

SITE PLAN

(| | C-1.1

SHEET INDEX SITE DEVELOPMENT DATA ZONING : TR-LIZ 36,589 S.F./ 0.84 ACRES 72 DU 508 S.F. / DU 86 UNITS/ACRE DWELLING UNITS C-0. NOTES & LEGENDS C-0.1 NOTES & LEGENOS
C-1.0 EXTENS C CONDITIONS
C-2.0 DEMOLITION FLAN
C-3.0 GRADING & EROSION CONTROL PLAN
C-3.0 GANDRING & EROSION CONTROL PLAN
C-5.0 CONSTRUCTION DETAILS
C-5.1 CONSTRUCTION DETAILS
C-5.2 CONSTRUCTION DETAILS
C-5.2 CONSTRUCTION DETAILS 27,139 S.F. = 74% (80% MAX, ALLOWED) 11,269 S.F. OR 156 S.F. / D.U. (40 S.F./ D.U. MIN. REQUIRED) DWELLING UNIT MIX: EFFICIENCY L-I.I LANDSCAPE PLAN L-2.I LANDSCAPE WORKSHEET ONE BEDROOM + DEN TWO BEDROOM + DEN TOTAL UNITS A-I.0 BASEMENT PLAN
A-I.1 HRST FLOOR PLAN
A-I.2 SECOND FLOOR PLAN
A-I.3 THIRD FLOOR PLAN
A-I.4 FOURTH FLOOR PLAN
A-I.5 HFTH FLOOR PLAN
A-I.6 ROOF PLAN VEHICLE PARKING STALLS: UNDERGROUND TOTAL 70 VEHICLE STALLS 85 VEHICLE STALLS BICYCLE PARKING STALLS

SURFACE GUESTISHOAT-TERM
UNDERGROUND GARAGE
UNDERGROUND GARAGE
UNDERGROUND GARAGE
1571LIS
80 RIKE STALLS
80 RIKE STALLS
80 RIKE STALLS A-2.1 EXTERIOR ELEVATIONS
A-2.2 EXTERIOR ELEVATIONS
A-2.3 EXTERIOR ELEVATIONS - COLOR
A-2.4 EXTERIOR ELEVATIONS - COLOR A-5. TYPICAL UNIT LAYOUT

GENERAL NOTES:

RENDERINGS

knothe - bruce
A R C H I T C T S

BEEL TO THE WHITE HOLE TO SEE THE SE

ISSUED Issued to DAT - August 5, 2021 Land Use Submittal - September Land Use Supplement - Septemb

IL THE APPLICANT SHALL REPLACE ALL SIDEWALK AND CURB AND GUTTER THAT ABUTS THE PROPRETY THAT IS DAMAGED BY THE CONSTRUCTION, OR ANY SIDEWALK AND CURB AND GUTTER WHICH THE CITY DENORMED DETERMEN SHORTS OF BE REPLACED BECAUSE IT IS NOT AT A DESIRABLE GRADE, REGARDLES OF WHETHER THE CONDITION EXISTED PRIOR TO BEGINNING CONSTRUCTION.

2.ALL WORK IN THE PUBLIC RIGHT OF WAY SHALL BE PERFORMED BY A CITY-LICENSED CONTRACTOR.

3.ALL DAMAGE TO THE PAVEMENT ON CITY STREETS, AND ADJACENT TO THIS DEVELOPMENT SHALL BE RESTORED IN ACCORDANCE WITH THE CITY OF MADISON'S PAVEMENT PATCHING CONTROL.

4. ALL PROPOSED STREET TREE REMOVALS WITHIN THE RESHT OF WAY SHALL BE REMEWED BY CITY FORSTY BEFORE THE RAIL COMMEDIAN METERN. STREET THE REMOVALS REQUIRE MEMOVAL AND THE REPROVAL PROPERTY. AND STREET THE REMOVAL AND THE REPROVAL REPORT THE COMMENSION OF THE REPORT AND THE REMOVAL PROPERTY. AND STREET THE RESOURCE AND THE ROBBE OF PRESET WORKS AND CITY FORSTRY WILL REQUIRE A PROPERTY OF THE ADDRESSON WITHIN WHO'S DETRICTE AFFECTED BY THE STREET TREE REMOVAL(B) PRIOR TO A TREE REMOVAL FIRST BRIDE STREET THE REMOVAL OF THE STREET THE S

SAS DEFINED BY THE SECTION 167 ID OF CITY OF MADBON STANDAND SPECIFICATIONS FOR PUBLIC WORKS CONTRUCTION NO EXCUNATION REPORTED WITH SECTION FOR THINK OF THE STREET REG OF WHICH CUTTING ACCOST OF ALL NORSH INCHESTS. IF THINK OF THE STREET REG OF WHICH CONTRING ACCOST AND THE STREET REG OF WHICH THE ACCOST AND THE STREET REG OF THE

ACONTRACTOR SHALL TAKE PRECAUTIONS DURING CONSTRUCTION TO NOT DESHQURE. SCAR, OR PHANR THE HEALTH OF ANY STREET THE CONTRACTOR SHALL OPERATE COLUMBRIN THE AMENISMA ST DO NOT DAMAGE THE BRANKES OF THE STREET TREES, THIS HAVE REQUIRE UNKNOWN SHALLES OF THE TIME OF THE STREET TREES, THIS HAVE THE STREET STREET THE STREET OF THE STREET THE STREET OF THE STREET OF

7.5C.(TION 107.1105) OF CITY OF MOREON STANDARD SECREPATIONS FOR FURILE, WORKS CONTRUCTION AND RESEARCH COMPRISED THE STREET THESE AND SHALL SE COLUMNETS. BLOKEN OF ATTEMENT AND STANDARD STAND

8.ON THIS PROJECT, STREET TREE PROTECTION ZONE FENCING IS REQUIRED. THE FENCING SHALL BE ERECTED BETORE THE DEPOLITION, GRADNED OR CONSTRUCTION BEGINS. THE PRICES SHALL INCLUDE THE ENTIRE WHITHOUT OF TERRACE AND, EXTEND AT LESTS 1 SEET ON BOTH SIDES OF THE OUTSIDE EDGS OF THE TREET TRUNK. DO NOT REMOVE THE PRIVICIPAL OF ALLOW FROM DELINERS OR EQUIPMENT ACCESS TRINCOLD HET THE TREE PROTECTION ZONE.

9.STREET TREE PRUNING SHALL BE COORDINATED WITH MADISON FORESTRY AT A MINIMUM OF TWO WESKS PRIOR TO THE START OF CONSTRUCTION FOR THE PROJECT. ALL PRUNING SHALL FOLLOW THE AMERICAN NATIONAL STANDARDS INSTITUTE (ANSI) A300 - PART I STANDARDS FOR PRUNING.

IO. APPROVAL OF PLANS FOR THIS PROJECT DOES NOT INCLUDE ANY APPROVAL TO PRUNE, REMOVE, OR PLANT TREES IN THE PUBLIC RIGHT-OF-WAY, PERMISSION FOR SUCH ACTIMITIES MUST BE OBTAINED FROM THE CITY FORESTER (266-4816).

II. THE PUBLIC RIGHT-OF-WAY IS THE SOLE JURISDICTION OF THE CITY OF MADISON AND IS SUBJECT TO CHANGE AT ANY THE. NO TIEMS SHOWN ON THIS STE PLAN IN THE RIGHT-OF-WAY ARE PERMANENT AND MAY NEED TO BE REMOVED AT THE APPLICANTS EXPENSE UPON NOTHECATION BY THE CITY.

SHEET TITLE
Site Plan

PROIECT TITLE

Madison, WI

222 N. Midvale Blvd.

SHEET NUMBER

C-I.I

PROJECT NO.

GRAPH**I**C SCALE
20 40 60


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BIKE RACKS:


INTERIOR & EXTERIOR FLOOR MOUNTED: "INVERTED U" TYPE. MADRAX UX OR SARIS BIKE DOCK

A 14

INTERIOR WALL MOUNTED: MADRAX VERTICAL RACK OR SARIS BIKE TRACK

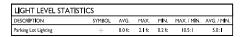

SYMBOL	LABEL	QTY	. MANUF.	CATALOG	DESCRIPTION	FILE	MOUNTING
	A	I	LITHONIA LIGHTING	DSX0 LED P 1 30K BLC MVOLT	DSX0 LED PI 30K BLC MVOLT	DSX0_LED_PI_30K_BLC _MVOLT.ies	16'-0" POLE ON 2'-0" TALI CONC. BASE
	В	1	LITHONIA LIGHTING	DSX0 LED P I 30K BLC MVOLT	DSX0 LED PI 30K BLC MVOLT	DSX0_LED_PI_30K_BLC _MVOLT.ies	18'-0" POLE ON FLUSH CONC. BASE
		(Ç-4	150	DLUX CONTOUR = 0.25 FC DLUX CONTOUR = 0.5 FC DLUX CONTOUR = 1.0 FC GHT FEXTURE	

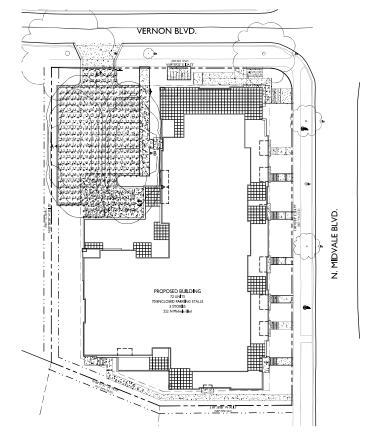





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Land Use Submittal - September [5, 202]


PROJECT TITLE 222 N Midvale Blvd

Madison, Wisconsin
SHEET TITLE
Site Lighting Plan

SHEET NUMBER

C-1.2

PROJECT NO. 2140

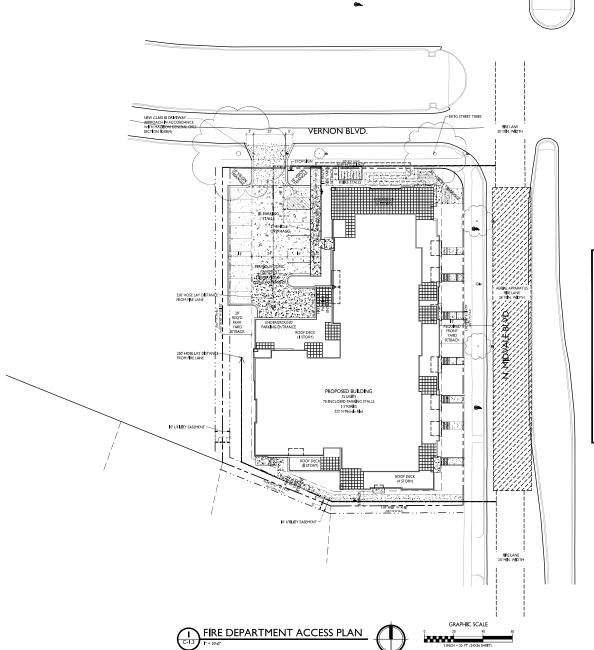

AcccDbFace (Acccland 110)

Knothe - bruce

FIRE DEPARTMENT ACCESS PLAN

AERIAL APPARATUS FIRE
LANE MINIMUM 26' WIDE


MINIMUM 20' WIDE ACCESS LANE W/ 28' INSIDE RADIUS

MAXIMUM 250' HOSE LAY TO EXTERIOR WALL FROM FIRE LANE

MAXIMUM 500' HOSE LAY TO FIRE LANE FROM TWO FIRE HYDRANTS

AY

ISSUED

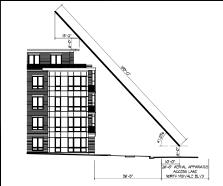

PROJECT TITLE
222 N Midvale Blvd

AERIAL ACCESS FROM STREET
N.T.S.


Madison, Wisconsin

Fire Department Access Plan

SHEET NUMBER

C-1.3

PROJECT NO. 2 140

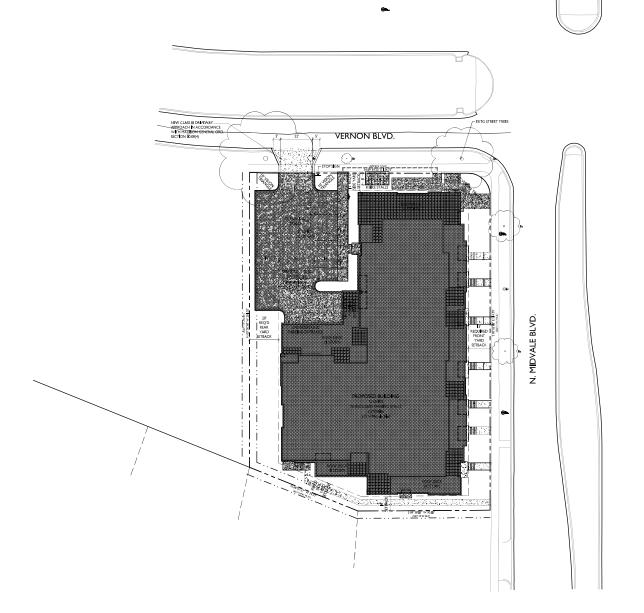



SSUED Land Use Submittal - September | 5, 202

PROJECT TITLE 222 N Midvale Blvd

Madison, Wisconsin
SHEET TITLE
Lot Coverage

SHEET NUMBER

LOT COVERAGE ZONING: TR-U2 MAXIMUM LOT COVERAGE:


LOT AREA PROPOSED COVERAGE

80%

36,589 S.F. 27,139 S.F. / 74%

LOT COVERAGE

AcccDBFace (Acccland \$10)

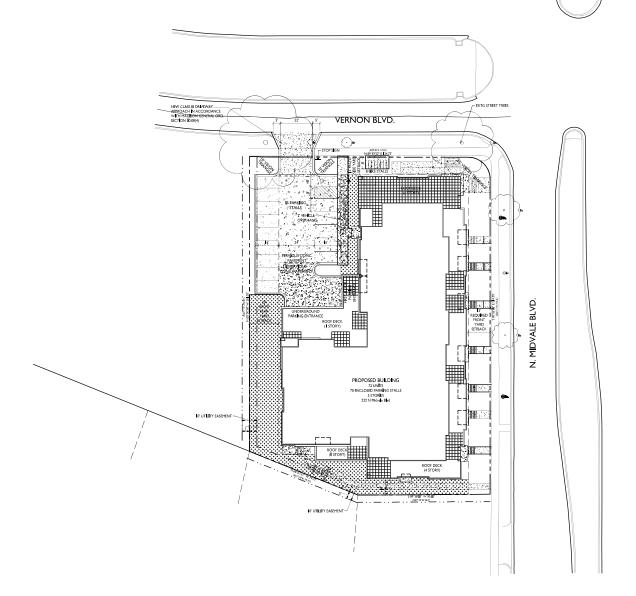



USABLE OPEN SPACE

ZONING: TR-J2

REQUIRED OPEN SPACE 40 S.F. / D.U.

DWELLING UNITS 72

2.880 S.F. REQUIRED

OPEN SPACE PROVIDED

BALCONIES / PRIVATE ROOF DECK 5.040 S.F.

COMMUNITY ROOF DECK 1.369 S.F.

SURFACE 4.880 S.F.

TOTAL 11269 S.F. PROVIDED

156 S.F. / D.U.

ISSUED
Land Use Submittal - September | 5, 202

PROJECT TITLE

222 N Midvale Blvd

Madison, Wisconsin
SHEET TITLE
Usable Open

Space

SHEET NUMBER

C-1.5

PROJECT NO. 2140

© Knothe & Bruce Architects, LLC

USABLE OPEN SPACE





- THE CONTRACTOR IS RESPONSIBLE FOR ANY DAMAGE CAUSED DURING CONSTRUCTION TO PUBLIC PROPERTY, PRIVATE PROPERTY OR UTILITIES.
- THE CONTRACTOR SHALL SUBMIT SHOP DRAWINGS FOR REVIEW BY THE ENGINEER, PRIOR TO PLACING AN ORDER OF ANY SUCH ITEM.
- EXISTING TOPOGRAPHIC INFORMATION IS BASED ON FIELD OBSERVATIONS AND/OR PLAN OF RECORD DRAWINGS. CONTRACTOR SHALL VERIFY TOPOGRAPHIC INFORMATION PRIOR TO STARTING CONSTRUCTION.
- RIGHT OF WAY (ROW) AND PROPERTY LINES ARE APPROXIMATE. CONTRACTOR SHALL BE RESPONSIBLE FOR PROTECTING EXISTING PROPERTY CORNER MONUMENTATION. ANY MONUMENTS DISTURBED BY CONTRACTOR SHALL BE REPLACED AT THE CONTRACTORS EXPENSE.
- CONTRACTOR SHALL COORDINATE WITH DRY UTILITY COMPANY'S REGARDING ANY POTENTIAL CONFLICTS AND COORDINATE RELOCATIONS AS MAY BE REQUIRED. CONTRACTOR SHALL ALSO COORDINATE THE PROPOSED INSTALLATION OF NEW FACILITIES AS REQUIRED.

- THIS SURVEY WAS PREPARED BASED UPON INFORMATION PROVIDED IN COMMITMENT FOR TITLE INSURANCE, COMMITMENT NO. 121070065, DATED JUNE 30, 2021 AT 7:44 A.M. FROM PREFERRED TITLE, LLC, 2728 COHO STREET, MADISON, WI 55713.
- 2. THE PARCELS SURVEYED CONTAIN 0.84 ACRES OR 36,619 SQ. FT. MORE OR LESS.
- THIS SURVEY IS BASED UPON FIELD SURVEY WORK PERFORMED BETWEEN JULY 27 AND JULY 30, 2021. ANY CHANGES IN SITE CONDITIONS AFTER JULY 30, 2021 ARE NOT REFLECTED BY THIS SURVEY.
- BENCHMARKS SHALL BE VERIFIED PRIOR TO CONSTRUCTION
- 5. ELEVATIONS DEPICTED ON THIS SURVEY ARE BASED UPON NAVD88 DATUM. (2012 GEOID)
- SURVEYOR HAS MADE NO INVESTIGATION OR INDEPENDENT SEARCH FOR EASEMENTS OF RECORD, ENCUMBRANCES, RESTRICTIVE COVENANTS, OR OWNERSHIP TITLE EVIDENCE.
- 7. UTILITY LOCATIONS WERE FIELD LOCATED BASED UPON SUBSTANTIAL, VISBLE, ABOVE GROUND STRUCTURES, UPON MAYS FROVIDED TO THE SURVEYOR, OR UPON MAKKINGS ON THE GROUND PLACED BY UTILITY OURPAINES AND/OR THEIR AGENTS. NO WARRANTY IS GIVEN TO THE UTILITY MARKINGS BY OTHERS OR THAT ALL UNDERGROUND UTILITIES AFFECTING THIS PROPERTY WERE MARKED AND SUBSEQUENTLY LOCATED FOR THIS SURVEY. A LOCATE REQUEST WAS SENT TO DIGGETS HOTHURE PER DIGGER'S HOTLINE ONE—CALL TICKET NUMBERS 20213107255, 20213107633, 20213107683, AND 20213107701. LOCATION OF BURIED PRIVATE UTILITIES ARE NOT WITHIN THE SCOPE OF THIS SURVEY.

DEMOLITION NOTES:

- CONTRACTOR SHALL KEEP ALL CITY STREETS FREE AND CLEAR OF CONSTRUCTION RELATED DIRT/DUST/DEBRIS.
- 2. COORDINATE EXISTING UTILITY REMOVAL/ABANDONMENT WITH LOCAL AUTHORITIES AND UTILITY COMPANIES HAVING JURISDICTION.
- 3. ALL SANCUTTING SHALL BE FULL DEPTH TO PROVIDE A CLEAN EDGE TO MATCH NEW CONSTRUCTION. MATCH EXISTING PLEVATIONS AT POINTS OF CONNECTION FOR NEW AND EXISTING PAVEMENT, CURB. SIDEVALUES, ETC. ALL SANCUT LOCATIONS SHOWN ARE APPROXIMATE AND MAY BE FIELD ADJUSTED TO ACCOMMODATE CONDITIONS, CONTS, MATERIAL TYPE, ETC. REVOKE MINIMUM AMOUNT NECESSAY FOR INSTALLATION OF
- 4. CONTRACTOR SHALL PROVIDE AND SHALL BE RESPONSIBLE FOR ANY NECESSARY TRAFFIC CONTROL SIGNAGE AND SAFETY MEASURES DURING DEMOLITION AND CONSTRUCTION OPERATIONS WITHIN OR NEAR THE PUBLIC ROADWAY.
- COORDINATE TREE REMOVAL WITH LANDSCAPE ARCHITECT. ALL TREES TO BE REMOVED SHALL BE REMOVED IN THEIR ENTIRETY AND STUMPS SHALL BE GROUND TO 12" BELOW PROPOSED SUBGRADE.
- IF APPLICABLE, PROVIDE TREE PROTECTION FENCING PRIOR TO CONSTRUCTION OPERATIONS. MAINTAIN THROUGHOUT CONSTRUCTION.
- ALL LIGHT POLES TO BE REMOVED FROM PRIVATE PROPERTY SHALL BE REMOVED IN THEIR ENTIRETY, INCLUDING BASE AND ALL APPURTENANCES. COORDINATE ABANDONMENT OF ELECTRICAL LINES WITH ELECTRICAL ENGINEER AND OWNER PRIOR TO DEMOUTION.
- 8. CONTRACTOR SHALL CLOSE ALL ABANDONED DRIVEWAYS BY REPLACING THE CURB IN FRONT OF THE DRIVEWAYS AND RESTORING THE TERRACE WITH GRASS.
- 9. CONTRACTOR SHALL OBTAIN ANY NECESSARY DEMOLITION AND UTILITY PLUGGING PERMITS
- ANY DAMAGE TO THE CITY PAVEMENT, INCLUDING DAMAGE RESULTING FROM CURB REPLACEMENT, WILL REQUIRE RESTORATION IN ACCORDANCE WITH THE CITY ENGINEERING PATCHING CRITERIA.

- 1. CONCRETE TO BE 5" THICK, CONSTRUCTED ON A BASE OF 4" COMPACTED SAND OR CRUSHED STONE.
- CONCRETE FOR DRIVEWAYS AND SIDEWALK AT DRIVEWAY ENTRANCES SHALL BE 7" THICK, CONSTRUCTED ON A BASE OF 5" COMPACTED SAND OR CRUSHED STONE.
- 3. ALL DIMENSIONS WITH CURB & GUTTER ARE REFERENCED TO THE FACE OF CURB.
- 4. CONTRACTOR SHALL DEEP TILL ANY DISTURBED AREAS AFTER CONSTRUCTION IS COMPLETE AND BEFORE RESTORING.
- CONTRACTOR TO OBTAIN ANY NECESSARY DRIVEWAY CONNECTION, RIGHT OF WAY AND EXCAVATION PERMITS PRIOR TO CONSTRUCTION.
- ANY SIDEWALK AND CURB & GUTTER ABUITING THE PROPERTY SHALL BE REPLACED IF IT IS DAMAGED DURING CONSTRUCTION OR IF THE CITY ENGINEERING DEPARTMENT DETERMINES THAT IT IS NOT AT A DESIRABLE GRADE, REGARDLESS OF WHETHER THE CONDITION EXISTED PRIOR TO BEGINNING CONSTRUCTION.


GRADING NOTES:

- CONTOURS ARE SHOWN FOR PURPOSES OF INDICATING ROUGH GRADING, FINAL GRADE SHALL BE ESTABLISHED ON PAVED SURFACES BY USING SPOT GRADES ONLY.
- 2. ALL GRADES SHOWN REFERENCE FINISHED ELEVATIONS.
- 3. CROSS SLOPE OF SIDEWALKS SHALL BE 1.5% UNLESS OTHERWISE NOTED.
- LONGITUDINAL GRADE OF SIDEWALK RAMPS SHALL NOT EXCEED 8.33% (1:12) AND SHALL BE IN ACCORDANCE WITH ADA REQUIREMENTS.
- LONGITUDINAL GRADE OF SIDEWALK SHALL NOT EXCEED 5.0% OR THE ADJACENT STREET GRADE WHICHEVER IS GREATER.
- ACCESSIBLE ROUTES SHALL BE 5.0% MAX LONGITUDINAL SLOPE AND 1.5% MAX CROSS SLOPE. ACCESSIBLE LOADING AREAS OR LANDINGS SHALL BE 6.33% MAX SLOPE IN ANY DIRECTION. RAMPS SHALL BE 6.33% MAX SLOPE.
- 7. NO LAND DISTURBANCE ACTIVITIES SHALL BEGIN UNTIL ALL EROSION CONTROL BMP'S ARE INSTALLED.
- 8. SEE DETAIL SHEETS FOR EROSION CONTROL NOTES AND CONSTRUCTION SEQUENCE.

UTILITY NOTES:

- CONTRACTOR SHALL OBTAIN ANY NECESSARY WORK IN RIGHT OF WAY, EXCAVATION, UTILITY CONNECTION, PLUGGING AND ABANDONMENT PERMITS PRIOR TO CONSTRUCTION.
- 2. CONTRACTOR TO VERIFY EXISTING UTILITY LOCATIONS AND ELEVATIONS PRIOR TO STARTING WORK.
- SANITARY & STORM SEWER LENGTHS SHOWN ARE FROM CENTER OF STRUCTURE TO CENTER OF STRUCTURE. STORM SEWER END SECTIONS ARE INCLUDED IN THE LENGTH AND SLOPE OF THE PIPE.
- 4. CONTRACTOR SHALL INVESTIGATE ALL UTILITY CROSSINGS PRIOR TO CONSTRUCTION AND NOTIFY ENGINEER OF ANY CONFLICTS.
- CONTRACTOR SHALL BE RESPONSIBLE FOR ADJUSTING ALL UTILITY STRUCTURES TO FINISHED GRADE (MANHOLE RIMS, WATER VALVES, AND CURB STOPS), IF NECESSARY.
- IF DEWATERING OPERATIONS EXCEED 70 GALLONS PER MINUTE OF PUMPING CAPACITY, A DEWATERING WELL PERMIT SHALL BE OBTAINED PRIOR TO STARTING ANY DEWATERING ACTIVITIES.
- A COPY OF THE APPROVED UTILITY PLANS, SPECIFICATIONS AND PLUMBING PERMIT APPROVAL LETTER SHALL BE ON-SITE DURING CONSTRUCTION AND OPEN TO INSPECTION BY AUTHORIZED REPRESENTATIVES OF THE DEPARTMENT OF SAFETY AND PROFESSIONAL SERVICES AND OTHER LOCAL INSPECTORS.
- 8. PROPOSED UTILITY SERVICE LINES SHOWN ARE APPROXIMATE. COORDINATE THE EXACT LOCATIONS WITH THE PLUMBING DRAWINGS. COORDINATE THE LOCATION WITH THE PLUMBING CONTRACTOR AND/OR OWNER'S CONSTRUCTION REPRESENTATIVE PRIOR TO INSTALLATION OF ANY NEW UTILITIES.
- STORM BUILDING SEWER PIPE SHALL CONFORM TO ONE OF THE STANDARDS LISTED IN TABLE 384.30-6 OF SPS 384.30(3)(c).
- 10. UNDERGROUND DRAIN AND VENT PIPE/TUBING SHALL CONFORM TO ONE OF THE STANDARDS LISTED IN TABLE 384.30-2 OF SPS 384.30(2).
- 11. PRIVATE WATER SERVICES AND PRIVATE WATER MAINS SHALL CONFORM TO ONE OF THE STANDARDS LISTED IN TABLE 384.30-7 OF SPS 384.30(4)(d).
- 12. PRIVATE SANITARY SEWER AND LATERALS SHALL BE POLYVINYL CHLORIDE (PVC) ASTM D3034 SDR 35 OR APPROVED EQUAL MATERIAL THAT CONFORMS TO ONE OF THE STANDARDS LISTED IN TABLE 384.30-3 OF SPS 384.30(2)(c).
- A MEANS TO LOCATE BURIED UNDERGROUND EXTERIOR NON METALLIC SEWERS/MAINS AND WATER SERVICES/MAINS MUST BE PRODUCED WITH TRACER WIRE OR OTHER METHODS IN ORDER TO BE LOCATED PER SPS 382.10(11)(n) AND SPS 382.40(6)(ic).

- 16. SITE CONTRACTOR SHALL LEAVE SANITARY AND WATER LATERALS FIVE (5) FEET SHORT (HORIZONTALLY) FROM THE BUILDING. BUILDING PLUMBER SHALL VERIFY SIZE, LOCATION, AND INVERT ELEVATION OF
- 18. CONTRACTOR TO CHLORINATE AND BACTERIA TEST BEFORE DOMESTIC SUPPLY PURPOSES
- CLEAN OUT ALL EXISTING AND PROPOSED STORM INLETS AND CATCH BASINS AT THE COMPLETION OF CONSTRUCTION.
- 21. CONTRACTOR SHALL COORDINATE WITH DRY UTILITY COMPANY'S REGARDING ANY POTENTIAL CONFLICTS AND COORDINATE RELOCATIONS AS MAY BE REQUIRED. CONTRACTOR SHALL ALSO COORDINATE THE PROPOSED INSTALLATION OF NEW FACILITIES AS REQUIRED.

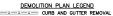

ASPHALT REMOVAL

CONCRETE REMOVAL

BUILDING REMOVAL TREE REMOVAL — SAWCUT

UTILITY STRUCTURE REMOVAL

SITE PLAN LEGEND PROPERTY BOUNDARY

CURB AND GUTTER (REVERSE CURB HATCHED) PROPOSED WOOD FENCE PROPOSED CONCRETE

PROPOSED PERVIOUS CONCRETE

PROPOSED BOLLARD

PROPOSED ADA DETECTABLE WARNING FIELD

ABBREVIATIONS TC - TOP OF CURB
FF - FINISHED FLOOR
FL - FLOW LINE
SW - TOP OF WALK
TW - TOP OF WALL
BW - BOTTOM OF WAL

GRADING LEGEND - EXISTING MAJOR CONTOURS -818 --- EXISTING MINOR CONTOURS

PROPOSED SPOT ELEVATIONS

INLET PROTECTION

PROPOSED MAJOR CONTOURS - B1B PROPOSED MINOR CONTOURS - · · - · · - DITCH CENTERLINE - SILT FENCE

ESSESSES VELOCITY CHECK

TRACKING PAD

DRAINAGE DIRECTION 2.92% PROPOSED SLOPE ARROWS EXISTING SPOT ELEVATIONS __1048.61

0

14. EXTERIOR WATER SUPPLY PIPING SETBACKS AND CROSSINGS SHALL BE IN ACCORDANCE WITH SPS 382.40(8)(b.).

15. NO PERSON MAY ENGAGE IN PLUMBING WORK IN THE STATE UNLESS LICENSED TO DO SO BY THE DEPARTMENT OF SAFETY AND PROFESSIONAL SERVICES PER S.145.06.

PROPOSED SANITARY AND WATER LATERALS.

17. IT IS THE CONTRACTOR'S RESPONSIBILITY TO VERIFY THAT THE EXISTING VALVES WILL HOLD THE PRESSURE TEST PRIOR TO CONNECTION. THE CITY IS NOT RESPONSIBLE FOR ANY COSTS INCURRED DUE TO THE CONTRACTOR NOT VERFINING THAT THE EXISTING VALVE WILL HOLD THE PRESSURE TEST PRIOR TO CONNECTION. IF A NEW VALVE IS REQUIRED, THE APPLICANT WILL BE REQUIRED TO INSTALL ONE AT THEIR EXPENSE, AT THE POINT OF CONNECTION.

- 20. SANITARY SEWER MAIN AT BURY DEPTHS GREATER THAN 15' SHALL BE SDR 21. ALL OTHER SANITARY SEWER MAIN SHALL BE SDR 26.
- 22. ALL WATER MAIN AND SERVICES SHALL BE INSTALLED AT A MINIMUM DEPTH OF 6.5' FROM TOP OF FINISHED GRADE ELEVATION TO TOP OF MAIN. PROVIDE 1.5' CLEAR SEPARATION IF WATER CROSSES BELOW SEWER AND MINIMUM 0.5' IF WATER CROSSES ABOVE.

HATCHING LEGEND

EXISTING CONCRETE PAVEMENT/SIDEWALK

EXISTING ASPHALT

EXISTING CURB INLET

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pict

<u>e</u>

d Legends Midvale Blvd

Notes and Le

@ EXISTING STORM MANHOLE

EXISTING WATER MAIN VALVE

FXISTING GAS VALVE

EXISTING DOWN GUY EXISTING ELECTRIC MANHOLE

EXISTING LIGHT POLE EXISTING ELECTRIC PEDESTAL

EXISTING UTILITY POLE

EXISTING TELEPHONE VAULT EXISTING HANDICAP PARKING

O EXISTING CONIFEROUS TREE O EXISTING DECIDUOUS TREE

LINEWORK LEGEND

— □ EXISTING UNDERGROUND TELEPHONE EXISTING RETAINING WALL

EXISTING GAS LINE

EXISTING OVERHEAD ELECTRIC LINE EXISTING OVERHEAD GENERAL LITHLITIES

EXISTING 8" SANITARY SEWER LINE EXISTING 10" SANITARY SEWER LINE EXISTING 12" SANITARY SEWER LINE

FXISTING LARGE DIAMETER BOX EXISTING 4" STORM SEWER LINE

EXISTING 6" STORM SEWER LINE EXISTING 8" STORM SEWER LINE EXISTING 12" STORM SEWER LINE

EXISTING 27" STORM SEWER LINE EXISTING 1" WATER SERVICE EXISTING 2" WATER SERVICE

- WH N --- WH N -- EXISTING 10" WATER MAIN - 820 - EXISTING MAJOR CONTOUR

PROPOSED UTILITY LEGEND STORM SEWER PIPE STORM SEWER MANHOLE

STORM SEWER CURB INLET STORM SEWER CURB INLET W/MANHOLE STORM SEWER FIELD INLET ROOF DRAIN CLEANOUT

SANITARY SEWER LATERAL PIPE - · · · · · · · WATER MAIN WATER SERVICE LATERAL PIPE FIRE HYDRANT

WATER VALVE −6 - GAS MAIN - or - or - ELECTRIC SERVICE

ABBREVIATIONS

EXISTING SIGN

EXISTING FIELD INLET RECTANGULAR EXISTING FIELD INLET

FXISTING ROOF DRAIN

S EXISTING SANITARY MANHOLE " EXISTING FIRE HYDRANT

EXISTING ELECTRIC RECTANGULAR MANHOLE

EXISTING GENERIC LIGHT

EXISTING TELEPHONE PEDESTAL

⊕ EXISTING SHRUB

EXISTING CHAIN LINK CONSTRUCTION FENCE

EXISTING UNDERGROUND ELECTRIC LINE

EXISTING SANITARY SEWER LATERAL

EXISTING 21" SANITARY SEWER LINE STORM SEWER LINE (SIZE NOTED)

EXISTING 15" STORM SEWER LINE

- NYS - NYS - FXISTING 6" WATER MAIN


--- 818 --- EXISTING MINOR CONTOUR


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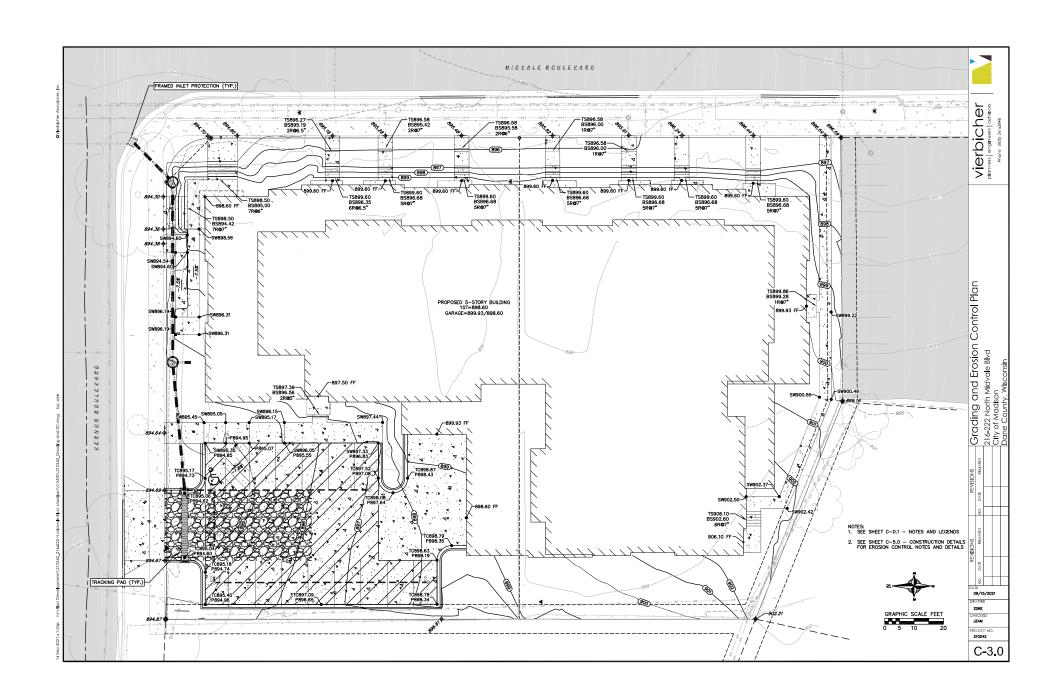
ZDRE


NOT FOR CONSTRUCTION

C-0.1



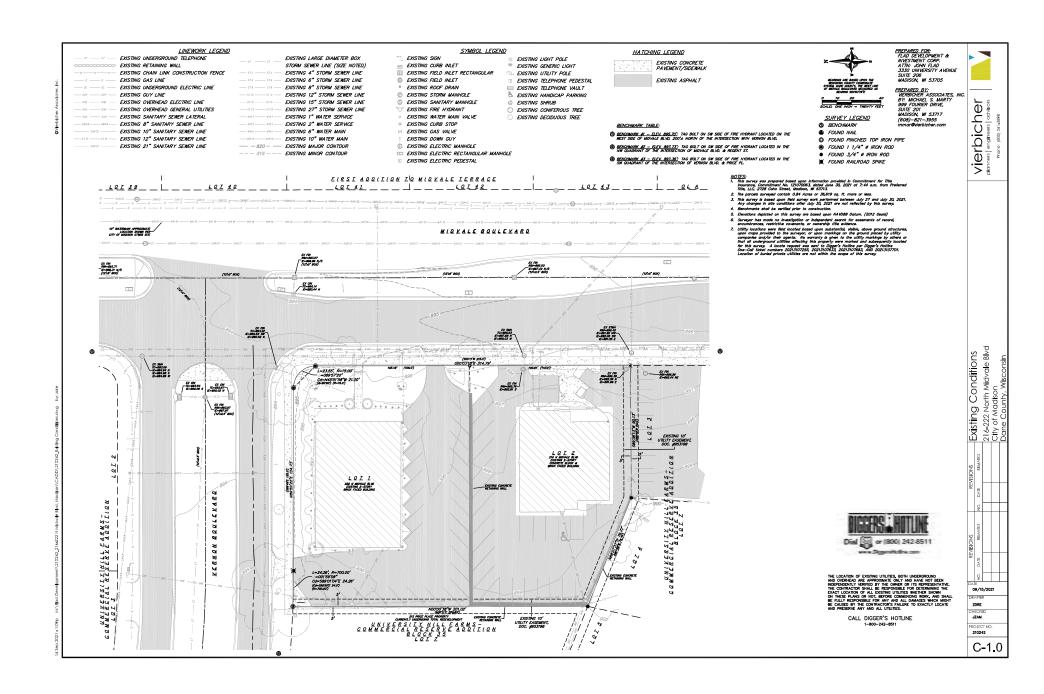

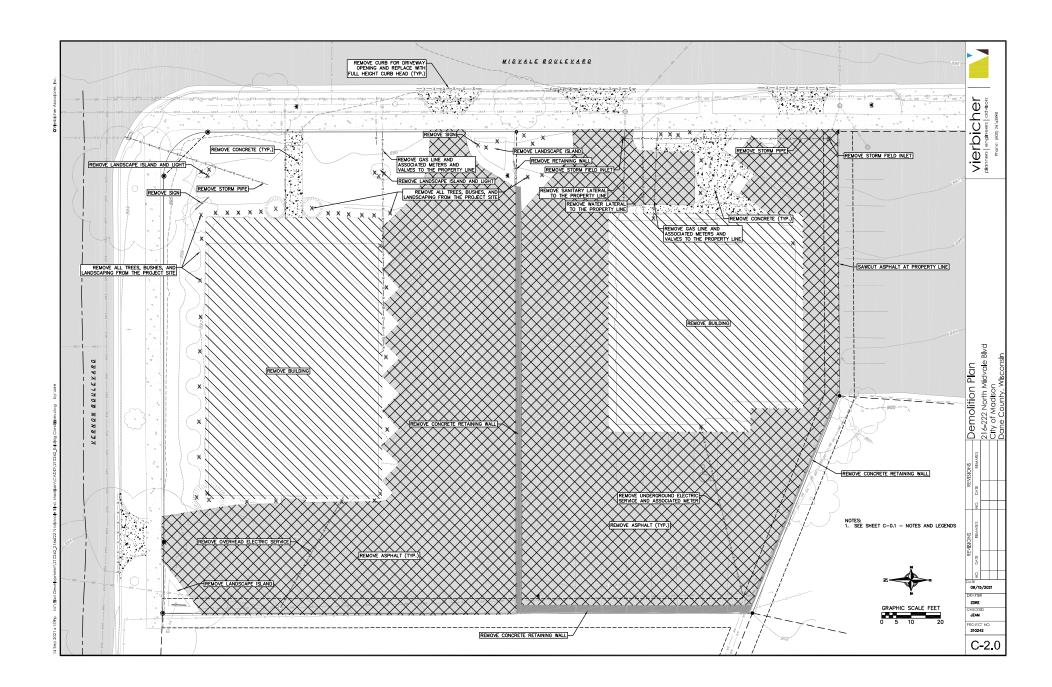

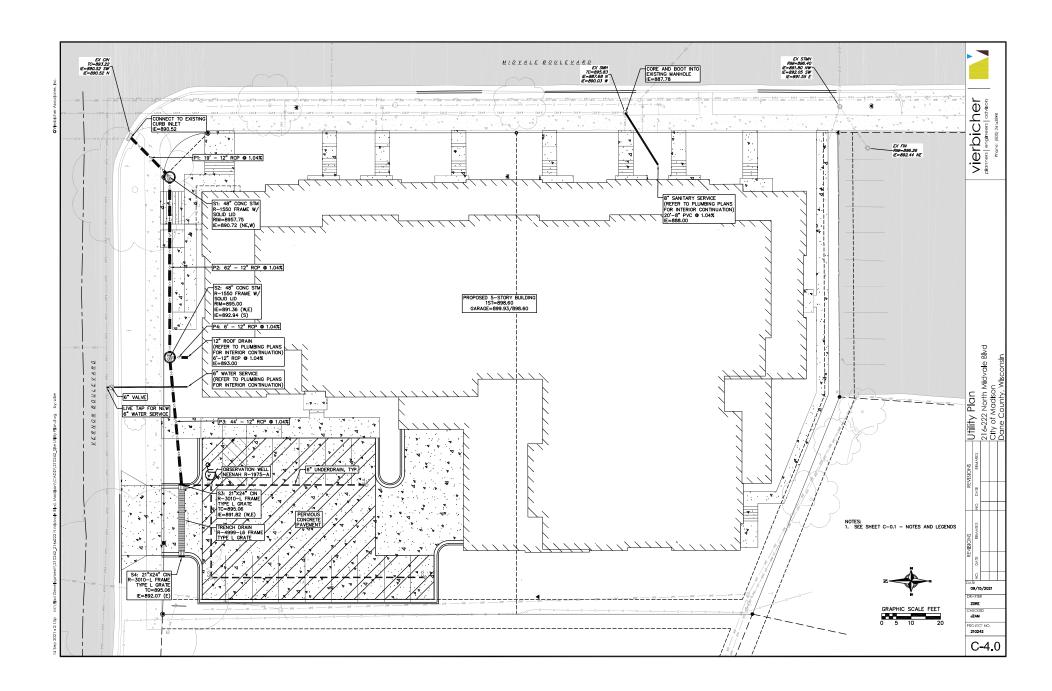

EROSION CONTROL MEASURES

- 1. EROSION CONTROL SHALL BE IN ACCORDANCE WITH THE CITY OF MADISON EROSION CONTROL ORDINANCE AND CHAPTER NR 216 OF THE WISCONSIN ADMINISTRATIVE CODE.
- CONSTRUCT AND MAINTAIN ALL EROSION AND SEDIMENT CONTROL MEASURES IN ACCORDANCE WITH WISCONSIN DNR TECHNICAL STANDARDS (http://dnr.ml.gov/runoff/stornwater/techstds.htm) AND WISCONSIN CONSTRUCTION SITE BEST MANAGEMENT PRACTICE HANDBOOK.
- 3. INSTALL SEDIMENT CONTROL PRACTICES (TRACKING PAD, PERIMETER SILT FENCE, INLET PROTECTION, ETC.) PRIOR TO INITIATING OTHER LAND DISTURBING CONSTRUCTION ACTIVITIES.
- THE CONTRACTOR IS REQUIRED TO MAKE EROSION CONTROL INSPECTIONS AT THE END OF EACH WEEK AND WHEN 0.5 INCHES OF RAIN FALLS WITHIN 24 HOURS. INSPECTION MEDICATE SHALL BE PREPARED AND FILED AS REQUIRED BY THE DNR AND/OR CITY. ALL MAINTENANCE WILL FOLLOW AN INSPECTION WITHIN 24 HOURS.
- 5. EROSION CONTROL IS THE RESPONSIBILITY OF THE CONTRACTOR UNTIL ACCEPTANCE OF THIS PROJECT. EROSION CONTROL MEASURES AS SHOWN SHALL BE THE MINIMUM PRECAUTIONS THAT WILL BE ALLOWD. ADDITIONAL EROSION CONTROL MEASURES, AS REQUESTED IN WRITING BY THE STATE OR LOCAL INSPECTORS, OR THE DEVELOPER'S ENGINEER, SHALL BE INSTALLED WITHIN 24 HOURS.
- 6. A 3" CLEAR STONE TRACKING PAD SHALL BE INSTALLED AT THE DID OF ROAD CONSTRUCTION LIMITS TO PREVENT SEDIMENT FROM BEING TRACKED INTO THE ANALOGENT PALADE PUBLIC ROAD WAY. SEDIMENT TRACKING PAD SHALL CONFORM TO WIGHOUT RECHNICAL STANDARD 1057. SEDIMENT REACHING THE PUBLIC ROAD SHALL BE REMOVED BY STREET CLEANING (NOT HYDRAULIC FLUSHING) BEFORE THE END OF EACH WORK DAY.
- 7. CHANNELIZED RUNOFF: FROM ADJACENT AREAS PASSING THROUGH THE SITE SHALL BE DIVERTED AROUND DISTURBED AREAS.
- 8. STABILIZED DISTURBED GROUND: ANY SOIL OR DIRT PILES WHICH WILL REMAIN IN EXISTENCE FOR MORE THAN 7-CONSECUTIVE DAYS, WHETHER TO BE WORKED DURING THAT PERIOD OR NOT. SHALL NOT BE LOCATED WITHIN 25-FEET OF ANY ROADWAY, PARKING LOT. THE LITER TO BE WATERU DUTWING THAT PETIND OR NOT, STALL NOT BE LUCKAIED WITHIN 25-FEET OF ANY ROADWAY, PARKING LOT, PAYED AREA, OR PRAINAGE STRUCTURE OR CHANNEL (UNLESS INTENDED TO BE USED AS PART OF THE EROSION CONTINUA MEASURES). TEMPORARY STABILIZATION AND CONTROL MEASURES (SEEDING, MULCHING, TARPING, EROSION MATTING, BARRIER FENCING, ETC.) ARE REQUIRED FOR THE PROTECTION OF DISTURBED AREAS AND SOIL PILES, WHICH WILL FEMAN UN-WORKED FOR A PERIOD OF MORE THAN 7-CONSECUTIVE CALENDAR DAYS. THESE MEASURES SHALL REMAIN IN PLACE UNTIL SITE HAS STRBILZED.
- SITE DE-MATERING: WATER PUMPED FROM THE SITE SHALL BE TREATED BY TEMPORARY SEDIMENTATION BASINS OR OTHER APPROPRIATE CONTROL MEASURES. SEDIMENTATION BASINS SHALL HAVE A DEPTH OF AT LEAST 3 FEET, BE SURROUNDED BY SNOWERICE OR EQUIVALENT BARRIER AND HAVE SUPPLICATION. THE STREAM SHALL HAVE A DEPTH OF AT LEAST 3 FEET, BE SURROUNDED BY SNOWERICE OR DEVIVATION. THE OF NO MORE THAT DO GALLONS PER SQUARE FOOT PER DAY AT THE HIGHEST DEWATERING PUMPING RATE. WATER MAY NOT BE DISCHARGED IN A MANNER THAT CAUSES EXCISION OF THE STIE, A NEGHORING STIE, OR THE BEST OR BANKS OF THE RECEIVING WATER. POFULTREST WATER USES AND STIED THE RECEIVING WATER. POFULTREST WATER WATER WATER POFULTREST WATER WATER POFULTREST WATER WATER WATER POFULTREST WATER WATER WATER WATER WATER WATER POFULTREST WATER WA
- 10. INLET FILTERS ARE TO BE PLACED IN STORMWATER INLET STRUCTURES AS SOON AS THEY ARE INSTALLED. ALL PROJECT AREA STORM INLETS NEED WISCONSIN D.O.T. TYPE D INLET PROTECTION. THE FILTERS SHALL BE MAINTAINED UNTIL THE CITY HAS ACCEPTED THE BINDER COURSE OF ASPHALT.
- 11. RESTORATION (SEED, FERTILIZE AND MULCH) SHALL BE PER SPECIFICATIONS ON THIS SHEET UNLESS SPECIAL RESTORATION IS CALLED FOR ON THE LANDSCAPE PLAN OR THE DETENTION BASIN DETAIL SHEET.
- TERRACES SHALL BE RESTORED WITH 6" TOPSOIL, PERMANENT SEED, FERTILIZER AND MULCH. LOTS SHALL BE RESTORED WITH 6" TOPSOIL, TEMPORARY SEED, FERTILIZER AND MULCH.
- 13. SEED, FERTILIZER AND MULCH SHALL BE APPLIED WITHIN 7 DAYS AFTER FINAL GRADE HAS BEEN ESTABLISHED. IF DISTURBED AREAS WILL NOT BE RESTORED IMMEDIATELY AFTER ROUGH GRADING, TEMPORARY SEED SHALL BE PLACED.
- 14. FOR THE FIRST SIX WEEKS AFTER RESTORATION (E.G. SEED & MULCH, EROSION MAT, SOD) OF A DISTURBED AREA, INCLUDE SUMMER WATERING PROVISIONS OF ALL NEWLY SEEDED AND MULCHED AREAS WHENEVER 7 DAYS ELAPSE WITHOUT A RAIN EVENT.
- 15. SOIL STABILIZERS SHALL BE RAPPLED TO DISTURBED AREAS WITH SLOPES BETWEEN 10X AND 3.1 (DO NOT USE IN CHANNELS). SOIL STABILIZERS SHALL BE TYPE B. PER WISCONSIN DO.1. F.ALL (PRODUCT ACCEPTABILITY LIST), OR EQUAL. APPLY AT ARES AND METHODS SPECIFED PER MANUFACTURER/THIS SHEET. SOIL STABILIZERS SHALL BE RE-APPLIED WHENEVER VEHICLES OR OTHER EQUIPMENT TRACK ON THE AREA.
- 16. SILT FENCE OR EROSION MAT SHALL BE INSTALLED ALONG THE CONTOURS AT 100 FOOT INTERVALS DOWN THE SLOPE ON THE DISTURBED SLOPES STEEPER THAN 5% AND MORE THAN 100 FEET LONG THAT SHEET FLOW TO THE ROADWAY UNLESS SOIL STABILIZERS ARE USED.
- 17. INSTALL MINIMUM 6'-7' WIDE EROSION MAT ALONG THE BACK OF CURB AFTER TOPSOIL HAS BEEN PLACED IN THE TERRACE IF THIS AREA WILL NOT BE SEEDED AND MULCHED WITHIN 48 HOURS OF PLACING TOPSOIL.
- 18. SILT FENCE TO BE USED ACROSS AREAS OF THE LOT THAT SLOPE TOWARDS A PUBLIC STREET OR WATERWAY. SEE DETAILS. 19. SEDIMENT SHALL BE CLEANED FROM CURB AND GUTTER AFTER EACH RAINFALL AND PRIOR TO PROJECT ACCEPTANCE.
- 20. ACCUMULATED CONSTRUCTION SEDIMENT SHALL BE REMOVED FROM ALL PERMANENT BASINS TO THE ELEVATION SHOWN ON THE GRADING PLAN FOLLOWING THE STABILIZATION OF DRAINAGE AREAS.
- 21. ALL CONSTRUCTION ENTRANCES SHALL HAVE TEMPORARY ROAD CLOSED SIGNS THAT WILL BE IN PLACE WHEN THE ENTRANCE IS NOT IN USE AND AT THE END OF EACH DAY.
- 22. ANY PROPOSED CHANGES TO THE EROSION CONTROL PLAN MUST BE SUBMITTED AND APPROVED BY DANE COUNTY LAND CONSERVATION OR PERMITTING MUNICIPALITY.
- 23. THE CITY, OWNER AND/OR ENGINEER MAY REQUIRE ADDITIONAL EROSION CONTROL MEASURES AT ANY TIME DURING CONSTRUCTION

CONSTRUCTION SEQUENCE:

- INSTALL SILT FENCE, TRACKING PAD AND INLET PROTECTION ON EXISTING INLETS
- 2. STRIP TOPSOIL AND ROUGH GRADE SITE
- EXCAVATE AND CONSTRUCT BUILDING FOUNDATION
- 4. EXCAVATE AND CONSTRUCT UNDERGROUND UTILITIES
- CONSTRUCT PAVEMENT, STONE BASE, CURB & GUTTER, AND SIDEWALK.
- 6. RESTORE TERRACES
- REMOVE TRACKING PAD, SILT FENCE AND INLET PROTECTION AFTER DISTURBED AREAS ARE RESTORED

SEEDING RATES

- IEMPORARY:


 1. USE ANNUAL OATS AT 3.0 LB./1,000 S.F. FOR SPRING AND SUMMER PLANTINGS.
- 2. USE WINTER WHEAT OR RYE AT 3.0 LB./1,000 SF FOR FALL PLANTINGS STARTED


AFTER SEPTEMBER 15.

PERMANENT:
1. USE WISCONSIN D.O.T. SEED MIX #40 AT 2 LB./1,000 S.F.

TEMPORARY AND PERMANENT: USE WISCONSIN D.O.T. TYPE A OR B AT 7 LB./1,000 S.F.


IEMPORARY AND PERMANENT:
USE & TO 1-8 STRAW OR HAY MULCH, CRIMPED PER
SECTION 607.3.2.3, OR OTHER RATE AND METHOD PER SECTION
627, MISCONSIN O.D.T. STANDARD SPECIFICATIONS FOR
HIGHWAY AND STRUCTURE CONSTRUCTION

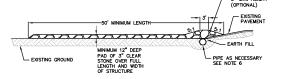

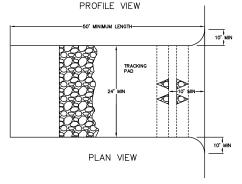

- 1. FOLLOW WISCONSIN DNR TECHNICAL STANDARD 1057 FOR FURTHER DETAILS AND INSTALLATION.
- 3. WIDTH 24' MINIMUM, SHOULD BE FLARED AT THE EXISTING ROAD TO PROVIDE A TURNING RADIUS.
- 4. ON SITES WITH A HIGH GROUND WATER TABLE OR WHERE SATURATED CONDITIONS EXIST, GEOTEXTILE FABRIC SHALL BE PLACED OVER EXISTING GROUND PRIOR TO PLACING STONE. FABRIC SHALL BE WISDOT TYPE—HIR GEOTEXTILE FABRIC.
- 5. STONE CRUSHED 3" CLEAR STONE SHALL BE PLACED AT LEAST 12" DEEP OVER THE ENTIRE LENGTH AND WIDTH OF ENTRANCE.
- SUPFACE WITER ALL SUFFACE WATTE FLOWNE TO OR DIFFERED TOWNEDS CONSTRUCTION ENTERMINES SHALL BE PIPED IMPROVED HER DIFFACE. WHAT AND ADDRESS HALL BE PROTECTED WITH A MOUNTABLE BERM WITH 51 SOPES AND MINIMUM OF 6' STONE OVER THE PIPE PENAL BE STED ACCORDING TO THE DRAINAGE REQUIREMENTS. WHEN THE SHARMORE STONE AND AND ADDRESS AN
- LOCATION A STABILIZED CONSTRUCTION ENTRANCE SHALL BE LOCATED WHERE CONSTRUCTION TRAFFIC ENTERS AND/OR LEAVES
 THE CONSTRUCTION SITE. VEHICLES LEAVING THE SITE MUST TRAVEL OVER THE ENTIRE LENGTH OF THE TRACKING PAD.



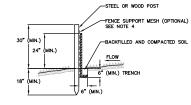

- INSTALL SILT FENCE TO FOLLOW THE GROUND CONTOURS AS CLOSELY AS POSSIBLE.
- CURVE THE SILT FENCE UP THE SLOPE TO PREVENT WATER FROM RUNNING AROUND THE ENDS.

MOUNTABLE BERI 6" MIN, HEIGHT

- POST SPACING WITH FENCE SUPPORT MESH = 10 FT. (MAX.)
- POST SPACING WITHOUT FENCE SUPPORT MESH = 6 FT. (MAX.)
- 4. SILT FENCE SUPPORT MESH CONSISTS OF 14-GAUGE STEEL WIRE WITH A MESH SPACING OF 6 IN. X 6 IN. OR PREFABRICATED POLYMERIC MESH OF EQUIVALENT STRENGTH

2	SILT	FENCE	
C-5.0	NOT TO	SCALE	


Construction Details 216-222 North Midvale Blvd City of Madison Dane County Wisconstru 09/15/2021


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210242

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PROJECT NO. 210242

Plant Material List

Broadleaf Dec	iduous			
Quantity	Code Name	Common Name	Scientific Name	Planting Size
9	ARM	Armstrong Maple	Acer X Freemanii 'armstrong'	2 I/2" B&B
5	AHHB	Amer Hophornbeam	Ostrya Virginiana	2" B&B
2	RPO	Regal Prince English Oak	Quercus Robur 'long'	2" B&B
Conifer Everg	reen			
Quantity	Code Name	Common Name	Scientific Name	Planting Size
18	EA	Emerald Arborvitae	Thuja Occidentalis 'smaragd'	6' B&B
3	WGA	Woodward Globe Arborvitae	Thuja Occidentalis 'woodwardii'	#5 CONT.
Perennia l				
Quantity	Code Name	Common Name	Scientific Name	Planting Size
50	KFG	Karl Foerster's Feather Reed Grass	Calamagnostis Acutiflora 'karl Foerster'	#I CONT.
Shrub				
Quantity	Code Name	Common Name	Scientific Name	Planting Size
6	GHC	Ground Hug Chokeberry	Aronia Melanocarpa 'uconnam0 l2'	#3 CONT.
8	LSMC	Low Scape Mound Chokeberry	Aronia Melanocarpa 'uconnam l 65'	#3 CONT.
24	DBH	Dwf Bush-Honeysuckle	Diervilla Lonicera	#5 CONT.
5	DROS	Double Red Oso Easy Rose	Rosa X 'meipeporia'	#3 CONT.
20	GFS	Goldflame Spirea	Spiraea Japonica 'goldflame'	#3 CONT.
I 5	PL	Palibin Lilac	Syringa Meyeri 'pa l ibin'	#5 CONT.
9	CLV	Chicago Lustre Arwd Viburnum	Viburnum Dentatum 'synnestvedt'	4' B&B

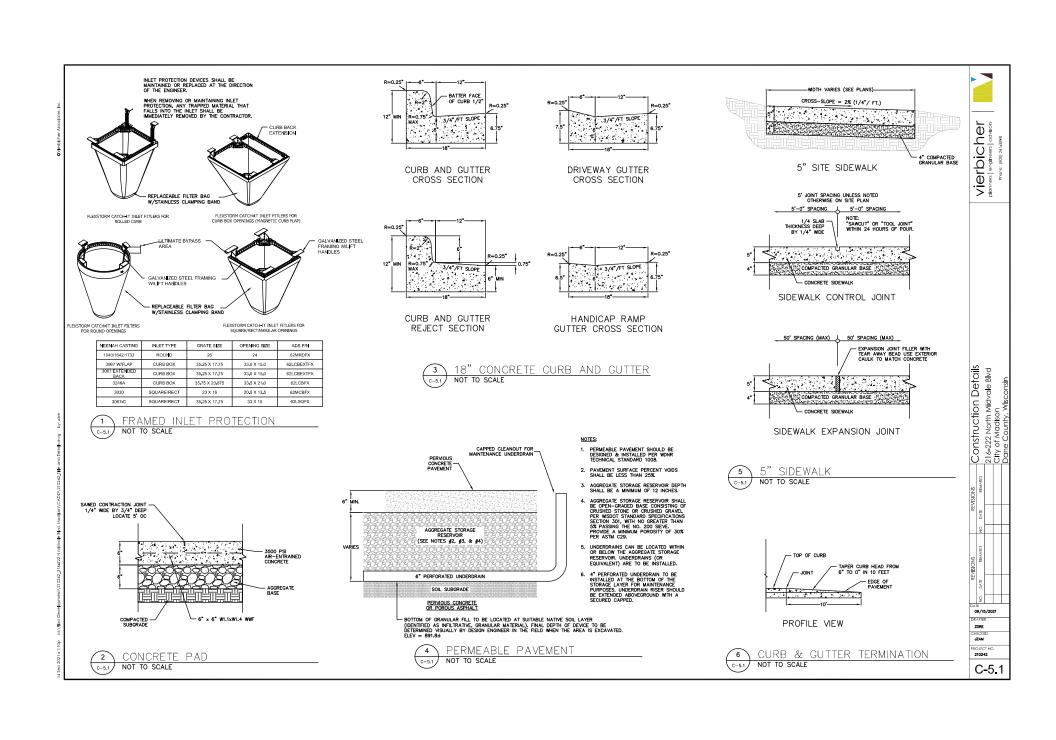GENERAL NOTES

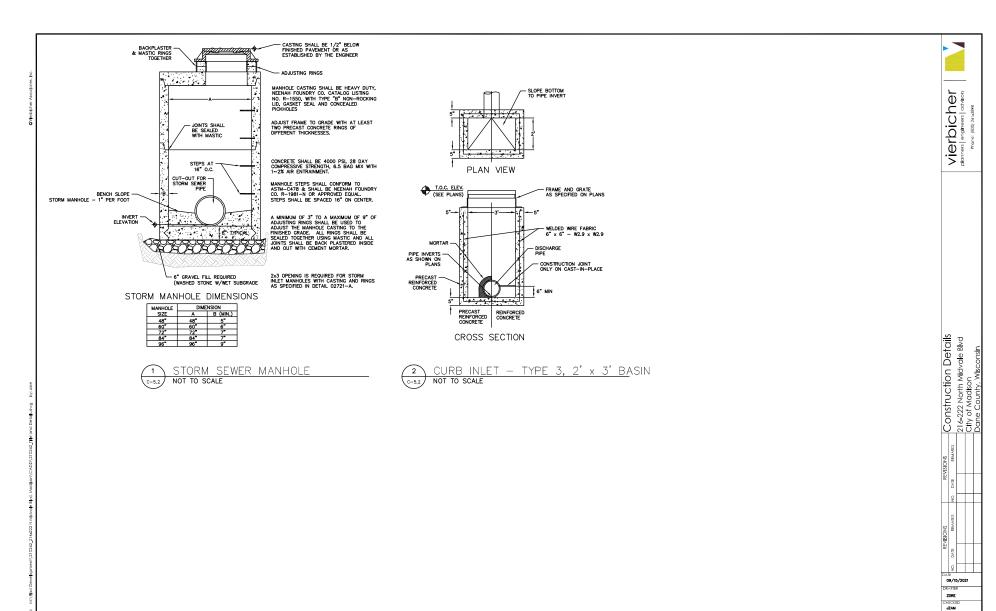A) Areas labeled "Brown Wood Mulch" to receive a mixture of recycled wood mulch, colored brown, spread to a 3" depth over pre-emergent herbicide.

B) Individual trees (and shrub groupings) found along perimeter of property as well as those found within lawn areas to receive wood mulch rings (and wood mulch beds) consisting of a mixture of recycled wood mulch, colored brown, spread to a minimum 3" depth (3' wide beds for shrub groupings).

C) "Vinyl Edging" to be Valley View Black Diamond Vinyl Edging or equivalent.

D) Areas labeled "washed stone" to receive 1-1/2" washed stone spread to a 3" depth over

E) "Seed" areas shall be finish-graded and seeded at a rate of 4 lbs. per 1,000 sq. ft.

F) Seed shall consist of the following mixture:

10% Palmer IV Perennial Ryegrass

20% Dragon Kentucky Bluegrass 20% Diva Kentucky Bluegrass

20% Foxy II Creeping Red Fescue I5% Vail II Perennial Ryegrass

15% Ginney Kentucky Bluegrass


G) Areas labeled "Seed/Mat" shall be seeded with the above-noted premium lawn seed mixture and overlaid with DS75 straw erosion control netting that is then pegged into the soil with metal staples.

H) Areas labeled "Sod" shall receive only No. I grade nursery-grown bluegrass sod.

I) Plant beds adjacent to building foundation to be mulched with 1-1/2" diameter washed stone mulch spread to a 3" depth over fabric weed barrier.

J) Existing street trees shall be protected. Contractor shall install tree protection fencing in the area between the curb and sidewalk and extend it at least 5 feet from both sides of the tree along the length of the terrace. No excavation is permitted within 5 feet of the outside edge of the tree trunk. If Excavation within 5 feet of any tree is necessary, contractor shall contact City Forestry (608)266-4892 prior to excavation to assess the impact to the tree and crost system. Tree pruning shall be coordinated with City Forestry. Tree protection specifications can be found in section 107.13 of City of Madison Standard specifications for Public Works Construction—
http://www.cityofmadison.com/business/pwldocuments/StdSpecs/2013/Part1.pdf.

K) Contractor shall contact City Forestry (608)266-4892 at least one week prior to installing street trees to schedule inspecting the nursery stock and reviewing landscaping specifications with the landscaper.

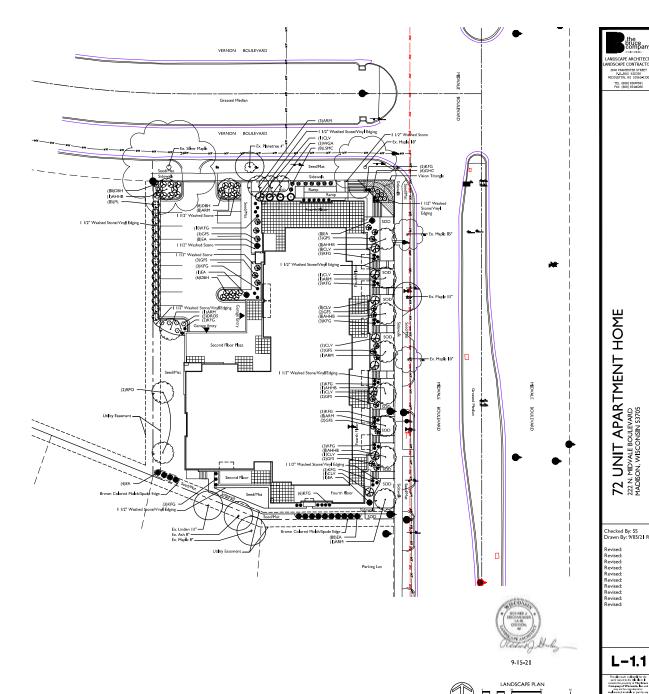

MADISON LANDSCAPE WORKSHEET

Zoning District: is TRU-2 Total square footage of developed area	5,638 SF
Total square footage of first 5 acres of developed area ÷ 300 square feet =	
Total square footage of 0 additional acres of developed area ÷ 100 square feet	: =0 Landscape Units
NUMBER OF LANDSCAPE POINT REQUIRED	
19 Landscape Units x 5 landscape points for first 5 acres	
0 Landscpe Units x I landscape point for additional 0 acres	
TOTAL LANDSCAPE POINTS REQURED	95 points

	Point	NE	W	EXIS	TING	
PLANT TYPE or ELEMENT	Value	Qty.	Points Achieved	Qty.	Points Achieved	
Overstory Deciduous Tree : 2-1/2" (dbh)	35	16	560			
Tall Evergreen Tree : 5-6 feet tall	35					
Ornamental Tree : I-I/2" Caliper (dbh)	15					
Upright Evergreen Shrub : 3-4 feet tall	10	18	I80			
Shrub, deciduous : 3 gallon / 12"-24"	3	87	26 I			
Shrub, evergreen : 3 gallon / 12"-24"	4	3	12			
Ornamental grass/perennial : I gallon / 8"-18"	2	50	100			
Ornamental / Decorative fencing or wall	4 per 10 l.f.					
Existing significant specimen tree	l 4 per Cal. In.					TOTAL
Landscape furniture for public seating and /or transit connections	5 per 'seat'					POINTS PROVIDED
	Sub	Totals	1,113	+		= 1,113

Street Frontage Landscape Required

Street Frontage = 382 LF

Canopy Trees Required: I per 30 LF Frontage = 13

Shrubs Required: 5 per 30 LF Frontage = 64

Street Frontage Landscape Supplied

Proposed Canopy Trees = 13 Proposed Shrubs = 64

72 UNIT APARTMENT HOME 222 N. MIDVALE BOULEVARD MADISON, WISCONSIN 53705

222 MAE


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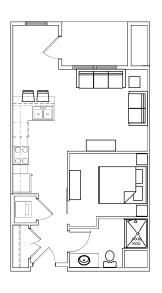
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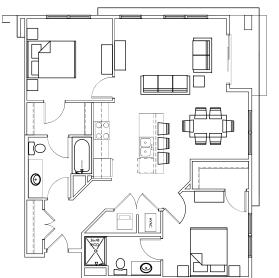
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ONE BEDROOM STUDIO TWO BEDROOM


222 N Midvale Blvd, Madison, Wisconsin sheet title Typical Unit Plans

SHEET NUMBER

PROJECT TITLE
THE
MANCHESTER

PROJECT NO. 2140

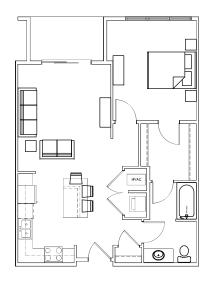• Knothe & Bruce Architects, LLC

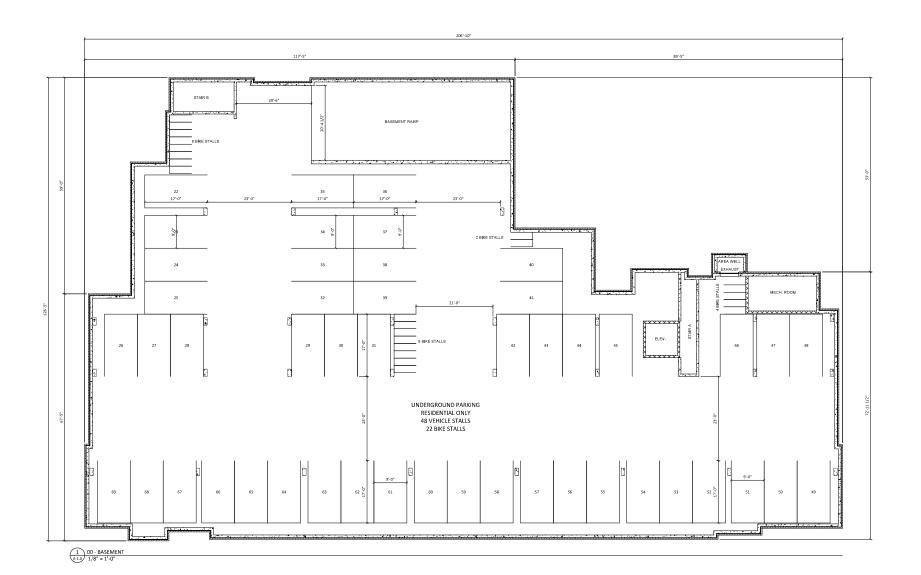

Knothe • bruce
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KEY PLAN

ISSUED Land Use Submittal - September 15, 2021

PROJECT TITLE
THE

MANCHESTER

222 N Midvale Blvd, Madison, WI 53705 SHEET TITLE

BASEMENT FLOOR PLAN


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A-1.0

PROJECT NUMBER 2140

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0' 1/2" 1" 2" 1/8" = 1 '-0" 4"



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A R C H | T E C T S
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(081331/9)
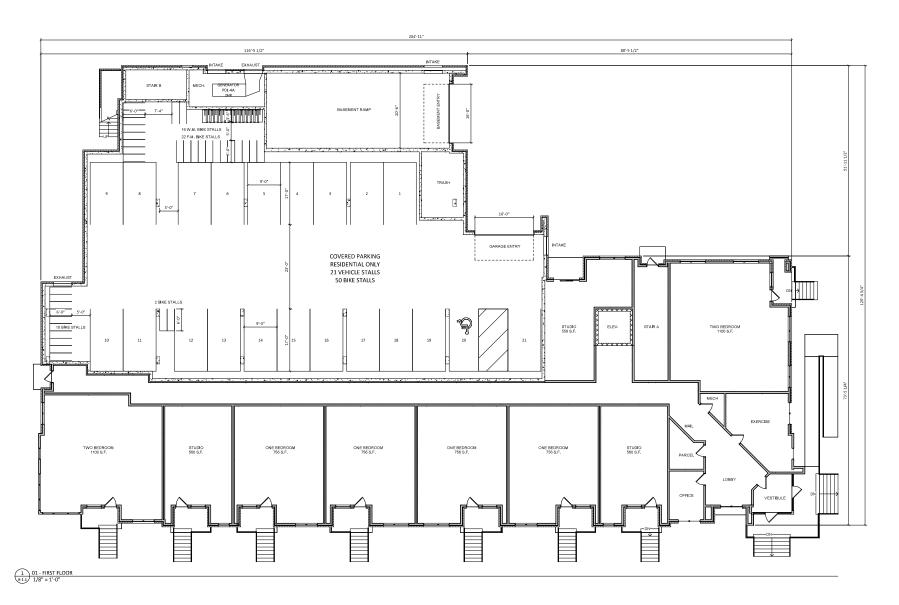
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PROJECT TITLE

THE MANCHESTER

222 N Midvale Blvd, Madison, WI 53705 SHEET TITLE

FIRST FLOOR PLAN

SHEET NUMBER

A-1.1

PROJECT NUMBER 2140

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0' 4' 8' 16' 32' 0' 1/2" 1" 2" 1/8" = 1 '-0" 4"



1 02 - SECOND FLOOR 1/8" = 1"=0"

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A R C H | T E C |
Flower | Model (Miller of Miller of Miller

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PROJECT TITLE

THE MANCHESTER

222 N Midvale Blvd, Madison, WI 53705 SHEET TITLE

SECOND FLOOR PLAN

SHEET NUMBER

A-1.2

PROJECT NUMBER 2140

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0' 1/2" 1" 2" 1/8" = 1 '-0" 4"



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KEY PLAN

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PROJECT TITLE
THE

MANCHESTER

222 N Midvale Blvd, Madison, WI 53705 SHEET TITLE THIRD FLOOR PLAN

SHEET NUMBER

PROJECT NUMBER 2140

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0' 1/2" 1" 2" 1/8" = 1'-0" 4"



04 - FOURTH FLOOR 1/8" = 1'-0"

KEY PLAN

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PROJECT TITLE

THE MANCHESTER

222 N Midvale Blvd, Madison, WI 53705 SHEET TITLE

FOURTH FLOOR PLAN

SHEET NUMBER

PROJECT NUMBER 2140





KEY PLAN

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THE MANCHESTER

PROJECT TITLE


222 N Midvale Blvd, Madison, WI 53705 SHEET TITLE

FIFTH FLOOR PLAN

SHEET NUMBER

A-1.5
PROJECT NUMBER 2140

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KEY PLAN

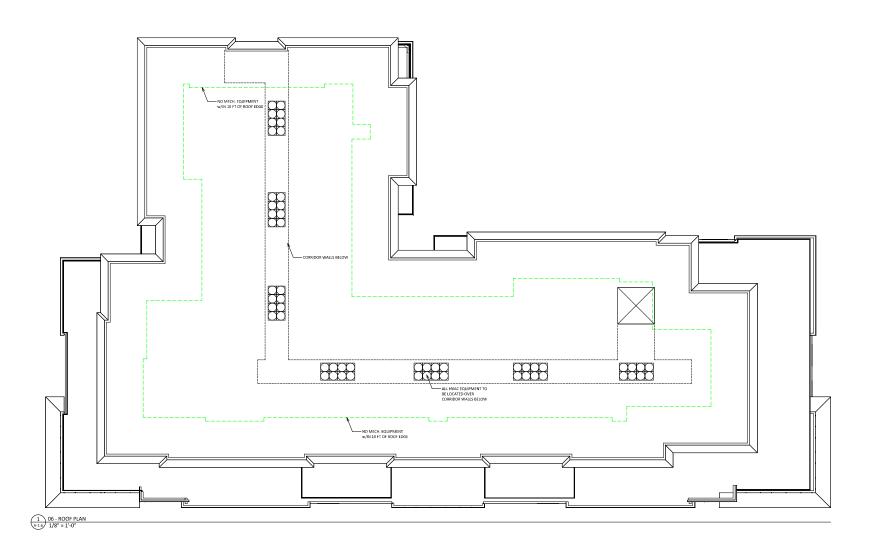ISSUED Land Use Submittal - September 15, 2021

PROJECT TITLE THE

MANCHESTER

222 N Midvale Blvd, Madison, WI 53705
SHEET TITLE

ROOF PLAN

SHEET NUMBER

PROJECT NUMBER 2140





2 ELEVATION - SOUTH 1/8" = 1'-0"

Knothe bruce
ARCHITECTS
Proc. 780 Ubreiny An #201
60883300

KEY PLAN

ISSUED Land Use Submit

PROJECT TITLE

THE MANCHESTER

222 N Midvale Blvd, Madison, WI 53705 SHEET TITLE EXTERIOR

EXTERIOR ELEVATIONS

SHEET NUMBER

BASEMENT 90'-8"

PROJECT NUMBER 2140





KEY PLAN

ISSUED

nd Use Submittal - September 15, 2



PROJECT TITLE THE

MANCHESTER

222 N Midvale Blvd, Madison, WI 53705 SHEET TITLE

EXTERIOR ELEVATIONS

SHEET NUMBER

 $\frac{\text{A-2.2}}{\text{\tiny PROJECT NUMBER} \ 2140}$



COLORED ELEVATION - NORTH



2 COLORED ELEVATION - SOUTH A-2.3 1/8" = 1'-0"



KEY PLAN

ISSUED Land Use Submittal - September 15, 2021

THE MANCHESTER

222 N Midvale Blvd, Madison, WI 53705 SHEET TITLE EXTERIOR

EXTERIOR ELEVATIONS COLORED

SHEET NUMBER

A-2.3
PROJECT NUMBER 2140





KEY PLAN

ISSUED Land Use Submitta

d Use Submittal - September 15,

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CONTOST SIN

PROJECT TITLE

THE MANCHESTER

222 N Midvale Blvd, Madison, WI 53705 SHEET TITLE

EXTERIOR ELEVATIONS COLORED

SHEET NUMBER

A-2.4

PROJECT NUMBER 2140















City of Madison Fire Department

314 W Dayton Street, Madison, WI 53703-2506

Phone: 608-266-4420 • Fax: 608-267-1100 • E-mail: fire@cityofmadison.com

Project Address:	222 N Midva	ale Blvd
Contact Name & Pl	none #:	Kevin Burow, 608-836-3690

FIRE APPARATUS ACCESS AND FIRE HYDRANT WORKSHEET

 Is the building completely protected by an NFPA 13 or 13R automatic fire sprinkler system? If non-sprinklered, fire lanes extend to within 150-feet of all portions of the exterior wall? If sprinklered, fire lanes are within 250-feet of all portions of the exterior wall? 	X Yes Yes Yes Yes Yes	☐ No ☐ No ☐ No	N/AN/AN/A
 2. Is the fire lane constructed of concrete or asphalt, designed to support a minimum load of 85,000 lbs? a) Is the fire lane a minimum unobstructed width of at least 20-feet? b) Is the fire lane unobstructed with a vertical clearance of at least 13½-feet? c) Is the minimum inside turning radius of the fire lane at least 28-feet? d) Is the grade of the fire lane not more than a slope of 8%? e) Is the fire lane posted as fire lane? (Provide detail of signage.) f) Is a roll-able curb used as part of the fire lane? (Provide detail of curb.) g) Is part of a sidewalk used as part of the required fire lane? (Must support +85,000 lbs.) 	 X Yes X Yes X Yes X Yes Yes Yes Yes Yes 	No	 N/A N/A N/A N/A N/A N/A N/A N/A N/A
3. Is the fire lane obstructed by security gates or barricades? If yes:a) Is the gate a minimum of 20-feet clear opening?b) Is an approved means of emergency operations installed, key vault, padlock or key switch?	☐ Yes ☐ Yes ☐ Yes	No No No	N/A N/A N/A N/A
4. Is the Fire lane dead-ended with a length greater than 150-feet? If yes, does the area for turning around fire apparatus comply with IFC D103?	☐ Yes ☐ Yes	X No No	□ N/A ▼ N/A
5. Is any portion of the building to be used for high-piled storage in accordance with IFC Chapter 3206.6 If yes, see IFC 3206.6 for further requirements.	Yes	X No	□ N/A
6. Is any part of the building greater than 30-feet above the grade plane?	X Yes	No	N/A
If yes, answer the following questions:			
If yes, answer the following questions: a) Is the aerial apparatus fire lane parallel to one entire side of the building and covering at least 25% of the perimeter?	X Yes	□No	□ N/A
 a) Is the aerial apparatus fire lane parallel to one entire side of the building and covering at least 25% of the perimeter? b) Is the near edge of the aerial apparatus fire lane between 15' and 30' from the building See sheet C-1 c) Are there any overhead power or utility lines located across the aerial apparatus fire lane? d) Are there any tree canopies expected to grow across the aerial fire lane? (Based on mature) 		_	_
 a) Is the aerial apparatus fire lane parallel to one entire side of the building and covering at least 25% of the perimeter? b) Is the near edge of the aerial apparatus fire lane between 15' and 30' from the building See sheet C-1 c) Are there any overhead power or utility lines located across the aerial apparatus fire lane? d) Are there any tree canopies expected to grow across the aerial fire lane? (Based on mature canopy width of tree species) e) Does the aerial apparatus fire lane have a minimum unobstructed width of 26-feet? 	.3☐ Yes X Yes	☐ No X No ☐ No	□ N/A □ N/A □ N/A
 a) Is the aerial apparatus fire lane parallel to one entire side of the building and covering at least 25% of the perimeter? b) Is the near edge of the aerial apparatus fire lane between 15' and 30' from the building See sheet C-I c) Are there any overhead power or utility lines located across the aerial apparatus fire lane? d) Are there any tree canopies expected to grow across the aerial fire lane? (Based on mature canopy width of tree species) e) Does the aerial apparatus fire lane have a minimum unobstructed width of 26-feet? f) Is the space between the aerial lane and the building free of trees exceeding 20' in heights? trees 7. Are all portions of the required fire lanes within 500-feet of at least (2) hydrants? 	.3	NoNoNoNoNoNo	 N/A N/A N/A N/A N/A N/A
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 a) Is the aerial apparatus fire lane parallel to one entire side of the building and covering at least 25% of the perimeter? b) Is the near edge of the aerial apparatus fire lane between 15' and 30' from the building See sheet C-I c) Are there any overhead power or utility lines located across the aerial apparatus fire lane? d) Are there any tree canopies expected to grow across the aerial fire lane? (Based on mature canopy width of tree species) e) Does the aerial apparatus fire lane have a minimum unobstructed width of 26-feet? f) Is the space between the aerial lane and the building free of trees exceeding 20' in heights? extg str. trees 7. Are all portions of the required fire lanes within 500-feet of at least (2) hydrants? Note: Distances shall be measured along the path of the hose lay as it comes off the fire apparatus. a) Is the fire lane at least 26' wide for at least 20-feet on each side of the hydrants? b) Is there at least 40' between a hydrant and the building? c) Are the hydrant(s) setback no less than 5-feet nor more than 10-feet from the curb or edge of the 	3 Yes	No	N/A

Attach an additional sheet if further explanation is required for any answers.

This worksheet is based on MGO 34.503 and IFC 2015 Edition Chapter 5 and Appendix D; please see the codes for further information.