


VICINITY MAP

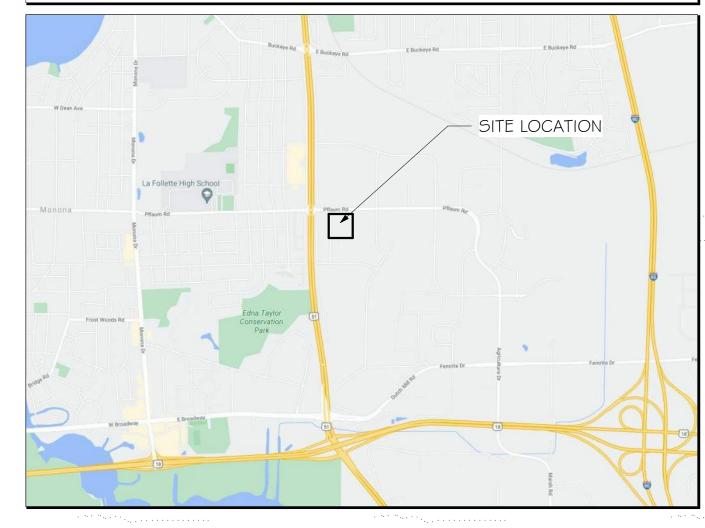

AERIAL VIEW OF SITE

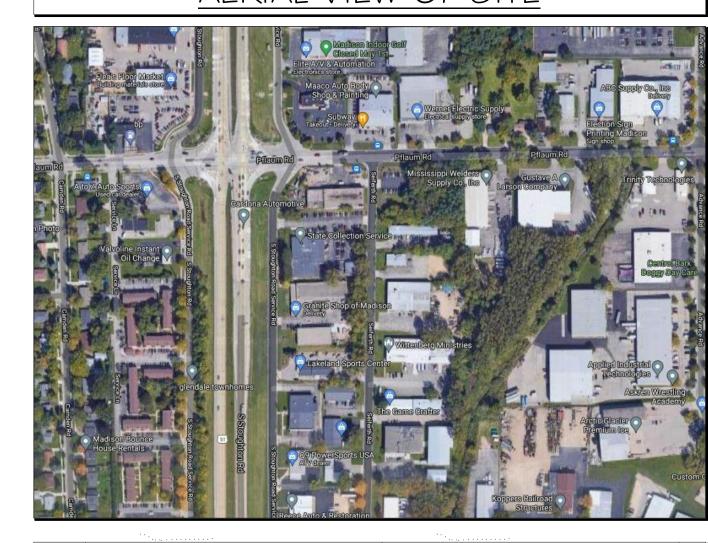

RED ROOSTER

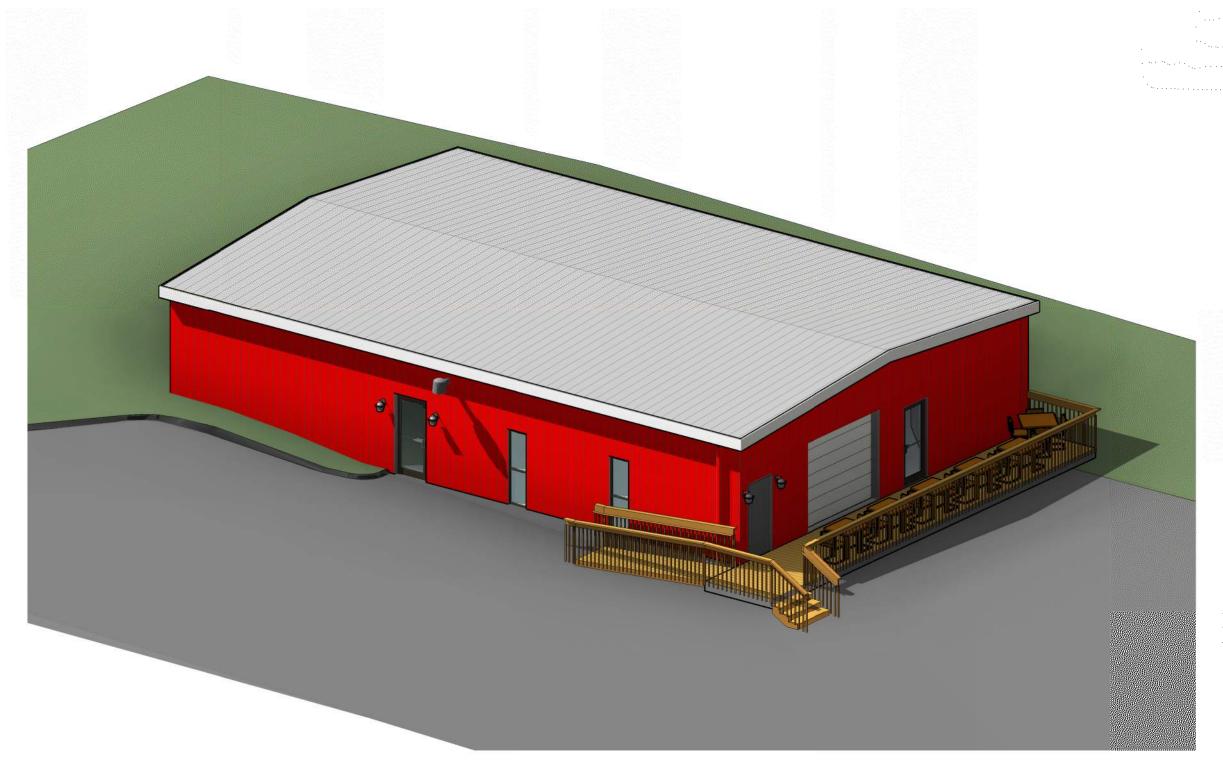

25 | 3 SEIFERTH ROAD MADISON DANE COUNTY, WI

GENERAL LOCATION



SHEET INDEX

GENERAL ARCHITECTURAL DEMO COVER SHEET _ADIOI DEMO - FIRST FLOOR PLAN

ADA DATA - IBC ARCHITECTURAL ADA DATA - IBC

FIRST FLOOR PLAN ···A201 EXTERIOR & INTERIOR ELEVATIONS

G00 I

G002

G003

G004

GENERAL DATA

ADA DATA - IBC

DOOR SCHEDULE

STRUCTURAL ENGINEER: RAMAKER \$ ASSOCIATES, INC. 855 COMMUNITY DRIVE SAUK CITY, WI 53583 PH: (608) 643-4100 FAX: (608) 643-7999

CONTACT: JEFF ZANDER EMAIL: JZANDER@RAMAKER.COM

DEVELOPER:

FORBAIR GROUP 6290 MARY IDA DR

ARCHITECT:

DE FOREST, WI 53532 PH: (608) 313-5454

CONTACT: NICK MCDONALD

EMAIL: NICK@FORBAIRGROUP.COM

RAMAKER \$ ASSOCIATES, INC.

EMAIL: JGALLAGHER@RAMAKER.COM

855 COMMUNITY DRIVE

SAUK CITY, WI 53583

PH: (608) 643-4100 FAX: (608) 643-7999 CONTACT: JOE GALLAGHER

PROJECT INFORMATION

RAMAKER
employee-owned
(608) 643-4100 www.ramaker.com

DATE 08/11/202

CITY OF MADISON CONDITIONAL USE APPROVAL SET PROJECT TITLE

RED ROOSTER

PROJECT OWNER

FORBAIR GROUP

BAR REMODEL

PROJECT LOCATION MADISON WI

COVER SHEET

PROJECT NUMBER 51488 SHEET NUMBER G00 I

GENERAL NOTES

- I. GENERAL NOTES APPLY TO ALL DRAWING SHEETS FOR ALL WORK DIVISIONS.
- CONTRACTOR TO FIELD VERIFY ALL DIMENSIONS AND EXISTING CONDITIONS PRIOR TO COMMENCING CONSTRUCTION. NOTIFY THE ARCHITECT IMMEDIATELY IF ANY CONFLICTS OR DISCREPANCIES OCCUR BEFORE AND/OR DURING CONSTRUCTION.
- VERIFY ALL SLAB ELEVATIONS AND DEPRESSIONS REQUIRED BY FLOOR FINISH SCHEDULE, SECTIONS, DETAILS AND SHOP DRAWINGS.
- 4. DO NOT SCALE DRAWINGS FOR BUILDING PURPOSES: USE PLAN INFORMATION, DIMENSIONS, DETAILS, SHOP DRAWINGS AND FIELD VERIFICATION.
- CROSS REFERENCE ARCHITECTURAL DRAWINGS W/ STRUCTURAL, MECHANICAL, ELECTRICAL AND PLUMBING DRAWINGS TO ASSURE COORDINATION OF LOCATIONS, SIZES, MATERIALS AND CODE COMPLIANCE. NOTIFY ARCHITECT IMMEDIATELY IF ANY CONFLICTS OR DISCREPANCIES ARE FOUND BEFORE PROCEEDING.
- FIRESTOP AROUND ALL PENETRATIONS IN RATED WALLS WITH UL APPROVED FIRESTOPPING MATERIAL. SINGLE SOURCE FIRESTOPPING IS REQUIRED. SEE
- PROVIDE METAL BACKING AND/OR WOOD BLOCKING IN WALLS AT ALL WALL MOUNTED EQUIPMENT. VERIFY HEIGHT AND LENGTH WITH ACTUAL EQUIPMENT. REFER TO BLOCKING AND FRAMING DETAILS WHERE APPLICABLE. SUPPORT BLOCKING TO MEET ALL REQUIRED CODES AND FIRE-RATING REQUIREMENTS.
- 8. GENERAL ARCHITECTURAL NOTES APPLY TO ALL ARCHITECTURAL DRAWING SHEETS.
- 9. ALL INTERIOR DIMENSIONS ARE TO FACE OF STUD AT NEW WALL ASSEMBLIES AND TO FACE OF FINISH AT EXISTING WALLS, UNLESS NOTED OTHERWISE (UNO)
- 10. ALL EXTERIOR DIMENSIONS ARE TO FACE OF MASONRY IN MASONRY CONNSTRUCTION AND TO EXTERIOR FACE OF SHEATHING IN STUD CONSTRUCTION
- II. EXPANSION JOINTS IN GYPSUM BOARD CEILINGS / WALLS NOT TO EXCEED 200 SF BETWEEN JOINTS. INSTALL PER GYPSUM ASSOCIATION STANDARD PRACTICES AND
- 12. NO SUBSTITUTIONS FOR UL APPROVED PRODUCTS.
- 13. SEE STRUCTURAL FOR REINFORCING, LOAD BEARING WALLS, SHEAR WALLS, STRUCTURAL SUPPORTS, ECT.
- 14. WINDOW SIZES ARE SHOWN AS NOMINAL DIMENSIONS. SEE MANUFACTURES FOR EXACT UNIT AND ROUGH OPENING MEASUREMENTS
- 15. PRIOR TO CONSTRUCTION AND INSTALLATION, CONTRACTOR TO VERIFY ALL DIMENSIONS (INCLUDING ROUGH-IN DIMENSIONS) W/ MANUFACTURER AND/OR SUPPLIER ON ALL FIXTURES \$ EQUIPMENT SUPPLIED. CONTRACTOR TO VERIFY REQUIREMENTS OF ALL OWNER FURNISHED ITMES WITH OWNER BEFORE PROCEEDING WITH WORK.

- I G. WHERE DRAPERY RODS ARE USED AT WINDOWS, PROVIDE BLOCKING IN WALL FOR ATTACHMENT AS REQUIRED.
- 17. ALL CONSTRUCTION IS INTENDED TO BE IN CONFORMANCE W/ FEDERAL & STATE LAWS, CURRENT LOCAL ORDINANCES & BUILDING CODES & 2010 ADA STANDARDS FOR ACCESSIBLE DESIGN. REPORT ANY DISCREPANCIES TO THE ARCHITECT BEFORE PROCEEDING WITH WORK.
- 18. A COMPLETE AUTOMATIC FIRE SPRINKLER IS REQUIRED. SYSTEM TO BE DESIGNED AND SUBMITTED FOR ALL REQUIRED APPROVALS BY SPRINKLER CONTRACTOR. SEE SPECIFICATION SECTION FOR ADDITIONAL REQUIREMENTS.
- 19. A COMPLETE FIRE ALARM SYSTEM IS REQUIRED. SYSTEM TO BE DESIGNED AND SUBMITTED FOR ALL REQUIRED APPROVALS BY FIRE ALARM CONTRACTOR. SEE SPECIFICATION SECTION FOR ADDITIONAL REQUIREMENTS.
- 20. CONTRACTOR TO FIELD VERIFY DIMENSIONS OF PLUMBING FIXTURES (TUB OR SHOWER) VS. PARTITION TYPES (WALL THICKNESSES VARY WITH SHEAR WALLS BEFORE COMMENCING FRAMING. VERIFY PLUMBING WALL LOCATIONS WITH
- 21. REFER TO ENLARGED PLANS FOR ADDITIONAL INFORMATION INCLUDING DIMENSIONS. ENLARGED PLANS TAKE PRECEDENCE OVER SMALLER SCALE DRAWINGS. NOTIFY ARCHITECT OF ANY DISCREPANCIES BEFORE PROCEEDING.
- 22. FOR SIZE & SPACING OF WALL STUDS, REFER TO WALL TAGS & WALL ASSEMBLY SHEET(S). PROVIDE MATERIAL AND STUD SPACING PER STRUCTURAL DRAWINGS.
- 23. CONTRACTOR IS RESPONSIBLE FOR PROVIDING ALL BLOCKING REQUIRED FOR ANY WALL HUNG EQUIPMENT (TOILET ACCESSORIES, SHELVING, SHOWER SEATS, EXTERIOR LIGHT FIXTURES, ECT.)
- 24. WINDOWS WITHIN 24" OF DOOR TO BE SAFETY GLASS. ALL GLAZING IN HAZARDOUS HAZARDOUS LOCATIONS SHOULD BE TEMPERED.
- 25. ALL GYPSUM BOARD IN CORRIDORS SHALL BE HUNG VERTICALLY.
- 26. FULL HEIGHT VINYL CORNER GUARDS TO BE INSTALLED AT ALL EXTERNAL CORNERS AT PUBLIC AREA, CORRIDORS, REGISTRATION, EMPLOYEE LOUNGE AND LAUNDRIES.
- 27. ROOMS WITH FLOOR DRAINS SHALL HAVE THE ENTIRE FLOOR STRUCTURALLY SLOPE TO THE DRAIN(S) IN A UNIFORM MANNER W/SLOPE OF 1/4" PER FOOT MAX.
- 28. ACCESS PANELS FOR PLUMBING AT LAVATORIES ARE TO MATCH FIRE RATING OF ADJACENT WALL. SEE CODE PLANS. VERIFY EXACT PANEL LOCATIONS WITH PLUMBING CONTRACTOR.
- 29. ALL INTERIOR CEILING/SOFFITS ARE TO BE FRAMED WITH METAL STUDS WHEN CREATING A CONCEALED SPACE CONDITION.

INTERIOR PARTITION TYPES - GYP ON WOOD STUD FIRE PARTITION STC UL DESIGN WALL TAG RATING WIDTH RATING # NOTES A - 4 3/4" 36 U305 2X DBL TOP PLATE -UNDERSIDE OF STRUCTURE ABOVE 5/8" TYPE 'X' GYP BD -FG SOUND BATT INSULATION -2X4 STUDS -5/8" TYPE 'X' GYP BD -2X SILL PLATE —

O HORIZONTAL ASSEMBLY FLOOR/CEILING (WD JOIST)								
TYPE MARK	FIRE RATING	ASSEMBLY THICKNESS	STC	UL#	NOTES	STRUCTURE		
1		ΙΟ"				WOOD JOIST		
	FLOOR JOIS	BOARDS —						

CODE DATA

A. BUILDING SUMMARY AND HISTORY

The project entails remodel of an existing restaurant in Madison, WI.

B. APPLICABLE CODES & REGULATIONS

	CODE BASIS OF DESIGN
BUILDING CODE	WISCONSIN ADMINISTRATION BUILDING CODE
	2015 INTERNATIONAL BUILDING CODE
PLUMBING CODE	2015 INTERNATIONAL PLUMBING CODE
MECHANICAL CODE	2015 INTERNATIONAL MECHANICAL CODE
	WITH WISCONSIN AMENDMENTS
ELECTRICAL CODE	2014 NATIONAL ELECTRICAL CODE
LIFE SAFETY / FIRE CODE	2015 INTERNATIONAL FIRE CODE
ACCESSIBILITY CODE	2009 ACCESSIBLE AND USABLE BUILDINGS AND FACILITIES
ENERGY CODE	2015 INTERNATIONAL ENERGY CONSERVATION CODE
	WITH WISCONSIN AMENDMENTS
FUEL GAS CODE	2015 INTERNATIONAL FUEL GAS CODE
	WITH WISCONSIN AMMENDMENTS

C. OCCUPANCY CLASSIFICATION - Chapter 3

Occupancy Type(s) Used:

Assembly \square A \square A-I [X] A-2 \square A-3 \square A-4 Residential R-I R-2 R-3 Storage S-1 S-2

D. TYPES OF CONSTRUCTION - Chapter 6

Type V-B Construction (Building elements are of any materials permitted by this code)

FIRE-RESISTANCE RATING REQUIREMENTS					
BUILDING ELEMENT	TYPE V-B				
STRUCTURAL FRAME, INCLUDING COLUMNS, GIRDERS, \$ TRUSSES	0				
BEARING WALLS - EXTERIOR	0				
BREAING WALLS - INTERIOR	0				
NON-BEARING WALLS - EXTERIOR	0				
NON-BEARING WALLS - INTERIOR	0				
FLOOR / CEILING CONSTRUCTION	0				
ROOF CONSTRUCTION	0				

E. INTERIOR FINISHES - Chapter 8

Flame Spread Classification - Table 803.1.1

Flame Spread Index Smoke Developed 0 -25 26 - 75 0 - 450 0 - 450 76 - 200 Flame Spread Requirements - Table 803.9

Occupancy Group and passageways Corridors Spaces

Standpipes: Yes [X] No

F. FIRE PROTECTION SYSTEMS - Chapter 9 Sprinkler & Standpipes

Sprinklers: Yes [X] No Partial

Exit enclosures Enclosed

Group A-2: Not Required (less than 5,000 SF or 100 occupants)

Rooms \$

Portable Extinguishers: located per 906 \$ IFC Fire Alarm and Detection Systems (907): Req'd per IBC and NFPA 72 "A-2" Occupancy (907.2.8): Not required in occupancy load less than 300. Manual Fire Alarm System is not required per 907.2.8. I Automatic Smoke Detection System is required throughout (907.2.8.2)

G. MEANS OF EGRESS - Chapter 10

Accessible Means of Egress (1007) 2 exits required from each floor (1007.1)

> Doors (1008) Must swing in direction of egress travel with occupant loads ≥ 50

H. ACCESSIBILITY - Chapter I I

Dining and Drinking Areas (1108.2.9)

In dining and drinking areas, all interior and exterior floor areas shall be accessible and be on an accessible route.

Exception I: An accessible route between accessible levels and stories above and below is not required where permitted by section 1104.4 Exception 1: An accessible route is not required to stories and mezzanines that have an aggregate area of not more than 3,000 square feet and are located above or below accessible levels.

Accessible route not required in raised section of the building.

I. PLUMBING FIXTURE COUNT - Chapter 29

Male = 1 per 40Female = 1 per 40 2 required Lavatories = 1 per 75 2 required in each



prepared by me or under my direct supervision and that I am a JOSEPH C **GALLAGHER** 12901-5 SAUK CITY,

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Minimum number of Required Plumbing Fixtures (2902)

Service Sink = 1

Drinking Fountains not required per substitution in IPC section 410.4: Where restaurants provide drinking water in a container free of charge, drinking fountains shall not be required in those restaurants.

DATE

08/11/202

CITY OF MADISON CONDITIONAL

USE APPROVAL SE

PROJECT TITLE

RED ROOSTER BAR REMODEL

PROJECT OWNER

FORBAIR GROUP

PROJECT LOCATION

MADISON WI

GENERAL DATA

51488 NUMBER

G002 NUMBER

∕LÜBRARY FIGURE 703.2.5 HEIGHT OF RAISED CHARACTERS

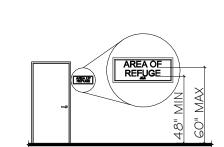


FIGURE 703.4.1 HEIGHT OF TACTILE CHARACTERS ABOVE FINISH FLOOR OR GROUND

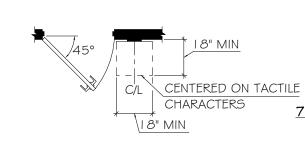


FIGURE 703.4.2 LOCATION OF TACTILE SIGNS AT DOORS

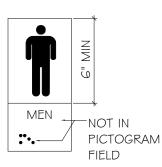


FIGURE 703.6. I PICTOGRAM FIELD



FIGURE 703.7.2.1 INTERNATIONAL ACCESSIBILITY SYMBOL



FIGURE 703.7.2.2 INTERNATIONAL SYMBOL OF TTY



FIGURE 703.7.2.3 **VOLUME CONTROL** TELEPHONE

FIGURE 703.7.2.4 INTERNATIONAL SYMBOL OF

703 SIGNS - 2010 ADA STANDARDS FOR ACCESSIBLE DESIGN

703.1 GENERAL. SIGNS SHALL COMPLY WITH 703. WHERE BOTH VISUAL AND TACTILE CHARACTERS ARE REQUIRED, EITHER ONE SIGN WITH BOTH VISUAL AND TACTILE CHARACTERS, OR TWO SEPARATE SIGNS, ONE WITH VISUAL, AND ONE WITH TACTILE CHARACTERS, SHALL BE PROVIDED.

703.2 RAISED CHARACTERS. RAISED CHARACTERS SHALL COMPLY WITH 703.2 AND SHALL BE DUPLICATED IN BRAILLE COMPLYING WITH 703.3. RAISED CHARACTERS SHALL BE INSTALLED IN ACCORDANCE WITH 703.4

703.2.1 DEPTH. RAISED CHARACTERS SHALL BE 1/32 INCH (0.8 MM) MINIMUM ABOVE THEIR BACKGROUND.

703.2.2 CASE. CHARACTERS SHALL BE UPPERCASE

703.2.3 STYLE. CHARACTERS SHALL BE SANS SERIF. CHARACTERS SHALL NOT BE ITALIC, OBLIQUE, SCRIPT, HIGHLY DECORATIVE, OR OF OTHER UNUSUAL FORMS.

703.2.4 CHARACTER PROPORTIONS. CHARACTERS SHALL BE SELECTED FROM FONTS WHERE THE WIDTH OF THE UPPERCASE LETTER "O" IS 55 PERCENT MINIMUM AND I IO PERCENT MAXIMUM OF THE HEIGHT OF THE UPPERCASE LETTER "I".

703.2.5 CHARACTER HEIGHT. CHARACTER HEIGHT MEASURED VERTICALLY FROM THE BASELINE OF THE CHARACTER SHALL BE 5/8 INCH (16 MM) MINIMUM AND 2 INCHES (51 MM) MAXIMUM BASED ON THE HEIGHT OF THE UPPERCASE LETTER "I" EXCEPTION: WHERE SEPARATE RAISED AND VISUAL CHARACTERS WITH THE SAME INFORMATION ARE PROVIDED, RAISED CHARACTER HEIGHT SHALL BE PERMITTED TO BE 1/2 INCH (13mm) MINIMUM.

703.2.6 STROKE THICKNESS. STROKE THICKNESS OF THE UPPERCASE LETTER "I" SHALL BE 15 PERCENT MAXIMUM OF THE HEIGHT OF THE CHARACTER.

703.2.7 CHARACTER SPACING. CHARACTER SPACING SHALL BE MEASURED BETWEEN THE TWO CLOSEST POINTS OF ADJACENT RAISED CHARACTERS WITHIN A MESSAGE, EXCLUDING WORD SPACES. WHERE CHARACTERS HAVE RECTANGULAR CROSS SECTIONS, SPACING BETWEEN INDIVIDUAL RAISED CHARACTERS SHALL BE 1/8 INCH (3.2 MM) MINIMUM AND 4 TIMES THE RAISED CHARACTER STROKE WIDTH MAXIMUM. WHERE CHARACTERS HAVE OTHER CROSS SECTIONS, SPACING BETWEEN INDIVIDUAL RAISED CHARACTERS SHALL BE 1/16 INCH (1.6 MM) MINIMUM AND 4 TIMES THE RAISED CHARACTER STROKE WIDTH MAXIMUM AT THE BASE OF THE CROSS SECTIONS, AND 1/8 INCH (3.2 MM) MINIMUM AND 4 TIMES THE RAISED CHARACTER STROKE WIDTH MAXIMUM AT THE TOP OF THE CROSS SECTIONS. CHARACTERS SHALL BE SEPARATED FROM RAISED BORDERS AND DECORATIVE ELEMENTS 3/8 INCH (9.5 MM) MINIMUM.

703.2.8 LINE SPACING. SPACING BETWEEN THE BASELINES OF SEPARATE LINES OF RAISED CHARACTERS WITHIN A MESSAGE SHALL BE 135 PERCENT MINIMUM AND 170 PERCENT MAXIMUM OF THE RAISED CHARACTER HEIGHT.

703.3 BRAILLE. BRAILLE SHALL BE CONTRACTED (GRADE 2) AND SHALL COMPLY WITH 703.3 AND 703.4.

703.3.1 DIMENSIONS AND CAPITALIZATION. BRAILLE DOTS SHALL HAVE A DOMED OR ROUNDED SHAPE AND SHALL COMPLY WITH TABLE 703.3.1. THE INDICATION OF AN UPPERCASE LETTER OR LETTERS SHALL ONLY BE USED BEFORE THE FIRST WORD OF SENTENCES, PROPER NOUNS AND NAMES, INDIVIDUAL LETTERS OF THE ALPHABET, INITIALS, AND ACRONYMS.

703.3.2 POSITION. BRAILLE SHALL BE POSITIONED BELOW THE CORRESPONDING TEXT. IF TEXT IS MULTI-LINED, BRAILLE SHALL BE PLACED BELOW THE ENTIRE TEXT. BRAILLE SHALL BE SEPARATED 3/8 INCH (9.5 MM) MINIMUM FROM ANY OTHER TACTILE CHARACTERS AND 3/8 INCH (9.5 MM) MINIMUM FROM RAISED BORDERS AND DECORATIVE ELEMENTS.

EXCEPTION: BRAILLE PROVIDED ON ELEVATOR CAR CONTROLS SHALL BE SEPARATED 3/16 INCH (4.8 MM) MINIMUM AND SHALL BE LOCATED EITHER DIRECTLY BELOW OR ADJACENT TO THE CORRESPONDING RAISED CHARACTERS OR SYMBOLS.

703.4 INSTALLATION HEIGHT AND LOCATION. SIGNS WITH TACTILE CHARACTERS SHALL COMPLY WITH 703.4

703.4.1 HEIGHT ABOVE FINISH FLOOR OR GROUND. TACTILE CHARACTERS ON SIGNS SHALL BE LOCATED 48 INCHES (1220 MM) MINIMUM ABOVE THE FINISH FLOOR OR GROUND SURFACE, MEASURED FROM THE BASELINE OF THE LOWEST TACTILE CHARACTER AND 60 INCHES (1525 MM) MAXIMUM ABOVE THE FINISH FLOOR OR GROUND SURFACE, MEASURED FROM THE BASELINE OF THE HIGHEST TACTILE CHARACTER.

EXCEPTION: TACTILE CHARACTERS FOR ELEVATOR CAR CONTROLS SHALL NOT BE REQUIRED TO COMPLY WITH 703.4.1.

703.4.2 LOCATION. WHERE A TACTILE SIGN IS PROVIDED AT A DOOR, THE SIGN SHALL BE LOCATED ALONGSIDE THE DOOR AT THE LATCH SIDE. WHERE A TACTILE SIGN IS PROVIDED AT DOUBLE DOORS WITH ONE ACTIVE LEAF, THE SIGN SHALL BE LOCATED ON THE INACTIVE LEAF. WHERE A TACTILE SIGN IS PROVIDED AT DOUBLE DOORS WITH TWO ACTIVE LEAFS, THE SIGN SHALL BE LOCATED TO THE RIGHT OF THE RIGHT HAND DOOR. WHERE THERE IS NO WALL SPACE AT THE LATCH SIDE OF A SINGLE DOOR OR AT THE RIGHT SIDE OF DOUBLE DOORS, SIGNS SHALL BE LOCATED ON THE NEAREST ADJACENT WALL. SIGNS CONTAINING TACTILE CHARACTERS SHALL BE LOCATED SO THAT A CLEAR FLOOR SPACE OF 18 INCHES (455 MM) MINIMUM BY 18 INCHES (455 MM) MINIMUM, CENTERED ON THE TACTILE CHARACTERS, IS PROVIDED BEYOND THE ARC OF ANY DOOR SWING BETWEEN THE CLOSED POSITION

AND 45 DEGREE OPEN POSITION. EXCEPTION: SIGNS WITH TACTILE CHARACTERS SHALL BE PERMITTED ON THE PUSH SIDE OF DOORS WITH CLOSERS AND WITHOUT HOLD-OPEN DEVICES.

703.5 VISUAL CHARACTERS. VISUAL CHARACTERS SHALL COMPLY WITH 703.5.

EXCEPTION: WHERE VISUAL CHARACTERS COMPLY WITH 703.2 AND ARE ACCOMPANIED BY BRAILLE COMPLYING WITH 703.3. THEY SHALL NOT BE REQUIRED TO COMPLY WITH 703.5.2 THROUGH 703.5.9.

703.5.1 FINISH AND CONTRAST. CHARACTERS AND THEIR BACKGROUND SHALL HAVE A NON-GLARE FINISH. CHARACTERS SHALL CONTRAST WITH THEIR BACKGROUND WITH EITHER LIGHT CHARACTERS ON A DARK BACKGROUND OR DARK CHARACTERS ON A LIGHT BACKGROUND.

703.5.2 CASE. CHARACTERS SHALL BE UPPERCASE OR LOWERCASE OR A COMBINATION OF BOTH.

703.5.3 STYLE. CHARACTERS SHALL BE CONVENTIONAL IN FORM. CHARACTERS SHALL NOT BE ITALIC, OBLIQUE, SCRIPT, HIGHLY DECORATIVE, OR OF OTHER UNUSUAL FORMS.

703.5.4 CHARACTER PROPORTIONS. CHARACTERS SHALL BE SELECTED FROM FONTS WHERE THE WIDTH OF THE UPPERCASE LETTER "O" IS 55 PERCENT MINIMUM AND I IO PERCENT MAXIMUM OF THE HEIGHT OF THE UPPERCASE LETTER "I".

703.5.5 CHARACTER HEIGHT. MINIMUM CHARACTER HEIGHT SHALL COMPLY WITH TABLE 703.5.5 (SEE 2010 ADA STANDARDS). VIEWING DISTANCE SHALL BE MEASURED AS THE HORIZONTAL DISTANCE BETWEEN THE CHARACTER AND AN OBSTRUCTION PREVENTING FURTHER APPROACH TOWARDS THE SIGN. CHARACTER HEIGHT SHALL BE BASED ON THE UPPERCASE LETTER "I".

703.5.6 HEIGHT FROM FINISH FLOOR OR GROUND. VISUAL CHARACTERS SHALL BE 40 INCHES (1015 MM) MINIMUM ABOVE THE FINISH FLOOR OR GROUND. EXCEPTION: VISUAL CHARACTERS INDICATING ELEVATOR CAR CONTROLS SHALL NOT BE REQUIRED TO COMPLY WITH 703.5.6.

703.5.7 STROKE THICKNESS. STROKE THICKNESS OF THE UPPERCASE LETTER "I" SHALL BE 10 PERCENT MINIMUM AND 30 PERCENT MAXIMUM OF THE HEIGHT OF THE CHARACTER.

703.5.8 CHARACTER SPACING. CHARACTER SPACING SHALL BE MEASURED BETWEEN THE TWO CLOSEST POINTS OF ADJACENT CHARACTERS, EXCLUDING WORD SPACES. SPACING BETWEEN INDIVIDUAL CHARACTERS SHALL BE 10 PERCENT MINIMUM AND 35 PERCENT MAXIMUM OF CHARACTER HEIGHT.

703.5.9 LINE SPACING. SPACING BETWEEN THE BASELINES OF SEPARATE LINES OF CHARACTERS WITHIN A MESSAGE SHALL BE 135 PERCENT MINIMUM AND 170 PERCENT MAXIMUM OF THE CHARACTER HEIGHT.

703.6 PICTOGRAMS. PICTOGRAMS SHALL COMPLY WITH 703.6.


703.6.1 PICTOGRAM FIELD. PICTOGRAMS SHALL HAVE A FIELD HEIGHT OF 6 INCHES (150 MM) MINIMUM. CHARACTERS AND BRAILLE SHALL NOT BE LOCATED IN THE PICTOGRAM FIELD.

703.6.2 FINISH AND CONTRAST. PICTOGRAMS AND THEIR FIELD SHALL HAVE A NON-GLARE FINISH. PICTOGRAMS SHALL CONTRAST WITH THEIR FIELD WITH EITHER A LIGHT PICTOGRAM ON A DARK FIELD OR A DARK PICTOGRAM ON A LIGHT FIELD.

703.6.3 TEXT DESCRIPTORS. PICTOGRAMS SHALL HAVE TEXT DESCRIPTORS LOCATED DIRECTLY BELOW THE PICTOGRAM FIELD. TEXT DESCRIPTORS SHALL COMPLY WITH 703.2, 703.3 AND 703.4.

703.7 SYMBOLS OF ACCESSIBILITY. SYMBOLS OF ACCESSIBILITY SHALL COMPLY WITH 703.7.

703.7.1 FINISH AND CONTRAST. SYMBOLS OF ACCESSIBILITY AND THEIR BACKGROUND SHALL HAVE A NON-GLARE FINISH. SYMBOLS OF ACCESSIBILITY SHALL CONTRAST WITH THEIR BACKGROUND WITH EITHER A LIGHT SYMBOL ON A DARK BACKGROUND OR A DARK SYMBOL ON A LIGHT BACKGROUND.

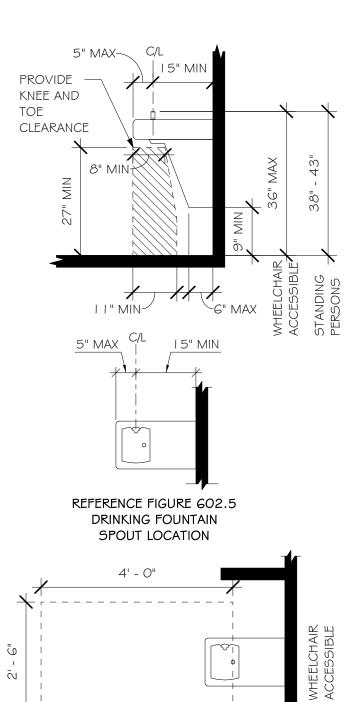

CLEAR FLOOR SPACE ---

4" MAX PROTRUSION

INTO CIRCULATION PATH

SCALE: N.T.S.

ACCESSIBILITY - DRINKING FOUNTAINS

30" MIN CLR

1 <u>2" MAX</u>/

ACCESSIBILITY - PROTRUDING OBJECTS

12" MAX

REFERENCE FIGURE 903.4

BENCH BACK SUPPORT

FIGURE 903.4

BENCH CLEARANCES

ACCESSIBILITY - BENCHES

BENCH

SCALE: N.T.S.

FIGURE 307.2

LIMITS OF PROTRUDING OBJECTS

SCALE: N.T.S.

CENTERED ON FOUNTAIN

602 DRINKING FOUNTAINS 2010 ADA STANDARDS FOR ACCESSIBLE DESIGN

602.1 GENERAL. ACCESSIBLE DRINKING FOUNTAINS SHALL COMPLY WITH SECTION 602 AND 307

602.2 CLEAR FLOOR SPACE. A CLEAR FLOOR SPACE COMPLYING WITH SECTION 305, POSITIONED FOR A FORWARD APPROACH TO THE DRINKING FOUNTAIN, SHALL BE PROVIDED. KNEE AND TOE SPACE COMPLYING WITH SECTION 306 SHALL BE PROVIDED. THE CLEAR FLOOR SPACE SHALL BE CENTERED ON THE DRINKING FOUNTAIN.

I. DRINKING FOUNTAINS FOR STANDING PERSONS. 2. DRINKING FOUNTAINS PRIMARILY FOR CHILDREN'S USE SHALL BE PERMITTED WHERE THE SPOUT OUTLET IS 30 INCHES (760 MM) MAXIMUM ABOVE THE FLOOR, A PARALLEL APPROACH COMPLYING WITH SECTION 305 IS PROVIDED AND THE CLEAR FLOOR SPACE IS CENTERED ON THE DRINKING FOUNTAIN.

602.3 OPERABLE PARTS. OPERABLE PARTS SHALL COMPLY WITH SECTION 309.

602.4 SPOUT OUTLET HEIGHT. SPOUT OUTLETS OF WHEELCHAIR ACCESSIBLE DRINKING FOUNTAINS SHALL BE 36 INCHES (915 MM) MAXIMUM ABOVE THE FLOOR. SPOUT OUTLETS OF DRINKING FOUNTAINS FOR STANDING PERSONS SHALL BE 38 INCHES (965 MM) MINIMUM AND 43 INCHES (1090 MM) MAXIMUM ABOVE THE FLOOR.

602.5 SPOUT LOCATION. THE SPOUT SHALL BE LOCATED 15 INCHES (380 MM) MINIMUM FROM THE VERTICAL SUPPORT AND 5 INCHES (125MM) MAXIMUM FROM THE FRONT EDGE OF THE DRINKING FOUNTAIN, INCLUDING BUMPERS. WHERE ONLY A PAR-ALLEL APPROACH IS PROVIDED, THE SPOUT SHALL BE LOCATED 3 I/2 INCHES (90 MM) MAXIMUM FROM THE FRONT EDGE OF THE DRINKING FOUNTAIN, INCLUDING BUMPERS.

602.6 WATER FLOW. THE SPOUT SHALL PROVIDE A FLOW OF WATER 4 INCHES (100 MM) MINIMUM IN HEIGHT. THE ANGLE OF THE WATER STREAM FROM SPOUTS WITHIN 3 INCHES (75 MM) OF THE FRONT OF THE DRINKING FOUNTAIN SHALL BE 30 DEGREES MAXIMUM, AND FROM SPOUTS BETWEEN 3 INCHES (75 MM) AND 5 INCHES (125 MM) FROM THE FRONT OF THE DRINKING FOUNTAIN SHALL BE 15 DEGREES MAXIMUM, MEASURED HORIZONTALLY RELATIVE TO THE FRONT FACE OF THE DRINKING FOUNTAIN.

903.1 GENERAL. BENCHES SHALL COMPLY WITH 903.

OR GROUND SPACE COMPLYING WITH 305 SHALL BE

PROVIDED AND SHALL BE POSITIONED AT THE END OF

(510 MM) DEEP MINIMUM AND 24 INCHES (610 MM)

903.4 BACK SUPPORT. THE BENCH SHALL PROVIDE

FOR BACK SUPPORT OR SHALL BE AFFIXED TO A WALL.

BACK SUPPORT SHALL BE 42 INCHES (1065 MM) LONG

MINIMUM AND SHALL EXTEND FROM A POINT 2 INCHES

POINT 18 INCHES (455 MM) MINIMUM ABOVE THE SEAT

903.5 HEIGHT. THE TOP OF THE BENCH SEAT SURFACE

INCHES (485 MM) MAXIMUM ABOVE THE FINISH FLOOR

903.6 STRUCTURAL STRENGTH. ALLOWABLE STRESSES

SHALL NOT BE EXCEEDED FOR MATERIALS USED WHEN A

VERTICAL OR HORIZONTAL FORCE OF 250 POUNDS

(1112 N) IS APPLIED AT ANY POINT ON THE SEAT, FASTENER, MOUNTING DEVICE, OR SUPPORTING

903.7 WET LOCATIONS. WHERE INSTALLED IN WET

RESISTANT AND SHALL NOT ACCUMULATE WATER.

LOCATIONS, THE SURFACE OF THE SEAT SHALL BE SLIP

X > 12"

SURFACE. BACK SUPPORT SHALL BE 21/2 INCHES (64

MM) MAXIMUM FROM THE REAR EDGE OF THE SEAT

SHALL BE 17 INCHES (430 MM) MINIMUM AND 19

(5 I MM) MAXIMUM ABOVE THE SEAT SURFACE TO A

THE BENCH.

DEEP MAXIMUM.

OR GROUND.

STRUCTURE.

MEASURED HORIZONTALLY.

X > 12"


FIGURE 307.3

POST-MOUNTED PROTRUDING OBJECTS

903.2 CLEAR FLOOR OR GROUND SPACE. CLEAR FLOOR

THE BENCH SEAT AND PARALLEL TO THE SHORT AXIS OF

903.3 SIZE. BENCHES SHALL HAVE SEATS THAT ARE 42

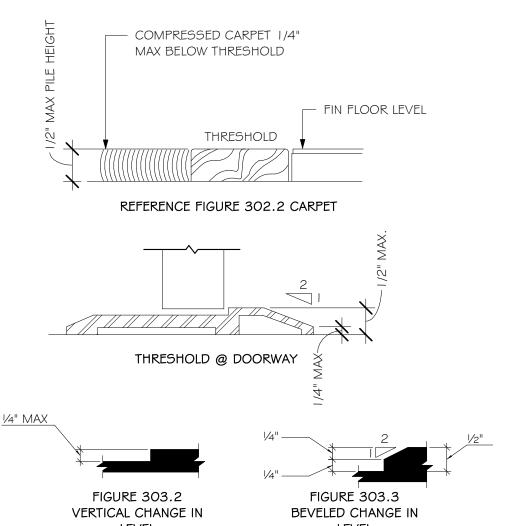


2010 ADA STANDARDS FOR ACCESSIBLE DESIGN

303.2 VERTICAL (303 CHANGES IN LEVEL) CHANGES IN LEVEL OF 1/4" HIGH MAXIMUM SHALL BE PERMITTED TO BE VERTICAL

303.3 BEVELED (303 CHANGES IN LEVEL) CHANGES IN LEVEL BETWEEN 1/4" HIGH MINIMUM AND 1/2" HIGH MAXIMUM SHALL BE BEVELED WITH A SLOP NOT STEEPER THAN 1:2.


608.7 THRESHOLDS (608 SHOWER COMPARTMENTS) THRESHOLDS IN ROLL-IN TYPE SHOWER COMPARTMENTS SHALL BE 1/2" HIGH MAXIMUM IN ACCORDANCE WITH 303. IN TRANSFER TYPE SHOWER COMPARTMENTS, THRESHOLDS 1/2" HIGH MAXIMUM SHALL BE BEVELED, ROUNDED, OR VERTICAL.

ACCESSIBILITY - THRESHOLD/LEVEL CHANGES

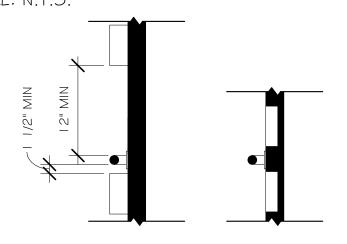

PROJECTING OBJECTS RECESSED OBJECTS FIGURE 609.3

SPACING OF GRAB BARS

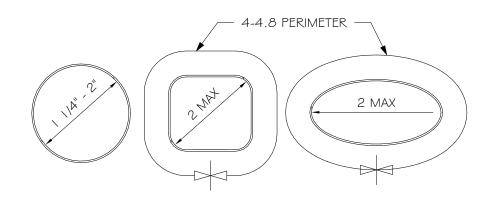

CIRCULAR CROSS SECTION

ACCESSIBILITY - GRAB BAR SECTIONS SCALE: N.T.S.

FIGURE 609.2.2

GRAB BAR NON-CIRCULAR CROSS SECTION

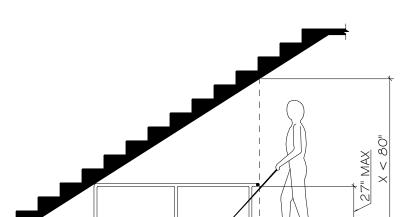


FIGURE 307.4

VERTICAL CLEARANCE

LEVEL

Certification & Seal: I hereby certify that this plan, specification, or report was

prepared by me or under my direct supervision and that I am a SALLAGHEF 12901-5 SAUK CITY.

RAMAKER

(608) 643-4100 www.ramaker.com

DATE 08/11/202 ISSUED

CITY OF MADISON CONDITIONA

USE APPROVAL SE PROJECT TITLE

RED ROOSTER |BAR REMODEL


PROJECT OWNER FORBAIR GROUP PROJECT LOCATION


MADISON WI


ADA DATA - IBC


51488 NUMBER G003 SHEET NUMBER

ACCESSIBILITY - SIGNS & PICTOGRAMS / SCALE: N.T.S.

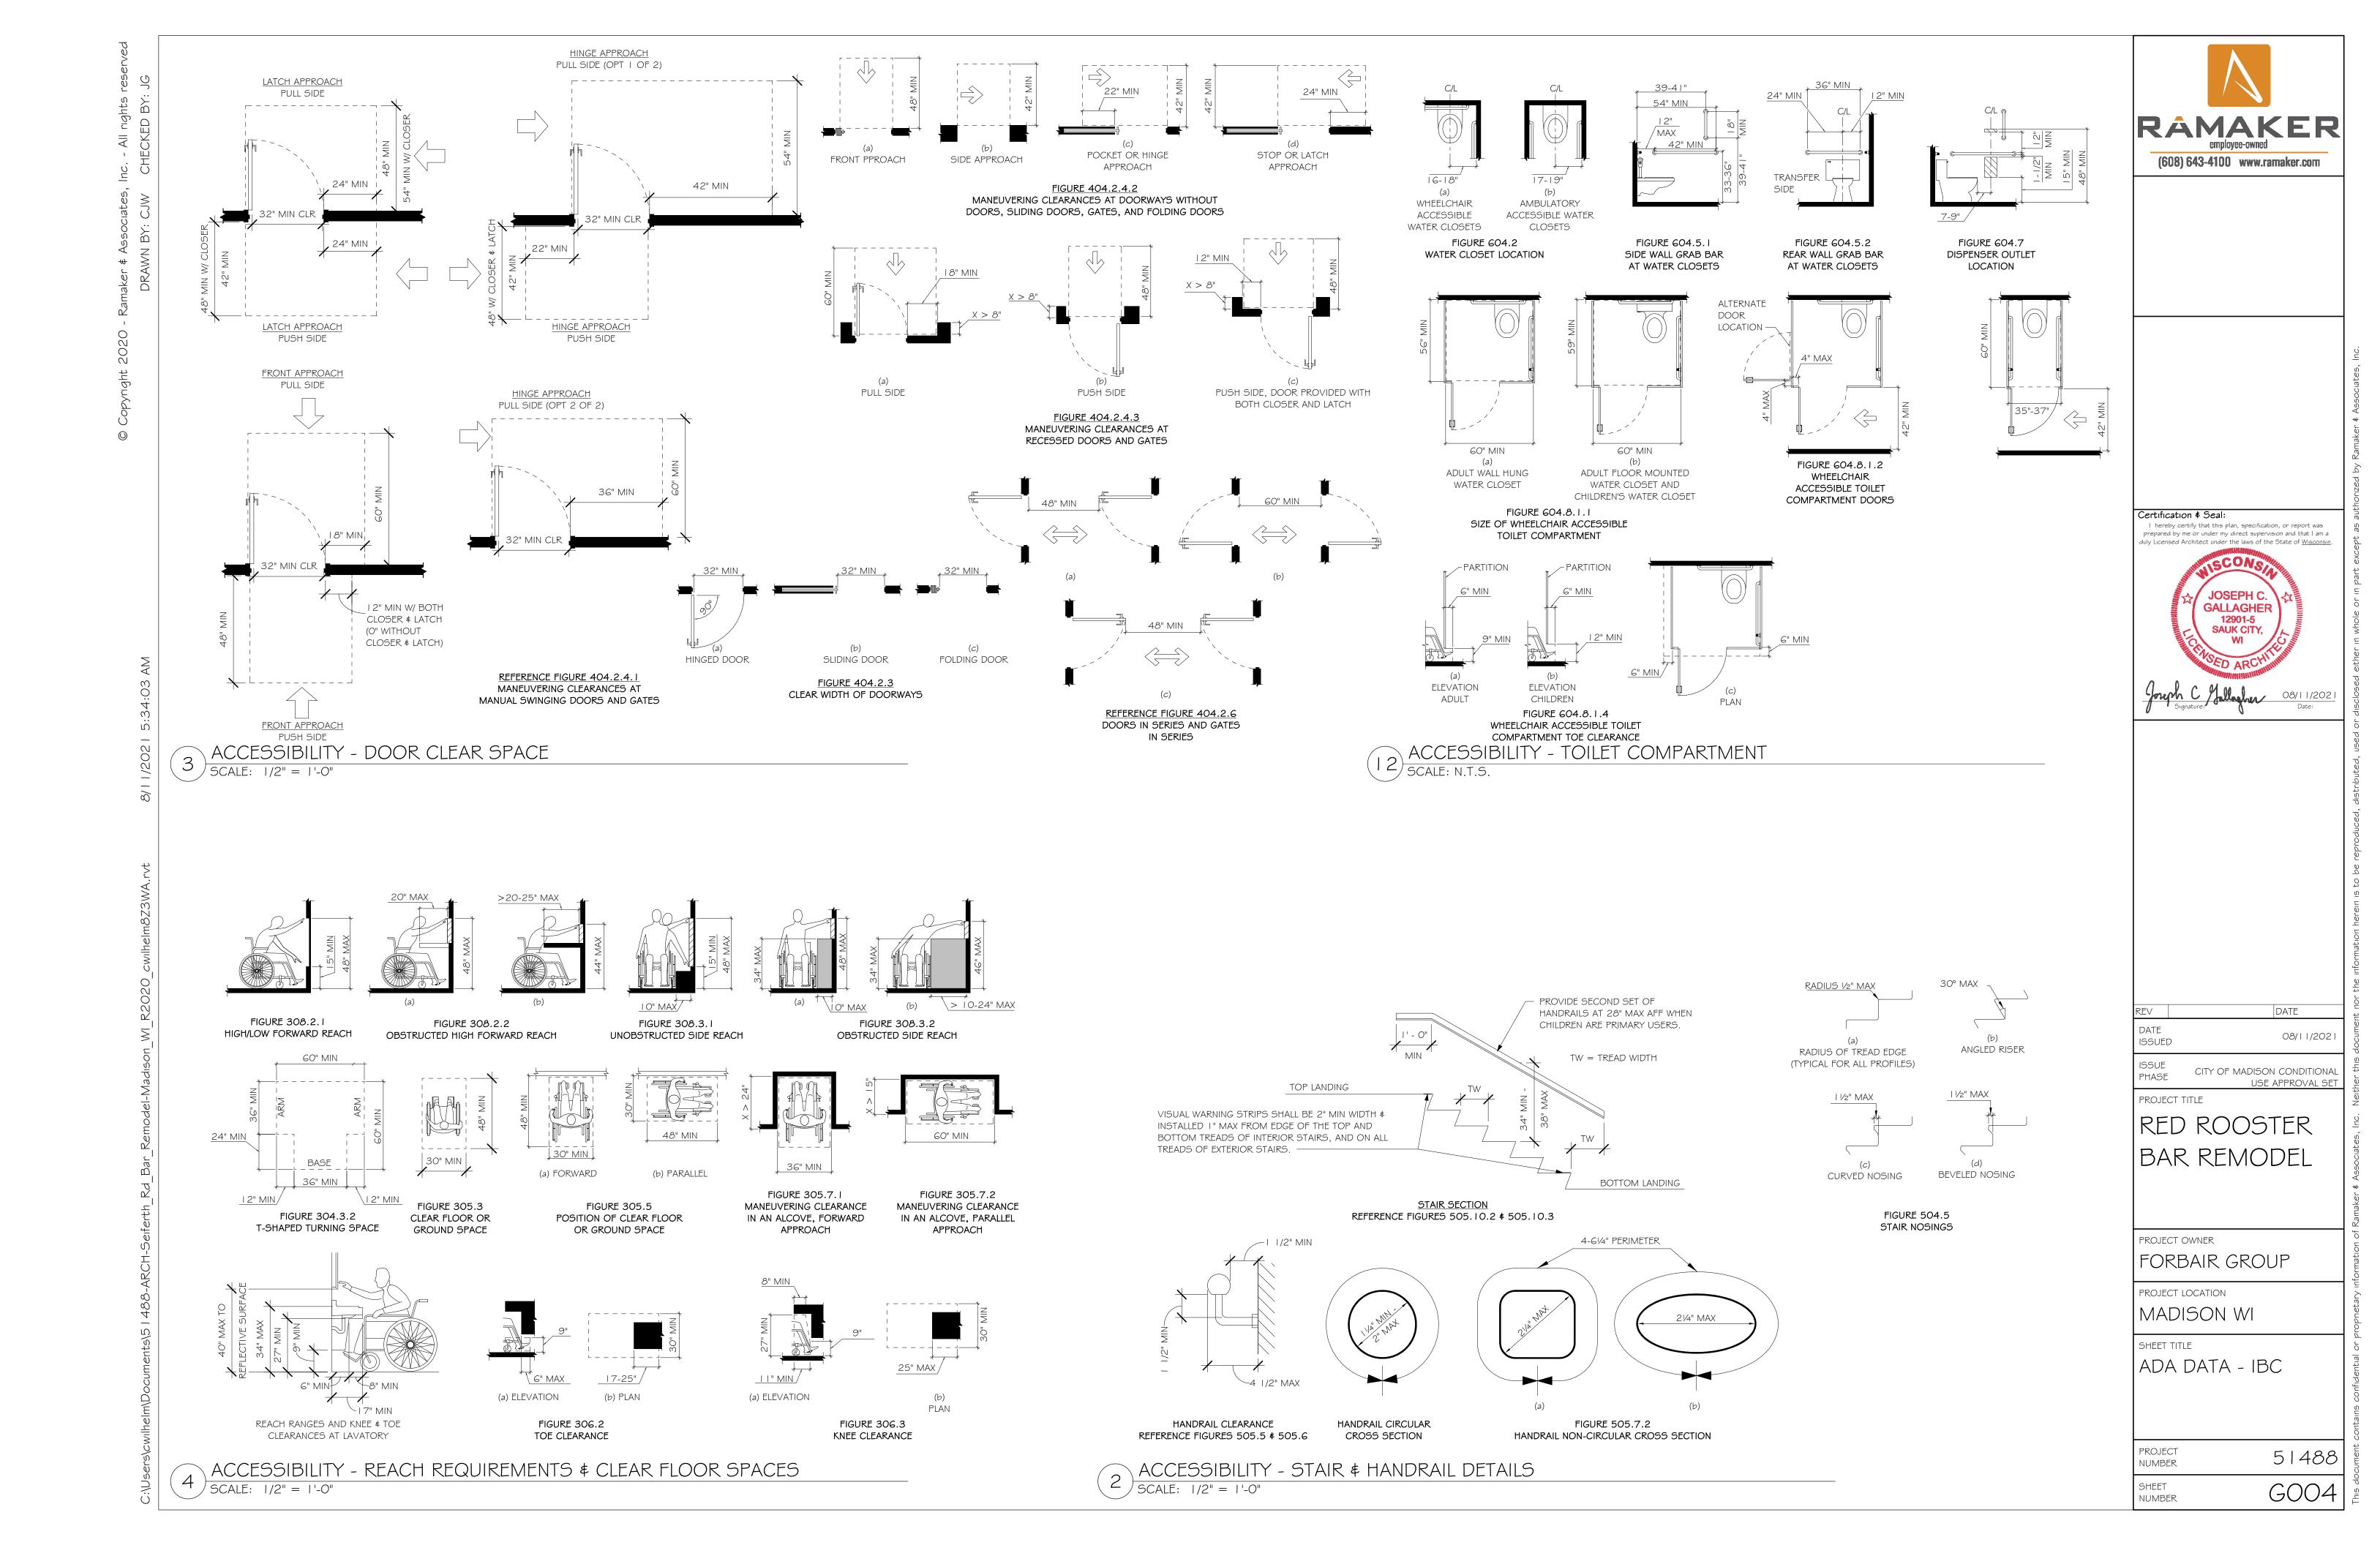

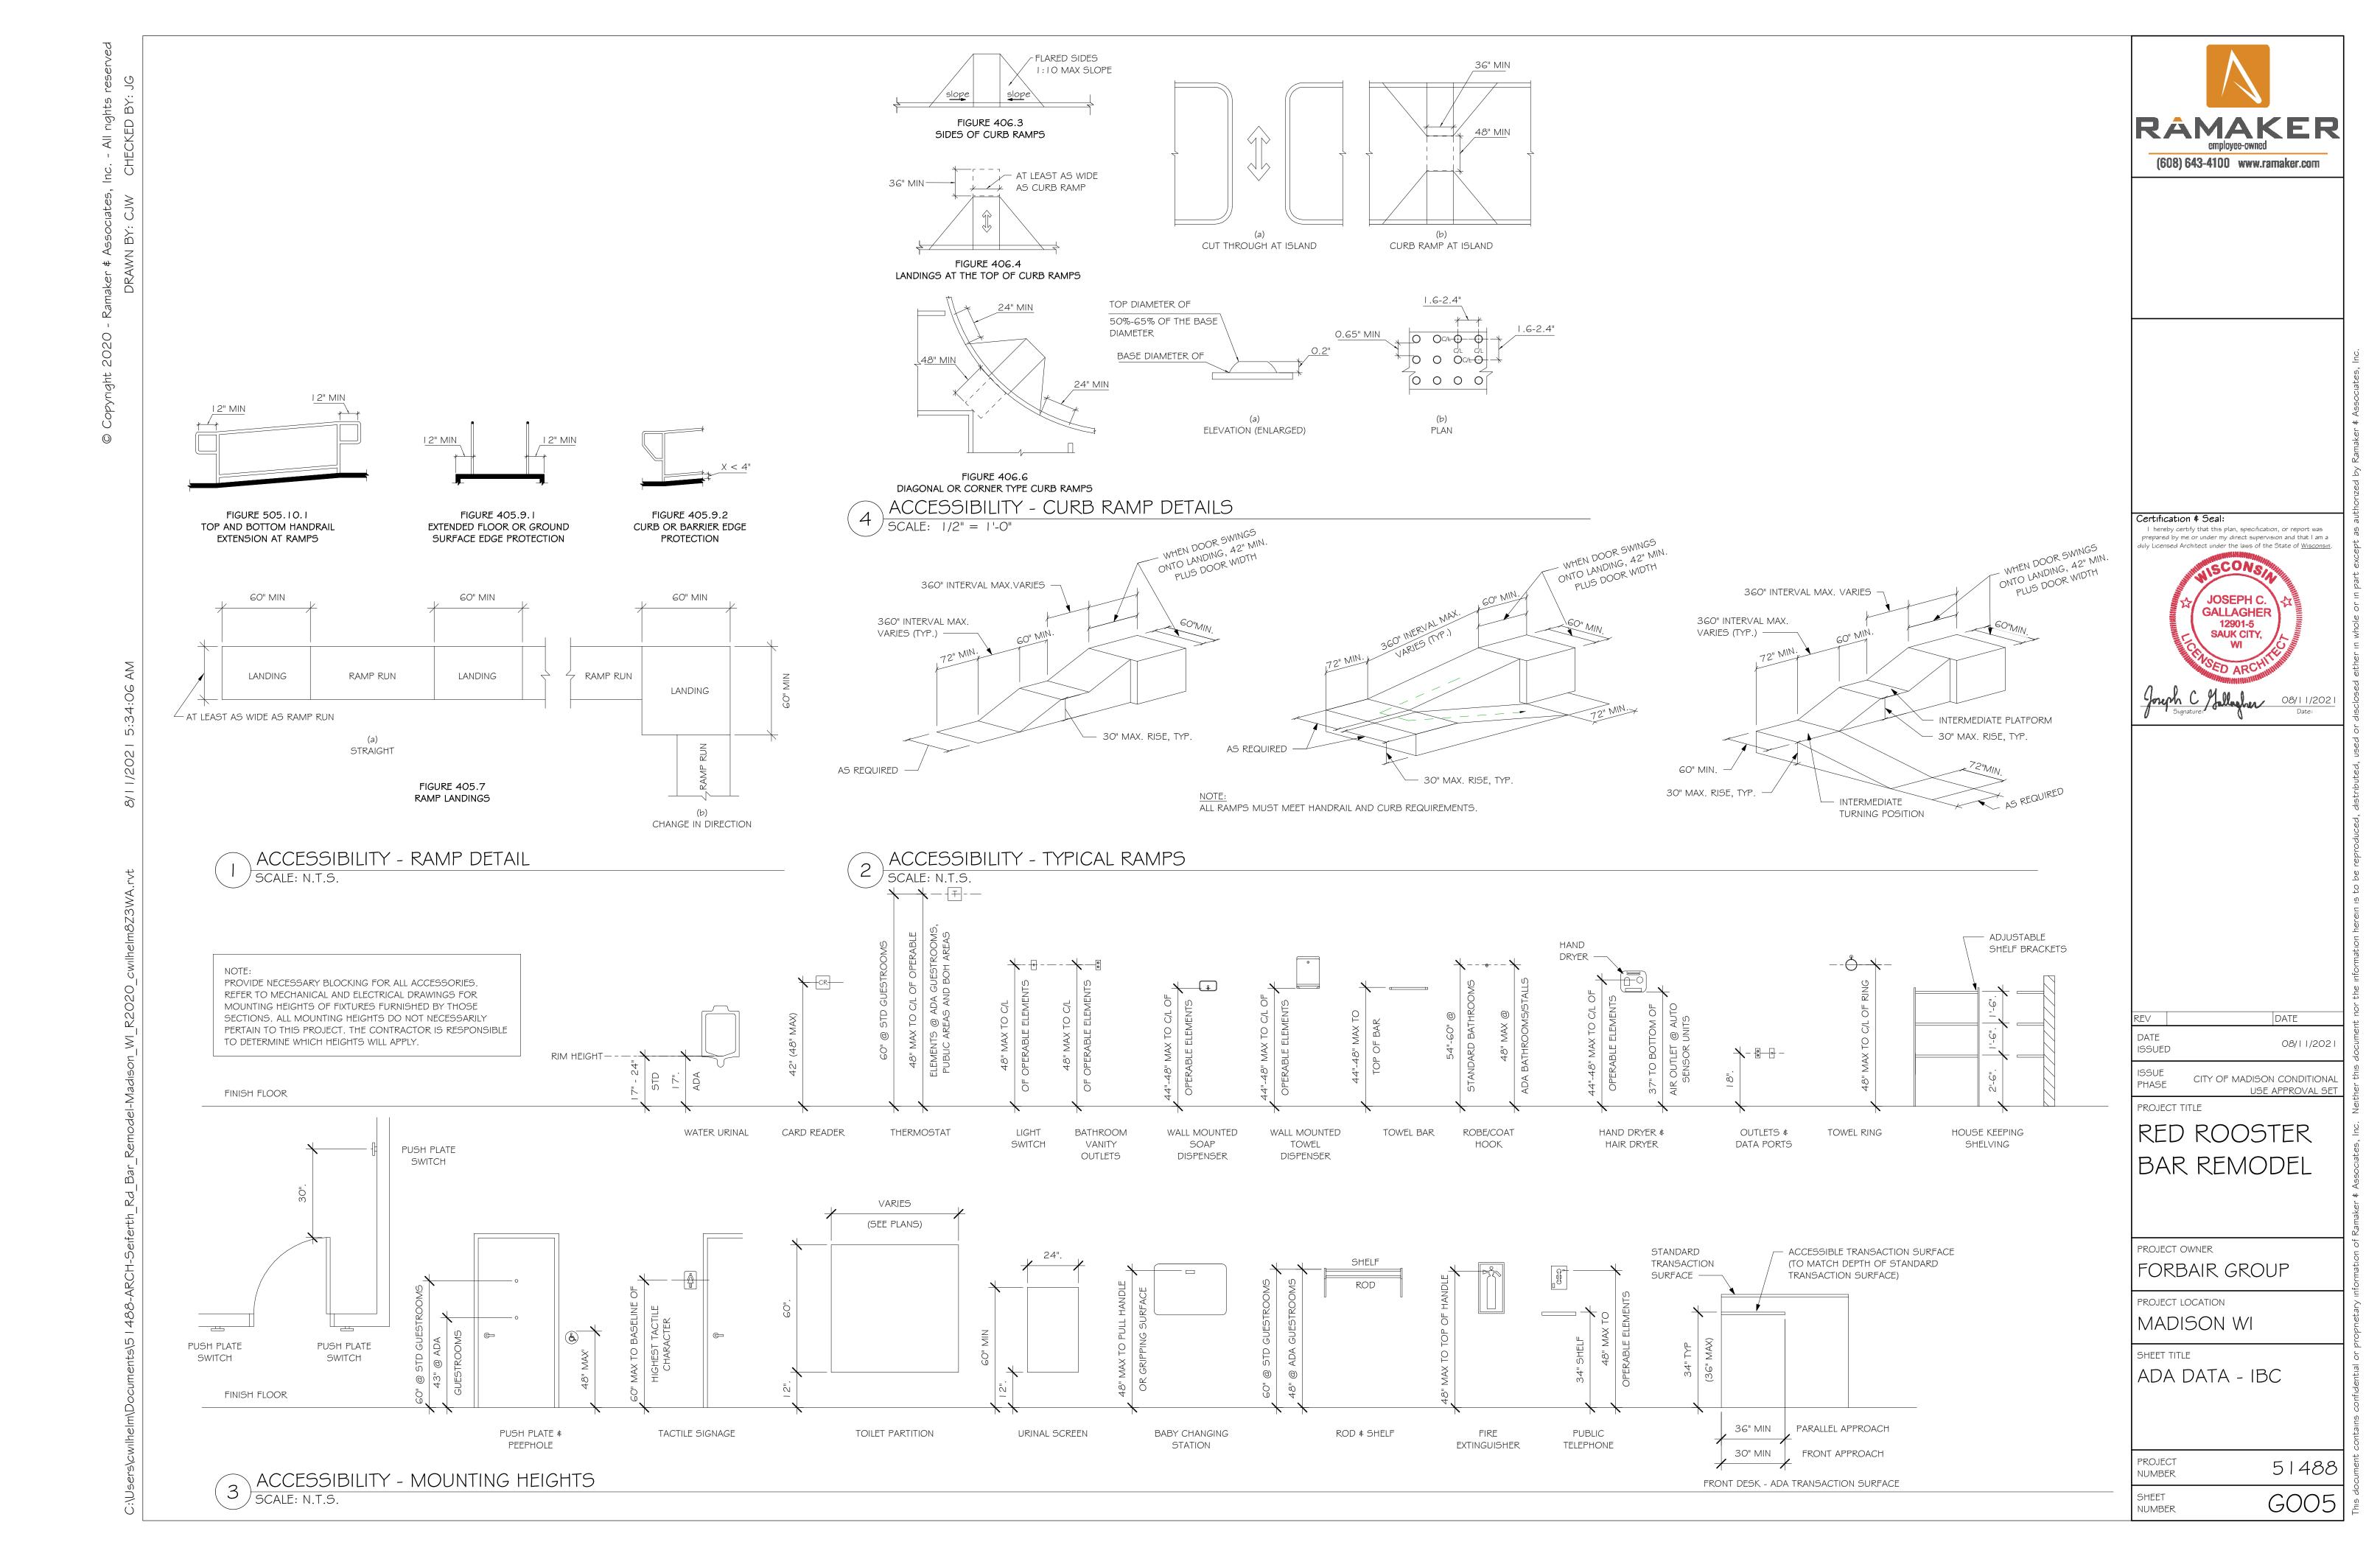

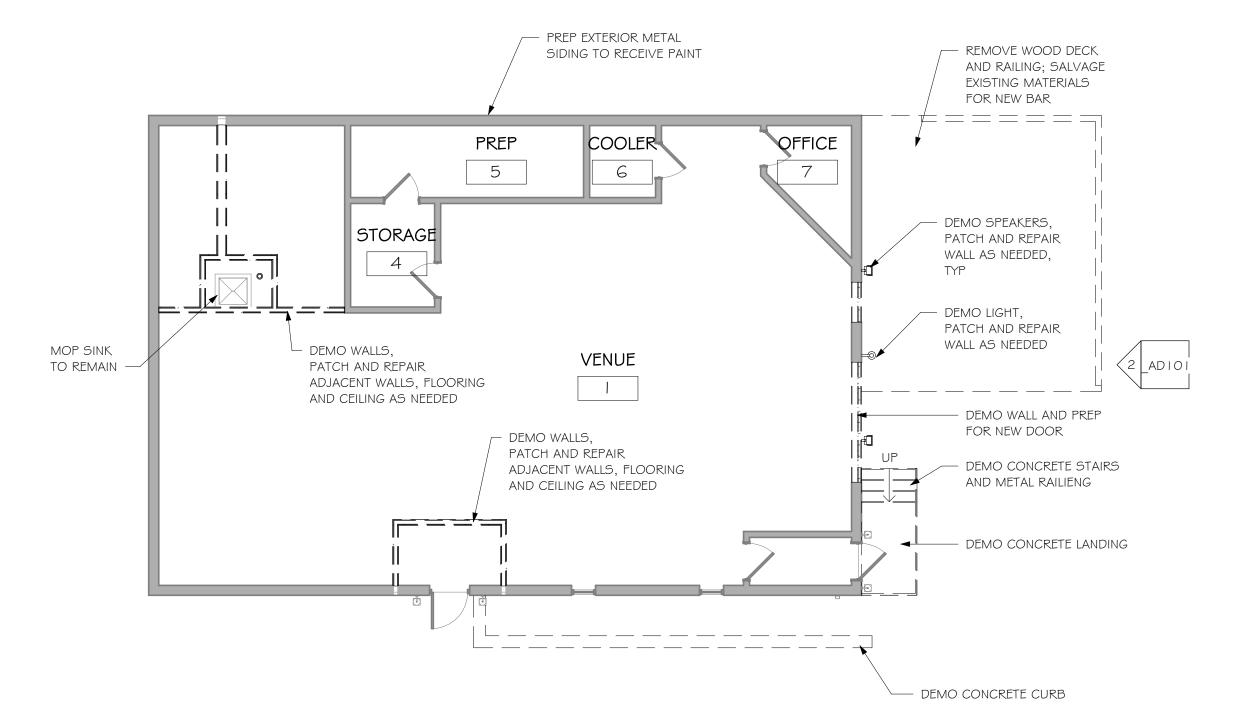

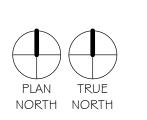

DEMO SPEAKERS, PATCH AND REPAIR WALL AS NEEDED -PREP EXTERIOR METAL SIDING TO RECEIVE PAINT DEMO CONCRETE LANDING, - REMOVE WOOD DECK AND CONCRETE STAIRS AND RAILING; SALVAGE EXISTING METAL RAILING -MATERIALS FOR NEW BAR DEMO CONCRETE CURB FIRST FLOOR 100'-0" DEMO LIGHT, PATCH AND REPAIR WALL AS NEEDED. -

DEMO EAST EXTERIOR ELEVATION SCALE: 1/8" = 1'-0"

GENERAL ARCHITECTURAL DEMOLITION/REMODEL NOTES:

I . GENERAL CONTRACTOR TO REMOVE AND DISPOSE OF ALL MATERIALS AS NECESSARY.

2. PROTECT EXISTING SURFACES AND FINISHES AT CONSTRUCTION ADJACENT TO REMODELED AREAS. PATCH, REPAIR OR REPLACE ALL AREAS DAMAGED OR DISTURBED BY CONSTRUCTION.

3. COORDINATE ALL CUTTING AND PATCHING AS REQUIRED (INDICATED OR NOT) FOR MECHANICAL AND ELECTRICAL WORK IN EXISTING SPACES.

4. PATCH ALL HOLES IN EXISTING SURFACES WHERE EQUIPMENT HAS BEEN REMOVED OR

DEMOLITION HAS OCCURRED AND PREPARE SURFACES AS REQUIRED FOR SCHEDULED FINISHES. PATCH TO MATCH ADJACENT SURFACES IF NOT SCHEDULED.

5. MATCH FINISHED WALL THICKNESS WHERE NEW WALLS OCCUR IN LINE WITH EXISTING

6. ALL EXISTING FLOOR OPENINGS AND DEPRESSIONS NOT USED IN THE WORK SHALL BE FILLED OR CLOSED WITH MATERIALS TO MATCH ADJACENT SURFACES AND FINISHES. FIELD VERIFY PRIOR TO BIDDING.

7. REINSTALL MISC. WALL HUNG EQUIPMENT / DEVICES REMOVED DURING DEMOLITION PER OWNERS DIRECTION.

8. PREPARE EXISTING WALL SURFACES (PATCH, SKIM COAT, ETC) AS REQUIRED IN PREPARATION FOR SCHEDULED FINISHES.

9. GENERAL CONTRACTOR TO PROVIDE SAFETY AND INSULATED DUST PARTITION BETWEEN


NEW ADDITION AND EXISTING HOTEL AS REQUIRED TO MINIMIZE DISRUPTION IN HOTEL. 10. GC TO COORDINATE SHUT-DOWN OF ANY UTILITIES WITH HOTEL MANAGER.

TEMPORARY GENERATOR MAY BE REQUIRED WHEN NEW ELECTRICAL SERVICE IS

HOTEL MANAGER.

CONNECTED TO EXISTING. I I. GENERAL CONTRACTOR WILL COORDINATE SCHEDULE OF DISRUPTIVE WORK WITH

12. AT ANY TIME DURING CONSTRUCTION, SHOULD DAMAGED OR MOLDY GYPSUM BOARD BE ENCOUNTERED, THE GENERAL CONTRACTOR SHALL NOTIFY THE ARCHITECT. BASED ON PHOTOGRAPHS OR ON-SITE INSPECTION, THE ARCHITECT WILL DETERMINE THE EXTENT OF REPLACEMENT OR ACTION REQUIRED IF ANY.

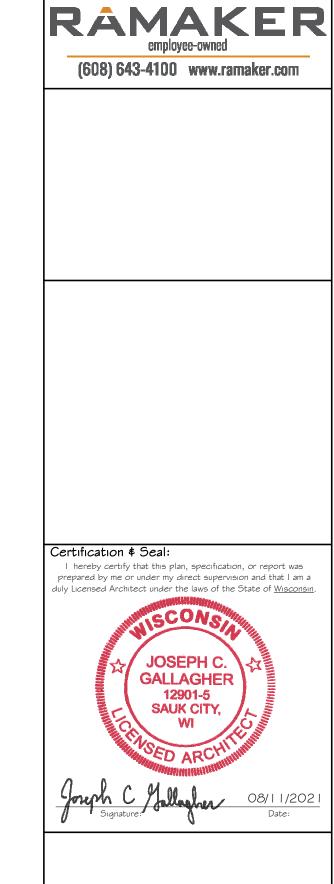

DATE

08/11/2021 ISSUED CITY OF MADISON CONDITIONAL

PROJECT TITLE

RED ROOSTER BAR REMODEL

PROJECT OWNER

PROJECT LOCATION


MADISON WI


NUMBER

DEMO - FIRST FLOOR

51488 NUMBER



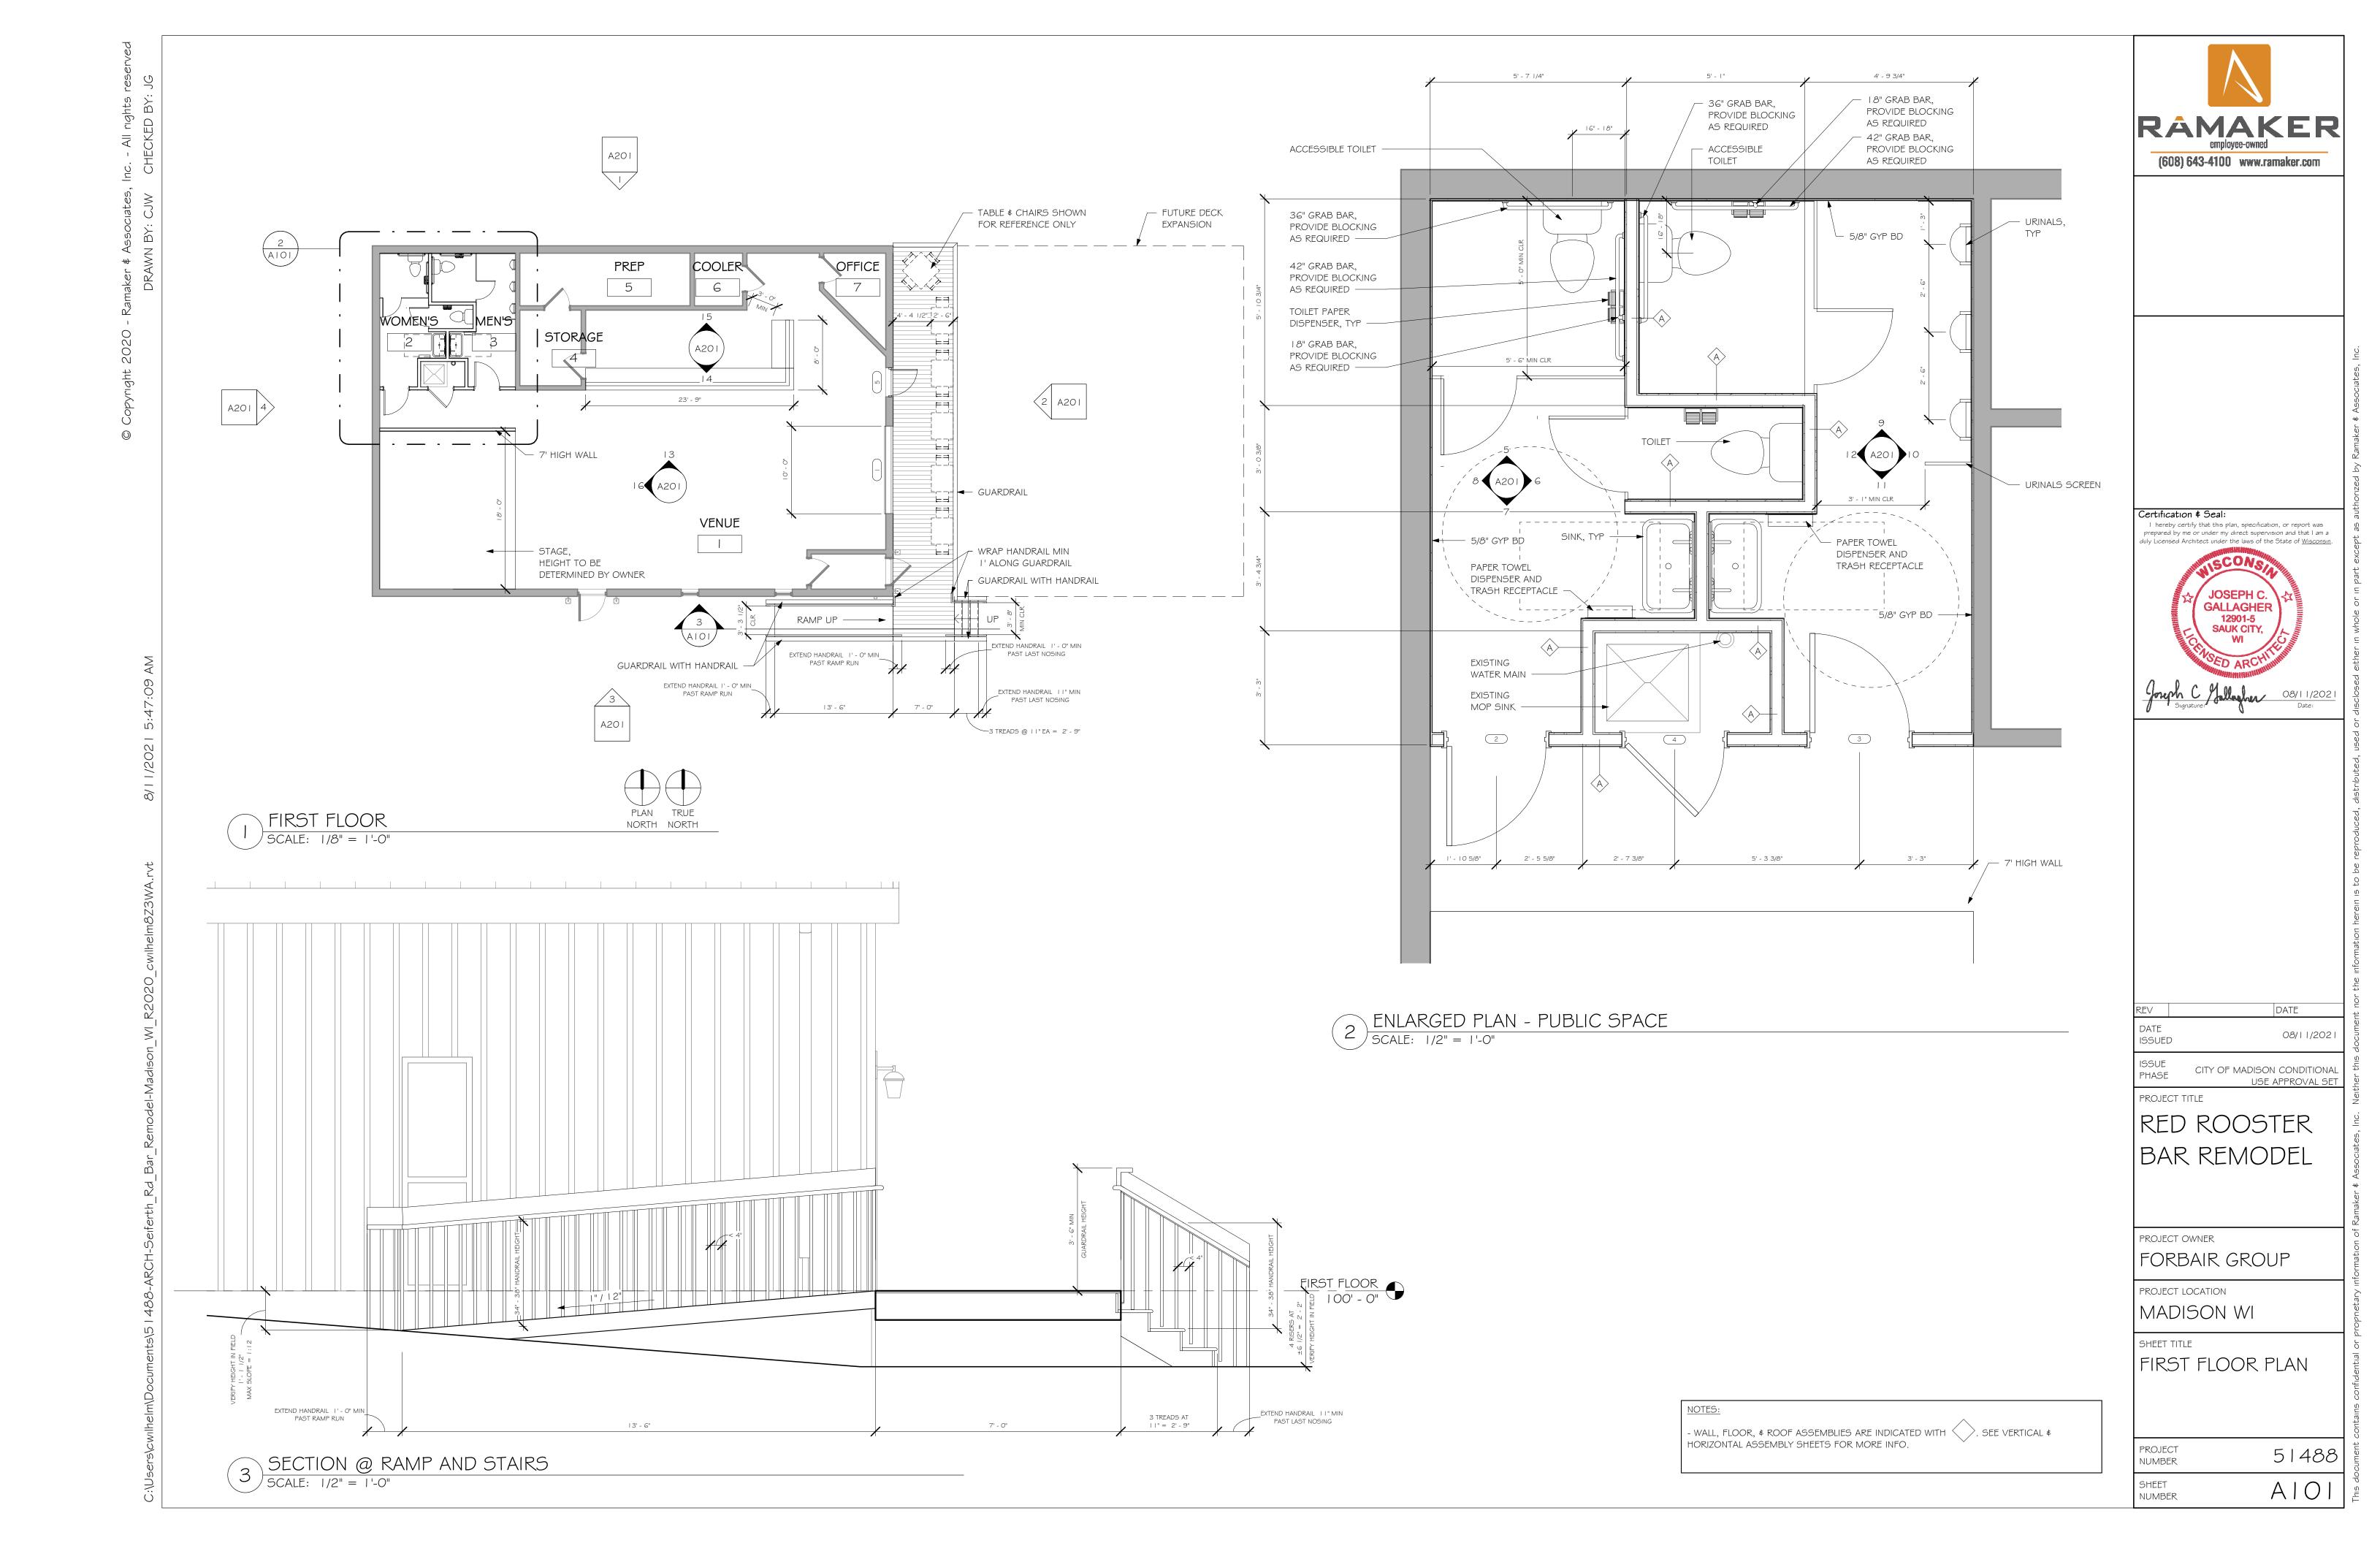


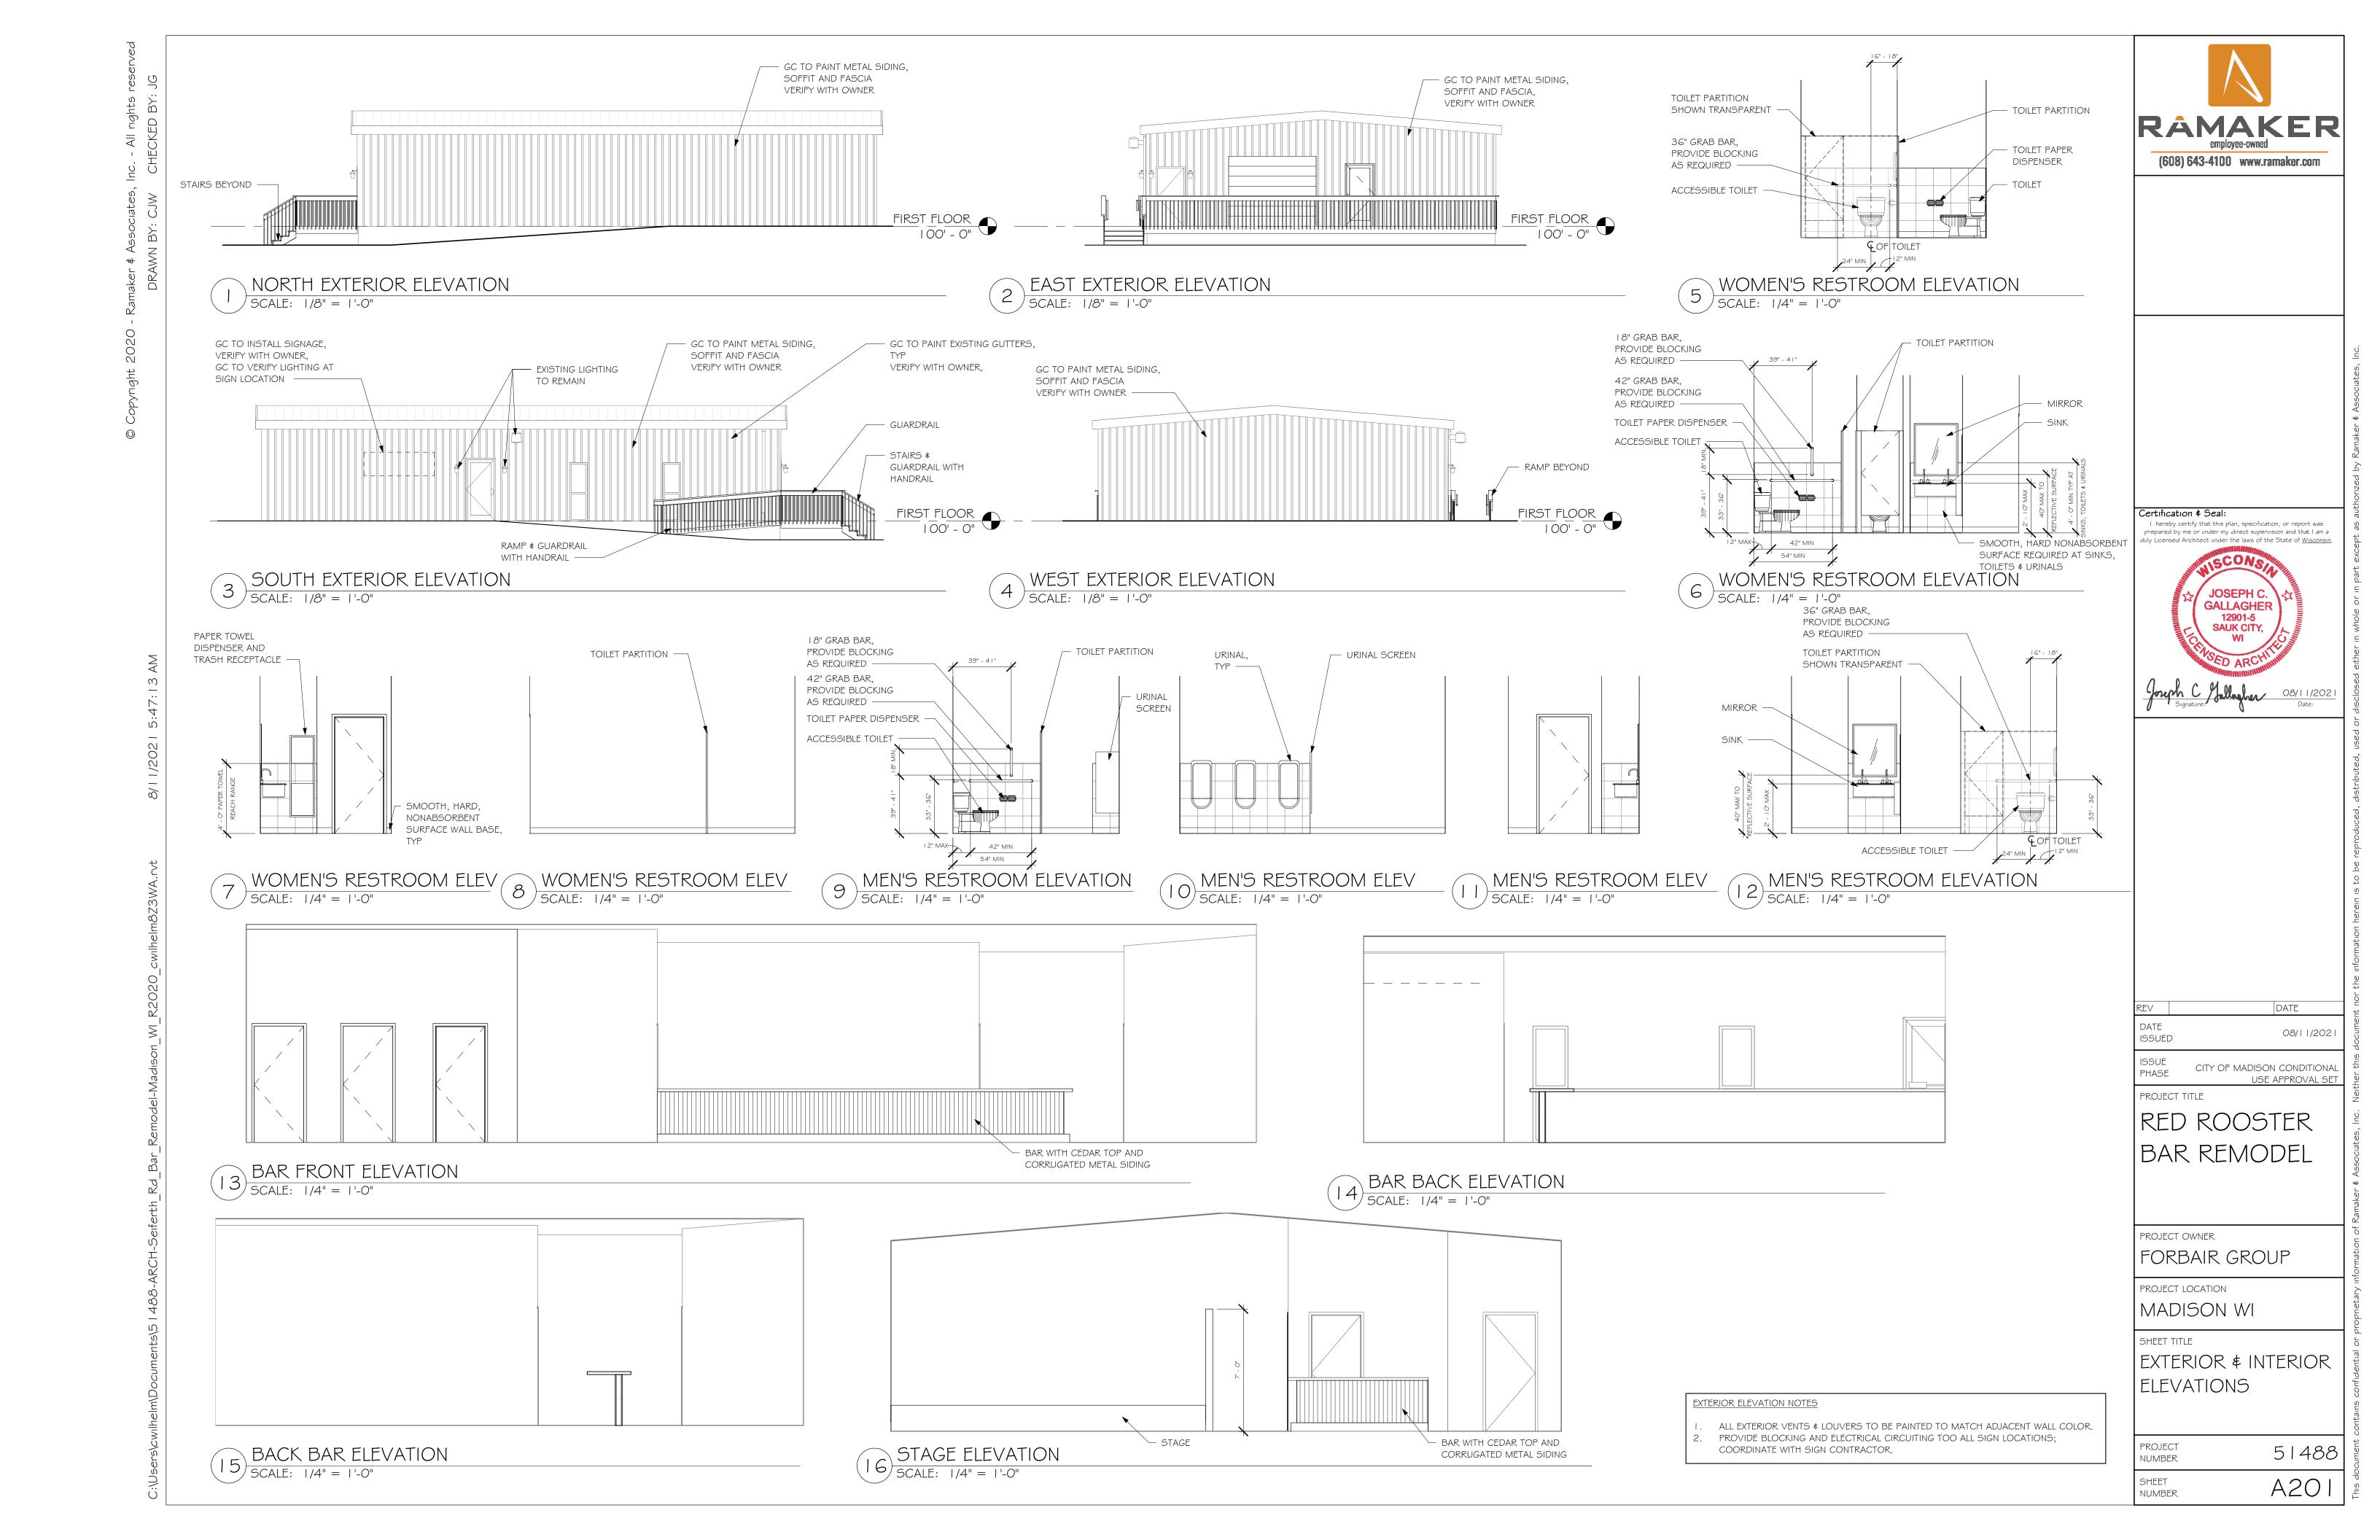

]	DOOR S	CHEDUI	LE					
	DOOR					FRAME							
		SIZE								HARDWARE		DOOR	
MARK	WIDTH	HEIGHT	THICKNESS	STYLE	MATERIAL	FINISH	STYLE	MATERIAL	FINISH	SET #	FIRE RATING	LOCATION	COMMENTS
I	10' - 0"	8' - 0"	1 1/2"										
2	2' - 10"	6' - 8"	1 3/4"	DI	WD	SŧV	FI	HM	PT				
3	2' - 10"	6' - 8"	1 3/4"	DI	WD	SŧV	FI	HM	PT				
4	2' - 10"	6' - 8"	1 3/4"	DI	WD	SŧV	FI	HM	PT				
5	3' - 0"	7' - 0"	2"	D3	ALUM	PREF	FI	ALUM	PREF				
							•	· · · · · · · · · · · · · · · · · · ·		•			

SEE SCHED	SEE SCHED // // // SEE SCHED	SEE SCHEDULE SEE SCHEDULE
DI	D2	D3
HM FLUSH	OVERHEAD	STOREFRONT



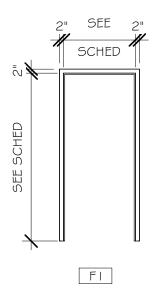

FRAME TYPES

SCALE: 1/4" = 1'-0"



Certification \$ Seal:

I hereby certify that this plan, specification, or report was prepared by me or under my direct supervision and that I am a duly Licensed Architect under the laws of the State of Wisconsin. SAUK CITY, WI

DATE 08/11/2021

ISSUE
PHASE

CITY OF MADISON CONDITIONAL
USE APPROVAL SET

RED ROOSTER BAR REMODEL

PROJECT OWNER FORBAIR GROUP

PROJECT LOCATION MADISON WI

DOOR SCHEDULE

PROJECT NUMBER 51488 A601


SHEET NUMBER

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FOR REVIEW PURPOSES ONLY

MADISON, WI 53716

SHEET NUMBER

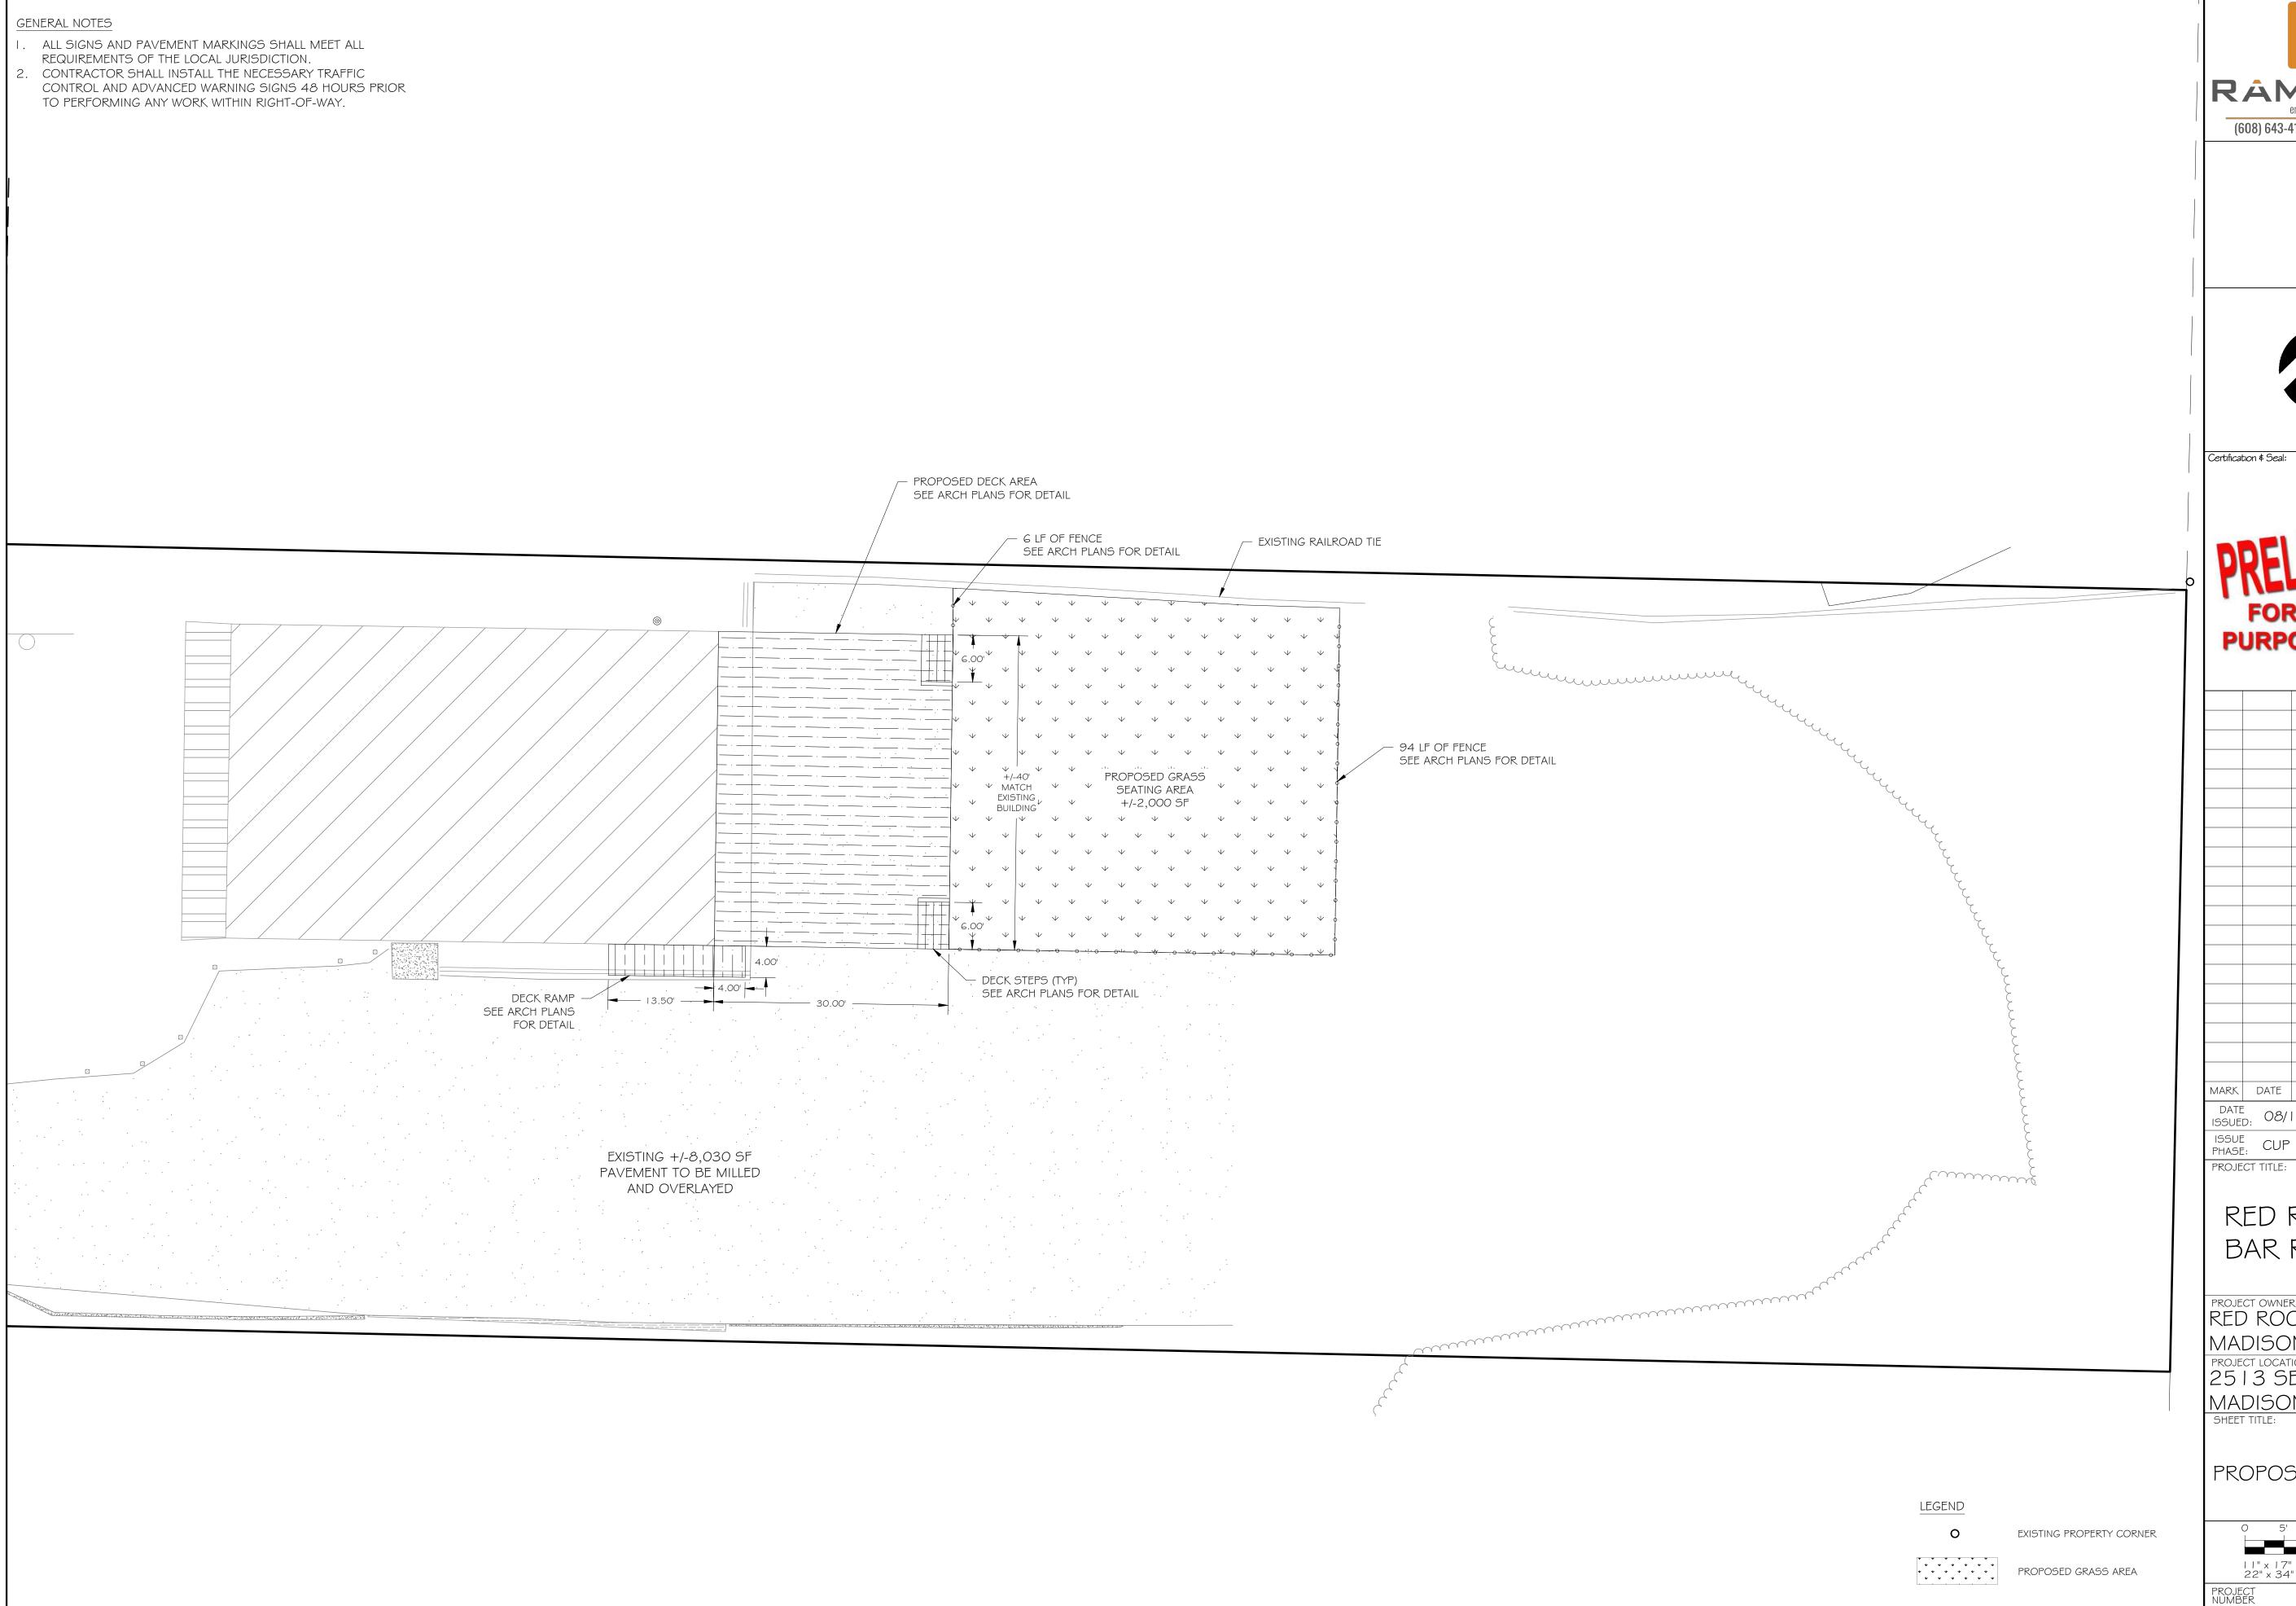


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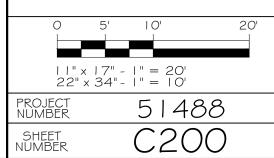
PRELIMINARY FOR REVIEW PURPOSES ONLY



RED ROOSTER BAR REMODEL

PROJECT OWNER:
RED ROOSTER
MADISON LLC
PROJECT LOCATION:
25 | 3 SEIFERTH RD.
MADISON, WI 537 | 6
SHEET TITLE:

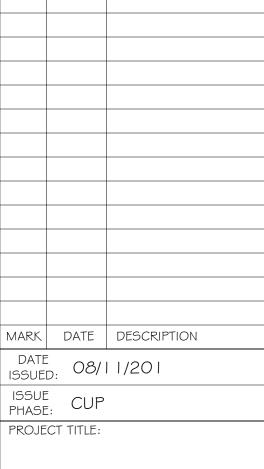PROPOSED SITE PLAN



EXISTING LOT LINES