### **URBAN DESIGN COMMISSION APPLICATION**



City of Madison Planning Division Madison Municipal Building, Suite 017 215 Martin Luther King, Jr. Blvd. P.O. Box 2985 Madison, WI 53701-2985 (608) 266-4635



Complete all sections of this application, including the desired meeting date and the action requested.

If you need an interpreter, translator, materials in alternate formats or other accommodations to access these forms, please call the phone number above immediately.

FOR OFFICE USE ONLY:				
Paid Receipt #				
Date received				
Received by 6/2/21				
Aldermanic District				
Zoning District				
Urban Design District				
Submittal reviewed by				
Legistar #				

1.	. Project Information					
	Address:					
	Title:					
2.	<b>Application Type</b> (check all that	apply) and Requested Date	e			
	UDC meeting date requested					
	New development	Alteration to an existing or	previously-approved development			
	Informational	Initial approval	Final approval			
3.	Project Type					
	Project in an Urban Design Dis	strict	Signage			
	Project in the Downtown Core District (DC), Urban		Comprehensive Design Review (CDR)			
	Mixed-Use District (UMX), or Mixed-Use Center District (MXC)  Project in the Suburban Employment Center District (SEC),  Campus Institutional District (CI), or Employment Campus		Signage Variance (i.e. modification of signage height,			
			area, and setback)			
	District (EC)	, , , ,	Signage Exception			
	Planned Development (PD)		Other			
	General Development Pl	• •	Please specify			
	Specific Implementation Plan (SIP)					
	Planned Multi-Use Site or Res	idential Building Complex				
4.	Applicant, Agent, and Property	Owner Information				
	Applicant name		Company			
	Street address		City/State/Zip			
	Telephone		Email			
	Project contact person		Company			
	Street address		City/State/Zip			
	Telephone		Email			
	Property owner (if not applicant	:)				
	Street address		City/State/Zip			
	Telephone		Email			
M-\ D	ANNUM C DIVISION COMMISSIONS & COMMITTEES !!!	RRANI DESIGNI COMMUSSIONI\ ARRIJICATIONI — F	EERBLIADY 2020 PAGE 1 OF A			

Each submittal must include

fourteen (14) 11" x 17" collated

paper copies. Landscape and

Lighting plans (if required)

must be full-sized and legible.

Please refrain from using

plastic covers or spiral binding.

### 5. Required Submittal Materials

- Application Form
- ☑ Letter of Intent
  - If the project is within an Urban Design District, a summary of how the development proposal addresses the district criteria is required
  - For signage applications, a summary of how the proposed signage is consistent with the applicable CDR or Signage Variance review criteria is required.
- Development Plans (Refer to checklist on Page 4 for plan details)
- ☑ Filing fee
- ☑ Electronic Submittal\*
- Notification to the District Alder
  - Please provide an email to the District Alder notifying them that you are filing this UDC application. Please send this
    as early in the process as possible and provide a copy of that email with the submitted application.

Both the paper copies and electronic copies <u>must</u> be submitted prior to the application deadline before an application will be scheduled for a UDC meeting. Late materials will not be accepted. A completed application form is required for each UDC appearance.

For projects also requiring Plan Commission approval, applicants must also have submitted an accepted application for Plan Commission consideration prior to obtaining any formal action (initial or final approval) from the UDC. All plans must be legible when reduced.

\*Electronic copies of all items submitted in hard copy are required. Individual PDF files of each item submitted should be compiled on a CD or flash drive, or submitted via email to <a href="mailto:udcapplications@cityofmadison.com">udcapplications@cityofmadison.com</a>. The email must include the project address, project name, and applicant name. Electronic submittals via file hosting services (such as Dropbox.com) are not allowed. Applicants who are unable to provide the materials electronically should contact the Planning Division at (608) 266-4635 for assistance.

### 6. Applicant Declarations

- Prior to submitting this application, the applicant is required to discuss the proposed project with Urban Design Commission staff. This application was discussed with <u>Janine Glaeser -UDC Planning Division</u> on Thursday May 27, 2021
- The applicant attests that all required materials are included in this submittal and understands that if any required information is not provided by the application deadline, the application will not be placed on an Urban Design Commission agenda for consideration.

Name of applicant Mark Laverty		Relationship to pro	perty De	eveloper	
Authorizing signature of property owner	min	Recorder	_ Date_	5/28/2021	
7 Application Filing Foos				ASSESSED INCOMPRESENTATION	

### 7. Application Filing Fees

Fees are required to be paid with the first application for either initial or final approval of a project, unless the project is part of the combined application process involving the Urban Design Commission in conjunction with Plan Commission and/or Common Council consideration. Make checks payable to City Treasurer. Credit cards may be used for application fees of less than \$1,000.

Please consult the schedule below for the appropriate fee for your request:

Urban Design Districts: \$350 (per §35.24(6) MGO).								
Minor Alteration in the Downtown Core District (DC) or Urban Mixed-Use District (UMX): \$150 (per §33.24(6)(b) MGO)								
Comprehensive Design Review: \$500 (per §31.041(3)(d)(1)(a) MGO)								
			to a Comp !)(c) MGO)	rehe	nsive	Sign Pla	n: \$100	
All	other	sign	requests	to	the	Urban	Design	

- A filing fee is not required for the following project applications if part of the combined application process involving both Urban Design Commission and Plan Commission:
- Project in the Downtown Core District (DC), Urban Mixed-Use District (UMX), or Mixed-Use Center District (MXC)
- Project in the Suburban Employment Center District (SEC), Campus Institutional District (CI), or Employment Campus District (EC)
- Planned Development (PD): General Development Plan (GDP) and/or Specific Implementation Plan (SIP)
- Planned Multi-Use Site or Residential Building Complex

Commission, including, but not limited to: appeals

from the decisions of the Zoning Administrator,

requests for signage variances (i.e. modifications of signage height, area, and setback), and additional sign

code approvals: \$300 (per §31.041(3)(d)(2) MGO)

### **URBAN DESIGN COMMISSION APPROVAL PROCESS**



### Introduction

The City of Madison's Urban Design Commission (UDC) has been created to:

- Encourage and promote high quality in the design of new buildings, developments, remodeling, and additions so as to maintain and improve the established standards of property values within the City.
- Foster civic pride in the beauty and nobler assets of the City, and in all other ways possible assure a functionally efficient and visually attractive City in the future.

### **Types of Approvals**

There are three types of requests considered by the UDC:

- Informational Presentation. Applicants may, at their discretion, request to make an Informational Presentation to the
  UDC prior to seeking any approvals to obtain early feedback and direction before undertaking detailed design. Applicants
  should provide details on the context of the site, design concept, site and building plans, and other relevant information
  to help the UDC understand the proposal and provide feedback. (Does not apply to CDR's or Signage Variance requests)
- <u>Initial Approval</u>. Applicants may, at their discretion, request initial approval of a proposal by presenting preliminary design information. As part of their review, the Commission will provide feedback on the design information that should be addressed at Final Approval stage.
- <u>Final Approval</u>. Applicants may request Final Approval of a proposal by presenting all final project details. Recommendations or concerns expressed by the UDC in the initial approval must be addressed at this time.

### **Presentations to the Commission**

Primarily, the UDC is interested in the appearance and design quality of projects. Emphasis should be given to the site plan, landscape plan, lighting plan, building elevations, exterior building materials, color scheme, and graphics.

When presenting projects to the UDC, applicants must fill out a registration slip provided in the meeting room and present it to the Secretary. Presentations should generally be limited to 5 minutes or as extended by motion by consent of the Commission. The Commission will withhold questions until the end of the presentation.

Applicants are encouraged to consider the use of various graphic presentation material including a locator map, photographs, renderings/model, scale drawings of the proposal in context with adjacent buildings/uses/signs, etc., as may be deemed appropriate to describe the project and its surroundings. Graphics should be mounted on rigid boards so that they may be easily displayed. Applicants/presenters are responsible for all presentation materials, AV equipment and easels.

### URBAN DESIGN DEVELOPMENT PLANS CHECKLIST



The items listed below are minimal application requirements for the type of approval indicated. Please note that the UDC and/ or staff may require additional information in order to have a complete understanding of the project

Or Stair Illa	y require additional information in order to	IIav		5 01 (	inc projec	
1. Informa	itional Presentation					
	Locator Map	١			Requirem	nents for All Plan Sheets
	Letter of Intent (If the project is within an Urban Design District, a summary of how the development proposal addresses the district criteria is required)		Providing additional			e block et number th arrow
	Contextual site information, including photographs and layout of adjacent buildings/structures		information beyond these minimums may generate a greater level of feedback from the Commission.	5. Date		y dimensioned plans, scaled
	Site Plan					"= 40' or larger
	Two-dimensional (2D) images of proposed buildings or structures.					ns must be legible, including ized landscape and lighting equired)
2. Initial A	pproval					
•	Locator Map				)	
	_ ·					
	structures  Site Plan showing location of existing and proposed buildings, walks, drives, bike minimums may gene					
					<ul> <li>minimums may generate</li> <li>a greater level of feedback</li> </ul>	
	Landscape Plan and Plant List (must be leg	jiblo	e)			from the Commission.
•	Building Elevations in both black & white and color for all building sides (include material callouts)					
	PD text and Letter of Intent (if applicable)				J	
3. Final Ap	proval					
All the re	equirements of the Initial Approval (see abo	ove	), <u>plus</u> :			
•	Grading Plan					
•	Proposed Signage (if applicable)					
•	<ul> <li>Lighting Plan, including fixture cut sheets and photometrics plan (must be legible)</li> </ul>					
•	<ul> <li>Utility/HVAC equipment location and screening details (with a rooftop plan if roof-mounted)</li> </ul>					
•	PD text and Letter of Intent (if applicable)					
	Samples of the exterior building materials	(pr	resented at the UDC meetin	ıg)		
4. Compre	hensive Design Review (CDR) and Variand	ce i	Requests ( <i>Signage applica</i>	ition	s only)	
	Locator Map					
_				<b>CD</b>	· ·	.,

☐ Letter of Intent (a summary of <u>how</u> the proposed signage is consistent with the CDR or Signage Variance criteria is required) ☐ Contextual site information, including photographs of existing signage both on site and within proximity to the project site ☐ Site Plan showing the location of existing signage and proposed signage, dimensioned signage setbacks, sidewalks, driveways, and right-of-ways ☐ Proposed signage graphics (fully dimensioned, scaled drawings, including materials and colors, and night view) ☐ Perspective renderings (emphasis on pedestrian/automobile scale viewsheds) ☐ Illustration of the proposed signage that meets Ch. 31, MGO compared to what is being requested. ☐ Graphic of the proposed signage as it relates to what the Ch. 31, MGO would permit



May 5<sup>th</sup>, 2021

City of Madison Planning Division Madison Municipal Building, Suite 017 215 Martin Luther King, Jr. Blvd. P.O. Box 2985 Madison, WI 53701-2985

Re: Rezoning of 575 Zor Shrine Place

Dear Members of the Plan Commission and Common Council:

Please accept this Letter of Intent, Application and plans as our formal request for approval to rezone the site at 575 Zor Shrine Place from the Suburban Employment (SE) to the Traditional Residential – Urban District (TR-U2). We are requesting approval of our plans for the development of two multifamily buildings on the site. The project is being financed through a first mortgage, owner equity, and equity partners in the deal. The experienced project team consists of Saturday Properties (Developer – Mark Laverty and Property Manager – Jaime Perron), a local developer out of the Twin Cities Area, Cuningham (Architect – David Stahl), Stevens Construction (General Contractor – Matt Hartenstein), and Vierbicher (Civil Engineer – Matt Schreiner).

We believe this project is a benefit to the City of Madison and neighborhood for the key reasons:

- Creation of 479 new, rental apartments that will give renters another option in an area with ~2% vacancy
- Public connection to the planned bike path
- Dedication of public right of way for future grid system as considered in the draft Odana Area Plan
- Estimated annual property taxes per year of \$1,060,000 for a parcel that is currently exempt from property taxes
- Park impact fees totalling \$1,860,000 at the time building permits are issued for the development

The Zor Shrine site is located at 575 Zor Shrine Place in Madison, WI. The site is currently home of the Madison Zor Shriners Zor Temple. They will be relocating downtown and entered into a Purchase and Sale Agreement with Saturday Properties to sell the site. The site is roughly 8.87 acres with the Zor Temple, a surface parking lot, and green space that underutilizes the site's potential. Both the temple and parking lot will be removed for the redevelopment.

The new site configuration was designed to allow for future street connectivity at the northern most point of the site between Zor Shrine Place and the West Town Mall out lot area, as called out by the Odana Area Plan, with a 65 foot right of way. The street was also designed to create a direct connection for pedestrians coming from Zor Shrine Place to get on to the future bike extension along West Beltline Hwy (Hwy 14). In addition to the development of the multifamily buildings, the western most portion of the site is also being left for the potential development of an office building at a later date.

The project redevelopment consists of an east and west multifamily building as designated by each building's geographical location on the site. The project will have a total of 479 rental units and 552 bedrooms across 471,479 gross square feet. Each building will have underground parking (247 stalls total) with shared surface parking for the project of 255 stalls, for a total parking count of 501 stalls. The breakdown between the buildings is provided on the following page.



<u>Metric</u>	<b>East Building</b>	<b>West Building</b>
Number of Units	263	216
Number of Bedrooms	305	247
Gross Square Footage	259,399	212,081
Garage Parking Stalls	130	117

Project amenities include fitness room, resort style pool, grill and chill areas, enclosed bike parking, dog run, top floor lounge with views, workout studio, yard games, hot tub, chef's kitchen, co-working space, remote working spaces, secure package storage, onsite concierge, residential events and designated move-in/move-out areas. Landscaping and trees surrounding the buildings will provide a sense of privacy and will include many native plant and tree species. The front entrance to the buildings will have seating for residents waiting for a rideshare or friends. Residents will have direct access to the future bike path connection, amongst many great neighborhood restaurants and shopping options.

The developer will acquire the property and start construction by December of 2021. Construction is scheduled to take place over two phases. The first phase consists of the east building and is estimated to take sixteen months to construct. The west building will begin in Fall 2022 and open in Spring 2024.

Once developed, the project will be managed by Saturday Properties with local staff hired to run and maintain the buildings. Saturday expects there to be a total of twelve fulltime employees across the two buildings, bringing new jobs to the area. The roles will be for a general manager, assistant manager, leasing, maintenance crew, and caretaker with staff available for questions at all times. The team will work typical hours with leasing and site visits available at peak times during the days and weeks.

Sincerely,

**Saturday Properties LLC** 

Name: Mark Laverty

# Multifamily at 575 Zor Shrine Place



Site Map

# **Project Team**

Archited	ot	Civil	<u>MEP</u>				
Name:	Cuningham	Name: Vierbicher Associates, Inc.	Name: Emanuelson-Podas	Name:	Name:	Name:	-
Contact:	Dave Stahl Natina James	Contact: Matthew Schreiner	Contact: Matthew Fults Michael Webert	Contact:	Contact:	Contact:	
Address:	201 SE Main Street Suite 325 Minneapolis, MN 55414	Address: 999 Fourier Drive Suite 201 Madison, WI 53717	Address: 7705 Bush Lake Road Edina, MN 55439	Address:	Address:	Address:	
Phone: FAX: E-Mail:	(612) 379-3400 (###) ###-#### njames@cuningham.com	Phone: (608) 821-3961 FAX: (###) ###-#### E-Mail: msch@vierbicher.com	Phone: (952) 930-0050 FAX: (###) ###-#### E-Mail: mfults@epinc.com	Phone: (###) ###-#### FAX: (###) ###-#### E-Mail:	Phone: (###) ###-#### FAX: (###) ###-#### E-Mail:	Phone: (###) ###-#### FAX: (###) ###-#### E-Mail:	
Landsca	аре						
Name:	Cuningham	Name:	Name:	Name:	Name:	Name:	-
Contact:	Mike Jones	Contact:	Contact:	Contact:	Contact:	Contact:	
Address:	201 SE Main Street Suite 325 Minneapolis, MN 55414	Address:	Address:	Address:	Address:	Address:	
Phone: FAX: F-Mail:	(612) 379-3400 (###) ###-#### miones@cuningham.com	Phone: (###) ###-#### FAX: (###) ###-#### F-Mail:	Phone: (###) ###-#### FAX: (###) ###-#### F-Mail:	Phone: (###) ###-#### FAX: (###) ###-#### F-Mail:	Phone: (###) ###-#### FAX: (###) ###-#### F-Mail:	Phone: (###) ###-#### FAX: (###) ###-####	

# Sheet Index - LUA

Number	Sheet Name
A-0	Cover Sheet
A-1	Site Plan (Overall)
A-2	Floor Plan - Parking Level
A-3	Floor Plan - Level 1
A-4	Floor Plan - Level 2 thru 4
A-5	Floor Plan - Level 5
A-6	Roof Plan
A-7	Building Elevations - West Building
A-8	Building Elevations - East Building
A-9	Enlarged Building Elevation
D 1	Sito Domo

Level	Area
East	
Parking Level 1	51187 SF
Level 1	41845 SF
Level 2	41591 SF
Level 3	41591 SF
Level 4	41591 SF
Level 5	41591 SF
	259399 SF
West	
Parking Level 1	44526 SF
Level 1	33511 SF
Level 2	33511 SF
Level 3	33511 SF
Level 4	33511 SF
Level 5	33511 SF
	212081 SF

Area Schedule (Rentable & Common)						
Level	Name	Area				
East						
Common Area						
Parking Level 1	Common Area	51187 SF				
_evel 1	Common Area	12806 SF				
evel 2	Common Area	5345 SF				
_evel 3	Common Area	5345 SF				
_evel 4	Common Area	5345 SF				
evel 5	Common Area	6439 SF				
		86468 SF				
Rentable Area						
evel 1	Rentable Area	29040 SF				
evel 2	Rentable Area	36246 SF				
_evel 3	Rentable Area	36246 SF				
evel 4	Rentable Area	36246 SF				
evel 5	Rentable Area	35153 SF				
		172931 SF				
		259399 SF				
West Common Area Parking Level 1	Common Area	44526 SF				
_evel 1	Common Area	13649 SF				
evel 2	Common Area	4144 SF				
evel 3	Common Area	4144 SF				
evel 4	Common Area	4144 SF				
evel 5	Common Area	5238 SF				
	I	75845 SF				
Rentable Area						
evel 1	Rentable Area	19862 SF				
evel 2	Rentable Area	29367 SF				
evel 3	Rentable Area	29367 SF				
evel 4	Rentable Area	29367 SF				
evel 5	Rentable Area	28273 SF				
		136236 SF				
		212081 SF				

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PRELIMINARY NOT FOR CONSTRUCTION

Revisions

No. Date Description

Project Information

Phase: LUA /UDC Date:

Project No.: 20-0084 PIC / AIC:


Multifamily at 575 Zor Shrine Place


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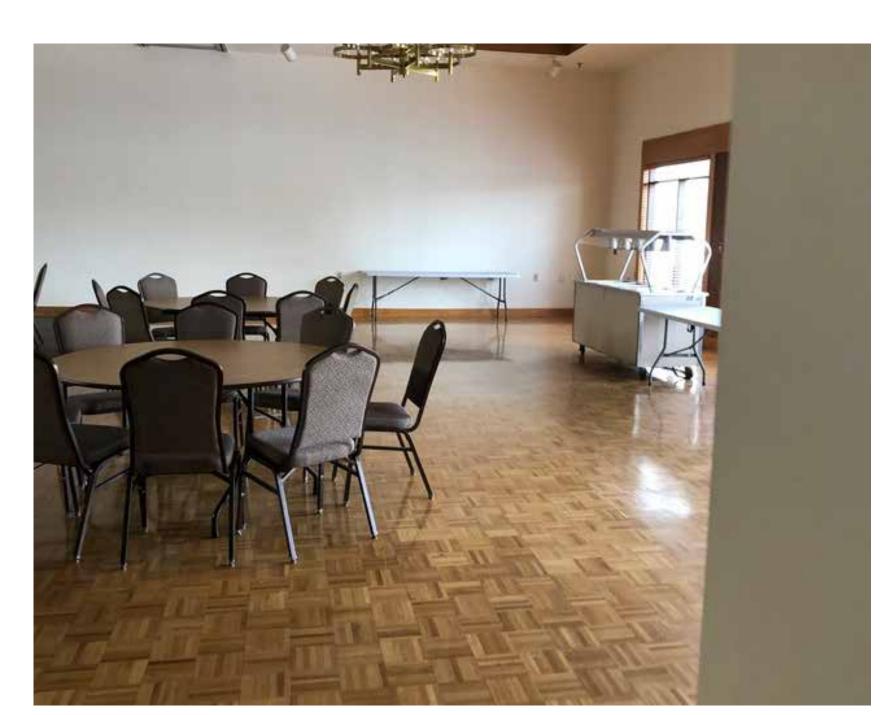
Cover Sheet

Sheet Number

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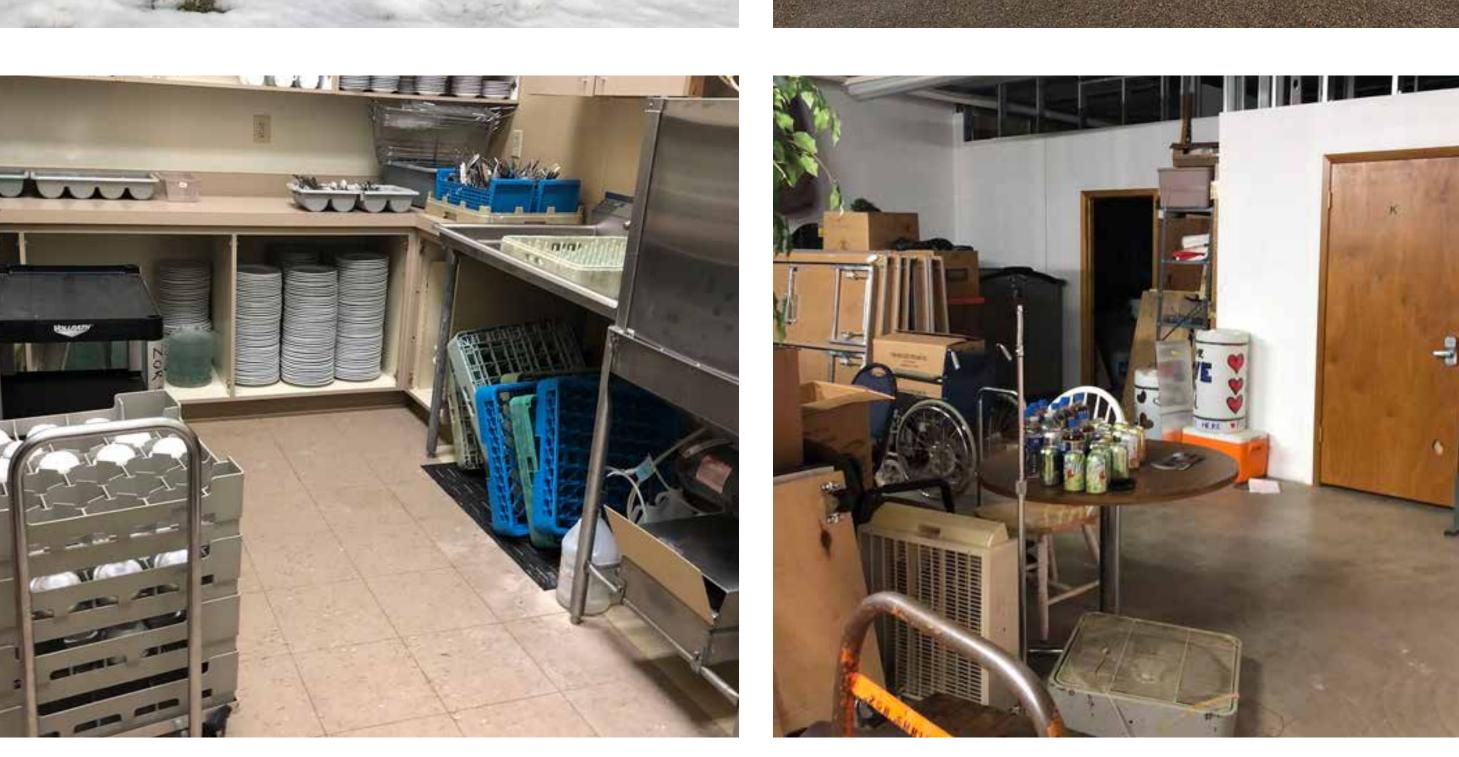




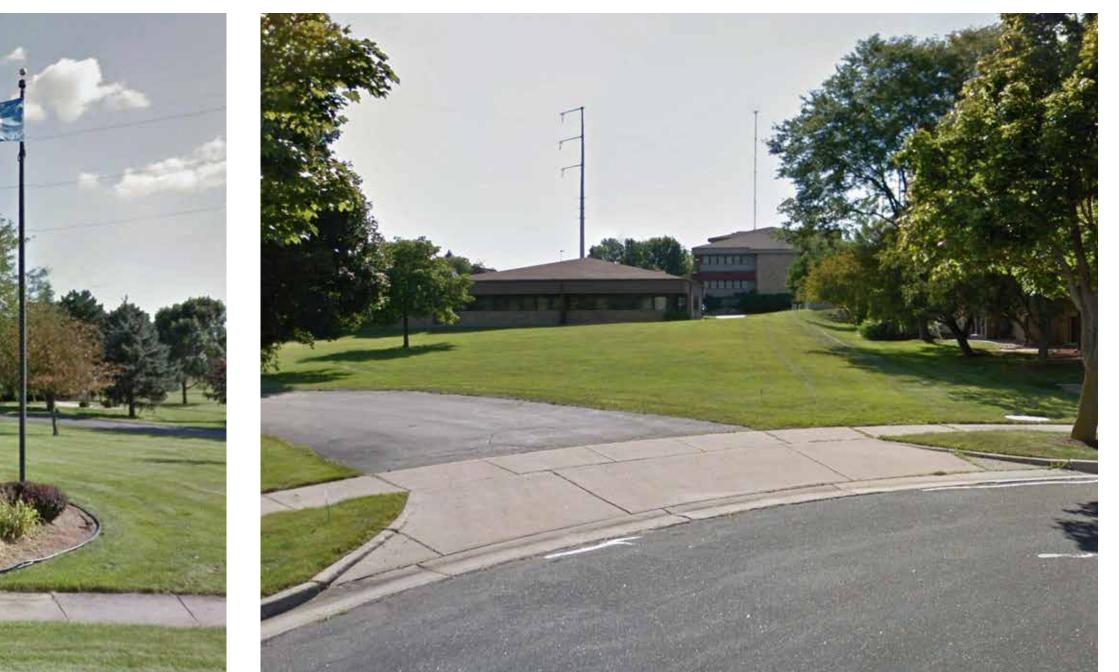

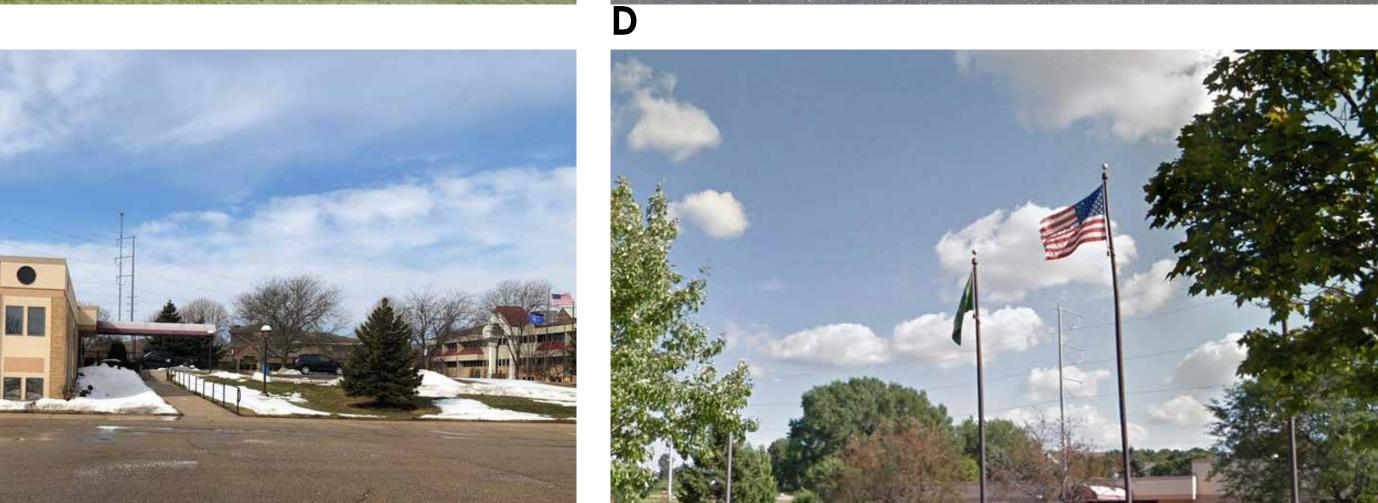










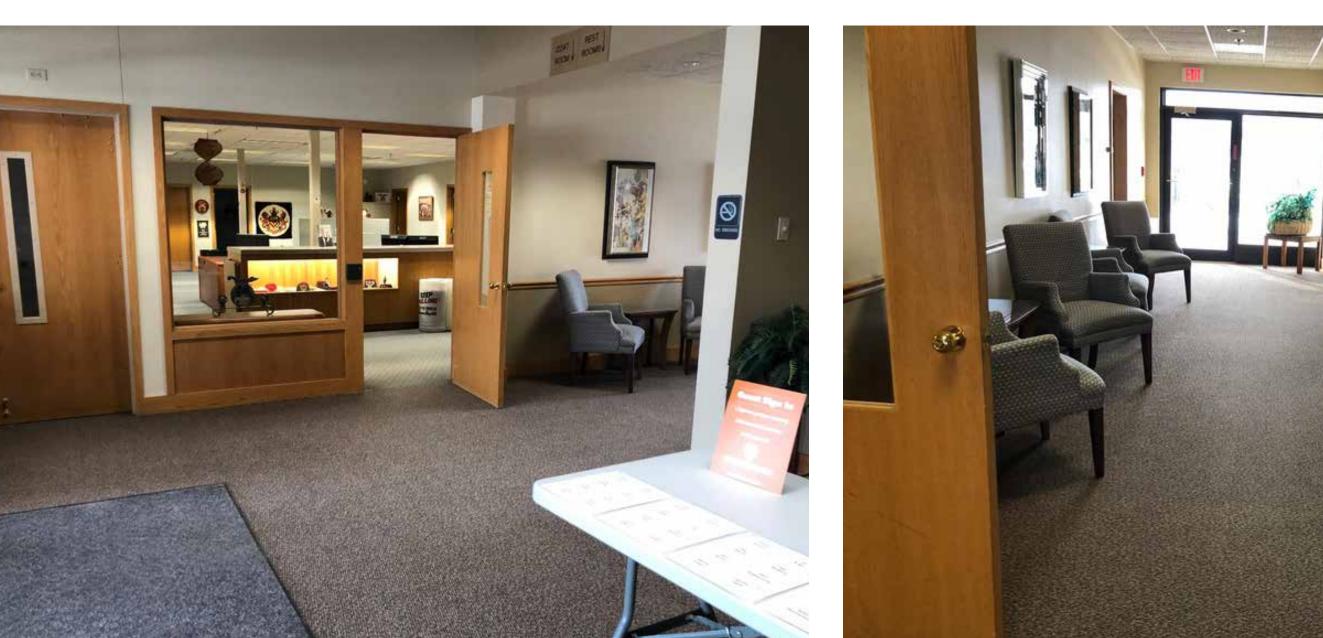



Madiaan Mix			
Project No.:	20-0084	PIC / AIC:	DStahl/JScho
Phase:	LUA	Date:	05/05
Project Information			

Madison Mixed Use

Existing Conditions

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Description


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Multifamily at 575 Zor Shrine Place

Site Plan (Overall)

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SITE METRICS

EXISTING ADDRESS: 575 ZOR SHRINE PLACE, MADISON, WI EXISTING SITE ACREAGE: 8.87 ACRES EXISTING ZONING: (SE) SUBURBAN EMPLOYMENT

PROPOSED ZONING: (TR-U2) TRADITION RESIDENTIAL - URBAN DISTRICT

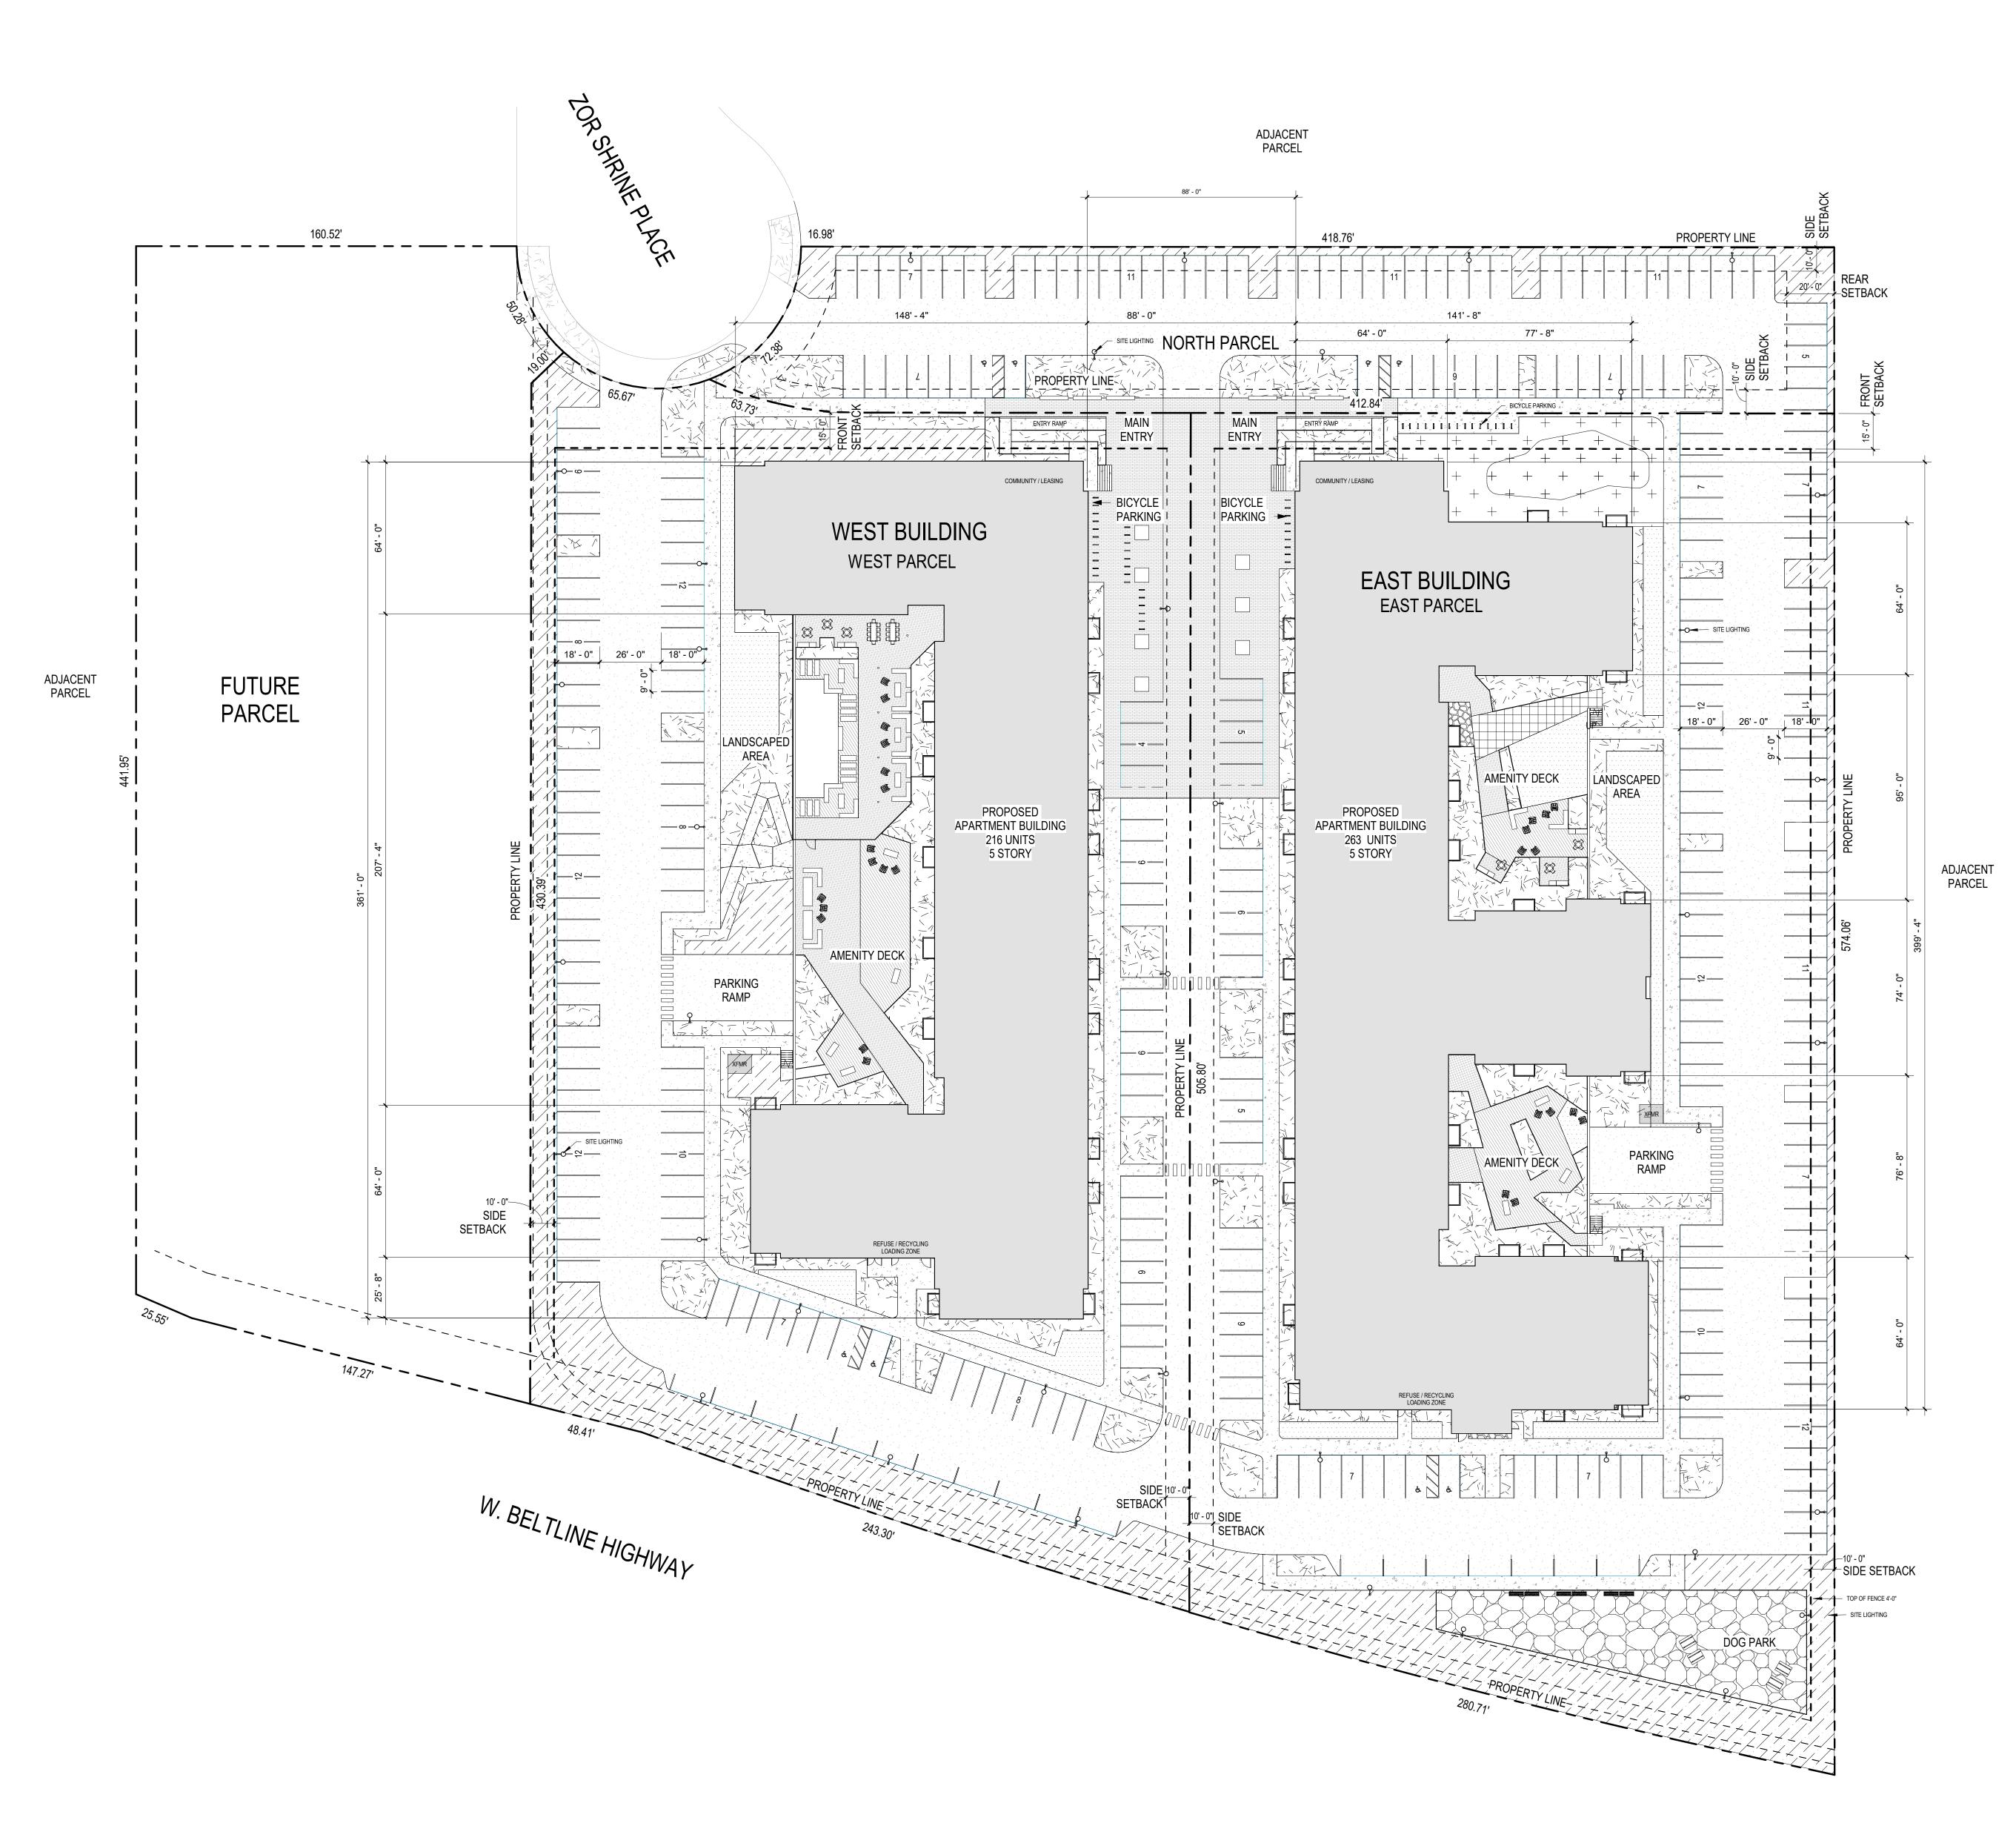TR-U2 REQUIREMENTS MAX. HEIGHT -

> REQUIRED - MAX. 6 STORIES OR 78' PROVIDED - 5 STORIES AT 62'

NORTH PARCEL

SITE: 31,357 SF (0.719 ACRES) LOT COVERAGE REQUIRED - 80% MAX. PROVIDED - 71% COVERAGE **USABLE OPEN SPACE:** 

REQUIRED - MIN. 140 SF PER D.U (0 UNITS = 0 SF REQUIRED) PROVIDED - 7,152 SF \*NO UNITS ARE PROVIDED ON THIS PARCEL

PAVED AREA: 22,238 SF LANDSCAPED AREA: 9,119 SF

BUILDING: 0 SF PARKING: 66 SPACES (NOT INCLUDED IN REQUIRED TOTALS)

**WEST PARCEL** 

SITE: 129,781 SF (2.979 ACRES) LOT COVERAGE: REQUIRED - 80% MAX.

PROVIDED: 87,804 SF / 67.6% COVERAGE USABLE OPEN SPACE: REQUIRED - MIN. 140 SF PER D.U (216 UNITS x 140 SF = 30,240 SF)

PROVIDED - 52,993 SF PAVED AREA: 43,278 SF LANDSCAPED AREA: 86,503 SF

BUILDING FOOTPRINT: 44,526 SF MAX. BUILDING COVERAGE: N/A GROSS BUILDING TOTAL: 212,081 SF

**UNITS: 216** NUMBER OF BEDS: 247 (SEE A2 - A5 FOR DETAILS)

PARKING: REQUIRED 216 SPACES (1 PER UNIT) 117 BELOW GRADE/ 120 AT GRADE (237 TOTAL SPACES) \*SEE PARKING NOTES BELOW

**BICYLE PARKING:** REQUIRED 216 SPACES (INDOOR) / 22 (OUTSIDE) (1 PER UNIT COVERED = 216, 1 PER 10 UNITS OUTDOOR = 22) PROVIDED 216 (INDOOR) - 22 (OUTSIDE)

**EAST PARCEL** 

SITE: 147,257 SF (3.381 ACRES)

LOT COVERAGE: REQUIRED - 80% MAX. PROVIDED: 100,828 SF / 68.4% COVERAGE

**USABLE OPEN SPACE:** REQUIRED - MIN. 140 SF PER D.U (263 UNITS = 36,820 SF REQUIRED)

PROVIDED: 53,914 SF PAVED AREA: 49,641 SF LANDSCAPED AREA: 55,842 SF

BUILDING FOOTPRINT: 51,187 SF GROSS BUILDING TOTAL: 259,399 SF UNITS: 263

NUMBER OF BEDS 305 (SEE A2 / A5 FOR DETAILS) PARKING:

REQUIRED: 263 SPACES (1 PER UNIT) PROVIDED: 130 BELOW GRADE/ 136 AT GRADE (266 TOTAL SPACES) \*SEE PARKING NOTES BELOW

BICYLE PARKING: REQUIRED: 263 SPACES (INDOOR) / 27 (OUTSIDE) (1 PER UNIT COVERED - 263, 1 PER 10 UNITS OUTDOOR = 27) PROVIDED: 263 SPACES (INDOOR) / 27 (OUTSIDE)

FUTURE PARCEL: 77,825 SF (1.787 ACRES) \*\*NOT TO BE DEVELOPED AT THIS TIME - NOT INCLUDED IN REQUIRED TOTALS

**PARKING NOTES** 

28.141 PARKING AND LOADING STANDARDS 2021-2025 - 10% EV READY SPACES / 2% EV INSTALLED

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Project No.: 20-0084 PIC / AIC: JSchoeneck

Multifamily at 575 Zor

Shrine Place

Sheet Title
Floor Plan - Parking Level

Sheet Number



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Typical Units Area

Area

445 SF 542 SF

644 SF

668 SF

Room Matrix - West Building

Room Matrix - East Building

1,067 SF

Unit Type

Alcove Unit

Corner Alcove Unit

1 Bedroom Unit

2 Bedroom Unit

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Multifamily at 575 Zor Shrine Place

Sheet Title
Floor Plan - Level 1

heet Number Current I



201 Main Street SE | Suite 325 | Minneapolis | MN 55414



Typical Units Area

Area

445 SF

542 SF

644 SF

668 SF

1,067 SF

**Room Matrix - East Building** 

Unit Type

Studio Unit

Alcove Unit

Corner Alcove Unit

1 Bedroom Unit

2 Bedroom Unit

## **PRELIMINARY** NOT FOR CONSTRUCTION


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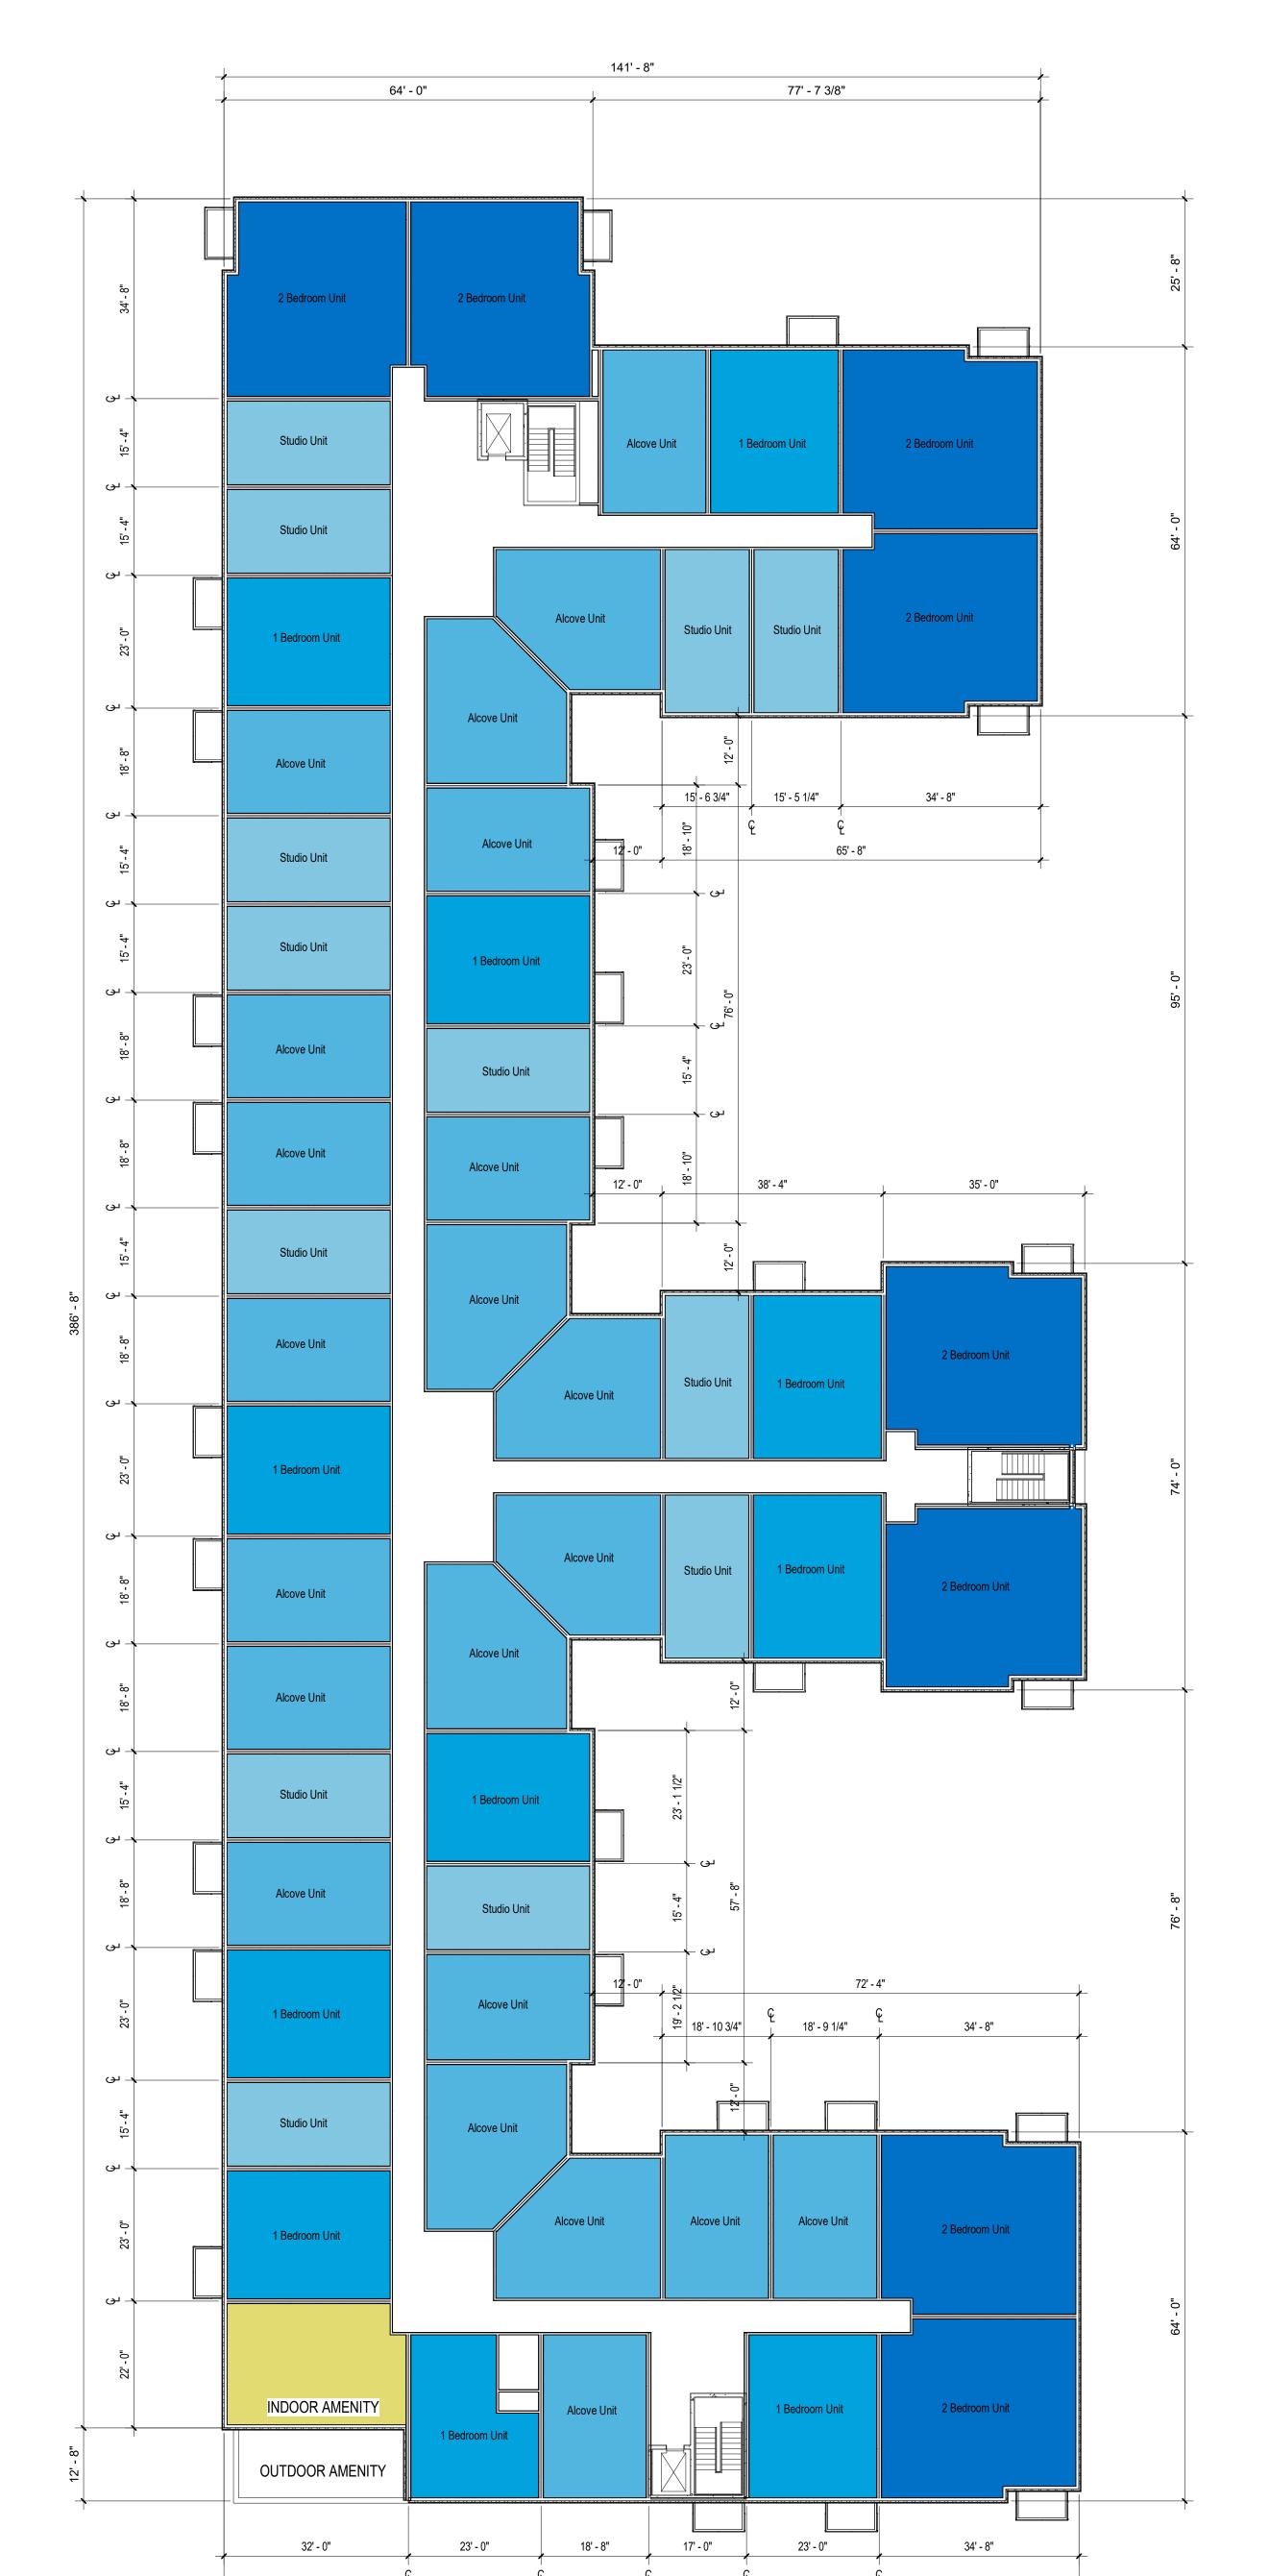
Multifamily at 575 Zor Shrine Place

Floor Plan - Level 5

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1 Level 5
A-5 1/16" = 1'-0"



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Revisions

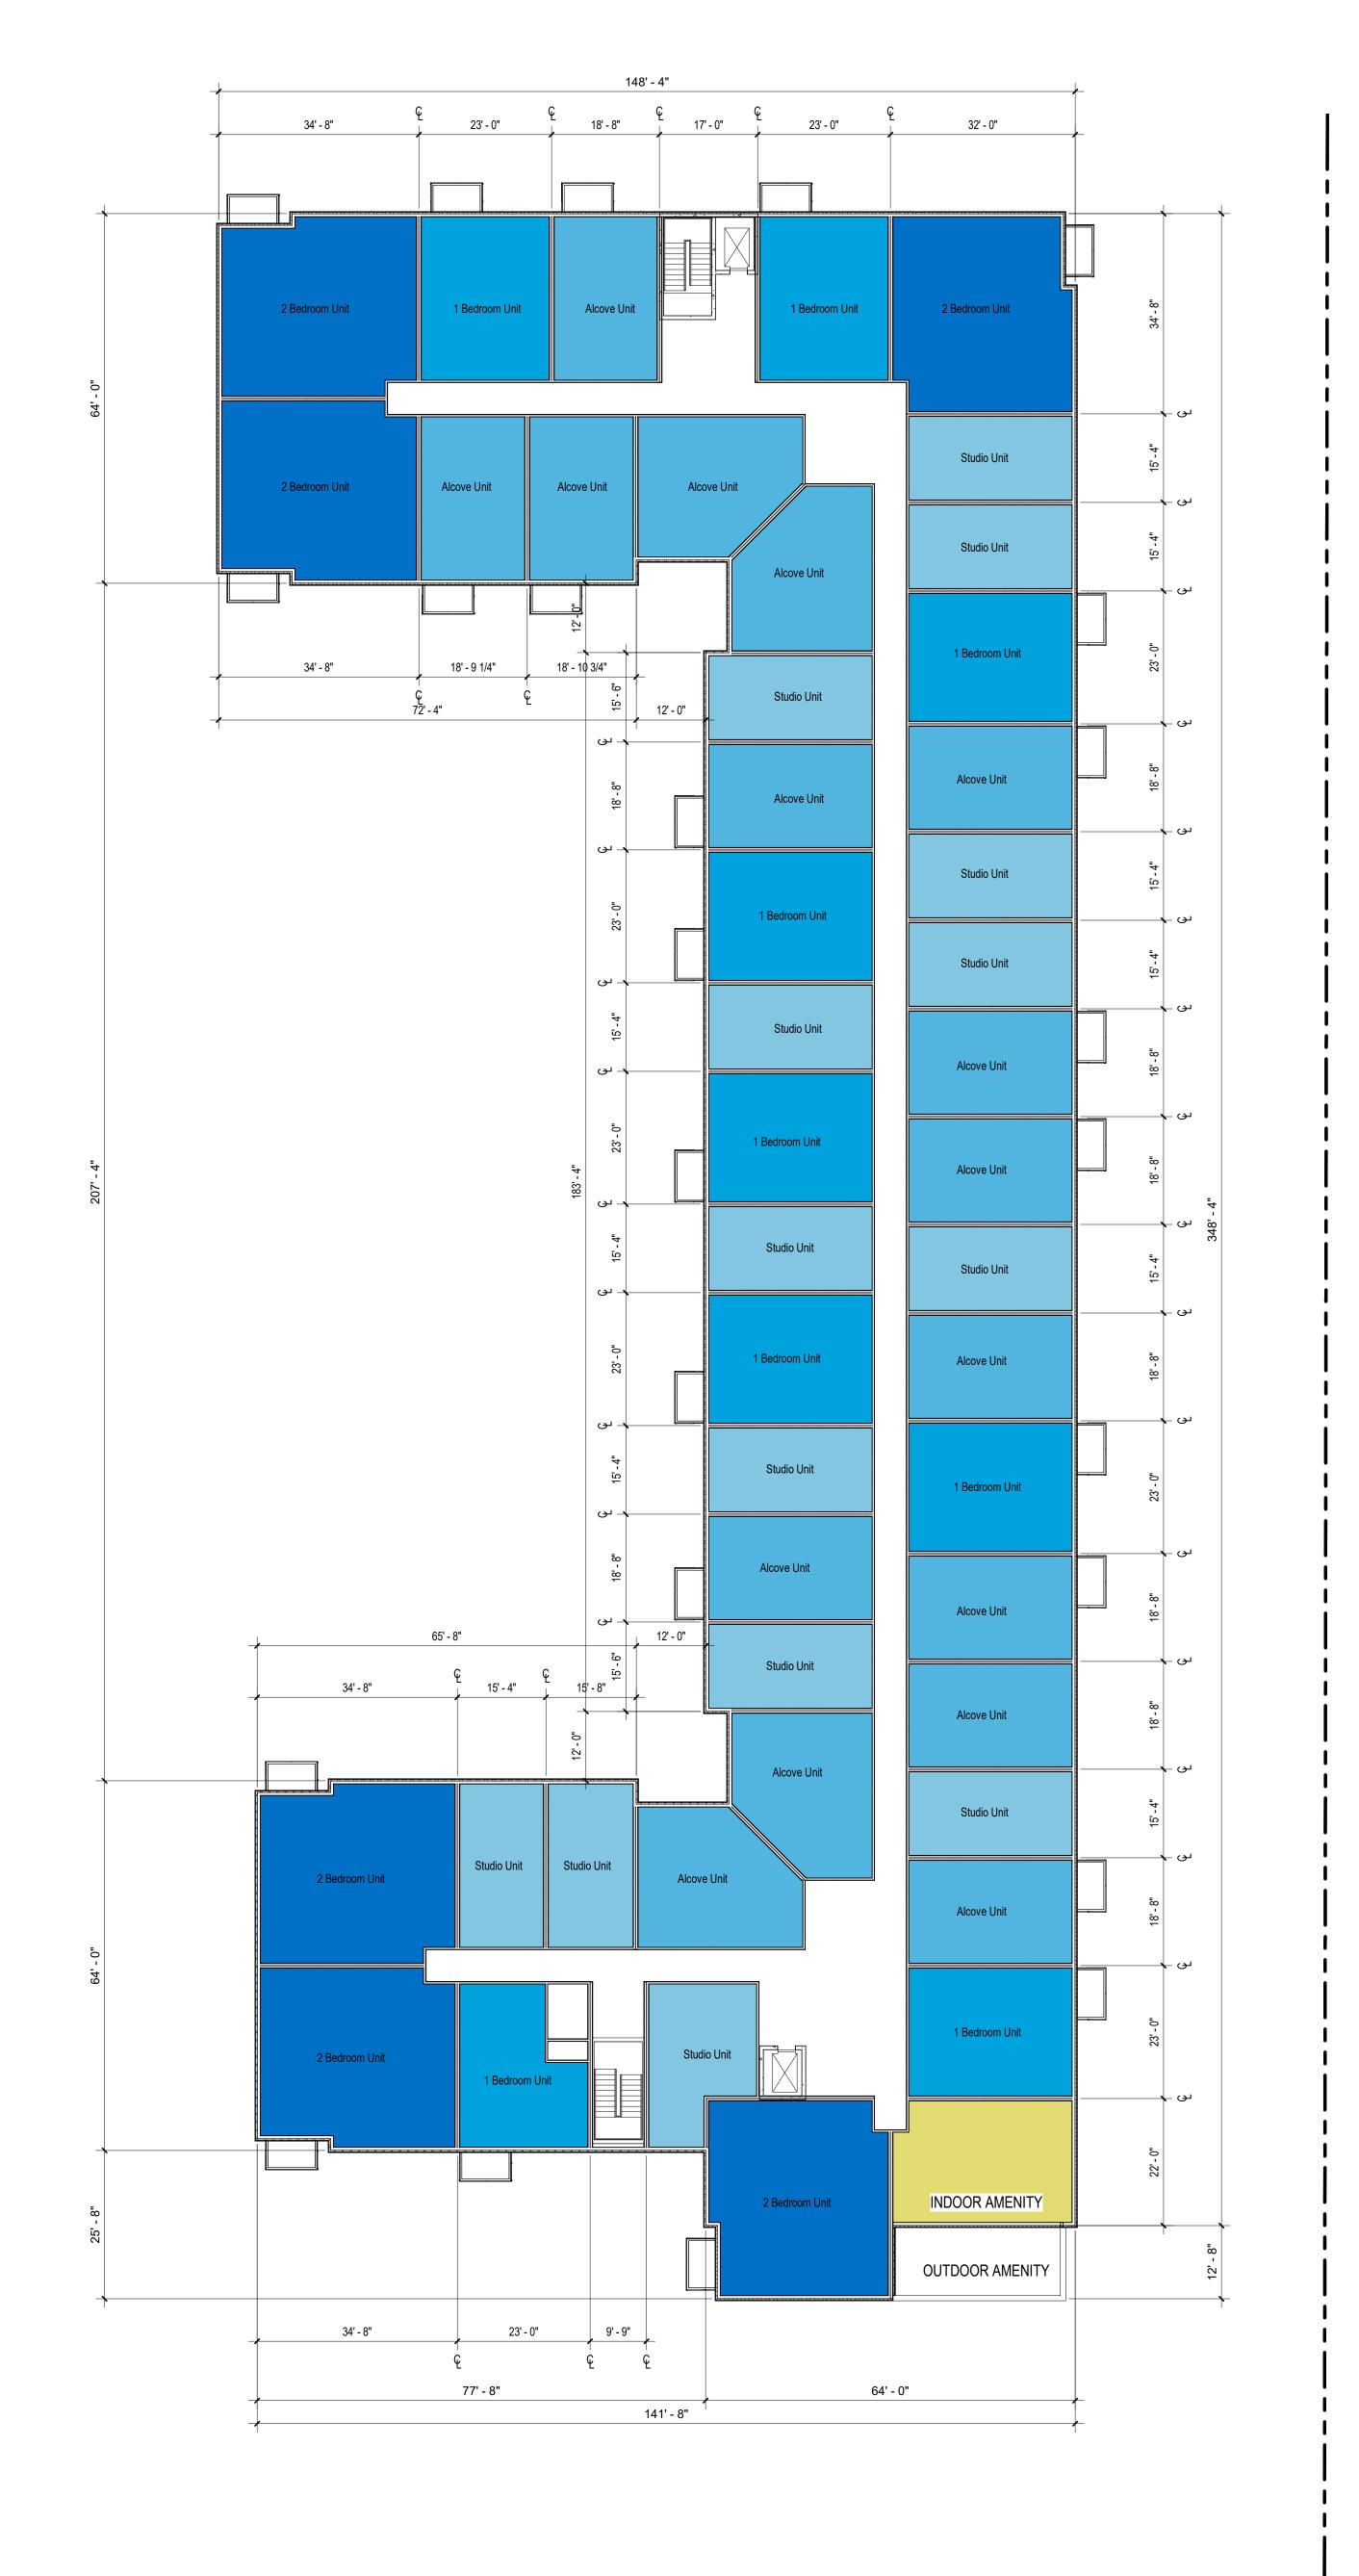No. Date Description

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 06/02/2021

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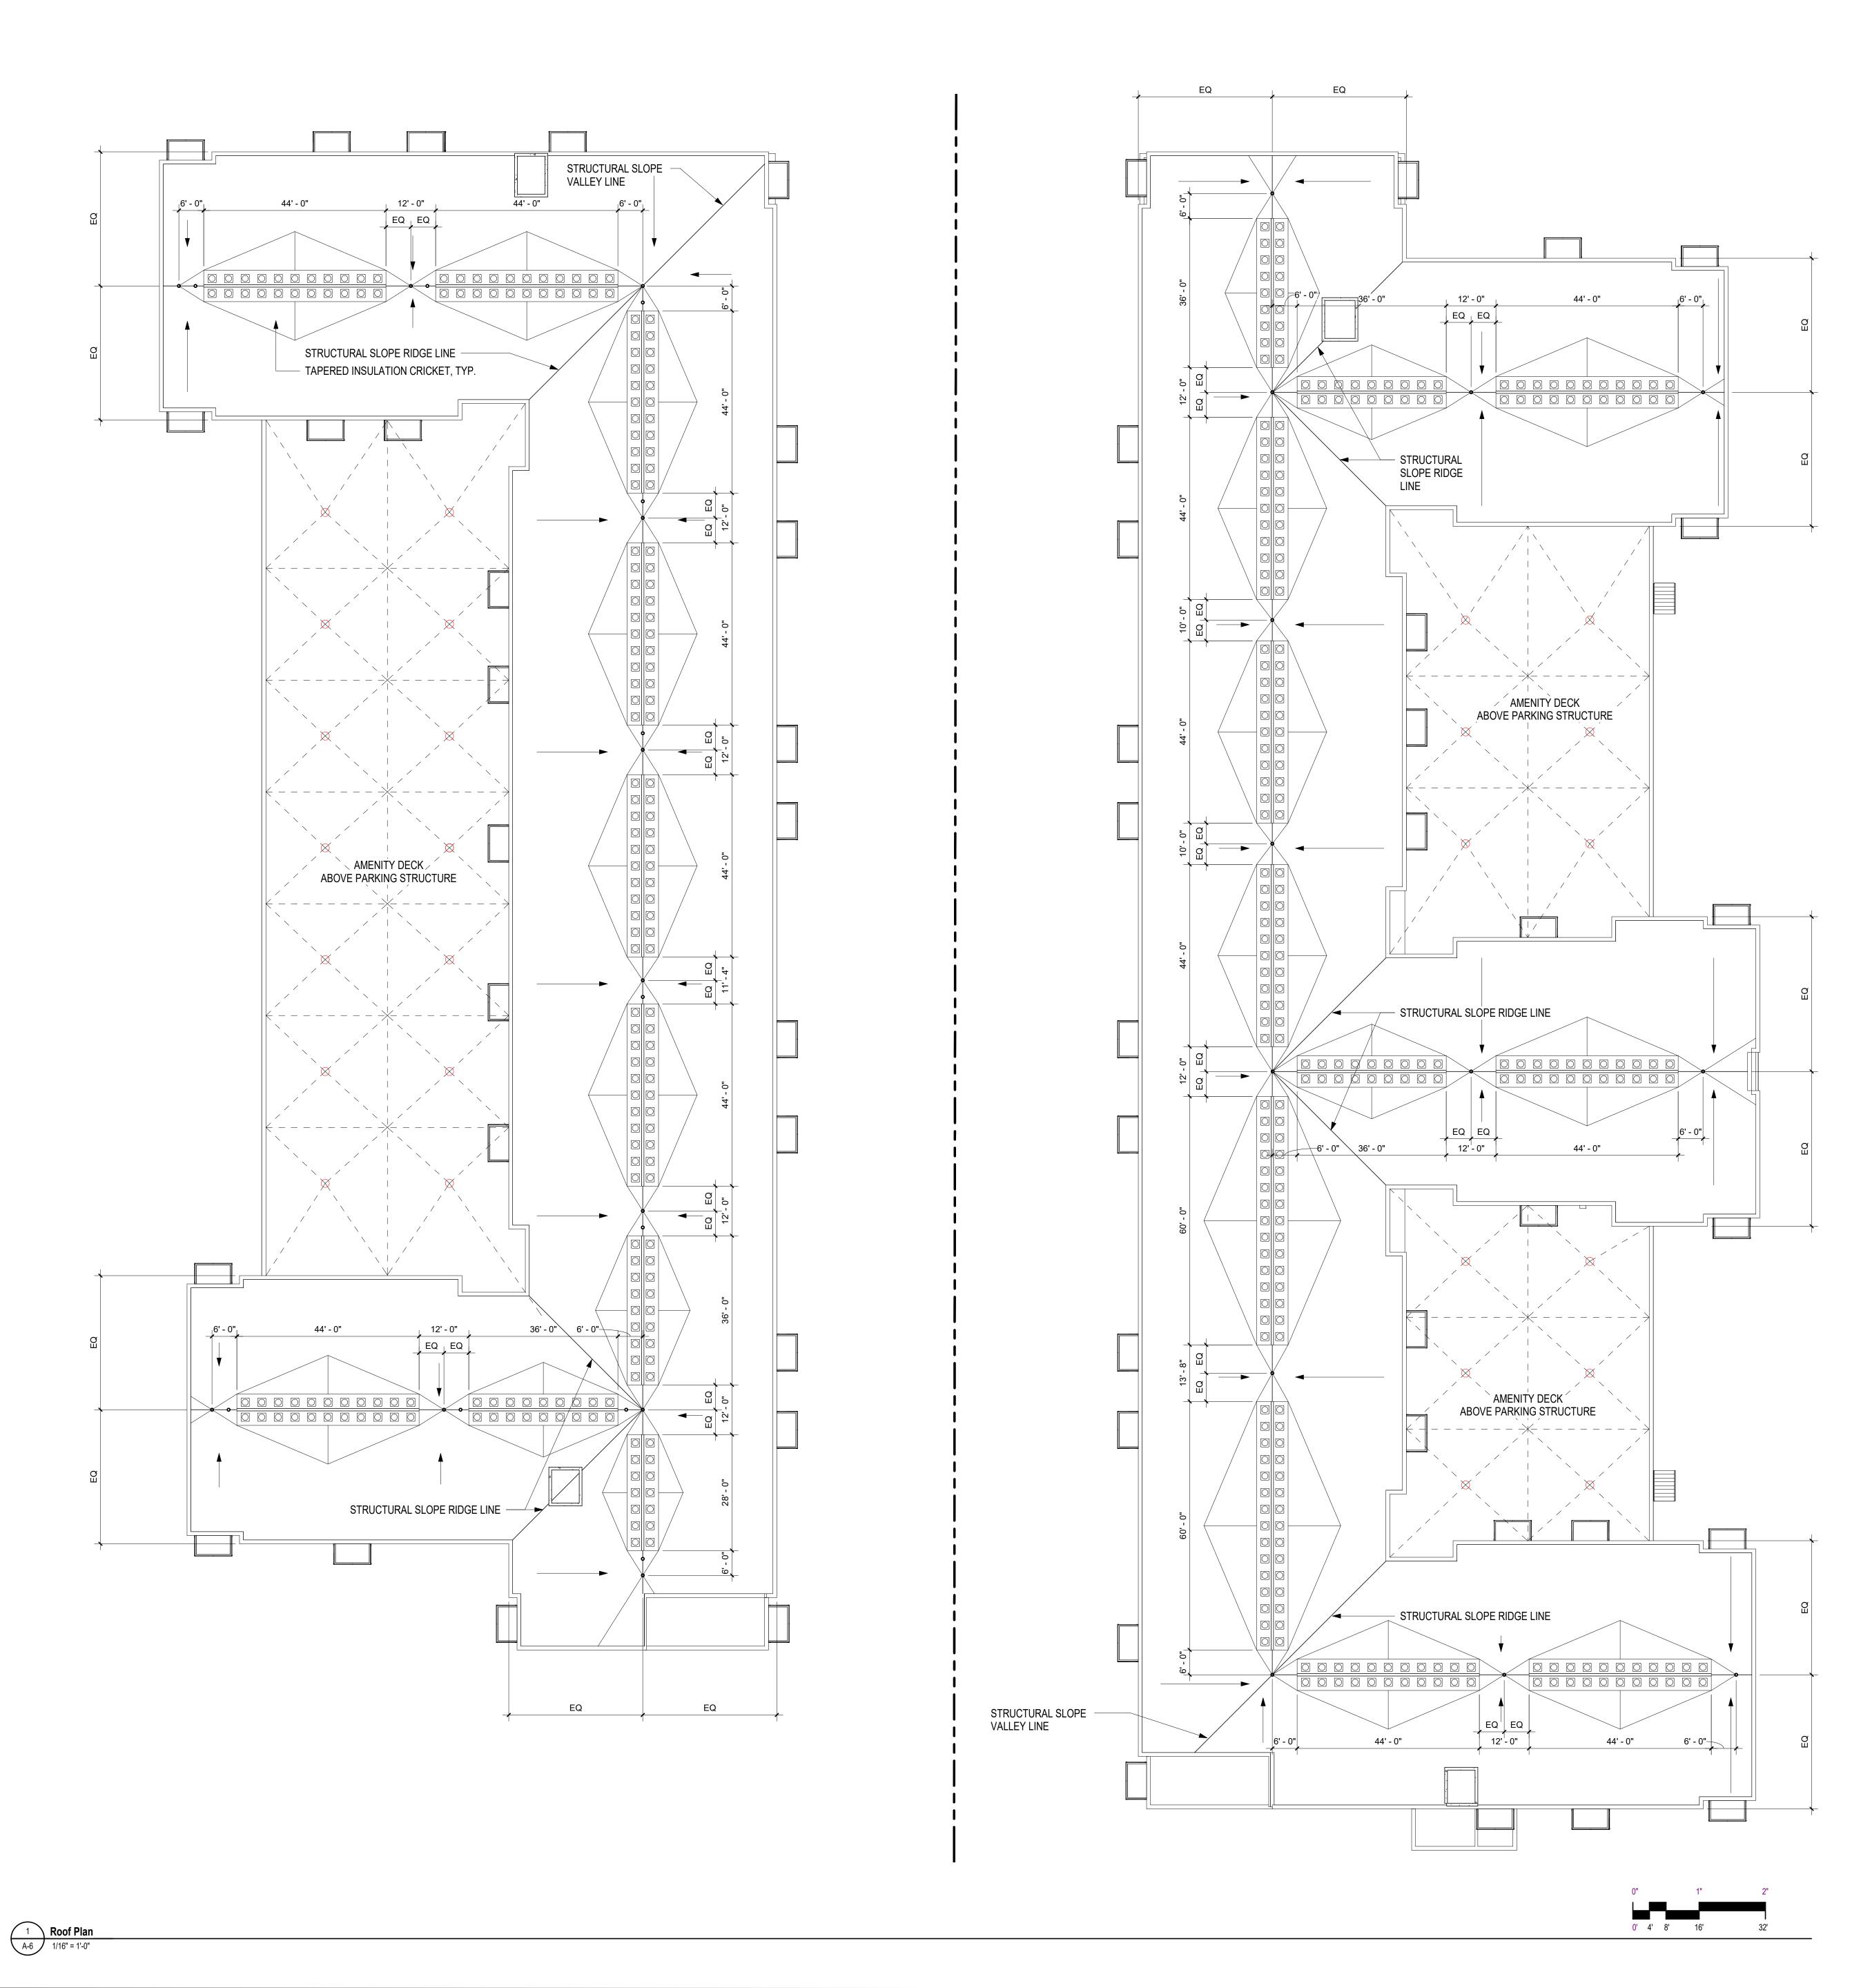
Sheet Title
Roof Plan

Sheet Number

Current Rev

A-6


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ROOF NARRATIVE

- HIGH ROOF TO BE TPO ROOFING AND AMENITY DECK TO BE LIQUID MEMBRANE ROOFING BELOW LANDSCAPE.
- 2. MECHANICAL ROOF CONDENSING UNITS WITH DRAIN LAY-OUT TO BE REVISED PER DESIGN DEVELOPMENT.
- 3. STRUCTURAL ROOF SLOPE AND DRAIN LOCATION SHOWN ARE CONCEPTUAL.
- 4. ROOF TOP MECHANICAL EQUIPMENT SCREENED PER CODE REQUIREMENTS.

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LEVEL 2

T.O. PARAPET
T.O. STRUCT. LEVEL 5 LEVEL 4 LEVEL 1

LEVEL 5 \_ \_ \_ LEVEL 3

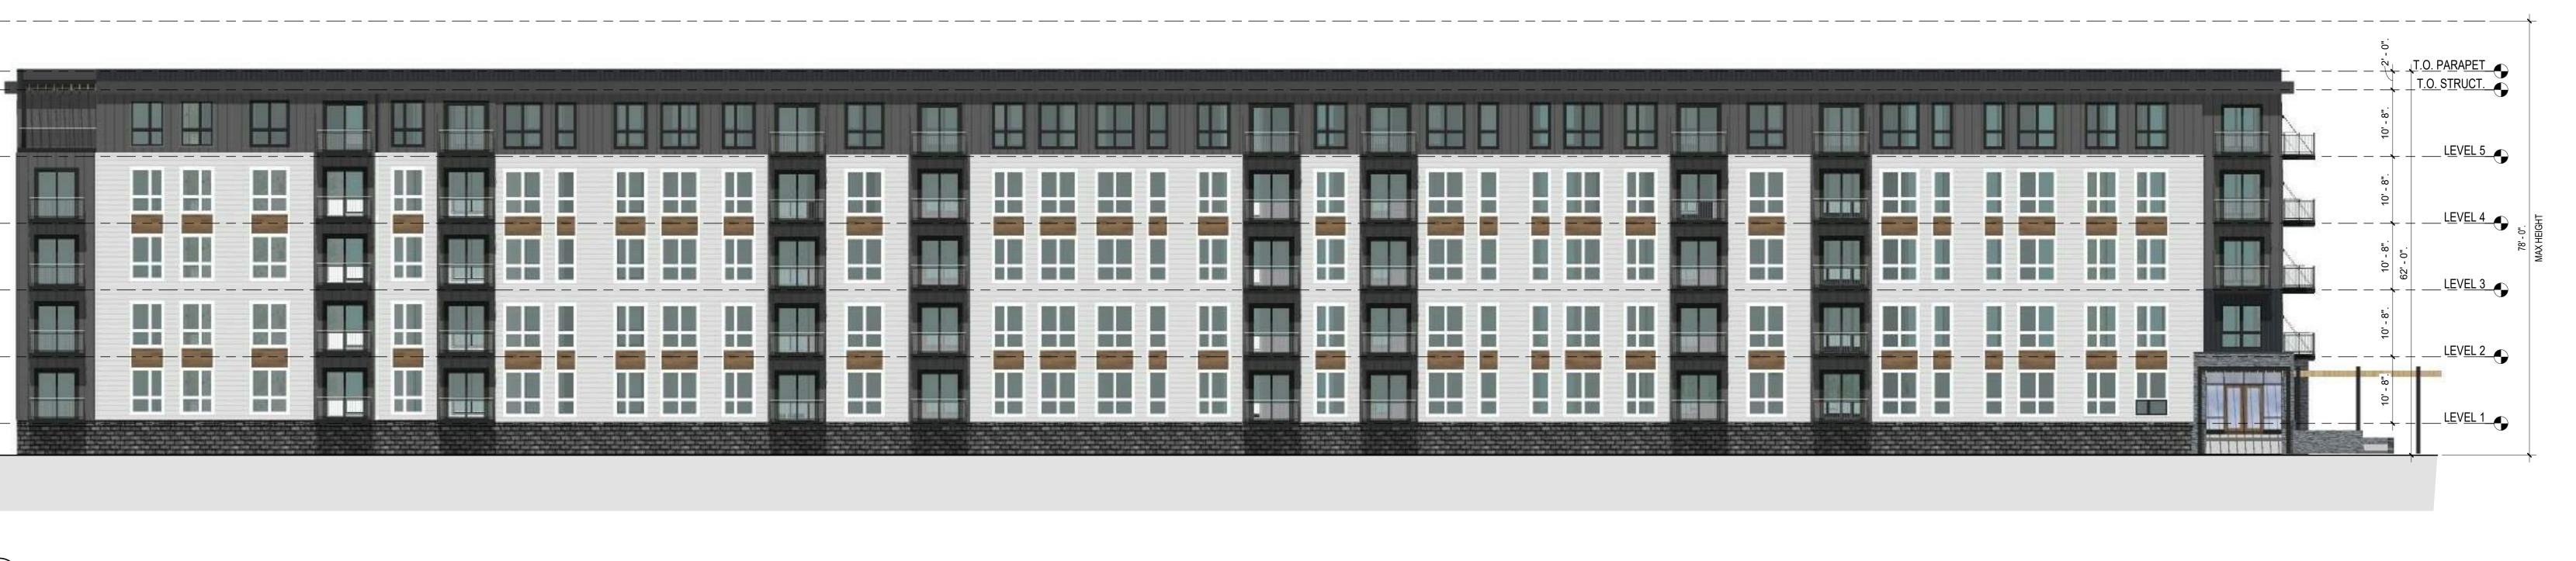West Building - North Elevation

A-7 1/16" = 1'-0"

West Building - West Elevation

1/16" = 1'-0"

West Building - South Elevation

1/16" = 1'-0"




**PRELIMINARY** 

Description

LUA /UDC Date: 20-0084 PIC / AIC:

Multifamily at 575 Zor Shrine Place

Building Elevations - West Building

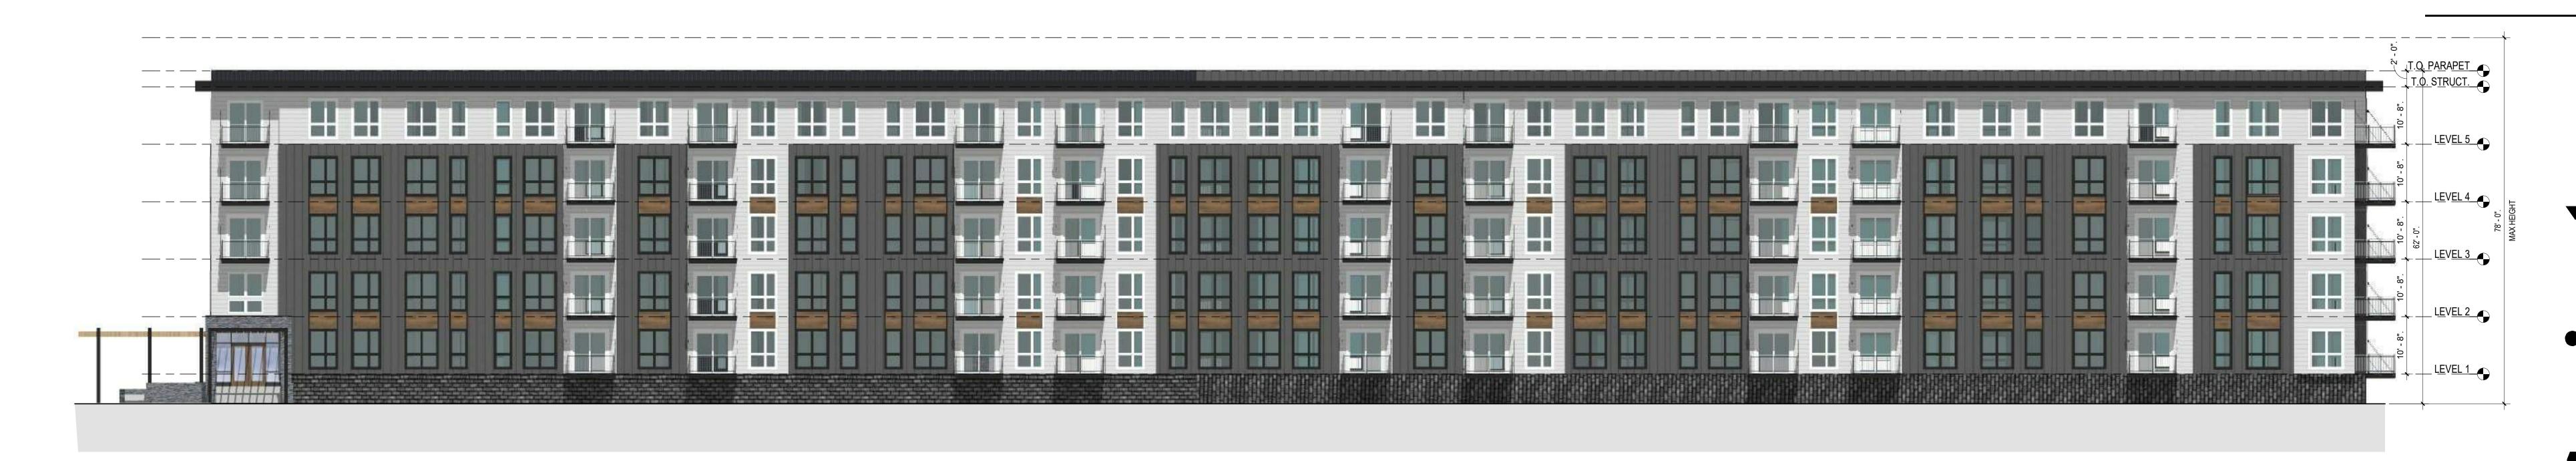

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East Building - East Elevation
1/16" = 1'-0"



3 East Building - North Elevation
1/16" = 1'-0"



East Building - South Elevation
1/16" = 1'-0"

PRELIMINARY NOT FOR CONSTRUCTION

Revisions

No. Date Descriptio

Project Information

Phase: LUA /UDC Date: 06/02/202

Project No.: 20-0084 PIC / AIC: JSchoene

Multifamily at 575 Zor
Shrine Place

Building Elevations - East Building

Sheet Number

Multifamily at 575 Zor Shrine Place

Enlarged Building Elevation

**A-9** 

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**EXTERIOR MATERIALS KEYNOTES** 

1. SPLIT FACE CMU, DARK, COLORED MORTAR ALUMINUM BALCONY AND RAILING, 9' x 5' (260 TOTAL) 5/4" FIBER CEMENT TRIM BOARD (EDGES, WINDOWS/DOORS)

4. VINYL WINDOWS SINGLE HUNG. 1' SILL HEIGHT, 8' HEAD HEIGHT FIBER CEMENT LAP SIDING


ARCHITECTURAL BAND: FIBER CEMENT FINISH FIBER CEMENT BOARD AND BATTEN

8. STONE OR FACE BRICK 9. "WOODTONE" LAP SIDING 10. ALUMINUM STOREFRONT SYSTEM

11. SLIDING PATIO DOOR - 8' H x 6'-4" W (OR OTHER ADA COMPLIANT WIDTH)



FIBER CEMENT BOARD AND BATTEN SIDING

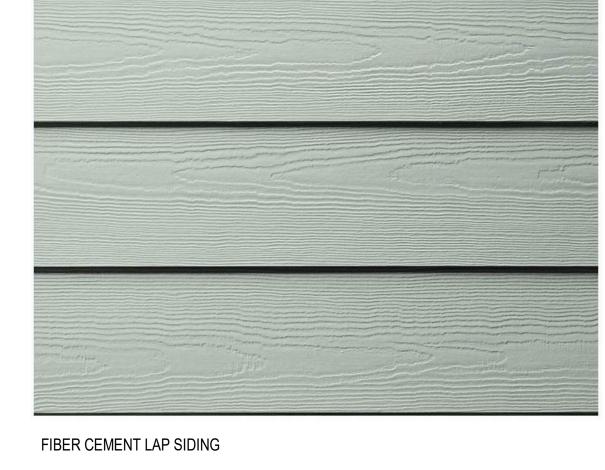




ROCK FACE CEMENT MASONRY BASE



FIBER CEMENT CEDAR-LOOK PLANK SIDING



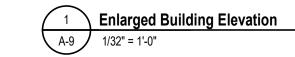








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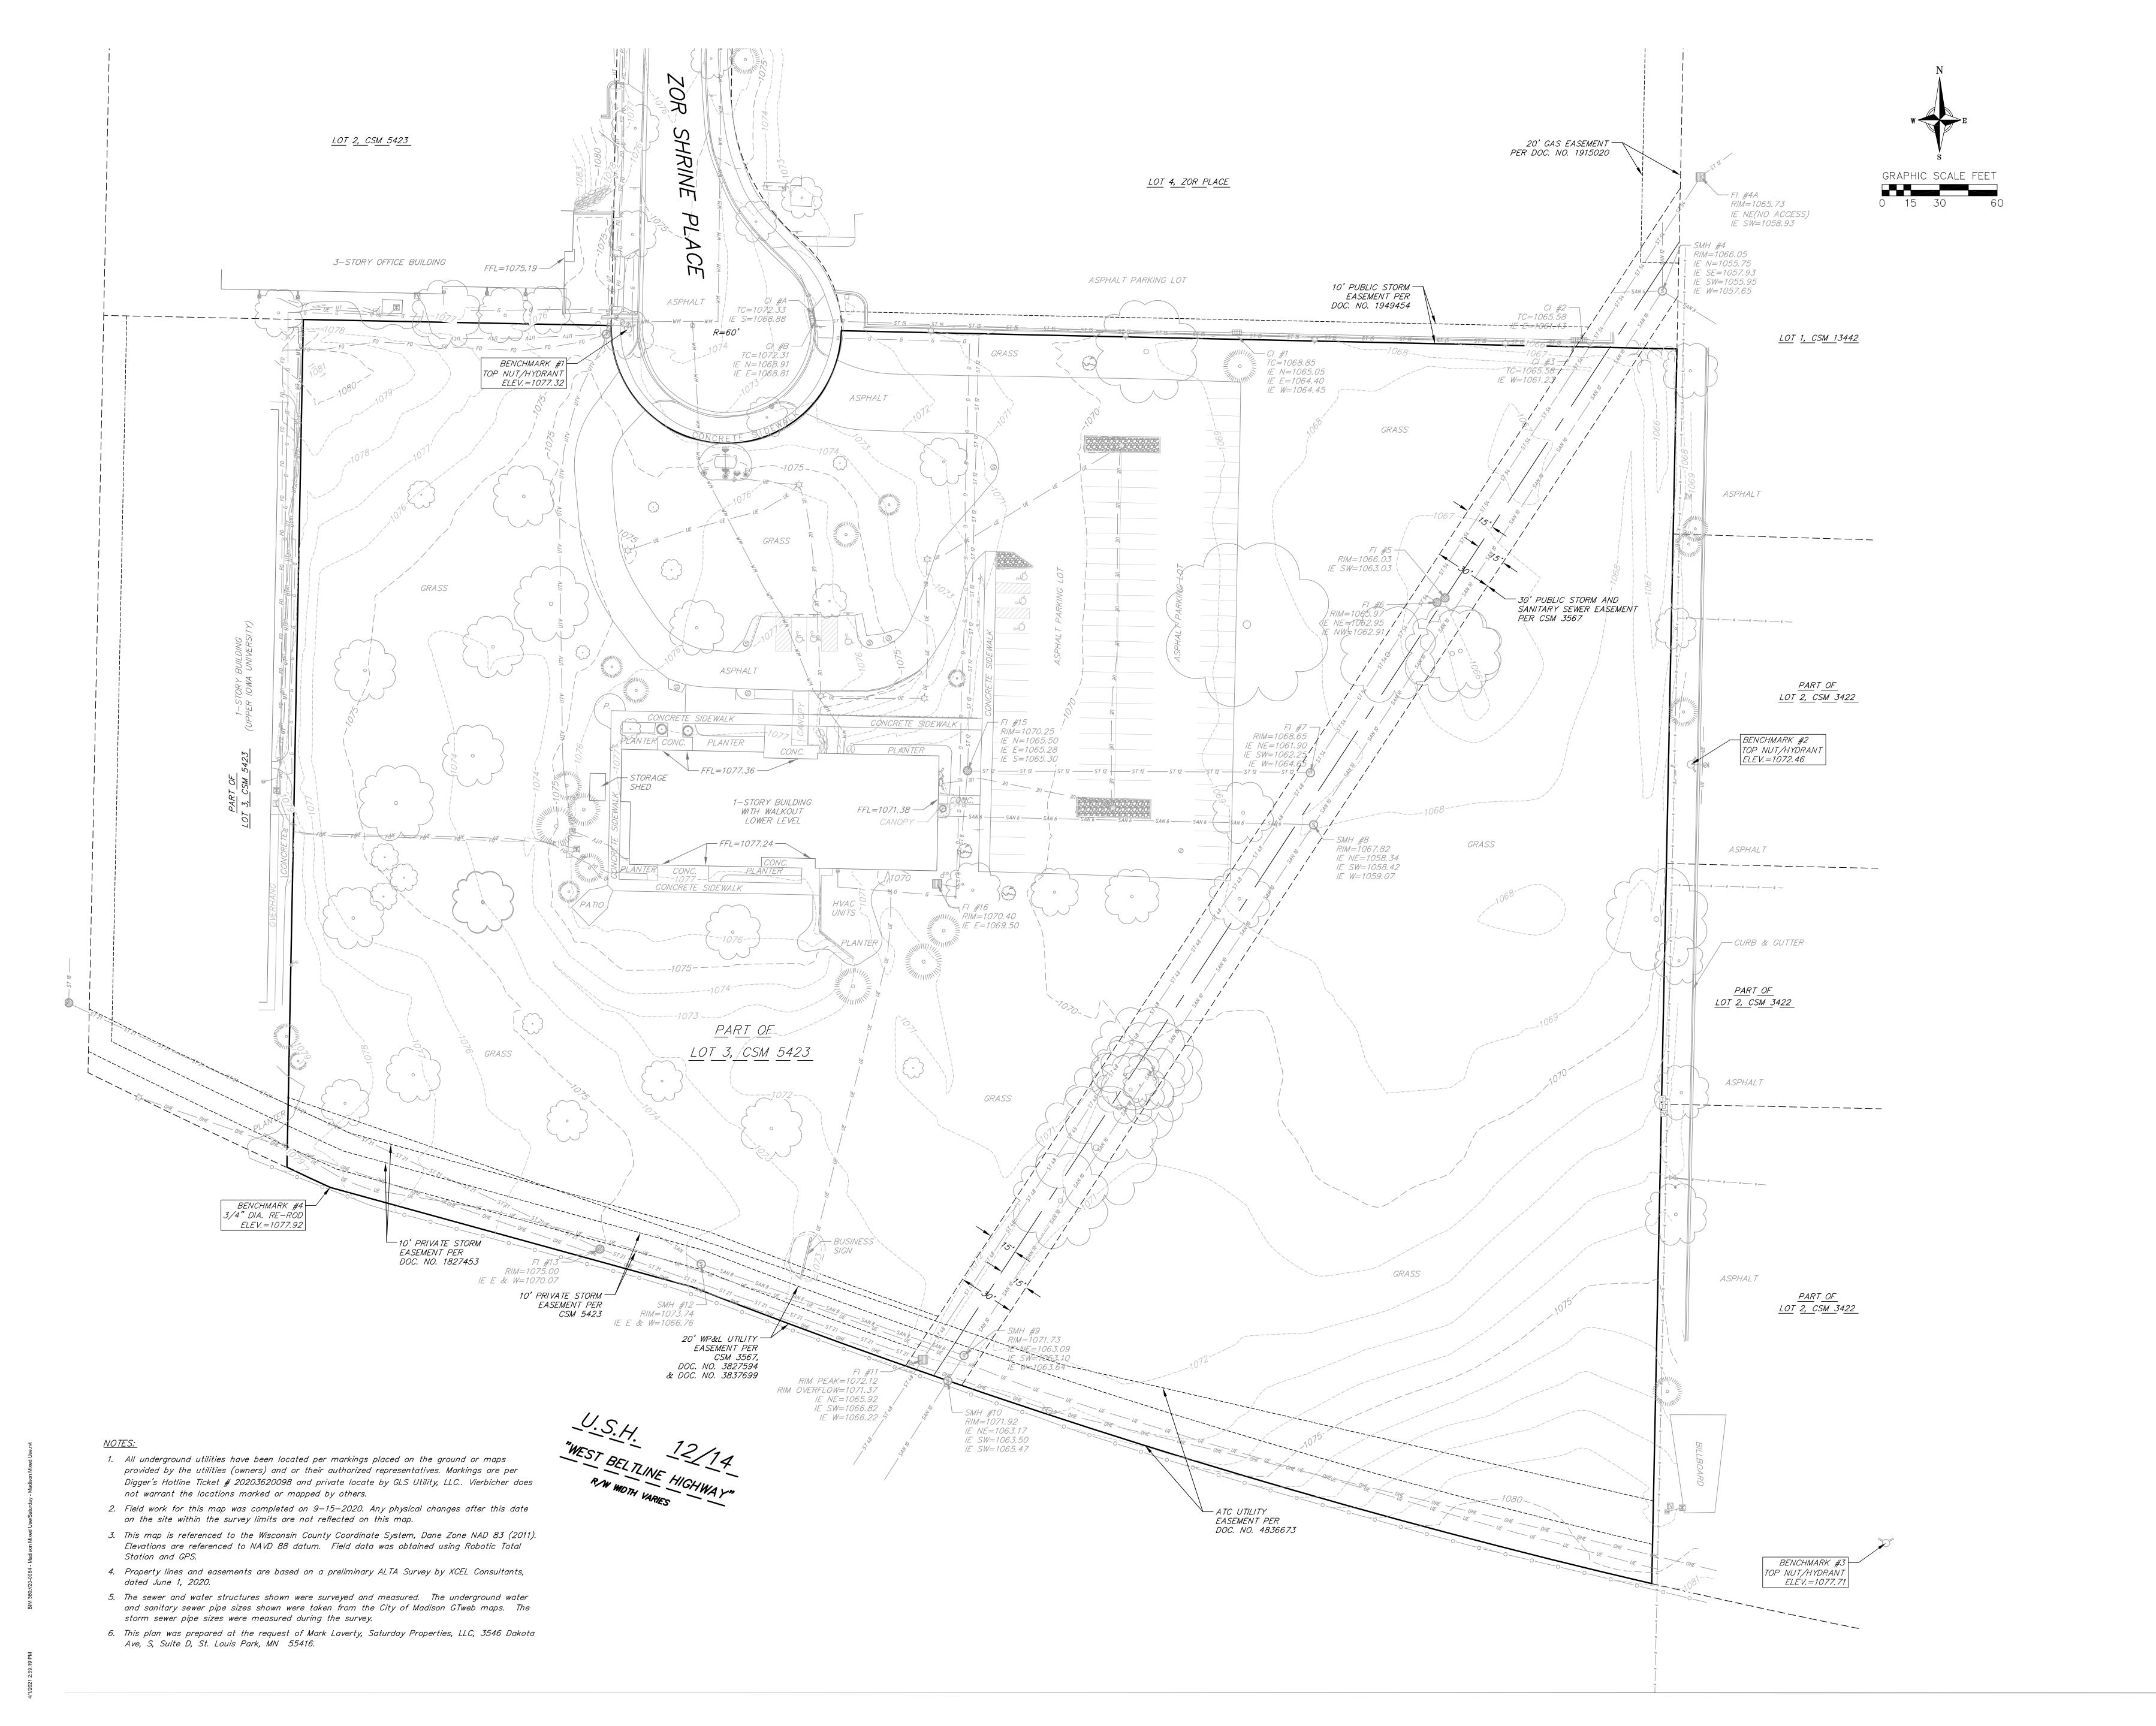
No. Date Description

LUA /UDC Date: 20-0084 | PIC / AIC: JSchoeneck

Multifamily at 575 Zor Shrine Place

Site Demo



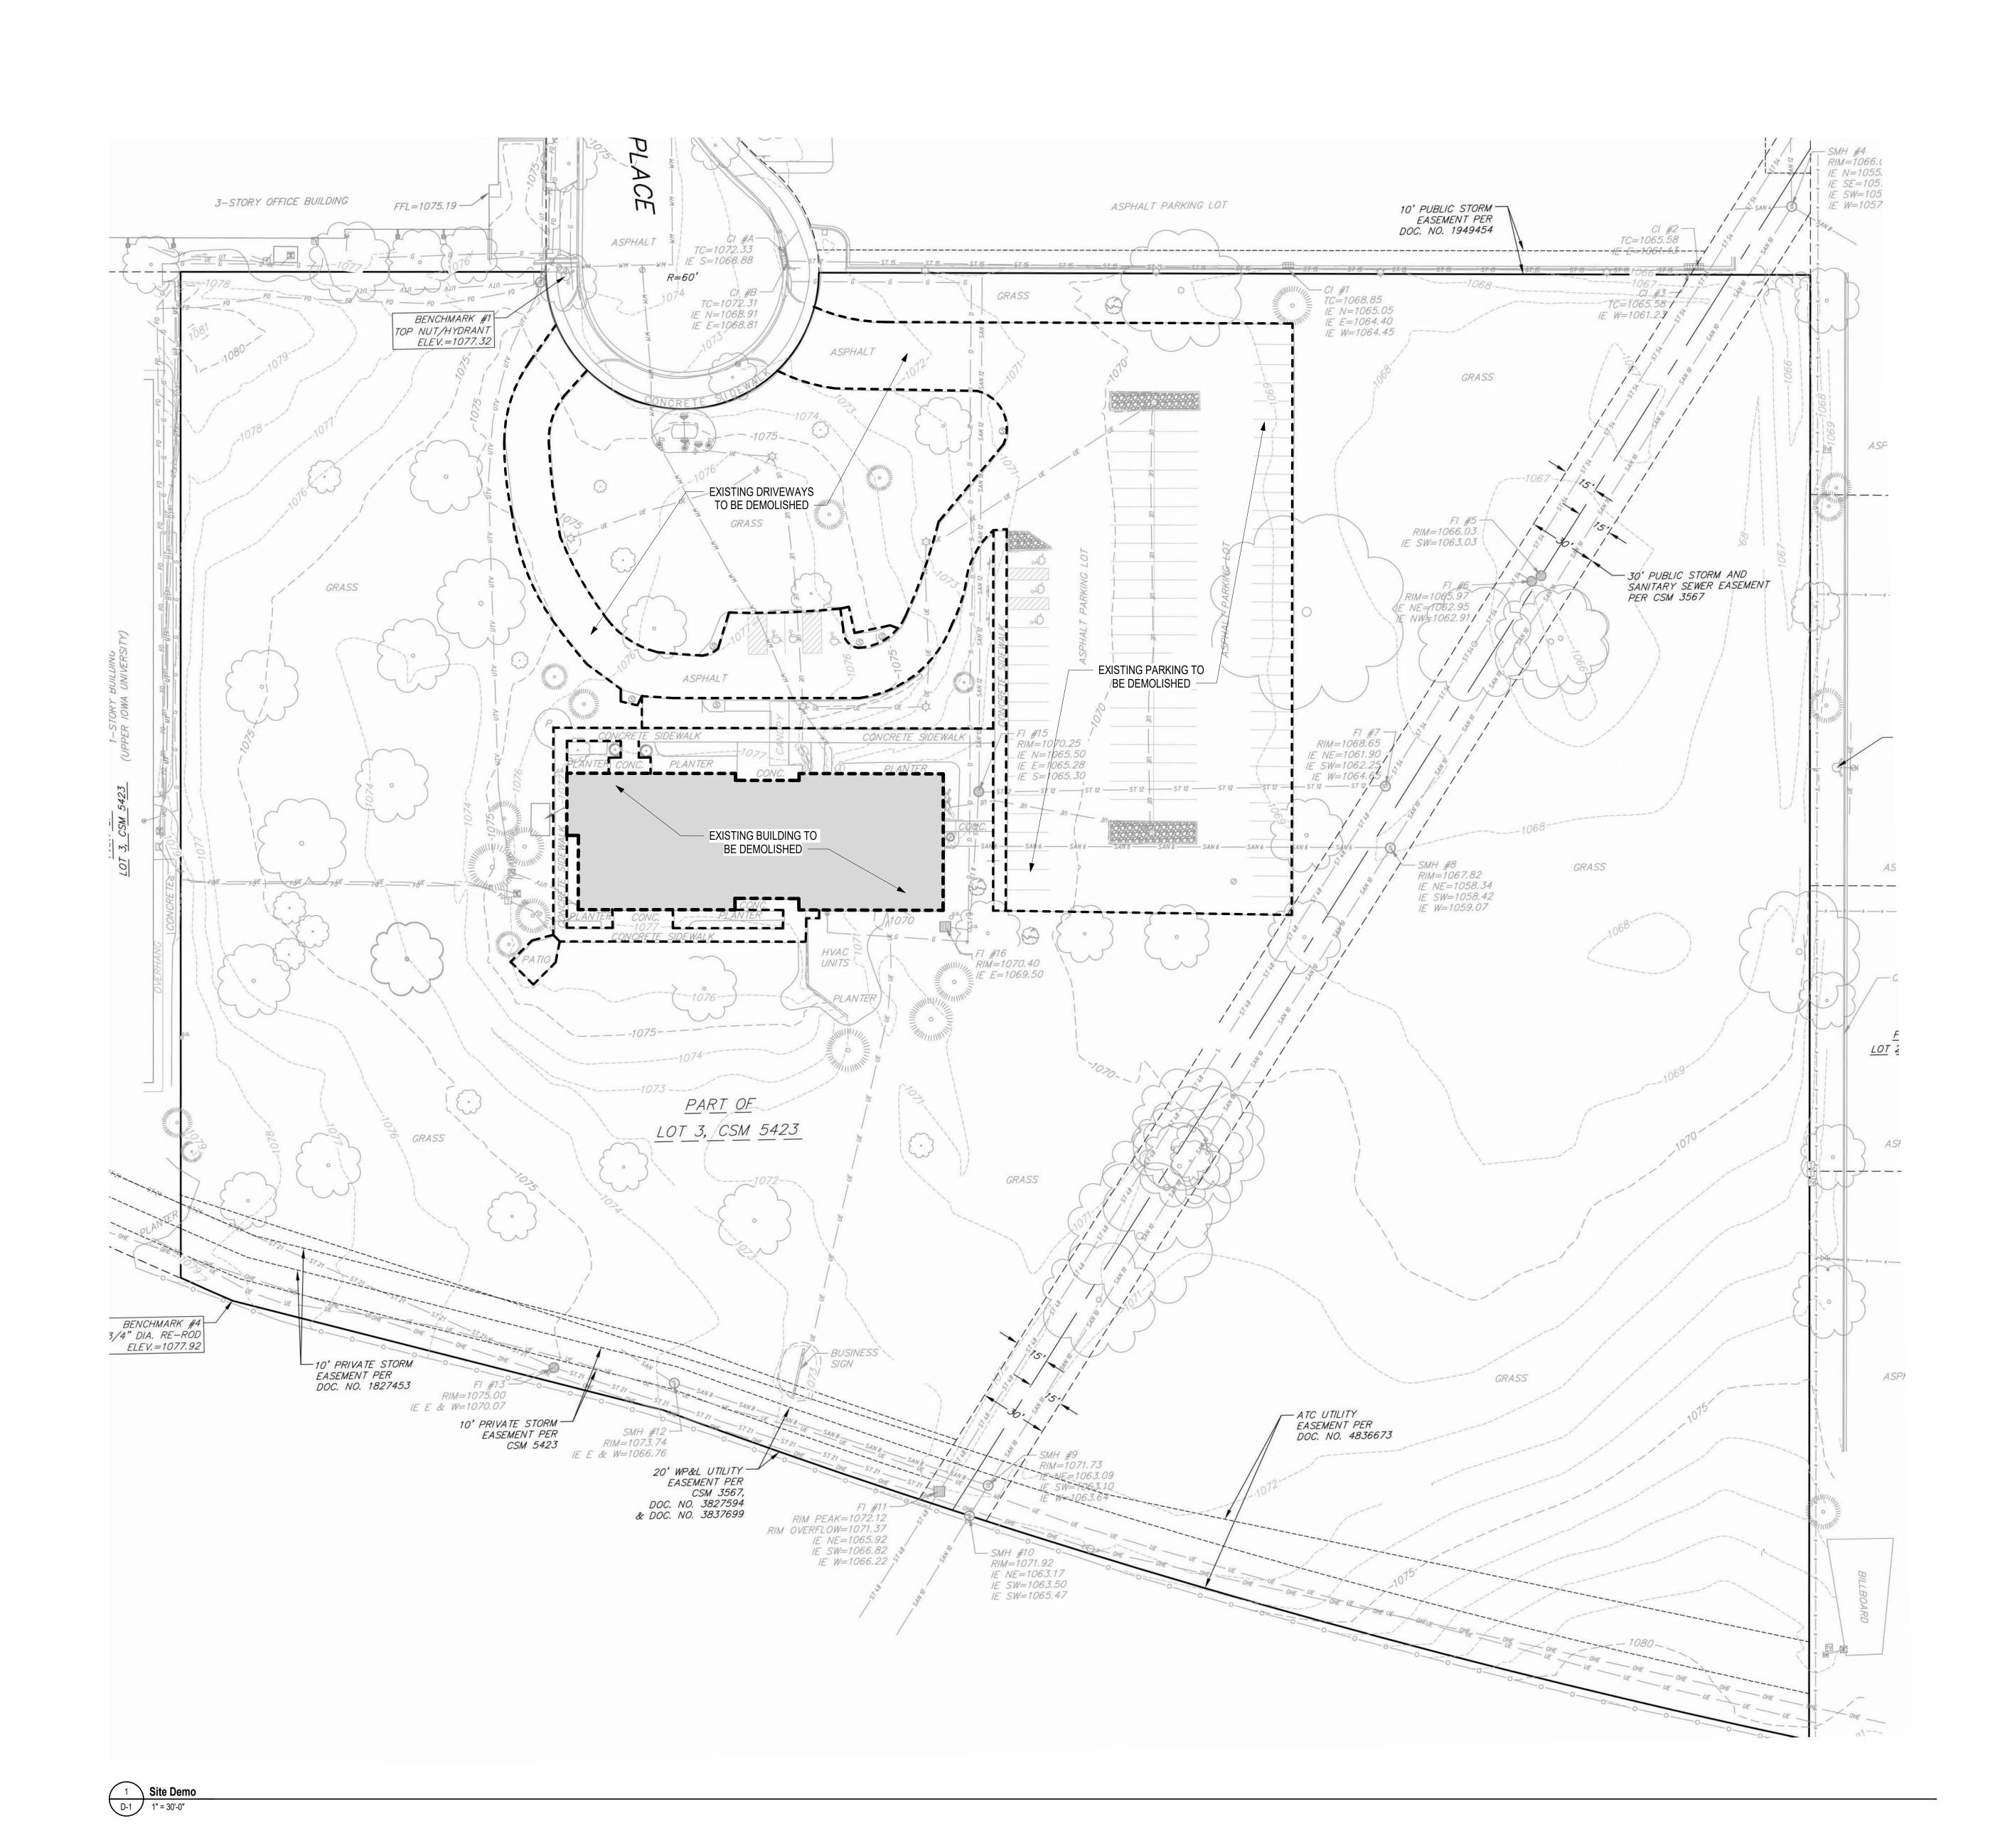

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cuningham.com

Vierbicher
planners | engineers | advisors

Phone: (800) 261-3898

PRELIMINARY NOT FOR CONSTRUCTION

Date Description

Project Information

Phase: CITY SUBMITTAL Date: 5-5-2021

Project No.: 200147 PIC / AIC:

EXISTING CONDITIONS
PLAN

Sheet Number

00

**Current Revision** 

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planners engineers advisors

Phone: (800) 261-3898

**PRELIMINARY** NOT FOR CONSTRUCTION

Phase: CITY SUBMITTAL Date: 5-5-2021 Project No.: **200147** 

Sheet Title
DEMOLITION PLAN

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**Current Revision** C200

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planners engineers advisors Phone: (800) 261-3898


> **PRELIMINARY** NOT FOR CONSTRUCTION


Phase: CITY SUBMITTAL Date: 5-5-2021

SITE PLAN

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Project No.: **200147** 



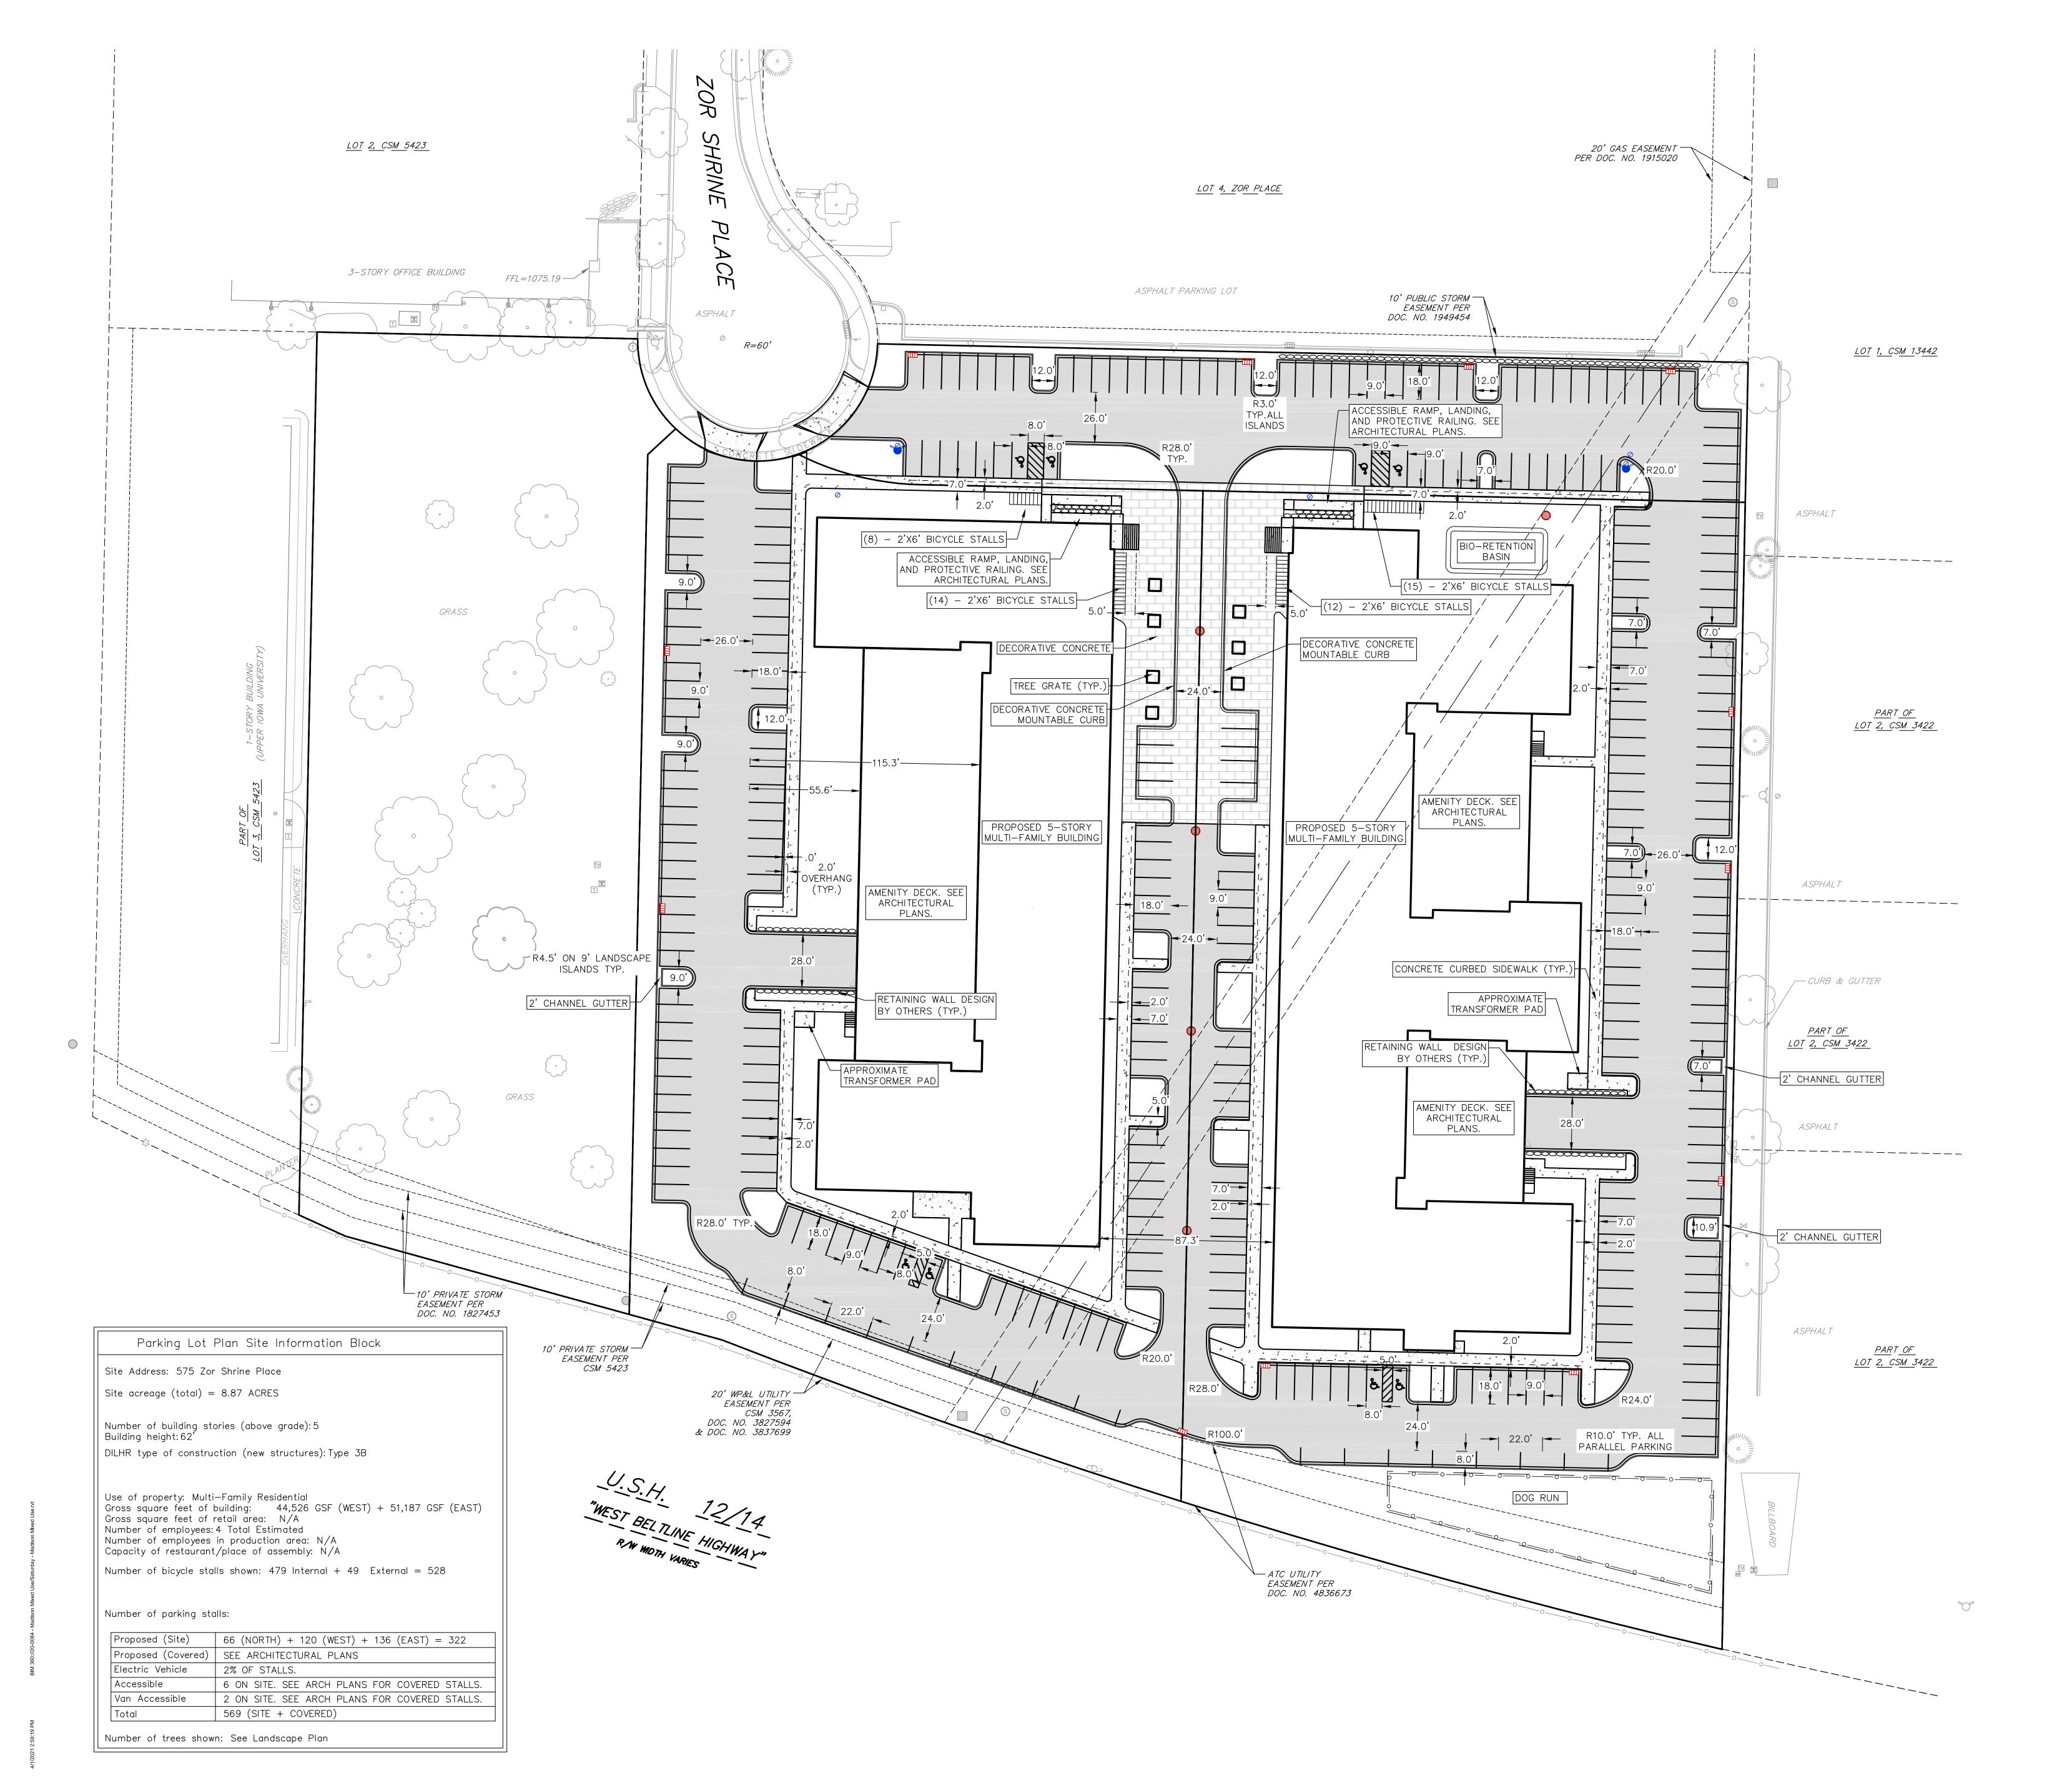

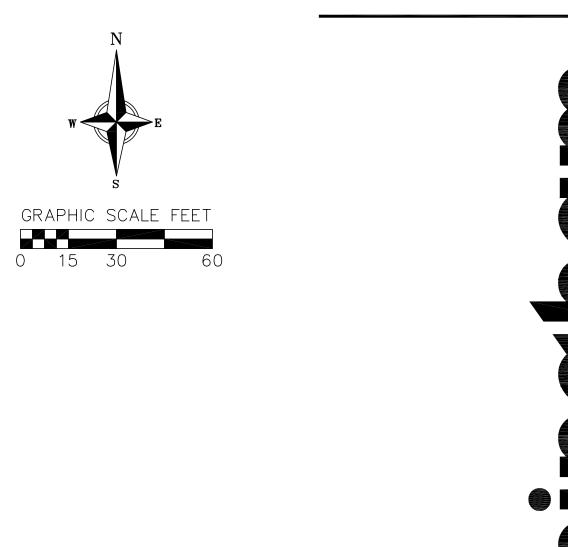

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Revisions

No. Date Description

 Phase: CITY SUBMITTAL
 Date: 5-5-2021

 Project No.: 200147
 PIC / AIC:

Sheet Title
GRADING PLAN

Sheet Number Curr

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LOT 4, ZOR PLACE 3—STORY OFFICE BUILDING FFL=1075.19 — ASPHALT PARKING LOT *ASPHALT* 1066.22 <u>LOT 1, CSM 13442</u> *ASPHALT* / 1076.21 BS-<u>PART\_OF</u> LOT 2, CSM 3422 FF=1081.0 LL=1069.0 FF=1081.0 LL=1069.0 **ASPHALT** · -||-----1070 1069.00 LL \_\_\_CURB & GUTTER <u>PART\_OF</u> LOT 2, CSM 3422 1069.00 LL-**ASPHALT** 1076.50\_ MID\_LEVEL \ 1076.50
/ MID LEVEL
1076.50
/ MID LEVEL 1076.50\_ MID LEVEL *ASPHALT* <u> PART\_OF</u> LOT 2, CSM 3422 "WEST BELTLINE HIGHWAY" 0

<u>LOT 2, CSM 5423</u>



PRELIMINARY NOT FOR CONSTRUCTION

Revisions


No. Date Description

Phase: CITY SUBMITTAL Date: 5-5-2021
Project No.: 200147 PIC / AIC:

Sheet Title
UTILITY PLAN

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Sheet Number Current Rev

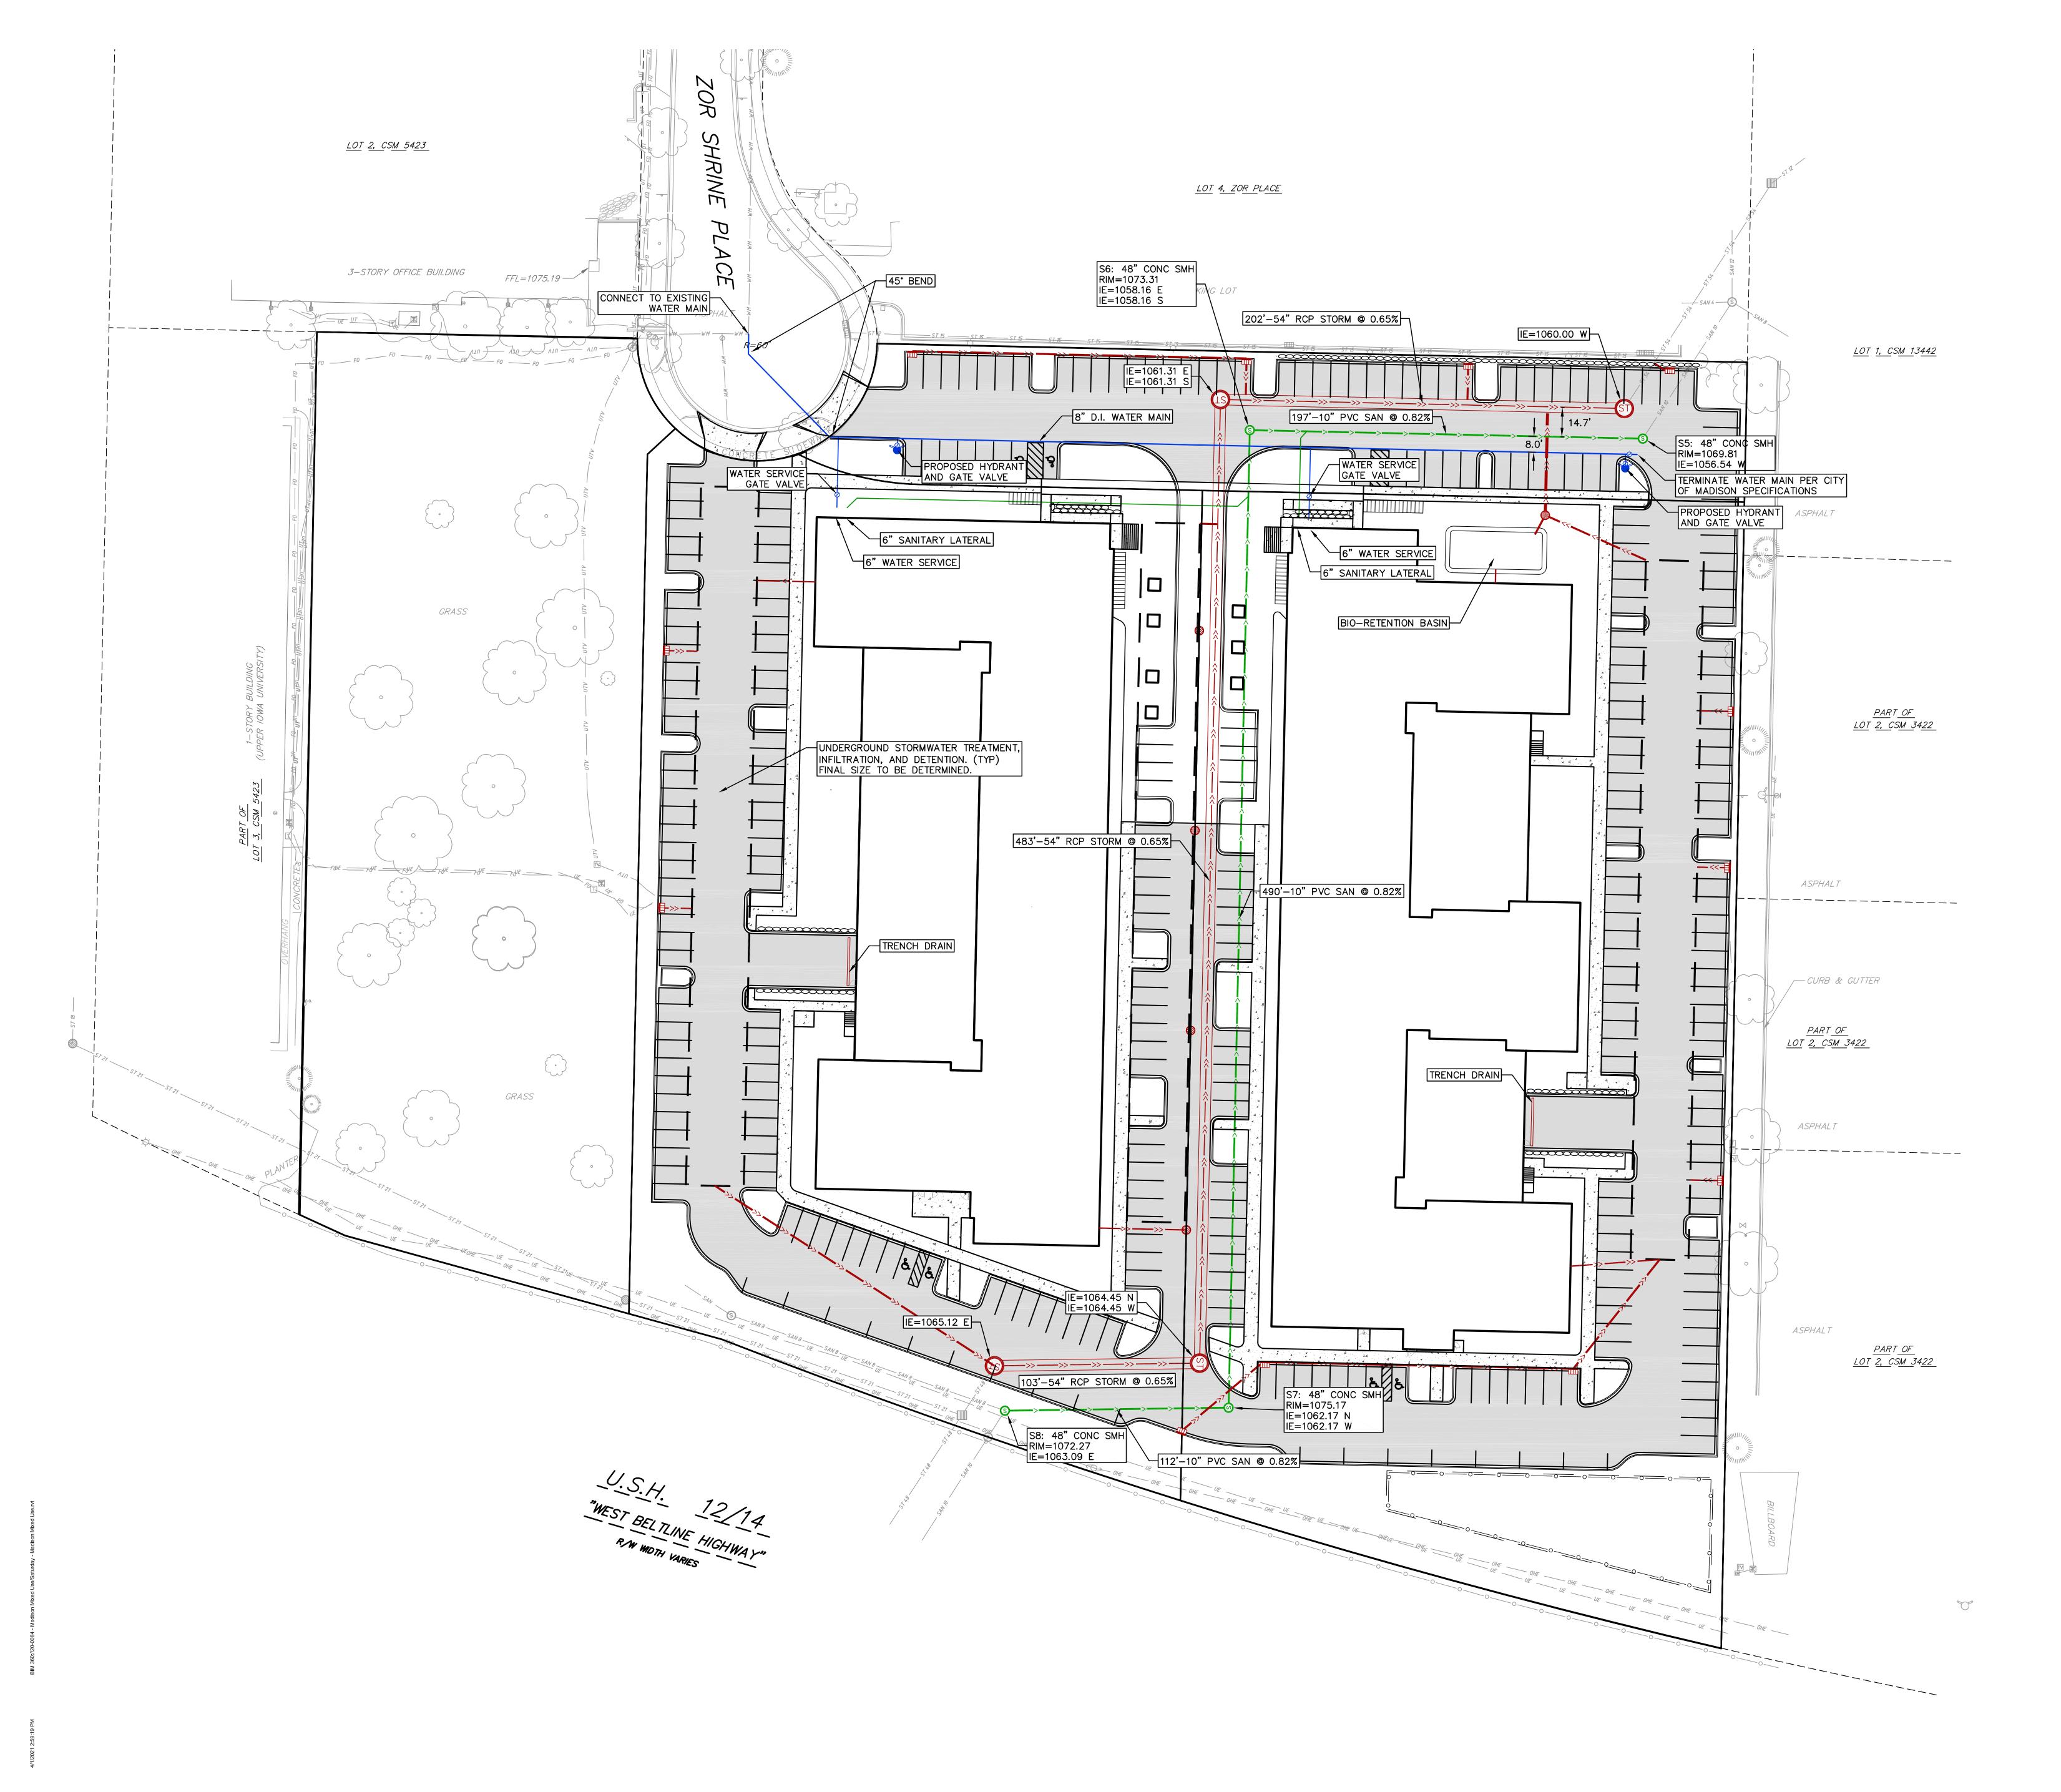

EXISTING NORWAY MAPLE — თ—,∜ HKM WSB BAR-ULM-

1 Overall Planting Plan

Type Mark	Common Name	Botanical Name	Quantity	Installed Size	Mature Height	Mature Width	Points Per Plant
71	I						
Coniferous S	Shrub						
TMT	Taunton Yew	Taxus x media 'Tauntonii'	66	#2 CONT	4' - 0"	6' - 0"	4
Deciduous S	Shrub		,	•			
AM	Autumn Magic Black Chokeberry	Aronia melanocarpa 'Autumn Magic'	73	#2 CONT	3' - 0"	3' - 0"	3
CRM	Muskingum Dogwood	Cornus racemosa 'Muszam'	83	#2CONT	0"	0"	3
CSC	Cardinal Dogwood	Cornus sericea 'Cardinal'	16	#2CONT	8' - 0"	8' - 0"	3
AFD	Arctic Fire Dogwood	Cornus stolonifera 'Farrow	98	#2 CONT	3' - 0"	3' - 0"	3
IVA	Afterglow Winterberry	Ilex verticillata 'Afterglow'	58	#5 CONT	6' - 0"	5' - 0"	3
SS	Sem Ash Leaf Spirea	Sorbaria sorbifolia 'Sem'	459	#2 CONT	3' - 0"	3' - 0"	3
VBC	Bailey Compact American Cranberrybush	Viburnum trilobum 'Bailey Compact'	4	#2 CONT	6' - 0"	5' - 0"	3
Deciduous T	ree					1	
RM	Red Maple	Acer rubrum	6	2.5" B&B	50' - 0"	40' - 0"	35
BTN	River Birch	Betula nigra	2	2.5" B&B	50' - 0"	40' - 0"	35
WSB	Whitespire Birch	Betula populifolia	24	2.5" B&B	40' - 0"	26' - 0"	35
СТО	Common Hackberry	Celtis occidentalis	17	2.5" B&B	70' - 0"	50' - 0"	35
POT	Quaking Aspen	Populus tremuloides	26	2.5" B&B	40' - 0"	20' - 0"	35
QBC	Swamp White Oak	Quercus bicolor	1	2.5" B&B	60' - 0"	60' - 0"	35
QMC	Bur Oak	Quercus macrocarpa	4	2.5" B&B	70' - 0"	60' - 0"	35
QRB	Northern Red Oak	Quercus rubra	8	2.5" B&B	70' - 0"	70' - 0"	35
ULM	Accolade Elm	Ulmus 'Morton'	26	2.5" B&B	60' - 0"	40' - 0"	35
Ornamental <sup>*</sup>	Tree						
AAB	Autumn Brilliance Serviceberry	Amelanchier x grandiflora 'Autumn Brilliance'	19	#20 CONT CLUMP	25' - 0"	18' - 0"	15
Perennial							
AN	Blackhawks Big Bluestem	Andropogon gerardii 'Blackhawks'	178	#1 CONT	5' - 0"	2' - 0"	2
ACD	Columbine	Aquilegia canadensis	76	#1 CONT	2' - 8"	2' - 0"	2
AST	Butterfly Milkweed	Asclepias tuberosa	69	#1 CONT	1' - 6"	1' - 6"	2
LIR	Lady in Red Fern	Athyrium filix-femina 'Lady in Red'	271	#1 CONT	3' - 0"	2' - 0"	2
ECP	Purple Coneflower	Echinacea purpurea	232	#1 CONT	1' - 6"	1' - 6"	2
HKM	Japanese Forest Grass	Hakonechloa macra	779	#1 CONT	2' - 0"	1' - 6"	2
BAR	Blue Arrows Rush	Juncus inflexus 'Blue Arrows'	571	#2CONT	5' - 0"	3' - 0"	2
LS	Kobold Blazingstar	Liatris spicata 'Kobold'	536	#1 CONT	1' - 0"	1' - 6"	2
MPR	Purple Rooster Beebalm	Monarda didyma 'Purple Rooster'	162	#1 CONT	2' - 8"	2' - 0"	2
PBF	Blue Fountain Switchgrass	Panicum virgatum 'Blue Fountain'	120	#2CONT	5' - 0"	3' - 0"	2
RF	Goldsturm Black Eyed Susan	Rudbeckia fulgida 'Goldsturm'	362	#1 CONT	2' - 0"	1' - 8"	2
SSP	Little Bluestem	Schizachyrium scoparium	249	#1 CONT	2' - 0"	2' - 0"	2
SH	Prairie Dropseed	Sporobolus heterolepis	93	#1 CONT	2' - 0"	2' - 0"	2

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### **Landscape Worksheet**

### LANDSCAPE POINTS (INCLUDES NORTH, WEST AND EAST PARCEL)

TOTAL SQUARE FOOTAGE OF DEVELOPED AREA: 308,395 SF FIRST FIVE ACRES (FIVE POINTS PER 300 SF): 3,360 POINTS REMAINDER OF DEVELOPED AREA: 90,595 SF TOTAL LANDSCAPE POINTS REQUIRED: 4,536 POINTS

First Editions Technito Arborvitae Thuja occidentalis 'Bailjohn'

Thuja occidentalis 'Holmstrup'

ORNAMENTAL TREE UPRIGHT EVERGREEN SHRUB DECIDUOUS SHRUB **EVERGREEN SHRUB** ORNAMENTAL GRASS/PERENNIAL #1 GAL. 2 3,679 7,358

### **TOTAL POINTS: 15,250 Landscape General Notes**

 LANDSCAPE CONTRACTOR SHALL INSPECT THE SITE AND BECOME FAMILIAR WITH EXISTING CONDITIONS RELATING TO THE NATURE AND SCOPE OF WORK. • LANDSCAPE CONTRACTOR SHALL VERIFY PLAN LAYOUT AND DIMENSIONS SHOWN AND BRING TO THE ATTENTION OF THE LANDSCAPE ARCHITECT DISCREPANCIES WHICH MAY COMPROMISE THE • LANDSCAPE CONTRACTOR SHALL REVIEW THE SITE FOR DEFICIENCIES IN THE PLANT MATERIAL SELECTIONS AND OTHER SITE CONDITIONS WHICH MIGHT NEGATIVELY AFFECT PLANT ESTABLISHMENT, SURVIVAL OR WARRANTY. UNDESIRABLE PLANT MATERIAL SELECTIONS OR SITE CONDITIONS SHALL BE BROUGHT TO THE ATTENTION OF THE LANDSCAPE ARCHITECT PRIOR TO

49 4' HT. BB 6' - 0"

INTERIOR PARKING LOT LANDSCAPING

PARKING LOT AREA: 119,008 SF

ISLANDS, PENINSULAS OR LANDSCAPED STRIPS.

PROPOSED: 11,091 SF (9.3% OF TOTAL PARKING AREA)

REQUIRED LANDSCAPE AREA: 9,521 SF (8% OF TOTAL PARKING AREA)

49 4' HT. BB 7' - 0" 3' - 0" 10

8% OF THE ASPHALT OR CONCRETE PARKING LOT SHALL BE DEVOTED TO INTERIOR PLANTING

- LANDSCAPE CONTRACTOR SHALL ASSURE COMPLIANCE WITH APPLICABLE CODES AND REGULATIONS GOVERNING THE WORK AND/OR MATERIALS SUPPLIED.
- LANDSCAPE CONTRACTOR SHALL PROTECT EXISTING ROADS, CURBS/GUTTERS, TRAILS, TREES, LAWNS AND SITE ELEMENTS DURING CONSTRUCTION OPERATIONS. DAMAGE TO SAME SHALL BE REPAIRED AT NO ADDITIONAL COST TO THE OWNER.
- LANDSCAPE CONTRACTOR SHALL VERIFY ALIGNMENT AND LOCATION OF UNDERGROUND AND ABOVE GRADE UTILITIES AND PROVIDE THE NECESSARY PROTECTION FOR SAME BEFORE CONSTRUCTION / MATERIAL INSTALLATION BEGINS (MINIMUM 10'- 0" CLEARANCE). • UNDERGROUND UTILITIES SHALL BE INSTALLED SO THAT TRENCHES DO NOT CUT THROUGH ROOT SYSTEMS OF ANY EXISTING TREES TO REMAIN.

CONTRACTOR SHALL VERIFY DISCREPANCIES PRIOR TO CONSTRUCTION AND NOTIFY LANDSCAPE ARCHITECT OF SAME.

EXISTING CONTOURS, TRAILS, VEGETATION, CURB/GUTTER AND OTHER ELEMENTS ARE BASED UPON INFORMATION SUPPLIED TO THE LANDSCAPE ARCHITECT BY OTHERS. LANDSCAPE

- ALIGNMENT AND GRADES OF THE PROPOSED WALKS, TRAILS AND/OR ROADWAYS ARE SUBJECT TO FIELD ADJUSTMENT REQUIRED TO CONFORM TO LOCALIZED TOPOGRAPHIC CONDITIONS AND TO MINIMIZE TREE REMOVAL AND GRADING. CHANGES IN THE ALIGNMENT AND GRADES MUST BE APPROVED BY THE LANDSCAPE ARCHITECT.
- NO PLANTS WILL BE INSTALLED UNTIL FINAL GRADING AND CONSTRUCTION HAS BEEN COMPLETED IN THE IMMEDIATE AREA. • SOD AREAS DISTURBED DUE TO GRADING SHALL BE REPLACED, UNLESS NOTED OTHERWISE. • PROPOSED PLANT MATERIAL SHALL COMPLY WITH THE LATEST EDITION OF THE AMERICAN STANDARD FOR NURSERY STOCK, ANSI Z60.1. UNLESS NOTED OTHERWISE, DECIDUOUS SHRUBS SHALL
- HAVE AT LEAST 5 CANES AT THE SPECIFIED HEIGHT. ORNAMENTAL TREES SHALL HAVE NO 'V' CROTCHES AND SHALL BEGIN BRANCHING NO LOWER THAN 3' FEET ABOVE THE ROOT BALL. STREET AND BOULEVARD TREES SHALL BEGIN BRANCHING NO LOWER THAN 6' ABOVE FINISHED GRADE.

• LANDSCAPE CONTRACTOR IS RESPONSIBLE FOR ONGOING MAINTENANCE OF NEWLY INSTALLED MATERIALS UNTIL TIME OF OWNER ACCEPTANCE. ACTS OF VANDALISM OR DAMAGE WHICH MAY

- OCCUR PRIOR TO OWNER ACCEPTANCE SHALL BE THE RESPONSIBILITY OF THE LANDSCAPE CONTRACTOR. • LANDSCAPE CONTRACTOR SHALL WARRANTY NEW PLANT MATERIAL THROUGH ONE CALENDAR YEAR FROM THE DATE OF THE OWNER ACCEPTANCE. NO PARTIAL ACCEPTANCE WILL BE
- SITE(S) SHALL BE LANDSCAPED PRIOR TO ISSUANCE OF A FINAL CERTIFICATE OF OCCUPANCY (CO) DURING THE GROWING SEASON OF APRIL 1ST TO OCTOBER 1ST, AT ALL OTHER TIMES THE INDIVIDUAL SITES SHALL BE LANDSCAPED WITHIN 45 (FORTY-FIVE) DAYS OF THE START OF THE FOLLOWING GROWING SEASON.
- UNLESS NOTED OTHERWISE, THE APPROPRIATE DATES FOR SPRING PLANT MATERIAL INSTALLATION AND SEED/SOD PLACEMENT IS FROM THE TIME GROUND HAS THAWED TO JUNE 15. • CONIFEROUS PLANTING IS GENERALLY ACCEPTABLE FROM AUGUST 15 TO OCTOBER 1. FALL DECIDUOUS PLANTING IS GENERALLY ACCEPTABLE FROM THE FIRST FROST UNTIL NOVEMBER 15. ADJUSTMENTS TO PLANTING DATES MUST BE APPROVED IN WRITING BY THE LANDSCAPE ARCHITECT.
- PLANTING AREAS AND SEEDED TURF AREAS TO BE IRRIGATED. IRRIGATION MAINLINE TO BE LOCATED WITHIN PROJECT PROPERTY.

• ANNUAL AND PERENNIAL PLANTING BEDS TO RECEIVE 4" DEEP SHREDDED HARDWOOD MULCH WITH NO WEED BARRIER. SHRUB BEDS TO RECEIVE 4" DEEP SHREDDED HARDWOOD MULCH WITH

- PLAN TAKES PRECEDENCE OVER PLANT SCHEDULE IF DISCREPANCIES IN QUANTITIES EXIST. DETAILS TAKE PRECEDENCE OVER NOTES. NO PLANT MATERIAL SUBSTITUTIONS WILL BE ACCEPTED UNLESS APPROVAL IS REQUESTED OF THE LANDSCAPE ARCHITECT BY THE LANDSCAPE CONTRACTOR PRIOR TO THE SUBMISSION OF BID AND/OR QUOTATION.
- ADJUSTMENTS IN LOCATION OF PROPOSED PLANT MATERIALS MAY BE NEEDED IN FIELD. LANDSCAPE ARCHITECT MUST BE NOTIFIED PRIOR TO ADJUSTMENT OF PLANTS. • LANDSCAPE CONTRACTOR SHALL COORDINATE THE PHASES OF CONSTRUCTION AND PLANTING INSTALLATION WITH OTHER CONTRACTORS WORKING ON SITE. • LANDSCAPE CONTRACTOR SHALL PREPARE AND SUBMIT REPRODUCIBLE AS-BUILT DRAWING(S) OF LANDSCAPE INSTALLATION, IRRIGATION AND SITE IMPROVEMENTS UPON COMPLETION OF
- CONSTRUCTION INSTALLATION AND PRIOR TO PROJECT ACCEPTANCE. • LANDSCAPE CONTRACTOR SHALL PREPARE AND SUBMIT A WRITTEN REQUEST FOR THE OWNER ACCEPTANCE INSPECTION OF LANDSCAPE AND SITE IMPROVEMENTS PRIOR TO SUBMITTING FINAL

# Material Legend

# CONCRETE SIDEWALK SPECIALTY SITE PAVERS PEDESTAL PAVERS TYPE 1 PEDESTAL PAVERS TYPE 2

PEDESTAL PAVERS TYPE 3
HARDWOOD MULCH PLANTING AREA
TURF SEED
NATIVE SEED MIX TVDE 1 SHORTODAS

NATIVE SEED MIX TYPE 1 - SHORTGRASS PRAIRIE NATIVE SEED MIX TYPE 2 - INFILTRATION BASIN ROCK MULCH - DOG RUN

# Keynote Legend

<b>◄</b> (1)	BIKE RACK
2	TREE GRATE
<b>◄</b> ──3	4' HT. BLACK CHAINLINK FENCE
4	PICNIC TABLE
<b>◄</b> 5	BENCH

**⋖** 6 SEAT WALL

Landscape Plan

**PRELIMINARY** 

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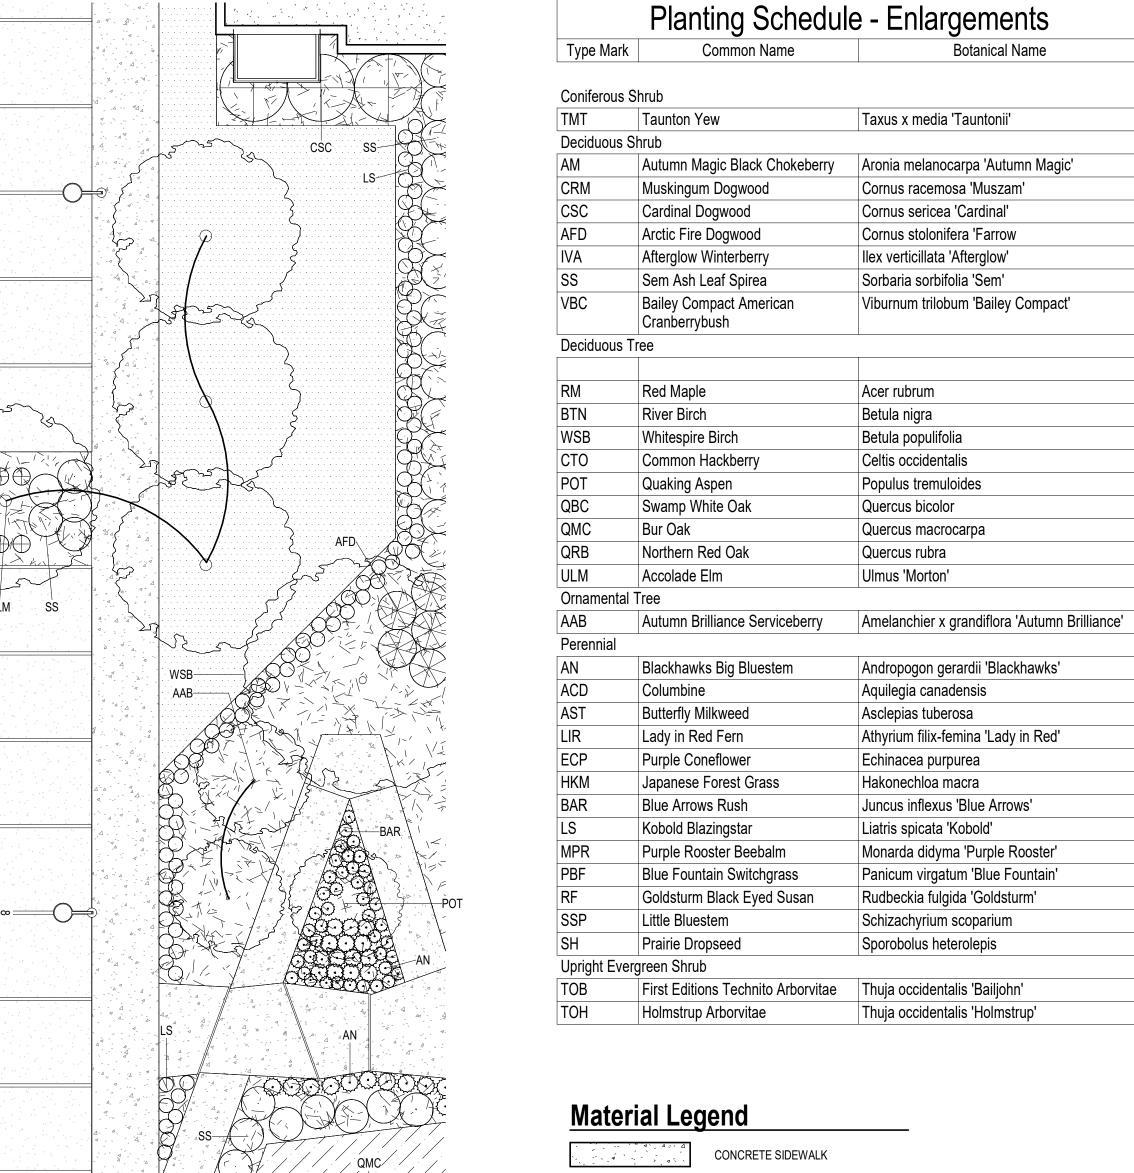
LUA/UDC Date:

Multifamily at 575 Zor Shrine Place

Description



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SPECIALTY SITE PAVERS PEDESTAL PAVERS TYPE 1 PEDESTAL PAVERS TYPE 2 PEDESTAL PAVERS TYPE 3 HARDWOOD MULCH PLANTING AREA NATIVE SEED MIX TYPE 1 - SHORTGRASS PRAIRIE NATIVE SEED MIX TYPE 2 - INFILTRATION BASIN **ROCK MULCH - DOG RUN** 

### **Keynote Legend**

- **■** 1 BIKE RACK
- TREE GRATE
- PICNIC TABLE

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	(6)	

Multifamily at 575 Zor Shrine Place


**PRELIMINARY** 

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Description

Enlarged Landscape Plans

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Overall Planting Plan - Callout 2

L-2

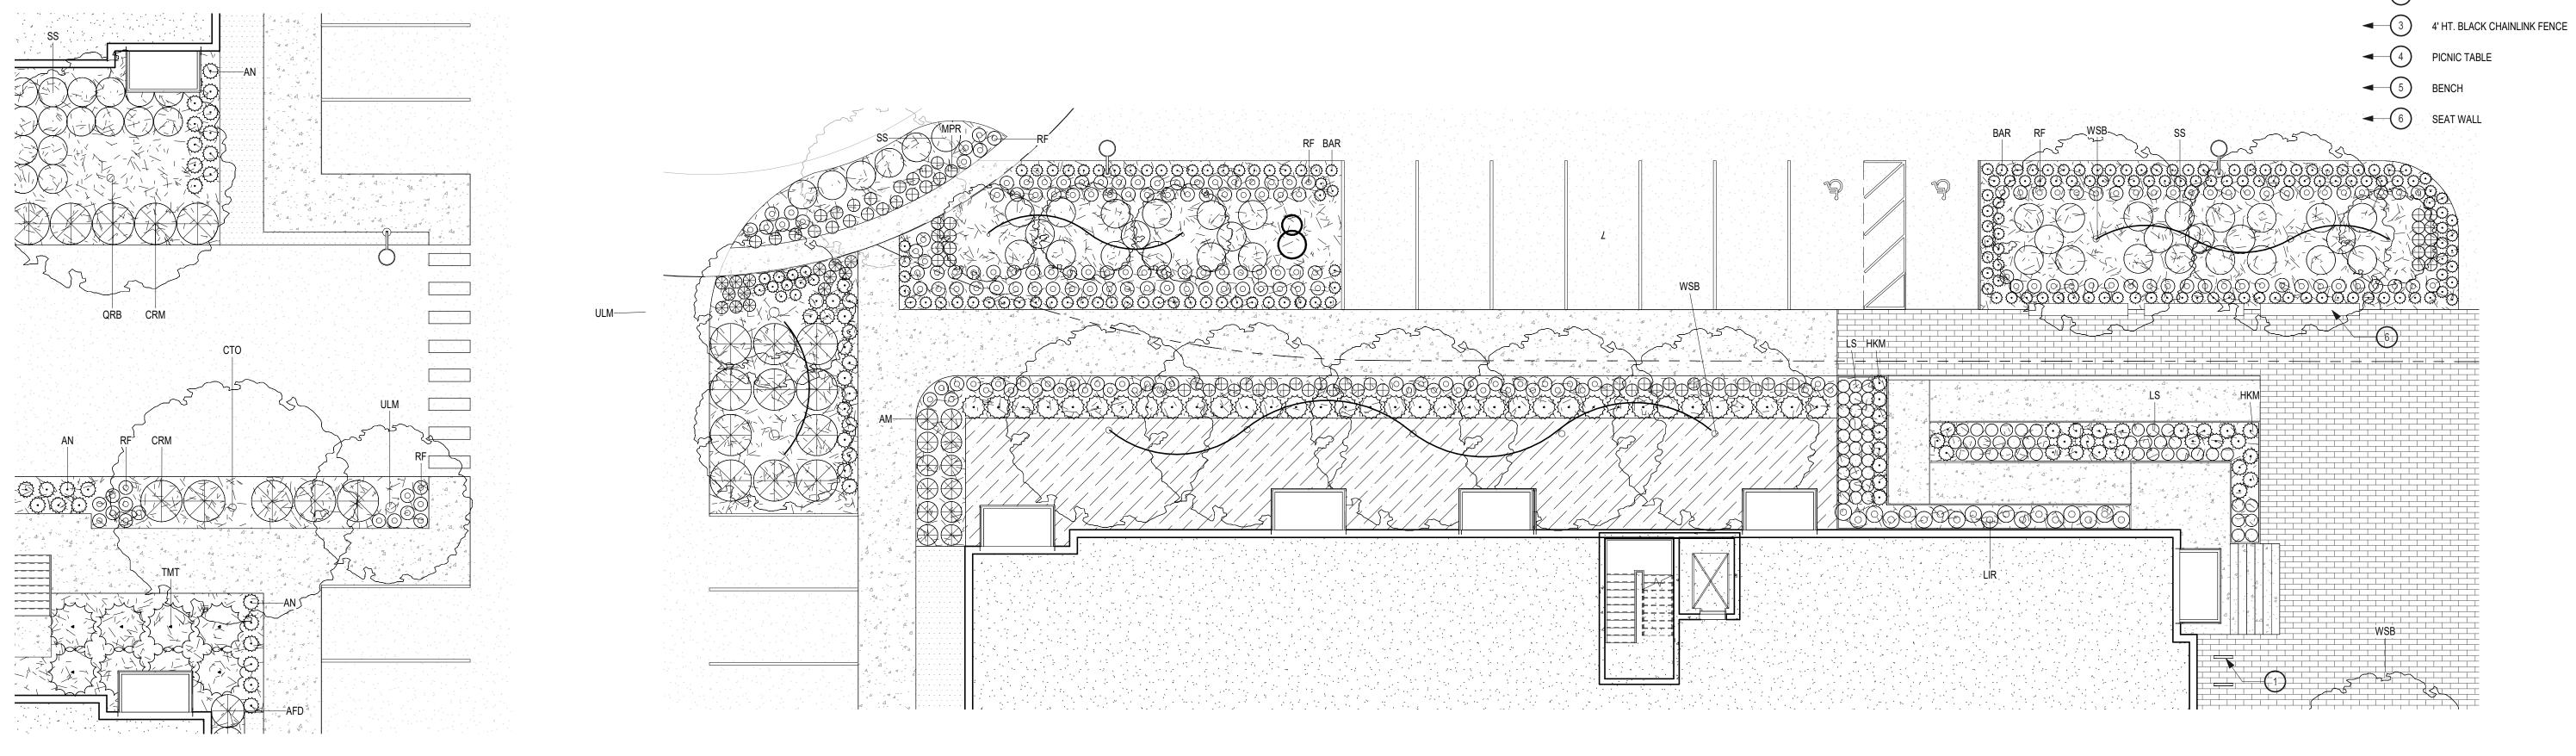1" = 10'-0"

1 Overall Planting Plan - Callout 1
L-2 1" = 10'-0"

Overall Planting Plan - Callout 6


1" = 10'-0"

BTN.

CTO-


Overall Planting Plan - Callout 7



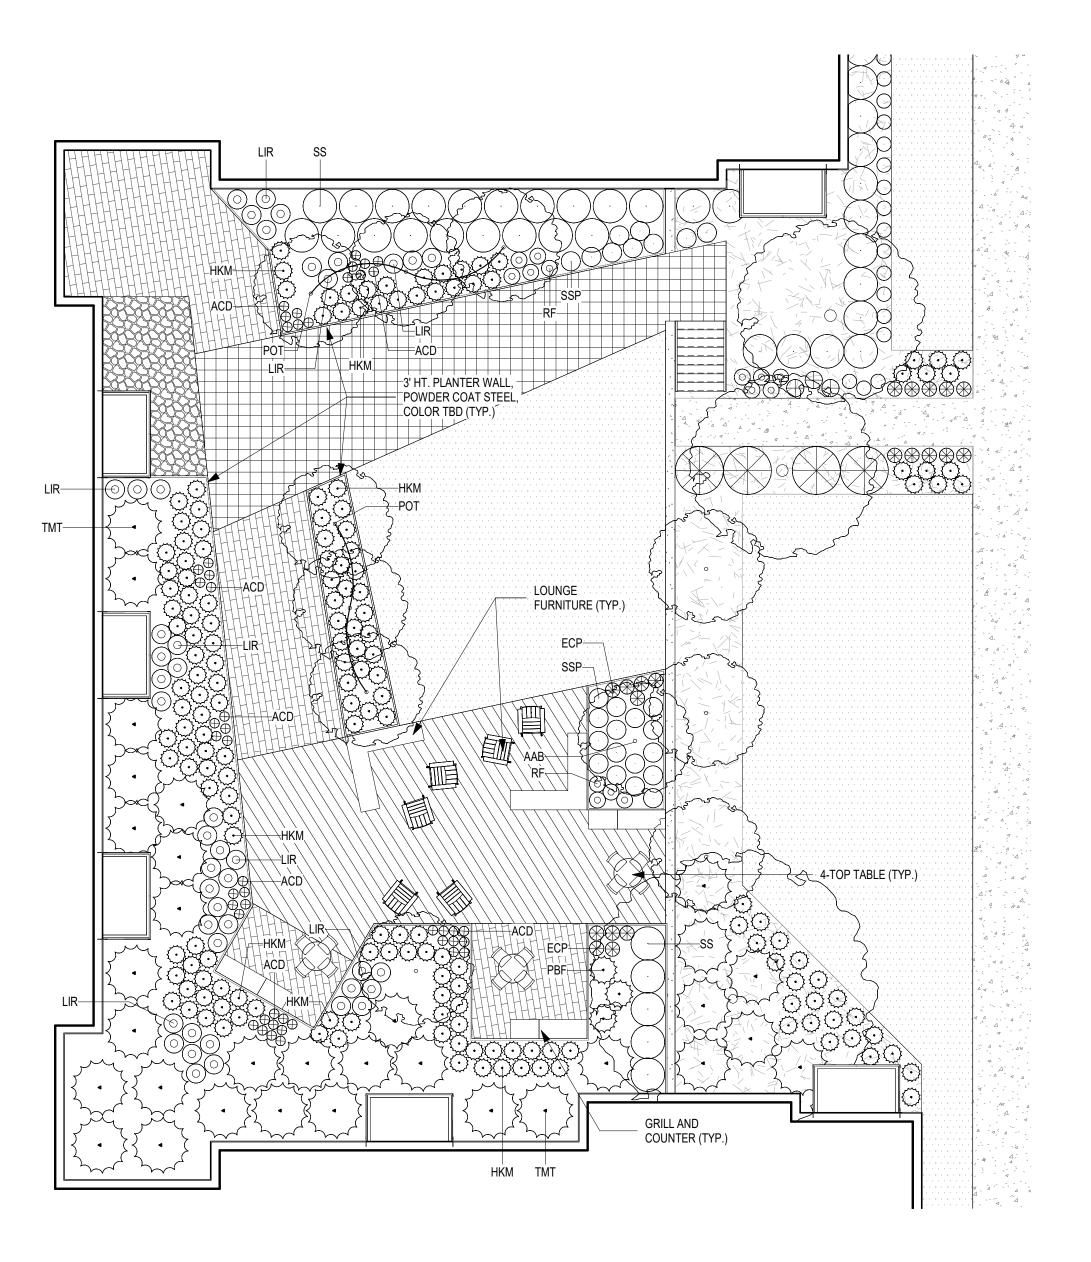

Overall Planting Plan - Callout 3

1" = 10'-0"

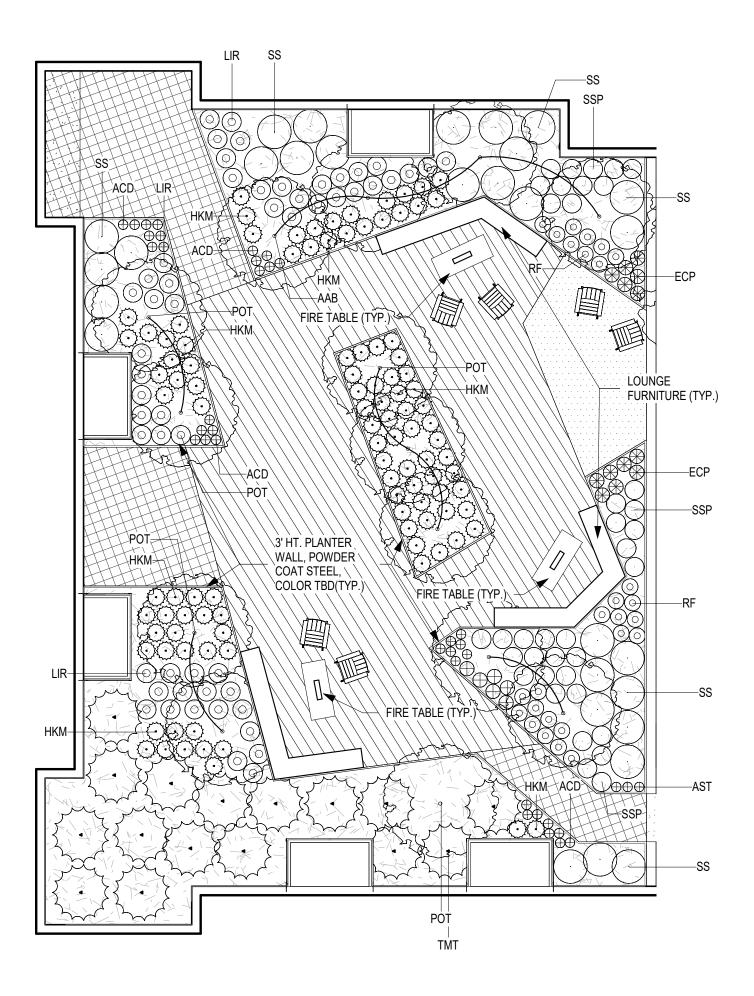

Overall Planting Plan - Callout 5

1" = 10'-0"

 • • ·
HARDWOOD MULCH
PEDESTAL PAVERS TYPE 1
PEDESTAL PAVERS TYPE 2
PEDESTAL PAVERS TYPE 3
 SYNTHETIC TURF
ROCK MULCH

# Keynote Legend

- 1 BIKE RACK
- TREE GRATE
- 4' HT. BLACK CHAINLINK FENCE
- ◆ 4 PICNIC TABLE
- **⋖** 6 SEAT WALL

|--|

9 9 -
HARDWOOD MULCH
PEDESTAL PAVERS TYPE 1
PEDESTAL PAVERS TYPE 2
PEDESTAL PAVERS TYPE 3
 SYNTHETIC TURF
ROCK MULCH


Planting Schedule - Amenity Decks				
Type Mark	Common Name	Botanical Name		
Coniferous S	hrub			
TMT	Taunton Yew	Taxus x media 'Tauntonii'		
Deciduous SI	hrub			
AM	Autumn Magic Black Chokeberry	Aronia melanocarpa 'Autumn Magic'		
CRM	Muskingum Dogwood	Cornus racemosa 'Muszam'		
CSC	Cardinal Dogwood	Cornus sericea 'Cardinal'		
AFD	Arctic Fire Dogwood	Cornus stolonifera 'Farrow		
IVA	Afterglow Winterberry	Ilex verticillata 'Afterglow'		
SS	Sem Ash Leaf Spirea	Sorbaria sorbifolia 'Sem'		
VBC	Bailey Compact American Cranberrybush	Viburnum trilobum 'Bailey Compact'		
Deciduous Tr	ree			
RM	Red Maple	Acer rubrum		
BTN	River Birch	Betula nigra		
WSB	Whitespire Birch	Betula populifolia		
СТО	Common Hackberry	Celtis occidentalis		
POT	Quaking Aspen	Populus tremuloides		
QBC	Swamp White Oak	Quercus bicolor		
QMC	Bur Oak	Quercus macrocarpa		
QRB	Northern Red Oak	Quercus rubra		
ULM	Accolade Elm	Ulmus 'Morton'		
Ornamental 1	ree			
AAB	Autumn Brilliance Serviceberry	Amelanchier x grandiflora 'Autumn Brilliance'		
Perennial				
AN	Blackhawks Big Bluestem	Andropogon gerardii 'Blackhawks'		
ACD	Columbine	Aquilegia canadensis		
AST	Butterfly Milkweed	Asclepias tuberosa		
LIR	Lady in Red Fern	Athyrium filix-femina 'Lady in Red'		
ECP	Purple Coneflower	Echinacea purpurea		
HKM	Japanese Forest Grass	Hakonechloa macra		
BAR	Blue Arrows Rush	Juncus inflexus 'Blue Arrows'		
LS	Kobold Blazingstar	Liatris spicata 'Kobold'		
MPR	Purple Rooster Beebalm	Monarda didyma 'Purple Rooster'		
PBF	Blue Fountain Switchgrass	Panicum virgatum 'Blue Fountain'		
RF	Goldsturm Black Eyed Susan	Rudbeckia fulgida 'Goldsturm'		
SSP	Little Bluestem	Schizachyrium scoparium		
SH	Prairie Dropseed	Sporobolus heterolepis		
Upright Everg		1		
TOB	First Editions Technito Arborvitae	Thuja occidentalis 'Bailjohn'		
TOH	Holmstrup Arborvitae	Thuja occidentalis 'Holmstrup'		
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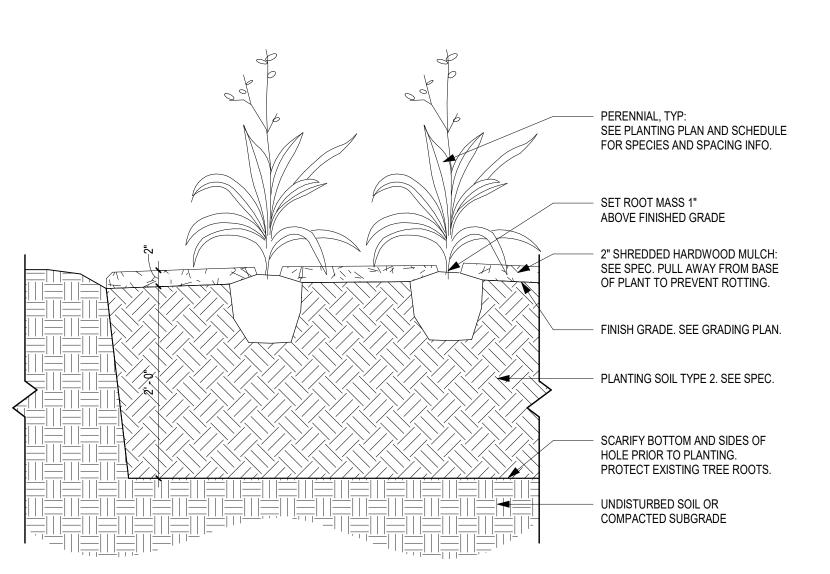
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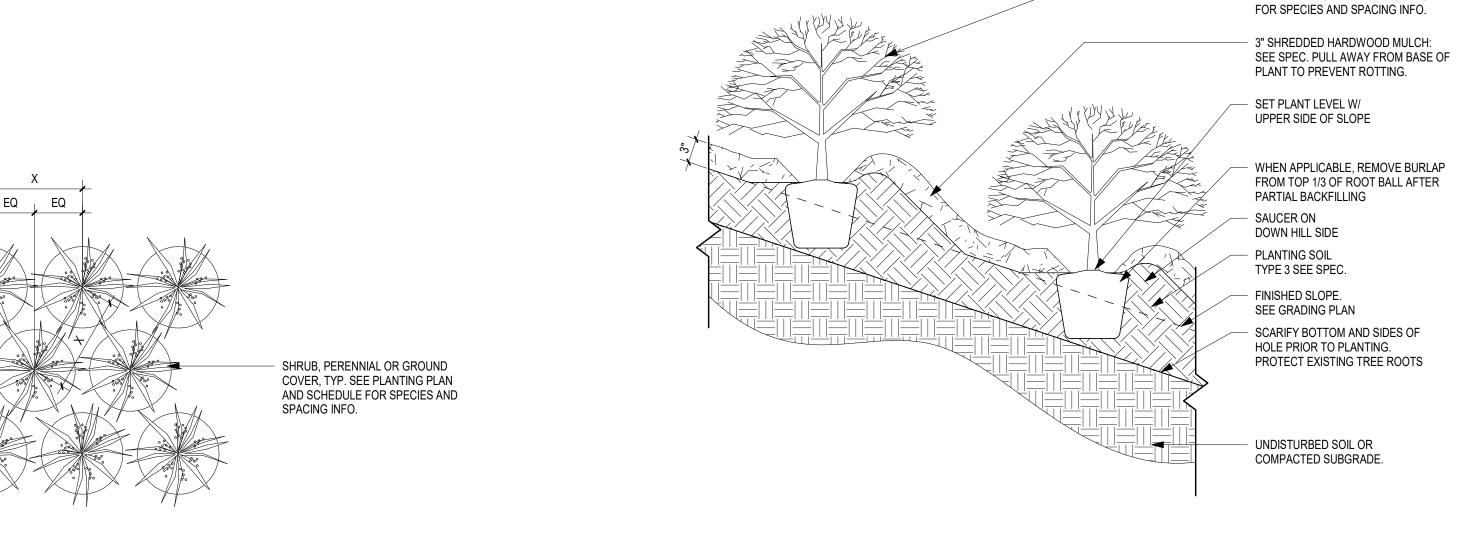
**PRELIMINARY** 

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Amenity Deck Landscape Plans







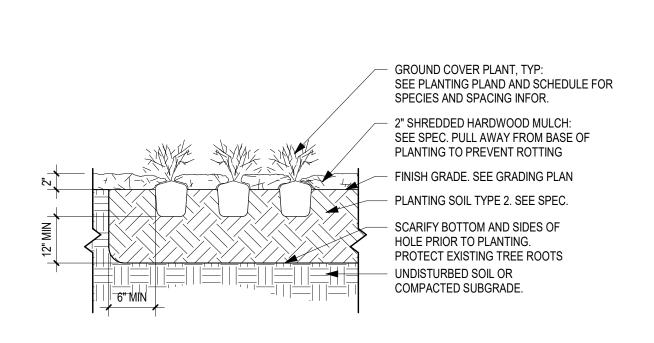



Triangular Spacing for Shrubs and Perennials Details



NOTES:


- SHRUB, TYP: SEE PLANTING PLAN AND SCHEDULE FOR SPECIES AND SPACING INFO. 3" SHREDDED HARDWOOD MULCH: SEE SPEC. PULL AWAY FROM ALL BASE OF PLANT TO PREVENT WHEN APPLICABLE, REMOVE BURLAP FROM TOP 1/3 OF ROOT BALL AFTER PARTIAL BACKFILLING FINISHED GRADE. SEE GRADING PLAN - PLANTING SOIL TYPE 3. SEE SPEC. SCARIFY BOTTOM AND SIDES OF HOLE PRIOR TO PLANTING. PROTECT EXISTING TREE ROOTS UNDISTURBED SOIL OR COMPACTED SUBGRADE. Shrub Planting in Individual Planting A Shrub Planting in Planting Beds

SEE PLANTING PLAN AND SCHEDULE FOR SPECIES AND SPACING INFO. WHEN APPLICABLE, REMOVE BURLAP FROM TOP 1/3 OF ROOT BALL AFTER PARTIAL BACKFILLING - 3" SHREDDED HARDWOOD MULCH: SEE SPEC. PULL AWAY FROM ALL BASE OF PLANT TO PREVENT - FINISHED GRADE. SEE GRADING PLAN PLANTING SOIL TYPE 3. SEE SPEC. SCARIFY BOTTOM AND SIDES OF HOLE PRIOR TO PLANTING. PROTECT EXISTING TREE ROOTS UNDISTURBED SOIL OR COMPACTED SUBGRADE.


POSTS: 7' U-CHANNEL 1.12 LBS/FOOT STRENGTH PAINTED OR GALVANIZED FENCE: MEET OR EXCEED MN/DOT 2572.2B — TREE PROTECTION FENCING: 48" WOOD SNOW FENCING OR CONSTRUCTION GRADE CHAIN LINK. FASTEN TO POSTS WITH GALVANIZED WIRE TIES. -

1. ALL TREE PROTECTION FENCING AND EROSION CONTROL FENCING SHALL BE INSTALLED ACCORDING TO THE PLANS PRIOR TO ANY DEMOLITION. AFTER DEMOLITION OR AS NECESSARY, TREE PROTECTION FENCING AND EROSION CONTROL DEVICES SHALL BE MAINTAINED FOR THE DURATION OF THE CONSTRUCTION PERIOD. 2. CONTRACTOR SHALL NOT STORE ANY MATERIALS OR PARK ANY VEHICLES IN TREE PROTECTED ZONES. THE FENCE SHALL PREVENT TRAFFIC MOVEMENT AND THE PLACEMENT OF TEMPORARY FACILITIES, EQUIPMENT, STOCKPILES AND SUPPLIES FROM HARMING VEGETATION WITHIN THE LIMITS OF PROTECTION. 3. THE CONTRACTOR SHALL CLEANLY CUT ALL ROOTS EXPOSED BY GRADING AS DIRECTED BY LANDSCAPE ARCHITECT.

SEE PLANTING PLAN AND SCHEDULE

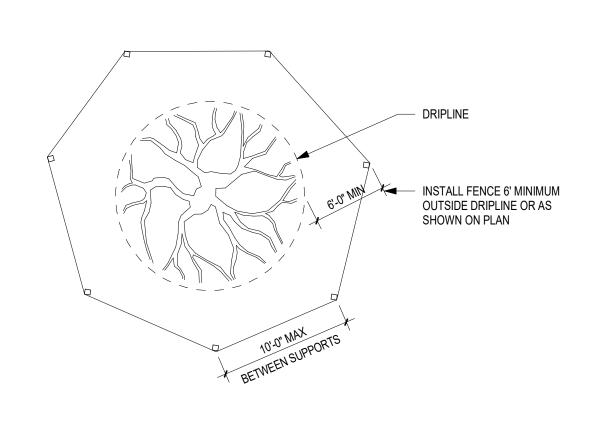

5 Shrub Planting Detail

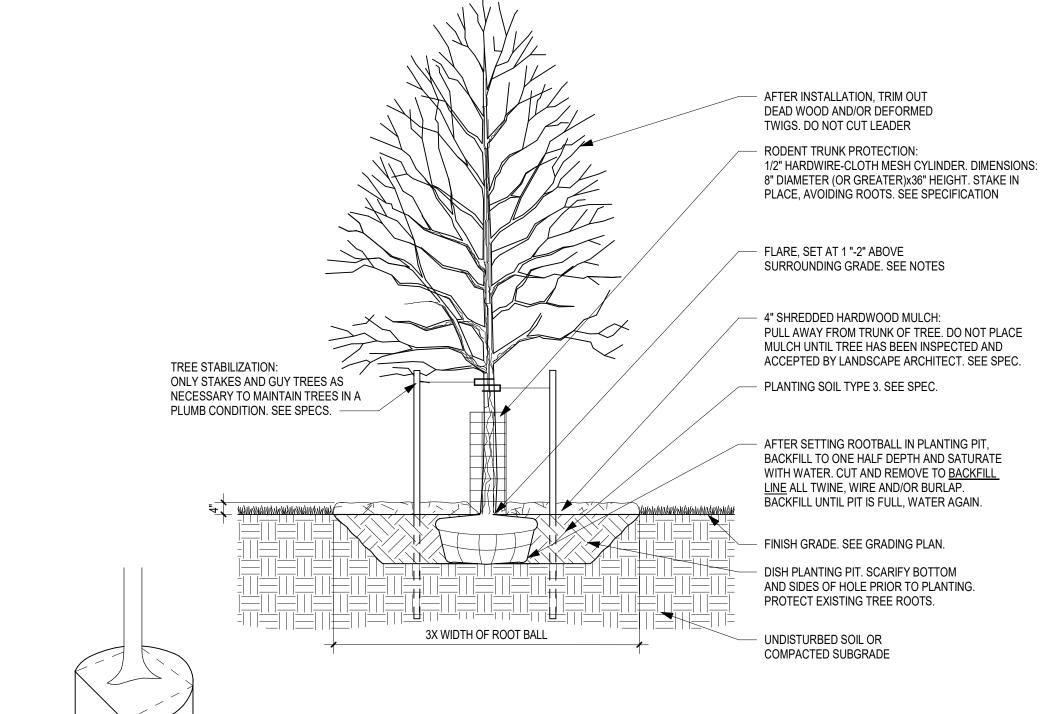

- IF ENCIRCLING WOODY ROOTS (PENCIL SIZE OR LARGER) ARE FOUND, REMOVE BY SLICING OFF SIDES OF ROOT BALL NOTES:
PRIOR TO DELIVERY TO THE SITE, THE CONTRACTOR SHALL LOCATE THE BUTTRESS ROOTS OR TRUNK FLARE OF EACH TREE. IF FLARE IS LOCATED MORE THAN 2" DOWN FROM THE TOP OF THE ROOTBALL, THE TREE IS REJECTED AND SHALL NOT BE DELIVERED TO THE SITE REMOVE SOIL FROM TOP OF ROOTBALL TO EXPOSE TOP OF FLARE. THE LANDSCAPE ARCHITECT WILL NOT ACCEPT ANY TREE UNLESS THE FLARE IS ONCE THE PROPERLY GROWN TREE IS DELIVERED TO THE SITE, MEASURE THE


DISTANCE BETWEEN TOP OF THE BUTTRESS ROOTS AND THE BOTTOM OF THE ROOTBALL. SUBTRACT 2" TO DETERMINE DEPTH OF PLANTING PIT. • DIG PIT TO DEPTH DETERMINED ABOVE AND 3x THE WIDTH OF THE ROOTBALL. PIT SHALL BE DISHED WITH SIDEWALLS AS SHOWN BELOW. SCARIFY WALLS AND BOTTOM OF PIT. SET TREE IN PIT SO THAT THE FLARE IS ONE-TWO INCHES ABOVE SURROUNDING GRADE. IN AREAS WITH HEAVY CLAY OR POORLY DRAINED SOILS (MOTTLING), CONTACT LANDSCAPE ARCHITECT. TREE MAY BE RELOCATED OR THE ROOTBALL FURTHER ELEVATED. BACKFILL PLANTING PIT TO ON HALF DEPTH AND THOROUGHLY WATER. FOR B&B MATERIAL REMOVE VISIBLE PORTIONS OF WIRE BASKET, BURLAP AND ROPE W/O DISTURBING ROOTBALL. BACKFILL TO THE TOP OF THE FIRST WOODY

ROOT, LEAVING NO EXPOSED BURLAP. HEAL IN SOIL W/ FOOT OVER ENTIRE ROOT BALL AREA TO REMOVE AIR POCKETS FROM THE SOIL. WATER ROOTBALL AND ENTIRE BACKFILL AREA. DO NOT CREATE WATERING RING. BACKFILL TO THE TOP OF THE ROOTBALL

TREES WILL BE REJECTED FOR THE FOLLOWING REASONS:

• POOR FORM DAMAGED TRUNK

 BURIED TRUNK FLARES ENCIRCLING TRANSPORT ROOTS UNCONSOLIDATED ROOTBALL SOIL (DUE TO EXCESSIVE HANDLING) NO OR DAMAGED CENTRAL LEADER

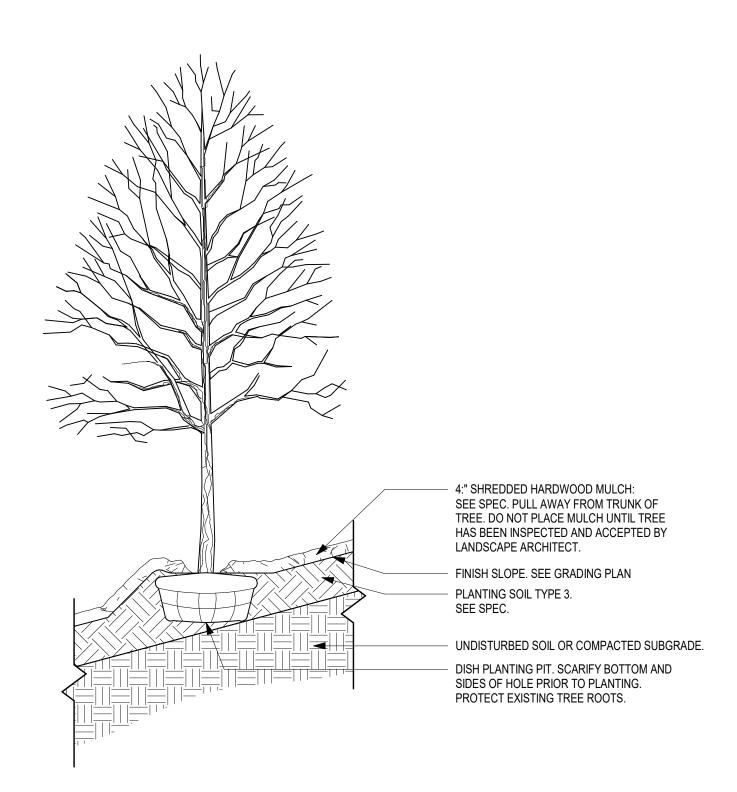

6 Tree Protection Detail

**PRELIMINARY** NOT FOR CONSTRUCTION

Description

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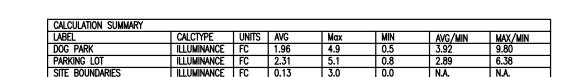
cuningham.com

LUA/UDC Date:

20-0084 PIC / AIC: DStahl / JSchoeneck Multifamily at 575 Zor Shrine Place

### **GENERAL NOTES**

- A. LIGHTING LEVELS SHOWN ARE MAINTAINED. LIGHT LOSS FACTOR OF .855 WAS USED TO ACCOUNT FOR DIRT AND LUMEN DEPRECIATION.
- B. FIXTURES SHALL BE CONTROLLED BY A COMBINATION OF PHOTOCELL AND TIMECLOCK.





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PRELIMINARY
OT FOR CONSTRUCTION

Revisions

No. Date Description

 Project Information
 Date:
 05/05/20

 Project No.: 4506.0000
 PIC / AIC:

Photometric
Site Plan

Sheet Number

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Out on Revision





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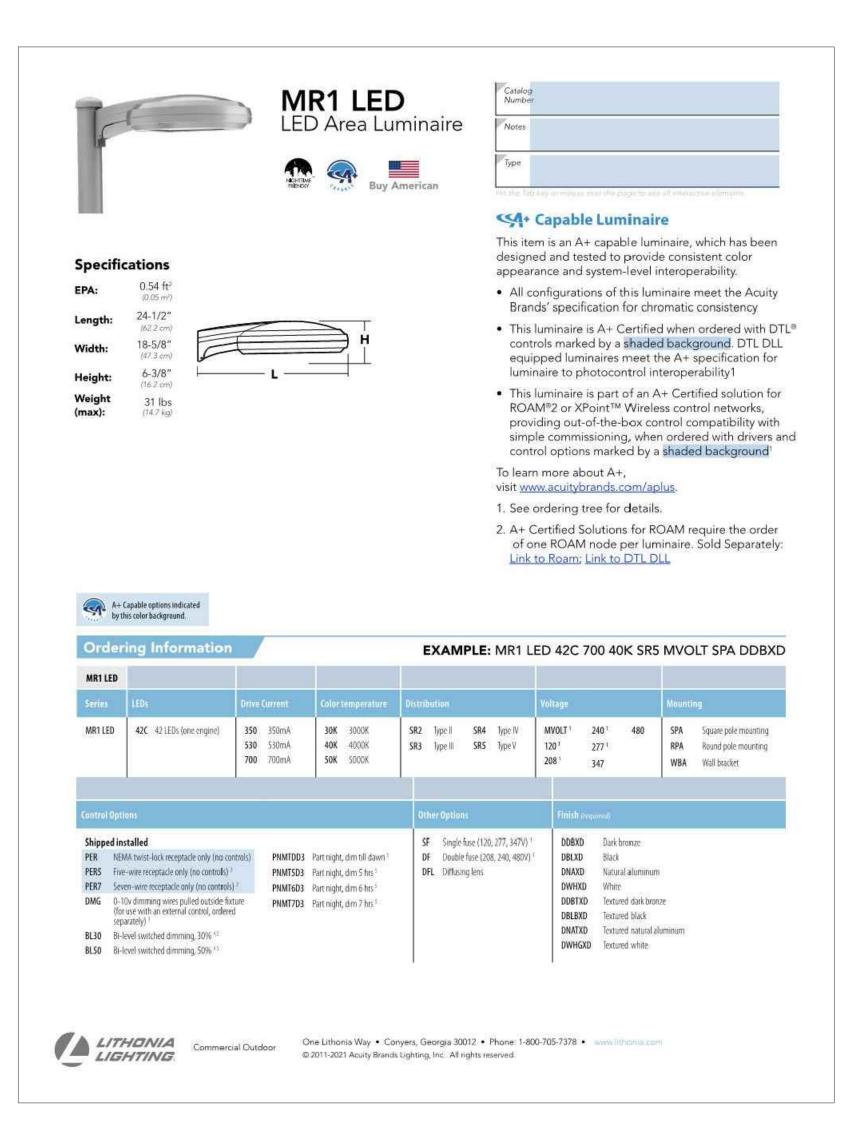
# **PRELIMINARY** NOT FOR CONSTRUCTION


Revisi	ons	
No.	Date	Description


Project Information				
Phase:	Date:	05/05/202		
Project No.: 4506.0000	PIC / AIC:			

**Photometric** 


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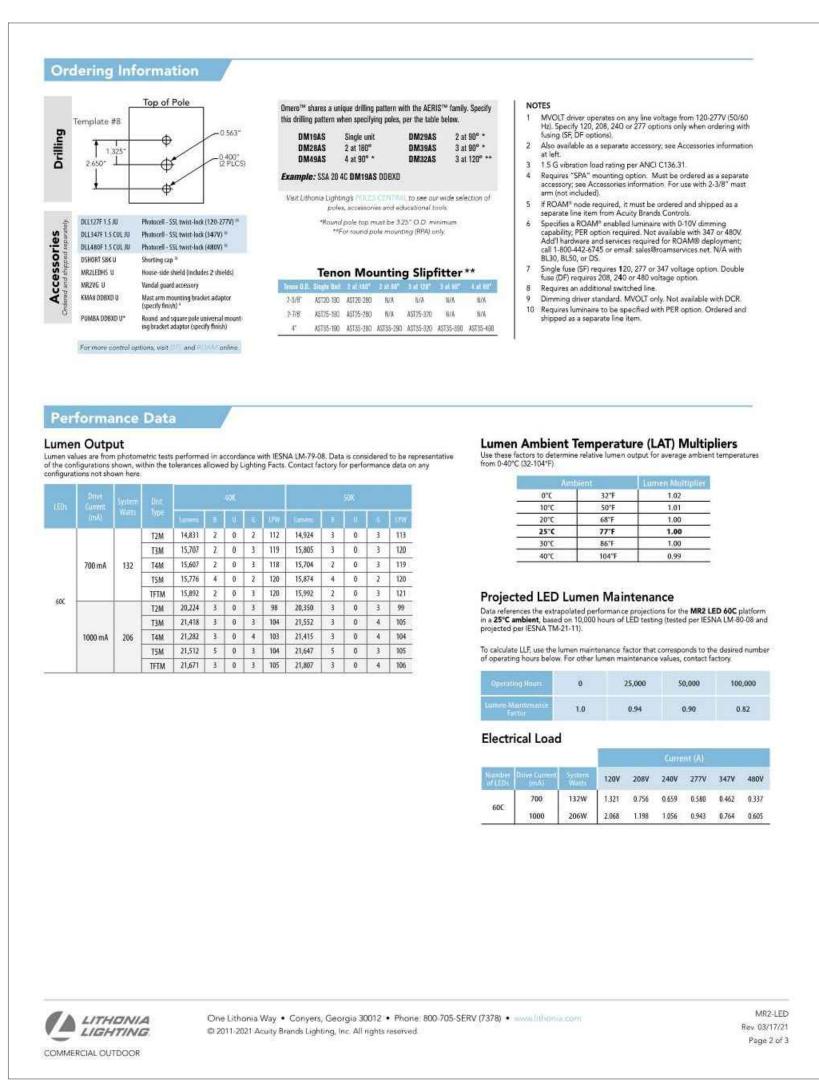




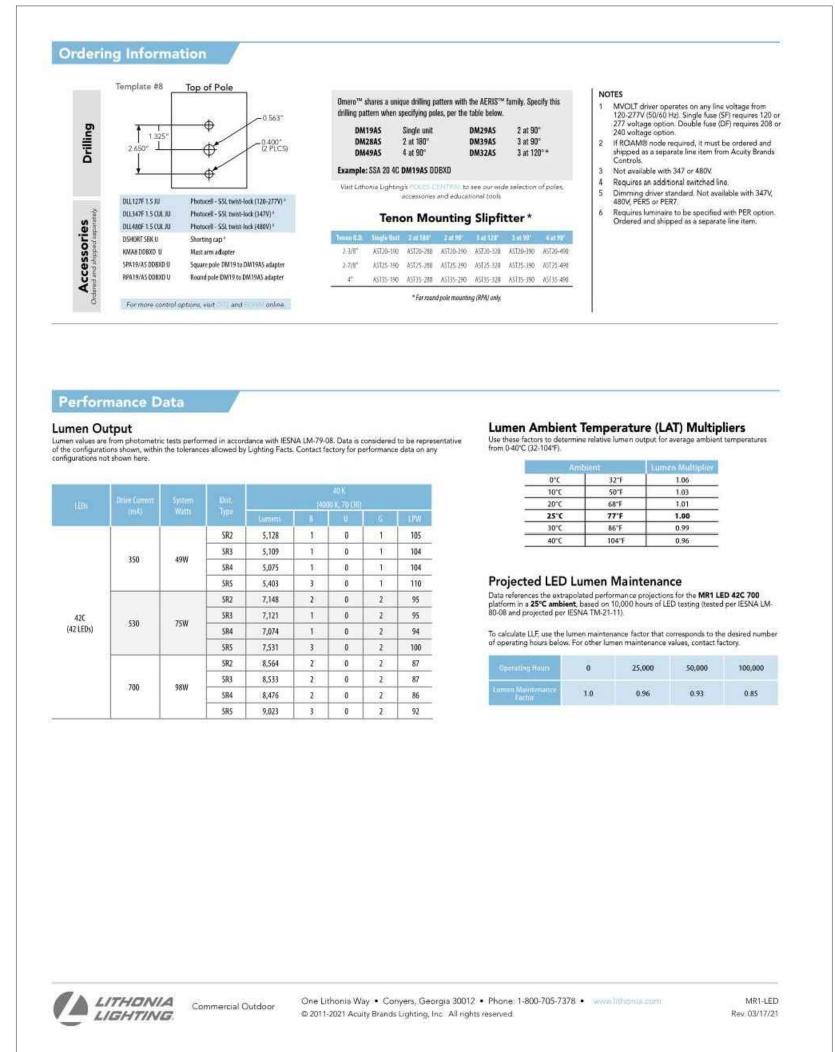
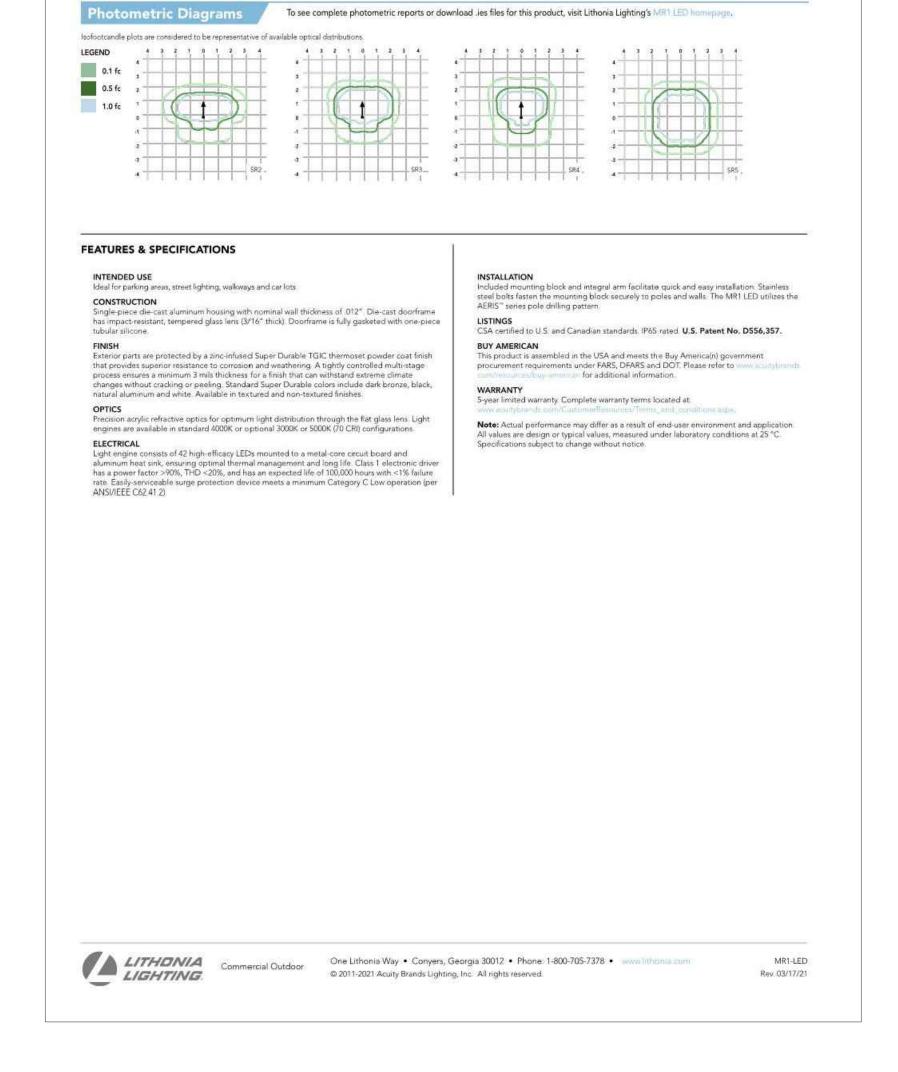
# FIXTURE TYPE P3



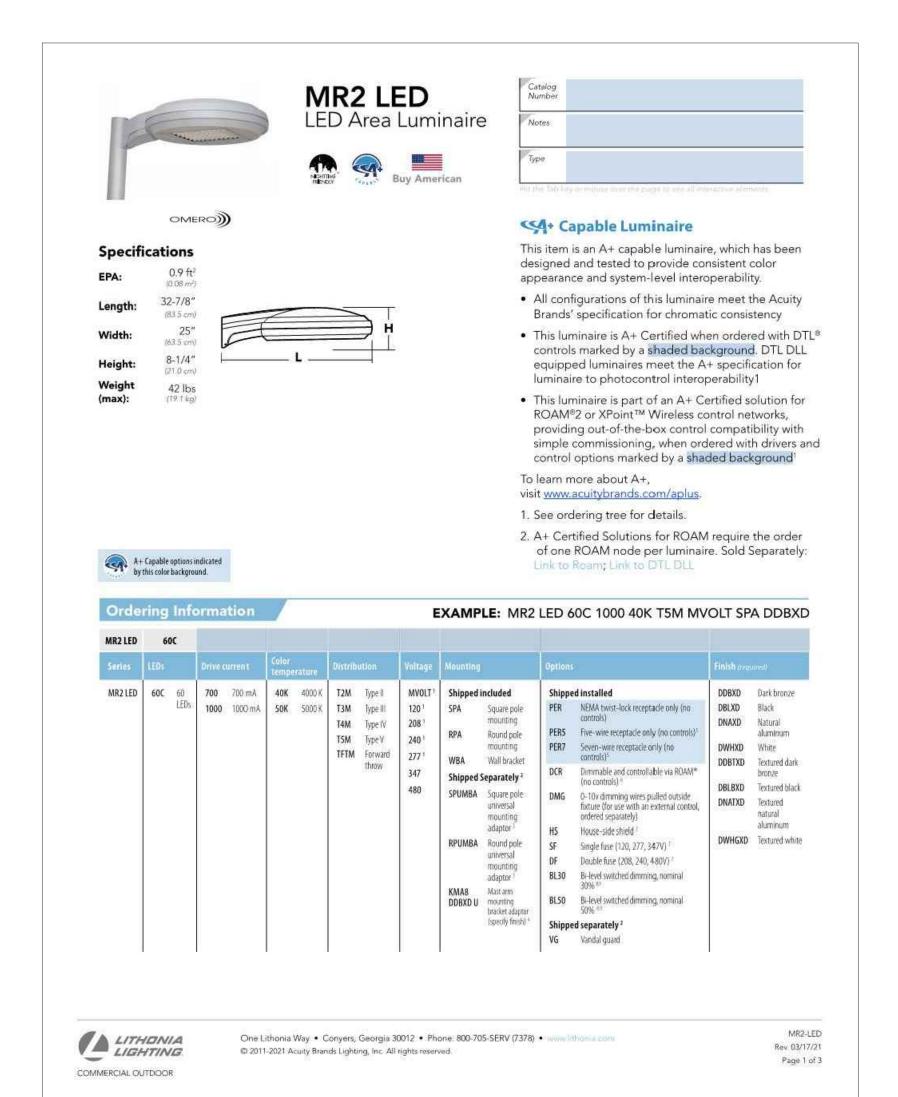


**FEATURES & SPECIFICATIONS** Highly efficient and long-lasting, the MR2 LED is ideal for parking areas, street lighting, walkways and car lots Light engine(s) consist of 60 high-efficacy LEDs mounted to metal-core circuit boards to maximize heat dissipation and promote long life (100,000 hrs at 40°C, L70). Class 1 electronic driver designed to provide a power factor >90%, THD <20%, with an expected life of 100,000 hours with <1% failure rate. Easily-serviceable surge protection device meets a minimum Category C Low operation (per ANSI/IEEE C62 41 2). Single-piece die cast housing has a unique flow-through design that allows for optimized thermal management through convective cooling. A perforated housing prevents debris build-up while allowing natural cleaning of the heat sinks. Modular design allows for ease of maintenance and future light engine upgrades. The LED driver and electronics are thermally isolated from the light Integral arm provides easy installation to a pole and assists in alignment and leveling. Secure connection withstands up to 2.0 G vibration load rating per ANSI C136.31. The MR2 utilizes the AERIS™ series pole drilling pattern for SPA and RPA options, wall mounting bracket also engine(s), ensuring long life. Housing is completely sealed against moisture and environmental contaminants. Low EPA (0.9 ft²) for optimized pole wind loading. Exterior parts are protected by a zinc-infused Super Durable TGIC thermoset powder coat finish that provides superior resistance to corrosion and weathering. A tightly controlled multi-stage process ensures a minimum 3 mils thickness for a finish that can withstand extreme climate CSA certified to U.S. and Canadian standards. Light engines are IP66 rated, luminaire is IP65 rated. U.S. Patent No. D556,357. changes without cracking or peeling. Standard Super Durable colors include dark bronze, black, natural aluminum and white. Available in textured and non-textured finishes. procurement requirements under FARS, DFARS and DOT. Please refer to www.acutybrands Precision-molded acrylic lenses provide optimal luminaire spacing and improved uniformity om/resturces/buy-american for additional information. Lenses are indexed to the circuit board to ensure consistent optical alignment and delivering repeatable photometric performance. Light engines are available in standard 4000 K (67 CRI) or optional 5000 K (67 CRI) configurations. The MR2 has zero uplight and qualifies as a Nighttime Friendly of product, meaning it is consistent with the LEED® and Green Globes™ criteria for 5-year limited warranty. Complete warranty terms located at: Note: Actual performance may differ as a result of end-user environment and application. eliminating wasteful uplight. All values are design or typical values, measured under laboratory conditions at 25 °C. MR2-LED LITHONIA LIGHTING One Lithonia Way . Conyers, Georgia 30012 . Phone: 800-705-SERV (7378) . www.lithonia.com Rev. 03/17/21 © 2011-2021 Acuity Brands Lighting, Inc. All rights reserved. Page 3 of 3 COMMERCIAL OUTDOOR

To see complete photometric reports or download .ies files for this product, visit Lithonia Lighting's MRQ\_LED homepage.

Isofootcandle plots for the MR2 LED 60C 1000 40K. Distances are in units of mounting height (20').

FIXTURES TYPE P1, P1A, P2, P4



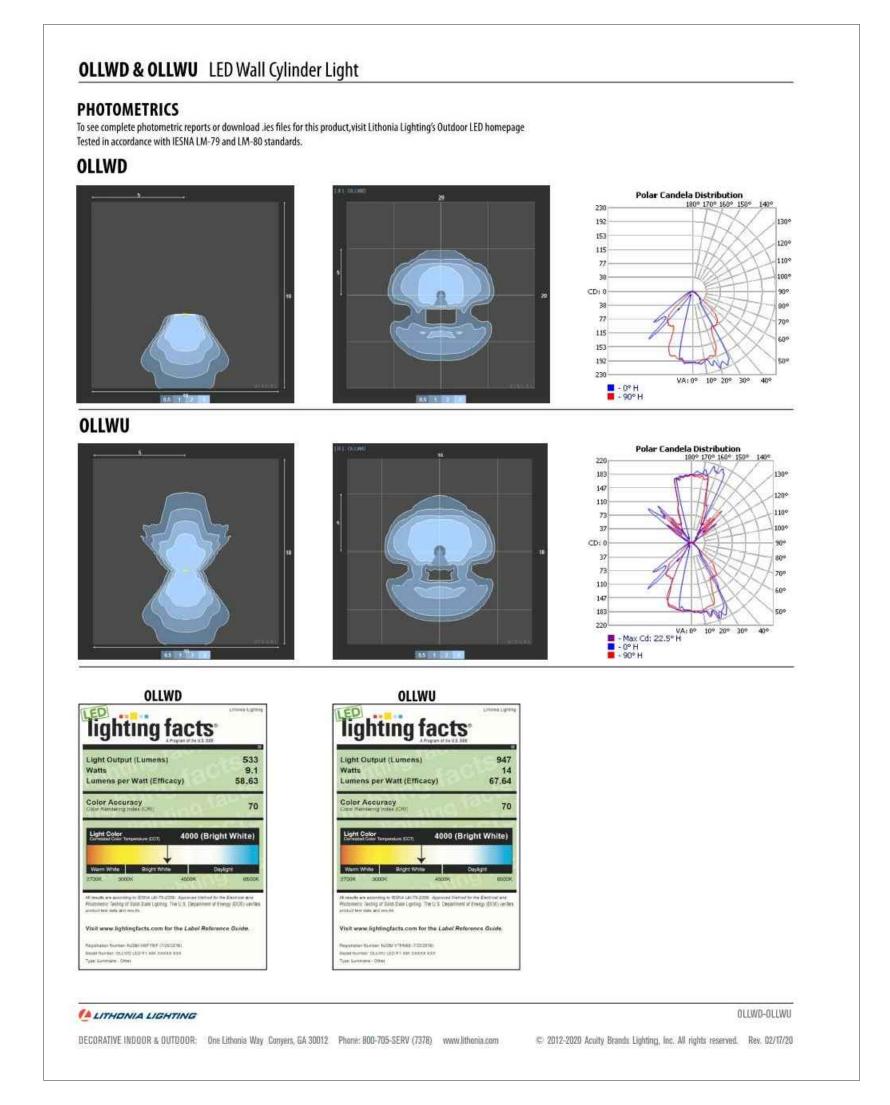

# **FIXTURE TYPE Q**

LIGHT FIXTURE SCHEDULE								
TYPE	DESCRIPTION	VOLT	LAMP TYPE	QTY / FIXT.	VA / FIXT.	MANUFACTURER	CATALOG NUMBER	NOTE
P1	EXTERIOR LIGHT POLE AND SINGLE ARM MOUNT HEAD, DIE-CAST ALUMINUM FIXTURE HOUSING, ACRYLIC LENS. 4" STRAIGHT SQUARE STEEL POLE WITH BASE COVER. FIXTURE AND POLE TO BE DARK BRONZE FINISH. HOUSE SIDE SHIELD. HEAD TO BE 25' ABOVE GRADE.	UNIV	LED 4000K	N/A	132	LITHONIA	MR2 LED 60C 700 40K T2M MVOLT SPA HS DDBXD	1
P1A	EXTERIOR LIGHT POLE AND SINGLE ARM MOUNT HEAD, DIE-CAST ALUMINUM FIXTURE HOUSING, ACRYLIC LENS. 4" STRAIGHT SQUARE STEEL POLE WITH BASE COVER. FIXTURE AND POLE TO BE DARK BRONZE FINISH. HOUSE SIDE SHIELD. HEAD TO BE 30' ABOVE GRADE.	UNIV	LED 4000K	N/A	132	LITHONIA	MR2 LED 60C 700 40K T2M MVOLT SPA HS DDBXD	1
P2	EXTERIOR LIGHT POLE AND SINGLE ARM MOUNT HEAD, DIE-CAST ALUMINUM FIXTURE HOUSING, ACRYLIC LENS. 4" STRAIGHT SQUARE STEEL POLE WITH BASE COVER. FIXTURE AND POLE TO BE DARK BRONZE FINISH. HOUSE SIDE SHIELD. HEAD TO BE 25' ABOVE GRADE.	UNIV	LED 4000K	N/A	132	LITHONIA	MR2 LED 60C 700 40K TFTM MVOLT SPA HS DDBXD	1
Р3	EXTERIOR LIGHT POLE AND SINGLE ARM MOUNT HEAD, DIE-CAST ALUMINUM FIXTURE HOUSING, ACRYLIC LENS. 4" STRAIGHT SQUARE STEEL POLE WITH BASE COVER. FIXTURE AND POLE TO BE DARK BRONZE FINISH. HEAD TO BE 20' ABOVE GRADE.	UNIV	LED 4000K	N/A	VARIES	LITHONIA	MR1 LED 42C 350 40K SR4 MVOLT SPA DDBXD	1
P4	EXTERIOR LIGHT POLE AND BACK TO BACK ARM MOUNT HEADS, DIE-CAST ALUMINUM FIXTURE HOUSING, ACRYLIC LENS. 4" STRAIGHT SQUARE STEEL POLE WITH BASE COVER. FIXTURE AND POLE TO BE DARK BRONZE FINISH. HEADS TO BE 30' ABOVE GRADE.	UNIV	LED 4000K	N/A	VARIES	LITHONIA	(2) MR2 LED 60C 700 40K T2M MVOLT SPA DDBXD	1
Q	8" H X 4-5/16" W X 3-11/16" D WALL CYLINDER, DOWNLIGHT ONLY, CAST ALUMINUM HOUSING IN DARK BRONZE PAINT. SURFANCE MOUNT TO FLUSH MOUNT JUNCTION BOX.	UNIV	LED 4000K	N/A	9.1	LITHONIA	OLLWD LED P1 40K MVOLT DDB	

1. COORDINATE POLE HEIGHT AND CONCRETE BASE. REFER TO POLE BASE DETAILS.

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**PRELIMINARY** 

Project No.: 4506.0000

Sheet Title
Photometric Cutsheets and Fixture Schedule