

OLIN AVENUE MIXED-USE DEVELOPMENT

222-232 EAST OLIN AVENUE MADISON, WISCONSIN

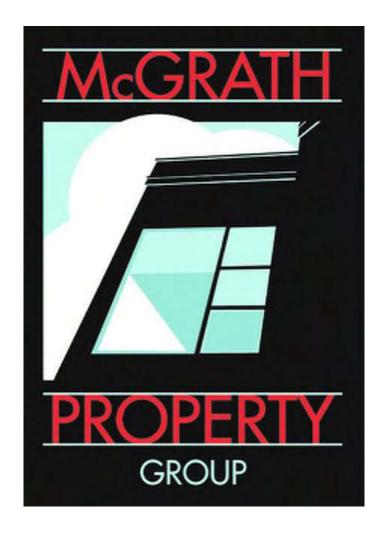


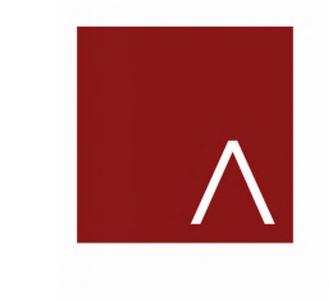

LAND USE APPLICATION






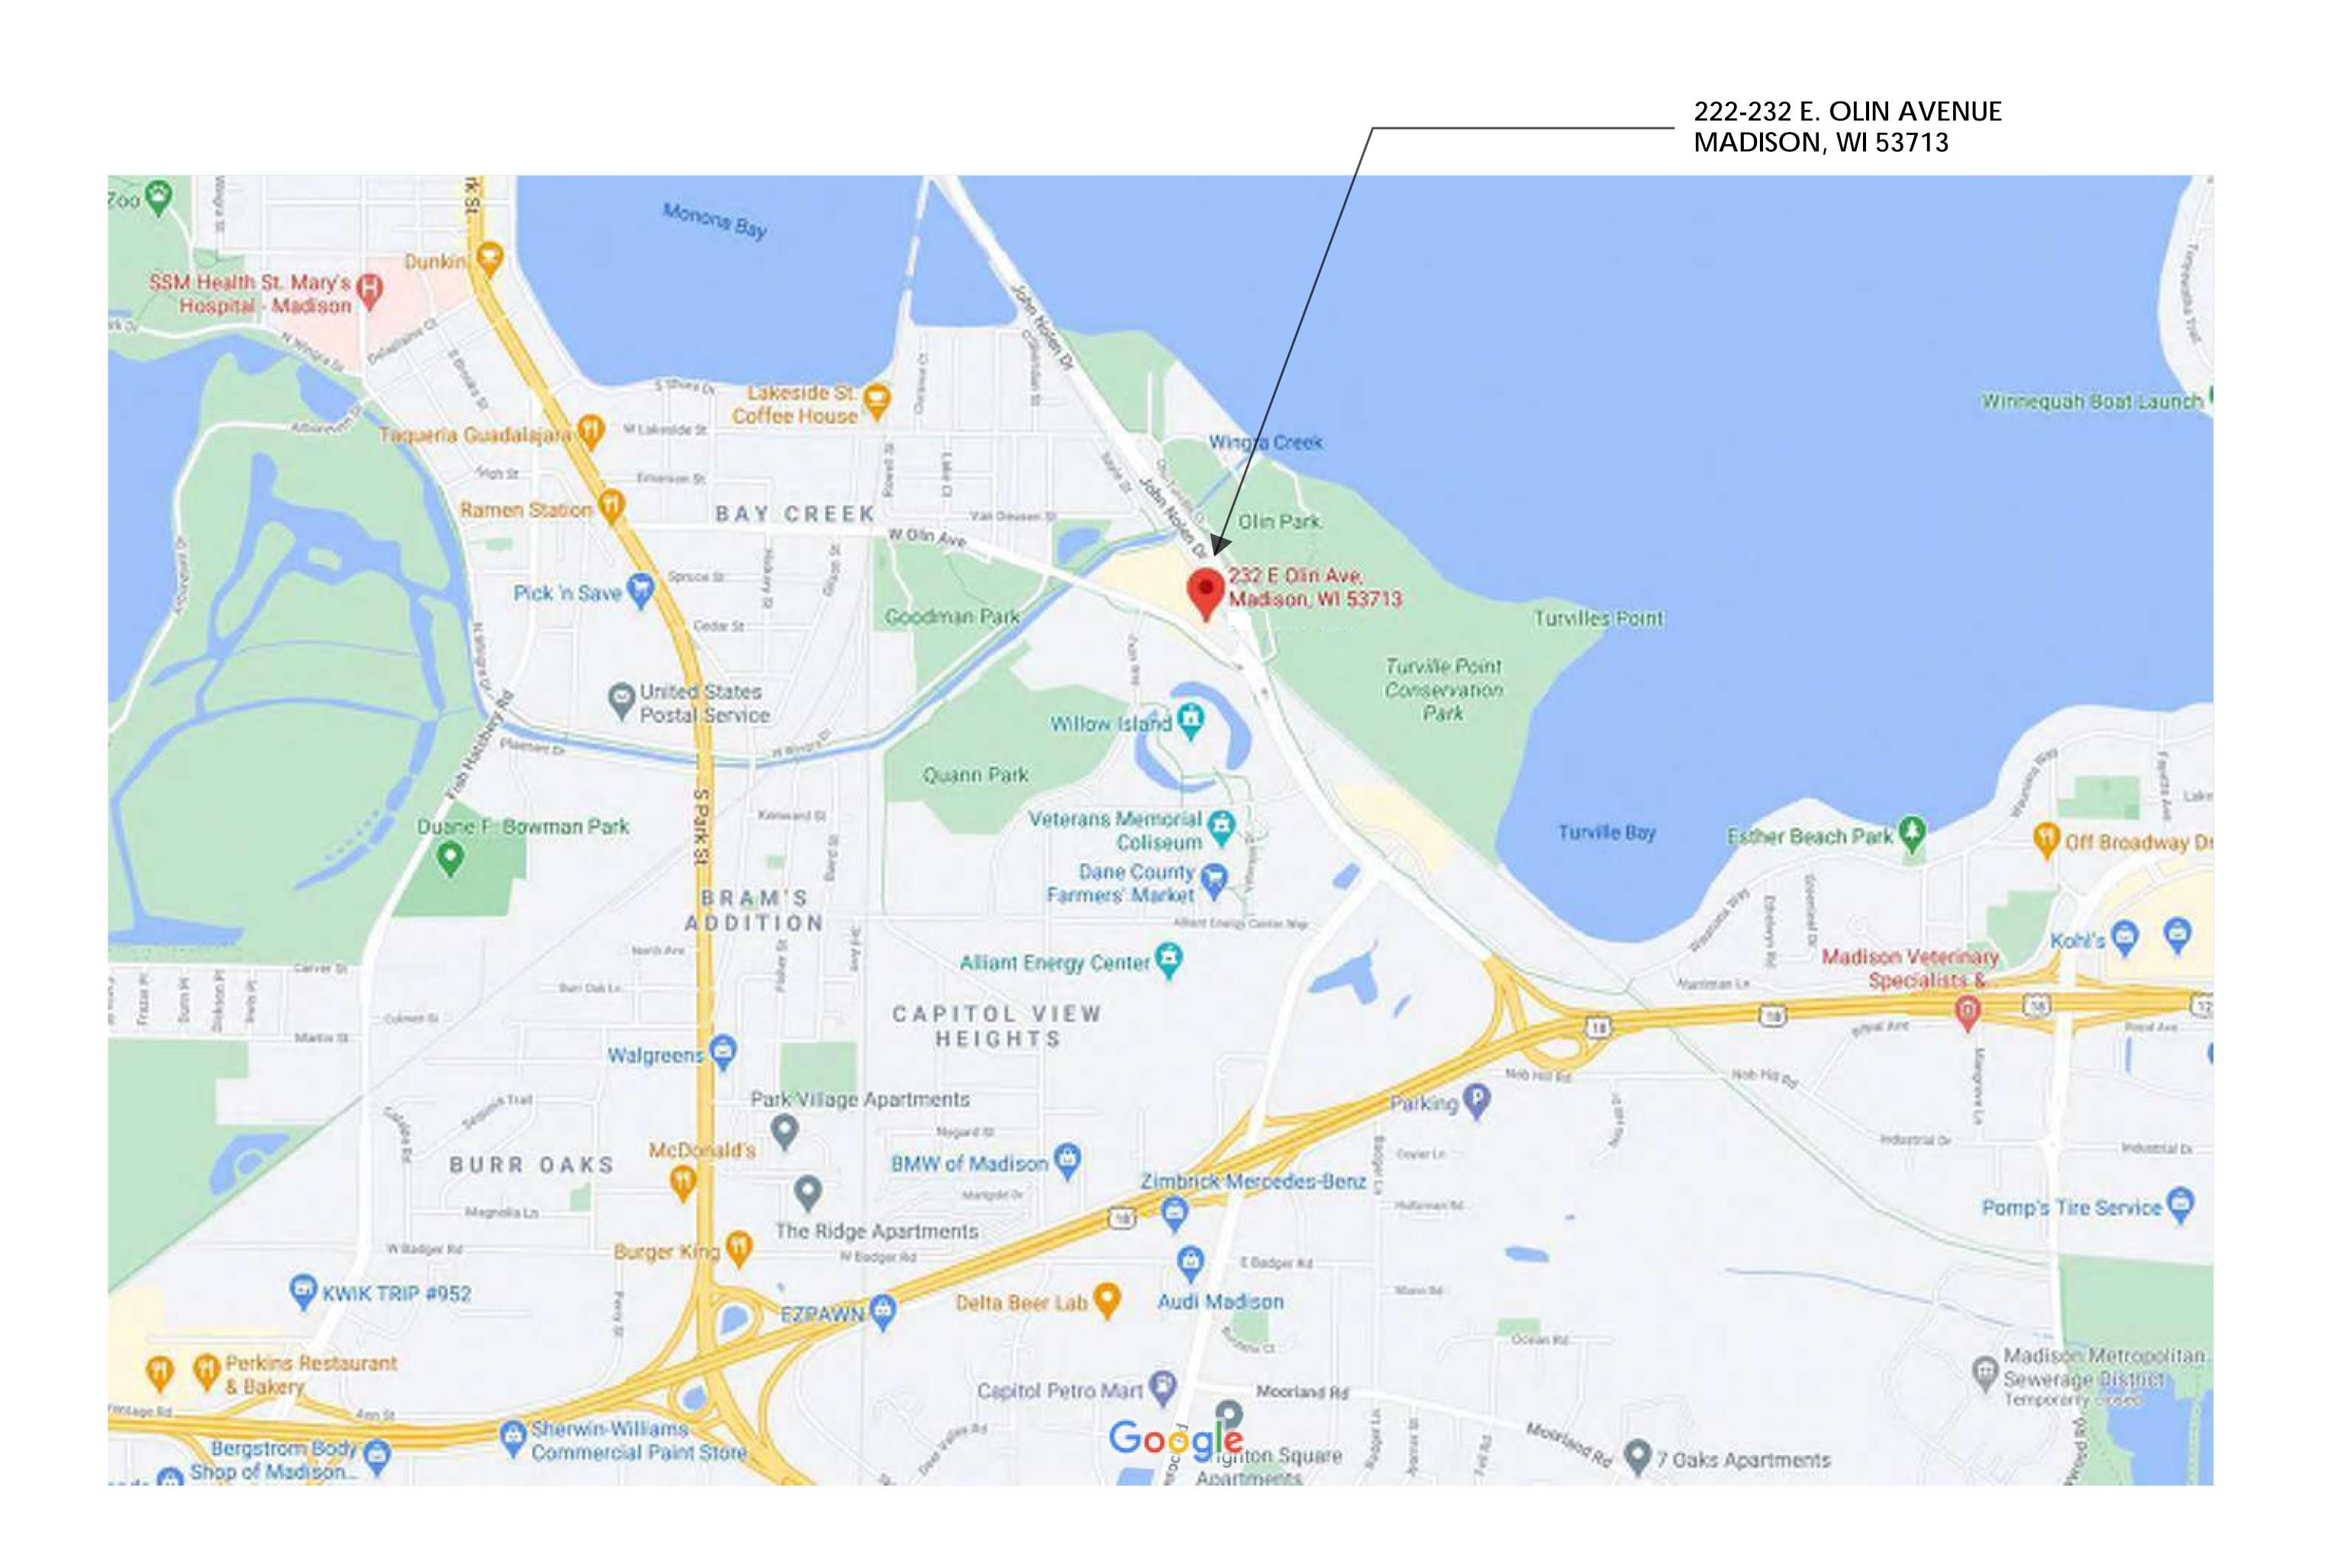


OLIN AVENUE MIXED-USE DEVELOPMENT – LAND USE APPLICATION

MAY 19, 2021

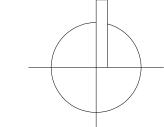



JLA PROJECT NUMBER:

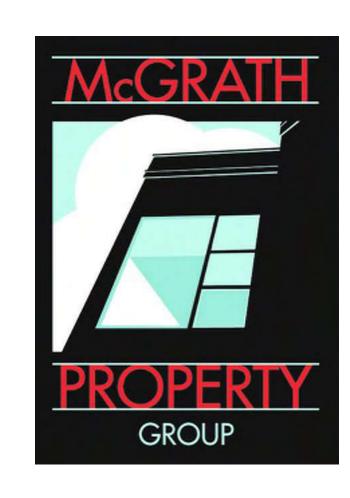

OLIN AVENUE MIXED-USE DEVELOPMENT

LAND USE APPLICATION

PROGRESS DOCUMENTS

These documents reflect progress and intent and may be subject to change, including additional detail. These are not final construction documents and should not be used for final bidding or appetr action related purposes.

DATE OF ISSUANCE MAY 19, 202

REVISION SCHEDULE

Mark Description Date

SHEET TITLE

SITE LOCATION

SHEET NUMBER

G002

Updated:

5/17/2021

| EL 0.0D | TOTAL GROSS | PARKING / | FINISHED NON- | RESIDENTIAL | RESIDENTIAL | COMMERCIAL | EEELOENIOV. | | | | UN | IITS | | | | | PAR | KING PROV | /IDED | |
|------------|-------------|------------|---------------|-------------|-------------|------------|-------------|--------|-------|-------|--------------|-------------|-------|-------|-----|------|-------|-----------|-----------|-----------|
| FLOOR | AREA | UNFINISHED | LEASABLE | AMENITY | LEASABLE | LEASABLE | EFFICENCY | STUDIO | 1BR | 1BR+ | 2BR | 2BR+ | 3BR | TOTAL | BRs | RES. | COMM. | TOTALS | RAT | TIOS |
| 18 | 3,961 | | 3,961 | | | | 0.00% | | | | | | | 0 | 0 | | | 0 | | |
| 17 | 20,442 | | 3,354 | | 17,088 | | 83.59% | 0 | 3 | 3 | 3 | 1 | 3 | 13 | 23 | | | 0 | | · |
| 16 | 20,442 | | 3,354 | | 17,088 | | 83.59% | 0 | 3 | 3 | 3 | 1 | 3 | 13 | 23 | | | 0 | | |
| 15 | 20,907 | | 2,954 | | 17,953 | | 85.87% | 0 | 8 | 1 | 2 | 4 | 2 | 17 | 27 | | | 0 | | |
| 14 | 23,161 | | 3,683 | 1,060 | 18,418 | | 84.10% | 0 | 10 | 2 | 3 | 2 | 2 | 19 | 28 | | | 0 | | |
| 13 | 24,845 | | 3,745 | | 21,100 | | 84.93% | 0 | 19 | 3 | 0 | 4 | 0 | 26 | 30 | | | 0 | | |
| 12 | 24,845 | | 3,745 | | 21,100 | | 84.93% | 0 | 19 | 3 | 0 | 4 | 0 | 26 | 30 | | | 0 | | |
| 11 | 24,845 | | 3,745 | | 21,100 | | 84.93% | 0 | 19 | 3 | 0 | 4 | 0 | 26 | 30 | | | 0 | | |
| 10 | 24,845 | | 3,745 | | 21,100 | | 84.93% | 0 | 19 | 3 | 0 | 4 | 0 | 26 | 30 | | | 0 | | |
| 9 | 24,845 | | 3,745 | | 21,100 | | 84.93% | 0 | 19 | 3 | 0 | 4 | 0 | 26 | 30 | | | 0 | | |
| 8 | 24,845 | | 3,745 | | 21,100 | | 84.93% | 0 | 19 | 3 | 0 | 4 | 0 | 26 | 30 | | | 0 | | |
| 7 | 24,845 | | 3,745 | | 21,100 | | 84.93% | 0 | 19 | 3 | 0 | 4 | 0 | 26 | 30 | | | 0 | | |
| 6 | 24,845 | | 3,745 | | 21,100 | | 84.93% | 0 | 19 | 3 | 0 | 4 | 0 | 26 | 30 | | | 0 | | |
| 5 | 24,731 | | 4,173 | 2,585 | 17,973 | | 83.13% | 0 | 11 | 3 | 1 | 5 | 0 | 20 | 26 | | | 0 | | |
| SUB-TOTALS | 312,404 | 0 | 51,439 | 3,645 | 257,320 | 0 | 83.53% | | | | | | | | | | | | | |
| 4 / P4 | 39,497 | 29,414 | 3,085 | 1,503 | | 5,517 | | | | COM | IMERCIAL - | OFFICE SPAC | CE #2 | | | 86 | | 86 | | |
| 3 / P3 | 37,994 | 29,414 | 3,085 | | | | | | | | | | | | | 88 | | 88 | | |
| 2 / P2 | 37,994 | 29,414 | 3,085 | | | 5,517 | | | | COM | IMERCIAL - | OFFICE SPAC | CE #1 | | | 88 | | 88 | | |
| | | | | 6,005 | | | | | | RE | SIDENTIAL I | ENTRY / LOB | BBY | | | | 3 | | 5 GUEST | SPACES |
| 1/P1 | 38,914 | 24,654 | 3,685 | | | | | | | | | | | | | | | 45 | | |
| | | | | | | 4,951 | | | | COMM | 1ERCIAL - RI | ESTAURANT | SPACE | | | 27 | 15 | | 3.0 PER 1 | 1,000 S.F |
| 1/PLL | 10,134 | 10,134 | | | | | | | | | | | | | | | 29 | 29 | PER UNIT | PER BI |
| TOTALS | 476,937 | 123,030 | 64,379 | 11,153 | 257,320 | 15,985 | | 0 | 187 | 36 | 12 | 45 | 10 | 290 | 367 | 289 | 47 | 336 | 1.16 | 0.92 |
| | | | | | | | | 0.0% | 64.5% | 12.4% | 4.1% | 15.5% | 3.4% | | | | | | | |

NOTES:

- GROSS AREA IS TO OUTSIDE FACE OF STRUCTURE/FRAMING AND DOES NOT INCLUDE EXTERIOR FINISH MATERIAL.
- INCLUDES ALL EGRESS STAIRS, CORRIDORS, ELEVATOR LOBBIES, MECH/STORAGE ROOMS ON RESIDENTIAL LEVELS, ETC.
- 1ST FLOOR AMENITY SPACE INCLUDES LOBBY, LEASING, ELEVATORS, STAIRS, MOVE-IN, AND MAIL/PARCEL. IT DOES NOT INCLUDE BIKE STORAGE.
- OPEN TO BELOW AREA @ 3-FLOOR SPACE TO BE INCLUDED WITH THE OVERALL AREA OF THE 2nd FLOOR OFFICE SPACE.
- 5) PER CITY OF MADISON BIKE PARKING ORDINANCE; RESIDENTIAL: (324) TOTAL BIKE STORAGE SPACES ARE REQUIRED – 295 RESIDENTIAL & 29 GUEST SPACES. COMMERCIAL: (17) TOTAL BIKE STORAGE SPACES ARE REQUIRED – 11 FUTURE RESTAURANT & 6 FUTURE OFFICE SPACES. TOTAL REQURED FOR THE FACILITY: (341)

**CURRENT DESIGNED BIKE SPACES = (348)

BUILDING DATA

NOTE:

AREAS NOTED ON THESE DOCUMENTS ARE CONCEPTUAL AND SHOULD NOT BE USED FOR CONSTRUCTION COST ESTIMATING PURPOSES. CONTRACTORS SHOULD PERFORM THEIR OWN 'TAKE-OFFS' TO CONFIRM/VERIFY AREAS AND CONTACT JLA ARCHITECTS IF ANY DISCREPANCIES ARE DISCOVERED.

OLIN AVENUE MIXED-USE DEVELOPMENT – LAND USE APPLICATION


MAY 19, 2021 3/32"=1' @ 30x42

PLAN TRUE NORTH NORTH

MADISON : MILWAUKEE

jla-ap.com

JLA PROJECT NUMBER:

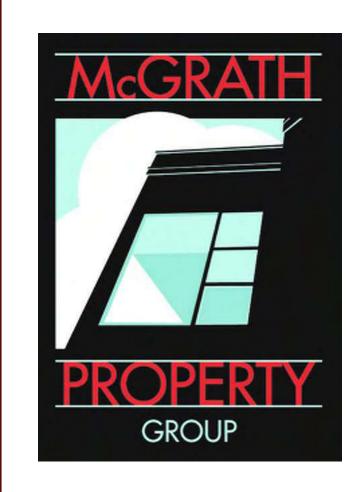

OLIN AVENUE MIXED-USE DEVELOPMENT


LAND USE APPLICATION

PROGRESS DOCUMENTS

DATE OF ISSUANCE REVISION SCHEDULE

BUILDING DATA


G003

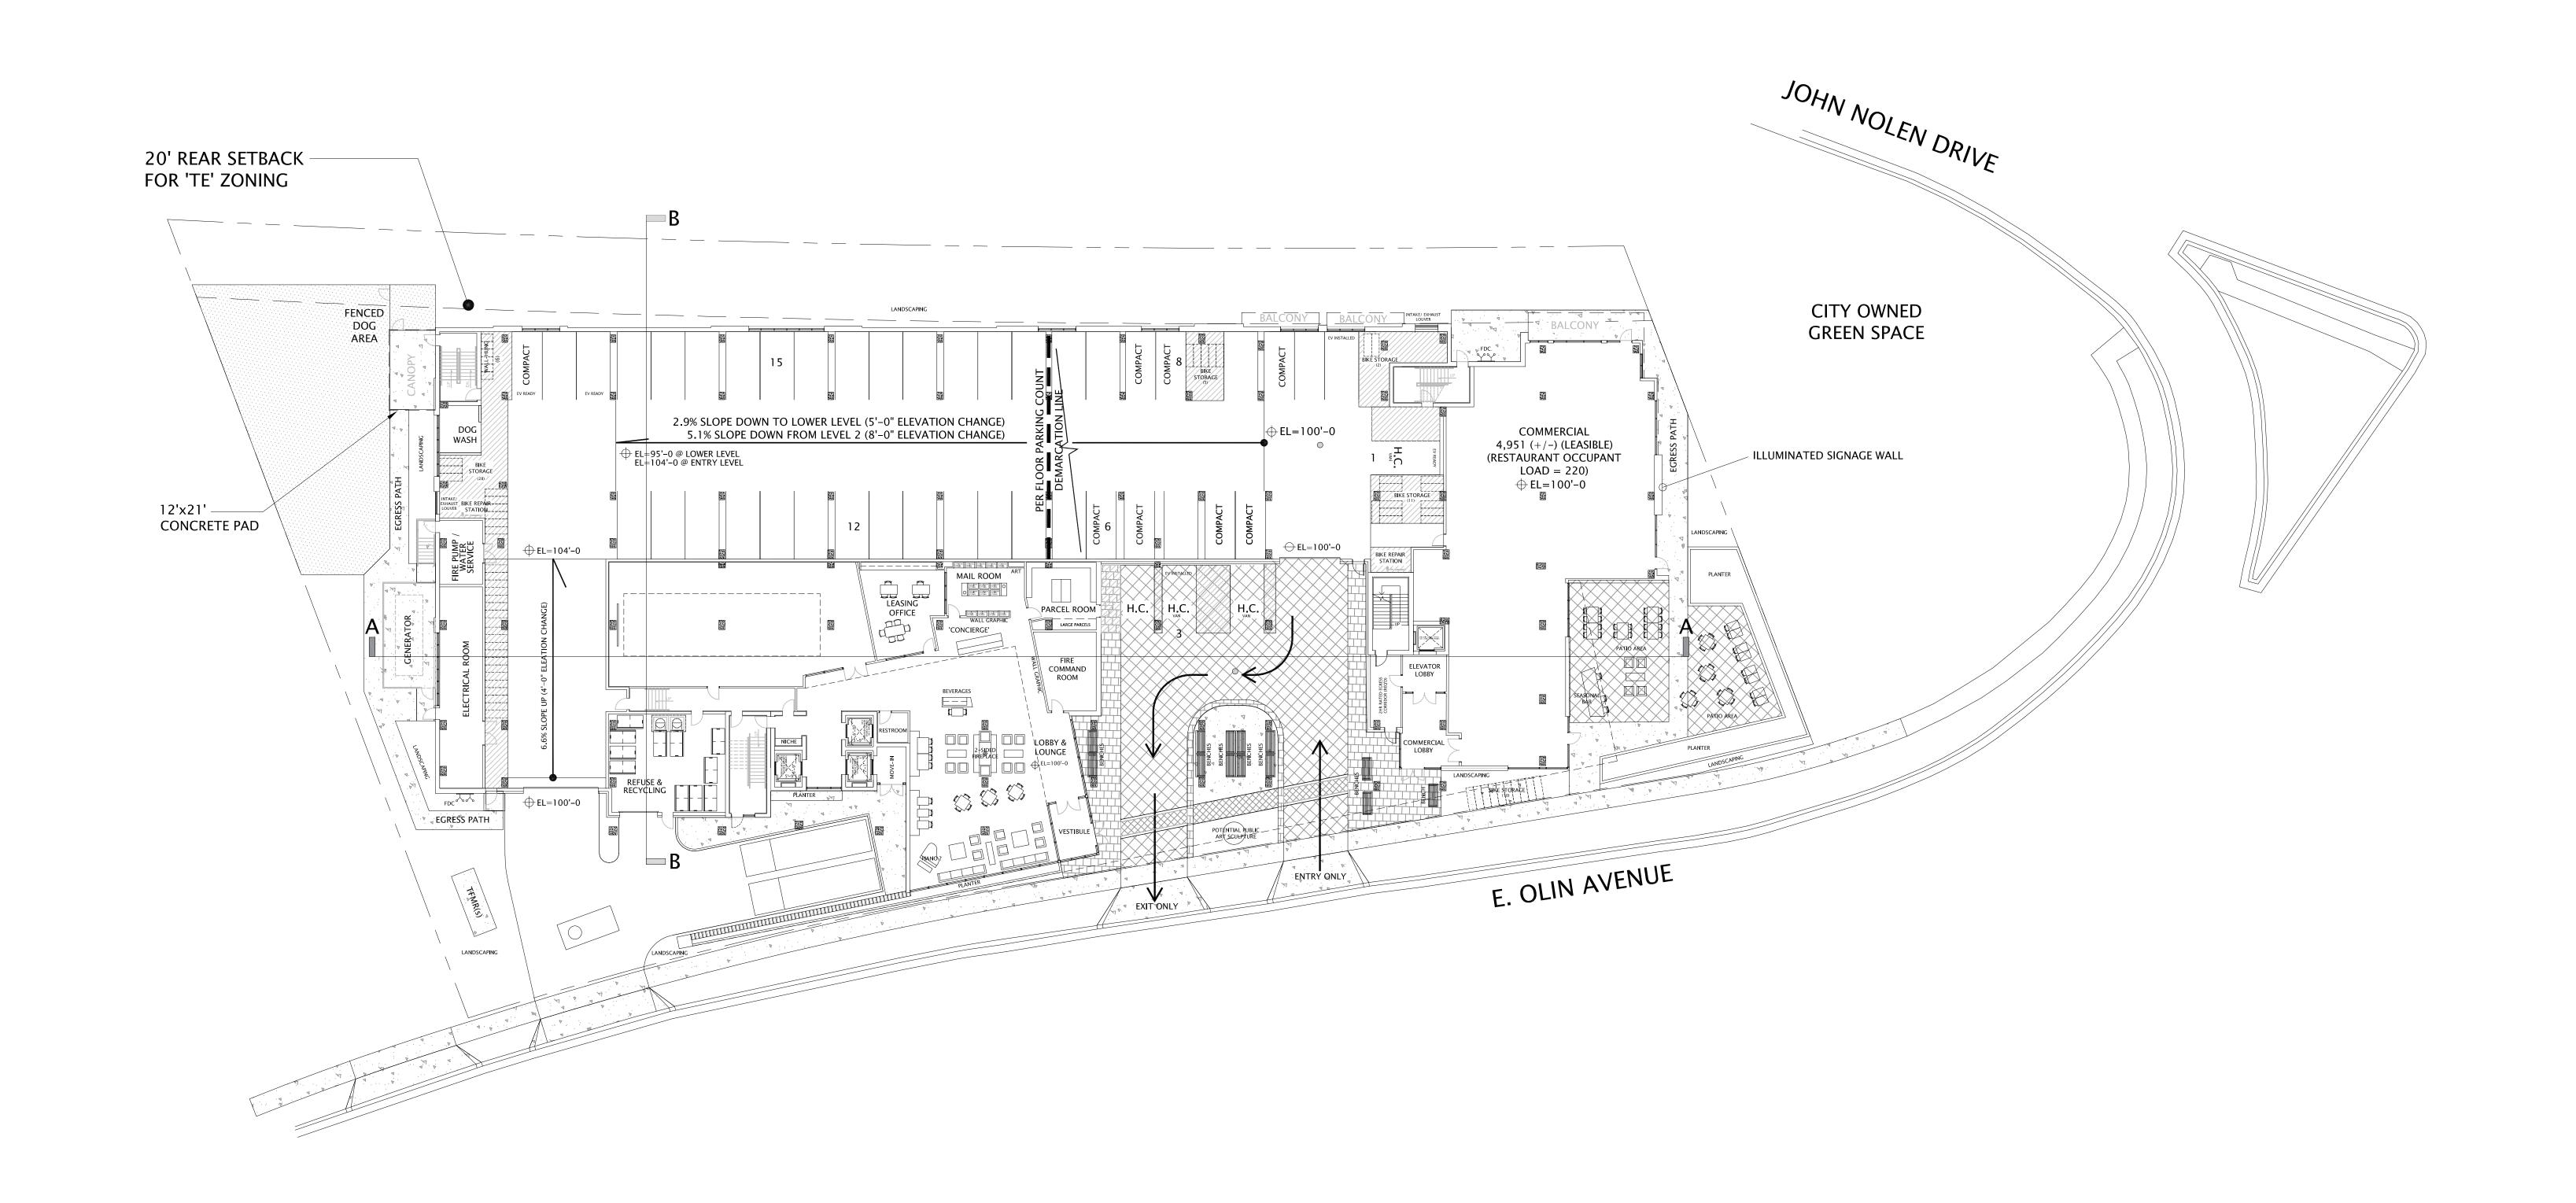

OLIN AVENUE MIXED-USE DEVELOPMENT – LAND USE APPLICATION

ARCHITECTURAL SITE LAYOUT PLAN


MAY 19, 2021 1"=20' @ 30x42

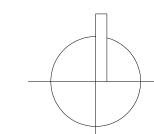

PLAN TRUE NORTH NORTH



JLA PROJECT NUMBER:

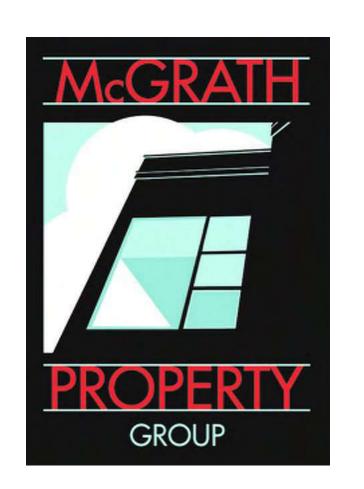

OLIN AVENUE MIXED-USE DEVELOPMENT

LAND USE APPLICATION

PROGRESS DOCUMENTS

These documents reflect progress and intent and may be subject to change, including additional detail. These are not final construction documents and should not be used for final bidding or

DATE OF ISSUANCE MAY 19, 202

REVISION SCHEDULE

Mark Description Date


ARCHITECTURAL SITE
LAYOUT PLAN

Sheet number


ASP-100

222-232 E. OLIN AVENUE

CITY OF MADISON, WISCONSIN

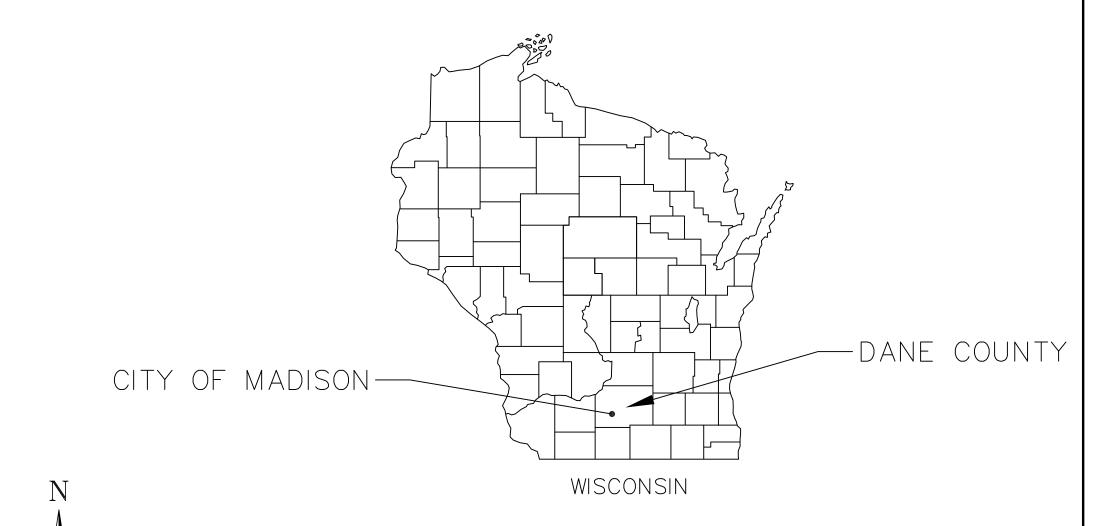



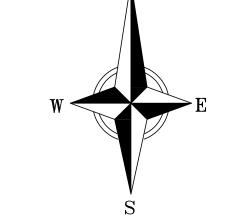

PROJECT LOCATION

ACCESS TO WINGRA-CREEK BIKE PATH

Franklin Field

Turville I Quann Park Expo Mall E

| $\vdash Z \overset{\sim}{\Sigma}$ | ⊣∟ | | |
|-----------------------------------|-----------|-------------------------------------|----------|
| SHEET 2 E. OLIN 7 MADIS(| ╛ | SHEET NO. DESCRIPTION | SHEET NO |
| E SH 232 e. Of M | | C000 TITLE SHEET | C000 |
| TITLE S 222-232 CITY OF | J⊨ | C100 EXISTING CONDITIONS PLAN | C100 |
| | | C200 DEMOLITION PLAN | C200 |
| NS REMARKS | S | C300 SITE PLAN | C300 |
| /ISICN | L L | C400 GRADING & EROSION CONTROL PLAN | C400 |
| DATE | RE | C401 GRADING DETAIL PLAN | C401 |
| Ö Z | | C500 UTILITY PLAN | C500 |
| S | | C501 UTILITY ALTERNATE PLAN | C501 |
| NS REMARKS | SN | C600 CONSTRUCTION DETAILS - 1 | C600 |
| | REVISIONS | C601 CONSTRUCTION DETAILS - 2 | C601 |
| DATE | 2 | C602 CONSTRUCTION DETAILS - 3 | C602 |
| O Z | DAI | L100 LANDSCAPE PLAN | L100 |
| 05-19-2021 DRAFTER | 0 | L101 LANDSCAPE PLAN — ROOF AREAS | L101 |

LANDSCAPE PLAN DETAILS

NOT FOR CONSTRUCTION C000


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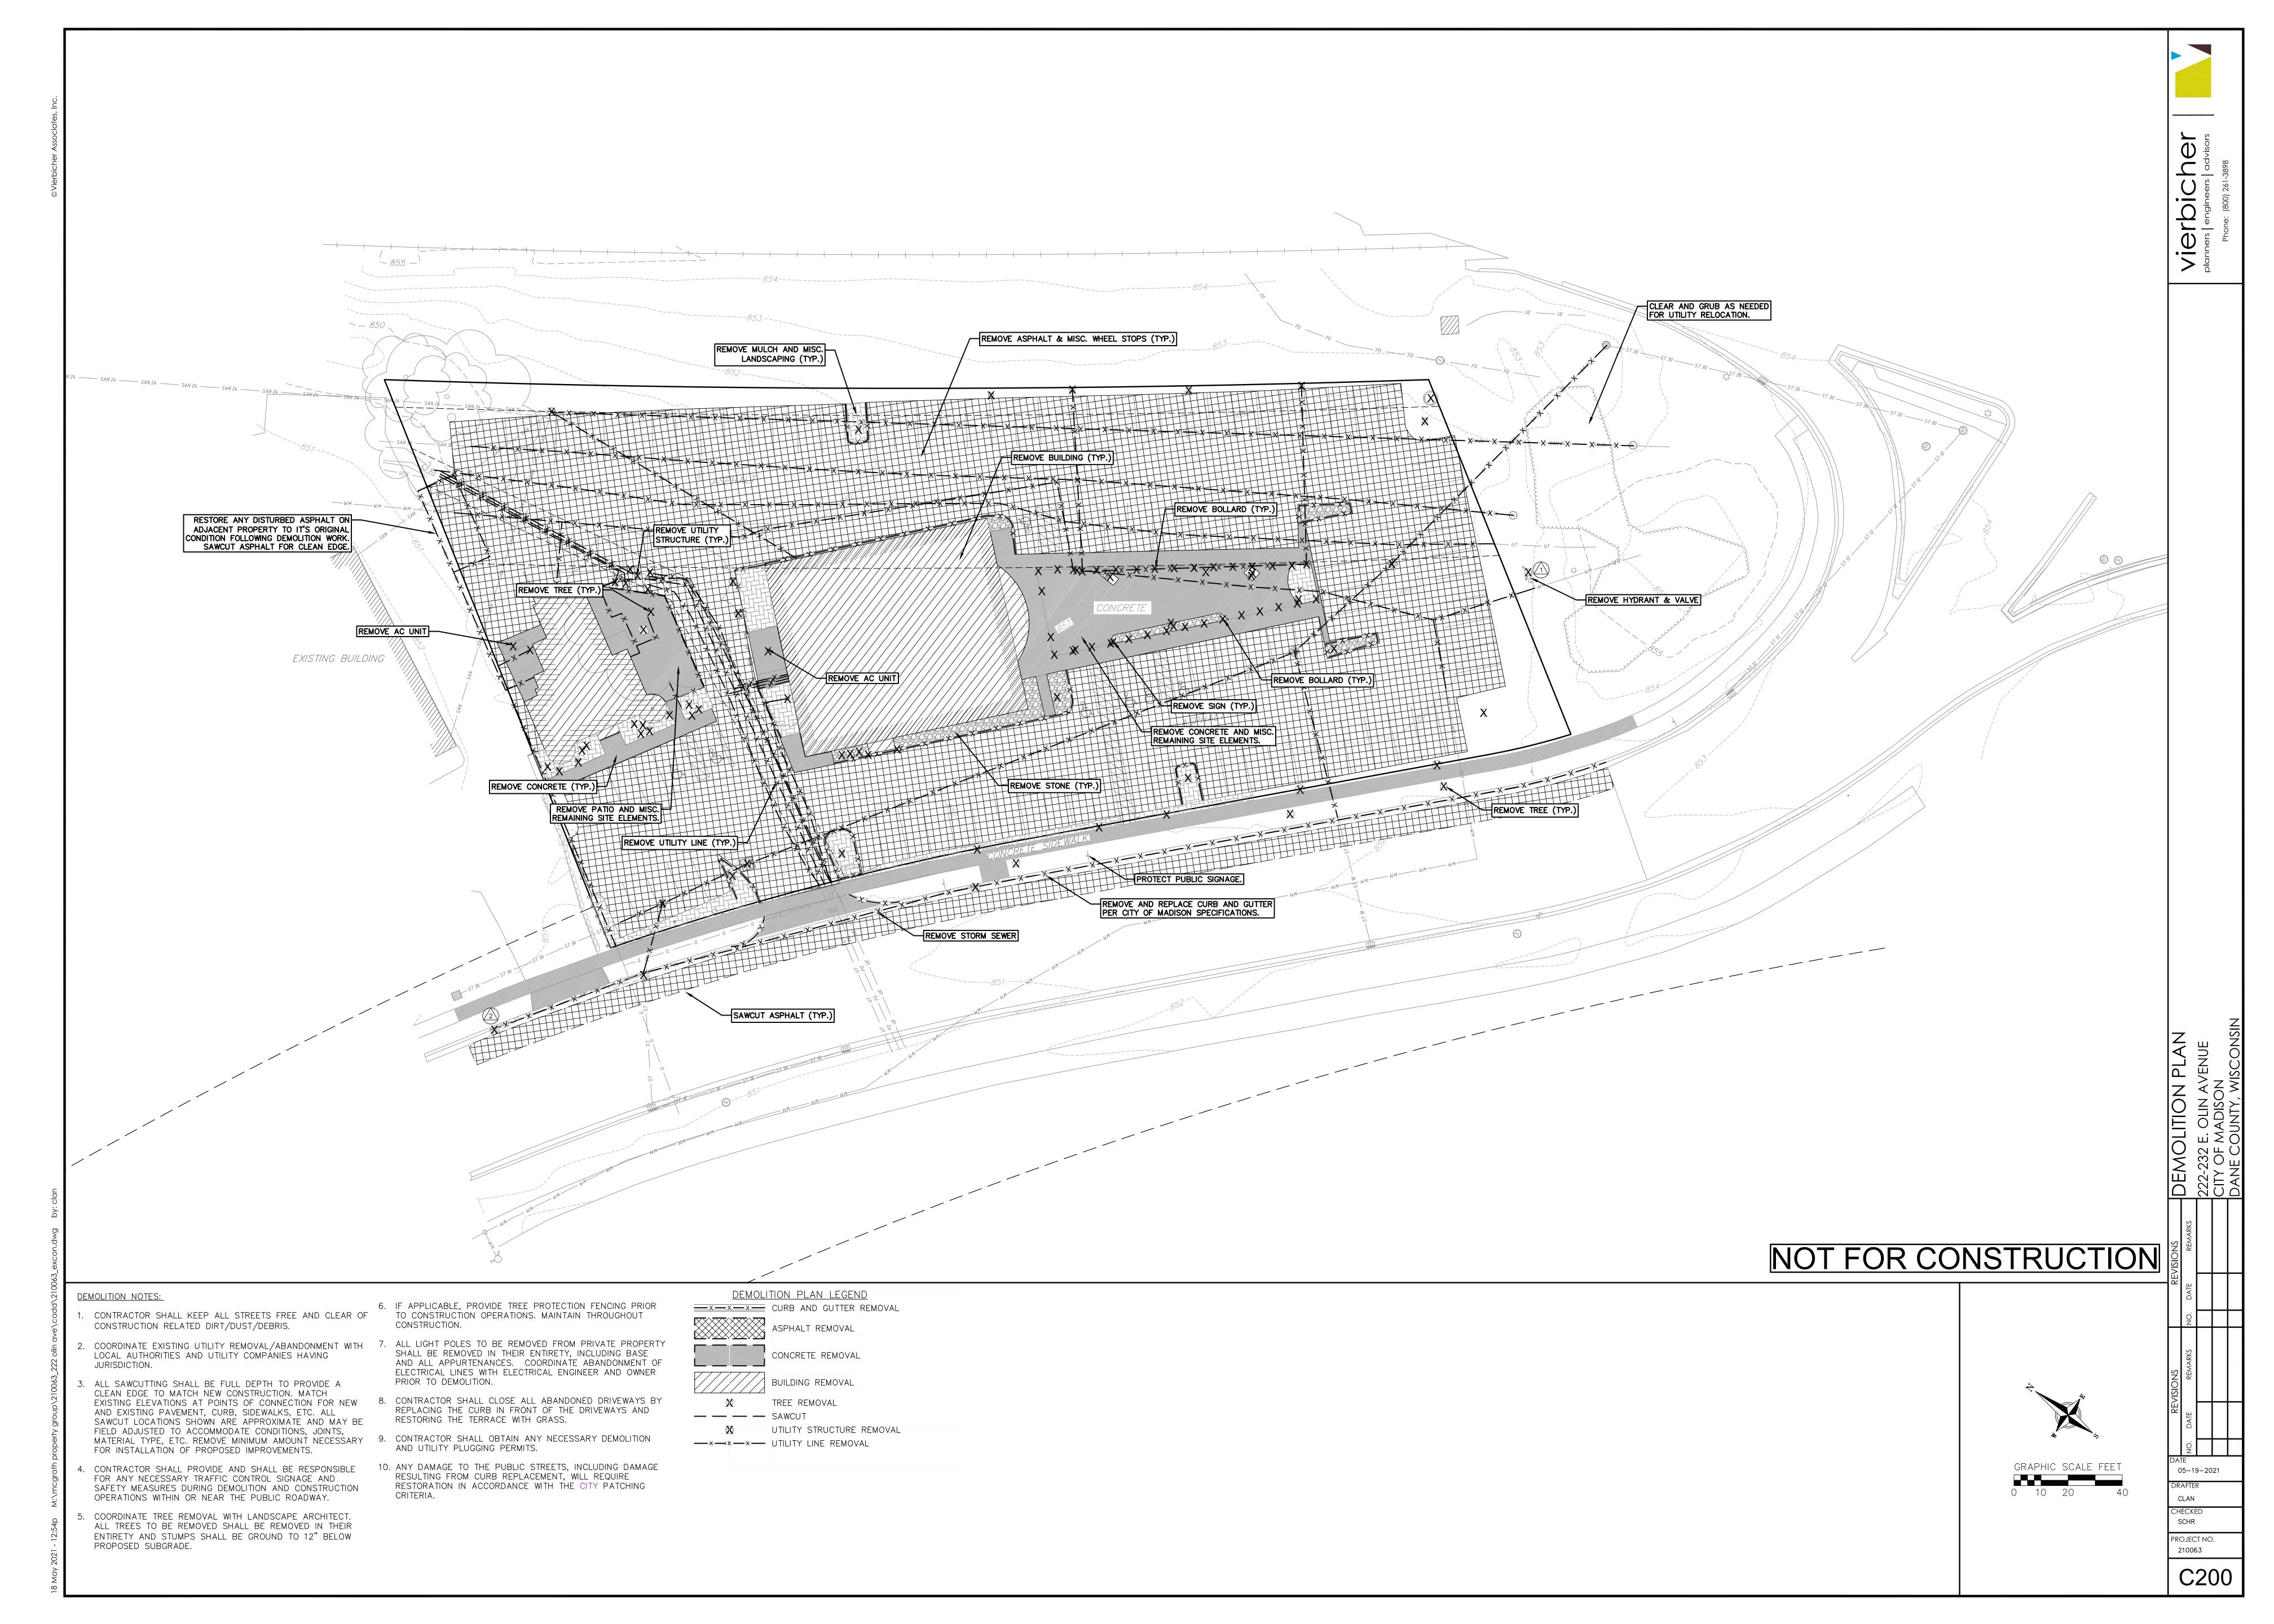
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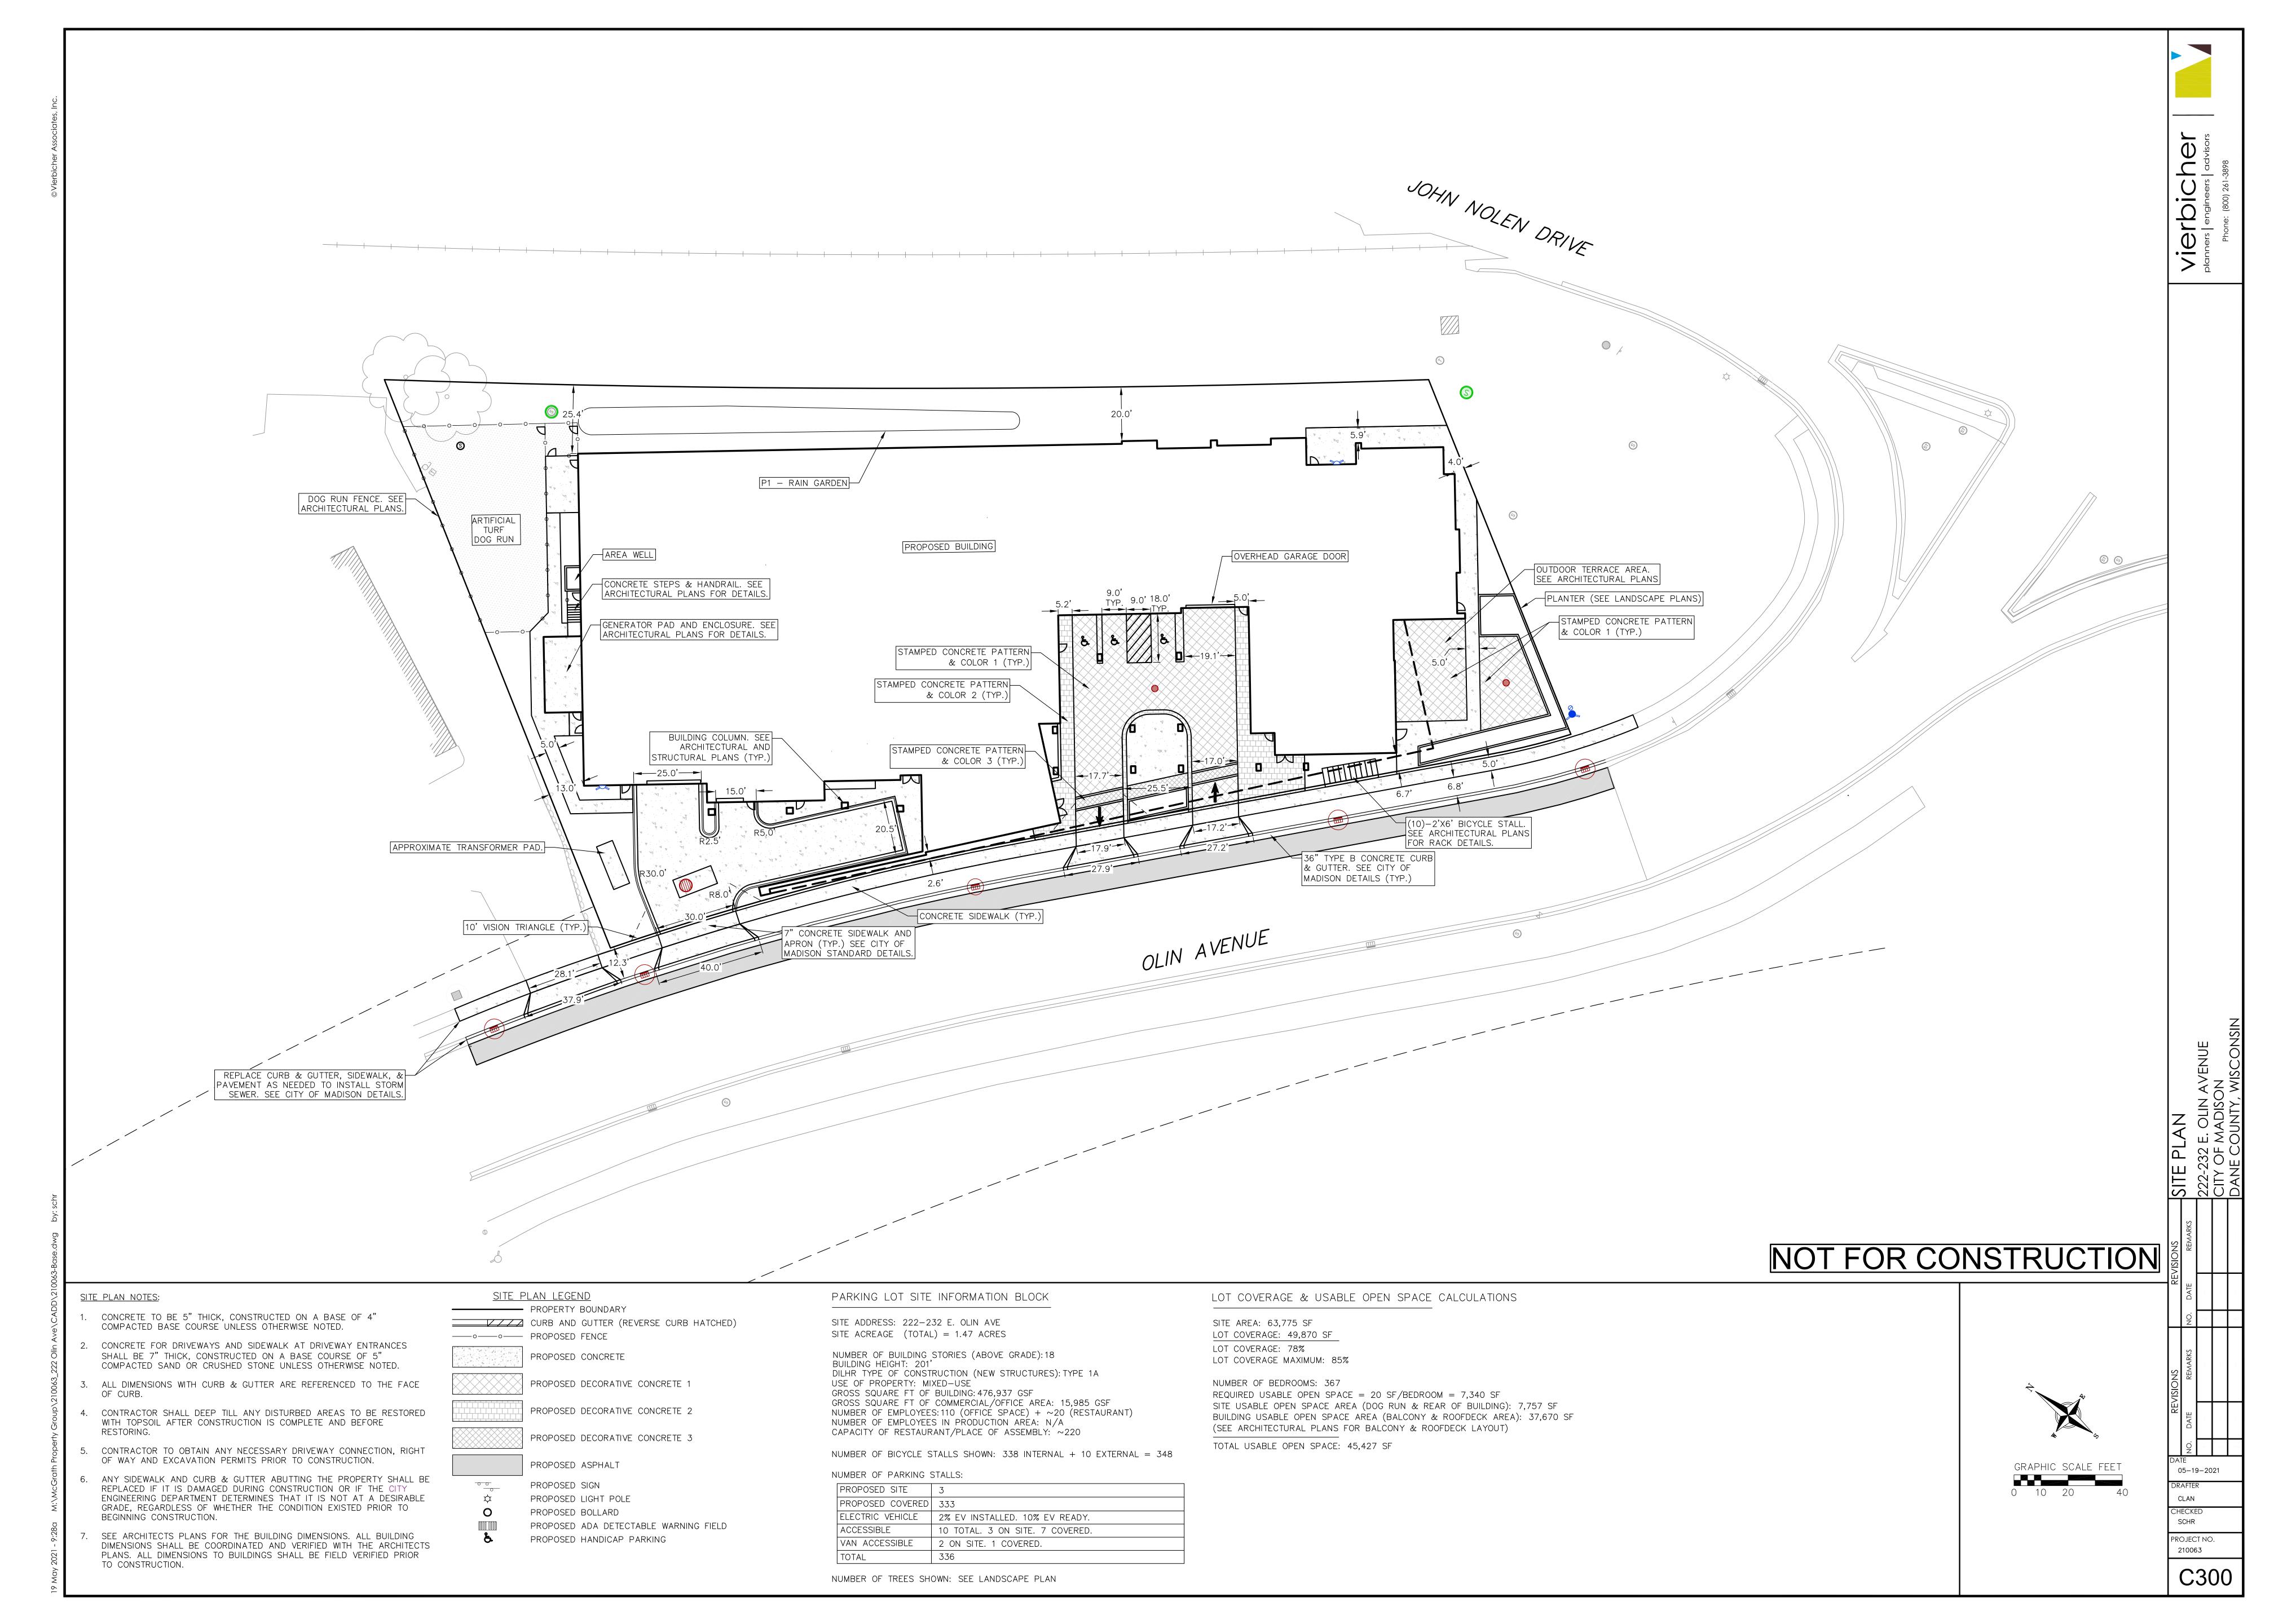
PROJECT NO. 210063


Dial or (800) 242-8511 www.DiggersHotline.com THE LOCATION OF EXISTING UTILITIES, BOTH UNDERGROUND AND OVERHEAD ARE APPROXIMATE ONLY AND HAVE NOT BEEN


INDEPENDENTLY VERIFIED BY THE OWNER OR ITS REPRESENTATIVE. THE CONTRACTOR SHALL BE RESPONSIBLE FOR DETERMINING THE EXACT LOCATION OF ALL EXISTING UTILITIES WHETHER SHOWN ON THESE PLANS OR NOT, BEFORE COMMENCING WORK, AND SHALL BE FULLY RESPONSIBLE FOR ANY AND ALL DAMAGES WHICH MIGHT BE CAUSED BY THE CONTRACTOR'S FAILURE TO EXACTLY LOCATE AND PRESERVE ANY AND ALL UTILITIES. CALL DIGGER'S HOTLINE 1-800-242-8511







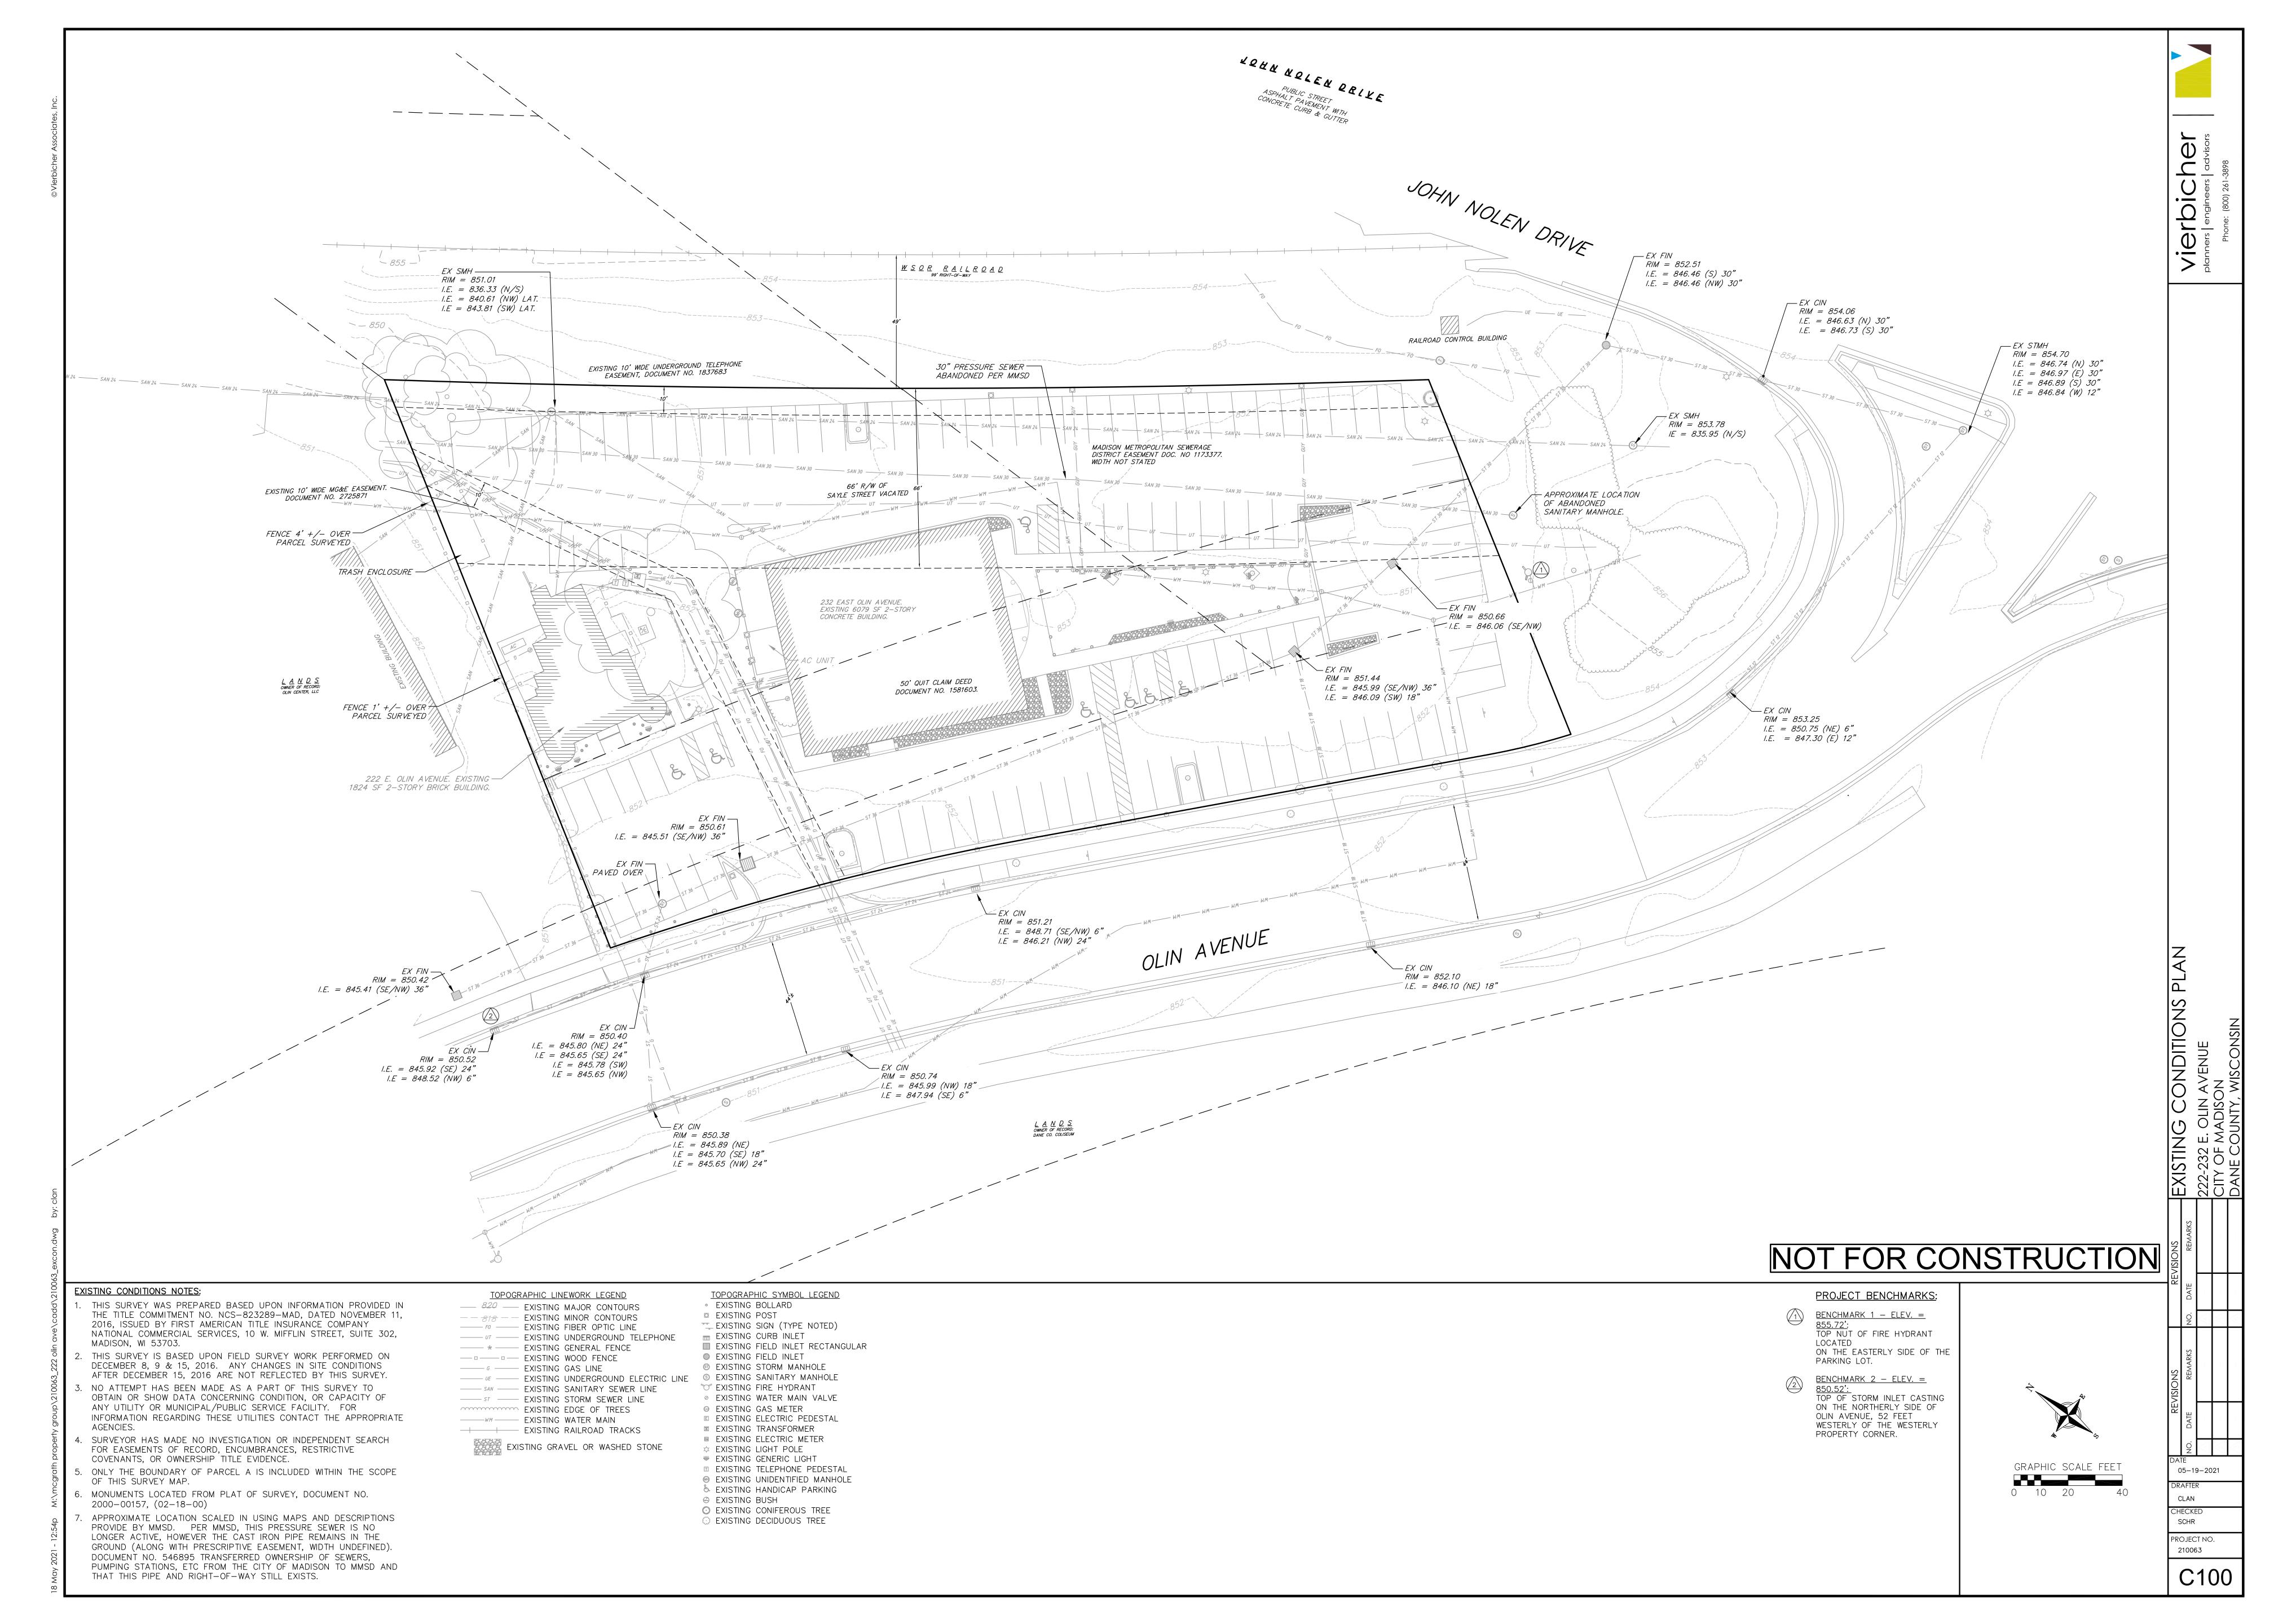

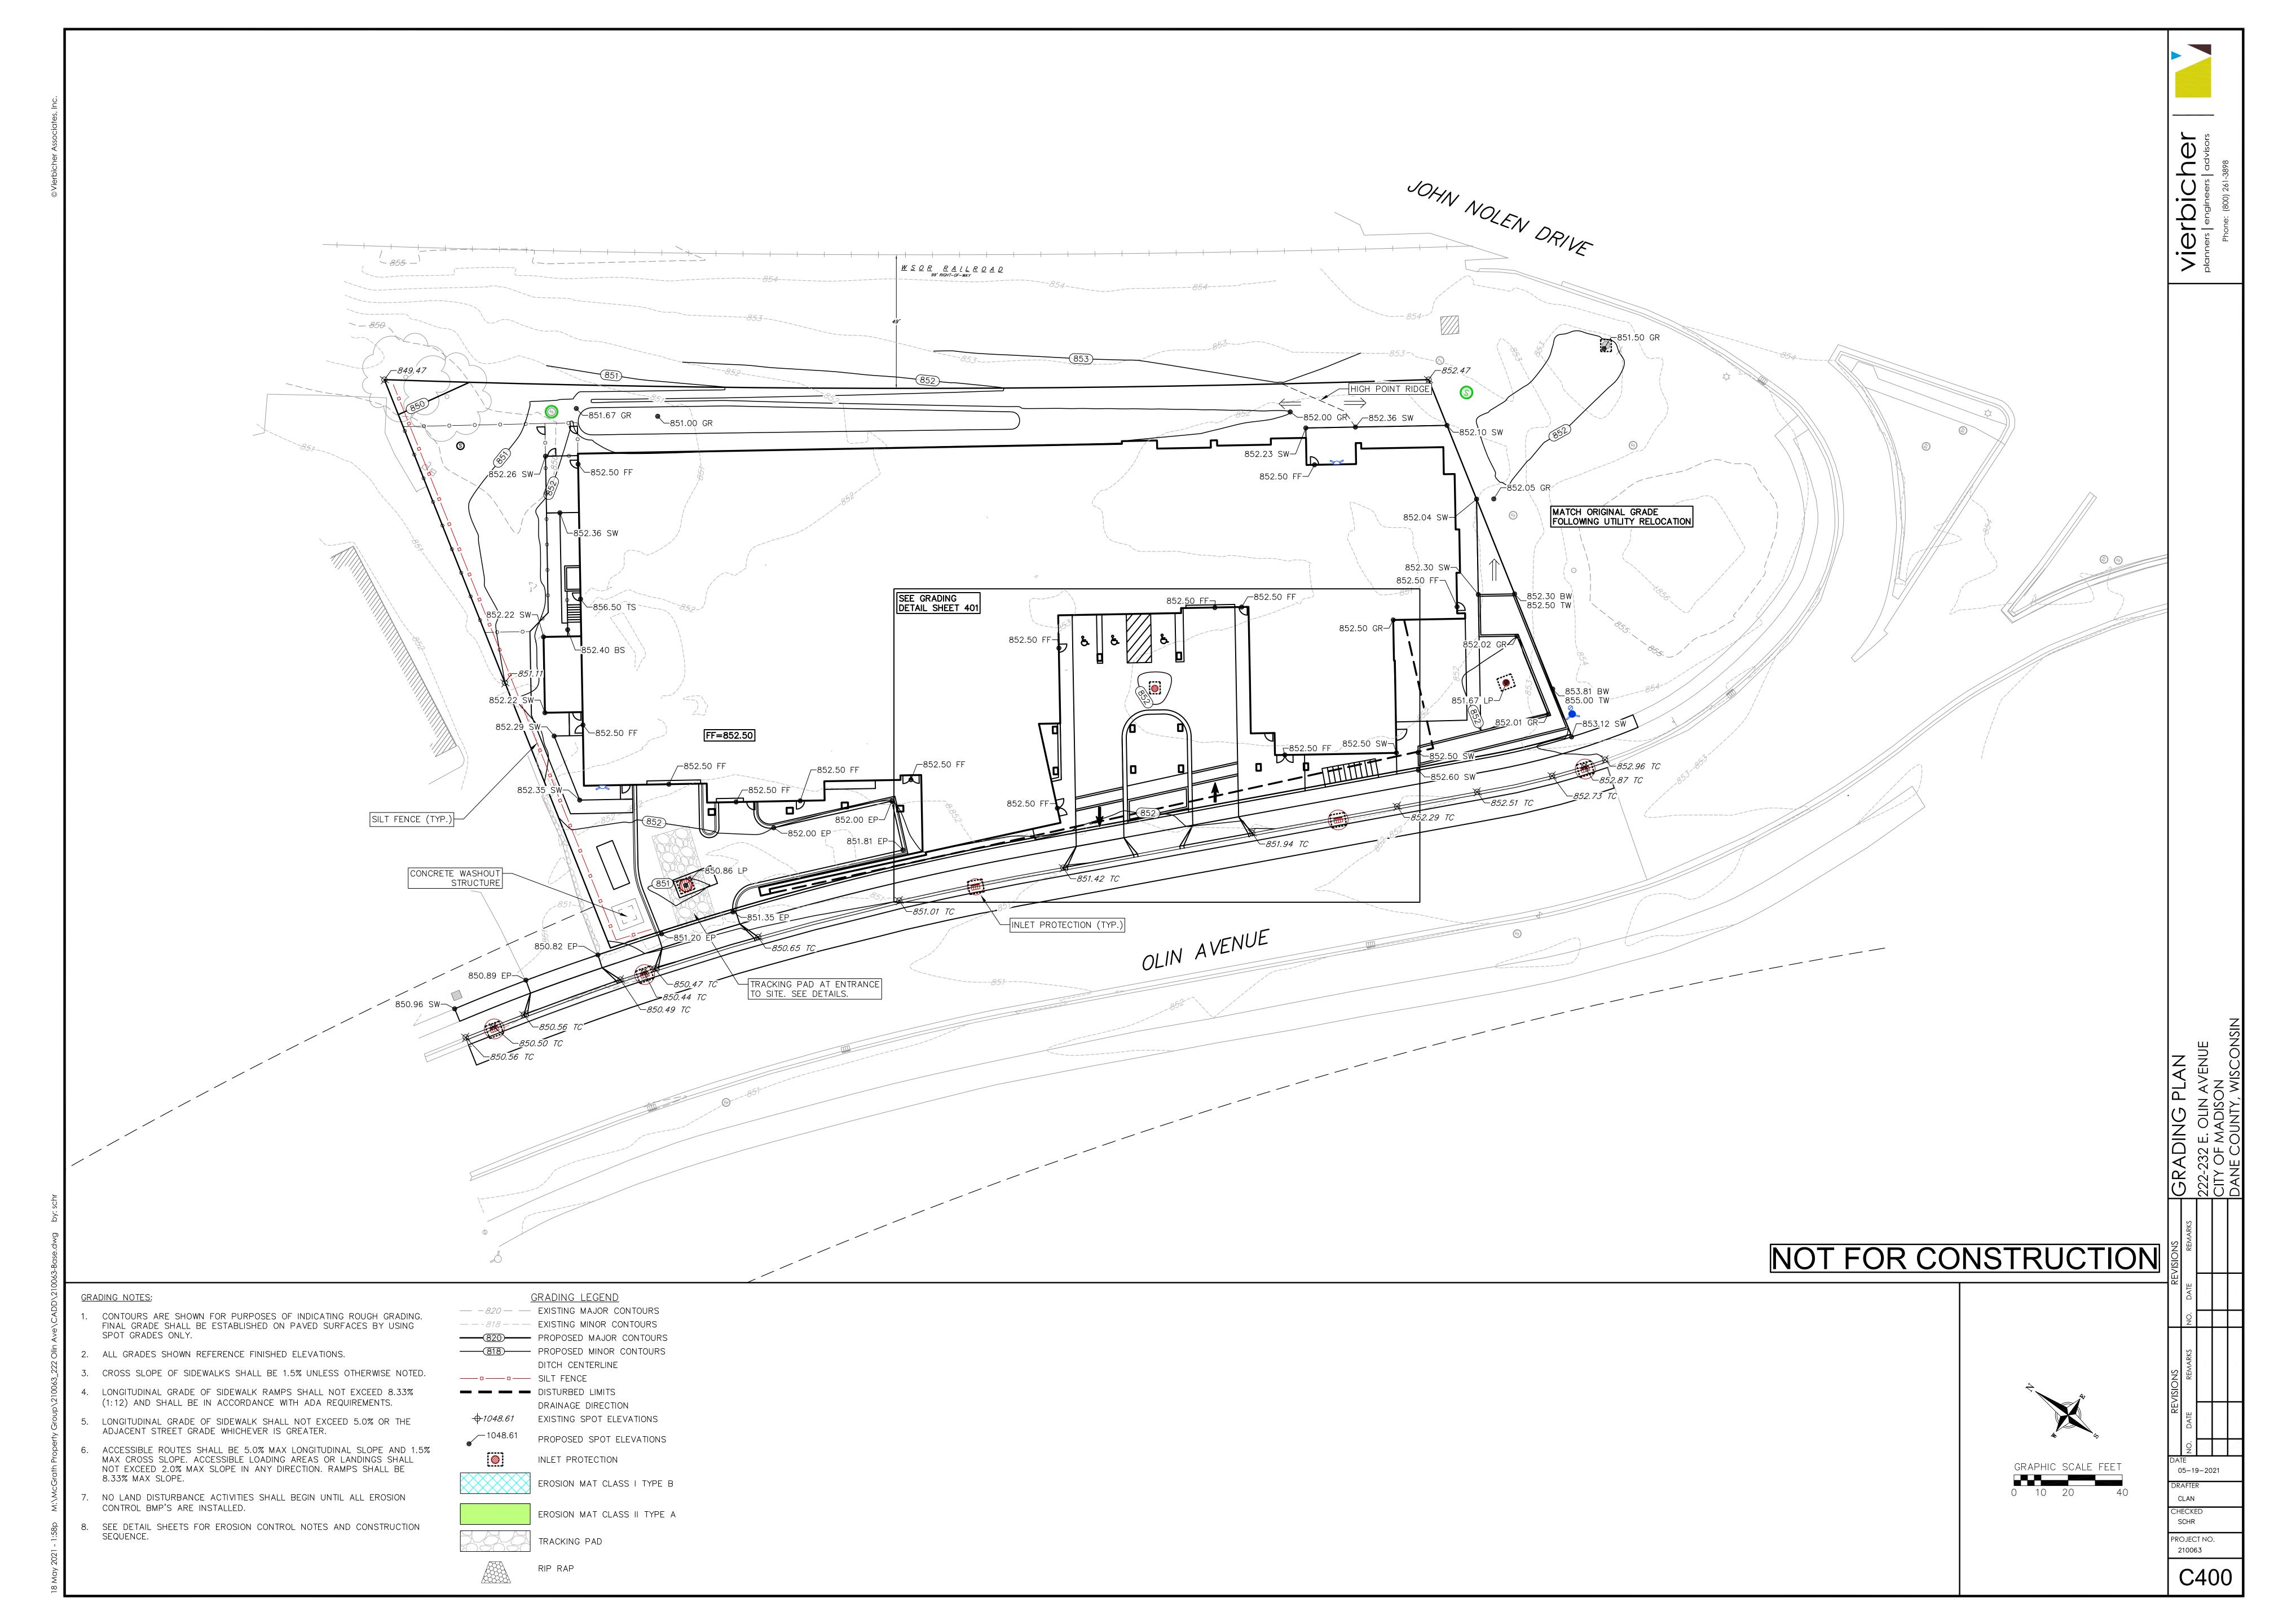

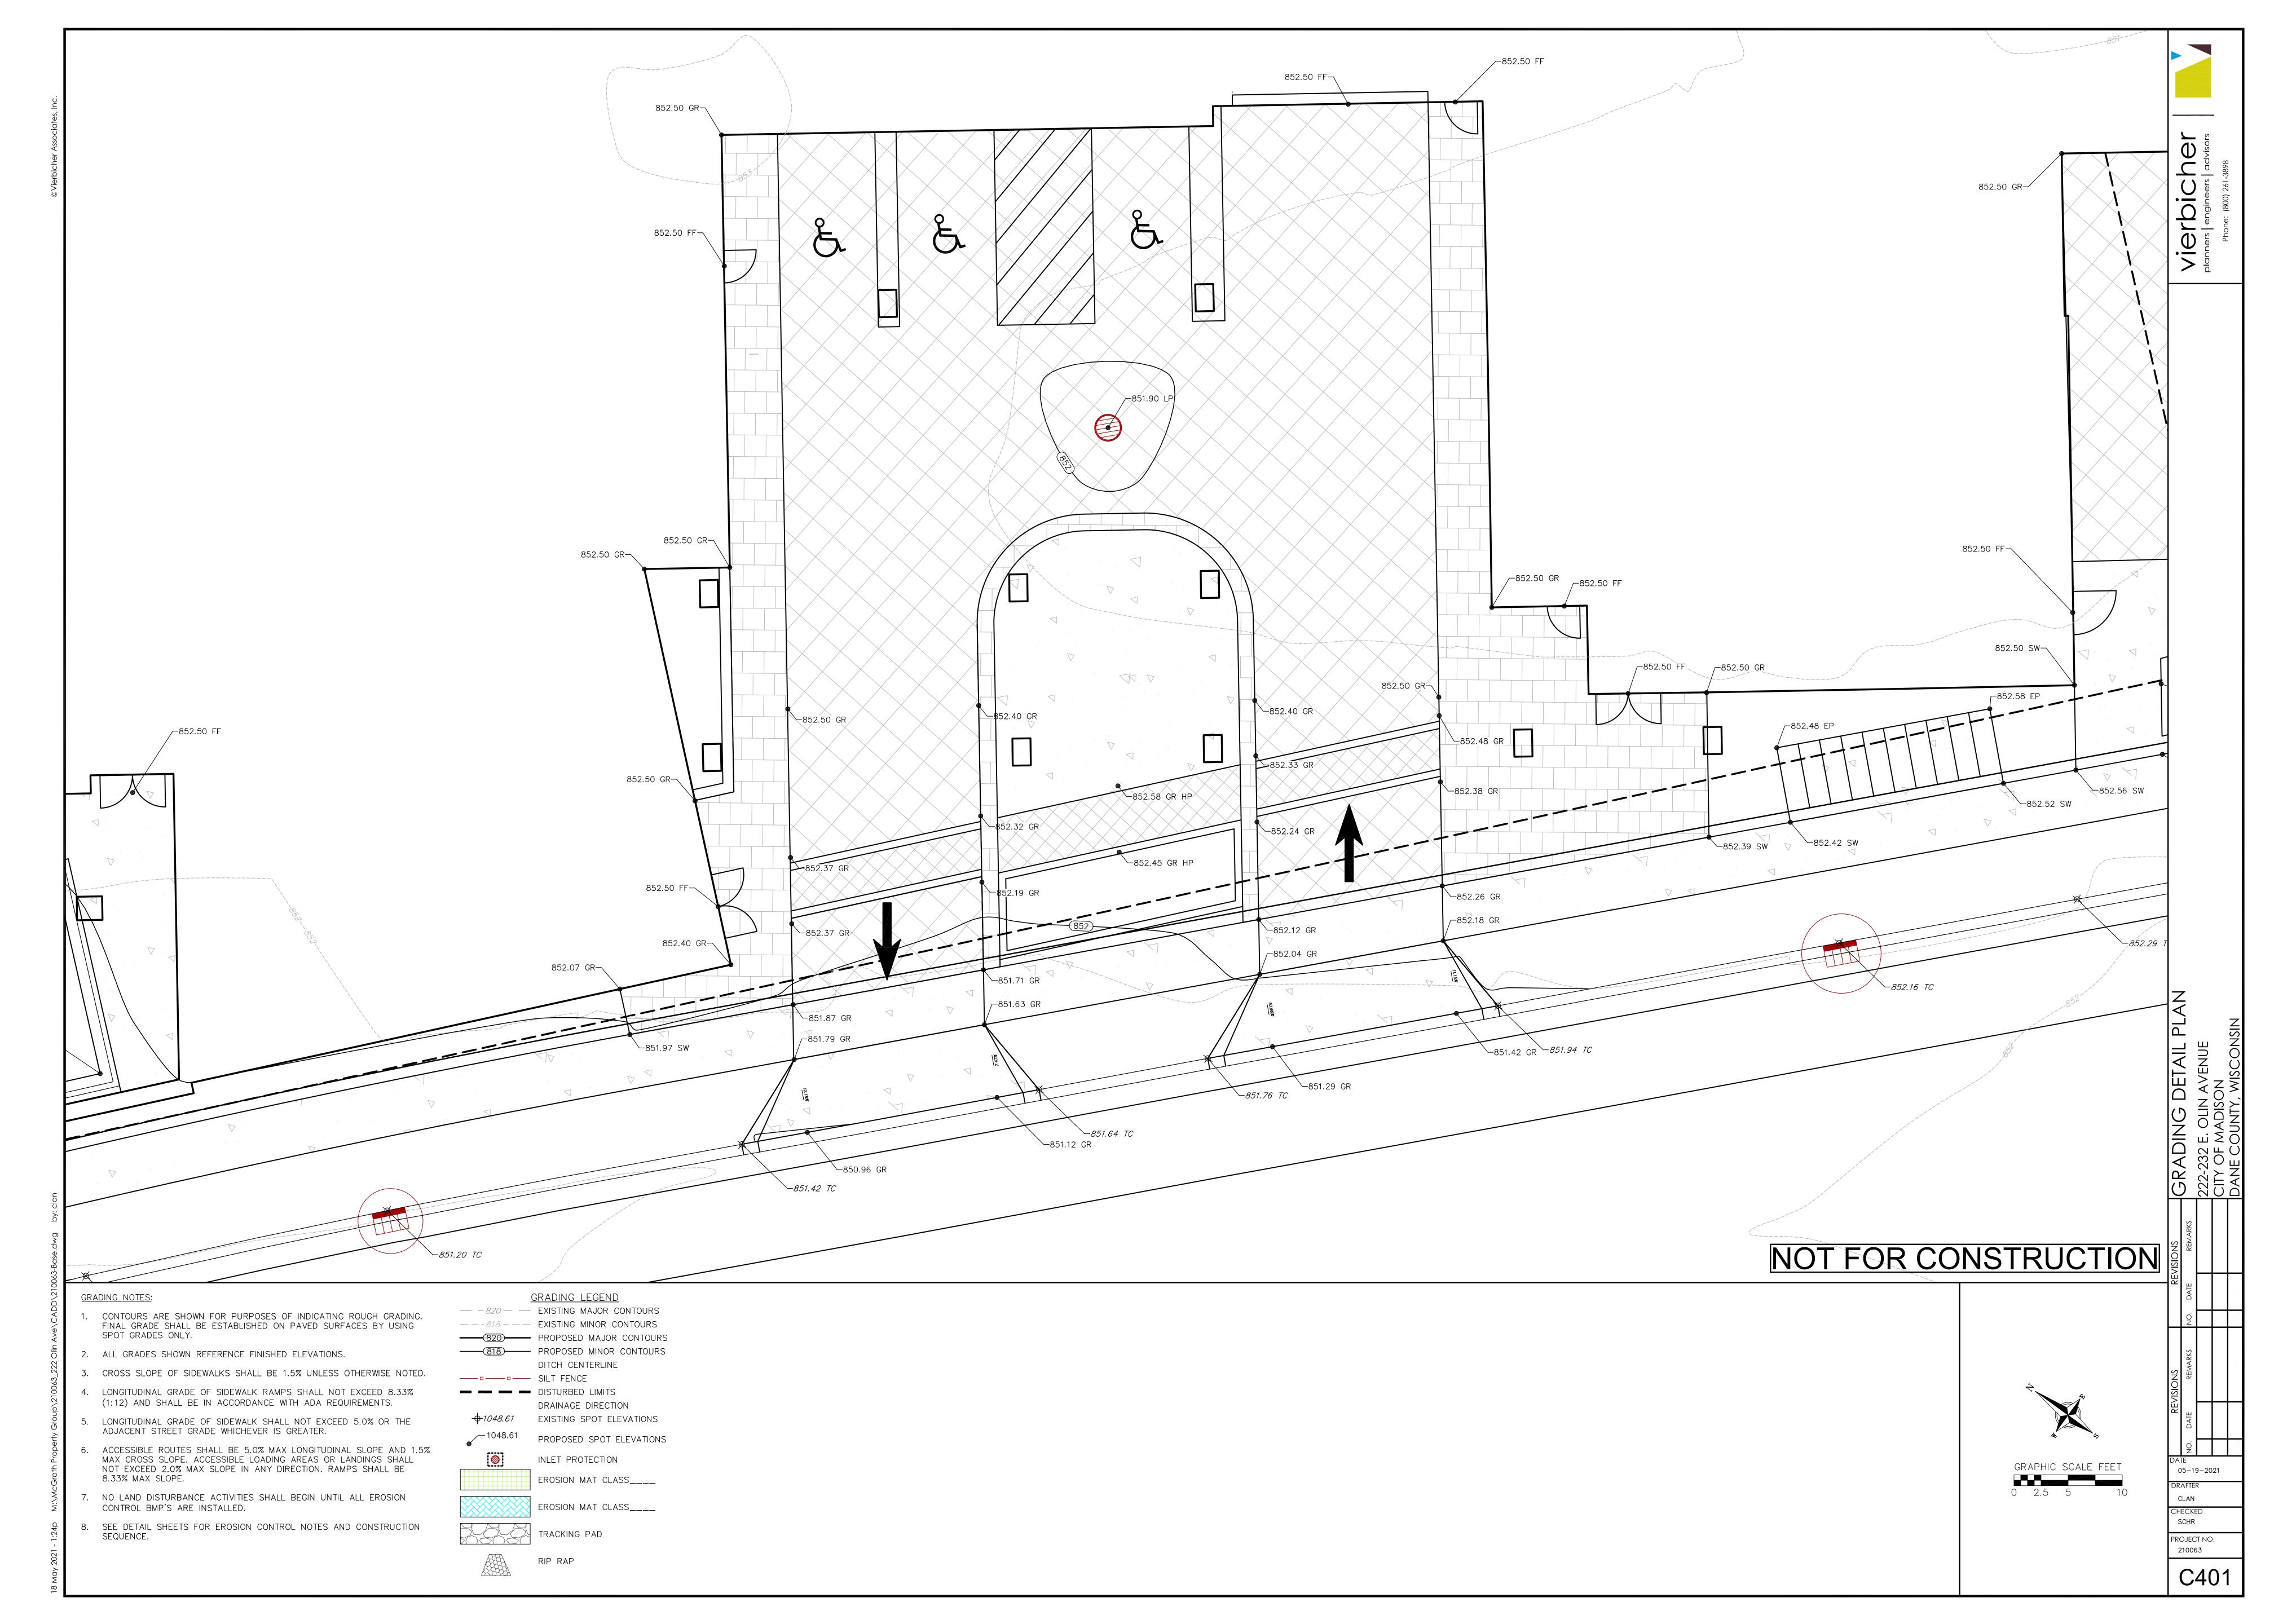

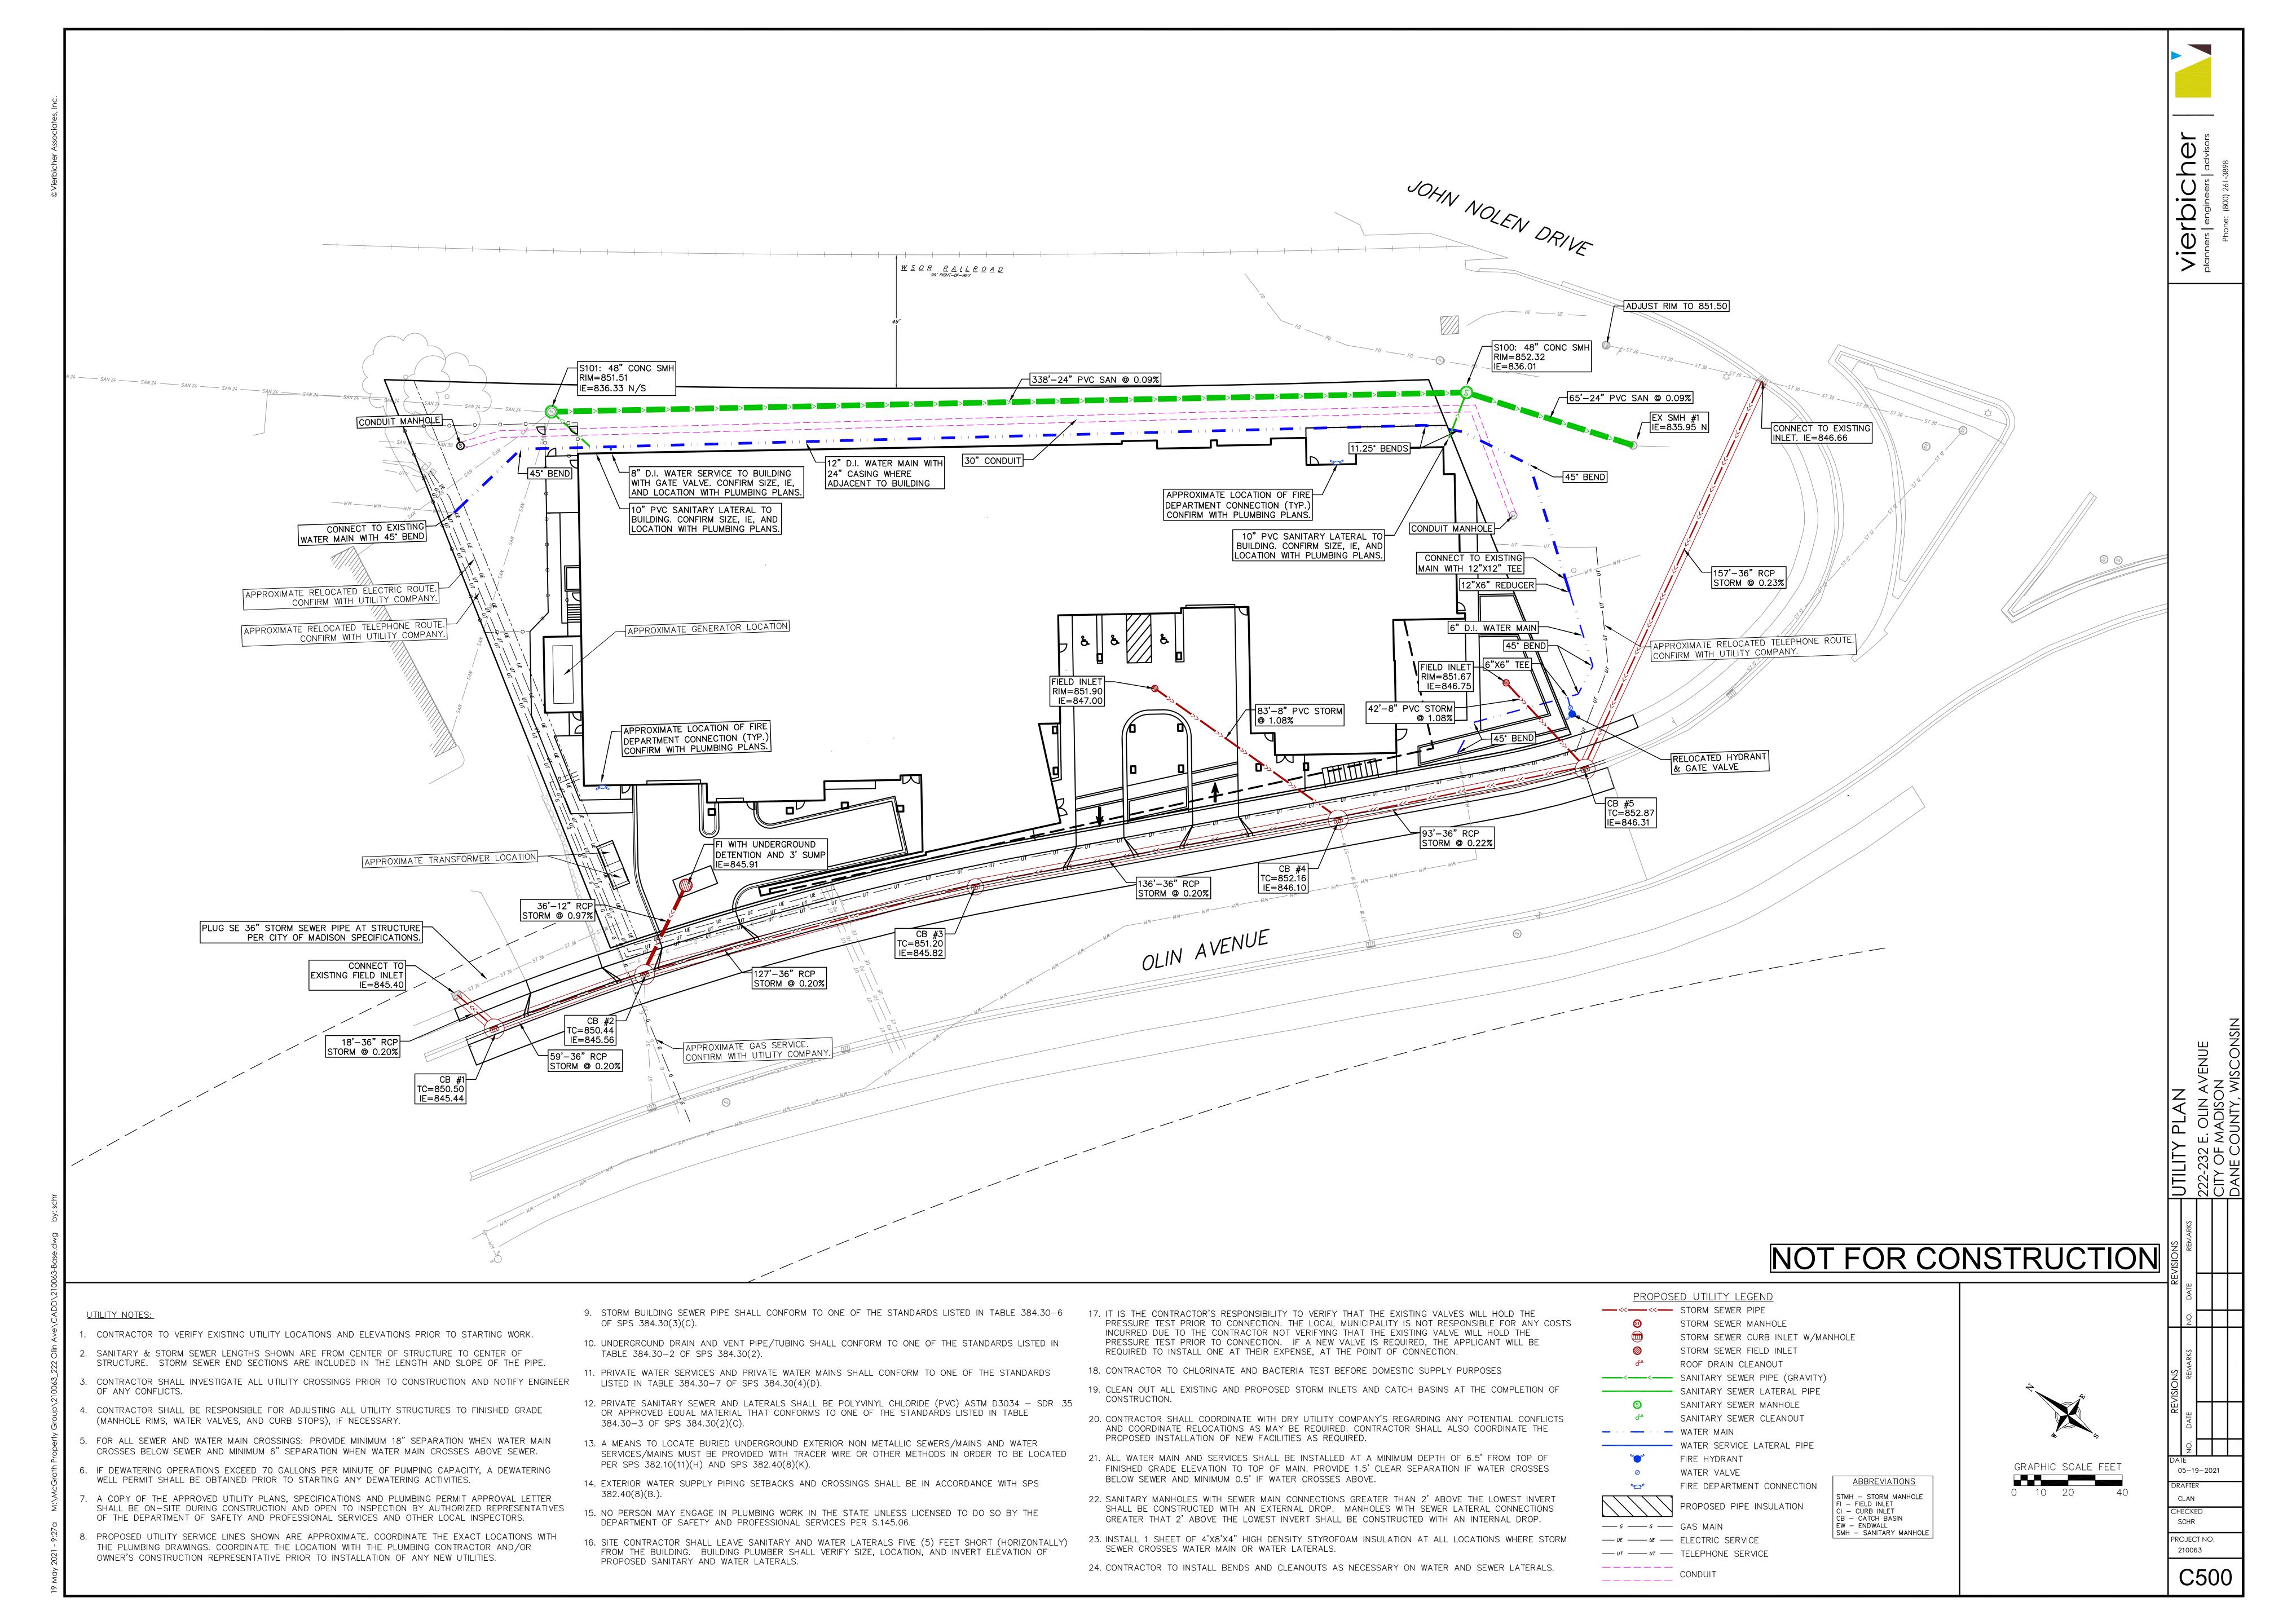

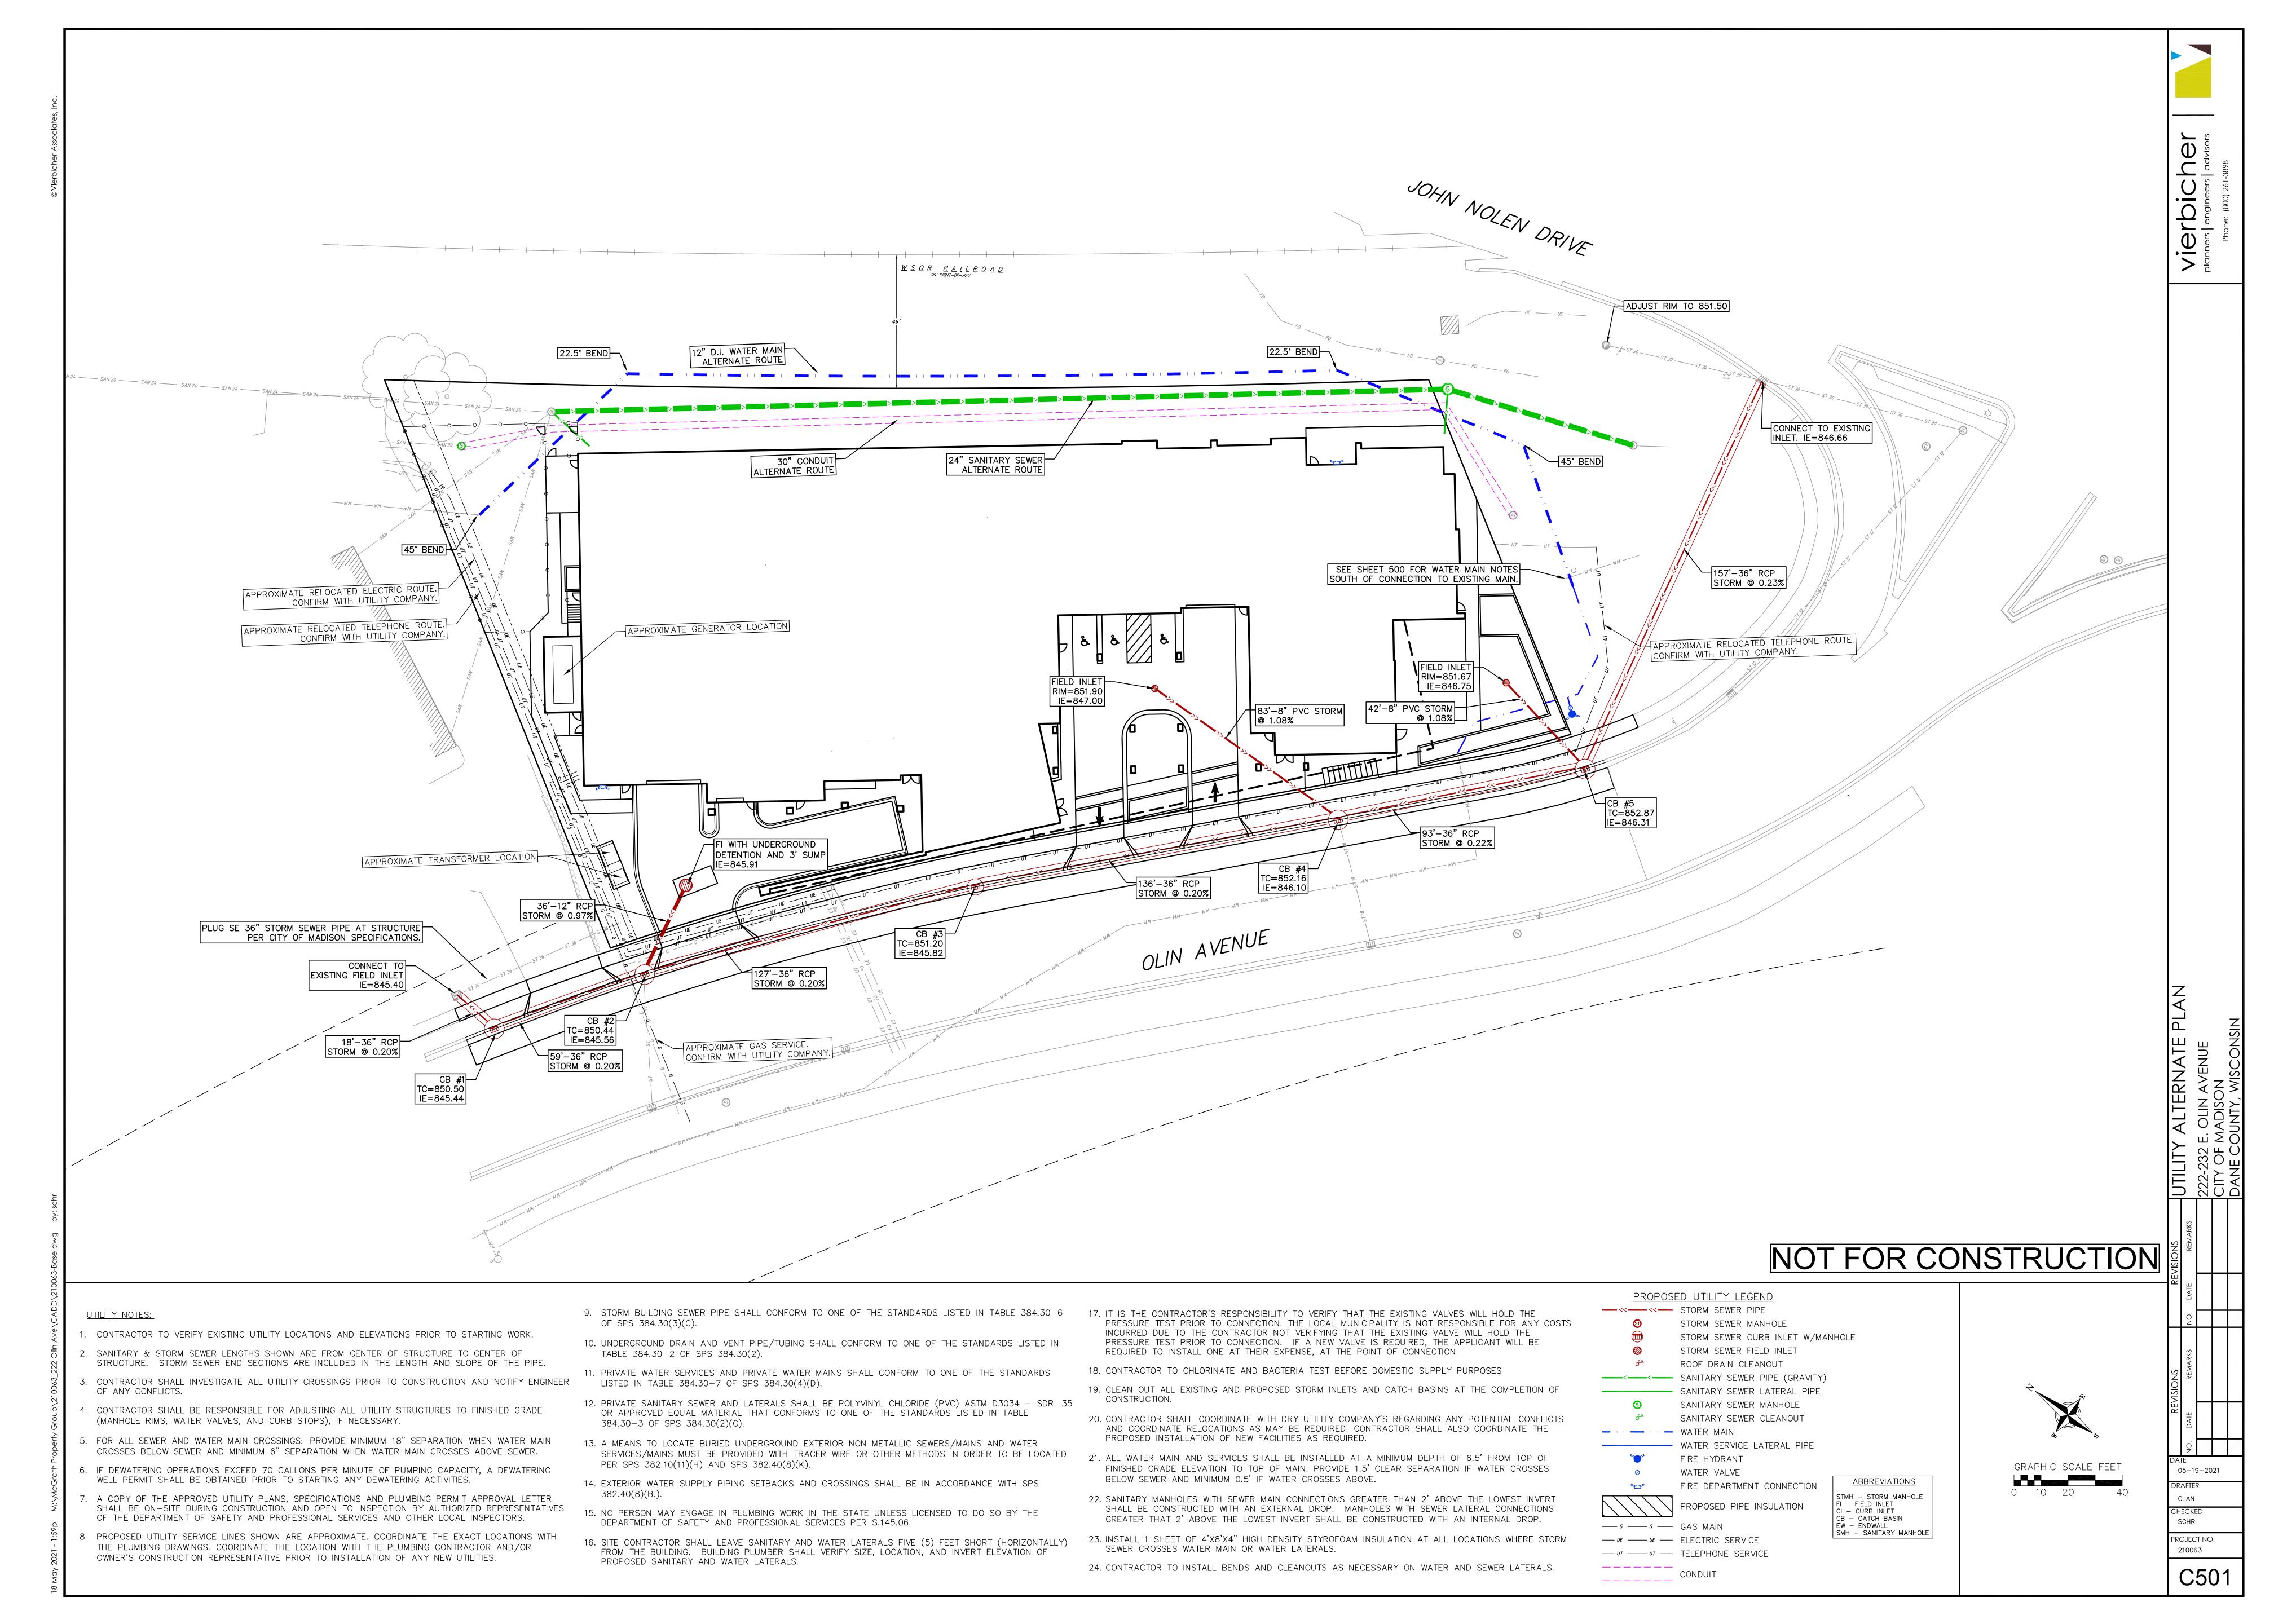

EROSION CONTROL MEASURES

EROSION CONTROL SHALL BE IN ACCORDANCE WITH THE CITY OF MADISON EROSION CONTROL ORDINANCE AND CHAPTER NR 216 OF THE WISCONSIN ADMINISTRATIVE CODE.

2. CONSTRUCT AND MAINTAIN ALL EROSION AND SEDIMENT CONTROL MEASURES IN ACCORDANCE WITH WISCONSIN DNR TECHNICAL STANDARDS (http://dnr.wi.gov/runoff/stormwater/techstds.htm) AND WISCONSIN CONSTRUCTION SITE BEST MANAGEMENT PRACTICE HANDBOOK.

3. INSTALL SEDIMENT CONTROL PRACTICES (TRACKING PAD, PERIMETER SILT FENCE, SEDIMENT BASINS, ETC.) PRIOR TO INITIATING OTHER LAND DISTURBING CONSTRUCTION ACTIVITIES.

4. THE CONTRACTOR IS REQUIRED TO MAKE EROSION CONTROL INSPECTIONS AT THE END OF EACH WEEK AND WHEN 0.5 INCHES OF RAIN FALLS WITHIN 24 HOURS. INSPECTION REPORTS SHALL BE PREPARED AND FILED AS REQUIRED BY THE DNR AND/OR CITY. ALL MAINTENANCE WILL FOLLOW AN INSPECTION WITHIN 24 HOURS.

5. EROSION CONTROL IS THE RESPONSIBILITY OF THE CONTRACTOR UNTIL ACCEPTANCE OF THIS PROJECT. EROSION CONTROL MEASURES AS SHOWN SHALL BE THE MINIMUM PRECAUTIONS THAT WILL BE ALLOWED. ADDITIONAL EROSION CONTROL MEASURES, AS REQUESTED IN WRITING BY THE STATE OR LOCAL INSPECTORS, OR THE DEVELOPER'S ENGINEER, SHALL BE INSTALLED WITHIN 24 HOURS.

6. A 3" CLEAR STONE TRACKING PAD SHALL BE INSTALLED AT THE END OF ROAD CONSTRUCTION LIMITS TO PREVENT SEDIMENT FROM BEING TRACKED ONTO THE ADJACENT PAVED PUBLIC ROADWAY. SEDIMENT TRACKING PAD SHALL CONFORM TO WISDNR TECHNICAL STANDARD 1057. SEDIMENT REACHING THE PUBLIC ROAD SHALL BE REMOVED BY STREET CLEANING (NOT HYDRAULIC FLUSHING) BEFORE THE END OF EACH WORK DAY.

7. CHANNELIZED RUNOFF: FROM ADJACENT AREAS PASSING THROUGH THE SITE SHALL BE DIVERTED AROUND DISTURBED AREAS.

8. STABILIZED DISTURBED GROUND: ANY SOIL OR DIRT PILES WHICH WILL REMAIN IN EXISTENCE FOR MORE THAN 7-CONSECUTIVE DAYS, WHETHER TO BE WORKED DURING THAT PERIOD OR NOT, SHALL NOT BE LOCATED WITHIN 25-FEET OF ANY ROADWAY, PARKING LOT, PAVED AREA, OR DRAINAGE STRUCTURE OR CHANNEL (UNLESS INTENDED TO BE USED AS PART OF THE EROSION CONTROL MEASURES). TEMPORARY STABILIZATION AND CONTROL MEASURES (SEEDING, MULCHING, TARPING, EROSION MATTING, BARRIER FENCING, ETC.) ARE REQUIRED FOR THE PROTECTION OF DISTURBED AREAS AND SOIL PILES, WHICH WILL REMAIN UN-WORKED FOR A PERIOD OF MORE THAN 14-CONSECUTIVE CALENDAR DAYS. THESE MEASURES SHALL REMAIN IN PLACE UNTIL SITE HAS STABILIZED.

9. <u>SITE DE-WATERING:</u> WATER PUMPED FROM THE SITE SHALL BE TREATED BY TEMPORARY SEDIMENTATION BASINS OR OTHER APPROPRIATE CONTROL MEASURES. SEDIMENTATION BASINS SHALL HAVE A DEPTH OF AT LEAST 3 FEET, BE SURROUNDED BY SNOWFENCE OR EQUIVALENT BARRIER AND HAVE SUFFICIENT SURFACE AREA TO PROVIDE A SURFACE SETTLING RATE OF NO MORE THAN 750 GALLONS PER SQUARE FOOT PER DAY AT THE HIGHEST DEWATERING PUMPING RATE. WATER MAY NOT BE DISCHARGED IN A MANNER THAT CAUSES EROSION OF THE SITE, A NEIGHBORING SITE, OR THE BED OR BANKS OF THE RECEIVING WATER. POLYMERS MAY BE USED AS DIRECTED BY DNR TECHNICAL STANDARD 1061 (DE-WATERING).

10. WASHED STONE WEEPERS OR TEMPORARY EARTH BERMS SHALL BE BUILT PER PLAN BY CONTRACTOR TO TRAP SEDIMENT OR SLOW THE VELOCITY OF STORM WATER.

11. SEE GRADING AND EROSION CONTROL PLAN FOR RIP-RAP SIZING. IN NO CASE WILL RIP-RAP BE SMALLER THAN 3" TO 6". 12. INLET FILTERS ARE TO BE PLACED IN STORMWATER INLET STRUCTURES AS SOON AS THEY ARE INSTALLED. THE FILTERS SHALL BE MAINTAINED UNTIL THE DISTURBED AREAS ARE BOTH 70% RESTORED AND PAVED.

13. RESTORATION (SEED, FERTILIZE AND MULCH) SHALL BE PER SPECIFICATIONS ON THIS SHEET UNLESS SPECIAL RESTORATION IS CALLED FOR ON THE LANDSCAPE PLAN.

14. SEED, FERTILIZER AND MULCH SHALL BE APPLIED WITHIN 7 DAYS AFTER FINAL GRADE HAS BEEN ESTABLISHED. IF DISTURBED AREAS WILL NOT BE RESTORED IMMEDIATELY AFTER ROUGH GRADING, TEMPORARY SEED SHALL BE PLACED.

15. FOR THE FIRST SIX WEEKS AFTER RESTORATION (E.G. SEED & MULCH, EROSION MAT, SOD) OF A DISTURBED AREA, INCLUDE SUMMER WATERING PROVISIONS OF ALL NEWLY SEEDED AND MULCHED AREAS WHENEVER 7 DAYS ELAPSE WITHOUT A RAIN EVENT. 16. EROSION MAT (CLASS I, TYPE B PER WISCONSIN D.O.T. P.A.L.) SHALL BE INSTALLED ON ALL SLOPES 3:1 OR GREATER BUT

17. SOIL STABILIZERS SHALL BE APPLIED TO DISTURBED AREAS WITH SLOPES BETWEEN 10% AND 3:1 (DO NOT USE IN CHANNELS). SOIL STABILIZERS SHALL BE TYPE B, PER WISCONSIN D.O.T. P.A.L. (PRODUCT ACCEPTABILITY LIST), OR EQUAL. APPLY AT RATES AND METHODS SPECIFIED PER MANUFACTURER. SOIL STABILIZERS SHALL BE RE-APPLIED WHENEVER VEHICLES OR OTHER EQUIPMENT TRACK ON THE AREA.

18. SILT FENCE OR EROSION MAT SHALL BE INSTALLED ALONG THE CONTOURS AT 100 FOOT INTERVALS DOWN THE SLOPE ON THE DISTURBED SLOPES STEEPER THAN 5% AND MORE THAN 100 FEET LONG THAT SHEET FLOW TO THE ROADWAY UNLESS SOIL STABILIZERS ARE USED.

19. SILT FENCE TO BE USED ACROSS AREAS OF THE LOT THAT SLOPE TOWARDS A PUBLIC STREET OR WATERWAY. SEE DETAILS. 20. SEDIMENT SHALL BE CLEANED FROM CURB AND GUTTER AFTER EACH RAINFALL AND PRIOR TO PROJECT ACCEPTANCE.

21. ACCUMULATED CONSTRUCTION SEDIMENT SHALL BE REMOVED FROM ALL PERMANENT BASINS TO THE ELEVATION SHOWN ON THE GRADING PLAN FOLLOWING THE STABILIZATION OF DRAINAGE AREAS.

22. ALL CONSTRUCTION ENTRANCES SHALL HAVE TEMPORARY ROAD CLOSED SIGNS THAT WILL BE IN PLACE WHEN THE ENTRANCE IS NOT IN USE AND AT THE END OF EACH DAY.

23. ANY PROPOSED CHANGES TO THE EROSION CONTROL PLAN MUST BE SUBMITTED AND APPROVED BY THE CITY AND STATE. 24. THE CITY, OWNER AND/OR ENGINEER MAY REQUIRE ADDITIONAL EROSION CONTROL MEASURES AT ANY TIME DURING CONSTRUCTION.

25. THE CONTRACTOR SHALL REMOVE ANY SEDIMENT TRACKED ONTO ADJACENT ROADS BY MEANS OF STREET SWEEPING (NOT FLUSHING) AT A MINIMUM OF THE END OF EACH WORK DAY OR MORE AS NEEDED.

SEEDING RATES:

LESS THAN 1:1.

- 1. USE ANNUAL OATS AT 3.0 LB./1,000 S.F. FOR SPRING AND SUMMER PLANTINGS.
- 2. USE WINTER WHEAT OR RYE AT 3.0 LB./1,000 SF FOR FALL PLANTINGS STARTED AFTER SEPTEMBER 15.

SEE LANDSCAPE PLAN.

FERTILIZING RATES:


TEMPORARY AND PERMANENT:

USE WISCONSIN D.O.T. TYPE A OR B AT 7 LB./1,000 S.F.

MULCHING RATES:

TEMPORARY AND PERMANENT:

USE 1" TO 1-1" STRAW OR HAY MULCH, CRIMPED PER SECTION 607.3.2.3. OR OTHER RATE AND METHOD PER SECTION 627. WISCONSIN D.O.T. STANDARD SPECIFICATIONS FOR HIGHWAY AND STRUCTURE CONSTRUCTION

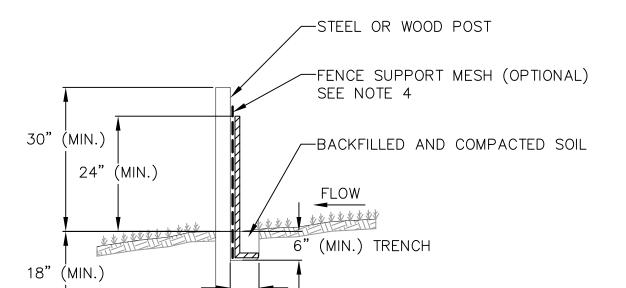


SILT FENCE NOT TO SCALE

CONSTRUCTION SEQUENCE:

- 1. INSTALL EROSION CONTROL MEASURES
- 2. CONDUCT DEMOLITION
- 3. STRIP TOPSOIL
- (UNWORKED AREAS MAY REMAIN NON-STABILIZED FOR A MAXIMUM OF 14 DAYS)
- 4. ROUGH GRADE SITE
- 5. CONSTRUCT UNDERGROUND UTILITIES
- 6. INSTALL INLET PROTECTION IN NEW INLETS
- 7. CONSTRUCT BUILDING
- 8. CONSTRUCT PAVEMENT
- 9. FINAL GRADE AND PERMANENTLY RESTORE DISTURBED AREAS
- 10. REMOVE EROSION CONTROL MEASURES AFTER DISTURBED AREAS ARE 70% RESTORED OR PAVED.
- 11. CONSTRUCT RAIN GARDEN

- 1. INSTALL SILT FENCE TO FOLLOW THE GROUND CONTOURS AS CLOSELY AS POSSIBLE.
- 2. CURVE THE SILT FENCE UP THE SLOPE TO PREVENT WATER FROM RUNNING AROUND THE
- 3. POST SPACING WITH FENCE SUPPORT MESH = 10 FT. (MAX.) POST SPACING WITHOUT FENCE SUPPORT
- MESH = 6 FT. (MAX.)4. SILT FENCE SUPPORT MESH CONSISTS OF 14-GAUGE STEEL WIRE WITH A MESH SPACING OF 6 IN. X 6 IN. OR PREFABRICATED


POLYMERIC MESH OF EQUIVALENT STRENGTH

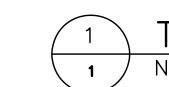


NOTE: REFER TO GENERAL STAPLE PATTERN GUIDE FOR CORRECT STAPLE PATTERN RECOMMENDATIONS FOR SLOPE INSTALLATIONS.

- 1. PREPARE SOIL BEFORE INSTALLING BLANKETS, INCLUDING APPLICATION OF FERTILIZER AND SEED. NOTE: WHEN USING CELL-O-SEED, DO NOT SEED PREPARED AREA.
- CELL-O-SEED MUST BE INSTALLED WITH PAPER SIDE DOWN. 2. BEGIN AT THE TOP OF THE SLOPE BY ANCHORING THE BLANKET IN 6" DEEP
- BY 6" WIDE TRENCH. BACKFILL AND COMPACT THE TRENCH AFTER STAPLING. 3. ROLL THE BLANKETS <A.> DOWN, OR <B.> HORIZONTALLY ACROSS THE SLOPE. 4. THE EDGES OF PARALLEL BLANKETS MUST BE STAPLED WITH APPROXIMATELY
- 2" OVERLAP. 5. WHEN BLANKETS MUST BE SPLICED DOWN THE SLOPE, PLACE BLANKETS END OVER END (SHINGLE STYLE) WITH APPROXIMATELY 4" OVERLAP. STAPLE
- THROUGH OVERLAPPED AREA, APPROXIMATELY 12" APART. 6. ALL BLANKETS MUST BE SECURELY FASTENED TO THE SLOPE BY PLACING STAPLES/STAKES IN APPROPRIATE LOCATIONS AS RECOMMENDED BY THE MANUFACTURER.



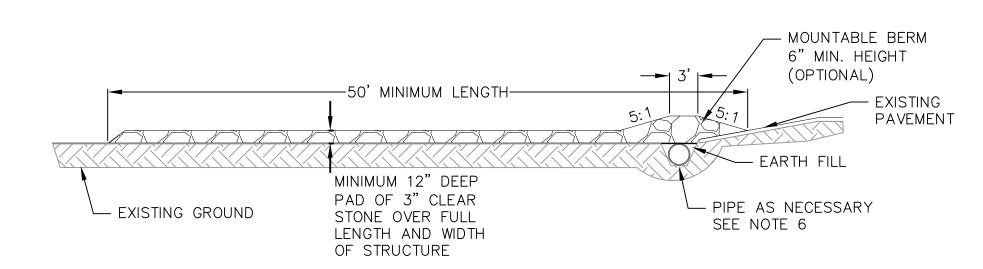

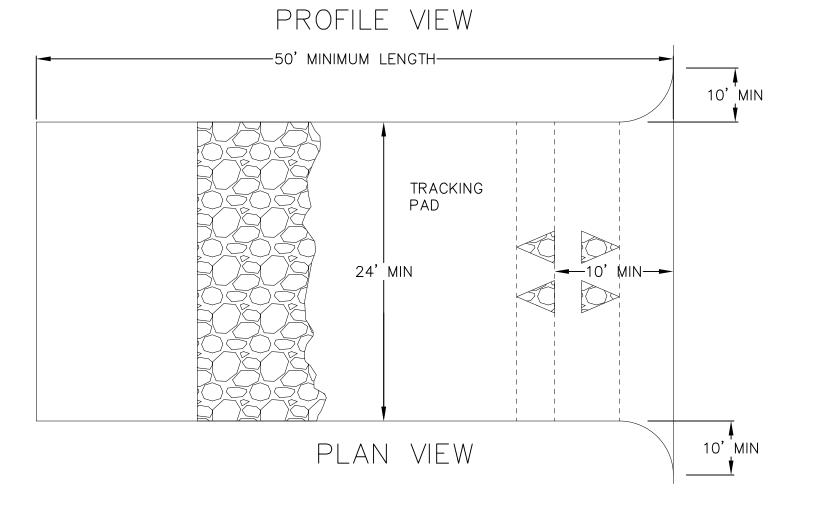

1. FOLLOW WISCONSIN DNR TECHNICAL STANDARD 1057 FOR FURTHER DETAILS AND INSTALLATION.

2. LENGTH - MINIMUM OF 50'.


3. WIDTH - 24' MINIMUM, SHOULD BE FLARED AT THE EXISTING ROAD TO PROVIDE A TURNING RADIUS. 4. ON SITES WITH A HIGH GROUNDWATER TABLE OR WHERE SATURATED CONDITIONS EXIST, GEOTEXTILE FABRIC SHALL BE PLACED OVER EXISTING GROUND PRIOR TO PLACING STONE. FABRIC SHALL BE WISDOT TYPE-HR GEOTEXTILE FABRIC.


5. STONE - CRUSHED 3" CLEAR STONE SHALL BE PLACED AT LEAST 12" DEEP OVER THE ENTIRE LENGTH AND WIDTH OF ENTRANCE.

6. SURFACE WATER - ALL SURFACE WATER FLOWING TO OR DIVERTED TOWARDS CONSTRUCTION ENTRANCES SHALL BE PIPED THROUGH THE ENTRANCE. MAINTAINING POSITIVE DRAINAGE. PIPE INSTALLED THROUGH THE STABILIZED CONSTRUCTION ENTRANCE SHALL BE PROTECTED WITH A MOUNTABLE BERM WITH 5:1 SLOPES AND MINIMUM OF 6" STONE OVER THE PIPE. PIPE SHALL BE SIZED ACCORDING TO THE DRAINAGE REQUIREMENTS. WHEN THE ENTRANCE IS LOCATED AT A HIGH SPOT AND HAS NO DRAINAGE TO CONVEY A PIPE SHALL NOT BE NECESSARY. THE MINIMUM PIPE DIAMETER SHALL BE 6". CONTRACTOR SHALL BE RESPONSIBLE FOR THE MAINTENANCE OF SAID PIPE.

7. LOCATION - A STABILIZED CONSTRUCTION ENTRANCE SHALL BE LOCATED WHERE CONSTRUCTION TRAFFIC ENTERS AND/OR LEAVES THE CONSTRUCTION SITE. VEHICLES LEAVING THE SITE MUST TRAVEL OVER THE ENTIRE LENGTH OF THE TRACKING PAD.



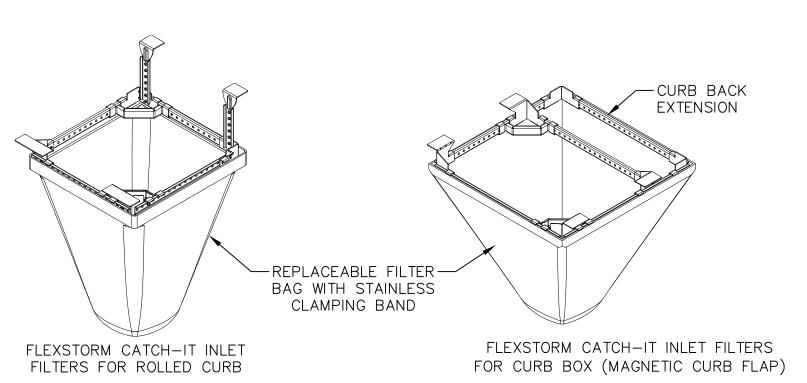

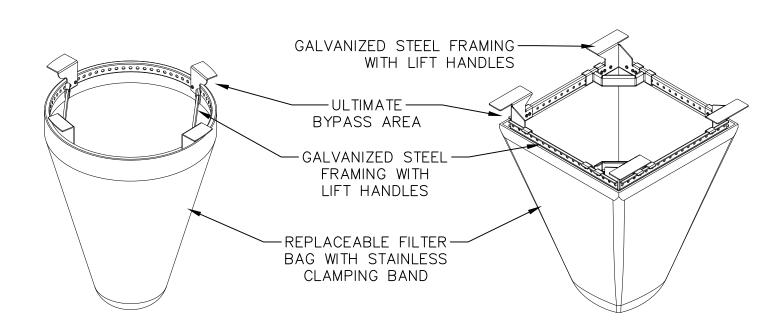


FLEXSTORM CATCH-IT INLET FILTERS FOR ROUND OPENINGS

FLEXSTORM CATCH-IT INLET FILTERS FOR SQUARE/RECTANGULAR OPENINGS

NOTES:

1. INLET PROTECTION DEVICES SHALL BE MAINTAINED OR REPLACED AT THE DIRECTION 2. WHEN REMOVING OR MAINTAINING INLET PROTECTION, ANY TRAPPED MATERIAL THAT

FALLS INTO THE INLET SHALL BE IMMEDIATELY REMOVED BY THE CONTRACTOR.

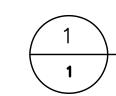


FRAMED INLET PROTECTION NOT TO SCALE

CONSTRUCTION SPECIFICATIONS

1. LOCATE WASHOUT STRUCTURE A MINIMUM OF 50 FEET AWAY FROM OPEN CHANNELS, STORM DRAIN INLETS, SENSITIVE AREAS, WETLANDS, BUFFERS AND WATER COURSES AND AWAY FROM CONSTRUCTION TRAFFIC.

2.PREPARE SOIL BASE FREE OF ROCKS OR OTHER DEBRIS THAT MAY CAUSE TEARS OR HOLES IN THE LINER. FOR LINER, USE 10 MIL OR THICKER UV RESISTANT, IMPERMEABLE SHEETING, FREE OF HOLES AND TEARS OR OTHER DEFECTS THAT COMPROMISE IMPERMEABILITY OF THE MATERIAL.

3.KEEP CONCRETE WASHOUT STRUCTURE WATER TIGHT. REPLACE IMPERMEABLE LINER IF DAMAGED (E.G., RIPPED OR PUNCTURED). EMPTY OR REPLACE WASHOUT STRUCTURE THAT IS 75 PERCENT FULL, AND DISPOSE OF ACCUMULATED MATERIAL PROPERLY. DO NOT REUSE PLASTIC LINER. WET-VACUUM STORED LIQUIDS THAT HAVE NOT EVAPORATED AND DISPOSE OF IN AN APPROVED MANNER. REMOVE HARDENED SOLIDS, WHOLE OR BROKEN UP, FOR DISPOSAL OR RECYCLING. MAINTAIN RUNOFF DIVERSION AROUND EXCAVATED WASHOUT STRUCTURE UNTIL STRUCTURE IS REMOVED.

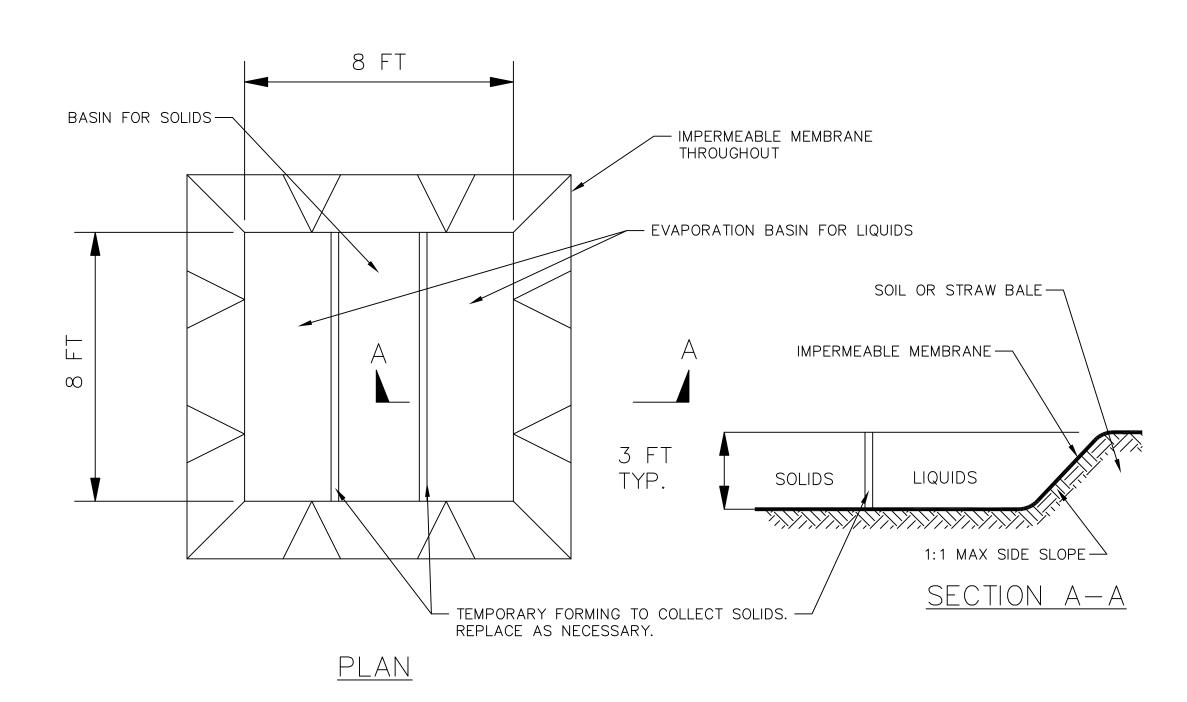



NOT FOR CONSTRUCTION

05-19-2021 CLAN CHECKED SCHR PROJECT NO. 210063

ONSTRUCTION DETAIL

<u>O</u>


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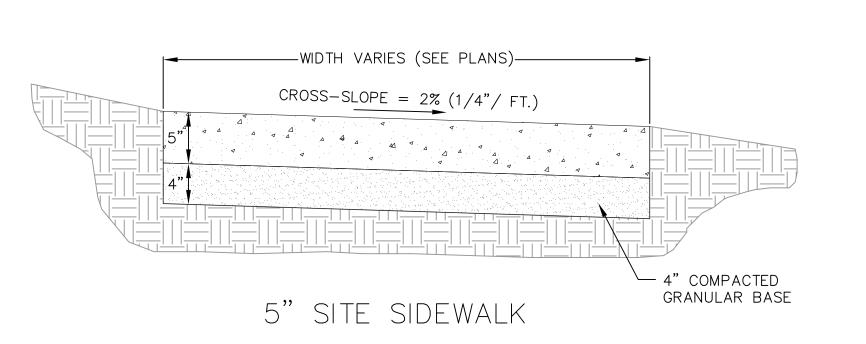
*THE UPPER 4" SHOULD CONSIST OF 1 1/4" DENSE GRADED BASE; THE BOTTOM PART OF THE LAYER CAN CONSIST OF 3" DENSE GRADED BASE


BITUMINOUS PAVEMENT









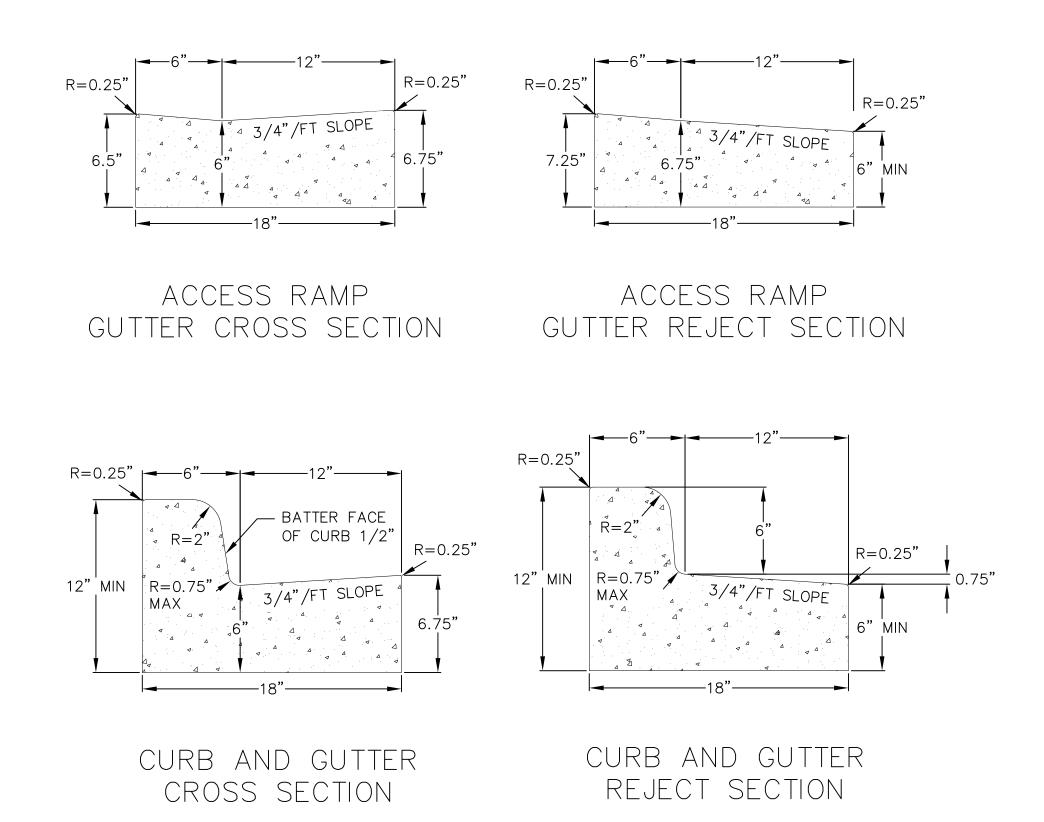

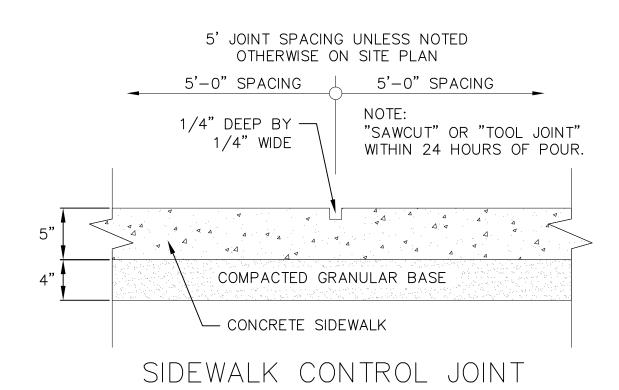


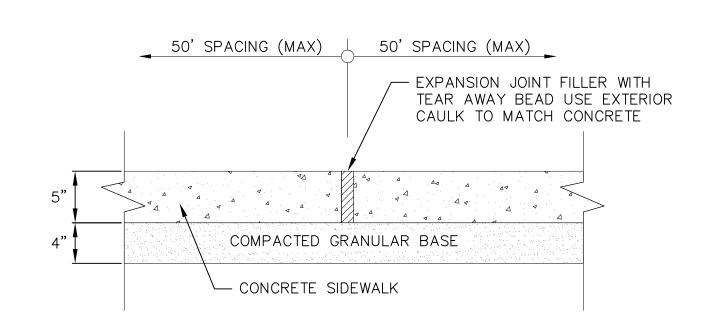




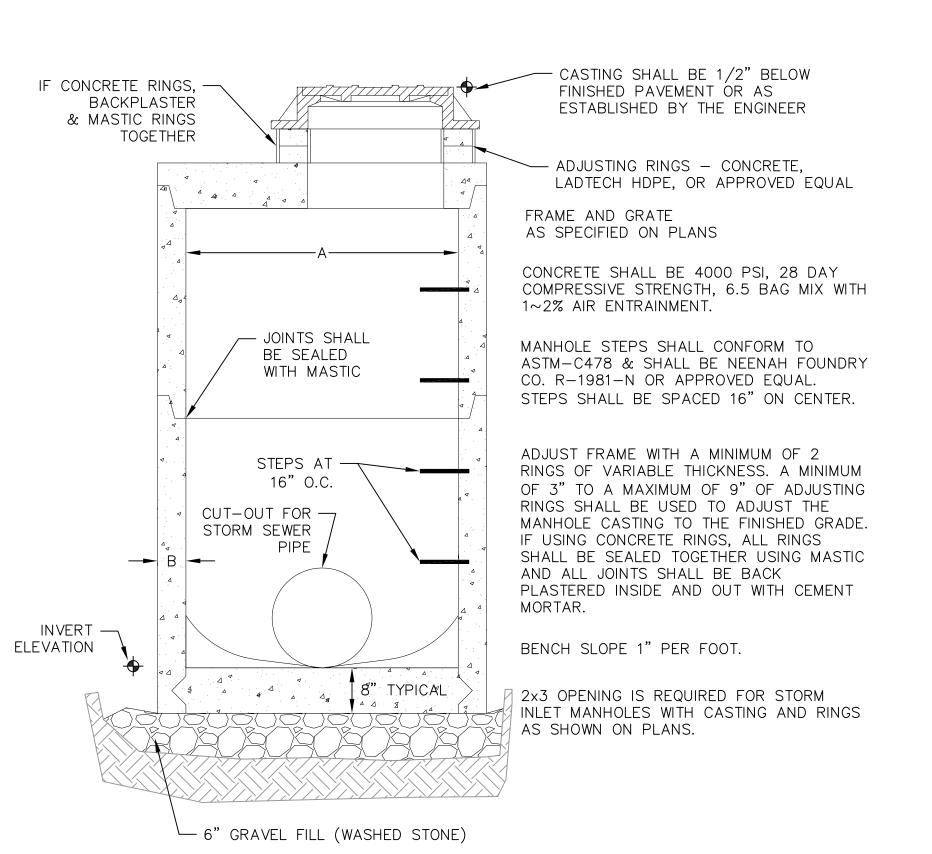

| TOR | M MAN | HOLE | DIMENS | SIONS |
|-----|---------|------------------|----------|------------|
| | MANHOLE | DIME | NSION | |
| | SIZE | Α | B (MIN.) | |
| | 48" | 48" | 5" | |
| | 60" | 60" | 6" | |
| | 72" | 72" | 7" | |
| | 84" | 84" | 7" | |
| | 96" | 96" | 9" | |
| | | STORM ot to s | | ER MANHOLE |

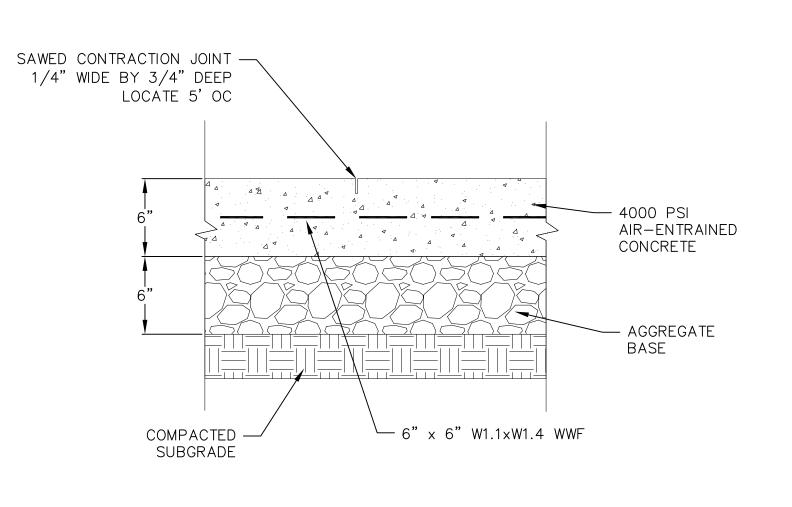



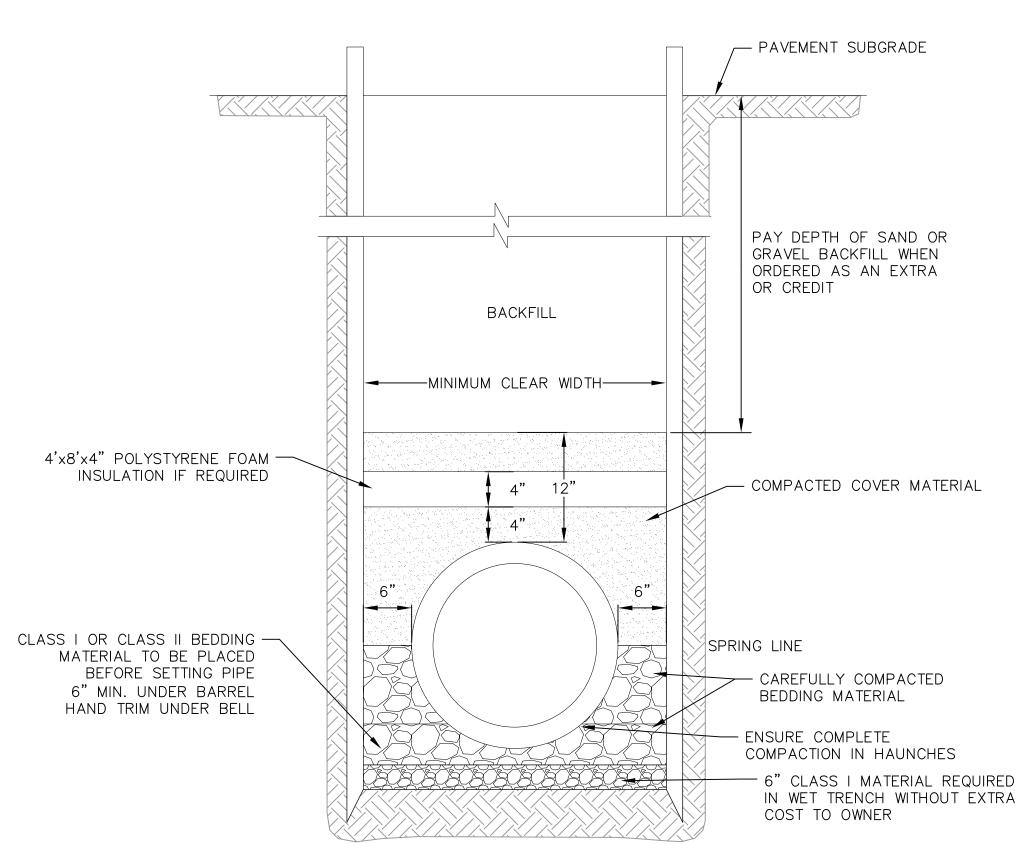



NOT FOR CONSTRUCTION

CLAN CHECKED SCHR PROJECT NO. C601

05-19-2021

CONSTRUCTION DETAILS - 222-232 E. OLIN AVENUE

NSTRUCTION DETAILS

05-19-2021


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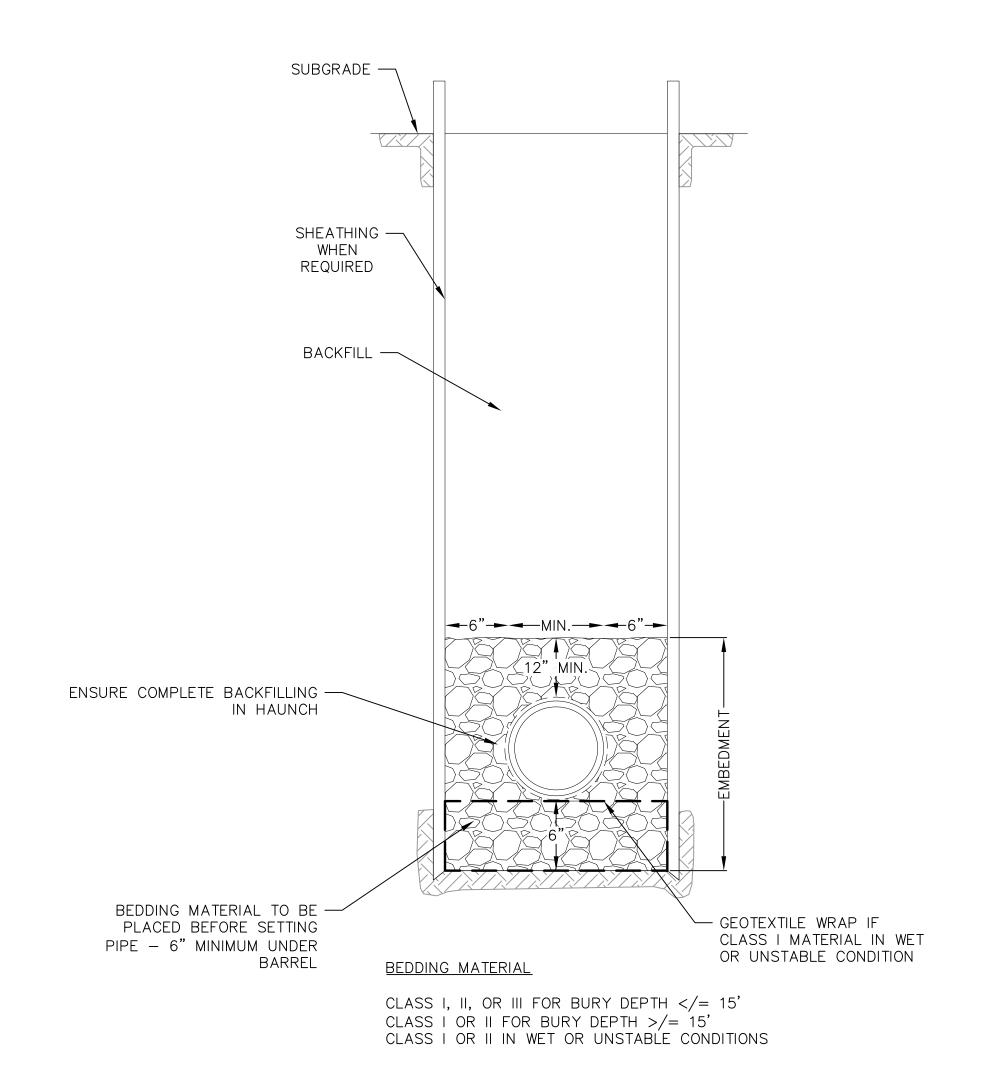
SCHR

PROJECT NO.


C602






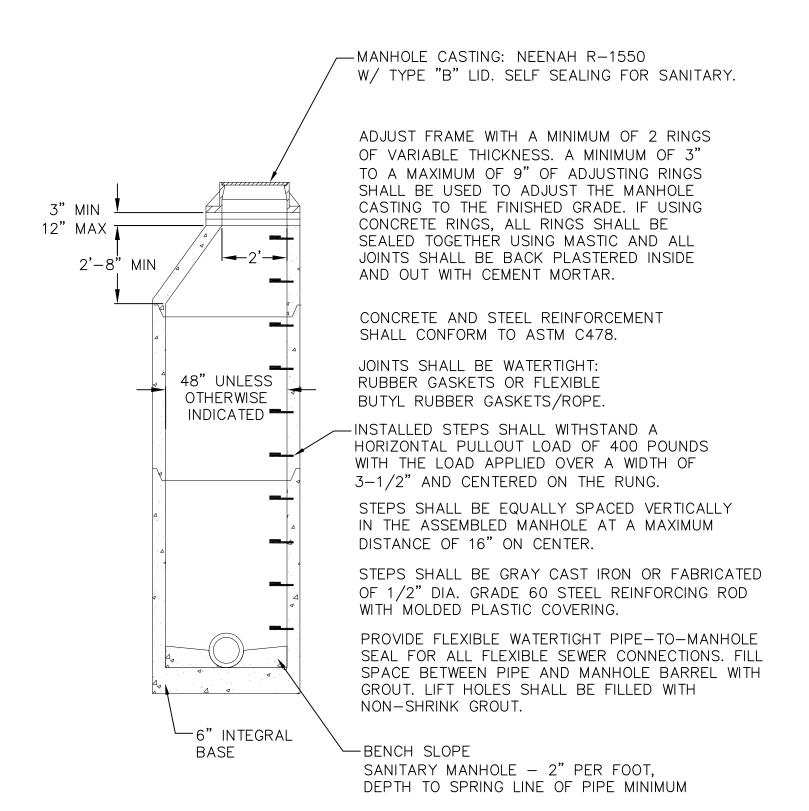


STANDARD SANITARY TRENCH SECTION NOT TO SCALE

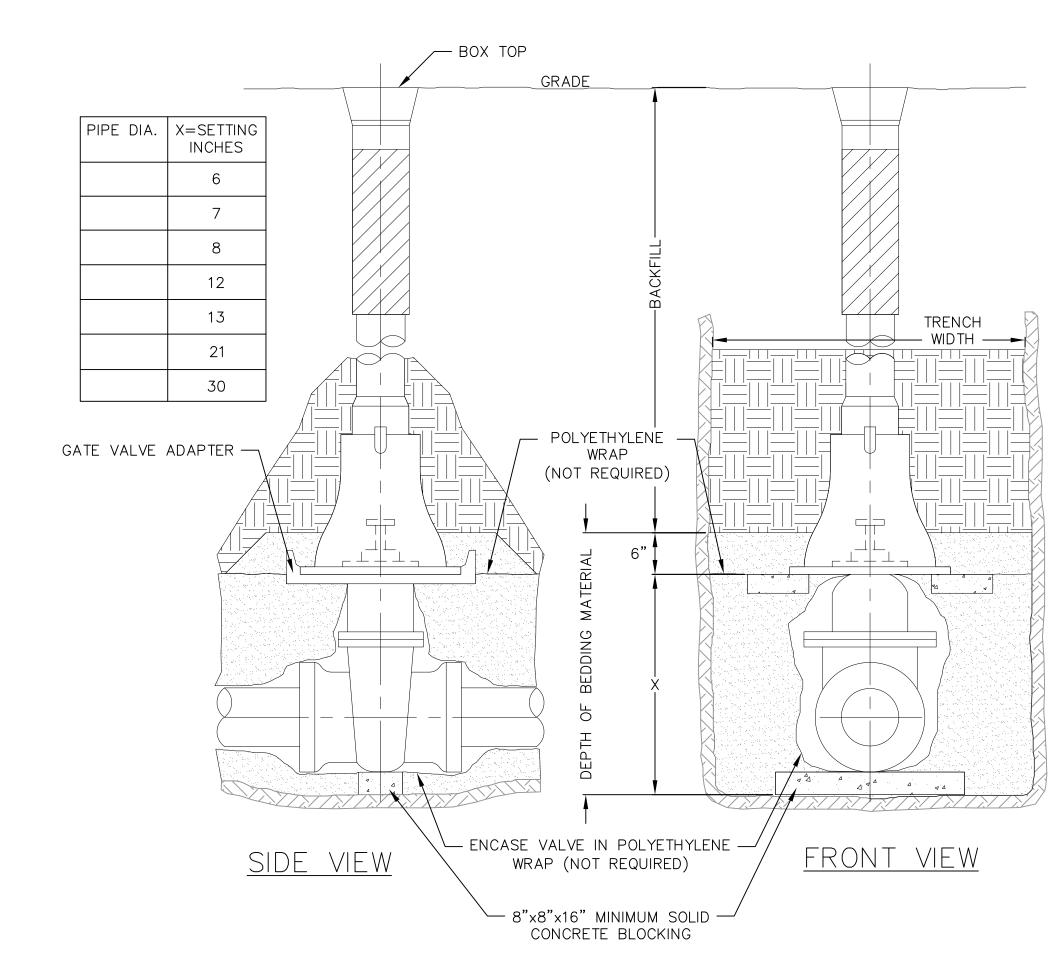



STANDARD GATE VALVE BOX SETTING NOT TO SCALE

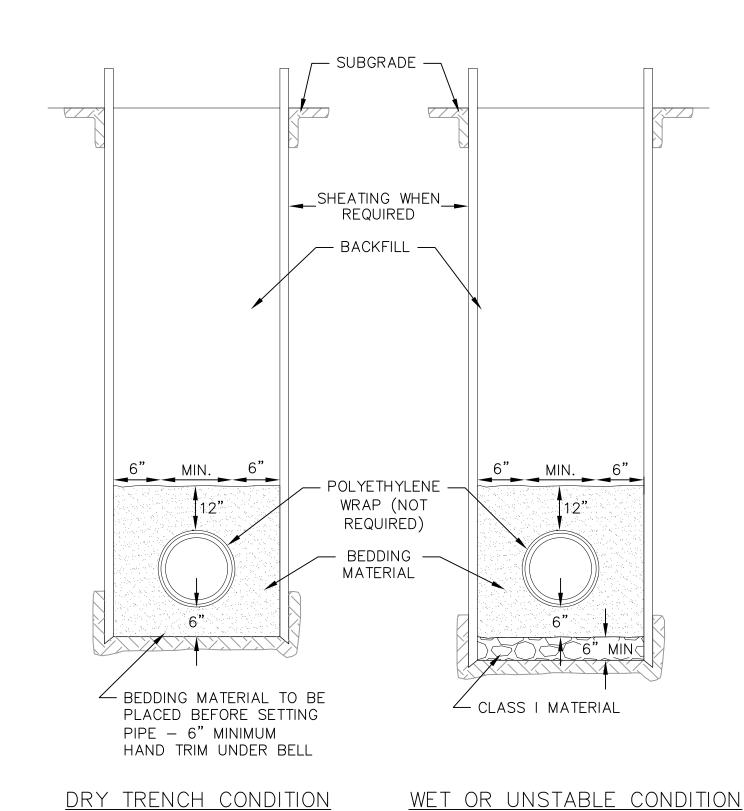


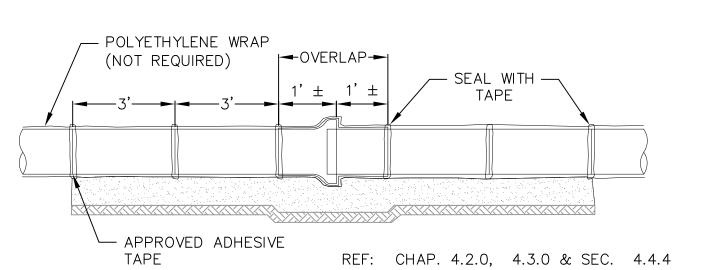

STANDARD WATER MAIN TRENCH SECTION NOT TO SCALE

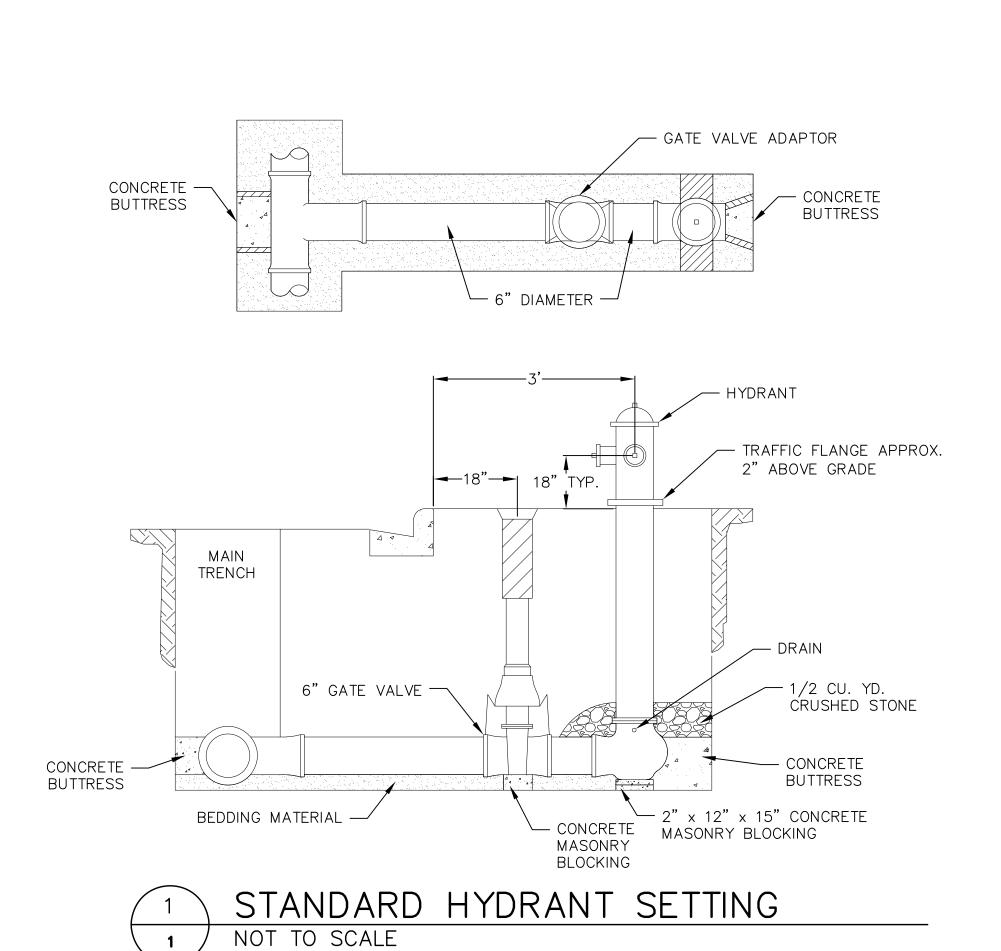

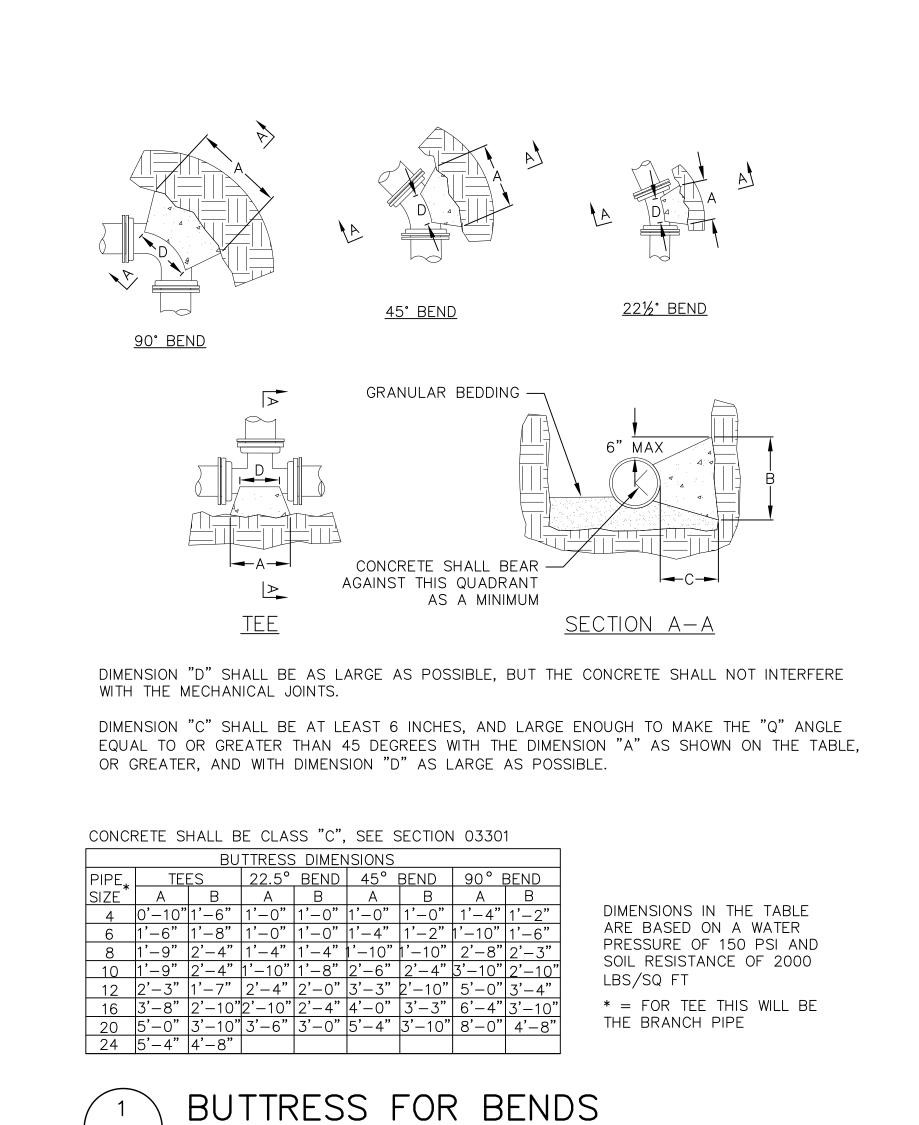

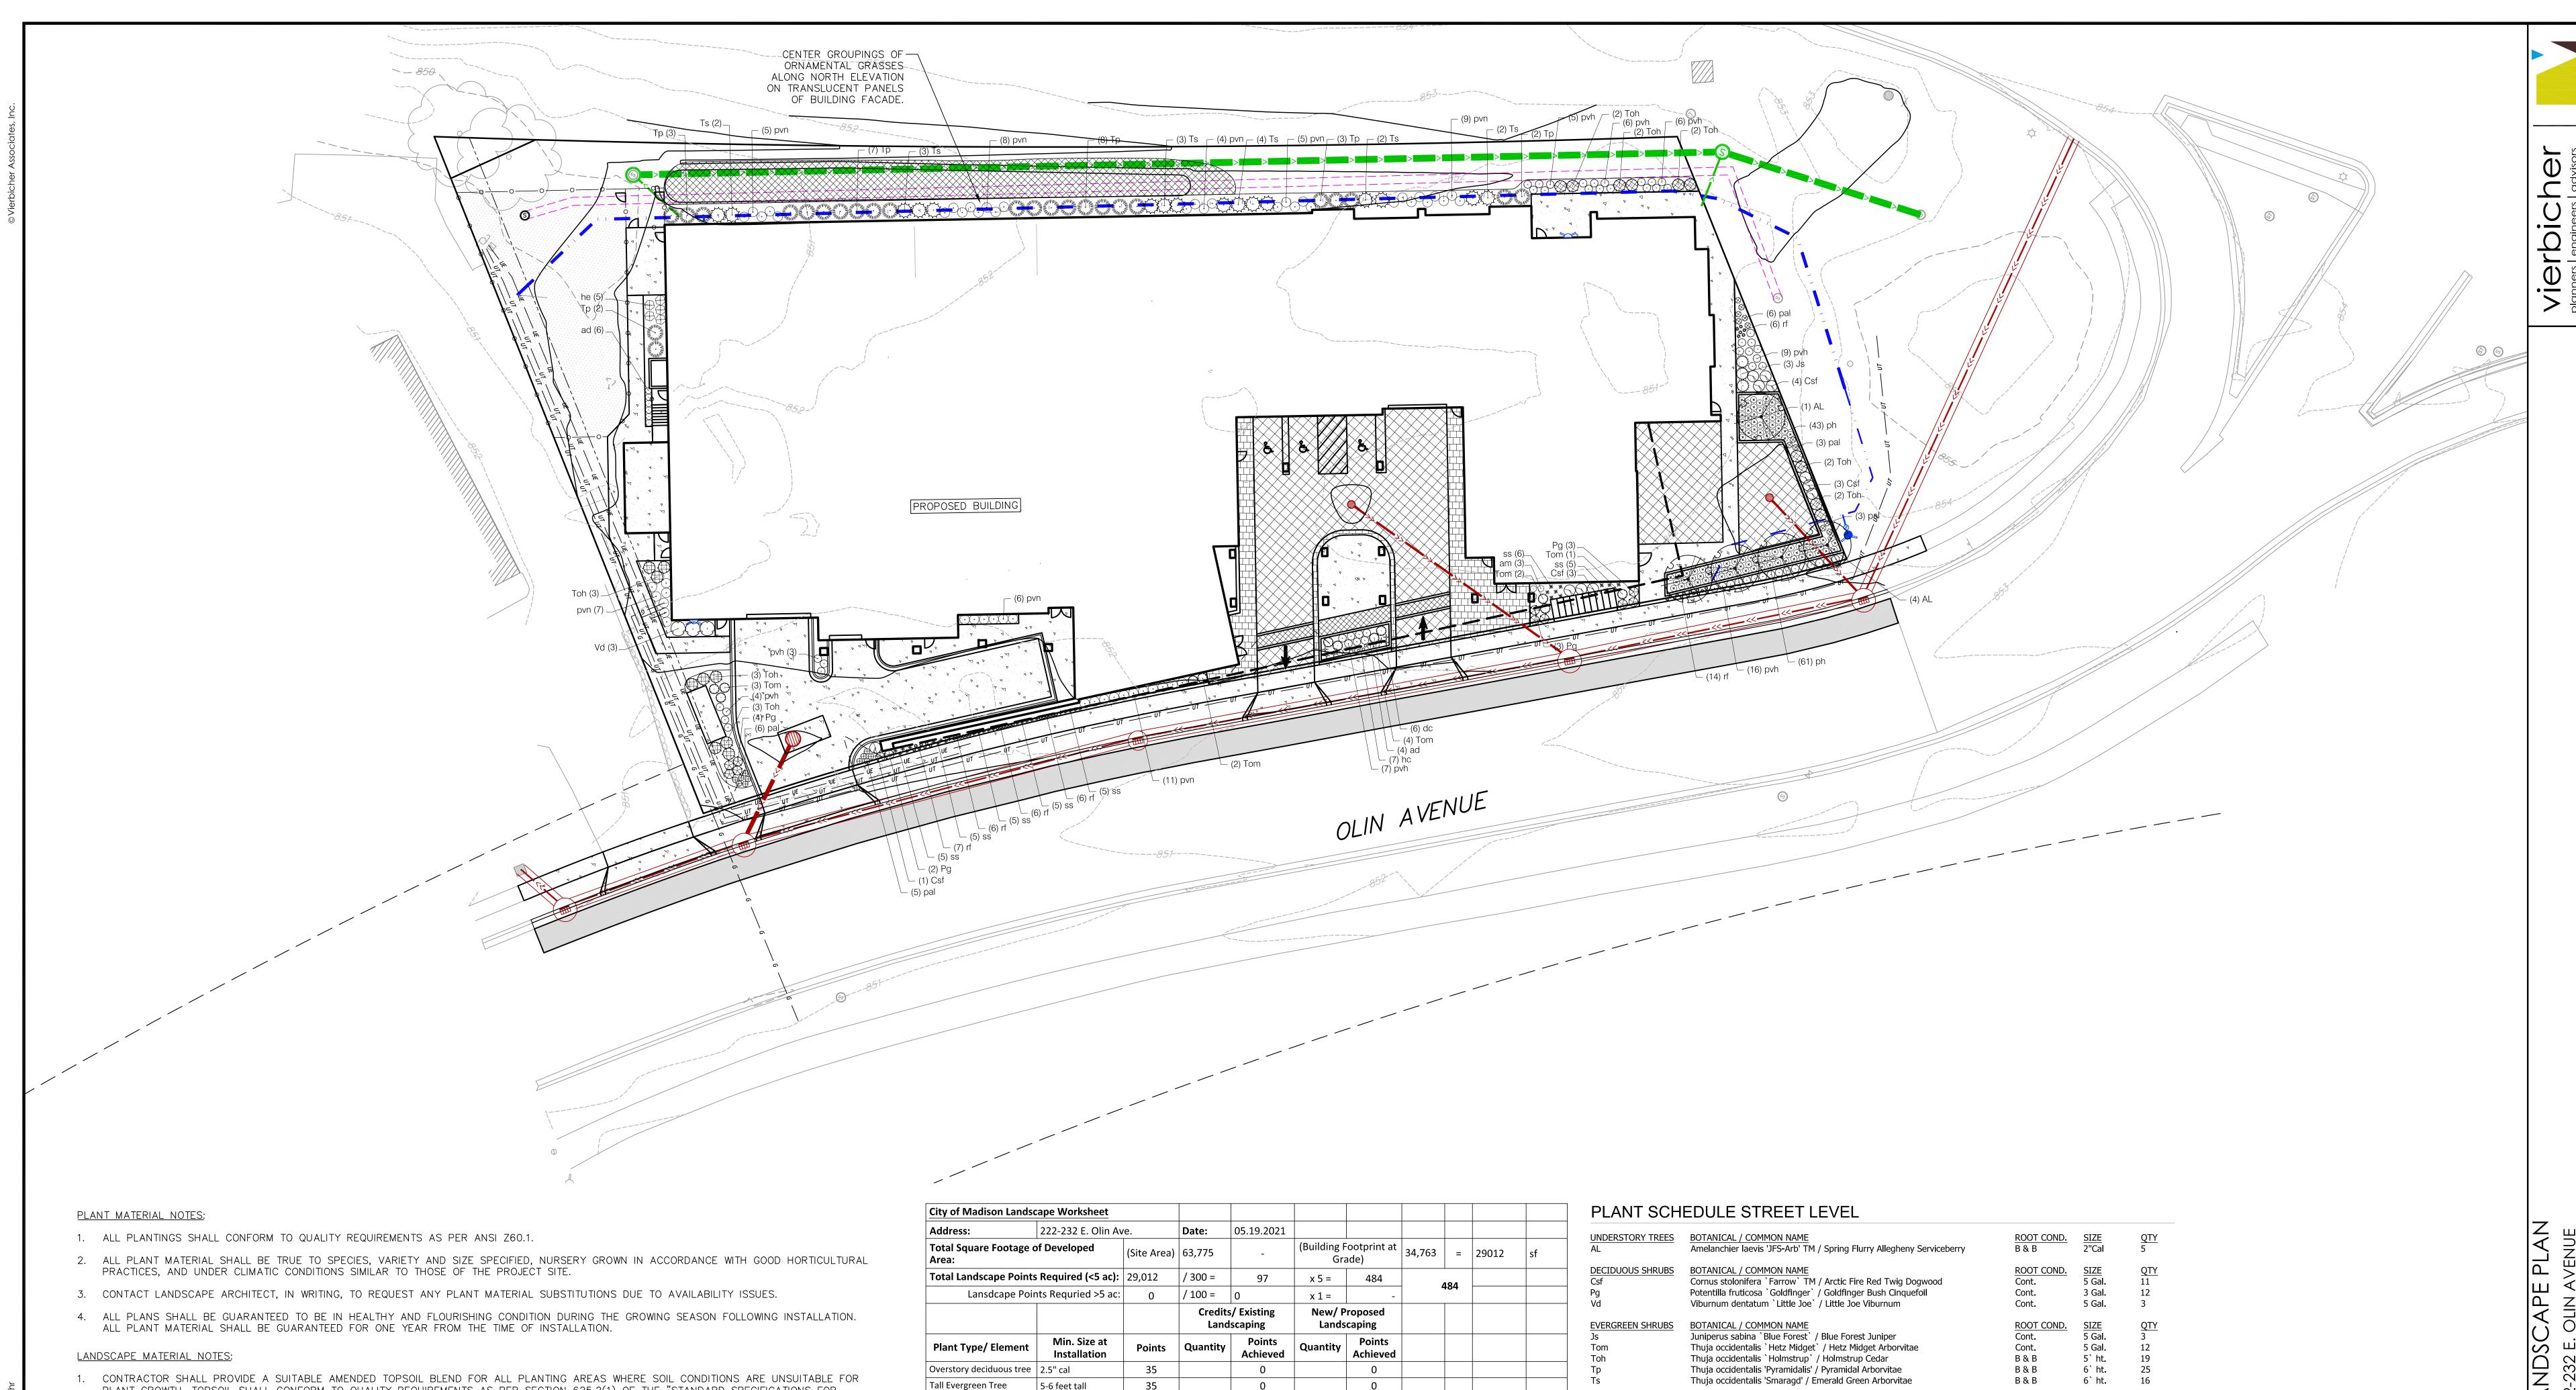

- 1. CONTRACTOR SHALL PROVIDE A SUITABLE AMENDED TOPSOIL BLEND FOR ALL PLANTING AREAS WHERE SOIL CONDITIONS ARE UNSUITABLE FOR PLANT GROWTH. TOPSOIL SHALL CONFORM TO QUALITY REQUIREMENTS AS PER SECTION 625.2(1) OF THE "STANDARD SPECIFICATIONS FOR HIGHWAY CONSTRUCTION." PROVIDE A MINIMUM OF 18" OF TOPSOIL IN ALL PLANTING AREAS AND 6" OF TOPSOIL IN AREAS TO BE SEEDED/SODDED.
- 2. LANDSCAPE BEDS TO BE MULCHED WITH UNDYED SHREDDED HARDWOOD BARK MULCH TO 3" DEPTH MIN. AND EDGED WITH COMMERCIAL GRADE ALUMINUM LANDSCAPE EDGING, PERMALOC CLEANLINE 3"X4" OR EQUAL, COLOR BLACK ANODIZED.

PRE-EMERGENT GRANULAR HERBICIDE WEED-PREVENTER SHOULD BE MIXED WITH MULCH AS WELL AS TOPICALLY APPLIED TO TREE RING.

3. ALL TREES AND/OR SHRUBS PLANTED IN LAWN AREAS TO BE INSTALLED WITH A 5' DIAMETER MULCH RING AND SHOVEL CUT EDGE. A

SEEDING AND PLUG PLANTING NOTES:


- 1. ALL DISTURBED AREAS, UNLESS OTHERWISE NOTED, TO BE SEEDED WITH 'MADISON PARKS' MIX BY 'LACROSSE SEED COMPANY' OR EQUIVALENT, PER MANUFACTURER'S SPECIFIED APPLICATION RATES. ALL SEEDED AREAS ARE TO BE WATERED DAILY TO MAINTAIN ADEQUATE SOIL MOISTURE
- FOR PROPER GERMINATION. AFTER VIGOROUS GROWTH IS ESTABLISHED, APPLY $\frac{1}{2}$ " WATER TWICE WEEKLY UNTIL FINAL ACCEPTANCE. 2. ALL AREAS NOTED ON PLAN AS RAIN GARDEN SEEDING, INSTALL 'MOIST MEADOW-RAIN GARDEN MIX' SEED MIX BY 'PRAIRIE NURSERY'. INSTALL PER MANUFACTURER'S SPECIFIED APPLICATION RATES. ALL SEEDED AREAS ARE TO BE WATERED DAILY TO MAINTAIN ADEQUATE SOIL MOISTURE FOR PROPER GERMINATION. AFTER VIGOROUS GROWTH IS ESTABLISHED, APPLY $\frac{1}{2}$ " WATER TWICE WEEKLY UNTIL FINAL ACCEPTANCE.

| City of Madison Lands | cape Worksheet | | | | | | | | | |
|---|---|--|-----------|-------------------------|----------|--------------------|----------|-----|-------|---------|
| Address: | 222-232 E. Olin Av | ve. | Date: | 05.19.2021 | | | | | | |
| Total Square Footage o | of Developed | (Site Area) | 63,775 | - | | ootprint at ade) | 34,763 | = | 29012 | sf |
| Total Landscape Points | s Required (<5 ac): | 29,012 | / 300 = | 97 | x 5 = | 484 | | 404 | | |
| Lansdcape Poi | nts Requried >5 ac: | 0 | / 100 = | 0 | x 1 = | - | ' | 184 | | |
| | | | | s/ Existing Iscaping | _ | roposed caping | | | | |
| Plant Type/ Element | Min. Size at Installation | Points | Quantity | Points Achieved | Quantity | Points Achieved | | | | |
| Overstory deciduous tree | 2.5" cal | 35 | | 0 | | 0 | | | | |
| Tall Evergreen Tree | 5-6 feet tall | 35 | | 0 | | 0 | | | | |
| Ornamental tree | 1.5" cal | 15 | | 0 | 12 | 180 | | | | |
| Upright evergreen shrub | 3-4 feet tall | 10 | | 0 | 60 | 600 | | | | |
| Shrub, deciduous | #3 gallon container size, Min. 12-24" | 3 | | 0 | 26 | 78 | | | | |
| Shrub, evergreen | #3 gallon container size, Min. 12-24" | 4 | | 0 | 12 | 48 | | | | |
| Ornamental grasses/perennials | #1 gallon container size, Min. 8-18" | 2 | | 0 | 421 | 842 | | | | |
| Ornamental/decorative fencing or wall | n/a | 4 per 10 LF | | 0 | | 0 | | | | |
| Existing significant specimen tree | Min. Size 2.5" cal. Trees must be within developed area and cannot comprise more than 30% of total required points. | 14 per caliper inch. Max. points per tree: 200 | | 0 | | 0 | | | | |
| Landscape Furniture for public seating and/or transit connections | Furniture must be within developed area, publicly accessible, and cannot comprise more than 5% of total required points | 5 points per "seat" | | 0 | | 0 | | | | |
| Sub Totals | | | | 0 | | 1748 | | | | \perp |
| | | | Total Poi | nts Provided: | 1748 | | | | | |

| I LANT SCIT | | | | |
|------------------|---|------------|---------------------|-----------------|
| UNDERSTORY TREES | BOTANICAL / COMMON NAME | ROOT COND. | SIZE | QTY |
| AL | Amelanchier laevis 'JFS-Arb' TM / Spring Flurry Allegheny Serviceberry | B & B | 2"Cal | <u>QTY</u> 5 |
| DECIDUOUS SHRUBS | BOTANICAL / COMMON NAME | ROOT COND. | SIZE | <u>QTY</u> |
| Csf | Cornus stolonifera `Farrow` TM / Arctic Fire Red Twig Dogwood | Cont. | 5 Gal. | 11 |
| Pg | Potentilla fruticosa `Goldfinger` / Goldfinger Bush Cinquefoil | Cont. | 3 Gal. | 12 |
| Vd | Viburnum dentatum `Little Joe` / Little Joe Viburnum | Cont. | 5 Gal. | 3 |
| EVERGREEN SHRUBS | BOTANICAL / COMMON NAME | ROOT COND. | SIZE | QTY |
| Js | Juniperus sabina `Blue Forest` / Blue Forest Juniper | Cont. | 5 Gal. | <u>QTY</u> 3 |
| Tom | Thuja occidentalis `Hetz Midget` / Hetz Midget Arborvitae | Cont. | 5 Gal. | 12 |
| Toh | Thuja occidentalis `Holmstrup` / Holmstrup Cedar | B & B | 5` ht. | 19 |
| Тр | Thuja occidentalis 'Pyramidalis' / Pyramidal Arborvitae | B & B | 6` ht. | 25 |
| Ts | Thuja occidentalis 'Smaragd' / Emerald Green Arborvitae | B & B | 6` ht. | 16 |
| PERENNIALS | BOTANICAL / COMMON NAME | ROOT COND. | SIZE | QTY |
| am | Amsonia x `Blue Ice` / Blue Ice Bluestar | Cont. | $\overline{1}$ Gal. | <u>QTY</u> 3 |
| ad | Astilbe x `Delft Lace` / Delft Lace Astilbe | Cont. | 1 Gal. | 10 |
| dc | Deschampsia cespitosa `Schottland` / Schottland Tufted Hair Grass | Cont. | 1 Gal. | 6 |
| hc | Heuchera x 'Citronelle' / Citronelle Yellow Coral Bells | Cont. | 4 In | 7 |
| he | Hosta x `Earth Angel` / Earth Angel Hosta | Cont. | 1 Gal. | 5 |
| pvh | Panicum virgatum `Heavy Metal` / Heavy Metal Switch Grass | Cont. | 1 Gal. | 56 |
| pvn | Panicum virgatum `Northwind` / Northwind Switch Grass | Cont. | 1 Gal. | 55 |
| ph | Pennisetum alopecuroides `Hameln` / Hameln Fountain Grass | Cont. | 1 Gal. | 104 |
| pal | Perovskia atriplicifolia `Little Spire` / Little Spire Russian Sage | Cont. | 1 Gal. | 23 |
| rf | Rudbeckia fulgida `Goldsturm` / Goldsturm Coneflower | Cont. | 1 Gal. | 45 |
| SS | Schizachyrium scoparium 'Standing Ovation' / Standing Ovation Little Bluestem | Cont. | 1 Gal. | 36 |

NATIVE SEEDING




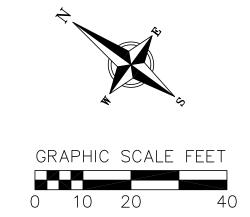

NOT FOR CONSTRUCTION

DRAFTER
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CHECKED
SCHR PROJECT NO. 210063

05-19-2021

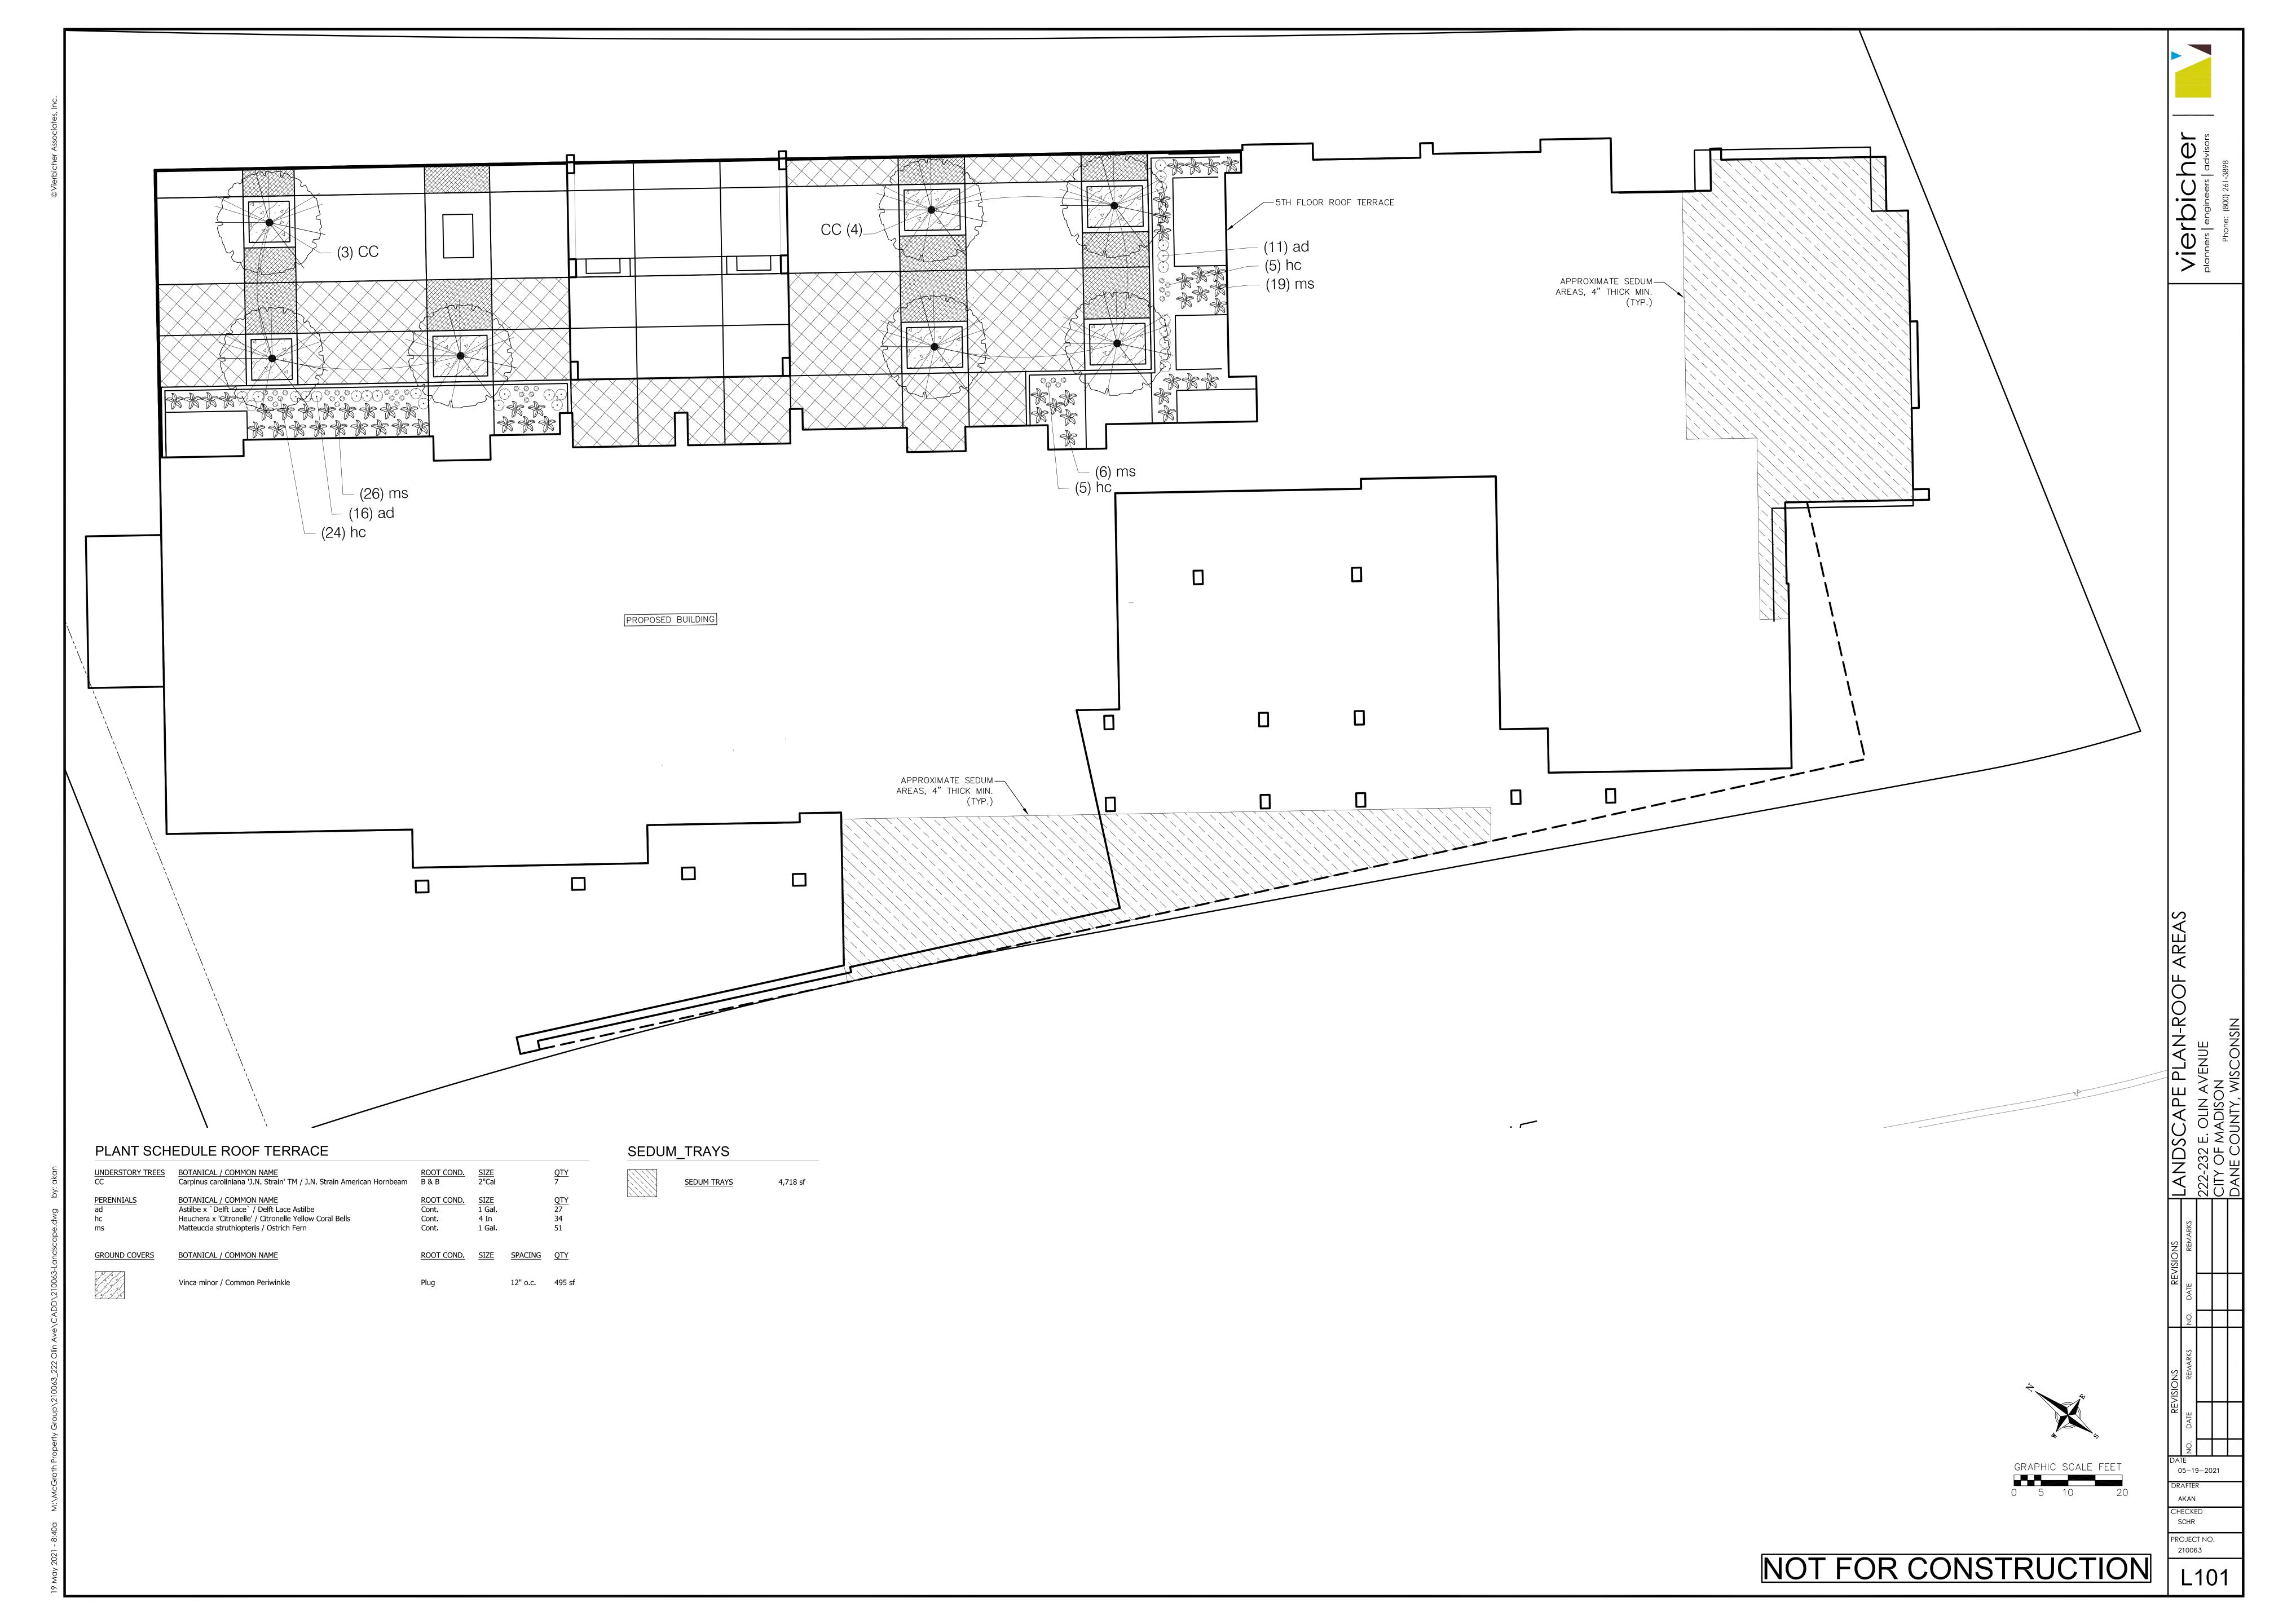


rbic engineers

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- DO NOT HEAVILY PRUNE TREE AT PLANTING. PRUNE ONLY CROSSING LIMBS, CO-DOMINANT LEADERS, AND BROKEN OR DEAD BRANCHES. DO NOT REMOVE THE TERMINAL BUDS OF BRANCHES THAT EXTEND TO THE EDGE OF THE CROWN.

- STAKE TREES ONLY UPON THE APPROVAL OF THE LANDSCAPE ARCHITECT.

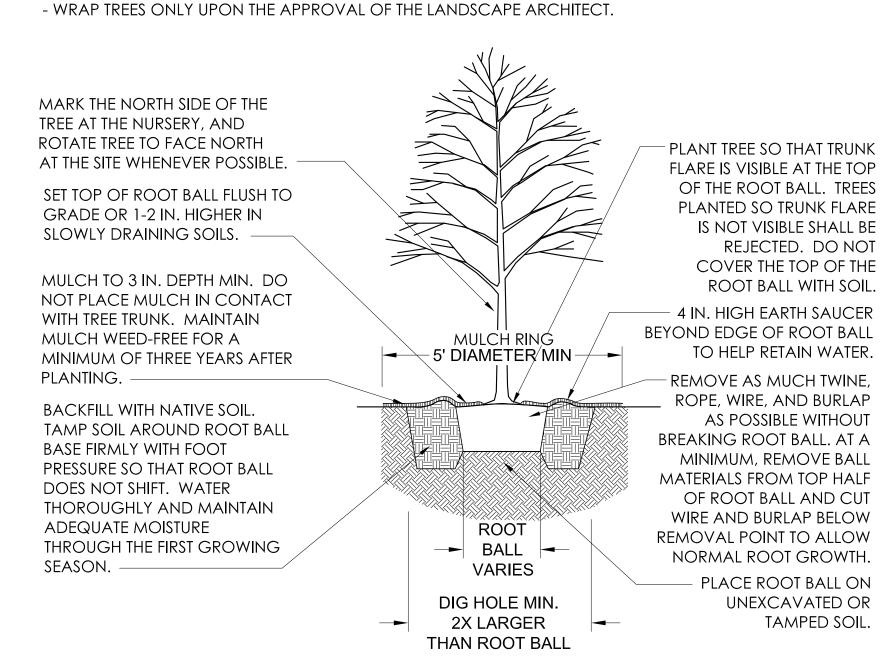

TREE PLANTING DETAIL - B&B TREES NOT TO SCALE

- KEEP CONTAINER/BURLAP ON PLANTS UNTIL READY TO INSTALL TO MINIMIZE ROOT DAMAGE FROM EXPOSURE TO AIR. GENTLY LOOSEN ROOTS ON ROOTBOUND PLANTS. SEVERELY ROOTBOUND PLANTS SHALL BE REJECTED.

- APPLY BALANCED SLOW RELEASE FERTILIZER PELLETS TO SURFACE OF SOIL PRIOR TO MULCHING,

PER SPECIFIED APPLICATION RATES. - WATER PLANTS THOROUGHLY AFTER PLANTING TO SETTLE SOIL.

REMOVE DEAD/DAMAGED SET ROOT FLARE AT OR SLIGHTLY BRANCHES AS NEEDED, RETAINING HIGHER (1/2-1") THAN FINISHED NORMAL PLANT SHAPE. GRADE. MULCH WITH SHREDDED MOUND TOSOIL TO 4" HT. HARDWOOD BARK TO 3" DEPTH AROUND PLANTING AREA TO MIN. -RETAIN WATER AROUND ROOTS BACKFILL WITH NATIVE TOPSOIL REMOVE WIRE/TWINE FROM TOP IN 8" MAX. LIFTS, TAMPING 1/2 OF ROOT BALL MIN. CUT LIGHTLY TO STABILIZE ROOT BALL. AND REMOVE BURLAP FROM TOP 1/2 OF ROOT BALL. REMOVE ROOT UNDISTURBED SUBGRADE. → BALL → ALL NON- BIODEGRADABLE MATERIALS FROM ROOT BALL IF **VARIES** POSSIBLE TO DO SO WITHOUT DISTURBING ROOTS. DIG HOLE MIN. → 2X LARGER → THAN ROOT BALL

SHRUB PLANTING DETAIL NOT TO SCALE

- KEEP CONTAINERS ON PLANTS UNTIL READY TO INSTALL TO MINIMIZE ROOT DAMAGE FROM EXPOSURE TO AIR. GENTLY LOOSEN ROOTS ON ROOTBOUND PLANTS. SEVERELY ROOTBOUND PLANTS WILL BE REJECTED.

- APPLY BALANCED SLOW RELEASE FERTILIZER PELLETS TO SOIL SURFACE PRIOR TO MULCHING, PER SPECIFIED APPLICATION RATES. - WATER PLANTS THOROUGHLY AFTER PLANTING TO SETTLE SOIL.


> PERENNIAL PLANTS- SEE PLANT LIST. SHREDDED HARDWOOD BARK MULCH TO 3" DEPTH MIN. DO NOT MOUND MULCH AGAINST PLANTS. - EXISTING TOPSOIL.

PERENNIAL PLANTING DETAIL

 CRITICAL ROOT RADIUS (IN FEET) = 1' x DBH EXAMPLE: 6" DBH TREE = 6' RADIUS

 ONLY HANDWORK ALLOWED WITHIN CRITICAL ROOT RADIUS. NO TRAFFIC OR STORAGE OF MATERIALS ALLOWED. NO EQUIPMENT SHALL BE OPERATED WITHIN THE CRITICAL ROOT RADIUS

INCLUDING DURING FENCE INSTALLATION AND REMOVAL. NO PRUNING SHALL BE PERFORMED EXCEPT BY APPROVED ARBORIST

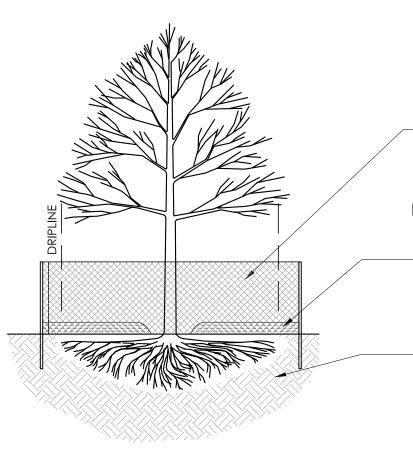

– MIN. 48" HT. CHAIN LINK OR SIMILARLY DURABLE FENCE AROUND CRITICAL ROOT RADIUS AS BASE PROTECTION. MOUNT FENCE ON VERTICAL PIPES DRIVEN 2'-0" MIN. IN THE GROUND, AT 10'-0" MAX. ON CENTER. NO GATES.

SPREAD 4" SHREDDED BARK MULCH INSIDE FENCE AREA OVER WEED BARRIER FABRIC. DO NOT PLACE WITHIN 6" OF TRUNK.


MAINTAIN ADEQUATE SOIL MOISTURE (ABOVE PERMANENT WILT POINT) WITHIN TOP 8" OF SOIL FOR THE DURATION OF CONSTRUCTION. APPLY ADDITIONAL WATER VIA HOSE, WATER TANK, OR TREE BAG DURING PERIODS OF DROUGHT OR EXTREME HEAT. MIN. 48" HT. ORANGE HDPE FENCE AROUND CRITICAL ROOT RADIUS AS BASE PROTECTION. SECURE WITH 2" X 6' STEEL POSTS 8' O.C. TYPICAL. FASTEN FENCE TO POSTS WITH PLASTIC ZIP TIES OR WIRE BINDING.

TREE PROTECTION FENCE NOT TO SCALE

DETAILS

NOT FOR CONSTRUCTION

PROJECT NO. 210063 L200

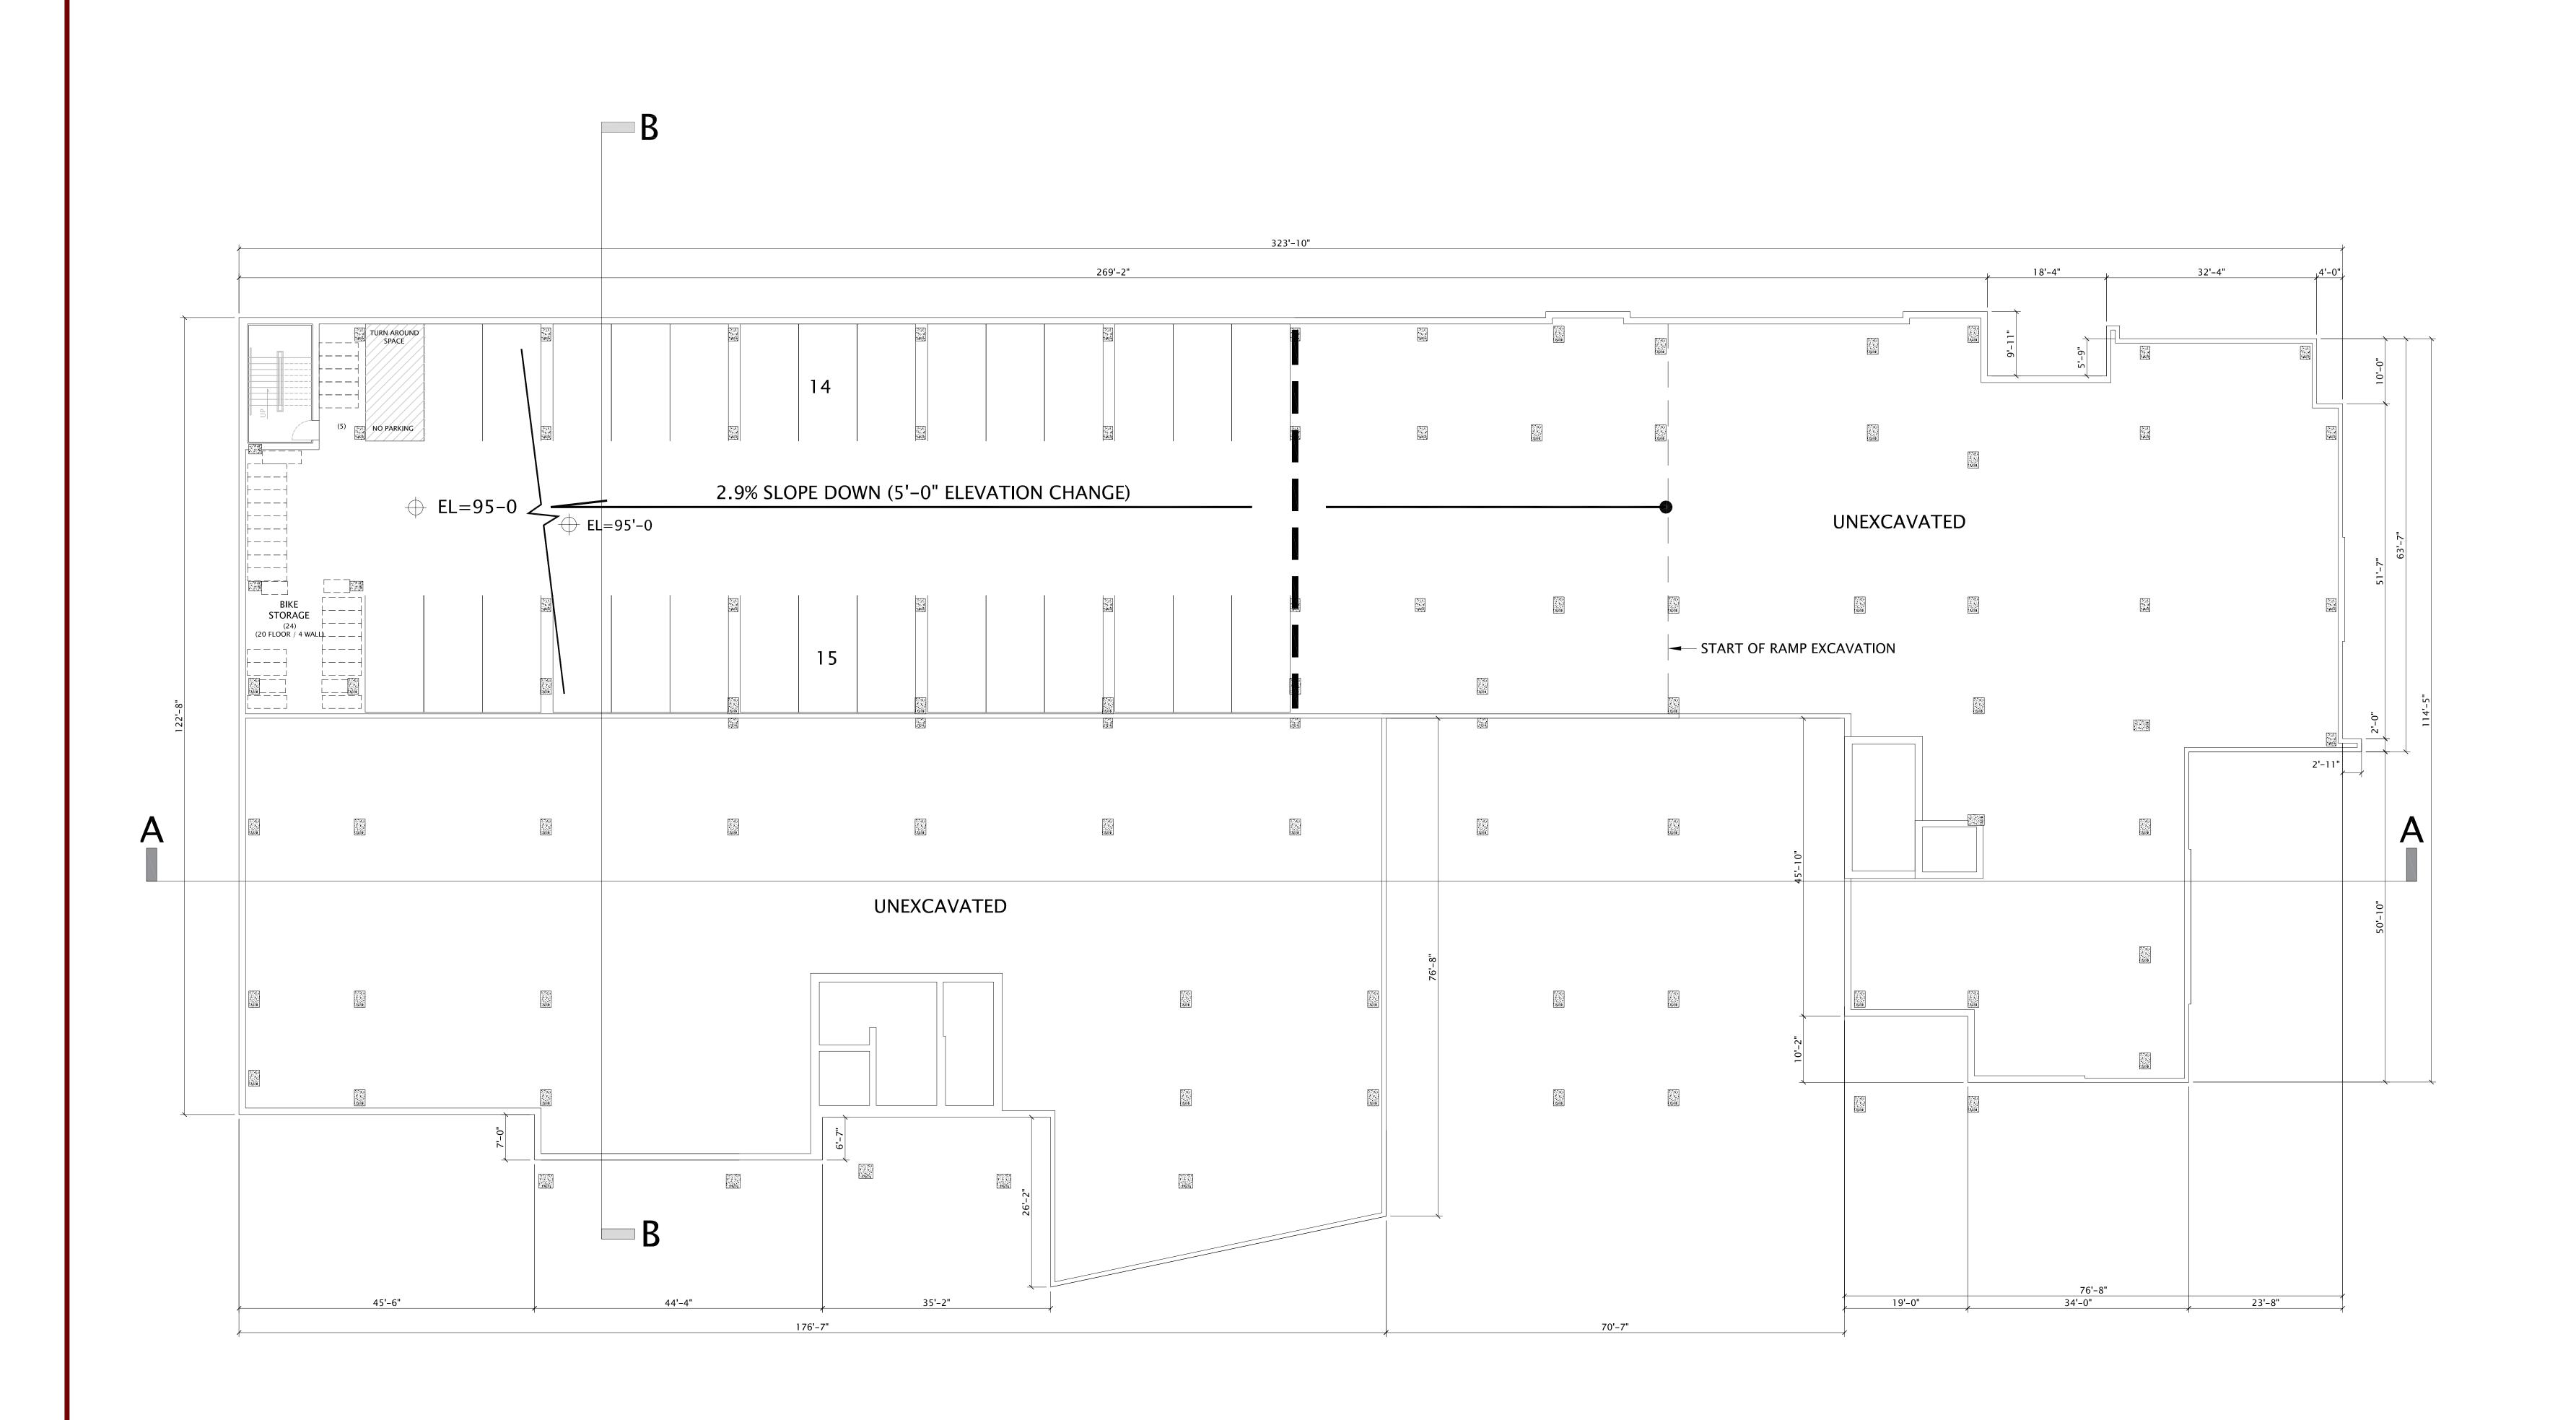

NUMBER OF LOWER LEVEL PARKING STALLS PROVIDED = 29

NUMBER OF LOWER LEVEL FLOOR BIKE STALLS PROVIDED = 25 NUMBER OF LOWER LEVEL WALL-MOUNT BIKE SPACES PROVIDED = 4

TOTAL LOWER LEVEL BIKE SPACES = 29

OLIN AVENUE MIXED-USE DEVELOPMENT – LAND USE APPLICATION


MAY 19, 2021 3/32"=1'@30x42

PLAN TRUE

NORTH NORTH



JLA PROJECT NUMBER:

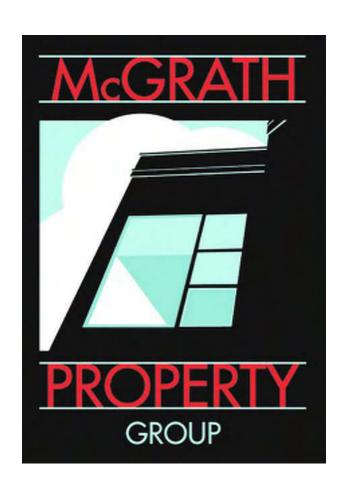

OLIN AVENUE MIXED-USE DEVELOPMENT

LAND USE APPLICATION

PROGRESS DOCUMENTS These documents reflect progress and intent and may be subject to change, including additional detail. These are not final construction documents


DATE OF ISSUANCE MAY 19, 2021 REVISION SCHEDULE Description

and should not be used for final bidding or


LOWER LEVEL FLOOR PLAN

A100

FLOOR PLANS – LOWER LEVEL 1 (PLL 1)

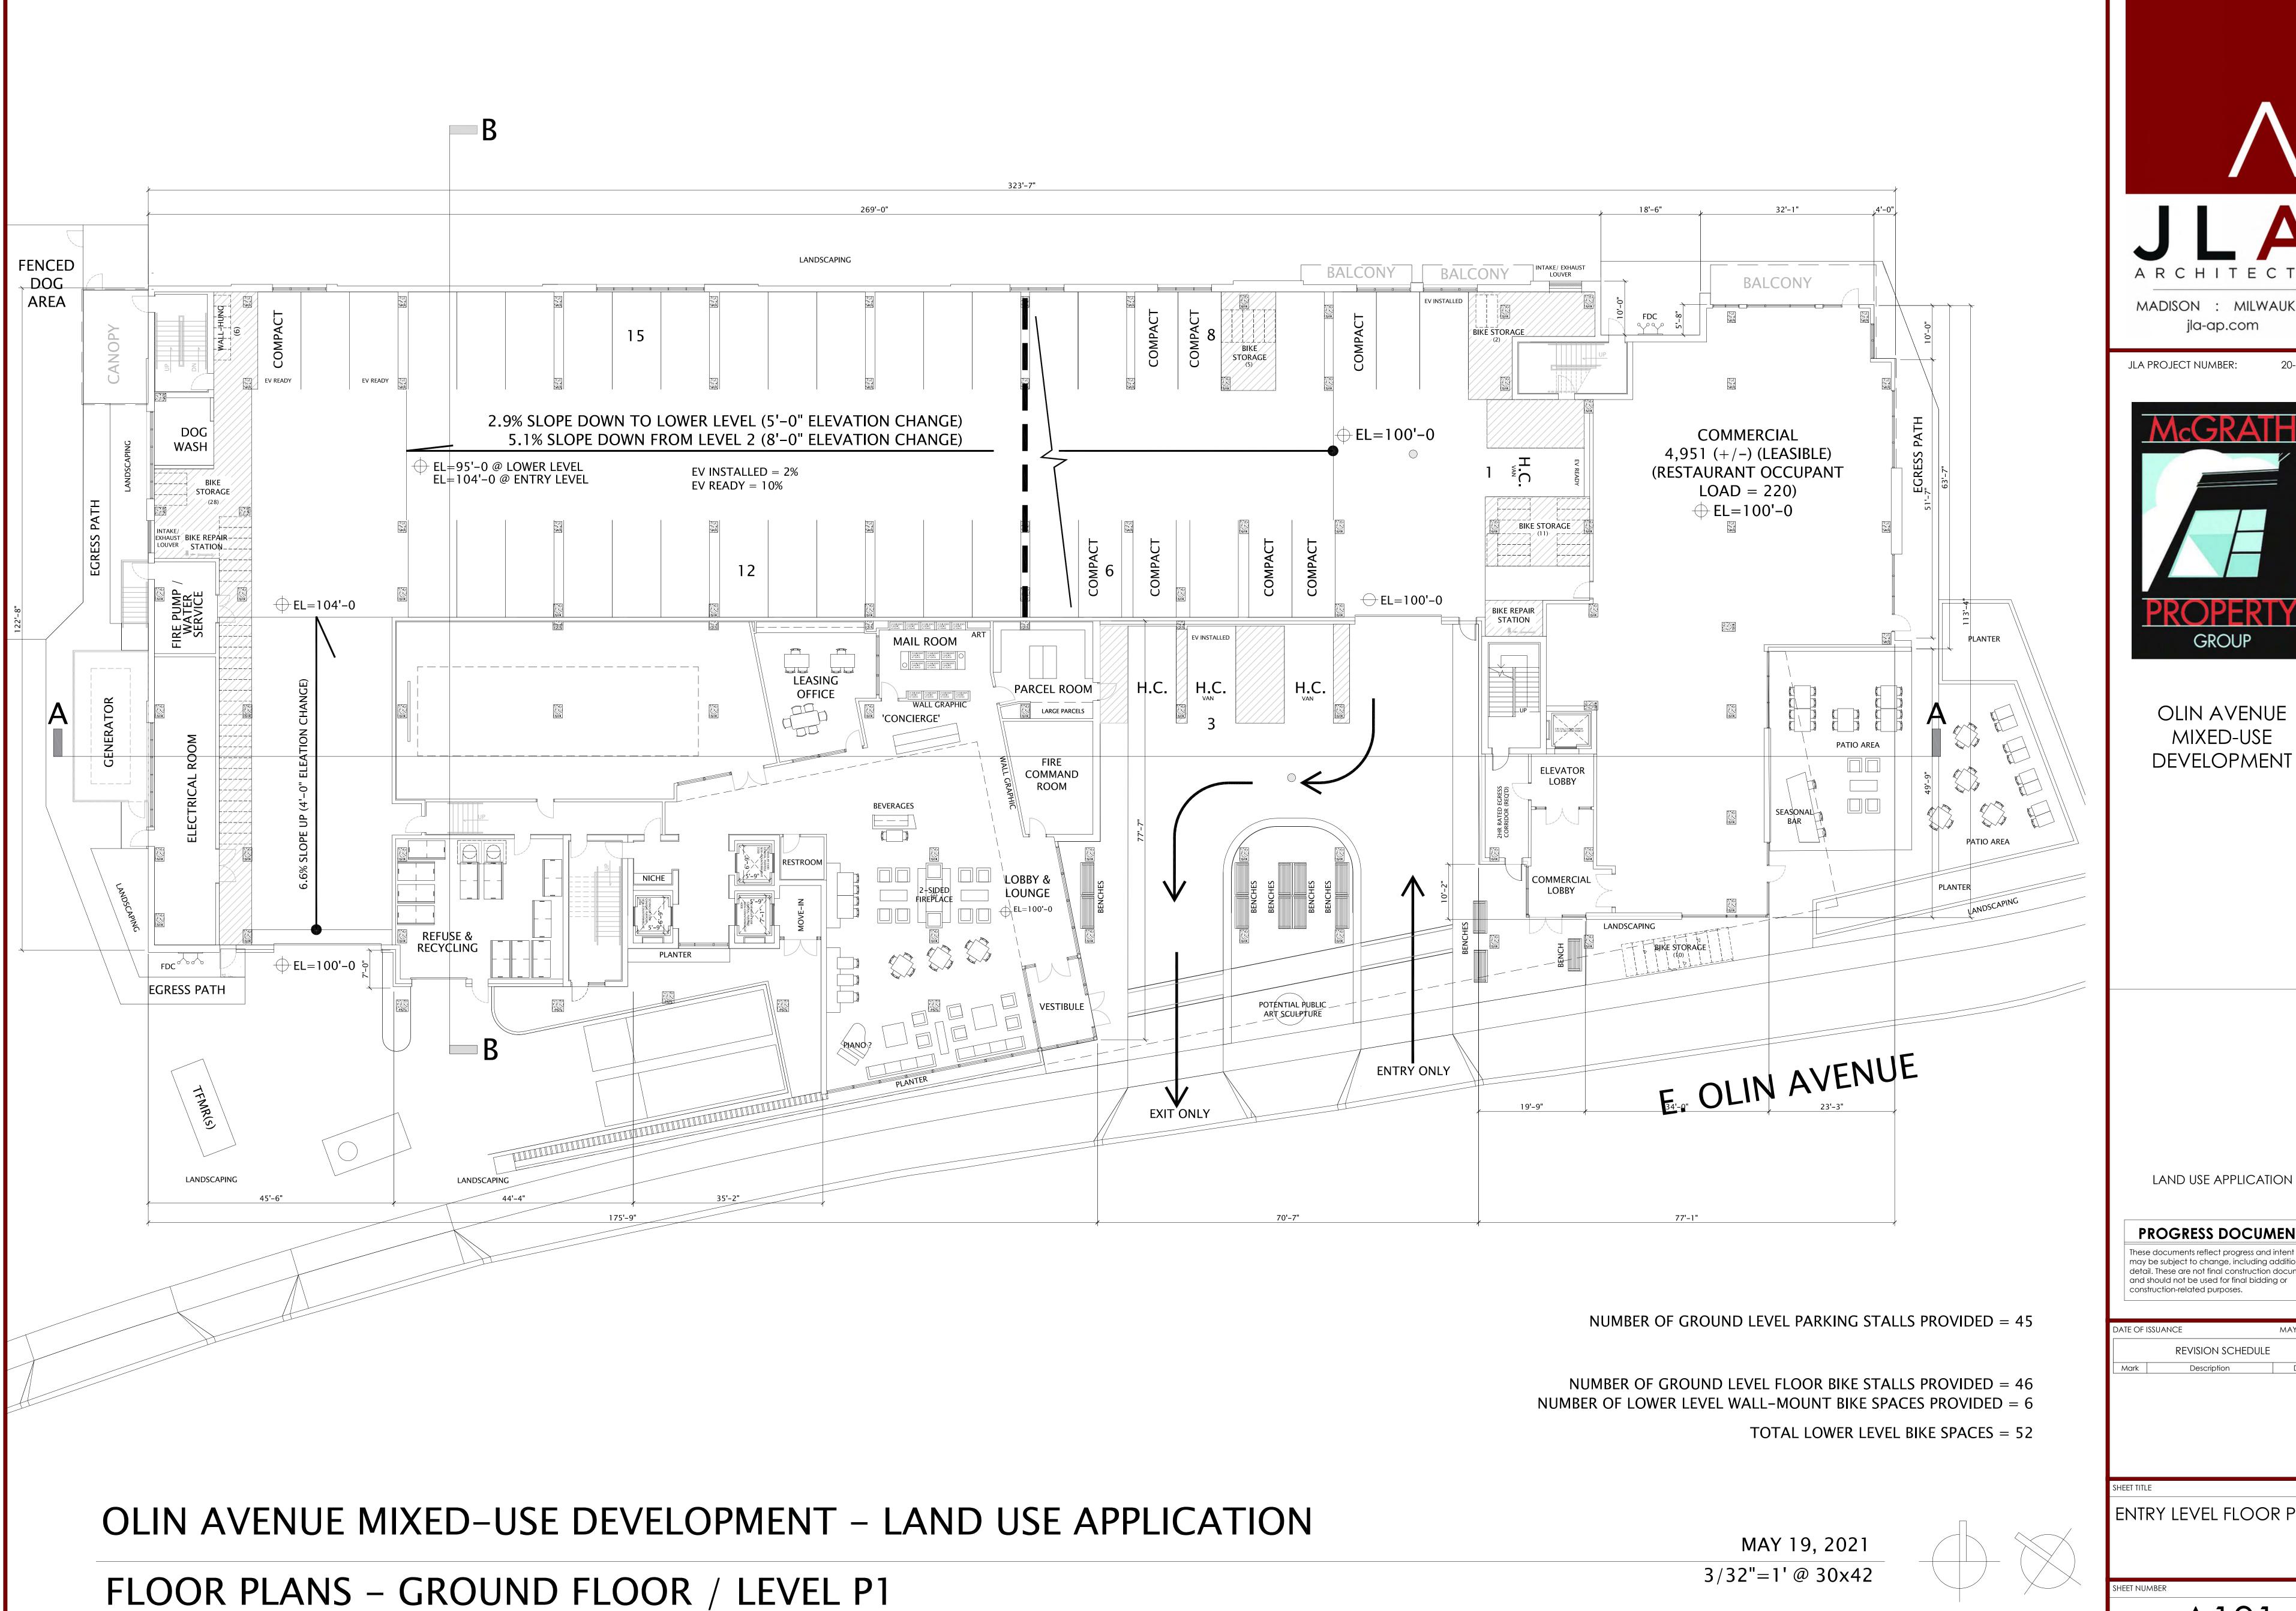

MADISON : MILWAUKEE

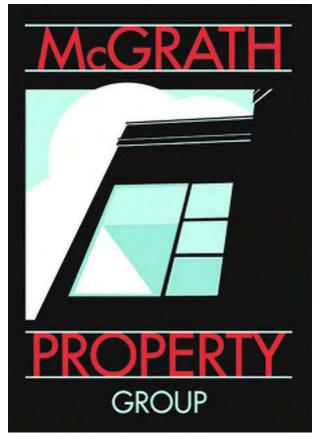

OLIN AVENUE MIXED-USE DEVELOPMENT

PROGRESS DOCUMENTS detail. These are not final construction documents and should not be used for final bidding or

MAY 19, 202 REVISION SCHEDULE


ENTRY LEVEL FLOOR PLAN

PLAN

NORTH NORTH

TRUE

A101

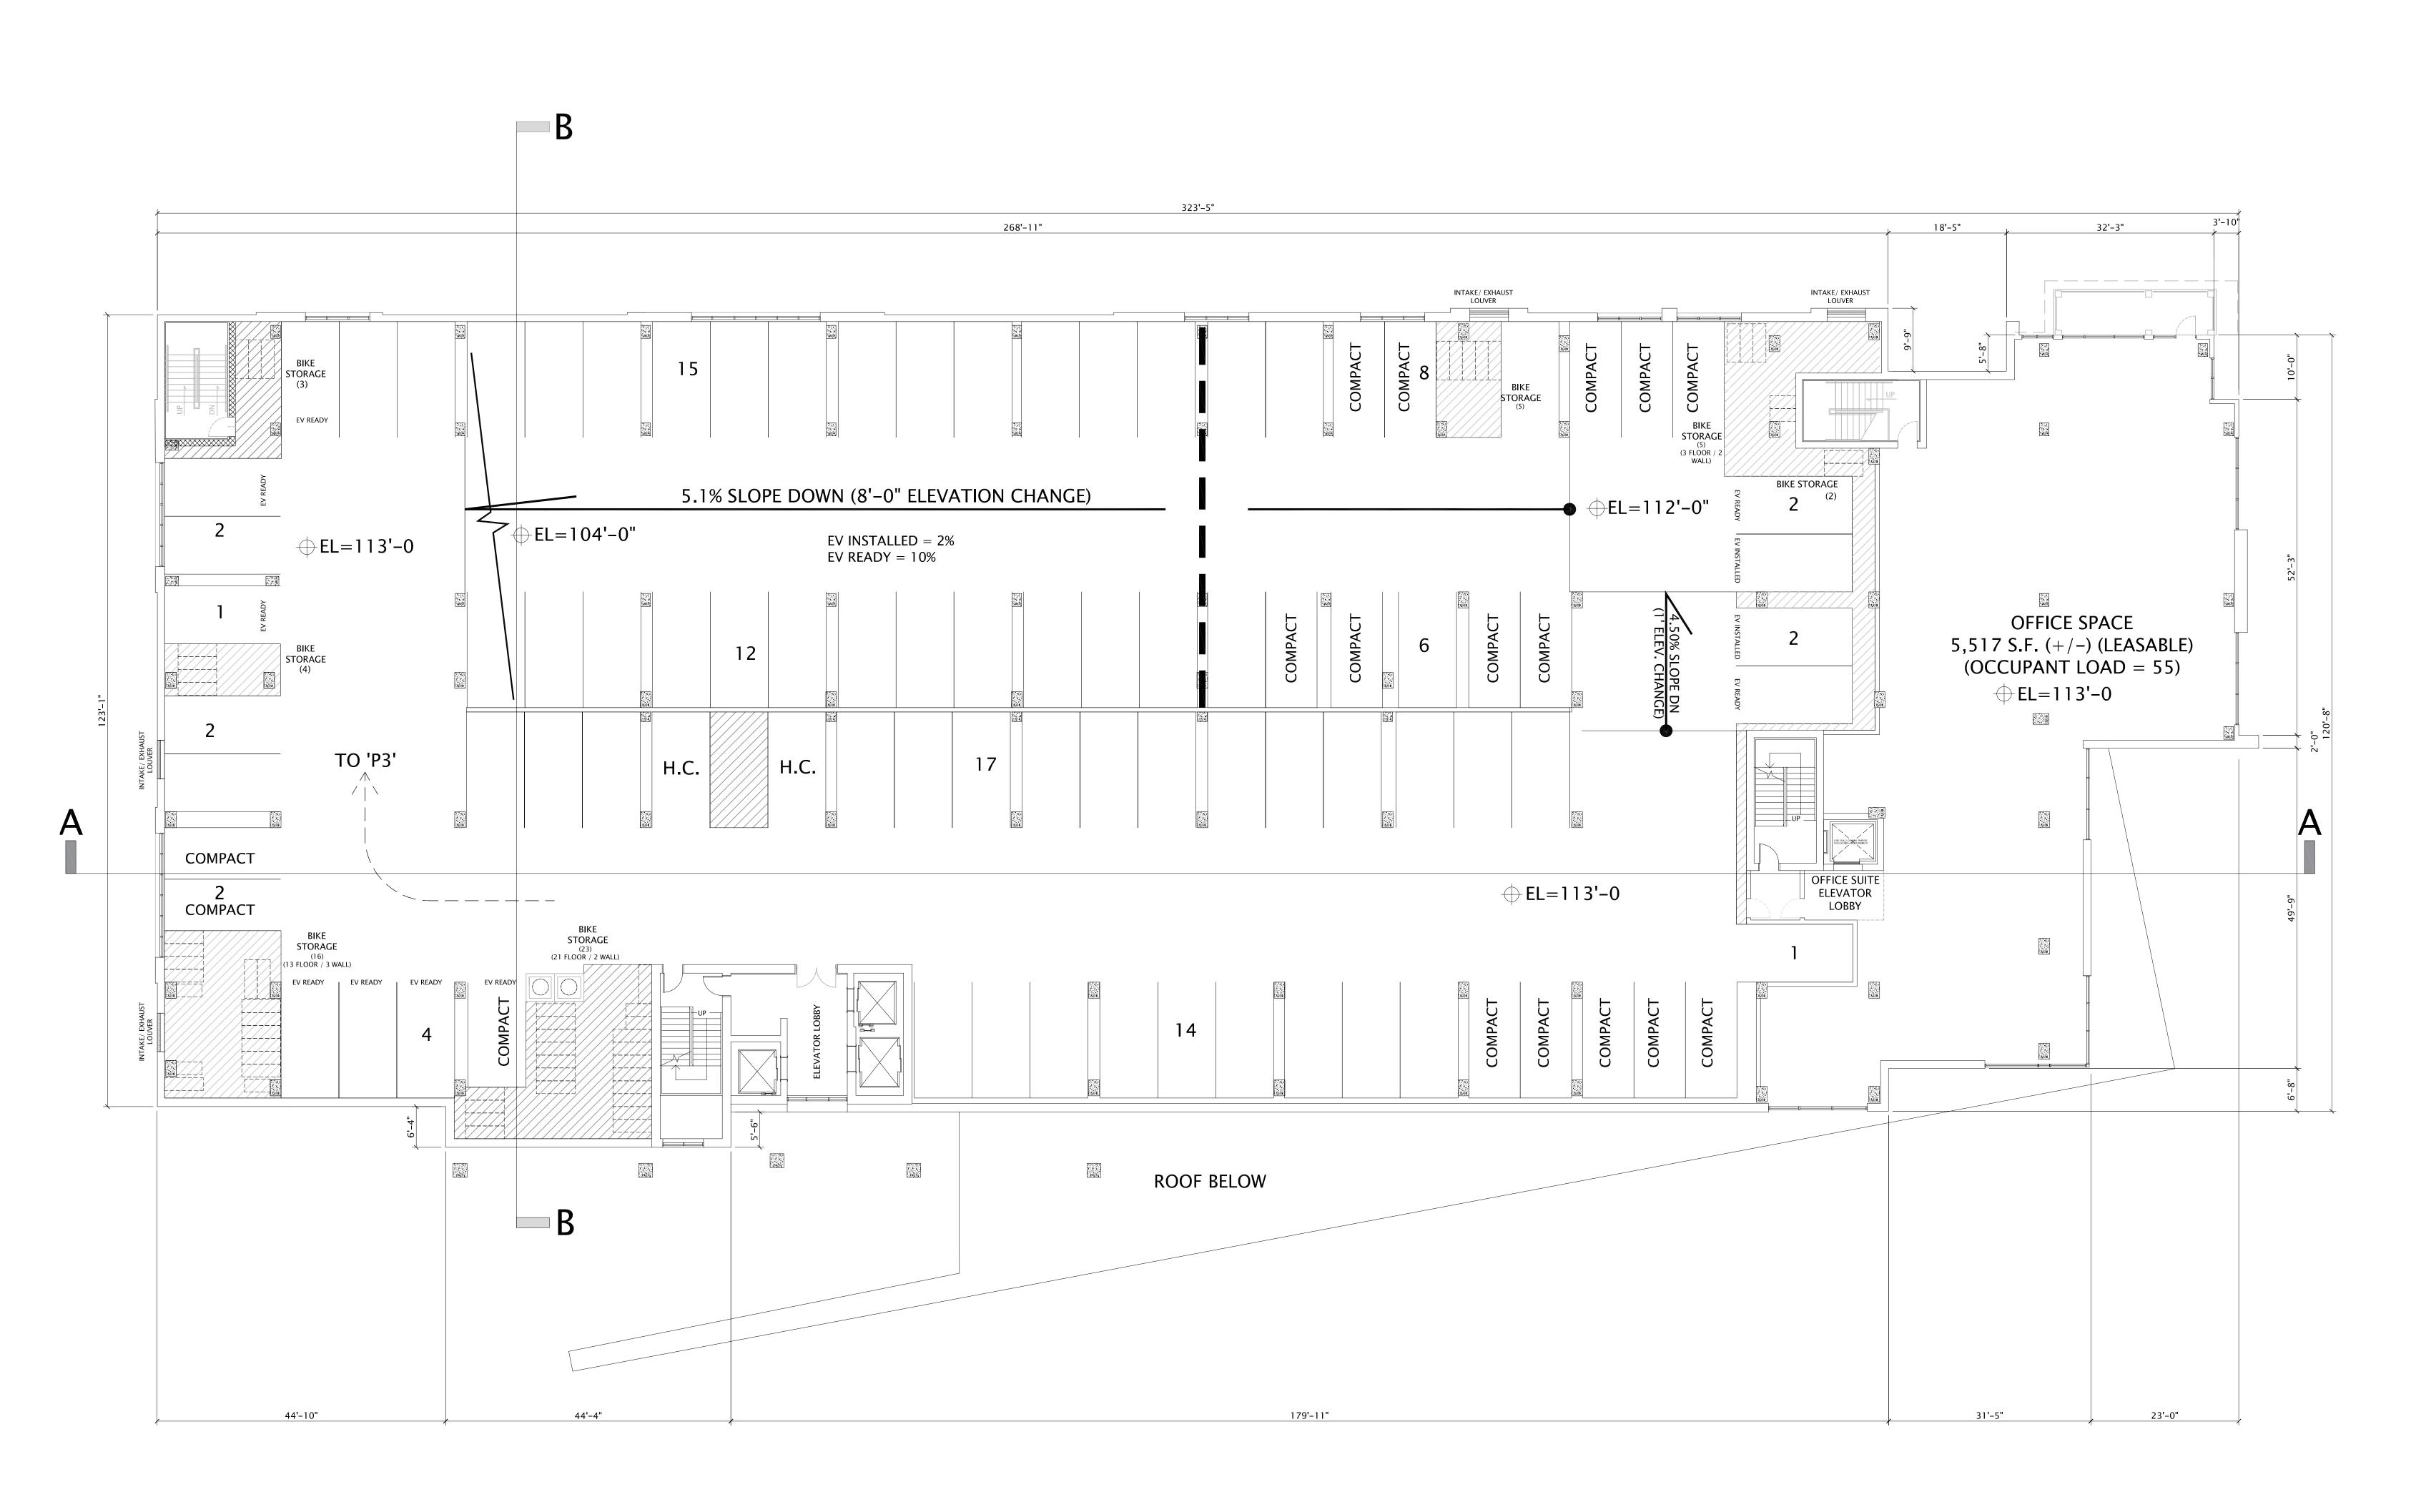

construction-related purposes.

NUMBER OF FLOOR BIKE STALLS = 51 NUMBER OF WALL-MOUNT BIKE SPACES = 7

NUMBER OF LEVEL 2 PARKING STALLS = 88

TOTAL LEVEL 2 BIKE SPACES = 58

OLIN AVENUE MIXED-USE DEVELOPMENT – LAND USE APPLICATION

MAY 19, 2021 3/32"=1' @ 30x42

PLAN TRUE NORTH NORTH

A102P

FLOOR PLANS – FLOOR 2 (P2)

LAND USE APPLICATION

MADISON : MILWAUKEE

jla-ap.com

GROUP

OLIN AVENUE

MIXED-USE

DEVELOPMENT

JLA PROJECT NUMBER:


PROGRESS DOCUMENTS These documents reflect progress and intent and may be subject to change, including additional detail. These are not final construction documents

DATE OF ISSUANCE MAY 19, 202 REVISION SCHEDULE

and should not be used for final bidding or

2nd LEVEL PARKING

FLOOR PLAN

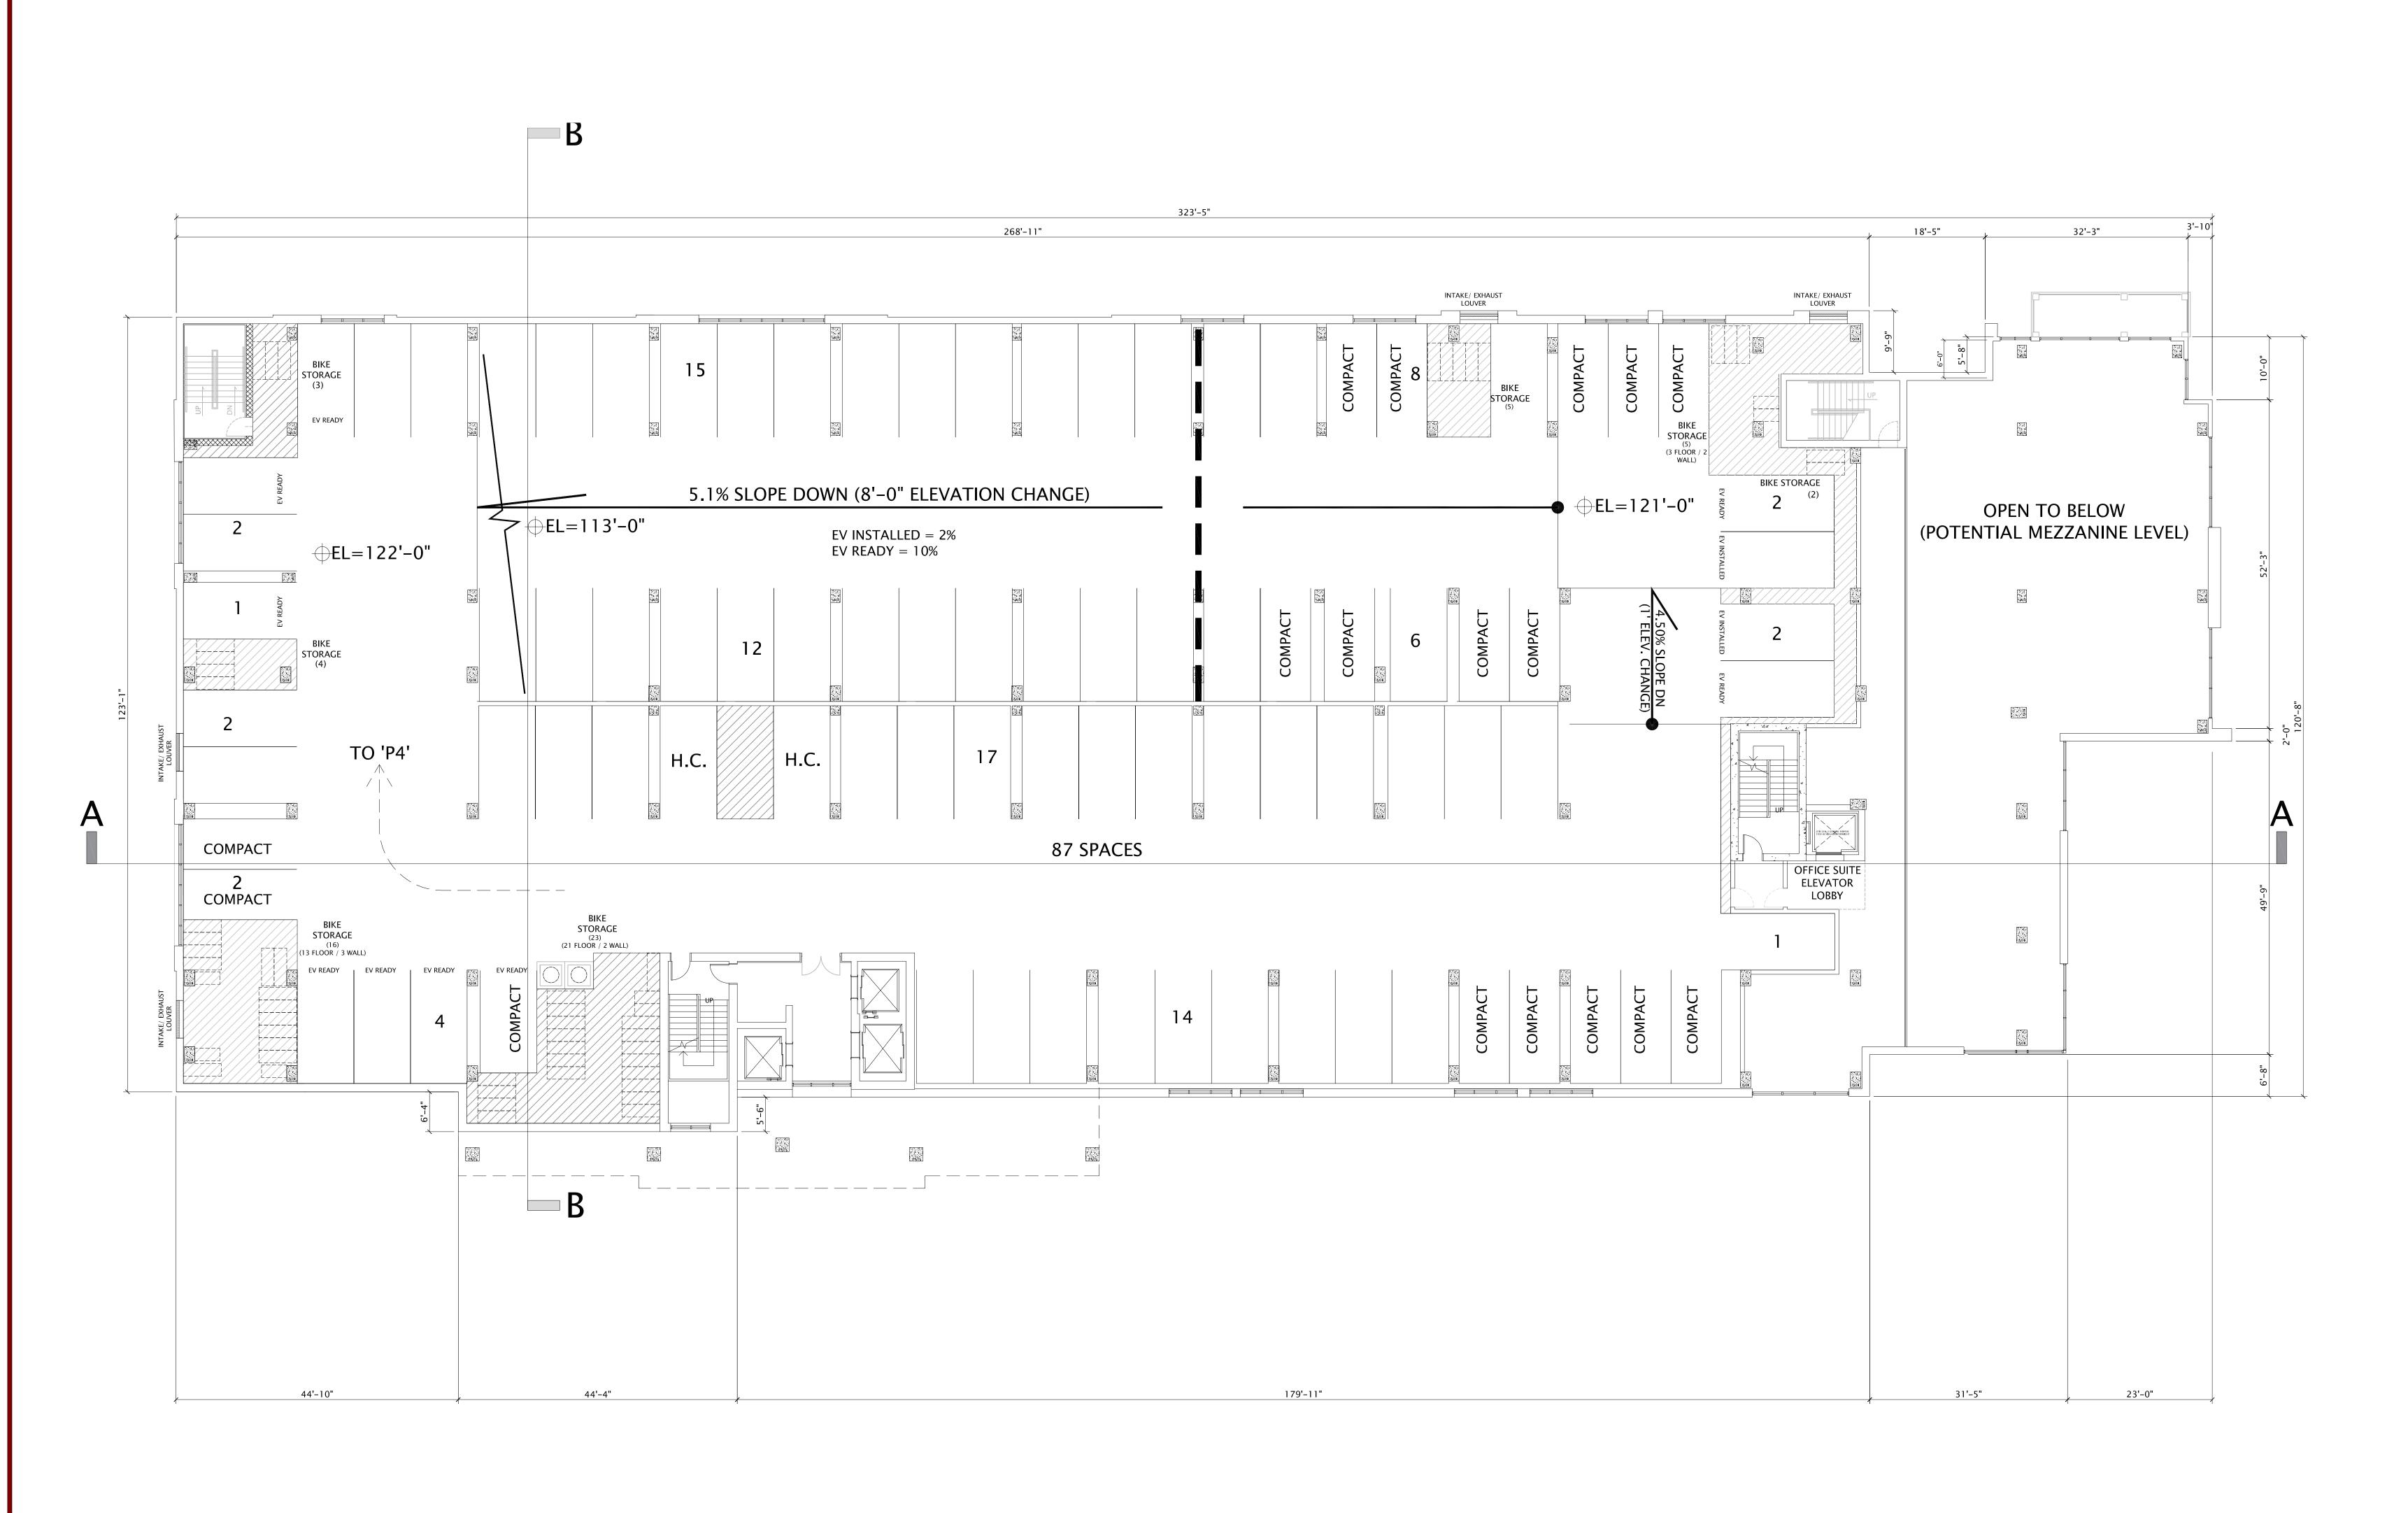

NUMBER OF PARKING STALLS = 88

NUMBER OF FLOOR BIKE STALLS = 51NUMBER OF WALL-MOUNT BIKE SPACES = 7

TOTAL LEVEL 3 BIKE SPACES = 58

OLIN AVENUE MIXED-USE DEVELOPMENT – LAND USE APPLICATION

MAY 19, 2021 3/32"=1' @ 30x42

PLAN TRUE NORTH NORTH

A103P

FLOOR PLANS – FLOOR 3 (P3)

LAND USE APPLICATION

MADISON : MILWAUKEE

jla-ap.com

GROUP

OLIN AVENUE

MIXED-USE

DEVELOPMENT


JLA PROJECT NUMBER:

PROGRESS DOCUMENTS

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DATE OF ISSUANCE MAY 19, 202 REVISION SCHEDULE

3rd LEVEL PARKING FLOOR PLAN

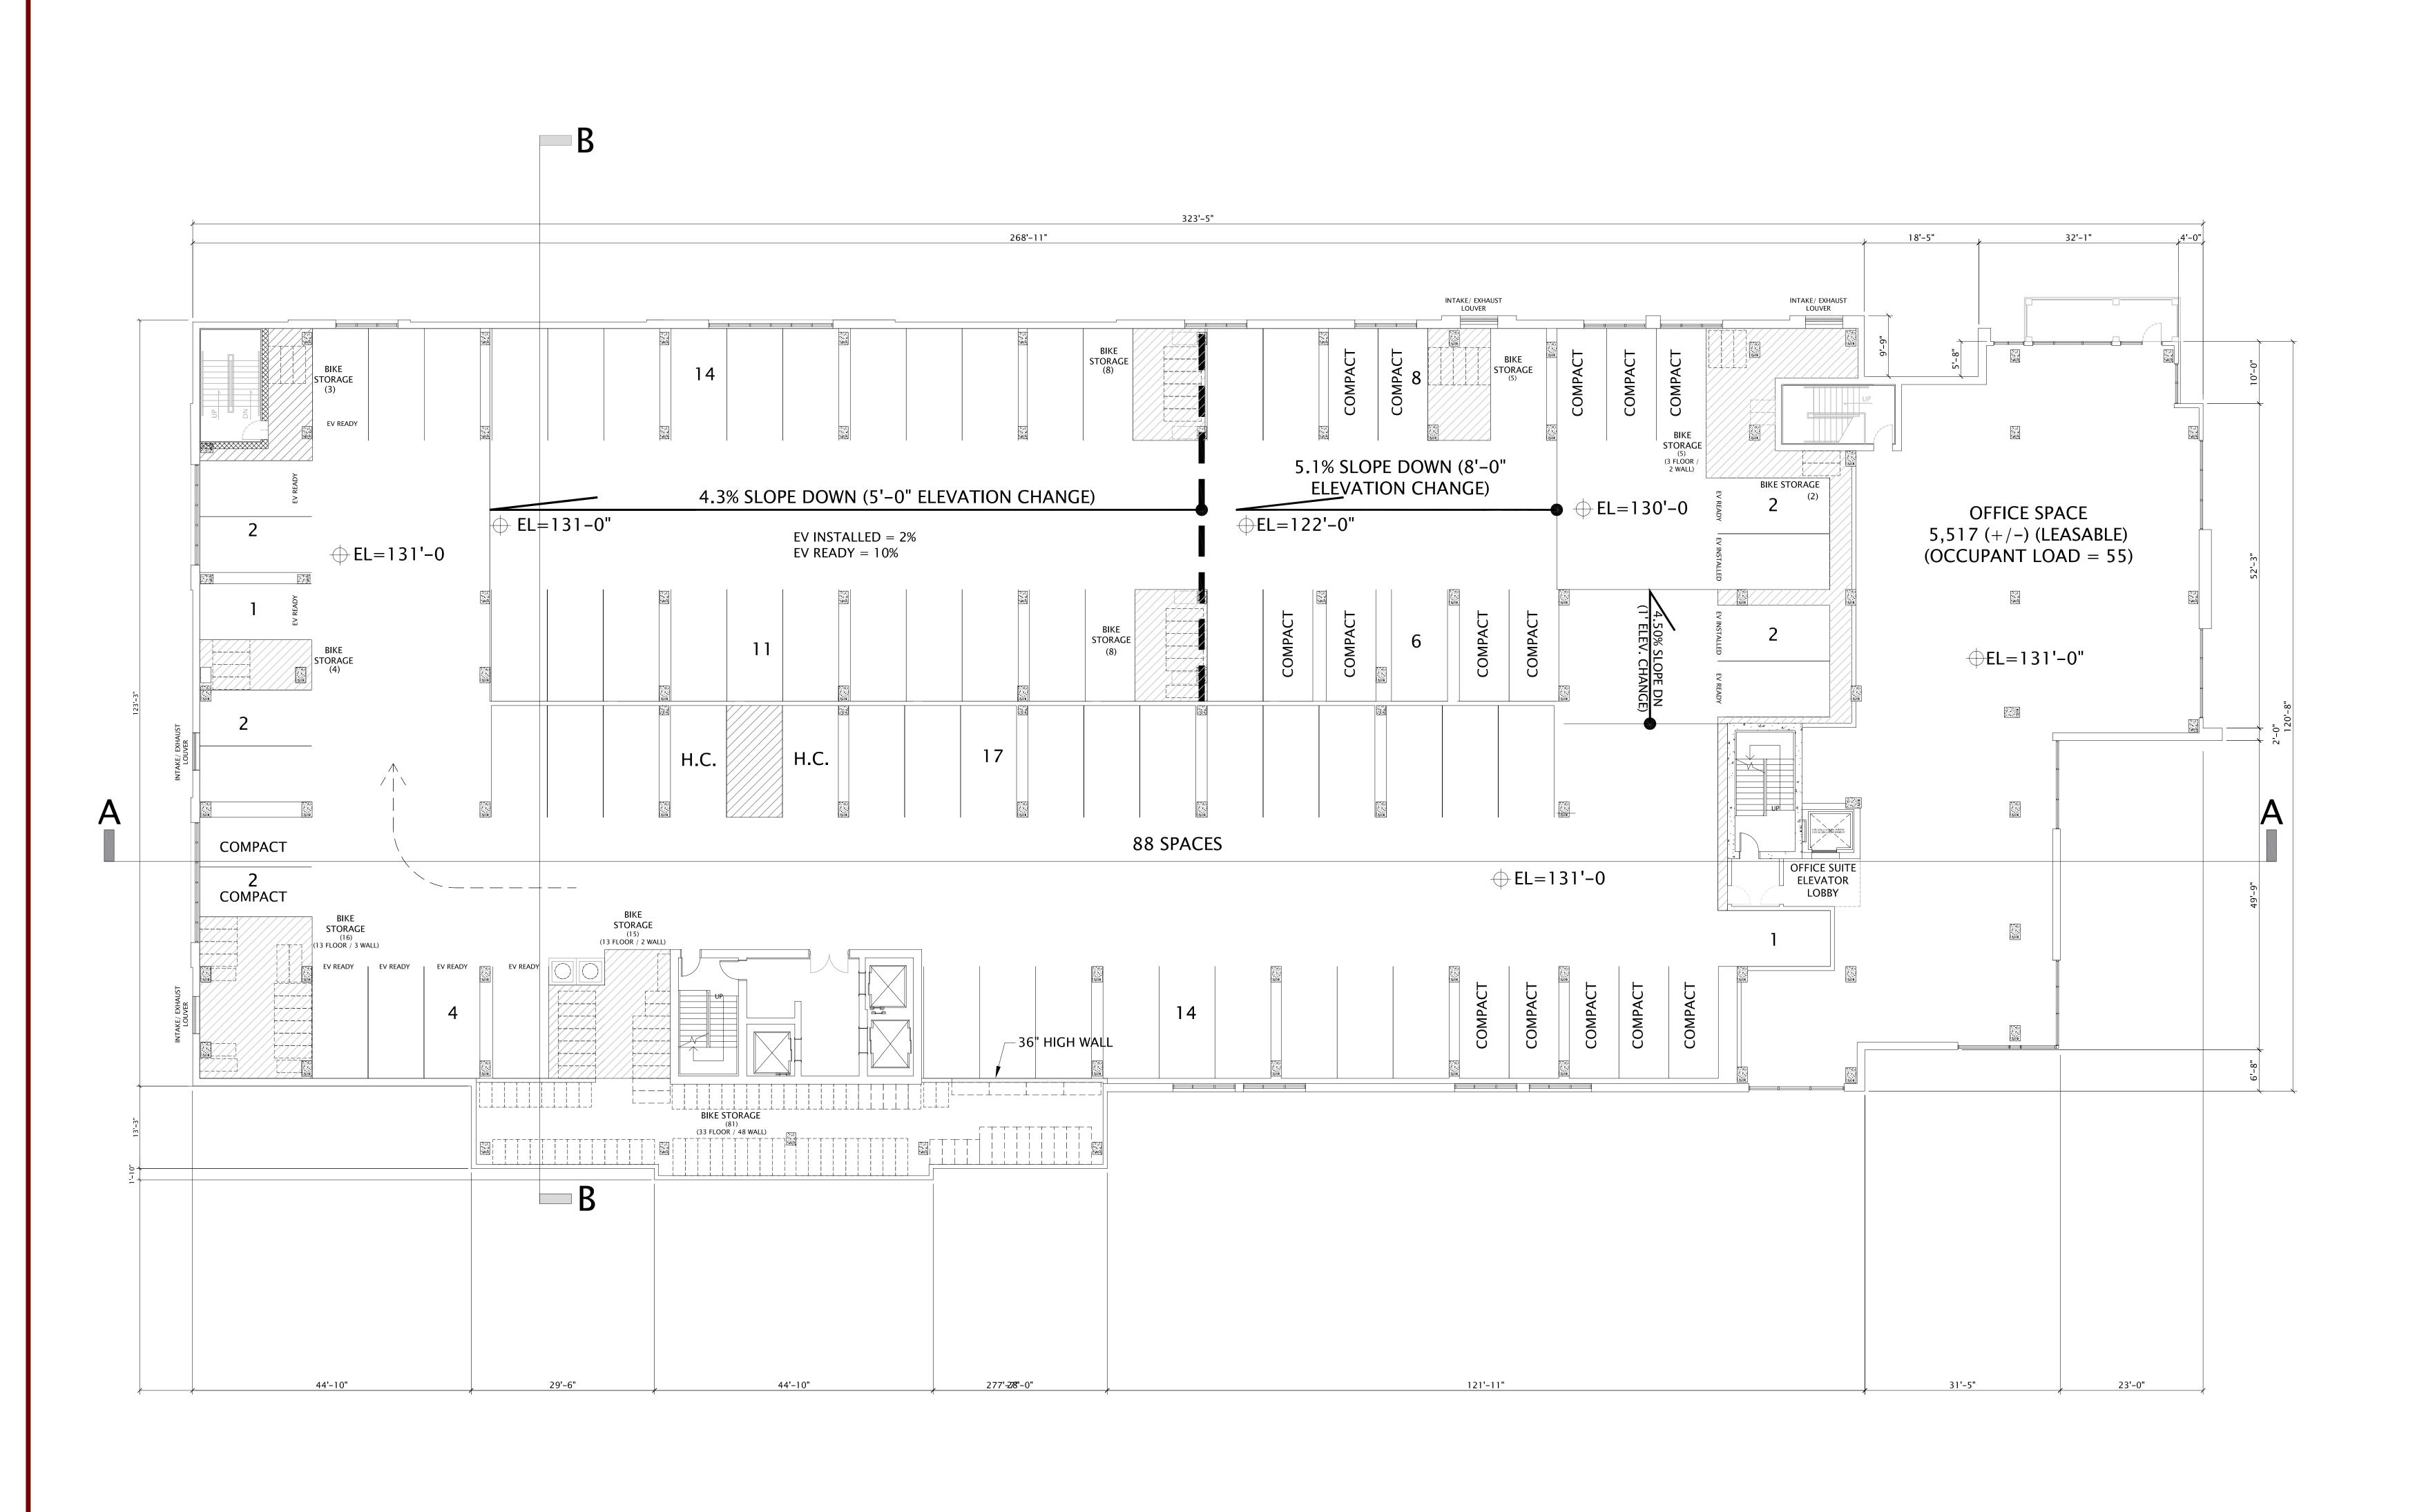

NUMBER OF PARKING STALLS = 86

NUMBER OF FLOOR BIKE STALLS = 87 NUMBER OF WALL-MOUNT BIKE SPACES = 60

TOTAL LEVEL 4 BIKE SPACES = 147

OLIN AVENUE MIXED-USE DEVELOPMENT – LAND USE APPLICATION

MAY 19, 2021 3/32"=1' @ 30x42

PLAN TRUE NORTH NORTH

A104P

MADISON : MILWAUKEE

jla-ap.com

GROUP

OLIN AVENUE

MIXED-USE

DEVELOPMENT

LAND USE APPLICATION

PROGRESS DOCUMENTS

These documents reflect progress and intent and may be subject to change, including additional detail. These are not final construction documents

REVISION SCHEDULE

4th LEVEL PARKING

FLOOR PLAN


MAY 19, 202

and should not be used for final bidding or

DATE OF ISSUANCE

JLA PROJECT NUMBER:

FLOOR PLANS – FLOOR 4 (P4)

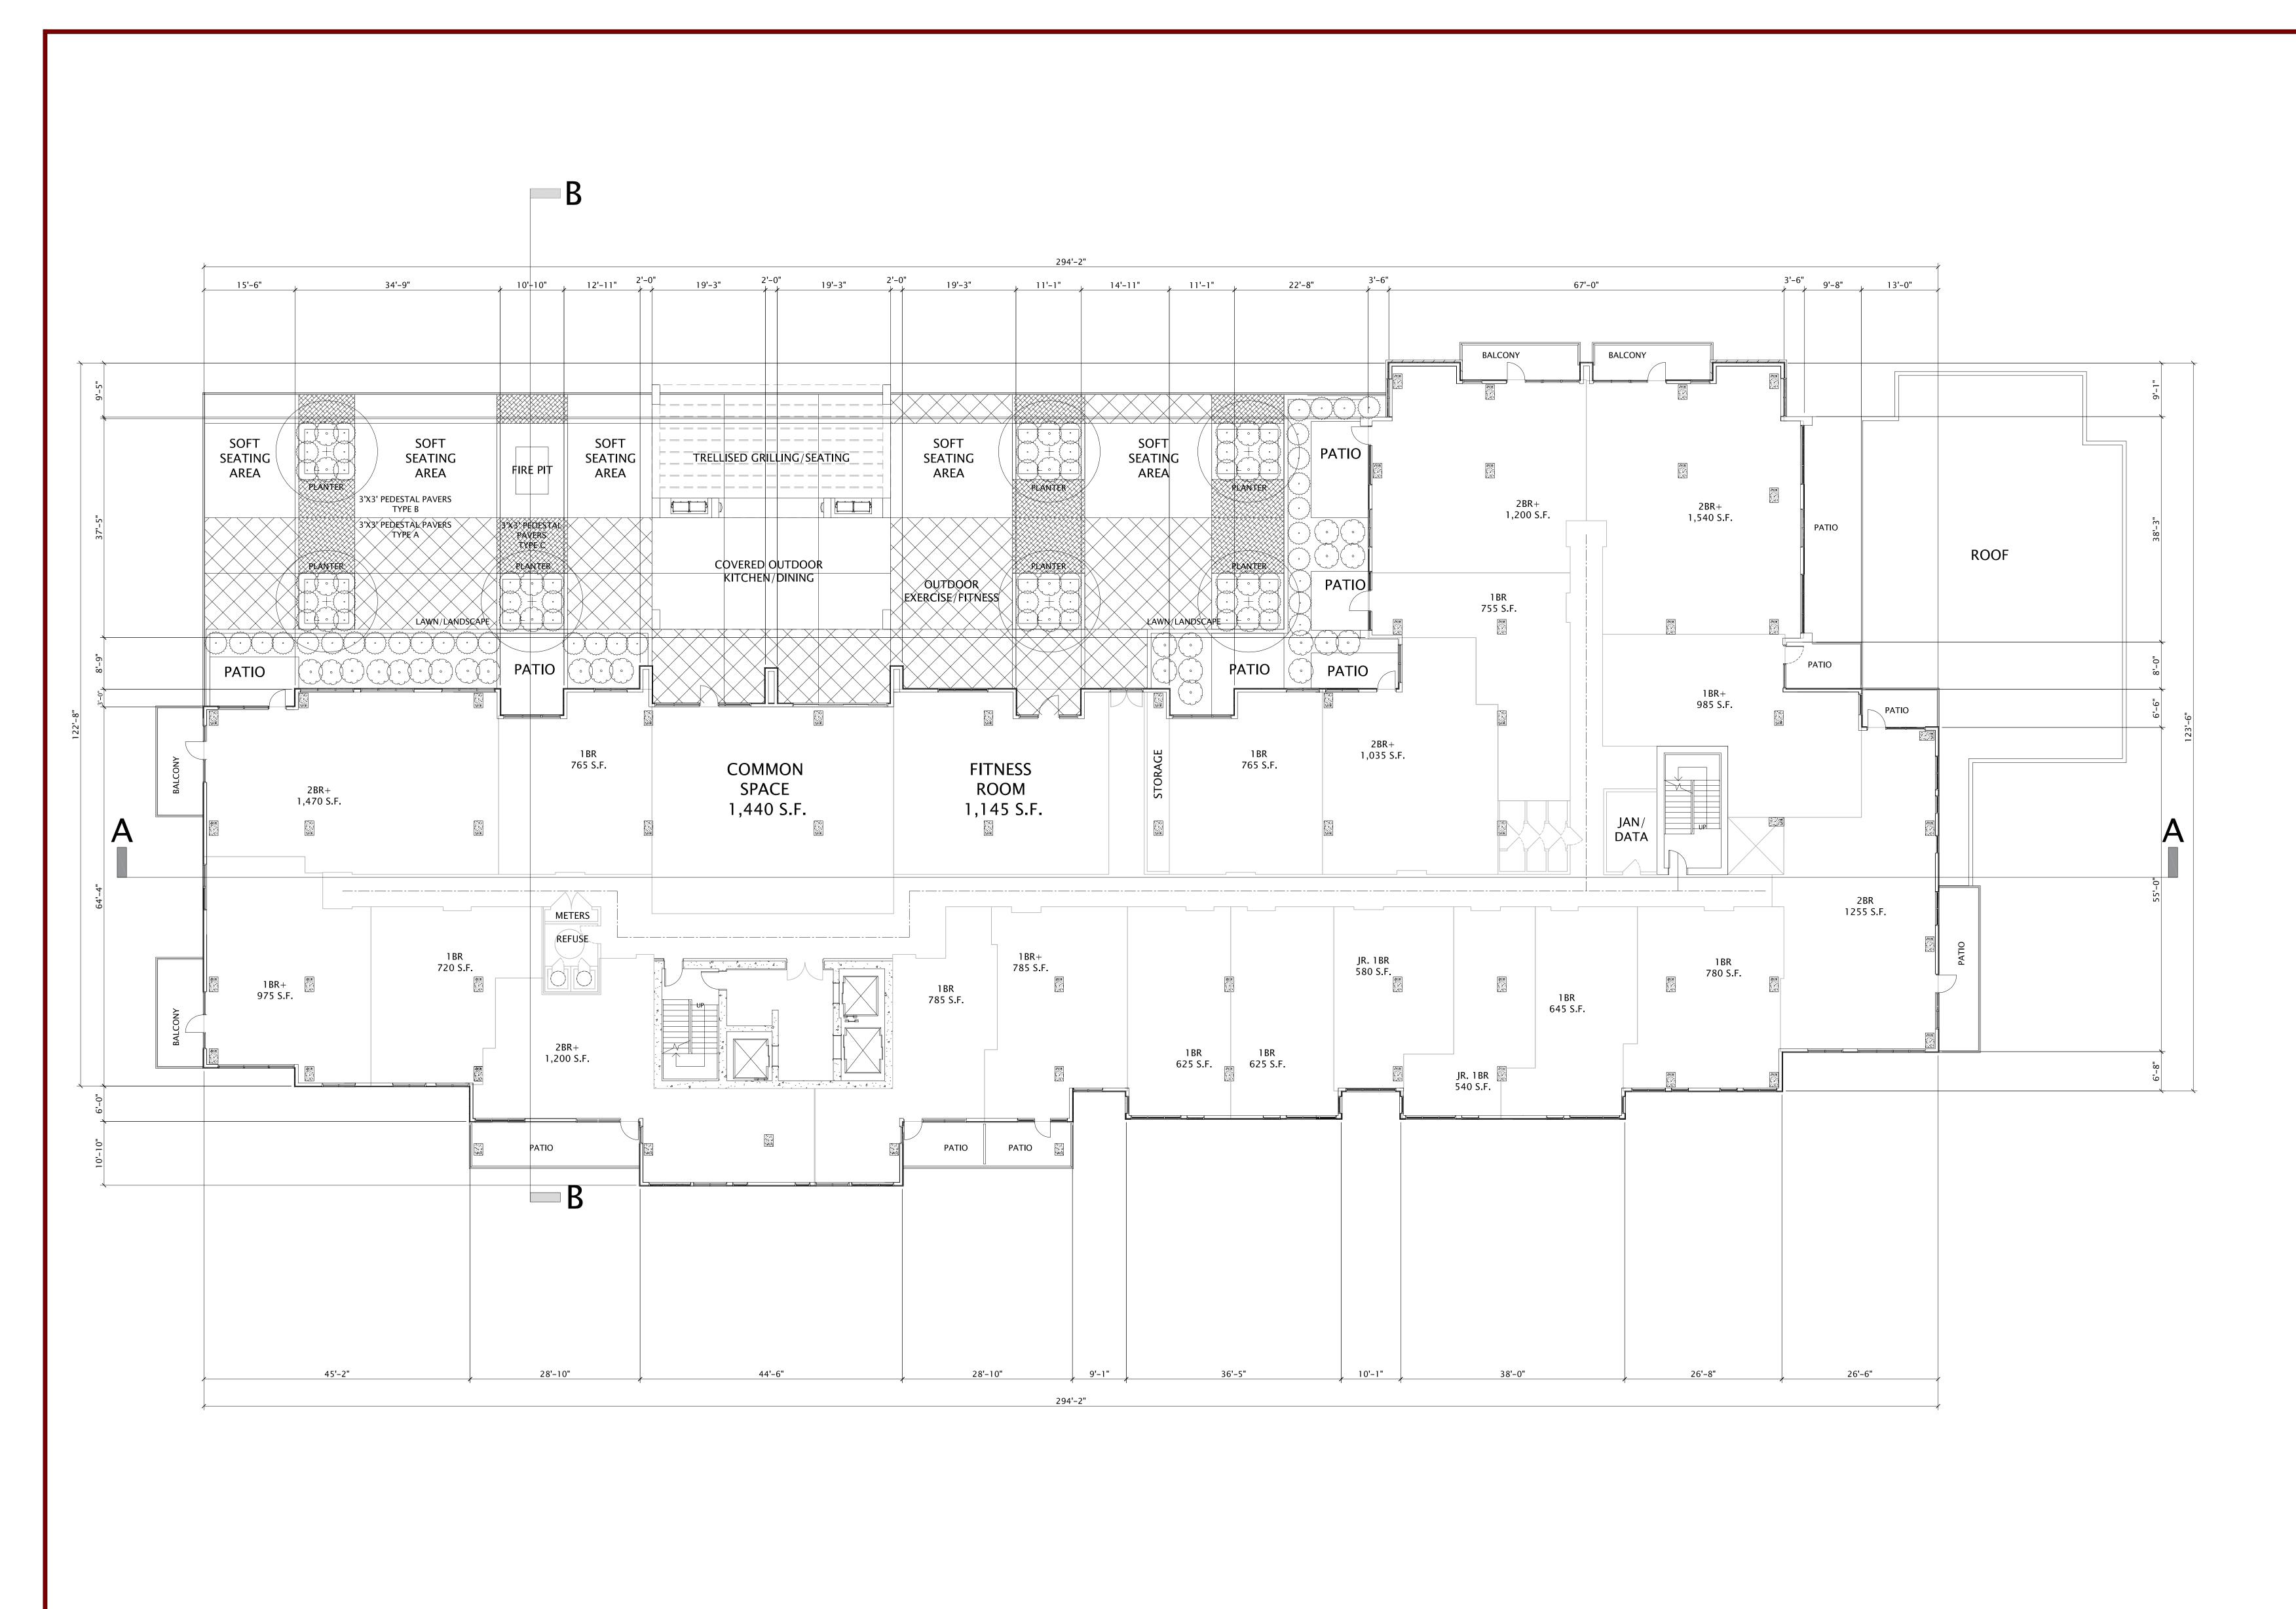

SHEET TITLE

5th LEVEL FLOOR FLOOR PLAN

MADISON : MILWAUKEE

jla-ap.com

GROUP

OLIN AVENUE

MIXED-USE

DEVELOPMENT

LAND USE APPLICATION

PROGRESS DOCUMENTS

These documents reflect progress and intent and may be subject to change, including additional detail. These are not final construction documents

REVISION SCHEDULE

MAY 19, 202

and should not be used for final bidding or

construction-related purposes.

DATE OF ISSUANCE

JLA PROJECT NUMBER:

SHEET NUMBER


TRUE A 105

OLIN AVENUE MIXED-USE DEVELOPMENT – LAND USE APPLICATION


FLOOR PLANS – FLOOR 5 (20 UNITS)

MAY 19, 2021 3/32"=1' @ 30x42

PLAN TRUE

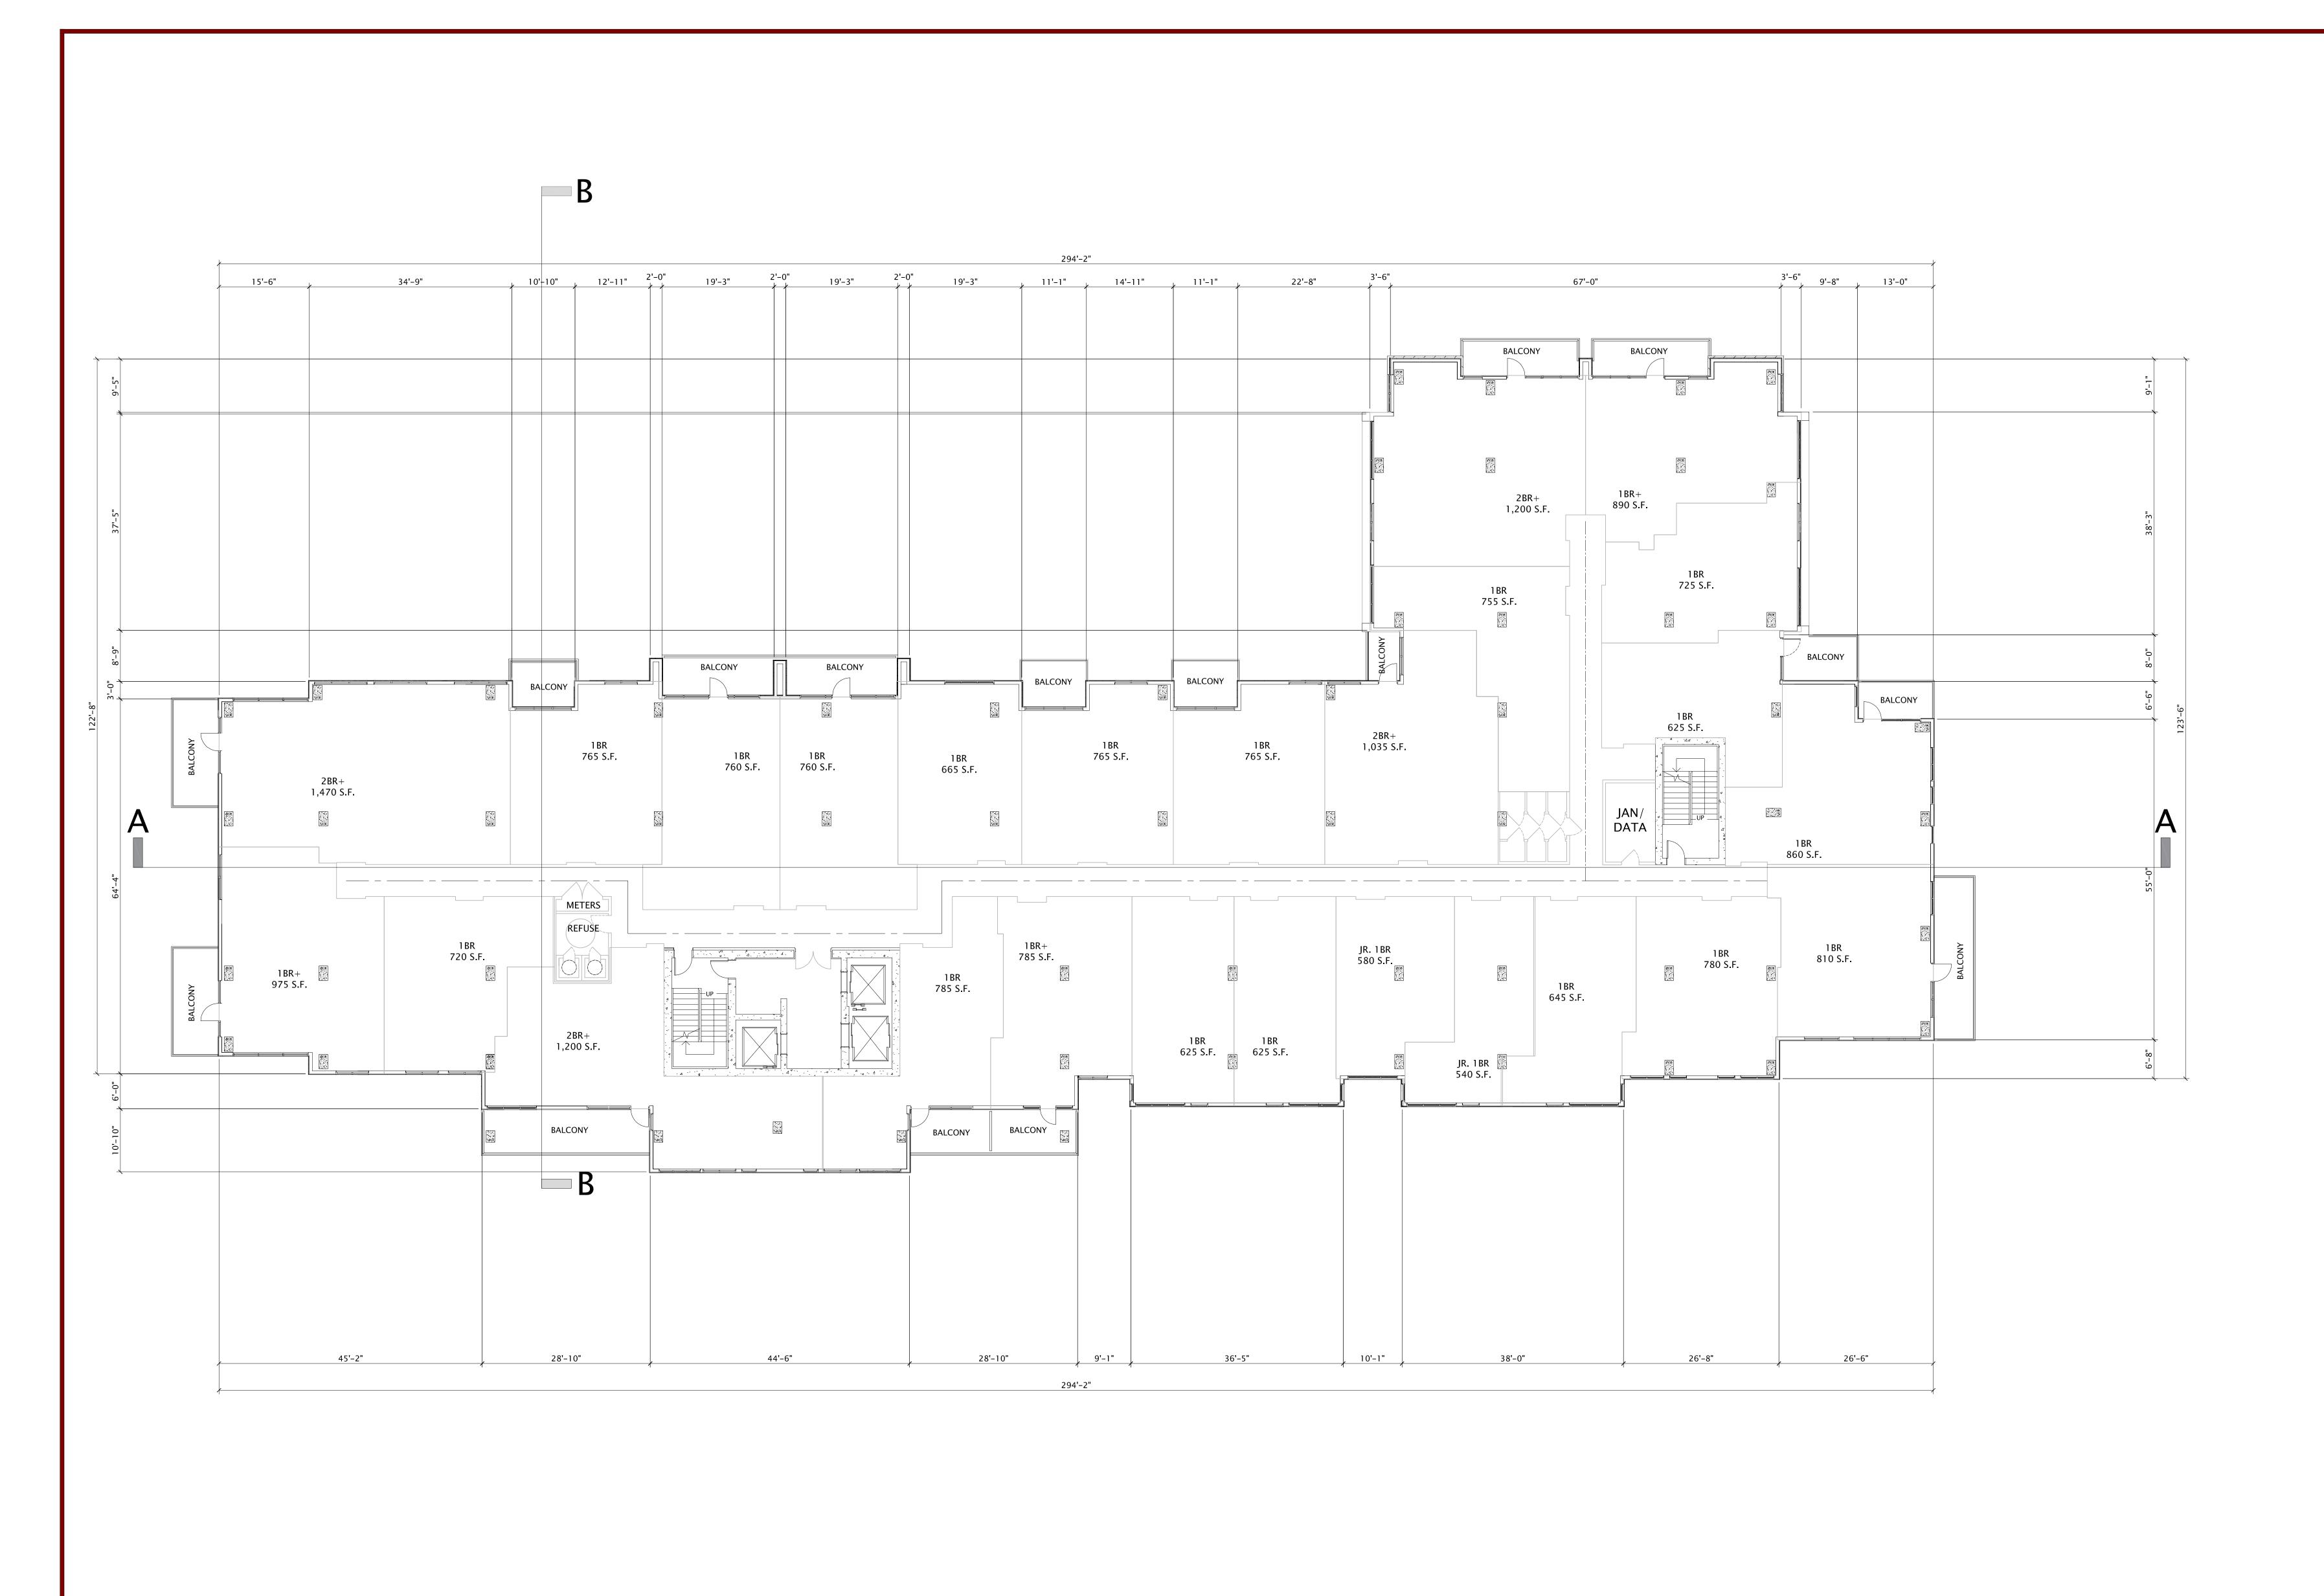

JLA PROJECT NUMBER: 20-1014

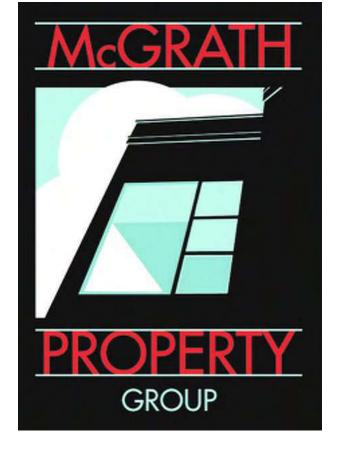

OLIN AVENUE MIXED-USE DEVELOPMENT

LAND USE APPLICATION

PROGRESS DOCUMENTS

These documents reflect progress and intent and may be subject to change, including additional detail. These are not final construction documents and should not be used for final bidding or

DATE OF ISSUANCE

REVISION SCHEDULE

Mark Description Date

construction-related purposes.

6th THRU 13th LEVEL FLOOR PLAN

SHEET NUMBER


A106

OLIN AVENUE MIXED-USE DEVELOPMENT – LAND USE APPLICATION

FLOOR PLANS – FLOORS 6–13 (26 UNITS/FLOOR)


MAY 19, 2021 3/32"=1' @ 30x42

PLAN TRUE

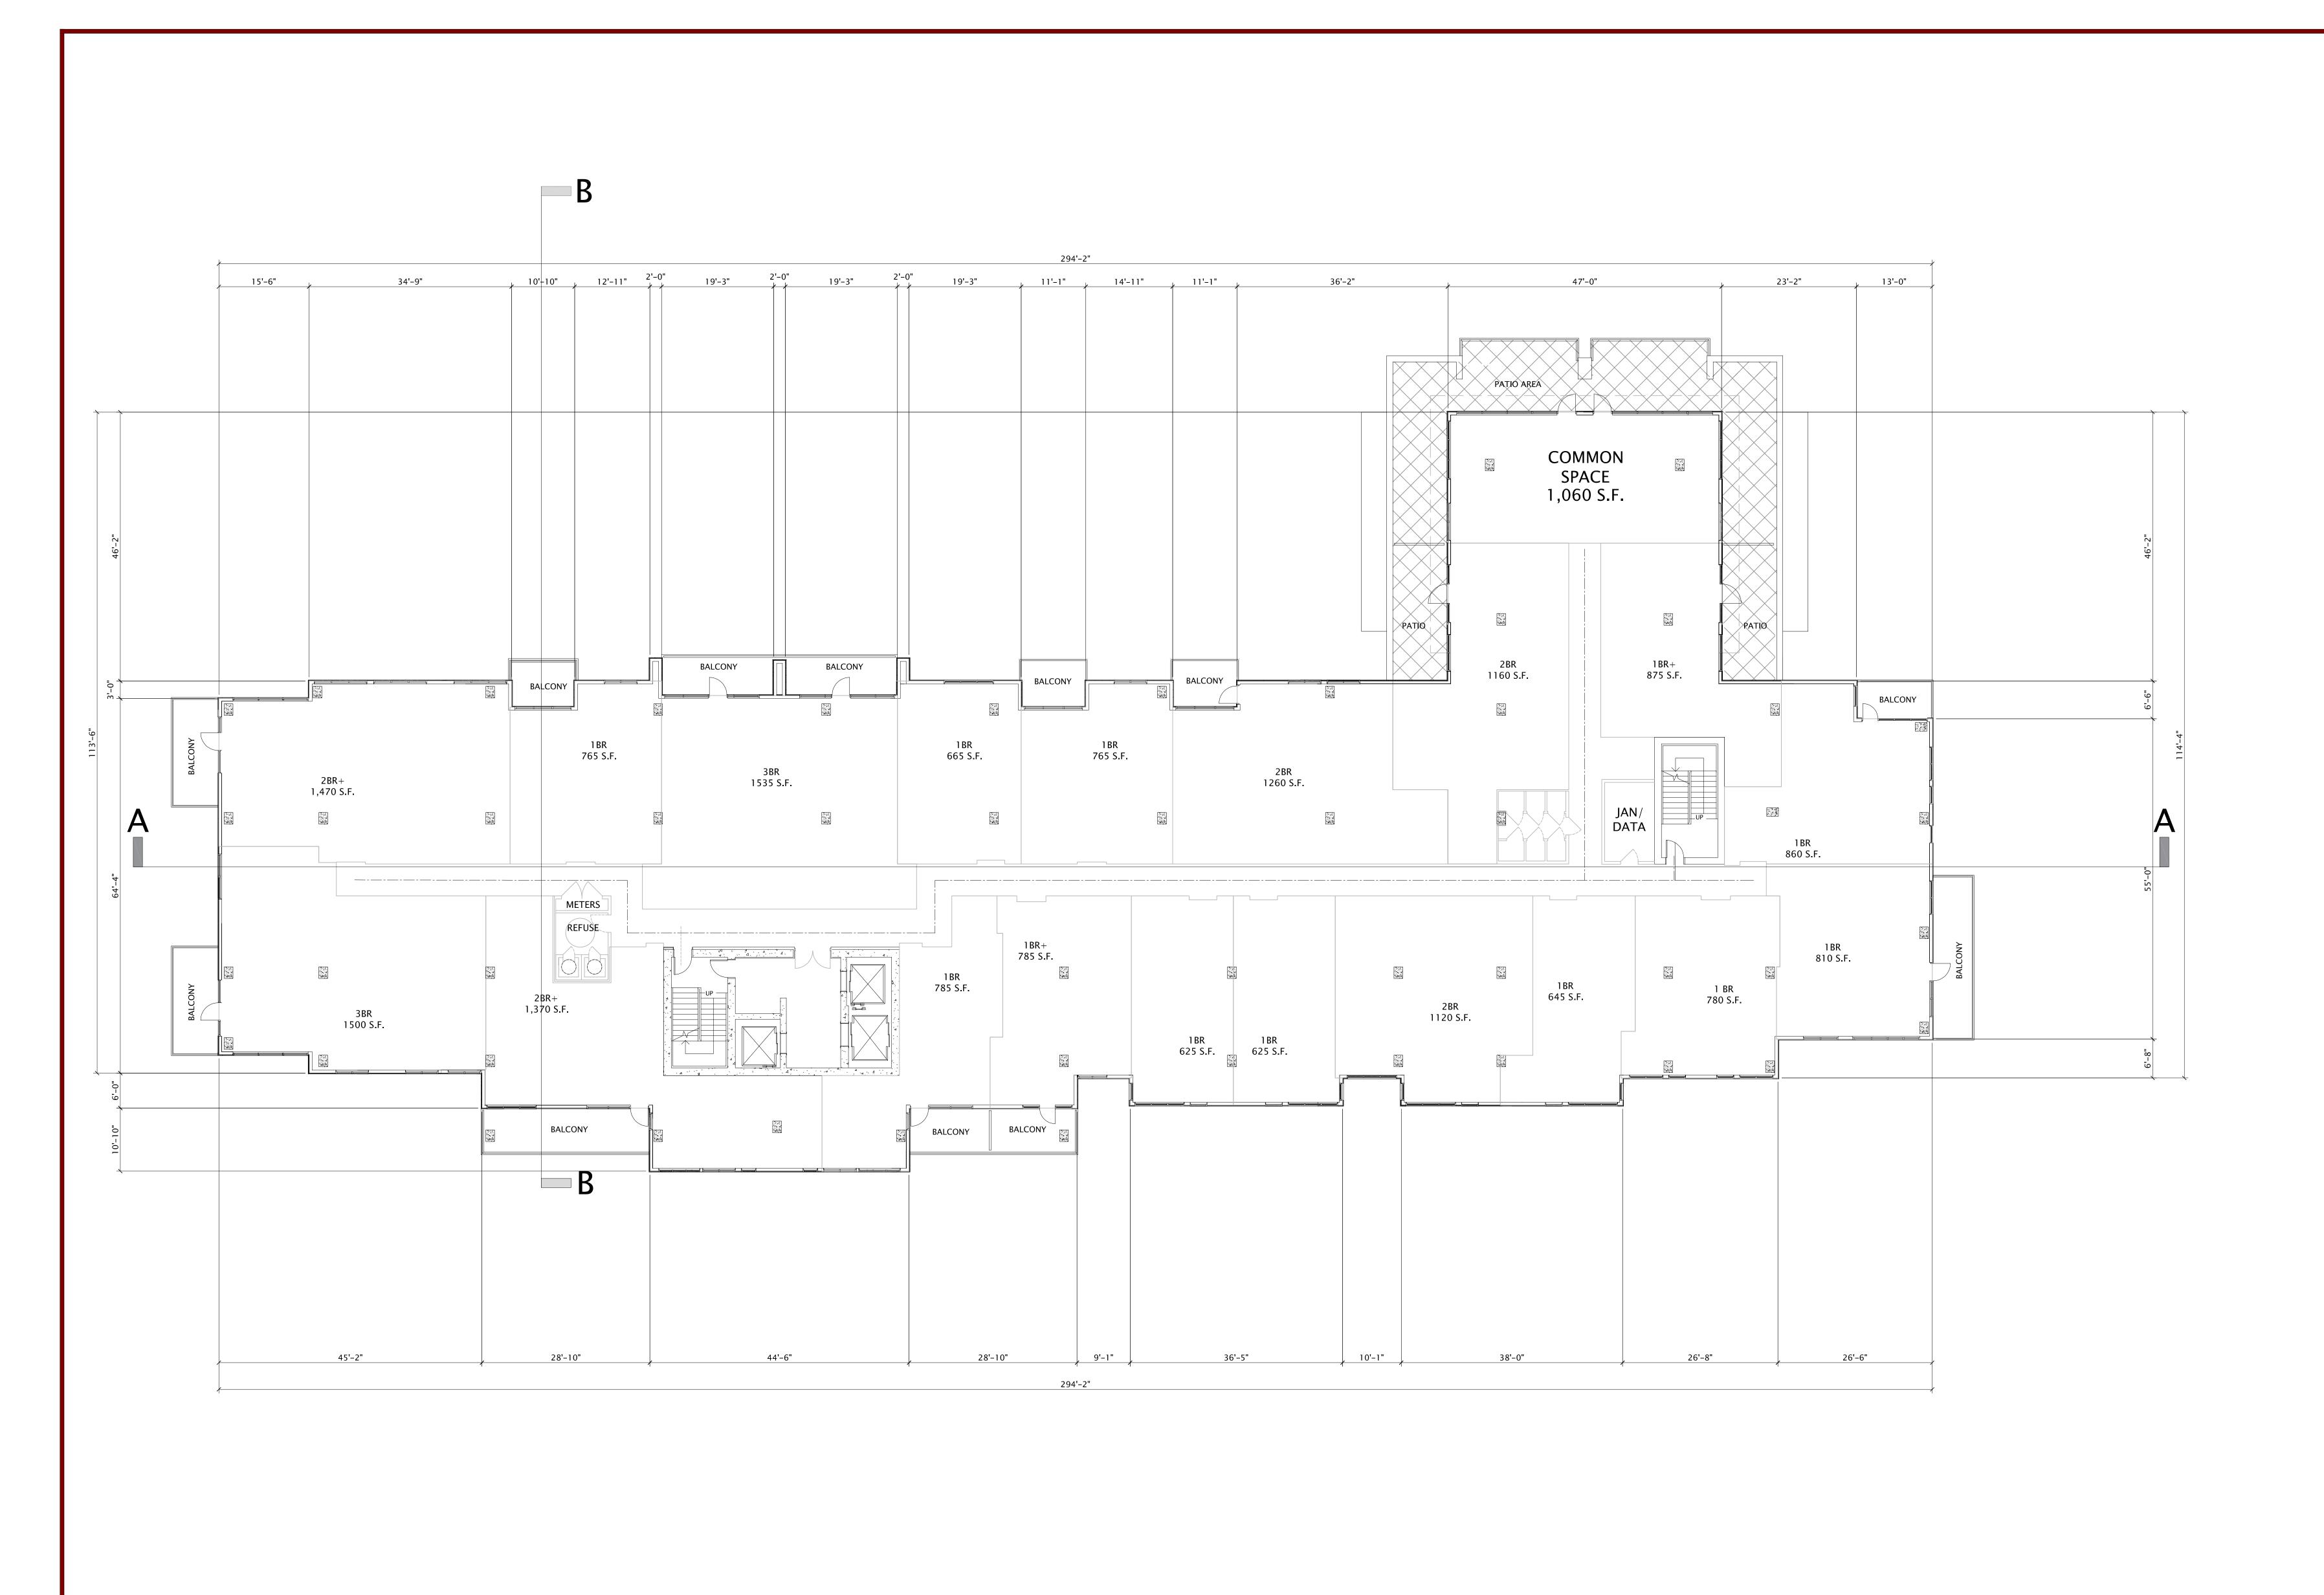

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14th LEVEL FLOOR PLAN


A114

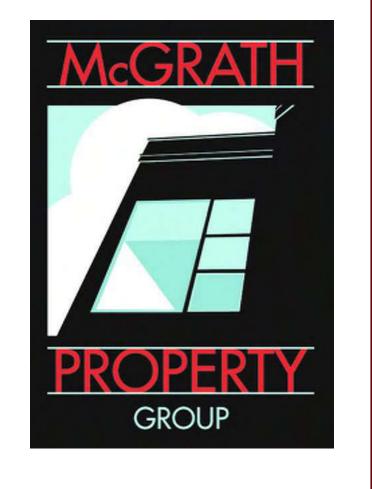OLIN AVENUE MIXED-USE DEVELOPMENT – LAND USE APPLICATION


3/32"=1'@30x42

MAY 19, 2021

FLOOR PLANS – FLOOR 14 (19 UNITS)

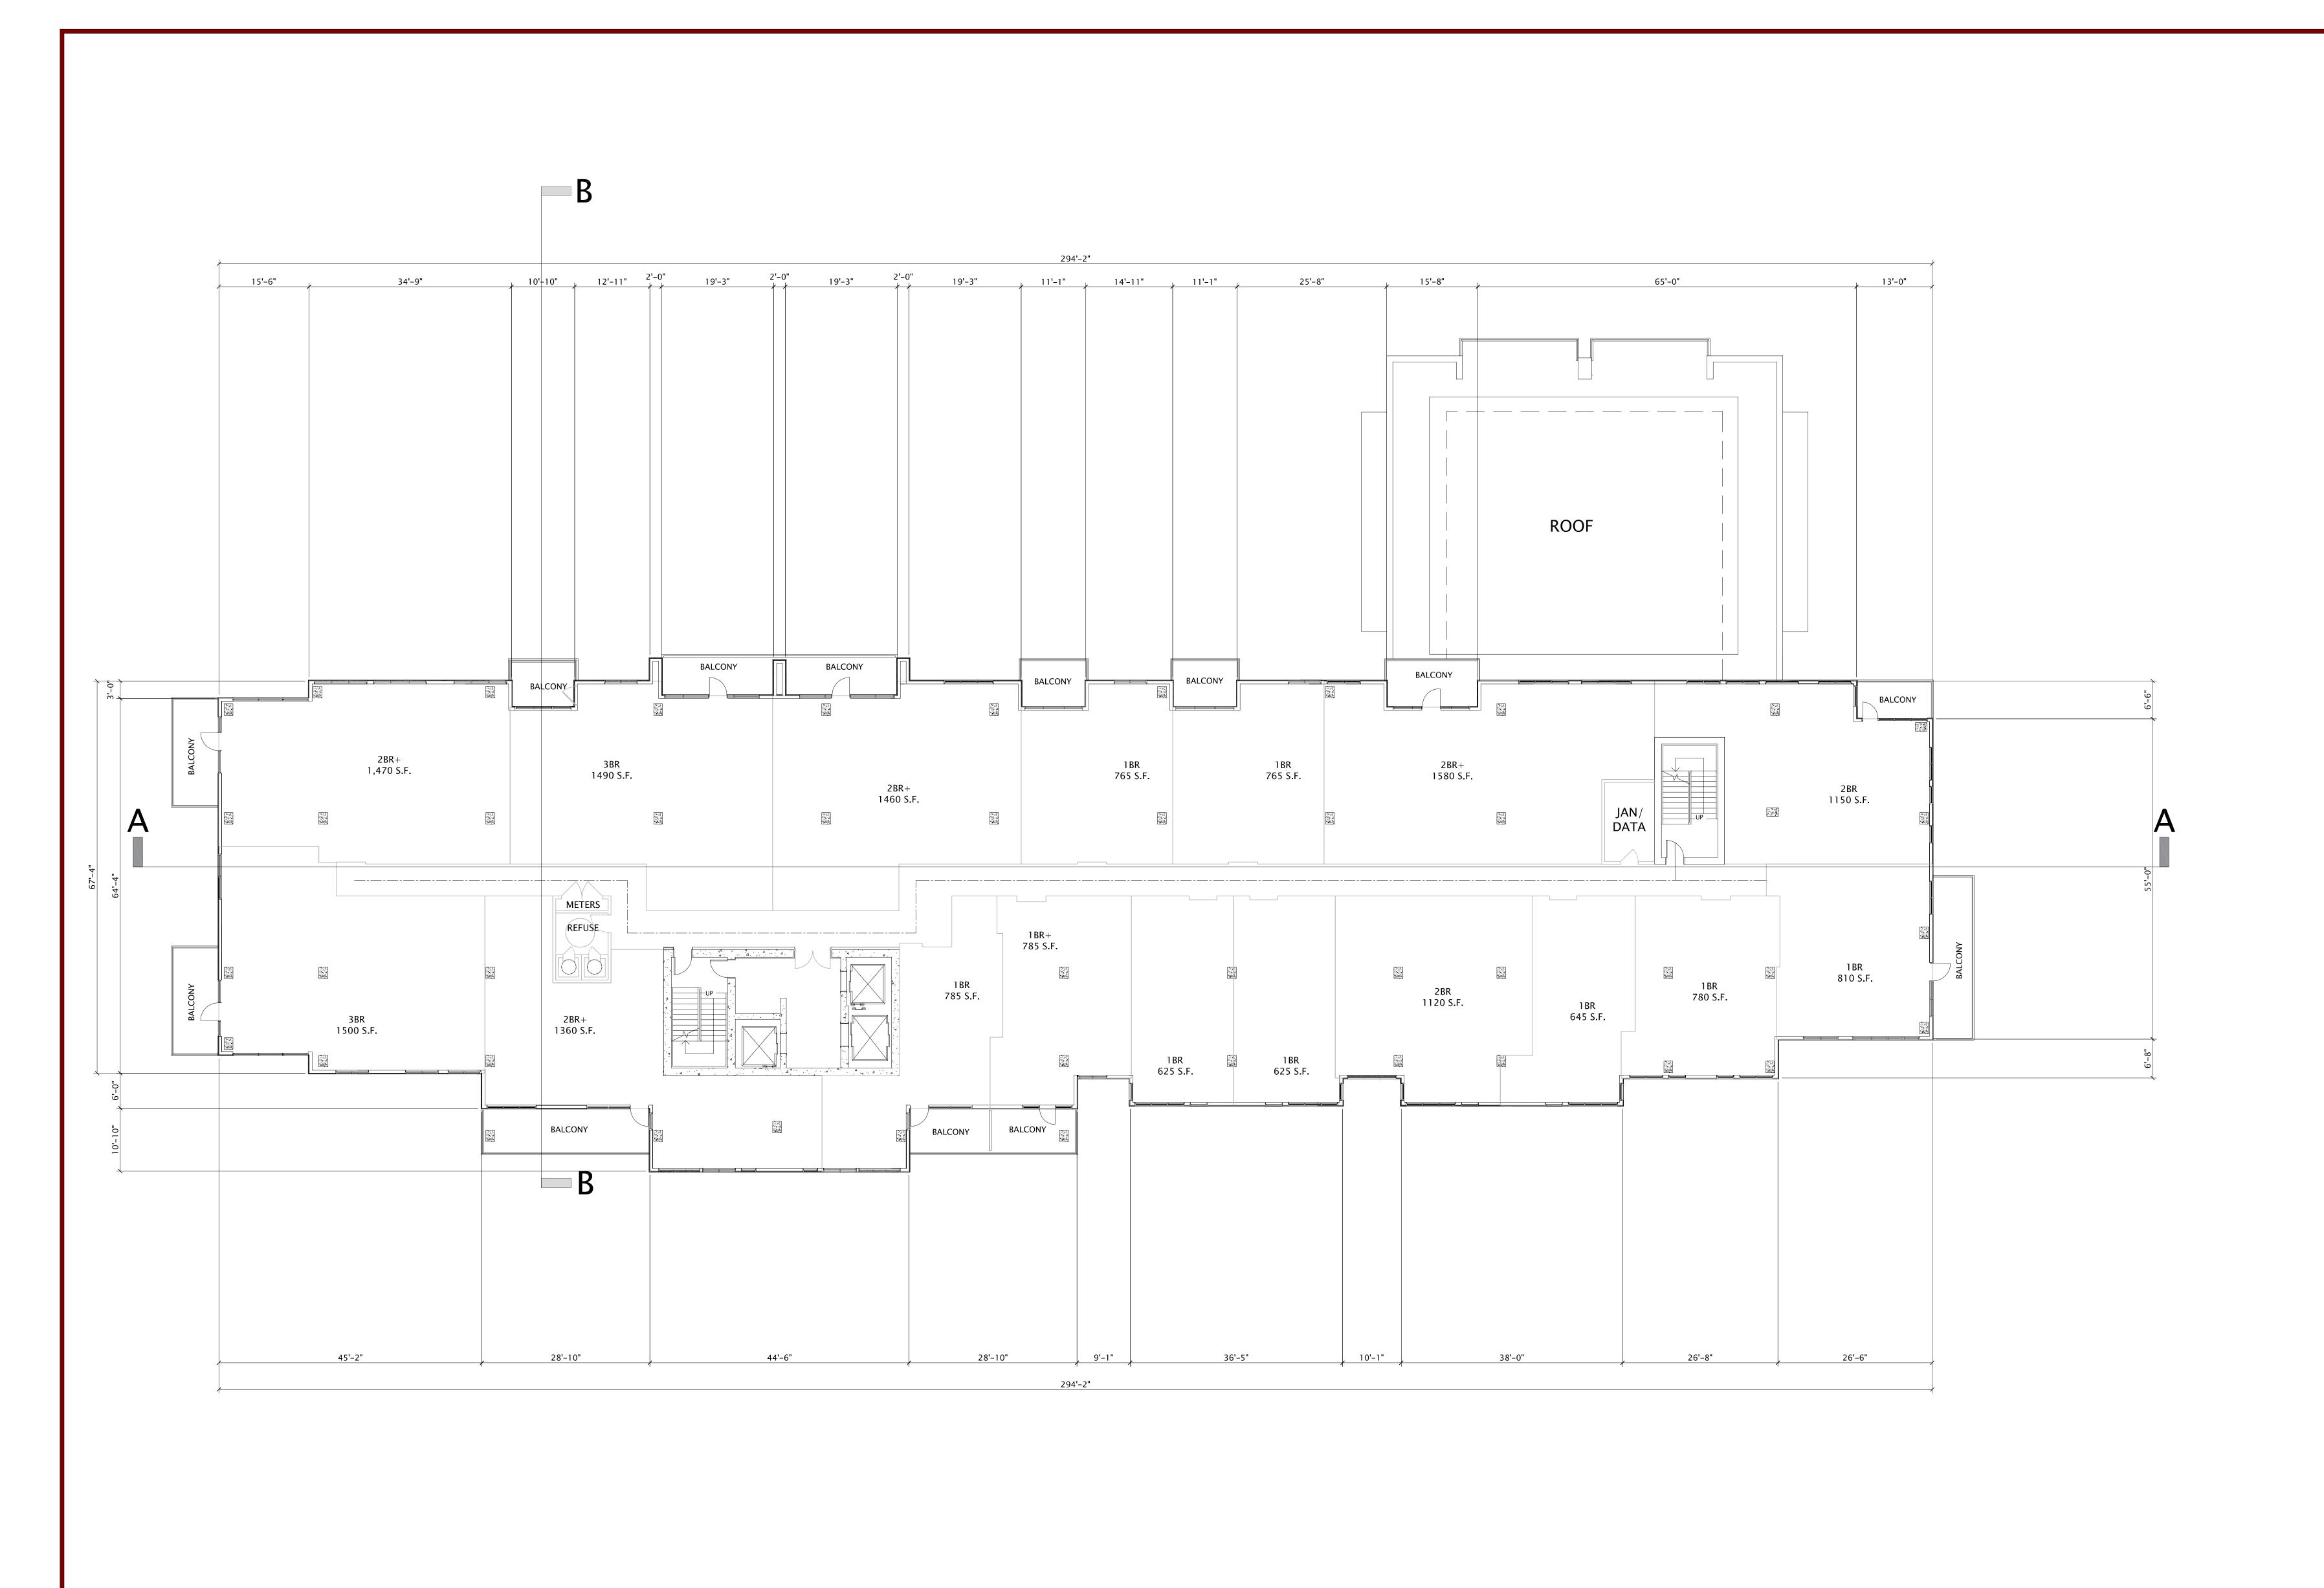

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15th LEVEL FLOOR PLAN

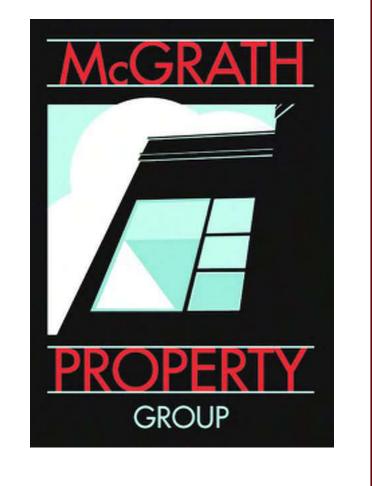A115


OLIN AVENUE MIXED-USE DEVELOPMENT – LAND USE APPLICATION

3/32"=1' @ 30x42

MAY 19, 2021

PLAN TRUE

FLOOR PLANS – FLOOR 15 (17 UNITS)

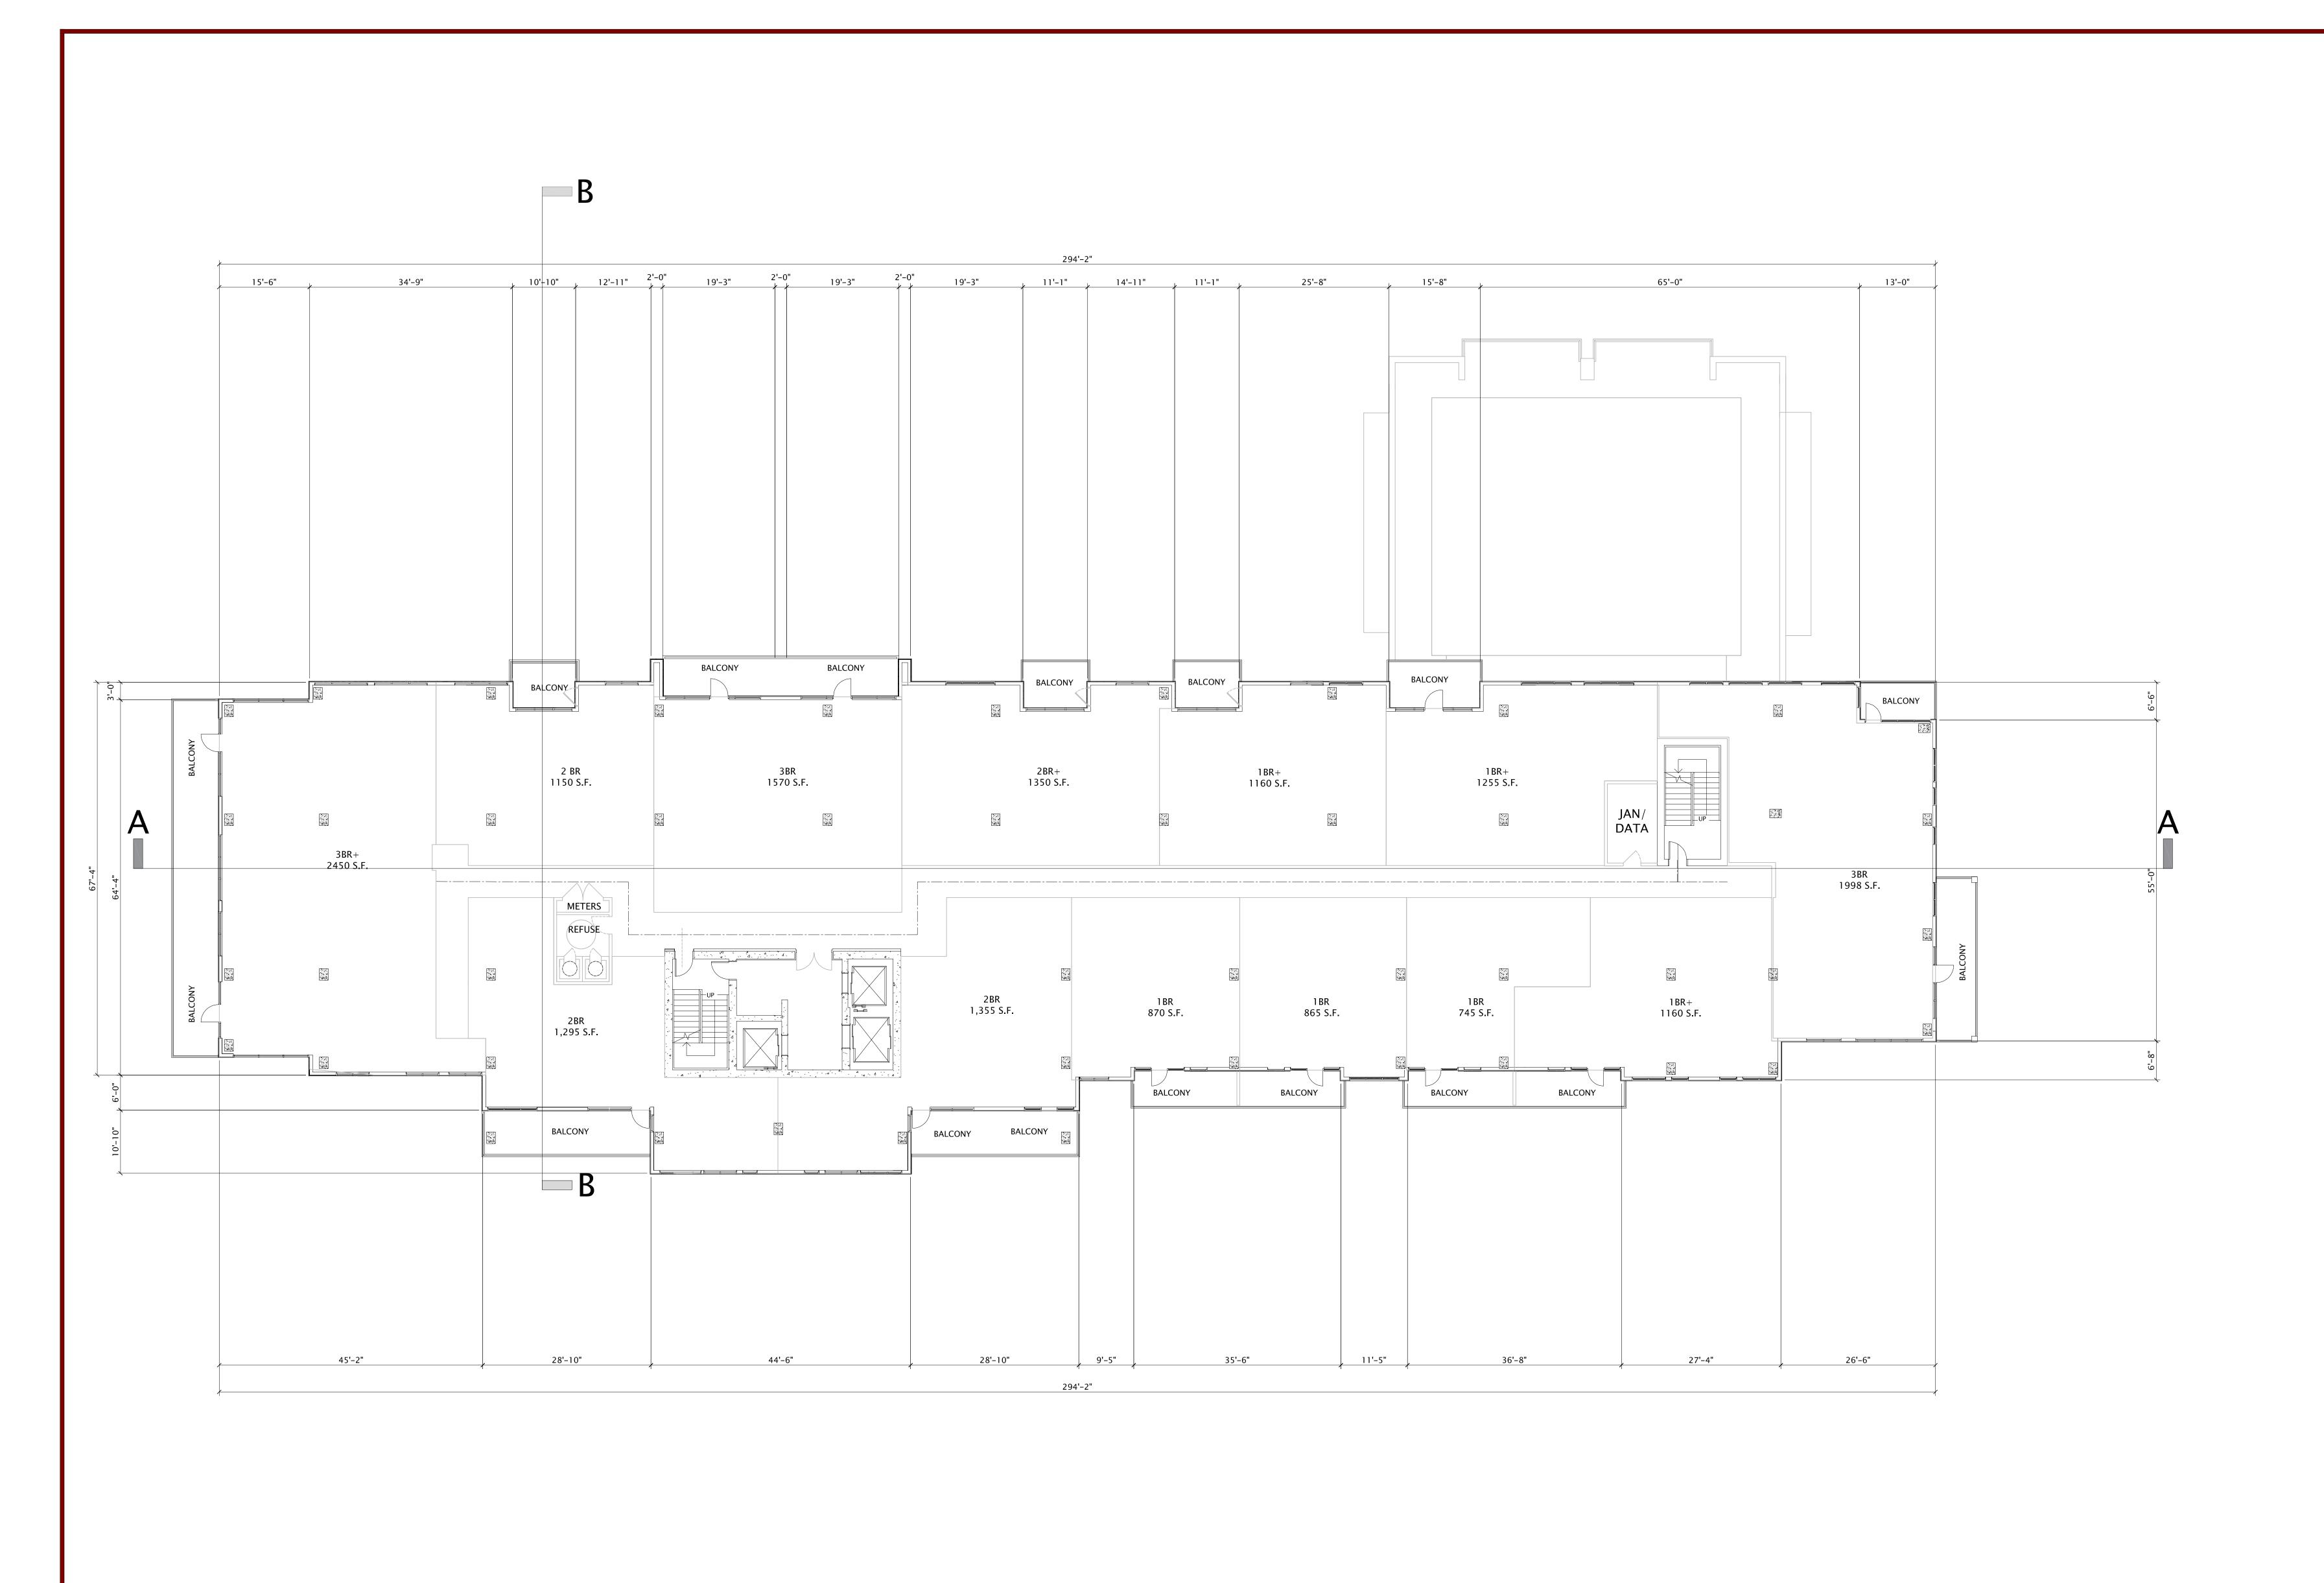


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LAND USE APPLICATION

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construction-related purposes.

SHEET TITLE

16th-17th LEVEL FLOOR PLAN


SHEET NUMBER

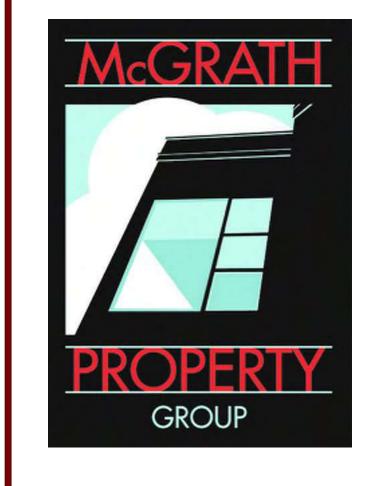A116

OLIN AVENUE MIXED-USE DEVELOPMENT – LAND USE APPLICATION


FLOOR PLANS – FLOORS 16–17 (PENTHOUSE) (13 UNITS/FLOOR)

MAY 19, 2021 3/32"=1'@30x42

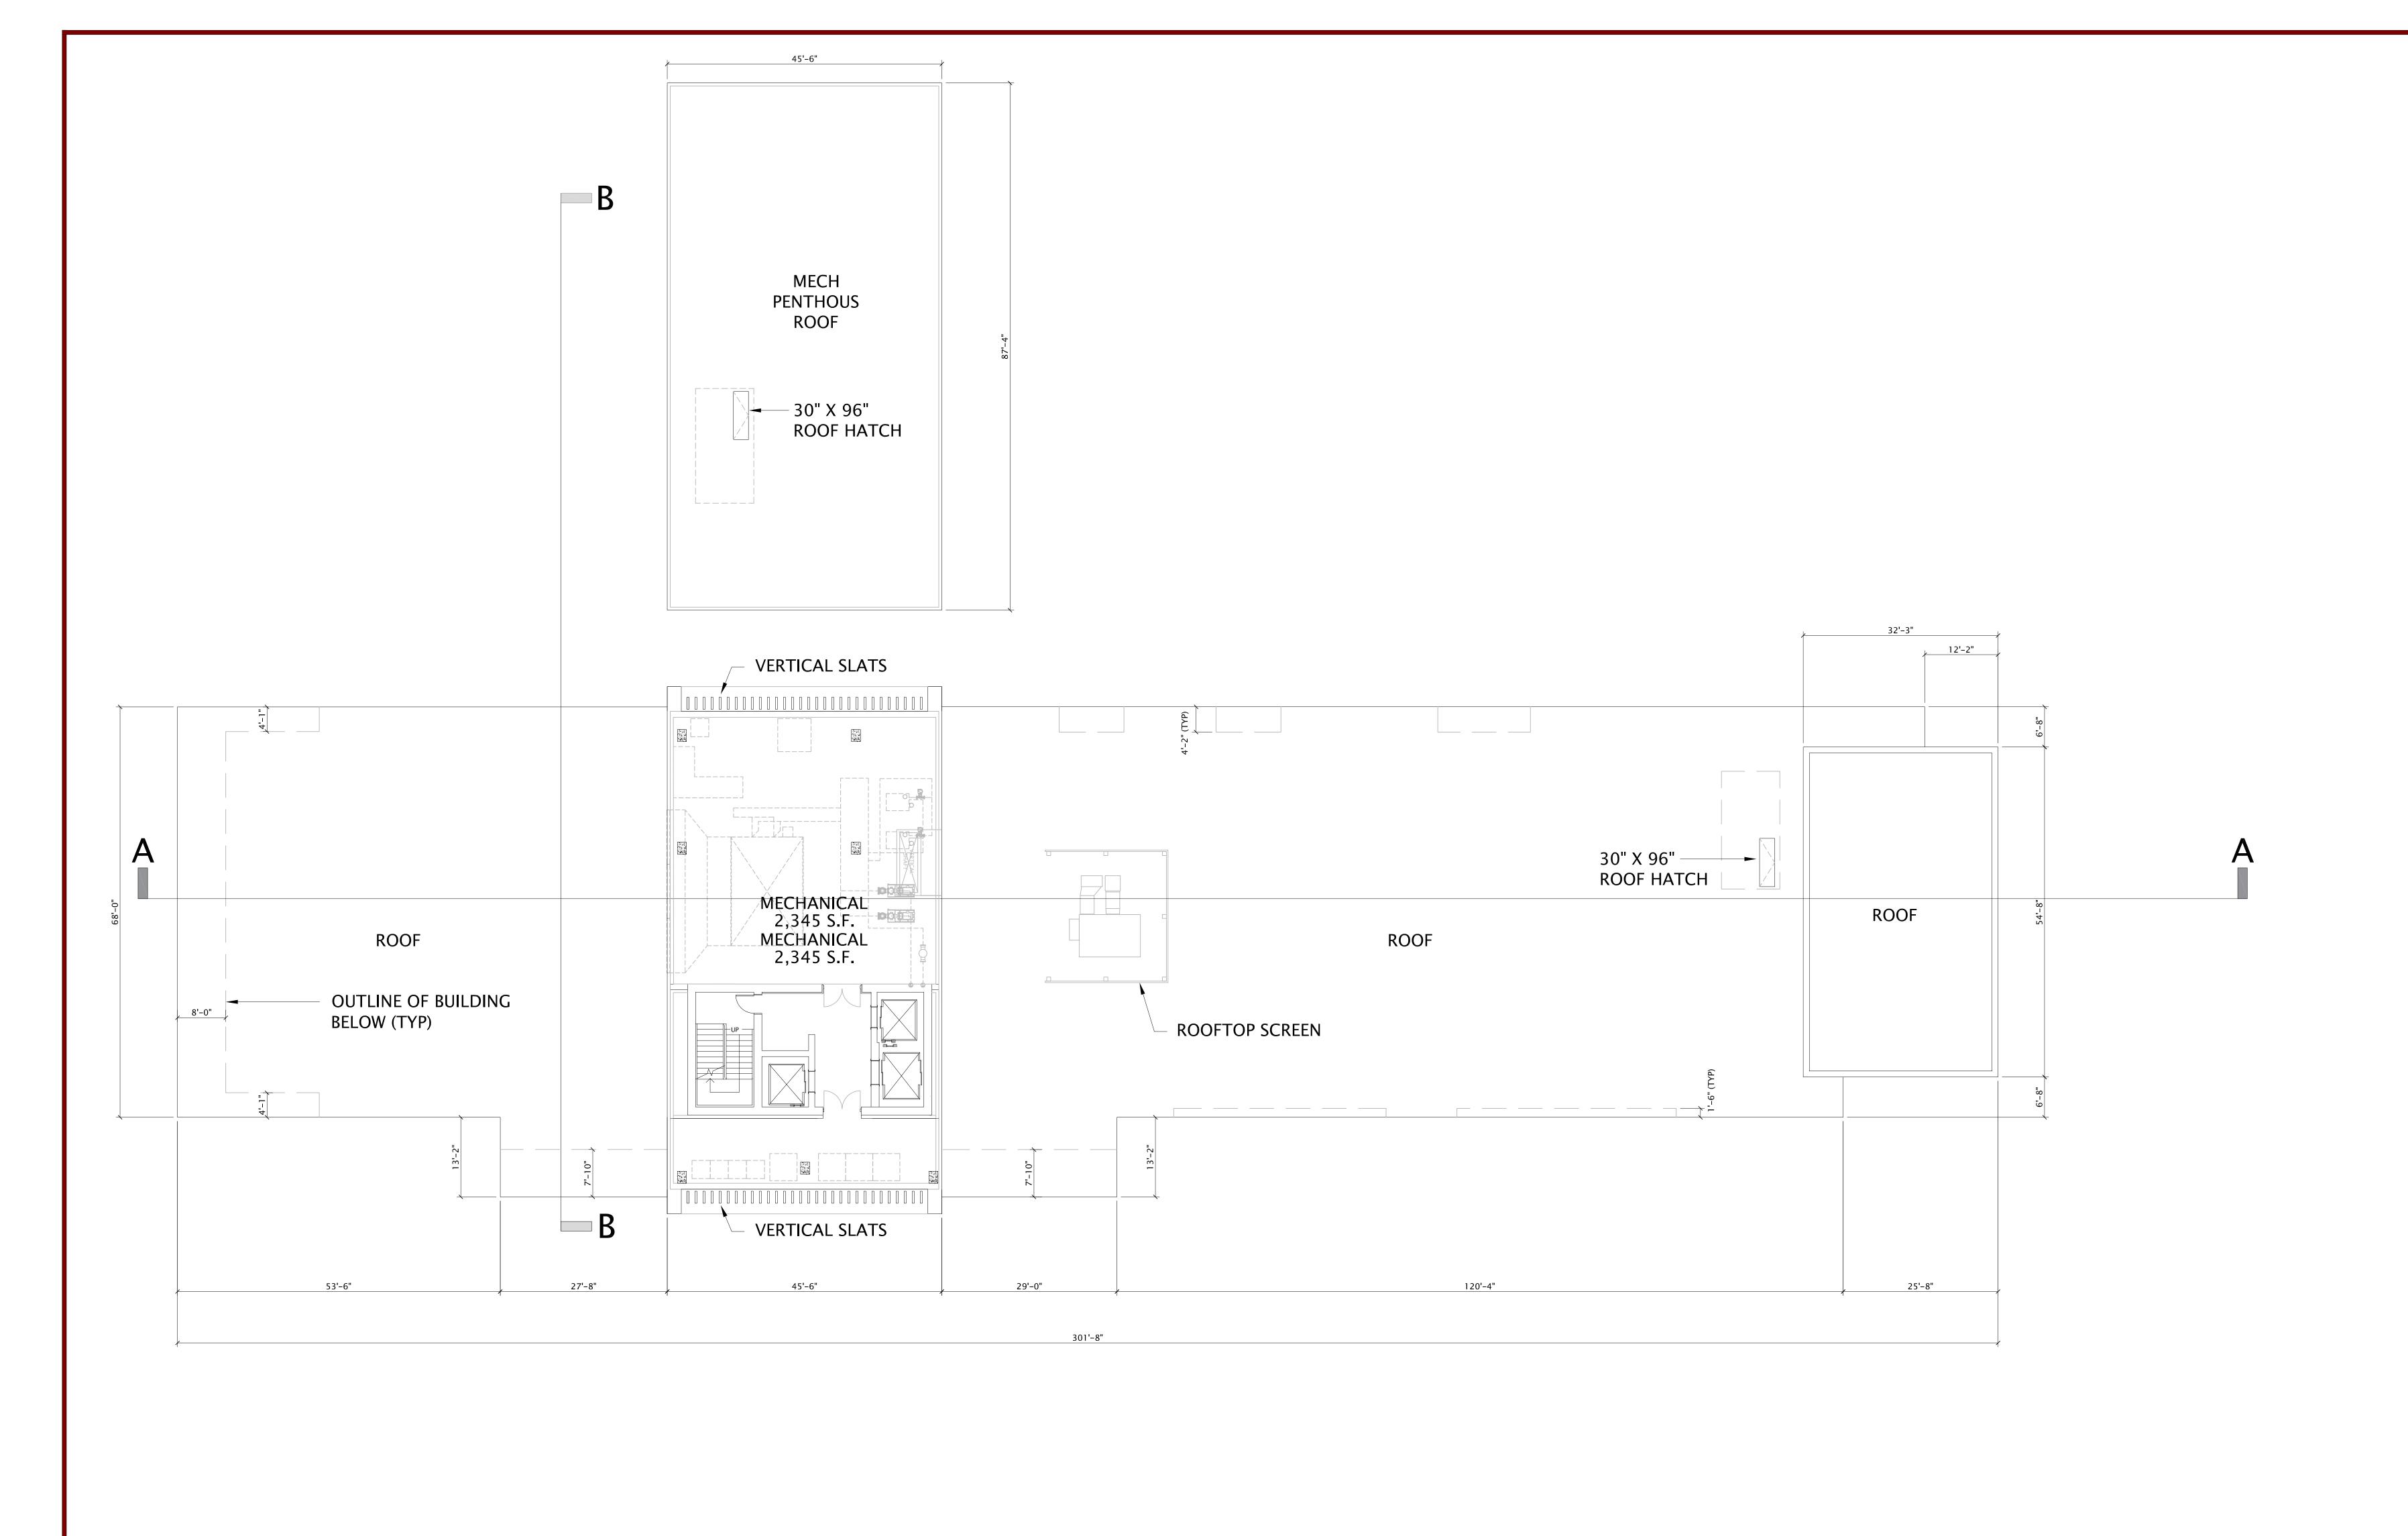

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LAND USE APPLICATION

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Mark Description Date
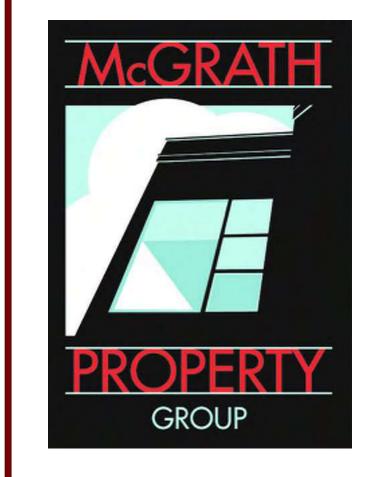
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18th LEVEL FLOOR PLAN (MECH PENTHOUSE)

SHEET NUMBER

A118


OLIN AVENUE MIXED-USE DEVELOPMENT – LAND USE APPLICATION

FLOOR PLANS – FLOOR 18 (MECHANICAL PENTHOUSE)

MAY 19, 2021 3/32"=1' @ 30x42


PLAN TRUE



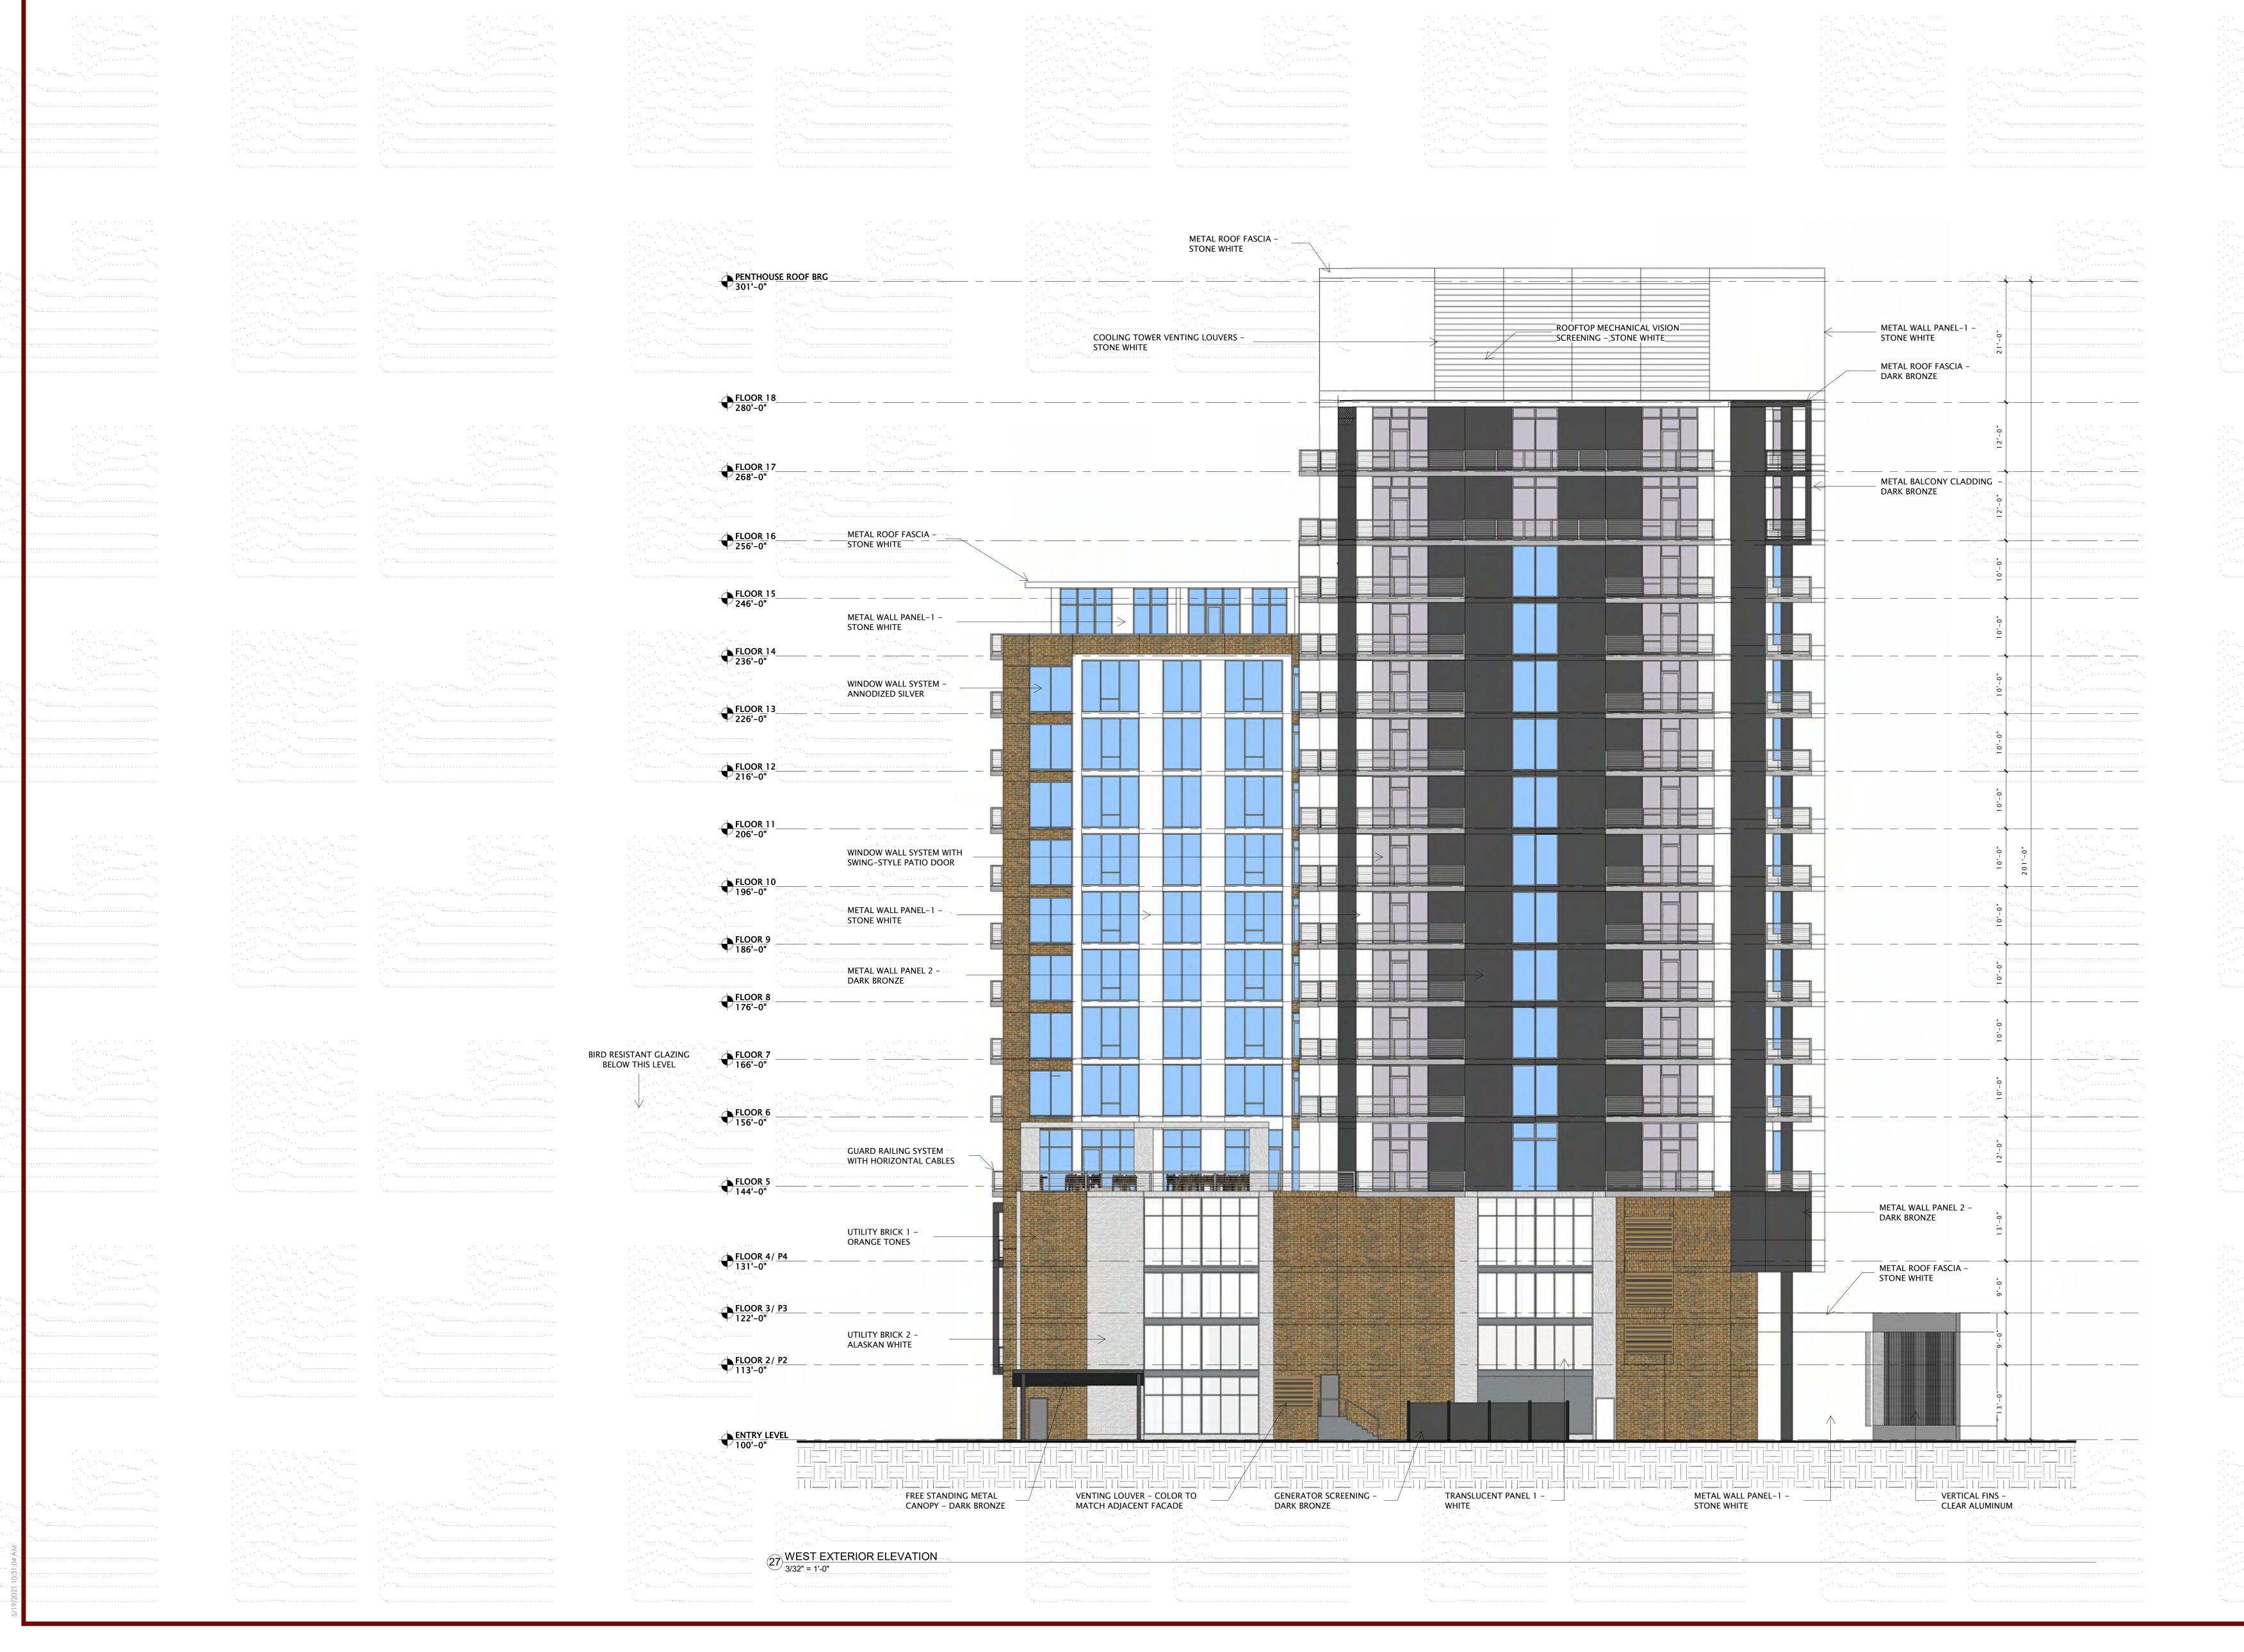



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LAND USE APPLICATION
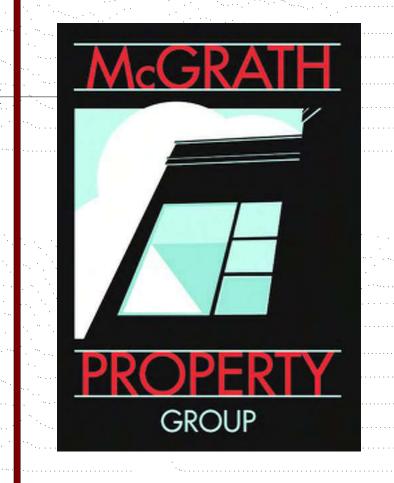
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REVISION SCHEDULE

Mark

Description

Date

WEST EXTERIOR ELEVATION


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A201S





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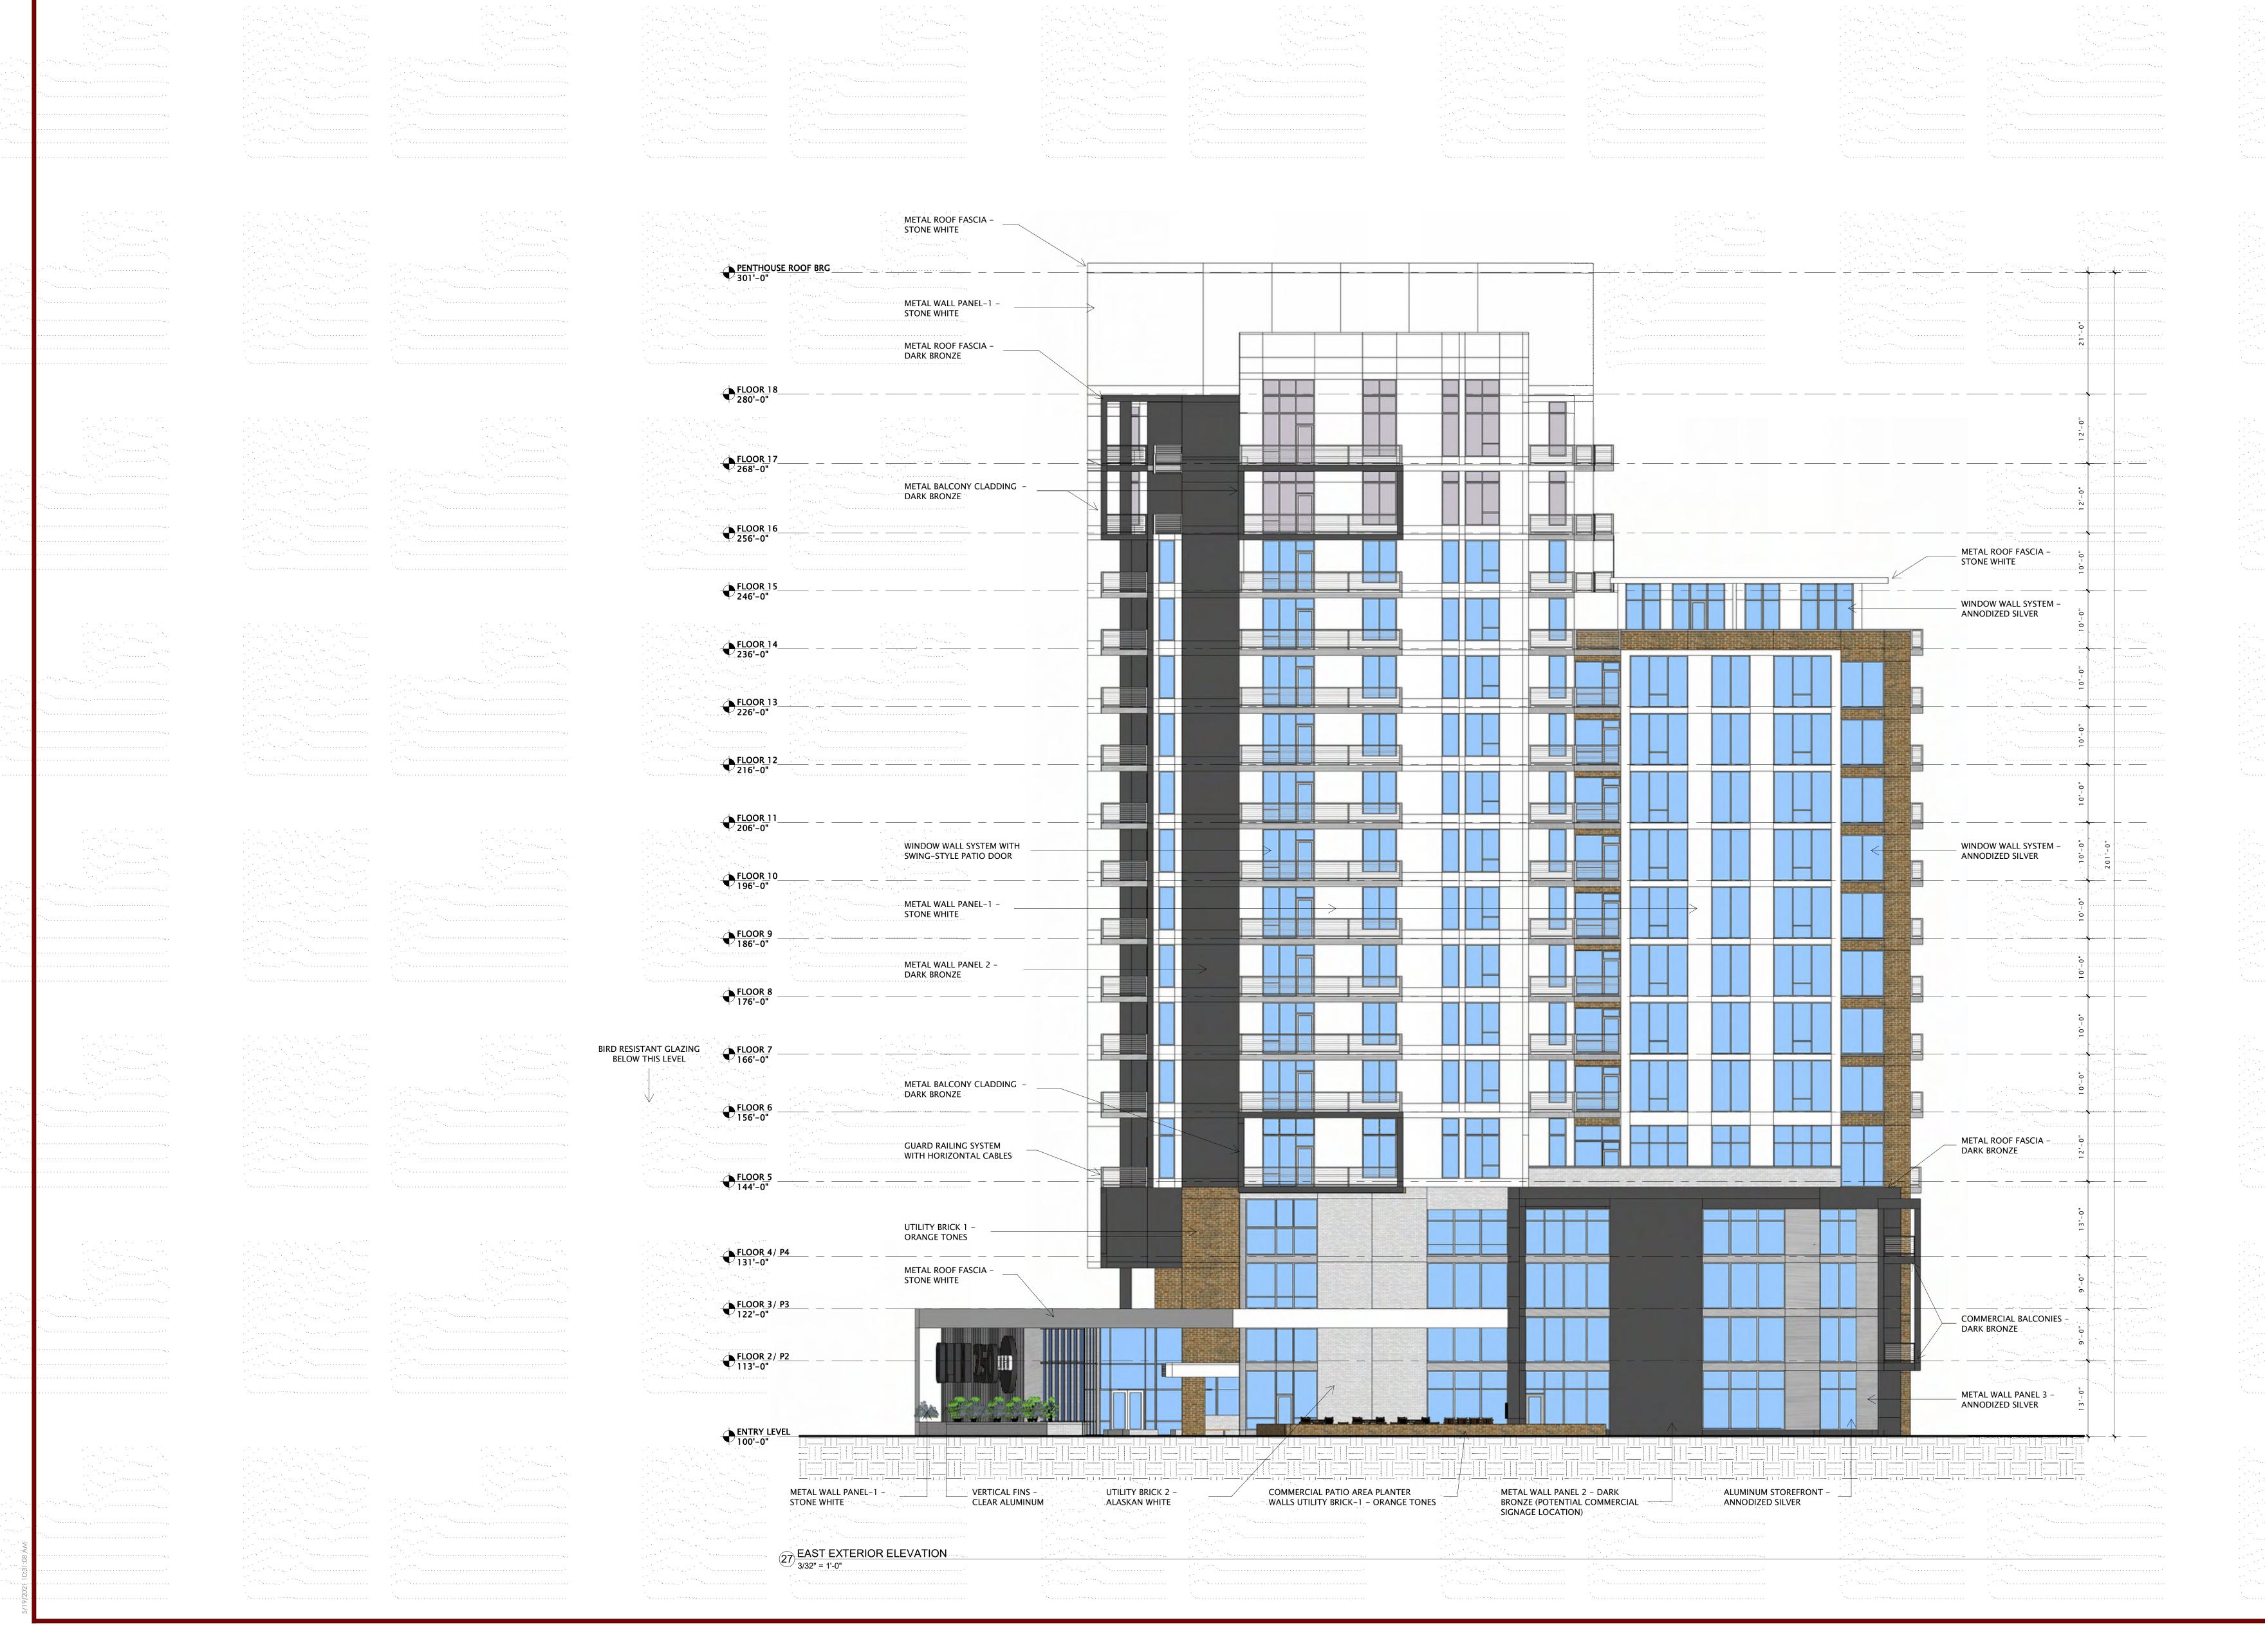
REVISION SCHEDULE

Mark Description Date

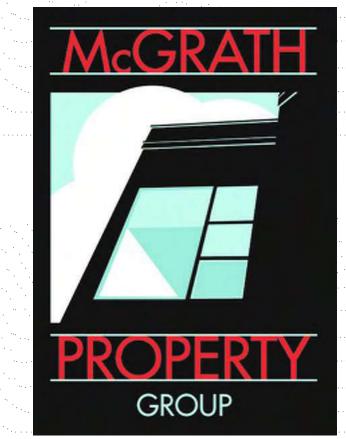NORTH EXTERIOR ELEVATION


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A202S





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LAND USE APPLICATION

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DATE OF ISSUANCE

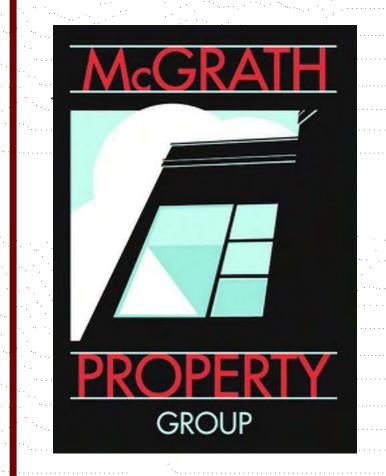REVISION SCHEDULE


Mark Description Date

EET TITLE

EAST EXTERIOR ELEVATION


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A203S

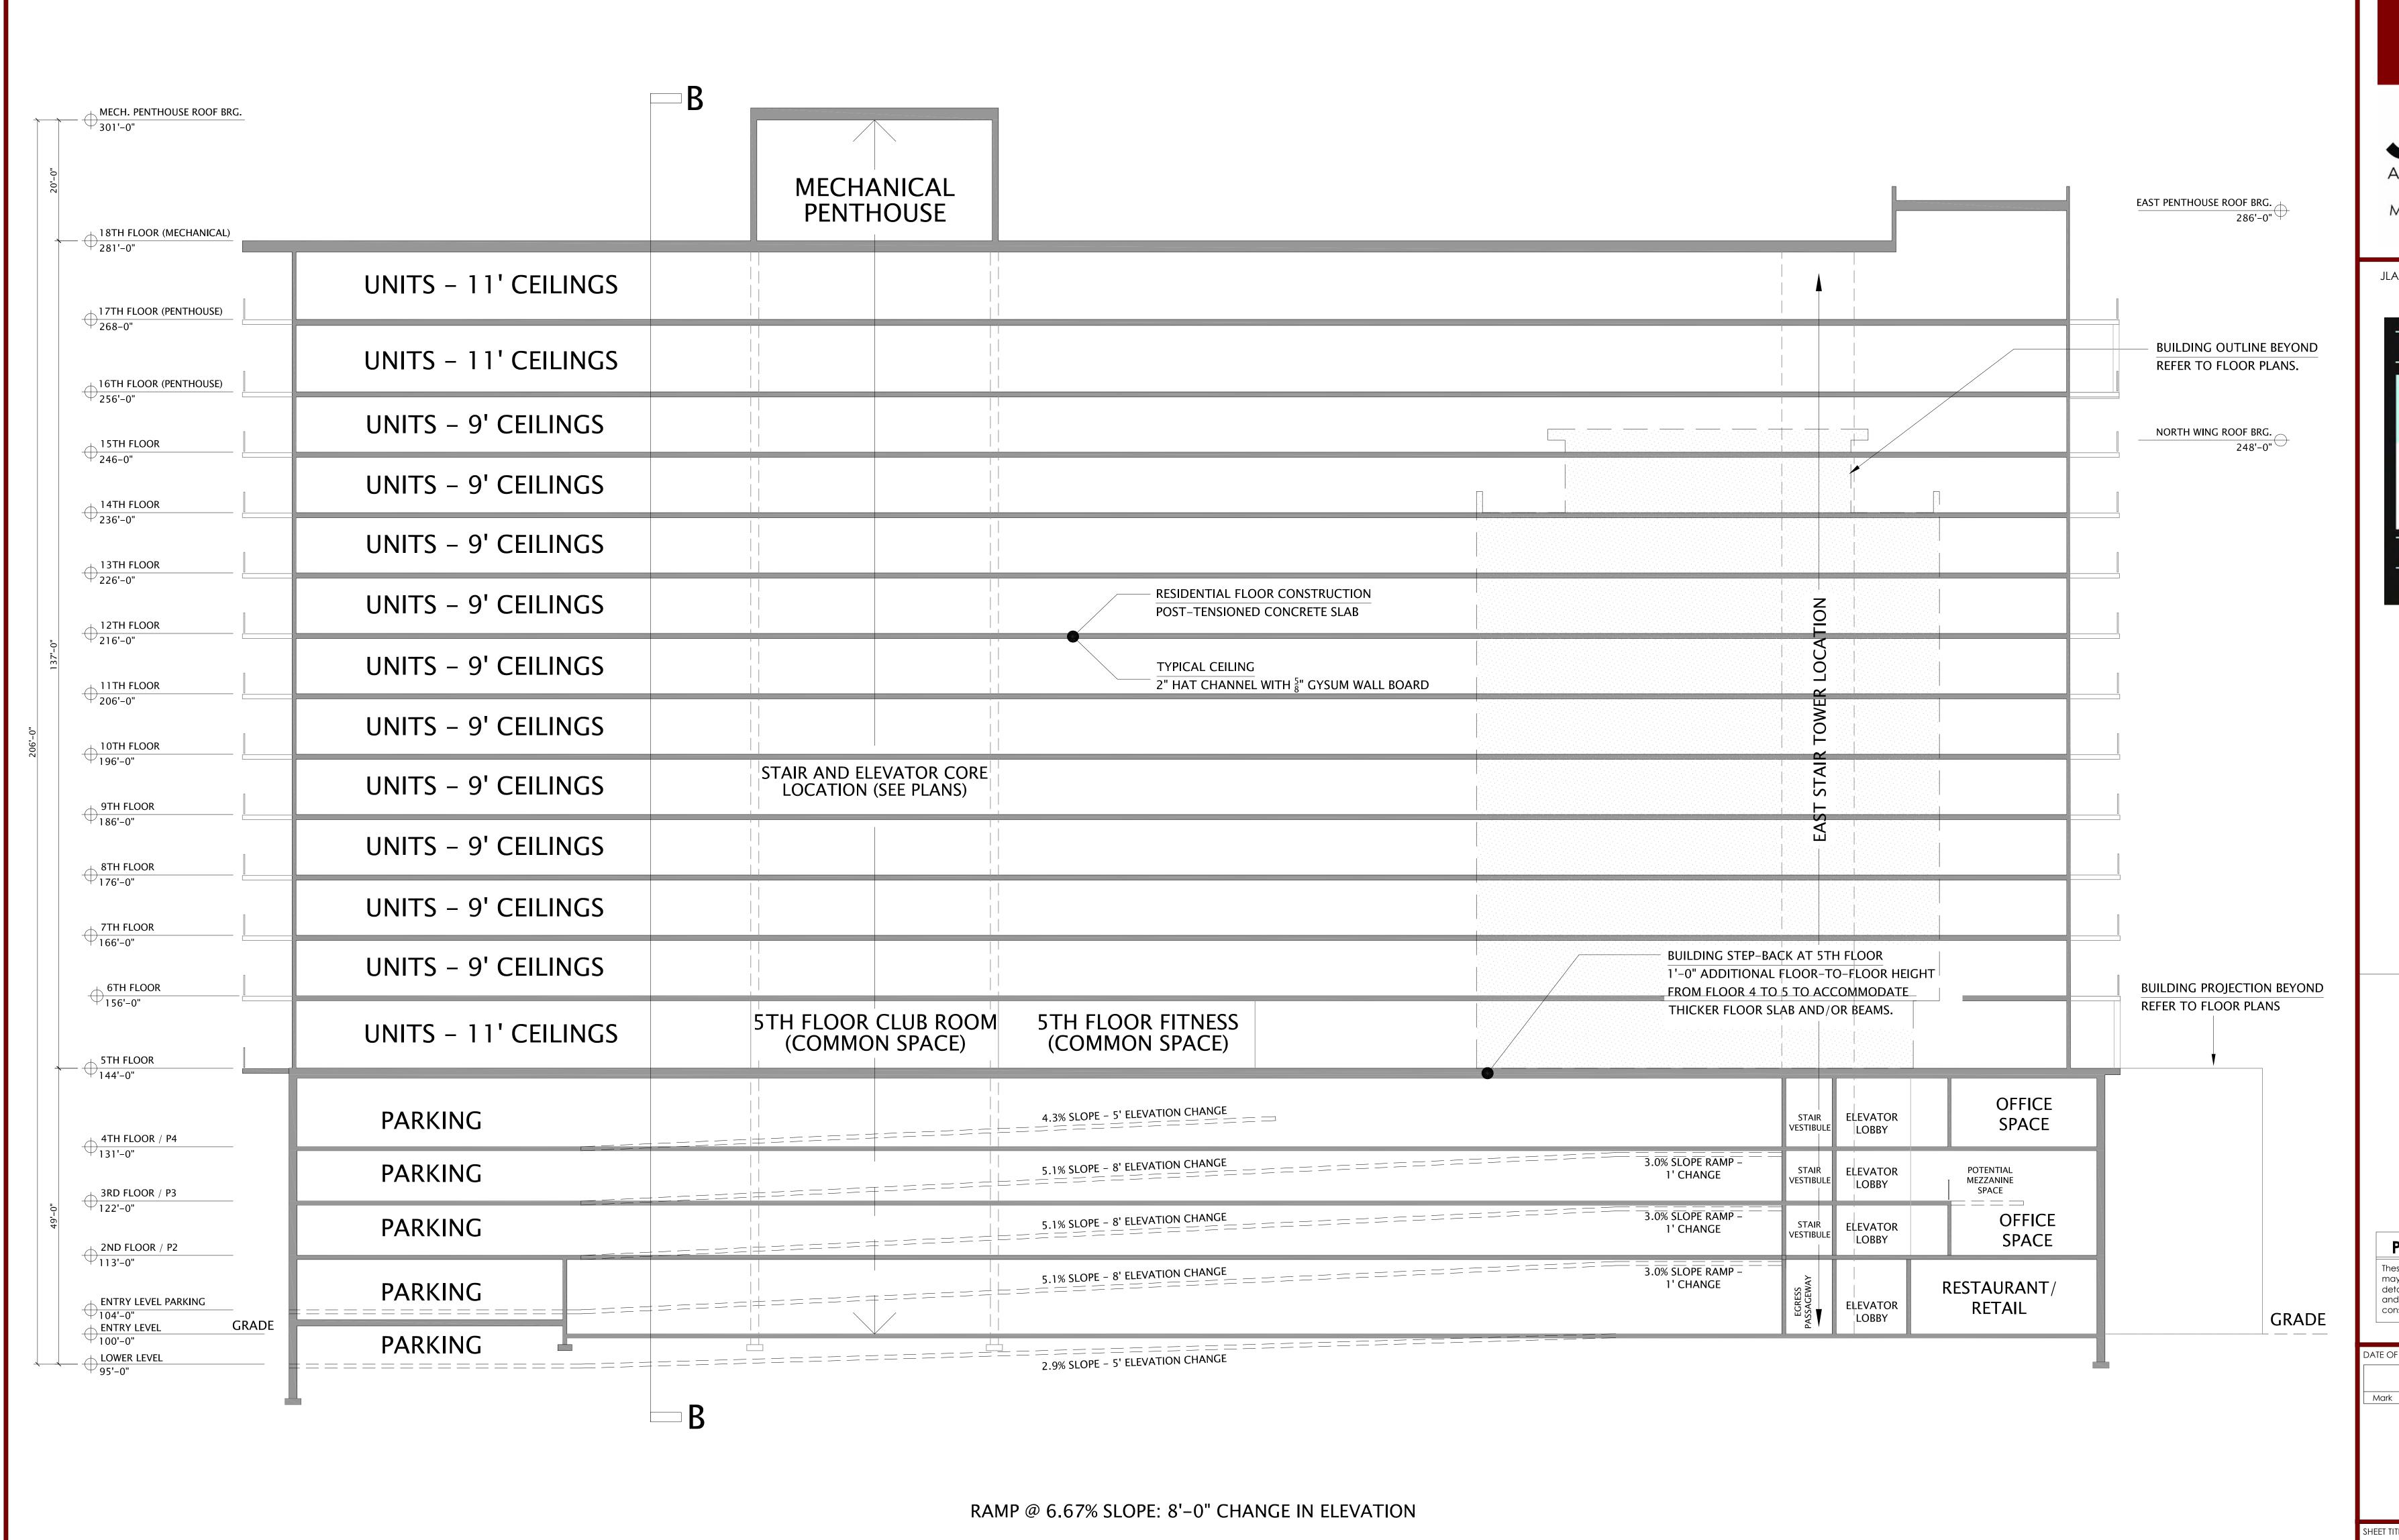

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20-1014

OLIN AVENUE MIXED-USE DEVELOPMENT

LAND USE APPLICATION
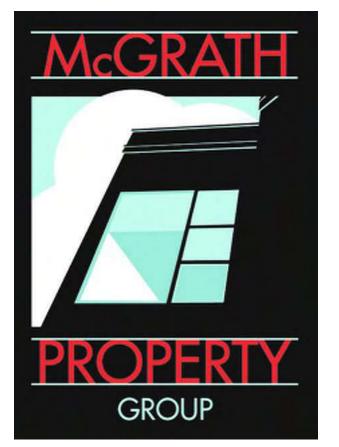
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DATE OF ISSUANCE MAY 19, 202 REVISION SCHEDULE Description

BUILDING SECTION

MAY 19, 2021

PLAN

NORTH NORTH


TRUE

3/32"=1'@30x42

A300


OLIN AVENUE MIXED-USE DEVELOPMENT – LAND USE APPLICATION

BUILDING SECTION A-A

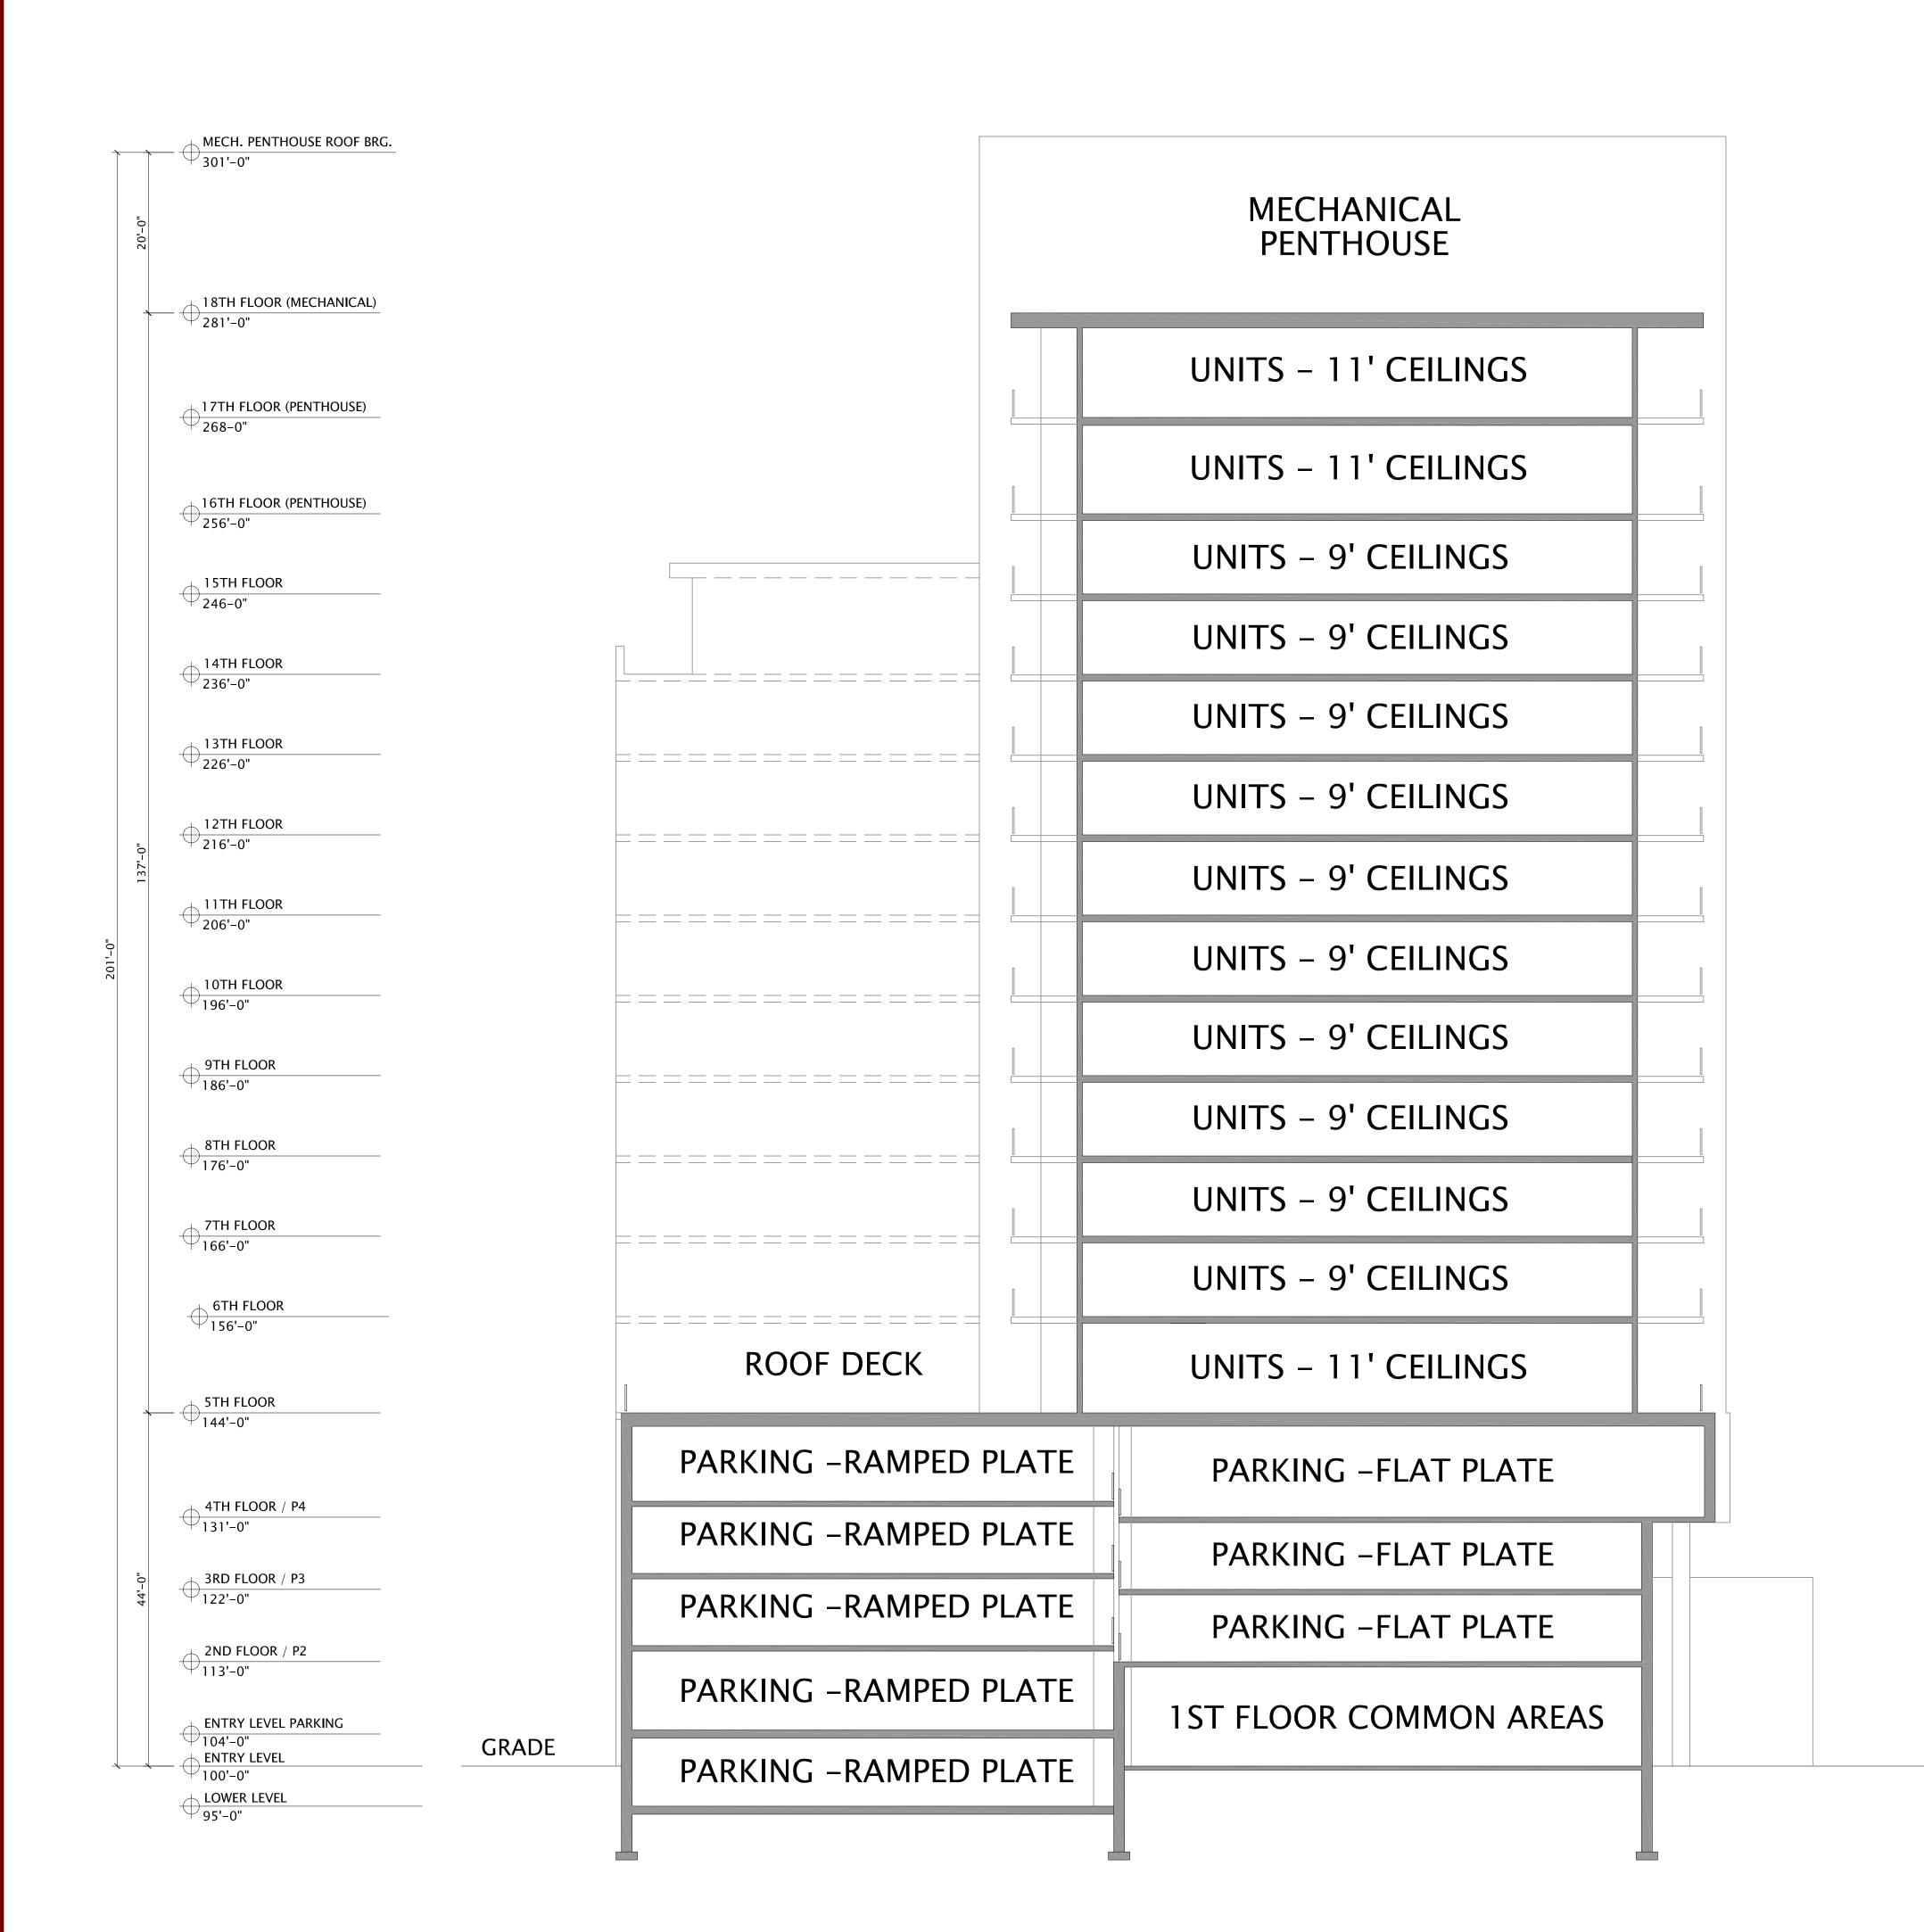

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OLIN AVENUE MIXED-USE DEVELOPMENT

LAND USE APPLICATION
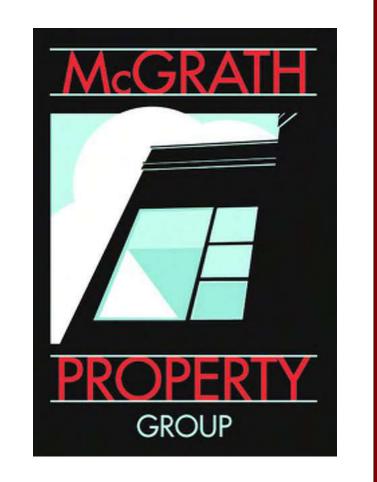
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BUILDING SECTIONS

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A301

OLIN AVENUE MIXED-USE DEVELOPMENT – LAND USE APPLICATION

MAY 19, 2021 3/32"=1' @ 30x42

OLIN AVENUE

BUILDING SECTION B-B

PLAN TRUE



































City of Madison Fire Department

314 W Dayton Street, Madison, WI 53703-2506

Phone: 608-266-4420 • Fax: 608-267-1100 • E-mail: fire@cityofmadison.com

| Project Address: | 222-232 E. Olin Ave | |
|-------------------------|---|--|
| Contact Name & I | hone #: Spencer Christiansen, P.E, Vierbicher | |

FIRE APPARATUS ACCESS AND FIRE HYDRANT WORKSHEET

| Is the building completely protected by an NFPA 13 or 13R automatic fire sprinkler system? If non-sprinklered, fire lanes extend to within 150-feet of all portions of the exterior wall? If sprinklered, fire lanes are within 250-feet of all portions of the exterior wall? | Yes Yes Yes | ☐ No ☐ No ☒ No | ☐ N/A ☑ N/A ☐ N/A |
|---|---|---|---|
| 2. Is the fire lane constructed of concrete or asphalt, designed to support a minimum load of 85,000 lbs? a) Is the fire lane a minimum unobstructed width of at least 20-feet? b) Is the fire lane unobstructed with a vertical clearance of at least 13½-feet? c) Is the minimum inside turning radius of the fire lane at least 28-feet? d) Is the grade of the fire lane not more than a slope of 8%? e) Is the fire lane posted as fire lane? (Provide detail of signage.) f) Is a roll-able curb used as part of the fire lane? (Provide detail of curb.) g) Is part of a sidewalk used as part of the required fire lane? (Must support +85,000 lbs.) | X Yes | No No No No No No No No | N/A N/A N/A N/A N/A N/A N/A N/A N/A |
| 3. Is the fire lane obstructed by security gates or barricades? If yes:a) Is the gate a minimum of 20-feet clear opening?b) Is an approved means of emergency operations installed, key vault, padlock or key switch? | Yes Yes Yes | NoNoNo | □ N/A ☑ N/A ☑ N/A |
| 4. Is the Fire lane dead-ended with a length greater than 150-feet? If yes, does the area for turning around fire apparatus comply with IFC D103? | Yes Yes | No No | □ N/A ▼ N/A |
| 5. Is any portion of the building to be used for high-piled storage in accordance with IFC Chapter 3206.6 If yes, see IFC 3206.6 for further requirements. | Yes | No No | □ N/A |
| 6. Is any part of the building greater than 30-feet above the grade plane? | X Yes | No | N/A |
| | | | |
| If yes, answer the following questions: a) Is the aerial apparatus fire lane parallel to one entire side of the building and covering at least 25% of the perimeter? b) Is the near edge of the aerial apparatus fire lane between 15' and 30' from the building? c) Are there any overhead power or utility lines located across the aerial apparatus fire lane? d) Are there any tree canopies expected to grow across the aerial fire lane? (Based on mature canopy width of tree species) e) Does the aerial apparatus fire lane have a minimum unobstructed width of 26-feet? f) Is the space between the aerial lane and the building free of trees exceeding 20' in heights? | ☐ Yes | NoNoNoNoNoNo | N/A N/A N/A N/A N/A N/A |
| a) Is the aerial apparatus fire lane parallel to one entire side of the building and covering at least 25% of the perimeter? b) Is the near edge of the aerial apparatus fire lane between 15' and 30' from the building? c) Are there any overhead power or utility lines located across the aerial apparatus fire lane? d) Are there any tree canopies expected to grow across the aerial fire lane? (Based on mature canopy width of tree species) | Yes Yes Yes | No No No No | N/A N/A N/A N/A |

Attach an additional sheet if further explanation is required for any answers.

This worksheet is based on MGO 34.503 and IFC 2015 Edition Chapter 5 and Appendix D; please see the codes for further information.

