URBAN DESIGN COMMISSION APPLICATION



City of Madison **Planning Division** Madison Municipal Building, Suite 017 215 Martin Luther King, Jr. Blvd.



FOR OFFICE USE ONLY: Paid Receipt # Date received Received by _____ Aldermanic District Zoning District Urban Design District ____ Submittal reviewed by Legistar #

P.O. Box 2985 Madison, WI 53701-2985 (608) 266-4635 Complete all sections of this application, including the desired meeting date and the action requested. If you need an interpreter, translator, materials in alternate formats or other accommodations to access these forms, please call the phone number above immediately. 1. Project Information Address: _____ 2. Application Type (check all that apply) and Requested Date UDC meeting date requested _____ Alteration to an existing or previously-approved development New development Informational Final approval Initial approval 3. Project Type Project in an Urban Design District Signage Project in the Downtown Core District (DC), Urban Comprehensive Design Review (CDR) Mixed-Use District (UMX), or Mixed-Use Center District (MXC) Signage Variance (i.e. modification of signage height, Project in the Suburban Employment Center District (SEC), area, and setback) Campus Institutional District (CI), or Employment Campus Signage Exception District (EC) Planned Development (PD) Other General Development Plan (GDP) Please specify Specific Implementation Plan (SIP) Planned Multi-Use Site or Residential Building Complex 4. Applicant, Agent, and Property Owner Information Company _____ Applicant name City/State/Zip _____ Street address Telephone Project contact person _____ Company _____ Street address City/State/Zip _____ Telephone Property owner (if not applicant) Street address City/State/Zip _____

Email

Telephone

Each submittal must include

fourteen (14) 11" x 17" collated

paper copies. Landscape and

Lighting plans (if required)

must be full-sized and legible.

Please refrain from using

plastic covers or spiral binding.

5. Required Submittal Materials

Application Form

Letter of Intent

- If the project is within an Urban Design District, a summary of how the development proposal addresses the district criteria is required
- For signage applications, a summary of how the proposed signage is consistent with the applicable CDR or Signage Variance review criteria is required.

Development Plans (Refer to checklist on Page 4 for plan details)

Filing fee

Electronic Submittal*

Notification to the District Alder

• Please provide an email to the District Alder notifying them that you are filing this UDC application. Please send this as early in the process as possible and provide a copy of that email with the submitted application.

Both the paper copies and electronic copies <u>must</u> be submitted prior to the application deadline before an application will be scheduled for a UDC meeting. Late materials will not be accepted. A completed application form is required for each UDC appearance.

For projects also requiring Plan Commission approval, applicants must also have submitted an accepted application for Plan Commission consideration prior to obtaining any formal action (initial or final approval) from the UDC. All plans must be legible when reduced.

*Electronic copies of all items submitted in hard copy are required. Individual PDF files of each item submitted should be compiled on a CD or flash drive, or submitted via email to udcapplications@cityofmadison.com. The email must include the project address, project name, and applicant name. Electronic submittals via file hosting services (such as Dropbox.com) are not allowed. Applicants who are unable to provide the materials electronically should contact the Planning Division at (608) 266-4635 for assistance.

6.	Арр	licant Declarations	
	1.	Prior to submitting this application, the applicant is requir Commission staff. This application was discussed with	
	2.	The applicant attests that all required materials are included in this not provided by the application deadline, the application will consideration.	
Na	me c	f applicant	Relationship to property
Αι	ıthori	zing signature of property owner	Date
7.	Appl	ication Filing Fees	

Fees are required to be paid with the first application for either initial or final approval of a project, unless the project is part of the combined application process involving the Urban Design Commission in conjunction with Plan Commission and/or Common Council consideration. Make checks payable to City Treasurer. Credit cards may be used for application fees of less than \$1,000.

Please consult the schedule below for the appropriate fee for your request:

Urban Design Districts: \$350 (per §35.24(6) MGO).

Minor Alteration in the Downtown Core District (DC) or Urban Mixed-Use District (UMX): \$150 (per §33.24(6)(b) MGO)

Comprehensive Design Review: \$500 (per §31.041(3)(d)(1)(a) MGO)

Minor Alteration to a Comprehensive Sign Plan: \$100 (per §31.041(3)(d)(1)(c) MGO)

All other sign requests to the Urban Design Commission, including, but not limited to: appeals from the decisions of the Zoning Administrator, requests for signage variances (i.e. modifications of signage height, area, and setback), and additional sign code approvals: \$300 (per §31.041(3)(d)(2) MGO)

A filing fee is not required for the following project applications if part of the combined application process involving both Urban Design Commission and Plan Commission:

- Project in the Downtown Core District (DC), Urban Mixed-Use District (UMX), or Mixed-Use Center District (MXC)
- Project in the Suburban Employment Center District (SEC), Campus Institutional District (CI), or Employment Campus District (EC)
- Planned Development (PD): General Development
 Plan (GDP) and/or Specific Implementation Plan (SIP)
- Planned Multi-Use Site or Residential Building Complex

URBAN DESIGN COMMISSION APPROVAL PROCESS



Introduction

The City of Madison's Urban Design Commission (UDC) has been created to:

- Encourage and promote high quality in the design of new buildings, developments, remodeling, and additions so as to maintain and improve the established standards of property values within the City.
- Foster civic pride in the beauty and nobler assets of the City, and in all other ways possible assure a functionally efficient and visually attractive City in the future.

Types of Approvals

There are three types of requests considered by the UDC:

- Informational Presentation. Applicants may, at their discretion, request to make an Informational Presentation to the
 UDC prior to seeking any approvals to obtain early feedback and direction before undertaking detailed design. Applicants
 should provide details on the context of the site, design concept, site and building plans, and other relevant information
 to help the UDC understand the proposal and provide feedback. (Does not apply to CDR's or Signage Variance requests)
- <u>Initial Approval</u>. Applicants may, at their discretion, request initial approval of a proposal by presenting preliminary design information. As part of their review, the Commission will provide feedback on the design information that should be addressed at Final Approval stage.
- <u>Final Approval</u>. Applicants may request Final Approval of a proposal by presenting all final project details. Recommendations or concerns expressed by the UDC in the initial approval must be addressed at this time.

Presentations to the Commission

Primarily, the UDC is interested in the appearance and design quality of projects. Emphasis should be given to the site plan, landscape plan, lighting plan, building elevations, exterior building materials, color scheme, and graphics.

When presenting projects to the UDC, applicants must fill out a registration slip provided in the meeting room and present it to the Secretary. Presentations should generally be limited to 5 minutes or as extended by motion by consent of the Commission. The Commission will withhold questions until the end of the presentation.

Applicants are encouraged to consider the use of various graphic presentation material including a locator map, photographs, renderings/model, scale drawings of the proposal in context with adjacent buildings/uses/signs, etc., as may be deemed appropriate to describe the project and its surroundings. Graphics should be mounted on rigid boards so that they may be easily displayed. Applicants/presenters are responsible for all presentation materials, AV equipment and easels.

URBAN DESIGN DEVELOPMENT PLANS CHECKLIST



The items listed below are minimal application requirements for the type of approval indicated. Please note that the UDC and/or staff may require additional information in order to have a complete understanding of the project.

1. Informational Presentation					
	Locator Map)		Requirem	ents for All Plan Sheets
	Letter of Intent (If the project is within			1. Title	block
	an Urban Design District, a summary of how the development proposal addresses			2. Shee	et number
	the district criteria is required)		Providing additional	3. Nort	th arrow
	_	}	information beyond these minimums may generate	4. Scale 5. Date	e, both written and graphic
	buildings/structures		a greater level of feedback from the Commission.	6. Fully	dimensioned plans, scaled
	Site Plan				'= 40' or larger as must be legible, including
	Two-dimensional (2D) images of proposed buildings or structures.				zed landscape and lighting
2. Initial A	pproval				
	Locator Map			1	
	Letter of Intent (If the project is within a the development proposal addresses the			of <u>how</u>	
	Contextual site information, including ph structures	otog	raphs and layout of adjacent bu	uildings/	Providing additional information beyond these
	Site Plan showing location of existing a lanes, bike parking, and existing trees ov			res, bike	minimums may generate a greater level of feedback
	Landscape Plan and Plant List (must be le	2gible	e)		from the Commission.
	Building Elevations in both black & whi material callouts)	te ar	nd color for all building sides	(include	
	PD text and Letter of Intent (if applicable	:)		J	
3. Final Ap	proval				
All the re	equirements of the Initial Approval (see al	oove), <u>plus</u> :		
	Grading Plan				
	Proposed Signage (if applicable)				
	Lighting Plan, including fixture cut sheet			-	
	Utility/HVAC equipment location and scr		ng details (with a rooftop plan	if roof-mou	inted)
	PD text and Letter of Intent (if applicable	•			
	Samples of the exterior building materia	ls (pr	resented at the UDC meeting)		
4. Compre	nensive Design Review (CDR) and Varia	nce	Requests (<u>Signage applicatio</u>	ons only)	
	Locator Map				
	Letter of Intent (a summary of how the prop	posec	d signage is consistent with the CI	DR or Signage	e Variance criteria is required)
	Contextual site information, including project site	hoto	ographs of existing signage bo	th on site a	and within proximity to the
	Site Plan showing the location of existing driveways, and right-of-ways	រូ sign	nage and proposed signage, din	nensioned s	signage setbacks, sidewalks,
	Proposed signage graphics (fully dimens	ione	d, scaled drawings, including m	naterials and	d colors, and night view)
	Perspective renderings (emphasis on pe	destr	ian/automobile scale viewshed	ds)	
	Illustration of the proposed signage that	mee	ets Ch. 31, MGO compared to v	vhat is being	g requested.
	Graphic of the proposed signage as it rel	ates	to what the Ch. 31, MGO wou	ld permit	

April 30, 2021



Ms. Heather Stouder
Director, Planning Division
City of Madison Department of Planning & Community & Economic Development
215 Martin Luther King Jr. Blvd., Ste 017
Madison, Wisconsin 53703

Re: Letter of Intent - Land Use

100 W Wilson St.
145, 147, 149, 151 W Wilson St 309, 313, 315, 321 S Henry St Madison, WI 53703
KBA Project #2017

Ms. Heather Stouder:

The following is submitted together with the plans and application for the staff and Plan Commission's consideration of approval.

Organizational Structure:

Owner: Walter Wayne Development, LLC Architect: Knothe & Bruce Architects, LLC

702 N High Point Rd. STE 200 7601 University Avenue, Ste 201

Madison, WI 53717 Middleton, WI 53562 (608) 828-9117 (608) 836-3690

Contact: Randy Christianson Contact: Kevin Burow rc@starkcommercial.com kburow@knothebruce.com

Engineer: Vierbicher Associates, Inc. Landscape Vierbicher Associates, Inc.

999 Fourier Dr.

Madison, WI 53717

(608) 826-0532

Contact: John Kastner

ikas@vierbicher.com

Design:

999 Fourier Dr.

Madison, WI 53717

(608) 826-0532

Contact: John Kastner

ikas@vierbicher.com

Introduction:

This proposed mixed-use development involves the redevelopment of 145, 147, 149, and 151 W Wilson St., and 309, 313, 315, and 321 S Henry St. located at the intersection of W Wilson St. and S Henry St. Located within the Capitol Neighborhoods, the site is currently occupied by residential units. This application requests permission for the development of a new ten-story mixed-use building. The development will include 206 apartment units and prominent first floor commercial space. The site is currently zoned UMX (Urban Mixed-Use) and will remain UMX (Urban Mixed-Use) zoning for the proposed redevelopment.

Letter of Intent – Land Use 100 W Wilson April 30, 2021 Page 2 of 3

Demolition Standards

The existing residential buildings are used as rental housing that is predominantly student housing. These buildings have served many people over their time but have become outdated and in need of repairs and updates. We are proposing the existing buildings be demolished. The site is located on a prominent corner in the city that is currently underutilized and would be better utilized as a mixed-use property. The demolition standards will be met, and a Re-use and Recycling Plan will be submitted prior to the deconstruction of the existing structure.

Project Description:

The proposed project is a mixed-use development consisting of 206 apartment units. It also includes a commercial space located on the first floor at the corner of S Henry St. and W Wilson St. The building is ten stories. The new development is comparable to the neighboring buildings in height while maximizing views.

The efficient planning takes the form of an angled "L" in a mix of classic and streamlined architecture. The light and neutral base paired with windows and with dark gray trim respect the surrounding neighborhood, especially the Stoner House across the street from the site. The Metal Panels and Bird-Safe glass on the upper levels ensure the development will become a calm addition to the City of Madison's skyline. The transitions in both the landscaping and building plans are particularly sensitive to the surrounding neighborhood. The project creates a year-round active transition between residential and commercial spaces downtown while enhancing the streetscapes; it is designed for the community.

The development offers apartments ranging from studio to two bedrooms, and the unique shape of the upper tower allows for approximately 85% of the units have unblocked lake views. A pool with lake views, a dog run and pet washing station, and a golf simulator are a few of the offered amenities. Community spaces such as co-working spaces, community room, kitchen, a solarium, and fitness rooms are also provided. Underground parking is provided at three levels within the building and accessed from both W Wilson St. and S Henry St. The site is also at the intersection of the number 12 bus stop and only two blocks away from the State Capital, allowing for easy access to many areas of the City.

In addition to amenities, the building also offers a sustainable living experience. The building offers a 1:1 bike parking ratio for residents, and electric car charging stations. Units are equipped with low flow fixtures, energy star appliances, and high-performance glass while maximizing natural light. Green roofs and native vegetation in the landscape create a total sustainable environment and it is our intention to add solar panels to the project.

City and Neighborhood Input:

We have met with the City on several occasions for this proposed development including a preapplication meeting on July 23, 2020 with Kevin Firchow and Sydney Prusak of City of Madison Planning, and Jenny Kirchgatter of City of Madison Zoning. It was presented at an Informational UDC Meeting on February 10, 2021. We have also met with the Steering Committee members of the Capitol Neighborhoods on multiple occasions and a full neighborhood meeting was hosted by Alder Verveer. This input has helped shape this proposed development.

Conditional Use Approvals:

The proposed development requires a conditional use to allow for a more than 8 multi-family dwelling units in a mixed-use building. The proposed building's size, scale and use are consistent with the City's Comprehensive Plan for this property, which calls for Downtown Core (DC) development. We have met or exceeded all standards of the UMX (Urban Mixed-Use) zoning.

Site Development Data:

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Lot Area 34,703 S.F. / 0.8 acres

Dwelling Units 206 D.U.
Lot Area / D.U. 168 S.F./D.U.
Density 258 units/acre
Lot Coverage 30,610 S.F. / 88%
Usable Open Space 18,787 S.F.

Building Height: 2 - 10 Stories / 28'-8" - 125'-0"

Commercial Area: 809 S.F.

Dwelling Unit Mix:

 Studio
 69

 One Bedroom
 112

 Two Bedroom
 25

 Total
 206 D.U.

Vehicle Parking:

Underground Parking 229
Total 229 vehicle stalls

Bicycle Parking:

Covered - Secure 206
Surface - Guest 21
Surface - Commercial 1
Total 228 bike stalls

Project Schedule:

It is anticipated that construction will start in Fall 2021 and be completed in Spring 2023.

Thank you for your time and consideration of our proposal.

Sincerely,

Kevin Burow, AIA, NCARB, LEED AP

Keni Bu

Managing Member

PROJECT GOALS

Maximize Views

Orient massing to maximize views of Lake & Capitol Orient amenities/pool with view to the Lake Take advantage of prominent views from John Nolen Drive

Efficiency of Planning

Efficiency of building form Consistency of unit types & floor plates Strategic amenity programming

Classic & Streamlined Architecture

Efficiency of building form Clarity in massing, materials & hierarchy Simplify language

Financially Responsible

Leverage efficiency of planning & streamlined architecture Hit target demographic & price point Design for staying power

Designing for Community

Make design decisions based on target demographic & wellness concepts Design for community interaction within building Be good neighbors






PROJECT LOCATION





UDC INFORMATIONAL PRESENTATION | 02/03/21



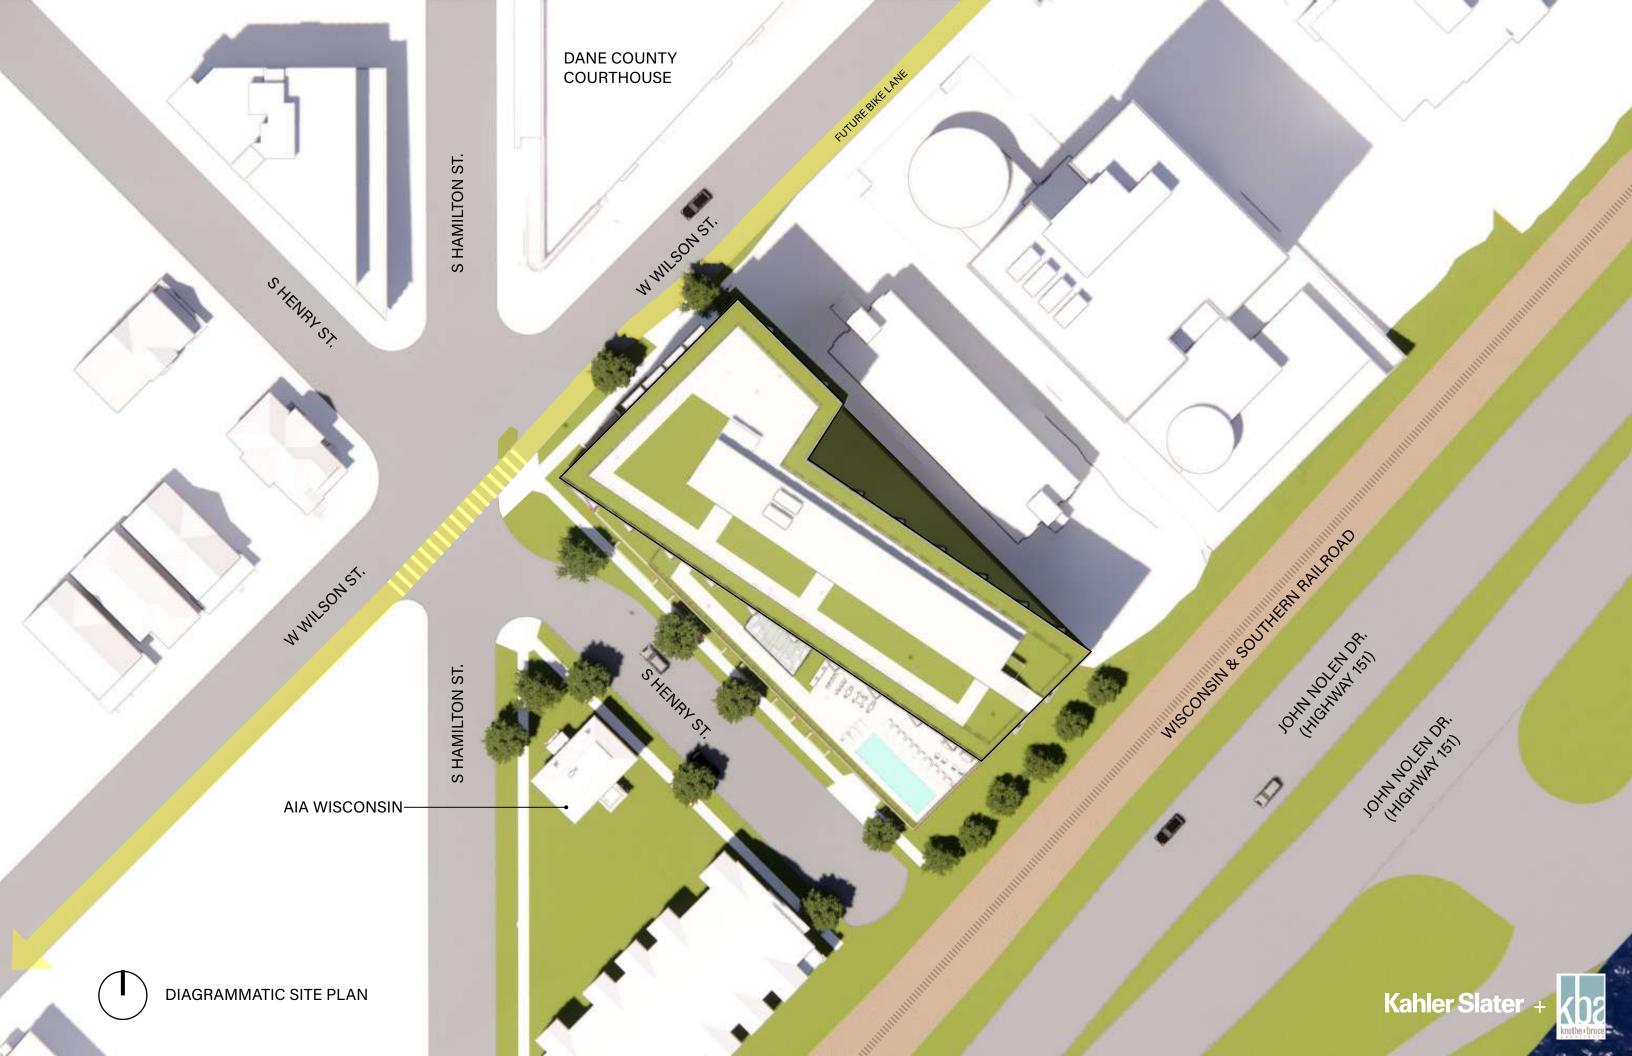



GENERAL NOTES:

I. THE APPLICANT SHALL REPLACE ALL SIDEWALK AND CURB AND GUTTER THAT ABUTS THE PROPERTY THAT IS DAMAGED BY THE CONSTRUCTION, OR ANY SIDEWALK AND CURB AND GUTTER WHICH THE CITY ENGINEER DETERMINES NEEDS TO BE REPLACED BECAUSE IT IS NOT AT A DESIRABLE GRADE, REGARDLESS OF WHETHER THE CONDITION EXISTED PRIOR TO BEGINNING CONSTRUCTION.

2.ALL WORK IN THE PUBLIC RIGHT OF WAY SHALL BE PERFORMED BY A CITY-LICENSED CONTRACTOR.

3. ALL DAMAGE TO THE PAVEMENT ON CITY STREETS, AND ADJACENT TO THIS DEVELOPMENT SHALL BE RESTORED IN ACCORDANCE WITH THE CITY OF MADISON'S PAVEMENT PATCHING CRITERIA.

4. ALL PROPOSED STREET TREE REMOVALS WITHIN THE RIGHT OF WAY SHALL BE REVIEWED BY CITY FORESTRY BEFORE THE PLAN COMMISSION MEETING. STREET TREE REMOVALS REQUIRE APPROVAL AND A TREE REMOVAL PERMIT ISSUED BY CITY FORESTRY. ANY STREET TREE REMOVALS REQUESTED AFTER THE DEVELOPMENT PLAN IS APPROVED BY THE PLAN COMMISSION OR THE BOARD O PUBLIC WORKS AND CITY FORESTRY WILL REQUIRE A MINIMUM OF A 72-HOUR REVIEW PERIOD WHICH SHALL INCLUDE THE NOTIFICATION OF THE ALDERPERSON WITHIN WHO'S DISTRICT IS AFFECTED BY THE STREET TREE REMOVAL(S) PRIOR TO A TREE REMOVAL PERMIT BEING ISSUED.

5. AS DEFINED BY THE SECTION 107.13 OF CITY OF MADISON STANDARD SPECIFICATIONS FOR PUBLIC WORKS CONSTRUCTION: NO EXCAVATION IS PERMITTED WITHIN 5 FEET OF THE TRUNK OF THE STREET TREE OR WHEN CUTTING ROOTS OVER 3 INCHES IN DIAMETER. IF EXCAVATION IS NECESSARY, THE CONTRACTOR SHALL CONTACT MADISON CITY FORESTRY (266-4816) PRIOR TO EXCAVATION. CITY OF MADISON FORESTRY PERSONNEL SHALL ASSESS THE IMPACT TO THE TREE AND TO ITS ROOT SYSTEM PRIOR TO WORK COMMENCING. TREE PROTECTION SPECIFICATIONS CAN BE FOUND ON THE FOLLOWING WEBSITE:

HTTPS://WWW.CITYOFMADISON.COM/BUSINESS/PW/SPECS.CFM

6.CONTRACTOR SHALL TAKE PRECAUTIONS DURING CONSTRUCTION TO NOT DISFIGURE, SCAR, OR IMPAIR THE HEALTH OF ANY STREET TREE. CONTRACTOR SHALL OPERATE EQUIPMENT IN A MANNER AS TO NOT DAMAGE THE BRANCHES OF THE STREET TREE(S). THIS MAY REQUIRE USING SMALLER EQUIPMENT AND LOADING AND UNLOADING MATERIALS IN A DESIGNATED SPACE AWAY FROM TREES ON THE CONSTRUCTION SITE. ANY DAMAGE OR INJURY TO EXISTING STREET TREES (EITHER ABOVE OR BELOW GROUND) SHALL BE REPORTED IMMEDIATELY TO CITY FORESTRY AT 266-4816. PENALTIES AND REMEDIATION SHALL BE REQUIRED.

7.SECTION 107.13(G) OF CITY OF MADISON STANDARD SPECIFICATIONS FOR PUBLIC WORKS CONSTRUCTION ADDRESSES SOIL COMPACTION NEAR STREET TREES AND SHALL BE FOLLOWED BY CONTRACTOR. THE STORAGE OF PARKED VEHICLES, CONSTRUCTION EQUIPMENT, BUILDING MATERIALS, REFUSE, EXCAVATED SPOILS OR DUMPING OF POISONOUS MATERIALS ON OR AROUND TREES AND ROOTS WITHIN FIVE (5) FEET OF THE TREE OR WITHIN THE PROTECTION ZONE IS PROHIBITED.

8.ON THIS PROJECT, STREET TREE PROTECTION ZONE FENCING IS REQUIRED. THE FENCING SHALL BE ERECTED BEFORE THE DEMOLITION, GRADING OR CONSTRUCTION BEGINS. THE FENCE SHALL INCLUDE THE ENTIRE WIDTH OF TERRACE AND, EXTEND AT LEAST 5 FEET ON BOTH SIDES OF THE OUTSIDE EDGE OF THE TREE TRUNK. DO NOT REMOVE THE FENCING TO ALLOW FOR DELIVERIES OR EQUIPMENT ACCESS THROUGH THE TREE PROTECTION ZONE.

9.STREET TREE PRUNING SHALL BE COORDINATED WITH MADISON FORESTRY A A MINIMUM OF TWO WEEKS PRIOR TO THE START OF CONSTRUCTION FOR THIS PROJECT. ALL PRUNING SHALL FOLLOW THE AMERICAN NATIONAL STANDARDS INSTITUTE (ANSI) A300 - PART I STANDARDS FOR PRUNING.

10. APPROVAL OF PLANS FOR THIS PROJECT DOES NOT INCLUDE ANY APPROVAL TO PRUNE, REMOVE, OR PLANT TREES IN THE PUBLIC RIGHT-OF-WAY. PERMISSION FOR SUCH ACTIVITIES MUST BE OBTAINED FROM THE CITY FORESTEF

II. THE PUBLIC RIGHT-OF-WAY IS THE SOLE JURISDICTION OF THE CITY OF MADISON AND IS SUBJECT TO CHANGE AT ANY TIME. NO ITEMS SHOWN ON THIS SITE PLAN IN THE RIGHT-OF-WAY ARE PERMANENT AND MAY NEED TO BE REMOVED AT THE APPLICANTS EXPENSE UPON NOTIFICATION BY THE CITY.


BIKE RACKS:



INTERIOR & EXTERIOR FLOOR MOUNTED: "INVERTED U" TYPE. MADRAX UX OR SARIS BIKE DOCK



INTERIOR WALL MOUNTED: MADRAX VERTICAL RACK OR SARIS BIKE TRACK

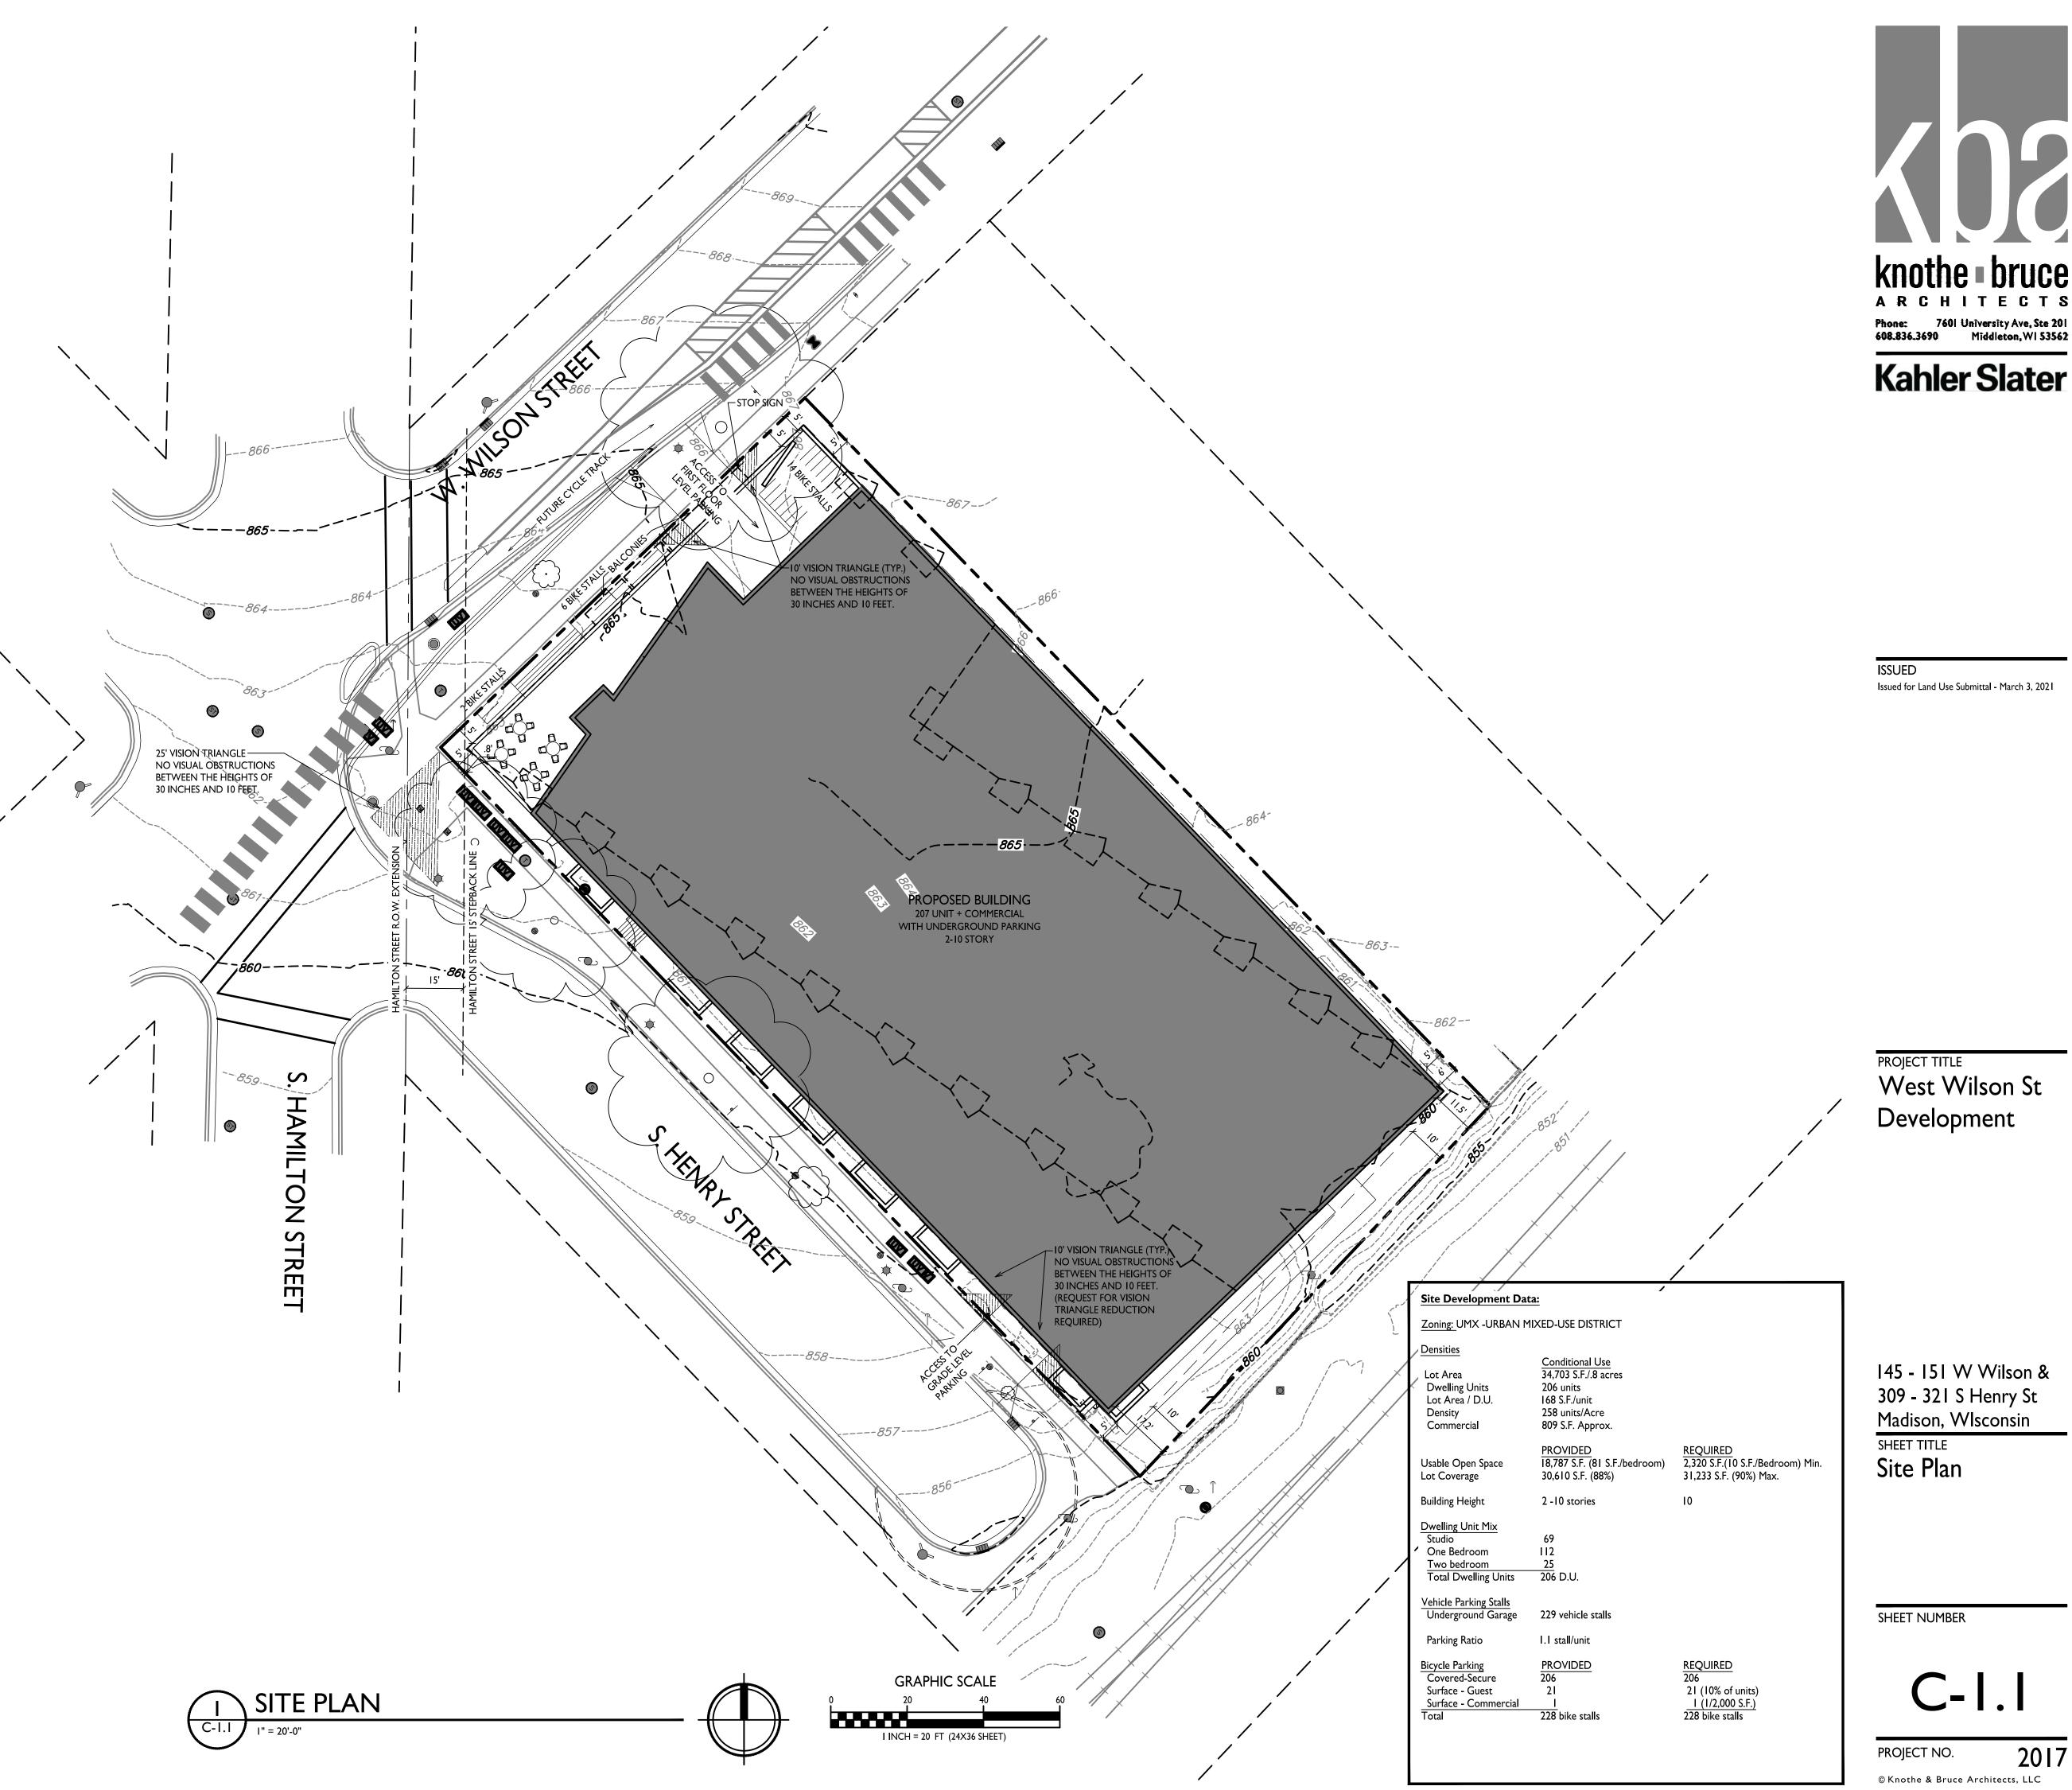



Issued for Land Use Submittal - March 3, 2021

PROJECT TITLE West Wilson St Development


145 - 151 W Wilson & 309 - 321 S Henry St Madison, WIsconsin

SHEET TITLE Site Plan

SHEET NUMBER

STATISTICS						
DESCRIPTION	SYMBOL	AVG.	MAX.	MIN.	MAX. / MIN.	AVG. / MIN.
First Floor Level Parking Entrance Lighting	g +	1.2 fc	5.9 fc	0.1 fc	59.0:1	12.0:1
Grade Level Parking Entrance Lighting	+	I.3 fc	4.8 fc	0.1 fc	58.0:I	13.0:1

LUMINAIRE SCHEDULE							
SYMBOL LABEL	. QTY. MANUF.	CATALOG	DESCRIPTION	FILE	MOUNTING		
A	I LITHONIA LIGHTING	LIL LED 30K MVOLT	LIL LED WALLPACK (STANDARD)	LIL_LED_30K_MVOLT.ies	ON BUILDING 8'-0" ABOVE GRADE		
ISOLUX CONTOUR = 0.25 FC ISOLUX CONTOUR = 0.5 FC ISOLUX CONTOUR = 1.0 FC LIGHT FIXTURE							

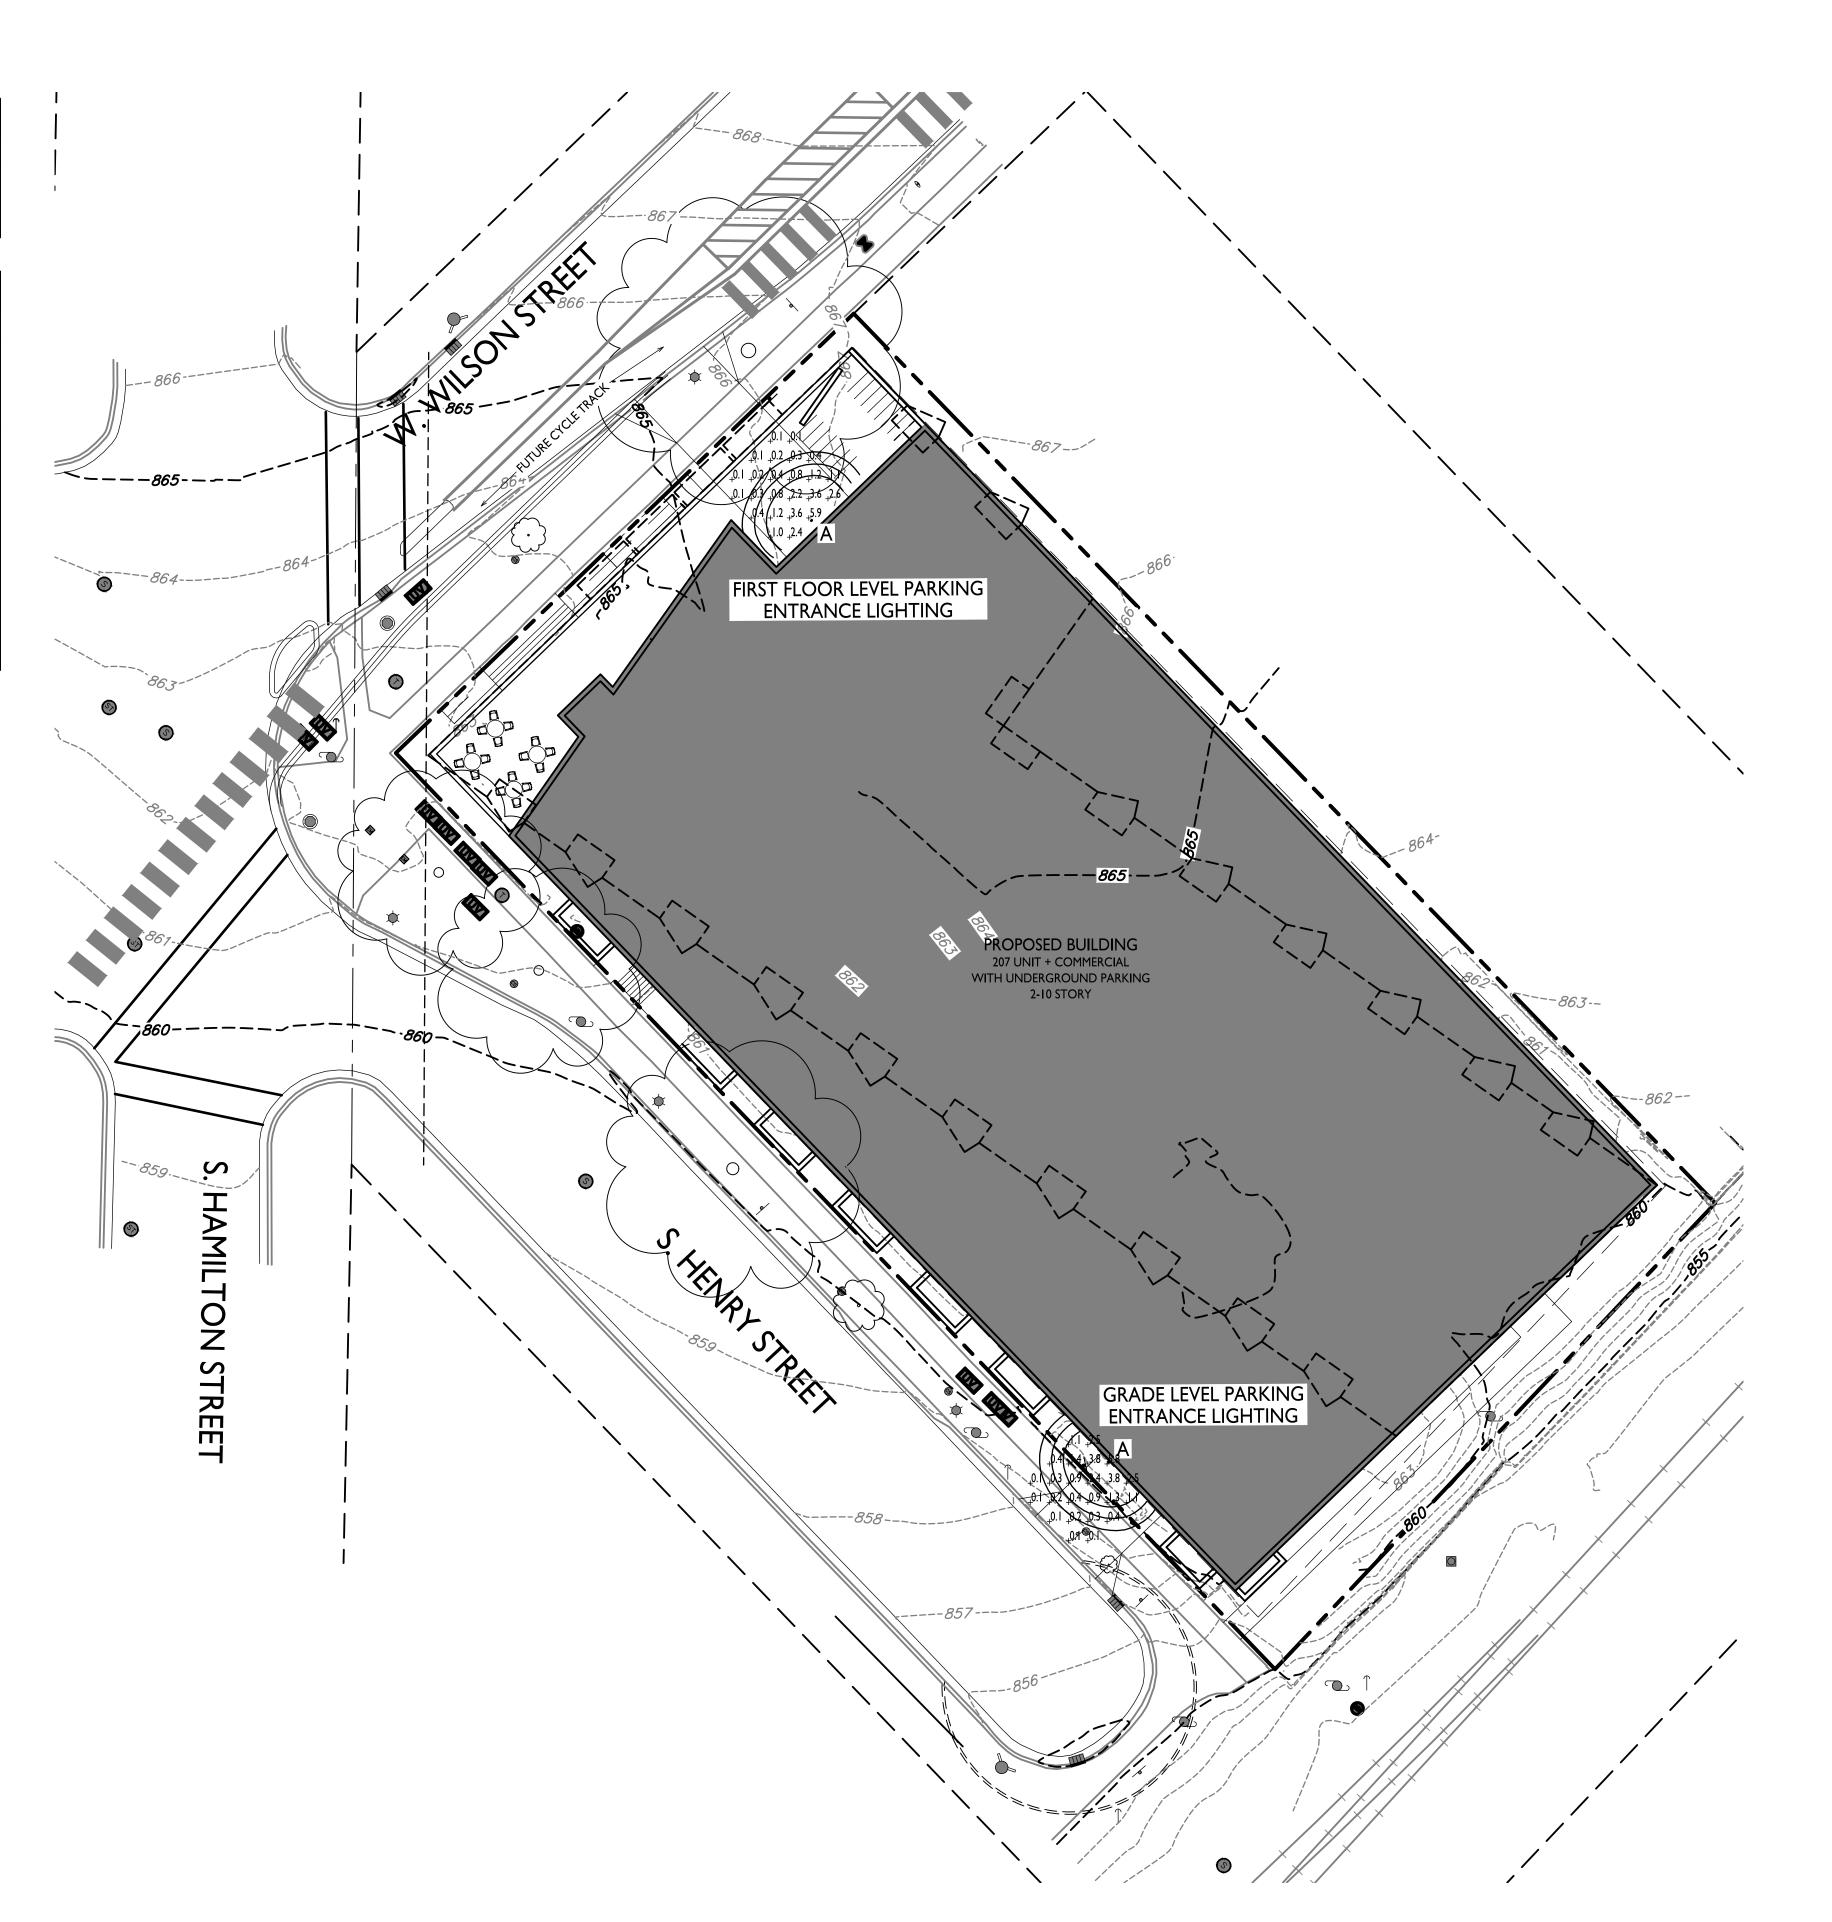



ISSUED
Issued for Land Use Submittal - March 3, 2021

PROJECT TITLE
West Wilson St
Development

145 - 151 W Wilson & 309 - 321 S Henry St Madison, Wisconsin SHEET TITLE

Site Lighting Plan

SHEET NUMBER

C-1.2


© Knothe & Bruce Architects, LLC


2017

PROJECT NO.





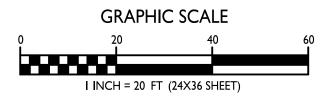

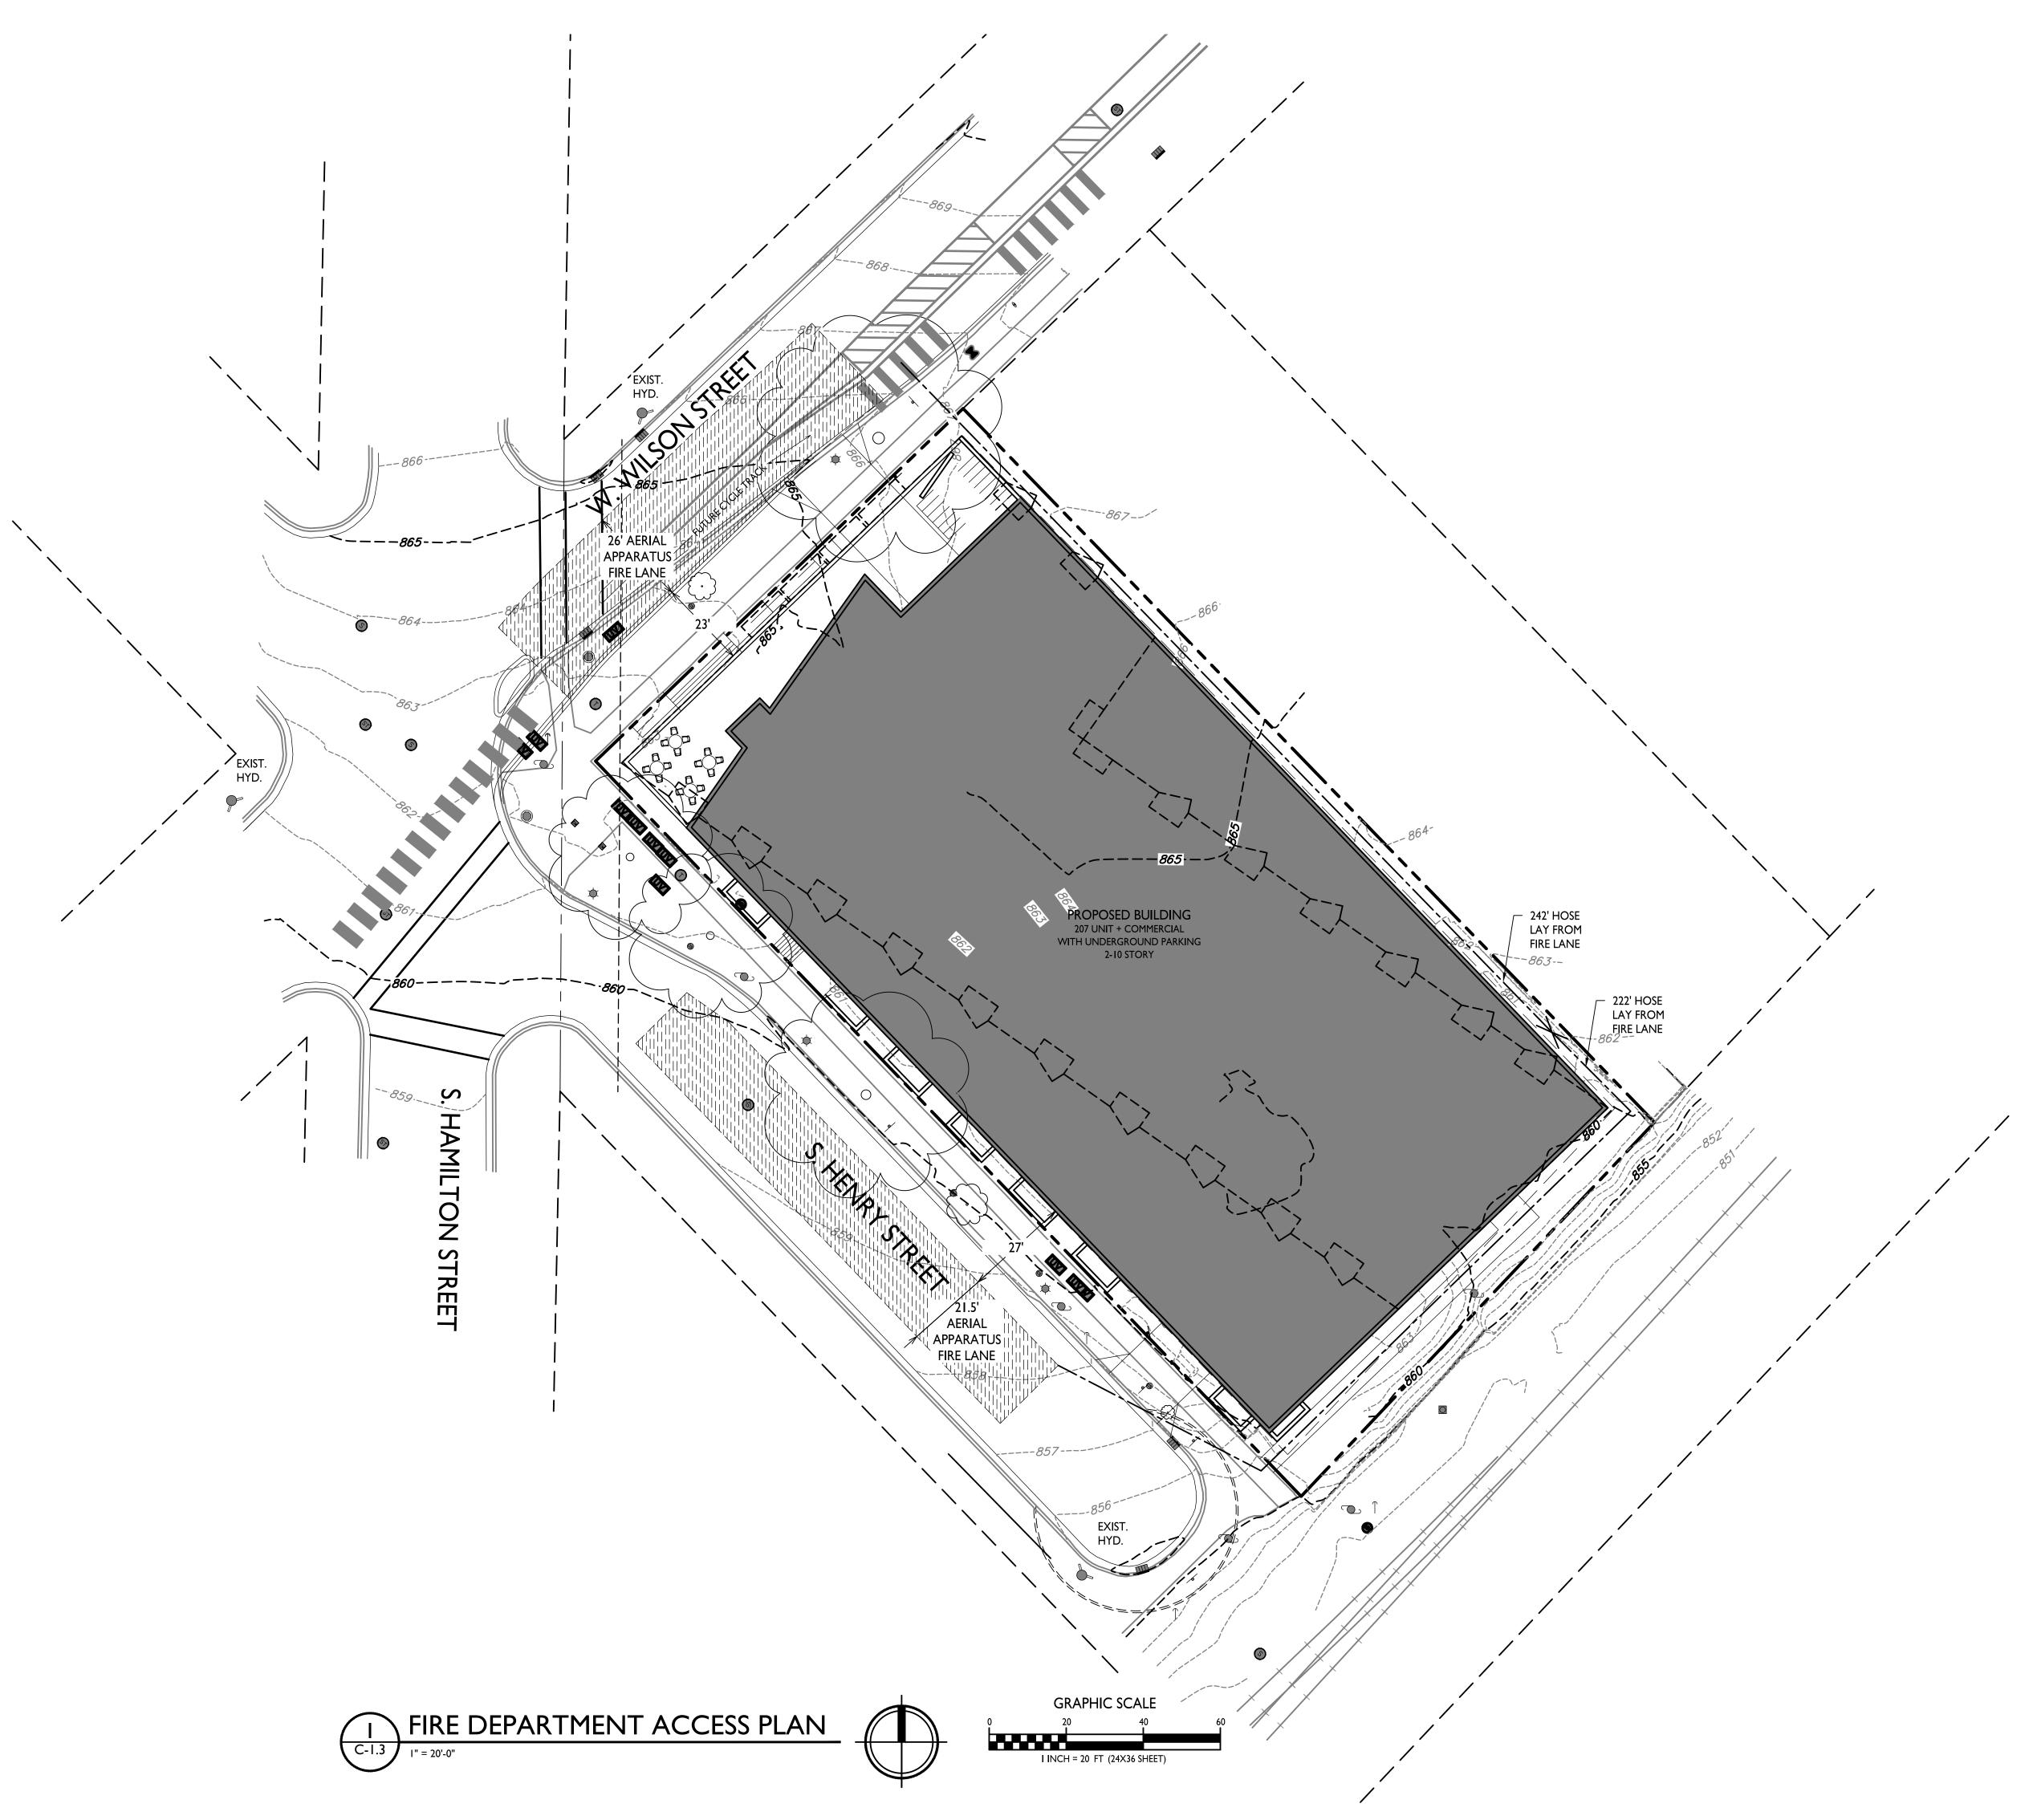



ISSUED
Issued for Land Use Submittal - March 3, 2021

PROJECT TITLE
West Wilson St
Development


145 - 151 W Wilson & 309 - 321 S Henry St Madison, WIsconsin


SHEET TITLE

Fire Department Access Plan

SHEET NUMBER

C-1.3

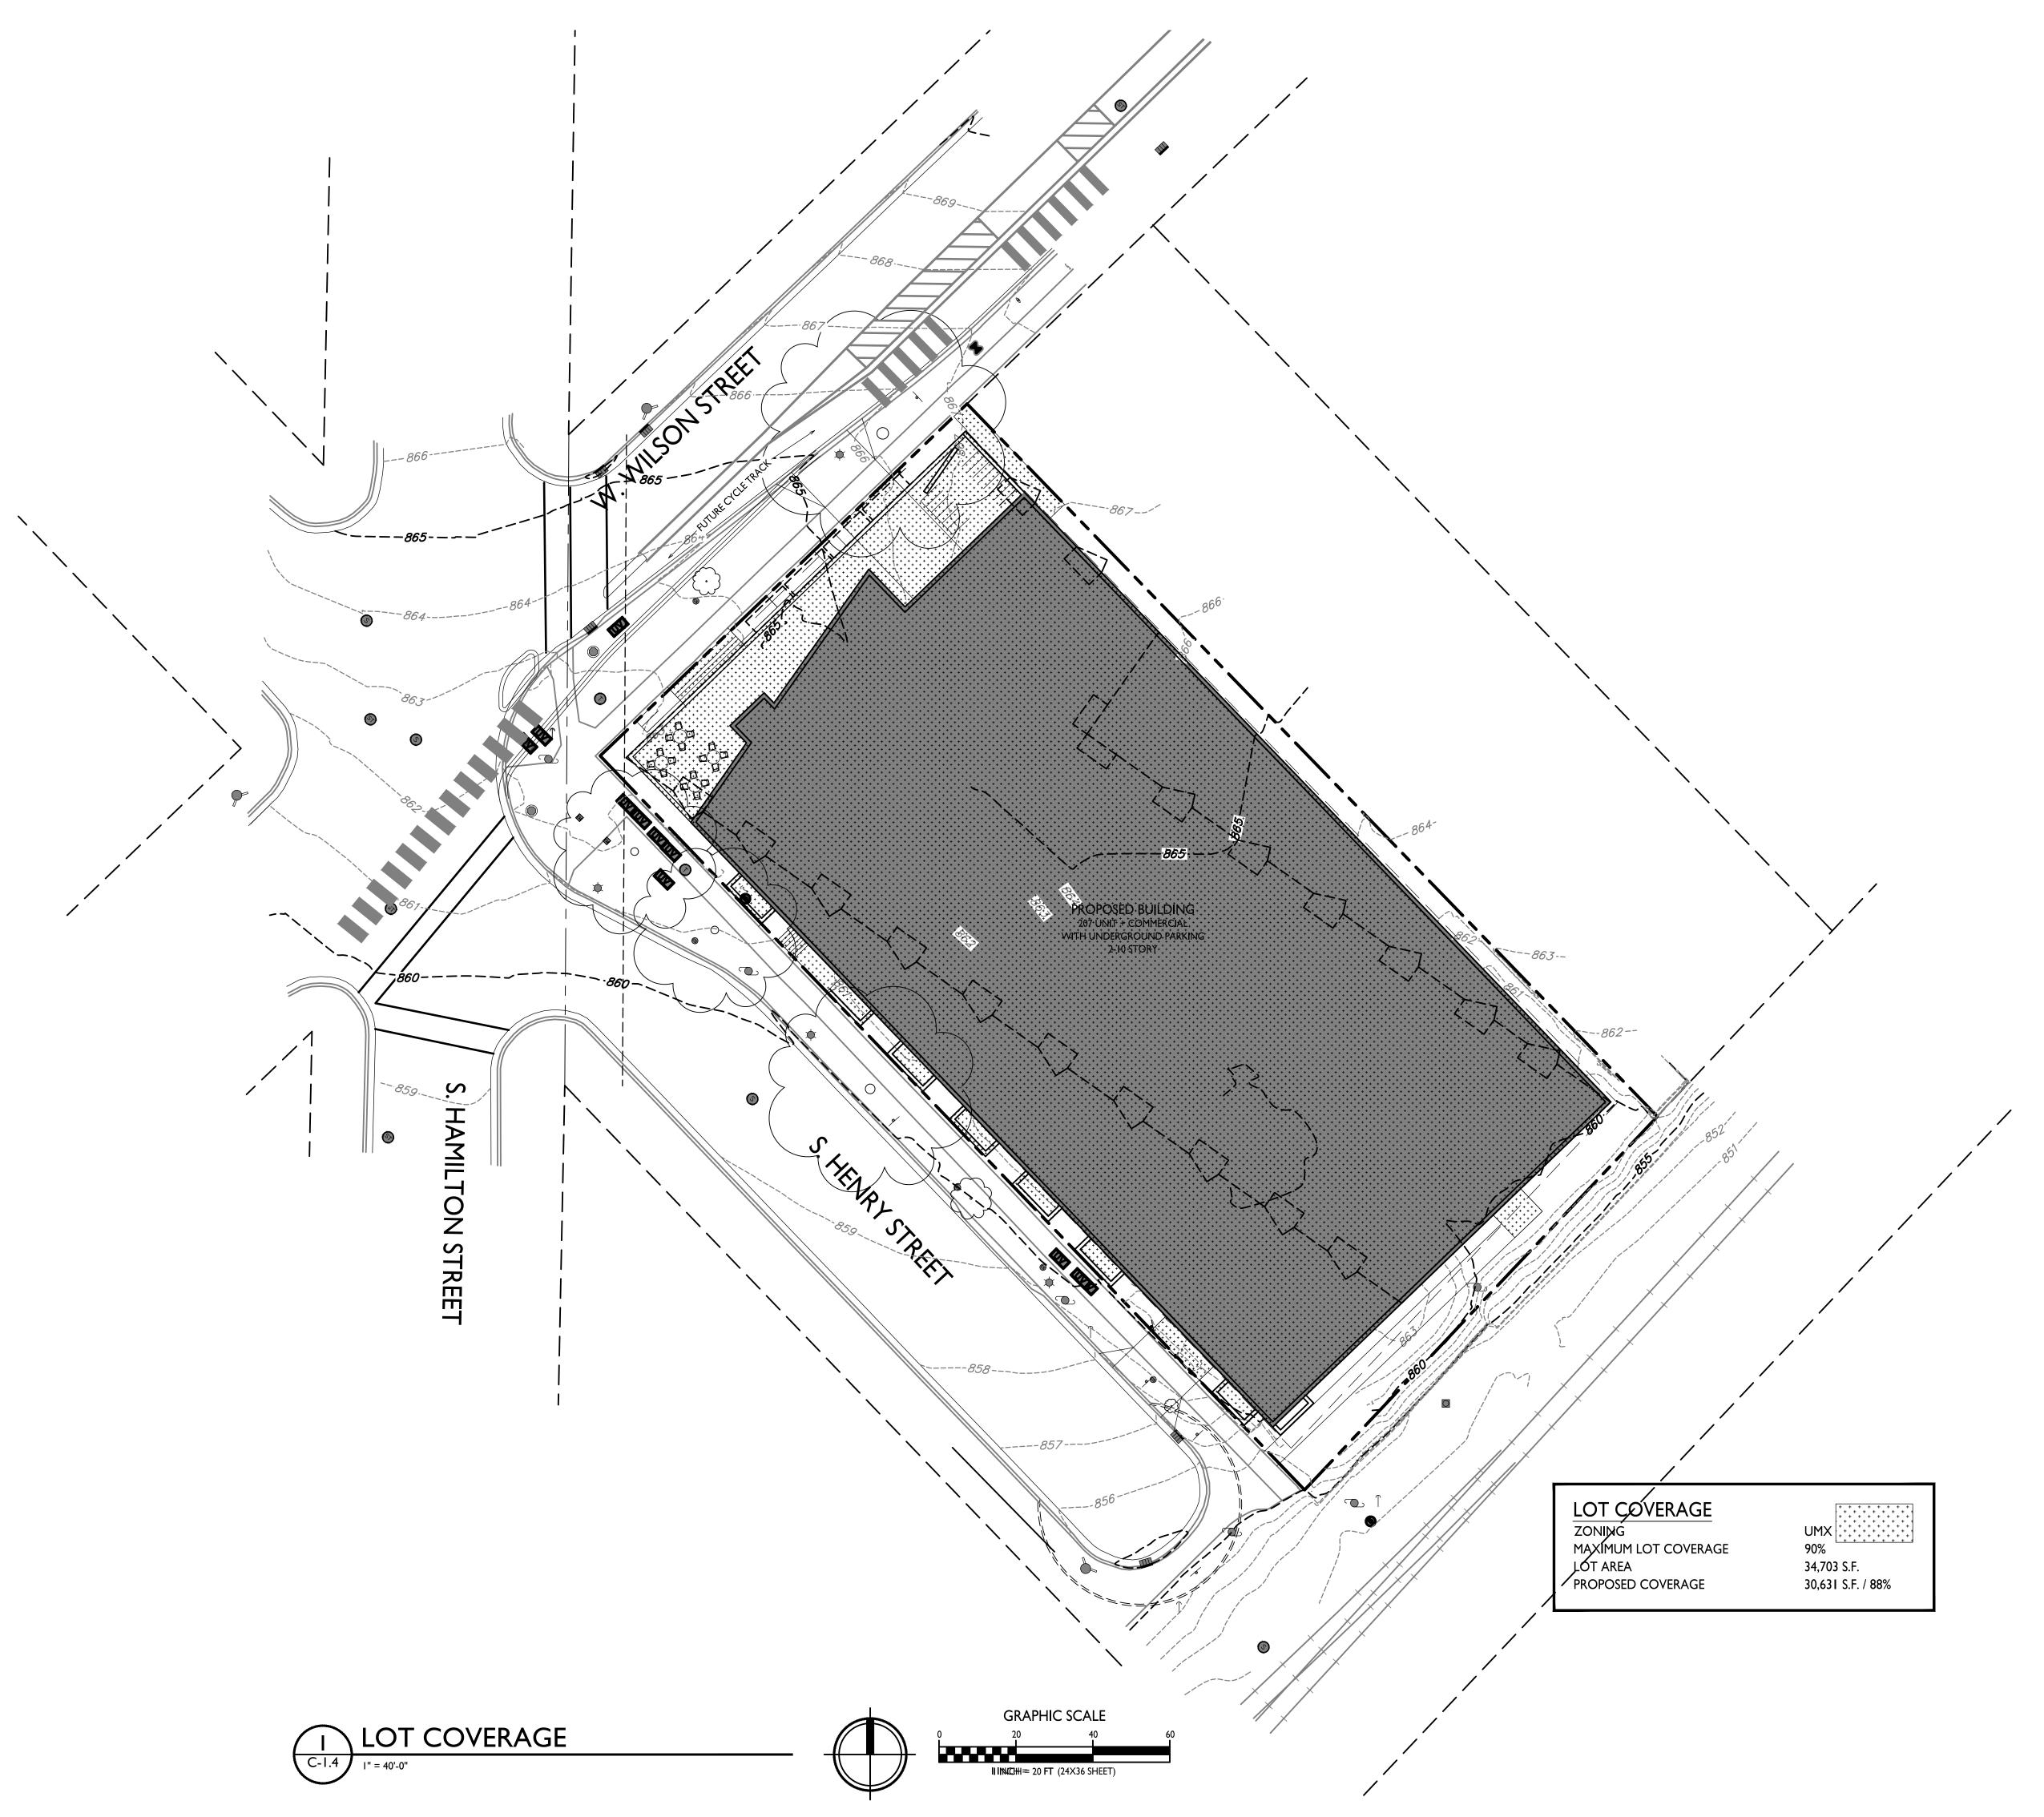

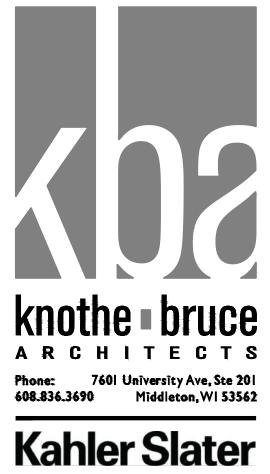

ISSUED
Issued for Land Use Submittal - March 3, 2021

PROJECT TITLE
West Wilson St
Development


145 - 151 W Wilson & 309 - 321 S Henry St Madison, WIsconsin
SHEET TITLE
Lot Coverage


SHEET NUMBER

C-1.4

PROJECT NO. 2017

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Issued for Land Use Submittal - March 3, 2021

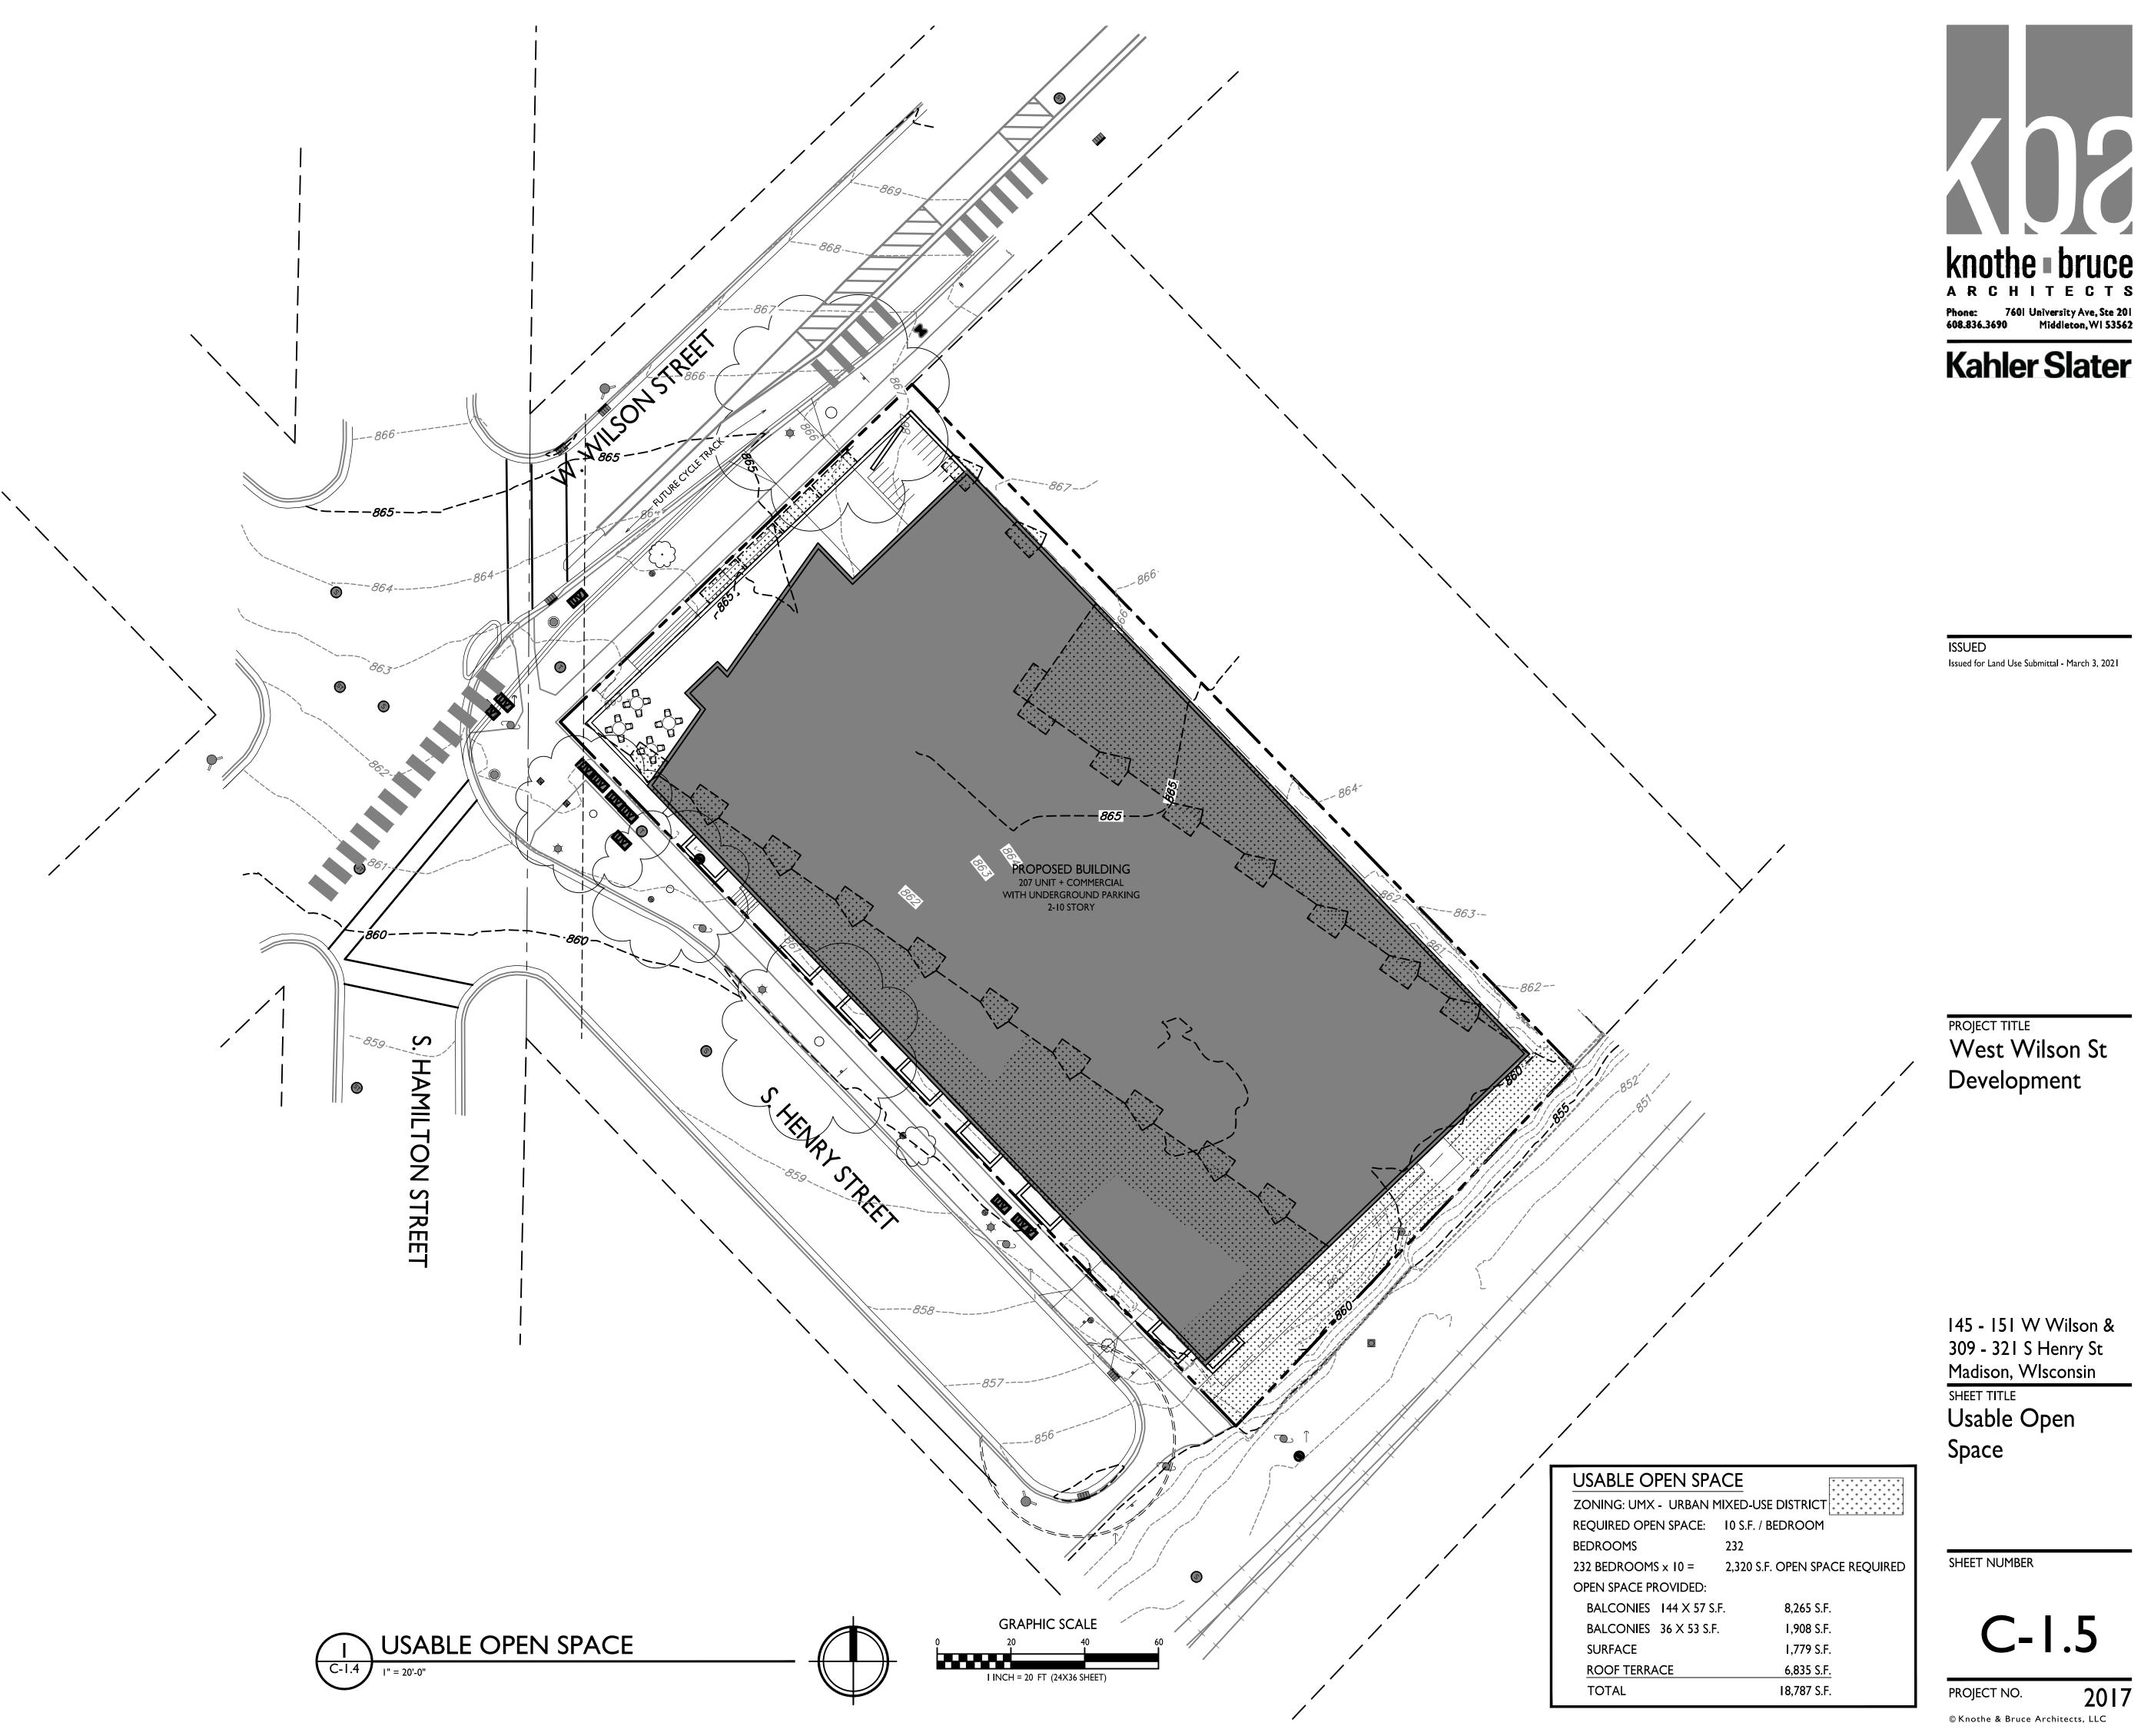PROJECT TITLE

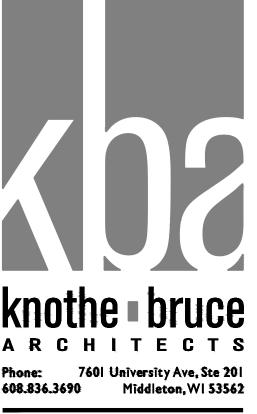West Wilson St Development

145 - 151 W Wilson &309 - 321 S Henry StMadison, WIsconsin SHEET TITLE
Usable Open Space

SHEET NUMBER

C-1.5



SURVEY LEGEND

- X FOUND CHISELED "X"
- ▲ FOUND PK NAIL
- \otimes FOUND 2" Ø IRON PIPE
- FOUND 1 1/4" Ø IRON ROD
- FOUND 3/4" Ø IRON ROD

<u>SUR VE YED FOR:</u> WALTER WAYNE DEVELOPMENT

ATTN: DAVE DIAMOND 702 NORTH HIGH POINT ROAD, SUITE 200 MADISON, WI 53717

SUR VE YED BY: VIERBICHER ASSOCIATES, INC. BY: DAVID N. GULLICKSON 999 FOURIER DRIVE, SUITE 201 MADISON, WI 53717

(608)-821-3966

dgul@vierbicher.com

∆ BENCHMARK 1 − ELEV. = 859.42: TOP NUT OF FIRE HYDRANT LOCATED AT THE INTERSECTION OF WEST WILSON STREET AND SOUTH HAMILTON STREET.

<u>BENCHMARK 2 - ELEV. = 858.98:</u>
TOP NUT OF FIRE HYDRANT LOCATED

HENRY STREET.

PROJECT BENCHMARKS:

BENCHMARK 2 - ELEV. = 864.04:
TOP NUT OF FIRE HYDRANT LOCATED AT THE INTERSECTION OF WEST WILSON STREET AND SOUTH HAMILTON STREET.

ON THE EASTERLY END OF SOUTH

UT DE UT UE GUARD — RAIL S44°05'10"E 258.09' GRAŞS _ - RETAINING GRASS 01 145 W. Wilson St. Ex. 3-Story Apt. Bld. 145 W. Wilson St. Ex. 2-Story Apt. Bld. GRASS 2 \(\rangle \) \(\begin{array}{c} \overline{\pi} \\ \overli \leq : OI : 15' WIDE R/W EASEMENT. $\mathcal{O}|_{\mathbb{F}}^{4}$ GRASS 10' WIDE GAS EASEMENT PER DOME NO. 1563774 149 W. Wilson St. Ex. 2-Story Apt. Bld. 0 RIM=863.57 | IE=855.11 **♦** 321 S. Henry St. Ex. 2—Story Apt. Bld. 151 W. Wilson St. Ex. 3—Story Apt. Bld. N43°49'03"W UV UV UV UV CONGRETE WALK UV UV K OHE OHE OHE OHE OHE OHE - S EX CIN —/ RIM=857.07 IE=852.54 SOUIH HENRY SIREEI EX SMH — RIM=859.60 EX SMH — RIM=862.65 IE=850.90 NE IE=850.80 SE IE=849.30 NW IE=849.20 SE IE=849.49 NE IE=853.95 E RIM=851.52 IE=846.51 NW IE=844.72 NE RIM=855.17 | IE=850.08 N | IE=849.90 S -----

- 1. This survey is based upon field survey work performed between November 18 and November 20, 2020. Any changes in site conditions after December 2, 2020 are not reflected by this survey.
- 2. Elevations depicted on this map are based upon NAVD88 (2012 Geoid) Datum.
- 3. Benchmarks shall be verified before construction.
- 4. Surveyor has made no investigation or independent search for easements of record, encumbrances, restrictive covenants, or ownership title evidence.
- 5. Utility locations were field located based upon substantial, visible, above ground structures, upon maps provided to the surveyor, or upon markings on the ground placed by utility companies and/or their agents. No warranty is given to the utility markings by others or that all underground utilities affecting this property were marked and subsequently located for this survey. A locate request was sent to Digger's Hotline per Digger's Hotline One—Call ticket number 20204702179, 20204702185, 20204702220, 20204702225, 20204702233, 20204702252, 20204702257, 20204702274, 20204702301, 20204702311, and 20204702179. Location of buried private utilities are not within the scope of this
- 6. No attempt has been made as a part of this survey to obtain or show data concerning condition, or capacity of any utility or municipal/public service facility. For information regarding these utilities contact the appropriate agencies.
- 7. The location of existing underground utilities as shown heron has been determined from the best available information and is given for the convenience of the contractor. The owner and the engineer do not assume responsibility in the event that during construction, utilities other than those shown may be encountered, and that the actual location of those which are shown may be different from the location as shown on the plans.
- 8. The contractor shall keep all streets free and clear of construction related dirt/dust/debris.
- 9. These drawings assume that the contractor will utilize an electronic drawing file and stake all site improvements using coordinates tied into control points, the dimensions indicated on the drawings are for the convenience of the contractor only.
- 10. Prior to the use of these drawings for construction purposes, the user shall verify all dimensions and locations of buildings with the foundation drawings and architectural site plan. If conflicts exist the user of these drawings shall contact the engineer immediately.

TOPOGRAPHIC SYMBOL LEGEND

- EXISTING BOLLARD
- EXISTING PARKING METER

- EXISTING WATER MAIN VALVE
- M EXISTING GAS VALVE
- EXISTING UTILITY POLE
- **E** EXISTING ELECTRIC PEDESTAL
- M EXISTING UNIDENTIFIED MANHOLE
- O EXISTING TRAFFIC SIGNAL
- EXISTING DECIDUOUS TREE

EXISTING SIGN

- EXISTING POST
- EXISTING CURB INLET
- (5) EXISTING STORM MANHOLE
- S EXISTING SANITARY MANHOLE
- EXISTING FIRE HYDRANT

- CEXISTING LIGHT POLE

- T EXISTING TELEPHONE PEDESTAL
- W EXISTING UNIDENTIFIED UTILITY VAULT

TOPOGRAPHIC LINEWORK LEGEND

— FO — FO — EXISTING FIBER OPTIC LINE

— ut — to EXISTING UNDERGROUND TELEPHONE

---- G ---- EXISTING GAS LINE ---- UE ----- EXISTING UNDERGROUND ELECTRIC LINE

--- OHE --- OHE --- EXISTING OVERHEAD ELECTRIC LINE EXISTING 10" SANITARY SEWER LINE

EXISTING 12" SANITARY SEWER LINE

EXISTING 15" SANITARY SEWER LINE

EXISTING 12" STORM SEWER LINE

EXISTING 10" WATER MAIN EXISTING 16" WATER MAIN

① EXISTING TELEPHONE MANHOLE --- EXISTING RAILING/ GUARD RAIL --- * --- * EXISTING CHAIN LINK FENCE ---- EXISTING WOOD FENCE

EXISTING RETAINING WALL EXISTING EDGE OF TREES

EXISTING MAJOR CONTOUR --- 818 --- EXISTING MINOR CONTOUR

TOPOGRAPHIC HATCHING LEGEND



EXISTING CONCRETE PAVEMENT/SIDEWALK

EXISTING ASPHALT PAVEMENT



THE LOCATION OF EXISTING UTILITIES, BOTH UNDERGROUND AND OVERHEAD ARE APPROXIMATE ONLY AND HAVE NOT BEEN INDEPENDENTLY VERIFIED BY THE OWNER OR ITS REPRESENTATIVE. THE CONTRACTOR SHALL BE RESPONSIBLE FOR DETERMINING THE EXACT LOCATION OF ALL EXISTING UTILITIES WHETHER SHOWN ON THESE PLANS OR NOT, BEFORE COMMENCING WORK, AND SHALL BE FULLY RESPONSIBLE FOR ANY AND ALL DAMAGES WHICH MIGHT BE CAUSED BY THE CONTRACTOR'S FAILURE TO EXACTLY LOCATE AND PRESERVE ANY AND ALL UTILITIES.

> CALL DIGGER'S HOTLINE 1-800-242-8511

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ISSUED

PROJECT TITLE West Wilson Street Development

Madison, WI

SHEET TITLE Existing Conditions


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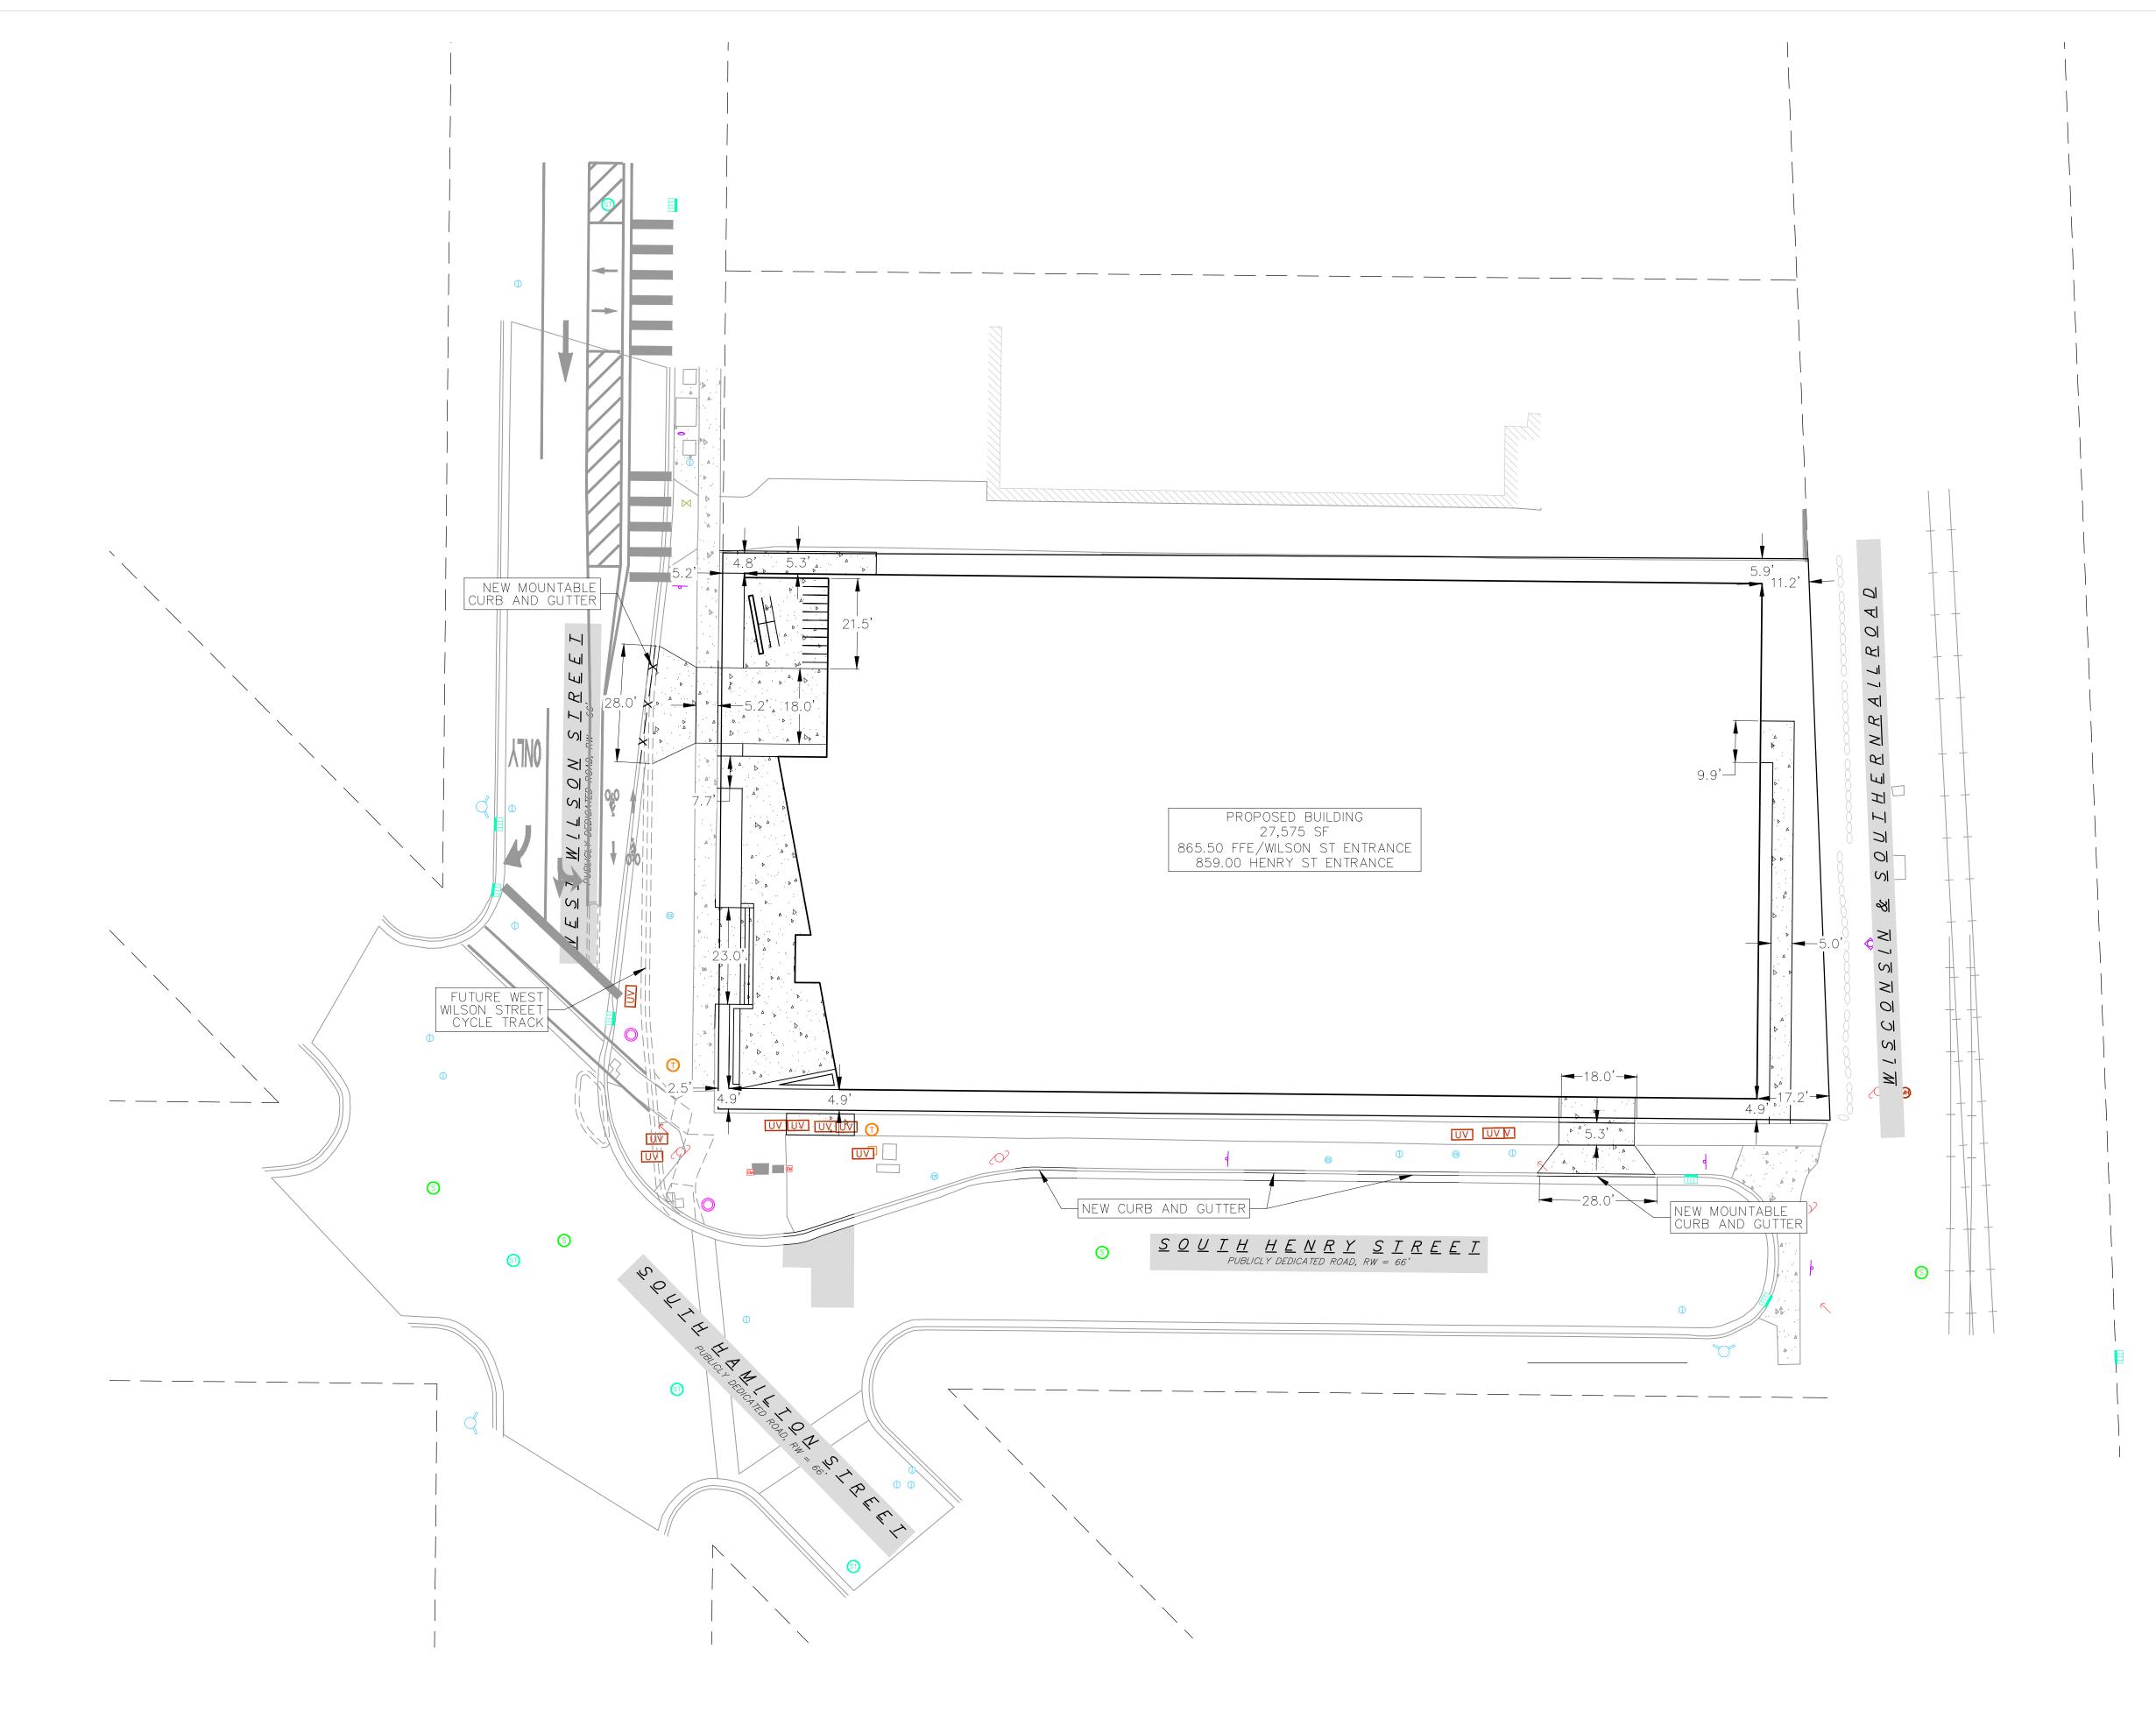
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<u>SITE PLAN LEGEND</u>

CURB AND GUTTER (REVERSE CURB HATCHED)



PROPOSED LIGHT-DUTY ASPHALT

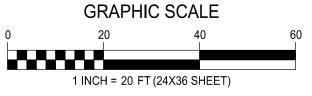

PROPOSED CONCRETE

<u>SITE PLAN NOTES:</u>

- 1. CONCRETE TO BE 5" THICK, CONSTRUCTED ON A BASE OF 4" COMPACTED SAND OR CRUSHED STONE.
- 2. CONCRETE FOR DRIVEWAYS AND SIDEWALK AT DRIVEWAY ENTRANCES SHALL BE 7" THICK, CONSTRUCTED ON A BASE OF 5" COMPACTED SAND OR CRUSHED STONE.
- 3. ALL DIMENSIONS WITH CURB & GUTTER ARE REFERENCED TO THE FACE OF CURB.
- 4. CONTRACTOR SHALL DEEP TILL ANY DISTURBED AREAS AFTER CONSTRUCTION IS COMPLETE AND BEFORE RESTORING.
- 5. CONTRACTOR TO OBTAIN ANY NECESSARY DRIVEWAY CONNECTION, RIGHT OF WAY AND EXCAVATION PERMITS PRIOR TO CONSTRUCTION.
- 6. ALL ABANDONED DRIVEWAYS ADJACENT TO THE SITE SHALL BE REPLACED WITH CURB AND THE TERRACE SHALL BE RESTORED WITH
- 7. ANY SIDEWALK AND CURB & GUTTER ABUTTING THE PROPERTY SHALL BE REPLACED IF IT IS DAMAGED DURING CONSTRUCTION OR IF THE CITY OF MADISON ENGINEERING DEPARTMENT DETERMINES THAT IT IS NOT AT A DESIRABLE GRADE, REGARDLESS OF WHETHER THE CONDITION EXISTED PRIOR TO BEGINNING CONSTRUCTION.



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PROJECT TITLE West Wilson Street Development

Madison, WI SHEET TITLE
Site Plan

SHEET NUMBER


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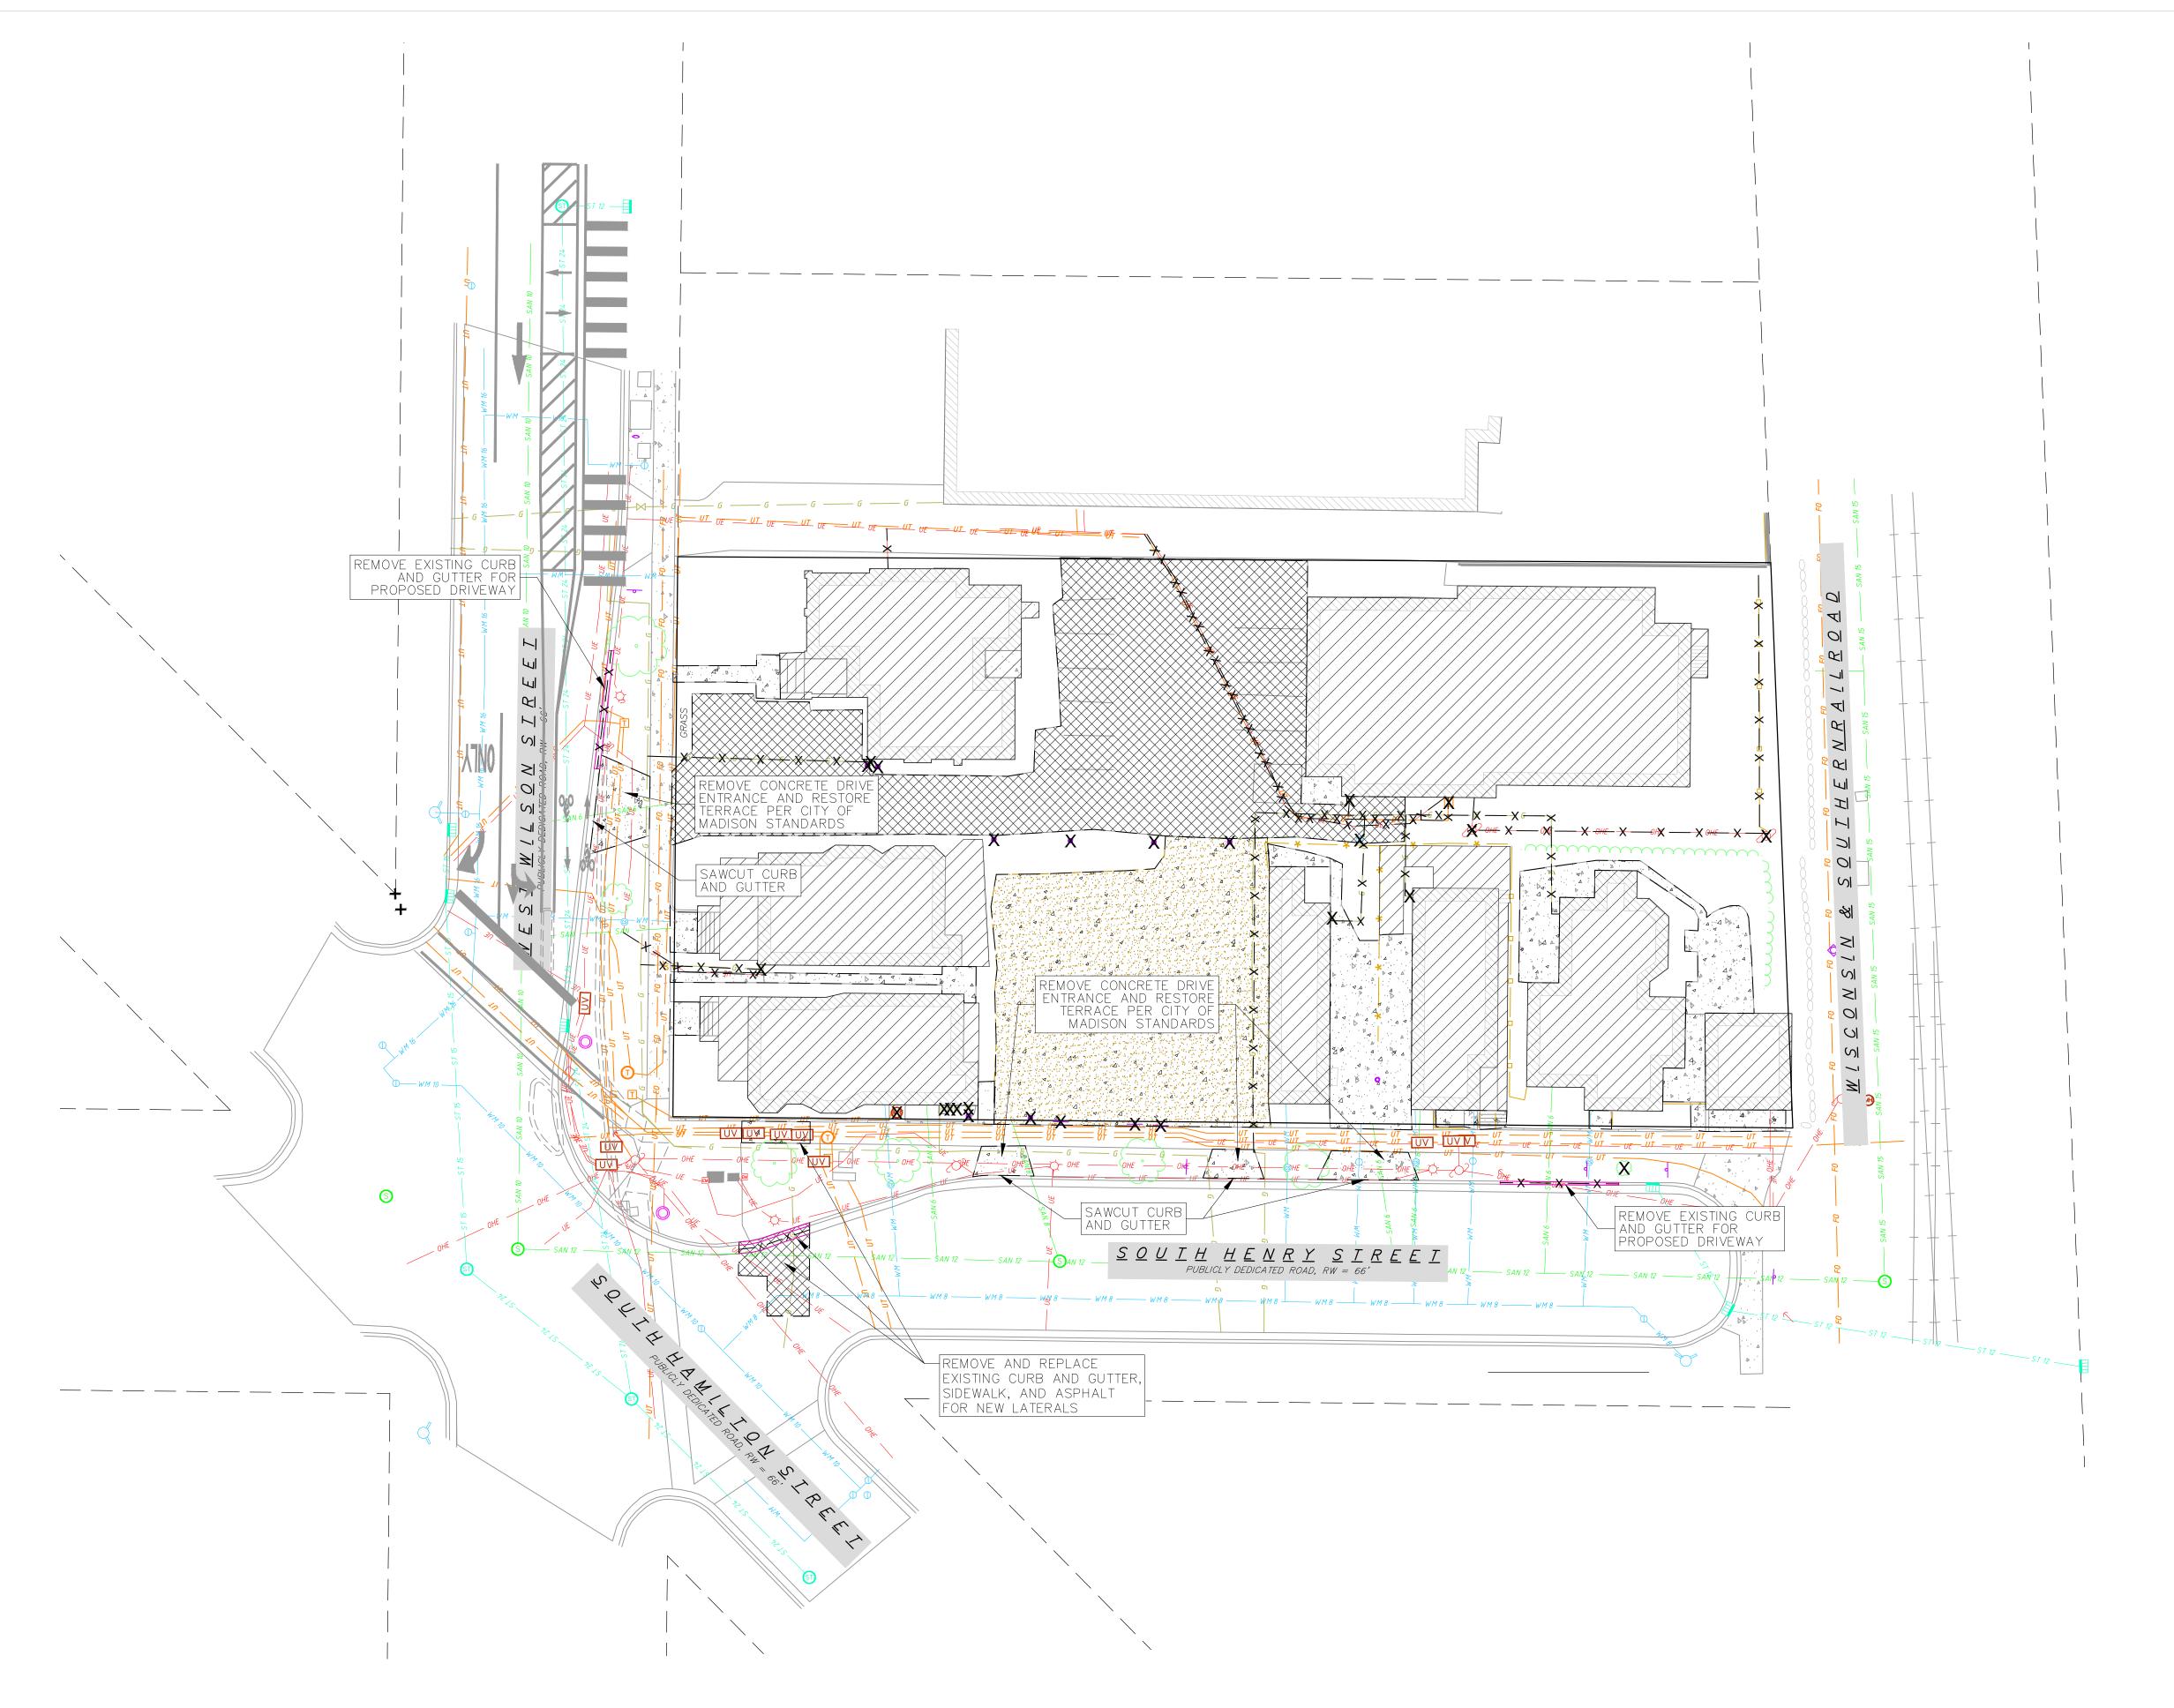
PROJECT NO. 200299


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<u>DEMOLITION NOTES:</u>

- 1. CONTRACTOR SHALL KEEP ALL CITY STREETS FREE AND CLEAR OF CONSTRUCTION RELATED DIRT/DUST/DEBRIS.
- 2. COORDINATE EXISTING UTILITY REMOVAL/ABANDONMENT WITH LOCAL AUTHORITIES AND UTILITY COMPANIES HAVING JURISDICTION.
- 3. ALL SAWCUTTING SHALL BE FULL DEPTH TO PROVIDE A CLEAN EDGE TO MATCH NEW CONSTRUCTION. MATCH EXISTING ELEVATIONS AT POINTS OF CONNECTION FOR NEW AND EXISTING PAVEMENT, CURB, SIDEWALKS, ETC. ALL SAWCUT LOCATIONS SHOWN ARE APPROXIMATE AND MAY BE FIELD ADJUSTED TO ACCOMMODATE CONDITIONS, JOINTS, MATERIAL TYPE, ETC. REMOVE MINIMUM AMOUNT NECESSARY FOR INSTALLATION OF PROPOSED IMPROVEMENTS.
- 4. CONTRACTOR SHALL PROVIDE AND SHALL BE RESPONSIBLE FOR ANY NECESSARY TRAFFIC CONTROL SIGNAGE AND SAFETY MEASURES DURING DEMOLITION AND CONSTRUCTION OPERATIONS WITHIN OR NEAR THE PUBLIC ROADWAY.
- 5. COORDINATE TREE REMOVAL WITH LANDSCAPE ARCHITECT. ALL TREES TO BE REMOVED SHALL BE REMOVED IN THEIR ENTIRETY AND STUMPS SHALL BE GROUND TO 12" BELOW PROPOSED SUBGRADE.
- 6. IF APPLICABLE, PROVIDE TREE PROTECTION FENCING PRIOR TO CONSTRUCTION OPERATIONS. MAINTAIN THROUGHOUT CONSTRUCTION.
- 7. ALL LIGHT POLES TO BE REMOVED FROM PRIVATE PROPERTY SHALL BE REMOVED IN THEIR ENTIRETY, INCLUDING BASE AND ALL APPURTENANCES. COORDINATE ABANDONMENT OF ELECTRICAL LINES WITH ELECTRICAL ENGINEER AND OWNER PRIOR TO DEMOLITION.
- 8. CONTRACTOR SHALL CLOSE ALL ABANDONED DRIVEWAYS BY REPLACING THE CURB IN FRONT OF THE DRIVEWAYS AND RESTORING THE TERRACE WITH GRASS.
- 9. CONTRACTOR SHALL OBTAIN ANY NECESSARY DEMOLITION AND UTILITY PLUGGING PERMITS.
- 10. ANY DAMAGE TO THE CITY PAVEMENT, INCLUDING DAMAGE RESULTING FROM CURB REPLACEMENT, WILL REQUIRE RESTORATION IN ACCORDANCE WITH THE CITY ENGINEERING PATCHING CRITERIA.



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West Wilson
Street
Development

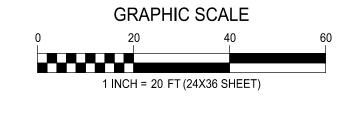Madison, WI
SHEET TITLE

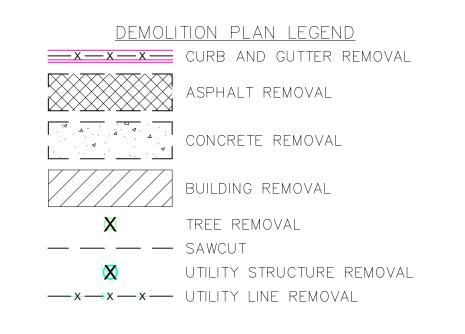Demolition Plan

SHEET NUMBER


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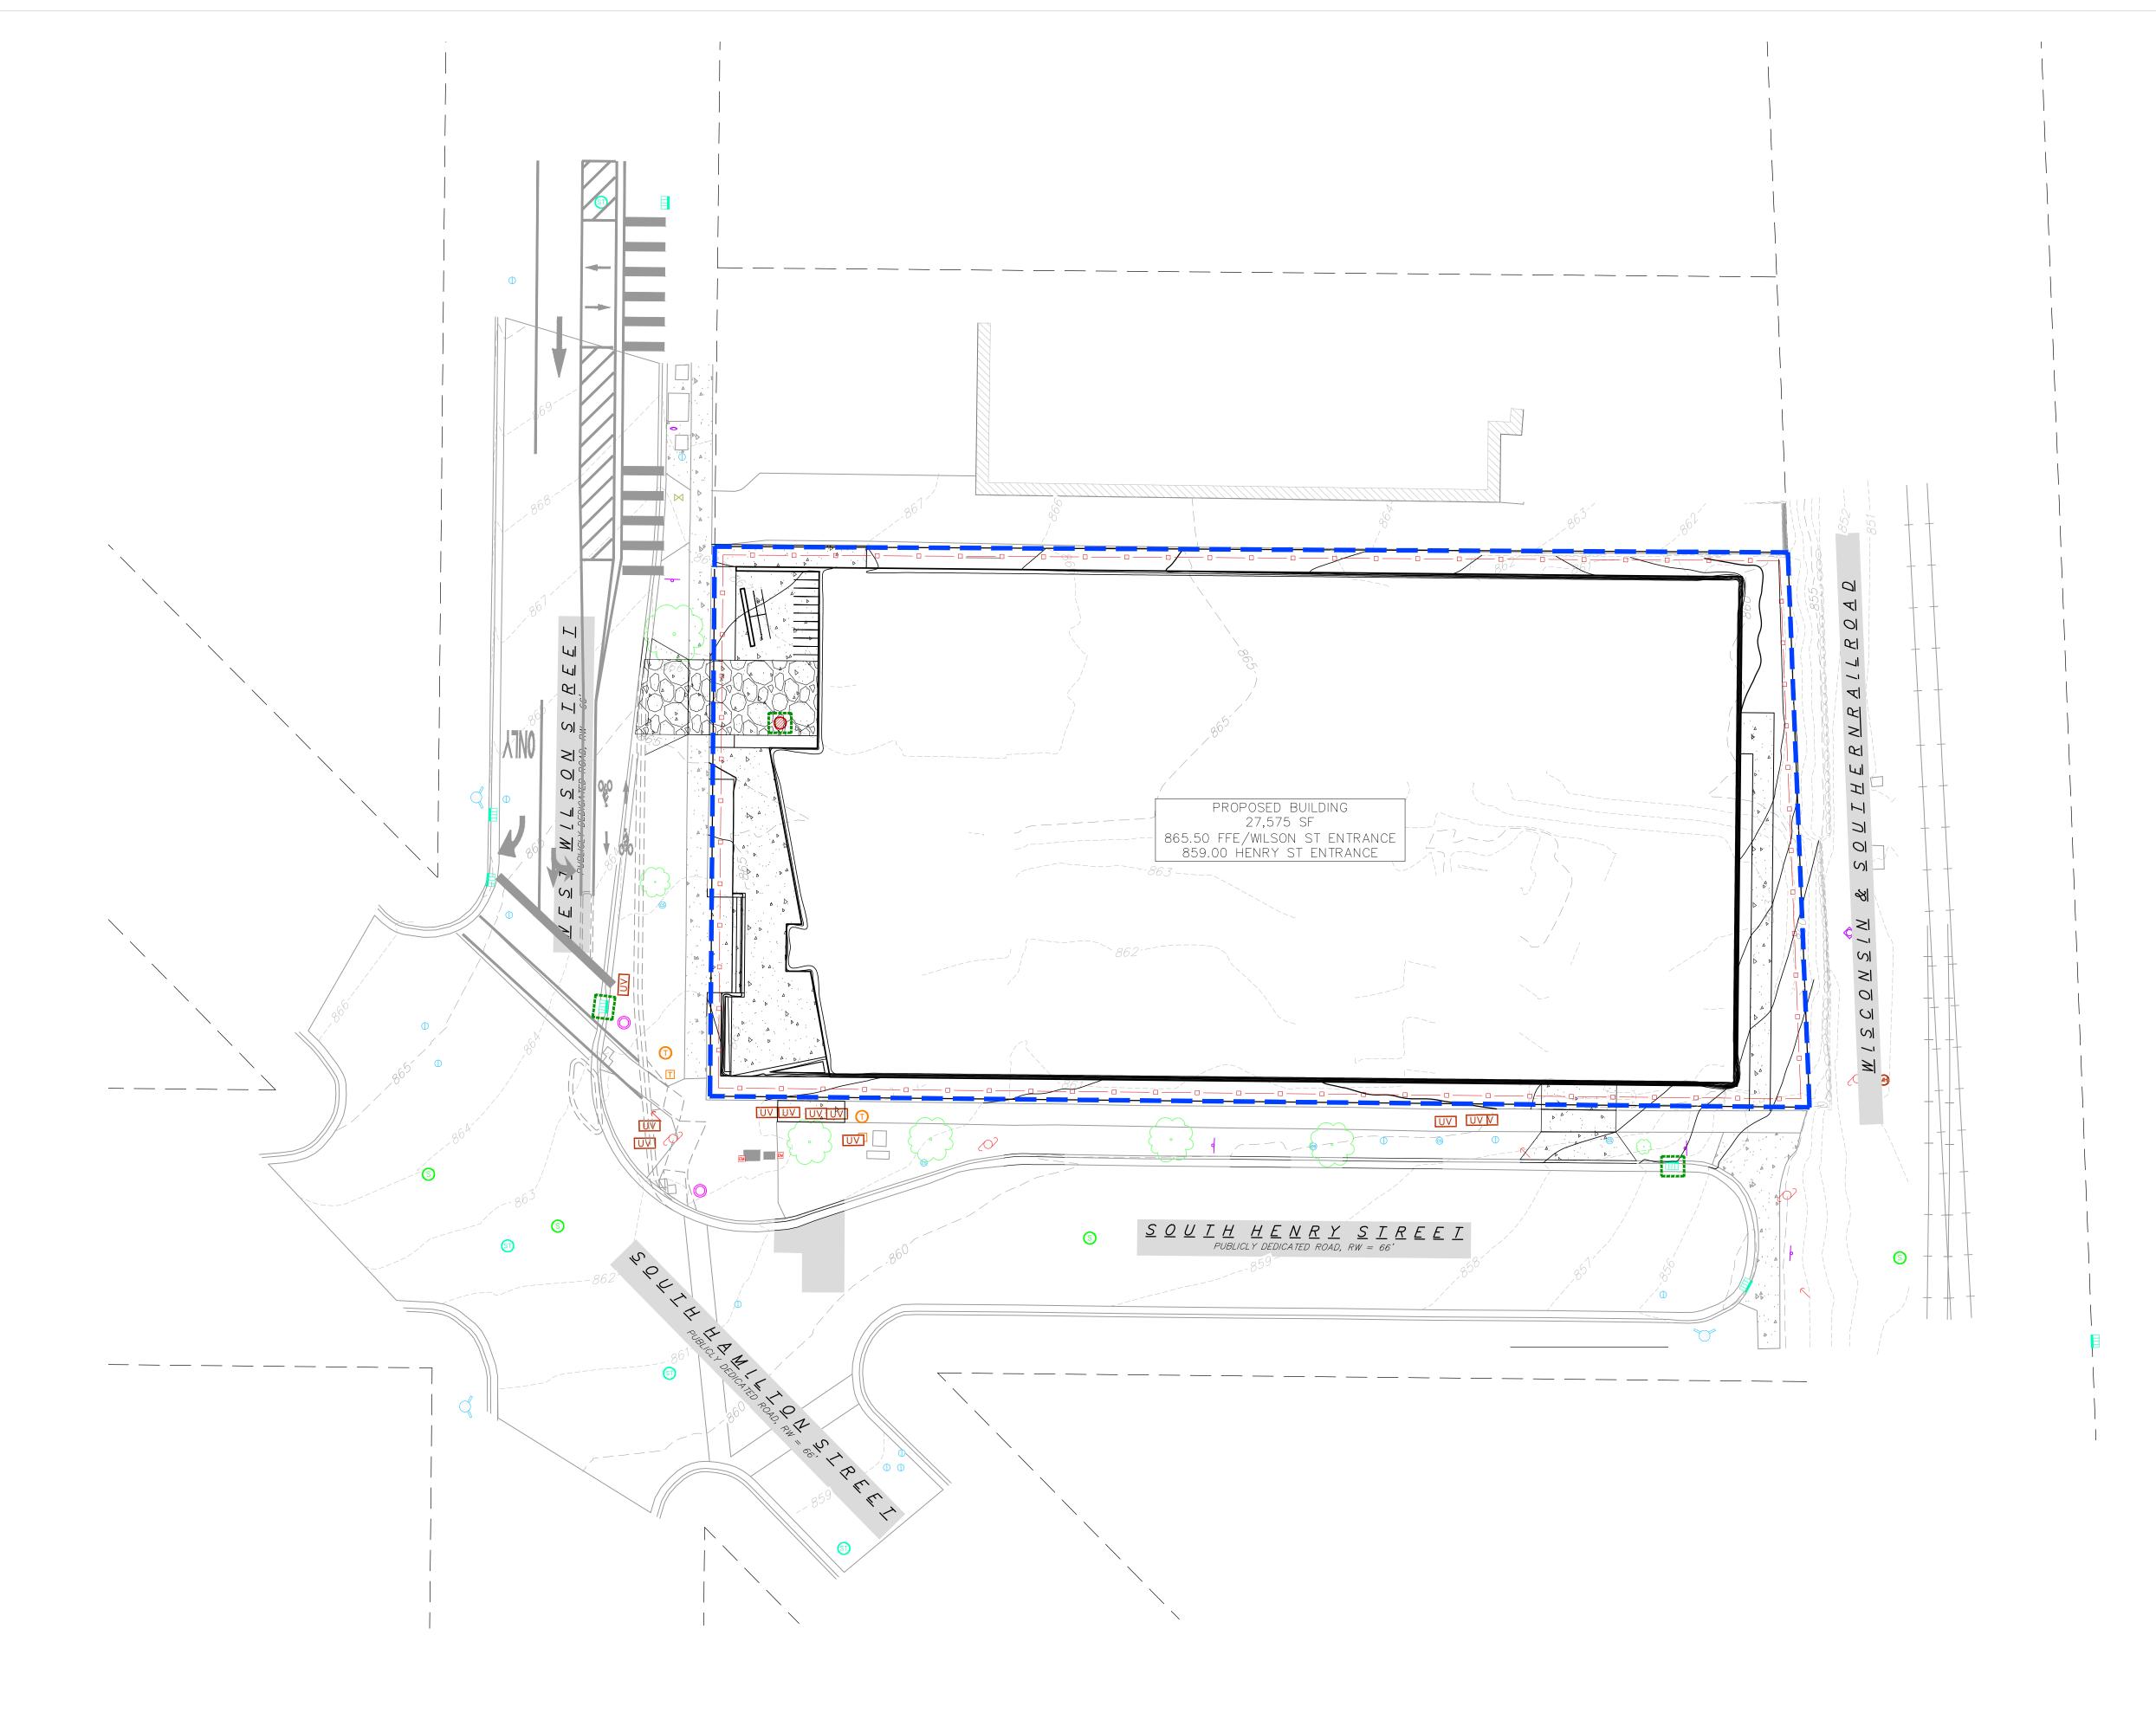
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EROSION CONTROL LEGEND

DISTURBED LIMITS

INLET PROTECTION



GENERAL NOTES:

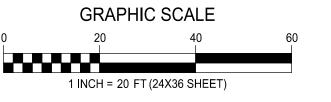- 1. CONTRACTOR SHALL KEEP ALL CITY STREETS FREE AND CLEAR OF CONSTRUCTION RELATED DIRT/DUST/DEBRIS.
- 2. CONTRACTOR SHALL PROVIDE AND SHALL BE RESPONSIBLE FOR ANY NECESSARY TRAFFIC CONTROL SIGNAGE AND SAFETY MEASURES DURING DEMOLITION AND CONSTRUCTION OPERATIONS WITHIN OR NEAR THE PUBLIC ROADWAY.
- IF APPLICABLE, PROVIDE TREE PROTECTION FENCING PRIOR TO CONSTRUCTION OPERATIONS. MAINTAIN THROUGHOUT CONSTRUCTION.



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ISSUED

PROJECT TITLE West Wilson Street Development

Madison, WI SHEET TITLE **Erosion Control** Plan

SHEET NUMBER


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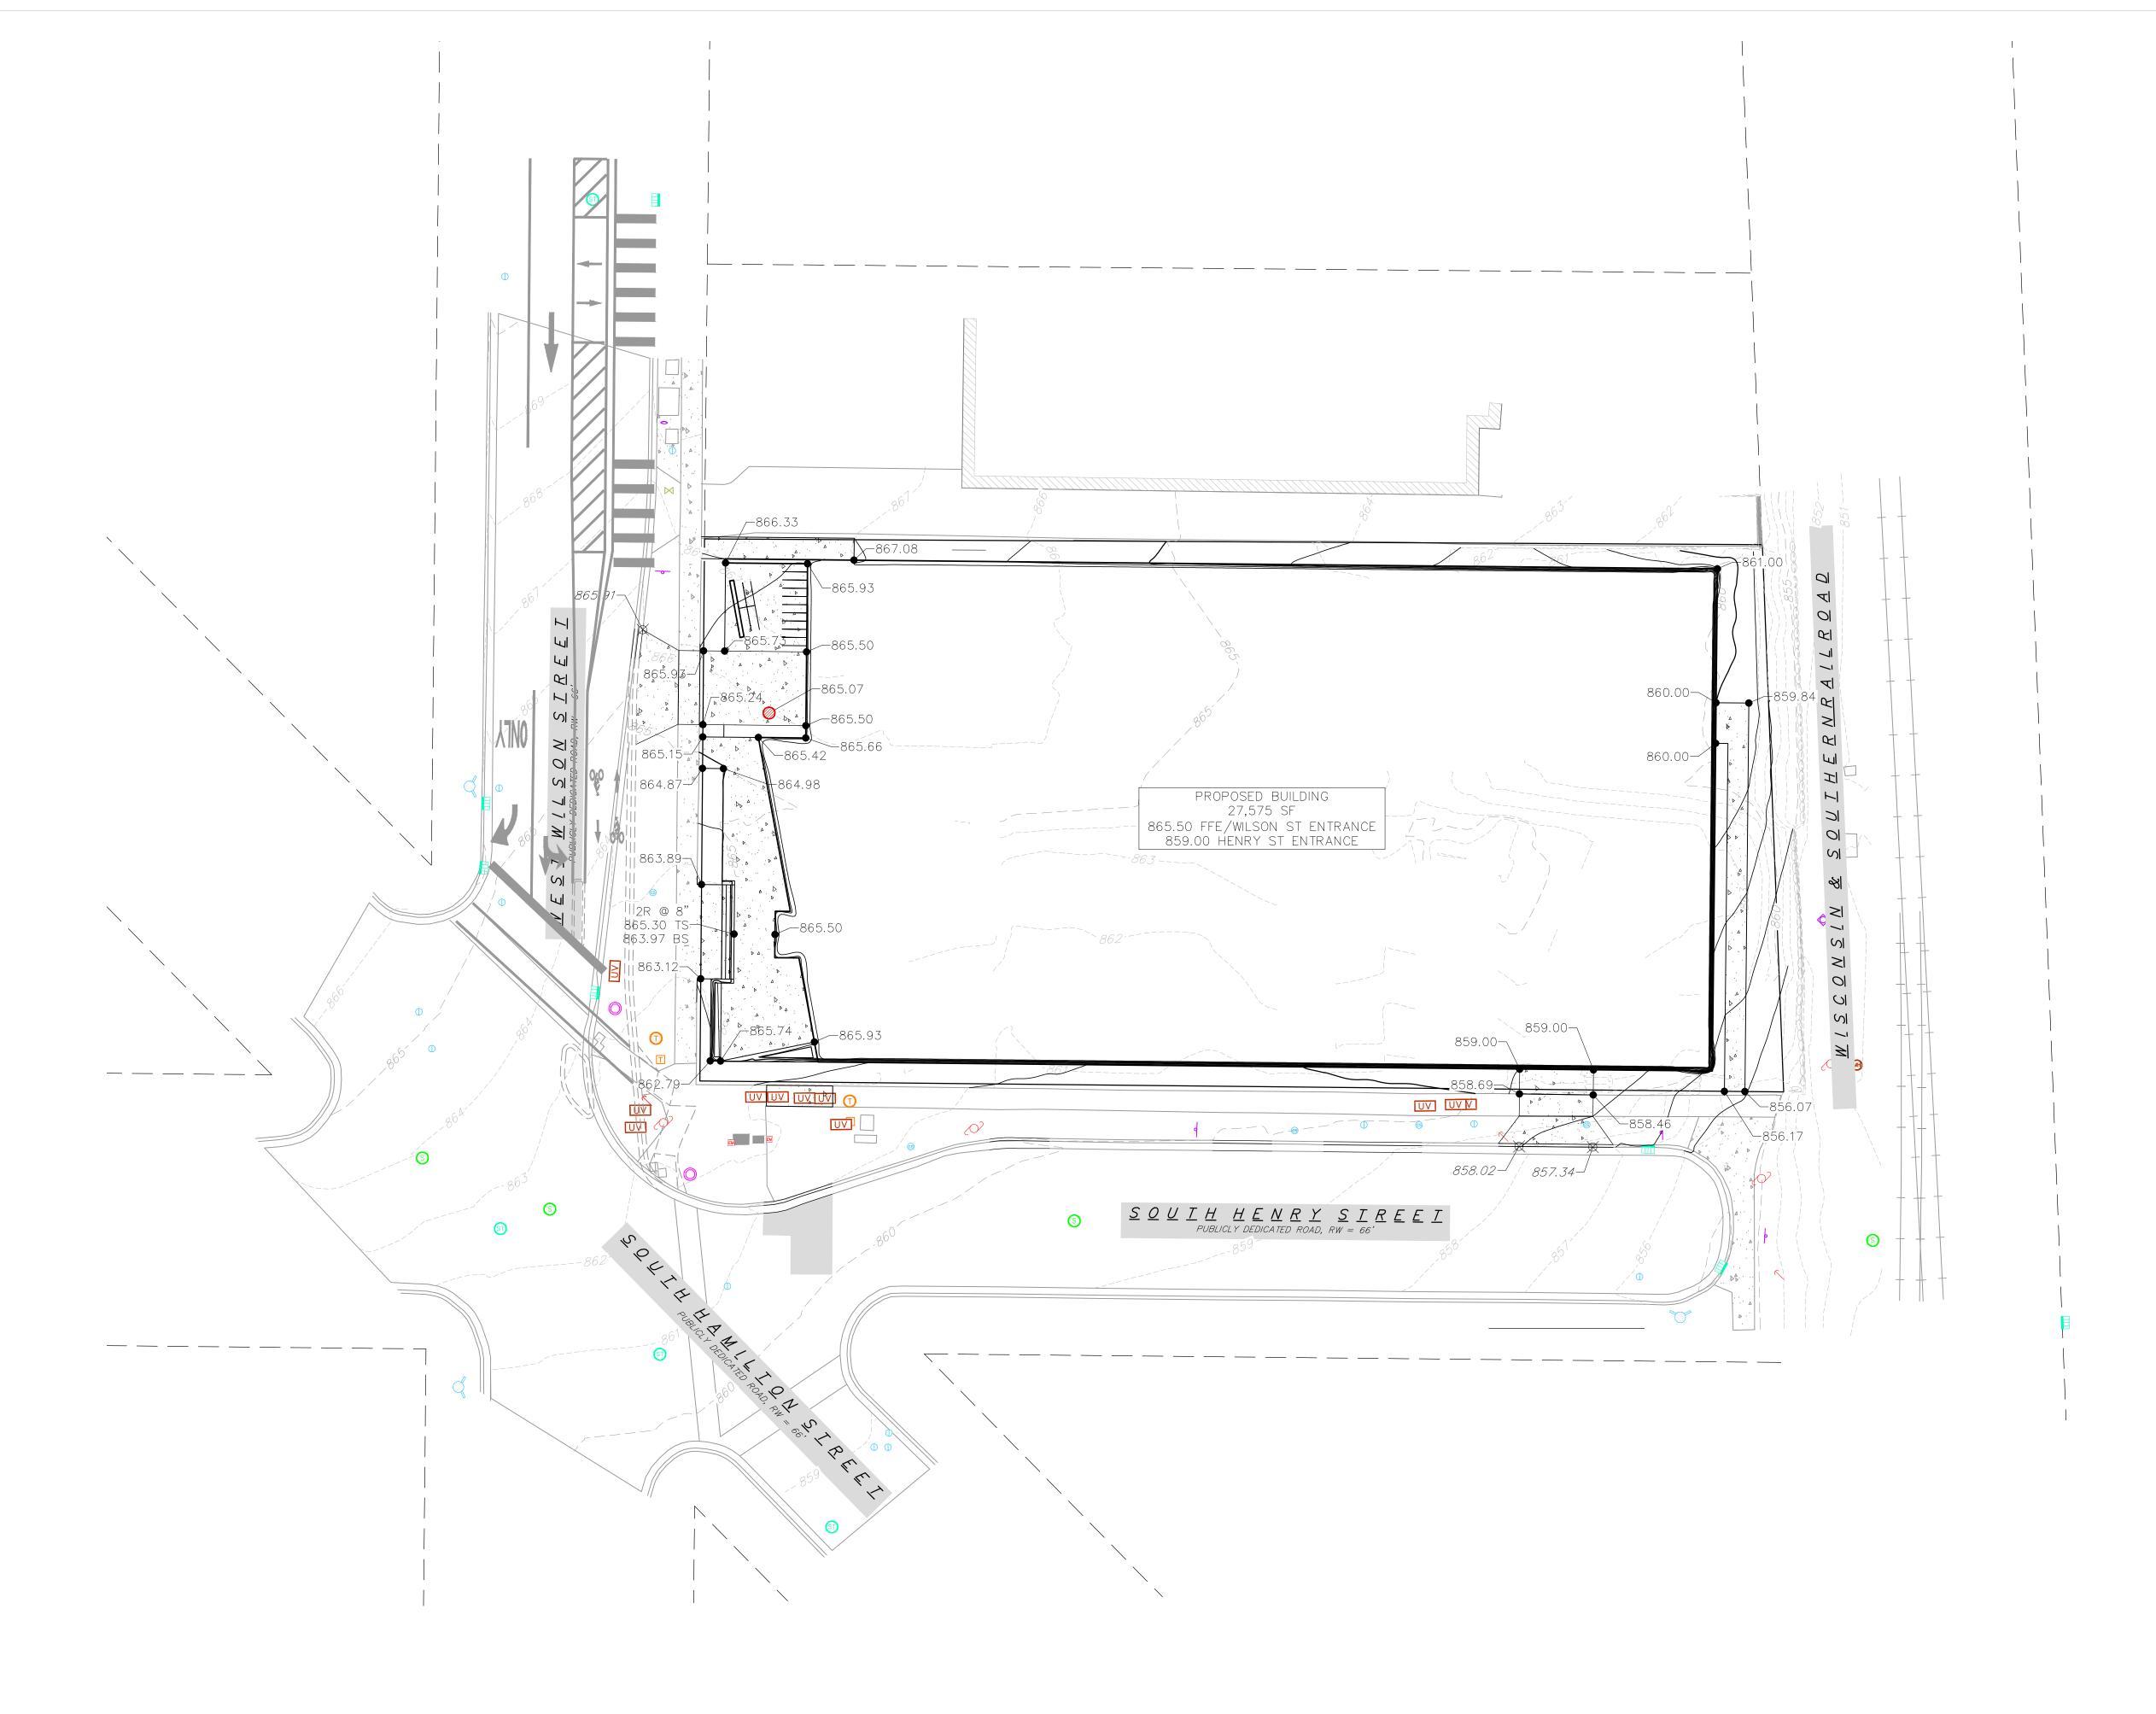
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West Wilson
Street
Development

Madison, WI
SHEET TITLE
Grading Plan

SHEET NUMBER


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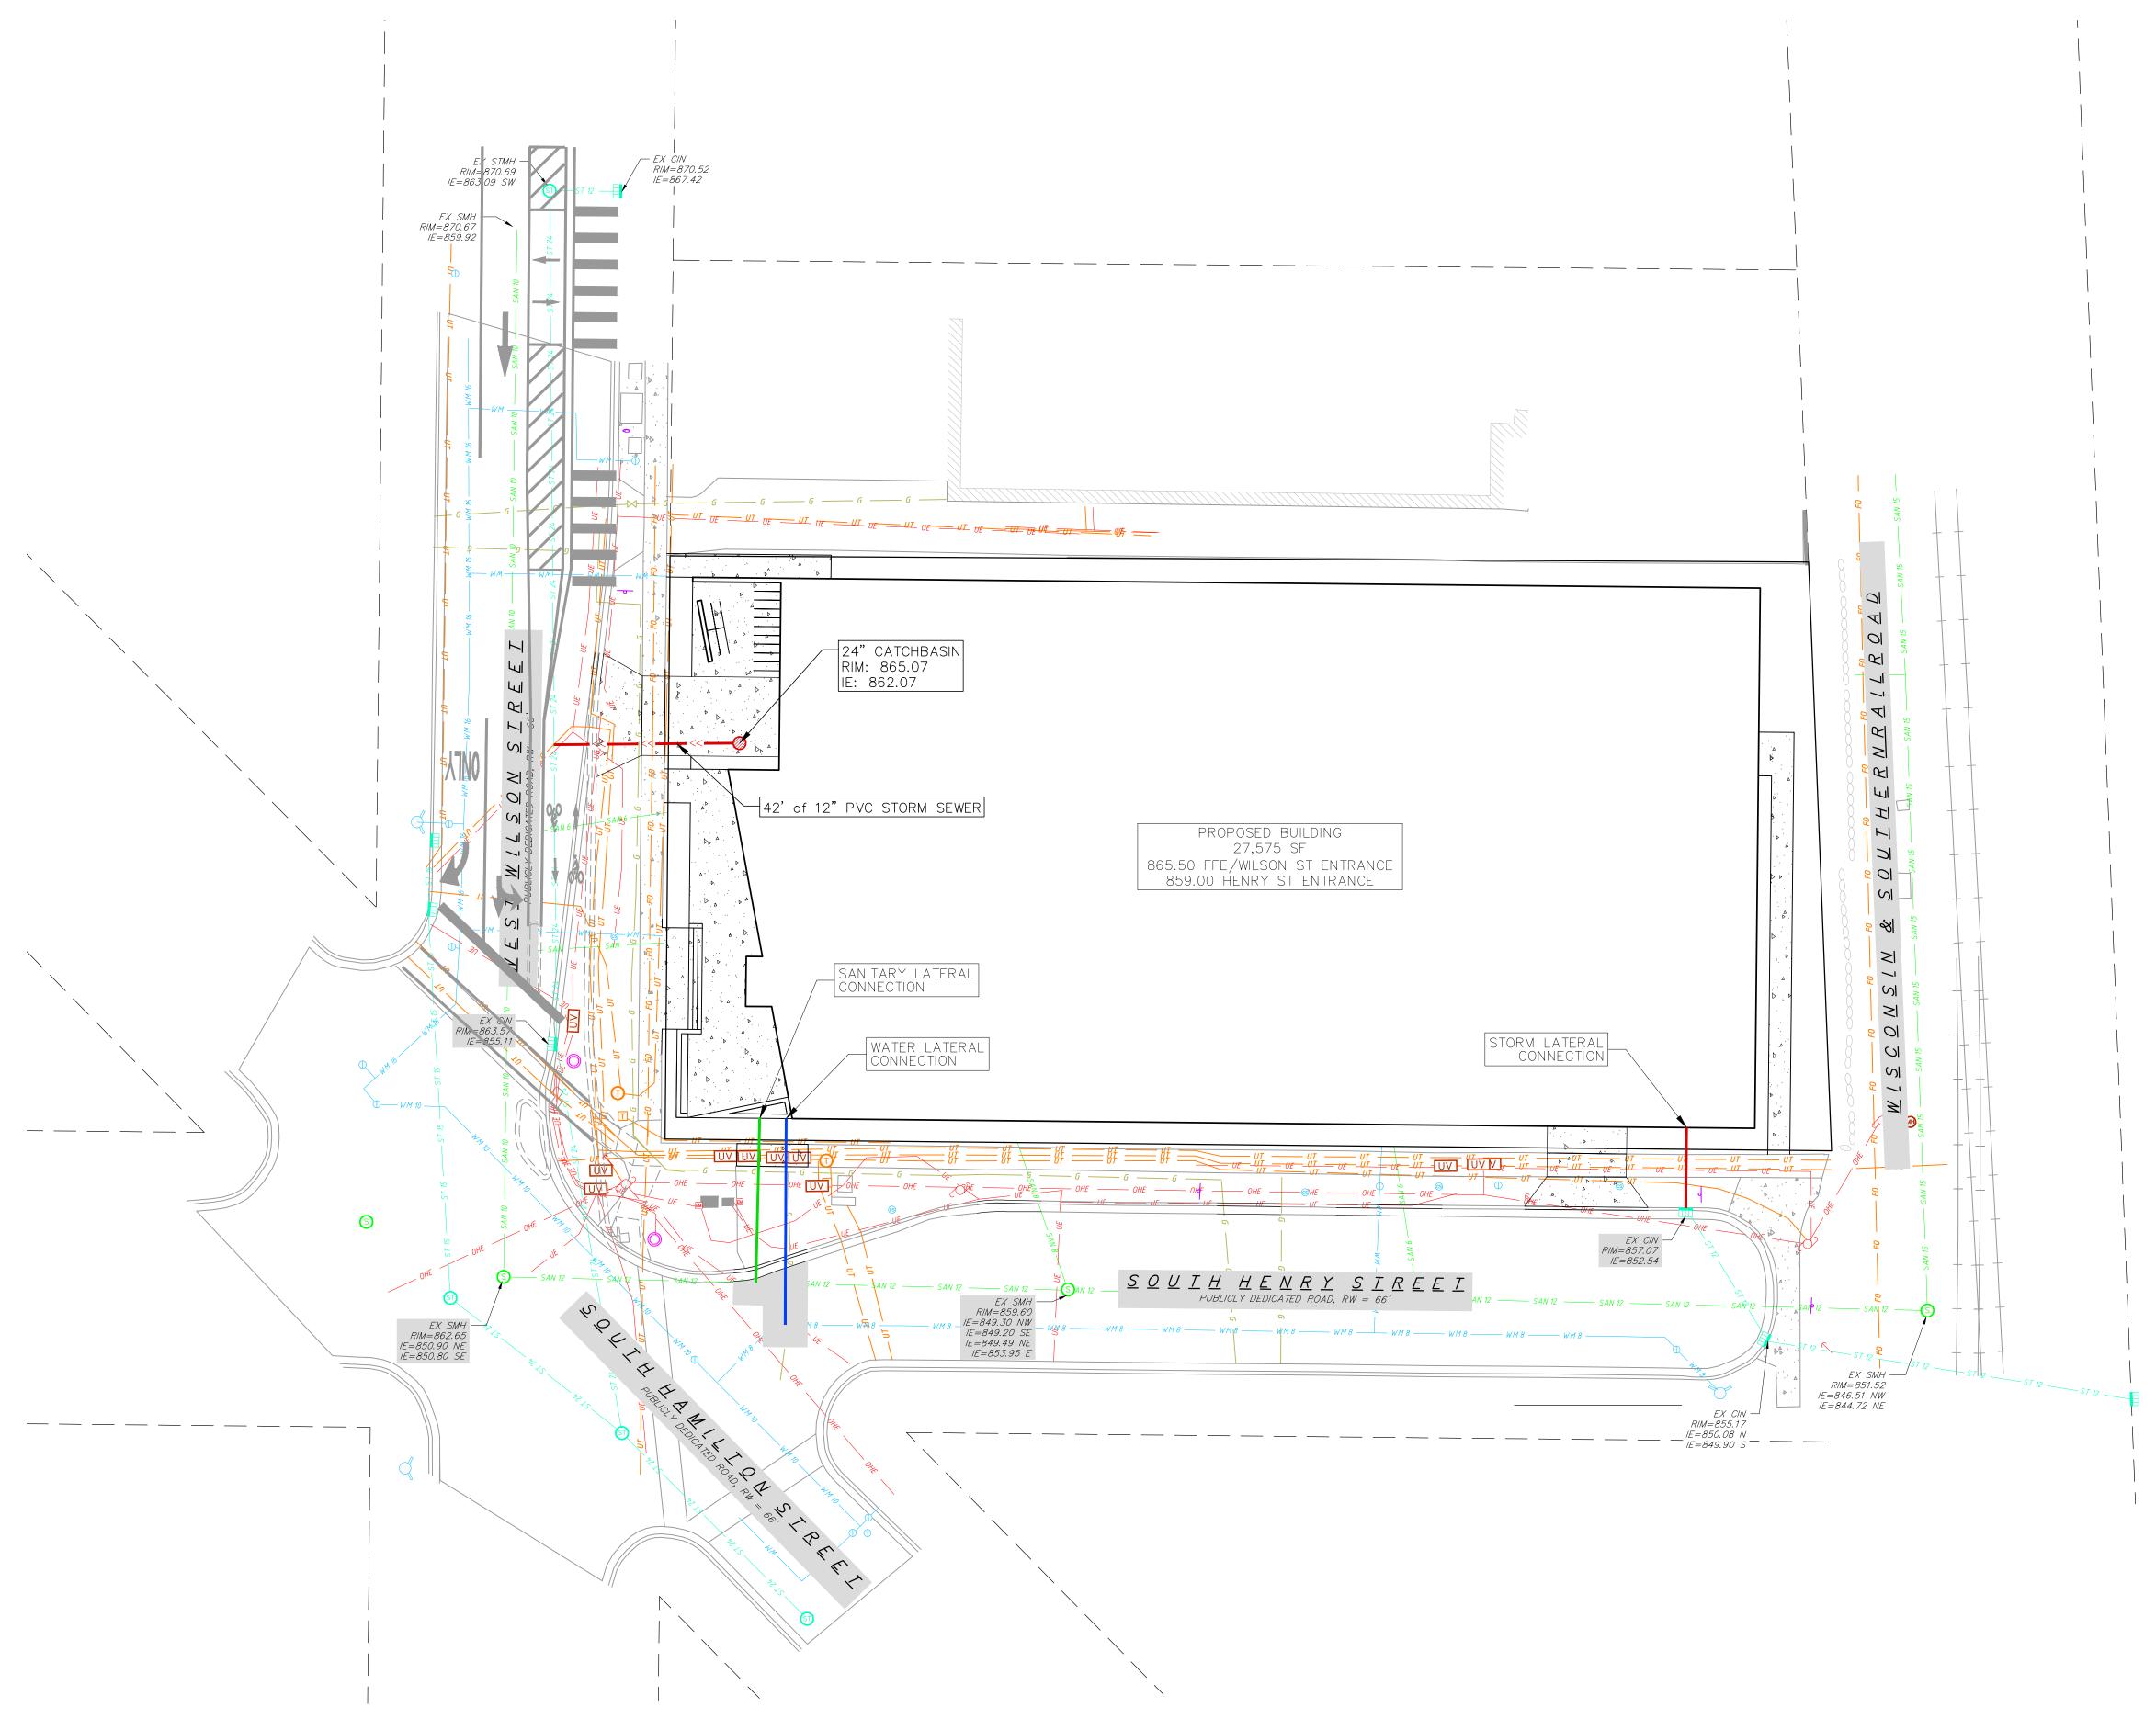
PROJECT NO. 200299

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----- Water service lateral pipe

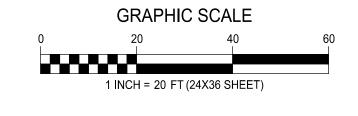UTILITY NOTES:

- 1. CONTRACTOR SHALL INVESTIGATE ALL UTILITY CROSSINGS PRIOR TO CONSTRUCTION AND NOTIFY ENGINEER OF ANY CONFLICTS.
- CONTRACTOR SHALL BE RESPONSIBLE FOR ADJUSTING ALL UTILITY STRUCTURES (MANHOLE RIMS, WATER VALVES, AND CURB STOPS), IF NECESSARY.
- 3. CONTRACTOR SHALL OBTAIN ANY NECESSARY WORK IN RIGHT—OF WAY, EXCAVATION, UTILITY CONNECTION, PLUGGING, ABANDONMENT, AND DRIVEWAY CONNECTION PERMITS PRIOR TO CONSTRUCTION.
- 4. FOR ALL SEWER AND WATER MAIN CROSSINGS: PROVIDE MINIMUM 18" SEPARATION WHEN WATER MAIN CROSSES BELOW SEWER AND MINIMUM 6" SEPARATION WHEN WATER MAIN CROSSES ABOVE SEWER.
- 5. IF DEWATERING OPERATIONS EXCEED 70 GALLONS PER MINUTE OF PUMPING CAPACITY, A DEWATERING WELL PERMIT SHALL BE OBTAINED PRIOR TO STARTING ANY DEWATERING ACTIVITIES.
- 6. A COPY OF THE APPROVED UTILITY PLANS, SPECIFICATIONS AND PLUMBING PERMIT APPROVAL LETTER SHALL BE ON—SITE DURING CONSTRUCTION AND OPEN TO INSPECTION BY AUTHORIZED REPRESENTATIVES OF THE DEPARTMENT OF SAFETY AND PROFESSIONAL SERVICES AND OTHER LOCAL INSPECTORS.
- 7. PRIVATE WATER SERVICES AND PRIVATE WATER MAINS SHALL CONFORM TO ONE OF THE STANDARDS LISTED IN TABLE 384.30-7 OF SPS 384.30(4)(d).
- 8. PRIVATE SANITARY SEWER AND LATERALS SHALL BE POLYVINYL CHLORIDE (PVC) ASTM D3034 SDR 35 OR APPROVED EQUAL MATERIAL THAT CONFORMS TO ONE OF THE STANDARDS LISTED IN TABLE 384.30—3 OF SPS 384.30(2)(c).
- 9. A MEANS TO LOCATE BURIED UNDERGROUND EXTERIOR NON METALLIC SEWERS/MAINS AND WATER SERVICES/MAINS MUST BE PROVIDED WITH TRACER WIRE OR OTHER METHODS IN ORDER TO BE LOCATED PER SPS 382.10(11)(h) AND SPS 382.40(8)(k).
- 10. EXTERIOR WATER SUPPLY PIPING SETBACKS AND CROSSINGS SHALL BE IN ACCORDANCE WITH SPS 382.40(8)(b.).
- 11. NO PERSON MAY ENGAGE IN PLUMBING WORK IN THE STATE UNLESS LICENSED TO DO SO BY THE DEPARTMENT OF SAFETY AND PROFESSIONAL SERVICES PER S.145.06.
- 12. SITE CONTRACTOR SHALL LEAVE SANITARY AND WATER LATERALS FIVE (5) FEET SHORT (HORIZONTALLY) FROM THE BUILDING. BUILDING PLUMBER SHALL VERIFY SIZE, LOCATION, AND INVERT ELEVATION OF PROPOSED SANITARY AND WATER LATERALS.
- 13. CONTRACTOR SHALL FIELD VERIFY THE SIZE, TYPE, LOCATION, AND ELEVATION OF EXISTING UTILITIES PRIOR TO INSTALLING ANY ON—SITE UTILITIES OR STRUCTURES. CONTACT ENGINEER PRIOR TO INSTALLATION IF DISCREPANCY EXISTS WITHIN THESE PLANS.
- 14. PROPOSED UTILITY SERVICE LINES SHOWN ARE APPROXIMATE.

 COORDINATE THE EXACT LOCATIONS WITH THE PLUMBING DRAWINGS.

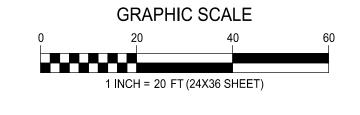 COORDINATE THE LOCATIONS WITH THE PLUMBING CONTRACTOR

 AND/OR OWNER'S CONSTRUCTION REPRESENTATIVE PRIOR TO

 INSTALLATION OF ANY NEW UTILITIES.
- 15. CONTRACTOR SHALL BE RESPONSIBLE FOR COORDINATING THE RELOCATION OF ANY UTILITIES ENCOUNTERED AND REPLACEMENT OF ANY UTILITIES DAMAGED WITHIN INFLUENCE ZONE OF NEW CONSTRUCTION. CONTACT ENGINEER IF THE EXISTING UTILITIES VARY APPRECIABLY FROM THE PLANS.
- 16. ALL WATER MAIN AND SERVICES SHALL BE INSTALLED AT A MINIMUM DEPTH OF 6.5' FROM TOP OF FINISHED GROUND ELEVATION TO TOP OF MAIN.
- 17. IT IS THE CONTRACTOR'S RESPONSIBILITY TO VERIFY THAT THE EXISTING VALVES WILL HOLD THE PRESSURE TEST PRIOR TO CONNECTION. THE CITY IS NOT RESPONSIBLE FOR ANY COSTS INCURRED DUE TO THE CONTRACTOR NOT VERIFYING THAT THE EXISTING VALVE WILL HOLD THE PRESSURE TEST PRIOR TO CONNECTION. IF A NEW VALVE IS REQUIRED, THE APPLICANT WILL BE REQUIRED TO INSTALL ONE AT THEIR EXPENSE, AT THE POINT OF CONNECTION.
- 18. CLEAN OUT ALL EXISTING AND PROPOSED STORM INLETS AND CATCH BASINS AT THE COMPLETION OF CONSTRUCTION.
- 19. THE LOCATION OF EXISTING UTILITIES AS SHOWN ON THE PLANS HAS BEEN DETERMINED FROM THE BEST AVAILABLE INFORMATION AND IS GIVEN FOR THE CONVENIENCE OF THE CONTRACTOR. THE OWNER AND THE ENGINEER DO NOT ASSUME RESPONSIBILITY IN THE EVENT THAT DURING CONSTRUCTION, UTILITIES OTHER THAN THOSE SHOWN MAY BE ENCOUNTERED, AND THAT THE ACTUAL LOCATION OF THOSE WHICH ARE SHOWN MAY BE DIFFERENT FROM THE LOCATION AS SHOWN ON THE PLANS. CONTRACTOR SHALL BE RESPONSIBLE FOR CONTACTING DIGGERS HOTLINE AND LOCATING ALL EXISTING UTILITIES AND ENSURING PROPER CLEARANCE OF NEW UTILITIES.
- 20. THE RIGHT-OF-WAY IS THE SOLE JURISDICTION OF THE CITY OF MADISON AND IS SUBJECT CHANGE AT ANY TIME PER THE RECOMMENDATION/PLAN OF TRAFFIC ENGINEERING AND CITY ENGINEERING DEPARTMENTS.



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ISSUED

West Wilson
Street
Development

Madison, WI

Utility Plan

SHEET NUMBER


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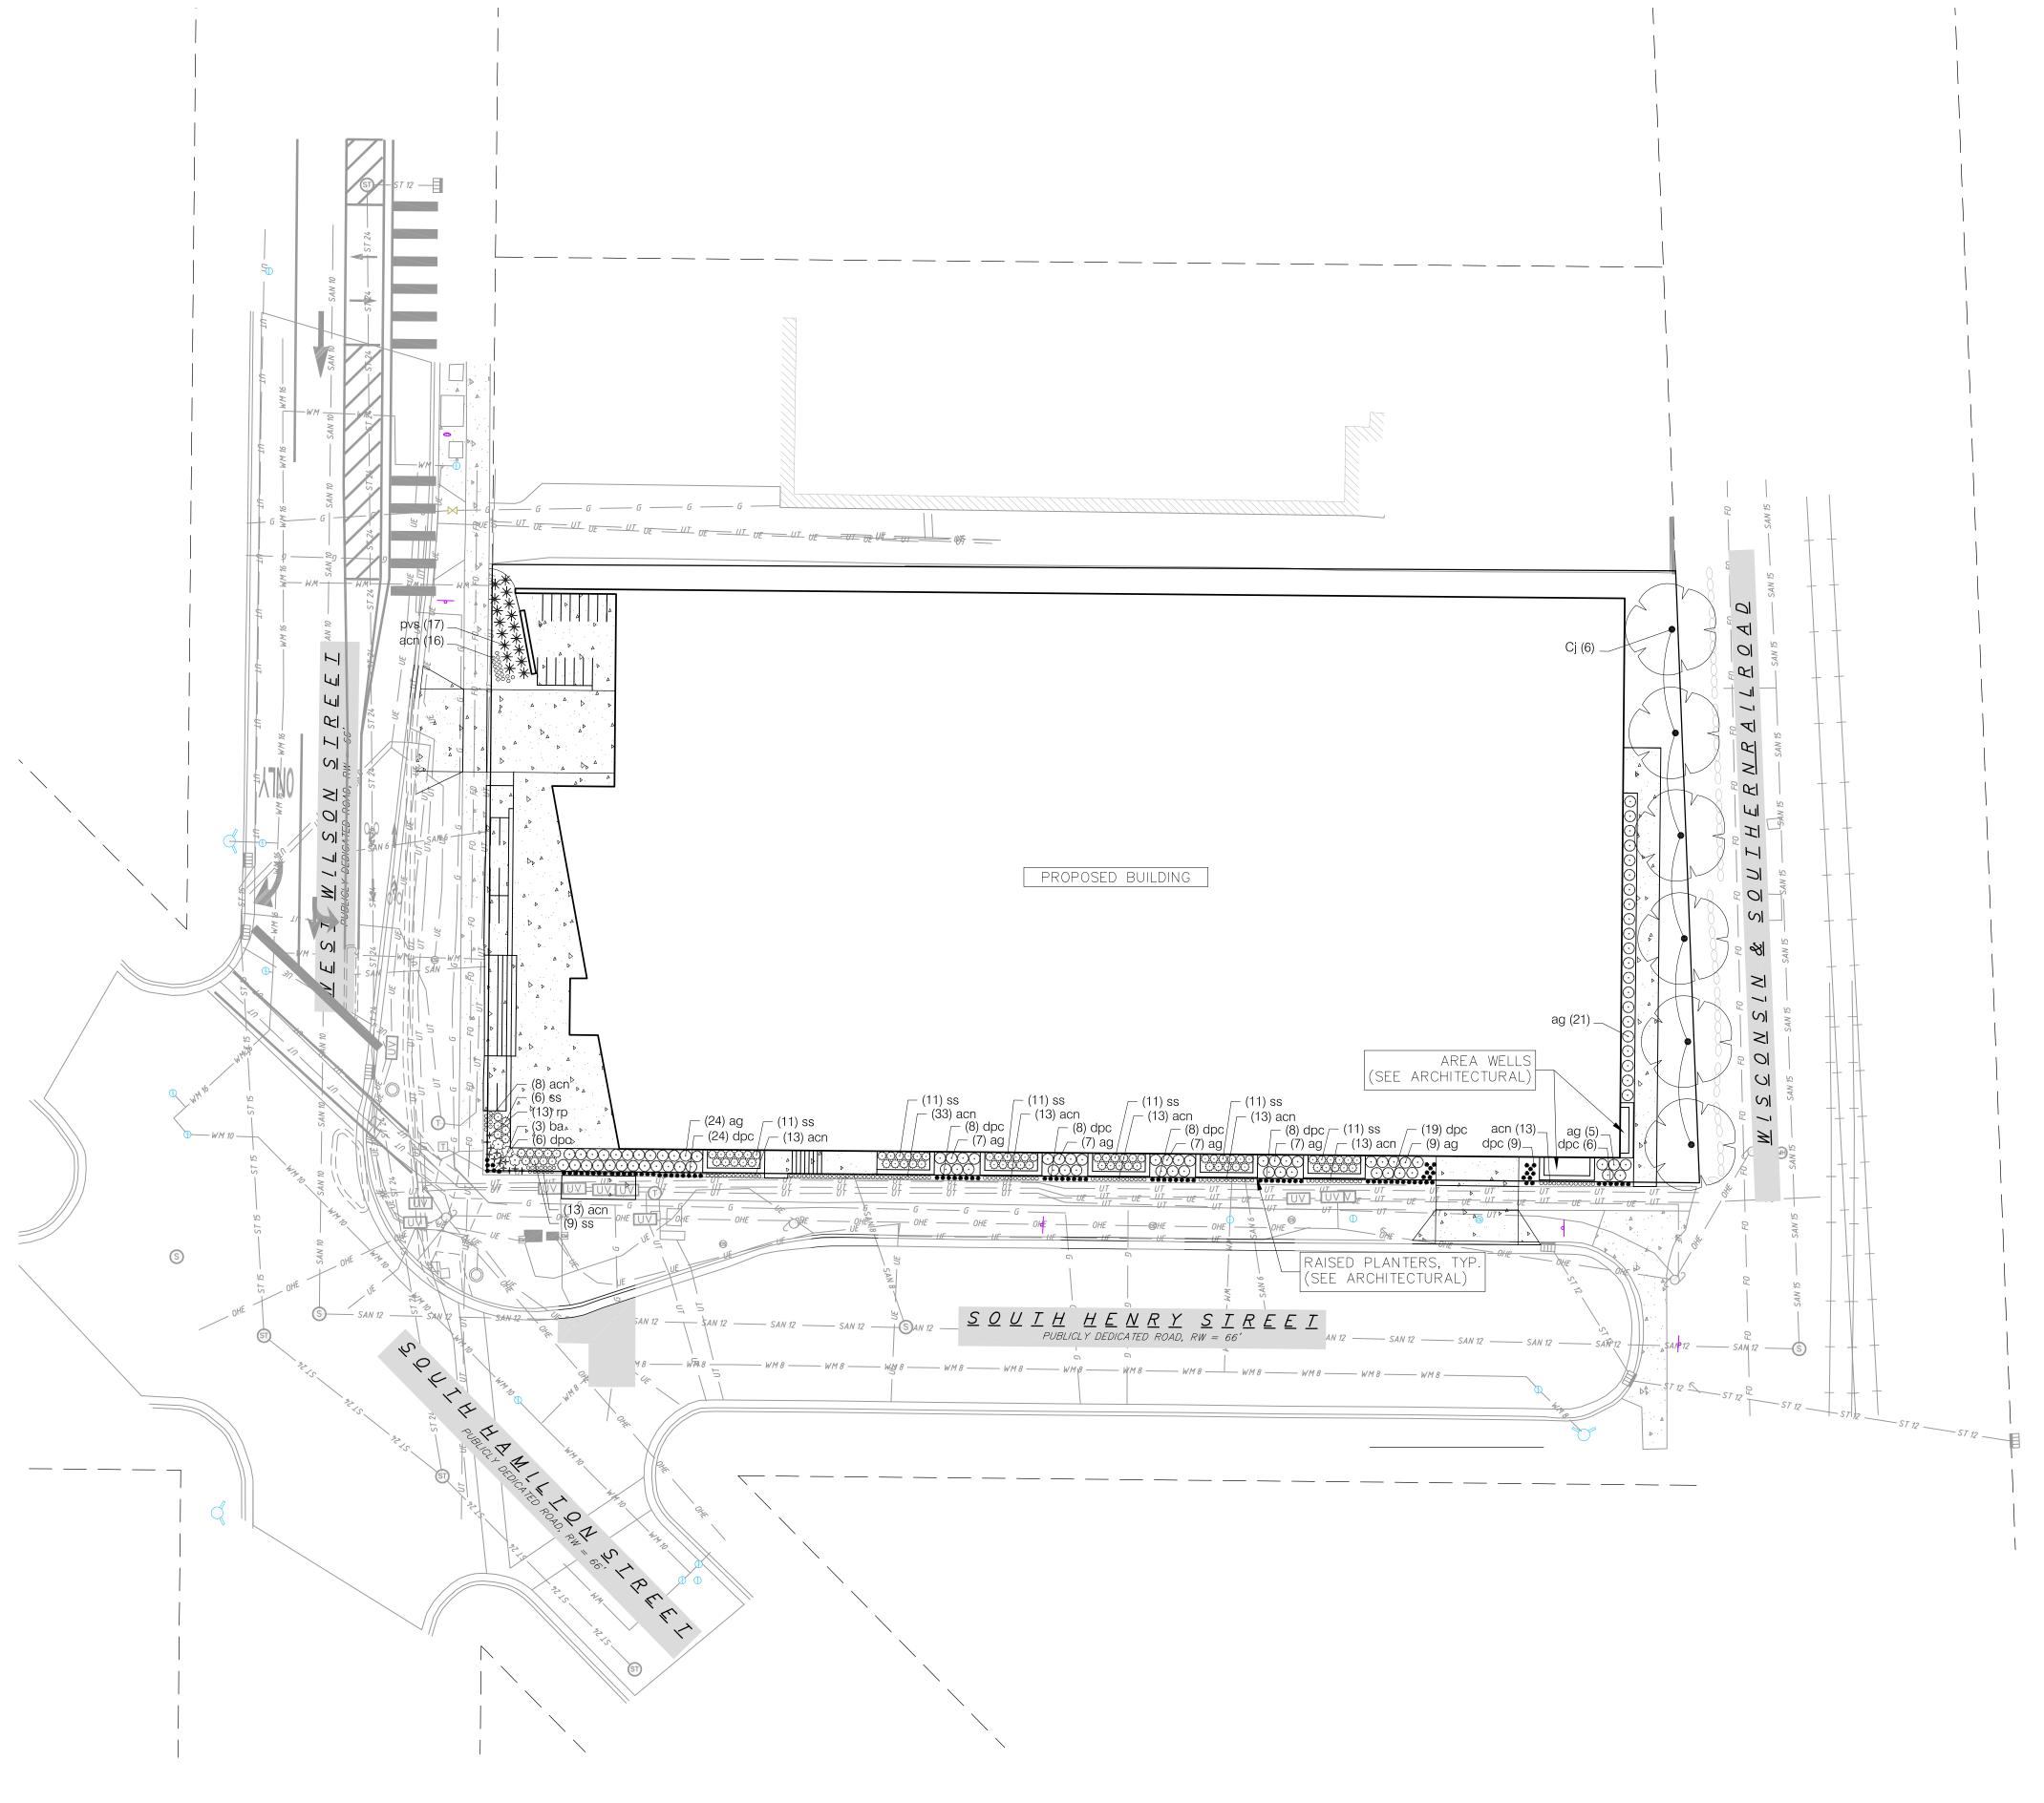
PROJECT NO. 200299
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UTILITY PLAN

1" = 20'-0"








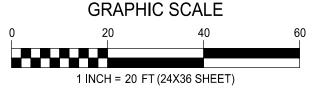



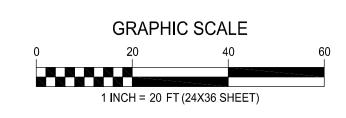

PLANT SCHEDULE

UNDERSTORY TREES Cj	BOTANICAL / COMMON NAME Carpinus caroliniana `J.N. Select A` TM / Fire King American Hornbeam	ROOT COND. B & B	SIZE 2"Cal	(
PERENNIALS	BOTANICAL / COMMON NAME	ROOT COND.	SIZE	(
acn	Allium cernuum / Nodding Onion	Cont.	4 In	-
ag	Andropogon gerardii / Big Bluestem	Cont.	1 Gal.	8
ba	Baptisia australis / Blue Wild Indigo	Cont.	1 Gal.	
dpc	Dalea purpurea / Purple Prairie Clover	Cont.	4 In	9
pvs	Panicum virgatum `Shenandoah` / Shenandoah Red Switch Grass	Cont.	1 Gal.	-
rp	Ratibida pinnata / Yellow Coneflower	Cont.	1 Gal.	-
SS	Schizachyrium scoparium / Little Bluestem Grass	Cont.	1 Gal.	8



City of Madison Lands	 									
Address:	West Wilson Stree	et	Date:	04.30.2021						
Total Square Footage o Area:	of Developed	(Site Area)	34,704	-		ootprint at ade)	27,575	=	7129	sf
Total Landscape Points	s Required (<5 ac):	7,129	/ 300 =	24	x 5 =	119		140		
Lansdcape Poir	nts Requried >5 ac:	0	/ 100 =	0	x 1 =	-	-	119		
				s/ Existing Iscaping	1 -	roposed caping				
Plant Type/ Element	Min. Size at Installation	Points	Quantity	Points Achieved	Quantity	Points Achieved				
Overstory deciduous tree	2.5" cal	35		0		0				
Tall Evergreen Tree	5-6 feet tall	35		0		0				
Ornamental tree	1.5" cal	15		0	6	90				
Upright evergreen shrub	3-4 feet tall	10		0		0				
Shrub, deciduous	#3 gallon container size, Min. 12-24"	3		0		0				
Shrub, evergreen	#3 gallon container size, Min. 12-24"	4		0		0				
Ornamental grasses/perennials	#1 gallon container size, Min. 8-18"	2		0	201	402				
Ornamental/decorative fencing or wall	n/a	4 per 10 LF		0		0				
Existing significant specimen tree	Min. Size 2.5" cal. Trees must be within developed area and cannot comprise more than 30% of total required points.	14 per caliper inch. Max. points per tree: 200		0		0				
Landscape Furniture for public seating and/or transit connections	Furniture must be within developed area, publicly accessible, and cannot comprise more than 5% of total required points	5 points per "seat"		0		0				
Sub Totals				0		492				
			Total Poi	nts Provided:	492					

PLANT MATERIAL NOTES:

1. All plantings shall conform to quality requirements as per ANSI Z60.1.

2. All plant material shall be true to the species, variety and size specified, nursery grown in accordance with good horticultural practices, and under climactic conditions similar to those of the project site.

Contact Landscape Architect, in writing, to request any plant material substitutions due to availability issues.
 All plants shall be guaranteed to be in healthy and flourishing condition during the growing season following installation.
 All plant material shall be guaranteed for one year from the time of installation.

LANDSCAPE MATERIAL NOTES:

1. Contractor shall provide a suitable amended topsoil blend for all planting areas where soil conditions are unsuitable for plant growth. Topsoil shall conform to quality requirements as per Section 625.2(1) of the Standard Specifications for Highway Construction. Provide a minimum of 18" of topsoil in all planting areas and 6" of topsoil in areas to be seeded/sodded.

2. Landscape beds to be mulched with undyed shredded hardwood bark mulch to 3" depth min. and edged with commercial grade aluminum landscape edging, Permaloc CleanLine ³/₁₆" x 4" or equal, color black anodized.
 3. All trees and/or shrubs planted in lawn areas to be installed with a 5' diameter mulch ring and shovel cut edge. A pre-emergent granular herbicide weed-preventer should be mixed with mulch as well as topically applied to tree ring.
 4. All areas noted on plan as Stone to be mulched with 1.5" washed stone to 3" depth over weed barrier fabric. Stone type and color to be approved by owner.

SOD NOTES:

1. All disturbed areas, unless otherwise noted, to be sodded with a premium grade turfgrass sod. Turfgrass sod shall be reasonably free of diseases, nematodes and soil-borne insects. Turfgrass sod shall be free of grassy and broadleaf weeds and weed seed. All soded areas are to be watered daily to maintain adequate soil moisture for proper germination. After vigorous growth is established, apply $\frac{1}{2}$ " water twice weekly until final acceptance.

PROJECT TITLE
West Wilson
Street
Development

ISSUED

Madison, WI

SHEET TITLE

Landscape Plan

SHEET NUMBER

L-1.0

PROJECT NO. 200299

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GREEN ROOF AREAS



ARTIFICIAL TURF DOG RUN

PLUG PLANTING NOTES:


1. Install Green Roof Plug Mix plantings as 2" x 2" x 4" deep plugs, 12" on center in a triangular grid pattern. Plant species in odd numbered groups of 5-9 plants, distributing each species randomly across planting area for natural appearance.

2. Install Green Roof Grasses plantings as 2" x 2" x 4" deep plugs, 18" on center in a triangular grid pattern

LANDSCAPE PLAN - 2ND FLOOR

1,659 sf



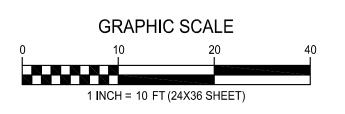





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ISSUE

West Wilson
Street
Development

----Madison, WI

SHEET TITLE


Landscape Plan
2nd Floor

SHEET NUMBER

L-1.1

PROJECT NO. 200299

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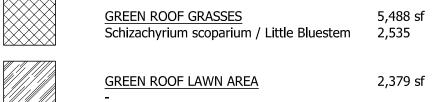


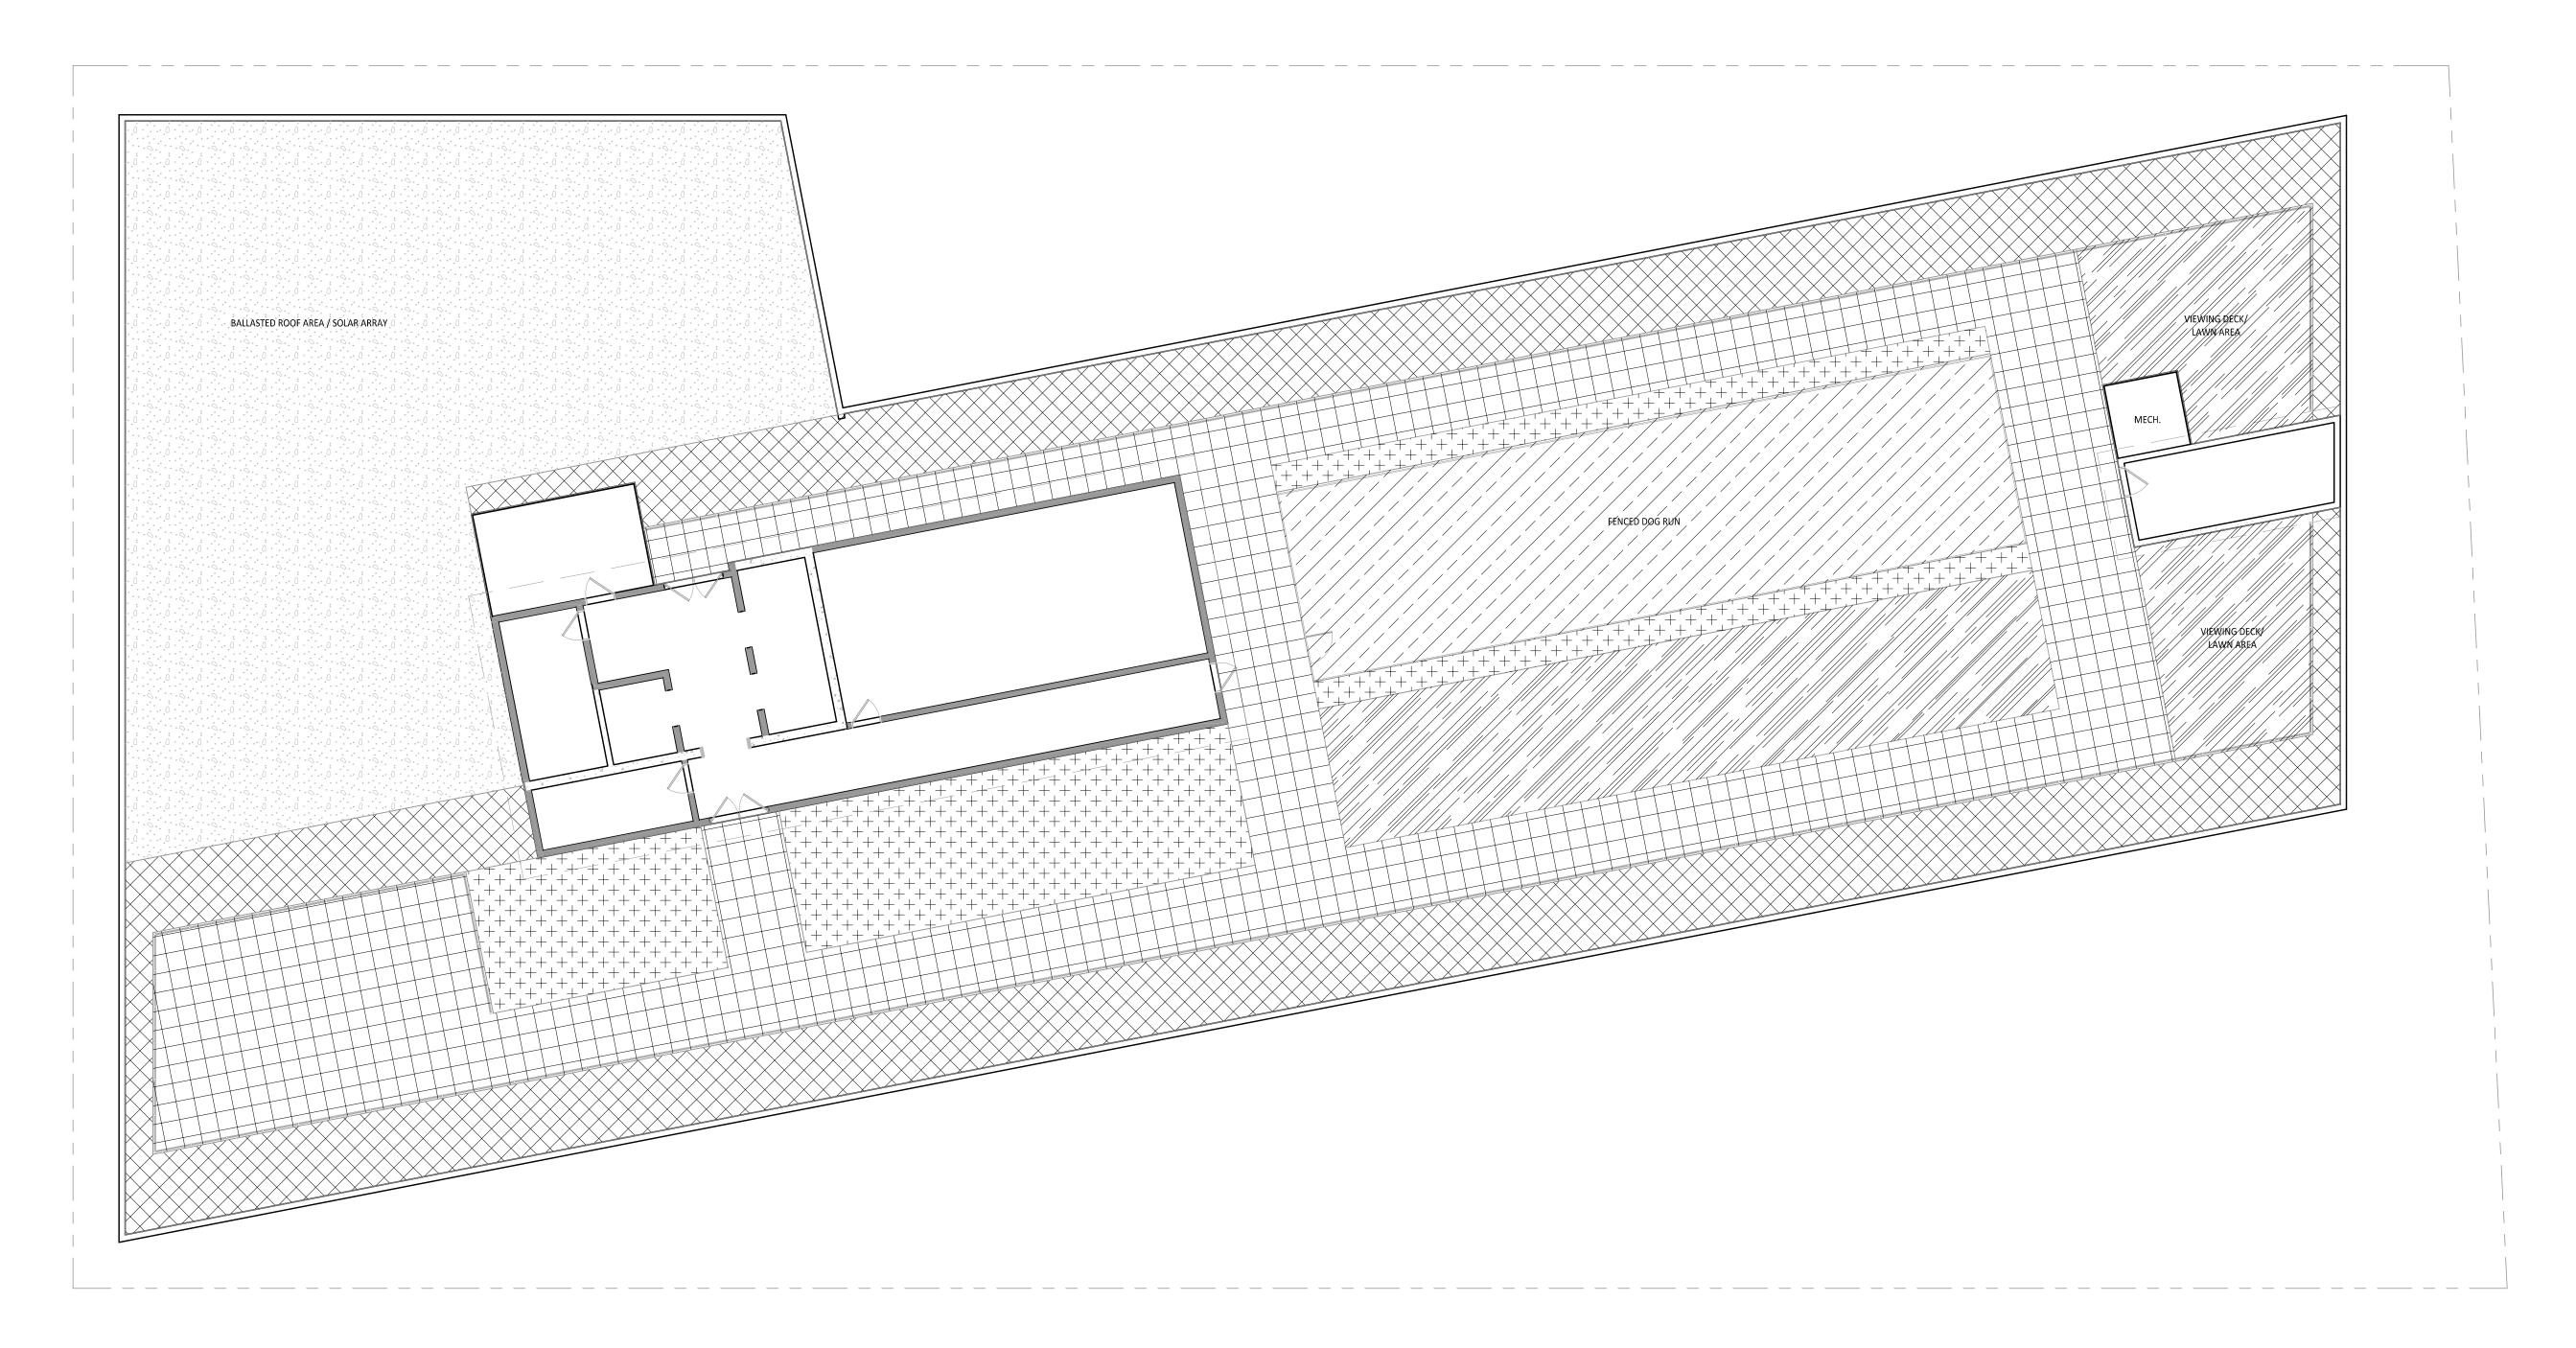GREEN ROOF AREAS




PLUG PLANTING NOTES:

1. Install Green Roof Plug Mix plantings as 2" x 2" x 4" deep plugs, 12" on center in a triangular grid pattern. Plant species in odd numbered groups of 5-9 plants, distributing each species randomly across planting area for natural appearance. 2. Install Green Roof Grasses plantings as 2" x 2" x 4" deep plugs, 18" on center in a triangular grid pattern






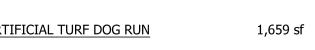





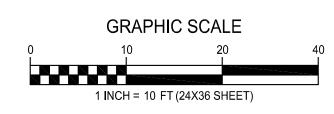





PROJECT TITLE West Wilson Street Development

Madison, WI

SHEET TITLE Landscape Plan -Rooftop

SHEET NUMBER

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KEY PLAN

ISSUED Issued for LU - March 03, 2021

Re-Issued for LU - May 03, 2021

PROJECT TITLE
WEST WILSON ST


DEVELOPMENT

145-151 W WILSON ST.
309-321 S HENRY ST.
MADISON, WI


SHEET TITLE
LOWER PARKING
LEVEL 03

SHEET NUMBER

A001

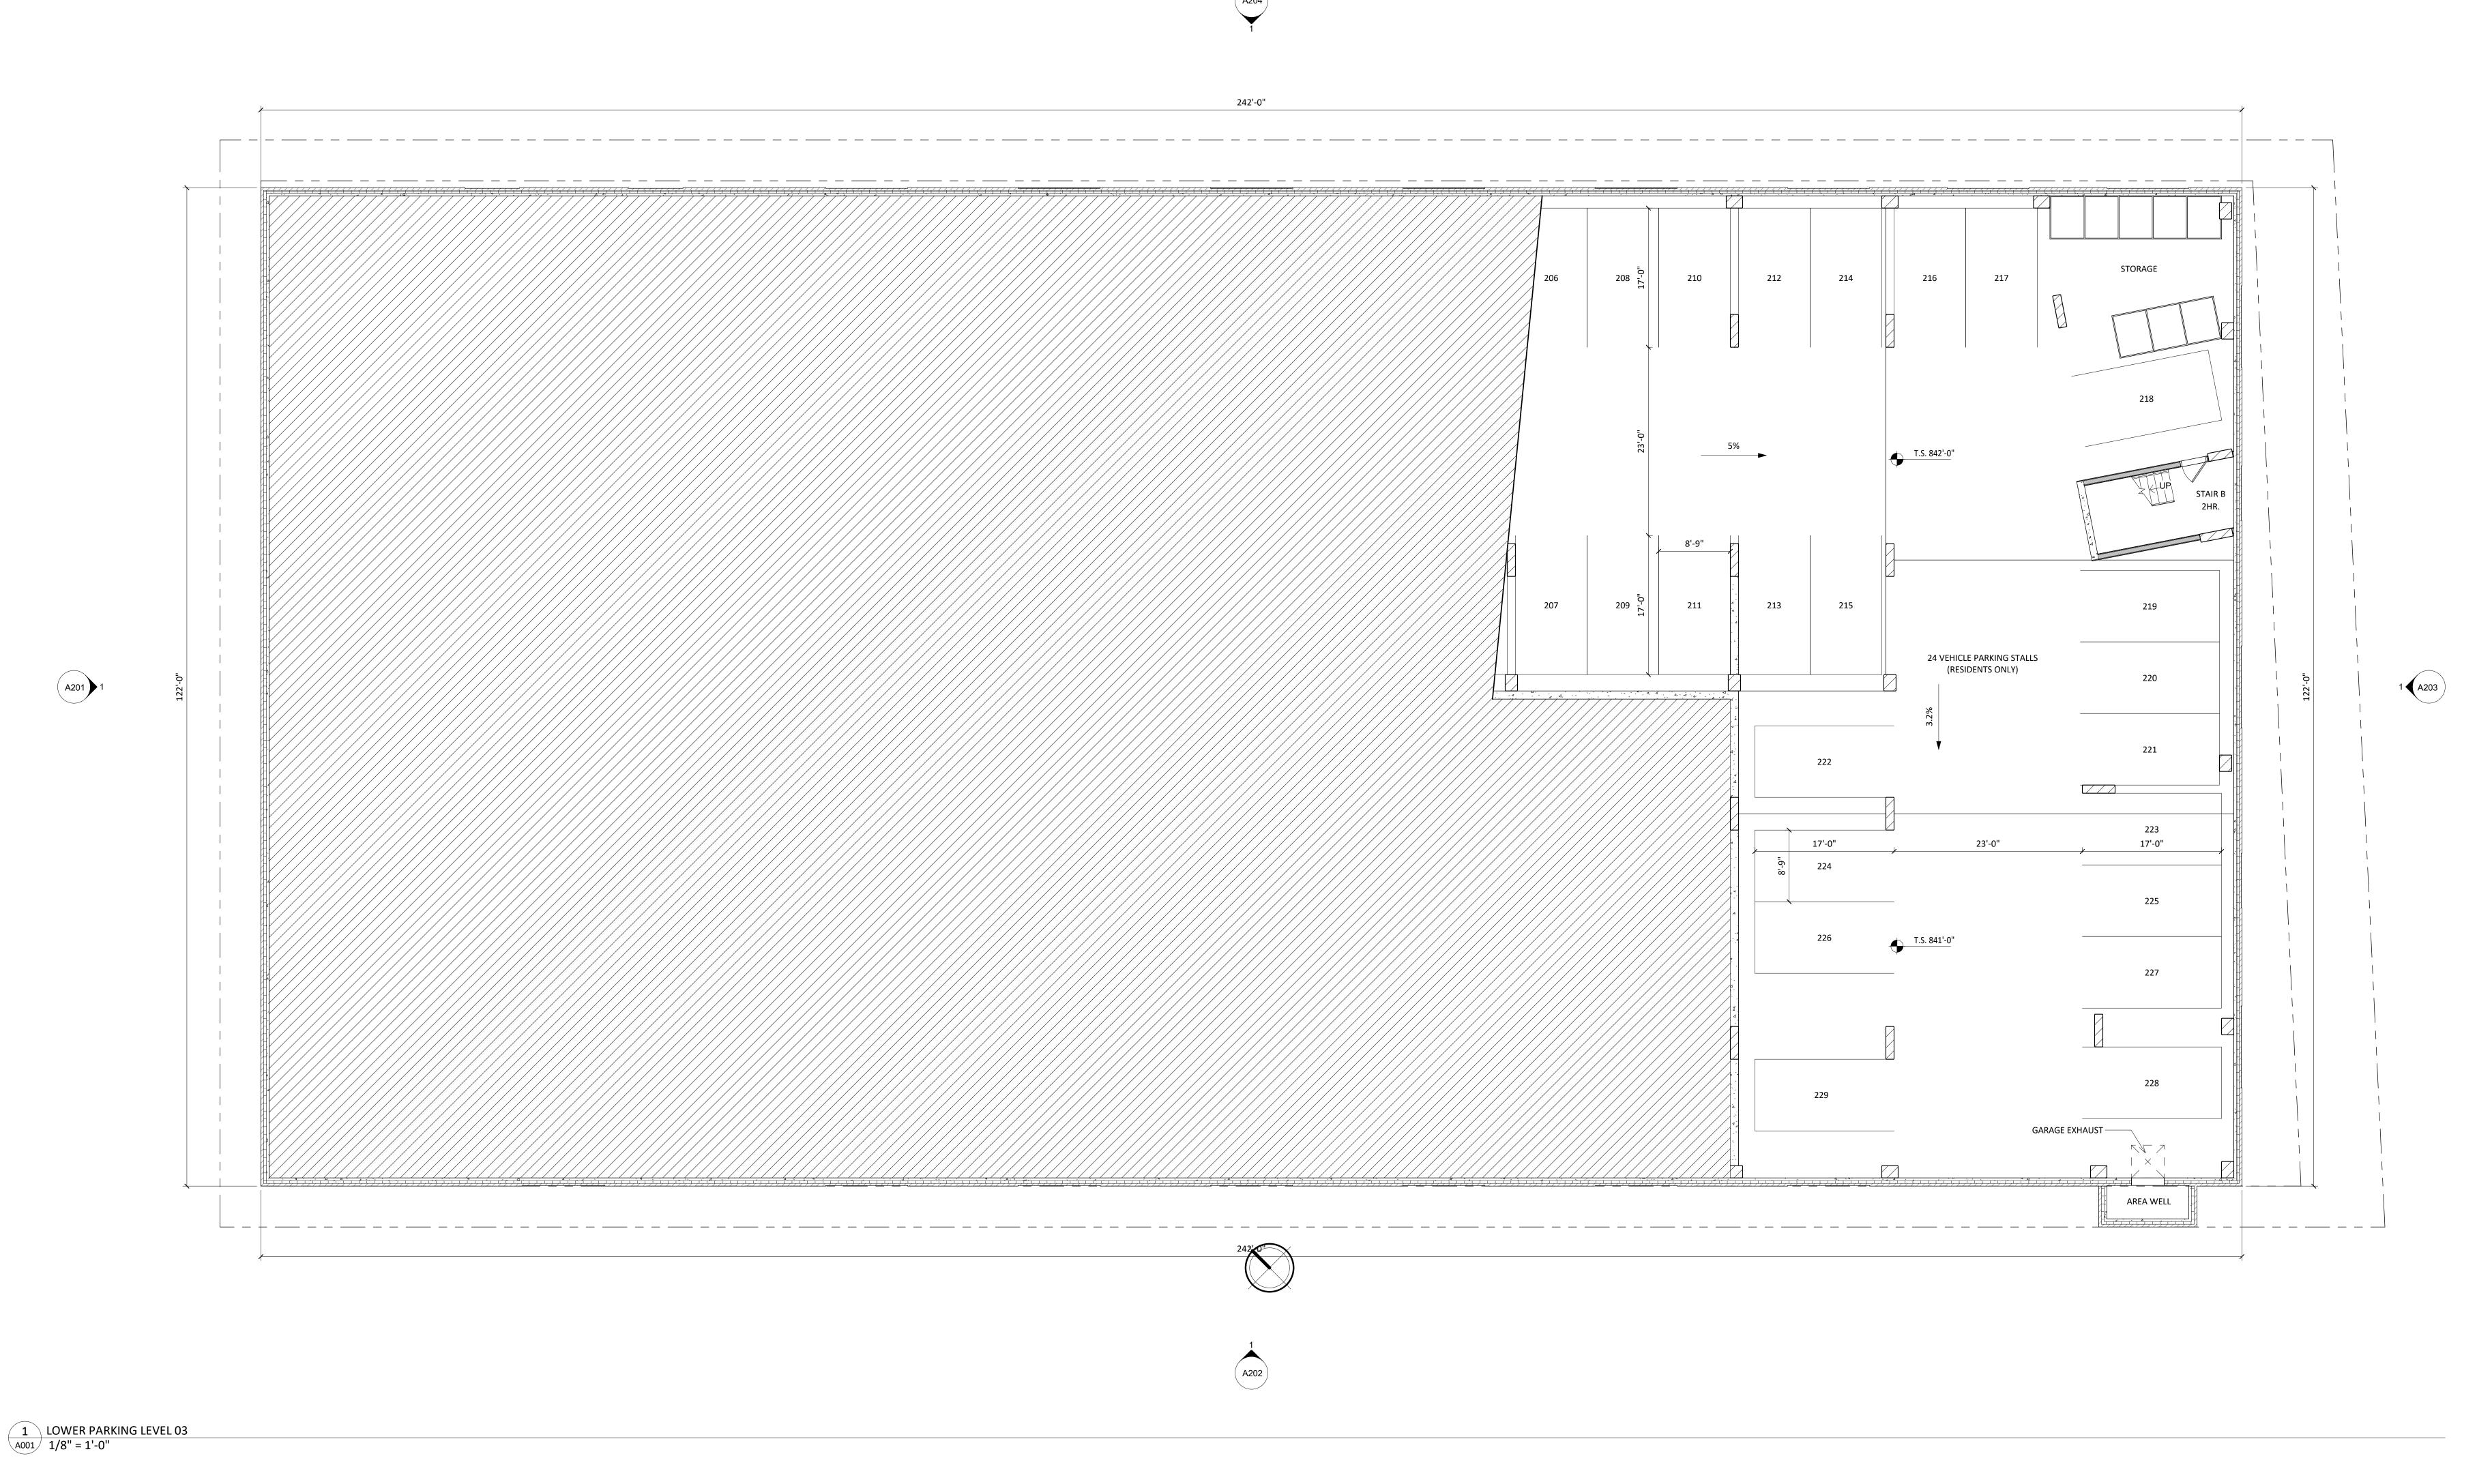



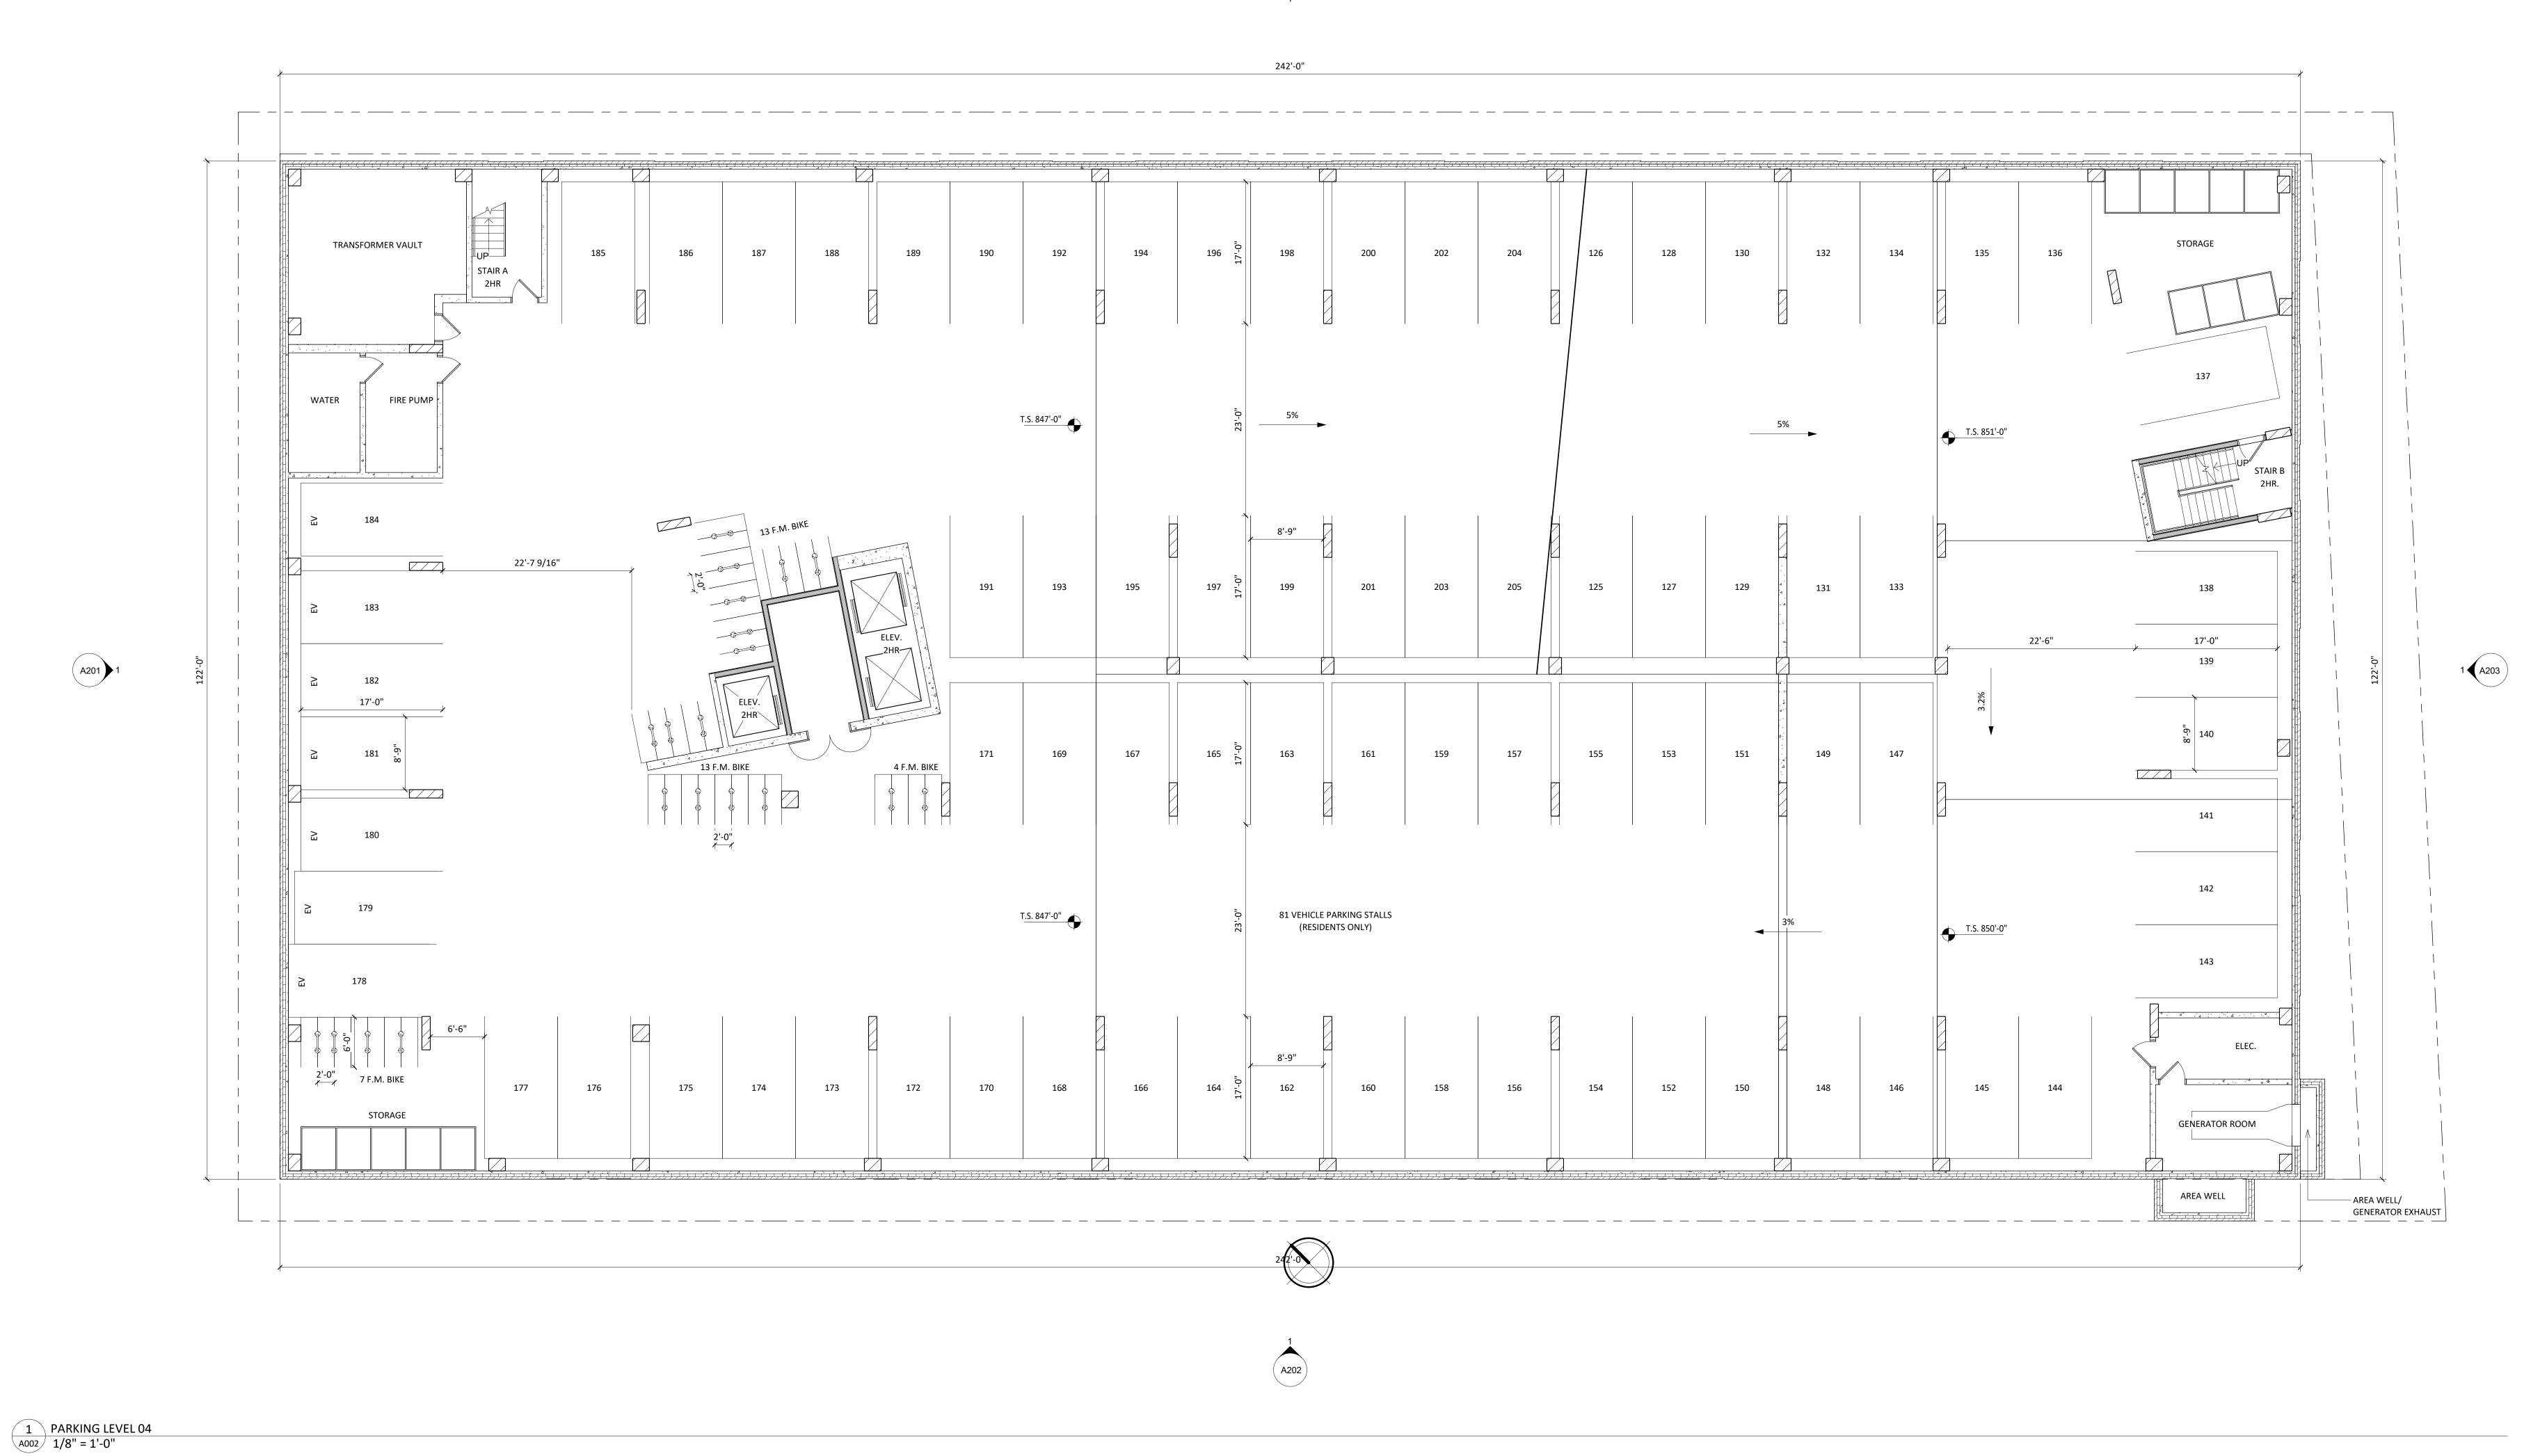



KEY PLAN

ISSUED
Issued for LU - March 03, 2021
Re-Issued for LU - May 03, 2021

PROJECT TITLE
WEST WILSON ST
DEVELOPMENT


145-151 W WILSON ST.
309-321 S HENRY ST.
MADISON, WI

SHEET TITLE
PARKING LEVEL
03

SHEET NUMBER

A002



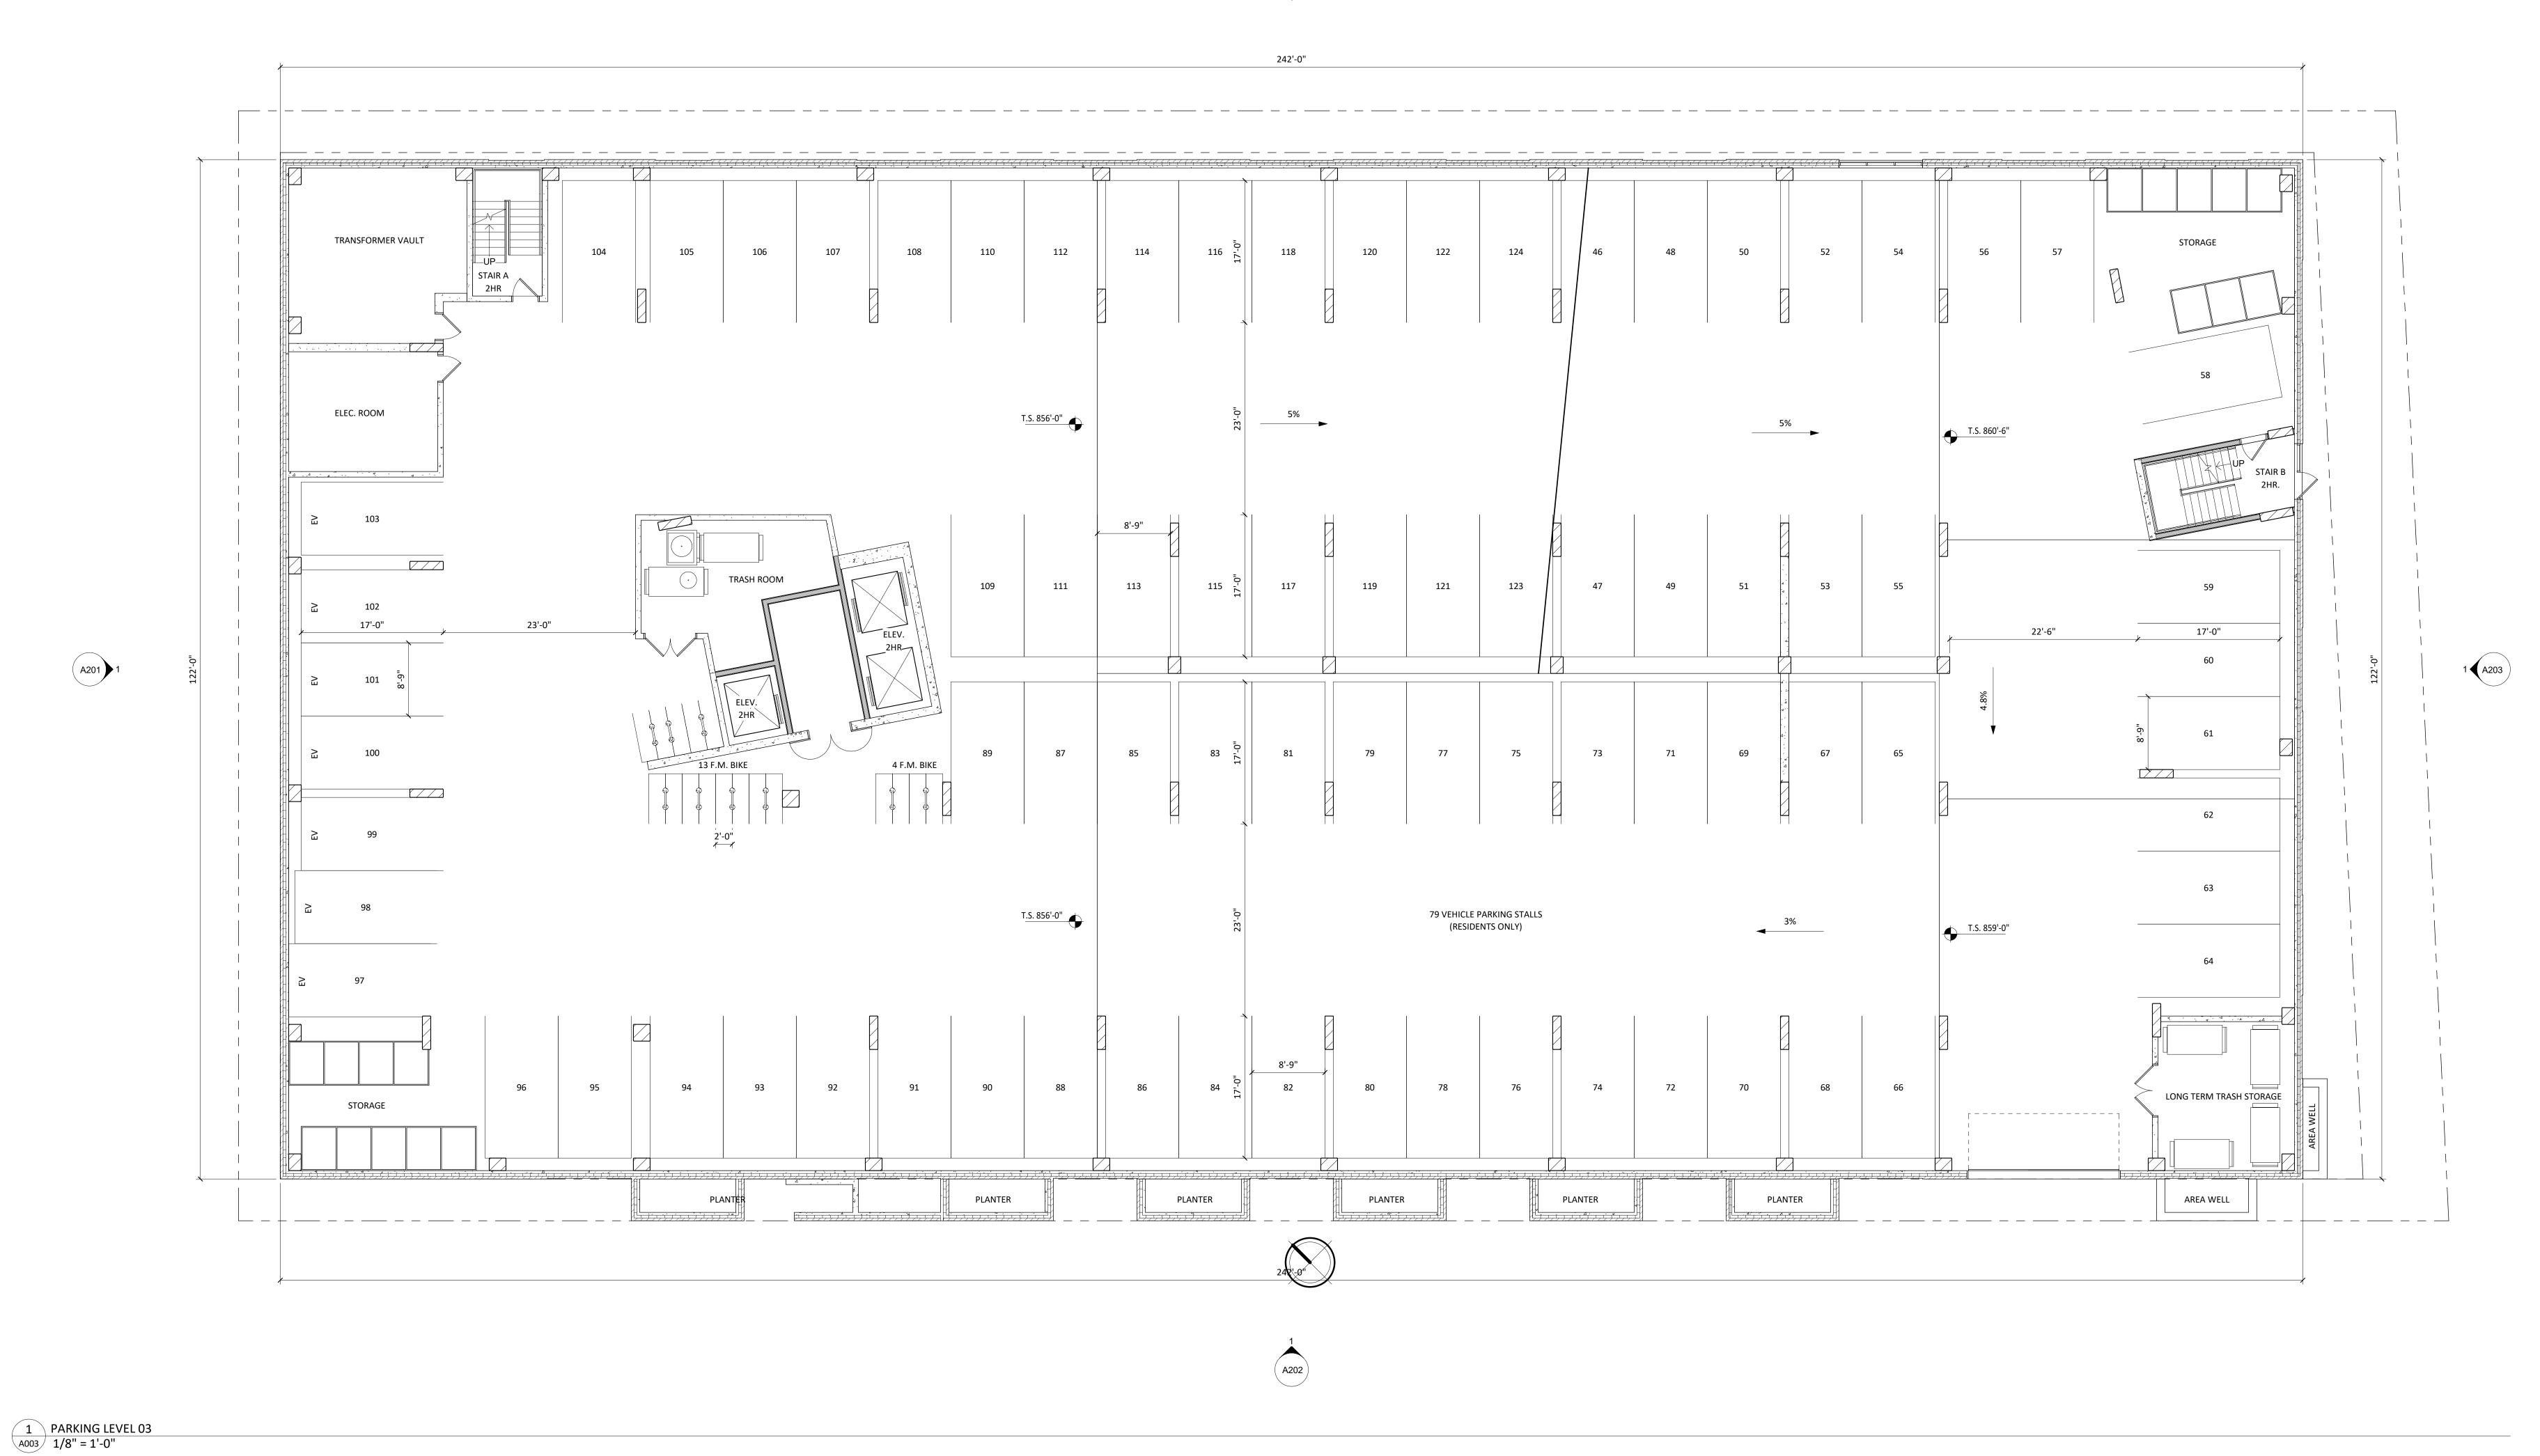



KEY PLAN

ISSUED
Issued for LU - March 03, 2021
Re-Issued for LU - May 03, 2021

PROJECT TITLE
WEST WILSON ST
DEVELOPMENT

145-151 W WILSON ST.
309-321 S HENRY ST.
MADISON, WI

SHEET TITLE
PARKING LEVEL
02

SHEET NUMBER

A003





KEY PLAN

ISSUED Issued for LU - March 03, 2021

Re-Issued for LU - May 03, 2021

PROJECT TITLE
WEST WILSON ST

DEVELOPMENT

145-151 W WILSON ST.
309-321 S HENRY ST.
MADISON, WI


SHEET TITLE
FIRST FLOOR
PLAN & PARKING

SHEET NUMBER

LEVEL 01

A101

PROJECT NUMBER 2017
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A202 A205

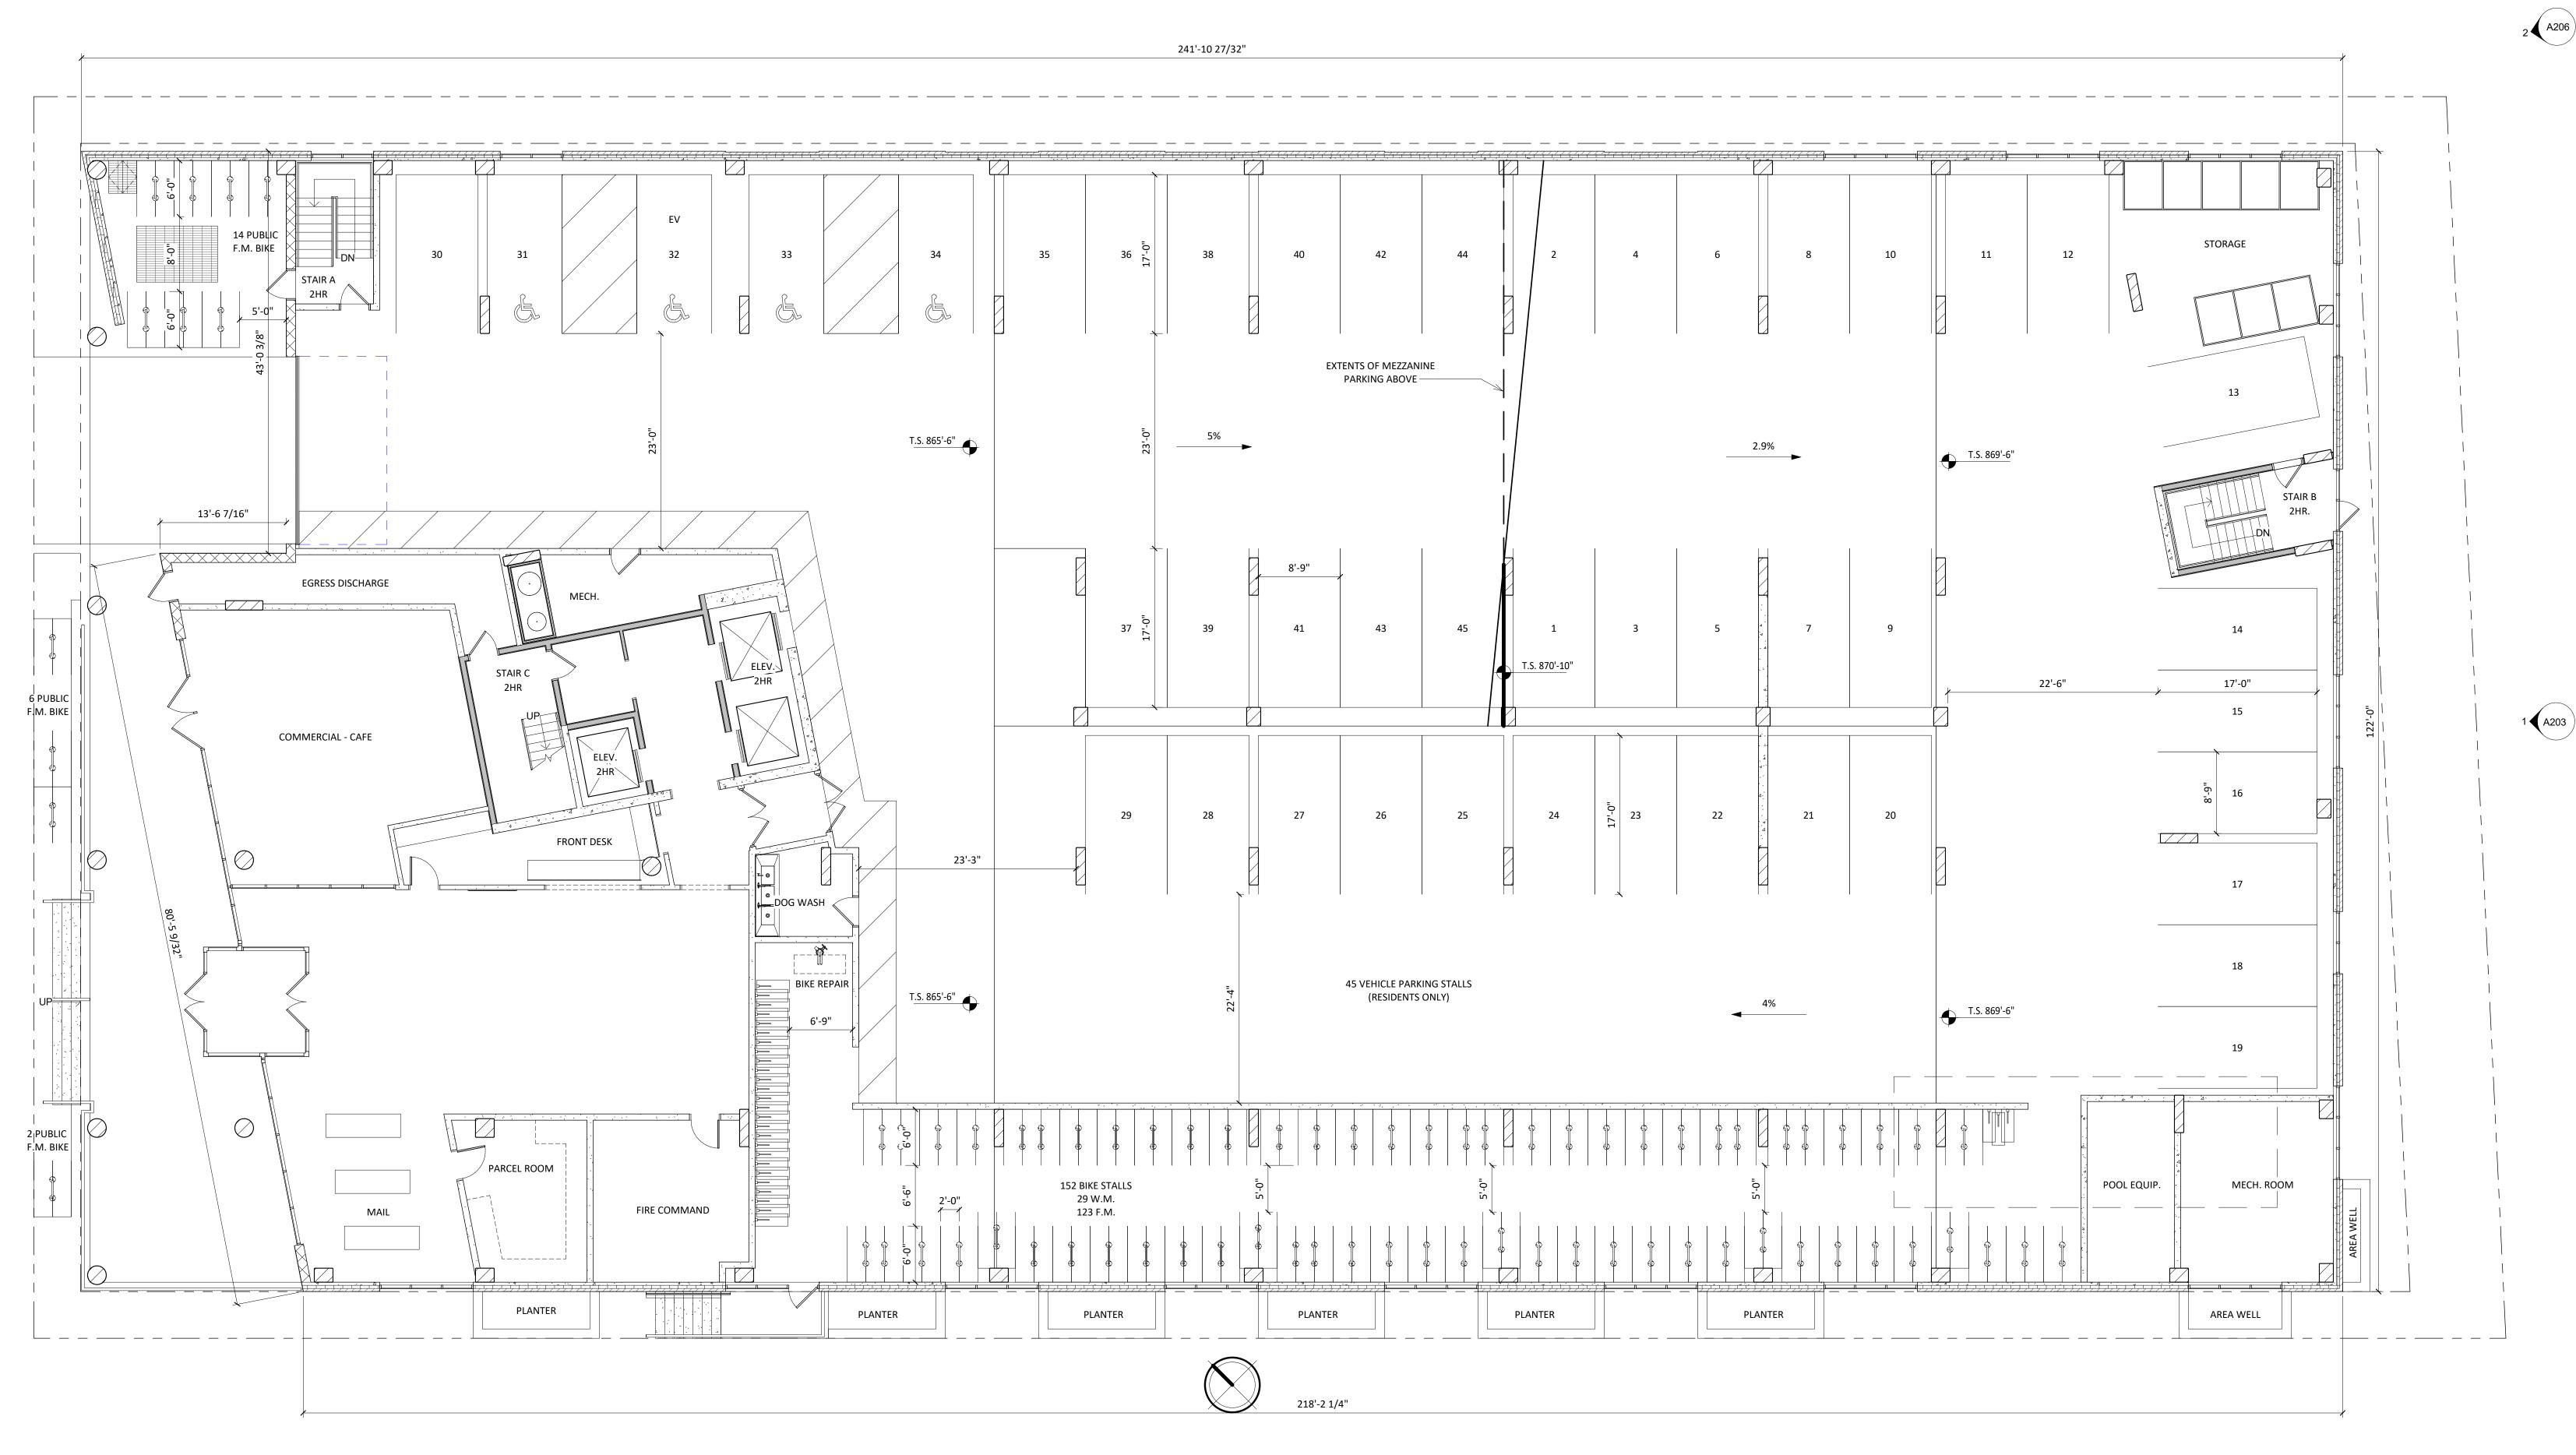1 PARKING LEVEL 02 A101 1/8" = 1'-0"







1 SECOND FLOOR PLAN A102 1/8" = 1'-0"



KEY PLAN

ISSUED
Issued for LU - March 03, 2021
Re-Issued for LU - May 03, 2021

PROJECT TITLE
WEST WILSON ST
DEVELOPMENT

145-151 W WILSON ST.
309-321 S HENRY ST.
MADISON, WI

SHEET TITLE
SECOND FLOOR
PLAN

SHEET NUMBER

A102



KEY PLAN

ISSUED
Issued for LU - March 03, 2021
Re-Issued for LU - May 03, 2021

PROJECT TITLE

WEST WILSON ST DEVELOPMENT

145-151 W WILSON ST.
309-321 S HENRY ST.
MADISON, WI

SHEET TITLE
THIRD - TENTH

THIRD - TENTI FLOOR PLAN

SHEET NUMBER

A103







KEY PLAN

Issued for LU - March 03, 2021 Re-Issued for LU - May 03, 2021

PROJECT TITLE


WEST WILSON ST DEVELOPMENT

145-151 W WILSON ST. 309-321 S HENRY ST. MADISON, WI SHEET TITLE
ROOF PLAN

SHEET NUMBER

A111

VIEWING DECK/ (BALLASTED ROOF AREA / SOLAR ARRAY) LAWN AREA GREEN ROOF 01 VIEWING DECK/ LAWN AREA GREEN ROOF 02 A202 A205

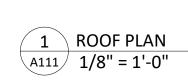



TYP. GLAZING			10-0"	
OPERABLE WINDOW TYP.			10,-0"	200'-0"
WINDOW WALL SYSTEM TYP.			10,-0"	LV <u>L 08</u>
PRE-FINISHED METAL PANEL TYP.			10,-0,,	
HATCH INDICATES			10-0"	
HATCH INDICATES BIRD GLASS TYP.			10-0"	
			10-0	LVL 04
			10,-0	
GLASS RAILING SYSTEM			12'-0"	LVL 02
ARCHITECTURAL CAST WALL PANELS CURTAIN WALL			18'-0"	
				LV 01/01 100'-0"

KEY PLAN

Issued for LU - March 03, 2021 Re-Issued for LU - May 03, 2021

PROJECT TITLE
WEST WILSON ST
DEVELOPMENT

145-151 W WILSON ST.
309-321 S HENRY ST.
MADISON, WI

SHEET TITLE
EXTERIOR
ELEVATIONS

SHEET NUMBER

A201


PROJECT NUMBER 2017

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1 NORTH WEST ELEVATION - ALONG WILSON 1/8" = 1'-0"

EXTERIOR MA	TERIAL SCHEDUL
BUILDING ELEMENT	COLOR
PRE-FINISHED METAL PANEL	WHITE
ARCHITECTURAL CAST PANELS	SANDRIFT
WINDOW WALL SYSTEM	ANODIZED DARK GRAY
ALUM. STOREFRONT	ANODIZED DARK GRAY
METAL DOORS/FRAMES	ANODIZED DARK GRAY
CAST STONE SILLS & BANDS	SANDRIFT
RAILINGS	GLASS RAILING - DARK GRAY



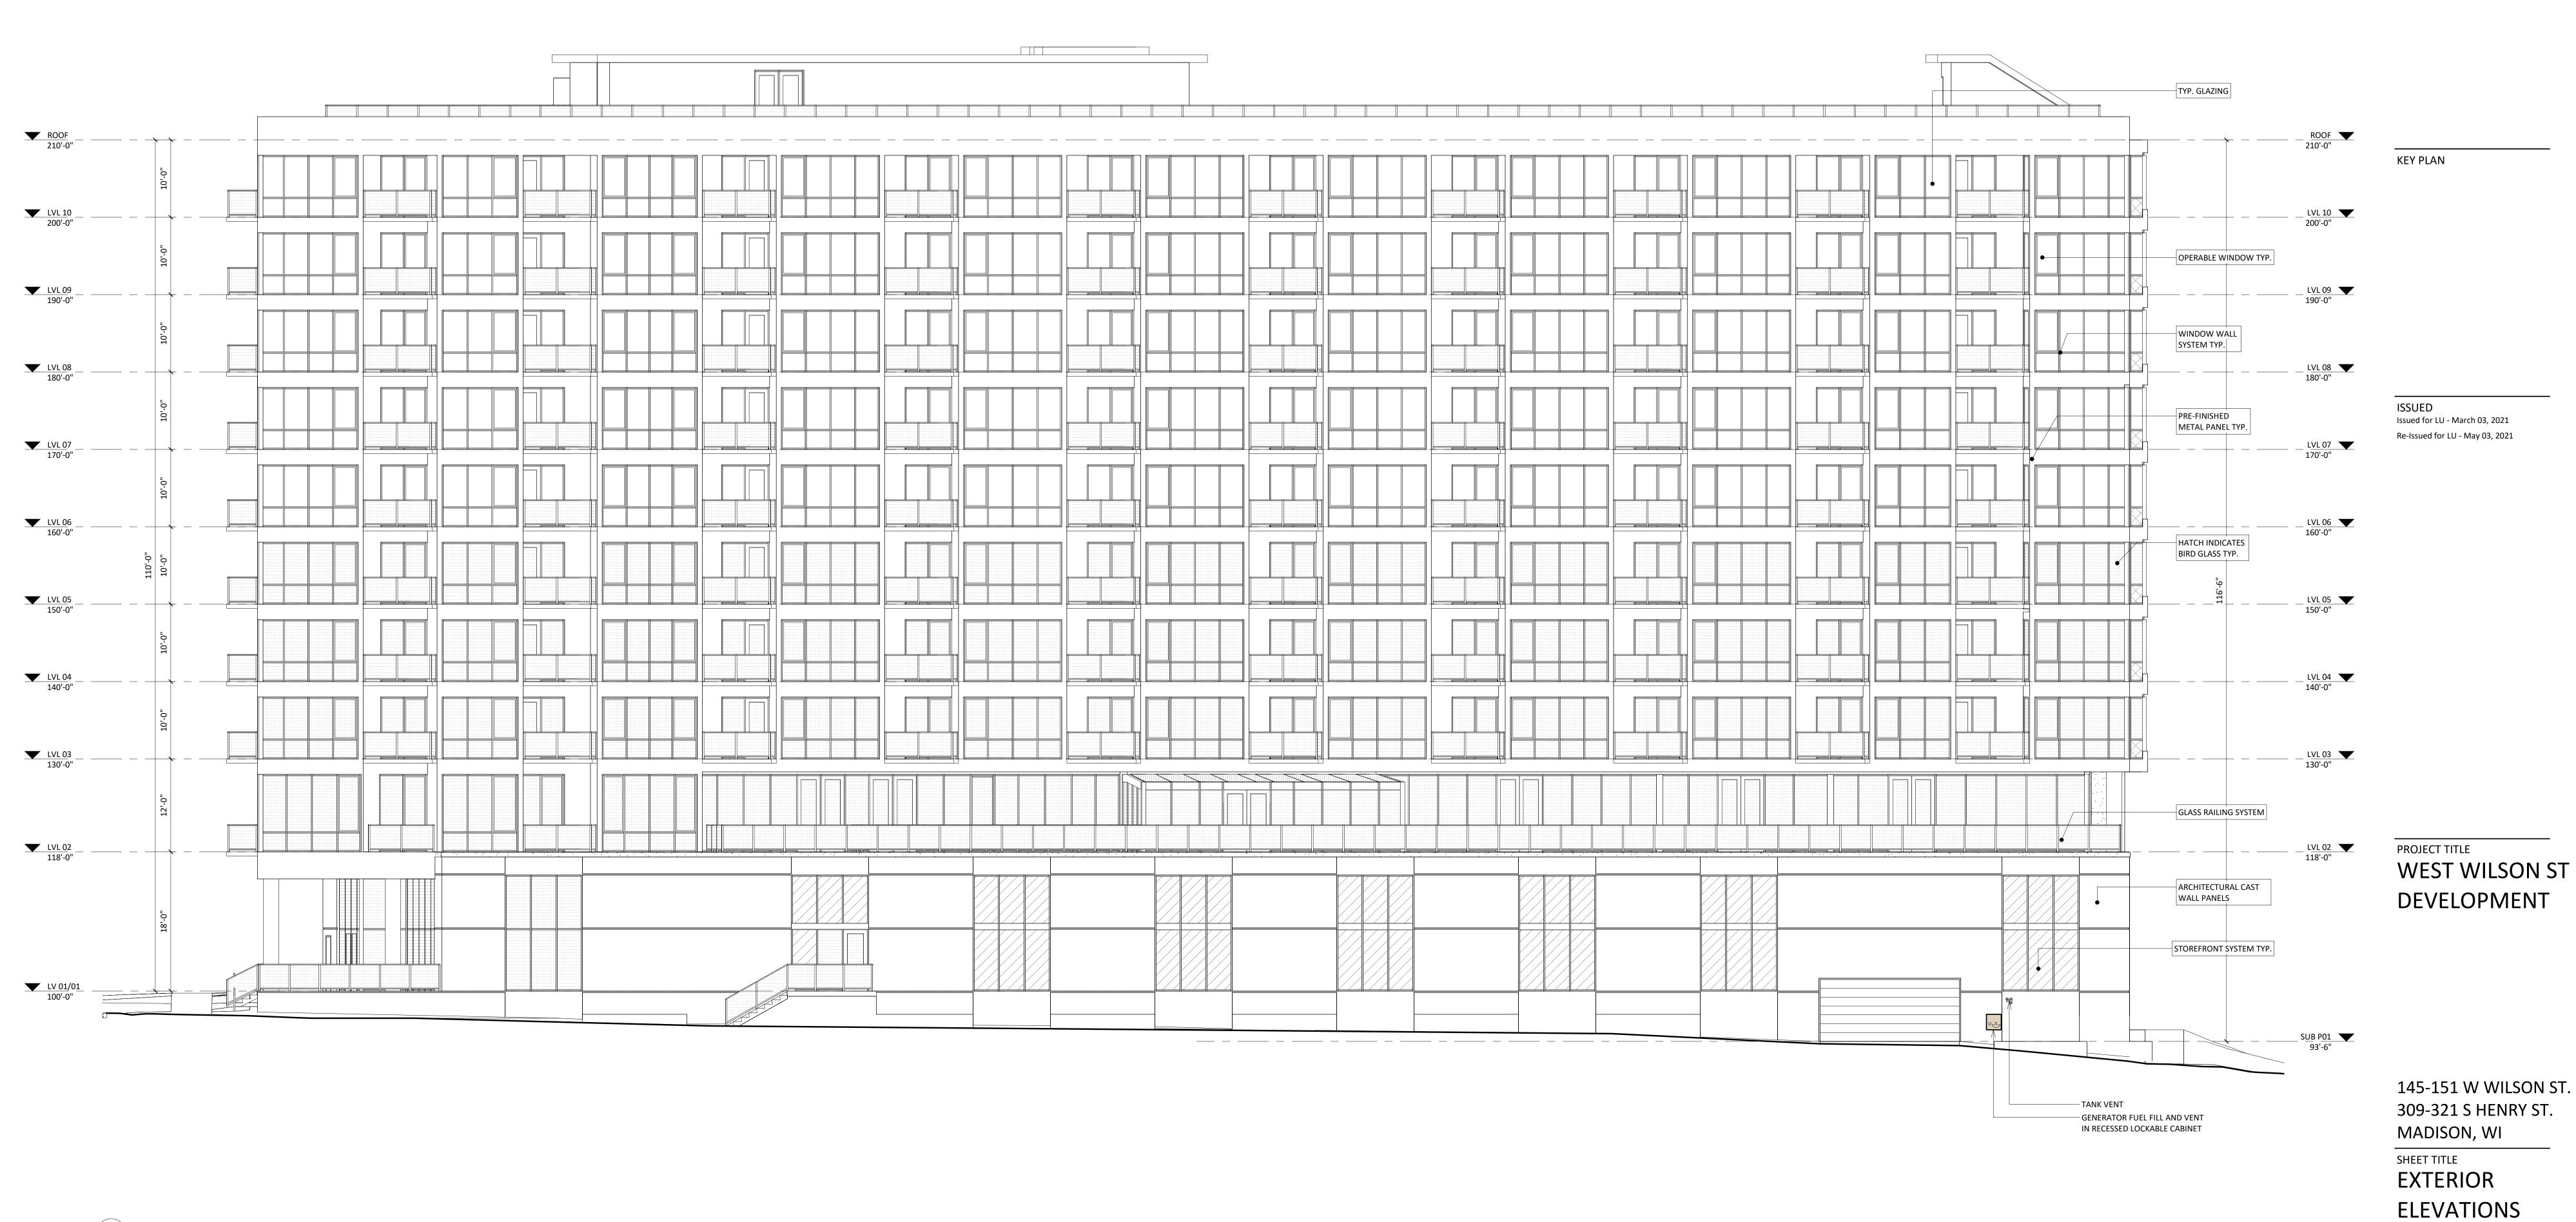

SOUTH WEST ELEVATION - ALONG HENRY
1/8" = 1'-0"

EXTERIOR MATERIAL SCHEDULE					
BUILDING ELEMENT	COLOR				
PRE-FINISHED METAL PANEL	WHITE				
ARCHITECTURAL CAST PANELS	SANDRIFT				
WINDOW WALL SYSTEM	ANODIZED DARK GRAY				
ALUM. STOREFRONT	ANODIZED DARK GRAY				
METAL DOORS/FRAMES	ANODIZED DARK GRAY				
CAST STONE SILLS & BANDS	SANDRIFT				

GLASS RAILING - DARK GRAY

RAILINGS

SHEET NUMBER

A202

PROJECT NUMBER 2017

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TYP. GLAZING ROOF 210'-0" OPERABLE WINDOW TYP. SYSTEM TYP. PRE-FINISHED METAL PANEL TYP. __LVL 06 _____160'-0" HATCH INDICATES BIRD GLASS TYP. __LVL 05 ___150'-0" __LVL 04 __140'-0" __LVL 03 _____130'-0" GLASS RAILING SYSTEM ARCHITECTURAL CAST WALL PANELS STOREFRONT SYSTEM TYP. SUB P01 93'-6"

SOUTH EAST ELEVATION
1/8" = 1'-0"

EXTERIOR MA	TERIAL SCHEDU
BUILDING ELEMENT	COLOR
PRE-FINISHED METAL PANEL	WHITE
ARCHITECTURAL CAST PANELS	SANDRIFT
WINDOW WALL SYSTEM	ANODIZED DARK GRAY
ALUM. STOREFRONT	ANODIZED DARK GRAY
METAL DOORS/FRAMES	ANODIZED DARK GRAY
CAST STONE SILLS & BANDS	SANDRIFT
RAILINGS	GLASS RAILING - DARK GRAY

KEY PLAN

ISSUED Issued for LU - March 03, 2021 Re-Issued for LU - May 03, 2021

PROJECT TITLE
WEST WILSON ST
DEVELOPMENT

145-151 W WILSON ST.
309-321 S HENRY ST.
MADISON, WI

SHEET TITLE
EXTERIOR
ELEVATIONS

SHEET NUMBER

A203





1 NORTH EAST ELEVATION
A204 1/8" = 1'-0"

EXTERIOR MA	TERIAL SCHEDUL
BUILDING ELEMENT	COLOR
PRE-FINISHED METAL PANEL	WHITE
ARCHITECTURAL CAST PANELS	SANDRIFT
WINDOW WALL SYSTEM	ANODIZED DARK GRAY
ALUM. STOREFRONT	ANODIZED DARK GRAY
METAL DOORS/FRAMES	ANODIZED DARK GRAY
CAST STONE SILLS & BANDS	SANDRIFT
RAILINGS	GLASS RAILING - DARK GRAY

OR MATERIAL SCHEDULE


SHEET NUMBER

SHEET TITLE

EXTERIOR

ELEVATIONS

A204

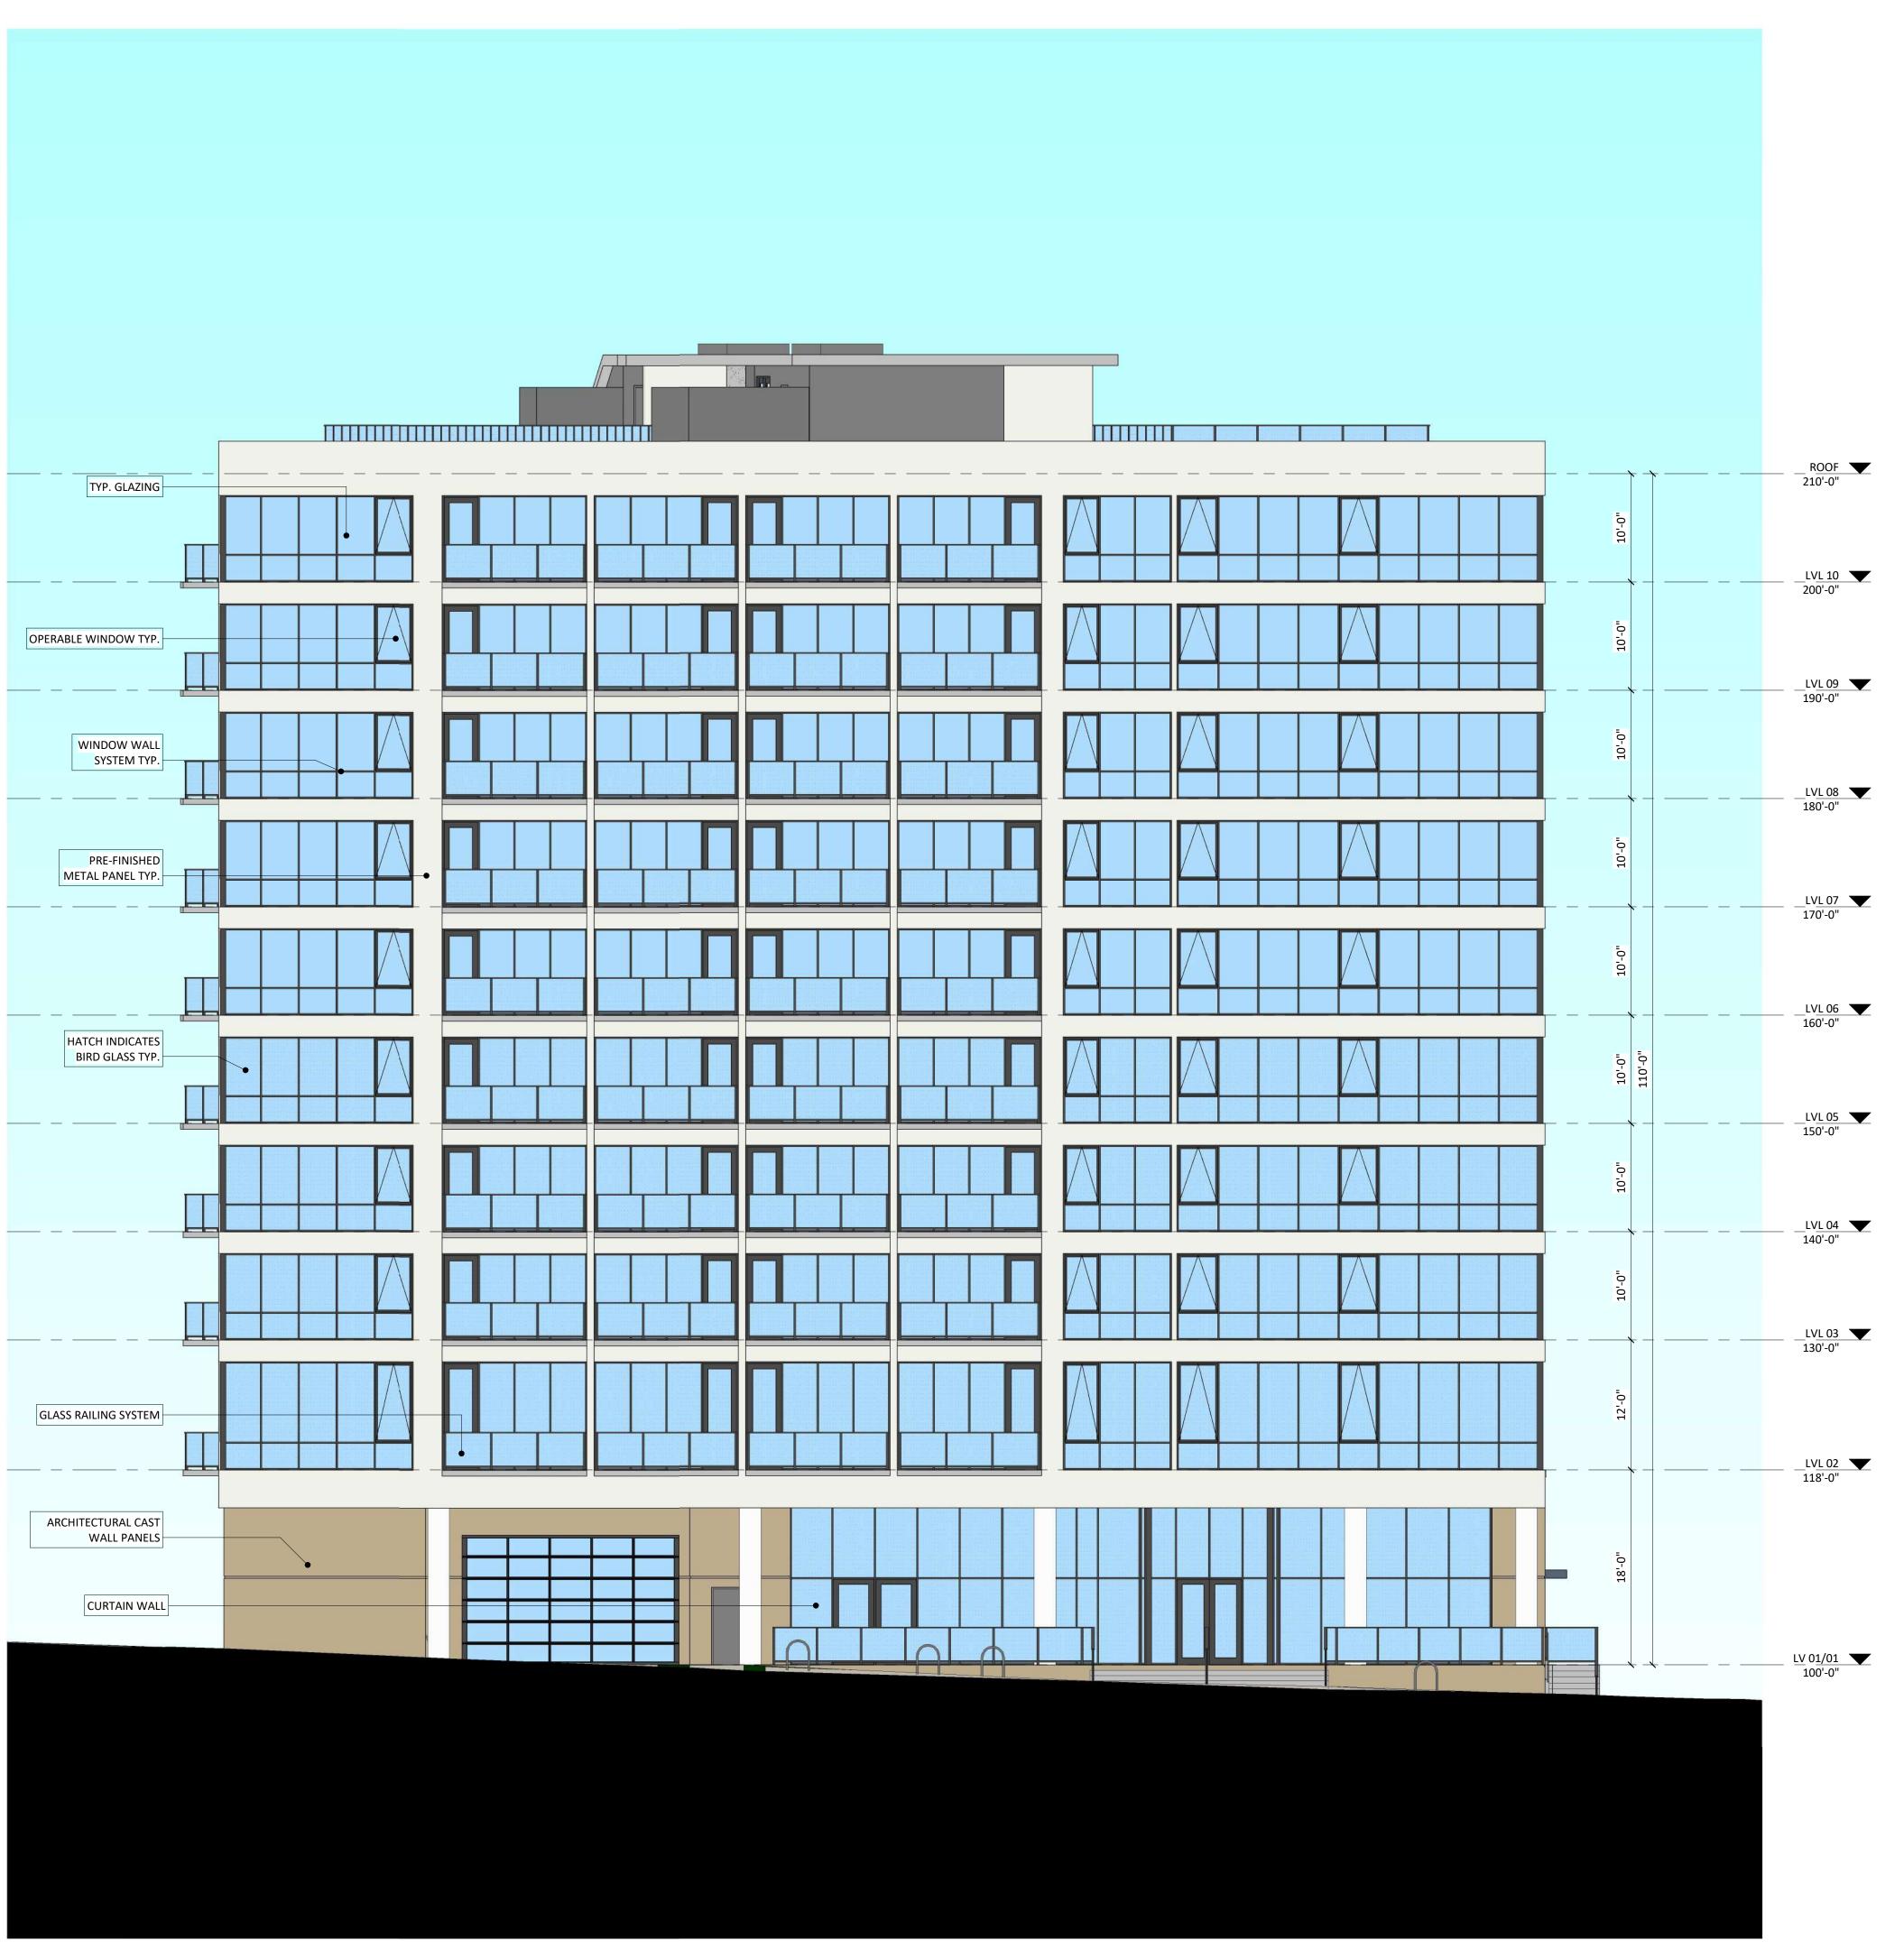

1 NORTH WEST ELEVATION - ALONG WILSON - COLOR A207 1/8" = 1'-0"

EXTERIOR MATERIAL SCHEDULE	
BUILDING ELEMENT	COLOR
PRE-FINISHED METAL PANEL	WHITE
ARCHITECTURAL CAST PANELS	SANDRIFT
WINDOW WALL SYSTEM	ANODIZED DARK GRAY
ALUM. STOREFRONT	ANODIZED DARK GRAY
METAL DOORS/FRAMES	ANODIZED DARK GRAY

SANDRIFT

GLASS RAILING - DARK GRAY

CAST STONE SILLS & BANDS

RAILINGS



KEY PLAN

ISSUED Issued for LU - March 03, 2021

Re-Issued for LU - May 03, 2021

PROJECT TITLE WEST WILSON ST DEVELOPMENT

145-151 W WILSON ST. 309-321 S HENRY ST. MADISON, WI SHEET TITLE COLOR **ELEVATION**

SHEET NUMBER

PROJECT NUMBER 2017

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KEY PLAN

ISSUED Issued for LU - March 03, 2021

PROJECT TITLE WEST WILSON ST

145-151 W WILSON ST. 309-321 S HENRY ST. MADISON, WI SHEET TITLE

COLOR **ELEVATION**

SHEET NUMBER

EXTERIOR MATERIAL SCHEDULE

WHITE SANDRIFT

ANODIZED DARK GRAY

ANODIZED DARK GRAY ANODIZED DARK GRAY

GLASS RAILING - DARK GRAY

BUILDING ELEMENT

PRE-FINISHED METAL PANEL

WINDOW WALL SYSTEM

METAL DOORS/FRAMES CAST STONE SILLS & BANDS

ALUM. STOREFRONT

RAILINGS

ARCHITECTURAL CAST PANELS

COLOR







EXTERIOR MATERIAL SCHEDULE	
BUILDING ELEMENT	COLOR
PRE-FINISHED METAL PANEL	WHITE
ARCHITECTURAL CAST PANELS	SANDRIFT
WINDOW WALL SYSTEM	ANODIZED DARK GRAY
ALUM. STOREFRONT	ANODIZED DARK GRAY
METAL DOORS/FRAMES	ANODIZED DARK GRAY
CAST STONE SILLS & BANDS	SANDRIFT
RAILINGS	GLASS RAILING - DARK GRAY



KEY PLAN

ISSUED Issued for LU - March 03, 2021 Re-Issued for LU - May 03, 2021

PROJECT TITLE
WEST WILSON ST
DEVELOPMENT

145-151 W WILSON ST.
309-321 S HENRY ST.
MADISON, WI

SHEET TITLE
COLOR
ELEVATION

SHEET NUMBER

A209



ISSUED Issued for LU - March 03, 2021 Re-Issued for LU - May 03, 2021

PROJECT TITLE WEST WILSON ST DEVELOPMENT

145-151 W WILSON ST. 309-321 S HENRY ST. MADISON, WI SHEET TITLE

COLOR **ELEVATION**

SHEET NUMBER

EXTERIOR MATERIAL SCHEDULE

WHITE SANDRIFT

ANODIZED DARK GRAY

ANODIZED DARK GRAY ANODIZED DARK GRAY

GLASS RAILING - DARK GRAY

BUILDING ELEMENT

PRE-FINISHED METAL PANEL

WINDOW WALL SYSTEM

METAL DOORS/FRAMES CAST STONE SILLS & BANDS

ALUM. STOREFRONT


RAILINGS

ARCHITECTURAL CAST PANELS

COLOR

A210



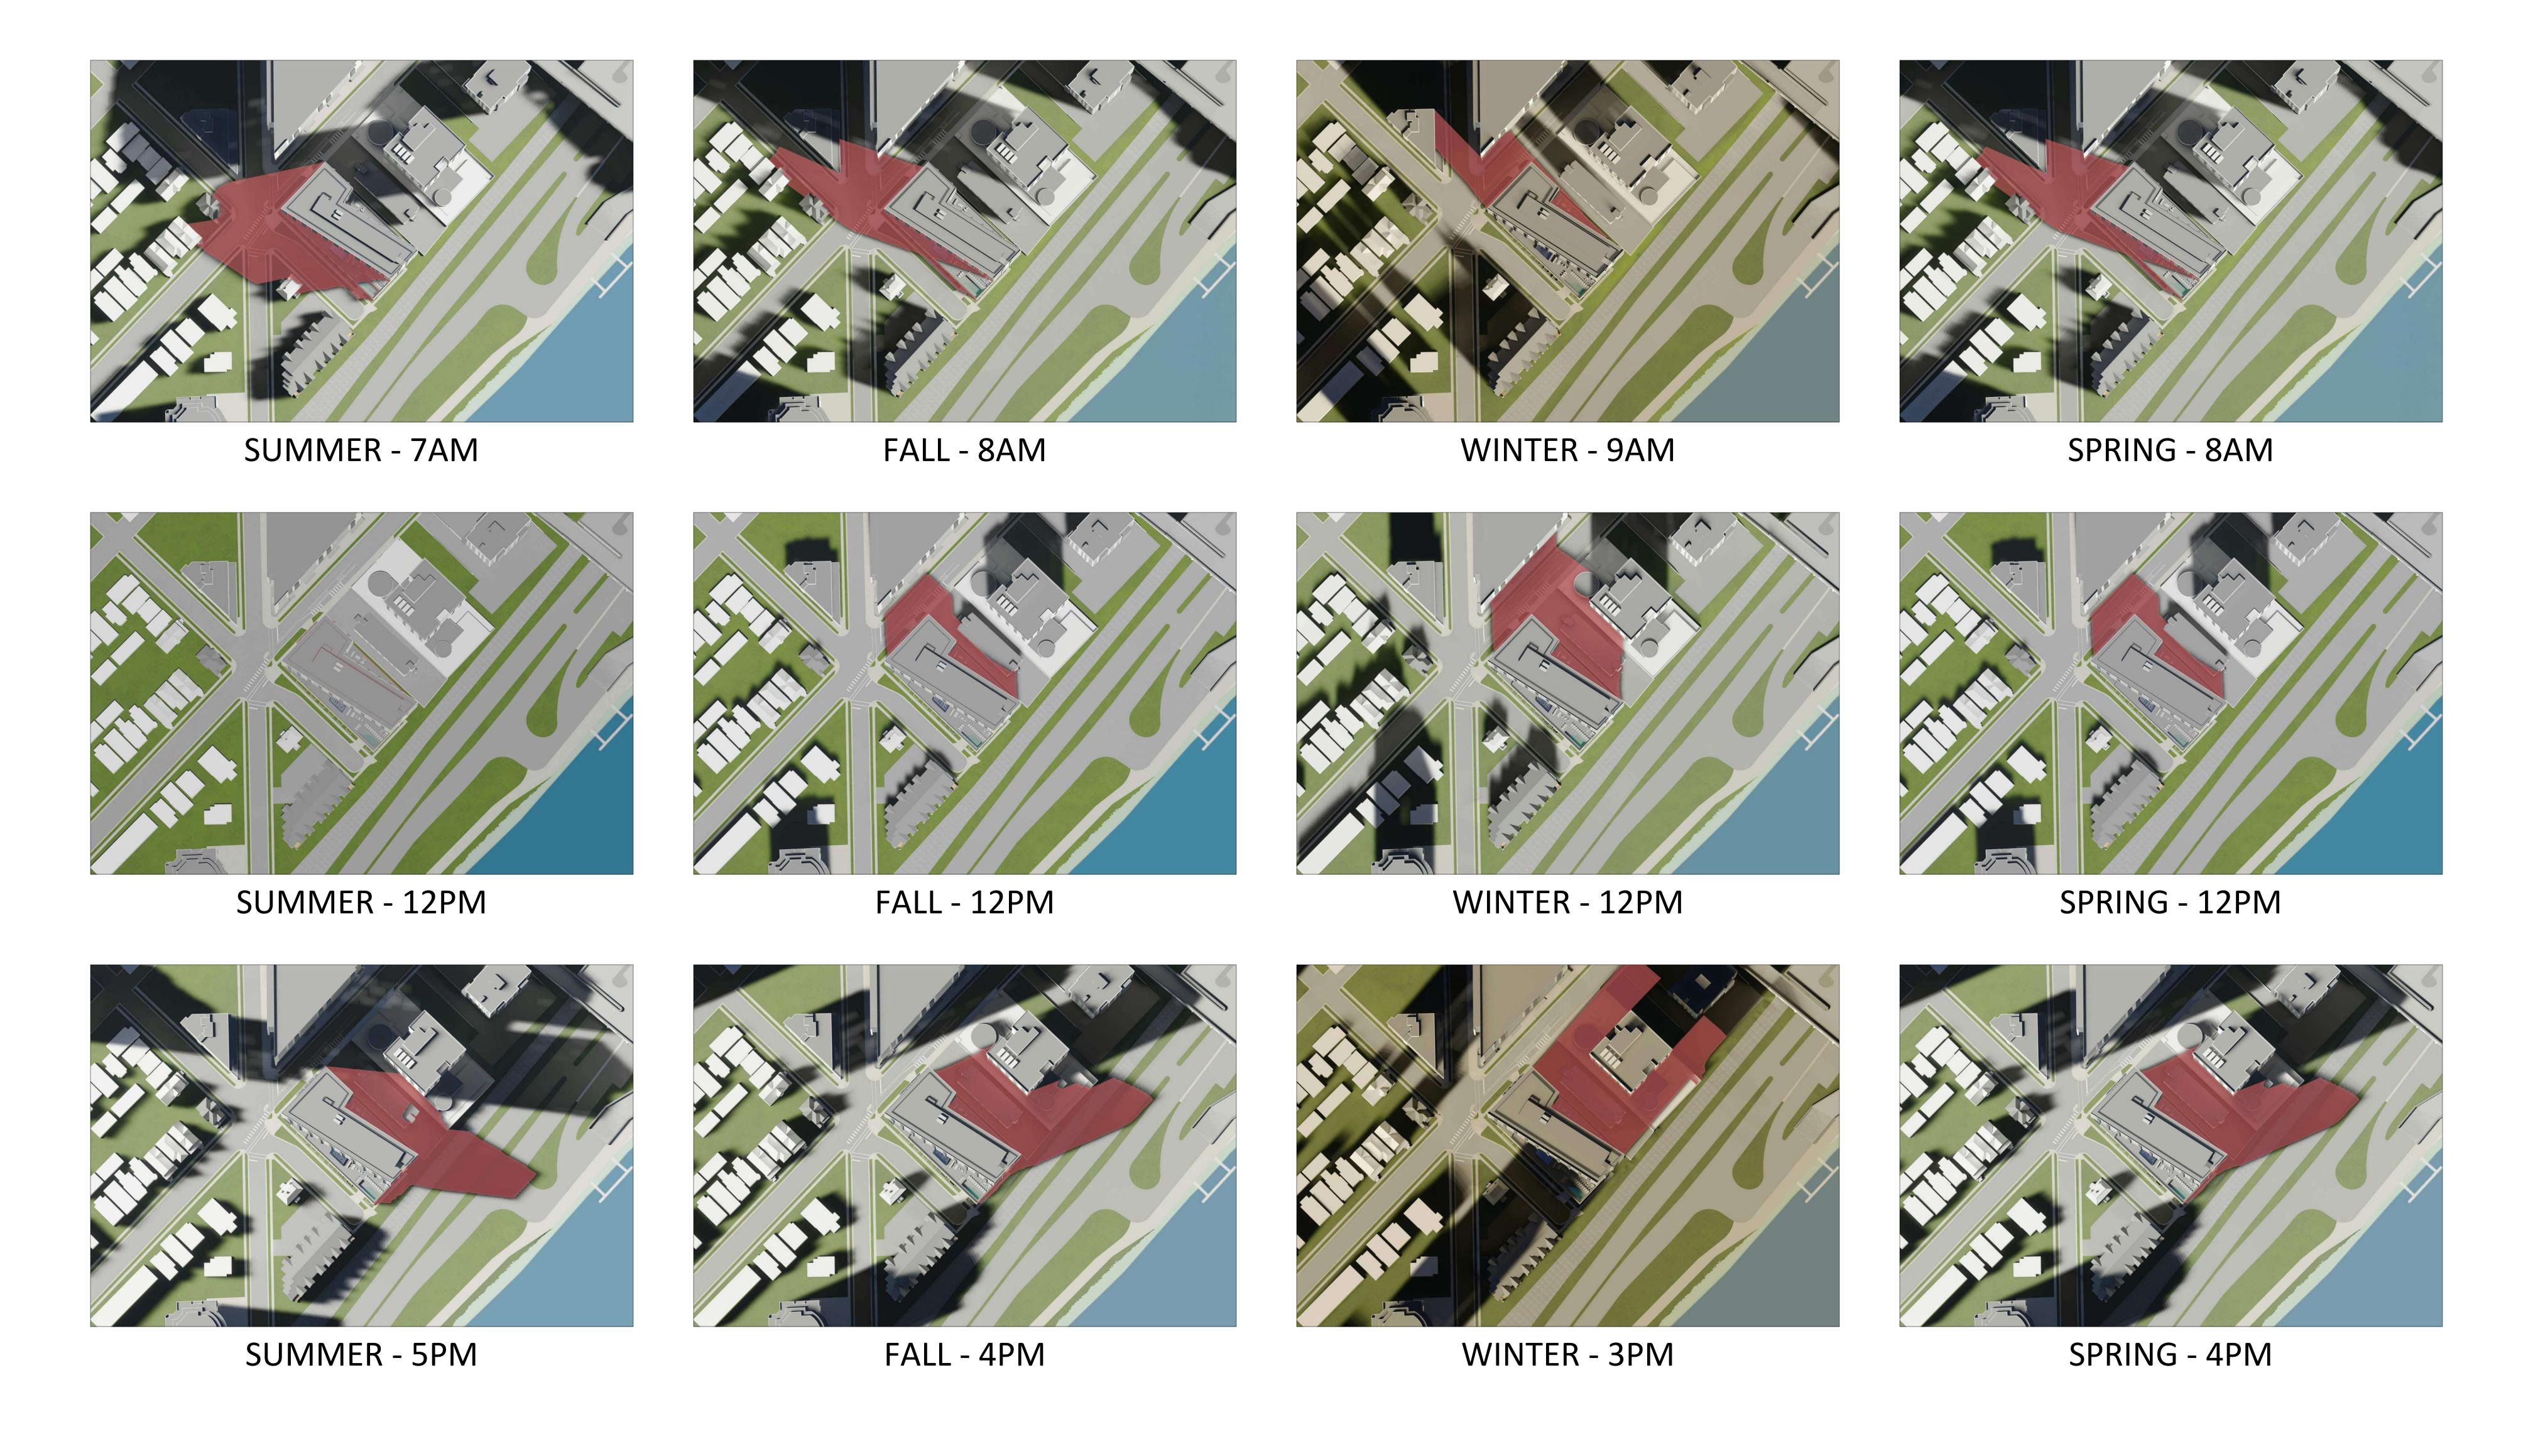

100 W WILSON ST. MADISON, WI SUN STUDY



Kahler Slater knothe bruce











