

AND 15, AS DOCUMENT NO. 1952891, DANE COUNTY REGISTRY, AND LOCATED IN THE

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GENERAL DEMOLITION NOTES

ALL EXISTING IMPROVEMENTS ARE TO REMAIN UNLESS NOTED OTHERWISE IN THESE PLANS.

The contractor is responsible for the denolition, removal, and disposal of (in a location approved by all Jursdictions Hwing Authorny) all derirs, structures, pads, walls, flumes, foundations, parking, brankae Structures, uillines, etc., such that the improvements shown on the plans can be constructed. All facilities to Removed Shall be undercut to suitable imternal and broadit to grade with suitable compared fill material per the removed shall be undercut to suitable imternal. And broadit to grade with suitable compared fill material per the

DISPOSAL WILL BE IN ACCORDANCE WITH ALL LOCAL, STATE AND/OR FEDERAL REGULATIONS GOVERNING SUCH CONTRACTOR IS RESPONSIBLE FOR OBTAINING ALL PERMITS REQUIRED FOR DEMOLITION AND DISPOSAL.

THE LOCATIONS OF ALL EXISTING UTILITIES SHOWN ON THIS PLAN HAVE BEEN DETERMINED FROM THE BEST INFORMATION AWALABLE AND ARE GIVEN FOR THE COMPANIENCE OF THE CONTRACTOR. THE ENGINEER ASSUMES NO RESPONSIBILITY FOR THEIR ACCURACY. PROR TO THE START OF ANY DEMOLITION ACTIVITY, THE CONTRACTOR SHALL NOTIFY THE UTILITY COMPANIES FOR ONSITE LOCATIONS OF EXISTING UTILITIES.

ALL EXISTING UTILITIES SHOWN ARE NOT TO BE INTERPRETED AS THE EXACT LOCATION, OR AS THE ONLY OBSTACLES THAT MAY OCCUR On the STRE. VERYEY EXISTING CONDITIONS AND PROCEED WITH CAUTION ARCUND MAY ANTICEPATED FEATURES, GRE NOTICE TO ALL UTILITY COMPARIS RECARMON DESTRUCTION AND REJUXAL OF ALL SERVICE LINES AND CAP ALL LINES BEFORE PROCEEDING WITH THE WORK. UTILITIES DETERMINED TO BE ABANDONED AND LEFT IN PLACE SHALL BE GROUTED IF UNDER BUILDINGS.

THE CONTRACTOR SHALL FIELD VERIFY THE EVACT LOCATION OF ALL PUBLIC AND PRIVATE UTILITIES, INCLUDING IRRIGATION, SPECIFIC TO THIS PROJECT PRIOR TO THE START OF ANY DEMOLITION OR CONSTRUCTION. SHOULD ANY UTILITY REQUIRE RELOCATION, CONTRACTOR COORDINATE WITH THE OWNER/DEVELOPER'S CONSTRUCTION MANAGER AND THE ENGINEER.

THE CONTRACTOR SHALL BE RESPONSIBLE FOR THE DISCONNECTION OF UTILITY SERVICES TO ANY EXISTING BUILDINGS PRIOR TO DEMOLITION OF THE EXISTING BUILDINGS.

THE CONTRACTOR SHALL MAINTAIN ALL UTILITY SERVICES TO ANY EXISTING BUILDINGS TO REMAIN AT ALL TIMES. UTILITY SERVICES SHALL NOT BE INTERRIPTED WITHOUT APPROVAL FROM AND COORDINATION WITH THE BUILDING OWNER.

THE CONTRACTOR SHALL COORDINATE WITH THE RESPECTIVE UTILITY COMPANES PRIOR TO THE REMOVAL AND/OR RELOCATION OF UTILITES CONCERNING PORTIONS OF WORK WHICH MAY BE PERFORMED BY THE UTILITY COMPANY'S FORCES AND ANY FEES WHICH ARE TO BE PAID TO THE UTILITY COMPANY FOR THEIR SERVICES. THE CONTRACTOR IS RESPONSIBLE FOR PAYING ALL FEES AND CHARGES.

ANY DRY UTILITY LINES NEEDING TO BE REMOVED OR RELOCATED SHALL BE COORDINATED WITH THE AFFECTED UTILITY COMPANY. ADEQUATE TIME SHALL BE PROVIDED FOR RELOCATION. CLOSE COORDINATION WITH THE UTILITY COMPANY IS NECESSARY TO PROVIDE A SMOOTH TRANSITION IN UTILITY SERVICE. CONTINUETOR SHALL PAY CLOSE ATTENTION TO EXISTING UTILITIES WITHIN THE RIGHT OF WAY DURING CONSTRUCTION.

THE CONTRACTOR SHALL COORDINATE WATER MAIN WORK WITH THE FIRE DEPARTMENT AND THE UTILITY COMPANY TO PLAN PROPOSED Improvements and to ensure adequate fire protection is constrainly awalable to the site throughout this specific work and through all phases of construction, contractor will be responsible for Aranacian/Providior any required water main shut offs with the utility company during construction. Any costs associated with water main shut offs will be the responsibility of the contractor.

The contractor is responsible for removing any existing irrigation systems in the areas of proposed improvements. The contractor small CAP any existing irrigation systems to remain such that the remaining systems shall continue to Function property.

existing pavement that will remain after construction shall be protected from damage. Contractor may limit sancut and pavement remain. To only those areas where it is required as shown on these plans, but if any damage is incurred on my of the suproviding pavement, the contractor shall be responsed for its remaind. No repare.

CONTRACTOR IS RESPONSIBLE FOR REPARING THE DAMAGE DONE TO ANY EXISTING IMPROVEMENTS TO REMAIN DURING CONSTRUCTION, Including, but not limited to, dramage structures, utilities, praement, straffing, cures, etc. Reprints shall be equal to or better than existing conditions and shall be at the contractors previse. Contractors is despensed to document IL EXISTING DAMAGE AND NOTIFY THE OWNER/DEVELOPER'S CONSTRUCTION MANAGER PRIOR TO CONSTRUCTION STAR

PRIOR TO DEMOLITION OCCURRING, ALL EROSION CONTROL DEVICES ARE TO BE INSTALLED.

CONTRACTOR MUST PROTECT THE PUBLIC AT ALL TIMES WITH FENCING, BARRICADES, ENCLOSURES, ETC., (AND OTHER APPROPRIATE BEST MANAGEMENT PRACTICES) AS APPROVED BY THE OWNER/DEVELOPER'S CONSTRUCTION MANAGER.

CONTINUOUS ACCESS SHALL BE MAINTAINED FOR THE SURROUNDING PROPERTIES AT ALL TIMES DURING DEMOLITION OF THE EXISTING

THE CONTRACTOR SHULL RESTORE ALL OFF SITE CONSTRUCTION AREAS TO AN EQUAL OR BETTER CONDITION THAN EXISTED PRIOR TO THE COMMENCEMENT OF WINK





EXTERIOR PHOTO #1 SHOWING REAR OF BUILDING



EXTERIOR PHOTO #2 LOOKING SOUTHWEST



EXTERIOR PHOTO #3 LOOKING SOUTHEAST



EXTERIOR PHOTO #4 SHOWING BUILDING ENTRANCE



INTERIOR PHOTO #1 SHOWING FORMER DINING AREA


INTERIOR PHOTO #2 SHOWING FORMER KITCHEN

INTERIOR PHOTO #3 SHOWING FORMER DINING AREA

INTERIOR PHOTO #4 SHOWING FORMER DINING AREA





EXTERIOR PHOTO #5 SHOWING BUILDING ENTRANCE

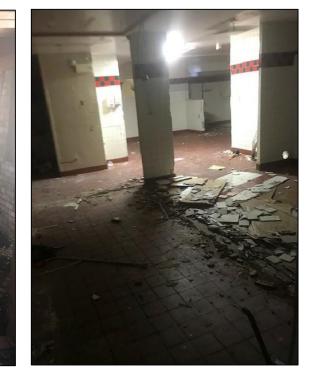

INTERIOR PHOTO #5 SHOWING FORMER KITCHEN


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)					SPECIFICAL SPECIFICAL	ATIONS, ESTIMATES, REPORTS, OR OTHER DOCUMENTS OR INSTRUMENTS NOT		
		_			31191 FOR ANY	EOR, ANY PART OR PARTS OF THE PROJECT TO WHICH THIS PAGE REFERS.	DATE	NO REVISION DESCRIPTION

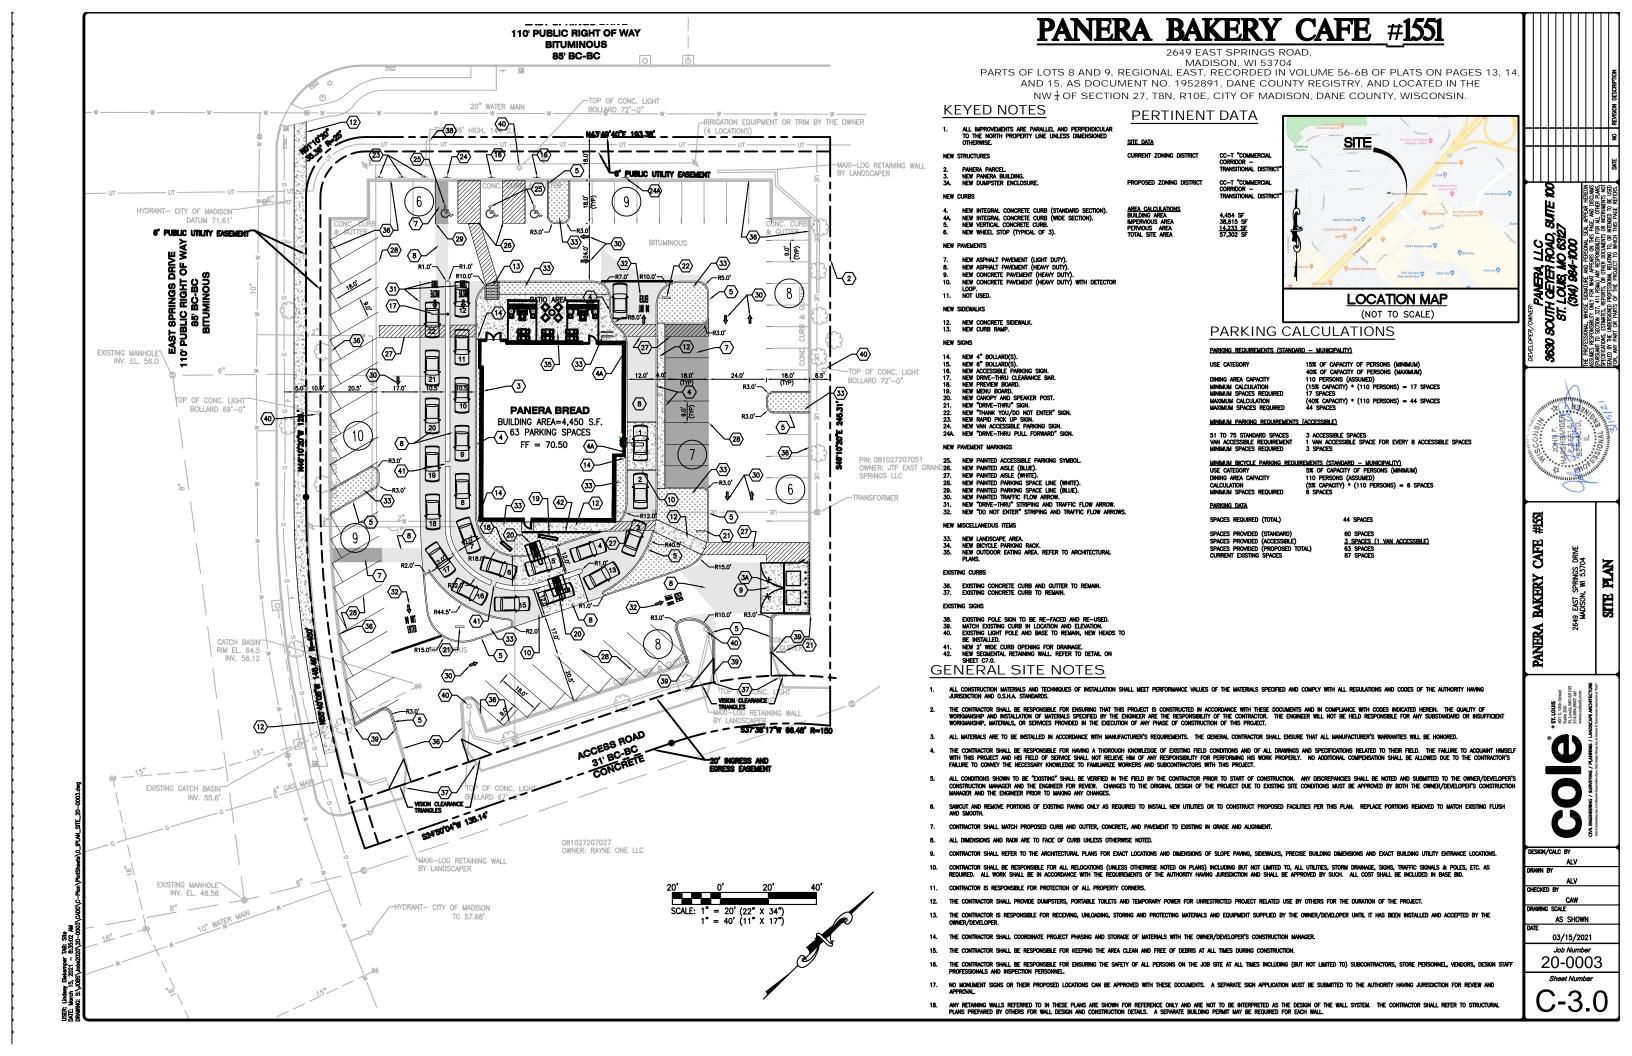


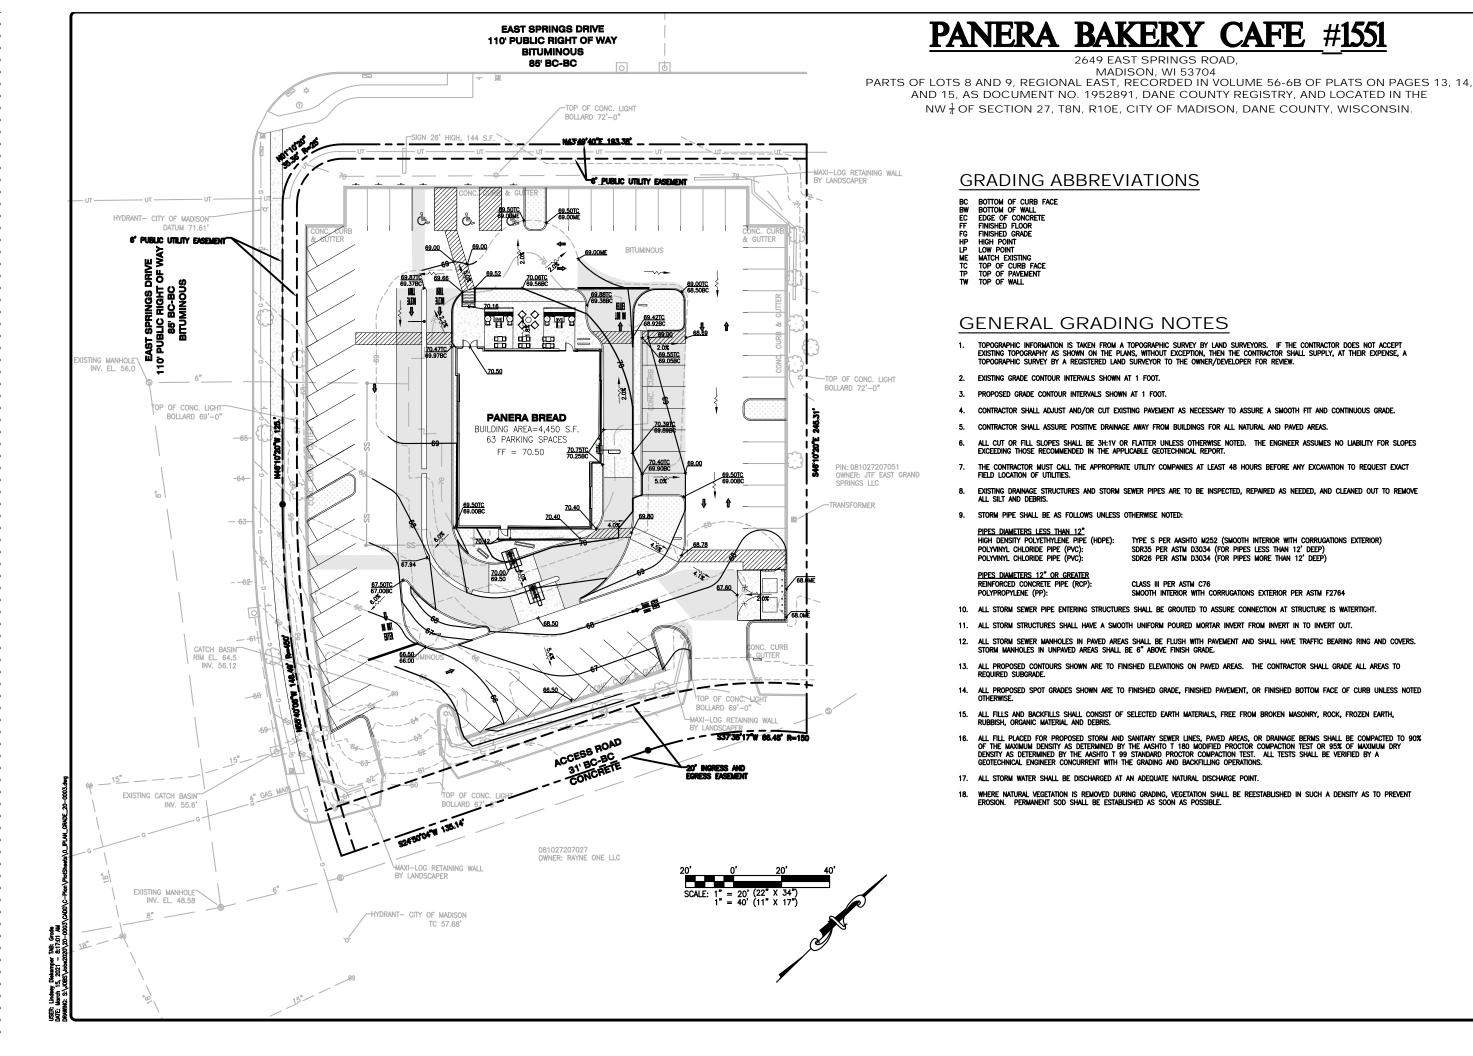

TYPE S PER AASHTO M252 (SMOOTH INTERIOR WITH CORRUGATIONS EXTERIOR) SDR35 PER ASTM D3034 (FOR PIPES LESS THAN 12' DEEP) SDR26 PER ASTM D3034 (FOR PIPES MORE THAN 12' DEEP)

SMOOTH INTERIOR WITH CORRUGATIONS EXTERIOR PER ASTM F2764

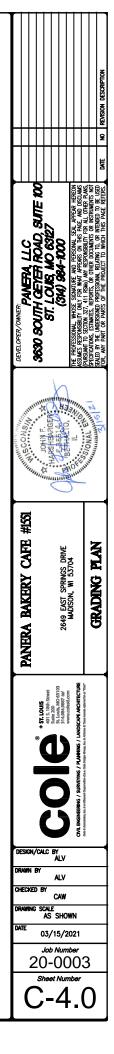

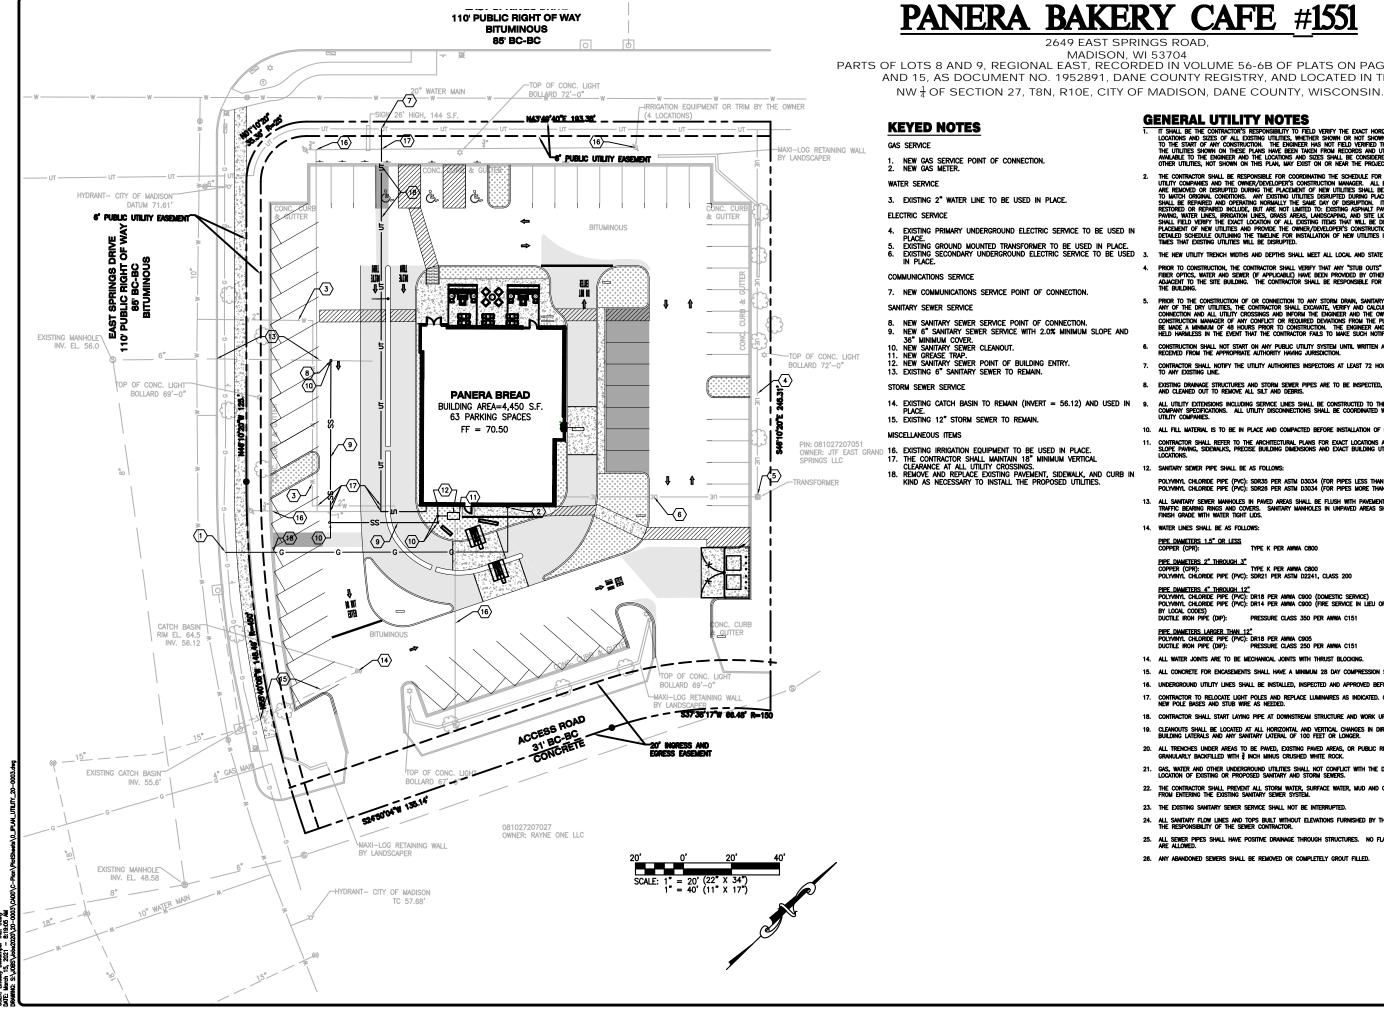


PARTS OF LOTS 8 AND 9, REGIONAL EAST, RECORDED IN VOLUME 56-6B OF PLATS ON PAGES 13, 14, AND 15, AS DOCUMENT NO. 1952891, DANE COUNTY REGISTRY, AND LOCATED IN THE


GENERAL UTILITY NOTES

- 1. IT SHALL BE THE CONTRACTOR'S RESPONSIBILITY TO FIELD VERIFY THE EXACT HORIZONTAL AND VERTICAL LOCATIONS AND SIZES OF ALL EXISTING UTILITES, WHETHER SHOWN OR NOT SHOWN IN THESE PLANS, PAR TO THE STATT OF ANY CONSTRUCTION. THE EXISTING UTILITES, WHETHER HAS NOT FIELD VERIFIED THE DISTING UTILITES, THE UTILITIES SHOWN ON THESE PLANS HAVE BEEN TAKEN FROM RECORDS AND UTILITY MANY AND EXIST ON OR NEAR THE PROXIMATE ONLY. OTHER UTILITIES, WHETHER UCATIONS AND SIZES SHALL BE CONSIDERED APPROXIMATE ONLY. OTHER UTILITIES, NOT SHOWN ON THIS PLAN, MAY EXIST ON OR NEAR THE PROJECT STE.
- THE CONTRACTOR SHALL BE RESPONSIBLE FOR COORDINATING THE SCHEDULE FOR INSTALLATION WITH THE THE CONTRACTOR SHALL BE RESPONSIBLE FOR COORDINATING THE SCHEDULE FOR INSTALLATION WITH THE UTLITY COMPARES AND THE OWNER/DEVELOPER'S CONSTRUCTION MANAGER. ALL DISTING CONDITIONS THA ARE REMOVED OR DISRUPTED DURING THE PLACEMENT OF NEW UTLITES SHALL BE RESTORED OR REPARED TO MATCH ORGINAL CONDITIONS. MAY DESTING UTLITES SHALL BE RESTORED OR NEW UTLITES SHALL BE REPARED AND OPERATING NORMALLY THE SAME DAY OF DISRUPTION. ITEMS THAT NEED SHALL BE REPARED AND OPERATING NORMALLY THE SAME DAY OF DISRUPTION. ITEMS THAT NEED RESTORED OR REPARED AND OPERATING NORMALLY THE SAME DAY OF DISRUPTION. ITEMS THAT NEED PAVING, WATER LINES, RIRGATON LINES, GRASS AREAS, LANDSCAPING, AND STE LICHTING. THE CONTRACTO SHALL FIELD VERITY THE DAYL LOCATION OF ALL DISTING TELS THAT WILL BE DISRUPTED DURING THE PLACEDENT OF NEW UTILITIES AND PROVIDE THE OWNER/DEVELOPER'S CONSTRUCTION MANAGE WITH A DETAILED SCHEDULE OUTLING THE TOWINE FOR INSTALLATION OF NEW UTILITIES INCLUDING THE TIMES THAT EXISTING UTILITIES WILL BE DISRUPTED.
- THE NEW UTILITY TRENCH WIDTHS AND DEPTHS SHALL MEET ALL LOCAL AND STATE REQUIREMENTS.
- PRIOR TO CONSTRUCTION, THE CONTRACTOR SHALL VERIFY THAT ANY "STUB OUTS" FOR POWER, TELEPHONE, FIBER OPTICS, WATER AND SEWER (IF APPLICABLE) HAVE BEEN PROVIDED BY OTHERS AT THE AREA ADJACENT TO THE STEE BUILDING. THE CONTRACTOR SHALL BE RESPONSIBLE FOR FINAL CONNECTIONS AT THE BUILDING.
- 5. PRIOR TO THE CONSTRUCTION OF OR CONNECTION TO ANY STORM DRAIN, SANITARY SEWER, WATER MAIN OR ANY OF THE DRY UTILITES, THE CONTRACTOR SHALL EXCAVATE, VERY AND CALCULATE ALL POINTS OF CONNECTION AND ALL UTILITY COSSINGS AND INFORM THE DENGREER AND THE OWNER/DEVELOPER'S CONSTRUCTION MANAGER OF ANY CONFLICT OR REQUIRED DEVATIONS FROM THE FLAM. NOTIFICATION SHALL BE MADE A MINIMUM OF 48 HOURS PROR TO CONSTRUCTION. THE ENGINEER AND TS CLEARTS SHALL BE HELD HARMLESS IN THE EVENT THAT THE CONTRACTOR FALS TO MME SUCH NOTIFICATION.
- CONSTRUCTION SHALL NOT START ON ANY PUBLIC UTILITY SYSTEM UNTIL WRITTEN APPROVAL HAS BEEN RECEIVED FROM THE APPROPRIATE AUTHORITY HAVING JURISDICTION.
- CONTRACTOR SHALL NOTIFY THE UTILITY AUTHORITIES INSPECTORS AT LEAST 72 HOURS BEFORE CONNECTIN
- Existing drainage structures and storm sewer pipes are to be inspected, repaired as needed, and cleaned out to remove all silt and debris.
- ALL UTILITY EXTENSIONS INCLUDING SERVICE LINES SHALL BE CONSTRUCTED TO THE APPROPRIATE UTILITY COMPANY SPECIFICATIONS. ALL UTILITY DISCONNECTIONS SHALL BE COORDINATED WITH THE DESIGNATED UTILITY COMPANIES.
- 10. ALL FILL MATERIAL IS TO BE IN PLACE AND COMPACTED BEFORE INSTALLATION OF PROPOSED UTILITIES.
- Contractor shall refer to the architectural plans for exact locations and dimensions of slope paying, sidewalks, precise building dimensions and exact building utility entrance locations.
- 12. SANITARY SEWER PIPE SHALL BE AS FOLLOWS: POLYVIN'L CHLORIDE PIPE (PVC): SDR35 PER ASTM D3034 (FOR PIPES LESS THAN 12' DEEP) POLYVIN'L CHLORIDE PIPE (PVC): SDR26 PER ASTM D3034 (FOR PIPES MORE THAN 12' DEEP)
- All sanitary sever manholes in paved areas shall be flush with pavement, and shall have traffic bearing rinks and covers. Sanitary manholes in unpaved areas shall be 12" above rinks (rouge with water tight lug).
- 14. WATER LINES SHALL BE AS FOLLOWS:
- PIPE DIAMETERS 1.5" OR LESS COPPER (CPR): TYPE K PER AWWA C800

<u>PIPE DAMETERS 2" THROUGH 3"</u> COPPER (CPR): TYPE K PER AWWA C800 POLYVINYL CHLORIDE PIPE (PVC): SDR21 PER ASTM D2241, CLASS 200 PIPE DAMAFTERS 4" THROUGH 12" POLVINIL CHLORIDE PIPE (PVC): DR18 PER ANNA C900 (DOMESTIC SERVICE) POLVINIL CHLORIDE PIPE (PVC): DR14 PER ANNA C900 (FIRE SERVICE IN LIEU OF DIP, WHERE ALLOWED BY LOCAL CODES) DUCTILE IRON PIPE (DIP): PRESSURE CLASS 350 PER AWWA C151

- <u>PIPE DAMETERS LARGER THAN 12"</u> POLYMINT, CHLORIDE PIPE (PVC): DR18 PER AWWA C905 DUCTILE IRON PIPE (DIP); PRESSURE CLASS 250 PER AWWA C151
- ALL WATER JOINTS ARE TO BE MECHANICAL JOINTS WITH THRUST BLOCKING.
- IL CONCRETE FOR ENCASEMENTS SHALL HAVE A MINIMUM 28 DAY COMPRESSION STRENGTH AT 3000 P.S.
- UNDERGROUND UTILITY LINES SHALL BE INSTALLED, INSPECTED AND APPROVED BEFORE BACKFILLING.
- NTRACTOR TO RELOCATE LIGHT POLES AND REPLACE LUMINAIRES AS INDICATED, CONTRACTOR TO BUILD W POLE BASES AND STUB WIRE AS NEEDED. CONTRACTOR SHALL START LAYING PIPE AT DOWNSTREAM STRUCTURE AND WORK UPSTREAM
- 19. CLEANOUTS SHALL BE LOCATED AT ALL HORIZONTAL AND VERTICAL CHANGES IN DIRECTION OF FLOW IN BUILDING LATERALS AND ANY SANITARY LATERAL OF 100 FEET OR LONGER. ALL TRENCHES UNDER AREAS TO BE PAVED, EXISTING PAVED AREAS, OR PUBLIC RIGHT-OF-WAY SHALL BE
- WULARLY BACKFILLED WITH & INCH MINUS CRUSHED WHITE ROCK. GAS, WATER AND OTHER UNDERGROUND UTILITIES SHALL NOT CONFLICT WITH THE DEPTH OR HORIZONTAL LOCATION OF EXISTING OR PROPOSED SANITARY AND STORM SEWERS.
- THE CONTRACTOR SHALL PREVENT ALL STORM WATER, SURFACE WATER, MUD AND CONSTRUCTION DEBRIS FROM ENTERING THE EXISTING SANITARY SEWER SYSTEM.
- 23. THE EXISTING SANITARY SEWER SERVICE SHALL NOT BE INTERRUPTED
- 24. ALL SANITARY FLOW LINES AND TOPS BUILT WITHOUT ELEVATIONS FURNISHED BY THE ENGINEER SHALL BE THE RESPONSIBILITY OF THE SEVER CONTRACTOR. 25. ALL SEVER PIPES SHALL HAVE POSITIVE DRAINAGE THROUGH STRUCTURES. NO FLAT INVERT STRUCTURES ARE ALLOWED.
- 26. ANY ABANDONED SEWERS SHALL BE REMOVED OR COMPLETELY GROUT FILLED.

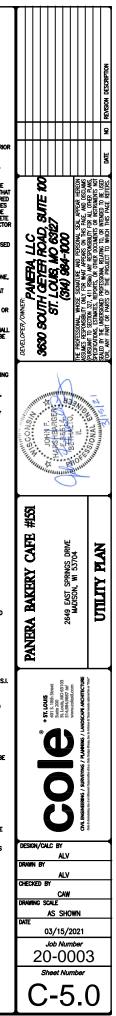


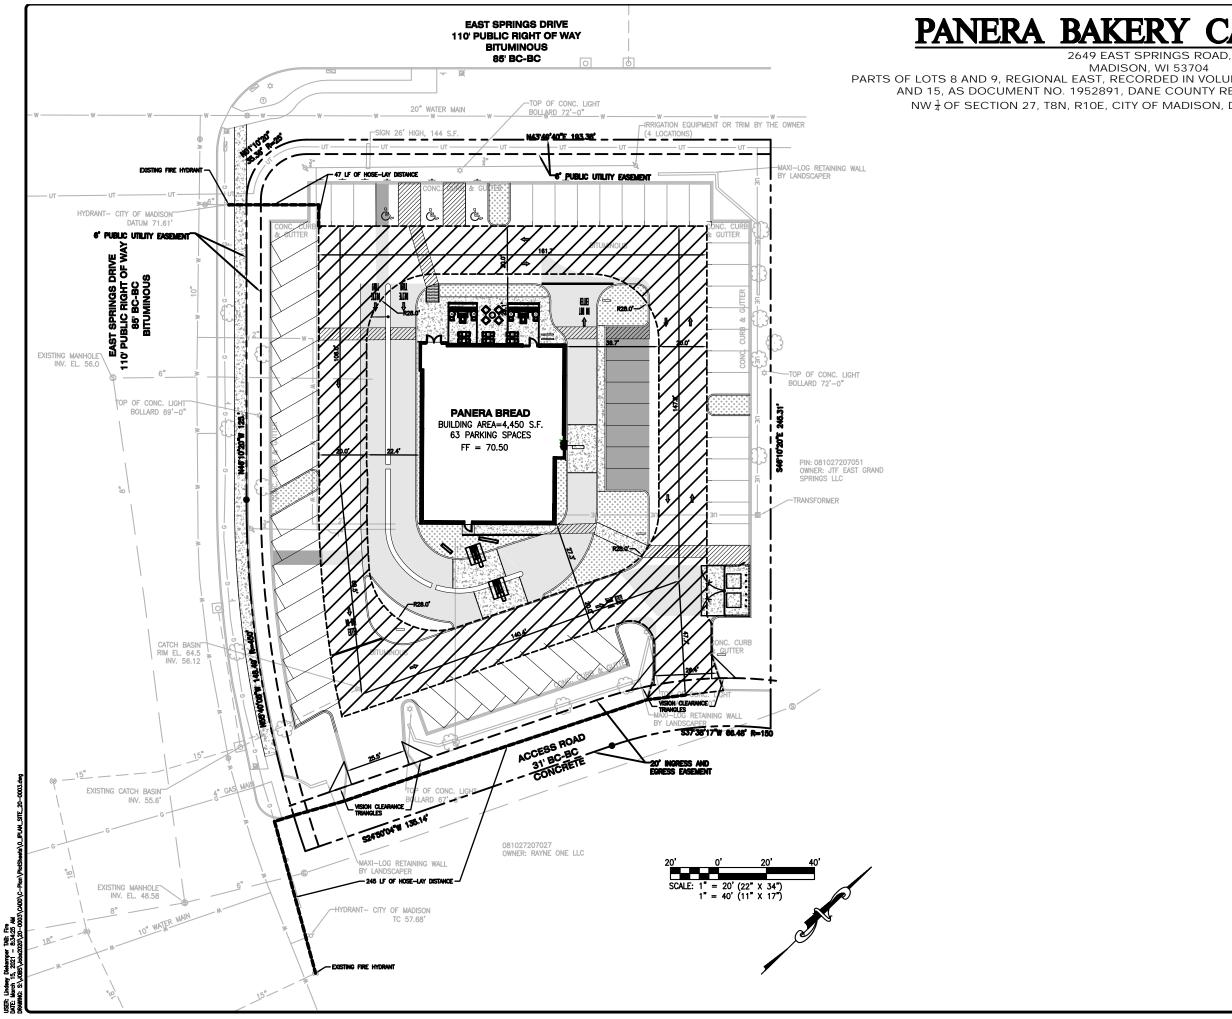

PANERA BAKERY CAFE #1551


MADISON, WI 53704 PARTS OF LOTS 8 AND 9, REGIONAL EAST, RECORDED IN VOLUME 56-6B OF PLATS ON PAGES 13, 14, AND 15, AS DOCUMENT NO. 1952891, DANE COUNTY REGISTRY, AND LOCATED IN THE NW 1 OF SECTION 27, T8N, R10E, CITY OF MADISON, DANE COUNTY, WISCONSIN.

DEVELOPER/OMMER. PANETRA LLC 3620 SOUTH CETTER POAD, SUTE 100 ST. LOUS NO 63127 ST. L
ANERA BAKERY CAFE #551 2648 EST SPENCE DENC MUDISON, WI 53704 FIRE LANE ACCESS FLAN
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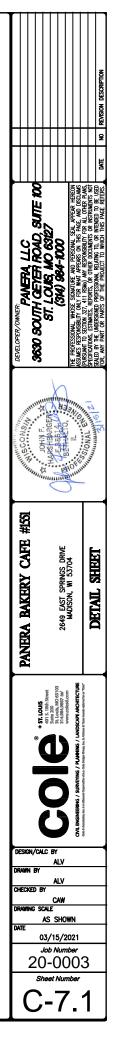


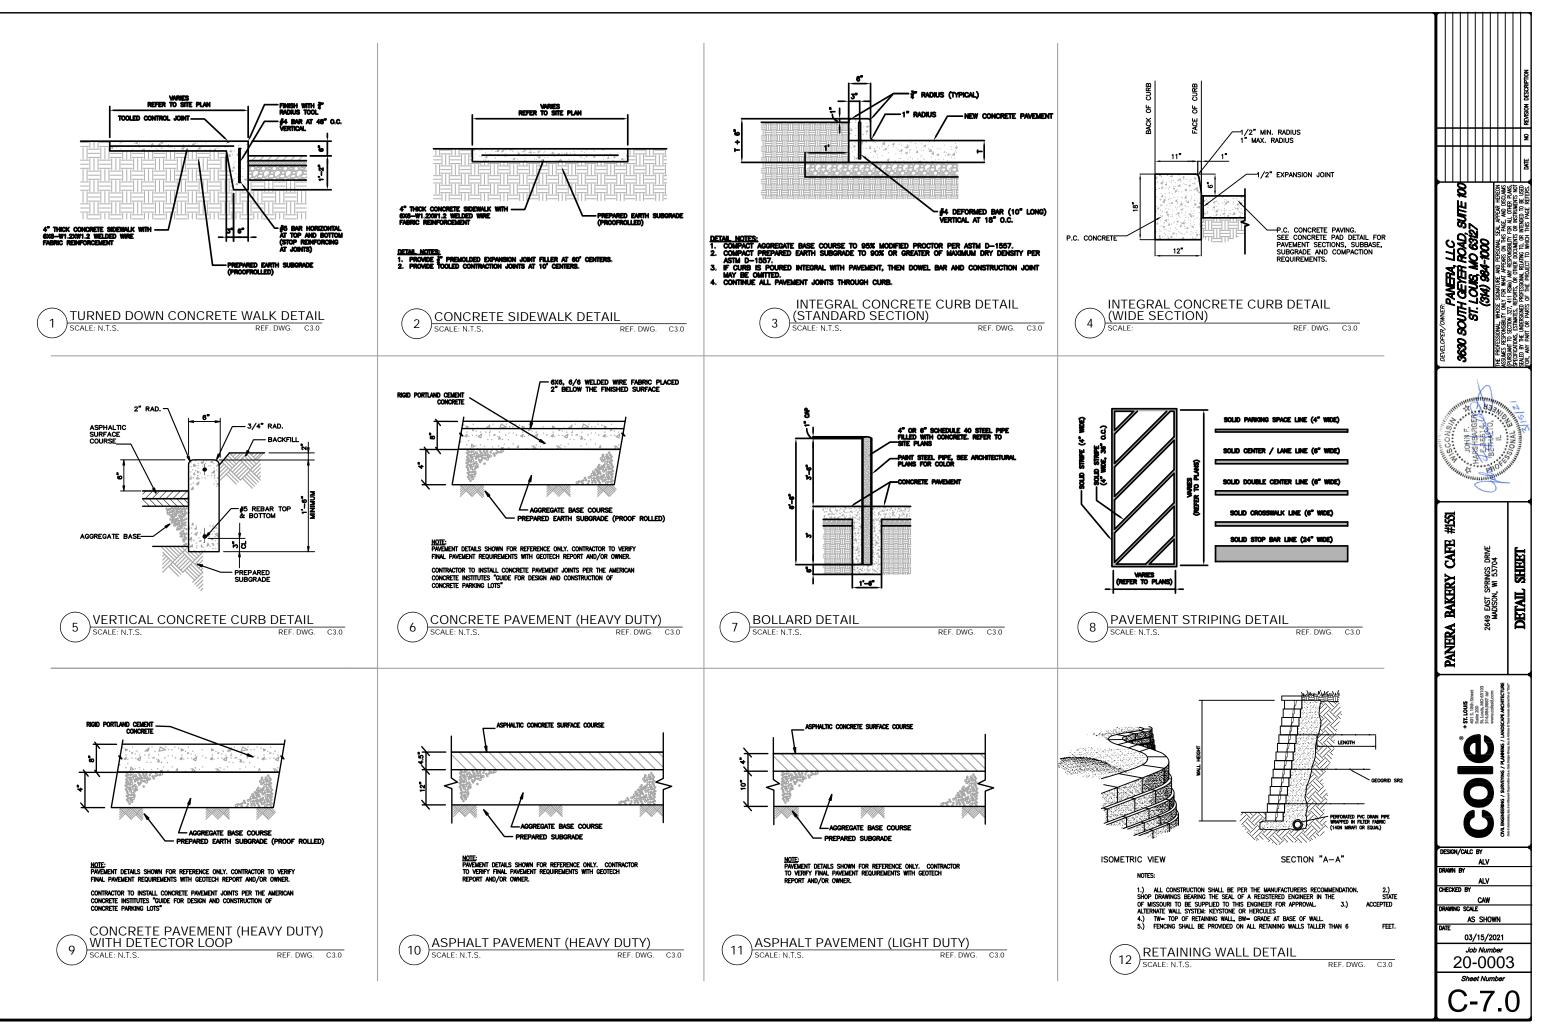
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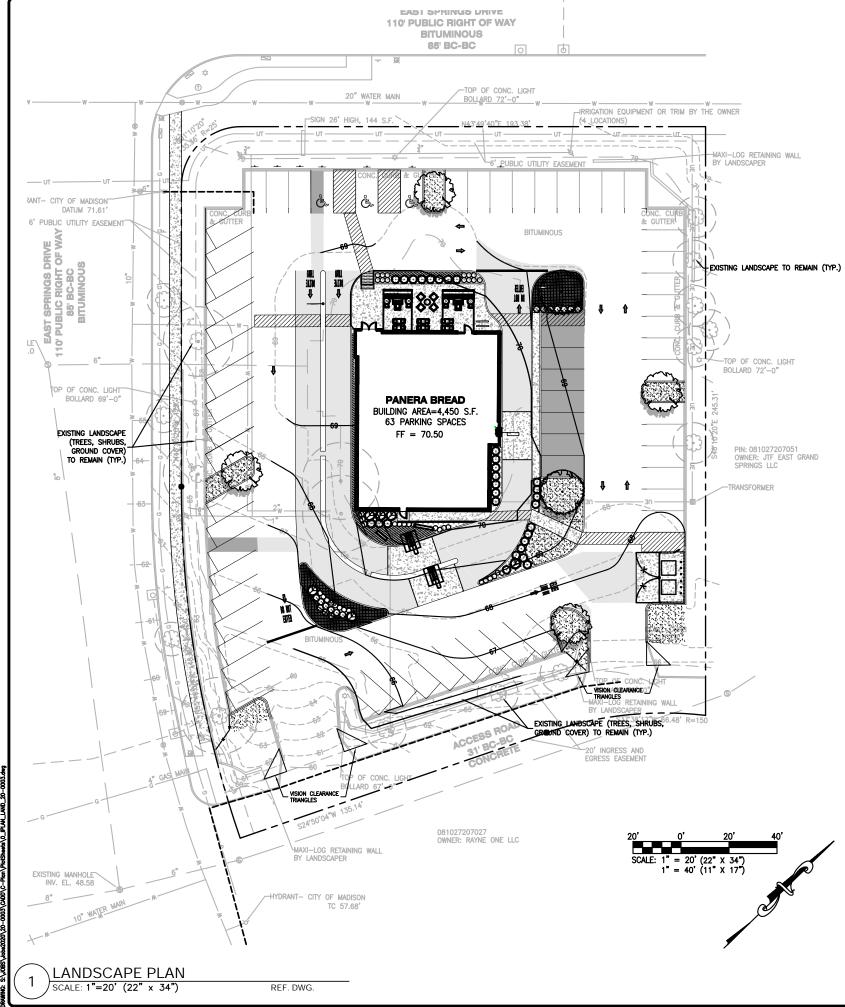


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MB: C7.

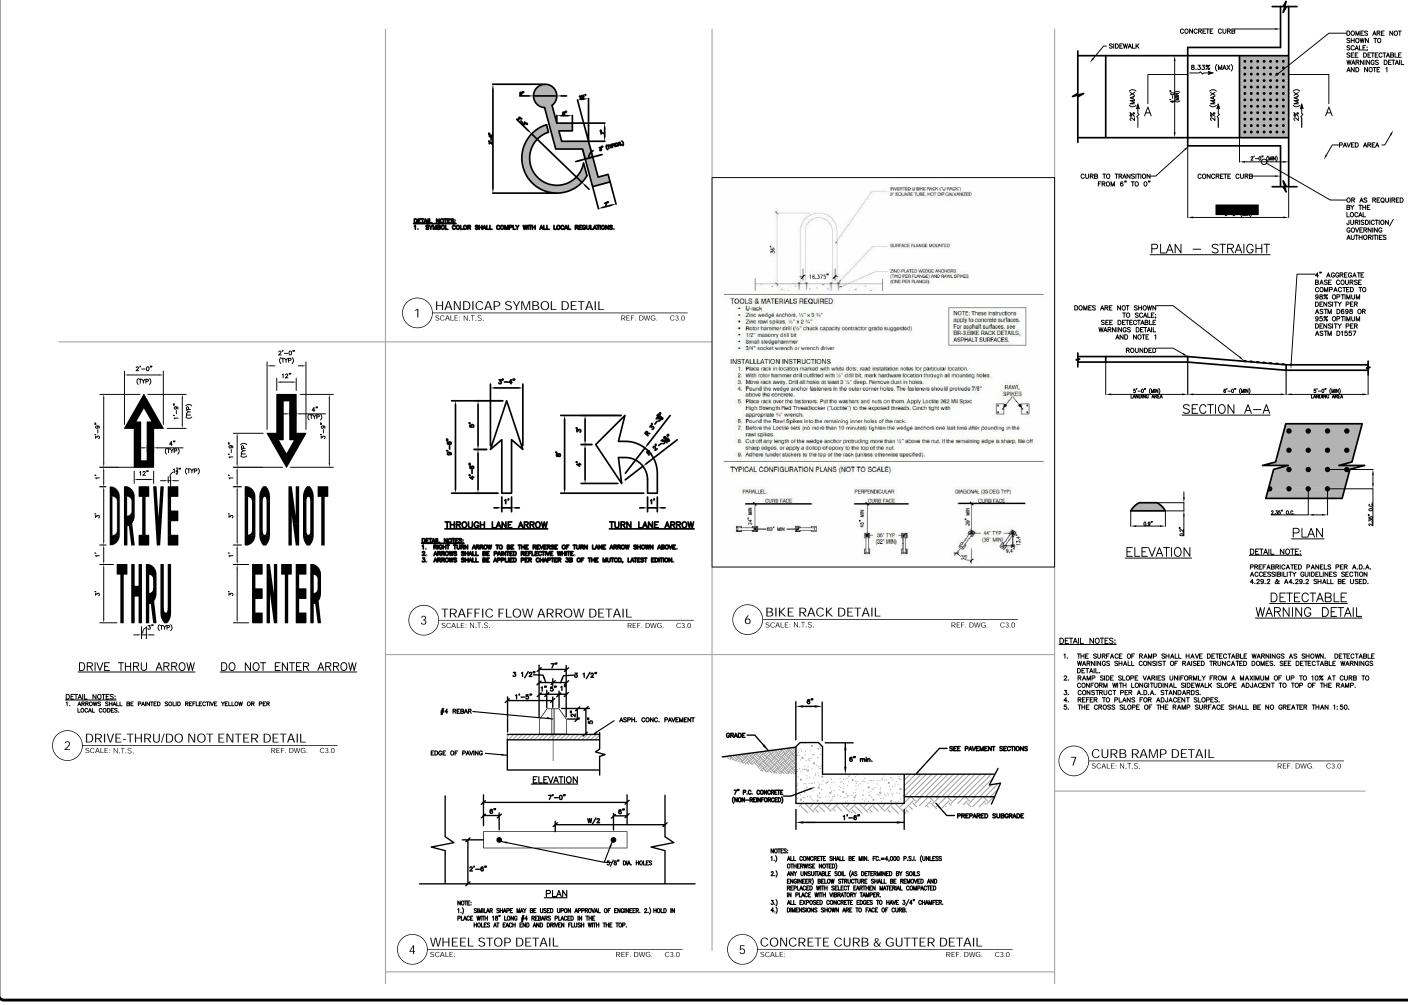

CANOPY TREES	QTY	BOTANICAL NAME	COMMON NAME	SPACING	SIZE	COMMENTS
	4	Gingko biloba	Gingko	As Shown	2.5" Cal. Min.	B&B male cultivars only
\odot	2	Quercus rubra	Red Oak	As Shown	2.5" Cal. Min.	B&B
	· · ·	PL	ANT SCHEDULE			
SHRUBS/ORNAMENTAL GRASS	QTY	BOTANICAL NAME	COMMON NAME	SPACING	SIZE	COMMENTS
Θ	16	Buxus x 'Green Velvet'	Green Velvet Boxwood	As Shown	18" min.	Cont.
Ō	30	Ceanothus americanus	New Jersey Tea	As Shown	24" min.	Cont.
⇔	3	Calamagrostis x acutiflora 'Karl Foerster'	Foerster's Feather Reed Grass	As Shown	2 gal.	Cont.
Ø	6	Juniperus chinensis 'Spearmint'	Chinese juniper	As Shown	4' HT. min.	Cont.
GROUND COVER	QTY	BOTANICAL NAME	COMMON NAME	SPACING	SIZE	COMMENTS
******	150	Sporobolis heterolepis	Prairie Dropseed	2.0' o.c.	1 gal.	Cont.
\bigcirc	36	Andropogon scoparius	Little Bluestem	As Shown	1 gal.	Cont.
ודדדדד	125	Liriope spicata	creeping liriope	1.5' o.c.	1 gal.	Cont.

- MATERIALS AND PRODUCTS PRIOR TO INSTALLATION. THE OWNER'S REPRESENTATIVE/AUNOSCIPE REACHTECT MAY ELECT TO UPSIZE PLANT MATERIAL AT THEIR DISCRETION BASED ON SELECTION, AVAILABILITY, OR TO ENHANCE SPECIFIC AREAS OF THE PROJECT. THE CONTRACTOR SHALL VERIFY PLANT MATERIAL SIZES WITH OWNER'S REPRESENTATIVE/AUNOSCAPE ARCHITECT PROR TO PURCHASING, SHIPPING OR STOCKING OF PLANT MATERIALS. SUBMIT CHANGE ORDER REQUEST TO OWNER'S REPRESENTATIVE/AUNOSCAPE ARCHITECT FOR APPROVAL IF ADDITIONAL COST IS REQUESTED BY THE CONTRACTOR PRIOR TO INSTALLATION. RE-STOCKING CHARGES WILL NOT BE APPROVED IF THE CONTRACTOR FAILS TO SUBMIT A REQUEST FOR MATERIAL CHANGES CONTON PRIOR TO INSTALLATION. RE-STOCKING CHARGES WILL NOT BE APPROVED IF THE CONTRACTOR FAILS TO SUBMIT A REQUEST FOR MATERIAL CHANGES.

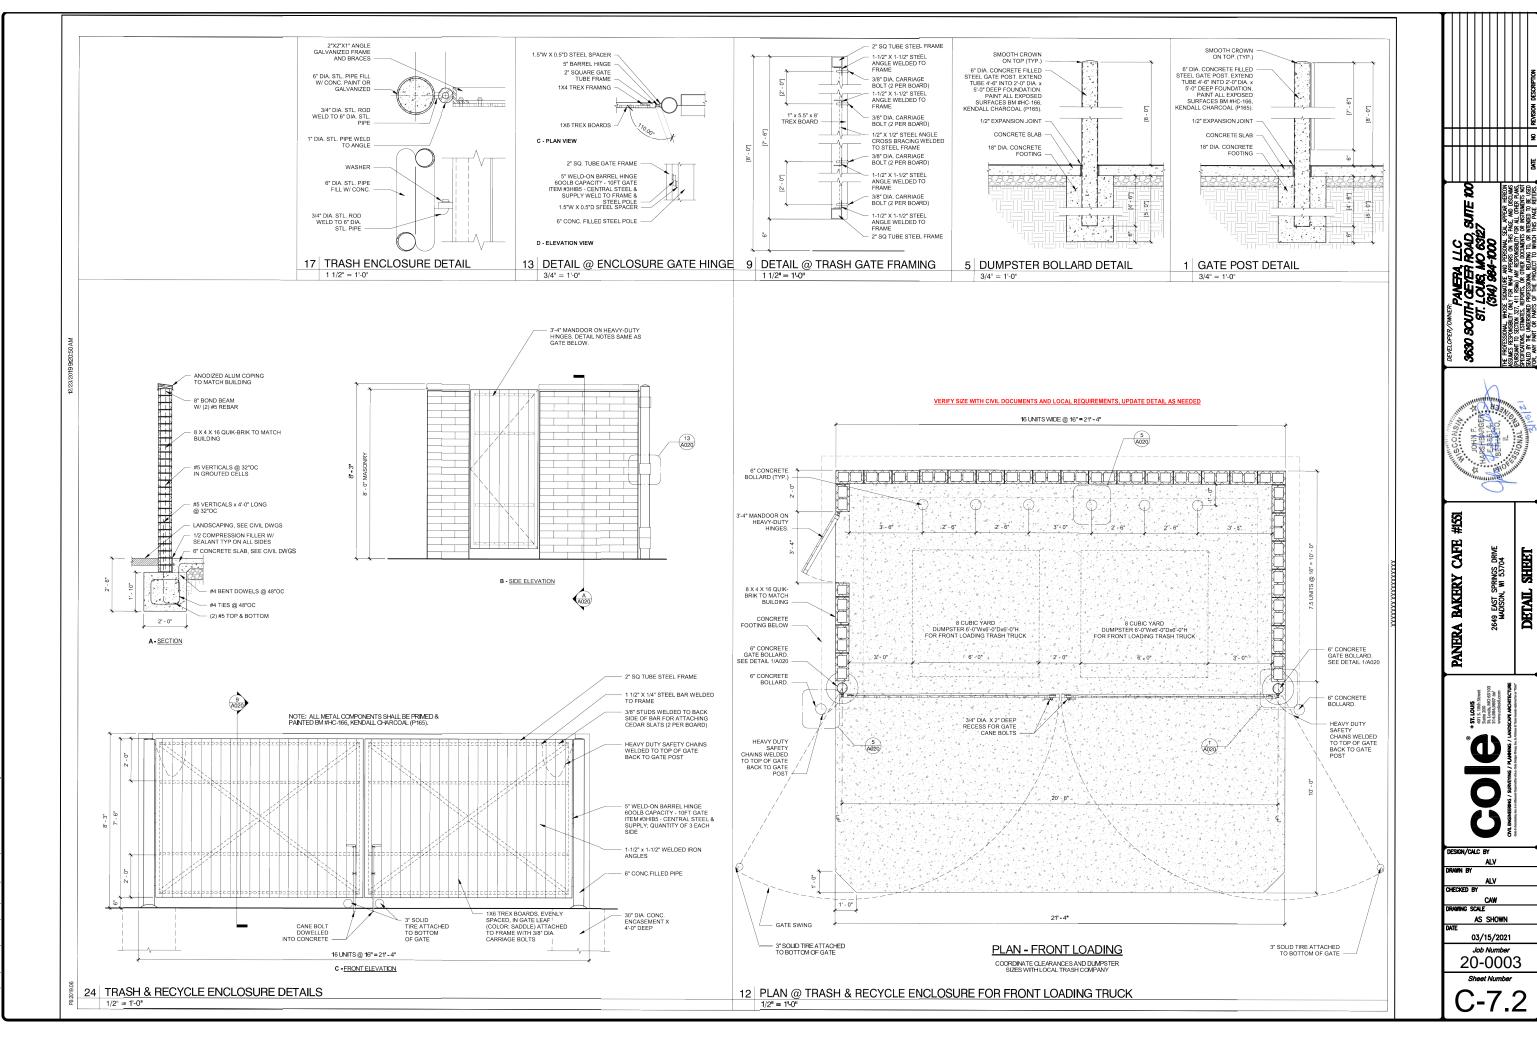- REPRESENTATIVE PRIOR TO REMOVAL.

- SPECIFIED ON THE PLANS.

- RIVER ROCK 5/8"-1" IN SIZE

TAB: L1.0 8:30:18 AM

LANDSCAPE CONTRACTOR TO VERIFY LOCATION OF UNDERGROUND UTILITIES BEFORE BEGINNING WORK.
 ALL LANDSCAPE SHALL COMPLY WITH THE CURRENT EDITION OF ANSI Z 60.1 "AMERICAN STANDARD FOR NURSERY STOCK."
 ALL PLANTS SHALL MEET THE REQUIREMENTS OF THE STATE AND FEDERAL LAW WITH RESPECT TO DISEASE AND INSECT INFESTATION.
 MULCH AREAS WITH TIRFLE GROUND HARDWOOD MULCH 3" MIN. DEPTH.

ALL PLANTS STALL MEET THE REQUIREMENTS OF THE STATE AND FOLDARL DW WITH RESHET 10 DISENSE AND INSECT INFESTIATION.
 MULCH AREAS WITH TIRRLE GROUND HARONOOD MULTS 3' MIN. DEPTH.
 ALL LANDSCAPE SUBSTITUTIONS MUST BE APROVED BY THE OWNER'S REPRESENTATIVE/LANDSCAPE ARCHITECT.
 FORMAL LINES AND GROUPINGS OF A SPECIES OF THEE, SHRILL BO REQUINDENDER SHALL BE MATCHED FOR SIZE, FORM, AND COLOR.
 ALL BRESKING DRUPINGS OF A SPECIES OF THEE, SHRILL BE MATCHED FOR SOLE.
 ALL INES AND GROUPINGS THE AUXCHED FOR SUSCESSINE MONSTURE REASONS.
 ALL INDSCAPTING SHALL BE INSTALLED AS SHALL BE PLANTED WITH A MULCH RING. OBTINN APPROVAL FROM OWNER'S REPRESENTATIVE/LANDSCAPE ARCHITECT FOR ANY THEES THAT WILL NOT BE MULCHED FOR SUSCESSINE MONSTURE REASONS.
 ALL LANDSCAPTING SHALL BE INSTALLED AS SHOWN ON THE APPROVED PLAN.
 AT PLANTING, TREE THAT WILL NOT BE MULCHED FOR SUSCESSINE MONSTURE REASONS.
 ALL LANDSCAPTING SHALL BE OSTANLED AS SHOWN ON THE APPROVED PLAN.
 AFPREVENTING, THE THUNKS MUST BE STRUGHT WITH IN MINIMAL DOGLEGS.
 WIRE BASKETS, BURLAP WRAPPINGS, ROPE, TIMIE OR ANY SMILLAR SHIPPING MATERIALS SHALL BE REMOVED BEFORE PLANTING.
 ASSEE CAIL, PLANS FOR TYPE AND LOCATION SWILE PLANTING BURGESS.
 DO NOT DISTURB DOSTING UTILITIES WITHIN WORK AREA. SLIT FENCE AND PLANTINGS SHALL ANOT ANY EXISTING UTILITES.
 THE CONTRACTOR IS SHALL FOLLOW THE LANDSCAPE PLANS. ANY SUBSTITUTION OR ALTERATION SHALL AND ANY EXISTING WITHOUT APPROVAL OF THE OWNER'S REPRESENTATIVE/LANDSCAPE ARCHITECT. OVERALL PLANT UNMITTY AND QUALITY SMALL BE CONTRACTOR SHALL COLUMNTIES. WATTERS UNATITIES, WITHITES MULTAR DRANDED WITHOUT APPROVAL OF THE OWNER'S REPRESENTATIVE/LANDSCAPE ARCHITECT. OVERLIP PLANT, AND CUALITY SMALL BE CONTRACTOR SHALL POLION THE LANDSCAPE PLANS. ANY SUBSTITUTION OR ALTERATION SHALL AND BAY EXISTING UTILITES. NOTIFY OWNER'S REPRESENTATIVE/LANDSCAPE ARCHITECT.

THE CONTRACTOR SHALL WARRANTY ALL CONTRACTED WORK AND MATERIALS FOR A PERIOD OF ONE YEAR AFTER SUBSTANTIAL COMPLETION HAS BEEN ISSUED BY THE OWNER'S REPRESENTATIVE/LANDSCAPE ARCHITECT FOR THE ENTIRE PROJECT UNLESS OTHERWISE SPECIFIED IN THE CONTRACT DOCUMENTS

ISSUED BY THE OWNER'S REPRESENTAINE/LONUSCHE PAYNTILLE RESPONSIBLE FOR THE INSTALLATION, MAINTENANCE AND REPLACEMENT OF ALL LANDSCAPING OR SPECIFICATIONS.
20. THE DEVELOPER, HIS SUCCESSORS AND ASSIGNS SHALL BE RESPONSIBLE FOR THE INSTALLATION, MAINTENANCE AND REPLACEMENT OF ALL LANDSCAPING IMPERALS SHOWN OR INDICATED ON THE APPROVED LANDSCAPE FUND ON FILE WITH THE FLANNING DEPARTMENT. ALL LANDSCAPING WILL BE INSTALLED AS DELINEATED ON THE FLAN, PRIOR TO ISSUANCE OF CERTIFICATE OF OCCUPANCY.
21. PRIOR TO INSTALLATION OF PLANTI MATERIALS, AREAS THAT HAVE BEEN COMPACTED OR DISTURBED BY CONSTRUCTION ACTIVITY SHALL BE THOROUGHLY LOOSDED TO A DEPTH OF 8^H - 12^{MAI} AMENDED.
23. ALL LANDSCAPED AREAS ARE TO HAVE SOIL PREPARATION, (MINIMUM RATE OF 3 CU. YDS. OF ORGANIC MATTER PER 1000 S.F.). TREES SHALL NOT BE

LOGENED TO A DEPTH OF 8 - 12 AND AMENDED. 22. ALL LANGSARED ARES ANE TO HAVE SOIL PREPARATION, (MINIMUM RATE OF 3 CU. YDS. OF ORGANIC MATTER PER 1000 S.F.). TREES SHALL NOT BE LOCATED IN DRAINAGE SWALES, DRAINAGE AREAS, OR UTILITY EASEMENTS. CONTACT OWNER'S REPRESENTATIVE/LANDSCAPE ARCHITECT FOR RELOCATION OF PLANTS IN QUESTIONABLE AREAS PROR TO INSTALLATION. 23. ALL TREES ARE TO BE STAKED AND GUPDE FOR A PERIOD OF 1 YEAR. THE CONTRACTOR SHALL BE RESPONSIBLE FOR REMOVING STAKES AT THE END OF 1 YEAR RROW ACCEPTINGE OF LIANDSCAPE INSTALLATION BY THE OWNER'S REPRESENTATIVE/LANDSCAPE ARCHITECT. OBTAIN APPROVAL BY OWNER'S TEXTORIZED OF DRAINING OF DRAINING.

24. PLACE PLANT MATERIAL IN SHRUB BED SO THAT ONCE PLANTS GROW TO FULL SIZE THEY ARE FULLY CONTAINED WITHIN THE SHRUB BED AREA AND DO NOT HANG OVER THE EDGER LINE. RUI HWW UYER I HE EUGER LINE. 25. REFER TO IRREATION PLANS FOR LINES AND TYPES OF IRRIGATION DESIGNED FOR THE LANDSCAPE. IN NO CASE SHALL IRRIGATION BE EMITTED WITHIN THE MINIMUM DISTANCE FORD BUILDING OR WALL FOUNDATIONS AS STIPULATED IN THE GEOTECHNICAL REPORT. ALL REFARMED IN THE GEOTECHNICAL REPORT. REPORT.

NO EMITTERS SHALL BE REPLOUISUE THE MINIMUM USINGE AWAY FROM ALL BUILDING YOU WALL FOUNDATION AS STIPULIED IN THE GEDIELINICAL REPORT. 28. LANDSCAPE AREAS SHALL BE IRRIGATED WITH AN AUTOMATIC UNDERGROUND IRRIGATION SYSTEM WITH INDIVIDUAL ZONES FOR TURF AND NON-TURF AREAS, AND MUST INCLUDE A MOSTURE DETECTION DEVICE TO PREVENT OPERATION DURING RAINY PERIODS. TURF AREAS SHALL BE IRRIGATED WITH AN AUTOMATIC POP-UP IRRIGATION SYSTEM. SHRUB AND PERENNIAL BEDS SHALL HAVE DIPI IRRIGATION. 27. LANDSCAPE MATERNI, LOCATIONS SHALL HAVE PREDENCE OVER IRRIGATION MUSTIC AUTOMATIC POP-UP IRRIGATED WITH AN AUTOMATIC POP-UP IRRIGATION SYSTEM. SHRUB AND PERENNIAL BEDS SHALL HAVE DIPI IRRIGATION 20. LANDSCAPE MATERNI, LOCATIONS SHALL HAVE PREDENCE OVER IRRIGATION MUNITIE AND LATERAL LOCATIONS. COORDINATE INSTALL HAVE PRECEDENCE OVER IRRIGATION MUNITIE AND LATERAL 28. THE LANDSCAPE CONTRACTOR SHALL BE RESPONSIBLE FOR DESURING POSITIE DRIVINGE DESTS IN ALL LANDSCAPE MATERIAL. 29. THE LANDSCAPE CONTRACTOR SHALL BE RESPONSIBLE FOR DESURING POSITIE DRIVINGE DEPEMBERIAL. 20. THE LANDSCAPE CONTRACTOR SHALL BE RESPONSIBLE FOR DESURING POSITIE DRIVINGE DEPEMBERIAL. 29. THE LANDSCAPE CONTRACTOR SHALL BE RESPONSIBLE FOR DESURING POSITIE DRIVINGE DEPEMBERIAL. 20. ADSCAPE AREAS SHALL NOT FLOW TOWARD STRUCTURES AND CURRES SHALL DRAIN REDEPT AND FORM FOUNDATIONS PER THE GEDIECHNICAL REPORT REPORTS PARAL IN TO CASE SHALL BE RESPONSIBLE FOR DESURING POSITIE DRIVINGE DEPEMBERIAL DAN WITER AGAINES THE GEDIECHNICAL REPORT REPORTS PARAL IN TO CASE SHALL DE RESPONSIBLE FOR DESURING POSITIE DRIVINGE DEPEMBERIAL DAN TREELY TO THE CURBES OTHERINGE DONTHE CONDUCTORS, ALL LANDSCAPE AREAS BETWEEN WALLS AND CURBES SHALL DRAIN REDEPLY TO THE CURBE UNLESS OTHERINGE DONTHE CRUDING PLAN. IN TO CASE SHALL BE 25% UNLESS SPECIFICALLY IDENTIFIED ON THE PLANS OR APPROVED BY THE OWNER'S REPRESENTATIVE/AUTOMOUS PER THATHERT.


30 ALL SING BEDS ARE TO BE MULCHED WITH MIN. 3" DEPTH, SHREDDED HARDWOOD BARK MULCH. 31. AT SEED AREA BOUNDARES ADJACENT TO EXISTING INATIVE AREAS, OVERLAP ABUTTING INATIVE AREAS BY THE FULL WIDTH OF THE SEEDER. 32. EXISTING TURF AREAS THAT ARE DISTURBED DURING CONSTRUCTION, ESTABLISHMENT AND THE MAINTEWANCE PERIOD SHALL BE RESTORED WITH NEW SOD TO MATCH EXISTING TURF SPECIES. DISTURBED NATIVE AREAS WICH AREA TO REMAIN SHALL BE OVER SEEDED AND RESTORED WITH SPECIFIED SEED MIX.

10 march existing turk species, distorbed mark areas which are to relative space over sedied and restored with specified sedient 33. When complete, all grades shall be within 4-7 1/8° of Finished grades as shown on the plans. These plans are not intended for construction or permitting unless stated in the title block. 34. Drawings are intended to be printed on 22° x 34° paper. Printing these drawings at a different size will impact the scale. Verify the graphic scale before referencing any measurements on these sheets. The recomplicit of these drawings shall be responsible for any errors resulting from incorrect printing, copying, or any other changes that alter the scale of the drawings.

35. VERIFY ALL PLAN DIMENSIONS PRIOR TO START OF CONSTRUCTION. NOTIFY THE OWNER'S REPRESENTATIVE TO ADDRESS ANY QUESTIONS OR CLARIFY ANY DISCREPANCIES.

DISCREPANCIES. 36. WRITEN DURINSIONS TAKE PRECEDENCE OVER SCALED DIMENSIONS. 37. SUBMIT A CHANGE ORDER FOR APPROVAL FOR ANY CHANGES TO WORK SCOPE RESULTING FROM FIELD CONDITIONS OR DIRECTION BY OWNER'S REPRESENTATIVE WHICH REQUIRE ADDITIONAL COST TO THE OWNER PROR TO PERFORMANCE OF WORK. 38. A METAL EQGE SHALL BE CREATED AT ALL LOCATIONS WHERE DECORATIVE GRAVEL SHALL COME FROM GREENSTONECOMPANY.COM AND BE STONY CREEK PROB. DOVG 4.64°. 'S IN STREE.

	DA	CH DR	DR					DEVELOPER/OWNER:		
	TE	ECI	.SIG			I PANFRA RAKFRY CAFF #159	MIL SOLONS MIL	PANERA // C		
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s/	0) B S(CA 3Y				DOACH SA	ן מסט פטעוה עבובה הטאני, שעוב ועין		
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mt	20:)	www.colestl.com	MADISON, WI 53704	N.N.	THE DEVELOCIONAL WHOLE SUMPLIES AND DESCAME SEAL ADDEAD HEREON		
	21			CIVIL ENGINEERING / SUR	onil engineering / survening / planning / landscape architecture		SONAL ENGINE	LITE FROFESSIONAL, THOSE SIGNATIONE AND FERSIONAL SEAL AFFEAN THEASUN ASSUMPS RESPONSIBILITY ONLY FOR WHAT ADDEADS ON THIS PACE AND DISCLAMS		
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)	2							SPECIFICATIONS, ESTIMATES, REPORTS, OR OTHER DOCUMENTS OR INSTRUMENTS NOT		
							1202.21.6	Staled by the undersigned professional relating to, or intended to be used for, any part or parts of the project to which this page refers.	DATE	NO REVISION DESCRIPTION

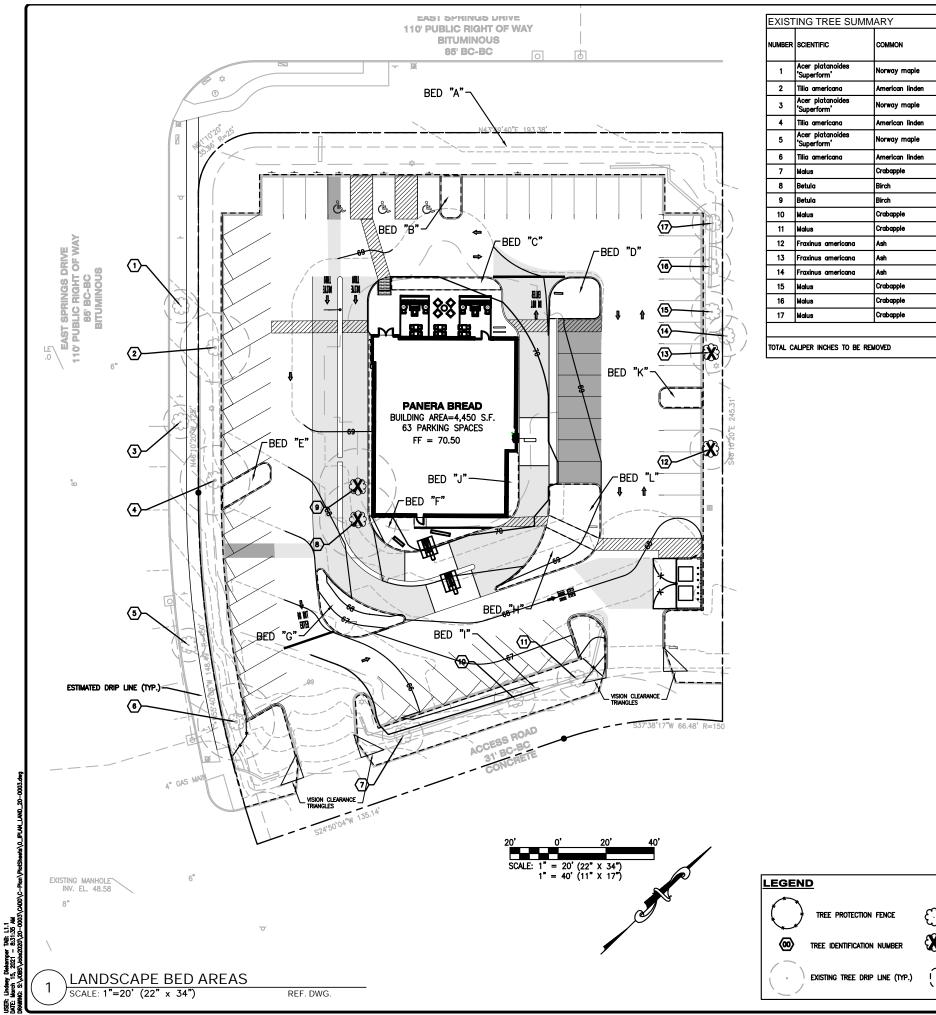

EXIST	ING TREE SUM	MARY					
NUMBER	SCIENTIFIC	COMMON	SIZE (caliper inch)	ON-SITE	TO REMAIN / REMOVE	CONDITION	CALIPER INCHES REQUIRED TO BE REPLACED
1	Acer platanoides 'Superform'	Norway maple	6	NO	REMAIN	GOOD	0
2	Tilia americana	American linden	12	YES	REMAIN	GOOD	0
3	Acer platanoides 'Superform'	Norway maple	6	NO	REMAIN	GOOD	0
4	Tilia americana	American linden	12	YES	REMAIN	GOOD	0
5	Acer platanoides 'Superform'	Norway maple	6	NO	REMAIN	GOOD	0
6	Tilia americana	American linden	12	YES	REMAIN	GOOD	0
7	Malus	Crabapple	6	YES	REMAIN	GOOD	0
8	Betula	Birch	8	YES	REMOVE	GOOD	8
9	Betula	Birch	8	YES	REMOVE	GOOD	8
10	Malus	Crabapple	6	YES	REMAIN	GOOD	0
11	Malus	Crabapple	6	YES	REMAIN	GOOD	0
12	Fraxinus americana	Ash	10	YES	REMOVE	POOR-DEAD	0
13	Fraxinus americana	Ash	10	YES	REMOVE	POOR-DYING	0
14	Fraxinus americana	Ash	10	NO	REMAIN	POOR-DYING	0
15	Malus	Crabapple	8	YES	REMAIN	GOOD	0
16	Malus	Crabapple	8	YES	REMAIN	GOOD	0
17	Malus	Crabapple	10	YES	REMAIN	GOOD	0
TOTAL C	ALIPER INCHES TO BE R	EMOVED					16.0

	6	YES	REMAIN	GOOD	0								
	8	YES	REMOVE	GOOD	8		F	448.7	336.5	448.7 - 100%	SHRUBS & VEG. GROUND COVER	B PLANS,	
	8	YES	REMOVE	GOOD	8		G	440.6	330.5	440.6 - 100%	SHRUBS & VEG. GROUND COVER	SUTE : A APPEAR HE MGE, AND USC	TO BE
	6	YES	REMAIN	GOOD	0		H	352	264	352 - 100%	SHRUBS & TURF	C APR	ENDED A
	6	YES	REMAIN	GOOD	0			407.6		183.5 - 100%			5 1 1 1 1 1 1 1 1 1 1 1 1 1 1 1 1 1 1 1
	10	YES	REMOVE	POOR-DEAD	0			183.5	137.6	183.5 - 100%	EDISTING & PROPOSED TURF & SHRUBS	HEAD HEAD HEAD HEAD HEAD HEAD HEAD HEAD	
	10	YES	REMOVE	POOR-DYING	0		J	110.7	83	110.7 - 100%			
	10	NO	REMAIN	POOR-DYING	0		К	137.8	103.4	137.8 - 100%	TURF	1 6 2 2 3 3 3 3 3 3 3 3 3 3 3 3 3 3 3 3 3	SIONAL
	8	YES	REMAIN	GOOD	0				280.5	374 - 100%	Shrubs & Turf		PORTS
	8	YES	REMAIN	GOOD	0			374	280.5	3/4 - 100%	Shirues at luna	ST. L	
	10	YES	REMAIN	GOOD	0							ER/OWNER: SOUTH OF ST. LC ST. LC (34) (34) (34) (34) (34) (34) (34) (34)	INDERSI INDERSI
					16.0							DEVELOPER/JONNER. PANETA LLC 3630 SOUTH CETER ROAD, SUTE 100 971, LOUE, MO 6327 1743, 384-2000 RE PROFESSION, WICE SAUNTER AND FERSION ESAME (MEMANTI DE SETINA 237, 411 Feas) WI RESON ESAME (MEMANTI DE SETINA 237, 411 Feas) WI RESONATION FOR ALL ORDE NOR (MEMANTI DE SETINA 237, 411 Feas)	CIFICATIONS, I LED BY THE L
												Eqc.	3.12.2021
						P	LANT PC	DINTS & CR	EDITS			SCONST SCONST JEREMY 715-14 T. LOUIS IISSOURI ONAL ENG	5
				PLANT TYPI	E / ELEMENT	MINIMUM SIZE AT	POINTS	CREDIT / EXISTING	G LANDSCAPING	NEW / PROPOSE	D LANDSCAPING		3
						INSTALLATION		QUANTITY	POINTS	QUANTITY P	OINTS ACHIEVED	PROFILING)
						2 1/2" inch	35	3	ACHIEVED 105	6	210		/
				OVER: DECIDUO	story Us tree	caliper measured diameter at breast height (dbh)		Ĩ				ន្ល	8
					ergreen Ree	5–6 feet tall	35	0	0	0	0	PANERA BAKERY CAFE #153 2649 EAST SPRINGS DRIVE MUDISON, WI 35704	LANDSCAPE AREA CALCS
				ORNAMEN	ital tree	1 1/2" inch caliper	15	6	90	0	0	A BAKERY CAF	PE AR
				UPRIGHT I SH	evergreen Rub	3–4 feet tall	10	0	0	6	60	ERA B	NDSCA
				Shrub, C	eciduous	#3 gallon container size, Min. 12"—24"	3	0	0	30	90	NVA	5
				Shrub, e	VERGREEN	#3 gallon container size, Min. 12"–24"	4	0	0	16	64	T. LOUIS In S. 19th Street une 2004, MO 63103 14,4944,9697 06 14,4944,0679 03 14,4944,0679 03 14,4944,0679 03 14,4044,0070 03 14,4044,0000 03 14,4044,0000000000000000000000000000000	
					iental Ses / Inials	#1 gallon container size, Min. 8"—18"	2	0	0	253	506		
				ORNAME DECORATIV OR	ENTAL / Æ FENCING WALL	n/a	4 per 10 lineal ft.	0	0	0	0		
				Existing s specimi	Significant En tree	Minimum size: 2 1/2" inch caliper dbh. *Trees must be within developed area and cannot comprise more than 30%	14 per caliper inch dbh. Maximum points per tree: 200	0	0	0	0	DESIGN/CALC BY	
				-,		of total require dpoints. * Furniture	5 points	0	0	0	0	JCH Drawn By JCH Checked By	
					CADING	must be within developed area,	per "seat"	-				JDR	
~				FURNIT	Caping Jre for	publically accessible, and						DRAWING SCALE AS SHOWN	
3	EXISTING	tree to f	remain (typ.)	AND/OR	SEATING TRANSIT	cannot compromise						DATE	
8	EXISTING	tree to e	be removed (typ	CÓNNE	CTIONS	compromise more than 5% of total required points.						03/12/2021 Job Number	,
				SUB T	OTALS				195		930	20-0003)
Í	I	plant bei	d boundary (ty	P.)				TOTA	L NUMBER OF POI	INTS PROVIDED	1125	Sheet Number	
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												<u> </u>	

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L	ANDSCAPE	BED CAL	CULATIO	٧S
BED	AREA / MEASUREMENT (S.F.)	REQ'D COVERAGE 75%	PROV'D COVERAGE	VEGETATION TYPE
Α	9416.5	7062.4	9416.5 - 100%	EXISTING TURF
В	143	107.3	143 - 100%	TURF
С	220.3	165.2	220.3 - 100%	SHRUBS & VEG. GROUND COVER
D	332	249	332 - 100%	Shrubs & Veg. Ground Cover
Ε	180	135	180 - 100%	TURF
F	448.7	336.5	448.7 - 100%	SHRUBS & VEG. GROUND COVER
G	440.6	330.5	440.6 - 100%	SHRUBS & VEG. GROUND COVER
Η	352	264	352 - 100%	Shrubs & Turf
I	183.5	137.6	183.5 - 100%	EXISTING & PROPOSED TURF & SHRUBS
J	110.7	83	110.7 - 100%	SHRUBS
K	137.8	103.4	137.8 - 100%	TURF
L	374	280.5	374 - 100%	Shrubs & Turf


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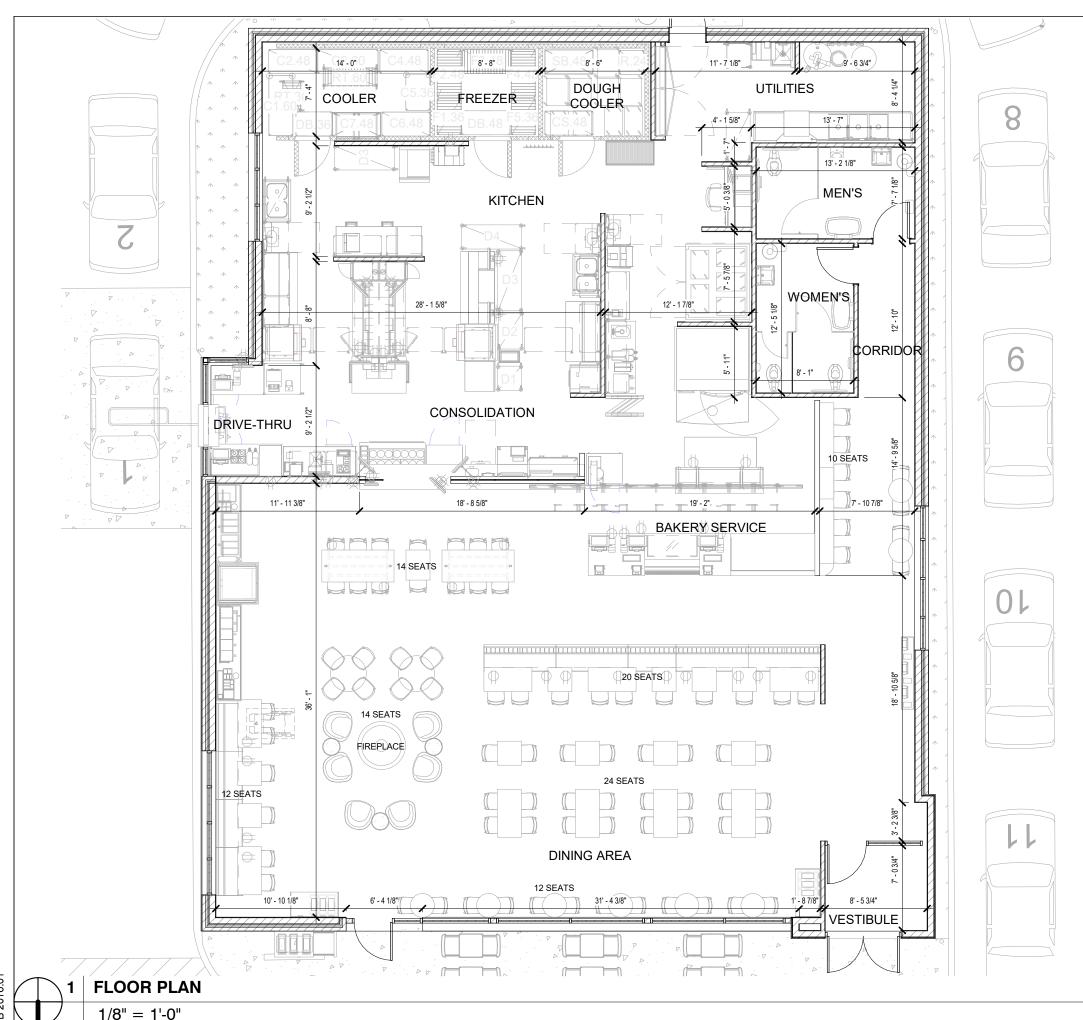
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APPEARS ON THIS In Responsibility Fi Ther documents Relating to, or i Diect to which

LANDSCAPE AREA CALCS

LANDSCAPE	BED	CALCUL	ATIONS



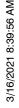

SQUARE FOOTAGE BREAKDOWN

TOTAL SQUARE FEET: 4,450 GROSS SQ. FT.

FRONT OF HOUSE: 2,652 SQ FT. BACK OF HOUSE: 1,798 SQ. FT.


SEATING BREAKDOWN:


INTERIOR SEAT COUNT: 106 INTERIOR TABLE COUNT: 36

2 TOPS:	22	61%
3+ TOPS:	14	39%

EXTERIOR SEAT COUNT: 28 EXTERIOR TABLE COUNT: 13 Bakery-Cafe:

#1551

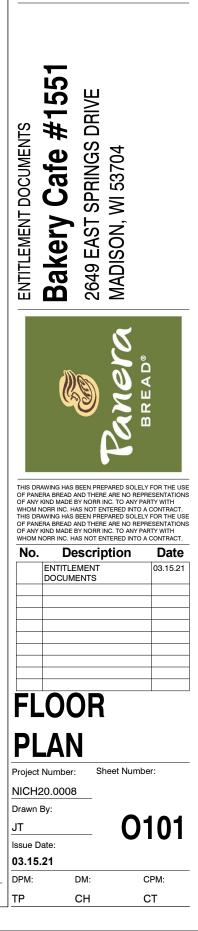

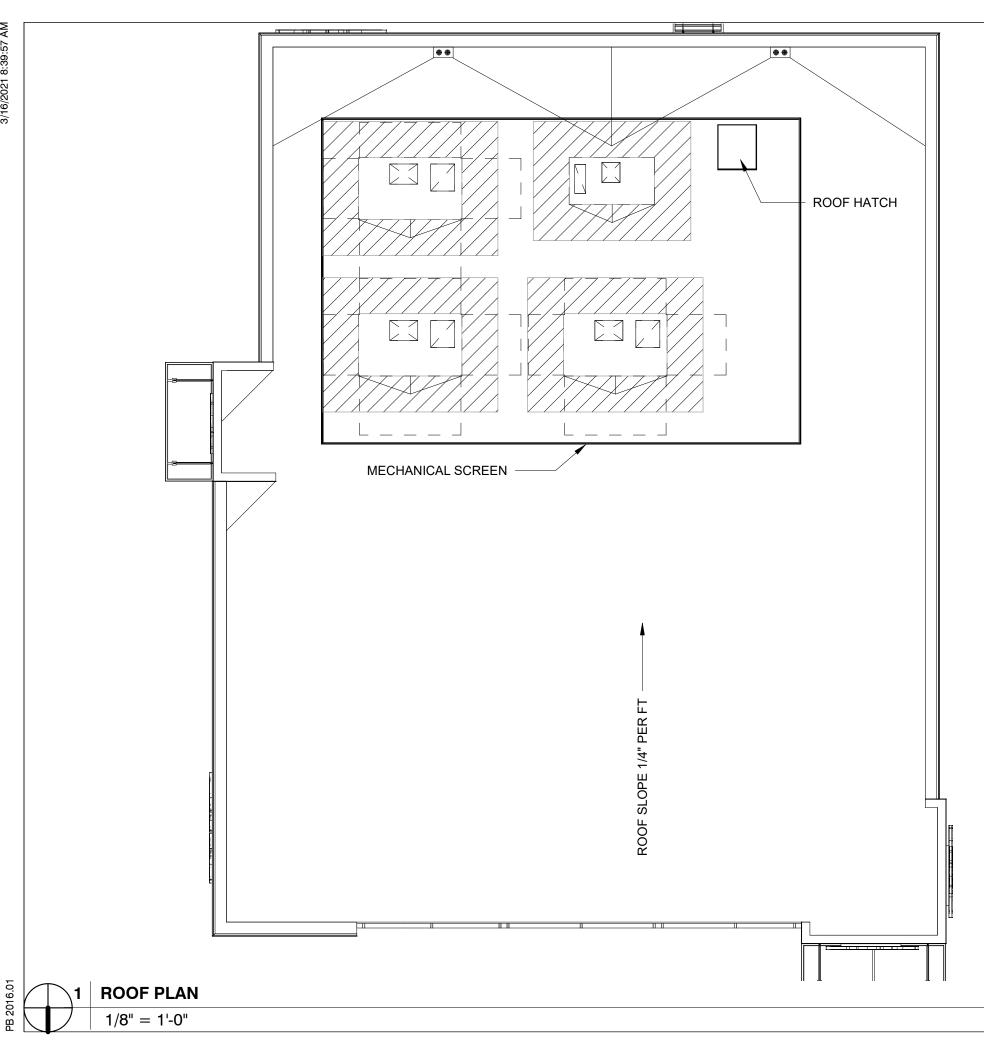

Bakery-Cafe:

#1551

ENTITLEMENT DOCUMENTS Bakery Cafe #1551 2649 EAST SPRINGS DRIVE MADISON, WI 53704



THIS DRAWING HAS BEEN PREPARED SOLELY FOR THE USE OF PANERA BREAD AND THERE ARE NO REPRESENTATIONS OF ANY KIND MADE BY NORR INC. TO ANY PARTY WITH WHOM NORR INC. HAS NOT ENTERED INTO A CONTRACT. THIS DRAWING HAS BEEN PREPARED SOLELY FOR THE USE OF PANERA BREAD AND THERE ARE NO REPRESENTATIONS OF ANY KIND MADE BY NORR INC. TO ANY PARTY WITH WHOM NORR INC. HAS NOT ENTERED INTO A CONTRACT.

No.	Description	Date
	ENTITLEMENT DOCUMENTS	03.15.21

ROOF PLAN

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Project Number: NICH20.0008 Sheet Number:


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Drawn By: JT

> CPM: СТ





#1551

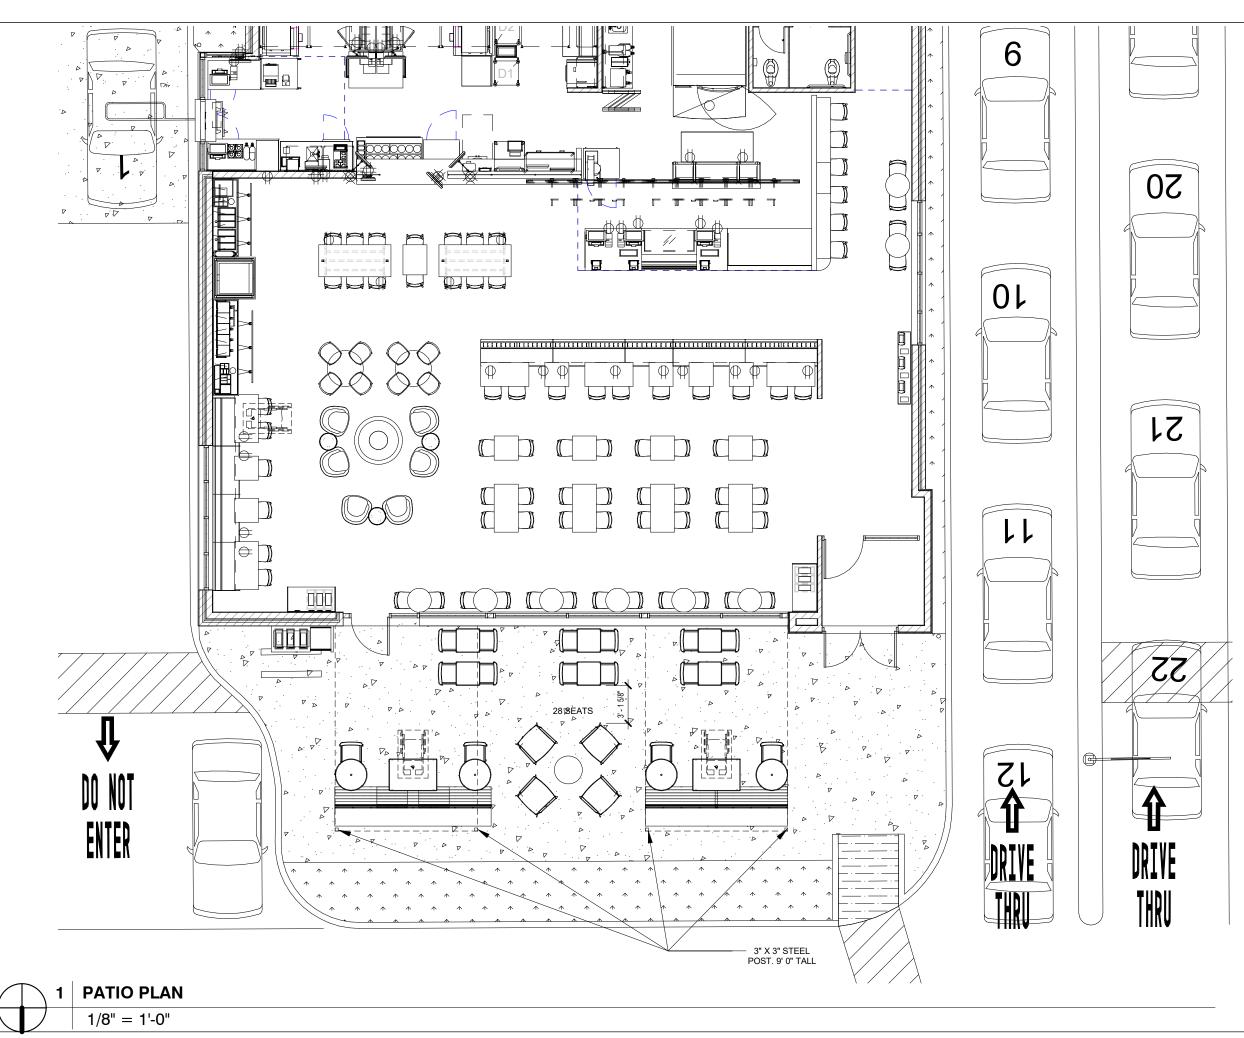Cafe #1551 2649 EAST SPRINGS DRIVE MADISON, WI 53704 ENTITLEMENT DOCUMENTS Bakery



THIS DRAWING HAS BEEN PREPARED SOLELY FOR THE USE OF PANERA BREAD AND THERE ARE NO REPRESENTATIONS OF ANY KIND MADE BY NORR INC. TO ANY PARTY WITH WHOM NORR INC. HAS NOT ENTERED INTO A CONTRACT. THIS DRAWING HAS BEEN PREPARED SOLELY FOR THE USE OF PANERA BREAD AND THERE ARE NO REPRESENTATIONS OF ANY KIND MADE BY NORR INC. TO ANY PARTY WITH WHOM NORR INC. HAS NOT ENTERED INTO A CONTRACT.

No.	Description	Date
	ENTITLEMENT DOCUMENTS	03.15.21

PATIO PLAN Sheet Number

Project Number:

NICH20.0008

Drawn By:

JT

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Issue Date: 03.15.21

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CPM: СТ



PB 2016.01

MCNEAR BRICK & BLOCK; FACE BRICK, 3 5/8"X 3 5/8" X 11 5/8", HORIZONTAL STACK BOND COLOR: SANTIAGO CREATIVE MATERIALS BLEND

MCNEAR BRICK & BLOCK; FACE BRICK, 3 5/8"X 3 5/8" X 11 5/8",

PRECAST CONCRETE BAND: PAINTED. BENJAMIN MOORE EMERALD EXTERIOR ACRYLIC LATEX PAINT COLOR: HOT SPRING STONES #AC-31; FINISH: EGGSHELL

POWDER COAT, COLOR: GREEN, TIGER DRYLAC, CUSTOM

PRE-FINISHED ALUMINUM CANOPY POW DER COAT, COLOR: CHARCOAL, TIGER DRYLAC, TO MATCH RAL 7043, FINISH: MATTE

RIBBED WALL PANEL SYSTEM; POWDER COAT, COLOR: TIGER DRYLAC, CUSTOM COLOR TO MATCH PMS 2307C

PERFORATED METAL PANELS; MCNICHOLS, PERFORATED METAL; ROUND, CARBON STEEL, COLD ROLD, 16 GUAGE, 1/2" ROUND ON 11/16" STAGGERED CENTERS, 48% OPEN AREA;

2" X 4-1/2" PROFILE (OR APPROVED EQUAL) COLOR: CHARCOAL, TIGER DRYLAC, TO MATCH RAL 7043, FINISH: MATTE, GLAZING: 1" INSULATED CLEAR GLASS

COLOR: GREEN, TIGER DRYLAC, CUSTOM COLOR TO MATCH PMS 2307C, GLAZING: 1" INSULATED CLEAR GLASS

ALL EXTERIOR SIGNAGE SHOWN FOR REFERENCE ONLY TO BE APPROVED AND PERMITTED SEPARATELY

Bakery-Cafe:

#1551





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No.	Description	Date
	ENTITLEMENT DOCUMENTS	03.15.21
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ELEVATIONS

Project Number:

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Drawn By:

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Issue Date:

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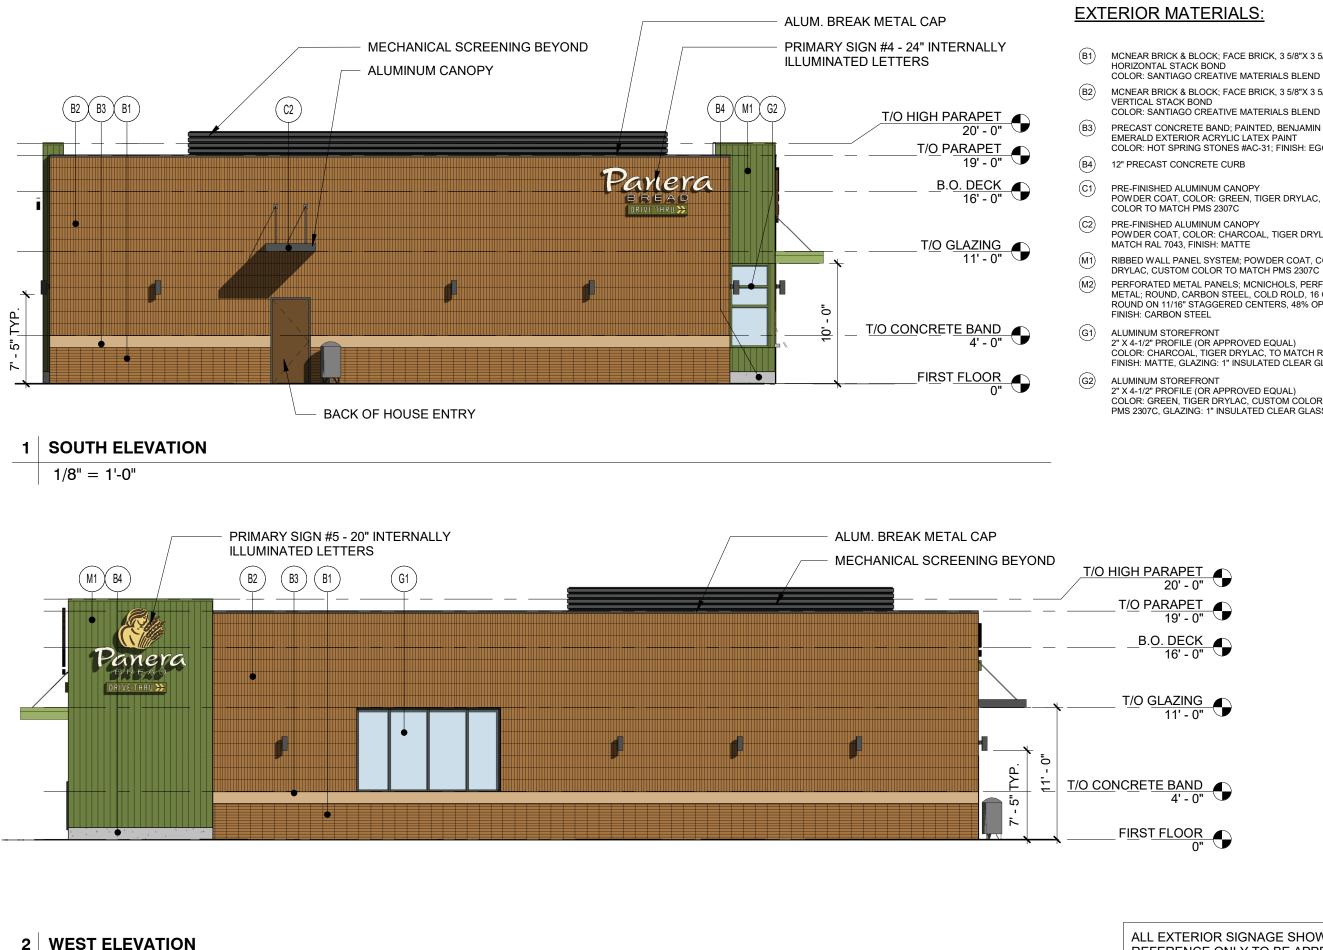
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0104

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2016.01

B

1/8" = 1'-0"

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MCNEAR BRICK & BLOCK; FACE BRICK, 3 5/8"X 3 5/8" X 11 5/8"

MCNEAR BRICK & BLOCK; FACE BRICK, 3 5/8"X 3 5/8" X 11 5/8",

PRECAST CONCRETE BAND; PAINTED, BENJAMIN MOORE EMERALD EXTERIOR ACRYLIC LATEX PAINT COLOR: HOT SPRING STONES #AC-31; FINISH: EGGSHELL

POWDER COAT, COLOR: GREEN, TIGER DRYLAC, CUSTOM

POWDER COAT, COLOR: CHARCOAL, TIGER DRYLAC, TO

RIBBED WALL PANEL SYSTEM; POWDER COAT, COLOR: TIGER DRYLAC, CUSTOM COLOR TO MATCH PMS 2307C

PERFORATED METAL PANELS; MCNICHOLS, PERFORATED METAL; ROUND, CARBON STEEL, COLD ROLD, 16 GUAGE, 1/2" ROUND ON 11/16" STAGGERED CENTERS, 48% OPEN AREA;

2" X 4-1/2" PROFILE (OR APPROVED EQUAL) COLOR: CHARCOAL, TIGER DRYLAC, TO MATCH RAL 7043, FINISH: MATTE, GLAZING: 1" INSULATED CLEAR GLASS

2" X 4-1/2" PROFILE (OR APPROVED EQUAL) COLOR: GREEN, TIGER DRYLAC, CUSTOM COLOR TO MATCH PMS 2307C, GLAZING: 1" INSULATED CLEAR GLASS

ALL EXTERIOR SIGNAGE SHOWN FOR REFERENCE ONLY TO BE APPROVED AND PERMITTED SEPARATELY

Bakery-Cafe:

#1551





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No.	Description	Date
	ENTITLEMENT DOCUMENTS	03.15.21
	DOCOMENTS	

ELEVATIONS

Project Number:

NICH20.0008

Drawn By:

JT

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Issue Date: 03.15.21 DPM: DM:

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Sheet Number

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VIEW FROM NORTHWEST 1

ALL EXTERIOR SIGNAGE SHOWN FOR **REFERENCE ONLY TO BE APPROVED** AND PERMITTED SEPARATELY

MATERIAL SAMPLE BOARD:



FACE BRICK **MCNEAR BRICK & BLOCK** UTILITY SIZE, HORIZONTAL STACK BOND COLOR: SANTIAGO CREATIVE MATERIALS BLEND



FACE BRICK **MCNEAR BRICK & BLOCK** UTILITY SIZE, VERTICAL STACK BOND COLOR: SANTIAGO CREATIVE MATERIALS BLEND

EXTERIOR GRADE POWDERCOAT

COLOR: CUSTOME COLOR TO MATCH

TIGER DRYLAC

PMS 2307C

EXTERIOR ACRYLIC LATEX PAINT BENJAMIN MOORE, EMERALD COLOR: HOT SPRING STONES #AC-31 FINISH: EGGSHELL

EXTERIOR GRADE POWDERCOAT TIGER DRYLAC COLOR: TO MATCH RAL 7043 FINISH: MATTE



PERFORATED METAL MCNICHOLS. PERFORATED METAK ROUND, CARBON STEEL, COLD ROLD, 16 GUAGE, 1/2" ROUND ON 11/16" STAGGERED CENTERS, 48% OPEN AREA

EXTERIOR MATERIALS:

- (B1) HORIZONTAL STACK BOND
- (B2) VERTICAL STACK BOND COLOR: SANTIAGO CREATIVE MATERIALS BLEND
- (B3)
- (B4) 12" PRECAST CONCRETE CURB
- (C1) COLOR TO MATCH PMS 2307C
- (C2) PRE-FINISHED ALUMINUM CANOPY MATCH RAL 7043, FINISH: MATTE
- (M1)
- (M2) FINISH: CARBON STEEL
- ALUMINUM STOREFRONT 2" X 4-1/2" PROFILE (OR APPROVED EQUAL) COLOR: CHARCOAL, TIGER DRYLAC, TO MATCH RAL 7043, (G1)
- (G2) ALUMINUM STOREFRONT 2" X 4-1/2" PROFILE (OR APPROVED EQUAL)

MATERIAL PERCENTAGES:

NORTH ELEVATION: 1,172 SF
B1: 128 SF, 11%
B2: 181 SF, 15%
B3 43 SF 4%

B4: 6 SF, 0.5% C1: 12 SF, 1% C2: 0 SF, 0% M1: 172 SF, 15% M2: 188 SF, 16% G1: 396 SF, 34% G2: 50 SF. 4%

EAST ELEVATION: 1,437 SF B1: 196 SF, 14% B2: 832 SF, 58% B3: 65 SF, 4% B4: 10 SF, 0.5% C1: 10 SF, 0.5% C2: 0 SF. 0% M1: 105, 8% M2: 0 SF, 0% G1: 69 SF, 5% G2: 150 SF, 10%

MCNEAR BRICK & BLOCK; FACE BRICK, 3 5/8"X 3 5/8" X 11 5/8", COLOR: SANTIAGO CREATIVE MATERIALS BLEND

MCNEAR BRICK & BLOCK: FACE BRICK. 3 5/8"X 3 5/8" X 11 5/8".

PRECAST CONCRETE BAND; PAINTED, BENJAMIN MOORE EMERALD EXTERIOR ACRYLIC LATEX PAINT COLOR: HOT SPRING STONES #AC-31; FINISH: EGGSHELL

PRE-FINISHED ALUMINUM CANOPY POWDER COAT, COLOR: GREEN, TIGER DRYLAC, CUSTOM

POWDER COAT, COLOR: CHARCOAL, TIGER DRYLAC, TO

RIBBED WALL PANEL SYSTEM; POWDER COAT, COLOR: TIGER DRYLAC, CUSTOM COLOR TO MATCH PMS 2307C

PERFORATED METAL PANELS; MCNICHOLS, PERFORATED METAL; ROUND, CARBON STEEL, COLD ROLD, 16 GUAGE, 1/2" ROUND ON 11/16" STAGGERED CENTERS, 48% OPEN AREA;

FINISH: MATTE, GLAZING: 1" INSULATED CLEAR GLASS

COLOR: GREEN, TIGER DRYLAC, CUSTOM COLOR TO MATCH PMS 2307C, GLAZING: 1" INSULATED CLEAR GLASS

SOUTH ELEVATION: 1,130 SF

B1: 160 SF, 14% B2: 836 SF. 74% B3: 53 SF, 5% B4: 4 SF, 0.5% C1: 0 SF, 0% C2: 3 SF, 0.5% M1: 47 SF, 4% M2: 0 SF, 0% G1: 0 SF, 0% G2: 27 SF. 2%

WEST ELEVATION: 1,451 SF

B1: 191 SF, 13% B2: 864 SF, 60% B3: 64 SF, 4% B4: 12 SF, 1% C1: 0 SF, 0% C2: 0 SF. 0% M1: 228 SF, 16% M2: 0 SF. 0% G1: 92 SF, 6% G2: 0 SF, 0%

Bakery-Cafe:

#1551

155 SPRINGS DRIVE # DOCUMENTS Cafe 2649 EAST SPRINGS MADISON, WI 53704 ENTITLEMENT akery EAST \mathbf{m}



THIS DRAWING HAS BEEN PREPARED SOLELY FOR THE USE OF PANERA BREAD AND THERE ARE NO REPRESENTATIONS OF ANY KIND MADE BY NORR INC. TO ANY PARTY WITH WHOM NORR INC. HAS NOT ENTERED INTO A CONTRACT. THIS DRAWING HAS BEEN PREPARED SOLELY FOR THE USE OF PANERA BREAD AND THERE ARE NO REPRESENTATIONS OF PANY KIND MADE BY NORR INC. TO ANY PARTY WITH WHOM NORD DRC. HAS NOT ENTERED INTO A CONTRACT. WHOM NORR INC. HAS NOT ENTERED INTO A CONTRACT

No.	Description	Date
	ENTITLEMENT DOCUMENTS	03.15.21

EXT. 3D

Sheet Number Project Number:

NICH20.0008

Drawn By:

JT


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0106

Issue Date:		
03.15.21		
DPM:	DM:	(
TP	СН	(

CPM: СТ



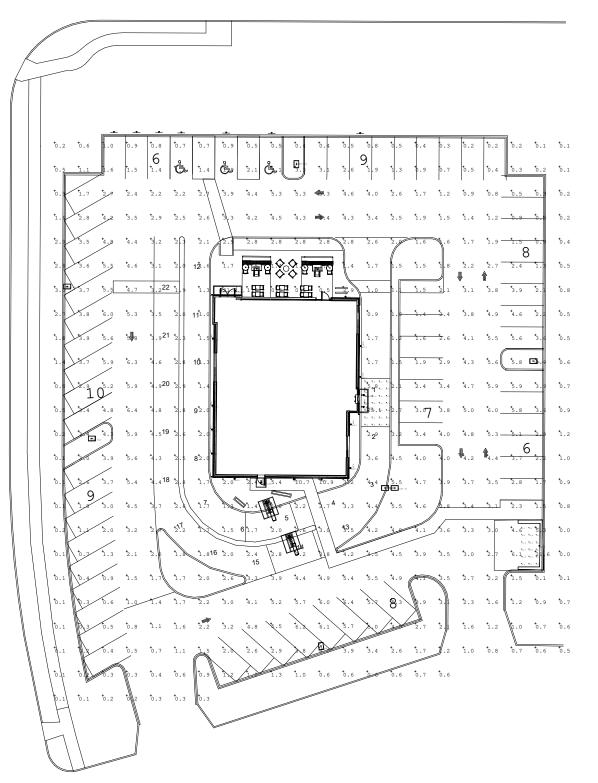

SITE LIGHTING PLAN

1" = 40'-0"

PB 2016.01

Bakery-Cafe:

#1551

Cafe #1551 2649 EAST SPRINGS DRIVE MADISON, WI 53704 ENTITLEMENT DOCUMENTS Bakery

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No.	Description	Date
	ENTITLEMENT DOCUMENTS	03.15.21
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LIGHTING Sheet Number:

СН

Project Number:

NICH20.0008 Drawn By:

TΡ

Author

Issue Date: 03.15.21 DPM: DM: LT01

CPM:

СТ

Avg	Max
7.29	33.0
2.65	25.1
12.32	24.7

CITY OF MADISON FIRE DEPARTMENT



Fire Prevention Division, 325 W. Johnson St., Madison, WI 53703 * Phone: 608-266-4484 * FAX: 608-267-1153

Project Address: 2649 East Springs Drive

Contact Name & Phone #: Cole & Associates-Chris Wilson (314)984-9887

FIRE APPARATUS ACCESS AND FIRE HYDRANT WORKSHEET

 Is the building completely protected by an NFPA 13 or 13R automatic fire sprinkler system? If non-sprinklered, fire lanes extend to within 150-feet of all portions of the exterior wall? If sprinklered, fire lanes are within 250-feet of all portions of the exterior wall? 	✓ Yes ↓Yes ✔Yes	☐ No ☐ No ☐ No	□ N/A □ N/A □ N/A
 2. Is the fire lane constructed of concrete or asphalt, designed to support a minimum load of 85,000 lbs? a) Is the fire lane a minimum unobstructed width of at least 20-feet? b) Is the fire lane unobstructed with a vertical clearance of at least 13½-feet? c) Is the minimum inside turning radius of the fire lane at least 28-feet? d) Is the grade of the fire lane not more than a slope of 8%? e) Is the fire lane posted as fire lane? a. Is a detail of the signage included on the site plan? f) Is a roll-able curb used as part of the fire lane? a. Is a detail of the curb included on the site plan? g) Is part of a sidewalk used as part of the required fire lane? a. Is the sidewalk constructed to withstand 85,000-lbs? 	Yes Yes Yes Yes Yes Yes Yes Yes Yes Yes	 N0 	□ N/A □ N/A □ N/A □ N/A ■ N/A ■ N/A □ N/A □ N/A □ N/A
3. Is the fire lane obstructed by security gates or barricades? If yes:a) Is the gate a minimum of 20-feet clear opening?b) Is an approved means of emergency operations installed, key vault, padlock or key switch?	☐ Yes ☐ Yes ☐ Yes	No No No No	□ N/A □ N/A □ N/A
 4. Is the Fire lane dead-ended with a length greater than 150-feet? If yes, is the area for turning around fire apparatus provided by: a) A cul-de-sac with a minimum inside diameter of 70-feet? b) A 45-degree wye with a minimum length of 60-feet per side? c) A 90-degree tee with a minimum length of 60-feet per side? 	☐ Yes ☐ Yes ☐ Yes ☐ Yes	No No No No No No	 ✓ N/A □ N/A □ N/A □ N/A
5. Is any portion of the building to be used for high-piled storage in accordance with IFC Chapter 23? If yes, see IFC 2306.6 for further requirements.	🗌 Yes	No No	□ N/A
 6. Is any part of the building greater than 30-feet above the lowest level of fire apparatus access? If yes, answer the following questions: a) Is the aerial apparatus fire lane parallel to one entire side of the building? b) Is the near edge of the aerial apparatus fire lane between 15' and 30' from the building? c) Are there any overhead power or utility lines located across the aerial apparatus fire lane? d) Does the aerial apparatus fire lane have a minimum unobstructed width of 26-feet? 	☐ Yes ☐ Yes ☐ Yes ☐ Yes ☐ Yes	 ✓ No □ No □ No □ No □ No □ No 	□ N/A □ N/A □ N/A □ N/A □ N/A
 7. Are all portions of the required fire lanes within 500-feet of at least (2) hydrants? Note: Distances shall be measured along the path of the hose lay as it comes off the fire apparatus. a) Is the fire lane at least 26' wide for at least 20-feet on each side of the hydrants? b) Is there at least 40' between a hydrant and the building? c) Are the hydrant(s) setback no less than 5-feet nor more than 10-feet from the curb or edge of the street or fire lane? d) Are hydrants located in parking lot islands a minimum of 3½-feet from the hydrant to the curb? e) Are there no obstructions, including but not limited to: power poles, trees, bushes, fences, posts located, or grade changes exceeding 1½-feet, within 5-feet of a fire hydrant? 	Yes Yes Yes Yes Yes Yes Yes	 No No No No No No No 	 N/A N/A N/A N/A N/A N/A N/A
Note: Hydrants shall be installed and in-service prior to combustible construction on the project site.			

Attach an additional sheet if further explanation is required for any answers.

This worksheet is based on MGO 34.20 and IFC 2006 Edition Chapter 5 and Appendix D; please see the codes for further information.