



	LEGEND (PROPO	SED)	A —				
AS E		PROPERTY BOUNDARY FACEMENT			NI & ION 53704 2032		
ETE		EASEMENTBUILDING FOOTPRINT			M 5 49.2		
		18" CURB AND GUTTER ASPHALT PAVEMENT	\ ∀ ¥	B	PLANE NUCT RANERAGE • C MADISON, WI FAX GOB.249.3		
N. D.	1180	CONCRETE PAVEMENT	1"=60' ON 24'X36'	Ш	MAE NAC		
		- PROPOSED MINOR CONTOUR	NTS ON 11'X17'				
S BY JLT	STM	 PROPOSED STORM SEWER SILT FENCE 			CONSTRUCTION VETAIL DRIVE		
		INLET PROTECTION DITCH CHECK					
IALL	1181.25 EP	SPOT GRADE DRAINAGE GRADE BREAK			OPMENT 4605 D		
FOR		DRAINAGE ARROW			DEVELOPMENT 4605 I		
	CONSTRUCTION SITE EROSION CONTROL REQUIREMENTS						
		UNTIL CONSTRUCTION ACTIVITIES HAVE CEASED, THE SITE IS STABILIZED, AND A NOTICE OF TERMINATION IS FILED					
	2. KEEP A COPY OF THE CURRI	ENT EROSION CONTROL PLAN ON SITE TH	ROUGHOUT THE DURATION OF THE PROJECT.				
	ADDITIONAL EROSION CO MADISON BUILDING INSP	ADDITIONAL EROSION CONTROL MEASURES AS NECESSARY. CONTRACTOR MUST NOTIFY THE CITY OF MADISON BUILDING INSPECTOR TO SCHEDULE AN ON SITE MEETING A MINIMUM OF TWO (2) WORKING DAYS IN ADVANCE OF ANY SOIL DISTURBANCE ACTIVITIES. . SUBMIT PLAN REVISIONS OR AMENDMENTS TO THE WDNR AT LEAST 5 DAYS PRIOR TO FIELD IMPLEMENTATION.			WYSER Engineering		
		L EVENT OF 0.5 INCHES OR GREATER. KEE	ONS AT LEAST ONCE EVERY 7 DAYS AND WITHIN P INSPECTION REPORTS ON-SITE AND MAKE THEM				
	6. INSPECT AND MAINTAIN ALI HAS BEEN STABILIZED.	INSPECT AND MAINTAIN ALL INSTALLED EROSION CONTROL PRACTICES UNTIL THE CONTRIBUTING DRAINAGE AREA HAS BEEN STABILIZED.			608.843.3388 www.wyserengineering.com		
	7. WHEN POSSIBLE: PRESERVE	. WHEN POSSIBLE: PRESERVE EXISTING VEGETATION (ESPECIALLY ADJACENT TO SURFACE WATERS), MINIMIZE LAND-DISTURBING CONSTRUCTION ACTIVITY ON SLOPES OF 20% OR MORE, MINIMIZE SOIL COMPACTION, AND PRESERVE TOPSOIL					
	PRESERVE TOPSOIL.	PRESERVE TOPSOIL.					
	http://dnr.wi.gov/topic/storm	http://dnr.wi.gov/topic/stormwater/standards/const_standards.html.					
	LAND-DISTURBING ACTIVITI	LAND-DISTURBING ACTIVITIES, INCLUDING CLEARING AND GRUBBING. USE WDNR TECHNICAL STANDARD STONE TRACKING PAD AND TIRE WASHING #1057 FOR ROCK CONSTRUCTION ENTRANCE(S).					
	IMMEDIATELY UPON INLET	INSTALL INLET PROTECTION PRIOR TO LAND-DISTURBING ACTIVITIES IN THE CONTRIBUTING DRAINAGE AREA AND/OR IMMEDIATELY UPON INLET INSTALLATION. COMPLY WITH WDNR TECHNICAL STANDARD STORM DRAIN INLET PROTECTION FOR CONSTRUCTION SITES #1060 AND DANE COUNTY REQUIREMENTS FOR FRAMED INLET PROTECTION.					
	11. CONTRACTOR TO PROVIDE S	PROTECTION FOR CONSTRUCTION SITES #1060 AND DANE COUNTY REQUIREMENTS FOR FRAMED INLET PROTECTION. CONTRACTOR TO PROVIDE SOLID LID OR METAL PLATE ON ALL OPEN MANHOLES DURING CONSTRUCTION TO MINIMIZE SEDIMENT FROM ENTERING THE STORM SEWER SYSTEM.			~		
	 STAGE CONSTRUCTION GRADING ACTIVITIES TO MINIMIZE THE CUMULATIVE EXPOSED AREA. CONDUCT TEMPORARY GRADING FOR EROSION CONTROL PER WDNR TECHNICAL STANDARD TEMPORARY GRADING PRACTICES FOR EROSION CONTROL #1067. PERMITTING OF GROUNDWATER DEWATERING IS THE RESPONSIBILITY OF THE CONTRACTOR. GROUNDWATER DEWATERING IS SUBJECT TO A DNR WASTEWATER DISCHARGE PERMIT AND A DNR HIGH CAPACITY WELL APPROVAL I CUMULATIVE PUMP CAPACITY IS 70 GPM OR MORE. 			YOMIN CT IG - WEST IG - WE			
		PROVIDE ANTI-SCOUR PROTECTION AND MAINTAIN NON-EROSIVE FLOW DURING DEWATERING. PERFORM DEWATERING OF ACCUMULATED SURFACE RUNOFF IN ACCORDANCE WITH WDNR TECHNICAL STANDARD DE-WATERING #1061.			JULL GALLE(OGES CONS		
	CONTROL RUNOFF DURING	COMPLETE AND STABILIZE SEDIMENT BASINS/TRAPS OR WET PONDS PRIOR TO MASS LAND DISTURBANCE TO CONTROL RUNOFF DURING CONSTRUCTION. REMOVE SEDIMENT AS NEEDED TO MAINTAIN 3 FEET OF DEPTH TO THE OUTLET, AND PROPERLY DISPOSE OF SEDIMENT REMOVED DURING MAINTENANCE (REFER TO NR 528). CONSTRUCT			VOC 15CC		
			RD SEDIMENT BASIN #1064 AND SEDIMENT TRAP #	S L S	∠ <u>∩</u> ¥ Q ≥		
		CONSTRUCT AND PROTECT THE BIOINFILTRATION BASIN AND VEGETATION FROM RUNOFF AND SEDIMENT DURING CONSTRUCTION. REFERENCE THE WDNR TECHNICAL STANDARD BIORETENTION FOR INFILTRATION # 1004.			OPOSE COPOSE DISON,		
	BEHIND SILT FENCES AND S	INSTALL AND MAINTAIN SILT FENCING PER WDNR TECHNICAL STANDARD SILT FENCE #1056. REMOVE SEDIMENT FROM BEHIND SILT FENCES AND SEDIMENT BARRIERS BEFORE SEDIMENT REACHES A DEPTH THAT IS EQUAL TO ONE-HALF OF THE FENCE AND/OR BARRIER HEIGHT.					
		REPAIR BREAKS AND GAPS IN SILT FENCES AND BARRIERS IMMEDIATELY. REPLACE DECOMPOSING STRAW BALES (TYPICAL BALE LIFE IS 3 MONTHS). LOCATE, INSTALL, AND MAINTAIN STRAW BALES PER WDNR TECHNICAL STANDARD DITCH CHECKS #1062.			AA MA		
		TER SOCKS IN ACCORDANCE WITH WDNR SLOPE INTERRUPTION PRODUCTS # 1071.	TECHNICAL STANDARD INTERIM MANUFACTURED				
		OCKPILES AND SURROUND STOCKPILES A OCKPILES WILL REMAIN INACTIVE FOR 7 D					
			NACTIVE FOR 14 DAYS OR LONGER. BETWEEN A AND A PERENNIAL SEED MIXED WITH WINTER				
			N AND SOIL TYPE OCTOBER 15 THROUGH COLD APPROPRIATE FOR REGION AND SOIL TYPE.	DATE:			
		GRADING WITHIN 7 DAYS OF REACHING FI MENT/TRASH THAT MOVES OFF-SITE DUE	NAL GRADE. TO CONSTRUCTION ACTIVITY OR STORM EVENTS				
		AME WORKDAY OR AS DIRECTED BY THE A AND TRASH) AND DISPOSE OF APPROPRIA	UTHORITIES WITH JURISDICTION. SEPARATE FELY.				
	24. THE CONTRACTOR IS RESPO CONSTRUCTION SITES # 106		INR TECHNICAL STANDARD DUST CONTROL ON				
		RUCTION MATERIALS) AND DO NOT ALLOV	_S (INCLUDING GARBAGE, DEBRIS, CLEANING / THESE MATERIALS TO BE CARRIED BY RUNOFF				
	THE ANTICIPATED OR LIKEL BE HAULED OFF-SITE FOR D	Y DISPOSAL LOCATIONS FOR ANY EXCAVA DISPOSAL. THE DEPOSITED OR STOCKPILEI	E THE LAND DISTURBANCE PERMIT TO INDICATE TED SOILS OR CONSTRUCTION DEBRIS THAT WILL D MATERIAL NEEDS TO INCLUDE PERIMETER ILTER SOCKS, OR COMPACTED EARTHEN BERMS).				
			OPES, PROVIDE CLASS CLASS I TYPE B EROSION TANDARD NON-CHANNEL EROSION MAT #1052.				
		N DISTURBED OR CONSTRUCTED AREAS, F ISE SPECIFIED ON THE PLAN. INSTALL AND					
	29. MAKE PROVISIONS FOR WAT		DWING SEEDING OR PLANTING OF DISTURBED				
	30. THE CONTRACTOR IS RESPO MANAGEMENT REQUIREMENT INFORMATION FOR AREAS W	DNSIBLE FOR COMPLYING WITH ALL APPLI NTS FOR HANDLING AND DISPOSING OF CO VITH KNOWN OR SUSPECTED SOIL AND/OF					
	https://www3.epa.gov/npdes	ONCRETE WASHOUT BASIN PER EPA 833-F /pubs/concretewashout.pdf, REQUIRE USE f NG, EVAPORATED, OR DISPOSED OF AS WA	BY ALL CONCRETE CONTRACTORS. LIQUID MAY BE	REVISION:			
		NG & RESTORATION N		O N			
	1. ALL GRADES SHOWN ARE F	FINAL FINISHED SURFACE GRADES.		SHEET TITLE:	ROSION CONTROL PLAN		
		AREAS TO BE SEEDED SHALL HAVE A MINIMUM 6 INCHES TOPSOIL UNLESS OTHERWISE NOTED. AREAS NOT RESTORED WITH EROSION MATTING OR OTHER STABILIZATION MEASURES SHALL BE STABILIZED			NUSION CONTROL PLAN		
	WITH MULCH.						
	5. CONTRACTOR SHALL CHISI	EL-PLOW OR DEEP TILL WITH DOUBLE	TINES THE STORMWATER MANAGEMENT	JOB NUMBER: DESIGNED BY:	I 9032 DOS/AJW		
		EEDING AND MULCHING TO PROMOTE REE STRAW AND SHALL BE INSTALLED	INFILTRATION. AT THE RATE OF 2 TONS PER ACRE PER	DRAWN BY:	DOS/AJW		
		RD SPECIFICATIONS FOR HIGHWAY AND	STRUCTURE CONSTRUCTION" (WISDOT 2014)	CHECKED BY:	- 01.12.2021		
	SEEDING/PLANTING METH		AY BE NECESSARY FOR SEEDING/PLANTING	SHEET NO:			


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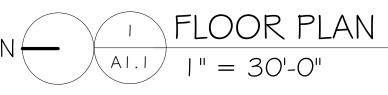
 TEMPORARY STABILIZATION SHALL CONSIST OF ONE OR MORE OF THE FOLLOWING OPTIONS:
 a. TEMPORARY SEEDING CONSISTING OF ANNUAL RYE GRASS APPLIED AT A RATE OF 1.5 LBS PER 1000 SQUARE FEET, b. WISDOT PAL CLASS I TYPE B URBAN EROSION CONTROL MAT.


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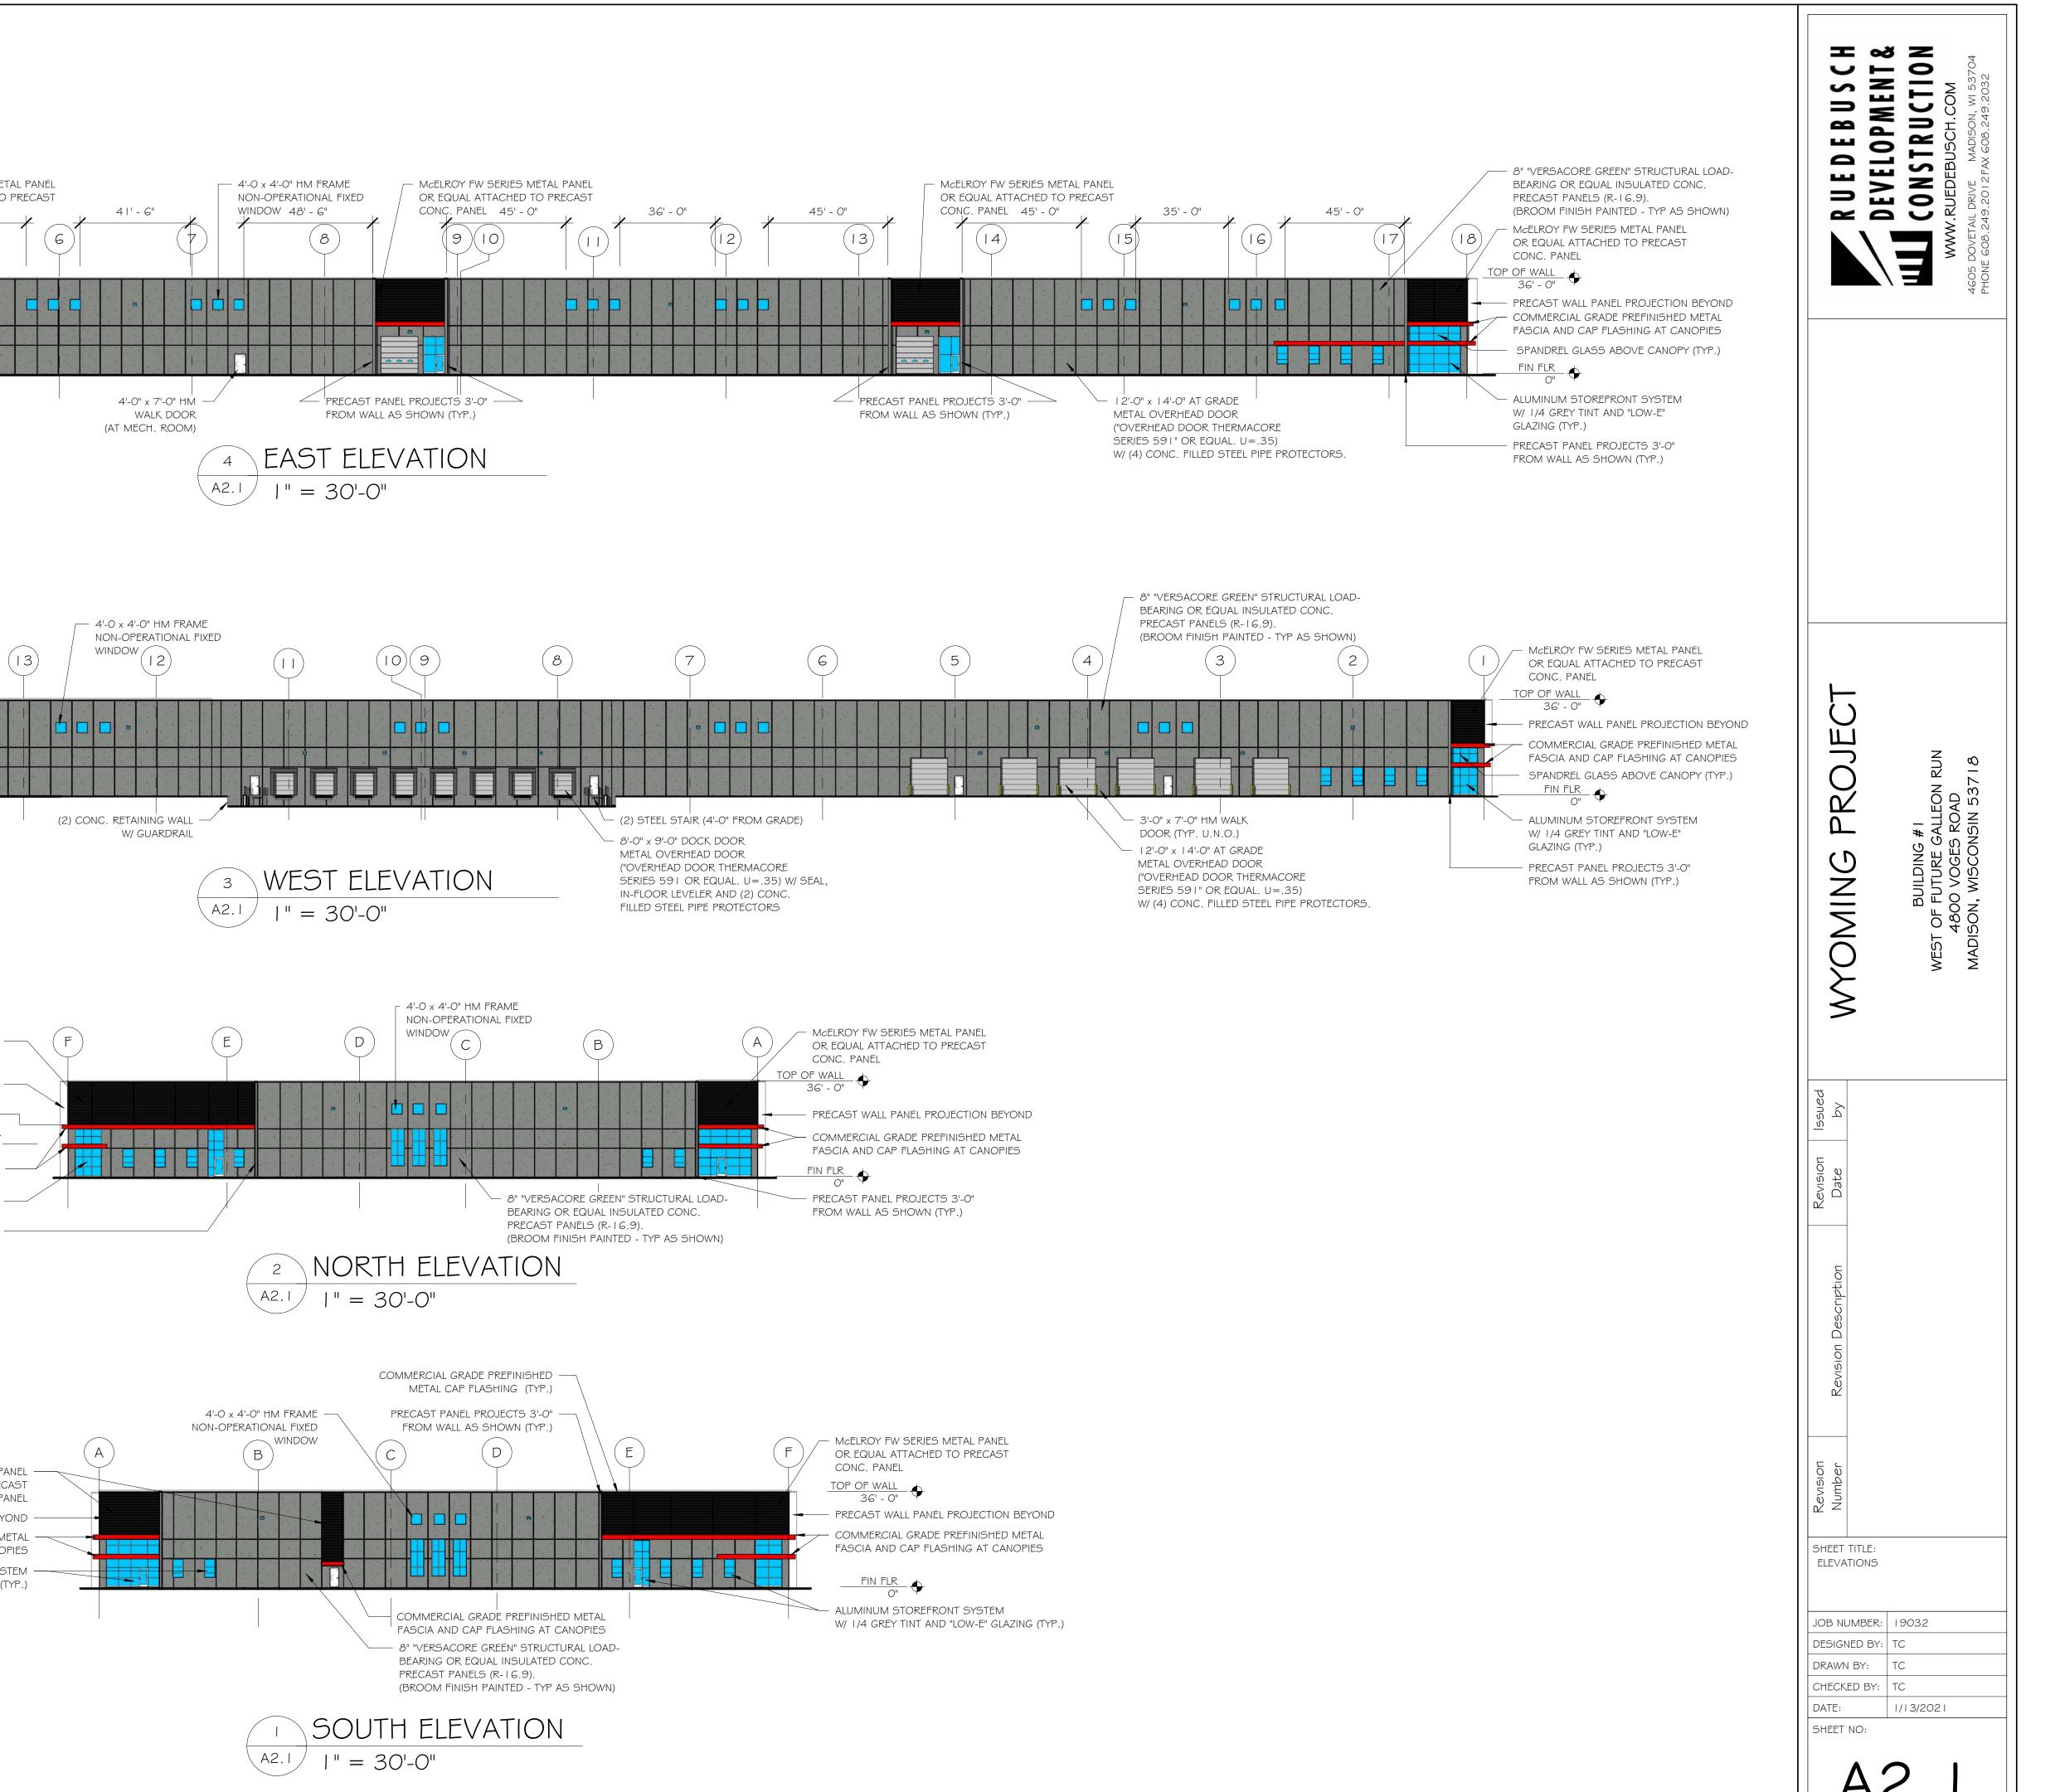


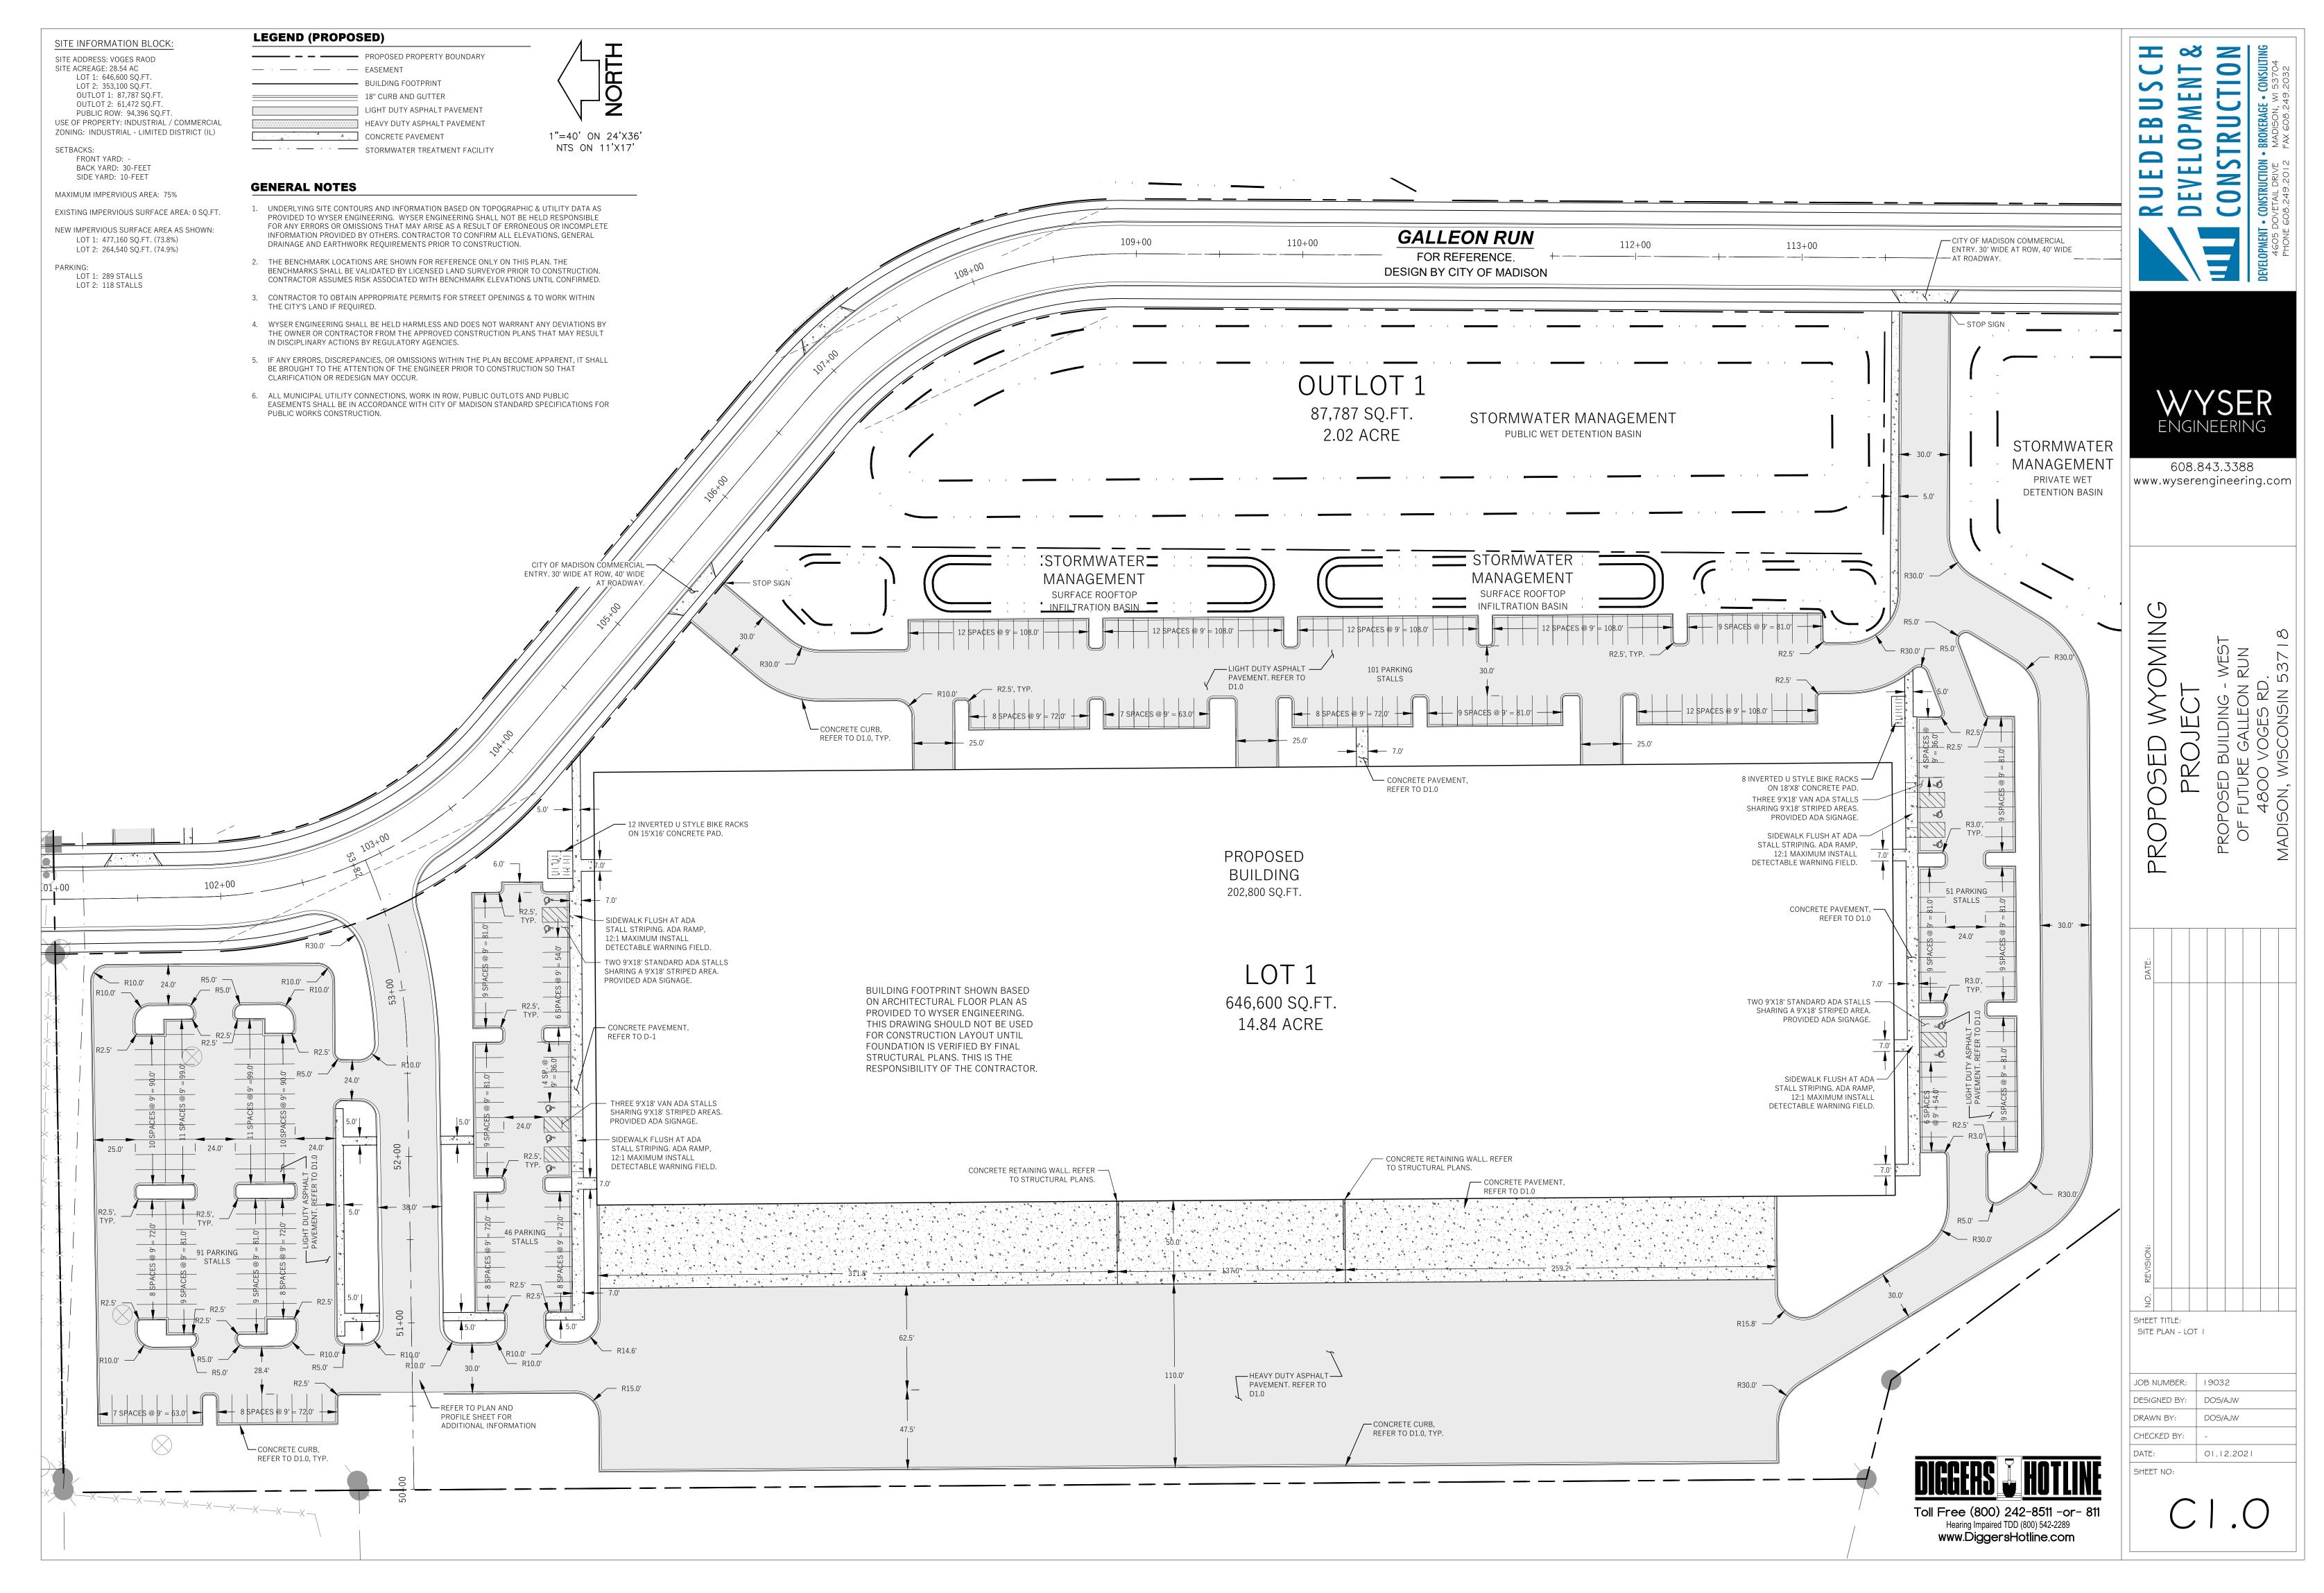




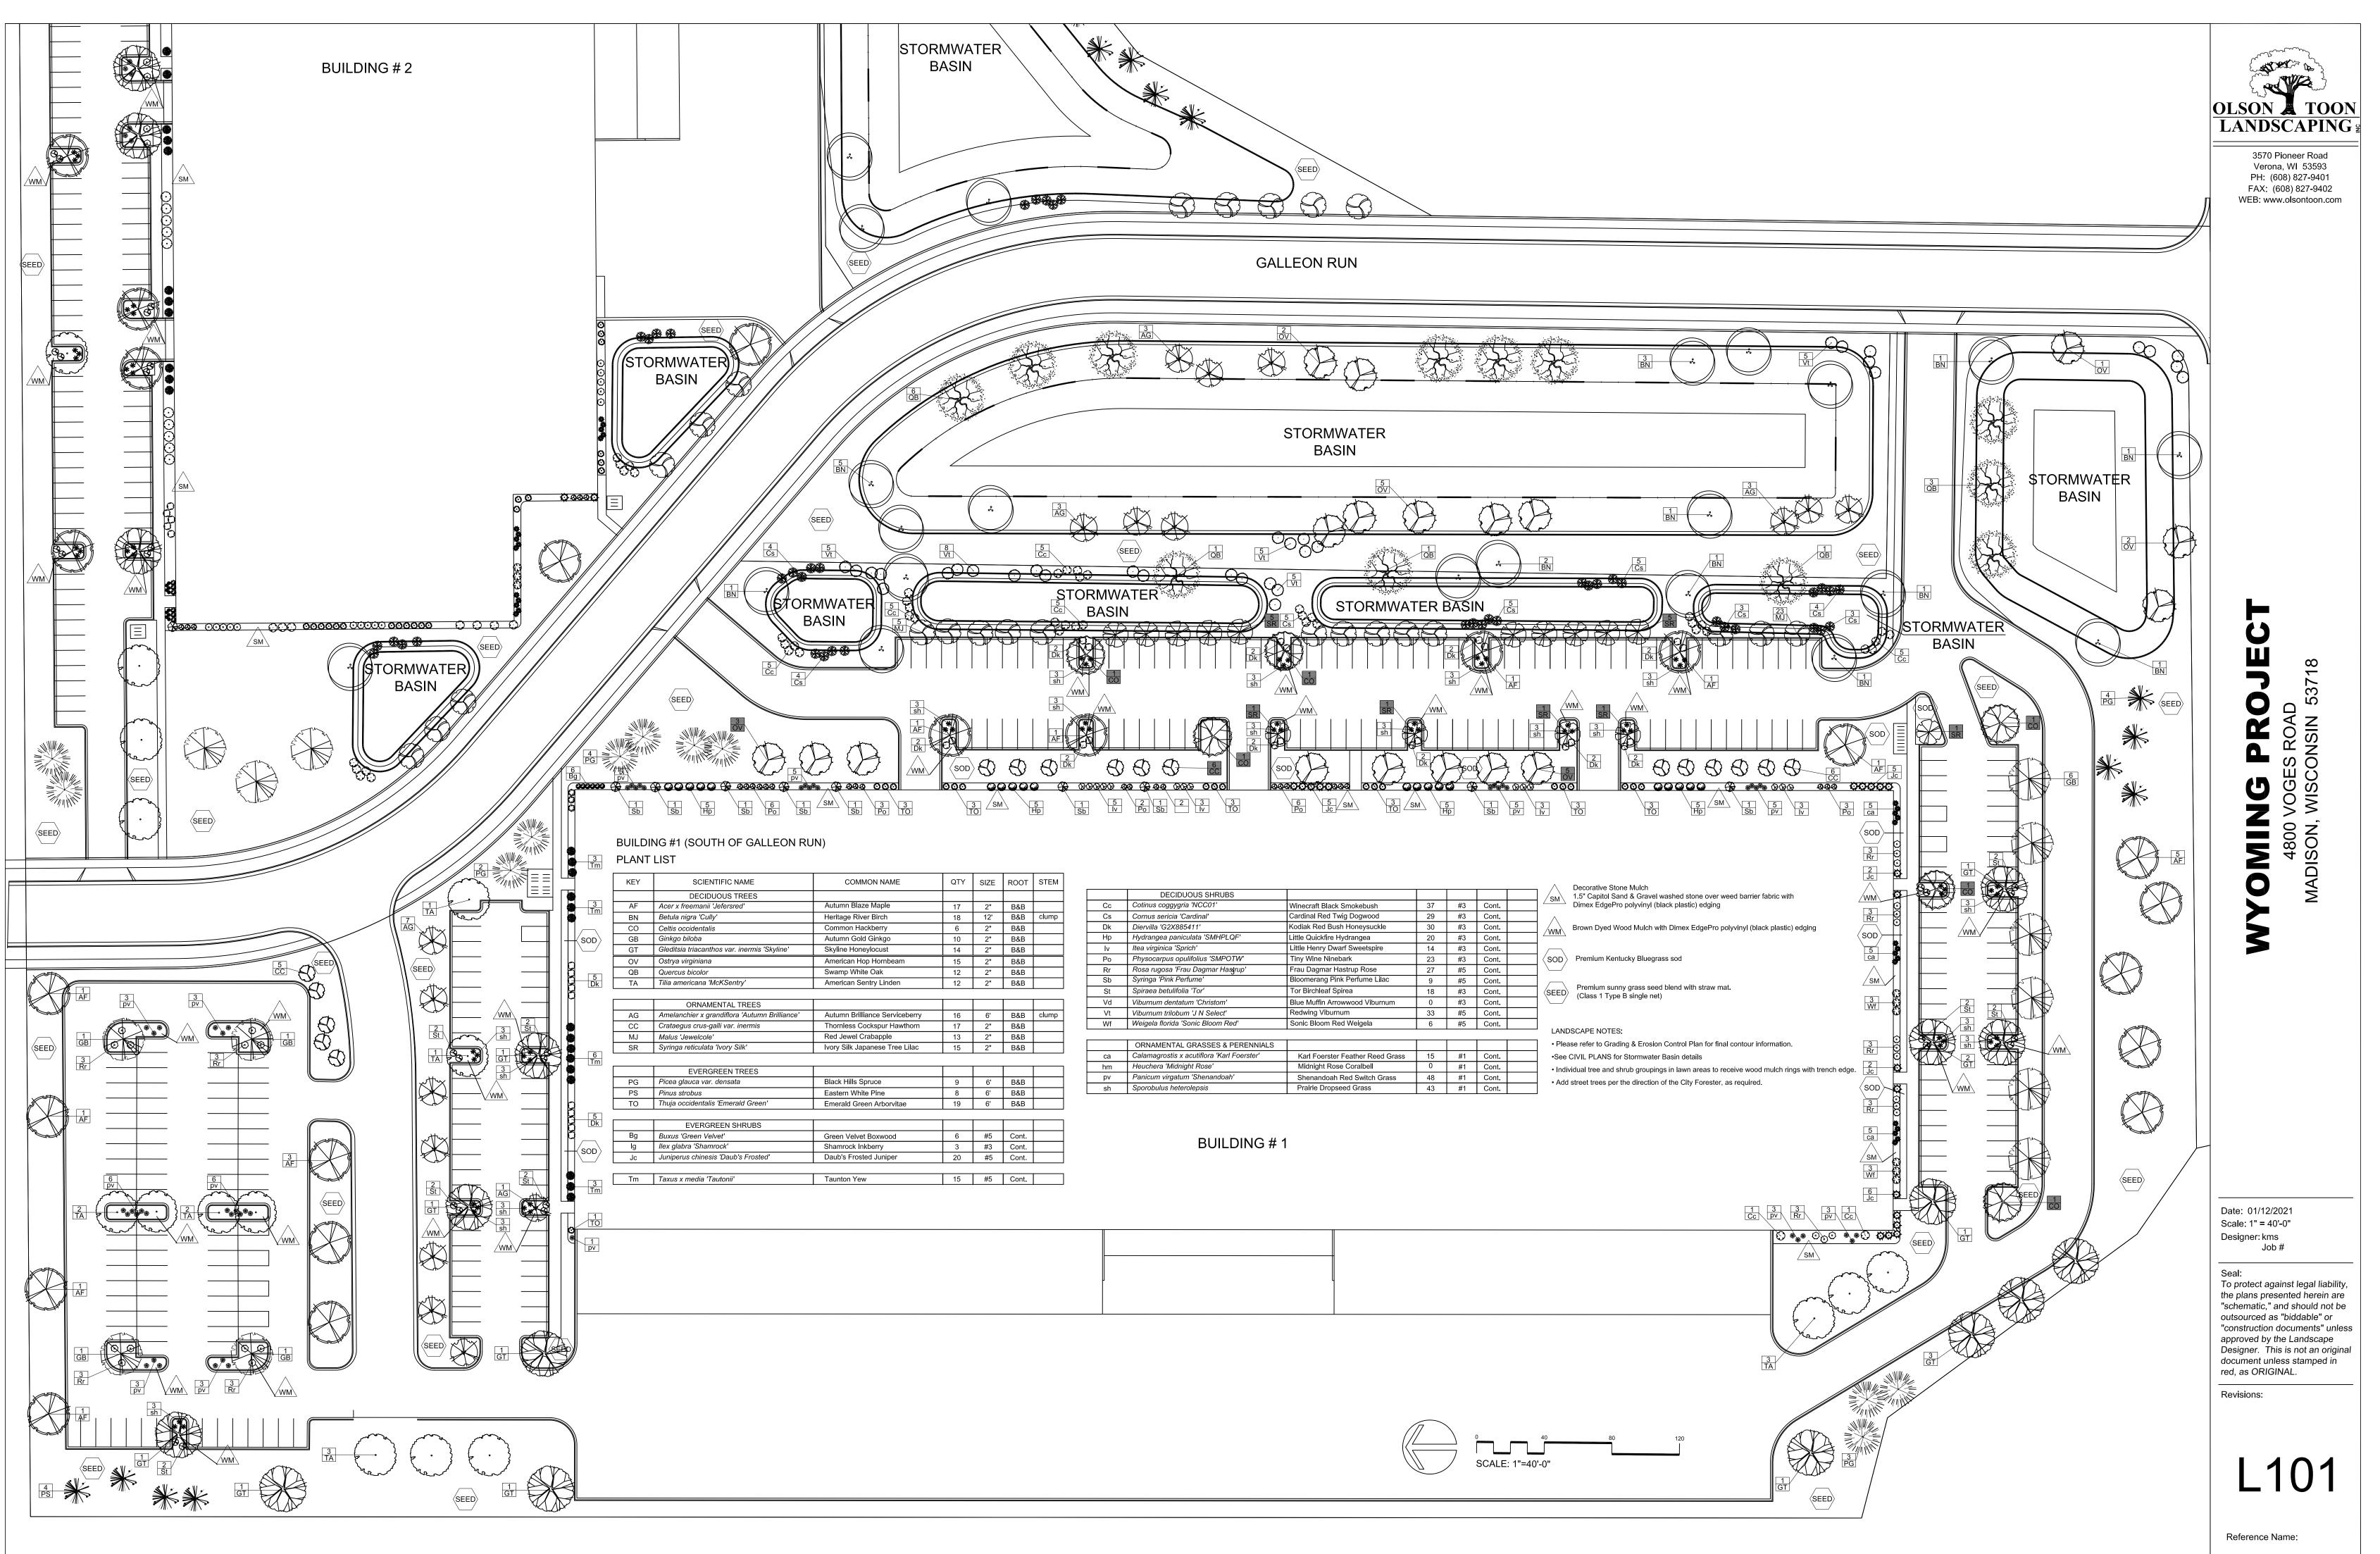

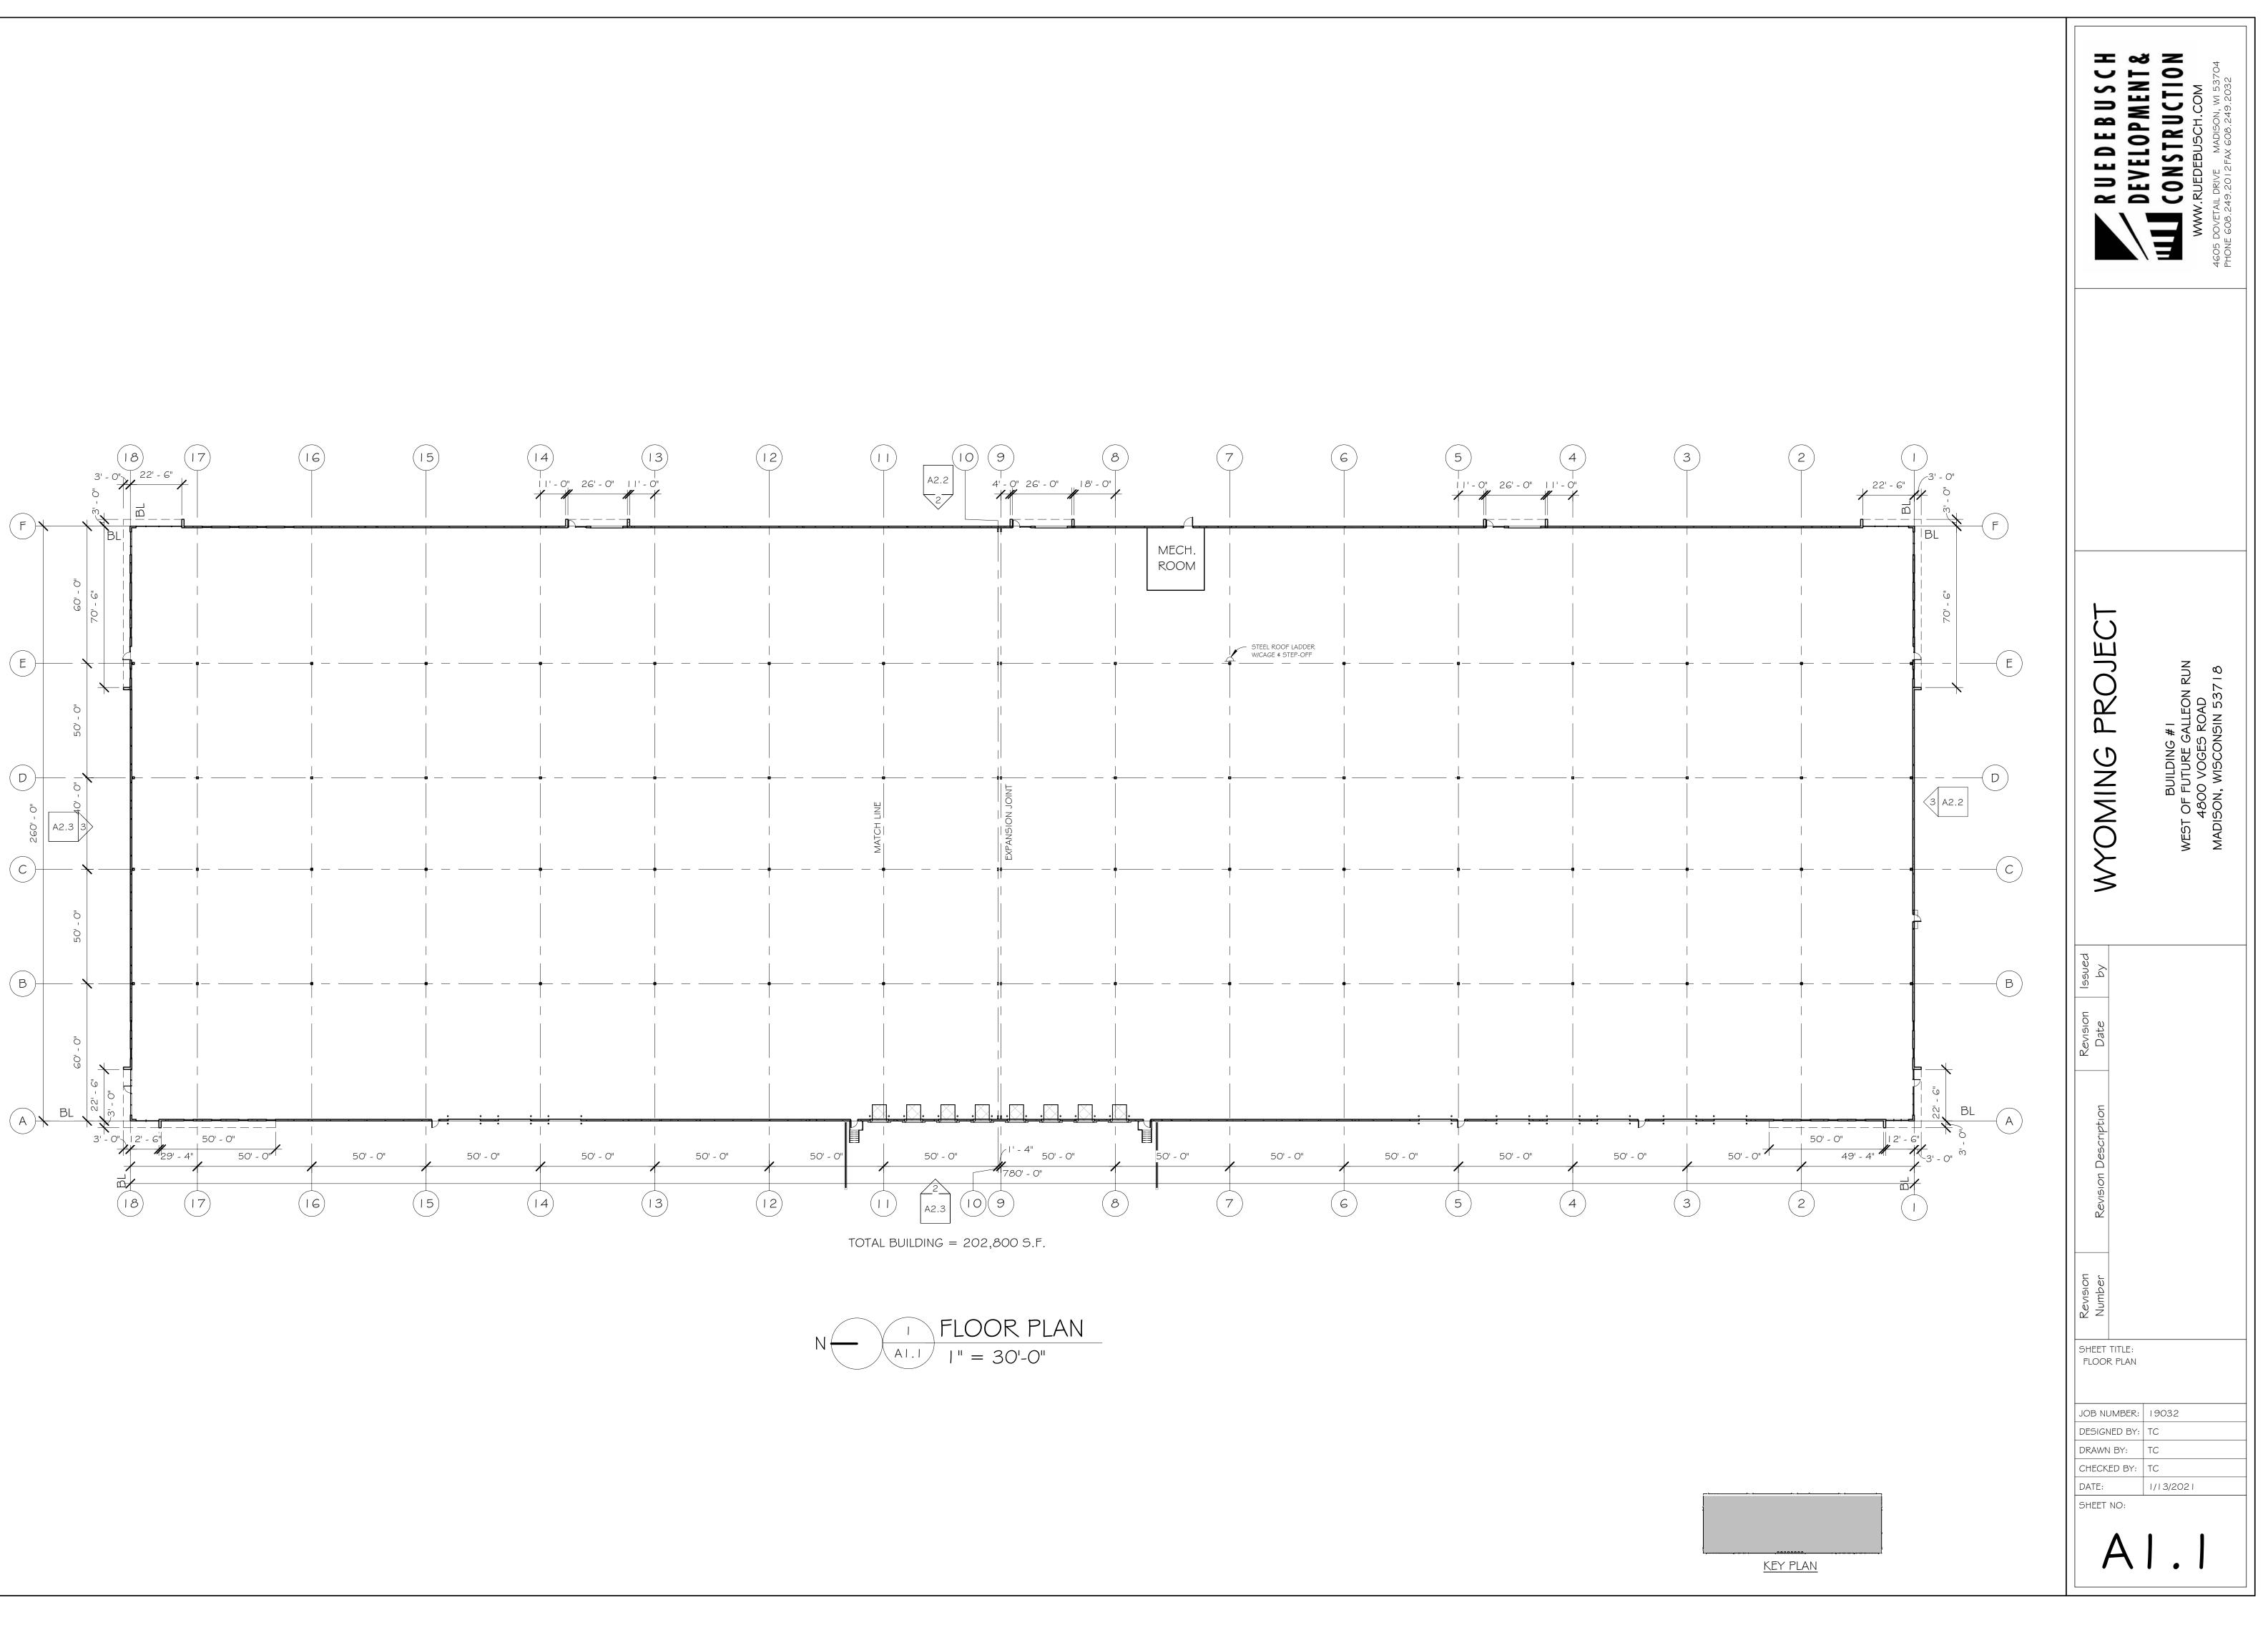

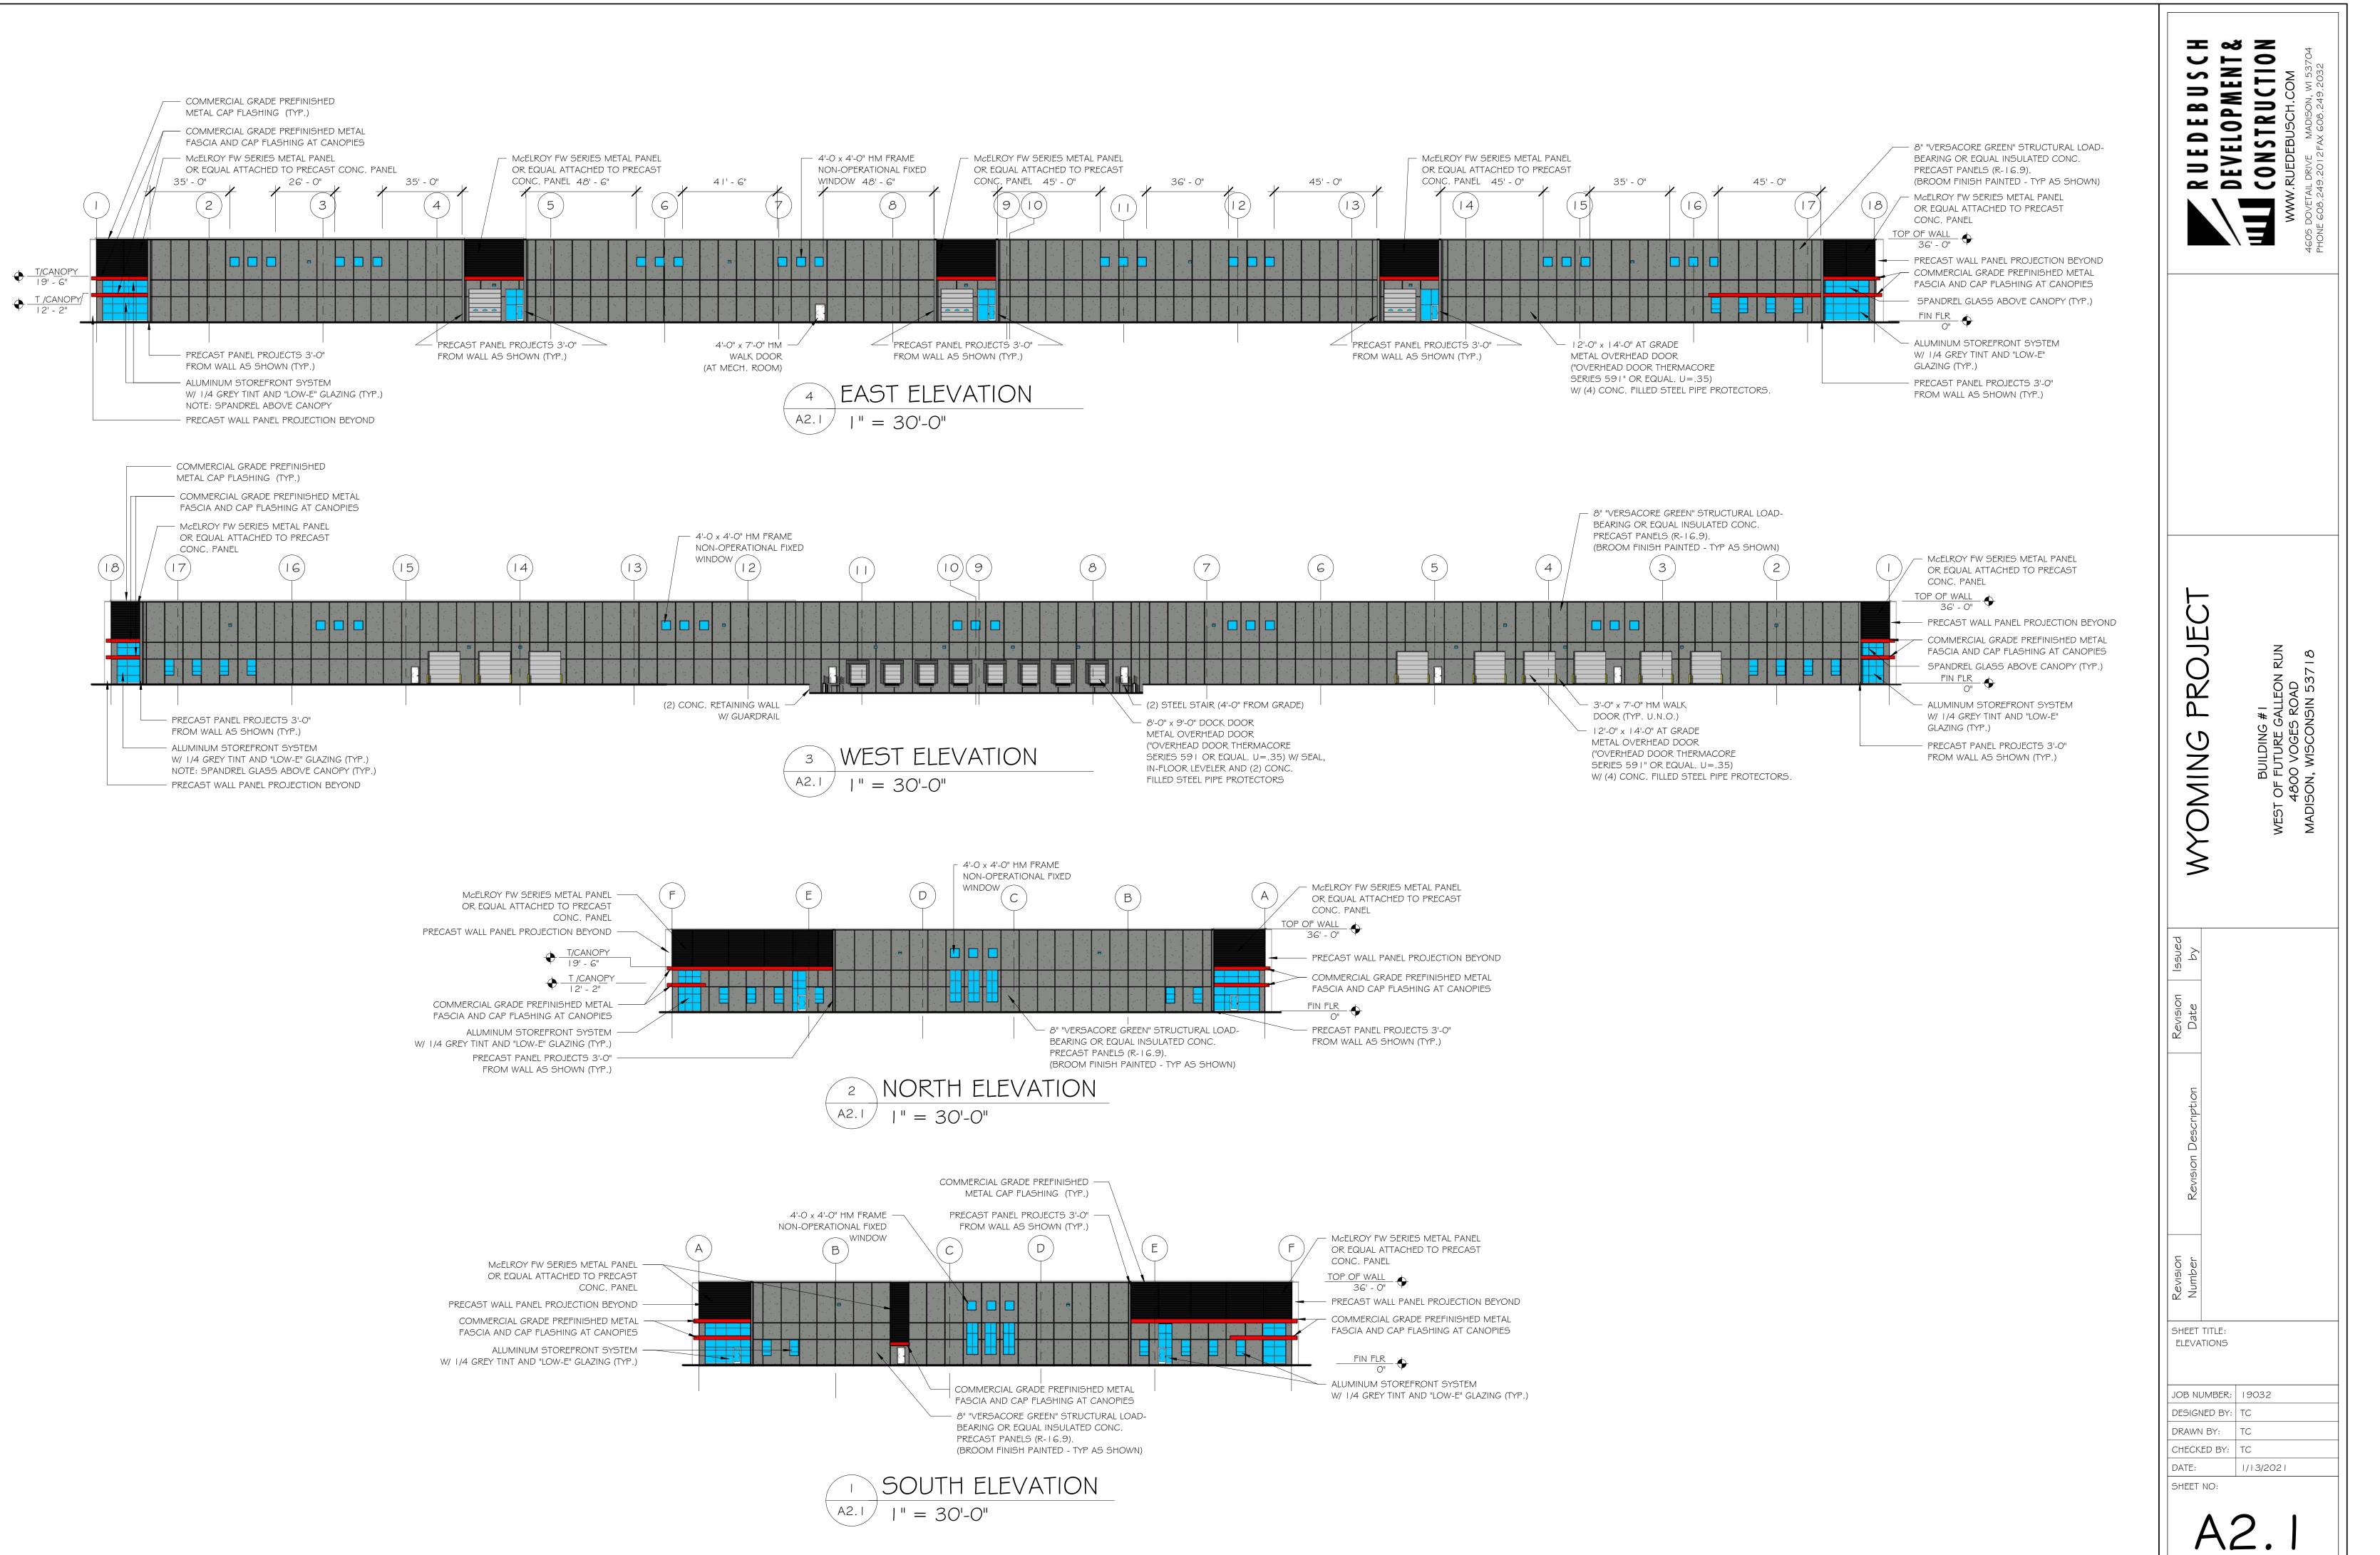



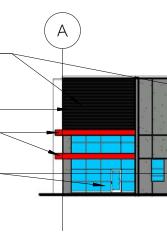

PROPOSED BUILDING #1 4800 VOGES ROAD VIEW FROM SOUTHEAST




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DEVELOPA CONSTRUCTION

DEVELOPMENT - CONSTRUCTION - BROKERAGE - CONSULTING


PROPOSED DEVELOPMENT 4800 VOGES ROAD VIEW FROM SOUTHEAST



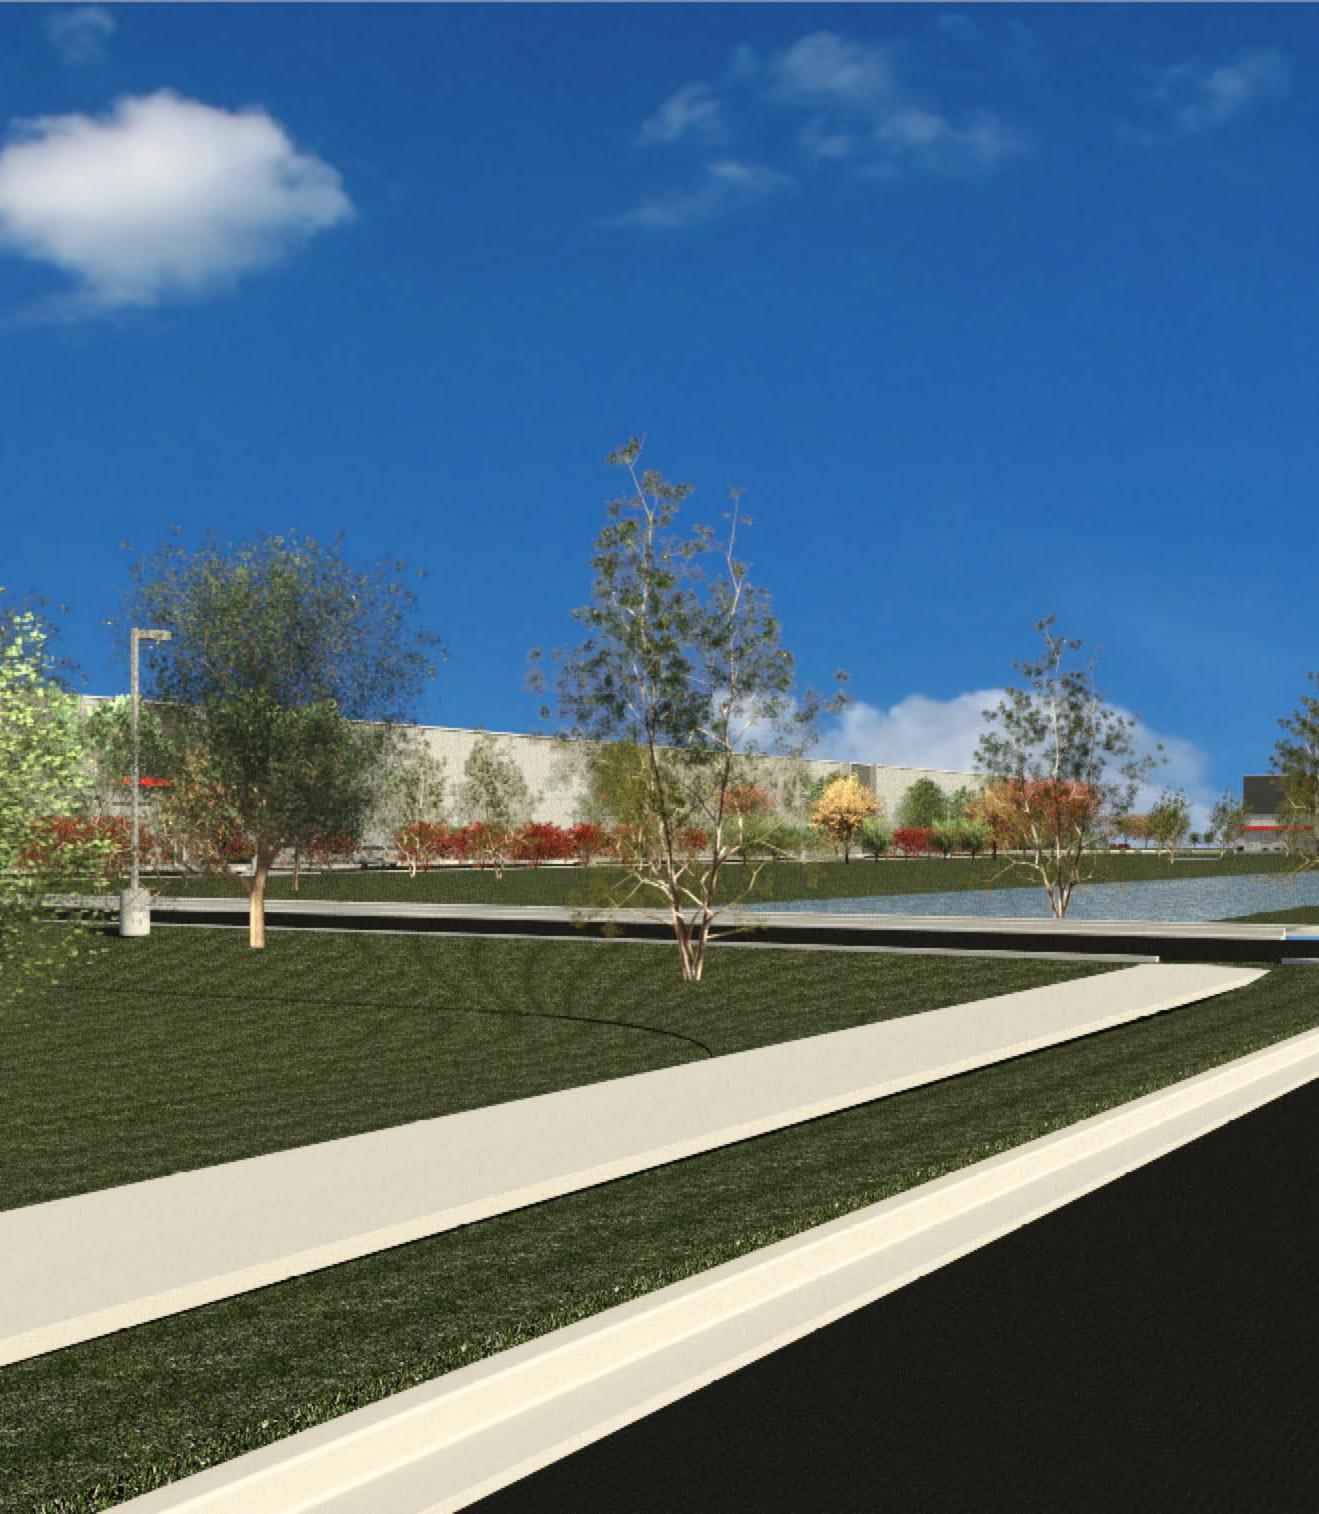

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PROPOSED BUILDING 4800 VOGES ROAD VIEW FROM SOUTHEAST

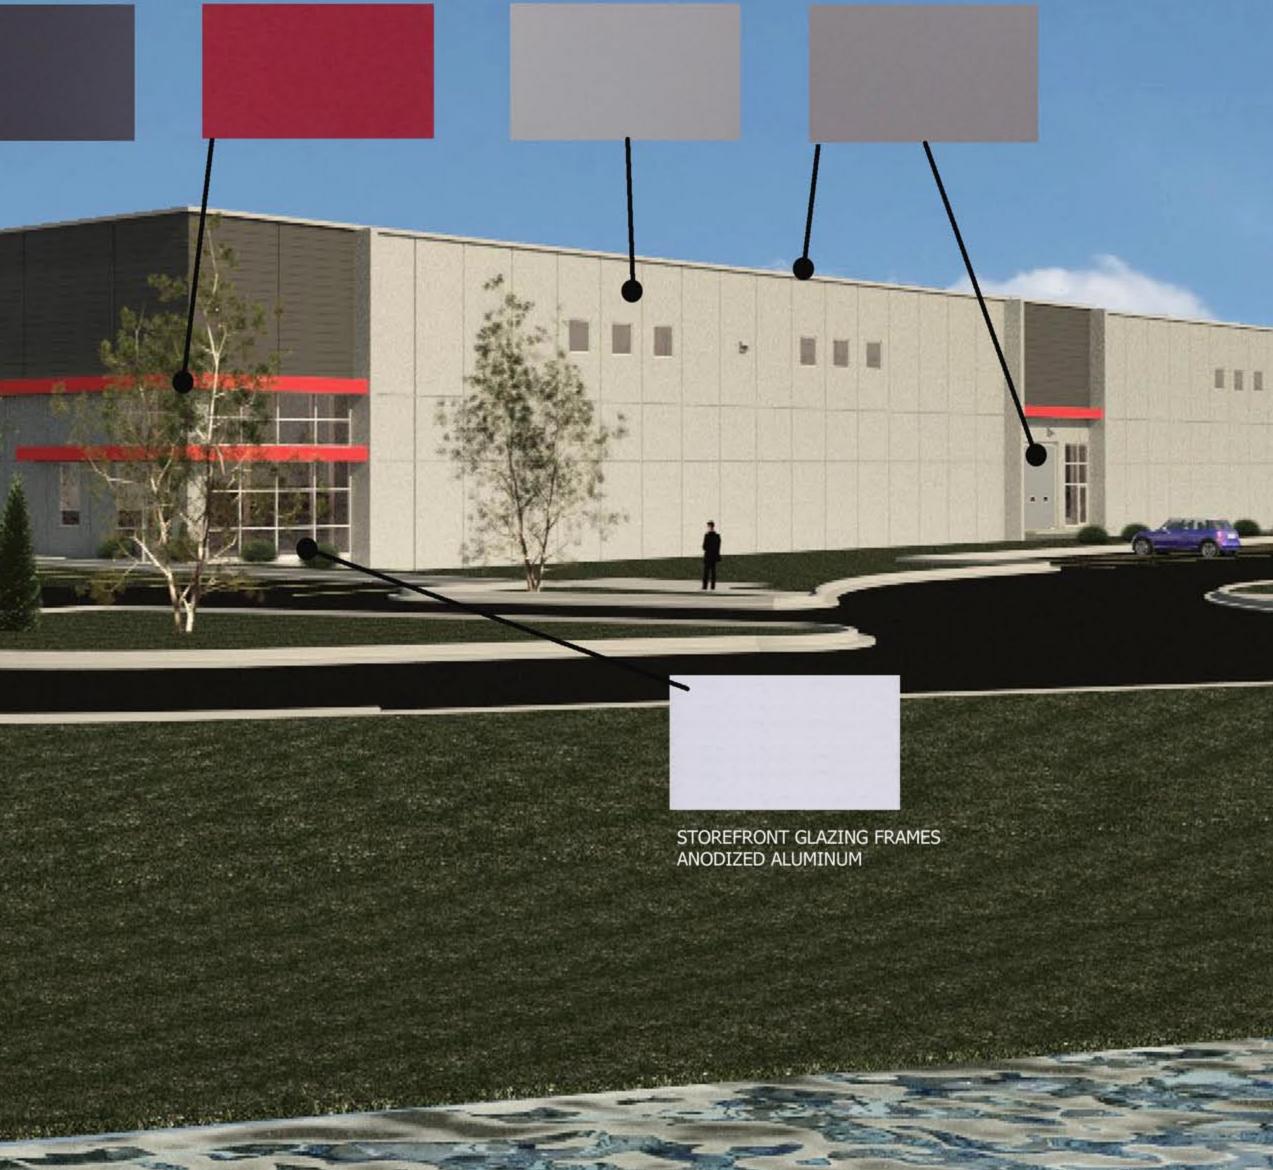

METAL PANEL-MCELROY "CHARCOAL GREY" OR EQUAL

CANOPIES - MCELROY "BRITE RED" OR EQUAL

WALL PANEL-SHERWIN WILLIAMS "REQUSITE GREY"

PARAPET METAL COPING, GARAGE AND MAN DOORS "ASH GREY"



EXAMPLE OF METAL PANEL SIMILAR TO GREY PANEL AND CANOPIES.

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