URBAN DESIGN COMMISSION APPLICATION



City of Madison Planning Division Madison Municipal Building, Suite 017 215 Martin Luther King, Jr. Blvd. P.O. Box 2985 Madison, WI 53701-2985



Paid _____ Receipt # ____ Date received (608) 266-4635 Aldermanic District _____ Zoning District ___ Complete all sections of this application, including Urban Design District ___ the desired meeting date and the action requested. If you need an interpreter, translator, materials in alternate Submittal reviewed by ___ formats or other accommodations to access these forms, please call the phone number above immediately. Legistar # _____

FOR OFFICE USE ONLY:

1.	Proj	ect Informatio	n						
	Add	ress: 701 Garde	ner Road						
	Title	: Madison Yards	s at Hill Farr	ns Block 2					
2.	App	lication Type (d	check all th	nat apply) and Requested Da	te				
	UDC	meeting date r	equested	January 13, 2021					
	V	New developm	ent	☐ Alteration to an existing of	or prev	iously-approved development			
		Informational	I	✓ Initial approval	V	Final approval			
3.	Proj	ect Type							
	V	Project in an Ur	Urban Design District Downtown Core District (DC), Urban			nage			
						Comprehensive Design Review (CDR)			
	_	Mixed-Use District (UMX), or Mixed-Use Center District (MXC) Project in the Suburban Employment Center District (SEC), Campus Institutional District (CI), or Employment Campus				Signage Variance (i.e. modification of signage height,			
						area, and setback)			
		District (EC)				Signage Exception			
	V	Planned Develo			Oth	ner			
			evelopment	Plan (GDP) on Plan (SIP)		Please specify			
		•	•	• •					
				Residential Building Complex					
4.	App	licant, Agent, a	•	rty Owner Information					
	App	licant name	Mark Theo		Co	mpany Madison Yards Block 2, LLC			
	Stre	et address	241 N. Bro	oadway, Suite 400	_	City/State/Zip Milwaukee, WI 53202			
	Tele	ephone (414) 453-011		0110	Em	Email mtheder@summitsmith.com			
	Proj	ect contact pers	son Sean I	Roberts	Co	mpany Summit Smith Development			
	Stre	et address	241 N. Bro	padway, Suite 400	Cit	y/State/Zip Milwaukee, WI 53202			
	Tele	phone	(414) 453-	0110	Em	ail sroberts@summitsmith.com			
	Pro	perty owner (if	not applica	ant) Madison Yards Block 6, LLC	C				
		et address		padway, Suite 400		City/State/Zip Milwaukee, WI 53202			
	Tele	phone	(414) 453-	0110	-	ail mtheder@summitsmith.com			
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Urbar	n Design Commission Application (continued)		UDO
5. Red	quired Submittal Materials		
₫	 Application Form Letter of Intent If the project is within an Urban Design District, a sum development proposal addresses the district criteria is reference on the proposed tent with the applicable CDR or Signage Variance review of the proposed tent with the applicable CDR or Signage Variance review of the proposed tent with the applicable CDR or Signage Variance review of the proposed tent with the applicable CDR or Signage Variance review of the proposed tent with the applicable CDR or Signage Variance review of the proposed tent with the applicable CDR or Signage Variance review of the proposed tent with the applicable CDR or Signage Variance review of the proposed tent with the proposed tent with the applicable CDR or Signage Variance review of the proposed tent with the proposed tent with the applicable CDR or Signage Variance review of the proposed tent with the proposed tent with the proposed tent with the proposed tent with the applicable CDR or Signage Variance review of the proposed tent with the proposed tent with	quiréd I signage is consis-	Each submittal must include fourteen (14) 11" x 17" collated paper copies. Landscape and Lighting plans (if required) must be full-sized and legible. Please refrain from using
 ✓	Development Plans (Refer to checklist on Page 4 for plan de	tails)	plastic covers or spiral binding.
	Filing fee	J	
	Electronic Submittal*		
Ø	 Notification to the District Alder Please provide an email to the District Alder notifying the as early in the process as possible and provide a copy of the company of the process. 		
	h the paper copies and electronic copies <u>must</u> be submitted preduled for a UDC meeting. Late materials will not be accepted. A co		
	projects also requiring Plan Commission approval, applicants must a sideration prior to obtaining any formal action (initial or final appro		
com proj not	ectronic copies of all items submitted in hard copy are requin npiled on a CD or flash drive, or submitted via email to <u>udcapt</u> ject address, project name, and applicant name. Electronic sub- allowed. Applicants who are unable to provide the materials of i-4635 for assistance.	olications@cityofmadiso bmittals via file hosting s	n.com. The email must include the services (such as Dropbox.com) are
6. Ap _l	plicant Declarations		
1.	Prior to submitting this application, the applicant is requ Commission staff. This application was discussed with $\frac{12}{19}$.		posed project with Urban Design on
2.	The applicant attests that all required materials are included in t is not provided by the application deadline, the application with consideration.		
Name	of applicant Mark Theder	_ Relationship to prope	orty Owner
Autho	rizing signature of property owner Man O Shall		Date <u>11/17/20</u>
7. App	olication Filing Fees		
of t Con	s are required to be paid with the first application for either in he combined application process involving the Urban Design nmon Council consideration. Make checks payable to City Trean \$1,000.	Commission in conjunc	tion with Plan Commission and/or
Plea	ase consult the schedule below for the appropriate fee for you	ır request:	
	Urban Design Districts: \$350 (per §35.24(6) MGO).		quired for the following project
	Minor Alteration in the Downtown Core District (DC) or Urban Mixed-Use District (UMX): \$150 (per §33.24(6)(b) MGO)	involving both Urban Commission:	he combined application process Design Commission and Plan
	Comprehensive Design Review: \$500	 Project in the Down 	ntown Core District (DC), Urban

- Project in the Downtown Core District (DC), Urban Mixed-Use District (UMX), or Mixed-Use Center District (MXC)
- Project in the Suburban Employment Center District (SEC), Campus Institutional District (CI), or **Employment Campus District (EC)**
- Planned Development (PD): General Development Plan (GDP) and/or Specific Implementation Plan (SIP)
- Planned Multi-Use Site or Residential Building Complex

Minor Alteration to a Comprehensive Sign Plan: \$100

All other sign requests to the Urban Design Commission, including, but not limited to: appeals

from the decisions of the Zoning Administrator,

requests for signage variances (i.e. modifications of signage height, area, and setback), and additional sign

code approvals: \$300 (per §31.041(3)(d)(2) MGO)

(per §31.041(3)(d)(1)(a) MGO)

(per §31.041(3)(d)(1)(c) MGO)

URBAN DESIGN COMMISSION APPROVAL PROCESS



Introduction

The City of Madison's Urban Design Commission (UDC) has been created to:

- Encourage and promote high quality in the design of new buildings, developments, remodeling, and additions so as to maintain and improve the established standards of property values within the City.
- Foster civic pride in the beauty and nobler assets of the City, and in all other ways possible assure a functionally efficient
 and visually attractive City in the future.

Types of Approvals

There are three types of requests considered by the UDC:

- Informational Presentation. Applicants may, at their discretion, request to make an Informational Presentation to the
 UDC prior to seeking any approvals to obtain early feedback and direction before undertaking detailed design. Applicants
 should provide details on the context of the site, design concept, site and building plans, and other relevant information
 to help the UDC understand the proposal and provide feedback. (Does not apply to CDR's or Signage Variance requests)
- <u>Initial Approval</u>. Applicants may, at their discretion, request initial approval of a proposal by presenting preliminary design information. As part of their review, the Commission will provide feedback on the design information that should be addressed at Final Approval stage.
- <u>Final Approval</u>. Applicants may request Final Approval of a proposal by presenting all final project details. Recommendations or concerns expressed by the UDC in the initial approval must be addressed at this time.

Presentations to the Commission

Primarily, the UDC is interested in the appearance and design quality of projects. Emphasis should be given to the site plan, landscape plan, lighting plan, building elevations, exterior building materials, color scheme, and graphics.

When presenting projects to the UDC, applicants must fill out a registration slip provided in the meeting room and present it to the Secretary. Presentations should generally be limited to 5 minutes or as extended by motion by consent of the Commission. The Commission will withhold questions until the end of the presentation.

Applicants are encouraged to consider the use of various graphic presentation material including a locator map, photographs, renderings/model, scale drawings of the proposal in context with adjacent buildings/uses/signs, etc., as may be deemed appropriate to describe the project and its surroundings. Graphics should be mounted on rigid boards so that they may be easily displayed. Applicants/presenters are responsible for all presentation materials, AV equipment and easels.

URBAN DESIGN DEVELOPMENT PLANS CHECKLIST



The items listed below are minimal application requirements for the type of approval indicated. Please note that the UDC and/or staff may require additional information in order to have a complete understanding of the project.

1. Informa	tional Presentation		
	Locator Map		Requirements for All Plan Sheets
	Letter of Intent (If the project is within		1. Title block
	an Urban Design District, a summary of		2. Sheet number
	<u>how</u> the development proposal addresses the district criteria is required)	Providing additional	3. North arrow
	Contextual site information, including	information beyond these minimums may generate	4. Scale, both written and graphic
	photographs and layout of adjacent	a greater level of feedback	5. Date
_	buildings/structures	from the Commission.	6. Fully dimensioned plans, scaled at 1"= 40' or larger
	Site Plan		** All plans must be legible, including
	Two-dimensional (2D) images of		the full-sized landscape and lighting
	proposed buildings or structures.		plans (if required)
2. Initial Aր	pproval		
X	Locator Map)
X	Letter of Intent (If the project is within a L the development proposal addresses the d		of how
X	Contextual site information, including phostructures	otographs and layout of adjacent	buildings/ Providing additional information beyond these
X	Site Plan showing location of existing a lanes, bike parking, and existing trees over		drives, bike minimums may generate a greater level of feedback
X	Landscape Plan and Plant List (must be leg	gible)	from the Commission.
X	Building Elevations in both black & white a material callouts)	and color for all building sides (in	clude
X	PD text and Letter of Intent (if applicable)		J
3. Final Ap	proval		
All the re	equirements of the Initial Approval (see above	ve), plus :	
X	Grading Plan		
	Proposed Signage (if applicable)		
X	Lighting Plan, including fixture cut sheets a		· ·
X	Utility/HVAC equipment location and scree	ening details (with a rooftop plan	if roof-mounted)
X	PD text and Letter of Intent (if applicable)		
	Samples of the exterior building materials ((presented at the UDC meeting)	
4. Comprel	nensive Design Review (CDR) and Varianc	e Requests (<i>Signage applicatio</i>	ns only)
	Locator Map	o noquesto (<u>orginage appinatio</u>	<u></u>
	Letter of Intent (a summary of how the propos	sed signage is consistent with the CI	OR or Signage Variance criteria is required)
	Contextual site information, including phoproject site		
	Site Plan showing the location of existing si driveways, and right-of-ways	gnage and proposed signage, din	nensioned signage setbacks, sidewalks,
П	Proposed signage graphics (fully dimension	and scaled drawings including m	naterials and colors and night view)

☐ Perspective renderings (emphasis on pedestrian/automobile scale viewsheds)

☐ Graphic of the proposed signage as it relates to what the Ch. 31, MGO would permit

Illustration of the proposed signage that meets Ch. 31, MGO compared to what is being requested.

Madison Yards Block 2, LLC 241 N. Broadway, Suite 400, Milwaukee, WI 53202

November 18, 2020

City of Madison Planning Division 215 Martin Luther King, Jr. Blvd, Suite 017 Madison, WI 53701

RE: Letter of Intent - Madison Yards at Hill Farms, Block 2 PD-SIP Land Use - UDC Initial/Final

This letter, together with plans, application and supplemental materials, constitutes our Land Use Application for Major Amendment to an Approved Planned Development – Specific Implementation Plan (PD-SIP) for the proposed Madison Yards at Hill Farms, Block 2 project.

Project Location:

The project site is located at 701 Gardener Road, Lot 2 Madison Yards at Hill Farms. The site is 2.897 acres.

Legal Description:

Lot 2, Madison Yards at Hill Farms, recorded in Volume 61-018B of Plats on Page 99, City of Madison, Dane County, Wisconsin.

Project Team:

Owner/Developer: Madison Yards Block 2, LLC

Master Planner/Civil Engineer/Landscape Architect: JSD Professional Services, Inc.

Architects: Kahler Slater & KTGY Group, Inc.

Project Description

The project is a portion of the larger multi-block development known as Madison Yards at Hill Farms. Block 2 is situated at the southwest corner of Segoe Rd. and University Ave. In Madison, WI. The project consists of a grocer, residential building, small property management shell space and associated loading and parking. The Block 2 project will be split into two separate condominium units (grocer and residential) with shared and limited common elements.

The approximately 56,000 gross square feet of commercial space located on the western side of the block includes 54,300+ gsf for the grocer shell space & receiving area and a 1,700 gsf property management shell space. The grocer's main entrance is on Madison Yards Way. Dedicated grocer parking is accessed on the main level from Madison Yards Way and on University Level from both Gardener Rd. and Segoe Rd. A shared loading dock and refuse area serving the grocer and residential building is accessed by right in right out from University Ave. The primary façade materials for the grocer and adjacent parking is comprised of painted aluminum framed glazing systems with insulated glass, masonry and wood look aluminum panels.

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The residential building is located at the eastern portion of Block 2. The residential building is planned for 273 dwelling units (41 efficiencies, 149 one bedroom., 83 two bedroom). The residential portion of the block is 14 stories above the main level with a partially exposed University Avenue Level for a total of 16 floors. The residential amenities include a bike storage and repair room, fitness center, club room, ground level patio and roof top deck. The main entry for the residential building is located on Madison Yards Way. The primary façade materials for the residential building consist of painted aluminum framed glazing systems with insulated glass, masonry, and metal panel.

An open parking deck located in the center portion of Block 2 provides parking for the grocer and residential units. The façade / screening materials for the raised parking deck will be that of the grocer to provide cohesive street facades along University and Madison Yards Way.

Existing Land Use

Former Wisconsin DOT Office Building Parking - Vacant

Zoning Request

The Madison Yards Planned Development General Development Plan (GDP) was approved and recorded in April 2019. The development team is seeking approval of the Madison Yards at Hill Farms Block 2 Specific Implementation Plan (SIP) as well as the following modifications to the approved GDP Zoning text:

- 1. Allow a portion of Block 2 to be one story as seen from Madison Yards Way
- Increase Block 2 Maximum # Residential Dwelling Units to 280 In Table 1.B Use Category Maximums
- 3. Increase Block 4 Maximum # Hotel Rooms to 200 In Table 1.B Use Category Maximums
- 4. Change the Block 2 Max Stories to 16 and Max Height to 175ft in Table 3 Minimum and Maximum Building Stories, Heights, Building Areas by Block

Zoning/Project Data:

Block 2 is part of the Planned Development District – General Development Plan, Madison Yards at Hill Farms Redevelopment, 4802 Sheboygan Ave.

Block 2	Allowable/ required	Proposed
1) Site Area	2.9 Ac	2.9 Ac
2) Bldg Area	80,000- 375,000 gsf	Building A 56,000 gsf
_	_	Building B 292,000 gsf
		Total 348,000 gsf (excluding parking)
3) Building Height (max)	13 stories/ 160 ft	16 stories/ 175 ft
4) Setback		
a) University	Min 80% @ 0' / 20% @15'	322'10" (79%) @ 0' / 86'7" (21%) @ 15'
	Max 30'	Max 21'
	Min 90% 3rd story above @10'	368' 5" (90%) @ 10'
b) Gardener	Min 8'	Min 8'
c) Madison Yd Way	Min 8'	Min 8'
d) Segoe Road	Min 8'	Min 8'
	Min 90% 3rd story above @ 18'	100% @18'

Page 2 of 3 November 18, 2020

Parking:

The required parking ratios for retail is a minimum of 1 space per 400 GSF and a maximum of 1 space per 200 GSF. The required parking ratios for residential is a minimum 0.9 spaces per unit and a maximum of 1.25 spaces per unit. Additional parking above the maximum may be shared with another use.

The proposed Block 2 development provides a total of 552 structured parking spaces and is complaint with the required parking ratios. 239 spaces are dedicated for the grocer tenant located between the University Ave. level and the Madison Yards Way level. 313 parking spaces are provided in the raised open parking deck with a separate entrance from the dedicated grocer parking on Madison Yards Way. The 313 raised parking spaces are for the residential building and can accommodate up to 25 grocer employee parking spaces.

Loading and trash areas will be provided within the building on the University Ave level accessed via right-in, right-out from University Ave.

Streets, Easements, Utilities and Fire Access

Streets within the Madison Yards development are privately held and maintained. Utility easements are in place for existing utility lines and future easements will be finalized and recorded once final plans are approved. Public access easements are in place as required in the final GDP approval.

Fire access for the site was discussed with Bill Sullivan of the Madison Fire Department, including fire lanes, aerial apparatus lanes, and street tree spacing. The approved GDP included a fire access plan for the project.

Traffic Impact Analysis

A traffic impact analysis (TIA) update memo from JSD Professional Services, Inc. and a TDM Plan has been submitted with this letter.

Exterior Signage

All signage depicted in this submittal is for illustrative purposes only. The project team will follow the UDC signage review process as the design develops. Signage will be allowed per Chapter 31 of the Madison General Ordinances and will be provided with each SIP.

Tax Increment Financing

The Development Team is seeking TIF financing for the Madison Yards project. Initial conversations have been held with City of Madison staff and a formal TIF application is pending.

Anticipated Schedule

Construction of Project is scheduled for a spring of 2021 start with completion in 2023.

Sincerely

Mark Theder


Madison Yards Block 2, LLC


Page 3 of 3 November 18, 2020

	EXTERIOR LIGHTING FIXTURE SCHEDULE													
					M	OUNTING								
MARK	MANUFACTURER	CATALOG NUMBER	DESCRIPTION					FINISH					LIGHT	
IVIARK	MANUFACTURER	CATALOG NOMBER	DESCRIPTION					LINIOL	LAMP				LOSS	
				RECESS.	SURF.	WALL	MOUNTING HEIGHT		TYPE	CODE	WATTAGE	LUMENS	FACTOR	REMARKS
"SL1"	MCGRAW-EDISON	GLEON-AF-01-LED-E1-T4W	POLE LIGHT		POLE		25'-0"	BLACK	LED	4000K	67	8,070	0.9	1,2
"SL2"	RAB LIGHITNG	ND6S620D-NDLED6SD-80Y-S-B	RECESSED CAN	X			-	BLACK	LED	4000K	20	1,900	0.9	
"WP1"	FC/SSL LIGHTING	ZFCC410-WM	WALL MOUNT UP/DOWN			Χ	8'-0"	WHITE	LED	4000K	35	3,000	0.9	
"WP2"	INDESSA	503-2LED14-SAL	DECORATIVE SCONCE			X	7'-0"	SILVER	LED	4000K	28	3,100	0.9	
"WP3"	LITHONIA	DSXW2 LED 30C 1000 40K T3M MVOLT	WALL MOUNT DOWNLIGHT			X	30'-0"	BLACK	LED	4000K	109	11,280	0.9	

REMARKS:

	Ph	otometri	Statistic	s	
Description	Avg FC	Max FC	Min FC	Max/Min	Avg/Min
Site	1.6	15.1	0	151:1	16.0:1
Parking	0.8	2.9	0.1	29.0:1	8.0:1
Rooftop	0.7	1.6	0.1	16.0:1	7.0:1

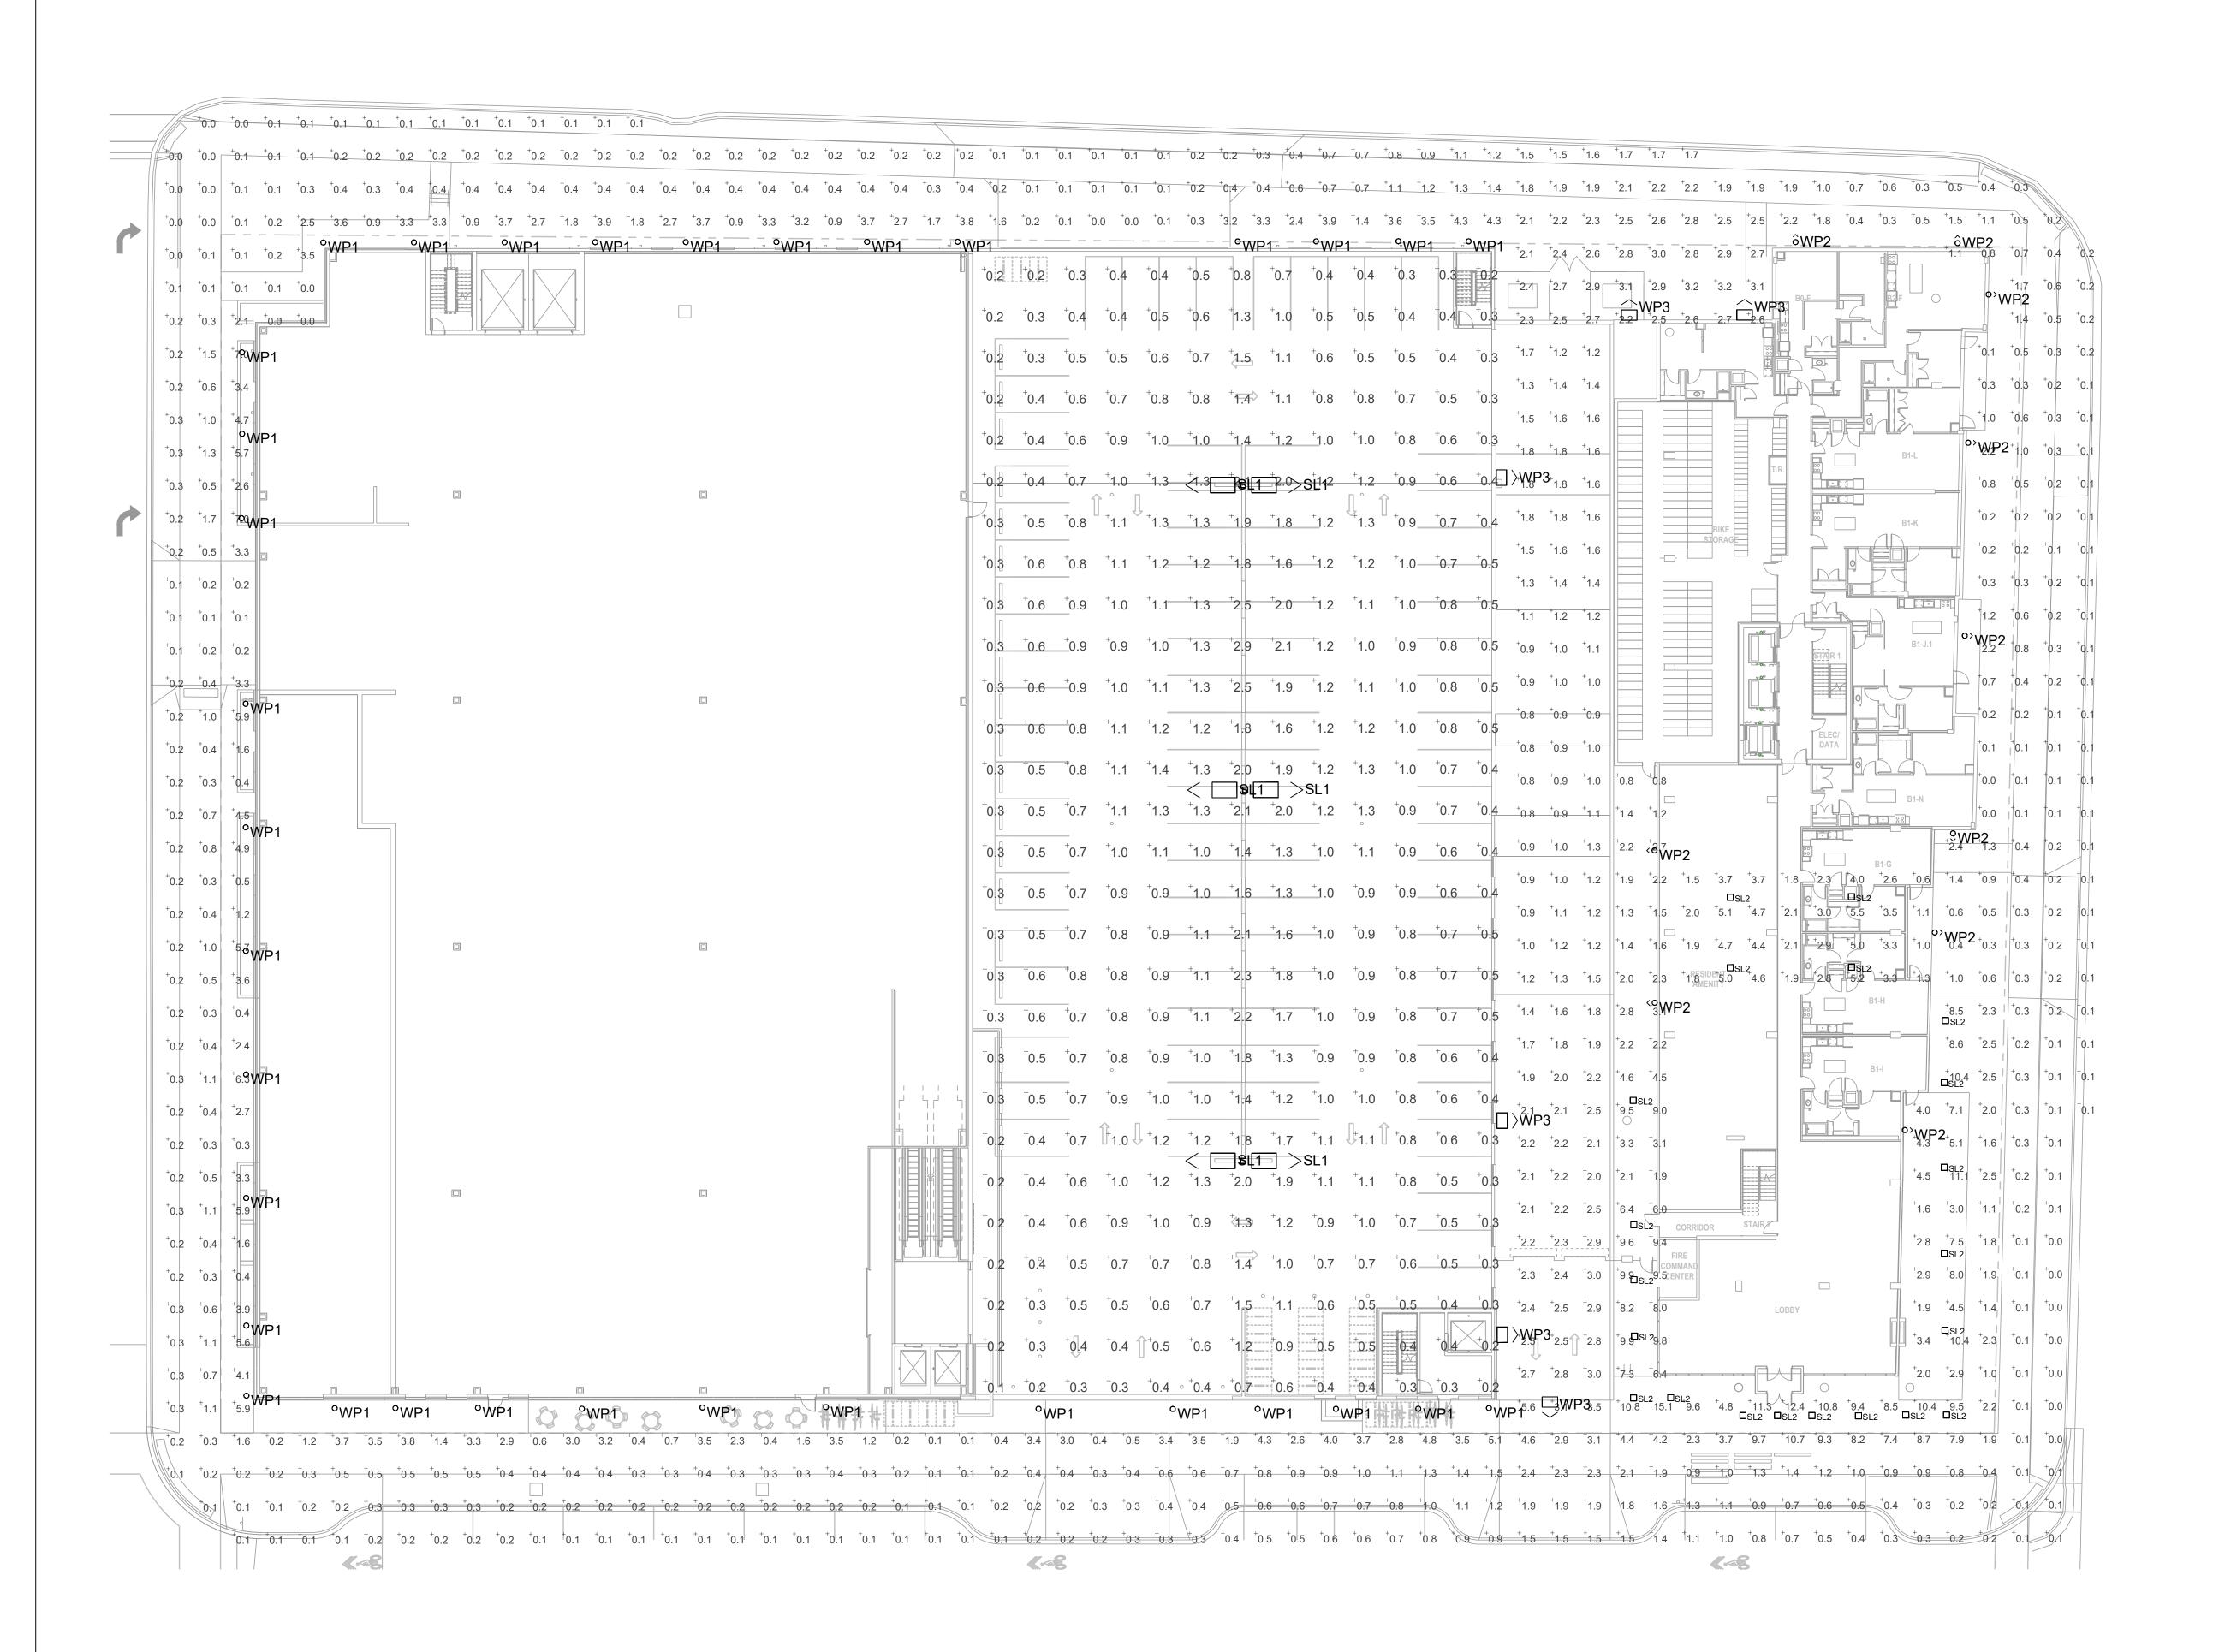

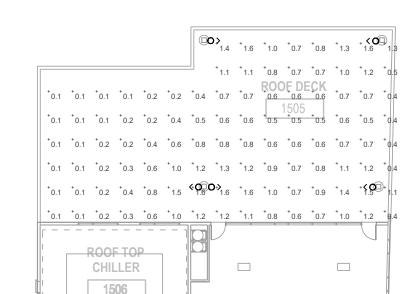







CONSULTING ENGINEERS 3639 SW Summerfield Drive, Suite A Topeka, Kansas 66614-3974 8625 College Boulevard, Suite 102 Overland Park, Kansas 66210 Telephone: (785) 233-3232 Email: Isapa@Isapa.com

LSA Project No: #2007004 David Everhart

LSA PROJECT NO. 2007004

deverhart@lsapa.com Email: David Everhart Principal: Project Designer: David Everhart

Developer

Gilbane Development Company

Contact: Shawn Zimny Address: 225. W. Wacker Dr. Suite 2160 Chicago, IL 60606

312.907.4493

Phone:

2

No.	Date	Description

contractor thoroughly knowledgeable with the building codes and methods of construction should reasonably be aware. Written instructions addressing such lient's subcontractors proceeding with the work. The client will be responsible for any


DESIGN DEVELOPMENT 11/16/2020

COPYRIGHT (C)

SITE PHOTOMETRIC PLAN

^{1.} Provide with 25' tall square straight steel pole. 2. Provide with (2) heads mounted on single pole, 180 degrees apart




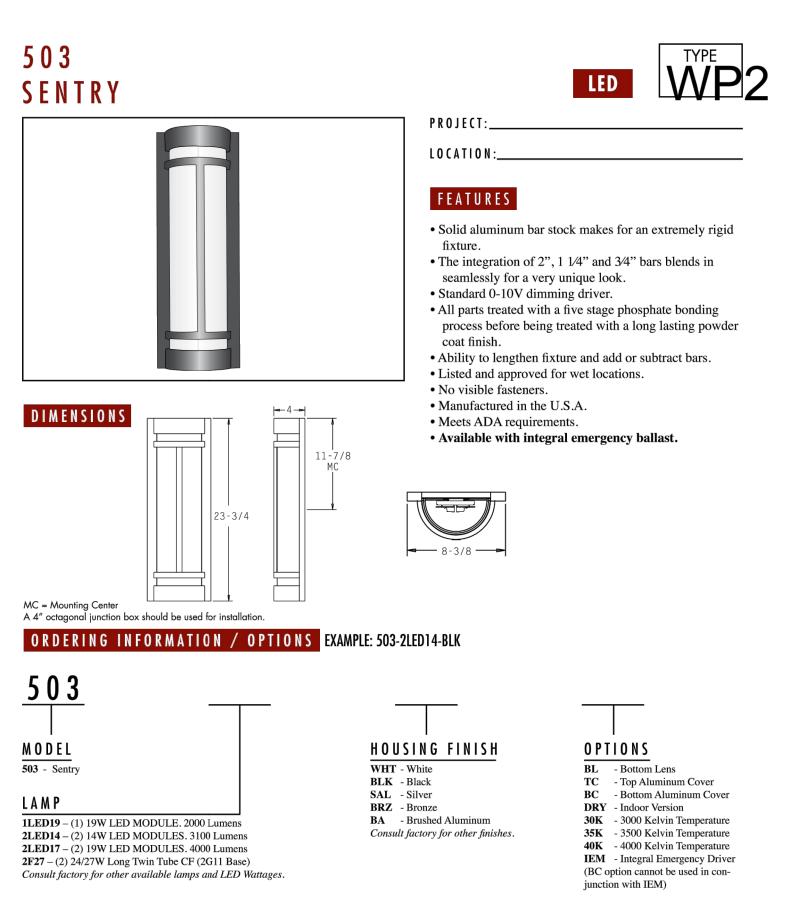


PHONE: 509.924.0243 • FAX: 509.924.2607 • www.indessa.com

Indessa Lighting reserves the right to make design revisions without prior notice.

LIGHTING

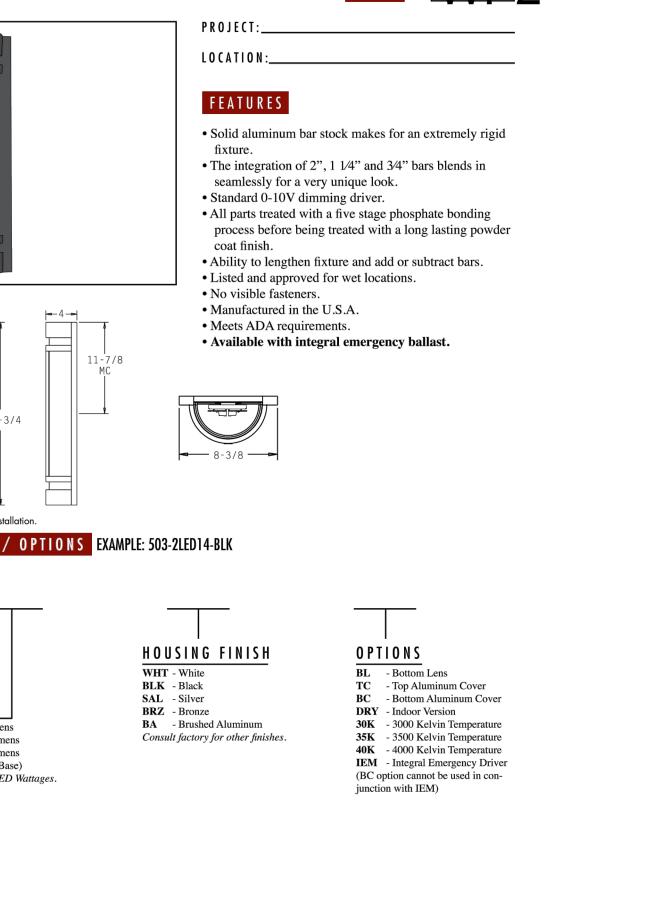


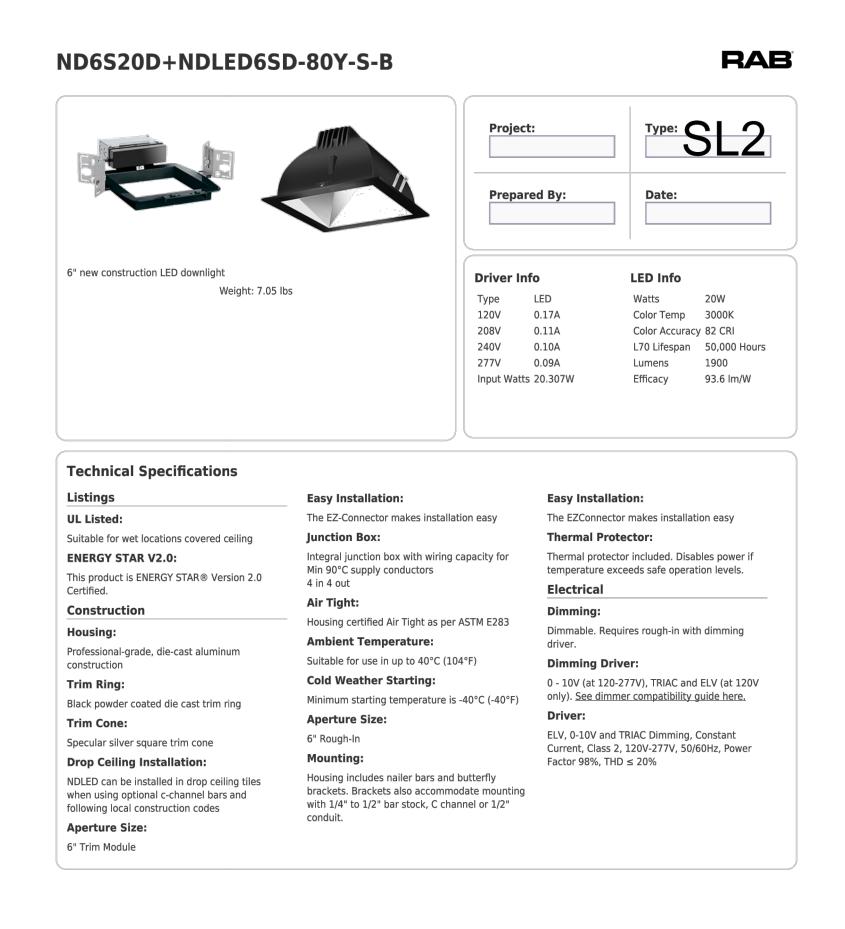



Need help? Tech help line: (888) 722-1000 Email: custserv@rablighting.com Website: www.rablighting.com

Copyright © 2020 RAB Lighting All Rights Reserved Note: Specifications are subject to change at any time without notice

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CONSULTING ENGINEERS

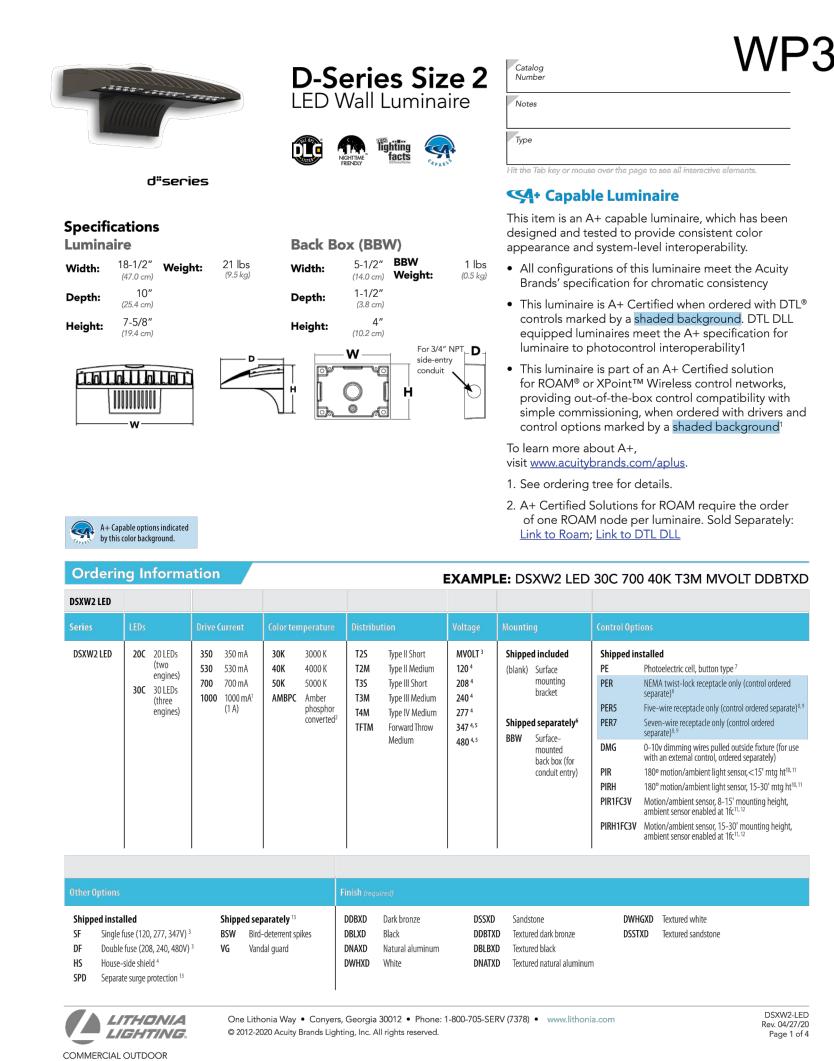3639 SW Summerfield Drive, Suite A Topeka, Kansas 66614-3974

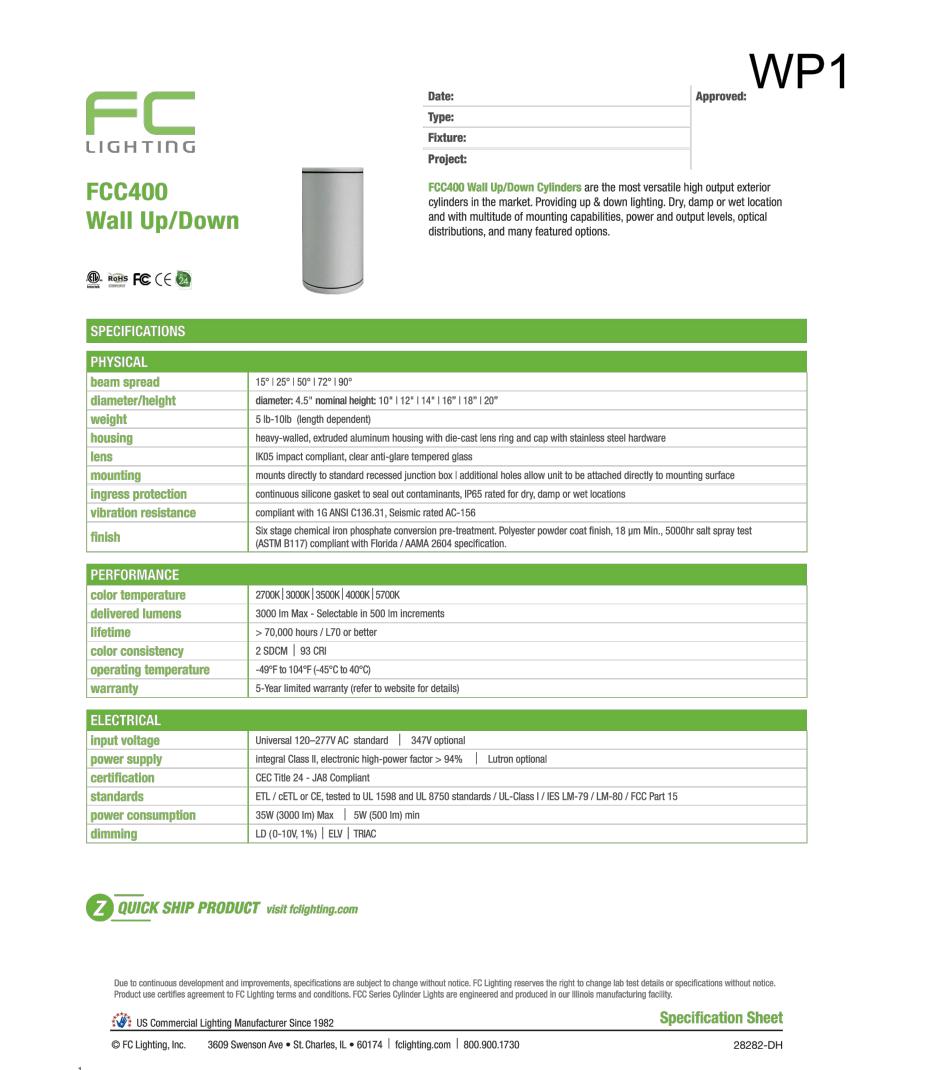8625 College Boulevard, Suite 102

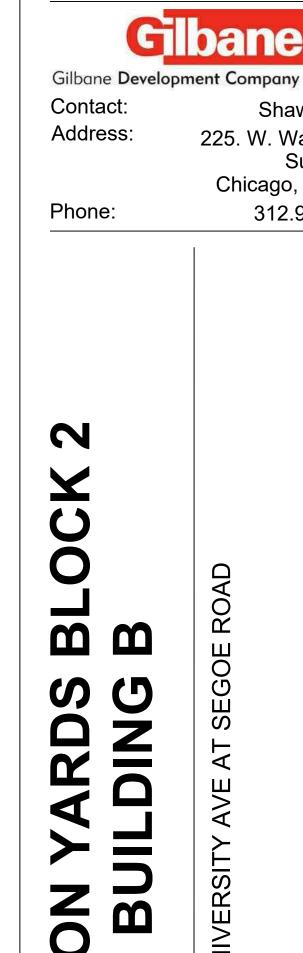Overland Park, Kansas 66210

Telephone: (785) 233-3232 Email: lsapa@lsapa.com

LSA PROJECT NO. 2007004

#2007004

David Everhart

David Everhart

Shawn Zimny

Suite 2160

225. W. Wacker Dr.

Chicago, IL 60606

312.907.4493

David Everhart

deverhart@lsapa.com

LSA Project No:

Project Designer:

Email:

Principal:

Developer

No.	Date	Description

It is the client's responsibility prior to or during construction to notify the architect in writing of any perceived errors or omissions in the plans and specifications of which a contractor thoroughly knowledgeable with the building codes and methods of construction should reasonably be aware. Written instructions addressing such client's subcontractors proceeding with the work. The client will be responsible for any defects in construction if these procedures are not followed.

DESIGN DEVELOPMENT 11/16/2020

SITE PHOTOMETRIC PLAN

MADISON YARDS AT HILLS FARMS BLOCK 2 PRIVATE IMPROVEMENTS SET


CITY OF MADISON, WISCONSIN

701 GARDENER ROAD, MADISON, WI 53705

DRAWING INDEX

	TOPOGRAPHIC SURVEY
B2-C0.1	BLOCK 2 NOTES & LEGEND
B2-C1.0 B2-C1.1 B2-C1.2 B2-C1.3 B2-C1.4	BLOCK 2 OVERALL SITE PLAN BLOCK 2 DETAILED SITE PLAN - NORTHWEST BLOCK 2 DETAILED SITE PLAN - SOUTHWEST BLOCK 2 DETAILED SITE PLAN - NORTHEAST BLOCK 2 DETAILED SITE PLAN - SOUTHEAST
B2-C2.0 B2-C2.1 B2-C2.2 B2-C2.3 B2-C2.4	BLOCK 2 GRADING & EROSION CONTROL PLAN BLOCK 2 DETAILED GRADING PLAN - NORTHWEST BLOCK 2 DETAILED GRADING PLAN - SOUTHWEST BLOCK 2 DETAILED GRADING PLAN - NORTHEAST BLOCK 2 DETAILED GRADING PLAN - SOUTHEAST
B2-C3.0	BLOCK 2 UTILITY PLAN
B2-C4.0 B2-C4.1	BLOCK 2 DETAILS - EROSION CONTROL & UTILITIES BLOCK 2 DETAILS - SITE
B2-L1.0 B2-L1.1 B2-L1.2 B2-L1.3 B2-L1.4 B2-L2.0	BLOCK 2 OVERALL LANDSCAPE PLAN BLOCK 2 DETAILED LANDSCAPE PLAN - NORTHWEST BLOCK 2 DETAILED LANDSCAPE PLAN - SOUTHWEST BLOCK 2 DETAILED LANDSCAPE PLAN - NORTHEAST BLOCK 2 DETAILED LANDSCAPE PLAN - SOUTHEAST BLOCK 2 LANDSCAPE DETAILS & NOTES

BLOCK 2 TITLE SHEET

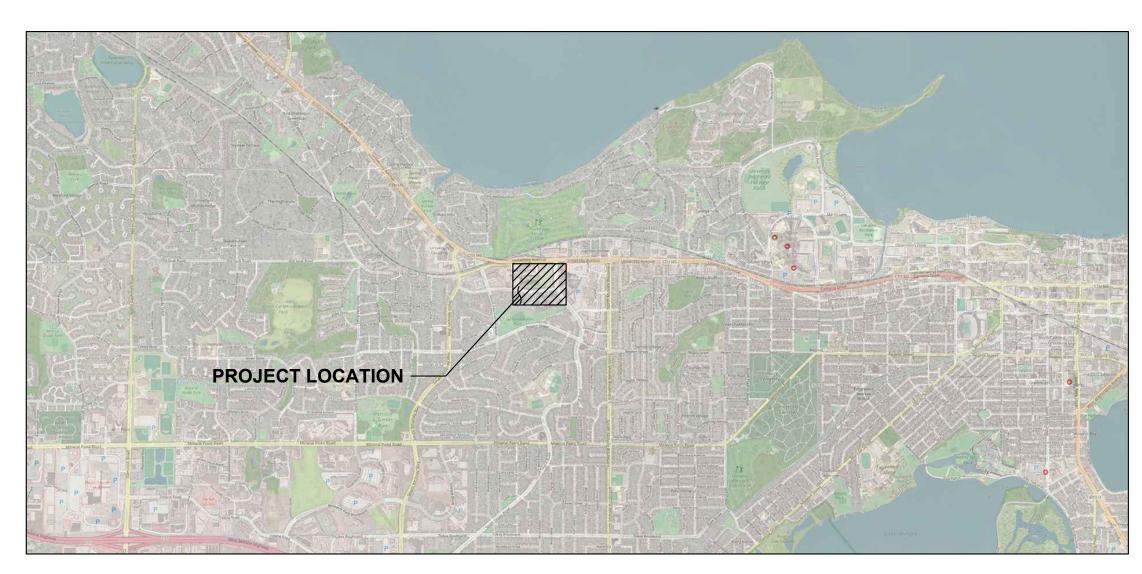





PROJECT INFORMATION

OWNER SMITH - GILBANE PROJECT CONTACT: SEAN ROBERTS 241 N. Broadway, Suite 400 Milwaukee, WI 53202 414-453-0110 412.999.9643

sroberts@summitsmith.com

JSD PROFESSIONAL SERVICES, INC.

PROJECT CONSULTANT / LANDSCAPE ARCHITECT

PROJECT CONTACT: KEVIN YESKA 161 Horizon Drive, Suite 101 608-848-5060

JSD PROFESSIONAL SERVICES, INC. PROJECT CONTACT: TOMAS TORO 161 Horizon Drive, Suite 101 Verona, WI 53593 608-848-5060

608-963-2133 tomas.toro@jsdinc.com

CONSTRUCTION MANAGER SMITH - GILBANE PROJECT CONTACT: JASON BOS 241 N. Broadway, Suite 400 Milwaukee, WI 53202

920-948-0692 jbos@cdsmith.com

ARCHITECT

KAHLER SLATER WHOLE FOODS CONTACT: ETHAN SKEELS 648 NORTH PLANKINTON AVENUE **MILWAUKEE. WI 53203** 414-272-2000

414-290-3778 eskeels@kahlerslater.com

KAHLER SLATER **HOTEL CONTACT: AARON EBENT** 648 NORTH PLANKINTON AVENUE **MILWAUKEE, WI 53203**

414-897-1990 414-290-3777

aebent@kahlerslater.com

MUNICIPAL CONTACTS

CITY OF MADISON DEPARTMENT OF PUBLIC **WORKS/ENGINEER CONTACT: JANET SCHMIDT City-County Building, Room 115**

210 Martin Luther King Jr. Boulevard Madison, WI 53703 P: 608-261-9688

E: jschmidt@cityofmadison.com

CITY OF MADISON FORESTRY CONTACT: BRAD HOFMANN

608-267-4908 608-220-6796

bhofmann@cityofmadison.com

UTILITY CONTACTS

Madison Gas & Electric Company CONTACT: STEVE BEVERSDORF 133 South Blair Street Madison, WI 53788 608-252-1552

608-444-9620

sbeversdorf@mge.com

Madison Gas & Electric Company CONTACT: BRIAN BIGGE 623 Railroad Street Madison, WI 53703

ELECTRIC

608-252-7338 E: bbigge@mge.com

PROJECT LOCATION: **701 GARDENER ROAD**

MADISON, WI 53705

BLOCK 2

HILL FARMS

CREATE THE VISION TELL THE STORY

MADISON | MILWAUKEE | WAUSAU APPLETON KENOSHA CHICAGO
COEUR D'ALENE

MADISON REGIONAL OFFICE 161 HORIZON DRIVE, SUITE 101 VERONA, WISCONSIN 53593

P. 608.848.5060

SMITH Glbar

241 N. BROADWAY, SUITE 400


MILWAUKEE, WI 53202

MADISON YARDS AT

REVIEW DRAWING **NOT TO BE USED** FOR CONSTRUCTION

01.24.2020 WHOLE FOODS DD SUBMITTA 02.28.2020 GMP SET 11.18.2020 LAND USE - UDC RESUBMITTAL

B2-TS

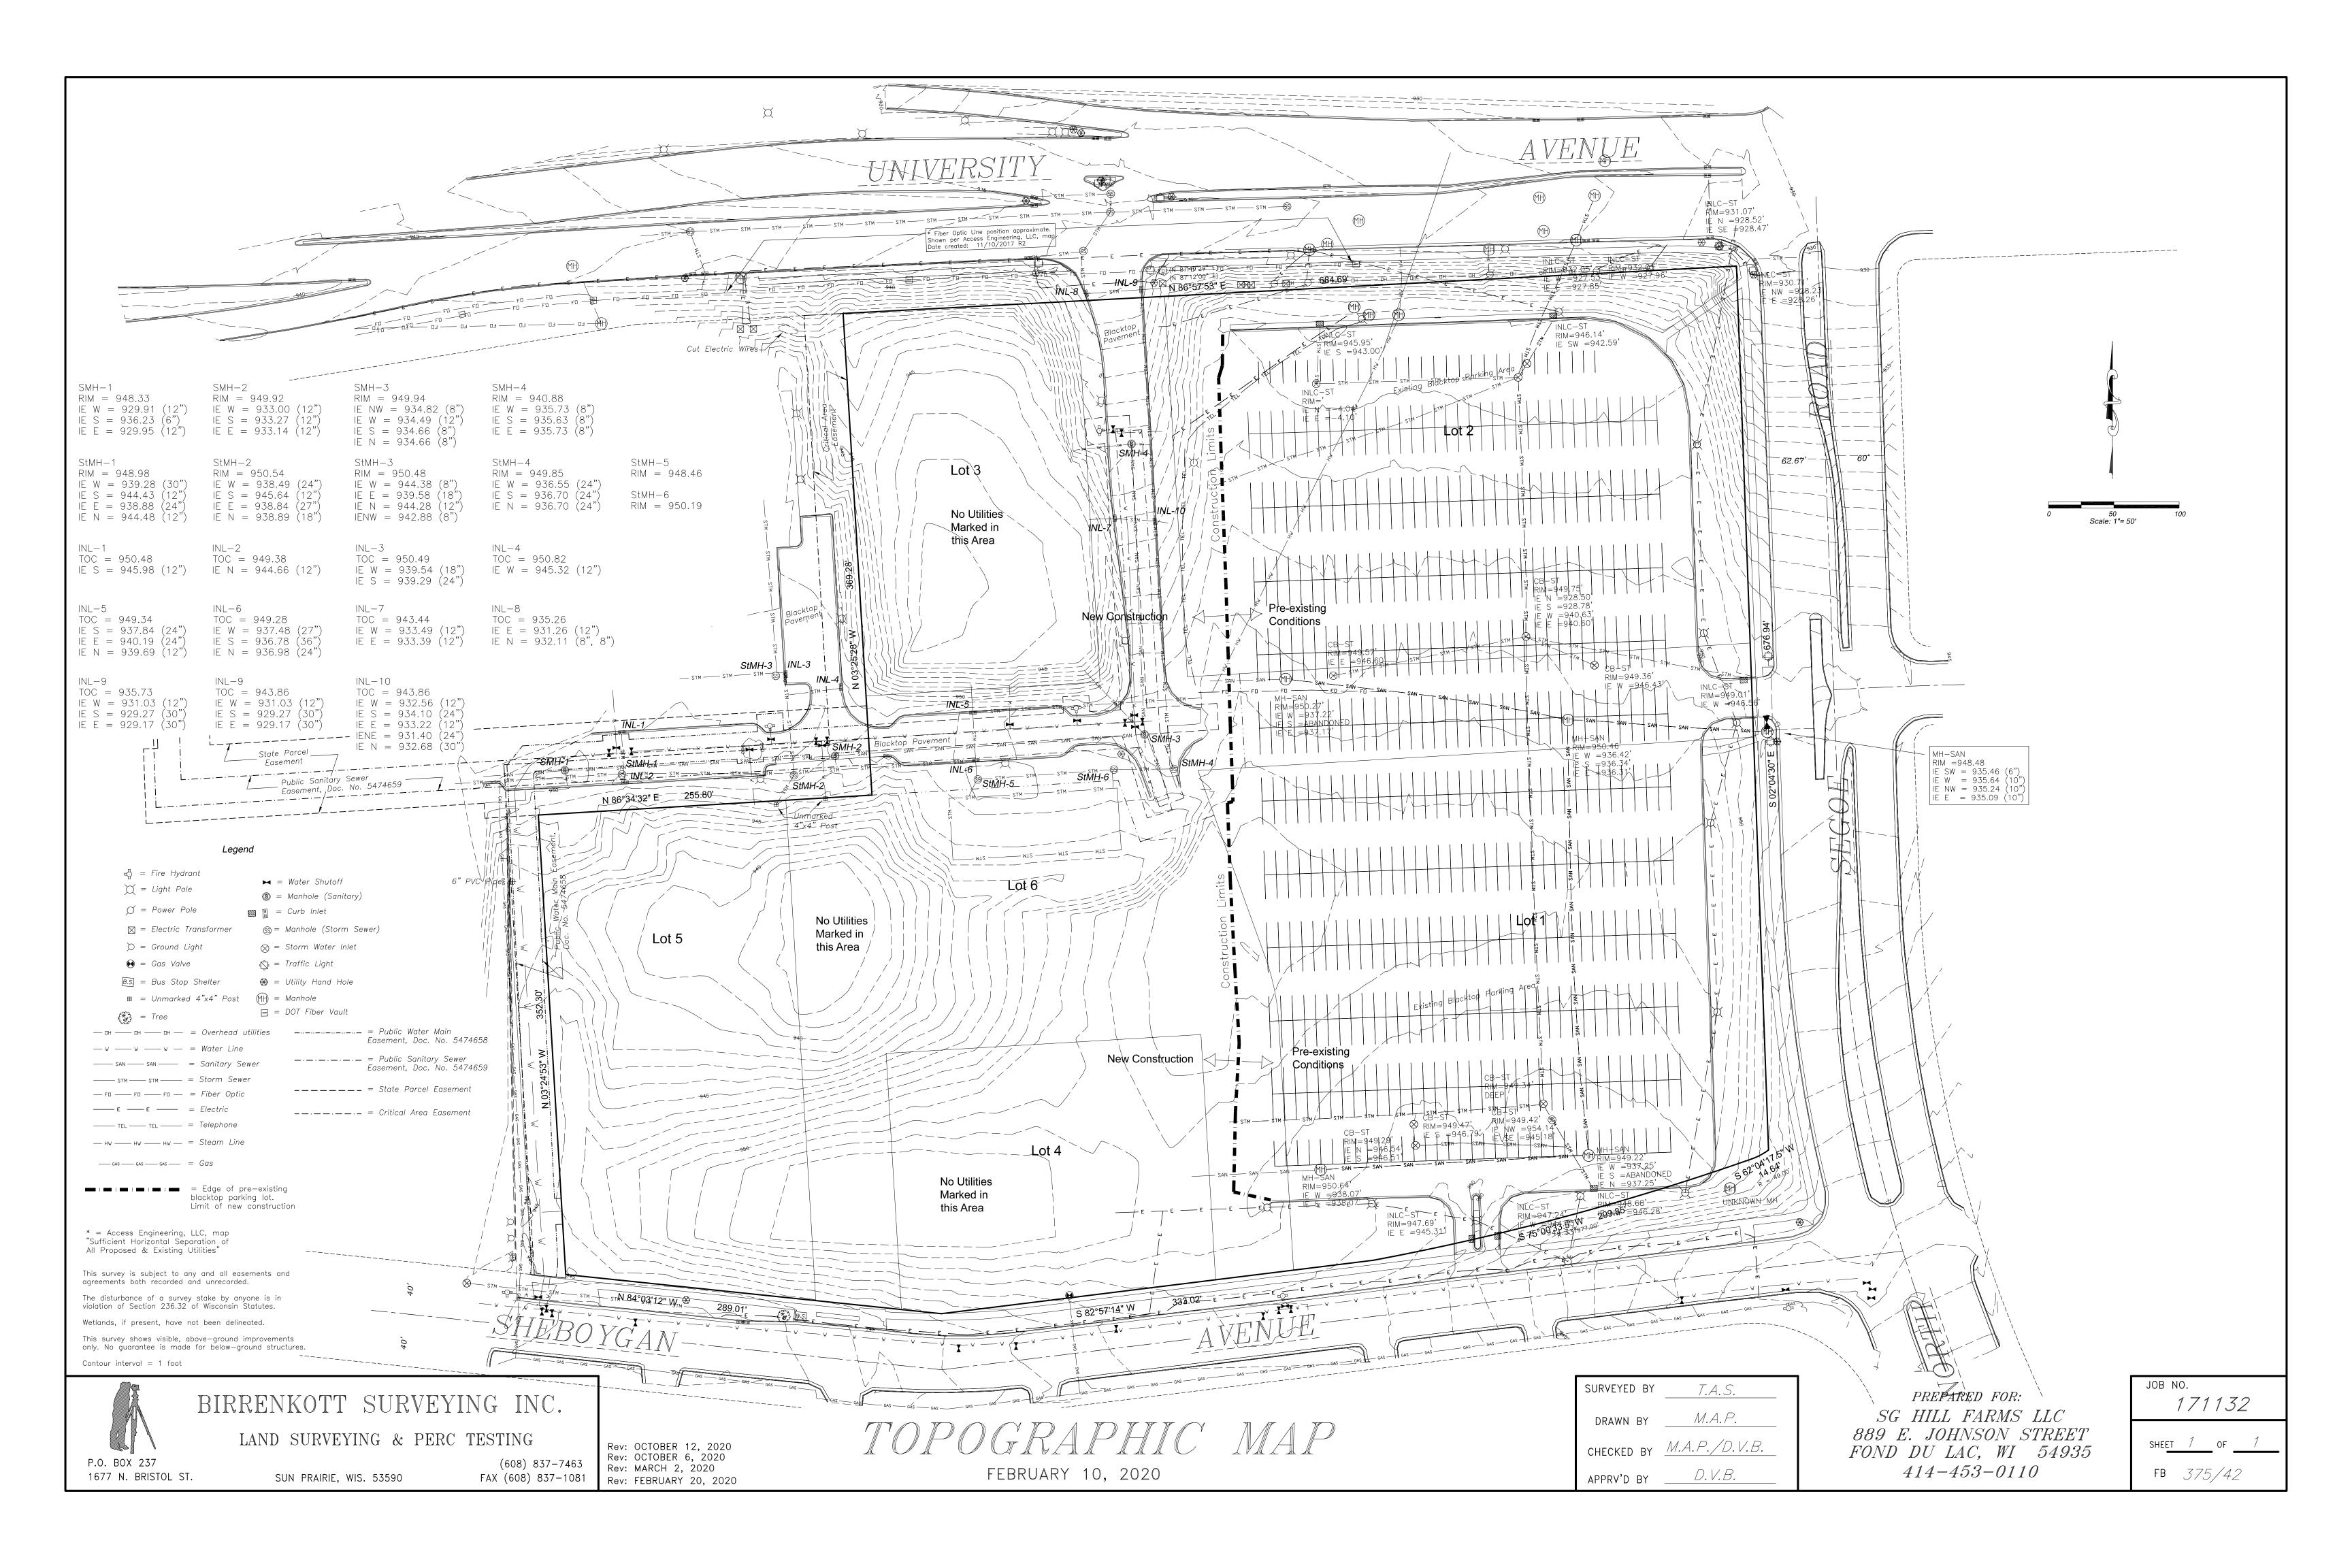

GENERAL NOTES

- 1. REFER TO THE EXISTING CONDITIONS SURVEY FOR EXISTING CONDITIONS NOTES AND LEGENDS. ALL WORK IN THE ROW AND/OR PUBLIC EASEMENTS SHALL BE IN ACCORDANCE WITH THE STANDARD
- SPECIFICATIONS FOR SEWER & WATER CONSTRUCTION IN WISCONSIN AND MUNICIPAL REQUIREMENTS. 3. EXISTING GRADE SPOT ELEVATIONS SHOWN FOR INFORMATIONAL PURPOSES. DURING CONSTRUCTION VERIFY AND MATCH EXISTING GRADES AT CONSTRUCTION LIMITS.
- 4. NO SITE GRADING OUTSIDE OR DOWNSLOPE OF PROPOSED SILT FENCE LOCATION. NO LAND DISTURBANCE BEYOND PROPERTY LINES.
- 5. JSD SHALL BE HELD HARMLESS AND DOES NOT WARRANT ANY DEVIATIONS BY THE OWNER/CONTRACTOR FROM THE APPROVED CONSTRUCTION PLANS THAT MAY RESULT IN DISCIPLINARY ACTIONS BY ANY OR ALL REGULATORY AGENCIES.

PAVING NOTES

- 1.1. ALL PAVING SHALL CONFORM TO "STATE OF WISCONSIN STANDARD SPECIFICATIONS FOR HIGHWAY & STRUCTURE CONSTRUCTION, LATEST EDITION, APPLICABLE CITY OF MADISON ORDINANCES AND THE GEOTECHNICAL REPORT PREPARED BY CGC INC. DATED FEBRUARY 27, 2018 (REPORT
- 1.2. ALL PAVING DIMENSIONS ARE TO FACE OF CURB UNLESS SPECIFIED OTHERWISE.
- 1.3. SURFACE PREPARATION NOTIFY ENGINEER/OWNER OF UNSATISFACTORY CONDITIONS. DO NOT BEGIN PAVING WORK UNTIL DEFICIENT SUBBASE AREAS HAVE BEEN CORRECTED AND ARE READY
- 1.4. ANY REQUIRED REPLACEMENT OF PUBLIC CURB AND GUTTER SHALL MATCH EXISTING AND MEET

CITY OF MADISON REQUIREMENTS. 2. ASPHALTIC CONCRETE PAVING SPECIFICATIONS

- 2.1. CODES AND STANDARDS THE PLACING, CONSTRUCTION AND COMPOSITION OF THE ASPHALTIC BASE COURSE AND ASPHALTIC CONCRETE SURFACE COURSE SHALL BE IN ACCORDANCE WITH THE REQUIREMENTS OF SECTIONS 450, 455, 460 AND 465 OF THE STATE OF WISCONSIN STANDARD SPECIFICATIONS FOR HIGHWAY AND STRUCTURE CONSTRUCTION, CURRENT EDITION. HEREAFTER, THIS PUBLICATION WILL BE REFERRED TO AS STATE HIGHWAY SPECIFICATIONS.
- 2.2. WEATHER LIMITATIONS APPLY TACK COATS WHEN AMBIENT TEMPERATURE IS ABOVE 50° F (10° C) AND WHEN TEMPERATURE HAS NOT BEEN BELOW 35° F (1° C) FOR 12 HOURS IMMEDIATELY PRIOR TO APPLICATION. DO NOT APPLY WHEN BASE IS WET OR CONTAINS EXCESS OF MOISTURE. CONSTRUCT ASPHALTIC CONCRETE SURFACE COURSE WHEN ATMOSPHERIC TEMPERATURE IS ABOVE 40° F (4° C) AND WHEN BASE IS DRY AND WHEN WEATHER IS NOT RAINY. BASE COURSE MAY BE PLACED WHEN AIR TEMPERATURE IS ABOVE 30° F (-1° C).
- 2.3. GRADE CONTROL ESTABLISH AND MAINTAIN REQUIRED LINES AND ELEVATIONS FOR EACH COURSE DURING CONSTRUCTION.
- 2.4. CRUSHED AGGREGATE BASE COURSE THE TOP LAYER OF BASE COURSE SHALL CONFORM TO SECTIONS 301 AND 305, STATE HIGHWAY SPECIFICATIONS.
- 2.5. BINDER COURSE AGGREGATE THE AGGREGATE FOR THE BINDER COURSE SHALL CONFORM TO SECTIONS 460 AND 315, STATE HIGHWAY SPECIFICATIONS.
- 2.6. SURFACE COURSE AGGREGATE THE AGGREGATE FOR THE SURFACE COURSE SHALL CONFORM TO SECTIONS 460 AND 465, STATE HIGHWAY SPECIFICATIONS.
- 2.7. ASPHALTIC MATERIALS THE ASPHALTIC MATERIALS SHALL CONFORM TO SECTION 455 AND 460, STATE HIGHWAY SPECIFICATIONS.

3. CONCRETE PAVING SPECIFICATIONS

- 3.1. CONCRETE PAVING SHALL BE IN ACCORDANCE WITH THE REQUIREMENTS OF SECTIONS 415 AND 416 OF THE STATE HIGHWAY SPECIFICATIONS.
- 3.2. CONCRETE PAVEMENT SHALL BE REINFORCED WITH NOVOMESH 950 (OR EQUAL) FIBER
- REINFORCEMENT AT A RATE OF 5 LBS/CUBIC YARD. 3.3. CURING COMPOUNDS SHALL CONFORM TO SECTION 415 OF THE STATE HIGHWAY SPECIFICATIONS.
- 3.4. CONTRACTOR SHALL PROVIDE CONTROL JOINTS AND CONSTRUCTION JOINTS OF ONE-QUARTER CONCRETE THICKNESS AT AN EQUAL RATIO OF LENGTH TO WIDTH WHEREVER POSSIBLE WITH A
- 3.5. CONTRACTOR SHALL PROVIDE EXPANSION JOINTS IN SIDEWALKS AT A MAXIMUM 24' ON CENTER.
- 3.6. EXTERIOR CONCRETE SURFACES SHALL BE BROOM FINISHED.
- 3.7. ALL CONCRETE SURFACES TO BE SEALED WITH TYPE TK-26UV CONCRETE SEALANT.

MAXIMUM LENGTH BETWEEN JOINTS OF 8' ON CENTER.

4. PAVEMENT MARKING SPECIFICATIONS

STANDARD 1059 AND CITY OF MADISON ORDINANCE.

- 4.1. USE 4" WIDE, HIGH VISIBILITY YELLOW LATEX PAINT FOR STALL LINES.
- 4.2. MARK AND STRIPE ADA PARKING SPACES APPROPRIATELY.
- 4.3. ALL PAVEMENT MARKINGS INCLUDING: STOP BARS, CROSSWALKS, DIRECTIONAL ARROWS, PARKING STALL LINES, ADA STALL MARKINGS, NO PARKING ZONES, DROP-OFF/PICK-UP ZONES SHALL BE PAINTED WITH LATEX PAINT PER SPECIFICATIONS.
- 4.4. 2' x 4' TRUNCATED DOME WARNING DETECTION FIELD SHALL BE PLACED AT ALL ADA RAMPS.

GRADING AND SEEDING NOTES

- 1. ALL PROPOSED GRADES SHOWN ARE FINISHED GRADES. CONTRACTOR SHALL VERIFY ALL GRADES, MAKE SURE ALL AREAS WILL DRAIN PROPERLY AND SHALL REPORT ANY DISCREPANCIES TO THE ENGINEER PRIOR TO CONSTRUCTION.
- 2. PARKING LOT AND DRIVEWAY ELEVATIONS ARE PAVEMENT GRADES, NOT TOP OF CURB GRADES, UNLESS OTHERWISE NOTED.
- 3. ANY WORK WITHIN RIGHT-OF-WAY SHALL BE PROPERLY PERMITTED AND COORDINATED WITH THE APPROPRIATE OFFICIALS PRIOR TO COMMENCEMENT OF ANY CONSTRUCTION ACTIVITIES. ALL GRADING WITHIN RIGHT-OF-WAY IS SUBJECT TO APPROVAL BY SAID OFFICIALS.
- 4. CONTRACTOR SHALL PROVIDE NOTICE TO THE CITY OF MADISON IN ADVANCE OF ANY SOIL DISTURBING ACTIVITIES, IN ACCORDANCE WITH CITY OF MADISON REQUIREMENTS.
- 5. ALL DISTURBED AREAS SHALL BE SODDED AND/OR SEEDED AND MULCHED IMMEDIATELY FOLLOWING GRADING ACTIVITIES. SOD/SEED MIX TO BE IN ACCORDANCE WITH LANDSCAPE PLAN.
- 6. CONTRACTOR SHALL WATER ALL NEWLY SODDED/SEEDED AREAS DURING THE SUMMER MONTHS WHENEVER THERE IS A 7 DAY LAPSE WITH NO SIGNIFICANT RAINFALL.
- 7. CONTRACTOR TO DEEP TILL ALL COMPACTED PERVIOUS SURFACES PRIOR TO SODDING AND/OR SEEDING AND MULCHING.
- 8. ALL SLOPES 20% OR GREATER SHALL BE TEMPORARY SEEDED, MULCHED, OR OTHER MEANS OF COVER PLACED ON THEM WITHIN 2 WEEKS OF DISTURBANCE.
- 9. ALL EXPOSED SOIL AREAS THAT WILL NOT BE BROUGHT TO FINAL GRADE OR ON WHICH LAND DISTURBING ACTIVITIES WILL NOT BE PERFORMED FOR A PERIOD GREATER THAN 30 DAYS AND REQUIRE VEGETATIVE COVER FOR LESS THAN 1 YEAR, REQUIRE TEMPORARY SEEDING FOR EROSION CONTROL. SEEDING FOR EROSION CONTROL SHALL BE IN ACCORDANCE WITH WDNR TECHNICAL

UTILITY NOTES

- 1. ALL EXISTING UTILITIES ARE SHOWN FOR INFORMATIONAL PURPOSES ONLY AND ARE NOT GUARANTEED TO BE ACCURATE OR ALL INCLUSIVE. THE CONTRACTOR IS RESPONSIBLE FOR MAKING HIS OWN DETERMINATION AS TO THE SIZE, TYPE, ELEVATION, AND LOCATIONS OF UNDERGROUND UTILITIES AS MAY BE NECESSARY TO AVOID DAMAGE THERETO. CONTRACTOR/OWNER SHALL CALL "DIGGER'S HOTLINE" PRIOR TO ANY CONSTRUCTION.
- 2. PRIOR TO CONSTRUCTION, THE PRIME CONTRACTOR IS RESPONSIBLE FOR: * EXAMINING ALL SITE CONDITIONS RELATIVE TO THE CONDITIONS INDICATED ON THE
 - ENGINEERING DRAWINGS. ANY DISCREPANCIES ARE TO BE REPORTED TO THE ENGINEER AND RESOLVED PRIOR TO THE START OF CONSTRUCTION. * OBTAINING ALL PERMITS INCLUDING PERMIT COSTS. TAP FEES, METER DEPOSITS, BONDS, AND ALL OTHER FEES REQUIRED FOR PROPOSED WORK TO OBTAIN OCCUPANCY. * VERIFYING ALL ELEVATIONS, LOCATIONS AND SIZES OF SANITARY, WATER AND STORM LATERALS AND CHECK ALL UTILITY CROSSINGS FOR CONFLICTS. NOTIFY ENGINEER OF ANY
 - DISCREPANCY. NO WORK SHALL BE PERFORMED UNTIL THE DISCREPANCY IS RESOLVED. NOTIFYING ALL UTILITIES PRIOR TO INSTALLATION OF ANY UNDERGROUND IMPROVEMENTS * NOTIFYING THE DESIGN ENGINEER AND MUNICIPALITY 48 HOURS PRIOR TO THE START OF CONSTRUCTION TO ARRANGE FOR APPROPRIATE CONSTRUCTION OBSERVATION. * COORDINATING ALL CONSTRUCTION WITH OTHER CONTRACTORS INVOLVED WITH CONSTRUCTION OF THE PROPOSED DEVELOPMENT AND FOR REPORTING ANY ERRORS OR DISCREPANCIES
- 3. ALL UTILITY WORK SHALL BE DONE IN ACCORDANCE WITH THE STANDARD SPECIFICATIONS FOR SEWER AND WATER CONSTRUCTION IN WISCONSIN - AND ALL STATE AND LOCAL CODES AND SPECIFICATIONS. IT IS THE CONTRACTORS RESPONSIBILITY TO DETERMINE WHICH SPECIFICATIONS AND CODES APPLY, AND TO COORDINATE ALL CONSTRUCTION ACTIVITIES WITH THE APPROPRIATE LOCAL AND STATE
- 4. SPECIFICATIONS SHALL COMPLY WITH THE CITY OF MADISON SPECIAL PROVISIONS.

OWNER'S SATISFACTION AT THE CONTRACTOR'S EXPENSE.

BETWEEN THESE PLANS AND PLANS PREPARED BY OTHERS.

- . LENGTHS OF ALL UTILITIES ARE TO CENTER OF STRUCTURES OR FITTINGS AND MAY VARY SLIGHTLY FROM PLAN. LENGTHS SHALL BE VERIFIED IN THE FIELD DURING CONSTRUCTION.
- 6. CONTRACTOR IS RESPONSIBLE FOR SITE SAFETY DURING THE CONSTRUCTION OF IMPROVEMENTS. CONTRACTOR SHALL INSTALL A PEDESTRIAN FENCE AROUND ALL EXCAVATIONS TO BE LEFT OPEN OVER NIGHT AS REQUIRED IN CONSTRUCTION SITES WHERE THE POTENTIAL FOR PEDESTRIAN INJURY
- 8. CONTRACTOR SHALL ADJUST AND/OR RECONSTRUCT ALL UTILITY COVERS (SUCH AS MANHOLE COVERS, VALVE BOX COVERS, ETC.) TO MATCH THE FINISHED GRADES OF THE AREAS EFFECTED BY THE
- 9. THE PRIME CONTRACTOR IS RESPONSIBLE FOR COORDINATING ALL CONSTRUCTION WITH OTHER CONTRACTORS INVOLVED WITH CONSTRUCTION OF THE PROPOSED DEVELOPMENT AND FOR REPORTING ANY ERRORS OR DISCREPANCIES BETWEEN THESE PLANS AND PLANS PREPARED BY OTHERS. 10. ANY SANITARY SEWER, SANITARY SEWER SERVICES, WATER MAIN, WATER SERVICES, STORM SEWER, OR OTHER UTILITIES, WHICH ARE DAMAGED BY THE CONTRACTORS, SHALL BE REPAIRED TO THE
- 11. THE CONTRACTOR IS RESPONSIBLE FOR PROVIDING THE ENGINEER WITH AS-BUILT CONDITIONS OF THE DESIGNATED IMPROVEMENTS IN ORDER THAT THE APPROPRIATE DRAWINGS CAN BE PREPARED, IF EQUIRED. ANY CHANGES TO THE DRAWINGS OR ADDITIONAL ITEMS MUST BE REPORTED TO THE ENGINEER AS WORK PROGRESSES.
- PIPE REINFORCED CONCRETE PIPE (RCP) SHALL MEET THE REQUIREMENTS OF ASTM CLASS III (MINIMUM) C-76 WITH RUBBER GASKET JOINTS CONFORMING TO ASTM C-443. HIGH DENSITY DUAL-WALL POLYETHYLENE CORRUGATED PIPE SHALL BE AS MANUFACTURED BY ADS OR EQUAL WITH WATER TIGHT JOINTS, AND SHALL MEET THE REQUIREMENTS OF AASHTO DESIGNATION M-294 TYPE
- INLETS INLETS SHALL BE CONSTRUCTED IN ACCORDANCE WITH FILE. NO. 28 OF THE "STANDARD

SPECIFICATIONS", OR APPROVED EQUAL WITH A 1'-8" X 2'-6" MAXIMUM OPENING. CURB FRAME &

GRATE SHALL BE NEENAH R-3067 OR EQUAL. BACKFILL AND BEDDING - STORM SEWER SHALL BE CONSTRUCTED WITH GRAVEL BACKFILL AND CLASS "B" BEDDING IN ALL PAVED AREAS AND TO A POINT 5 FEET BEYOND THE EDGE OF PAVEMENT. TRENCHES RUNNING PARALLEL TO AND LESS THAN 5 FEET FROM THE EDGE OF PAVEMENT SHALL ALSO REQUIRE GRAVEL BACKFILL. LANDSCAPED AREAS MAY BE BACKFILLED WITH EXCAVATED MATERIAL

IN CONFORMANCE WITH SECTION 8.43.5 OF THE "STANDARD SPECIFICATIONS".

MANHOLE FRAMES AND COVERS - MANHOLE FRAMES AND COVERS SHALL BE NEENAH R-1550 WITH SELF SEALING LIDS, NON-ROCKING OR EQUAL. FIELD TILE CONNECTION — ALL FIELD TILE ENCOUNTERED DURING CONSTRUCTION SHALL BE INCLUDED IN THE UNIT PRICE(S) FOR STORM SEWER. TILE LINES CROSSED BY THE TRENCH SHALL BE REPLACED

13. WATER MAIN SPECIFICATIONS -

WITH THE SAME MATERIAL AS THE STORM SEWER.

12. STORM SEWER SPECIFICATIONS -

PIPE - DUCTILE IRON PIPE SHALL BE CLASS 52 CONFORMING TO AWWA C151 AND CHAPTER 8.18.0 OF THE "STANDARD SPECIFICATIONS". POLYVINYL CHLORIDE (PVC) PIPE SHALL MEET THE REQUIREMENTS OF AWWA STANDARD C-900, CLASS 150, DR-18, WITH CAST IRON O.D. AND INTEGRAL ELASTOMERIC BELL AND SPIGOT JOINTS. NON-METALLIC WATER MAINS SHALL BE INSTALLED WITH BLUE INSULATION TRACER WIRE AND CONFORM WITH SPS 382.30(11)(h).

VALVES AND VALVE BOXES - GATE VALVES SHALL BE AWWA GATE VALVES MEETING THE REQUIREMENTS OF AWWA C-500 AND CHAPTER 8.27.0 OF THE "STANDARD SPECIFICATIONS". GATE VALVES AND VALVE BOXES SHALL CONFORM TO LOCAL PLUMBING ORDINANCES. HYDRANTS — HYDRANTS SHALL CONFORM TO THE SPECIFICATIONS OF THE CITY OF MADISON. THE DISTANCE FROM THE GROUND LINE TO THE CENTERLINE OF THE LOWEST NOZZLE AND THE LOWEST

BEDDING AND COVER MATERIAL - PIPE BEDDING AND COVER MATERIAL SHALL BE SAND, CRUSHED STONE CHIPS OR CRUSHED STONE SCREENINGS CONFORMING TO CHAPTER 8.43.2 OF THE "STANDARD

CONNECTION OF THE FIRE DEPARTMENT SHALL BE NO LESS THAN 18-INCHES AND NO GREATER THAN

BACKFILL - BACKFILL MATERIAL AND INSTALLATION SHALL BE IN ACCORDANCE WITH CHAPTER 2.6.0 OF THE "STANDARD SPECIFICATIONS". GRAVEL BACKFILL IS REQUIRED IN ALL PAVED AREAS AND TO A POINT 5 FEET BEYOND THE EDGE OF PAVEMENT. TRENCHES RUNNING PARALLEL TO AND LESS THAN 5 FEET FROM THE EDGE OF PAVEMENT SHALL ALSO REQUIRE GRAVEL BACKFILL. LANDSCAPED AREAS MAY BE BACKFILLED WITH EXCAVATED MATERIAL IN CONFORMANCE WITH SECTION 8.43.5 OF THE

"STANDARD SPECIFICATIONS". 14. SANITARY SEWER SPECIFICATIONS -

PIPE - SANITARY SEWER PIPE MATERIAL SHALL BE POLYVINYL CHLORIDE (PVC) MEETING REQUIREMENTS OF ASTM D 3034, SDR-35, WITH INTEGRAL BELL TYPE FLEXIBLE ELASTOMERIC JOINTS, MEETING THE REQUIREMENTS OF ASTM D-3212.

BEDDING AND COVER MATERIAL - BEDDING AND COVER MATERIAL SHALL CONFORM TO THE APPROPRIATE SECTIONS OF THE "STANDARD SPECIFICATION" WITH THE FOLLOWING MODIFICATION: "COVER MATERIAL SHALL BE THE SAME AS USED FOR BEDDING AND SHALL CONFORM TO SECTION 8.43.2 (A). BEDDING AND COVER MATERIAL SHALL BE PLACED IN A MINIMUM OF THREE SEPARATE LIFTS, OR AS REQUIRED TO INSURE ADEQUATE COMPACTING OF THESE MATERIALS, WITH ONE LIFT OF BEDDING MATERIAL ENDING AT OR NEAR THE SPRINGLINE OF THE PIPE. THE CONTRACTOR SHALL TAKE CARE TO COMPLETELY WORK BEDDING MATERIAL UNDER THE HAUNCH OF THE PIPE TO PROVIDE ADEQUATE SIDE SUPPORT."

BACKFILL - BACKFILL MATERIAL AND INSTALLATION SHALL BE IN ACCORDANCE CHAPTER 2.6.0 OF THE "STANDARD SPECIFICATIONS." GRAVEL BACKFILL IS REQUIRED IN ALL PAVED AREAS AND TO A POINT 5 FEET BEYOND THE EDGE OF PAVEMENT. TRENCHES RUNNING PARALLEL TO AND LESS THAN 5 FEET FROM THE EDGE OF PAVEMENT SHALL ALSO REQUIRE GRAVEL BACKFILL. LANDSCAPED AREAS MAY BE BACKFILLED WITH EXCAVATED MATERIAL IN CONFORMANCE WITH SECTION 8.43.5 OF THE "STANDARD

MANHOLES - MANHOLES SHALL BE CONSTRUCTED IN ACCORDANCE WITH FILE NOS. 12, 13 AND 15 OF THE "STANDARD SPECIFICATIONS" AND ALL SPECIAL PROVISIONS OF THE CITY OF MADISON. MANHOLE FRAMES AND COVERS - MANHOLE FRAMES AND COVERS SHALL BE NEENAH R-1550 WITH SELF SEALING LIDS, NON-ROCKING OR EQUAL.

15. WATERMAIN AND SANITARY SEWER SHALL BE INSULATED WHEREVER THE DEPTH OF COVER IS LESS THAN 6 FEET. INSULATION AND INSTALLATION OF INSULATION SHALL BE CONFORMING WITH CHAPTER 4.17.0 "INSULATION" OF THE STANDARD SPECIFICATIONS FOR SEWER AND WATER CONSTRUCTION IN WISCONSIN 6TH EDITION UPDATED WITH ITS LATEST ADDENDUM (TYP.).

EROSION CONTROL NOTES

- CONTRACTOR IS RESPONSIBLE TO NOTIFY ENGINEER OF RECORD AND OFFICIALS OF ANY CHANGES TO THE EROSION CONTROL AND STORMWATER MANAGEMENT PLANS. ENGINEER OF RECORD AND APPROPRIATE CITY OF MADISON OFFICIALS MUST APPROVE ANY CHANGES PRIOR TO DEVIATION FROM THE APPROVED PLANS.
- 2. ALL EROSION CONTROL MEASURES SHALL BE CONSTRUCTED AND MAINTAINED BY THE CONTRACTOR IN ACCORDANCE WITH THE WISCONSIN DEPARTMENT OF NATURAL RESOURCES (WDNR) TECHNICAL STANDARDS (REFERRED TO AS BMP'S) AND CITY OF MADISON ORDINANCE. IT IS THE CONTRACTOR'S RESPONSIBILITY TO OBTAIN A COPY OF THESE STANDARDS. CONTRACTOR SHALL BE RESPONSIBLE FOR ANY ADDITIONAL EROSION CONTROL MEASURES WHICH MAY BE NECESSARY TO MEET UNFORESEEN FIELD CONDITIONS.
- 5. INSTALL PERIMETER EROSION CONTROL MEASURES (SUCH AS CONSTRUCTION ENTRANCES, SILT FENCE AND EXISTING INLET PROTECTION) PRIOR TO ANY SITE WORK, INCLUDING GRADING OR DISTURBANCE OF EXISTING SURFACE COVER. AS SHOWN ON PLAN. MODIFICATIONS TO THE APPROVED EROSION CONTROL DESIGN IN ORDER TO MEET UNFORESEEN FIELD CONDITIONS IS ALLOWED IF MODIFICATIONS. CONFORM TO BMP'S. ALL DESIGN MODIFICATIONS MUST BE APPROVED BY THE CITY OF MADISON
- PRIOR TO DEVIATION OF THE APPROVED PLAN. 4. ADDITIONAL EROSION CONTROL MEASURES, AS REQUESTED BY STATE INSPECTORS, LOCAL INSPECTORS
- 5. INSPECTIONS AND MAINTENANCE OF ALL EROSION CONTROL MEASURES SHALL BE ROUTINE (ONCE PER WEEK MINIMUM) TO ENSURE PROPER FUNCTION OF EROSION CONTROLS AT ALL TIMES. EROSION CONTROL MEASURES ARE TO BE IN WORKING ORDER AT THE END OF EACH WORK DAY.

COUNTY INSPECTORS AND/OR ENGINEER OF RECORD SHALL BE INSTALLED WITHIN 24 HOURS OF

- 6. ALL EROSION AND SEDIMENT CONTROL ITEMS SHALL BE INSPECTED WITHIN 24 HOURS OF ALL RAIN EVENTS EXCEEDING 0.5 INCHES. ANY DAMAGED EROSION CONTROL MEASURES SHALL BE REPAIRED OR REPLACED IMMEDIATELY UPON INSPECTION.
- 7. CONSTRUCTION ENTRANCES SHALL BE INSTALLED AT ALL LOCATIONS OF VEHICLE INGRESS/EGRESS POINTS, ADDITIONAL LOCATIONS OTHER THAN AS SHOWN ON THE PLANS MUST BE PRIOR APPROVED BY THE MUNICIPALITY. CONSTRUCTION ENTRANCES SHALL BE 50' LONG AND NO LESS THAN 12" THICK BY USE OF 3" CLEAR STONE. CONSTRUCTION ENTRANCES SHALL BE MAINTAINED BY THE CONTRACTOR IN A CONDITION WHICH WILL PREVENT THE TRACKING OF MUD OR DRY SEDIMENT ONTO ADJACENT PUBLIC STREETS AFTER EACH WORKING DAY OR MORE FREQUENTLY AS REQUIRED.
- 8. PAVED SURFACES ADJACENT TO CONSTRUCTION SITE VEHICLE ACCESS SHALL BE SWEPT AND/OR SCRAPED TO REMOVE ACCUMULATED SOIL, DIRT AND/OR DUST AFTER THE END OF EACH WORK DAY AND AS REQUESTED BY THE CITY OF MADISON.
- 9. INLET PROTECTION SHALL BE IMMEDIATELY FITTED AT THE INLET OF ALL INSTALLED STORM SEWER AND SILT FENCE SHALL BE IMMEDIATELY FITTED AT ALL INSTALLED CULVERT INLETS TO PREVENT SEDIMENT DEPOSITION WITHIN STORM SEWER SYSTEMS.
- 10. INSTALL EROSION CONTROLS ON THE DOWNSTREAM SIDE OF STOCKPILES. IF STOCKPILE REMAINS UNDISTURBED FOR MORE THAN SEVEN (7) DAYS, TEMPORARY SEEDING AND STABILIZATION IN ACCORDANCE WITH BEST MANAGEMENT PRACTICES IS REQUIRED. IF DISTURBANCE OCCURS BETWEEN NOVEMBER 15TH AND MAY 15TH, THE MULCHING SHALL BE PERFORMED BY HYDRO-MULCHING WITH A
- "TACKIFIER." 11. DITCH CHECKS AND APPLICABLE EROSION NETTING/MATTING SHALL BE INSTALLED IMMEDIATELY AFTER COMPLETION OF GRADING EFFORTS WITHIN DITCHES/SWALES TO PREVENT SOIL TRANSPORTATION.
- 12. EROSION CONTROL FOR UTILITY CONSTRUCTION (STORM SEWER, SANITARY SEWER, WATER MAIN, ETC.): A. PLACE EXCAVATED TRENCH MATERIAL ON THE HIGH SIDE OF THE TRENCH. BACKFILL, COMPACT, AND STABILIZE THE TRENCH IMMEDIATELY AFTER PIPE CONSTRUCTION. C. DISCHARGE TRENCH WATER INTO A SEDIMENTATION BASIN OR FILTERING TANK IN ACCORDANCE WITH THE DEWATERING TECHNICAL STANDARD NO. 1061 PRIOR TO RELEASE INTO THE STORM SEWER, RECEIVING STREAM, OR DRAINAGE DITCH.
- 13. ALL SLOPES 4:1 OR GREATER SHALL BE STABILIZED WITH CLASS I, TYPE B EROSION MATTING OR APPLICATION OF A WISCONSIN DEPARTMENT OF TRANSPORTATION (WisDOT) APPROVED POLYMER SOIL STABILIZATION TREATMENT OR A COMBINATION THEREOF, AS REQUIRED WITHIN 7 DAYS OF REACHING FINAL GRADE AND/OR AS SOON AS CONDITIONS ALLOW. DRAINAGE SWALES SHALL BE STABILIZED WITH CLASS II, TYPE B EROSION MATTING. EROSION MATTING AND/OR NETTING USED ONSITE SHALL BE INSTALLED IN ACCORDANCE WITH MANUFACTURER'S GUIDELINES AND WDNR TECHNICAL STANDARDS
- 14. CONTRACTOR SHALL TAKE ALL NECESSARY STEPS TO CONTROL DUST ARISING FROM CONSTRUCTION OPERATIONS. REFER TO WDNR TECHNICAL STANDARD 1068.
- 15. EROSION CONTROL MEASURES SHALL NOT BE REMOVED UNTIL ALL LAND DISTURBING CONSTRUCTION ACTIVITY AT THE SITE HAS BEEN COMPLETED AND THAT A UNIFORM PERENNIAL VEGETATIVE COVER HAS BEEN ESTABLISHED WITH A DENSITY OF AT LEAST 70% FOR UNPAVED AREAS AND AREAS NOT COVERED BY PERMANENT STRUCTURES OR THAT EMPLOY EQUIVALENT PERMANENT STABILIZATION
- 16. CONTRACTOR/OWNER SHALL FILE A NOTICE OF TERMINATION UPON COMPLETION OF THE PROJECT IN MITH WDNR REQUIREMENTS AND/OR PROPERTY SALE IN ACCORDANCE WITH WDNF
- 17. STABILIZATION PRACTICES: *STABILIZATION MEASURES SHALL BE INITIATED AS SOON AS PRACTICABLE IN PORTIONS OF THE SITE WHERE CONSTRUCTION ACTIVITIES HAVE TEMPORARILY OR PERMANENTLY CEASED.
- NO MORE THAN SEVEN (7) DAYS SHALL PASS AFTER THE CONSTRUCTION ACTIVITY IN THAT PORTION OF THE SITE HAS CEASED UNLESS: *THE INITIATION STABILIZATION MEASURES BY THE SEVENTH (7) DAY AFTER CONSTRUCTION
- ACTIVITY HAS CEASED IS PRECLUDED BY SNOW COVER. IN THAT EVENT, STABILIZATION SHALL BE INITIATED AS SOON AS PRACTICABLE. *CONSTRUCTION ACTIVITY WILL RESUME ON A PORTION OF THE SITE WITHIN FOURTEEN (14) DAYS FROM WHEN ACTIVITY CEASED, (I.E. THE TOTAL TIME PERIOD THAT THE CONSTRUCTION ACTIVITY IS TEMPORARILY CEASED IS LESS THAN FOURTEEN (14) DAYS. IN THAT EVENT,
- STABILIZATION MEASURES DO NOT HAVE TO BE INITIATED ON THAT PORTION OF THE SITE BY THE SEVENTH (7) DAY AFTER CONSTRUCTION ACTIVITY HAS TEMPORARILY CEASED. *STABILIZATION MEASURES SHALL BE DETERMINED BASED ON SITE CONDITIONS AT THE TIME OF CONSTRUCTION ACTIVITY HAS CEASED, INCLUDING BUT NOT LIMITED TO WEATHER CONDITIONS AND LENGTH OF TIME MEASURE MUST BE EFFECTIVE. THE FOLLOWING ARE ACCEPTABLE STABILIZATION MEASURES:

* PERMANENT SEEDING: IN ACCORDANCE WITH APPROVED CONSTRUCTION SPECIFICATION

* TEMPORARY SEEDING; MAY CONSIST OF SPRING OATS(100LBS/ACRE) AND/OR WHEAT OR CEREAL RYE (150LB/ACRE) * HYDRO-MULCHING WITH A TACKIFIER * GEOTEXTILE EROSION MATTING

LEGEND

PROPERTY LINE ----- EASEMENT LINE BUILDING OUTLINE ---- BUILDING OVERHANG — BUILDING SETBACK LINE — — PAVEMENT SETBACK LINE EDGE OF PAVEMENT CONCRETE PAVEMENT HEAVY DUTY CONCRETE PAVEMENT PROPOSED 1 FOOT CONTOUR -----960 PROPOSED 5 FOOT CONTOUR — — ·959· — — EXISTING 1 FOOT CONTOUR DRAINAGE DIRECTION RAILING FENCING FENCE (REFER TO ARCHITECTURAL)

PARKING DROP OFF-PICK UP SIGN BOLLARD BOLLARD WITH SIGN BIKE RACK SANITARY SEWER

WATERMAIN D STORM SEWER 8'x4'x4" INSULATION (PLAN VIEW) 8'x4'x4" INSULATION (PROFILE VIEW)

RIP-RAP

> MATCH - MATCH EXISTING GRADE HP - HIGH POINT SW - SIDEWALK

INLET PROTECTION

CONSTRUCTION ENTRANCE EROSION MATTING . + + + + + + + + + + + + + TURF REINFORCEMENT MATTING SPOT ELEVATION EP - EDGE OF PAVEMENT FG - FINISH GRADE EC - EDGE OF CONCRETE BOC - BACK OF CURB

Professional Services, Inc. Engineers • Surveyers • Planners

CREATE THE VISION TELL THE STORY

APPLETON KENOSHA CHICAGO COEUR D'ALENI MADISON REGIONAL OFFICE

MADISON | MILWAUKEE | WAUSAU

161 HORIZON DRIVE SUITE 101 VERONA, WISCONSIN 53593 P. 608.848.5060

CLIENT ADDRESS: 241 N. BROADWAY, SUITE 400 MILWAUKEE, WI 53202

MADISON YARDS AT **HILL FARMS BLOCK 2**

PROJECT LOCATION: 701 GARDENER ROAD MADISON, WI 53705

> REVIEW DRAWING NOT TO BE USED FOR CONSTRUCTION


Description: 01.24.2020 WHOLE FOODS DD SUBMITTAI 02.28.2020 GMP SET 11.18.2020 LAND USE - UDC RESUBMITTAL


PLAN MODIFICATIONS:

NOTES & LEGEND



B2-C0.1

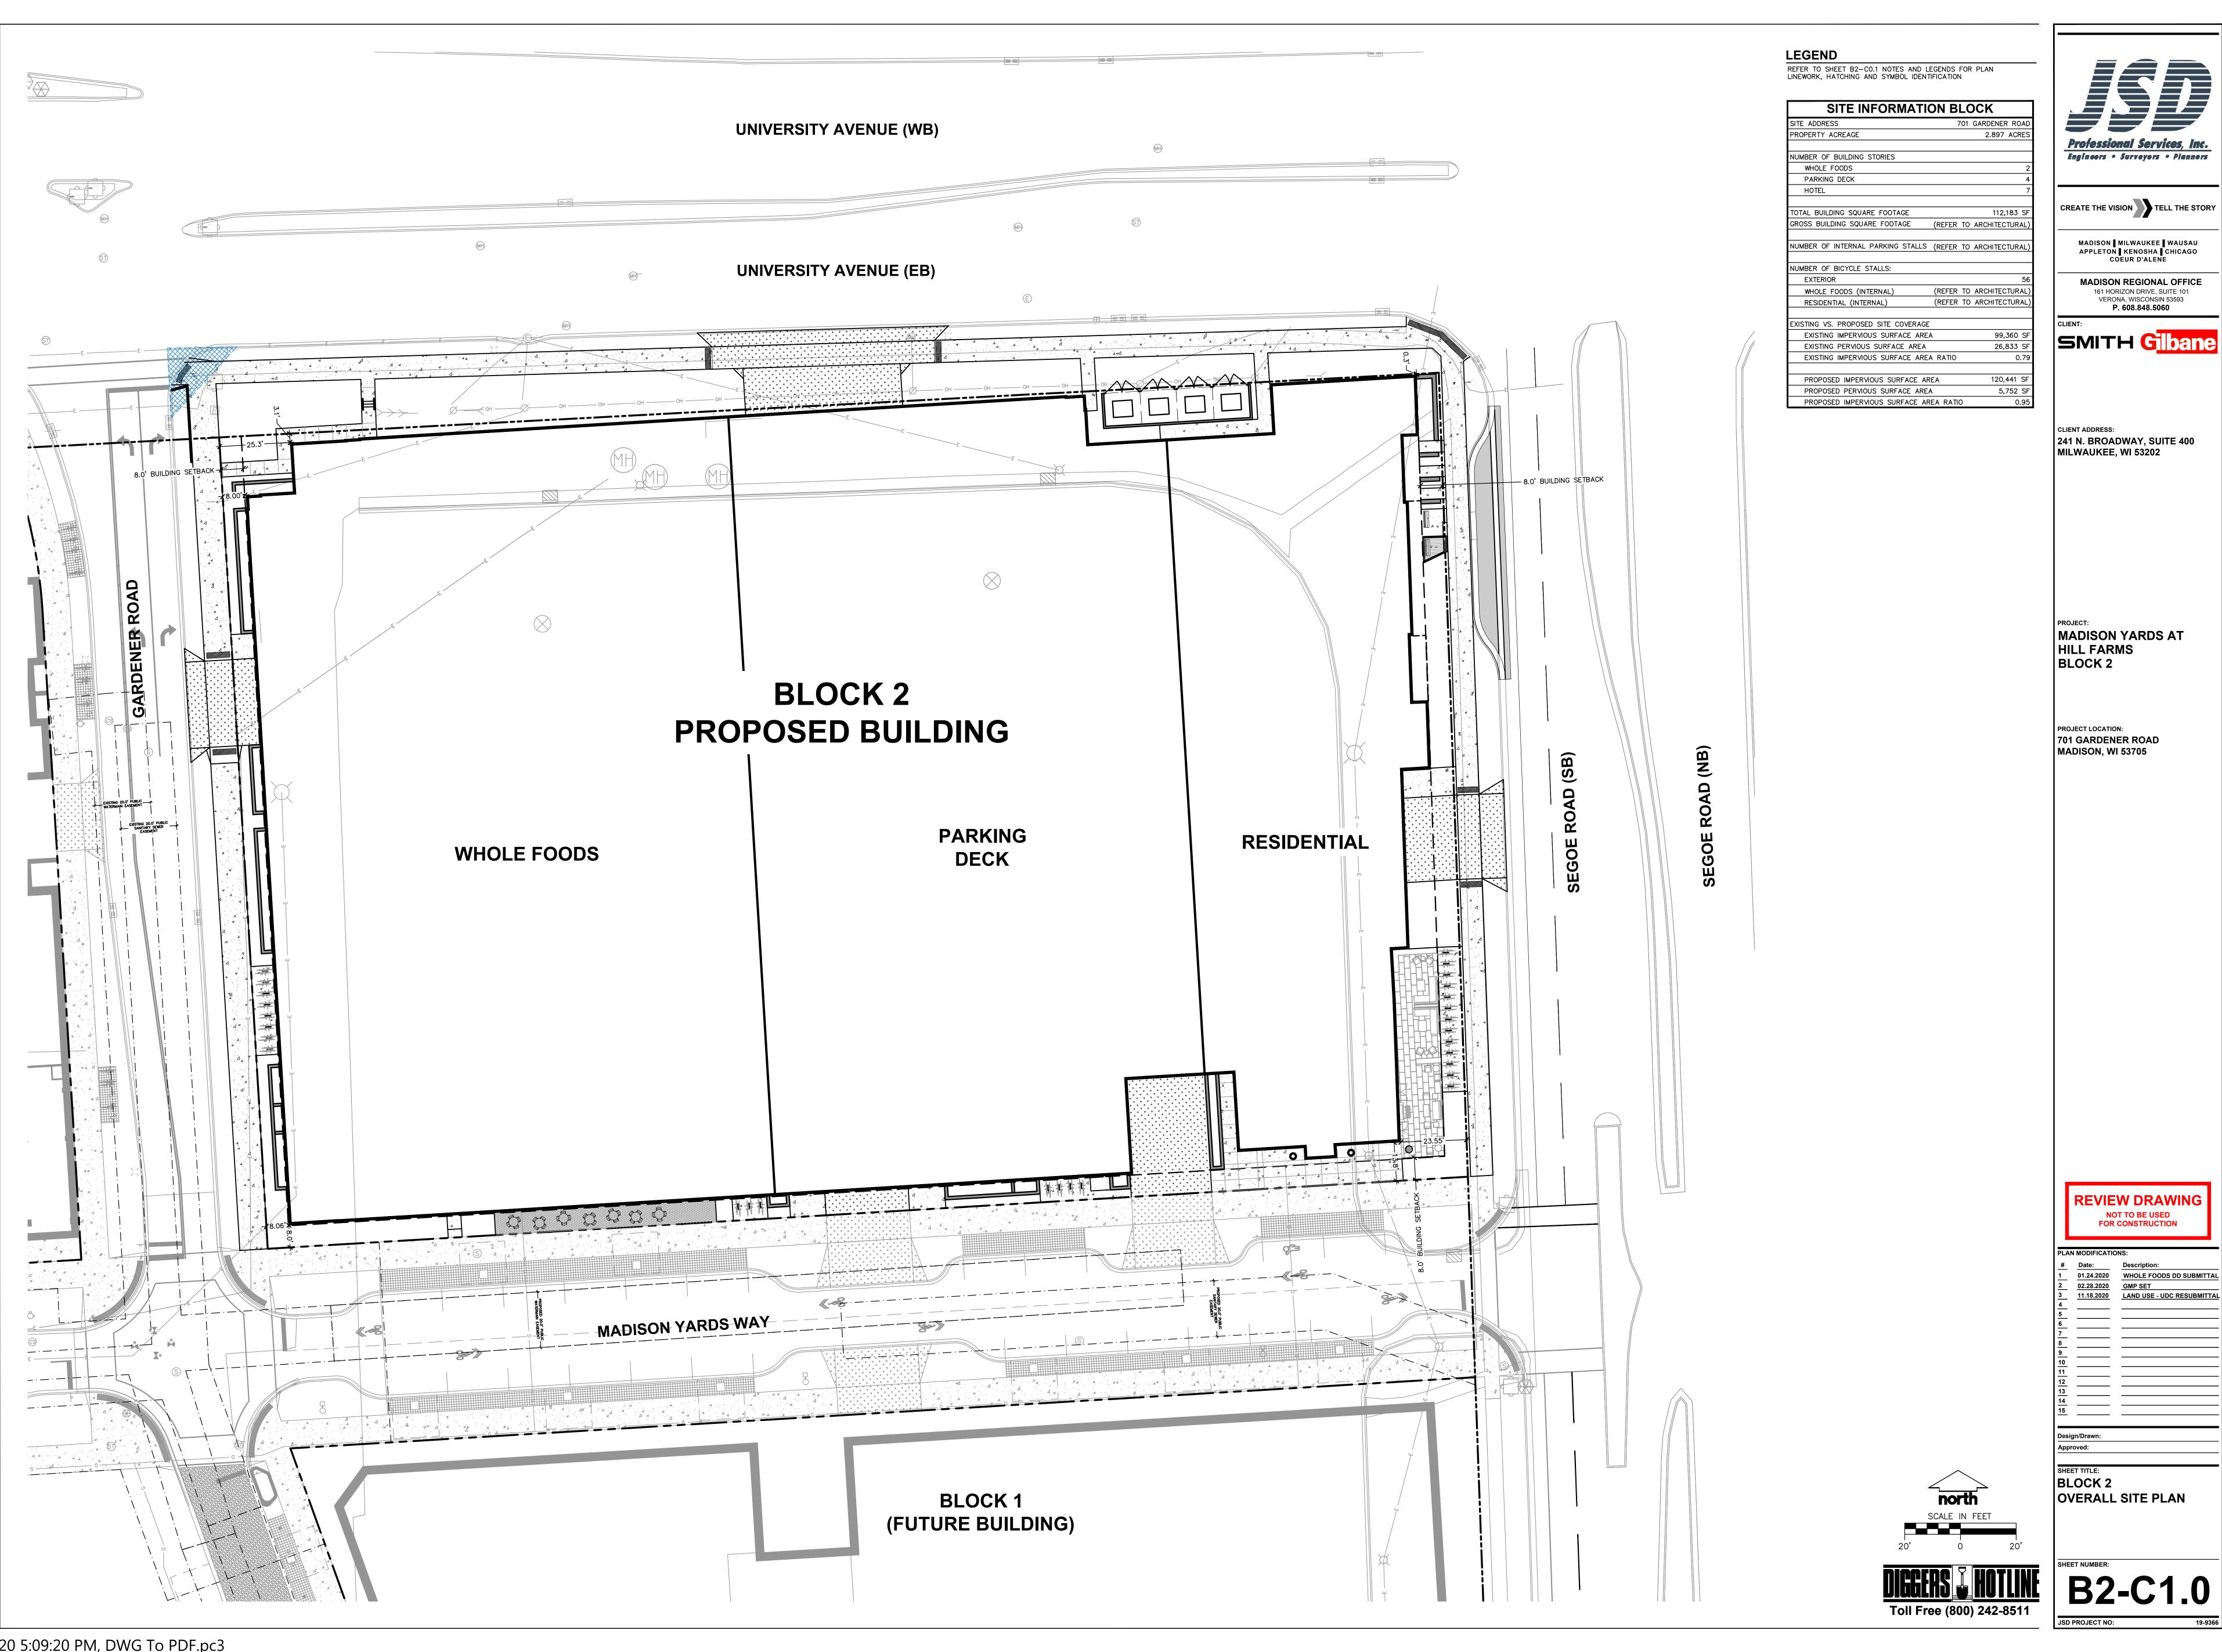

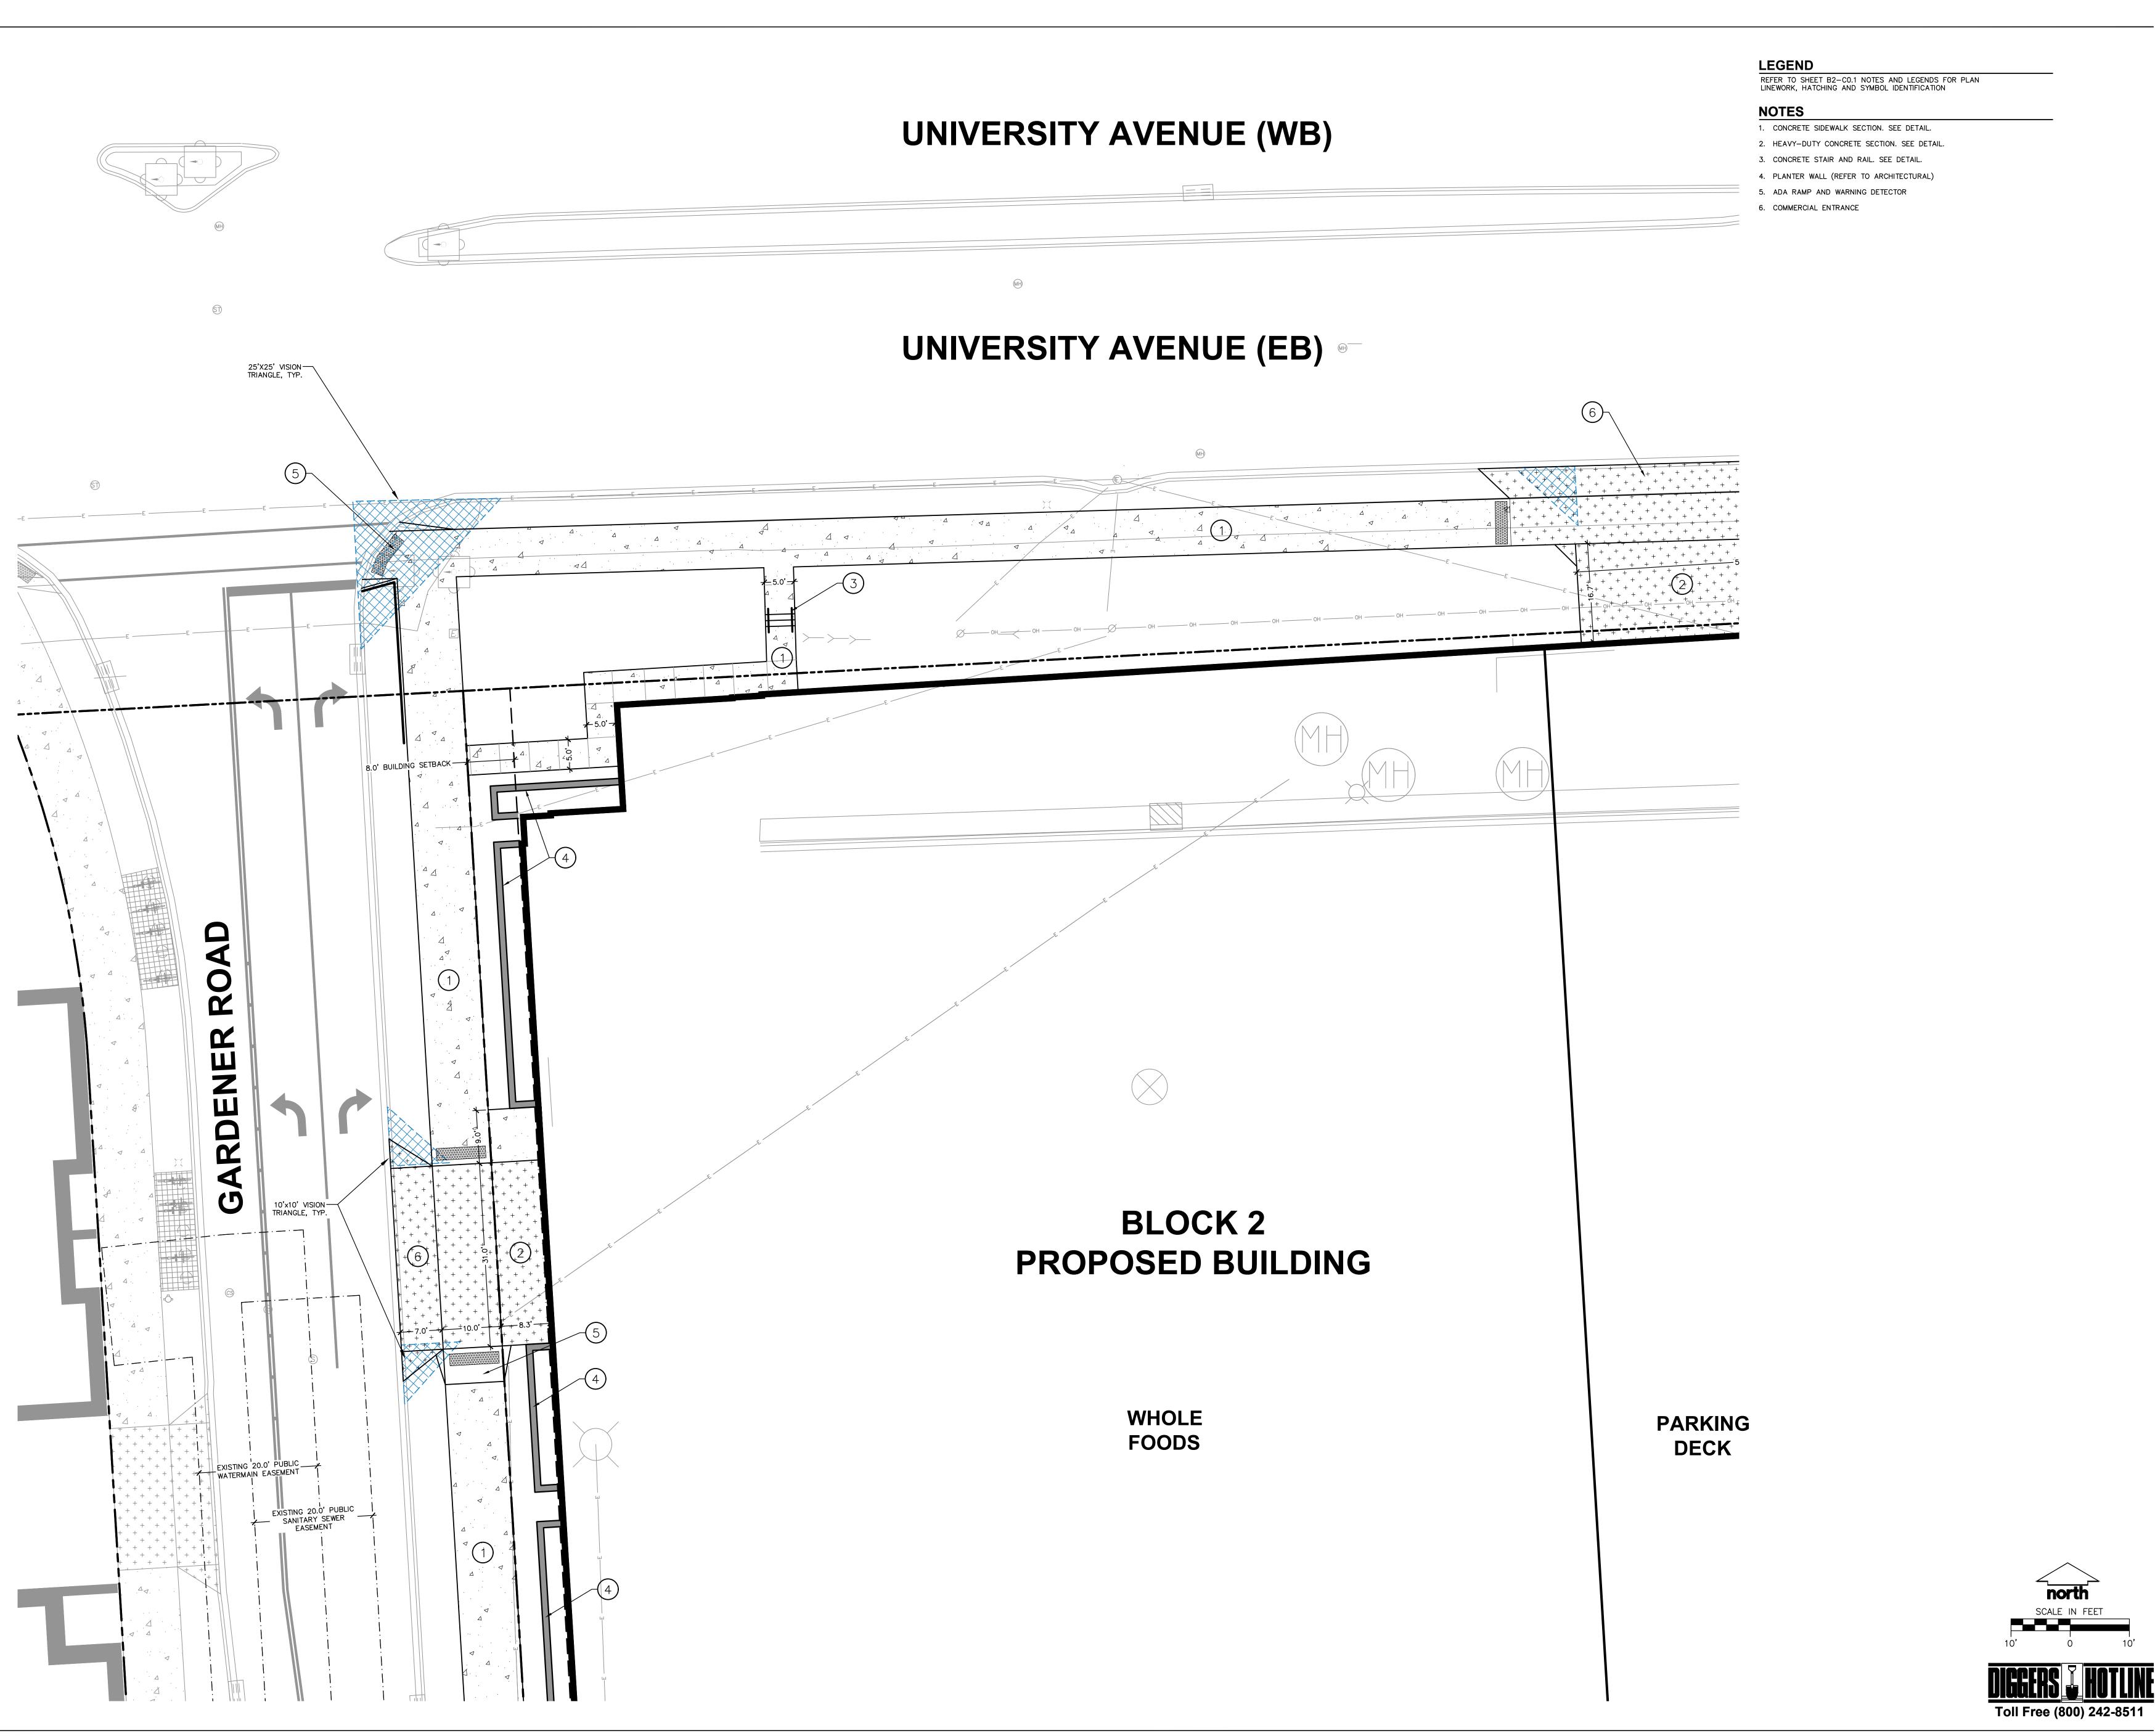





MADISON MILWAUKEE WAUSAU
APPLETON KENOSHA CHICAGO
COEUR D'ALENE

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P. 608.848.5060

SMITH Gibane

client address: 241 N. BROADWAY, SUITE 400 MILWAUKEE, WI 53202

PROJECT:
MADISON YARDS AT
HILL FARMS
BLOCK 2

PROJECT LOCATION:
701 GARDENER ROAD
MADISON, WI 53705

REVIEW DRAWING

NOT TO BE USED
FOR CONSTRUCTION


N MODIFICATIONS:

| Date: | Desc. |
| 01.24.2020 | WHO

Design/Drawn:

Approved:

SHEET TITLE:
BLOCK 2
DETAILED SITE PLAN NORTHWEST

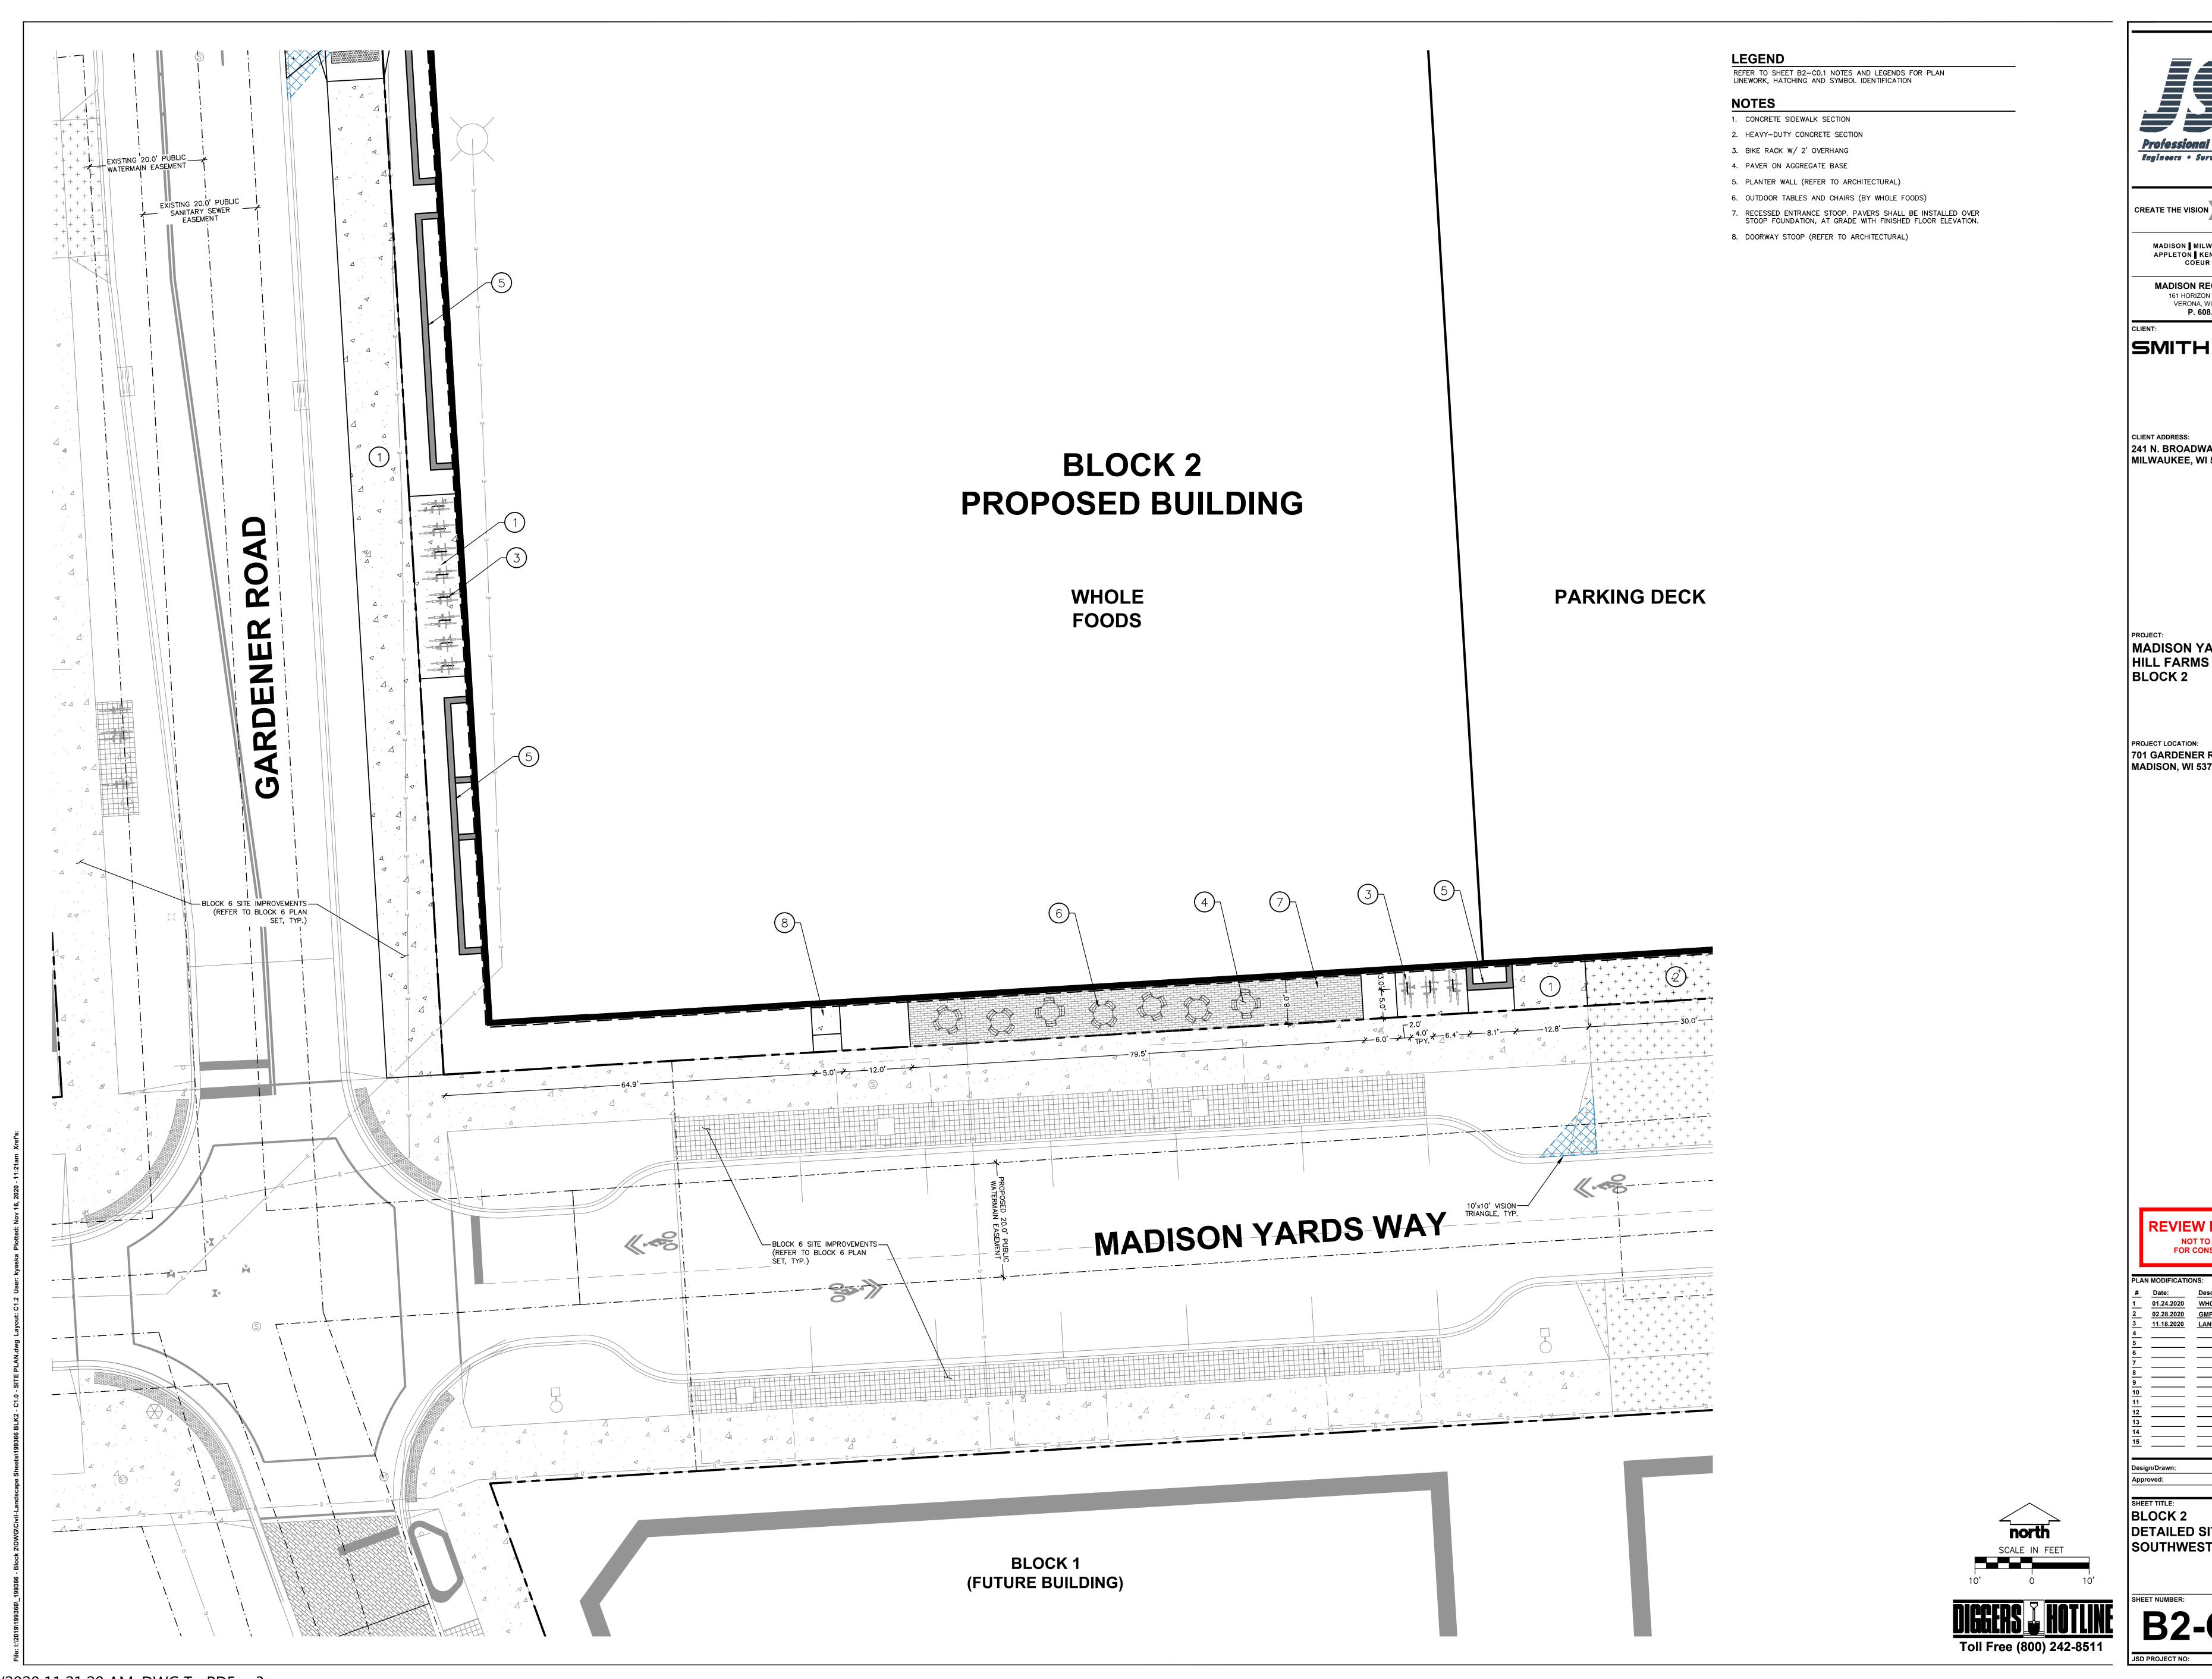





MADISON █ MILWAUKEE █ WAUSAU APPLETON █ KENOSHA █ CHICAGO COEUR D'ALENE

MADISON REGIONAL OFFICE 161 HORIZON DRIVE, SUITE 101 VERONA, WISCONSIN 53593 P. 608.848.5060

SMITH Giban


241 N. BROADWAY, SUITE 400 MILWAUKEE, WI 53202

MADISON YARDS AT

701 GARDENER ROAD MADISON, WI 53705

> **REVIEW DRAWING** FOR CONSTRUCTION

SHEET TITLE:
BLOCK 2
DETAILED SITE PLAN -SOUTHWEST

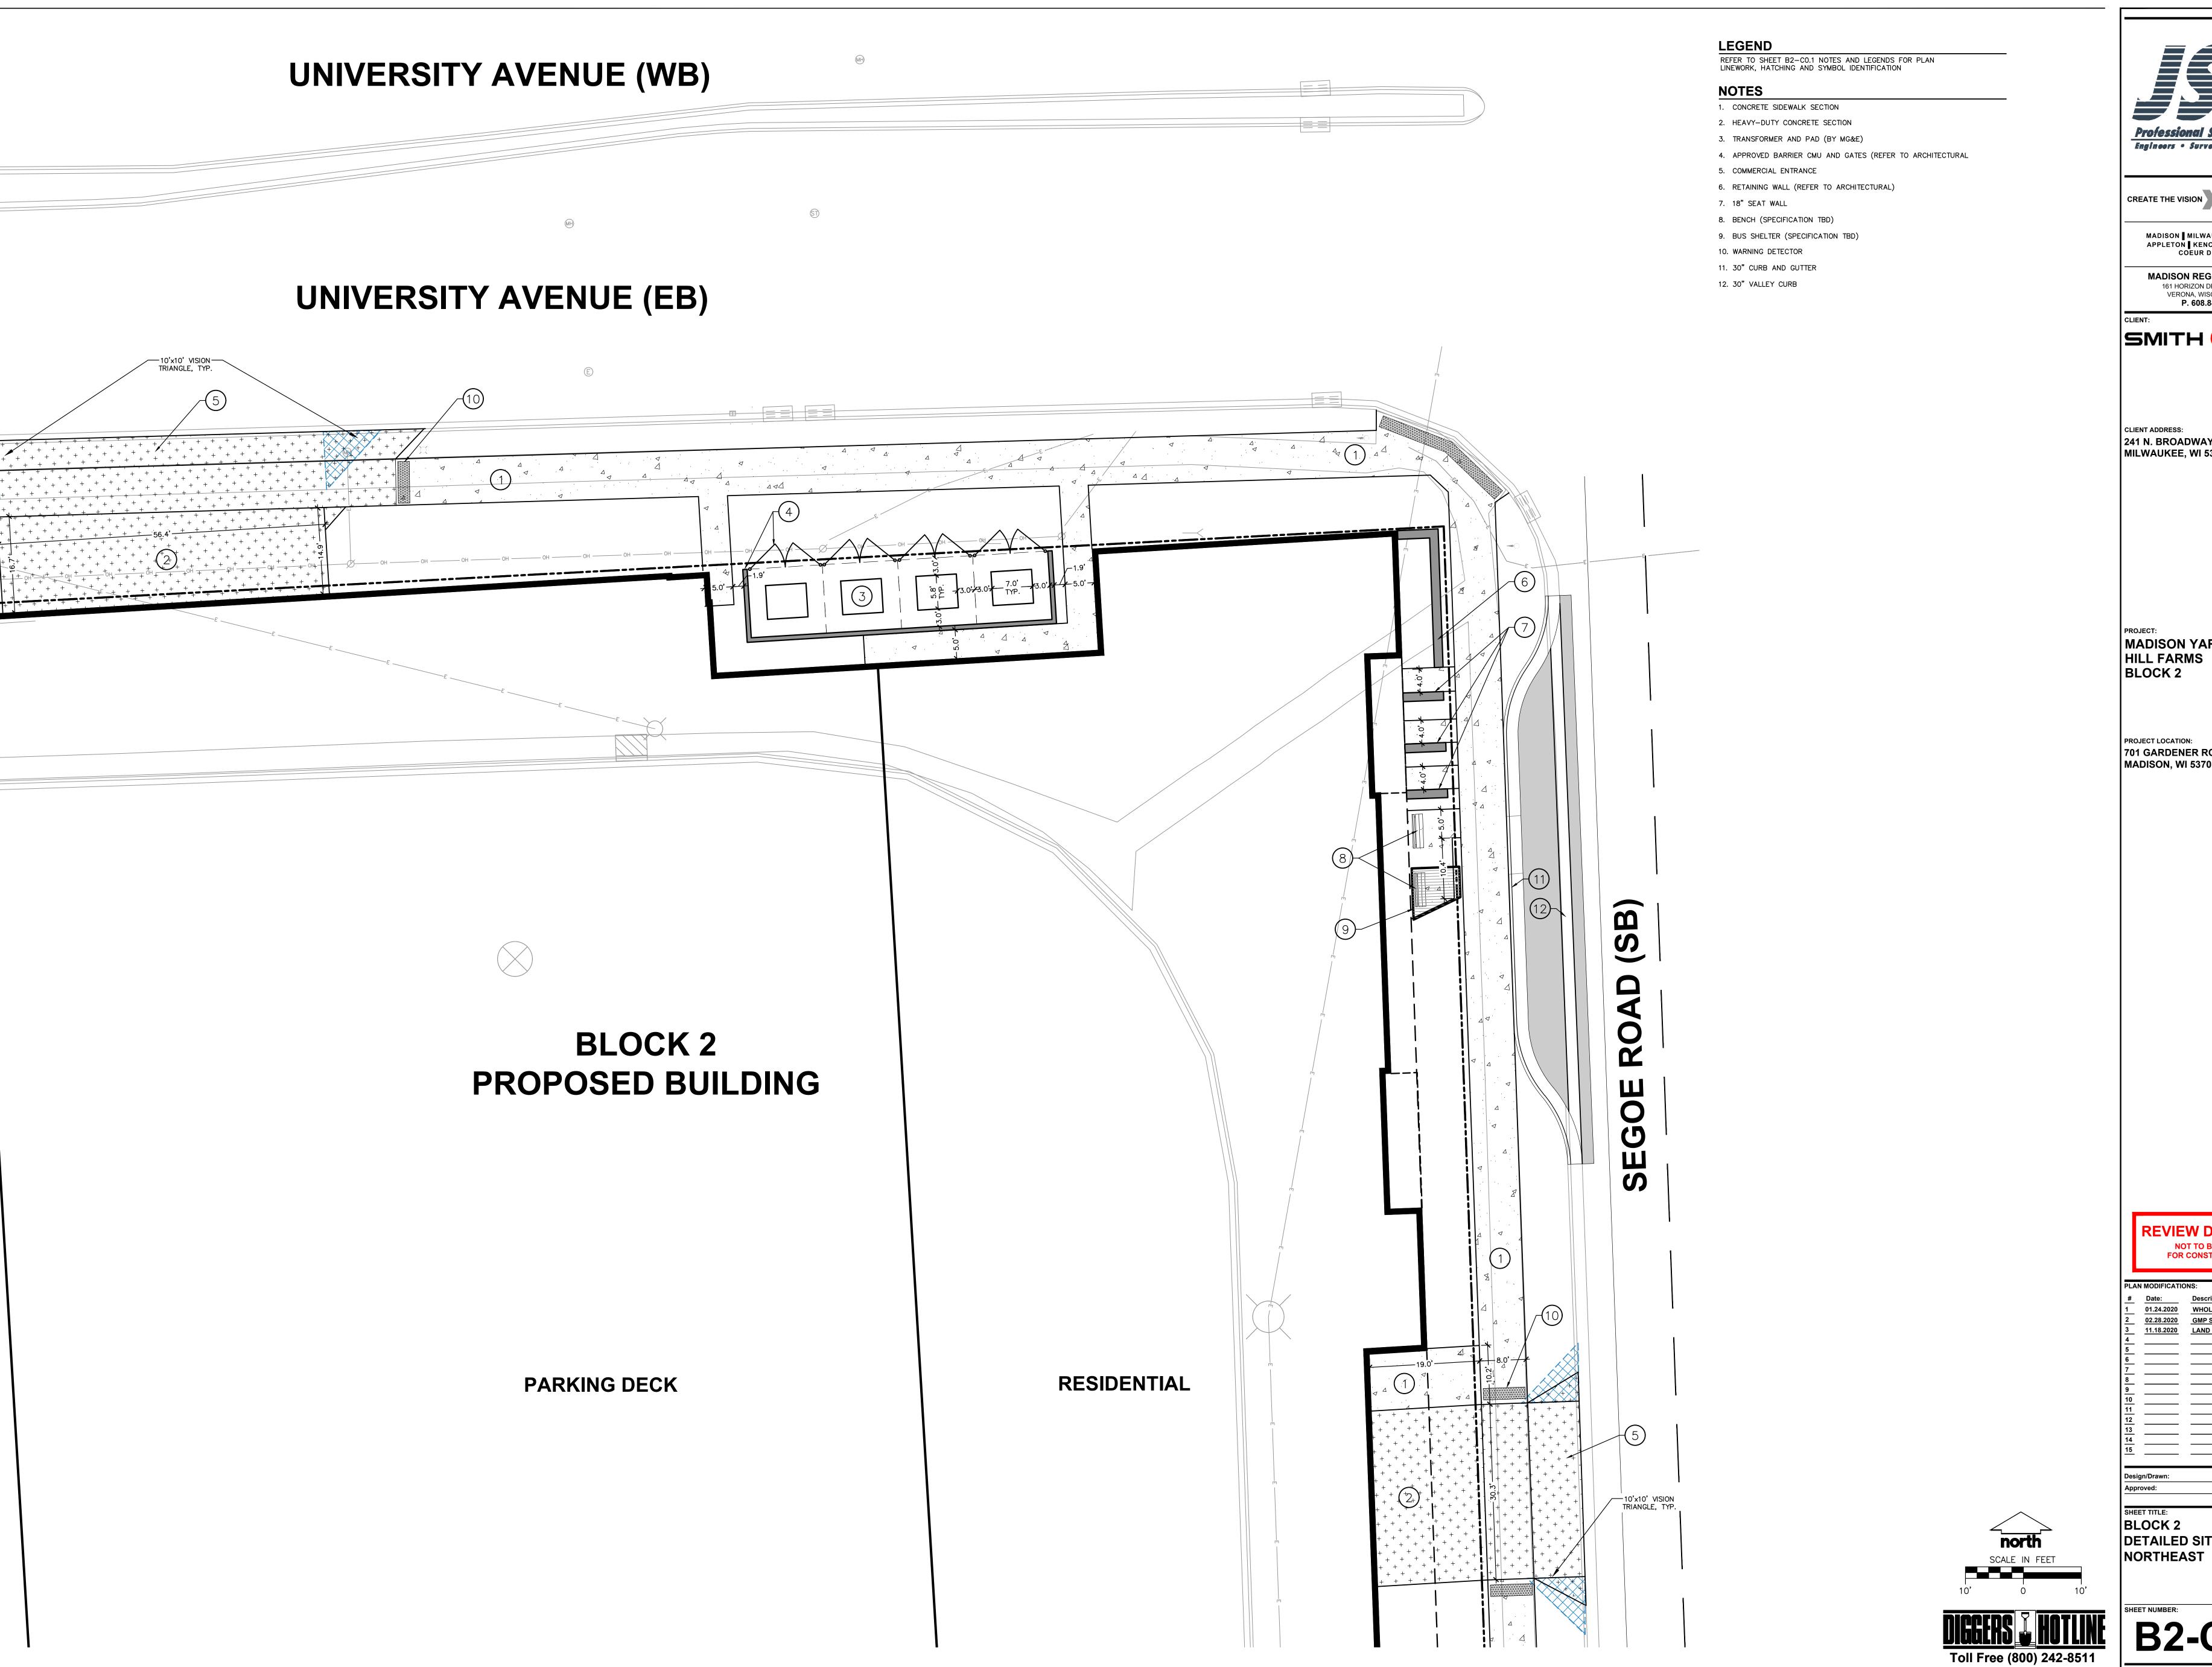



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MADISON REGIONAL OFFICE

161 HORIZON DRIVE, SUITE 101

VERONA, WISCONSIN 53593 P. 608.848.5060

SMITH Gibar


241 N. BROADWAY, SUITE 400 MILWAUKEE, WI 53202

MADISON YARDS AT HILL FARMS BLOCK 2

PROJECT LOCATION:
701 GARDENER ROAD
MADISON, WI 53705

SHEET TITLE:
BLOCK 2
DETAILED SITE PLAN -

B2-C1.3

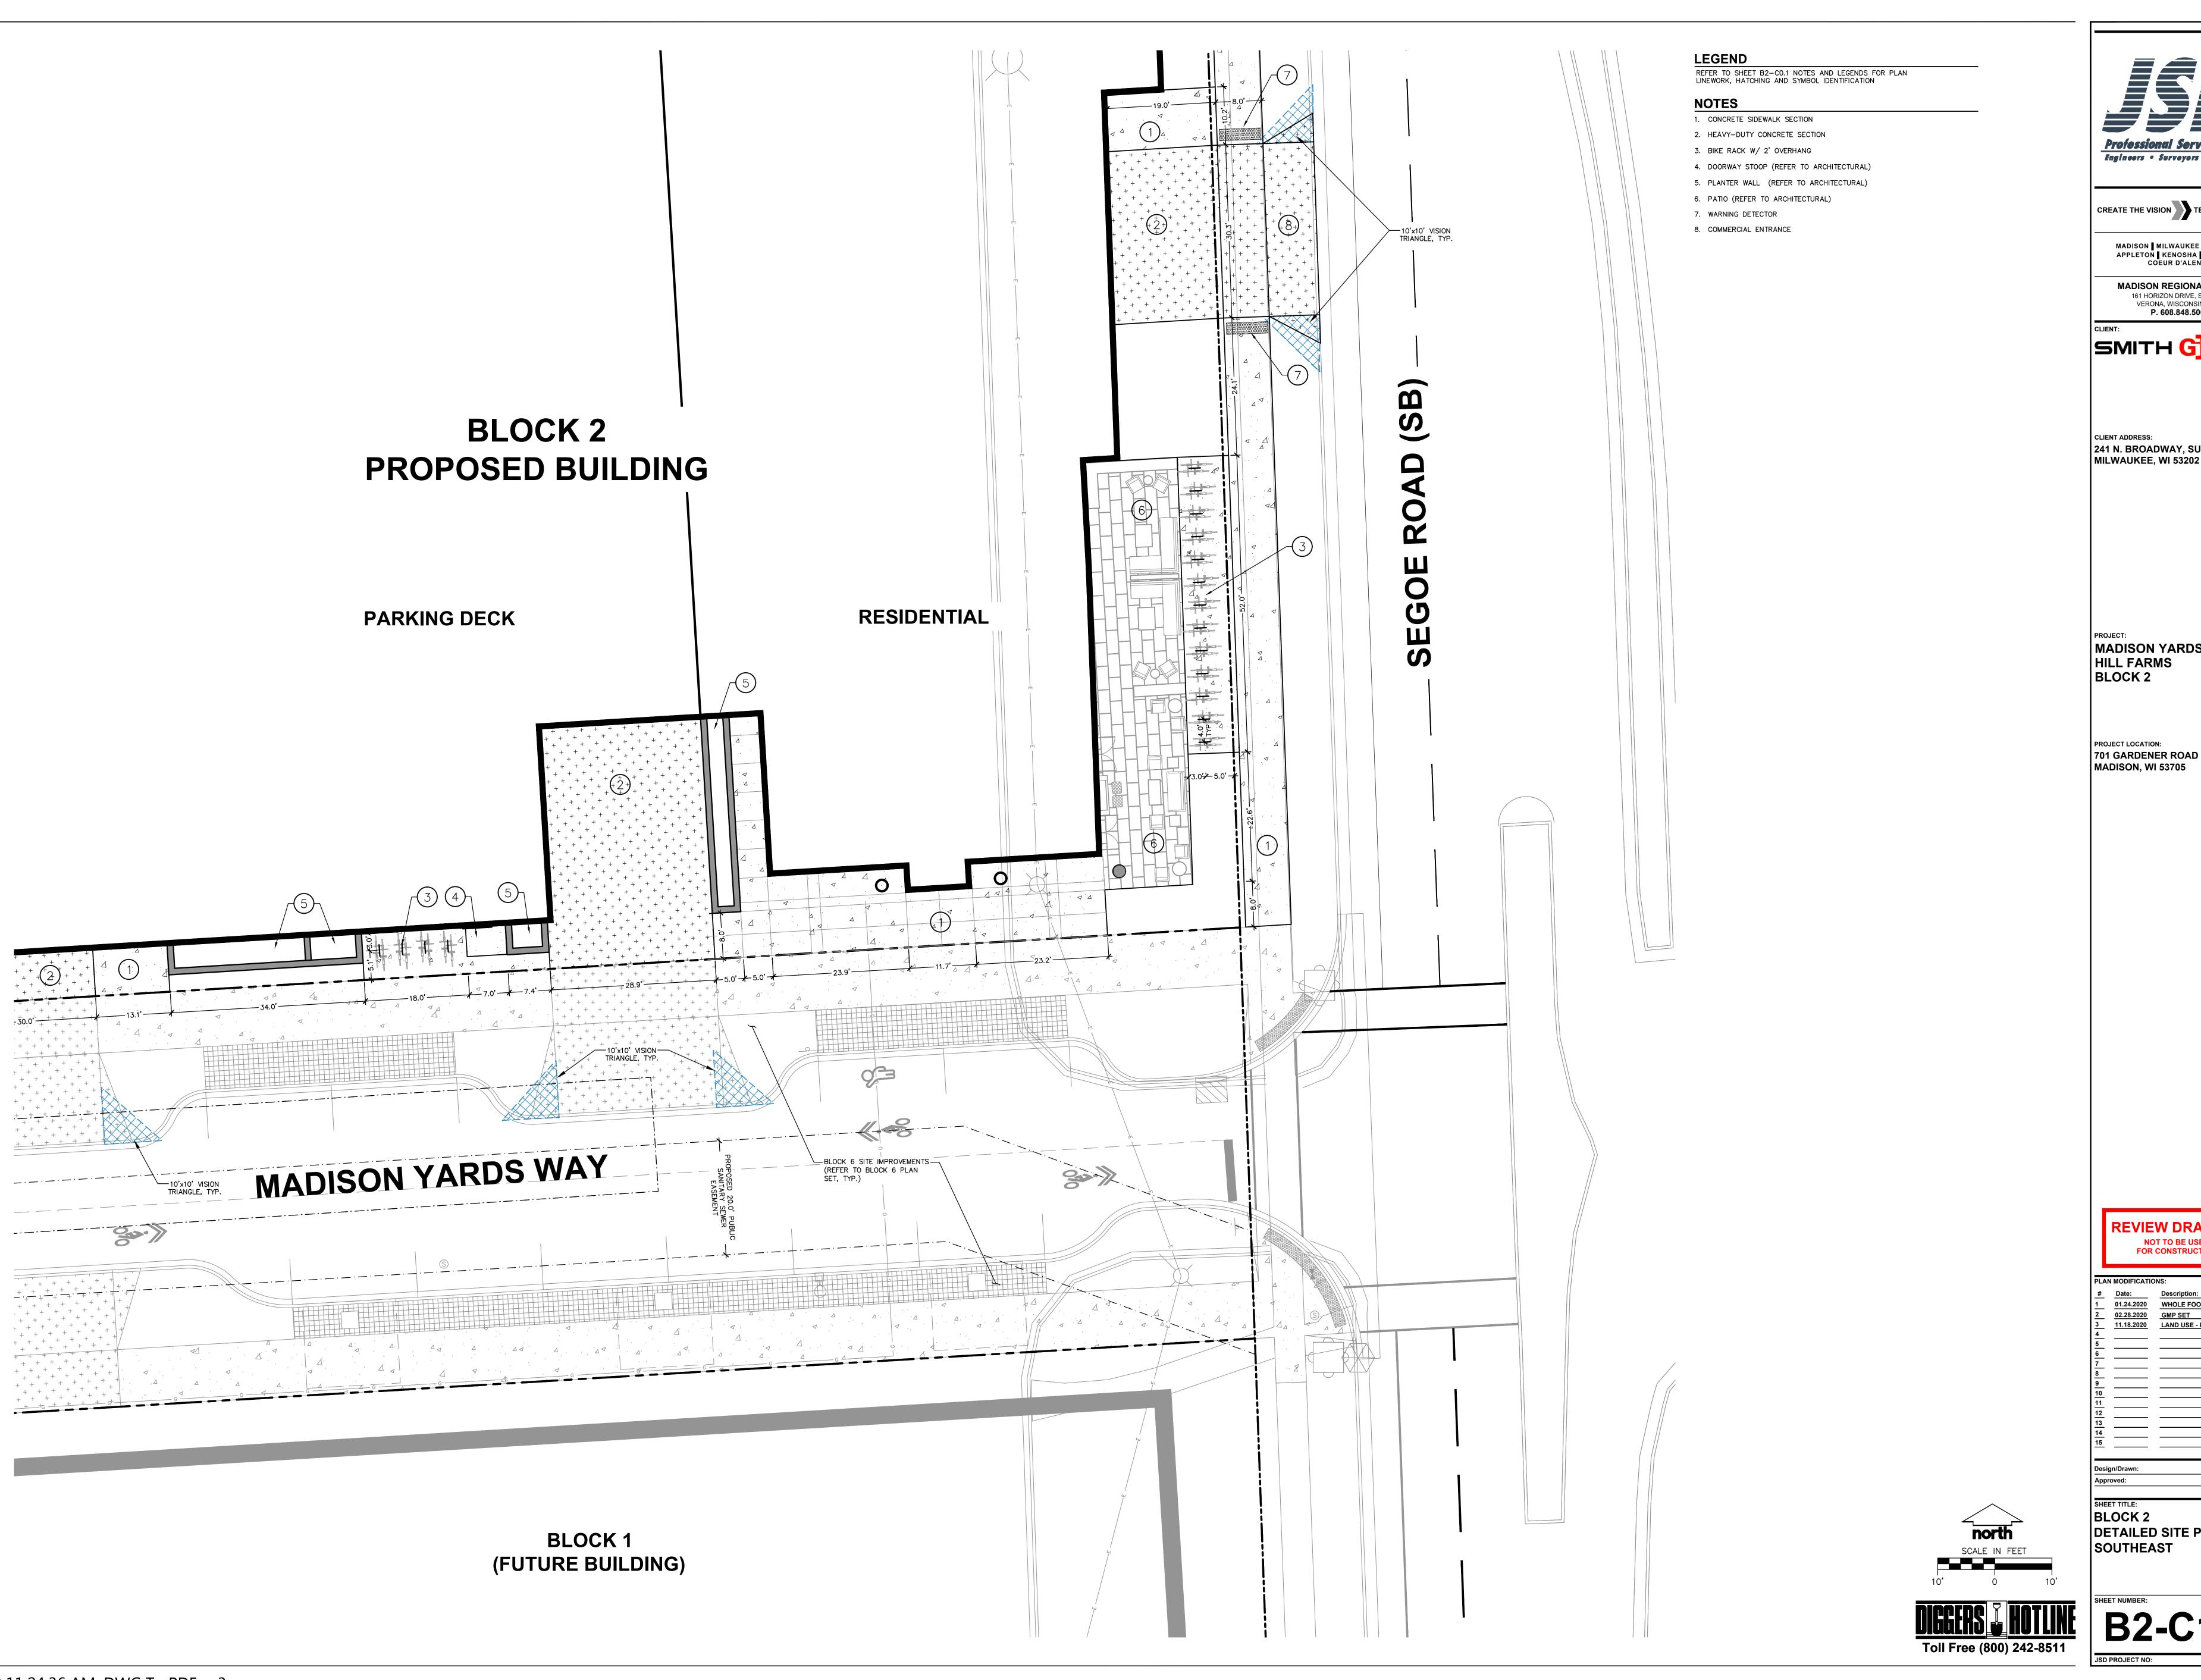





MADISON █ MILWAUKEE █ WAUSAU APPLETON █ KENOSHA █ CHICAGO COEUR D'ALENE

MADISON REGIONAL OFFICE

161 HORIZON DRIVE, SUITE 101

VERONA, WISCONSIN 53593 P. 608.848.5060

SMITH Giban

241 N. BROADWAY, SUITE 400


MADISON YARDS AT HILL FARMS BLOCK 2


PROJECT LOCATION: 701 GARDENER ROAD MADISON, WI 53705


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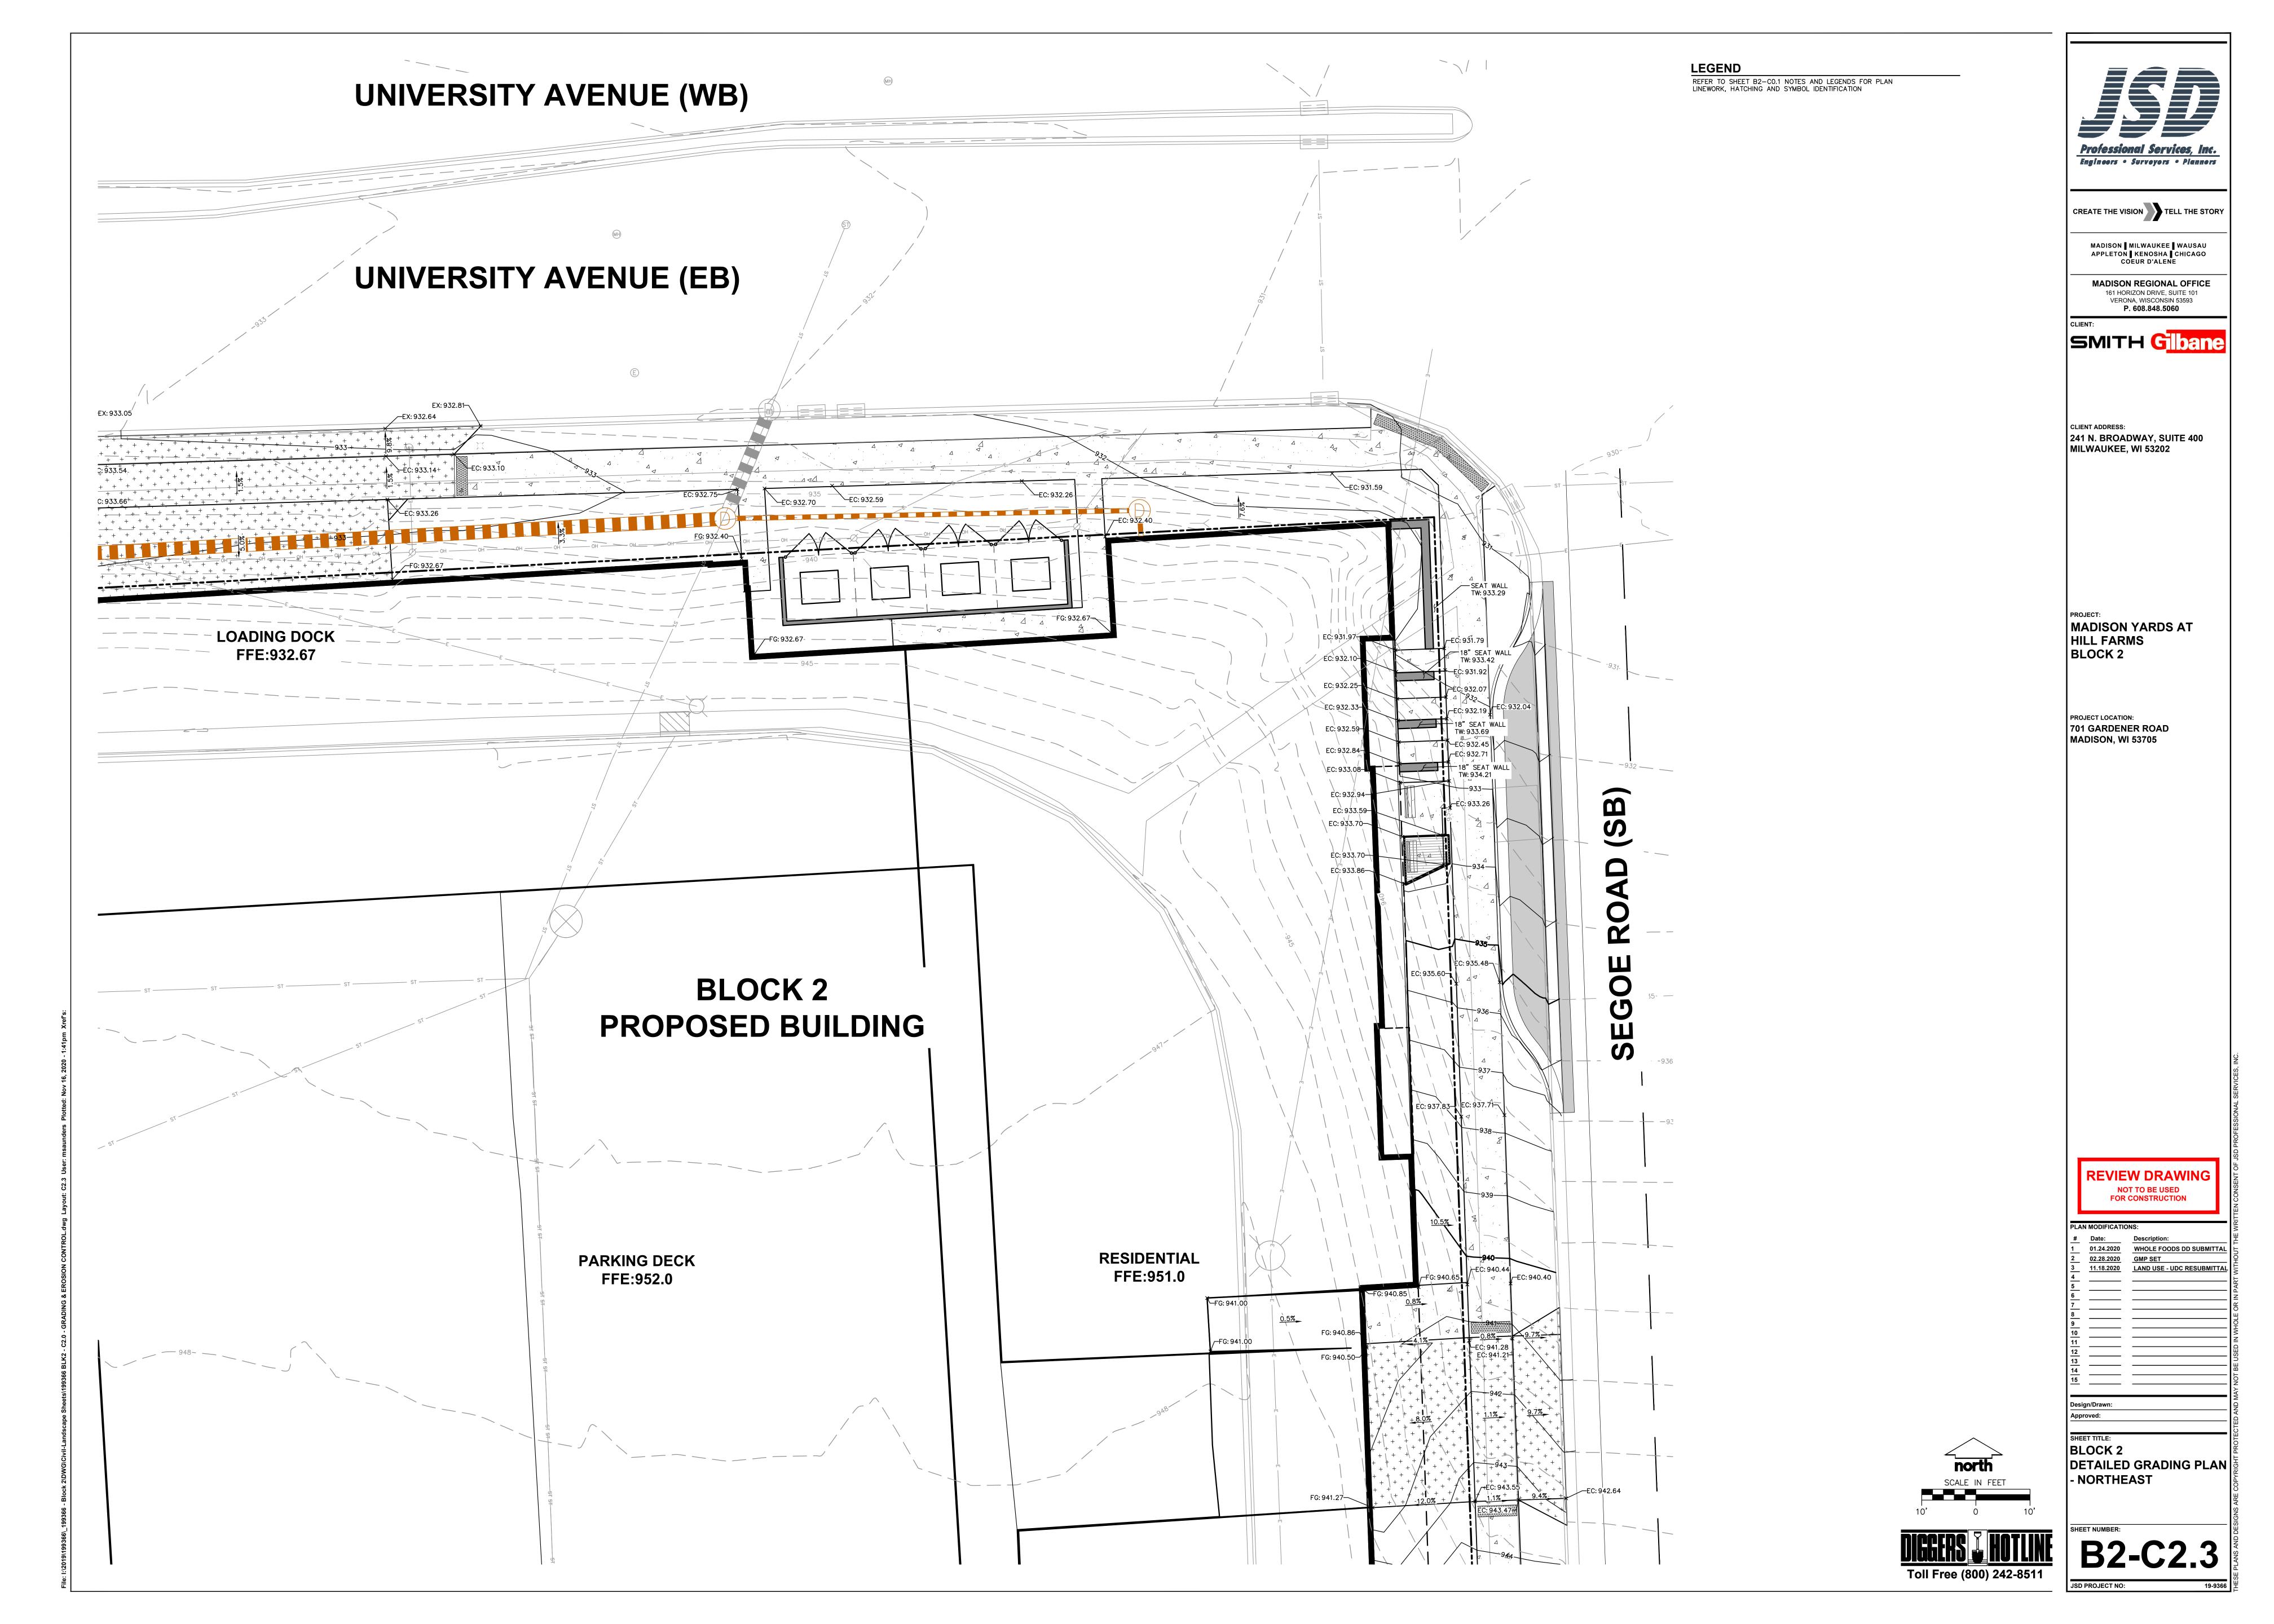
SHEET TITLE:
BLOCK 2
DETAILED SITE PLAN SOUTHEAST


B2-C1.4




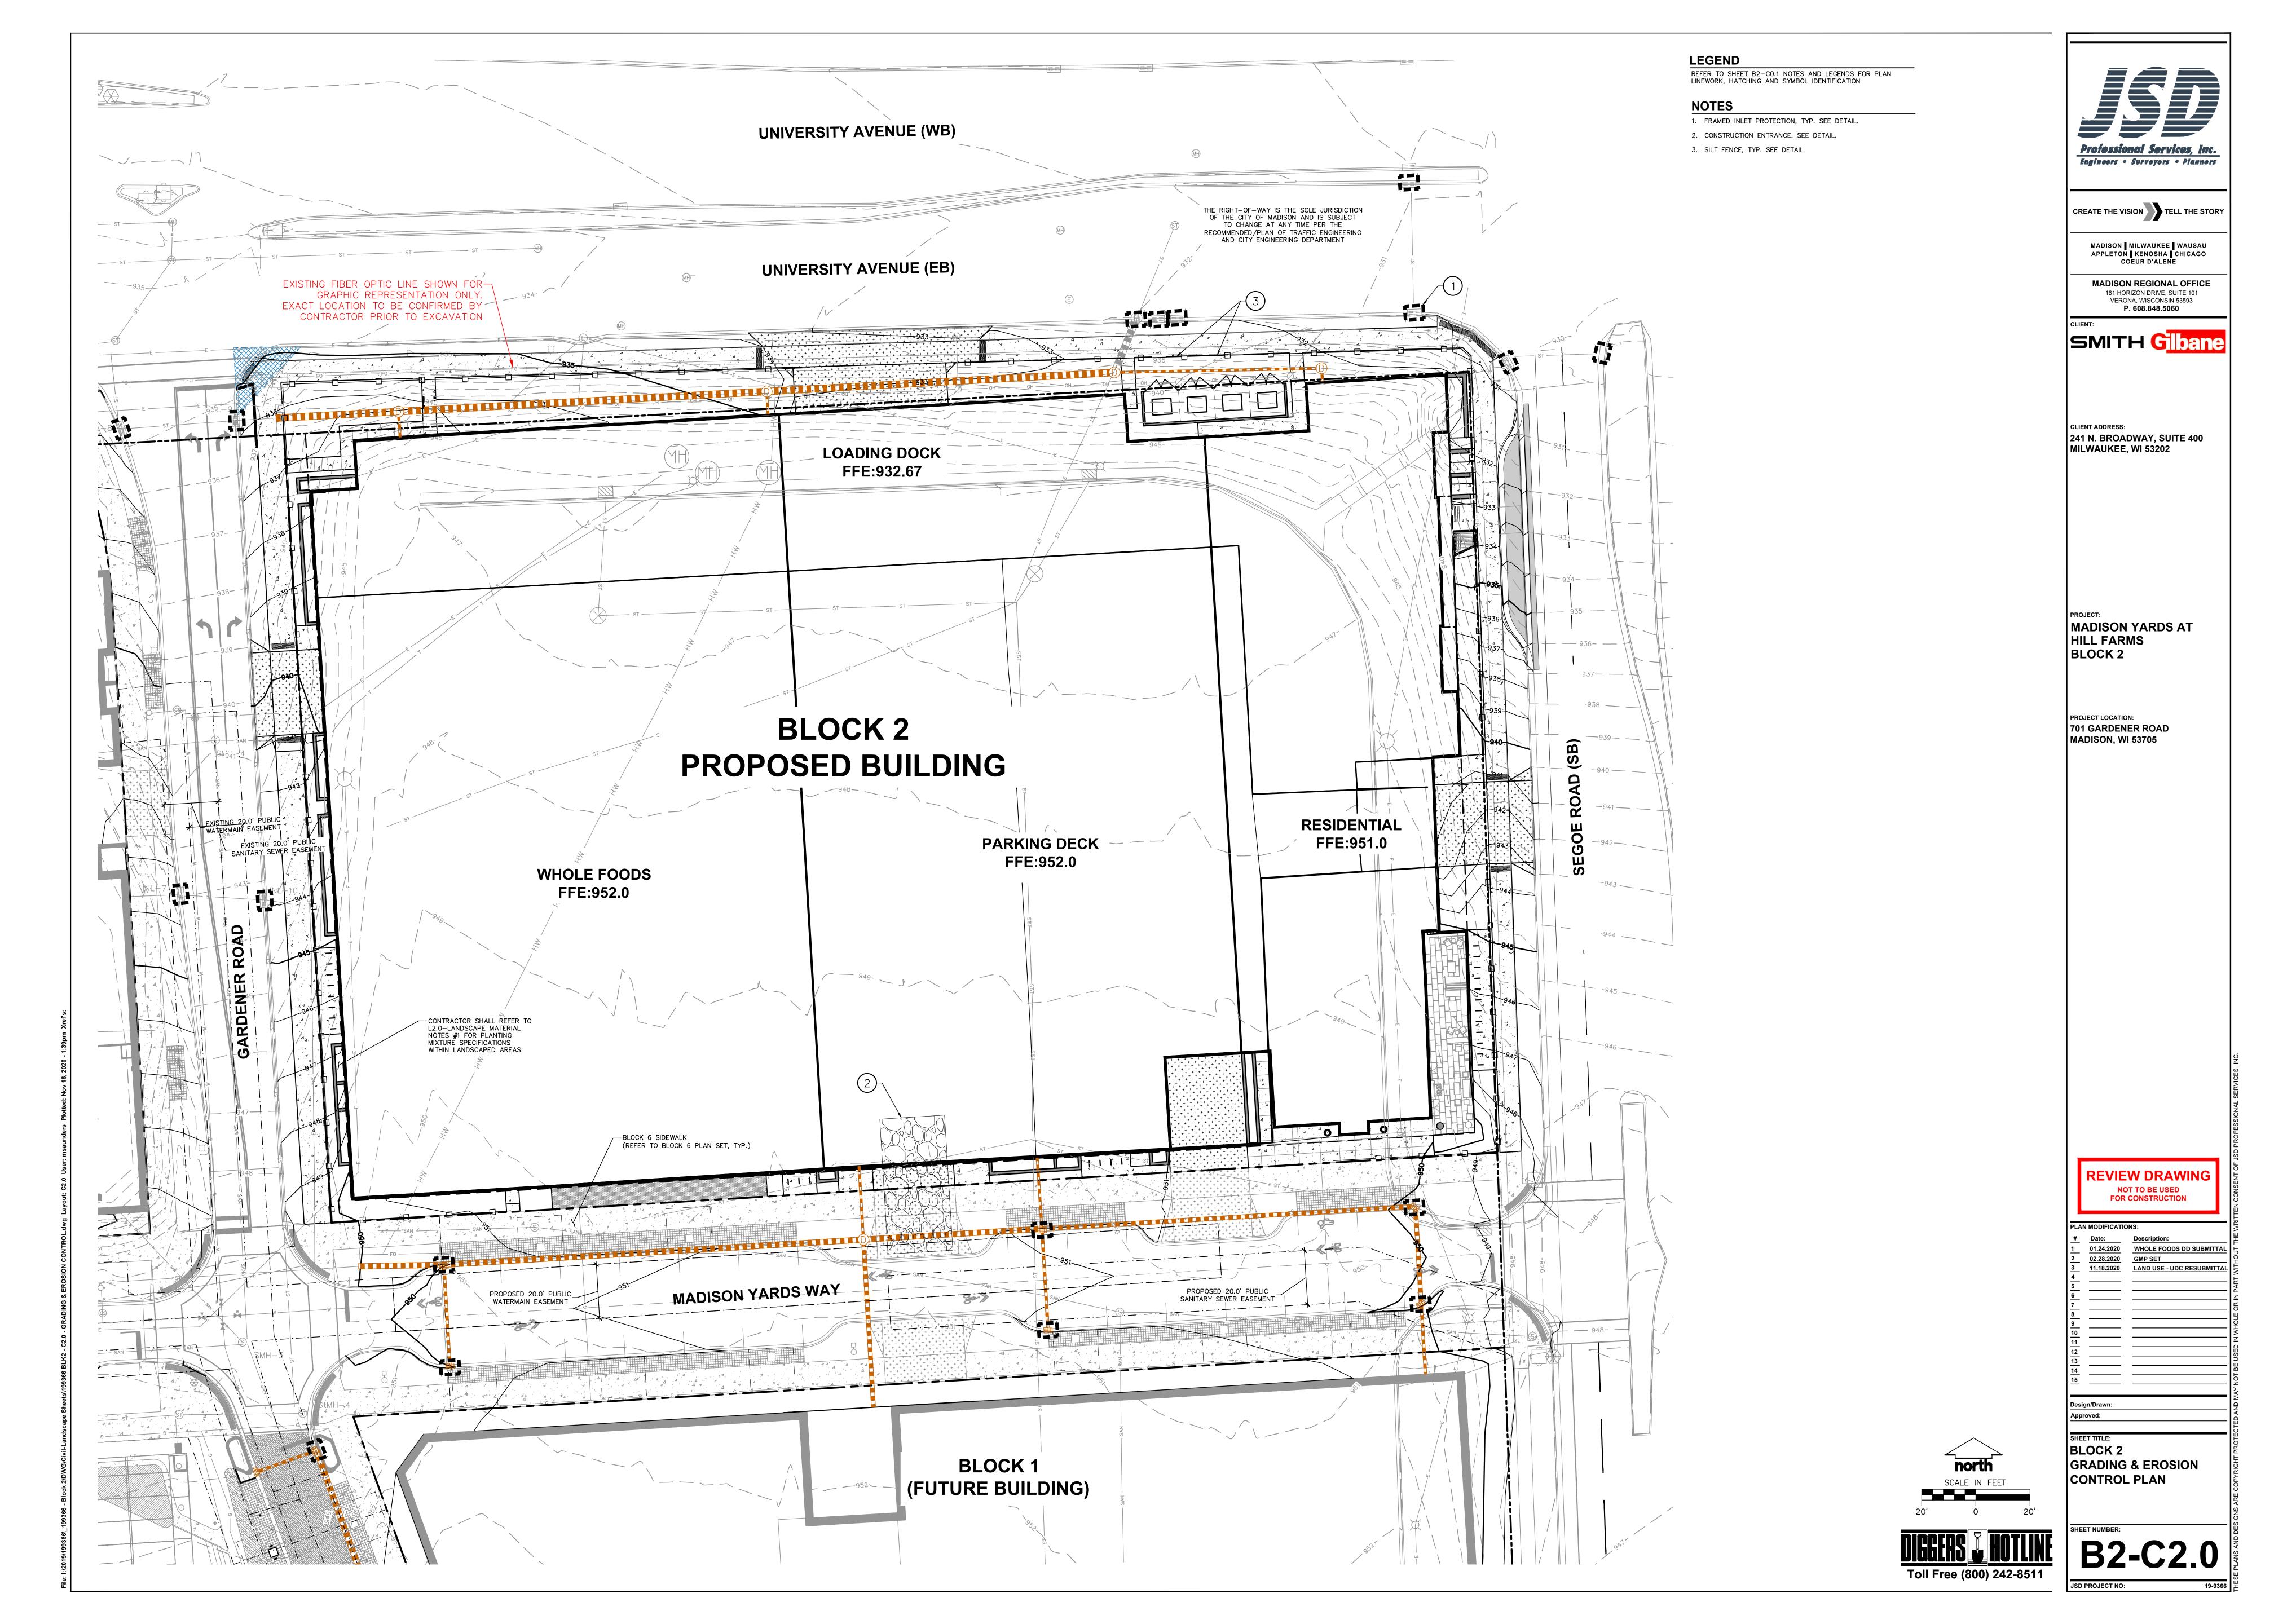


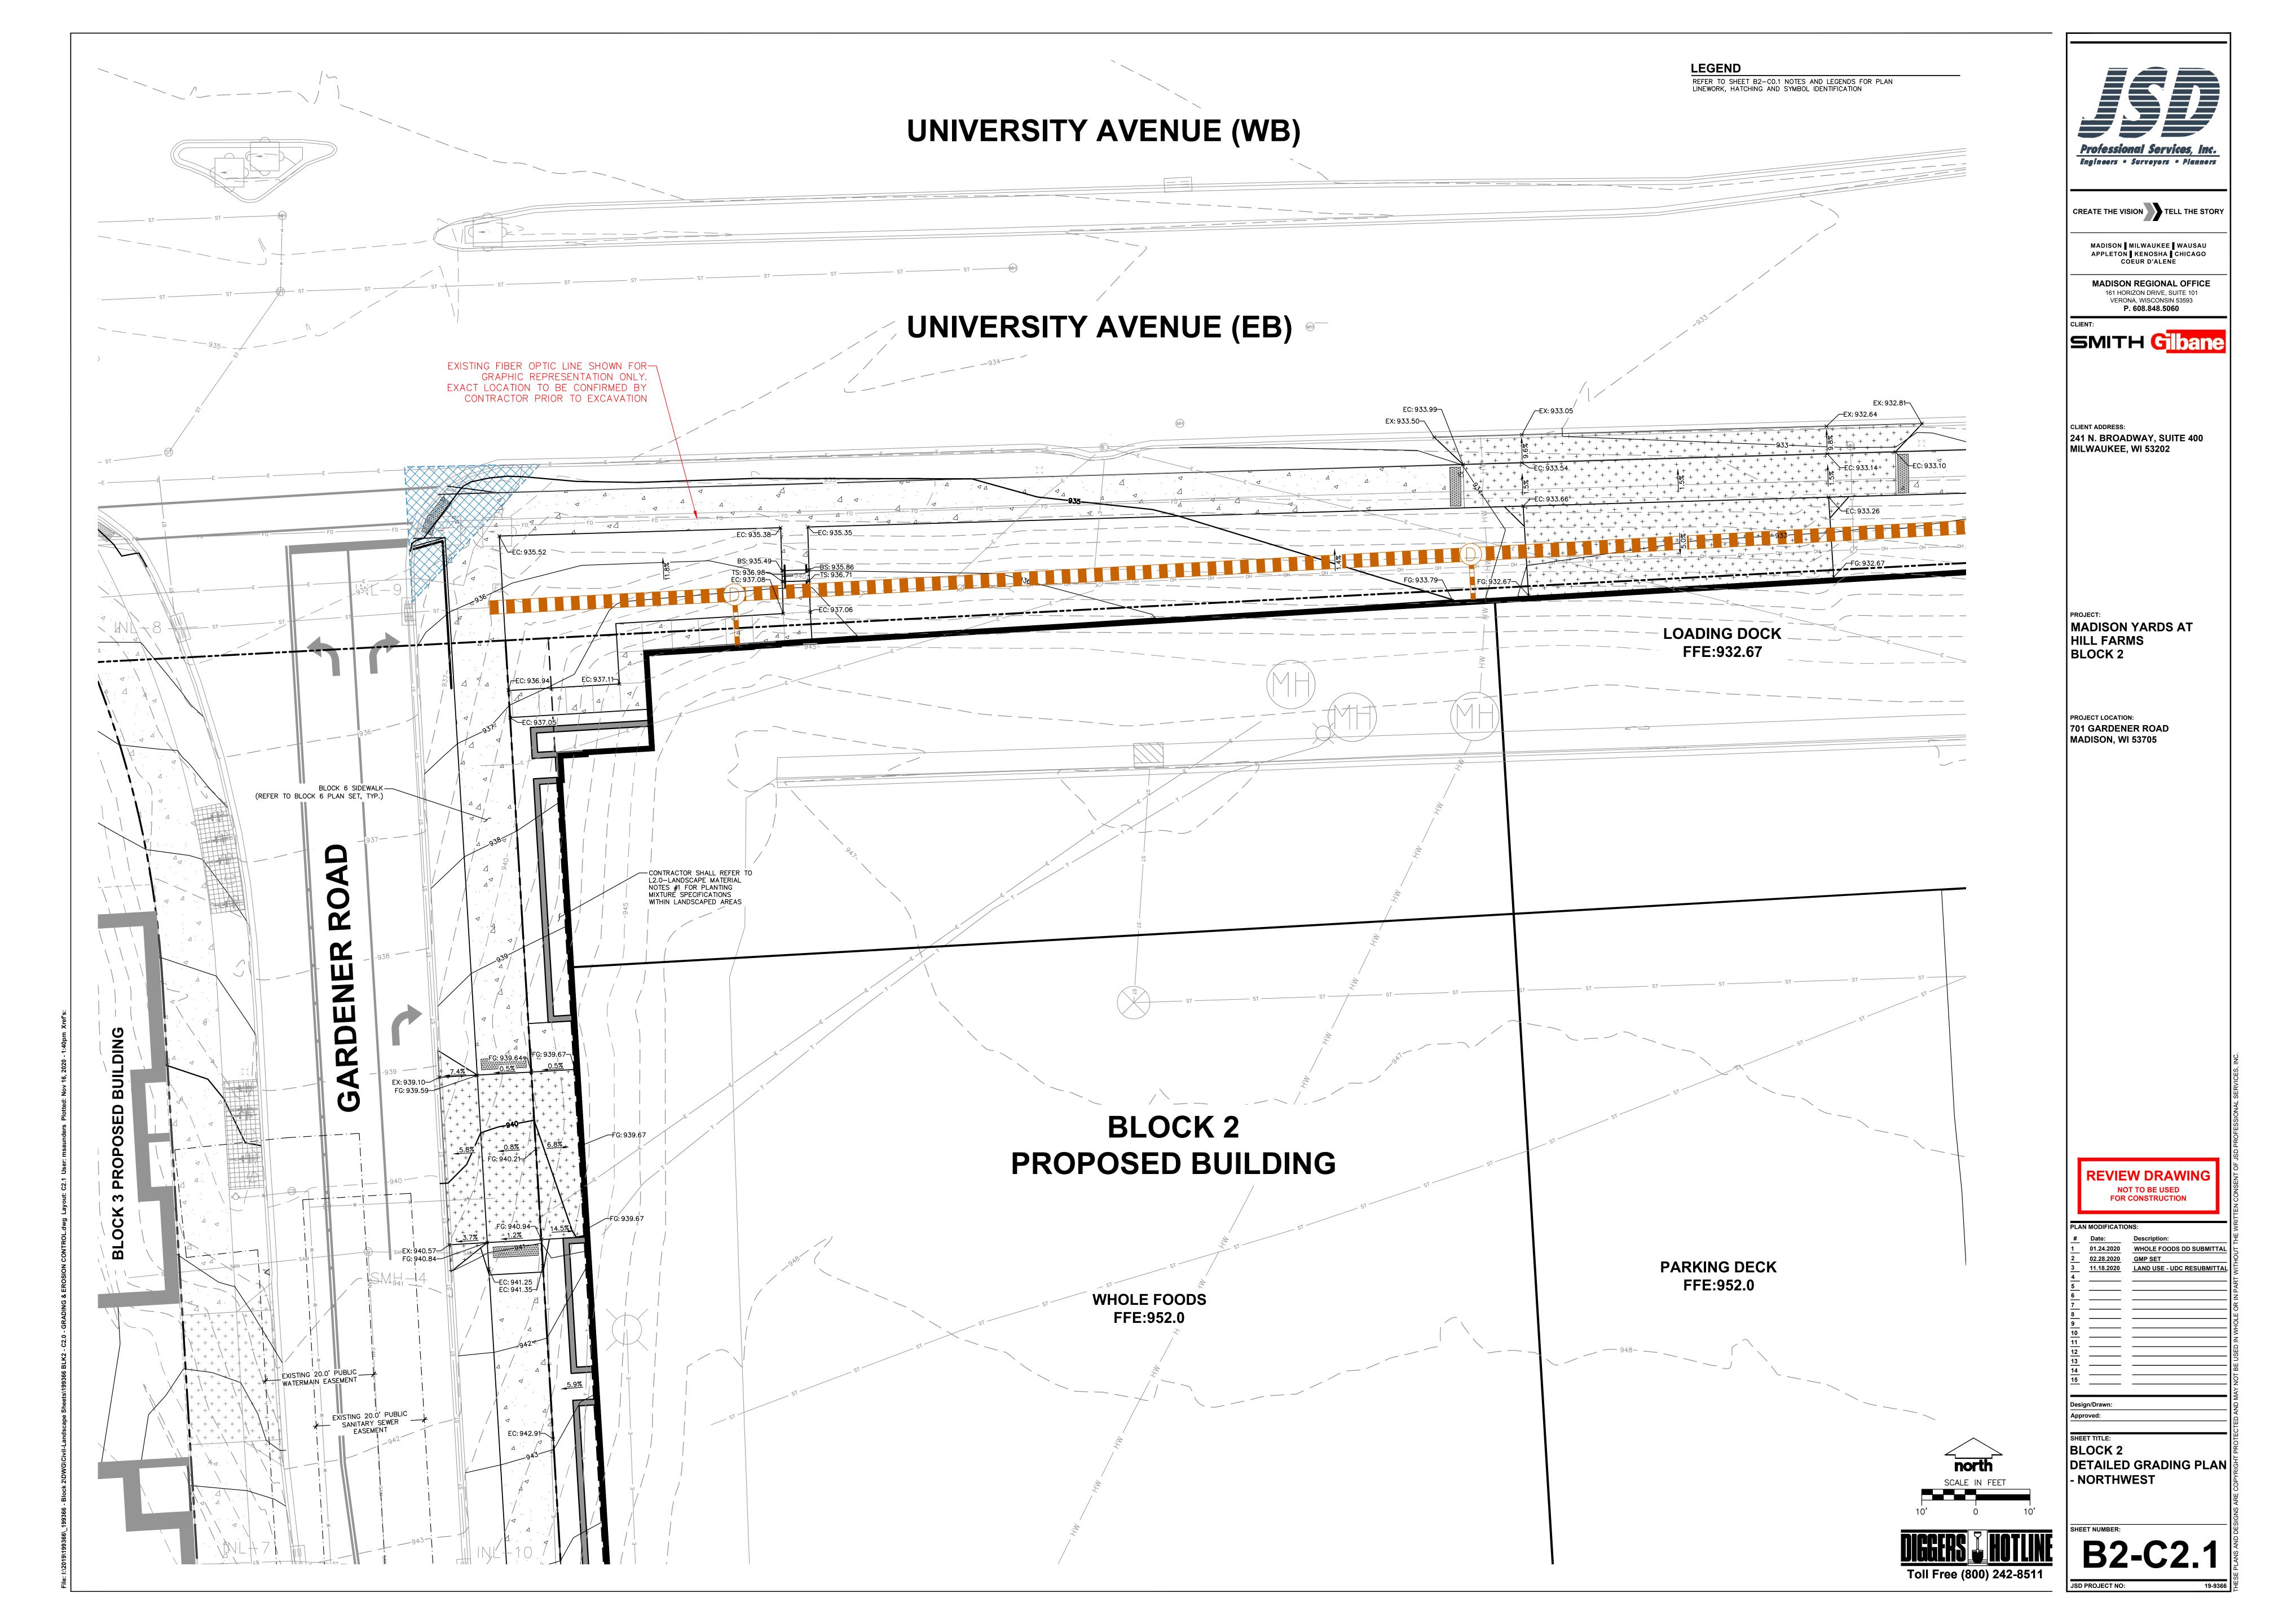


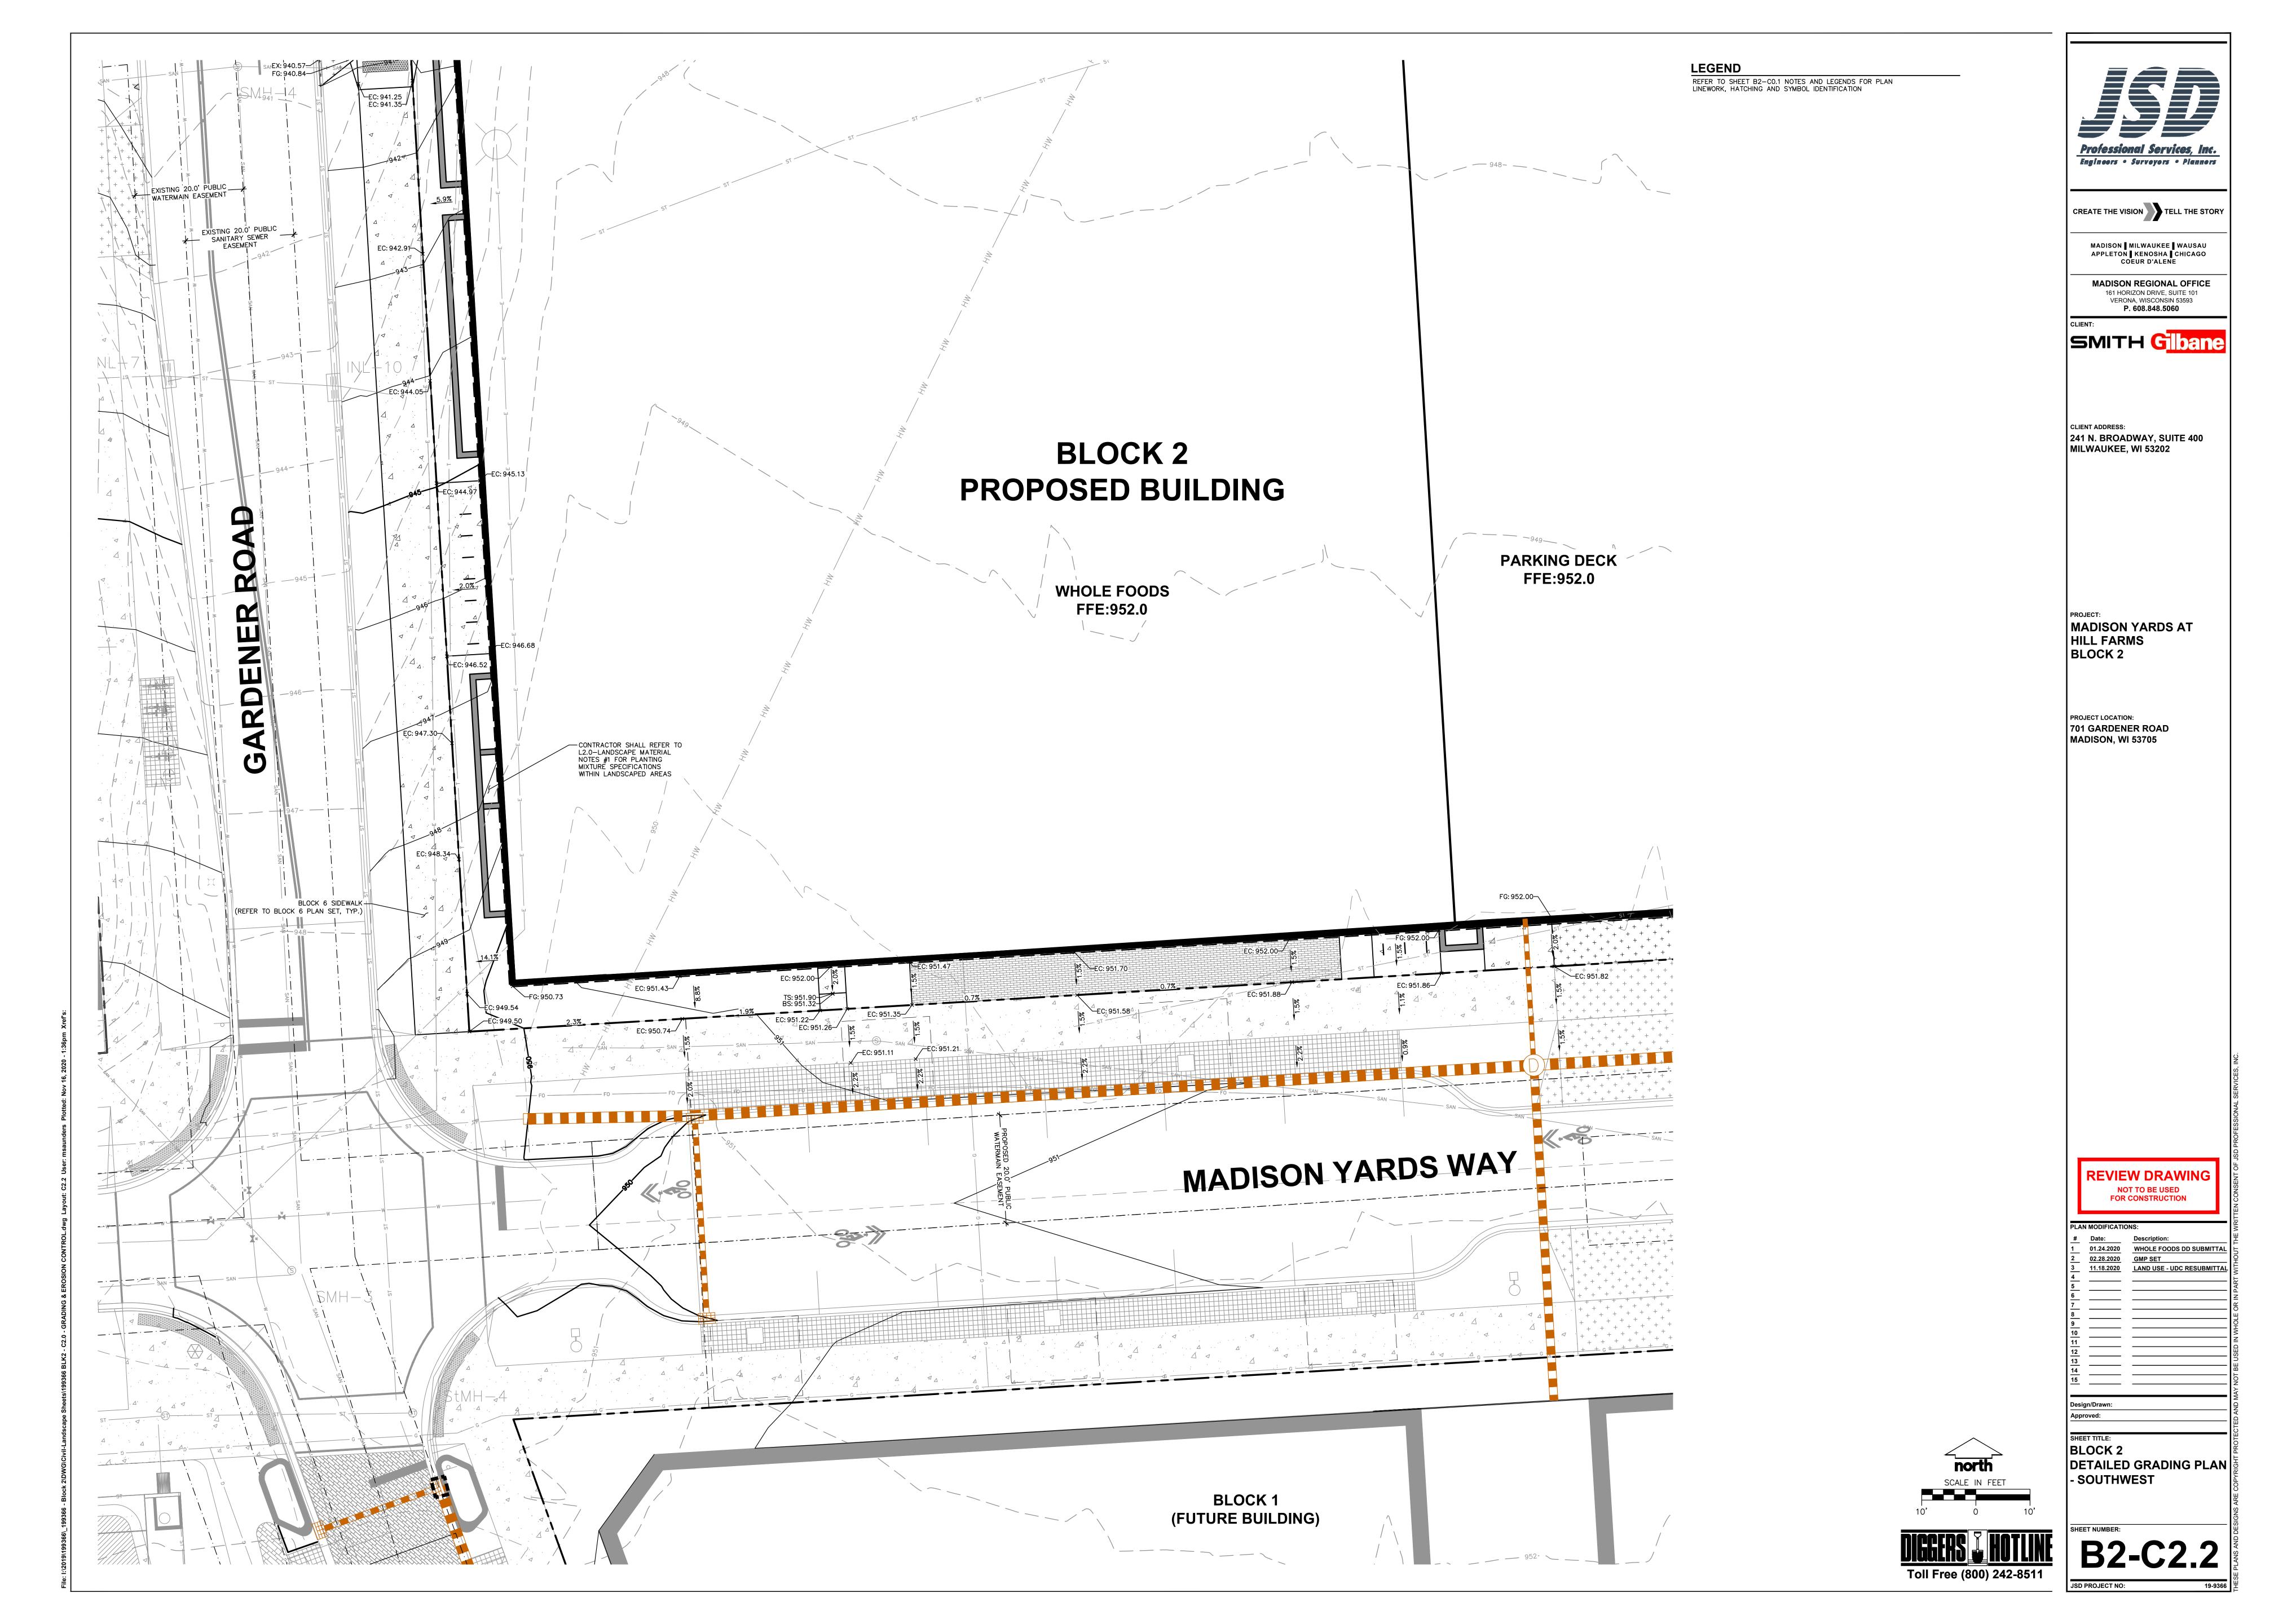

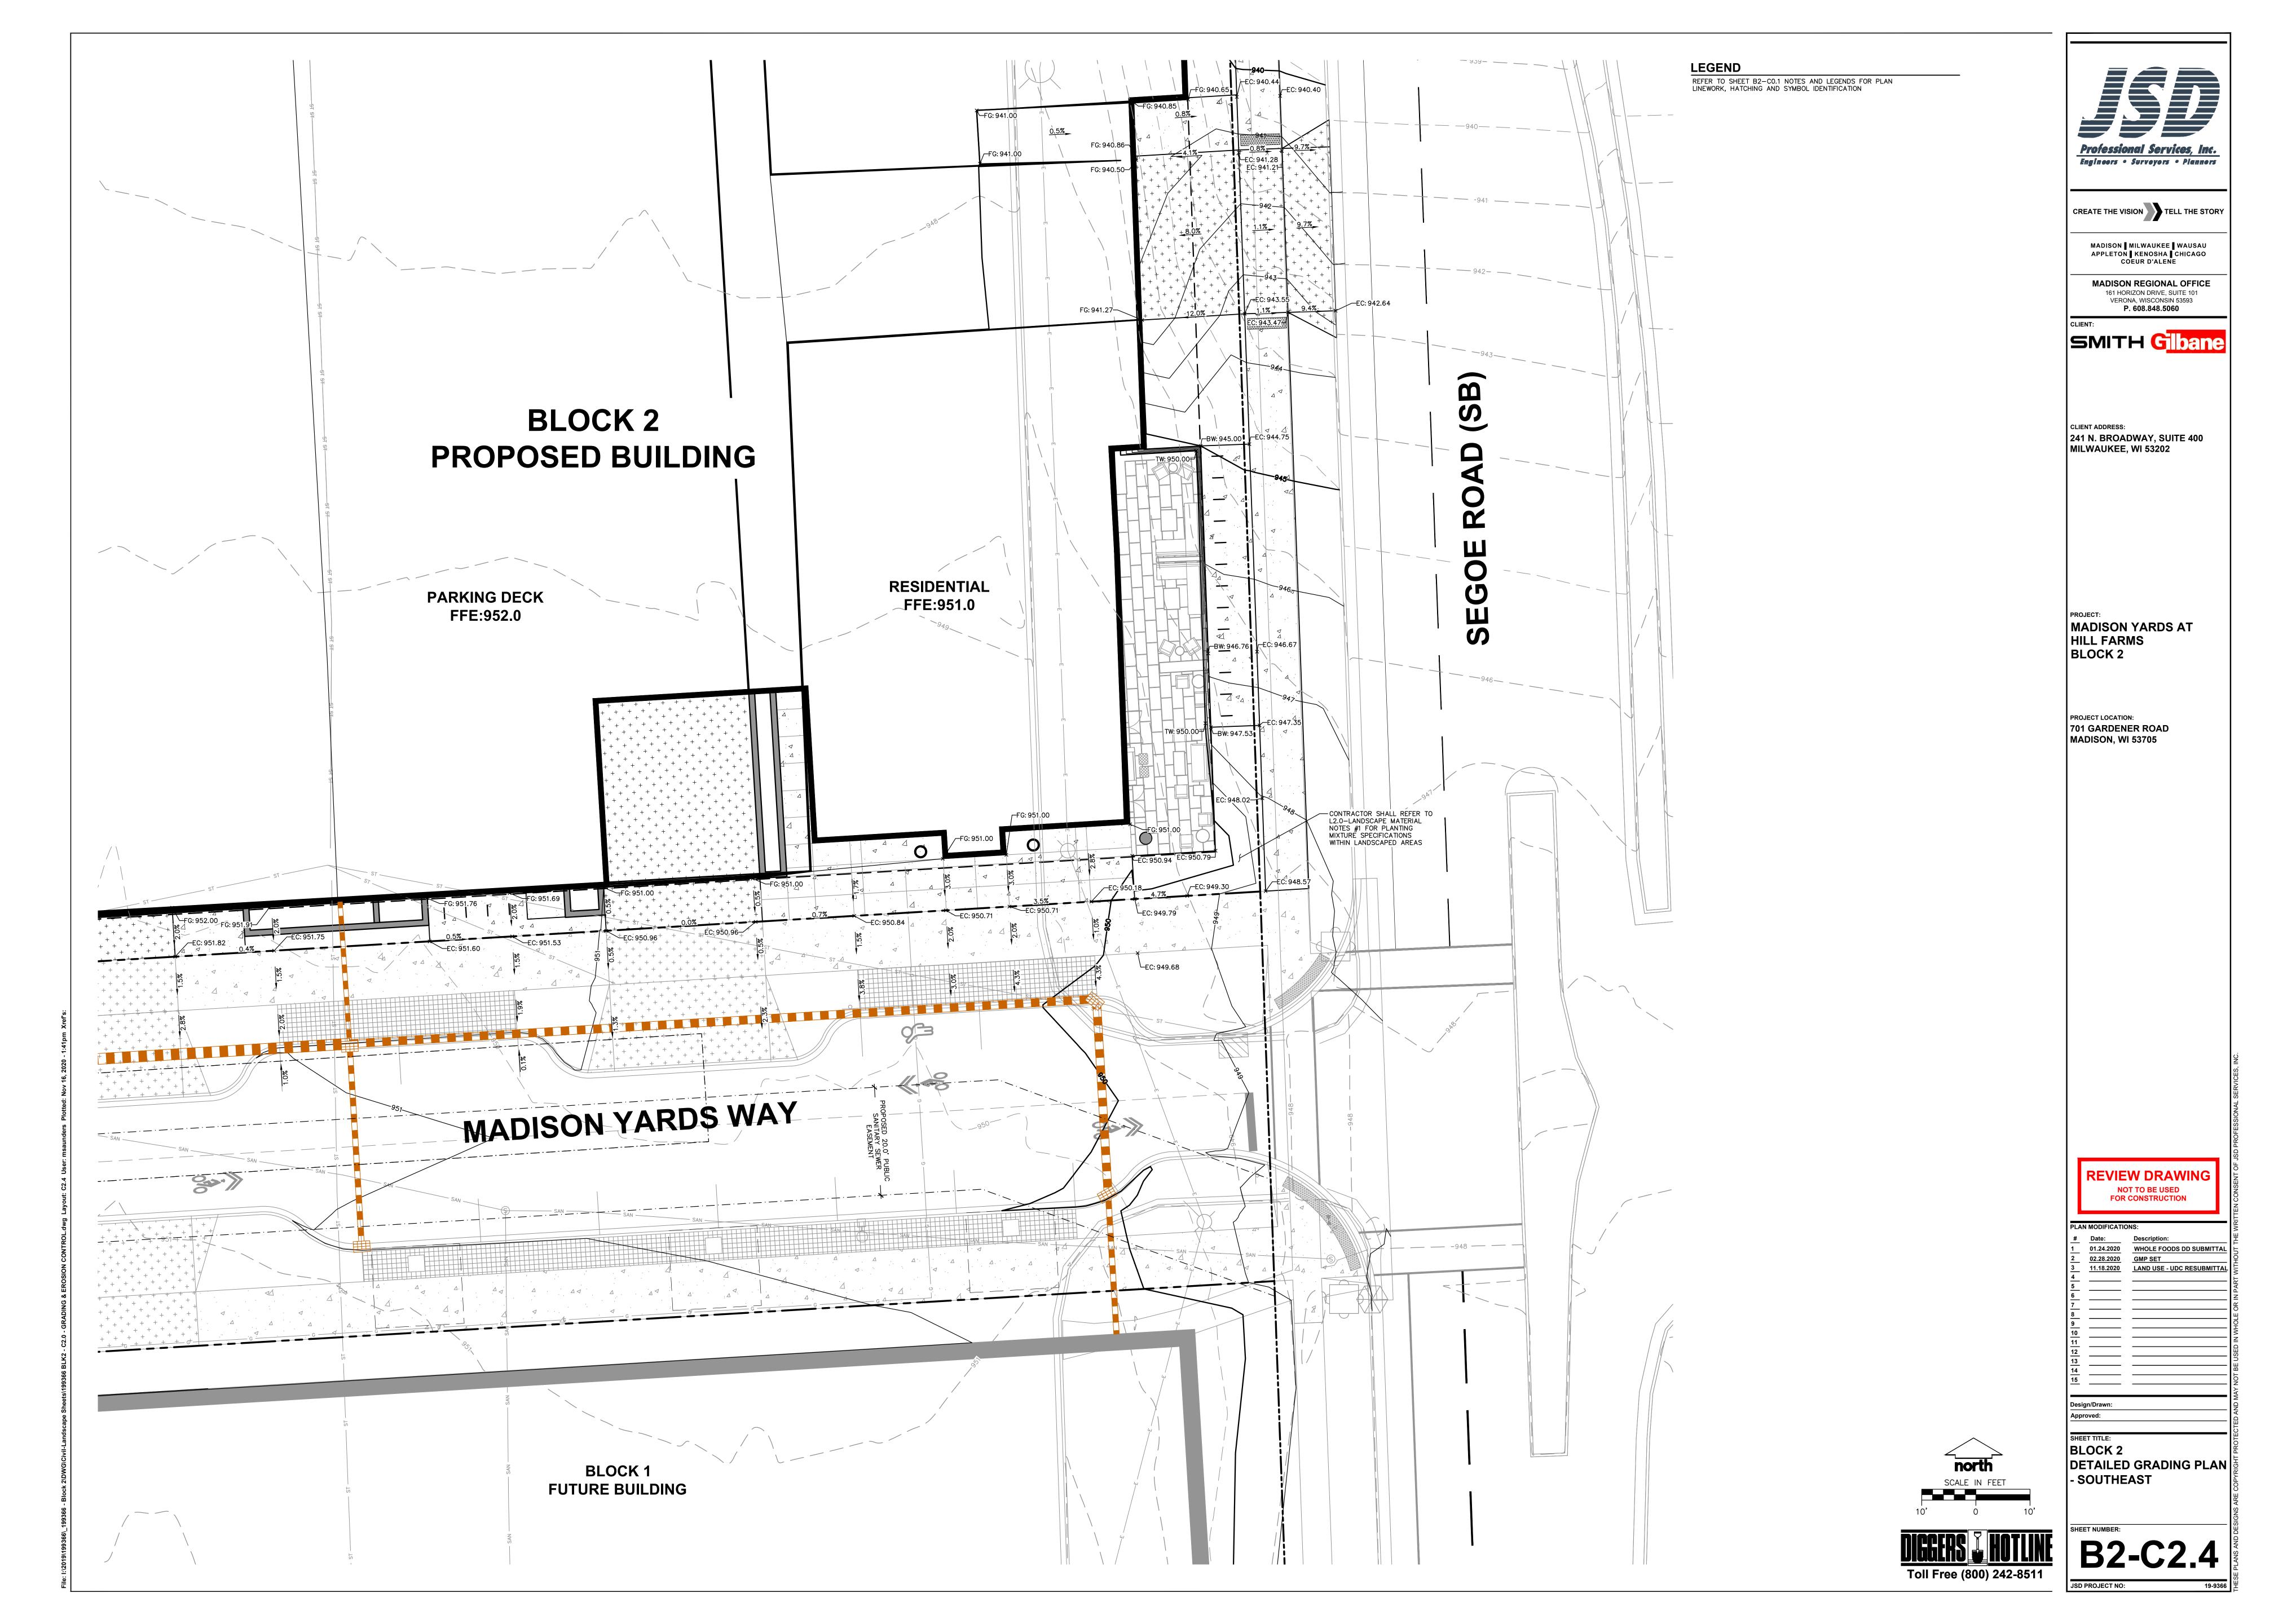

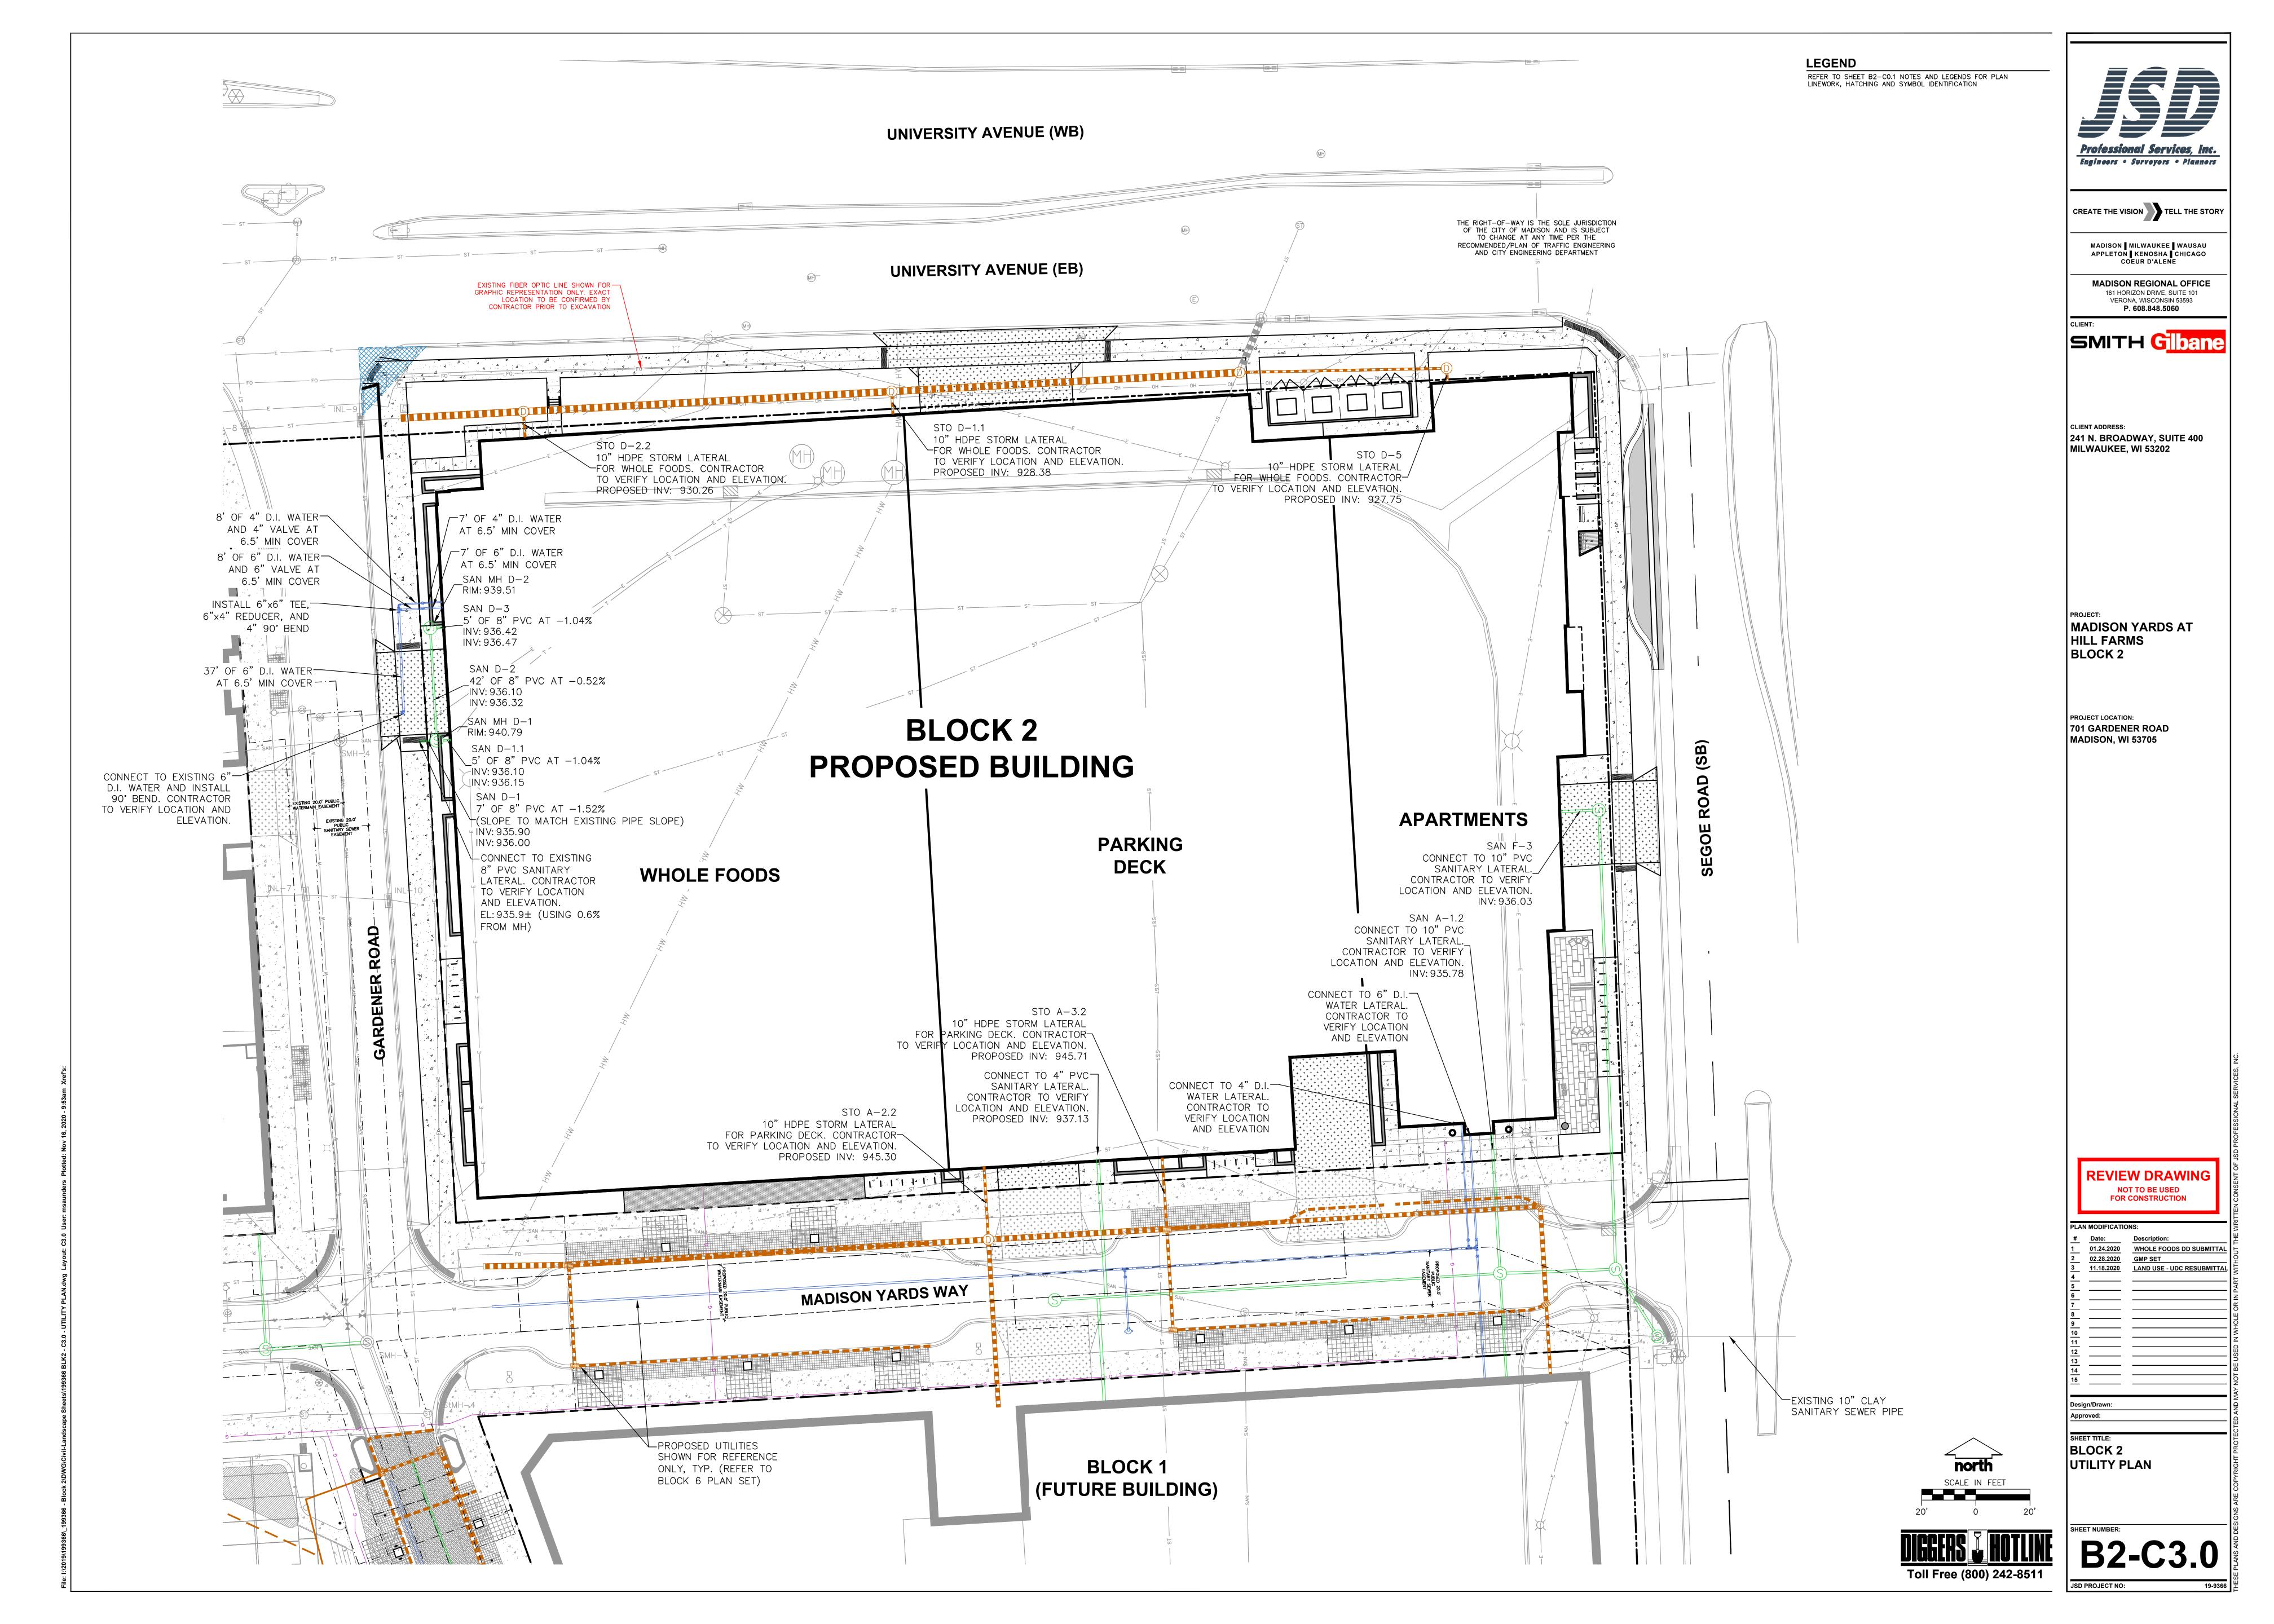

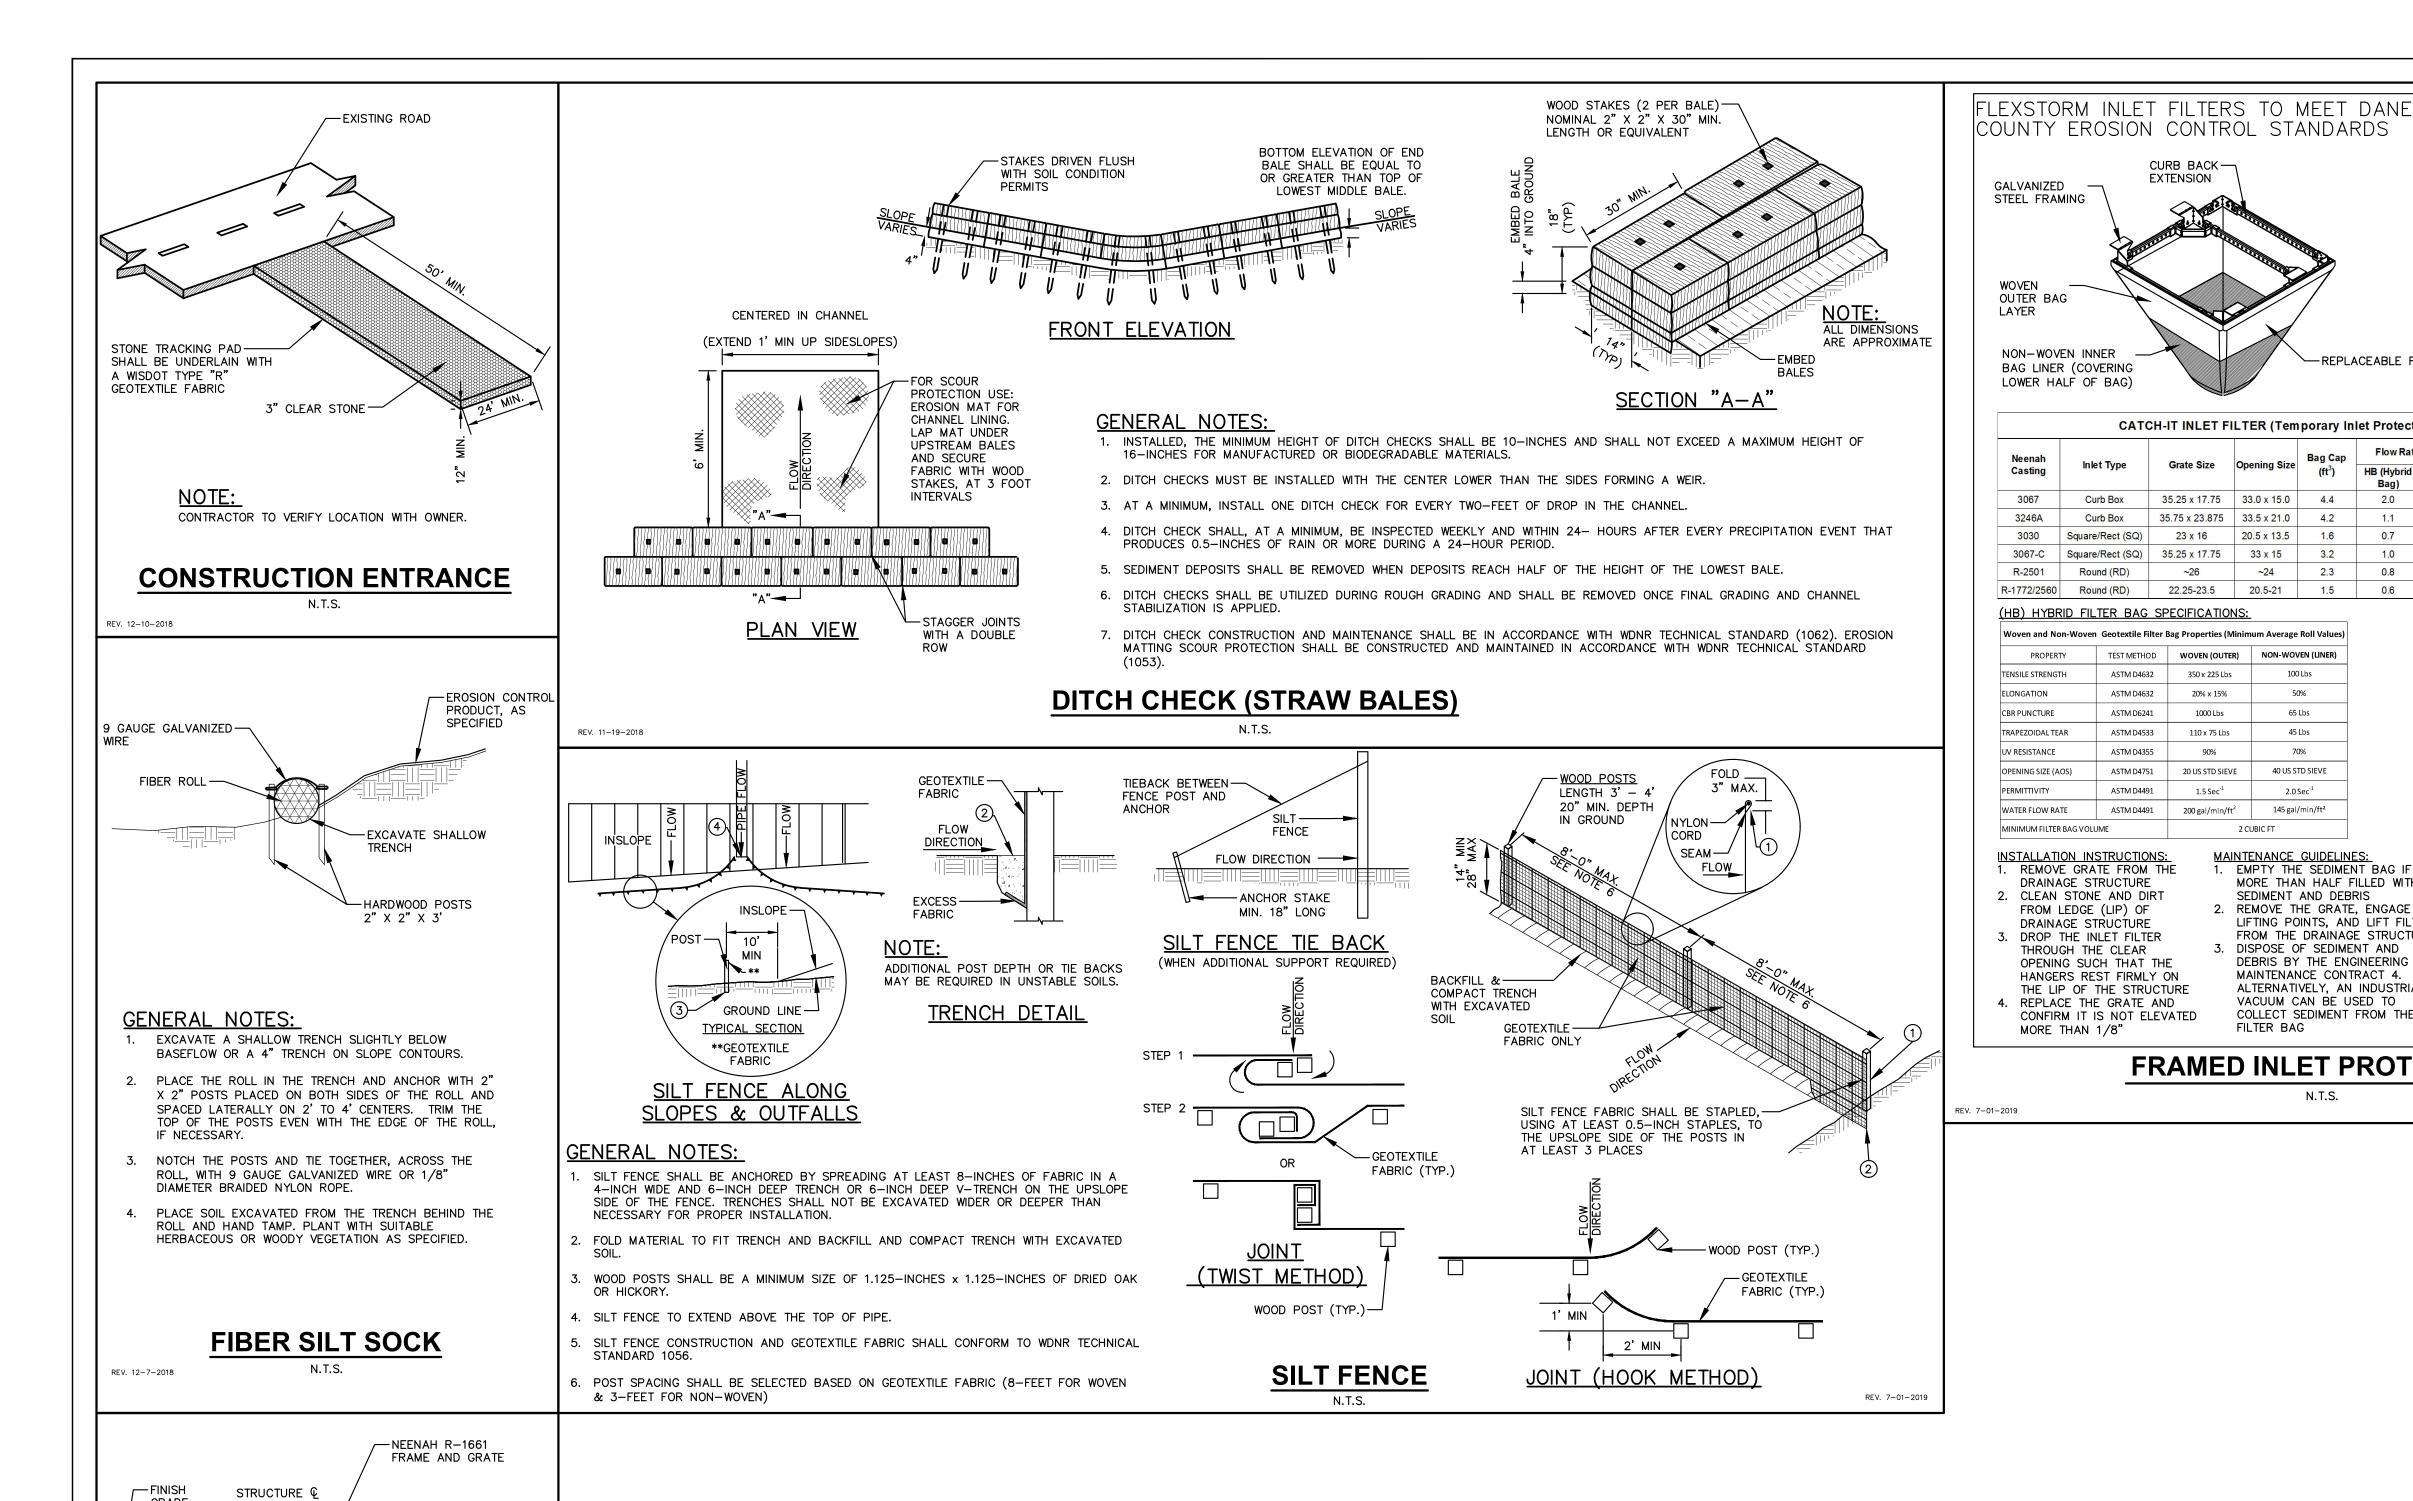

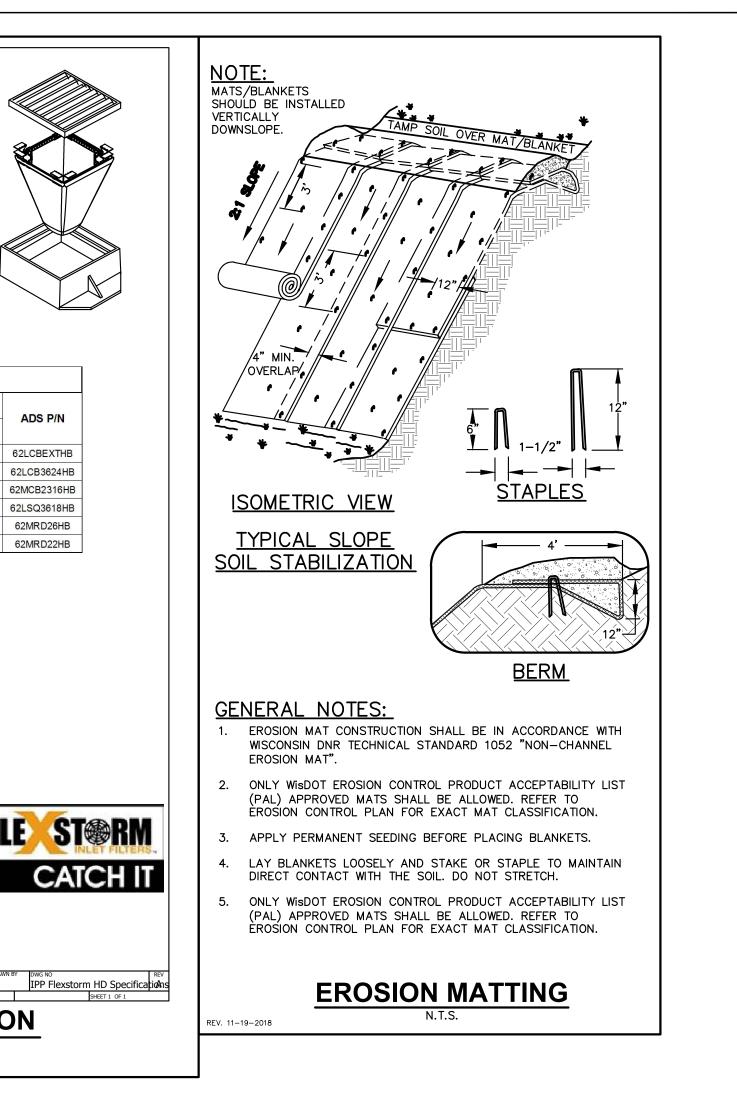

CURB BACK— EXTENSION

22.25-23.5 20.5-21 1.5 0.6 4.6 62MRD22HB

62LCBEXTHB

3.3 62LCB3624HB

5.2 62LSQ3618HB

CATCH-IT INLET FILTER (Temporary Inlet Protection)

100 Lbs

65 Lbs

40 US STD SIEVE

2.0 Sec⁻¹

145 gal/min/ft²

SEDIMENT AND DEBRIS REMOVE THE GRATE, ENGAGE

MAINTENANCE GUIDELINES:
1. EMPTY THE SEDIMENT BAG IF

MORE THAN HALF FILLED WITH

LIFTING POINTS, AND LIFT FILTER

FROM THE DRAINAGE STRUCTURE

DEBRIS BY THE ENGINEERING OR

ALTERNATIVELY, AN INDUSTRIAL

DISPOSE OF SEDIMENT AND

MAINTENANCE CONTRACT 4.

VACUUM CAN BE USED TO

FRAMED INLET PROTECTION

COLLECT SEDIMENT FROM THE

2 CUBIC FT

20% x 15%


1000 Lbs


20 US STD SIEVE

200 gal/min/ft²


ASTM D4491

ASTM D4491

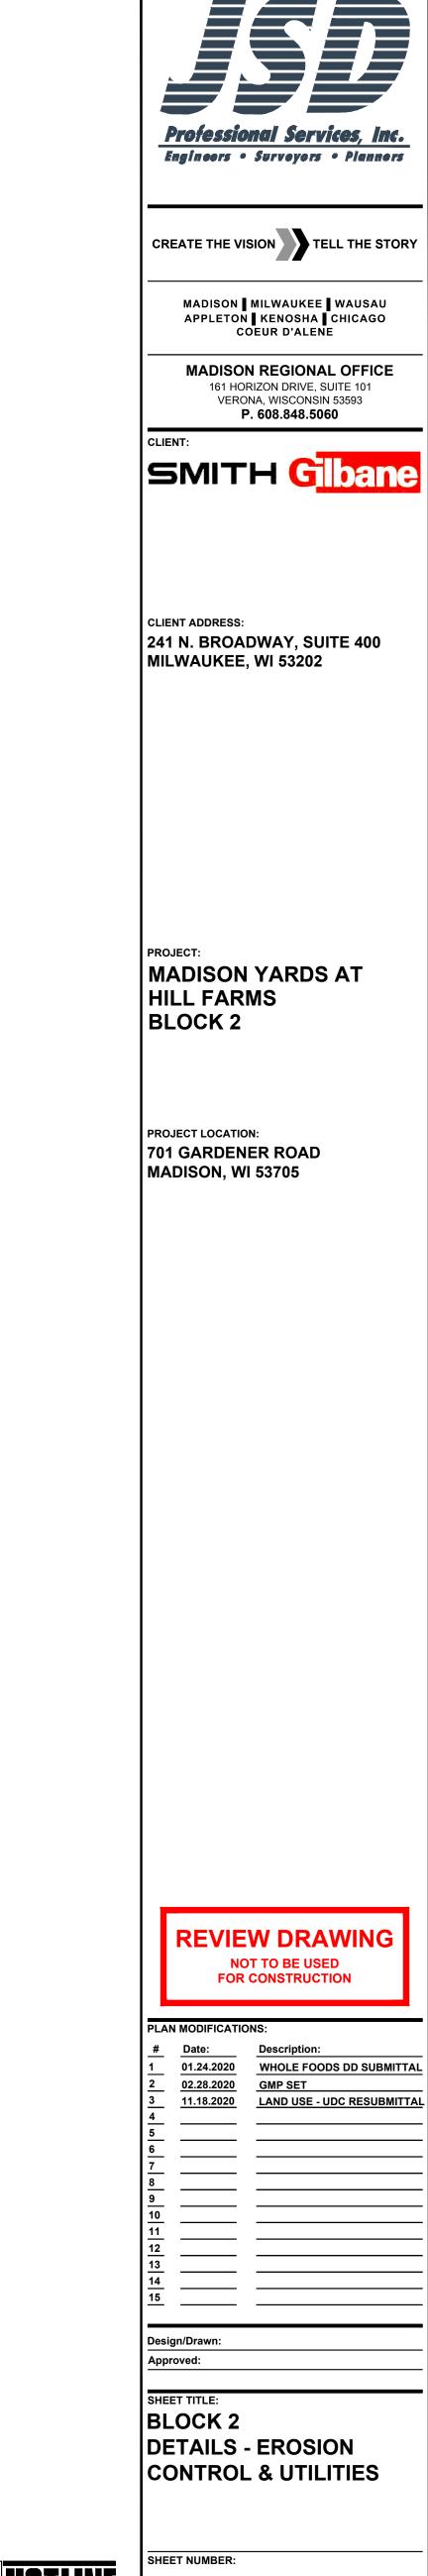

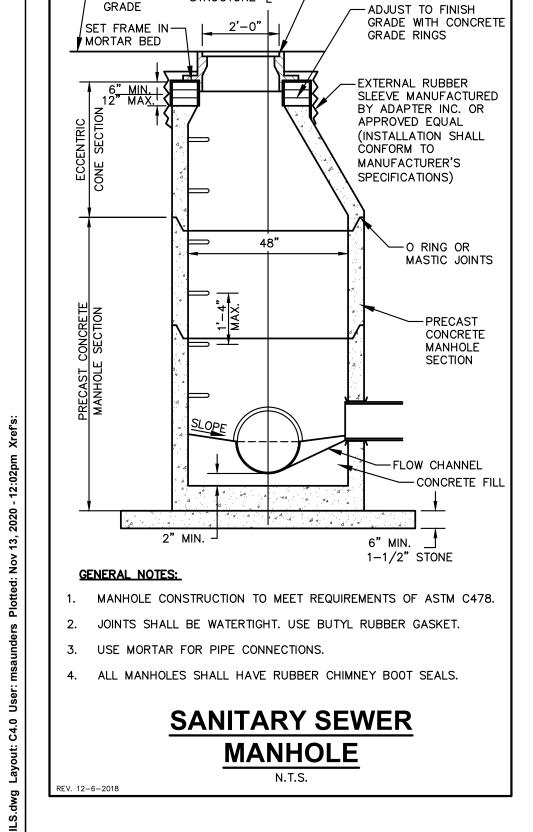

DIGGERS HOTLINE B2-C4.0

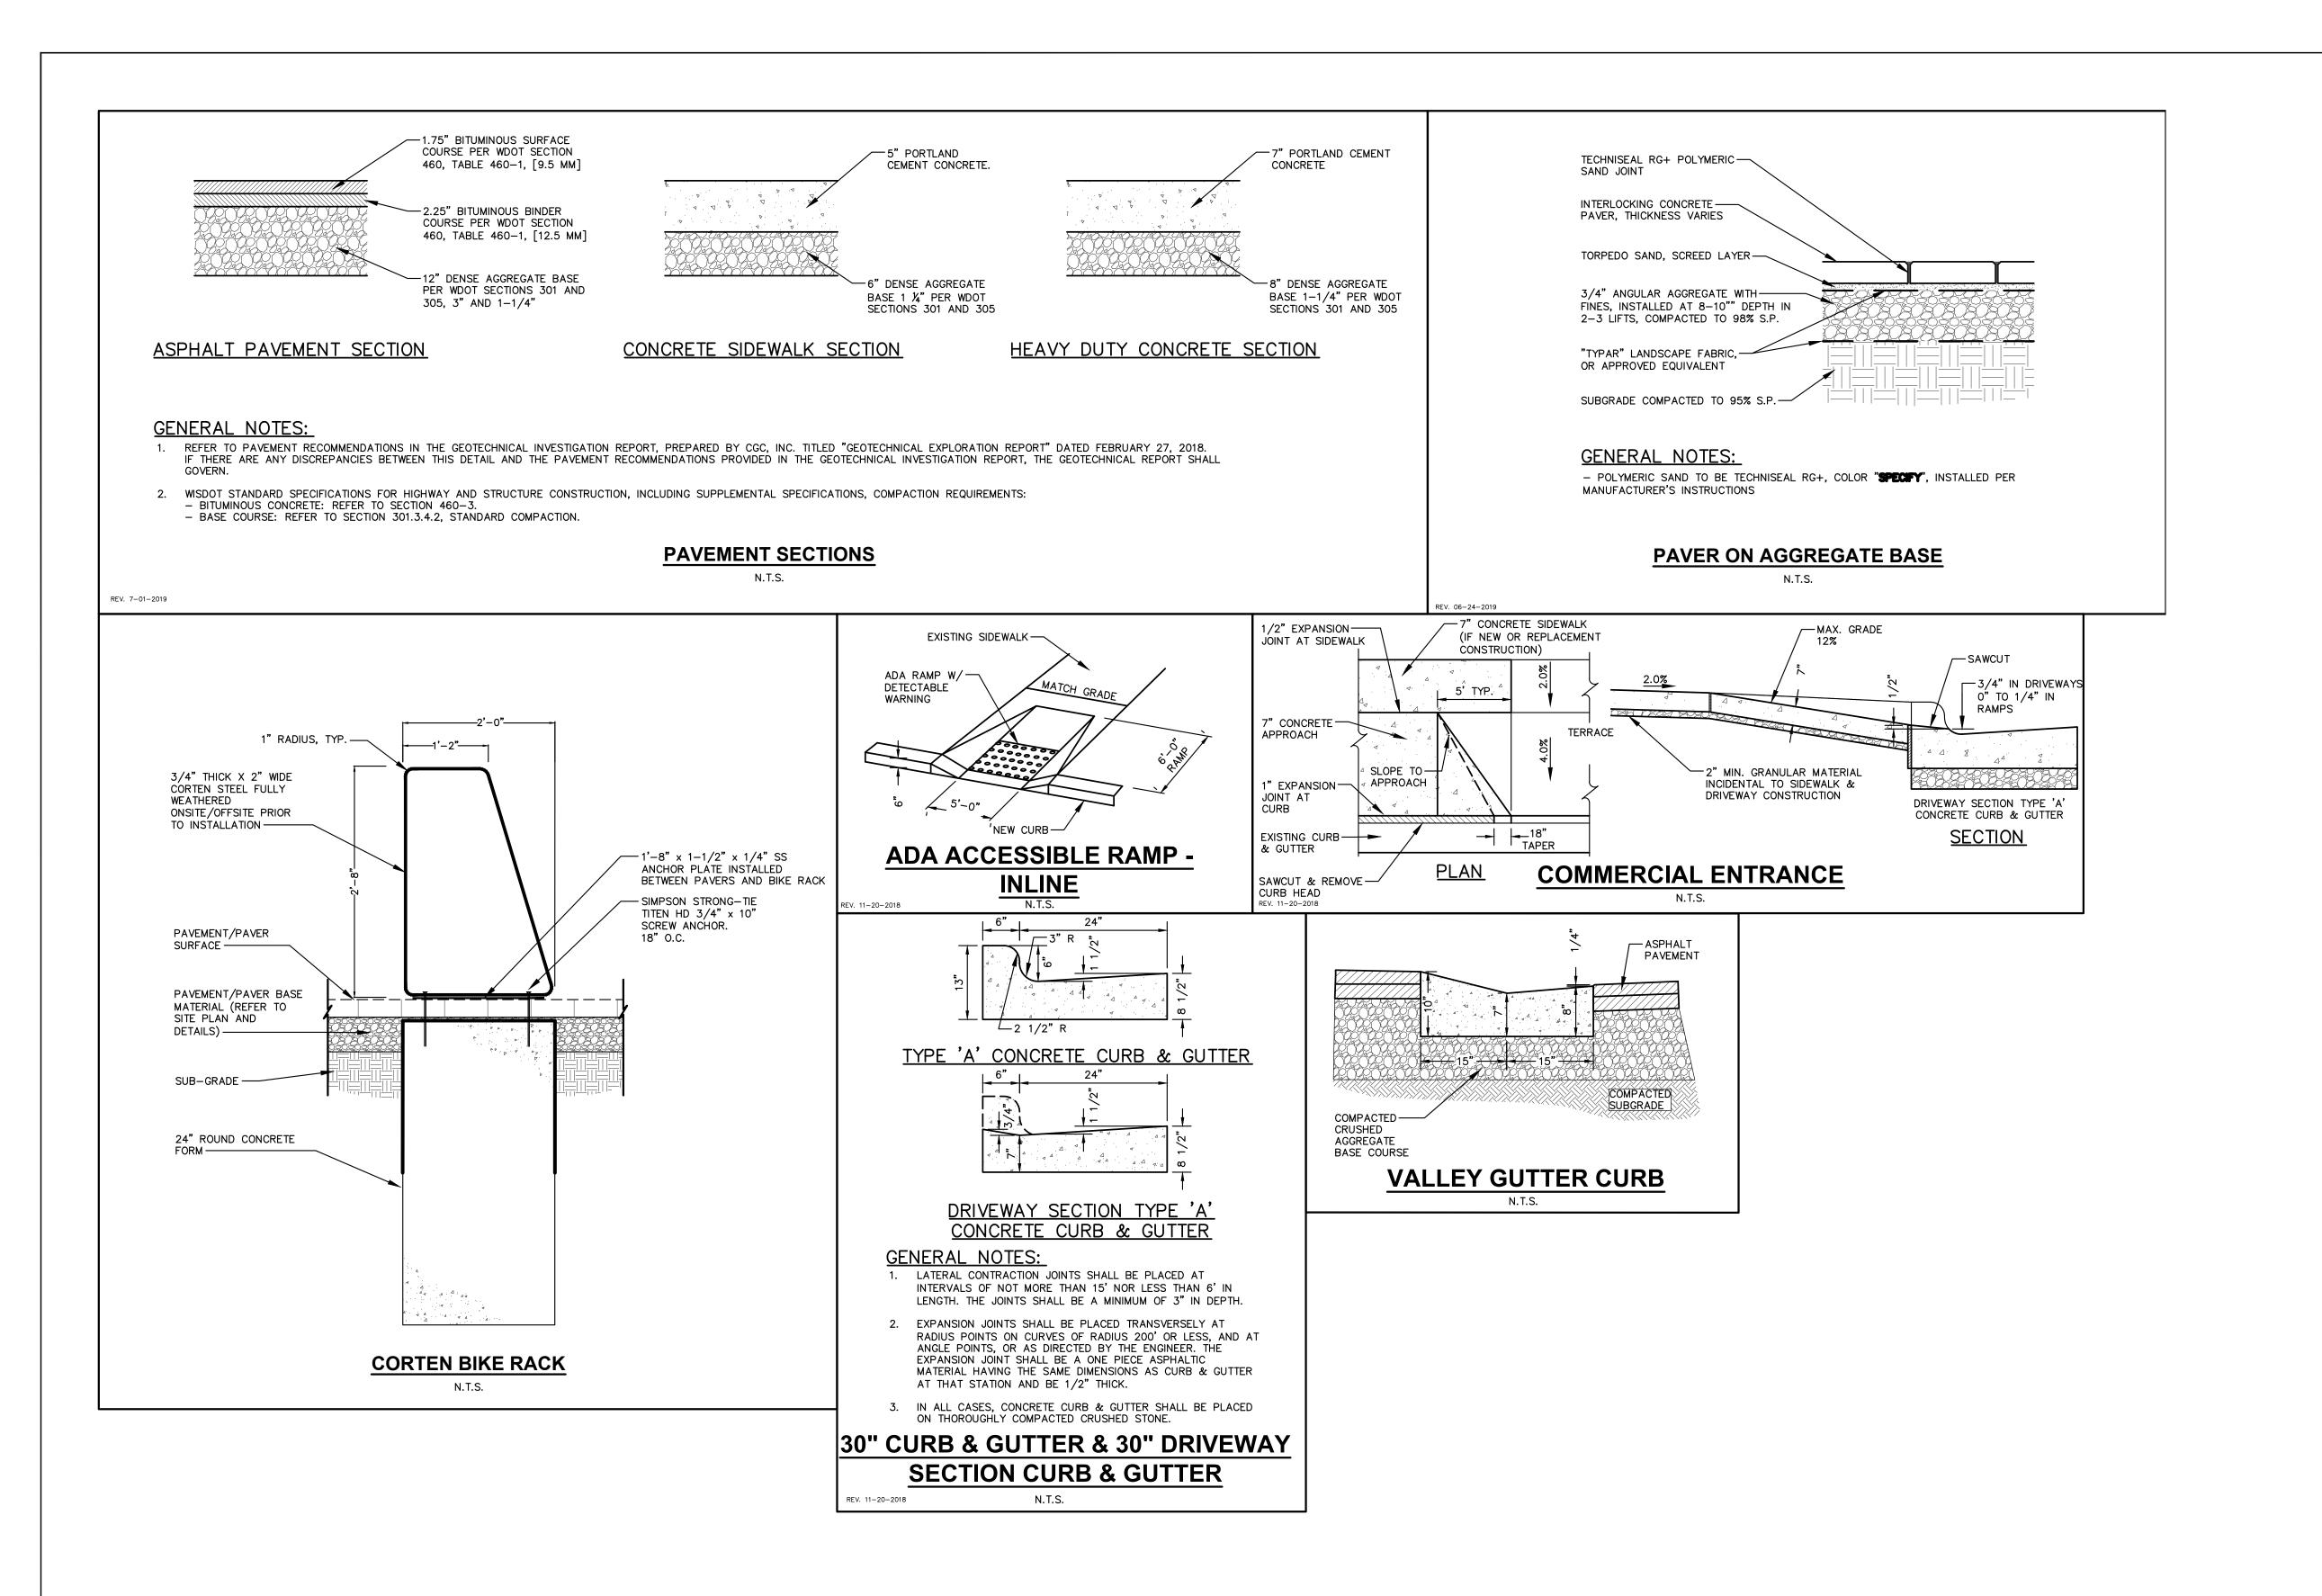





MADISON MILWAUKEE WAUSAU APPLETON KENOSHA CHICAGO COEUR D'ALENE

MADISON REGIONAL OFFICE 161 HORIZON DRIVE, SUITE 101 VERONA, WISCONSIN 53593 P. 608.848.5060

SMITH Glbar

CLIENT ADDRESS: 241 N. BROADWAY, SUITE 400 MILWAUKEE, WI 53202

MADISON YARDS AT HILL FARMS BLOCK 2

PROJECT LOCATION: 701 GARDENER ROAD MADISON, WI 53705

REVIEW DRAWING NOT TO BE USED FOR CONSTRUCTION


PLAN MODIFICATIONS:

01.24.2020 WHOLE FOODS DD SUBMITTAL 02.28.2020 GMP SET 11.18.2020 LAND USE - UDC RESUBMITTAL

SHEET TITLE:
BLOCK 2
DETAILS - SITE

DIGGERS HOTLINE
Toll Free (800) 242-8511

SHEET NUMBER:
B2-C4.1

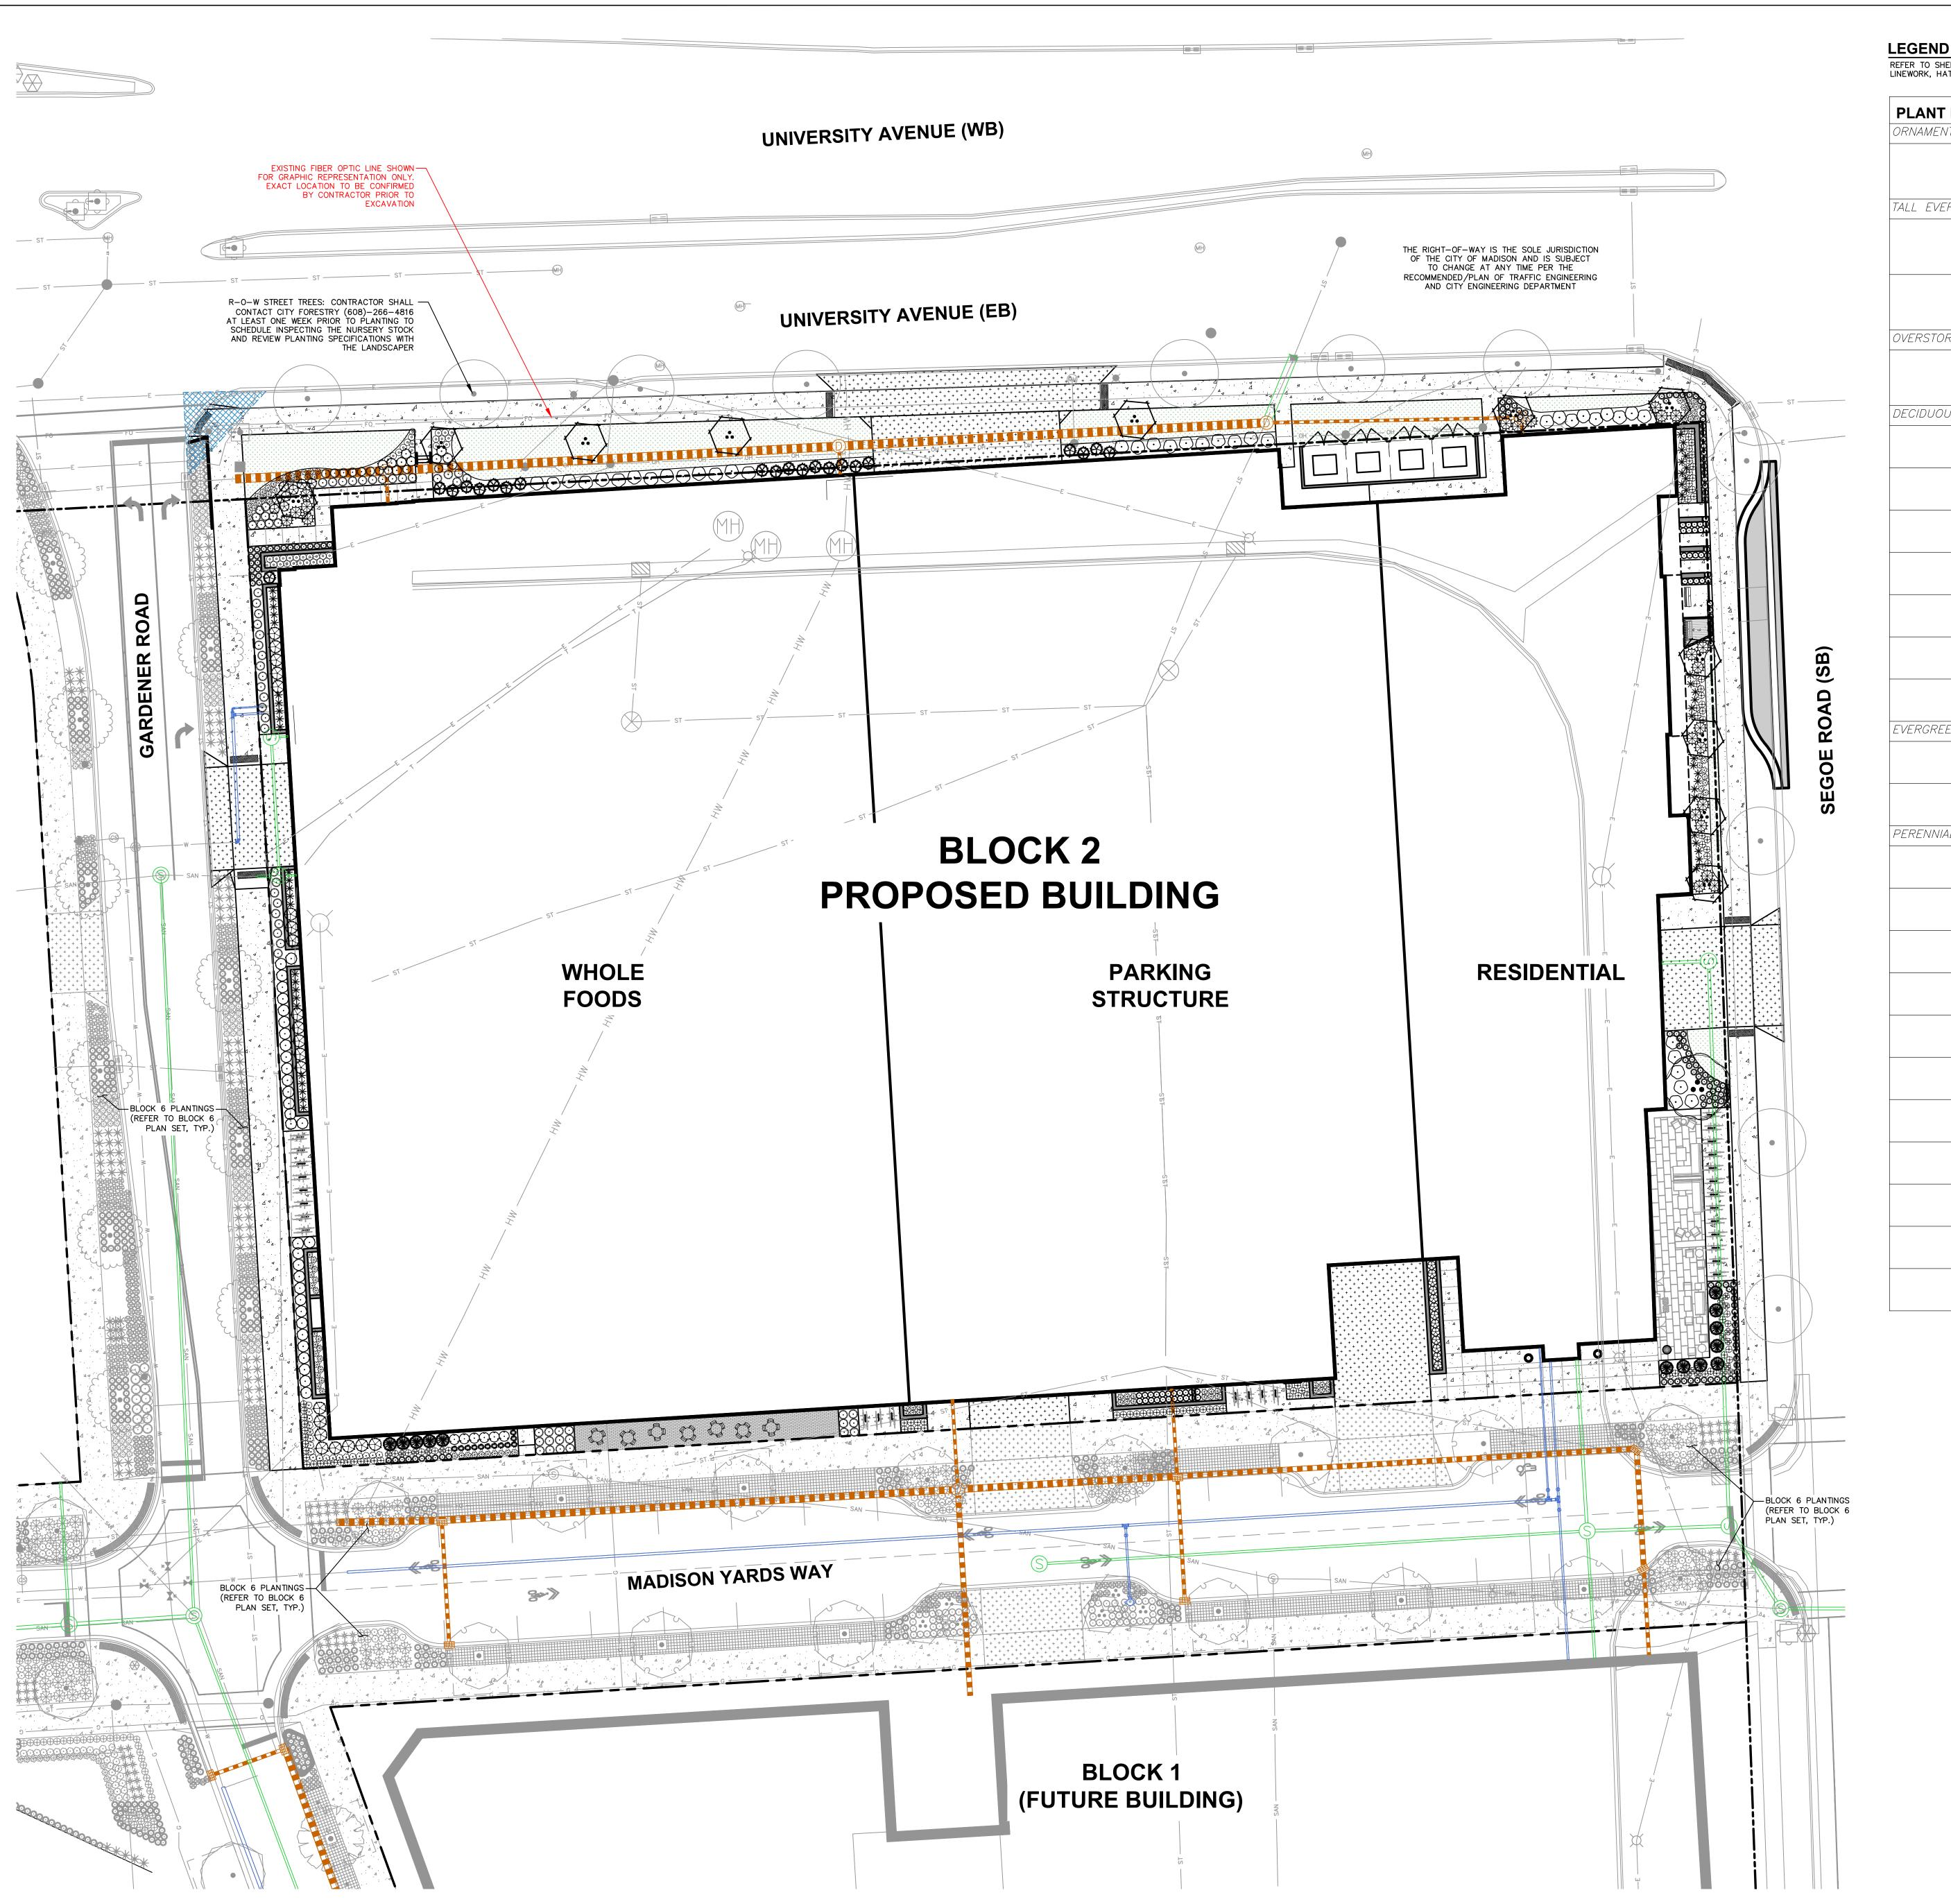

REFER TO SHEET B2-C0.1 NOTES AND LEGENDS FOR PLAN LINEWORK, HATCHING AND SYMBOL IDENTIFICATION

PLANT LIST	SEE SHI	EET L2.0 FOR COMPREHENSIVE PLANT SCHEDULE
ORNAMENTAL TREES	CODE	BOTANICAL / COMMON NAME
•	AAB	Amelanchier x grandiflora 'Autumn Brilliance' / Autumn Brilliance Serviceberry M.S.
TALL EVERGREEN TREE	CODE	BOTANICAL / COMMON NAME
	PCC	Pinus cembra 'Chalet' / Chalet Swiss Stone Pine
	THP	Thuja occidentalis 'Pyramidalis' / Pyramidalis Cedar
OVERSTORY DECIDUOUS TREE	CODE	BOTANICAL / COMMON NAME
••	BN	Betula nigra 'BNMTF' TM / Dura Heat River Birch
DECIDUOUS SHRUBS	CODE	BOTANICAL / COMMON NAME
\odot	AM	Aronia melanocarpa 'Morton' TM / Iroquis Beauty Black Chokeberry
Exercise Section 1	AMS	Aronia melanocarpa 'UCONNAM166' TM / Low Scape Hedger Chokeberry
\odot	CF	Cornus stolonifera 'Farrow' / Arctic Fire Dogwood
₩	HB	Hydrangea paniculata 'ILVOBO' TM / Bobo Panicled Hydrangea
\bigcirc	HLL	Hydrangea paniculata 'Little Lime' / Little Lime Hydrangea
	HLQ	Hydrangea paniculata 'Little Quick Fire' / Little Quick Fire Hydrangea
\odot	PHC	Physocarpus opulifolius 'Center Glow' / Center Glow Ninebark
EVERGREEN SHRUBS	CODE	BOTANICAL / COMMON NAME
\bigotimes	PP	Pinus mugo 'Pumilio' / Mugo Pine
	TME	Taxus x media 'Everlow' / Yew
PERENNIALS & GRASSES	CODE	BOTANICAL / COMMON NAME
	CMW	Calamintha nepeta 'Montrose White' / Montrose White Catmint
€:3	EP	Echinacea purpurea 'PAS7Ø2918' TM / PowWow White Coneflower
	EF	Echinacea x 'Firebird' / Firebird Coneflower
	ET	Echinacea x 'Tiki Torch' / Coneflower
0	GT	Geranium x 'Tiny Monster' / Tiny Monster Geranium
E AMAZE E E E E E E E E E E E E E E E E E E	LK	Liatris spicata 'Kobold' / Spike Gayfeathe
*	PVN	Panicum virgatum 'North Wind' / Northwind Switch Grass
annoner	PVS	Panicum virgatum 'Shenandoah' / Switch Grass
£#3	RFS	Rudbeckia fulgida speciosa / Showy Coneflower
•	SNC	Salvia nemorosa 'Caradonna' / Cardonna Perennial Salvia
MANUE MA MANUE MANUE MANUE MANUE MANUE MANUE MANUE MANUE MANUE MANUE MA MANUE MA MANUE MA MANUE MA MANUE MA MANUE MANUE MANUE MANUE MANUE MANUE	SH	Sporobolus heterolepis 'Tara' / Prairie Dropseed



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MADISON █ MILWAUKEE █ WAUSAU APPLETON █ KENOSHA █ CHICAGO COEUR D'ALENE MADISON REGIONAL OFFICE 161 HORIZON DRIVE, SUITE 101 VERONA, WISCONSIN 53593

SMITH Gibar

P. 608.848.5060

CLIENT ADDRESS: 241 N. BROADWAY, SUITE 400


MILWAUKEE, WI 53202


MADISON YARDS AT HILL FARMS BLOCK 2

PROJECT LOCATION: 701 GARDENER ROAD MADISON, WI 53705

REVIEW DRAWING

SHEET TITLE:
BLOCK 2
OVERALL LANDSCAPE
PLAN

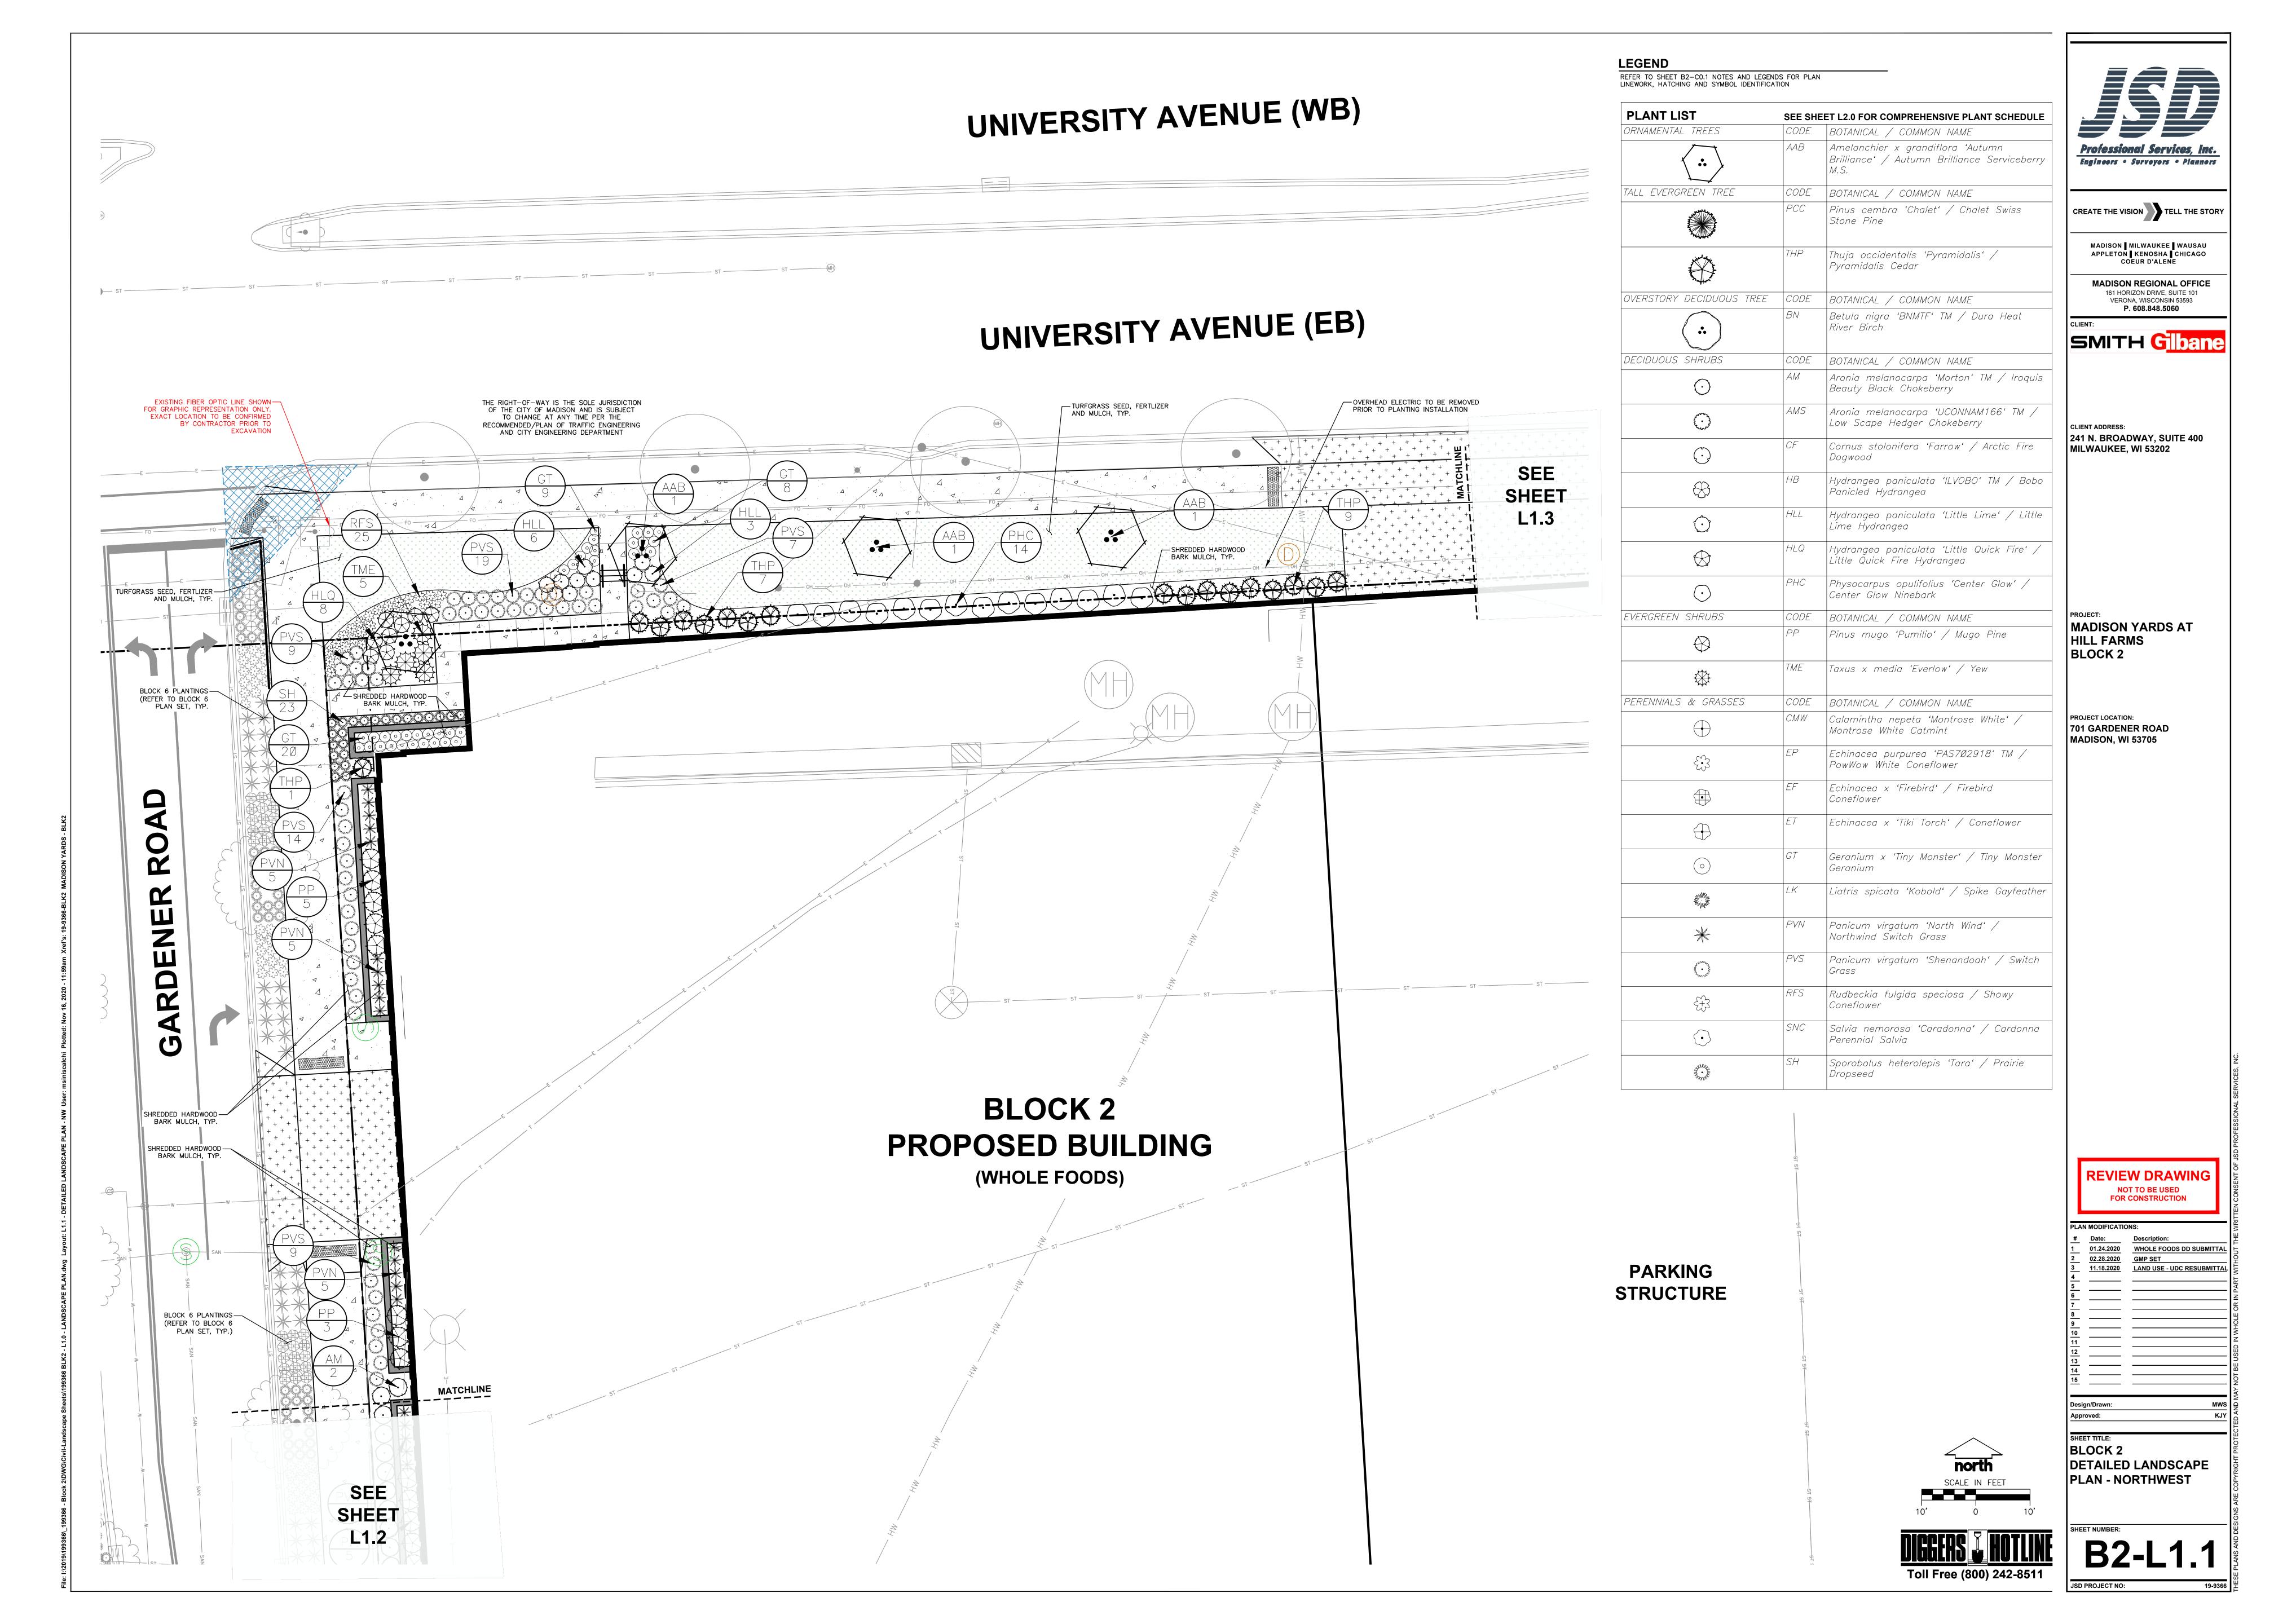

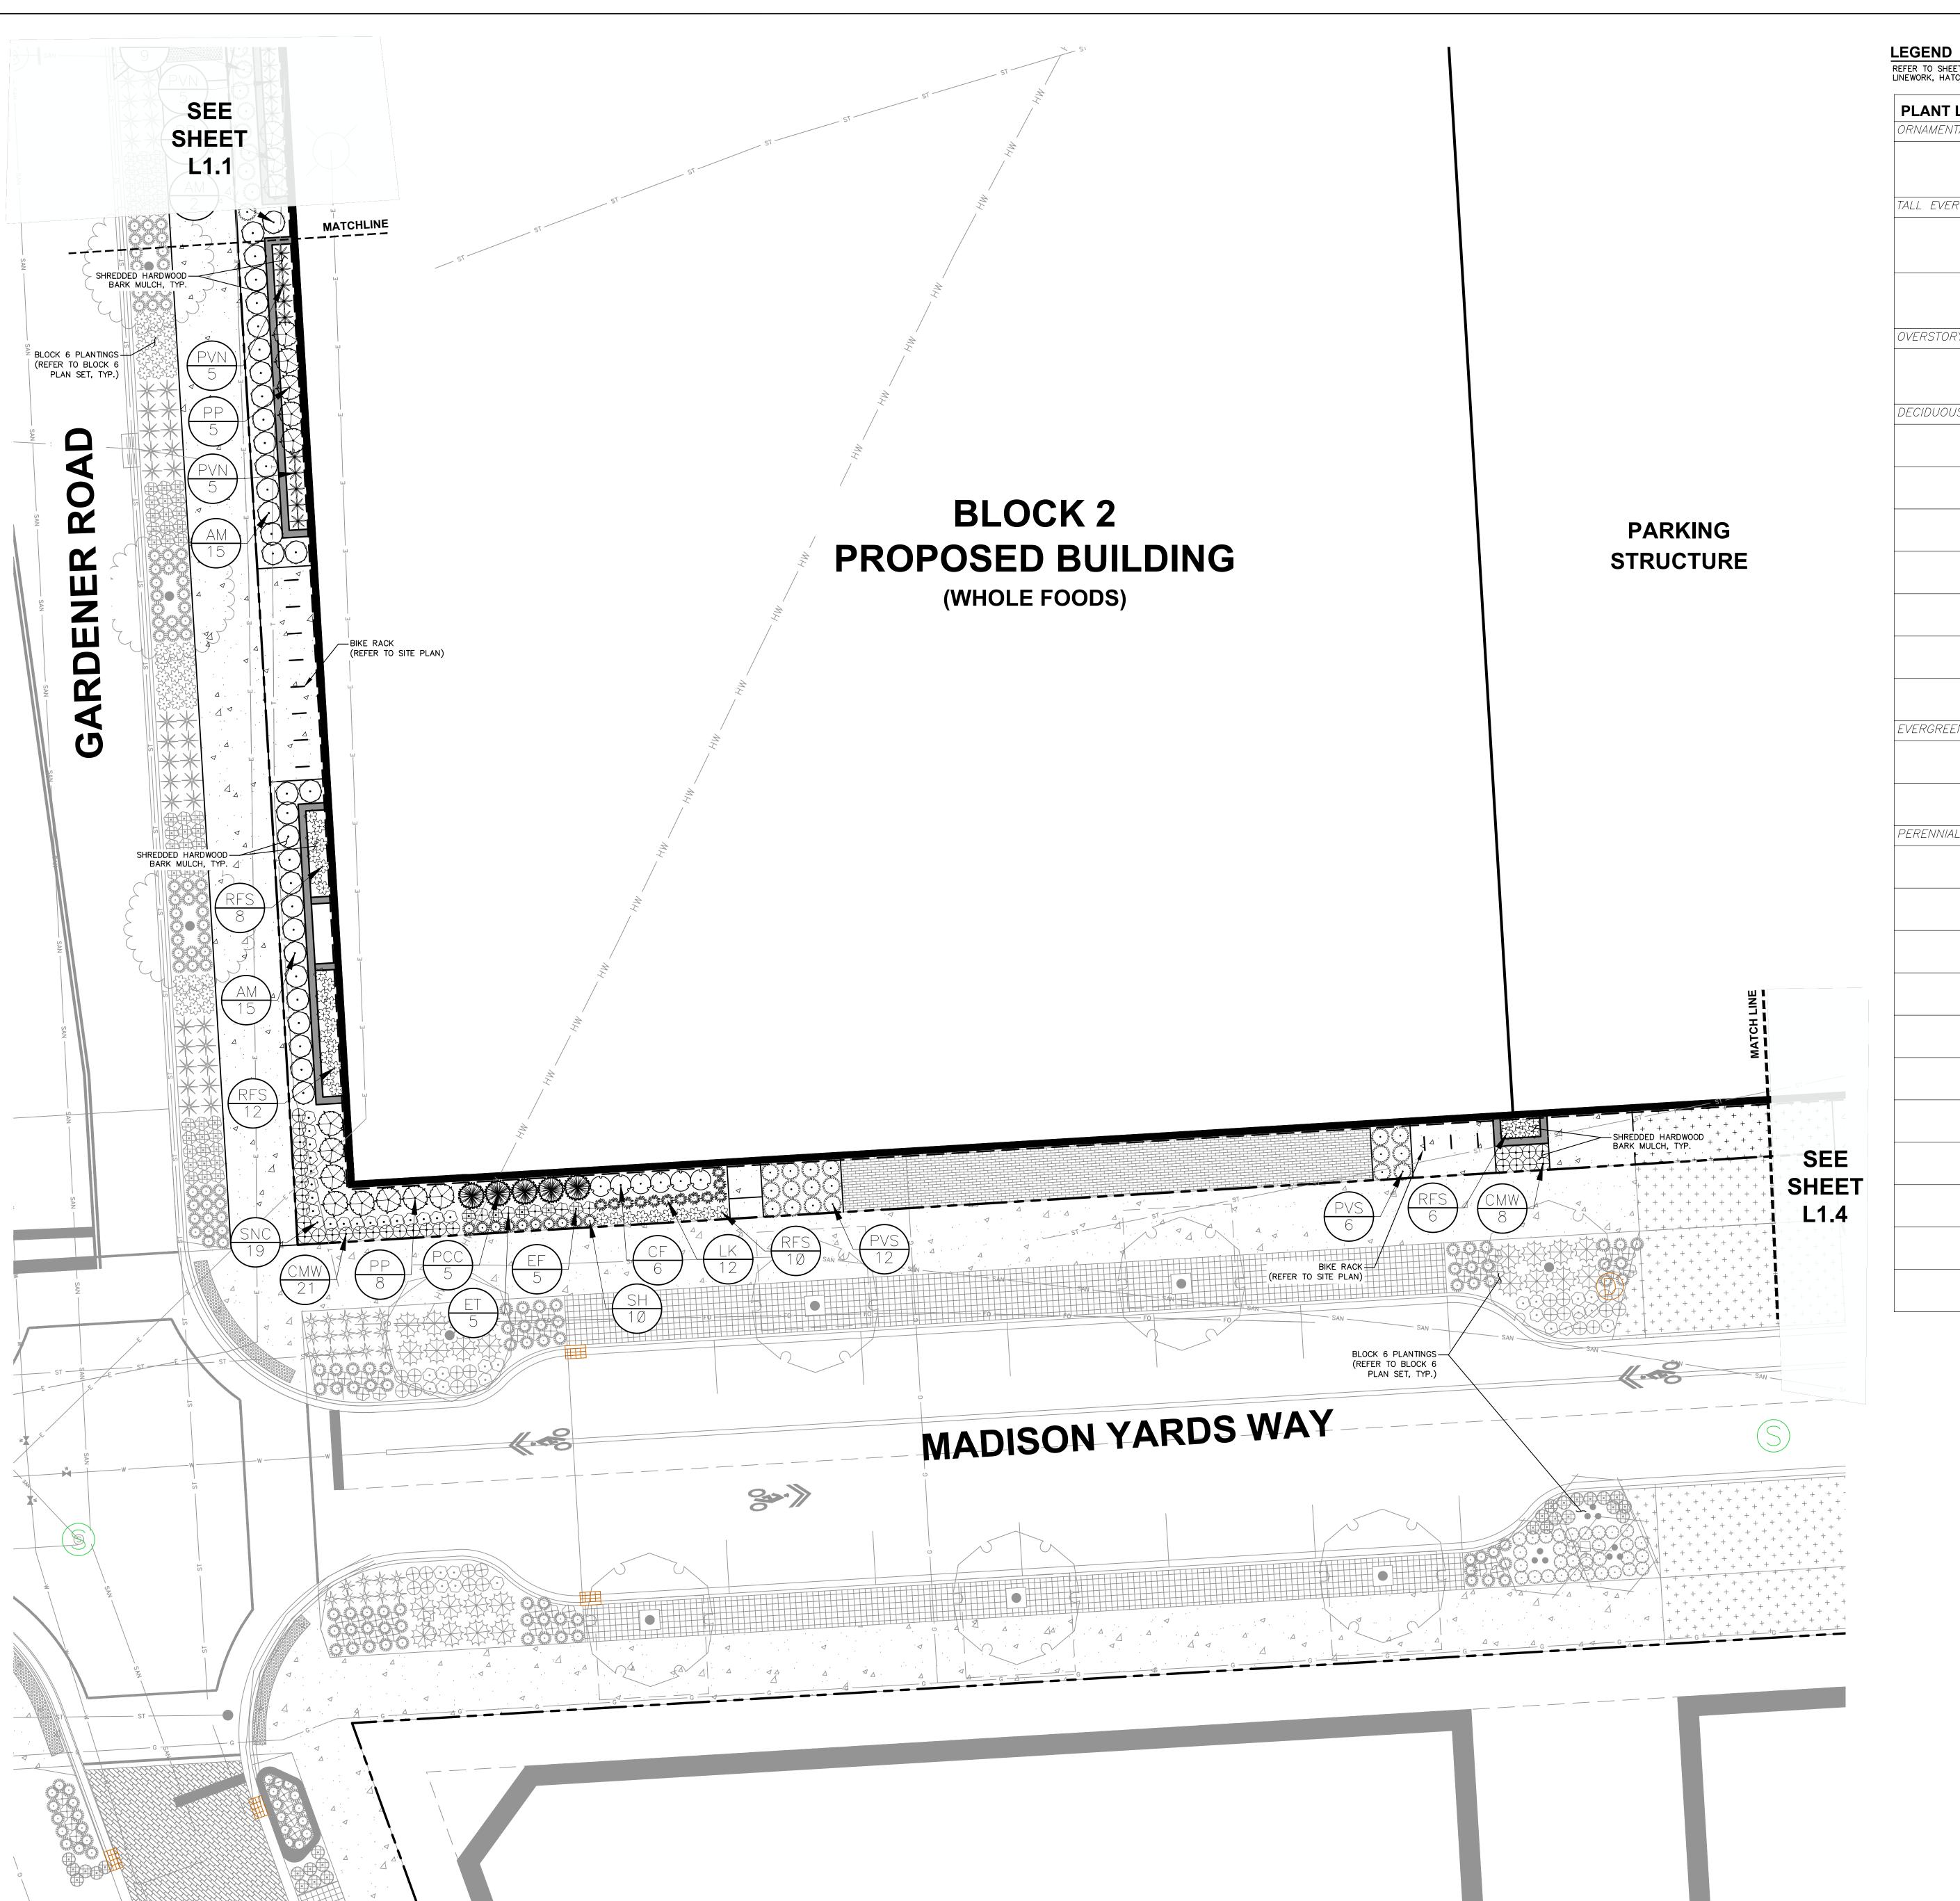

REFER TO SHEET B2-C0.1 NOTES AND LEGENDS FOR PLAN LINEWORK, HATCHING AND SYMBOL IDENTIFICATION

PLANT LIST		EET L2.0 FOR COMPREHENSIVE PLANT SCHEDULE
ORNAMENTAL TREES	CODE	BOTANICAL / COMMON NAME
•	AAB	Amelanchier x grandiflora 'Autumn Brilliance' / Autumn Brilliance Serviceberry M.S.
TALL EVERGREEN TREE	CODE	BOTANICAL / COMMON NAME
	PCC	Pinus cembra 'Chalet' / Chalet Swiss Stone Pine
	THP	Thuja occidentalis 'Pyramidalis' / Pyramidalis Cedar
OVERSTORY DECIDUOUS TREE	CODE	BOTANICAL / COMMON NAME
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DECIDUOUS SHRUBS	CODE	BOTANICAL / COMMON NAME
\odot	AM	Aronia melanocarpa 'Morton' TM / Iroquis Beauty Black Chokeberry
Edward Comment	AMS	Aronia melanocarpa 'UCONNAM166' TM / Low Scape Hedger Chokeberry
$\langle \cdot \rangle$	CF	Cornus stolonifera 'Farrow' / Arctic Fire Dogwood
\otimes	HB	Hydrangea paniculata 'ILVOBO' TM / Bobo Panicled Hydrangea
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EVERGREEN SHRUBS	CODE	BOTANICAL / COMMON NAME
\bigotimes	PP	Pinus mugo 'Pumilio' / Mugo Pine
	TME	Taxus x media 'Everlow' / Yew
PERENNIALS & GRASSES	CODE	BOTANICAL / COMMON NAME
	CMW	Calamintha nepeta 'Montrose White' / Montrose White Catmint
£*3	EP	Echinacea purpurea 'PAS7Ø2918' TM / PowWow White Coneflower
	EF	Echinacea x 'Firebird' / Firebird Coneflower
	ET	Echinacea x 'Tiki Torch' / Coneflower
0	GT	Geranium x 'Tiny Monster' / Tiny Monster Geranium
	LK	Liatris spicata 'Kobold' / Spike Gayfeathe
*	PVN	Panicum virgatum 'North Wind' / Northwind Switch Grass
Synony Co.	PVS	Panicum virgatum 'Shenandoah' / Switch Grass
M)	RFS	Rudbeckia fulgida speciosa / Showy Coneflower
273		
<u></u> €	SNC	Salvia nemorosa 'Caradonna' / Cardonna Perennial Salvia



CREATE THE VISION TELL THE STORY

MADISON MILWAUKEE WAUSAU
APPLETON KENOSHA CHICAGO
COEUR D'ALENE

MADISON REGIONAL OFFICE
161 HORIZON DRIVE, SUITE 101
VERONA, WISCONSIN 53593

VERONA, WISCONSIN 53593
P. 608.848.5060

SMITH Gibane

CLIENT ADDRESS:
241 N. BROADWAY, SUITE 400
MILWAUKEE, WI 53202

PROJECT:
MADISON YARDS AT
HILL FARMS
BLOCK 2

PROJECT LOCATION:
701 GARDENER ROAD
MADISON, WI 53705

REVIEW DRAWING

NOT TO BE USED
FOR CONSTRUCTION

Date: Description:

01.24.2020 WHOLE FOODS DD SUBMITTAL

02.28.2020 GMP SET

11.18.2020 LAND USE - UDC RESUBMITTAL


n/Drawn:

Approved:

BLOCK 2
DETAILED LANDSCAPE
PLAN - SOUTHWEST

SHEET NUMBER:
B2-L1.2

19 **NUILINE B2-L1.2** (19) 242-8511

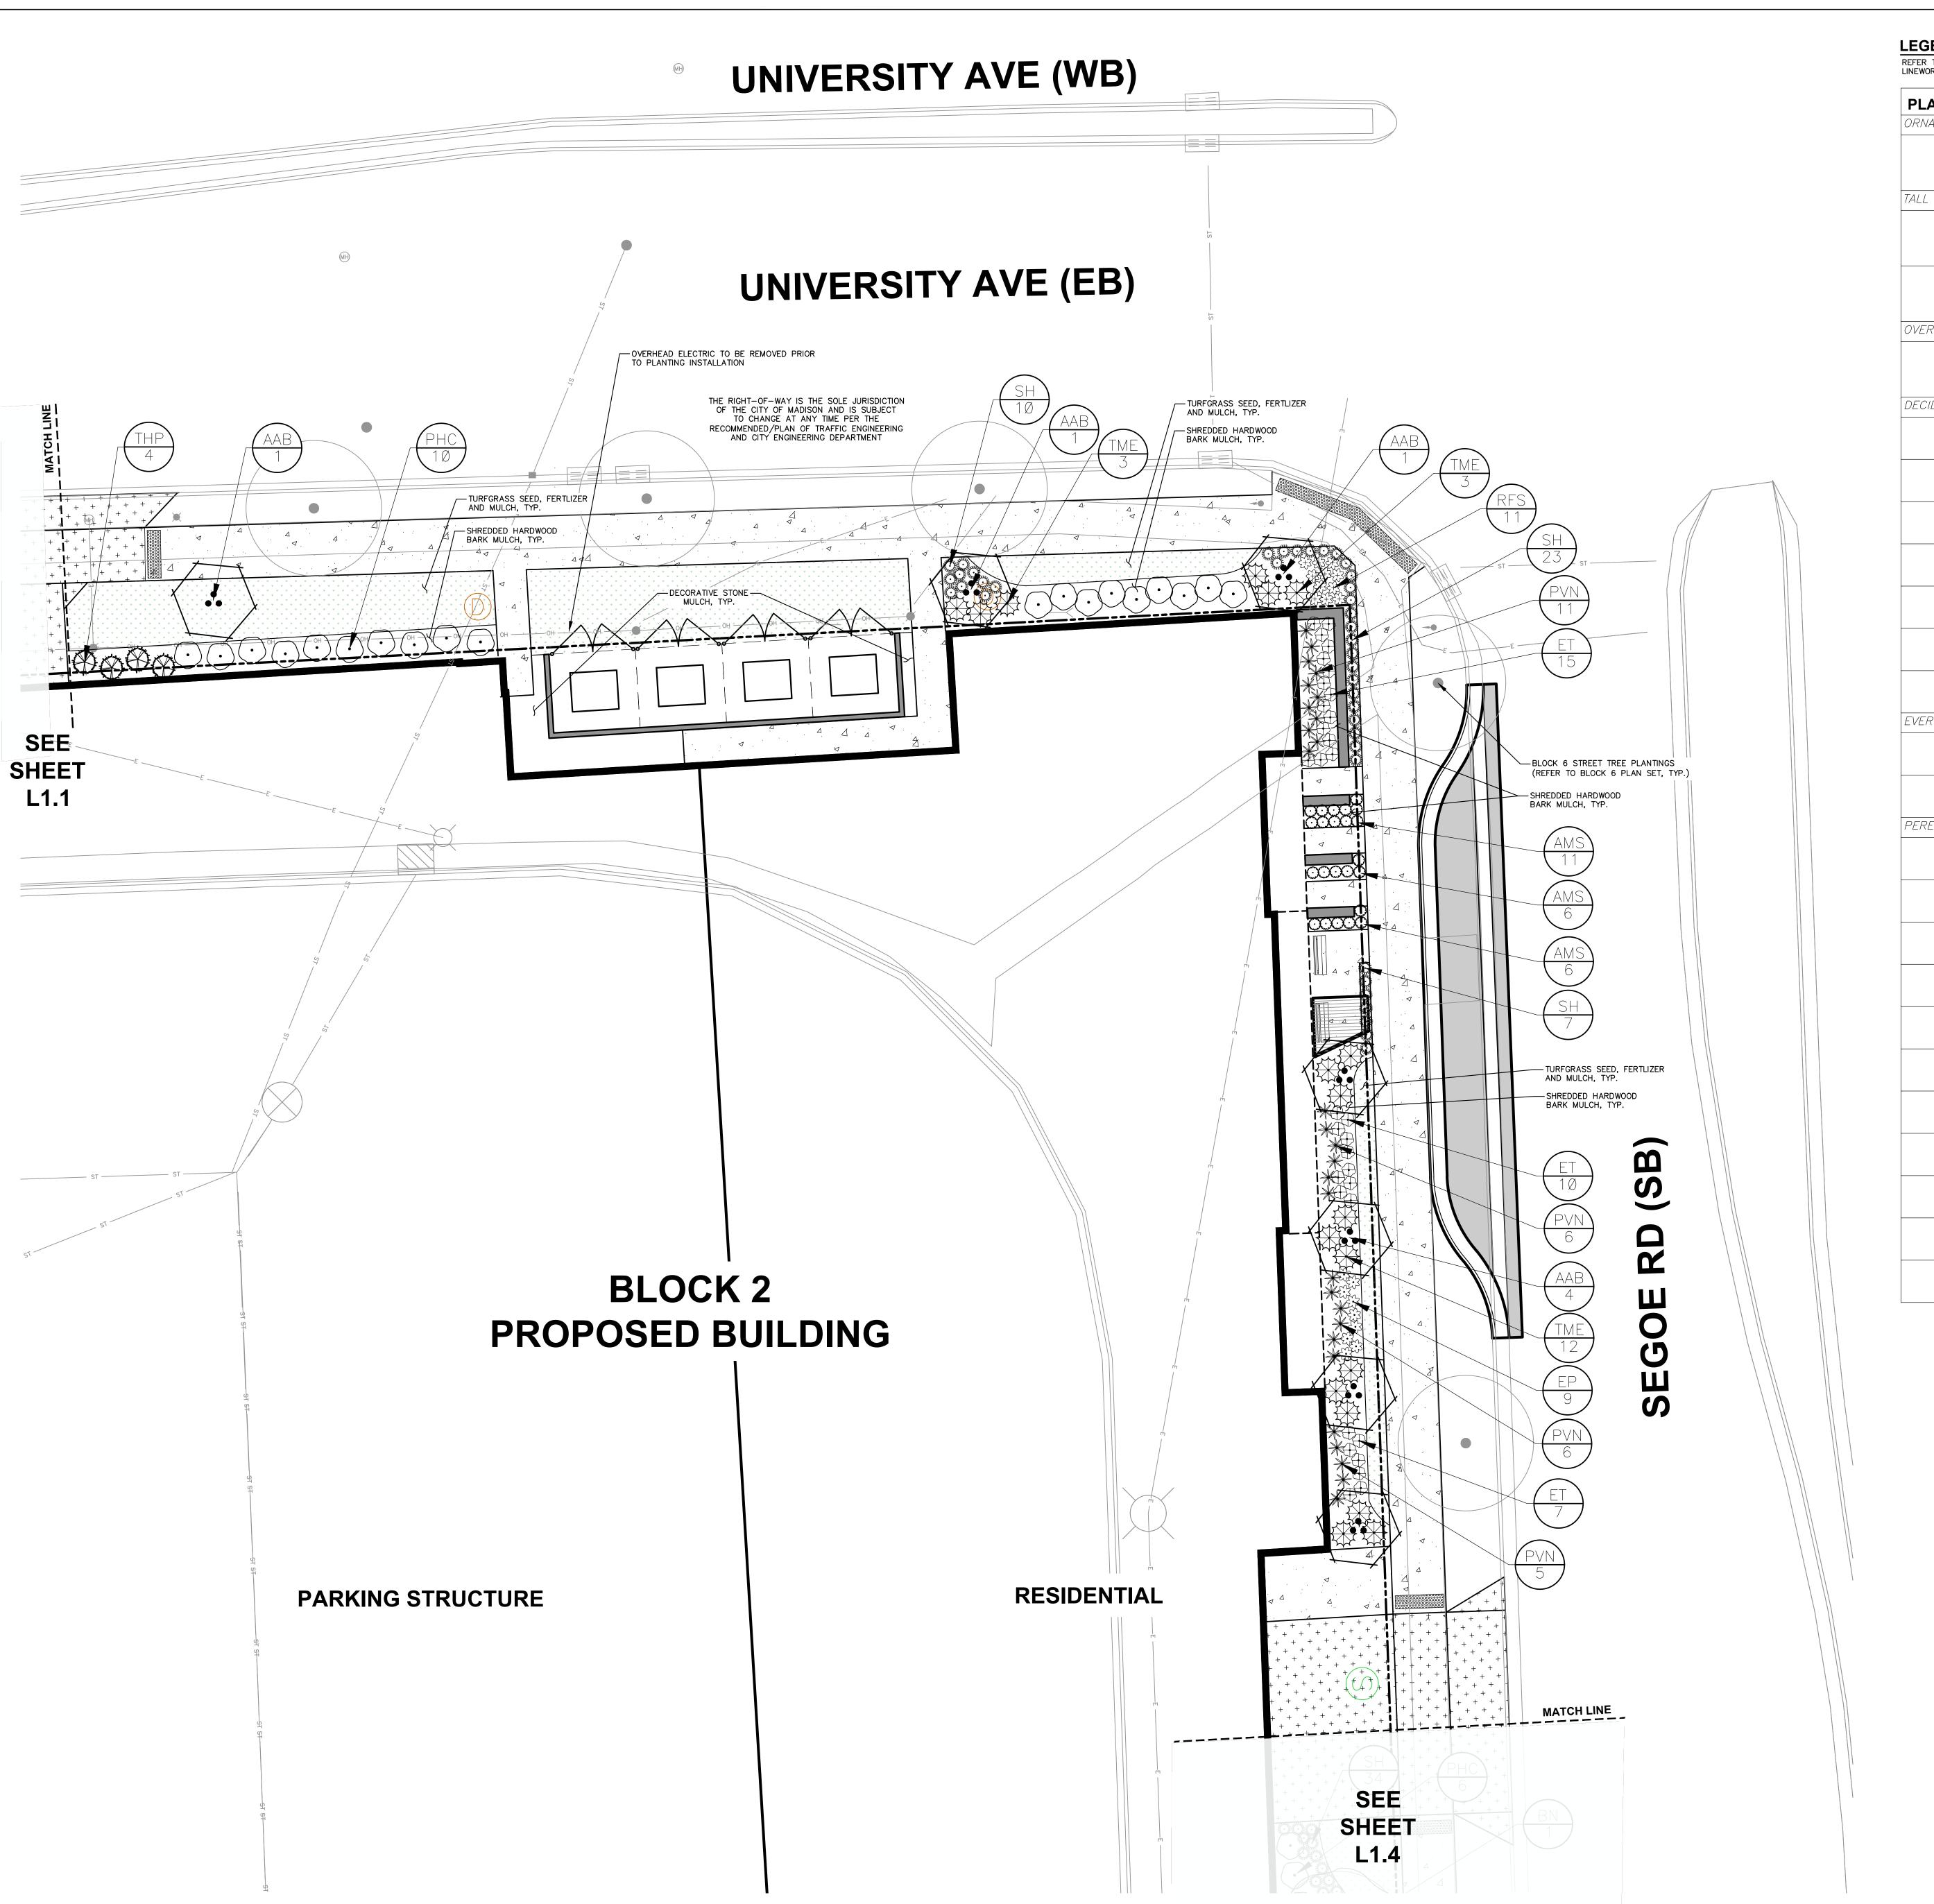

LEGEND

REFER TO SHEET B2-C0.1 NOTES AND LEGENDS FOR PLAN LINEWORK, HATCHING AND SYMBOL IDENTIFICATION

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TALL EVERGREEN TREE	CODE	BOTANICAL / COMMON NAME
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	THP	Thuja occidentalis 'Pyramidalis' / Pyramidalis Cedar
OVERSTORY DECIDUOUS TREE	CODE BN	BOTANICAL / COMMON NAME Betula nigra 'BNMTF' TM / Dura Heat River Birch
DECIDUOUS SHRUBS	CODE	BOTANICAL / COMMON NAME
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*	PVN	Panicum virgatum 'North Wind' / Northwind Switch Grass
33300 O O O O O O O O O O O O O O O O O	PVS	Panicum virgatum 'Shenandoah' / Switch Grass
£ +3	RFS	Rudbeckia fulgida speciosa / Showy Coneflower
•	SNC	Salvia nemorosa 'Caradonna' / Cardonna Perennial Salvia
WHILE S. E	SH	Sporobolus heterolepis 'Tara' / Prairie



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161 HORIZON DRIVE, SUITE 101

VERONA, WISCONSIN 53593 P. 608.848.5060


SMITH Giban

241 N. BROADWAY, SUITE 400 MILWAUKEE, WI 53202

MADISON YARDS AT HILL FARMS BLOCK 2

PROJECT LOCATION:
701 GARDENER ROAD
MADISON, WI 53705

SHEET TITLE:
BLOCK 2
DETAILED LANDSCAPE
PLAN - NORTHEAST

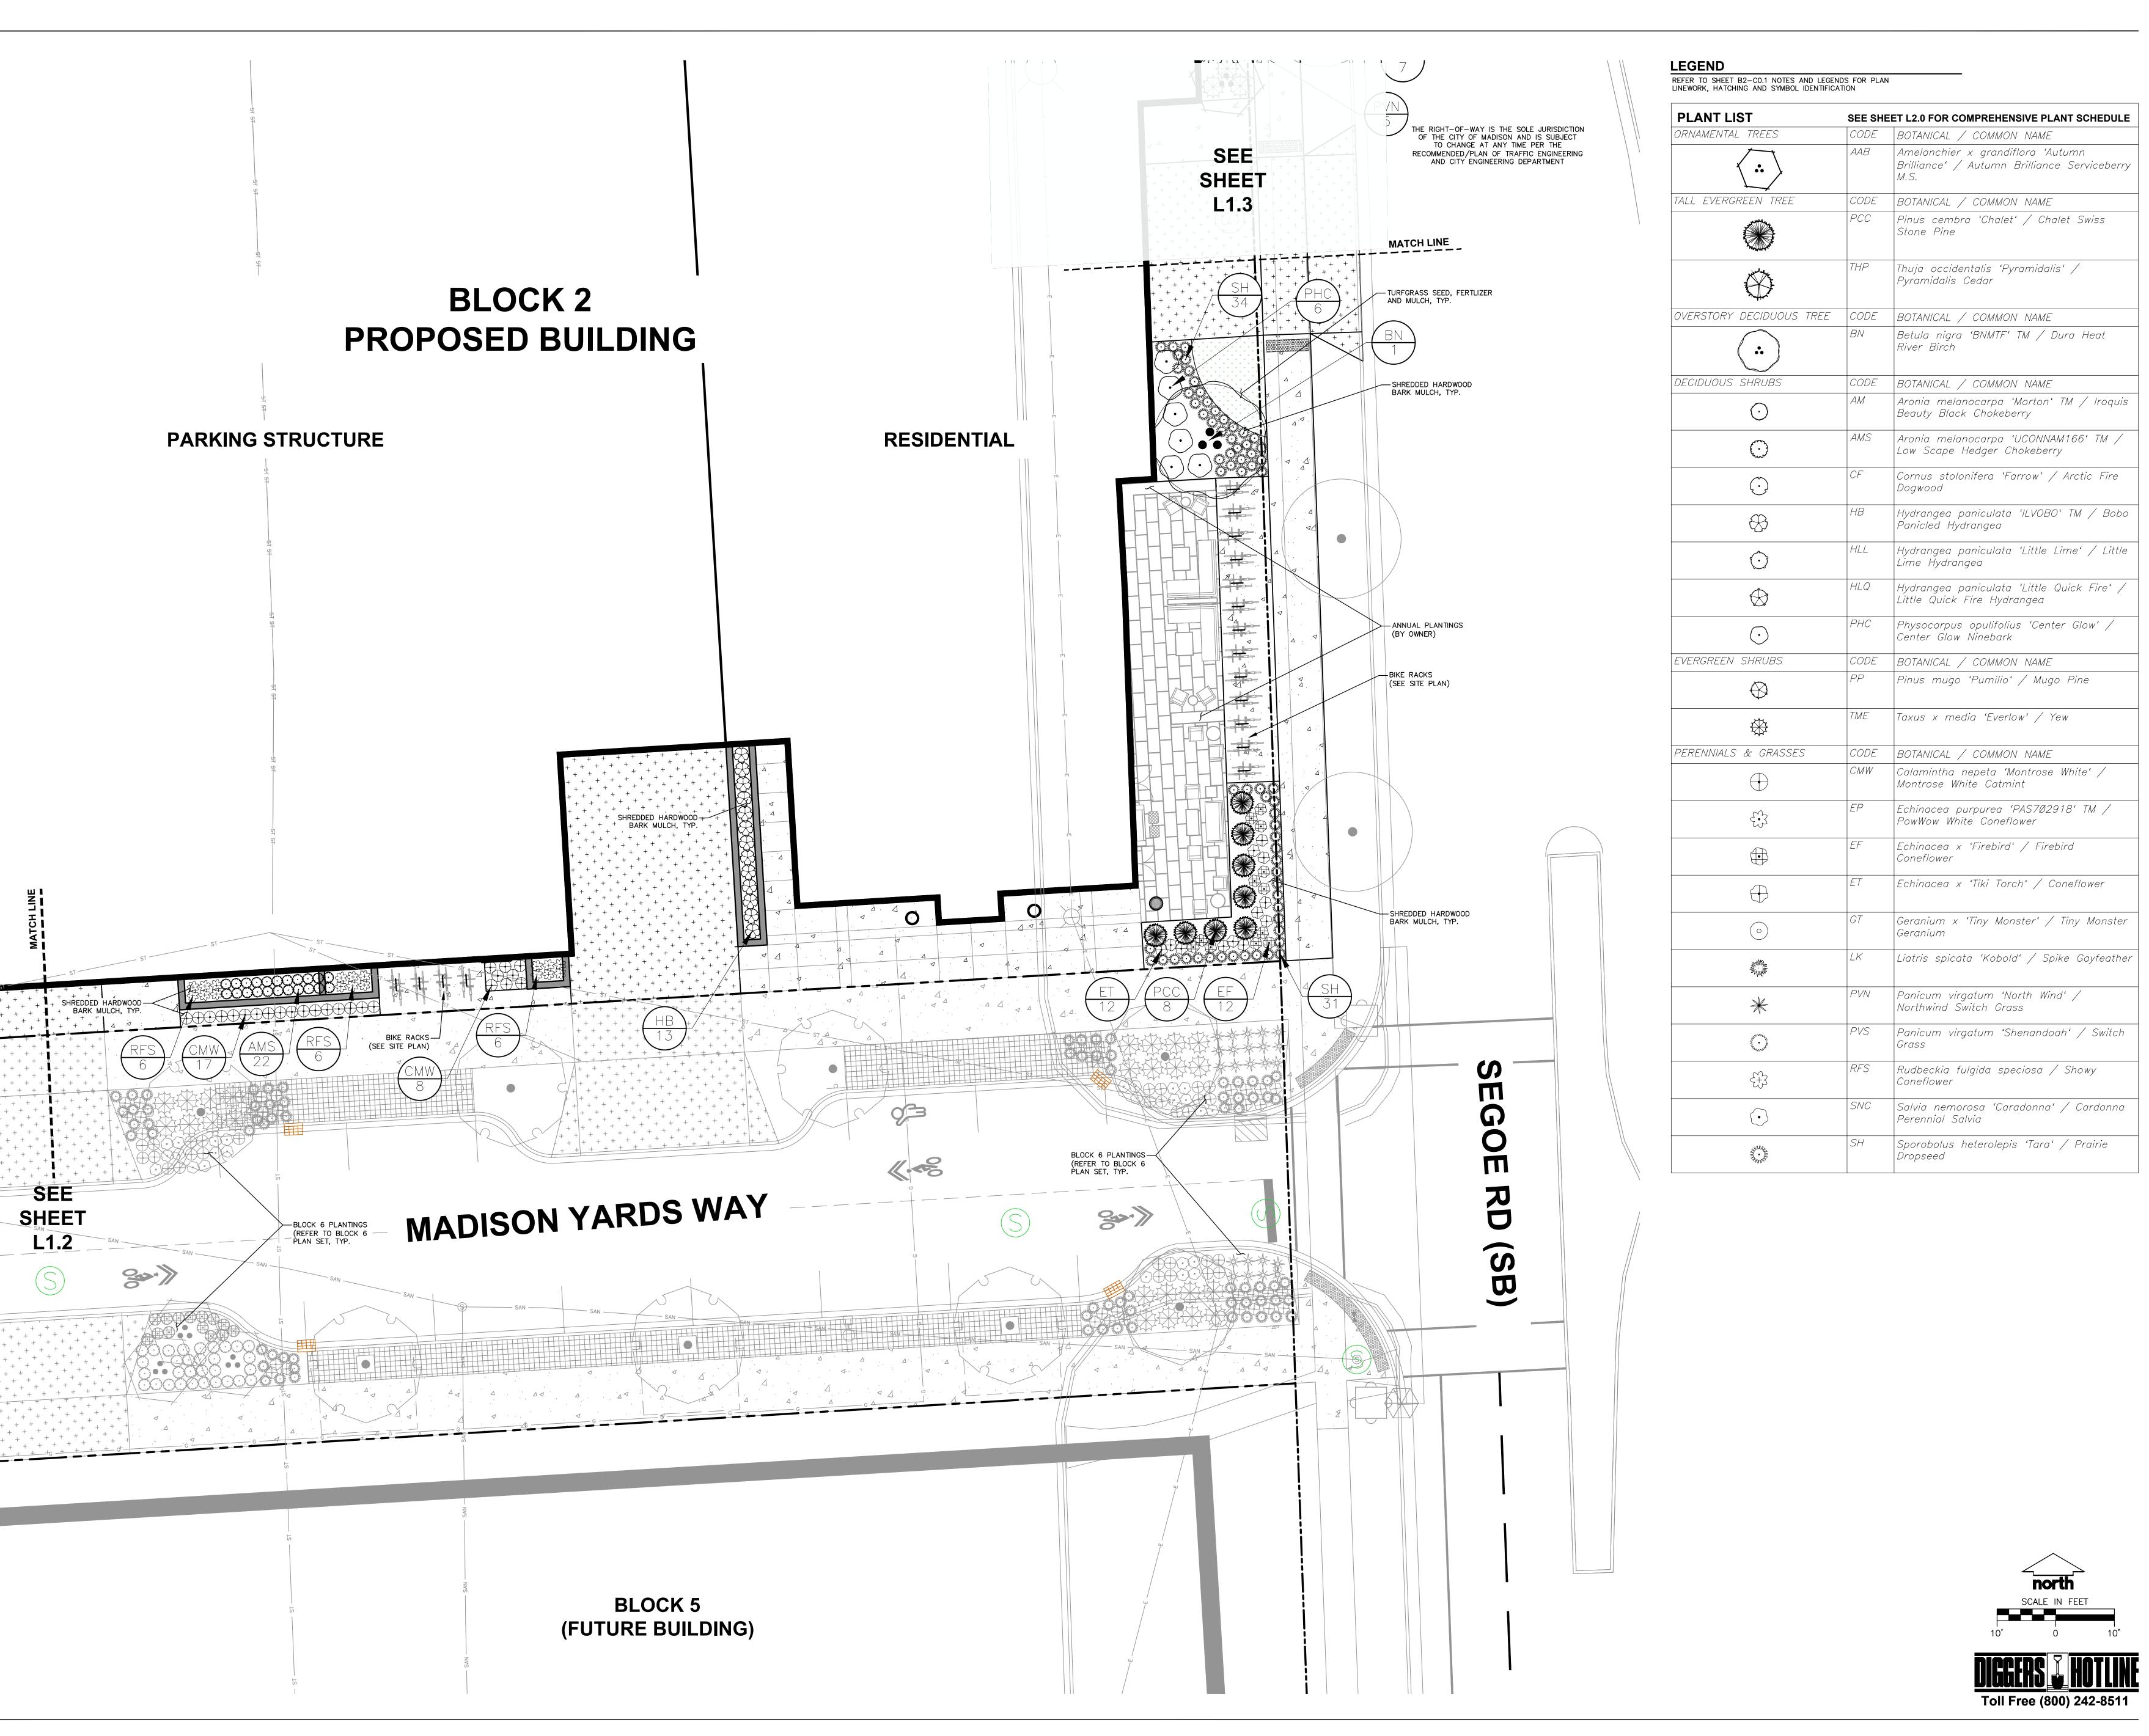



CREATE THE VISION TELL THE STORY

MADISON █ MILWAUKEE █ WAUSAU APPLETON █ KENOSHA █ CHICAGO COEUR D'ALENE

MADISON REGIONAL OFFICE 161 HORIZON DRIVE, SUITE 101 VERONA, WISCONSIN 53593 P. 608.848.5060

SMITH Giban

241 N. BROADWAY, SUITE 400 MILWAUKEE, WI 53202


MADISON YARDS AT HILL FARMS BLOCK 2

PROJECT LOCATION: 701 GARDENER ROAD MADISON, WI 53705

> **REVIEW DRAWING** NOT TO BE USED FOR CONSTRUCTION

WHOLE FOODS DD SUBMITTAL 11.18.2020 LAND USE - UDC RESUBMITTAL

SHEET TITLE:
BLOCK 2
DETAILED LANDSCAPE
PLAN - SOUTHEAST

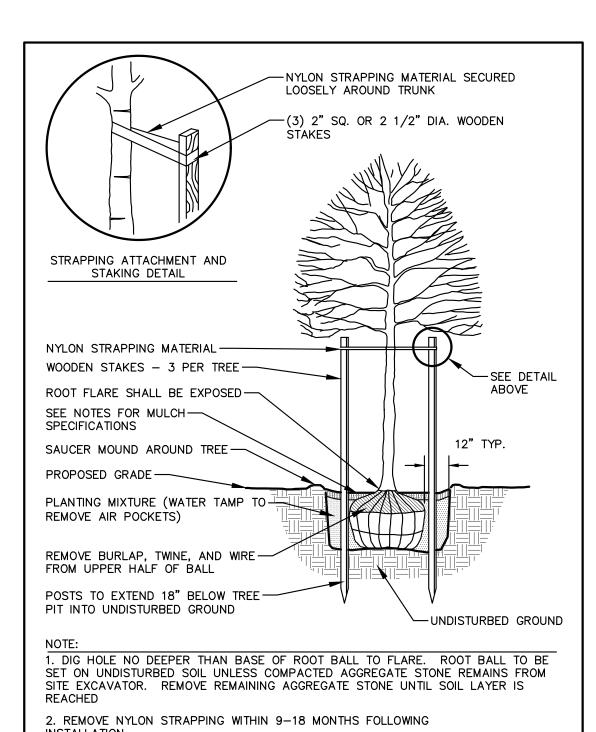


DECIDUOUS TREE PLANTING DETAIL

SEE NOTES FOR MULCH-SPECIFICATIONS SAUCER MOUND AROUND SHRUB-PROPOSED GRADE -REMOVE BURLAP, TWINE AND WIRE FROM UPPER HALF OF BALL PLANTING MIXTURE (WATER TAMP REMOVE AIR POCKETS)


SHRUB PLANTING DETAIL

. ROOT FLARE TO BE EXPOSED.

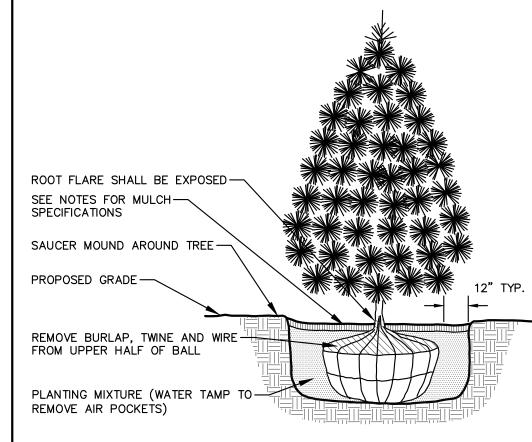


. DIG HOLE NO DEEPER THAN BASE OF ROOT BALL TO FLARE. ROOT BALL TO BE SET ON UNDISTURBED SOIL UNLESS COMPACTED AGGREGATE STONE REMAINS FROM SITE EXCAVATOR. REMOVE REMAINING AGGREGATE STONE UNTIL SOIL LAYER IS

EVERGREEN TREE PLANTING DETAIL

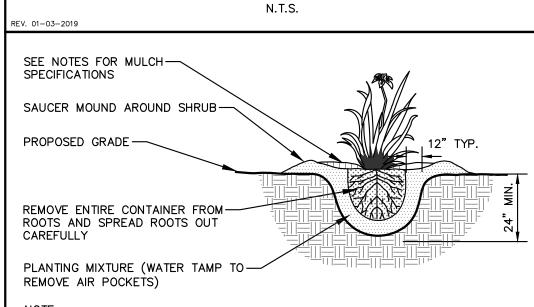

PERENNIAL/ORNAMENTAL GRASS **PLANTING DETAIL**

1. ROOT FLARE TO BE EXPOSED

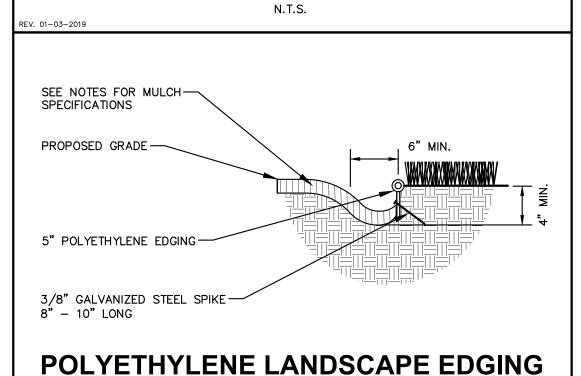

DETAIL



Project Location /	Address 701 GARDENER ROA	D
Name of Project	MADISON YARDS AT HILL FAF	RMS - BLOCK 2
Owner / Contact	KEVIN YESKA - JSD PROFESS	SIONAL SERVICES
Contact Phone 60	08-848-5060	Contact Email KEVIN.YESKA@JSDINC.COM

** Landscape plans for zoning lots greater than ten thousand (10,000) square feet in size MUST be prepared by a registered landscape architect. **

The following standards apply to all exterior construction and development activity, including the expansion of existing buildings, structures and parking lots, except the construction of detached single-family and two-family dwellings and their accessory structures. The entire development site must be brought up to compliance with this section unless all of the following conditions apply, in which case only the affected areas need to be brought up to compliance:

- (a) The area of site disturbance is less than ten percent (10%) of the entire development site during any ten-(10)
- (b) Gross floor area is only increased by ten percent (10%) during any ten-(10) year period.
- (c) No demolition of a principal building is involved. (d) Any displaced landscaping elements must be replaced on the site and shown on a revised landscaping plan.

Landscape Calculations and Distribution

Required landscaped areas shall be calculated based upon the total developed area of the property. Developed area is defined as that area within a single contiguous boundary which is made up of structures, parking, driveways and docking/loading facilities, but excluding the area of any building footprint at grade, land designated for open space uses such as athletic fields, and undeveloped land area on the same zoning lot. There are three methods for calculating landscape points depending on the size of the lot and Zoning District.

(a) For all lots except those described in (b) and (c) below, five (5) landscape points shall be provided for each three hundred (300) square feet of developed area.

Total square footage of developed area	3,505 SF
Total landscape points required	58 POINTS

(b) For lots larger than five (5) acres, points shall be provided at five (5) points per three hundred (300) square feet for the first five (5) developed acres, and one (1) point per one hundred (100) square feet for all additional

actes.	
Total square footage of developed area	
Five (5) acres = $\underline{217,800}$ square feet	
First five (5) developed acres = $3,630 \text{ points}$	
Remainder of developed area	
Total landscape points required	

(c) For the Industrial – Limited (IL) and Industrial – General (IG) districts, one (1) point shall be provided per one hundred (100) square feet of developed area.

Total square footage of developed area	_
Total landscape points required	_

Tabulation of Points and Credits

Use the table to indicate the quantity and points for all existing and proposed landscape elements.

Dlant Towns / Electrical	Minimum Size at Installation	Points	Credits/ Existing Landscaping		New/ Proposed Landscaping	
Plant Type/ Element			Quantity	Points Achieved	Quantity	Points Achieved
Overstory deciduous tree	2½ inch caliper measured diameter at breast height (dbh)	35			1	35
Tall evergreen tree (i.e. pine, spruce)	5-6 feet tall	35				
Ornamental tree	1 1/2 inch caliper	15			11	165
Upright evergreen shrub (i.e. arborvitae)	3-4 feet tall	10			34	340
Shrub, deciduous	#3 gallon container size, Min. 12"-24"	3			152	456
Shrub, evergreen	#3 gallon container size, Min. 12"-24"	4			44	176
Ornamental grasses/ perennials	#1 gallon container size, Min. 8"-18"	2			554	1,108
Ornamental/ decorative fencing or wall	n/a	4 per 10 lineal ft.				
Existing significant specimen tree	Minimum size: 2 ½ inch caliper dbh. *Trees must be within developed area and cannot comprise more than 30% of total required points.	14 per caliper inch dbh. Maximum points per tree: 200				
Landscape furniture for public seating and/or transit connections	* Furniture must be within developed area, publically accessible, and cannot comprise more than 5% of total required points.	5 points per "seat"				
Sub Totals						2,280

Total Number of Points Provided 2,280

* As determined by ANSI, ANLA- American standards for nursery stock. For each size, minimum plant sizes shall conform to the specifications as stated in the current American Standard for Nursery Stock.

(•)

ANOTHER STATES

COMPREHENSIVE PLANT SCHEDULE ORNAMENTAL TREES CODE BOTANICAL / COMMON NAME LS POINTS QTY Amelanchier x grandiflora 'Autumn Brilliance' / Autumn $B \& B \mid 1.5$ " min. cal. Brilliance Serviceberry M.S. TALL EVERGREEN TREE |CODE |BOTANICAL / COMMON NAME LS POINTS QTY B & B | 5' Min Ht. Pinus cembra 'Chalet' / Chalet Swiss Stone Pine B & B | 5' Min Ht.Thuja occidentalis 'Pyramidalis' / Pyramidalis Cedar OVERSTORY DECIDUOUS TREE | CODE | BOTANICAL / COMMON NAME LS POINTS |QT) Betula nigra 'BNMTF' TM / Dura Heat River Birch B & B 2.5" min. cal. •• DECIDUOUS SHRUBS CODE BOTANICAL / COMMON NAME S POINTS QTY Aronia melanocarpa 'Morton' TM / Iroquis Beauty Black 8 gal | Min. 12"-24" Chokeberrv | Aronia melanocarpa 'UCONNAM166' TM / Low Scape 3 gal | Min. 12"-24" Hedger Chokeberry Cornus stolonifera 'Farrow' / Arctic Fire Dogwood 3 gal | Min. 12"-24" | Hydrangea paniculata 'ILVOBO' TM / Bobo Panicled gal Min. 12"-24" \otimes 3 gal | Min. 12"-24" Hydrangea paniculata 'Little Lime' / Little Lime | Hydrangea paniculata 'Little Quick Fire' / Little Quick Fire | 3 gal | Min. 12"-24" Physocarpus opulifolius 'Center Glow' / Center Glow 3 gal | Min. 12"-24" EVERGREEN SHRUBS S POINTS QTY CODE BOTANICAL / COMMON NAME |Pinus mugo 'Pumilio' / Mugo Pine gal | Min. 12"-24" Taxus x media 'Everlow' / Yew gal | Min. 12"-24" PERENNIALS & GRASSES LS POINTS QTY | CODE | BOTANICAL / COMMON NAME Gal Min. 8"-18" Calamintha nepeta 'Montrose White' / Montrose White Echinacea purpurea 'PAS7Ø2918' TM / PowWow White Gal | Min. 8"-18" Echinacea x 'Firebird' / Firebird Coneflower Gal | Min. 8"-18" | Echinacea x 'Tiki Torch' / Coneflower Gal Min. 8"-18" Gal Min. 8"-18" | Geranium x 'Tiny Monster' / Tiny Monster Geranium ' Gal | Min. 8"−18" |Liatris spicata 'Kobold' / Spike Gayfeather Eduna E | PVN | Panicum virgatum 'North Wind' / Northwind Switch Grass | 1 Gal | Min. 8"-18" |PVS | Panicum virgatum 'Shenandoah' / Switch Grass ' Gal | Min. 8"-18" Gal | Min. 8"-18" |RFS | Rudbeckia fulgida speciosa / Showy Coneflower

SNC | Salvia nemorosa 'Caradonna' / Cardonna Perennial Salvia | 1 Gal | Min. 8" – 18"

Sporobolus heterolepis 'Tara' / Prairie Dropseed

Gal | Min. 8"-18"

GENERAL NOTES

PLANTING OPERATIONS TO LANDSCAPE ARCHITECT

- . REFER TO THE EXISTING CONDITIONS SURVEY FOR EXISTING CONDITIONS NOTES AND LEGEND.
- JSD SHALL BE HELD HARMLESS AND DOES NOT WARRANT ANY DEVIATIONS BY THE OWNER/CONTRACTOR FROM THE APPROVED CONSTRUCTION PLANS THAT MAY RESULT IN DISCIPLINARY ACTIONS BY ANY OR ALL REGULATORY AGENCIES.
- 3. THE LANDSCAPE CONTRACTOR SHALL COORDINATE ALL FINE GRADING AND TOPSOILING WITH GENERAL CONTRACTOR CONTRACTOR SHALL REVIEW SITE CONDITIONS FOR UTILITY CONFLICTS, DRAINAGE ISSUES, SUBSURFACE ROCK, AND PLANT PLACEMENT CONFLICTS PRIOR TO PLANT INSTALLATION. REPORT ANY CONDITIONS THAT MAY HAVE ADVERSE IMPACT ON
- 5. DO NOT COMMENCE PLANTING OPERATIONS UNTIL ALL ADJACENT SITE IMPROVEMENTS, IRRIGATION INSTALLATION, AND FINISH GRADING ARE COMPLETE
- GENERAL: ALL WORK IN THE R-O-W AND PUBLIC EASEMENTS SHALL BE IN ACCORDANCE WITH LOCAL MUNICIPAL REQUIREMENTS. JSD SHALL BE HELD HARMLESS AND DOES NOT WARRANT ANY DEVIATIONS BY THE OWNER/CONTRACTOR FROM THE APPROVED CONSTRUCTION PLANS THAT MAY RESULT IN DISCIPLINARY ACTIONS BY ANY OR ALL REGULATORY AGENCIES. LOCATE ALL UTILITIES PRIOR TO CONSTRUCTION. THE CONTRACTOR IS RESPONSIBLE FOR REPAIRING ANY DAMAGE DONE TO UTILITIES. CONTRACTOR MUST CALL 1-800-242-8511 FOR UTILITY LOCATIONS AT LEAST THREE DAYS DIGGING. HAND DIG AND INSTALL ALL PLANTS THAT ARE NEAR EXISTING UTILITIES. PROTECT PREVIOUSLY INSTALLED WORK OF OTHER TRADES. CONTRACTOR IS RESPONSIBLE FOR STAKING THE PLANT MATERIALS FOR REVIEW BY OWNER PRIOR TO DIGGING AND PLACEMENT AND SHALL COORDINATE ALL FINE GRADING AND RESTORATION WITH THE
- DELIVERY AND HANDLING: DO NOT DELIVER MORE PLANT MATERIALS THAN CAN BE PLANTED IN ONE DAY, UNLESS ADEQUATE, APPROPRIATE AND SECURE STORAGE IS PROVIDED AND APPROVED BY OWNER'S REPRESENTATIVE. AT ALL TIMES. PROTECT ALL PLANT MATERIALS FROM WIND AND DIRECT SUN. DELIVER PLANTS WITH LEGIBLE IDENTIFICATION LABELS. PROTECT PLANTS DURING DELIVERY AND DO NOT PRUNE PRIOR TO DELIVERY. ALL TREES AND SHRUBS SHALL BE PLANTED ON THE DAY OF DELIVERY; IF THIS IS NOT POSSIBLE, PROTECT THE PLANT MATERIALS NOT PLANTED BY STORING THEM IN A SHADED, SECURE AREA, PROTECTING THE ROOT MASS WITH WET SOIL, MULCH, HAY OR OTHER SUITABLE MEDIUM. CONTRACTOR TO KEEP ALL PLANT MATERIALS ADEQUATELY WATERED TO PREVENT ROOT DESICCATION. DO NOT REMOVE CONTAINER GROWN STOCK FROM CONTAINERS BEFORE TIME OF PLANTING. DO NOT PICK UP CONTAINER OR BALLED PLANTS BY STEM OR ROOTS. ALL PLANTS SHALL BE LIFTED AND HANDLED FROM THE BOTTOM OF THE CONTAINER OR BALL. PERFORM ACTUAL PLANTING ONLY WHEN WEATHER AND SOIL CONDITIONS ARE SUITABLE IN ACCORDANCE WITH LOCALLY ACCEPTED BEST HORTICULTURAL PRACTICES.
- MATERIALS PLANTS: ALL PLANTS SHALL CONFORM TO THE LATEST VERSION OF THE AMERICAN STANDARD FOR NURSERY STOCK ANSI Z60.1. PLANTS SHALL BE TRUE TO SPECIES AND VARIETY SPECIFIED AND NURSERY GROWN IN ACCORDANCE WITH GOOD HORTICULTURAL PRACTICES UNDER CLIMATIC CONDITIONS SIMILAR TO THOSE IN THE LOCALITY OF THE PROJECT FOR AT LEAST 2 YEARS. PLANTS SHALL BE FRESHLY DUG (DURING THE MOST RECENT FAVORABLE HARVEST SEASON). PLANTS SHALL BE SO TRAINED IN DEVELOPMENT AND APPEARANCE AS TO BE UNQUESTIONABLY SUPERIOR IN FORM. COMPACTNESS, AND SYMMETRY. PLANTS SHALL BE SOUND, HEALTHY, VIGOROUS, WELL BRANCHED AND DENSELY FOLIATED WHEN IN LEAF, AND FREE OF DISEASE AND INSECTS (ADULT EGGS, PUPAE OR LARVAE). THEY SHALL HAVE HEALTHY. WELL-DEVELOPED ROOT SYSTEMS AND SHALL BE FREE FROM PHYSICAL DAMAGE OR OTHER CONDITIONS THAT WOULD PREVENT THRIVING GROWTH OR PREMATURE MORTALITY. PLANTS SHALL BE OF THE HIGHEST QUALITY, POSSESS TYPICAL GROWTH HABITS AND FORM FOR THEIR SPECIES AND BE FREE OF INJURY. PARKWAY TREES AND PARKING LOT TREES SHALL HAVE A MINIMUM BRANCHING HEIGHT OF SIX (6) FEET ABOVE THE GROUND TO ALLOW ADEQUATE VISUAL AND PHYSICAL CLEARANCE.
- PRUNING: THE CONTRACTOR SHALL PRUNE ALL TREES AND REPAIR ANY INJURIES THAT OCCURRED DURING THE PLANTING PROCESS. DOUBLE LEADERS, DEAD BRANCHES, AND LIMBS DAMAGED OR BROKEN DURING THE PLANTING PROCESS, SHALL BE PRUNED. THIS SHALL BE THE ONLY PRUNING ALLOWED AT PLANTING. PRUNING SHALL CONFORM TO THE LATEST VERSION OF THE AMERICAN STANDARD FOR TREE CARE OPERATIONS, ANSI A300. PRUNE TREES IN ACCORDANCE WITH NAA GUIDELINES. DO NOT TOP TREES. PRUNE SHRUBS ACCORDING TO STANDARD HORTICULTURAL PRACTICES. ON CUTS OVER 3/4" IN DIAMETER AND BRUISES OR SCARS ON BARK, TRACE THE INJURED CAMBIUM LAYER BACK TO LIVING TISSUE AND REMOVE. SMOOTH AND SHAPE WOUNDS SO AS NOT TO RETAIN WATER. TREAT THE AREA WITH AN APPROVED INCONSPICUOUS LATEX BASED ANTISEPTIC TREE PAINT, IF PRUNING OCCURS "IN SEASON". DO NOT PRUNE ANY OAK TREES DURING THE MONTHS FROM APRIL TO OCTOBER.
- 10. CLEANUP: THE WORK AREA SHALL BE KEPT SAFE AND NEAT AT ALL TIMES. DISPOSED OF EXCESS SOIL. REMOVE ALL CUTTINGS AND WASTE MATERIALS. SOIL AND BRANCHES. BIND AND WRAP THESE MATERIALS, ANY REJECTED PLANTS, AND ANY OTHER DEBRIS RESULTING FROM ALL PLANTING TASKS AND PROMPTLY CLEAN UP AND REMOVE FROM THE PROJECT SITE. UNDER NO CIRCUMSTANCES SHALL THE ACCUMULATION OF SOIL, BRANCHES OR OTHER DEBRIS BE ALLOWED UPON A PUBLIC PROPERTY IN SUCH A MANNER AS TO RESULT IN A PUBLIC SAFETY HAZARD OR DAMAGE. LIKEWISE, UNDER NO CIRCUMSTANCES SHALL ANY DEBRIS OR INCIDENTAL MATERIALS BE ALLOWED UPON ADJACENT PRIVATE PROPERTY.
- 1. ANY SUBSTITUTIONS IN PLANT TYPE, LOCATION, OR SIZE SHALL BE APPROVED BY LANDSCAPE ARCHITECT PRIOR TO INSTALLATION.
- 12. CONTRACTOR TO VERIFY PLANT MATERIAL QUANTITIES AND SQUARE FOOTAGES. QUANTITIES SHOWN ON PLAN TAKE PRECEDENCE OVER THOSE ON SCHEDULE.

LANDSCAPE MATERIAL NOTES

MATERIALS — PLANTING MIXTURE: ALL HOLES EXCAVATED FOR TREES, SHRUBS, PERENNIALS AND ORNAMENTAL GRASSES SHALL BE BACKFILLED WITH TWO (2) PARTS TOPSOIL, ONE (1) PART SAND AND ONE (1) PART COMPOST. SOIL MIXTURE SHALL BE WELL BLENDED PRIOR TO INSTALLATION. LANDSCAPE CONTRACTOR SHALL CONFIRM EXCAVATION AND BACKFILLING SCHEDULE WITH SITE CONTRACTOR

- MATERIALS TOPSOIL: TOPSOIL TO BE CLEAN, FRIABLE LOAM FROM A LOCAL SOURCE, FREE FROM STONES OR DEBRIS OVER 3/4" IN DIAMETER, AND FREE FROM TOXINS OR OTHER DELETERIOUS MATERIALS. TOPSOIL SHALL HAVE A ph VALUE BETWEEN 6 AND 7. TOPSOIL AND PLANTING SOIL SHALL BE TESTED TO ENSURE CONFORMANCE WITH THESE SPECIFICATIONS AND SHALL BE AMENDED TO MEET THESE SPECIFICATIONS. PROVIDE TEST RESULTS TO OWNER'S REPRESENTATIVE PRIOR TO PLACEMENT. DO NOT PLACE FROZEN OR MUDDY TOPSOIL. APPLY SOIL AMENDMENTS TO ALL LANDSCAPE AREAS PER SOIL TEST.
- MATERIALS SHREDDED HARDWOOD BARK MULCH: ALL PLANTING AREAS LABELED ON PLAN SHALL RECEIVE CERTIFIED WEED FREE SHREDDED HARDWOOD BARK MULCH INSTALLED TO A MINIMUM AND CONSISTENT DEPTH OF 3-INCHES. SHREDDED HARDWOOD BARK MULCH SIZE & COLOR TO BE APPROVED BY OWNER'S REPRESENTATIVE PRIOR TO INSTALLATION. FERTILIZER SHALL BE IN ACCORDANCE WITH APPLICABLE LOCAL, COUNTY AND STATE REQUIREMENTS. SHREDDED HARDWOOD BARK MULCH AREAS SHALL NOT RECEIVE WOVEN WEED BARRIER FABRIC.
- MATERIALS DECORATIVE STONE MULCH: ALL PLANTING AREAS LABELED ON PLAN SHALL RECEIVE DECORATIVE STONE MULCH SPREAD TO A MINIMUM AND CONSISTENT DEPTH OF 3-INCHES. DECORATIVE STONE MULCH TYPE, SIZE & COLOR TO BE APPROVED BY OWNER'S REPRESENTATIVE PRIOR TO INSTALLATION. FERTILIZER SHALL BE IN ACCORDANCE WITH APPLICABLE LOCAL, COUNTY AND STATE REQUIREMENTS. STONE MULCH AREAS SHALL RECEIVE WOVEN WEED BARRIER FABRIC. NO PLASTIC/IMPERVIOUS BARRIERS WILL BE PERMITTED. EXAMPLE: BLACK VISQUEEN
- MATERIALS TREE & SHRUB RINGS: ALL TREES AND/OR SHRUBS PLANTED IN SEEDED LAWN AREAS TO BE INSTALLED WITH A MINIMUM 4' DIAMETER SHREDDED HARDWOOD BARK MULCH TREE RING SPREAD TO A CONSISTENT DEPTH OF 3-INCHES. ALL TREE RINGS SHOULD BE INSTALLED WITH A 5" DEPTH SHOVEL CUT EDGE, ANGLED 45 DEGREES INTO SOIL AT A 5' DIAMETER ABOUT THE CENTER OF THE TREE PLANTING. A PRE-EMERGENT GRANULAR HERBICIDE WEED-PREVENTER SHOULD BE MIXED WITH MULCH USED TO INSTALL TREE RING AS WELL AS TOPICALLY APPLIED TO COMPLETED INSTALLATION OF TREE RING.
- MATERIALS POLYETHYLENE EDGING: EDGING SHALL BE 5" DEEP, POLYETHYLENE EDGING. OWNER'S REPRESENTATIVE SHALL APPROVE PRODUCT SPECIFICATION PROVIDED BY LANDSCAPE CONTRACTOR.
- MATERIALS TREE PROTECTION: ALL TREES TO BE INSTALLED WITH LDPE TREE GUARDS AS MANUFACTURED BY A.M. LEONARD HORTICULTURAL TOOL & SUPPLY CO., OR APPROVED EQUAL.
- 8. TREE WATERING PROGRAM: BASE BID WATERING OF ALL TREES ON A REGULAR WEEKLY BASIS. CONTRACTOR TO KEEP A LOG OR JOURNAL OF A RECORD OF DATES AND QUANTITIES OF SUPPLEMENTAL WATERING EFFORTS ALTERNATE BID 1* - INSTALLATION OF ONE (1) WATERING BAG PER TREE. DOCUMENTATION OF WEEKLY WATERING PROGRAM REQUIREDMATERIALS — (ALTERNATE 1): TREE WATERING BAGS: ALL TREES TO BE INSTALLED WITH ONE (1) WATER BAG. PRODUCT TO BE "TREE GATOR ORIGINAL SLOW RELEASE WATERING BAG," PRODUCT NO. 98183-R OR APPROVED EQUAL. INSTALL IN ACCORDANCE WITH MANUFACTURER'S RECOMMENDATIONS.

SEEDING NOTES

MATERIALS - TURFGRASS SEED: DISTURBED LAWN AREAS LABELED ON PLAN AS SUCH, SHALL RECEIVE 6" OF TOPSOIL AND EARTH CARPET'S "MADISON PARKS" GRASS SEED, OR EQUIVALENT AS APPROVED BY THE OWNER'S REPRESENTATIVE, INSTALLED PER MANUFACTURER'S RECOMMENDATIONS. IN ADDITION TO TURFGRASS SEED, ANNUAL RYE SHALL BE APPLIED TO ALL DISTURBED AREAS AT A RATE OF 1 1/2 LBS PER 1000 SQUARE FEET. FERTILIZE AND MULCH PER MANUFACTURER'S RECOMMENDATIONS. MULCH SHALL BE CERTIFIED NOXIOUS WEED SEED-FREE.

CONTRACTOR AND OWNER RESPONSIBILITY NOTES

- GUARANTEE: THE CONTRACTOR SHALL GUARANTEE ALL PLANTS THROUGH ONE (1) YEAR AFTER ACCEPTANCE BY THE OWNER'S REPRESENTATIVE. PLANTS SHALL BE ALIVE AND IN HEALTHY AND FLOURISHING CONDITION AT THE END OF THE GUARANTEE PERIOD. THE CONTRACTOR SHALL REPLACE (AT NO COST TO OWNER) ANY PLANTS THAT ARE DEAD OR NOT IN A VIGOROUS THRIVING CONDITION. REPLACEMENT PLANTS SHALL BE OF THE SAME KIND AND SIZE AS ORIGINALLY SPECIFIED UNLESS OTHERWISE DIRECTED BY OWNER'S REPRESENTATIVE. RESTORE BEDS AS NECESSARY FOLLOWING PLANT REPLACEMENT, INCLUDING BUT NOT LIMITED TO BEDDING, EDGING, MULCH, ETC. REPLACE PLANTS DAMAGED AT TIME OF PLANTING. REPAIR AREAS DISTURBED IN ANY WAY DURING PLANT REPLACEMENT AT NO COST TO OWNER. CONTRACTOR SHALL PROVIDE A ONE (1)-YEAR STRAIGHTENING GUARANTEE FOR ALL TREES.
- CONTRACTOR IS RESPONSIBLE FOR STAKING THE PLANT MATERIALS FOR REVIEW BY OWNER'S REPRESENTATIVE PRIOR TO DIGGING AND PLACEMENT AND SHALL COORDINATE ALL FINE GRADING AND RESTORATION WITH THE GRADING CONTRACTOR.
- MAINTENANCE: (CONTRACTOR) FOR ALL PLANTINGS. SEEDED AND/OR SODDED LAWN AREAS: THE CONTRACTOR SHALL MAINTAIN ALL PLANTINGS AND LAWN AREAS FOR A MINIMUM TIME PERIOD OF 60 DAYS, UNTIL FINAL ACCEPTANCE BY OWNER'S REPRESENTATIVE. THE CONTRACTOR IS RESPONSIBLE FOR ADEQUATELY WATERING PLANTS AND LAWN/TURFGRASS DURING THI 60 DAY ESTABLISHMENT PERIOD. CONTRACTOR IS RESPONSIBLE FOR THE ESTABLISHMENT OF HEALTHY VIGOROUS PLANT MATERIALS AND LAWN/TURFGRASS GROWTH. CONTRACTOR IS ALSO RESPONSIBLE FOR ANY PRUNING OF PLANT MATERIALS, AND SHAPING AND/OR REPLACEMENT OR SUPPLEMENT OF DEFICIENT SHREDDED HARDWOOD BARK MULCH DURING THIS PERIOD. LONG TERM PLANT MATERIALS AND LAWN/TURFGRASS MAINTENANCE AND ANY PROGRAM FOR SUCH IS THE RESPONSIBILITY OF THE OWNER. ALL PLANTINGS AND LAWN/TURFGRASS AREAS SHALL BE MAINTAINED IN A MANICURED CONDITION UNTIL THE TIME WHEN THE OWNER'S ACCEPTANCE IS GIVEN.
- MAINTENANCE: (OWNER) THE OWNER IS RESPONSIBLE FOR THE CONTINUED MAINTENANCE, REPAIR AND REPLACEMENT OF ALL LANDSCAPING MATERIALS AND WEED BARRIER FABRIC AS NECESSARY FOLLOWING THE ONE (1) YEAR CONTRACTOR GUARANTEE



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MADISON REGIONAL OFFICE 161 HORIZON DRIVE, SUITE 101 VERONA, WISCONSIN 53593 P. 608.848.5060

SMITH G 📆

CLIENT ADDRESS: 241 N. BROADWAY, SUITE 400 **MILWAUKEE, WI 53202**

MADISON YARDS AT HILL FARMS BLOCK 2

PROJECT LOCATION: 701 GARDENER ROAD MADISON, WI 53705

> REVIEW DRAWING **NOT TO BE USED** FOR CONSTRUCTION

PLAN MODIFICATIONS:

Date:	Description:
01.24.2020	WHOLE FOODS DD SUBMITT
02.28.2020	GMP SET
11.18.2020	LAND USE - UDC RESUBMITT

BLOCK 2 LANDSCAPE DETAILS &

GMP/SIP PACKAGE

MADISON YARDS: BLOCK 2 - GROCER BASE CORE & SHELL

UNIVERSITY AVENUE AT GARDNER ROAD

Kahler Slater

SMITH Gilbane

MADISON YARDS HILL FARMS

KAHLER SLATER PROJECT: 219143.00 NOVEMBER 17, 2020



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A1-A11	1ST FLOOR PLAN		
A1-A12	2ND FLOOR PLAN		
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NOVEMBER 17, 2020

MADISON YARDS: BLOCK 2 - GROCER **BASE CORE & SHELL**

219143.00

Sheet Title

COVER SHEET

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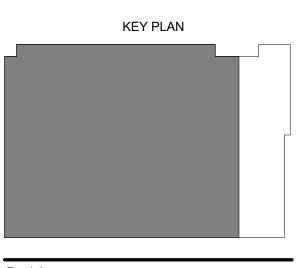
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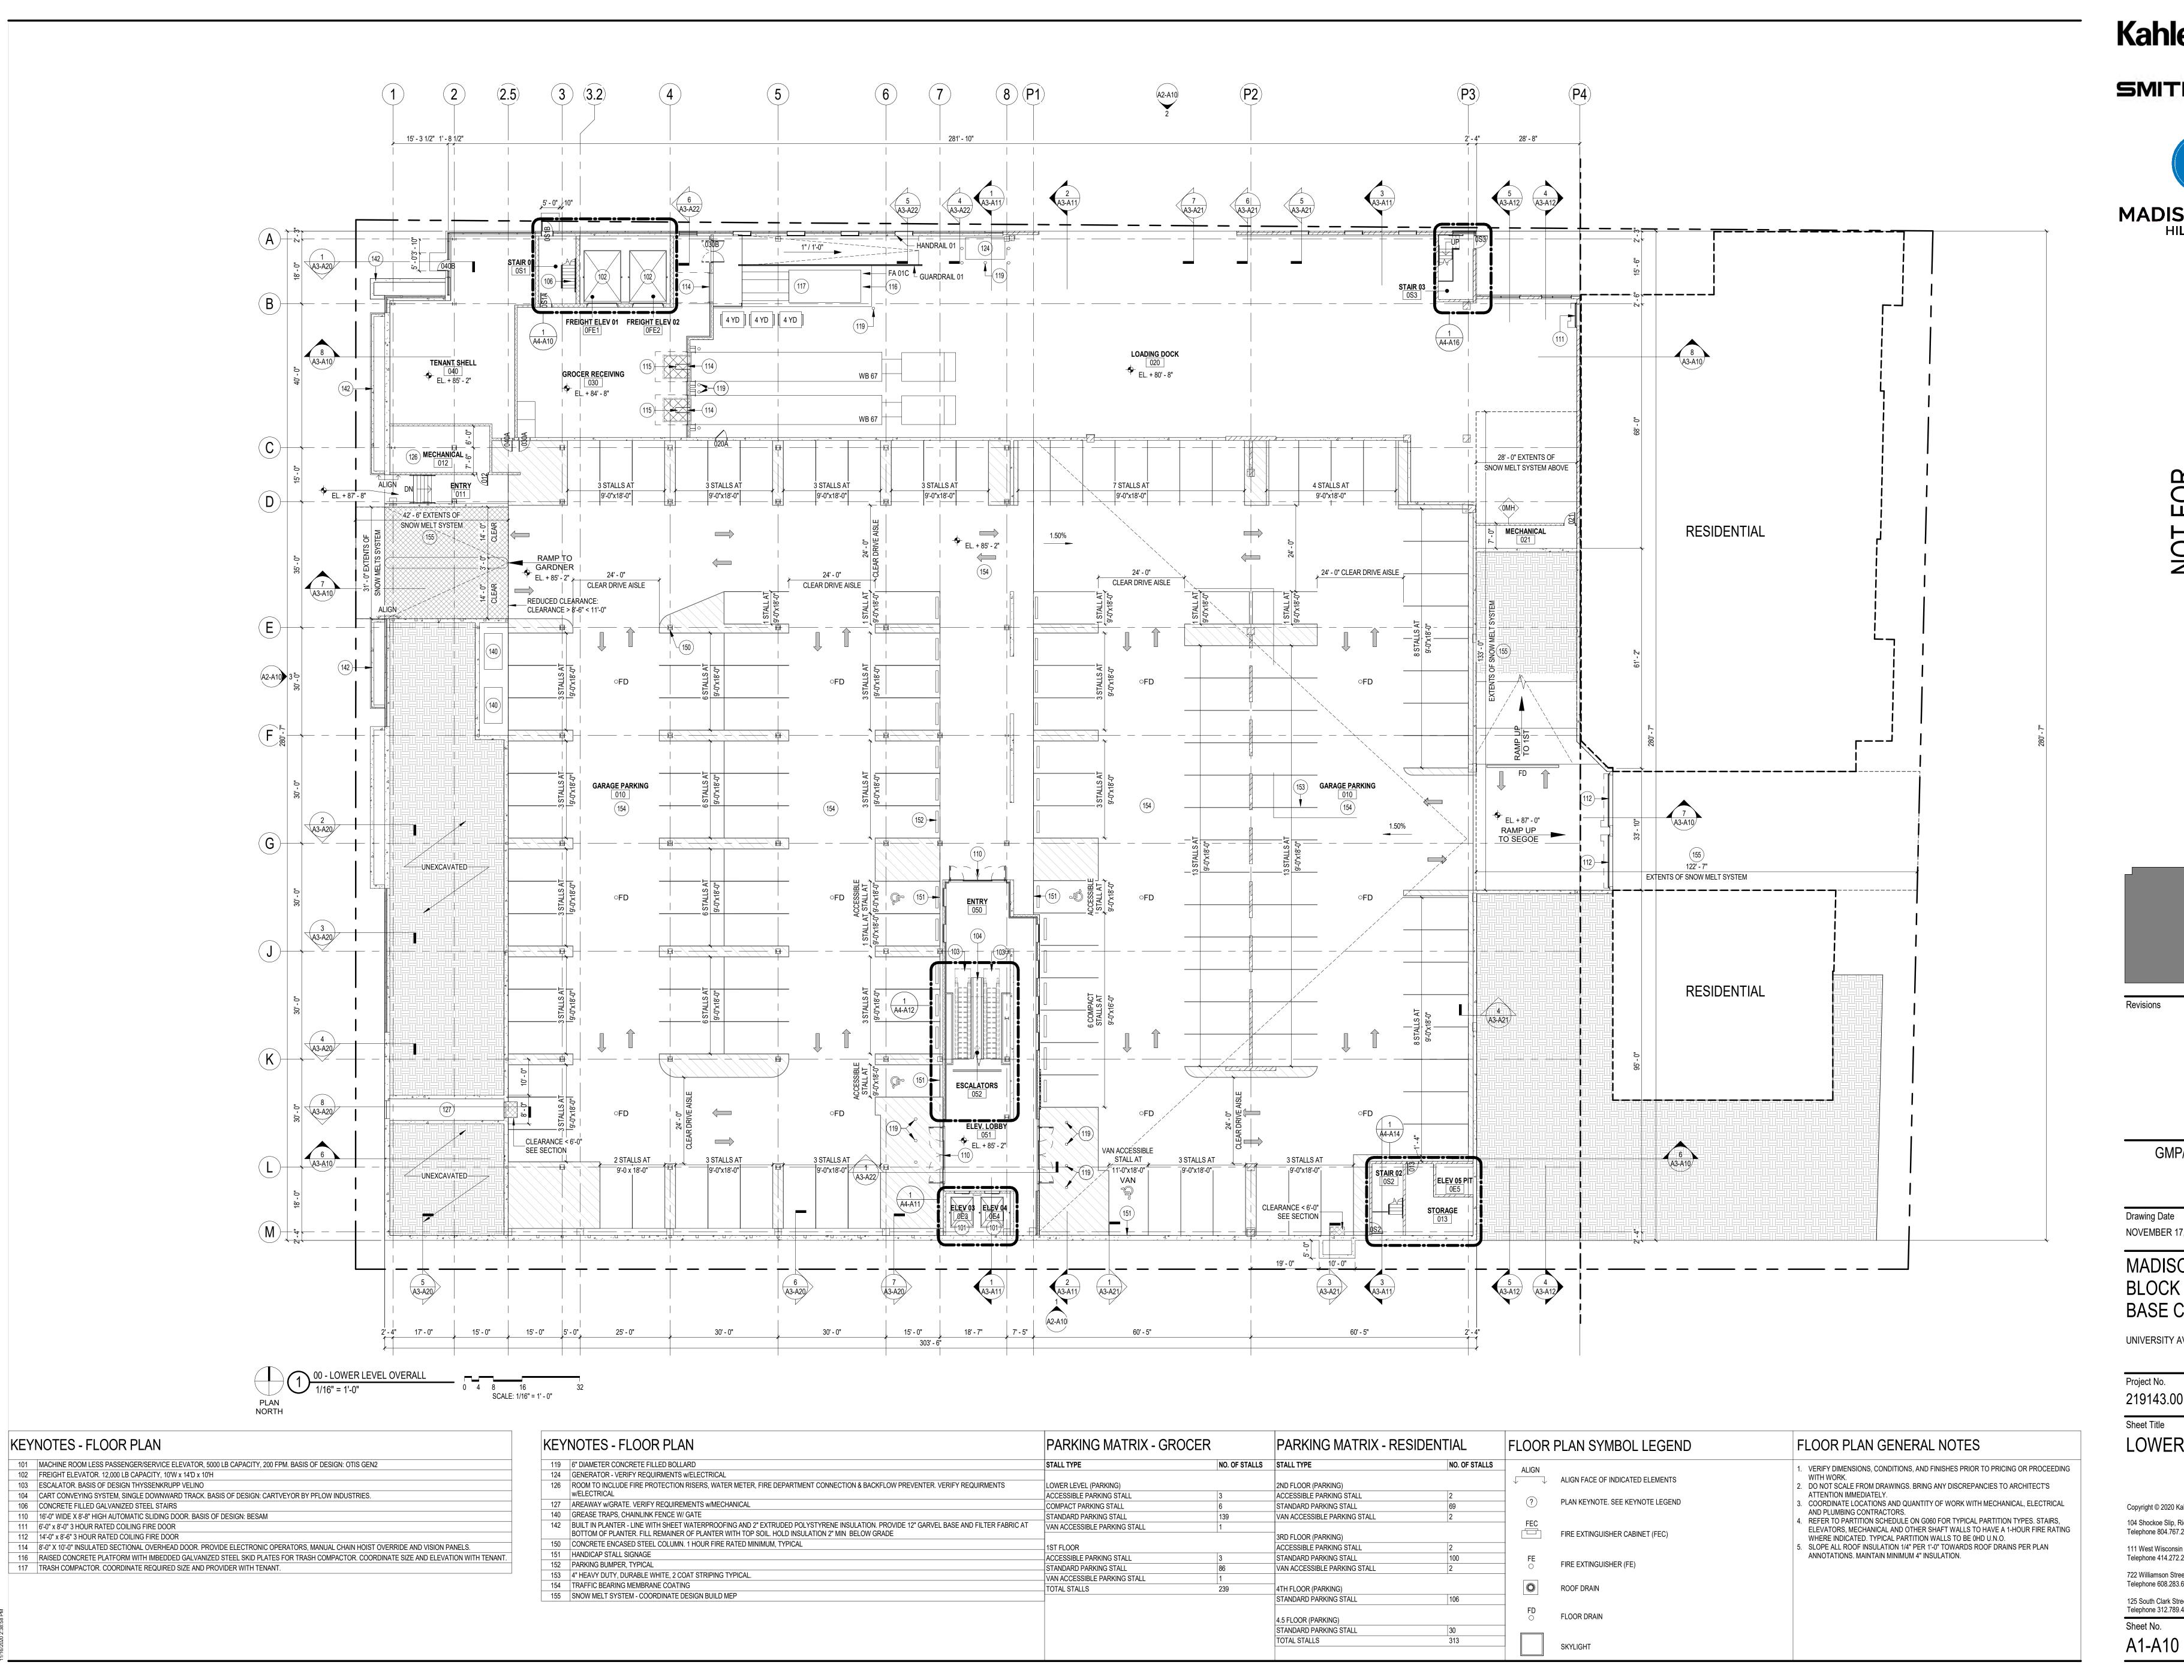
UNIVERSITY AVENUE AT GARDNER ROAD

Project No. SUMMIT SMITH/GILBANE 219143.00

Sheet Title ARCHITECTURAL SITE


PLAN

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UNIVERSITY AVENUE AT GARDNER ROAD


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LOWER LEVEL PLAN

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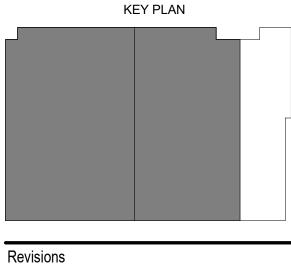
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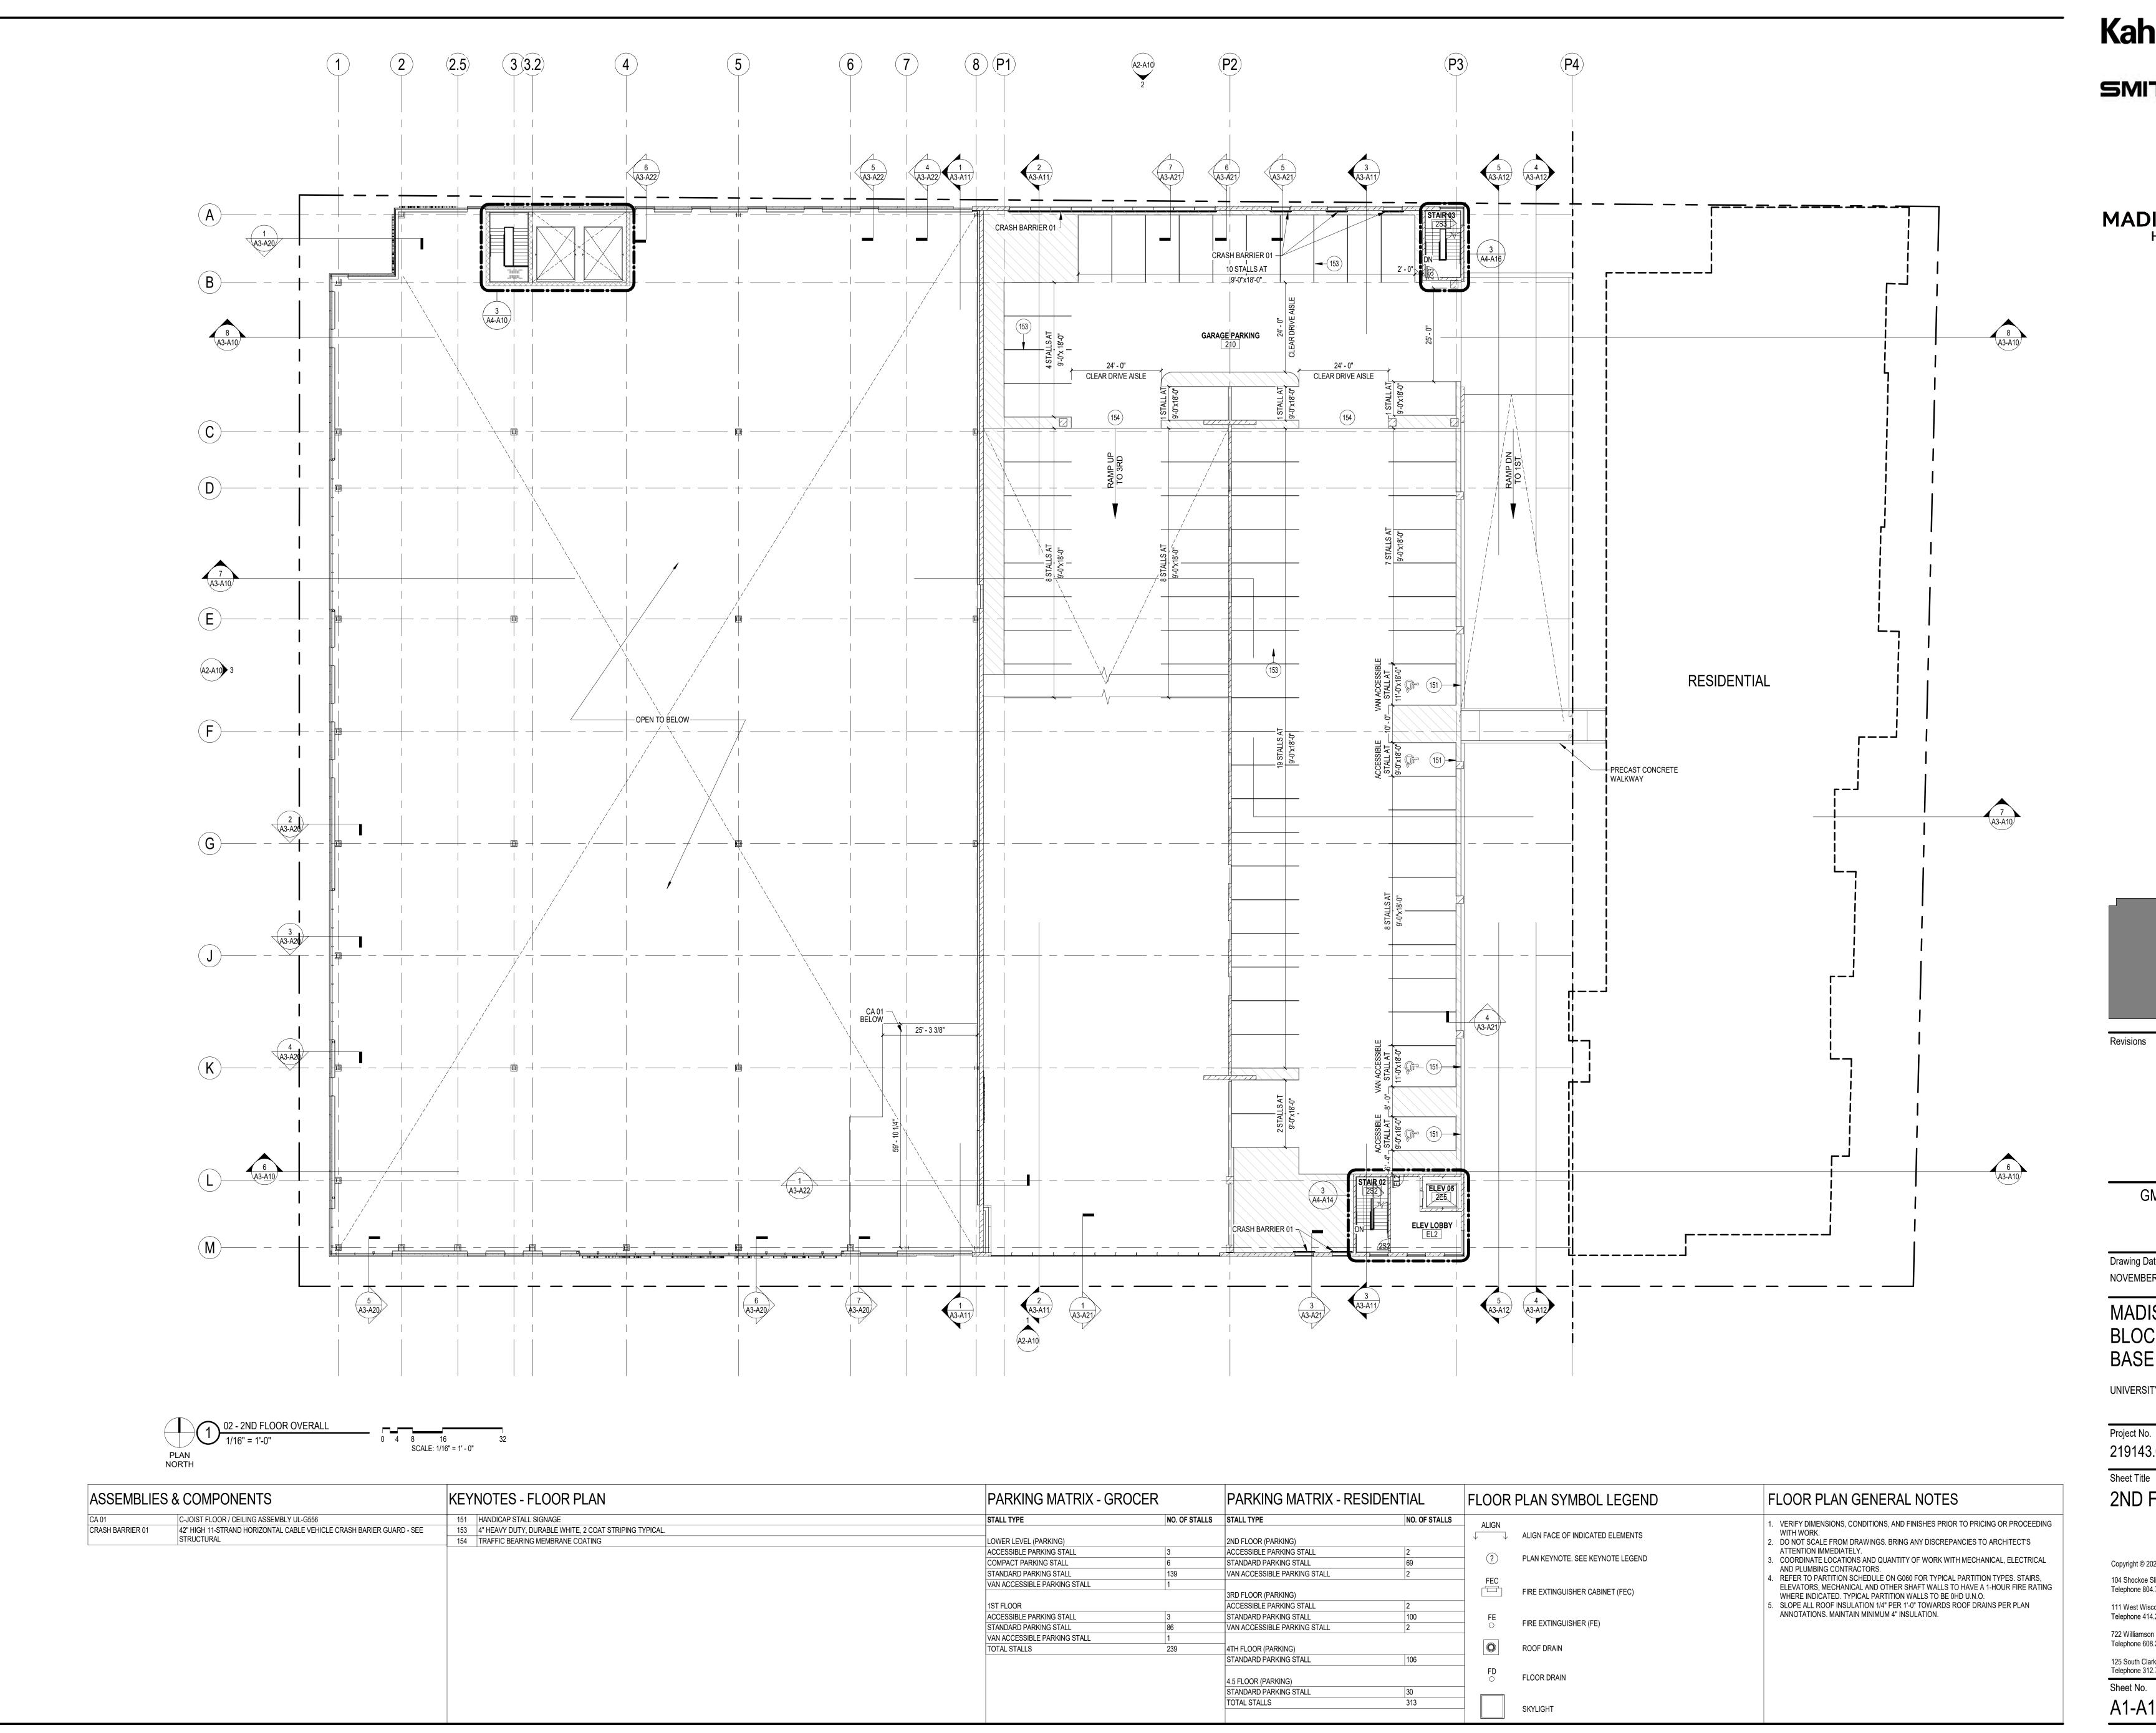
MADISON YARDS: BLOCK 2 - GROCER **BASE CORE & SHELL**

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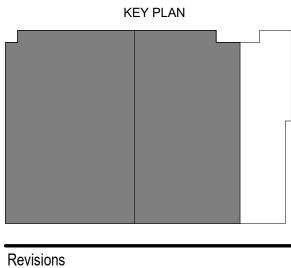
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Sheet No. A1-A11

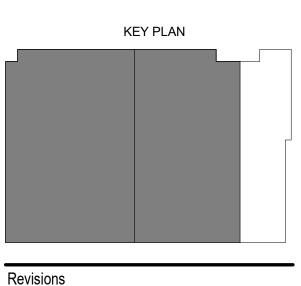

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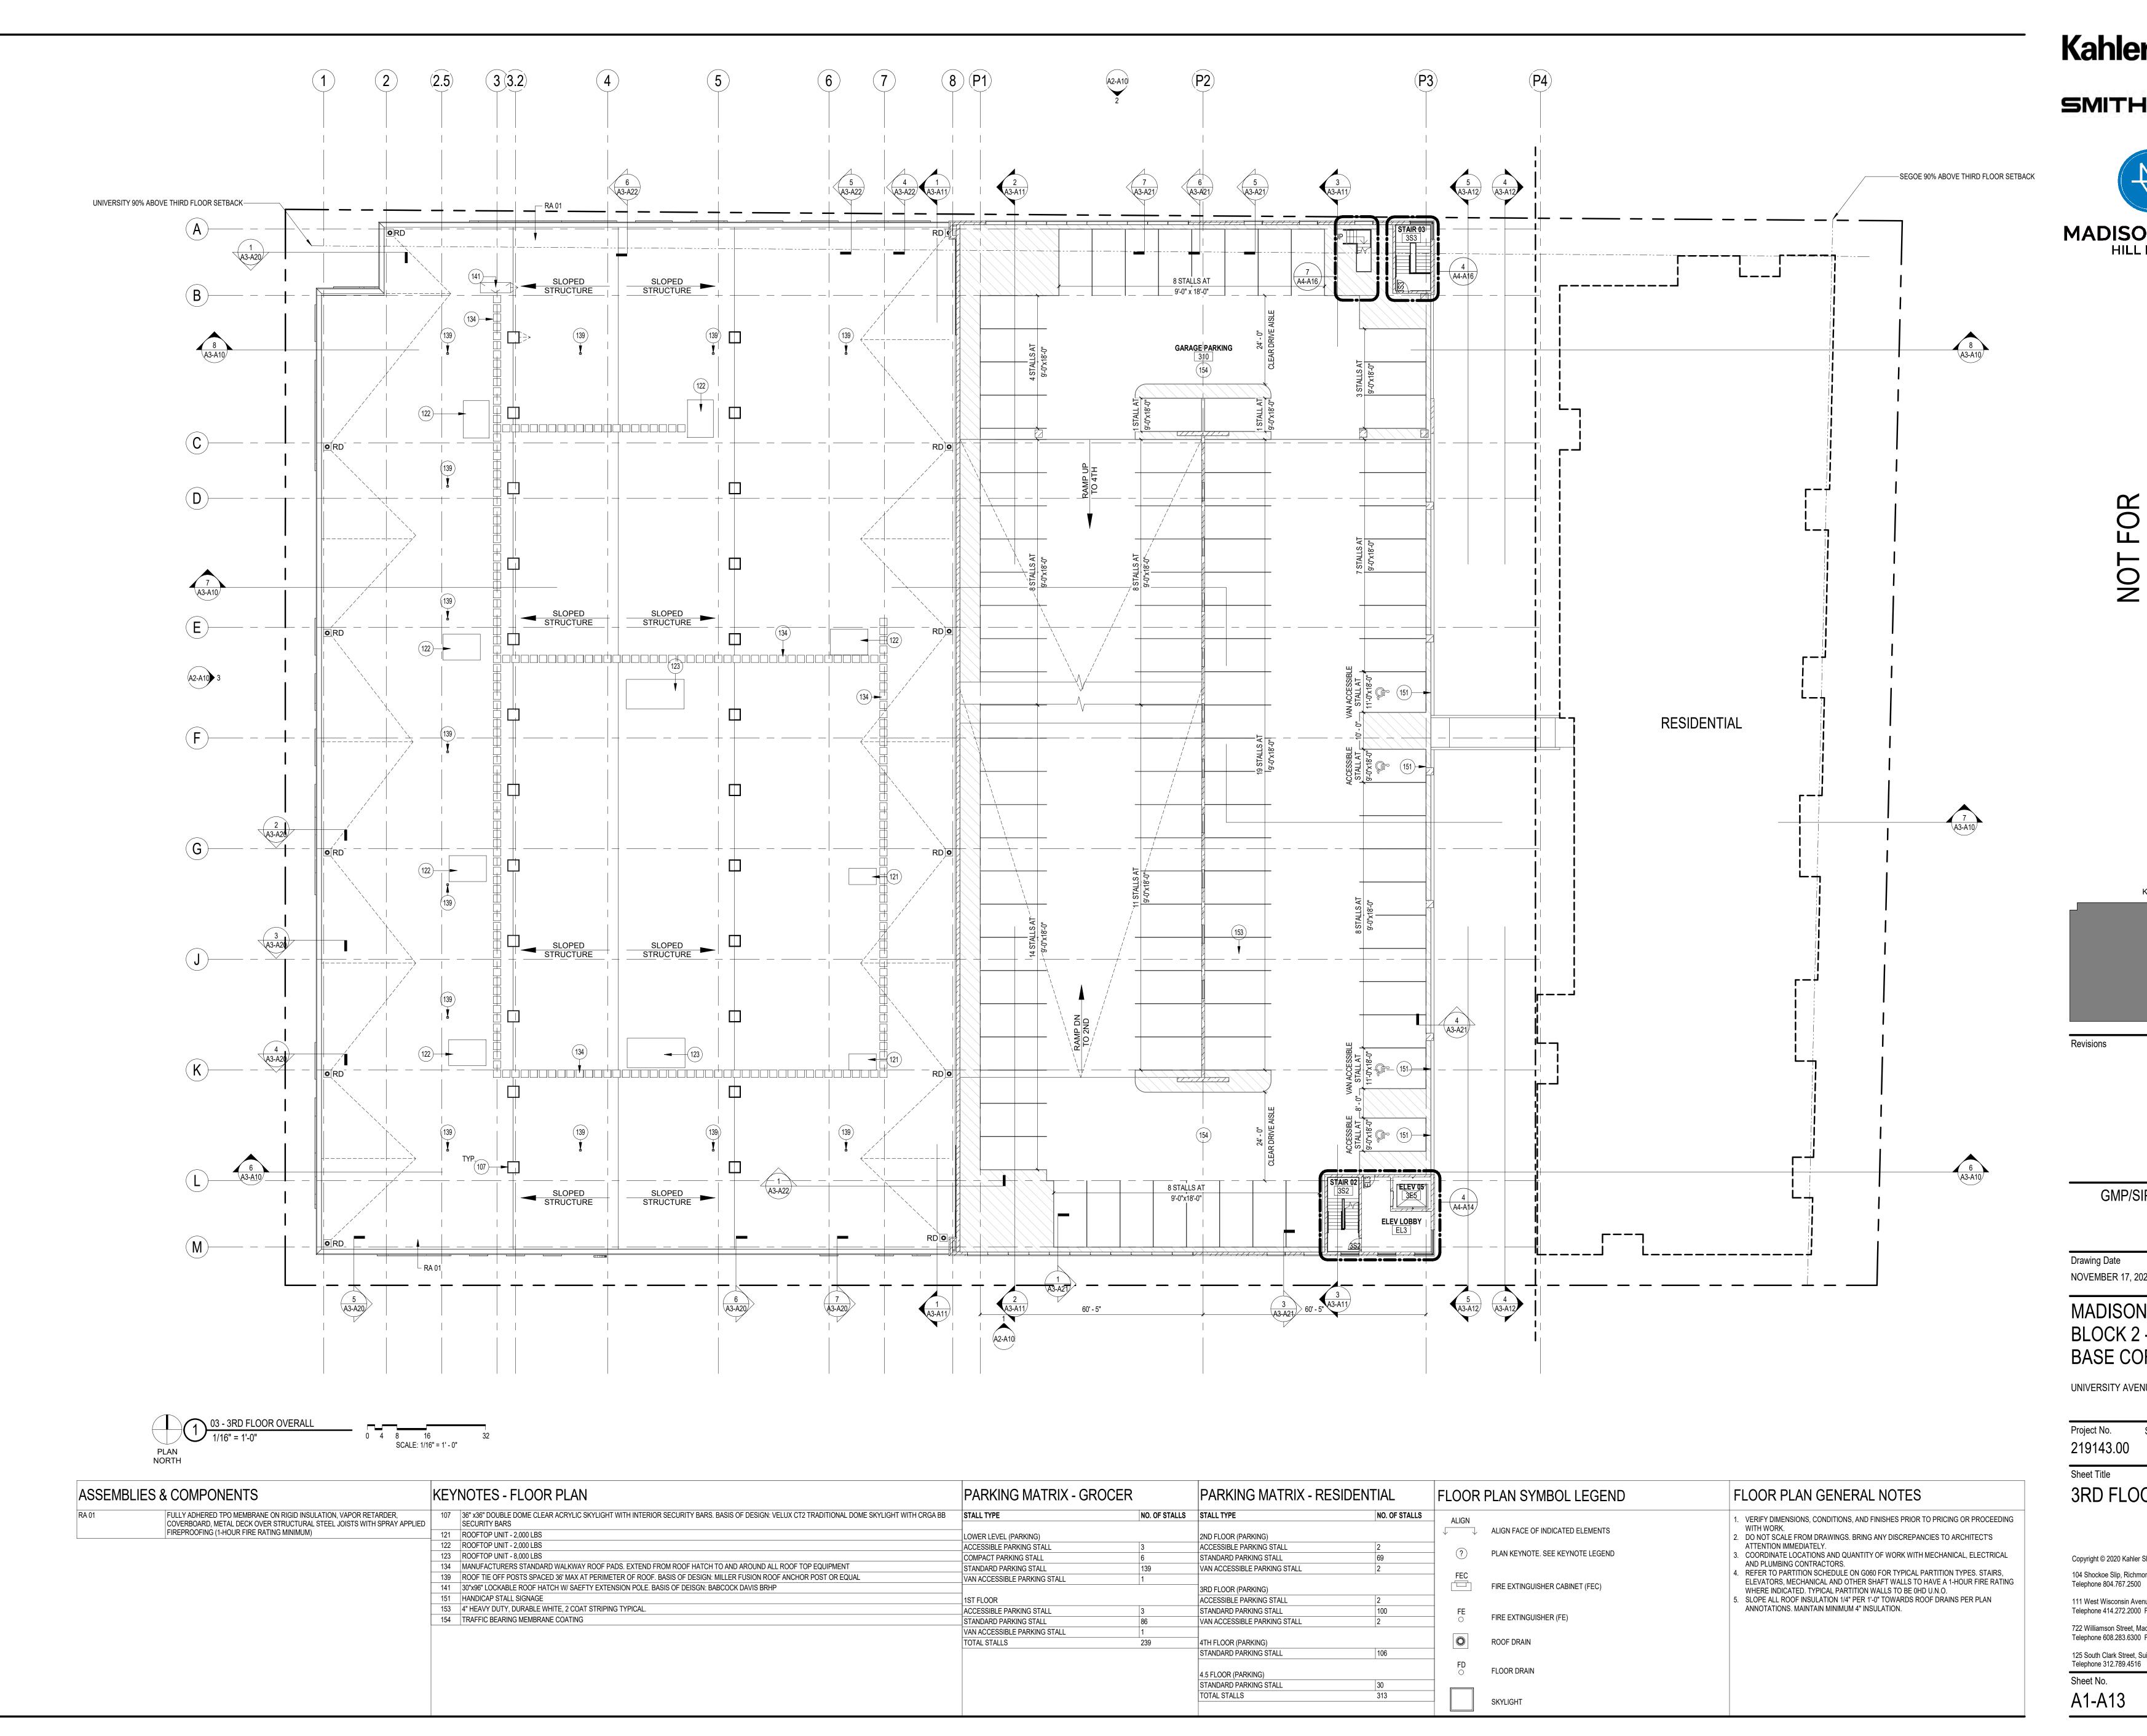
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2ND FLOOR PLAN

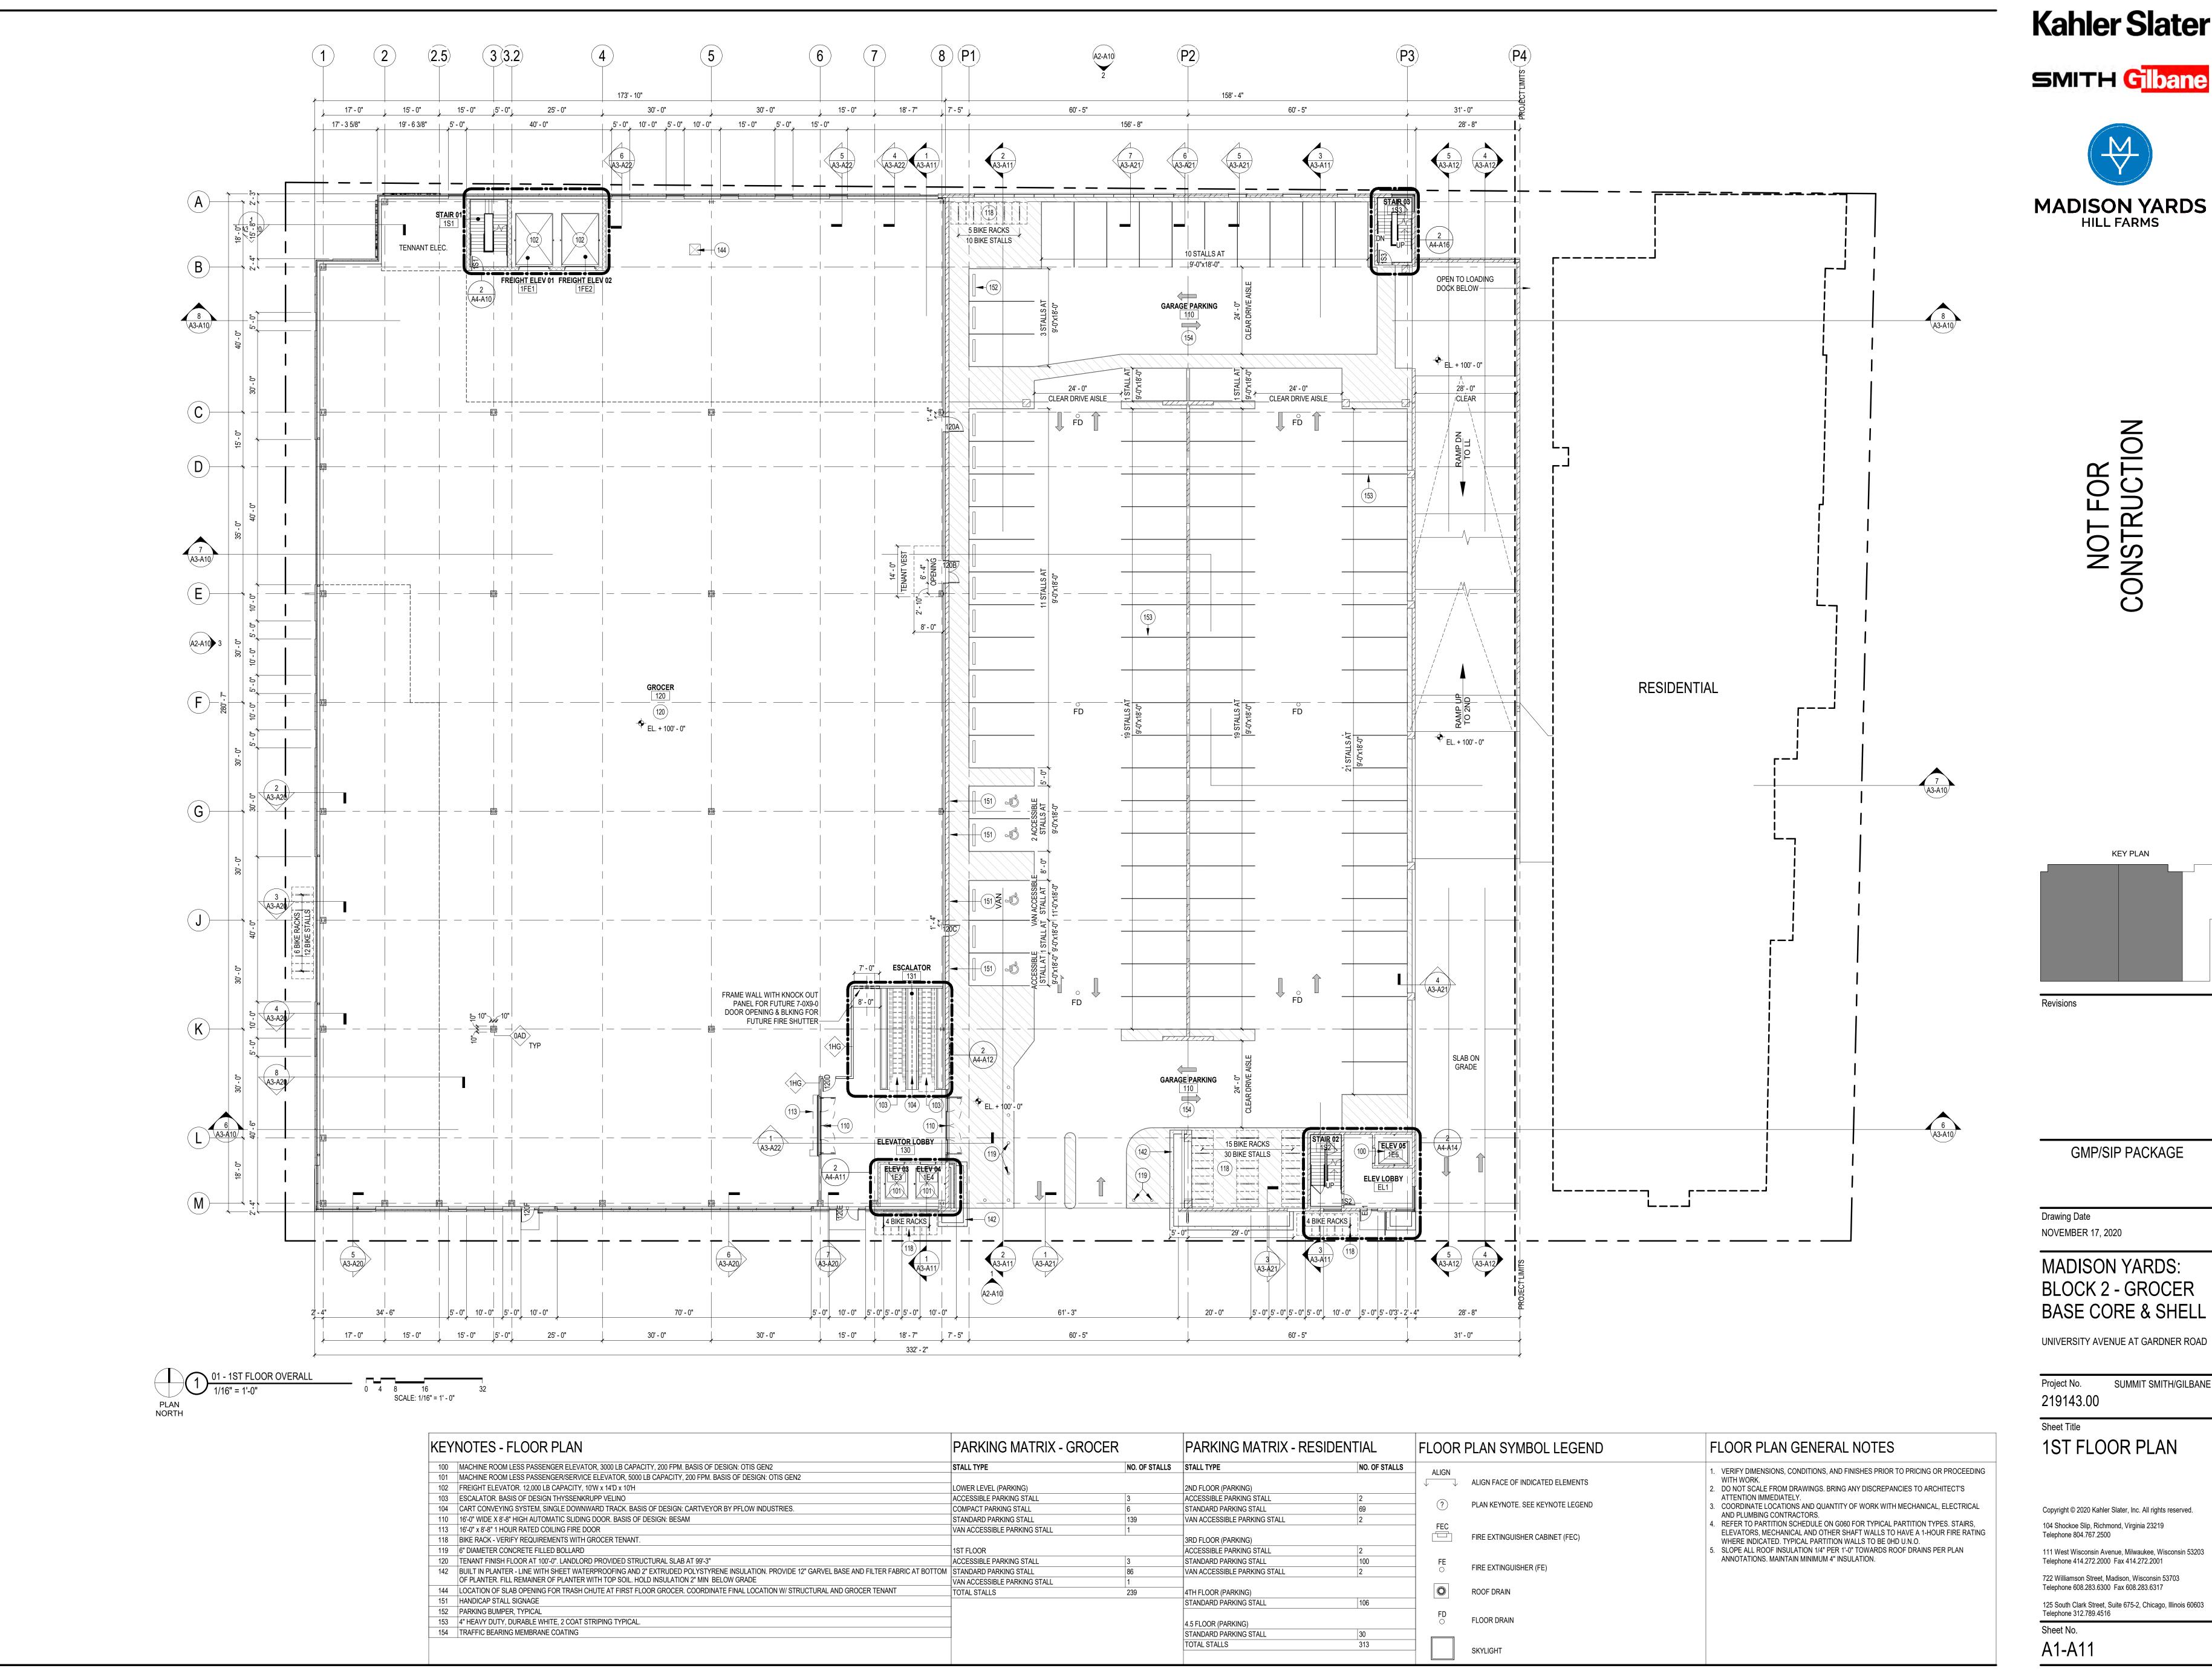
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MADISON YARDS: BLOCK 2 - GROCER **BASE CORE & SHELL**

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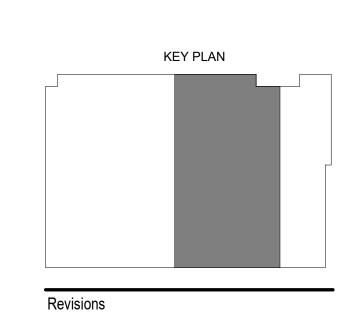
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MADISON YARDS: BLOCK 2 - GROCER BASE CORE & SHELL

UNIVERSITY AVENUE AT GARDNER ROAD

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Sheet Title 4TH FLOOR & ROOF PLANS

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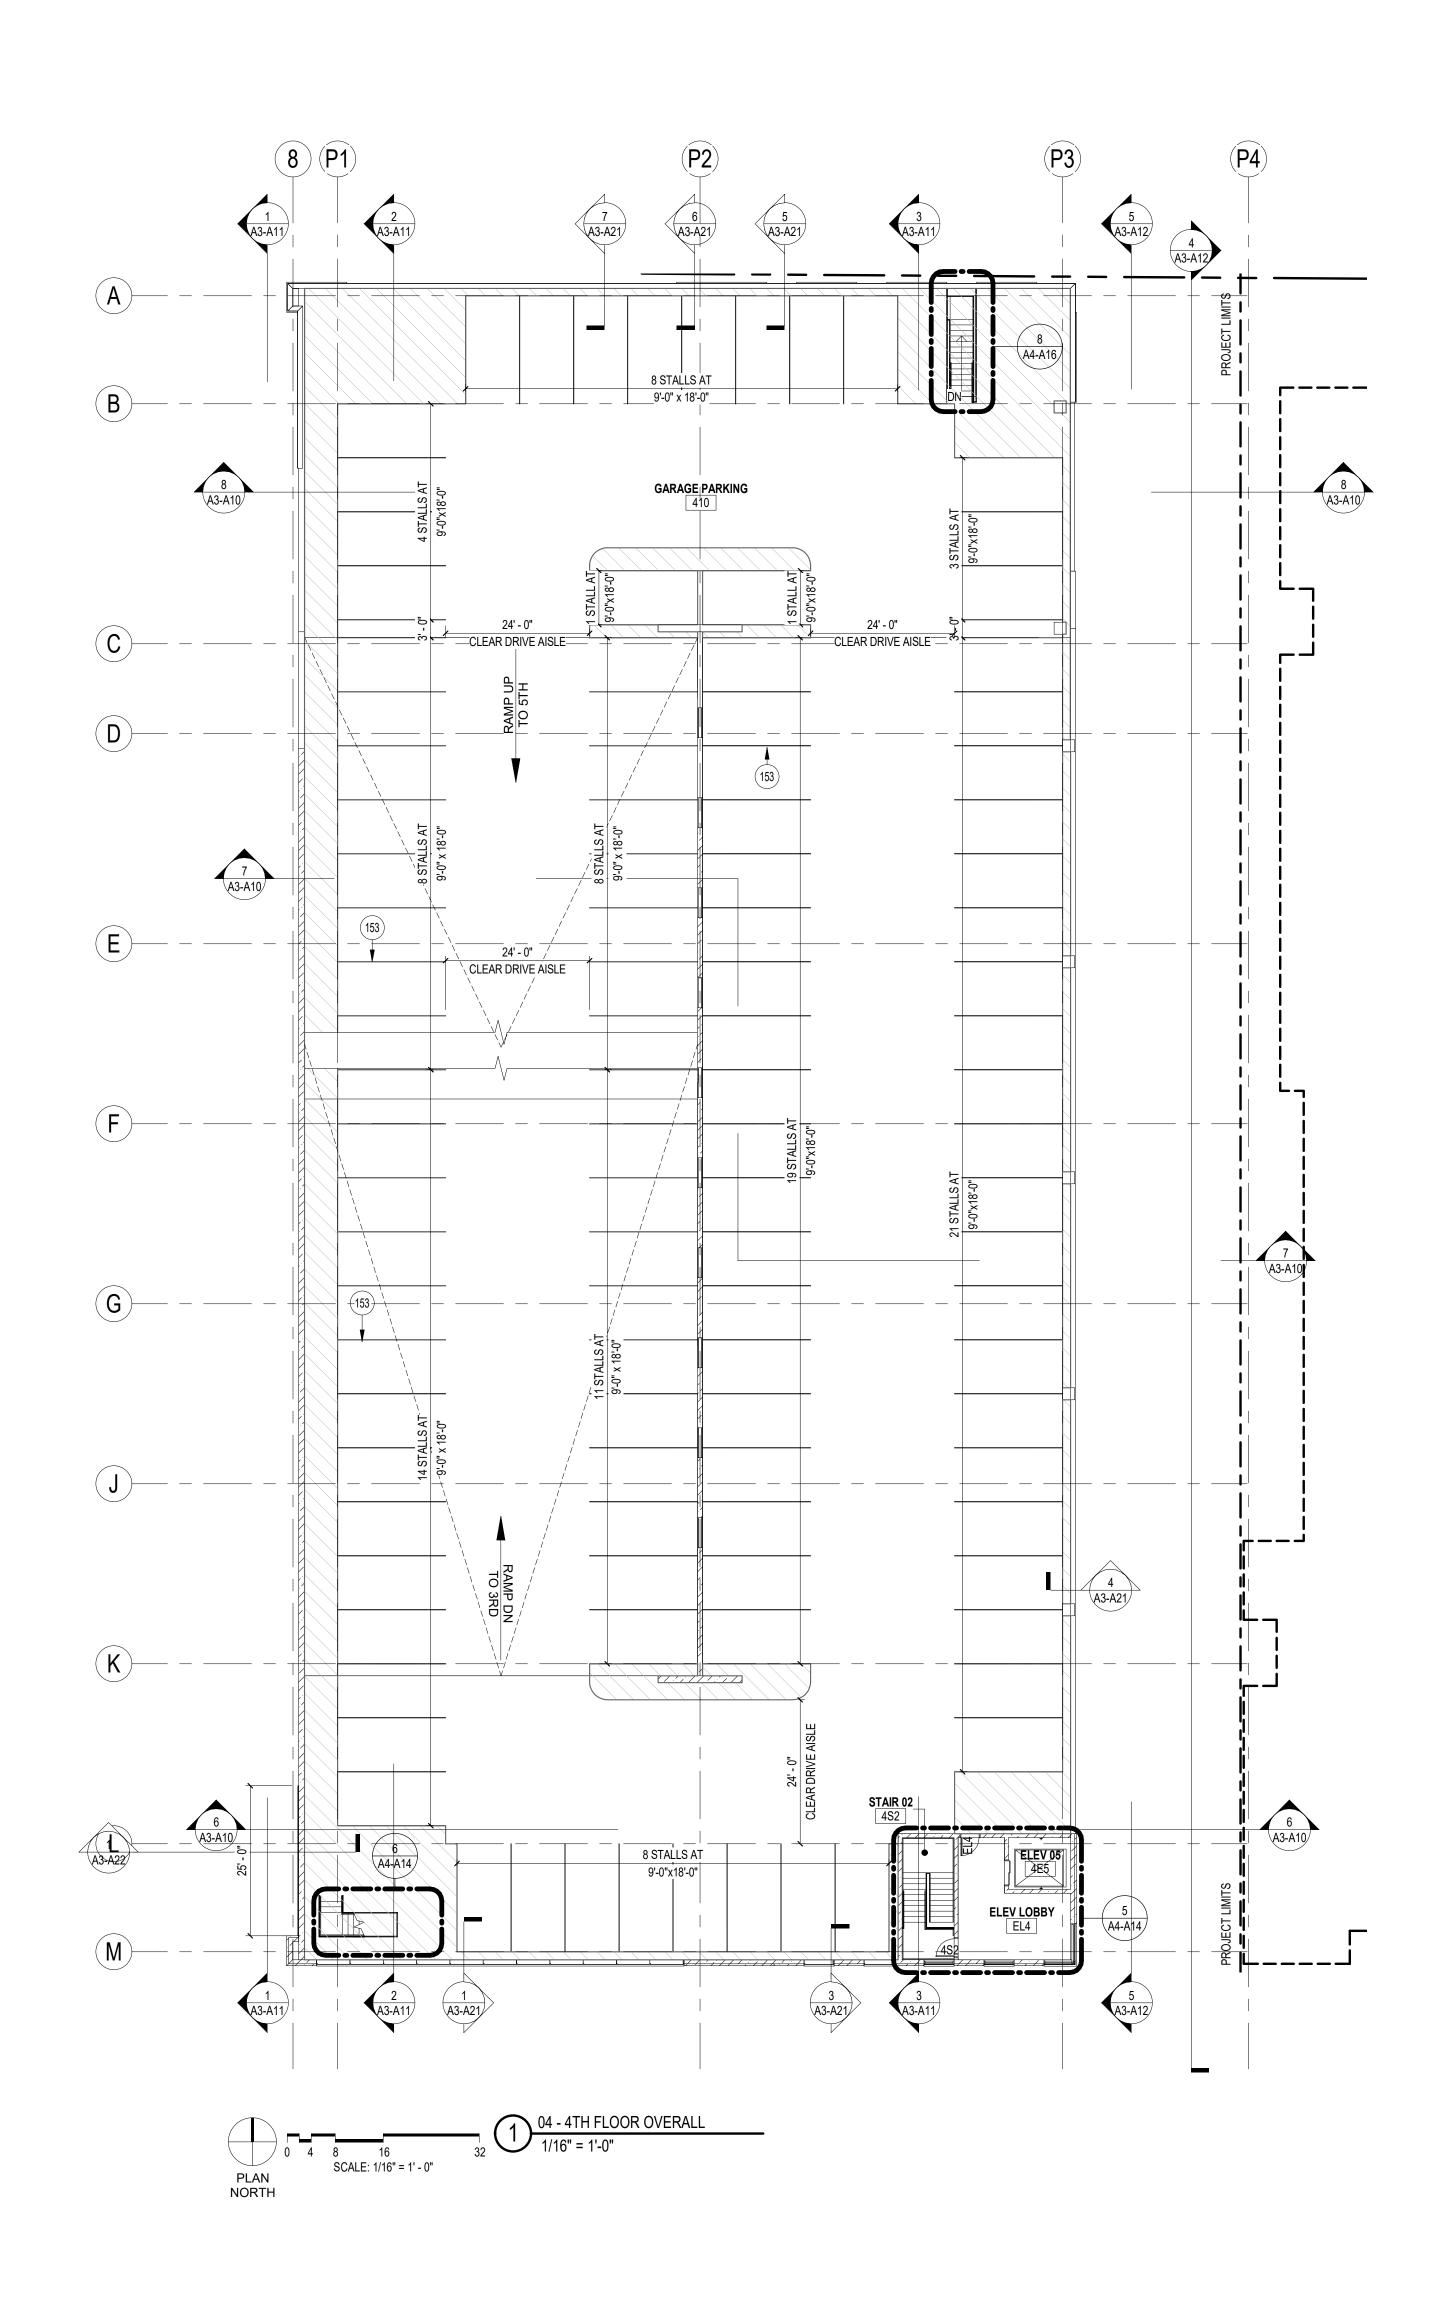
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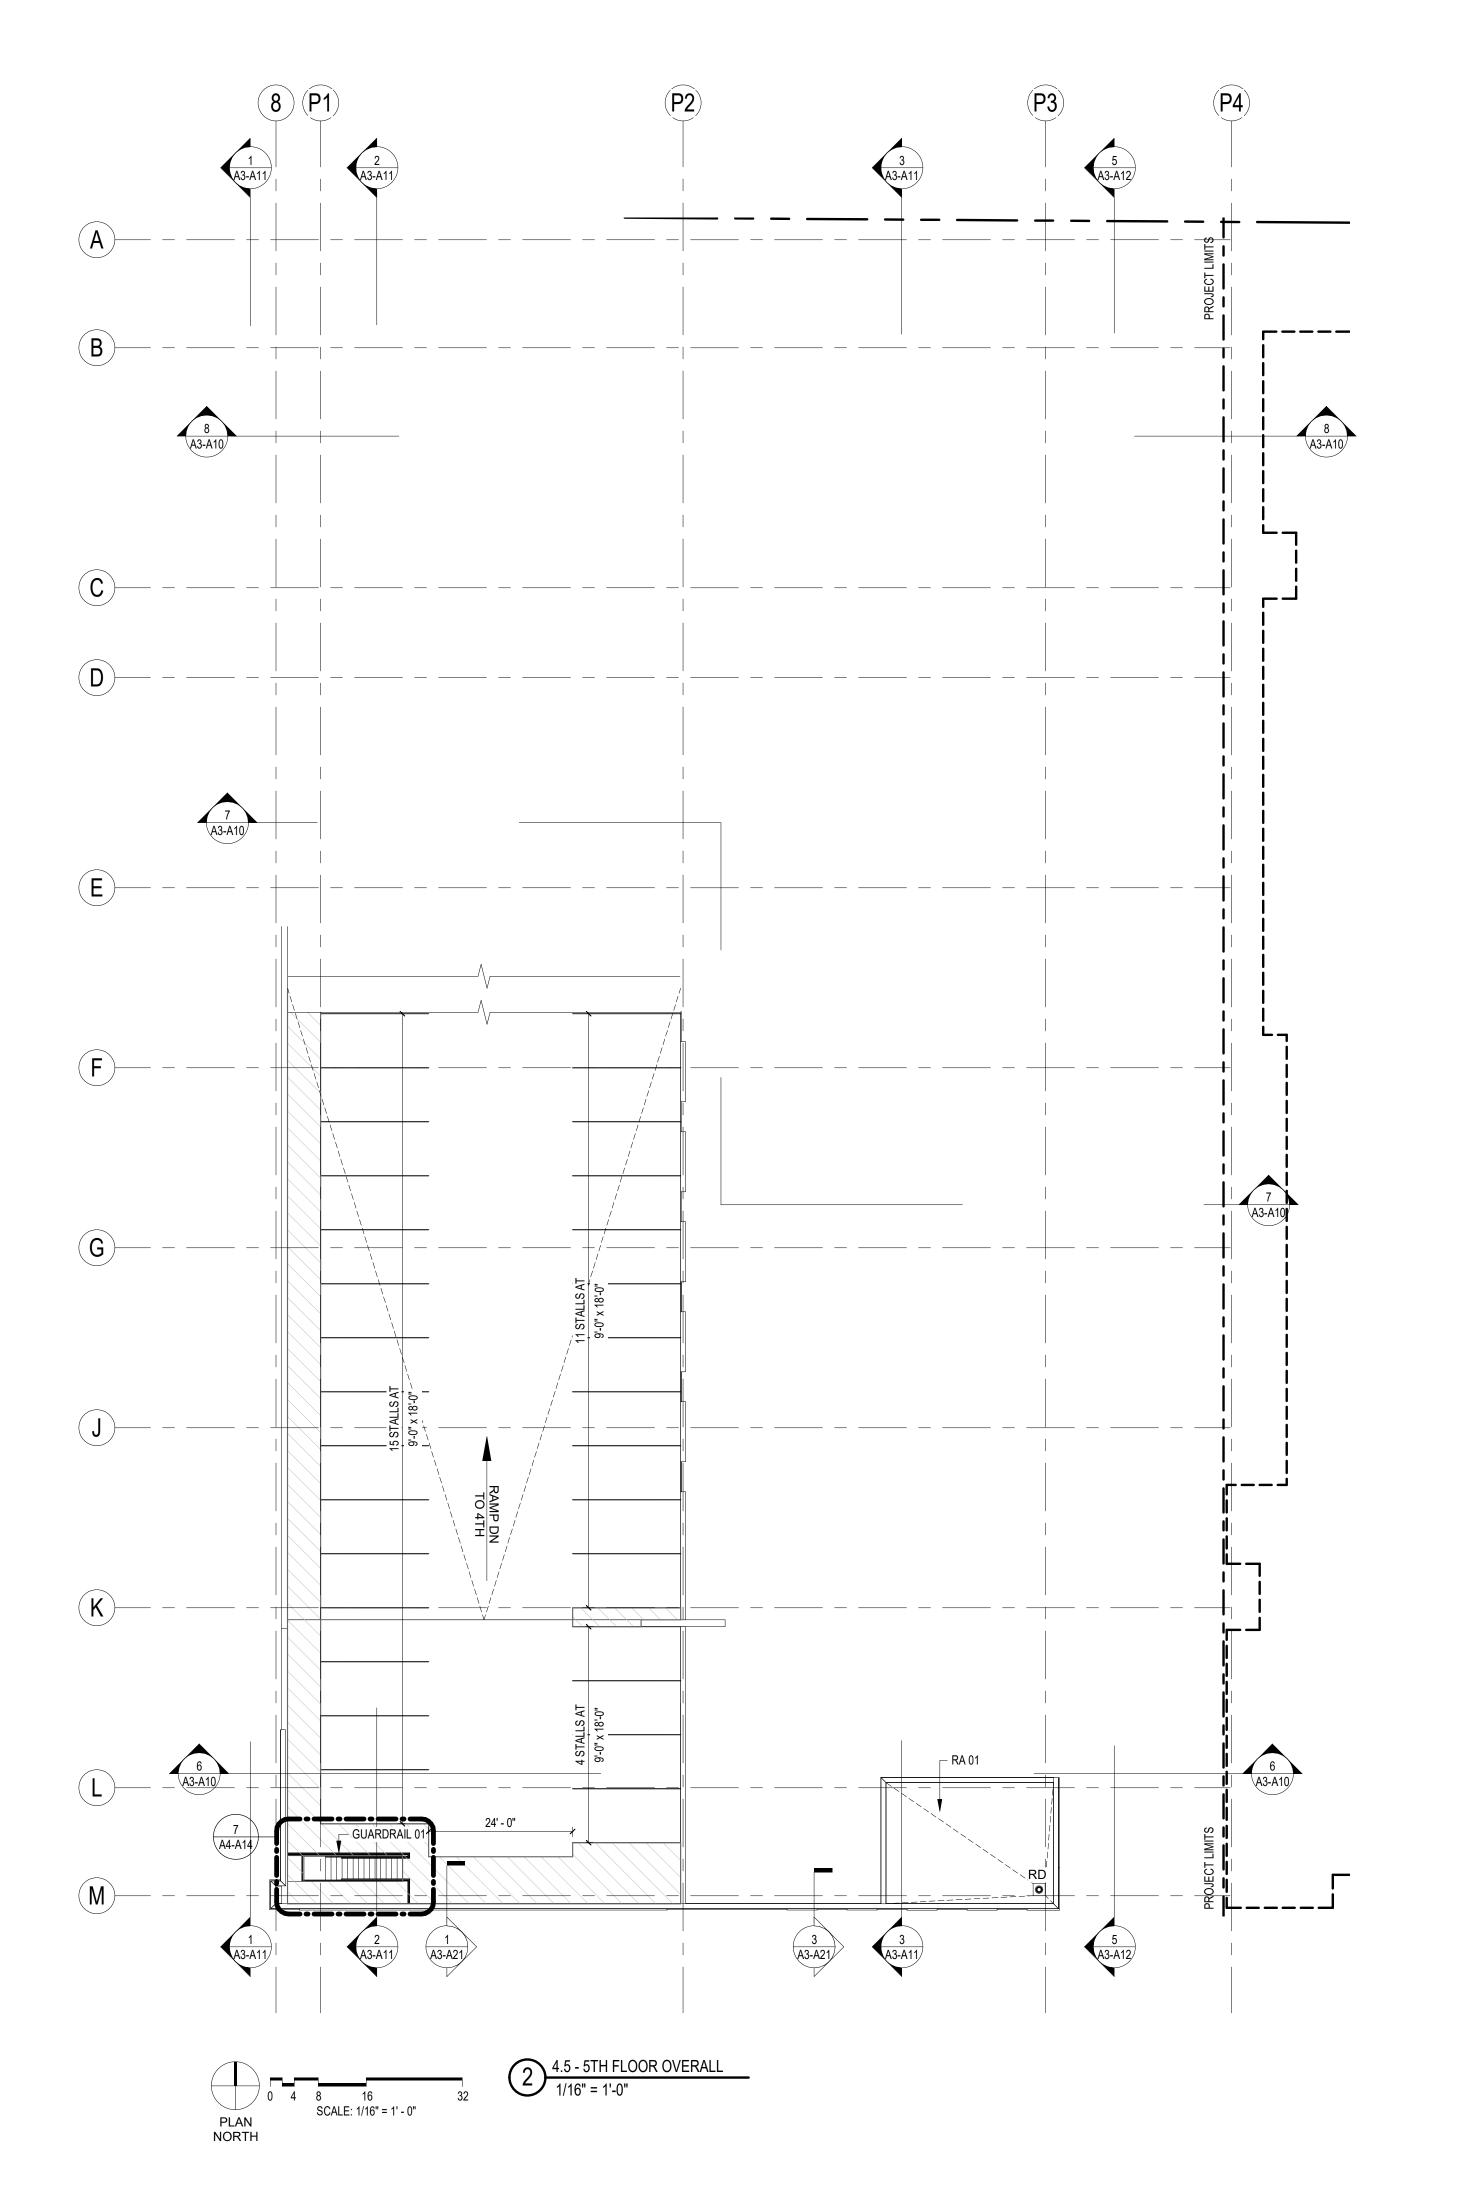
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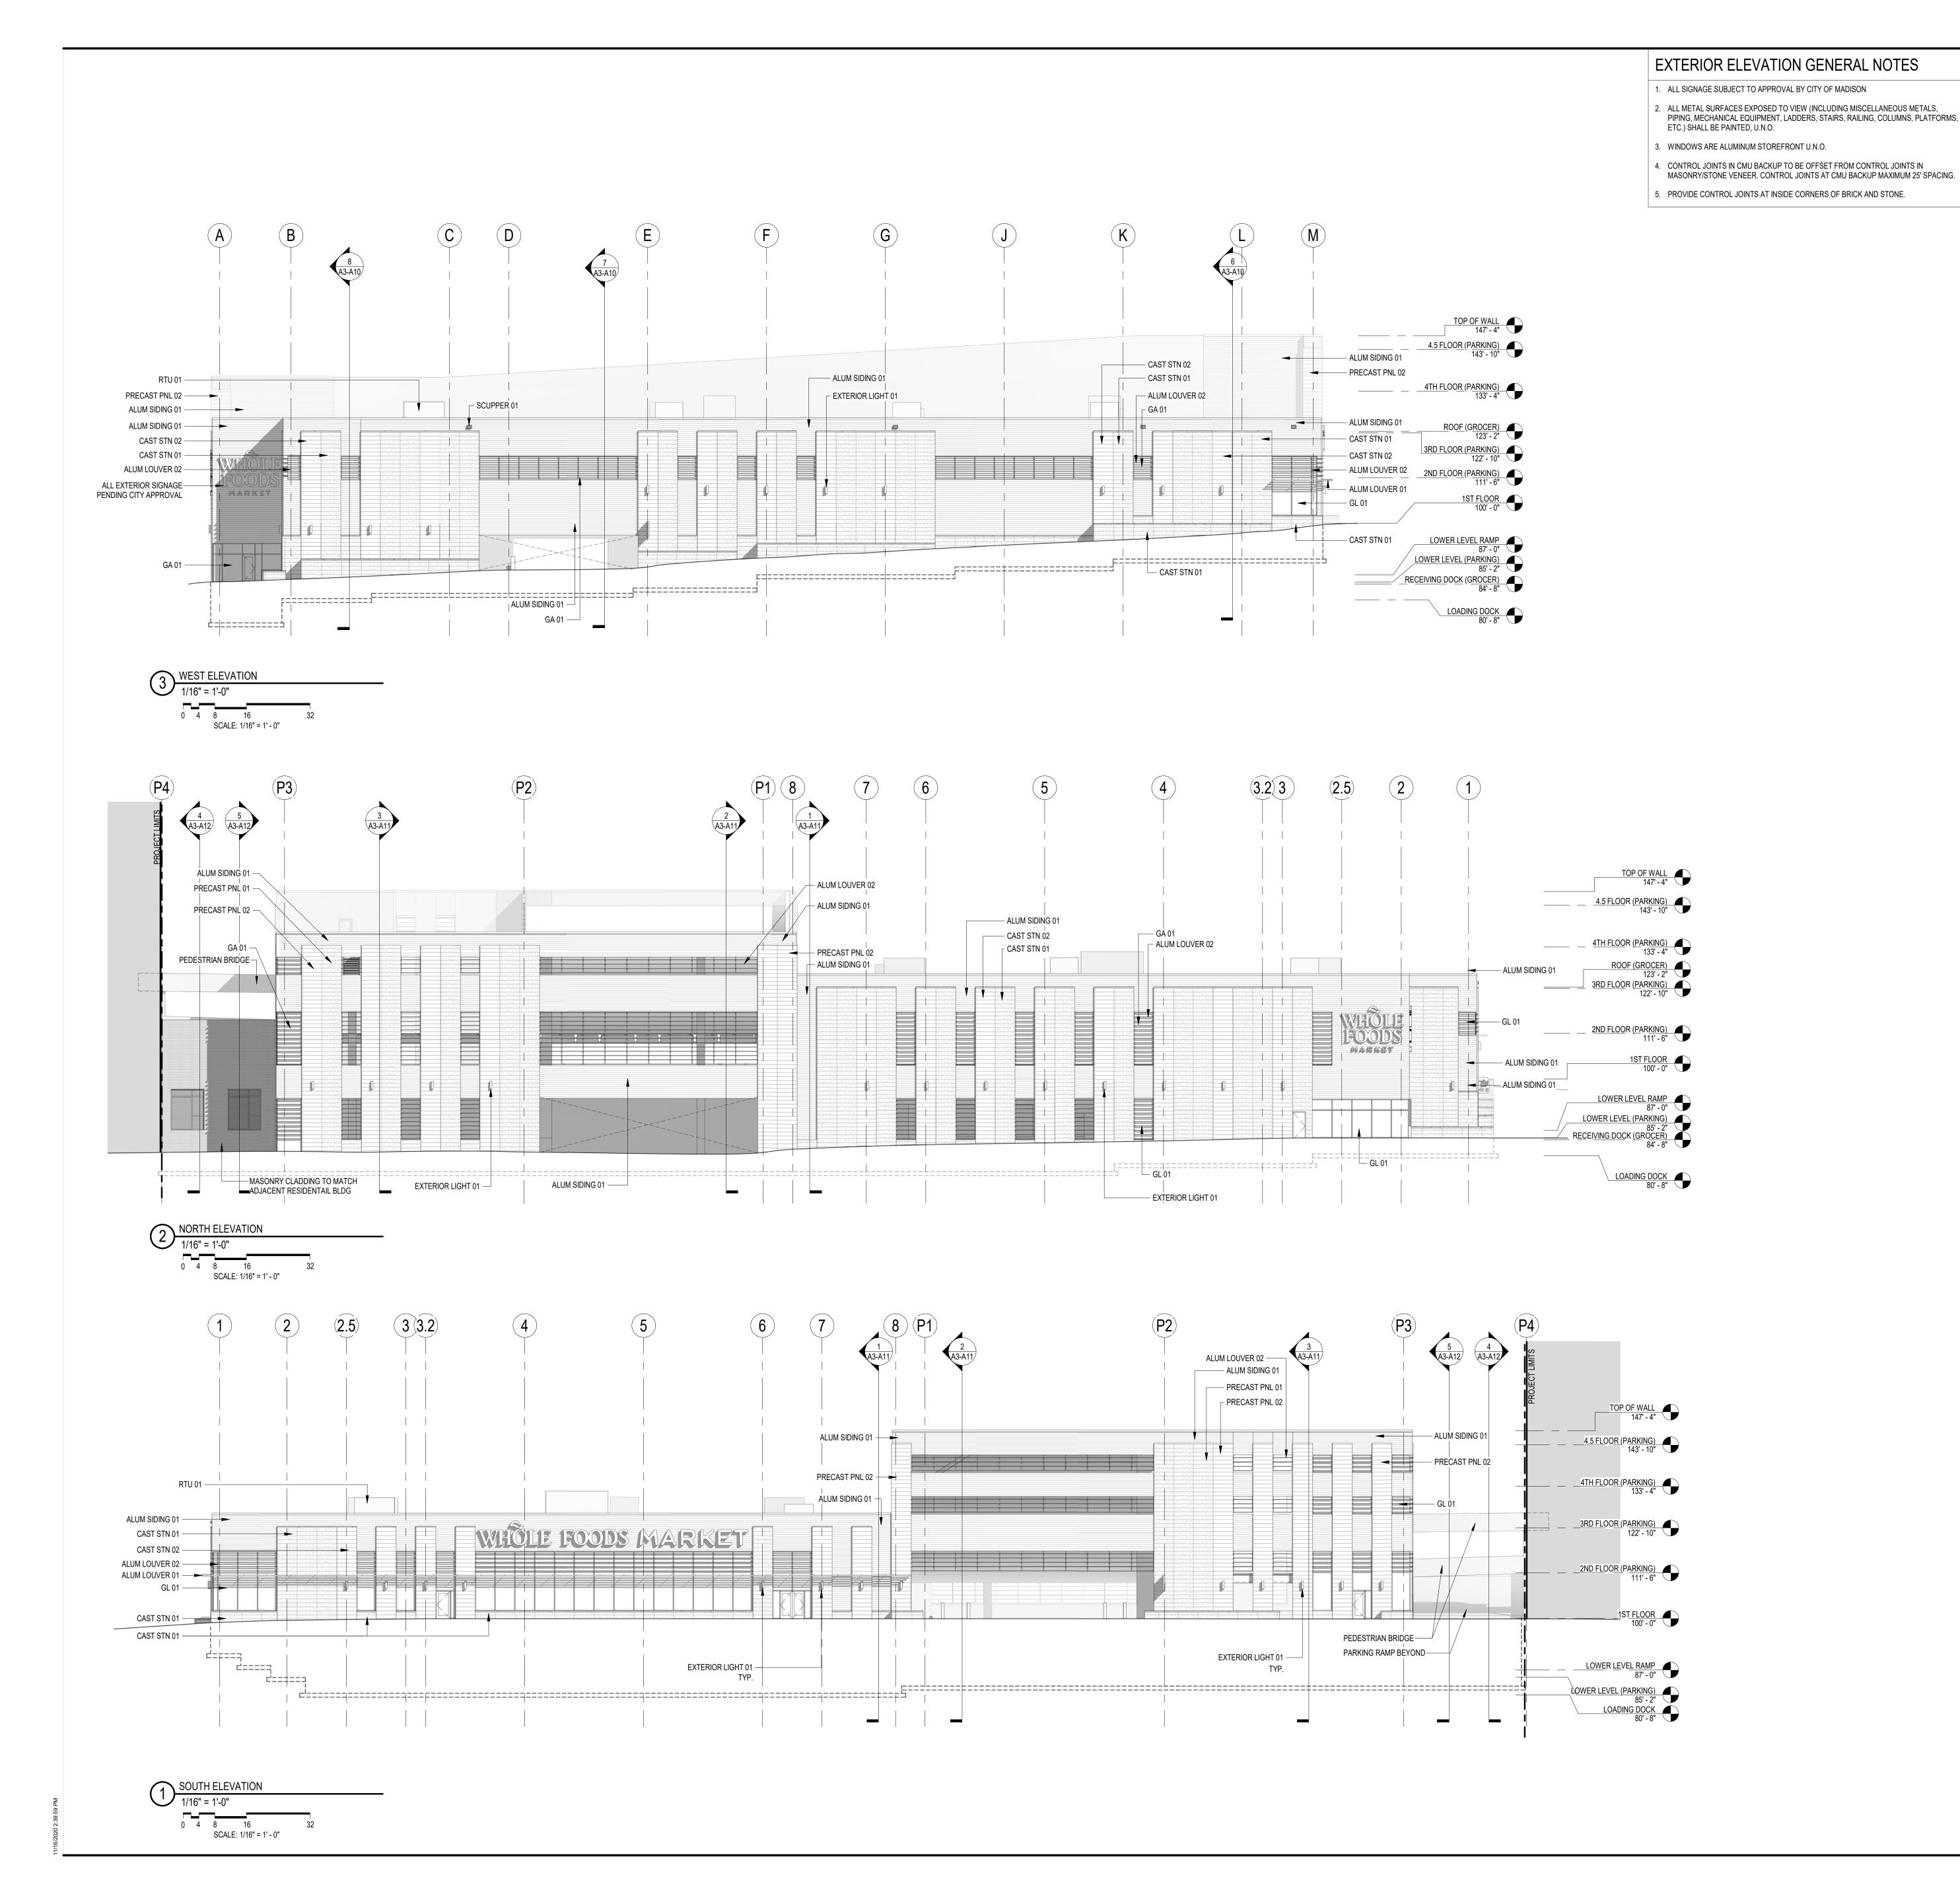
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SSEMBLIE	ES & COMPONENTS	KEYNOTES - FLOOR PLAN	PARKING MATRIX - GROCER	PARKIN	NG MATRIX - RES	DENTIAL	FLOOR PLAN SYMBOL LEGEND	FLOOR PLAN GENERAL NOTES
UARDRAIL 01	PREFABRICATED PAINTED STEEL GUARDRAIL, 42", STRINGER MOUNTED, 12" EXTENSIONS AT BOTH ENDS	153 4" HEAVY DUTY, DURABLE WHITE, 2 COAT STRIPING TYPICAL.	STALL TYPE NO. OF	TALLS STALL TYPE		NO. OF STALLS	ALIGN	VERIFY DIMENSIONS, CONDITIONS, AND FINISHES PRIOR TO PRICING OR PROCEED
01	FULLY ADHERED TPO MEMBRANE ON RIGID INSULATION, VAPOR RETARDER,		LOWER LEVEL (PARKING)	2ND FLOOR (PA	PARKING)		ALIGN FACE OF INDICATED ELEMENTS	WITH WORK. 2. DO NOT SCALE FROM DRAWINGS. BRING ANY DISCREPANCIES TO ARCHITECT'S
	COVERBOARD, METAL DECK OVER STRUCTURAL STEEL JOISTS WITH SPRAY APPLIED		ACCESSIBLE PARKING STALL 3	,	PARKING STALL	2		ATTENTION IMMEDIATELY.
	FIREPROOFING (1-HOUR FIRE RATING MINIMUM)		COMPACT PARKING STALL 6	STANDARD PA	ARKING STALL	69	? PLAN KEYNOTE. SEE KEYNOTE LEGEND	3. COORDINATE LOCATIONS AND QUANTITY OF WORK WITH MECHANICAL, ELECTRICAL AND BLUMBING CONTRACTORS
			STANDARD PARKING STALL 139	VAN ACCESSIE	IBLE PARKING STALL	2		AND PLUMBING CONTRACTORS. 4. REFER TO PARTITION SCHEDULE ON G060 FOR TYPICAL PARTITION TYPES. STAIRS
			VAN ACCESSIBLE PARKING STALL 1	0DD 51 00D /D	DA DI ((140)		FIRE EXTINGUISHER CABINET (FEC)	ELEVATORS, MECHANICAL AND OTHER SHAFT WALLS TO HAVE A 1-HOUR FIRE RA
			4CT FLOOR	3RD FLOOR (PA	,	0	TINE EXTINOUIDITEN GABINET (I EO)	WHERE INDICATED. TYPICAL PARTITION WALLS TO BE 0HD U.N.O. 5. SLOPE ALL ROOF INSULATION 1/4" PER 1'-0" TOWARDS ROOF DRAINS PER PLAN
			1ST FLOOR ACCESSIBLE PARKING STALL 3		PARKING STALL ARKING STALL	100		ANNOTATIONS. MAINTAIN MINIMUM 4" INSULATION.
			STANDARD PARKING STALL 86		IBLE PARKING STALL	2	○ FIRE EXTINGUISHER (FE)	
			VAN ACCESSIBLE PARKING STALL 1	VAIVAGGEGGIE	IDEL I AITHING OTALL	L		
			TOTAL STALLS 239	4TH FLOOR (PA	PARKING)		ROOF DRAIN	
				STANDARD PA	ARKING STALL	106		
				4.5 FLOOR (PA	A DIZINIO)		FD O FLOOR DRAIN	
				(ARKING) ARKING STALL	30	<u> </u>	
				TOTAL STALLS		313		
				1017120171220		0.10	SKYLIGHT	

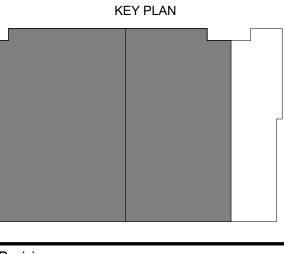

ASSEMBLIES & COMPONENTS DECORATIVE HORIZONTAL EXTRUDED ALUMINUM WOOD-LOOK LOUVER. BASIS OF ALUM LOUVER 01 DESIGN: LONGBOARD FIXED LOUVER SYSTEM ALUM LOUVER 02 DECORITIVE VERTICAL EXTRUDED ALUMINUM WOOD-LOOK LOUVER. BASIS OF DESIGN: LONGBOARD FIXED LOUVER SYSTEM ALUMINUM WOOD-LOOK SIDING SYSTEM - SEE ELEVATIONS FOR SIZE AND COURSING COLOR TBD. BASIS OF DESIGN: LONGBOARD PLANK SYSTEM CAST STONE MASONRY - SEE ELEVATIONS FOR SIZE AND COURSING. COLOR TBD. BASIS OF DESIGN: STONECAST PRODUCTS FULL DEPTH VENEER. CAST STONE MASONRY - SEE ELEVATIONS FOR SIZE AND COURSING. COLOR TBD. BASIS OF DESIGN: STONECAST PRODUCTS FULL DEPTH VENEER. EXTERIOR DOWN-LIGHT SCONCE EXTERIOR LIGHT 01 ALUMINUM FRAMED ENTRANCES AND STOREFRONTS. BASIS OF DESIGN: KAWNEER 601T GLAZING SYSTEM GLAZING - VISION GLASS; 1" INSULATED GLAZING UNIT PRECAST PNL 01 PRE-CAST PANEL 01 - PRECAST WALL PANEL W/ MASONRY LOOK FORMLINER COLOR

PREFINISHED ALUMINUM SCUPPER TO MATCH ALUM SIDING 01

PRE-CAST PANEL 02 - PRECAST WALL PANEL W/ MASONRY LOOK FORMLINER COLOR

AND TEXTURE TO MATCH CAST STN 01

AND TEXTURE TO MATCH CAST STN 02

ROOFTOP UNIT - COORDINATE w/MECHANICAL

PRECAST PNL 02

SCUPPER 01

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Revisions

GMP/SIP PACKAGE

Drawing Date NOVEMBER 17, 2020

MADISON YARDS: BLOCK 2 - GROCER BASE CORE & SHELL

UNIVERSITY AVENUE AT GARDNER ROAD

Project No. SUMMIT SMITH/GILBANE 219143.00

EXTERIOR ELEVATIONS

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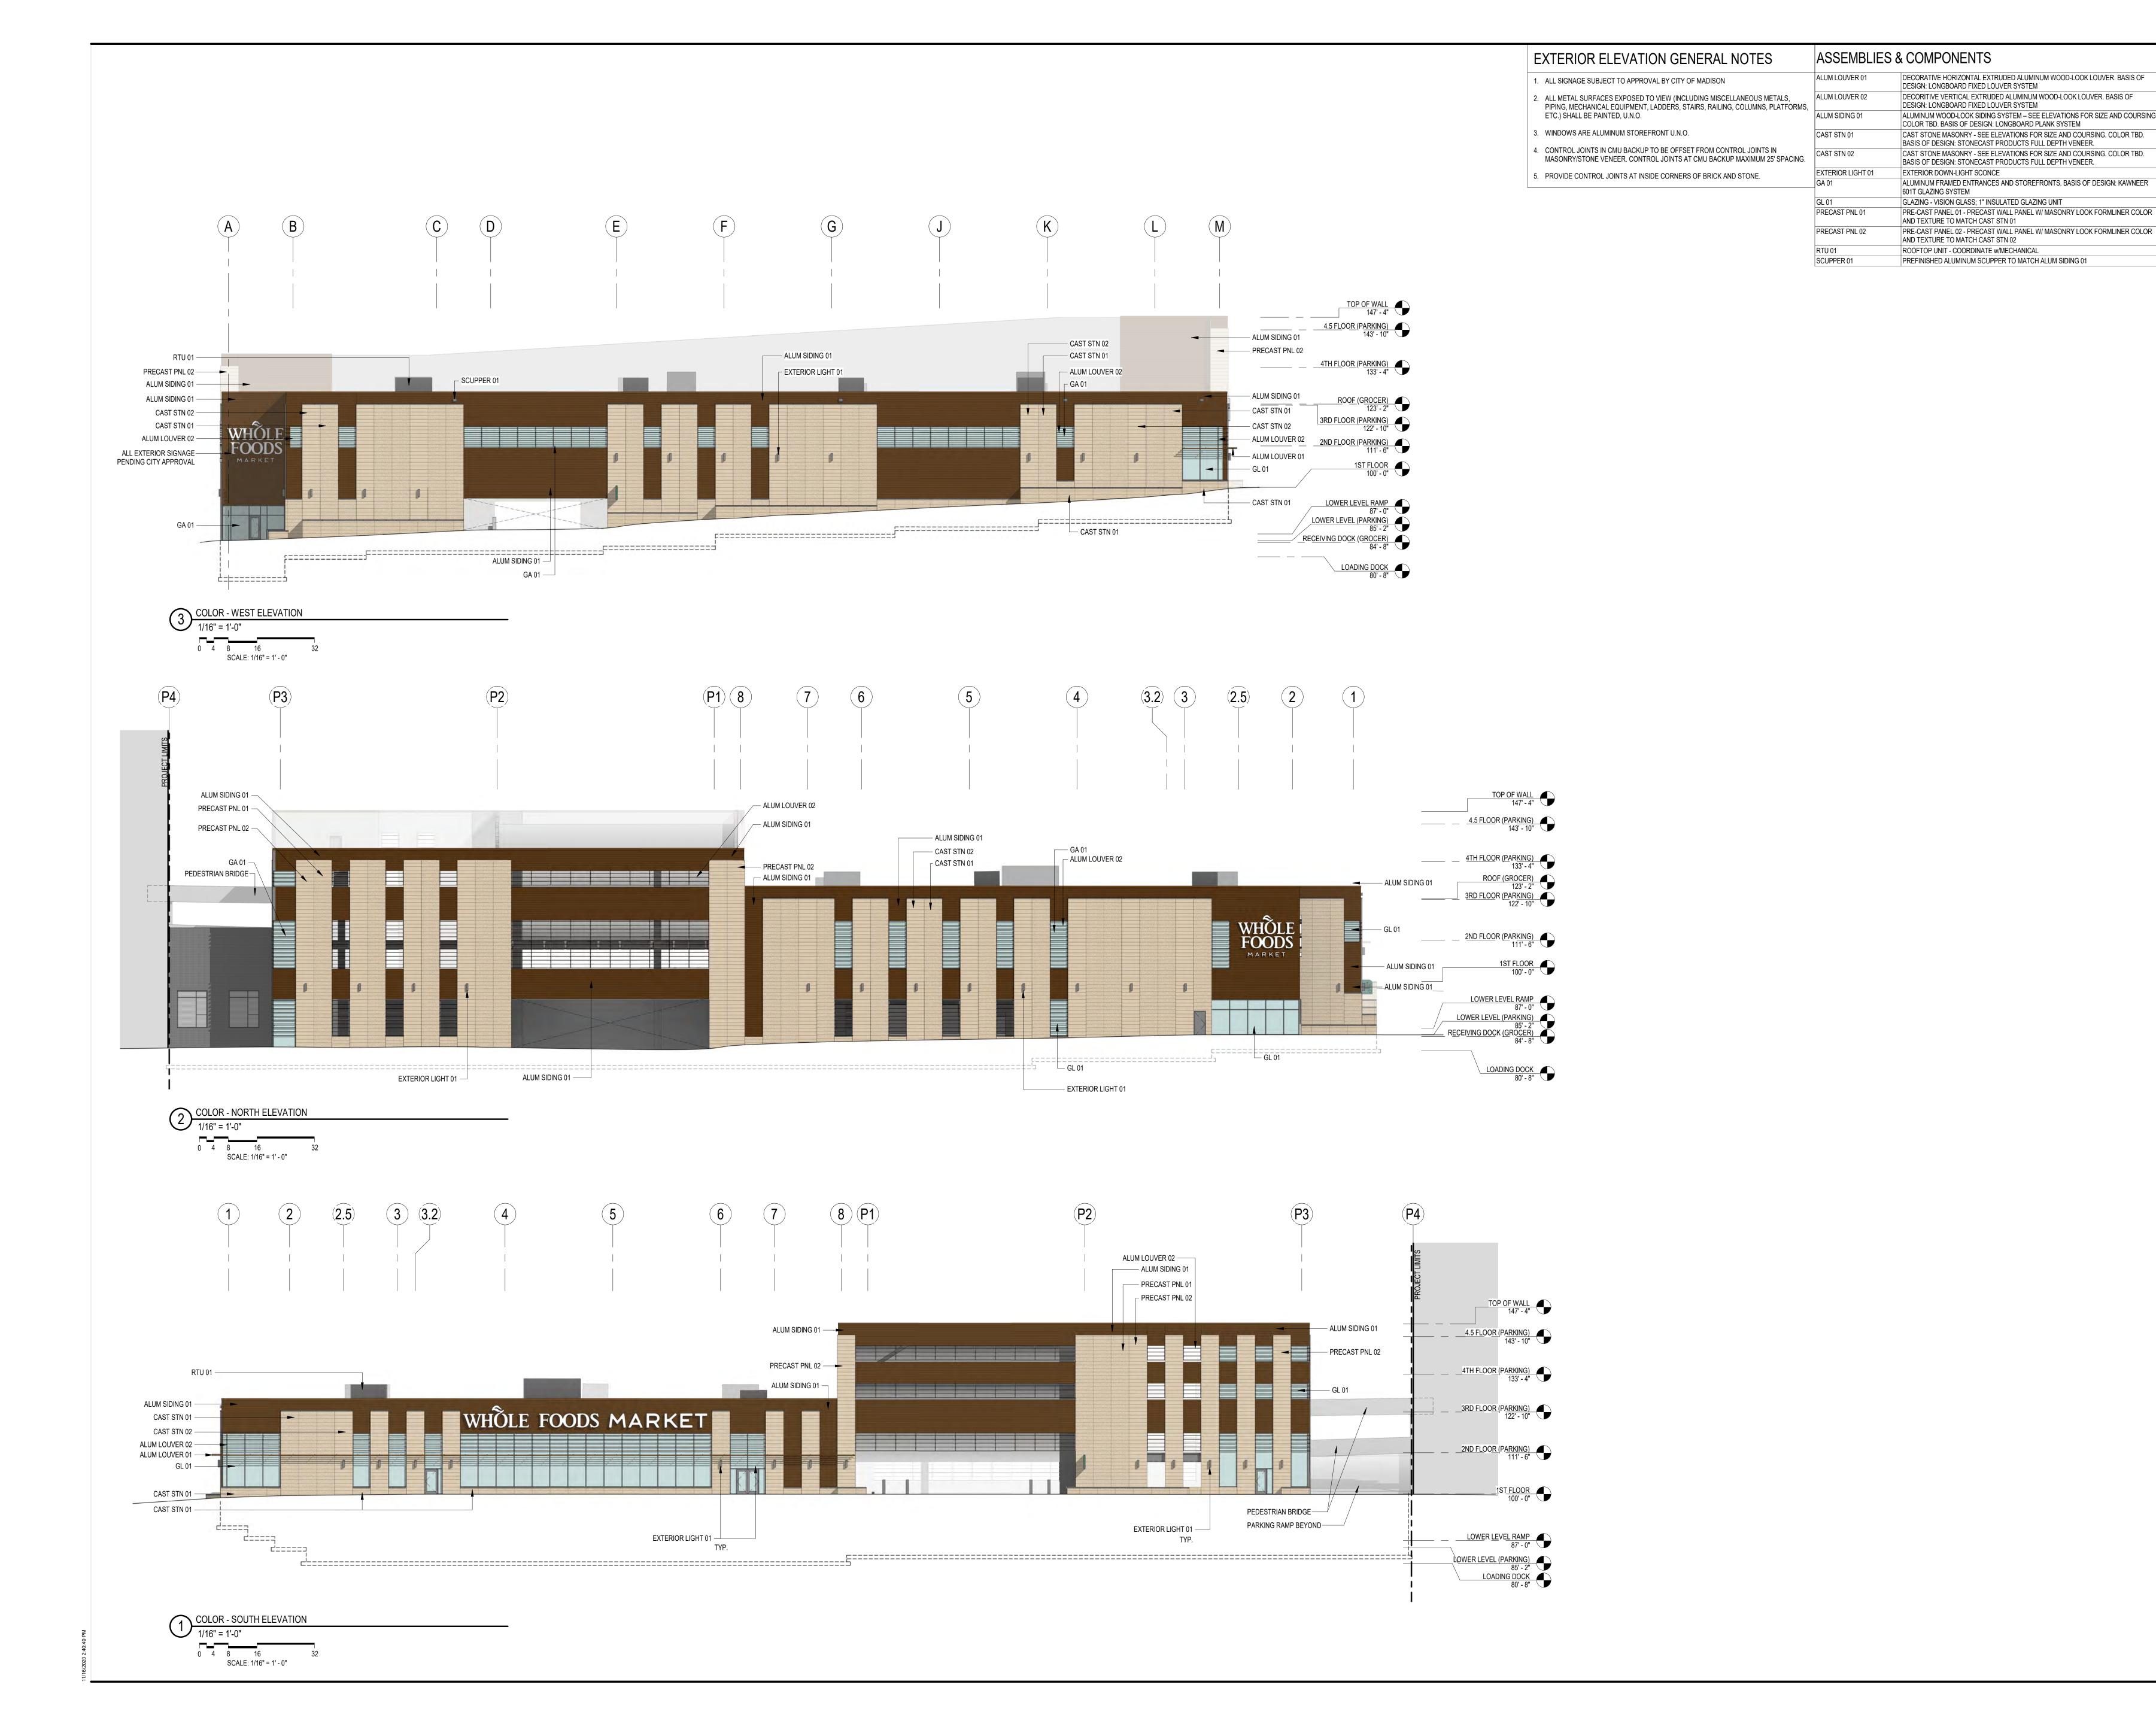
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Sheet No.
A2-A10

Sheet Title



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MADISON YARDS: BLOCK 2 - GROCER BASE CORE & SHELL

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EXTERIOR ELEVATIONS

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Sheet No.
A2-A10C

EXTERIOR ELEVATION GENERAL NOTES	ASSEMBLIES &	& COMPONENTS
ALL SIGNAGE SUBJECT TO APPROVAL BY CITY OF MADISON	ALUM LOUVER 01	DECORATIVE HORIZONTAL EXTRUDED ALUMINUM WOOD-LOOK LOUVER. BASIS (DESIGN: LONGBOARD FIXED LOUVER SYSTEM
ALL METAL SURFACES EXPOSED TO VIEW (INCLUDING MISCELLANEOUS METALS, PIPING, MECHANICAL EQUIPMENT, LADDERS, STAIRS, RAILING, COLUMNS, PLATFORMS,	ALUM LOUVER 02	DECORITIVE VERTICAL EXTRUDED ALUMINUM WOOD-LOOK LOUVER. BASIS OF DESIGN: LONGBOARD FIXED LOUVER SYSTEM
ETC.) SHALL BE PAINTED, U.N.O.	ALUM SIDING 01	ALUMINUM WOOD-LOOK SIDING SYSTEM – SEE ELEVATIONS FOR SIZE AND COUCOLOR TBD. BASIS OF DESIGN: LONGBOARD PLANK SYSTEM
WINDOWS ARE ALUMINUM STOREFRONT U.N.O.	CAST STN 01	CAST STONE MASONRY - SEE ELEVATIONS FOR SIZE AND COURSING. COLOR TE BASIS OF DESIGN: STONECAST PRODUCTS FULL DEPTH VENEER.
CONTROL JOINTS IN CMU BACKUP TO BE OFFSET FROM CONTROL JOINTS IN MASONRY/STONE VENEER. CONTROL JOINTS AT CMU BACKUP MAXIMUM 25' SPACING.	CAST STN 02	CAST STONE MASONRY - SEE ELEVATIONS FOR SIZE AND COURSING. COLOR TE BASIS OF DESIGN: STONECAST PRODUCTS FULL DEPTH VENEER.
PROVIDE CONTROL JOINTS AT INSIDE CORNERS OF BRICK AND STONE.	EXTERIOR LIGHT 01	EXTERIOR DOWN-LIGHT SCONCE
THE TOTAL SOUTH OF THE STATE OF BRUSE AND STORE.	GA 01	ALUMINUM FRAMED ENTRANCES AND STOREFRONTS. BASIS OF DESIGN: KAWNE 601T GLAZING SYSTEM
	ROOF EDGE 01	PREFINISHED METAL ROOF EDGE SYSTEM, COLOR TO MATCH MF-1

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ROOF EDGE 01 ———	
ALUM SIDING 01 ————	
CAST STN 01 ———	
CAST STN 02 ———	WUNT FOOD
ALUM LOUVER 02 —	WINDLE FUODS MARKET
ALUM LOUVER 01 ————	
EXTERIOR LIGHT 01 ————	
GA 01 ————	
CAST STN 01	

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Drawing Date NOVEMBER 17, 2020

MADISON YARDS: BLOCK 2 - GROCER BASE CORE & SHELL

UNIVERSITY AVENUE AT GARDNER ROAD

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PERSPECTIVES

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Sheet No.
A2-A20



ALMA SIDINS of ALMA ICOVER 22

SOUTHEAST PERSPECTIVE 2

NOT TO SCALE

SOUTHEAST PERSPECTIVE

NOT TO SCALE

NO 2. 10. 20

EXTERIOR ELEVATION GENERAL NOTES	ASSEMBLIES	S & COMPONENTS
ALL SIGNAGE SUBJECT TO APPROVAL BY CITY OF MADISON	ALUM LOUVER 01	DECORATIVE HORIZONTAL EXTRUDED ALUMINUM WOOD-LOOK LOUVER. BASIS DESIGN: LONGBOARD FIXED LOUVER SYSTEM
2. ALL METAL SURFACES EXPOSED TO VIEW (INCLUDING MISCELLANEOUS METALS, PIPING, MECHANICAL EQUIPMENT, LADDERS, STAIRS, RAILING, COLUMNS, PLATFORMS,	ALUM LOUVER 02	DECORITIVE VERTICAL EXTRUDED ALUMINUM WOOD-LOOK LOUVER. BASIS OF DESIGN: LONGBOARD FIXED LOUVER SYSTEM
ETC.) SHALL BE PAINTED, U.N.O.	ALUM SIDING 01	ALUMINUM WOOD-LOOK SIDING SYSTEM – SEE ELEVATIONS FOR SIZE AND COLOR TBD. BASIS OF DESIGN: LONGBOARD PLANK SYSTEM
3. WINDOWS ARE ALUMINUM STOREFRONT U.N.O.	CAST STN 01	CAST STONE MASONRY - SEE ELEVATIONS FOR SIZE AND COURSING. COLOR T BASIS OF DESIGN: STONECAST PRODUCTS FULL DEPTH VENEER.
4. CONTROL JOINTS IN CMU BACKUP TO BE OFFSET FROM CONTROL JOINTS IN MASONRY/STONE VENEER. CONTROL JOINTS AT CMU BACKUP MAXIMUM 25' SPACING.	CAST STN 02	CAST STONE MASONRY - SEE ELEVATIONS FOR SIZE AND COURSING. COLOR T BASIS OF DESIGN: STONECAST PRODUCTS FULL DEPTH VENEER.
5. PROVIDE CONTROL JOINTS AT INSIDE CORNERS OF BRICK AND STONE.	EXTERIOR LIGHT 01	EXTERIOR DOWN-LIGHT SCONCE
C. TROVIDE CONTROL CONTROL NO MICHO OF BRIGHTAND CHOILE.	GA 01	ALUMINUM FRAMED ENTRANCES AND STOREFRONTS. BASIS OF DESIGN: KAWN 601T GLAZING SYSTEM
	ROOF EDGE 01	PREFINISHED METAL ROOF EDGE SYSTEM, COLOR TO MATCH MF-1

SMITH Gilbane



		ROOF EDGE 01
		ALUM SIDING 01 CAST STN 02
		CAST STN 01
WHÔLE		GA 01
FOODS	FOOM	ALUM LOUVER 02
MARKET	MARKET	EXTERIOR LIGHT 01

Revisions

GMP/SIP PACKAGE

Drawing Date

NOVEMBER 17, 2020

MADISON YARDS: BLOCK 2 - GROCER BASE CORE & SHELL

UNIVERSITY AVENUE AT GARDNER ROAD

Project No. SUMMIT SMITH/GILBANE 219143.00

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PERSPECTIVES

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Sheet No.
A2-A21

NORTHWEST PERSPECTIVE

NOT TO SCALE






SOUTHWEST PERSPECTIVE

NOT TO SCALE

NORTHWEST PERSPECTIVE
NOT TO SCALE

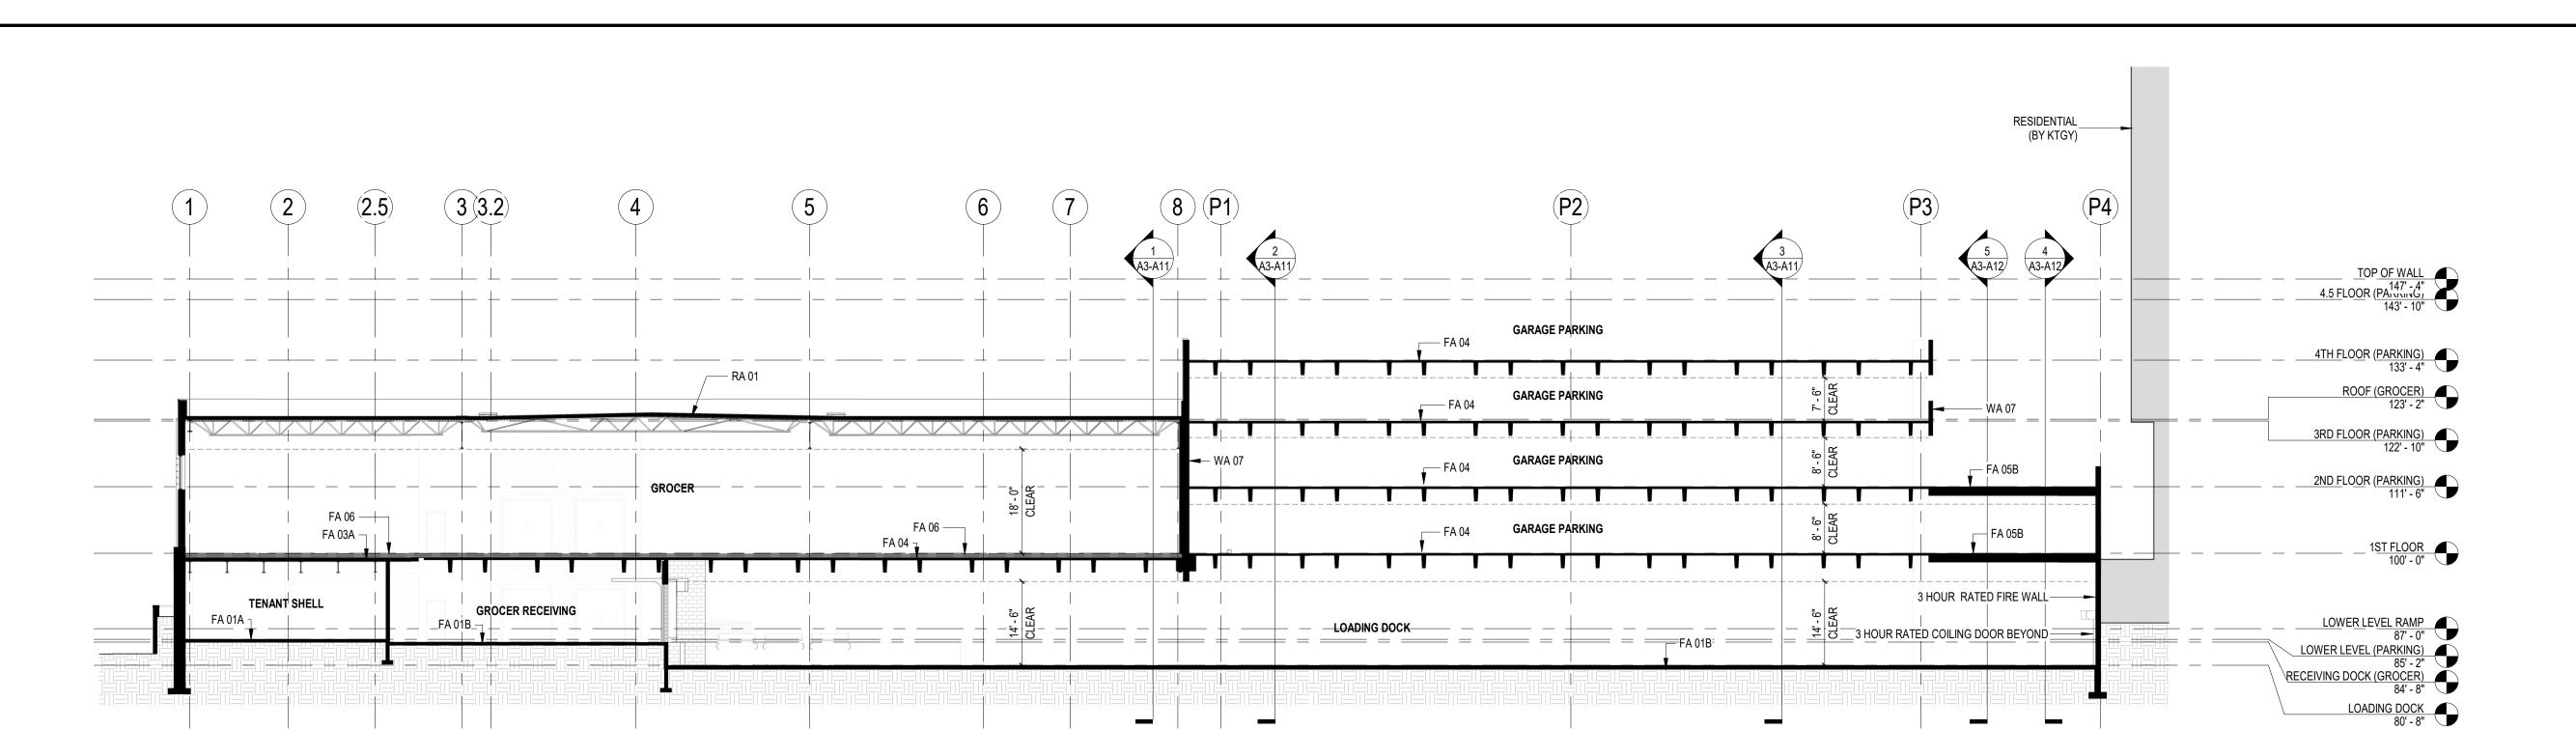

1	
ASSEMBL	IES & COMPONENTS
FA 01A	6" CONCRETE SLAB ON GRADE OVER VAPOR RETARDER OVER COMPACTED GRANULAR FILL
FA 01B	8" CONCRETE SLAB ON GRADE OVER VAPOR RETARDER OVER COMPACTED GRANULAR FILL
FA 02	6" CONCRETE SLAB ON GRADE ON 2" OF EXTRUDED POLYSTYRENE INSULATION WITH RADIENT HEAT SNOW MELT SYSTEM OVER VAPOR RETARDER OVER COMPACTED GRANULAR FILL
FA 03A	7" CONCRETE ON COMPOSITE METAL DECK ON STEEL BEAMS WITH SPRAY APPLIED FIREPROOFING (1-HOUR FIRE RATING)
FA 04	PRECAST CONCRETE DOUBLE TEE - SEE STRUCTURAL
FA 05B	4" CONCRETE SLAB ON 2" OF EXTRUDED POLYSTYRENE INSULATION WITH RADIENT HEAT SNOW MELT SYSTEM ON PRECAST CONCRETE PLANK - SEE STRUCTURAL
FA 06	5" CONCRETE SLAB (BY TENANT) ON 4" OF 40 PSI EXTRUDED POLYSTYRENE INSULATION (R-20 MINIMUM) & WATERPROOFING MEMBRANE, OVER FLOOR ASSEMBLY 03A
RA 01	FULLY ADHERED TPO MEMBRANE ON RIGID INSULATION, VAPOR RETARDER, COVERBOARD, METAL DECK OVER STRUCTURAL STEEL JOISTS WITH SPRAY APPLIED FIREPROOFING (1-HOUR FIRE RATING MINIMUM)
WA 07	PRECAST CONCRETE WALL - PAINTED - REFER TO ASSEMBLIES SHEET FOR MORE INFORMATION

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MADISON YARDS: BLOCK 2 - GROCER BASE CORE & SHELL

UNIVERSITY AVENUE AT GARDNER ROAD


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Sheet Title **BUILDING SECTIONS**

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Sheet No. A3-A10



FA 01A ¬

8 BUILDING SECTION 8 - E/W AT LOADING DOCK
1/16" = 1'-0"

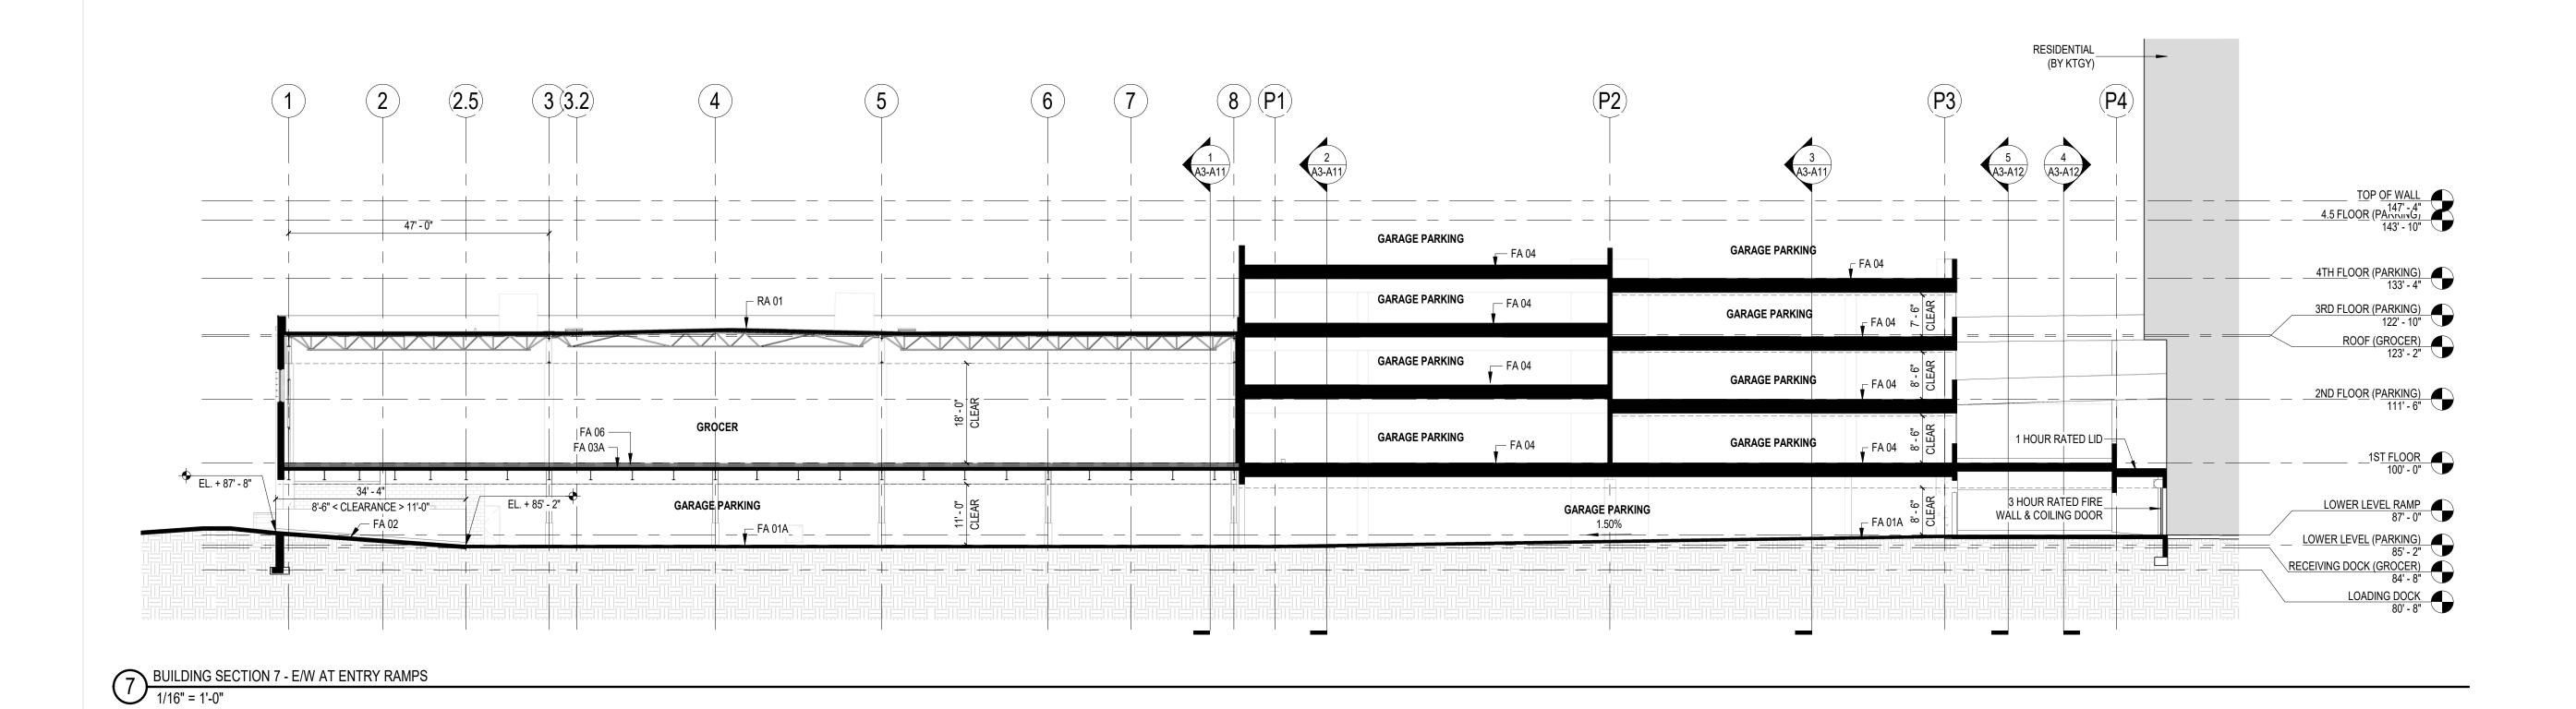COLUMN FURRING (TYPICAL AT ALL GROCER COLUMNS)

GARAGE PARKING

FA 06 —

FA 03A \neg

GARAGE PARKING **GARAGE PARKING** FA 04 \neg GARAGE PARKING 1.50%

GARAGE PARKING

GARAGE PARKING

FA 04 \neg

FA 04 ¬

ROOF (GROCER) 123' - 2"

2ND FLOOR (PARKING) 111' - 6"

LOWER LEVEL RAMP LOWER LEVEL (PARKING)

RECEIVING DOCK (GROCER)
84' - 8"

6 BUILDING SECTION 6 - E/W 1/16" = 1'-0"

4005140	
ASSEMBL	LIES & COMPONENTS
FA 01A	6" CONCRETE SLAB ON GRADE OVER VAPOR RETARDER OVER COMPACTED GRANULAR FILL
FA 01B	8" CONCRETE SLAB ON GRADE OVER VAPOR RETARDER OVER COMPACTED GRANULAR FILL
FA 03A	7" CONCRETE ON COMPOSITE METAL DECK ON STEEL BEAMS WITH SPRAY APPLIED FIREPROOFING (1-HOUR FIRE RATING)
FA 04	PRECAST CONCRETE DOUBLE TEE - SEE STRUCTURAL
FA 06	5" CONCRETE SLAB (BY TENANT) ON 4" OF 40 PSI EXTRUDED POLYSTYRENE INSULATION (R-20 MINIMUM) & WATERPROOFING MEMBRANE, OVER FLOOR ASSEMB 03A
FN 01	CAST-IN-PLACE CONCRETE FOUNDATION WALL - REFER TO ASSEMBLIES SHEET FOR MORE INFORMATION
RA 01	FULLY ADHERED TPO MEMBRANE ON RIGID INSULATION, VAPOR RETARDER, COVERBOARD, METAL DECK OVER STRUCTURAL STEEL JOISTS WITH SPRAY APPLIE FIREPROOFING (1-HOUR FIRE RATING MINIMUM)

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Drawing Date NOVEMBER 17, 2020

MADISON YARDS: BLOCK 2 - GROCER BASE CORE & SHELL

UNIVERSITY AVENUE AT GARDNER ROAD


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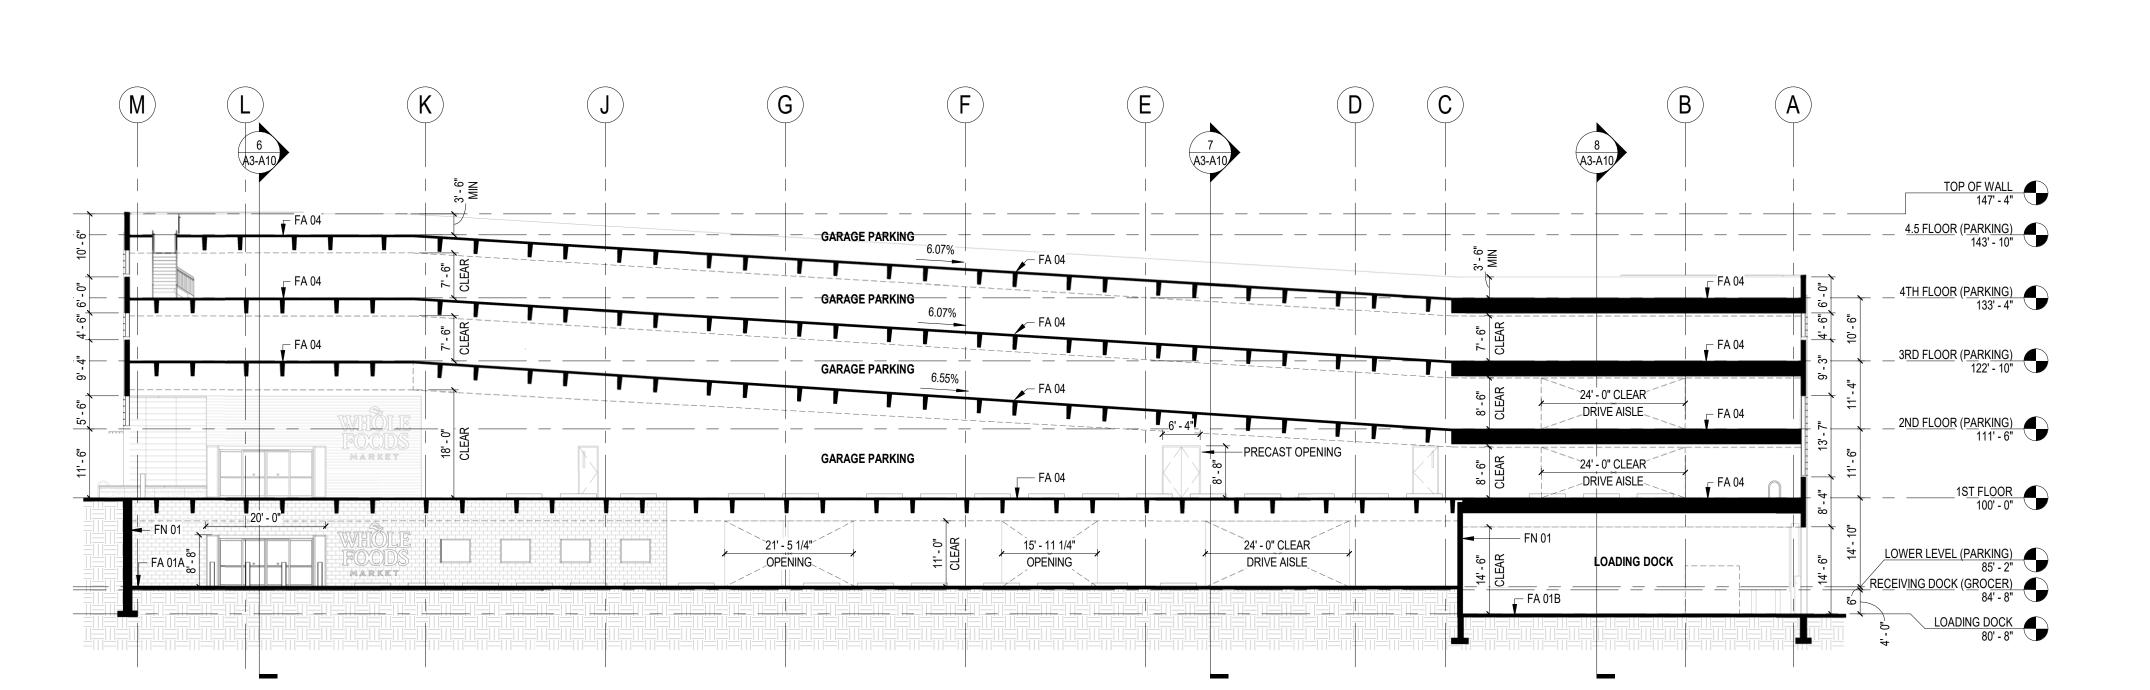
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Sheet No. A3-A11





BUILDING SECTION 2 - N/S AT PARKING
1/16" = 1'-0"

┌─ RA 01 **ELEVATOR LOBBY GROCER** ─ FA 03A FA 06 FA 03A ⊢ FA 04 24' - 0" CLEAR DRIVE AISLE ENTRY GARAGE PARKING ELEV. LOBBY LOADING DOCK FA 01A FA 01B LOWER LEVEL (PARKING) 85' - 2" RECEIVING DOCK (GROCER) 84' - 8"

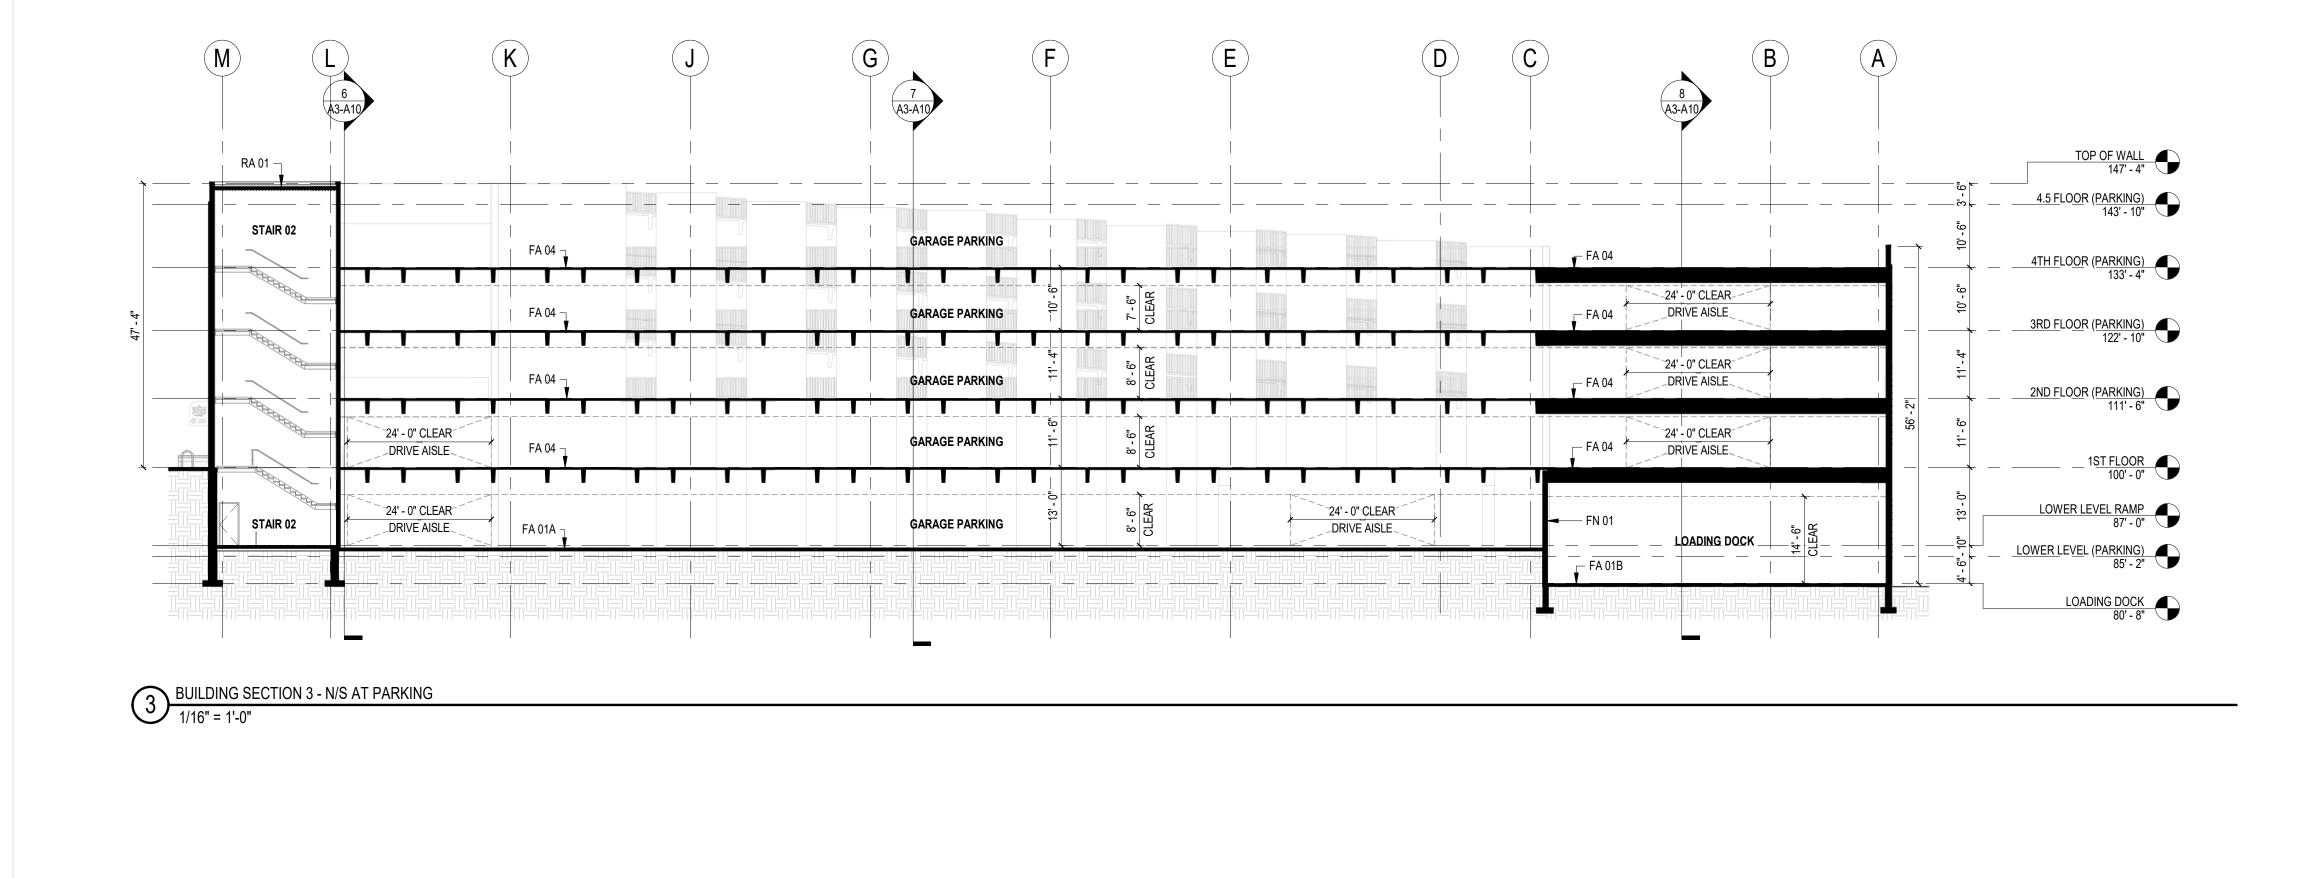LOADING DOCK 80' - 8"

BUILDING SECTION 1 - N/S AT GROCER
1/16" = 1'-0"

ALUM LOUVER 02	DECORITIVE VERTICAL EXTRUDED ALUMINUM WOOD-LOOK LOUVER. BASIS OF DESIGN: LONGBOARD FIXED LOUVER SYSTEM
ALUM SIDING 01	ALUMINUM WOOD-LOOK SIDING SYSTEM – SEE ELEVATIONS FOR SIZE AND COUF COLOR TBD. BASIS OF DESIGN: LONGBOARD PLANK SYSTEM
CONCRETE 02	PRE-CAST CONCRETE
FA 01A	6" CONCRETE SLAB ON GRADE OVER VAPOR RETARDER OVER COMPACTED GRANULAR FILL
FA 01B	8" CONCRETE SLAB ON GRADE OVER VAPOR RETARDER OVER COMPACTED GRANULAR FILL
FA 02	6" CONCRETE SLAB ON GRADE ON 2" OF EXTRUDED POLYSTYRENE INSULATION RADIENT HEAT SNOW MELT SYSTEM OVER VAPOR RETARDER OVER COMPACTE GRANULAR FILL
FA 05A	PRECAST CONCRETE PLANK - SEE STRUCTURAL
FA 05B	4" CONCRETE SLAB ON 2" OF EXTRUDED POLYSTYRENE INSULATION WITH RADIE HEAT SNOW MELT SYSTEM ON PRECAST CONCRETE PLANK - SEE STRUCTURAL
FN 01	CAST-IN-PLACE CONCRETE FOUNDATION WALL - REFER TO ASSEMBLIES SHEET MORE INFORMATION
GA 01	ALUMINUM FRAMED ENTRANCES AND STOREFRONTS. BASIS OF DESIGN: KAWNE 601T GLAZING SYSTEM
PRECAST PNL 01	PRE-CAST PANEL 01 - PRECAST WALL PANEL W/ MASONRY LOOK FORMLINER CO AND TEXTURE TO MATCH CAST STN 01
PRECAST PNL 02	PRE-CAST PANEL 02 - PRECAST WALL PANEL W/ MASONRY LOOK FORMLINER CC AND TEXTURE TO MATCH CAST STN 02
WA 07	PRECAST CONCRETE WALL - PAINTED - REFER TO ASSEMBLIES SHEET FOR MORINFORMATION
WA 07X	FULL DEPTH BRICK MASONRY VENEER (MATCH RESIDENTIAL BUILDING) ON PREC CONCRETE BACKUP WALL - REFER TO ASSEMBLIES SHEET FOR MORE INFORMA



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MADISON YARDS: BLOCK 2 - GROCER BASE CORE & SHELL

UNIVERSITY AVENUE AT GARDNER ROAD

Project No. SUMMIT SMITH/GILBANE 219143.00


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Sheet No. A3-A12

	6 A3-A10	A3-A10		8 A3-A10	
		PERFORATED ACCENT PANELS DESIGN TBD - CONTRATOR TO ESTABLISH BUDGET -ALLOWANCE W/ OWNER	PEDESTRIAN WALKWAY ENCLOSURE TO BE 50% OPEN MINIMUM. DESIGN TBD - CONTRATOR TO ESTABLISH BUDGET ALLOWANCE W/ OWNER—	CONCRETE 02	TOP OF V
	ALUM SIDING 01 PRECAST PNL 02 CONCRETE 02			PRECAST PNL 01	
	<u> </u>				4 <u>TH FLOOR</u> (PAF
		0-10-10-10-10-10-10-10-10-10-10-10-10-10			
DUVER 02			FA 05A WA 07	FA 05B PARKING	2 <u>ND FLOOR</u> (<u>PA</u>
GA 01 -		FA 05B —	8.33% FA 05B 12.61% FA 05B	8.33% FA 05B PARKING WA 07X	5 - - - - - - - - - - - - - - - - - - -
		FN 01 PARKING FA 02	14.67%	OMH)	13' - 0"
== == == 	== == == == == == ==		8.3370 FN 01	FA 01B	LOWER LEVEL
					LOADIN



BUILDING SECTION 5 - N/S AT SPEED RAMP

1/16" = 1'-0"

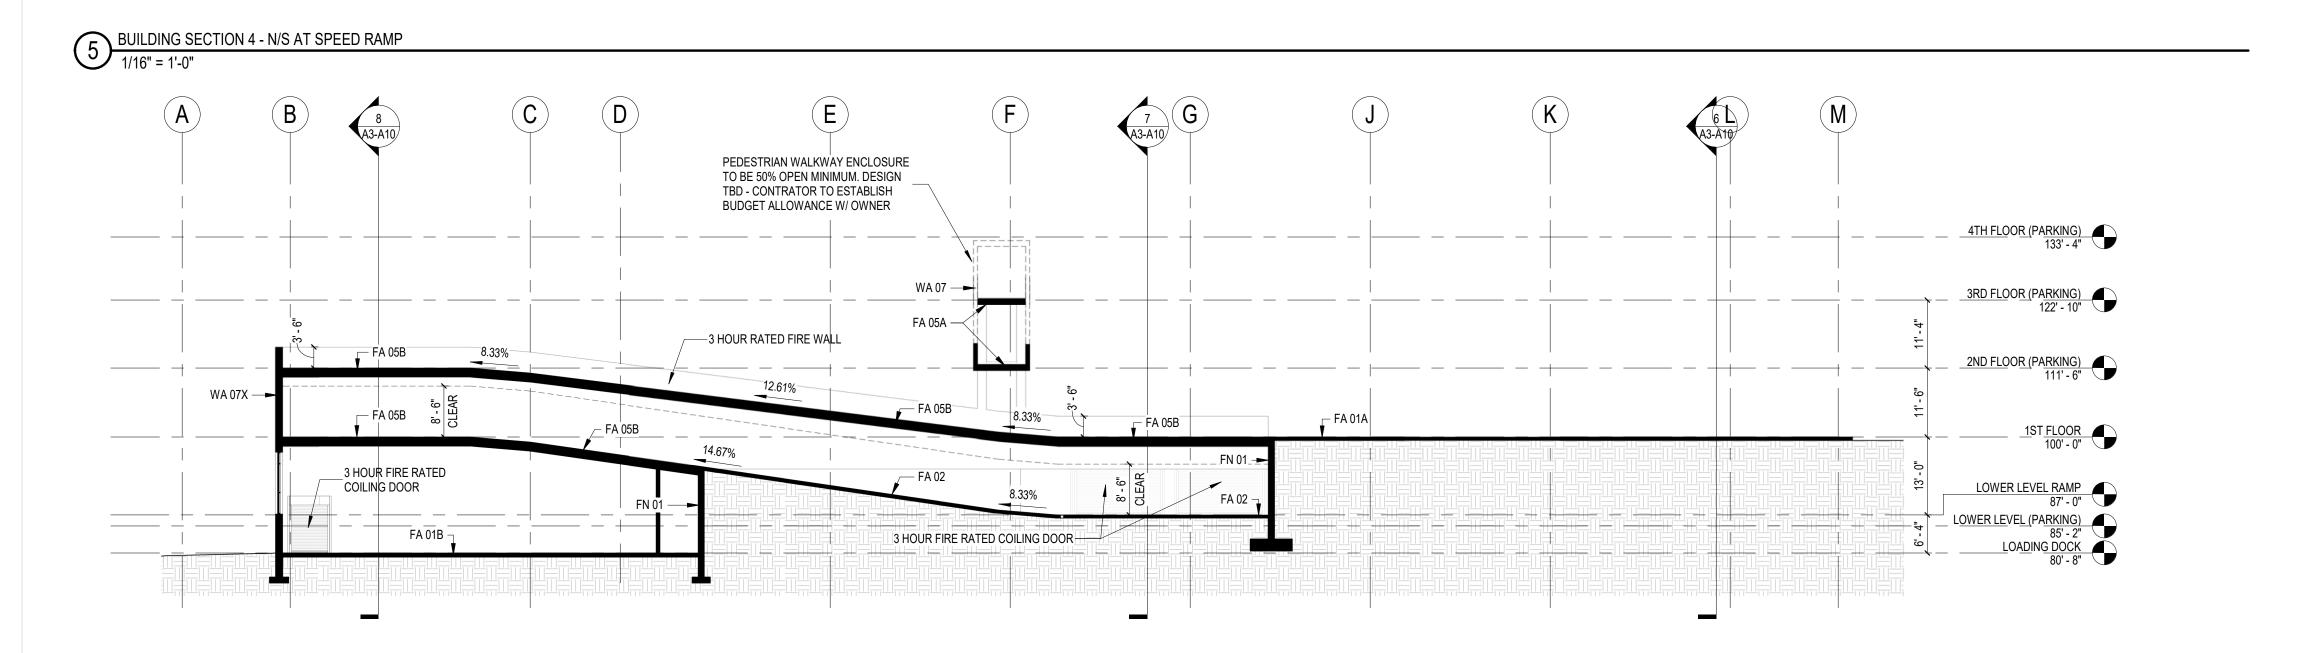CONSULTANTS

OWNER/DEVELOPER

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<u>ARCHITECT</u>

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LANDSCAPE ARCHITECT

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INTERIOR DESIGNER

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JSD PROFESSIONAL SERVICES, INC. 161 HORIZON DRIVE, SUITE 101 VERONA, WI 53593 P: 608.848.5060 KEVIN YESKA: KEVIN.YESKA@JSDINC.COM

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LATIMER SOMMERS & ASSOCIATES 3639 SW SUMMERFIELD DRIVE, SUITE A **TOPEKA, KA 66614** P:785.233.3232 DAVID EVERHART: DEVERHART@LSAPA.COM



MADISON YARDS BLOCK 2 BUILDING B

NEW CONSTRUCTION ISSUE FOR SIP REVIEW 11/17/20







HILL FARMS

KTGY Project No: 20200326

Eric Lukacsik elukacsik@ktgy.com Craig Pryde Principal: Project Designer:

Developer



PHONE NO.

2

No.	Date	Description
	09/25/20	PRELIMINARY PRICING
	11/17/20	ISSUE FOR SIP REVIEW
riting of any pontractor thore onstruction she croeived error ient's subconting the contraction of the contr	erceived errors or omission oughly knowledgeable with ould reasonably be aware s or omissions shall be re	uring construction to notify the architect in ons in the plans and specifications of which the building codes and methods of . Written instructions addressing such ceived from the architect prior to the client he work. The client will be responsible for a

BUILDING B

A0-B00

Elevators (Section 3006)				
	Required	Provided		
Emergency Communication for hearing and speech impaired (Section 30001.2)	Yes	Yes		
Number of Elevator cars in a hoistway (Section 3002.2)	4	3		
Elevator Car to Accommodate Ambulance Stretcher (Section 3002.4)				
	Yes	Yes		
Elevator Lobbies and Hoistway Protection (Section 3006.1)	Yes	Yes	comply with (Section	vacuation elevators are provided, enclosed elevator lobbies shall
Rated Corridor (Section 3006.2.1)	Yes	Yes		required to be fire-resistance rated in accordance with Section way openings shall be protected in accordance with Section 3006.3
Hoistway Opening Protection			Both a Fire Service A	ccess Elevators and Fire Service Access Elevator Lobby are provided
(Section 3006.3)	No	No		
Number of Evacuation Elevators (Section 3008.1.1)	2	2		all be provided in each occupant evacuation elevator lobby where tor opens into the lobby.
Fire Service Access Elevators Lobby (Section 3007.6)	Yes	Yes		2 requires protection of the elevator hoistway door opening, the rovided by: An enclosed elevator lobby or additional hoistway doors
Access to interior exit	163	163		Direct access or access through a protected path
stairway	Yes	Yes	(Section 3007.6.1)	
Lobby Enclosure	Yes	Yes	(Section 3008.6.1) (Section 3007.6.2) (Section 3008.6.2) (Section 708)	Direct access or access through a protected path 1 HR rated Fire Partition 1 HR rated Fire Partition Smoke Proof Partitions
Lobby Doors	Yes	Yes	(Section 3007.6.3) (Section 3008.6.3) (Section 3008.6.3)	Enclosure not required at level of Exit Discharge (Section 716) 3/4HR Fire Doors Assembly (Section 716) 3/4HR Fire Doors Assembly (Section 716.2.2.1.1) Smoke And Daft Control Door Assembly
Lobby Size	150 sq. ft. 72 sq. ft.	256 sq. ft. 256 sq. ft.	(Section 3006.4) (Section 3008.6.4)	Fire service access elevator lobby shall not be less than 150 sq. ft. 3 sq ft per Occupant or not less then 25% of the Occupant Load of floor 18,600 sq. ft. / 200 gross sq. ft. 93 Maximum Total Occupa
Two-way			(Section 3008.6.3.1)	(Section 716) A vision panel shall be installed in each Door From Evacuation Lobby to Fire Command Center or alternate
Communication	Yes	Yes	(Section 3008.6.6)	location approved by the Fire Department
Protected Duct Penetrations	Yes	Yes	(Section 3006.3)	(Section 717.5.4.1) Protection of duct penetrations from corridor
Automatic Sprinkler				(Section 903.3.1.1) Automatic sprinkler system
System	Yes	Yes	(Section 3006.3) (Section 3008.2)	

Occupant Load (Section 1004.5)			
R2	Allowable 200 Gross	Actual T.B.D.	Refer to Plans for Actual Occupant Load
B A-3	200 Gross 150 Gross	T.B.D. T.B.D.	Refer to Plans for Actual Occupant Load Refer to Plans for Actual Occupant Load
S-2	15 Net	T.B.D.	Refer to Plans for Actual Occupant Load
Spaces with one Exit / Exit Access Doorway Common path of Travel (Table 1006.2.1)	Occupancy Allowable	Occupancy Actual	Actual Building equipped throughout with sprinkler (Section 903.1.1) and (Section Travel 403.3.3)
R2	49	T.B.D.	T.B.D. 125'-0" Maximum common path of travel
B A-3	49 49	T.B.D. T.B.D.	T.B.D. 100'-0" Maximum common path of travel T.B.D. 75'-0" Maximum common path of travel
S-2 Minimum Number of Exits per	29	T.B.D.	T.B.D. 100'-0" Maximum common path of travel 1- 500 Occupants per Story
Story (Table 1006.3.2)	Required 2	Provided 2	
Remoteness of Exits (Section 1015) High-Rise (Section 403.5.1)	Allowable	Actual	30'-0" Minimum separation or not less than one forth the maximum overall diagonal dimension of the building area
Length of Exit Access Travel (Table 1017.2)	30'-0" Maximum Travel	T.B.D. Actual Travel	Building equipped throughout with sprinklers as per (Section 903.1.1) and (Section 403.3.3)
R2 B	250'-0" 250'-0"	T.B.D. T.B.D.	Refer to Plans for Travel Path Provided Refer to Plans for Travel Path Provided
A-3	250'-0"	T.B.D.	Refer to Plans for Travel Path Provided
S-2 Dead End Corridor (Section	400'-0" Maximum	T.B.D. Actual	Refer to Plans for Travel Path Provided In Occupancies in Groups B, R-2, s where the building equipped throughout with
1020.4) Exception 2.	50'-0"	T.B.D.	sprinklers as per (Section 903.1.1) and (Section 403.3.3)
Corridor Continuity (Section 1020.6) Exception 1. and 2	rooms 2. Enc		otion rooms constructed as required for Corridors shall not be construed as intervening or lobbies as permitted by Item 1 of Section 1016.2 shall not be construed as intervening
Egress through intervening		_	enclosed elevator lobby is permitted. Access to not less than one of the required Exits sha
Spaces (Section 1016.2)	·		el through the enclosed elevator lobbies required by Section 3006
Exit Discharge (Section 1028.1) Exceptions 1.		•	t of the number and minimum width or required capacity of interior exit stairways and gress through areas on the level of discharge, provided that ALL of the following conditions
	Comply	_	ge shall be provided with a free and unobstructed path of travel to an exterior exit door xit is readily visible and identifiable from the point of termination of the enclosure.
	Comply	1.2 The enti	ire area of level of exit discharge is separated from areas below by construction
	Comply	1.3. The egre	to the fire-resistance rating for the enclosures. ress path at the level of discharge and spaces with access to the egress path shall be
	Comply		hroughout by an automatic sprinklered system in accordance with Section 903.3.1.1 he termination of the Exit Accessed Stairway and Exit discharge door of the Interior Exit
	Comp.,	Stairway are	re at the same level of exit discharge, they shall be separated by a distance of not less then one-forth the length of the overall diagonal dimension of the building, which ever is less,
			aged in a straight line.
Accessible Means of Egress			ans of egress is required by Section 1006.2 or 1006.3 from any accessible space, each
(Table 1006.3.2)	accessible po	rtion of the s _l	space shall be served by not less than two accessible means of egress.
Stairs Accessible Requirements (Sections 1009.3)			In order to be considered part of an acceptable means of egress a stairway between stories shall comply with section 1009.3.1 to 1009.3.3
	Required		
Stair Width		Provided	Exception 1: The clear width of 48" between handrails is not required with an Automatic
(Section 1009.3.2.) Exception	No		Exception 1: The clear width of 48" between handrails is not required with an Automatic Sprinkler System installed in accordance with (Section 903.1.1.1)
(Section 1009.3.2.) Exception 1.	No	Provided No	Sprinkler System installed in accordance with (Section 903.1.1.1)
(Section 1009.3.2.) Exception 1. Area of Refuge Stairs			
(Section 1009.3.2.) Exception 1. Area of Refuge Stairs			Sprinkler System installed in accordance with (Section 903.1.1.1) Exception 1: Areas of refuge not required in buildings equipped throughout with an
(Section 1009.3.2.) Exception 1. Area of Refuge Stairs (Section 1009.4.2) Exceptions 1 Elevators Accessible Requirements (Section		No	Sprinkler System installed in accordance with (Section 903.1.1.1) Exception 1: Areas of refuge not required in buildings equipped throughout with an
1009.2.1) Stand-by Power	No Required	No No Provided	Sprinkler System installed in accordance with (Section 903.1.1.1) Exception 1: Areas of refuge not required in buildings equipped throughout with an automatic sprinkler system installed in accordance with (Section 903.1.1) In buildings with an accessible floor, four or more stories above level of discharge one
(Section 1009.3.2.) Exception 1. Area of Refuge Stairs (Section 1009.4.2) Exceptions 1 Elevators Accessible Requirements (Section 1009.2.1)	No	No No	Sprinkler System installed in accordance with (Section 903.1.1.1) Exception 1: Areas of refuge not required in buildings equipped throughout with an automatic sprinkler system installed in accordance with (Section 903.1.1) In buildings with an accessible floor, four or more stories above level of discharge one required accessible means of egress shall be an elevator as per (Section 1009.4)
(Section 1009.3.2.) Exception 1. Area of Refuge Stairs (Section 1009.4.2) Exceptions 1 Elevators Accessible Requirements (Section 1009.2.1) Stand-by Power (Section 1009.4.1) Area of Refuge Elevators (Section 1009.4.2)	No Required	No No Provided	Sprinkler System installed in accordance with (Section 903.1.1.1) Exception 1: Areas of refuge not required in buildings equipped throughout with an automatic sprinkler system installed in accordance with (Section 903.1.1) In buildings with an accessible floor, four or more stories above level of discharge one required accessible means of egress shall be an elevator as per (Section 1009.4)
(Section 1009.3.2.) Exception 1. Area of Refuge Stairs (Section 1009.4.2) Exceptions 1 Elevators Accessible Requirements (Section 1009.2.1) Stand-by Power (Section 1009.4.1) Area of Refuge Elevators (Section 1009.4.2) Exceptions 1 Two-way Communication	No Required Yes	No No Provided Yes	Exception 1: Areas of refuge not required in buildings equipped throughout with an automatic sprinkler system installed in accordance with (Section 903.1.1) In buildings with an accessible floor, four or more stories above level of discharge one required accessible means of egress shall be an elevator as per (Section 1009.4) Stand-by power to be provide in accordance with Chapter 27 and Section 3003 Exception 1 Areas of refuge not required in buildings equipped throughout with an automatic sprinkler system installed in accordance with (Section 903.1.1)
(Section 1009.3.2.) Exception 1. Area of Refuge Stairs (Section 1009.4.2) Exceptions 1 Elevators Accessible Requirements (Section 1009.2.1) Stand-by Power (Section 1009.4.1) Area of Refuge Elevators (Section 1009.4.2) Exceptions 1 Two-way Communication Elevators (Section 1009.4.2)	No Required Yes	No No Provided Yes	Exception 1: Areas of refuge not required in buildings equipped throughout with an automatic sprinkler system installed in accordance with (Section 903.1.1) In buildings with an accessible floor, four or more stories above level of discharge one required accessible means of egress shall be an elevator as per (Section 1009.4) Stand-by power to be provide in accordance with Chapter 27 and Section 3003 Exception 1 Areas of refuge not required in buildings equipped throughout with an automatic sprinkler system installed in accordance with (Section 903.1.1) Two-way communication system shall be provided at each required location and the Fire
(Section 1009.3.2.) Exception 1. Area of Refuge Stairs (Section 1009.4.2) Exceptions 1 Elevators Accessible Requirements (Section 1009.2.1) Stand-by Power (Section 1009.4.1) Area of Refuge Elevators (Section 1009.4.2) Exceptions 1 Two-way Communication Elevators (Section 1009.4.2) Stairways	No Required Yes No Yes	No No Provided Yes No Yes	Exception 1: Areas of refuge not required in buildings equipped throughout with an automatic sprinkler system installed in accordance with (Section 903.1.1) In buildings with an accessible floor, four or more stories above level of discharge one required accessible means of egress shall be an elevator as per (Section 1009.4) Stand-by power to be provide in accordance with Chapter 27 and Section 3003 Exception 1 Areas of refuge not required in buildings equipped throughout with an automatic sprinkler system installed in accordance with (Section 903.1.1) Two-way communication system shall be provided at each required location and the Fire
(Section 1009.3.2.) Exception 1. Area of Refuge Stairs (Section 1009.4.2) Exceptions 1 Elevators Accessible Requirements (Section 1009.2.1) Stand-by Power (Section 1009.4.1) Area of Refuge Elevators (Section 1009.4.2) Exceptions 1 Two-way Communication Elevators (Section 1009.4.2) Stairways (Section 1011) Stairway Width	No Required Yes No Yes Required 44"	No No Provided Yes Provided 44"	Exception 1: Areas of refuge not required in buildings equipped throughout with an automatic sprinkler system installed in accordance with (Section 903.1.1) In buildings with an accessible floor, four or more stories above level of discharge one required accessible means of egress shall be an elevator as per (Section 1009.4) Stand-by power to be provide in accordance with Chapter 27 and Section 3003 Exception 1 Areas of refuge not required in buildings equipped throughout with an automatic sprinkler system installed in accordance with (Section 903.1.1) Two-way communication system shall be provided at each required location and the Fire Command Center or Central Location Approved by the Fire Department (Section 1011.2) Measured from wall to wall
(Section 1009.3.2.) Exception 1. Area of Refuge Stairs (Section 1009.4.2) Exceptions 1 Elevators Accessible Requirements (Section 1009.2.1) Stand-by Power (Section 1009.4.1) Area of Refuge Elevators (Section 1009.4.2) Exceptions 1 Two-way Communication Elevators (Section 1009.4.2) Stairways (Section 1011)	No Required Yes No Yes Required 44" 80" 7"	No No Provided Yes Provided 44" 80" T.B.D.	Exception 1: Areas of refuge not required in buildings equipped throughout with an automatic sprinkler system installed in accordance with (Section 903.1.1) In buildings with an accessible floor, four or more stories above level of discharge one required accessible means of egress shall be an elevator as per (Section 1009.4) Stand-by power to be provide in accordance with Chapter 27 and Section 3003 Exception 1 Areas of refuge not required in buildings equipped throughout with an automatic sprinkler system installed in accordance with (Section 903.1.1) Two-way communication system shall be provided at each required location and the Fire Command Center or Central Location Approved by the Fire Department (Section 1011.2) Measured from wall to wall (Section 1011.5.2) Measured vertically tread to nosing (Section 1011.5.2) Maximum Riser
(Section 1009.3.2.) Exception 1. Area of Refuge Stairs (Section 1009.4.2) Exceptions 1 Elevators Accessible Requirements (Section 1009.2.1) Stand-by Power (Section 1009.4.1) Area of Refuge Elevators (Section 1009.4.2) Exceptions 1 Two-way Communication Elevators (Section 1009.4.2) Stairways (Section 1011) Stairway Width Stair Headroom Stair Treads and Risers	No Required Yes No Yes Required 44" 80" 7" 4" 11"	No No Provided Yes No Yes Provided 44" 80" T.B.D. T.B.D. T.B.D.	Exception 1: Areas of refuge not required in buildings equipped throughout with an automatic sprinkler system installed in accordance with (Section 903.1.1) In buildings with an accessible floor, four or more stories above level of discharge one required accessible means of egress shall be an elevator as per (Section 1009.4) Stand-by power to be provide in accordance with Chapter 27 and Section 3003 Exception 1 Areas of refuge not required in buildings equipped throughout with an automatic sprinkler system installed in accordance with (Section 903.1.1) Two-way communication system shall be provided at each required location and the Fire Command Center or Central Location Approved by the Fire Department (Section 1011.2) Measured from wall to wall (Section 1011.5.2) Measured vertically tread to nosing (Section 1011.5.2) Minimum Riser (Section 1011.5.2) Minimum Riser (Section 1011.5.2) Minimum Tread
(Section 1009.3.2.) Exception 1. Area of Refuge Stairs (Section 1009.4.2) Exceptions 1 Elevators Accessible Requirements (Section 1009.2.1) Stand-by Power (Section 1009.4.1) Area of Refuge Elevators (Section 1009.4.2) Exceptions 1 Two-way Communication Elevators (Section 1009.4.2) Stairways (Section 1011) Stairway Width Stair Headroom	No Required Yes No Yes Required 44" 80" 7" 4" 11" 34" to 38" 42"	No No Provided Yes Provided 44" 80" T.B.D. T.B.D.	Exception 1: Areas of refuge not required in buildings equipped throughout with an automatic sprinkler system installed in accordance with (Section 903.1.1) In buildings with an accessible floor, four or more stories above level of discharge one required accessible means of egress shall be an elevator as per (Section 1009.4) Stand-by power to be provide in accordance with Chapter 27 and Section 3003 Exception 1 Areas of refuge not required in buildings equipped throughout with an automatic sprinkler system installed in accordance with (Section 903.1.1) Two-way communication system shall be provided at each required location and the Fire Command Center or Central Location Approved by the Fire Department (Section 1011.2) Measured from wall to wall (Section 1011.5.2) Maximum Riser (Section 1011.5.2) Minimum Riser (Section 1011.5.2) Minimum Tread (Section 1014.2) Height of grip surface (Section 1014.2)
(Section 1009.3.2.) Exception 1. Area of Refuge Stairs (Section 1009.4.2) Exceptions 1 Elevators Accessible Requirements (Section 1009.2.1) Stand-by Power (Section 1009.4.1) Area of Refuge Elevators (Section 1009.4.2) Exceptions 1 Two-way Communication Elevators (Section 1009.4.2) Stairways (Section 1011) Stairway Width Stair Headroom Stair Treads and Risers Height of Handrails	No Required Yes No Yes Required 44" 80" 7" 4" 11" 34" to 38"	No No Provided Yes Provided 44" 80" T.B.D. T.B.D. T.B.D. 34"	Exception 1: Areas of refuge not required in buildings equipped throughout with an automatic sprinkler system installed in accordance with (Section 903.1.1) In buildings with an accessible floor, four or more stories above level of discharge one required accessible means of egress shall be an elevator as per (Section 1009.4) Stand-by power to be provide in accordance with Chapter 27 and Section 3003 Exception 1 Areas of refuge not required in buildings equipped throughout with an automatic sprinkler system installed in accordance with (Section 903.1.1) Two-way communication system shall be provided at each required location and the Fire Command Center or Central Location Approved by the Fire Department (Section 1011.2) Measured from wall to wall (Section 1011.5.2) Measured vertically tread to nosing (Section 1011.5.2) Minimum Riser (Section 1011.5.2) Minimum Riser (Section 1011.5.2) Minimum Tread (Section 1014.2) Height of grip surface
(Section 1009.3.2.) Exception 1. Area of Refuge Stairs (Section 1009.4.2) Exceptions 1 Elevators Accessible Requirements (Section 1009.2.1) Stand-by Power (Section 1009.4.1) Area of Refuge Elevators (Section 1009.4.2) Exceptions 1 Two-way Communication Elevators (Section 1009.4.2) Stairways (Section 1011) Stairway Width Stair Headroom Stair Treads and Risers Height of Handrails Height of Guardrails Stair to Roof	No Required Yes No Yes Required 44" 80" 7" 4" 11" 34" to 38" 42" 4 1/2"	No No Provided Yes Provided 44" 80" T.B.D. T.B.D. T.B.D. 34"	Exception 1: Areas of refuge not required in buildings equipped throughout with an automatic sprinkler system installed in accordance with (Section 903.1.1) In buildings with an accessible floor, four or more stories above level of discharge one required accessible means of egress shall be an elevator as per (Section 1009.4) Stand-by power to be provide in accordance with Chapter 27 and Section 3003 Exception 1 Areas of refuge not required in buildings equipped throughout with an automatic sprinkler system installed in accordance with (Section 903.1.1) Two-way communication system shall be provided at each required location and the Fire Command Center or Central Location Approved by the Fire Department (Section 1011.3) Measured from wall to wall (Section 1011.5.2) Maximum Riser (Section 1011.5.2) Minimum Riser (Section 1011.5.2) Minimum Tread (Section 1014.2) Height of grip surface (Section 1014.8) Maximum Projection
(Section 1009.3.2.) Exception 1. Area of Refuge Stairs (Section 1009.4.2) Exceptions 1 Elevators Accessible Requirements (Section 1009.2.1) Stand-by Power (Section 1009.4.1) Area of Refuge Elevators (Section 1009.4.2) Exceptions 1 Two-way Communication Elevators (Section 1009.4.2) Stairways (Section 1011) Stairway Width Stair Headroom Stair Treads and Risers Height of Handrails Height of Guardrails	No Required Yes No Yes Required 44" 80" 7" 4" 11" 34" to 38" 42" 4 1/2" 1 1/2" Yes	No No Provided Yes Provided 44" 80" T.B.D. T.B.D. T.B.D. 34" 42" Yes	Sprinkler System installed in accordance with (Section 903.1.1.1) Exception 1: Areas of refuge not required in buildings equipped throughout with an automatic sprinkler system installed in accordance with (Section 903.1.1) In buildings with an accessible floor, four or more stories above level of discharge one required accessible means of egress shall be an elevator as per (Section 1009.4) Stand-by power to be provide in accordance with Chapter 27 and Section 3003 Exception 1 Areas of refuge not required in buildings equipped throughout with an automatic sprinkler system installed in accordance with (Section 903.1.1) Two-way communication system shall be provided at each required location and the Fire Command Center or Central Location Approved by the Fire Department (Section 1011.2) Measured from wall to wall (Section 1011.5.2) Maximum Riser (Section 1011.5.2) Minimum Riser (Section 1014.2) Height of grip surface (Section 1014.8) Minimum Projection (Section 1014.8) Maximum Projection (Section 1014.8) Clear space form wall to Rail
(Section 1009.3.2.) Exception 1. Area of Refuge Stairs (Section 1009.4.2) Exceptions 1 Elevators Accessible Requirements (Section 1009.2.1) Stand-by Power (Section 1009.4.1) Area of Refuge Elevators (Section 1009.4.2) Exceptions 1 Two-way Communication Elevators (Section 1009.4.2) Stairways (Section 1011) Stairway Width Stair Headroom Stair Treads and Risers Height of Handrails Height of Guardrails Stair to Roof Corridors (Section 1018) Corridor Width	No Required Yes No Yes Required 44" 80" 7" 4" 11" 34" to 38" 42" 4 1/2" 1 1/2" Yes Required 44"	No No Provided Yes Provided 44" 80" T.B.D. T.B.D. T.B.D. 42" Yes Provided 5'-6"	Exception 1: Areas of refuge not required in buildings equipped throughout with an automatic sprinkler system installed in accordance with (Section 903.1.1) In buildings with an accessible floor, four or more stories above level of discharge one required accessible means of egress shall be an elevator as per (Section 1009.4) Stand-by power to be provide in accordance with Chapter 27 and Section 3003 Exception 1 Areas of refuge not required in buildings equipped throughout with an automatic sprinkler system installed in accordance with (Section 903.1.1) Two-way communication system shall be provided at each required location and the Fire Command Center or Central Location Approved by the Fire Department (Section 1011.5.2) Measured from wall to wall (Section 1011.5.2) Maximum Riser (Section 1011.5.2) Minimum Riser (Section 1014.2) Height of grip surface (Section 1014.8) Maximum Projection (Section 1014.8) Maximum Projection (Section 1014.8) Clear space form wall to Rail (Section 1011.12) Refer to plans
(Section 1009.3.2.) Exception 1. Area of Refuge Stairs (Section 1009.4.2) Exceptions 1 Elevators Accessible Requirements (Section 1009.2.1) Stand-by Power (Section 1009.4.1) Area of Refuge Elevators (Section 1009.4.2) Exceptions 1 Two-way Communication Elevators (Section 1009.4.2) Stairways (Section 1011) Stairway Width Stair Headroom Stair Treads and Risers Height of Handrails Height of Guardrails Stair to Roof Corridors (Section 1018) Corridor Width Corridor Headroom Doors	No Required Yes No Yes Required 44" 80" 7" 4" 11" 34" to 38" 42" 4 1/2" 1 1/2" Yes Required	No No Provided Yes No Yes Provided 44" 80" T.B.D. T.B.D. T.B.D. 34" 42" Yes	Exception 1: Areas of refuge not required in buildings equipped throughout with an automatic sprinkler system installed in accordance with (Section 903.1.1) In buildings with an accessible floor, four or more stories above level of discharge one required accessible means of egress shall be an elevator as per (Section 1009.4) Stand-by power to be provide in accordance with Chapter 27 and Section 3003 Exception 1 Areas of refuge not required in buildings equipped throughout with an automatic sprinkler system installed in accordance with (Section 903.1.1) Two-way communication system shall be provided at each required location and the Fin Command Center or Central Location Approved by the Fire Department (Section 1011.5.2) Measured from wall to wall (Section 1011.5.2) Maximum Riser (Section 1011.5.2) Minimum Riser (Section 1011.5.2) Minimum Riser (Section 1014.2) Height of grip surface (Section 1014.8) Maximum Projection (Section 1014.8) Maximum Projection (Section 1014.8) Maximum Projection (Section 1014.8) Refer to plans
(Section 1009.3.2.) Exception 1. Area of Refuge Stairs (Section 1009.4.2) Exceptions 1 Elevators Accessible Requirements (Section 1009.2.1) Stand-by Power (Section 1009.4.1) Area of Refuge Elevators (Section 1009.4.2) Exceptions 1 Two-way Communication Elevators (Section 1009.4.2) Stairways (Section 1011) Stairway Width Stair Headroom Stair Treads and Risers Height of Handrails Height of Guardrails Stair to Roof Corridors (Section 1018) Corridor Width Corridor Headroom Doors	No Required Yes No Yes Required 44" 80" 7" 4" 11" 34" to 38" 42" 4 1/2" 1 1/2" Yes Required 44"	No No Provided Yes Provided 44" 80" T.B.D. T.B.D. T.B.D. 42" Yes Provided 5'-6"	Exception 1: Areas of refuge not required in buildings equipped throughout with an automatic sprinkler system installed in accordance with (Section 903.1.1) In buildings with an accessible floor, four or more stories above level of discharge one required accessible means of egress shall be an elevator as per (Section 1009.4) Stand-by power to be provide in accordance with Chapter 27 and Section 3003 Exception 1 Areas of refuge not required in buildings equipped throughout with an automatic sprinkler system installed in accordance with (Section 903.1.1) Two-way communication system shall be provided at each required location and the Fin Command Center or Central Location Approved by the Fire Department (Section 1011.5.2) Measured from wall to wall (Section 1011.5.2) Maximum Riser (Section 1011.5.2) Minimum Riser (Section 1014.2) Height of grip surface (Section 1014.8) Maximum Projection (Section 1014.8) Maximum Projection (Section 1014.8) Clear space form wall to Rail (Section 1011.12) Refer to plans
(Section 1009.3.2.) Exception 1. Area of Refuge Stairs (Section 1009.4.2) Exceptions 1 Elevators Accessible Requirements (Section 1009.2.1) Stand-by Power (Section 1009.4.1) Area of Refuge Elevators (Section 1009.4.2) Exceptions 1 Two-way Communication Elevators (Section 1009.4.2) Stairways (Section 1011) Stairway Width Stair Headroom Stair Treads and Risers Height of Handrails Height of Guardrails Stair to Roof Corridors (Section 1018) Corridor Width Corridor Headroom	No Required Yes No Yes Required 44" 80" 7" 4" 11" 34" to 38" 42" 4 1/2" 1 1/2" Yes Required 44" 80"	No No Provided Yes Provided 44" 80" T.B.D.	Sprinkler System installed in accordance with (Section 903.1.1.1) Exception 1: Areas of refuge not required in buildings equipped throughout with an automatic sprinkler system installed in accordance with (Section 903.1.1) In buildings with an accessible floor, four or more stories above level of discharge one required accessible means of egress shall be an elevator as per (Section 1009.4) Stand-by power to be provide in accordance with Chapter 27 and Section 3003 Exception 1 Areas of refuge not required in buildings equipped throughout with an automatic sprinkler system installed in accordance with (Section 903.1.1) Two-way communication system shall be provided at each required location and the Fin Command Center or Central Location Approved by the Fire Department (Section 1011.2) Measured from wall to wall (Section 1011.5.2) Maximum Riser (Section 1011.5.2) Minimum Riser (Section 1014.2) Height of grip surface (Section 1014.2) Height of grip surface (Section 1014.8) Maximum Projection (Section 1014.8) Clear space form wall to Rail (Section 1011.12) Measured from wall to Rail (Section 1011.12) Measured from wall to wall (Section 1011.13) Measured vertically tread to nosing (Table 1018.2) Measured from wall to wall (Section 1011.3) Measured vertically tread to nosing
(Section 1009.3.2.) Exception 1. Area of Refuge Stairs (Section 1009.4.2) Exceptions 1 Elevators Accessible Requirements (Section 1009.2.1) Stand-by Power (Section 1009.4.1) Area of Refuge Elevators (Section 1009.4.2) Exceptions 1 Two-way Communication Elevators (Section 1009.4.2) Stairways (Section 1011) Stairway Width Stair Headroom Stair Treads and Risers Height of Handrails Height of Guardrails Stair to Roof Corridors (Section 1018) Corridor Width Corridor Headroom Doors (Section 1010)	No Required Yes No Yes Required 44" 80" 7" 4" 11" 34" to 38" 42" 4 1/2" 1 1/2" Yes Required 44" 80" Required 30" 78" 32"	No No Provided Yes Provided 44" 80" T.B.D. T.B.D. T.B.D. 34" 42" Yes Provided 5'-6" T.B.D.	Exception 1: Areas of refuge not required in buildings equipped throughout with an automatic sprinkler system installed in accordance with (Section 903.1.1) In buildings with an accessible floor, four or more stories above level of discharge one required accessible means of egress shall be an elevator as per (Section 1009.4) Stand-by power to be provide in accordance with Chapter 27 and Section 3003 Exception 1 Areas of refuge not required in buildings equipped throughout with an automatic sprinkler system installed in accordance with (Section 903.1.1) Two-way communication system shall be provided at each required location and the Fin Command Center or Central Location Approved by the Fire Department (Section 1011.2) Measured from wall to wall (Section 1011.5.2) Maximum Riser (Section 1011.5.2) Minimum Riser (Section 1014.2) Height of grip surface (Section 1014.3) Maximum Projection (Section 1014.8) Clear space form wall to Rail (Section 1014.8) Clear space form wall to Rail (Section 1011.1) Refer to plans (Table 1018.2) Measured from wall to wall (Section 1011.1) Measured vertically tread to nosing (Section 1011.1) Measured from wall to wall (Section 1011.1) Minimum Height (Section 1010.1.1) Minimum Height (Section 1010.1.1) Minimum Height (Section 1010.1.1) Minimum Width
(Section 1009.3.2.) Exception 1. Area of Refuge Stairs (Section 1009.4.2) Exceptions 1 Elevators Accessible Requirements (Section 1009.2.1) Stand-by Power (Section 1009.4.1) Area of Refuge Elevators (Section 1009.4.2) Exceptions 1 Two-way Communication Elevators (Section 1009.4.2) Stairways (Section 1011) Stairway Width Stair Headroom Stair Treads and Risers Height of Handrails Height of Guardrails Stair to Roof Corridors (Section 1018) Corridor Width Corridor Headroom Doors (Section 1010) Door Headroom Door Width Door Swing	No Required Yes No Yes Required 44" 80" 7" 4" 11" 34" to 38" 42" 4 1/2" 1 1/2" Yes Required 44" 80" 78" 32" 48" Yes	No No Provided Yes Provided 44" 80" T.B.D. T.B.D. T.B.D. 34" 42" Yes Provided 5'-6" T.B.D. Provided Yes Yes Yes Yes Yes Yes Yes Yes	Exception 1: Areas of refuge not required in buildings equipped throughout with an automatic sprinkler system installed in accordance with (Section 903.1.1) In buildings with an accessible floor, four or more stories above level of discharge one required accessible means of egress shall be an elevator as per (Section 1009.4) Stand-by power to be provide in accordance with Chapter 27 and Section 3003 Exception 1 Areas of refuge not required in buildings equipped throughout with an automatic sprinkler system installed in accordance with (Section 903.1.1) Two-way communication system shall be provided at each required location and the Fin Command Center or Central Location Approved by the Fire Department (Section 1011.2) Measured from wall to wall (Section 1011.5.2) Maximum Riser (Section 1011.5.2) Minimum Riser (Section 1011.5.2) Minimum Riser (Section 1014.2) (Section 1014.3) Measured vertically tread to nosing (Section 1014.8) Maximum Projection (Section 1014.8) Maximum Projection (Section 1014.8) Clear space form wall to Rail (Section 1011.1) Refer to plans (Table 1018.2) Measured from wall to wall (Section 1011.1) Minimum Height (Section 1010.1.1) Minimum Height (Section 1010.1.1) Minimum Width (Section 1010.1.2) Swing in direction of egress where space has 50 or more
(Section 1009.3.2.) Exception 1. Area of Refuge Stairs (Section 1009.4.2) Exceptions 1 Elevators Accessible Requirements (Section 1009.2.1) Stand-by Power (Section 1009.4.1) Area of Refuge Elevators (Section 1009.4.2) Exceptions 1 Two-way Communication Elevators (Section 1009.4.2) Stairways (Section 1011) Stairway Width Stair Headroom Stair Treads and Risers Height of Handrails Height of Guardrails Stair to Roof Corridors (Section 1018) Corridor Width Corridor Headroom Doors (Section 1010) Door Headroom Door Width Door Width	No Required Yes No Yes Required 44" 80" 7" 4" 11" 34" to 38" 42" 4 1/2" 1 1/2" Yes Required 44" 80" Required 44" 80" Required 44" 80"	No No Provided Yes No Yes Provided 44" 80" T.B.D. T.B.D. T.B.D. 34" 42" Yes Provided 5'-6" T.B.D. Provided Yes Yes Yes Yes	Exception 1: Areas of refuge not required in buildings equipped throughout with an automatic sprinkler system installed in accordance with (Section 903.1.1) In buildings with an accessible floor, four or more stories above level of discharge one required accessible means of egress shall be an elevator as per (Section 1009.4) Stand-by power to be provide in accordance with Chapter 27 and Section 3003 Exception 1 Areas of refuge not required in buildings equipped throughout with an automatic sprinkler system installed in accordance with (Section 903.1.1) Two-way communication system shall be provided at each required location and the Fin Command Center or Central Location Approved by the Fire Department (Section 1011.5.2) Measured from wall to wall (Section 1011.5.2) Minimum Riser (Section 1011.5.2) Minimum Riser (Section 1011.5.2) Minimum Riser (Section 1014.2) Height of grip surface (Section 1014.2) (Section 1014.3) Maximum Projection (Section 1014.8) Clear space form wall to Rail (Section 1014.8) Clear space form wall to Rail (Section 1011.1) Refer to plans (Table 1018.2) Measured from wall to wall (Section 1011.1) Minimum Height (Section 1010.1.1) Minimum Height (Section 1010.1.1) Projections - Door Closer and Stops minimum clear (Section 1010.1.1) Minimum Width (Section 1010.1.1) Minimum Width (Section 1010.1.1) Maximum Width of Swing door leaf
(Section 1009.3.2.) Exception 1. Area of Refuge Stairs (Section 1009.4.2) Exceptions 1 Elevators Accessible Requirements (Section 1009.2.1) Stand-by Power (Section 1009.4.1) Area of Refuge Elevators (Section 1009.4.2) Exceptions 1 Two-way Communication Elevators (Section 1009.4.2) Stairways (Section 1011) Stairway Width Stair Headroom Stair Treads and Risers Height of Handrails Height of Guardrails Stair to Roof Corridors (Section 1018) Corridor Width Corridor Headroom Doors (Section 1010) Door Headroom Door Width Door Swing	No Required Yes No Yes Required 44" 80" 7" 4" 11" 34" to 38" 42" 4 1/2" 1 1/2" Yes Required 44" 80" Required 44" 80" Required 44" Yes Yes Yes	No No Provided Yes No Yes Provided 44" 80" T.B.D. T.B.D. T.B.D. 34" 42" Yes Provided 5'-6" T.B.D. Provided Yes Yes Yes Yes Yes Yes Yes Yes Yes	Sprinkler System installed in accordance with (Section 903.1.1.1) Exception 1: Areas of refuge not required in buildings equipped throughout with an automatic sprinkler system installed in accordance with (Section 903.1.1) In buildings with an accessible floor, four or more stories above level of discharge one required accessible means of egress shall be an elevator as per (Section 1009.4) Stand-by power to be provide in accordance with Chapter 27 and Section 3003 Exception 1 Areas of refuge not required in buildings equipped throughout with an automatic sprinkler system installed in accordance with (Section 903.1.1) Two-way communication system shall be provided at each required location and the Fire Command Center or Central Location Approved by the Fire Department (Section 1011.2) Measured from wall to wall (Section 1011.5.2) Maximum Riser (Section 1014.2) Height of grip surface (Section 1014.3) Maximum Projection (Section 1014.8) Clear space form wall to Rail (Section 1011.1) Measured vertically tread to nosing (Section 1011.1) Measured rom wall to wall (Section 1011.1) Measured vertically tread to nosing (Section 1010.1.1) Measured vertically tread to nosing (Section 1010.1.1) Measured vertically tread to nosing (Section 1010.1.1) Measured vertically tread to nosing

Project Name:	Madison Ya				
Project Address:	1 Madison	•			of the proof in where any works have been all the second of the second o
Project Description:	consisting of amenities w	f studios, o	one bedroon ential lobby,	n and two be leasing offic	I. ft., cast-in-place concrete high-rise building with 270 units droom units. The project also contains 0000 sq ft of ground floor es, fitness center and tenant bike storage. The penthouse level of the a 0000 sq. ft. lounge and 000 sq. ft. exterior roof terrace and trellis.
Applicable Code:					365 (IBC 2015)
	2015 INTER				,
	2015 INTER				
	2015 INTER 2015 INTER				
	2013 1111211		022 07 10 00	0 2	
	STATE WISC			DE SPS 380 -3	87
	STATE WISC				
	NFPA 2012				
	ANSI 2017 1 2010 FEDER		ANDARD		
				THE FAIR HC	USING ACT
Project is fully Sprinkled as per Use and Occupancy (Section 302)	Building eq	uipped thro	oughout wit	h automatic s	prinkler system NFPA13 (Section 903.1.1) and (Section 403.3.3)
Group Classification	Residential	R2		(Section 30	3.4)
		S-2		-	3.4) Low-Hazard
	Business Assembly	B A-3		(Section 30)	•
(Section 303.1.2.1) Small Assembly		•		•	ipant load of less than 50 people and accessary to another occupanc
High Rise Buildings (Section 403)	shall be clas	ssified as a	Group B Occ	cupancy.	
Dadustias is Fire resistance Dating	Faula dia		420 -	C : l:	the five resistance ration of building alcohols in Toronto he all be
Reduction in Fire resistance Rating (Section 403.2.1)	_	_	er then 420 i ed to Type I	_	the fire resistance rating of building elements in Type IA shall be
Fire Service access elevators			•		0 feet above lowest level of fire department access not fewer than
(Section 403.6.1)	1			th a capacity Idings over fo	of 3500lbs shall be provide. SPS 362.302.1.a.2 reduces qty of fire
Remoteness of interior Exit stairways				_	maximum overall diagonal dimension of the building area
(Section 403.5.1)	50-0 sepai	auvii Of N	ינ ובא נווטא ו	one iorui the	maximum overali diagonal dimension of the building area
Separations of Occupancies (Table	_				
508.4)	Group R2	R2	S-2 1HR	B 1HR	A-3 1HR
	S-2	1HR		1HR	1HR
	B A-3	1HR 1HR	1HR 1HR	1HR	1HR
					vehicles only
Types of Construction (Section 602)	10	10			
General Building Heights and Areas	IA Allowable	IA Actual			
Allowable height (Table 504.3)	UL	160'-0"		and Occupar	
Number of stories (Table 504.4) Allowable area (Table 506.2)	UL UL	15 T.B.D.		and Occupar	
Fire Resistance rating requirements for	OL	1.0.0.	TOT all OSE	and Occupat	icy droups
ouilding elements (Table 601)					
Primary Structural Frame			/= II co.		
Columns Girders, Beam and Trusses	3HR 3HR		(Table 601 (Table 601	•	
Bearing walls			(1000000	,	
Exterior Interior	3HR 3HR		(Table 601 (Table 601	-	
Non-bearing walls	эпк		(14016-001)	
Exterior	4115		/T-1-1- 602	Eliza Dialesca	
X < 5' 5' ≤ X < 10'	1HR 1HR		•	Fire Distance Fire Distance	•
10' ≤ X< 20'	1HR		•	Fire Distance	•
X≥ 20' Interior	OHR OHR		(Table 602	Fire Distance	e)(Note "g")
Floor construction	2HR		(Table 601) Associated	Secondary Member
Roof construction	1.5HR		(Table 601) Associated	Secondary Member
Fire Partitions Corridor	0.5HR		(Table 101	8.1)	
Fire Service Lobby	1HR		(Section 30	•	
Dwelling Unit Separation Dwelling Unit Separation	1HR 1HR		(Section 7:	•	ontal Separation cal Separation
Fire Barriers	71117		125CHOU /(oo.o, verti	sar Separation
Enclosure of Exit Stair	2HR		(Section 10	-	
Enclosure Elevations Enclosure Vertical Shaft	2HR 2HR		(Section 70 (Section 70	•	
	Note "g": W		705.8 perm	its, non-load	bearing exterior walls with unlimited area of unprotected openings,
	tne require	u rire-resist	ance rating.	ior the exter	or wall is 0 HOUR.
Maximum area of Exterior Wall Opening Based on fire Distance (Table 705.8)	Allowable	Actual Distance	Actual	•	aration Line" shall be Located and used between buildings for contro
3'-0" to 5'-0"	15%	istatice	Opening	of openings	
5'-0" to 10'-0"	25%	6'-6"	T.B.D.	Partial Wes	•
10'-0 to 15'-0" 15'-0" to 20'-0"	45% 75%	10'-4" 14'-8"	T.B.D. T.B.D.	Partial Wes Partial Wes	·
20'-0" to Greater	No Limit	Greater	No Limit	North, Sout	h and East Exposures
Vertical Exposure Separation of Openings (Section 705.8.5)	This section with (Section			idings equipp	ed throughout with an automatic sprinkler system in accordance
	_				
Vertical Exposure Buildings on Same lot (Section 705.8.6) Exception 1			•		oof assembly of the adjacent buildings has a fire-resistance rating of 10 feet from the exterior wall facing the imaginary line and the
	entire lengt	h and span	of the supp	orting eleme	nts for the roof assembly has a fire-resistance rating of not less the
Fire Protection and Life Cofety					
Fire Protection and Life Safety Section 9)	YES	NO			
Automatic Sprinkler System	X				d for Group R in accordance with
(Section 903)	v				(Section 205.3.1) Class I standpines are allowed in buildings
Standpipe System (Section 905)	X		1 -		(Section 905.3.1) Class I standpipes are allowed in buildings natic sprinkler system in accordance with Section 903.1.1
			Required i	n Interior Exi	Stairways with a maximum remote spacing of 200'-0"
Portable Fire Extinguishers	x		1.	•	distance of travel 75'-0"
(Section 906) Smoke Detection	x				Requirements (Section 907.2.12.1) Installed in immediate vicinity of bedroom.
(Section 907)			1 -		ised for sleeping
Fire Alarm System	Х		1 -	•	(Section 907.2.12) Manual fire alarm boxes are not required where
(Section 907)			_		h an automatic sprinkler system in accordance with Section 5.2.3) Visible Alarm notification appliances shall be provided
Fire Command Center	X				ze of 200 sq. ft. with a minimum dimension of 10'-0".
	1				•
(Section 911)			(Section 30	008.6.6) Two-	Way Communication to Elevator lobbies with Manual Elevator Reca





Project Contact: Eric Lukacsik
Email: elukacsik@ktgy.com
Principal: Craig Pryde
Project Designer: Demetrios
Stavrianos

Developer



PHONE NO.

MADISON YARDS BLOCK 2 BUILDING B

No.	Date	Description
1	09/25/20	PRELIMINARY PRICING
2	11/17/20	ISSUE FOR SIP REVIEW
		_
		_

It is the client's responsibility prior to or during construction to notify the architect in writing of any perceived errors or omissions in the plans and specifications of which a contractor thoroughly knowledgeable with the building codes and methods of construction should reasonably be aware. Written instructions addressing such perceived errors or omissions shall be received from the architect prior to the client or client's subcontractors proceeding with the work. The client will be responsible for any defects in construction if these procedures are not followed.

BUILDING B

CODE MATRIX

A0-B10

Floor		Stories	Dwelling Units/Flr	Gross Area	Common Area	Net Rentable	Eff.
LL		1	6	14,615	9,210	5,405	37%
1st		1	10	19,477	11,048	8,429	43%
2nd		1	19	19,368	3,197	16,171	83%
3rd		1	19	18,510	2,448	16,062	87%
4th		1	19	18,510	2,258	16,252	88%
5th		1	19	18,510	2,258	16,252	88%
6th		1	19	18,510	2,258	16,252	88%
7th		1	19	18,510	2,258	16,252	88%
8th		1	19	18,510	2,258	16,252	88%
9th		1	19	18,510	2,258	16,252	88%
10th		1	19	18,510	2,258	16,252	88%
11th		1	19	18,510	2,258	16,252	88%
12th		1	19	18,510	2,258	16,252	88%
13th		1	19	18,510	2,258	16,252	88%
14th		1	19	18,510	2,258	16,252	88%
15th/Mech		1	10	15,946	7,192	8,754	55%
Total		16	273	291,526	57,933	233,593	80%
	Average L	Init Size	855 SQFT	-			

Jnit Mi	X																					
Unit 7	Туре	Area SF	Quanity at LL	Quantity at 1st Flr	Quantity at 2nd Flr	Quantity at 3rd Flr	Quantity at 4th Flr	Quantity at 5th Flr	Quantity at 6th Flr	Quantity at 7th Flr	Quantity at 8th Flr	Quantity at 9th Flr	Quantity at 10th Flr	Quantity at 11th Flr	Quantity at 12th Flr	Quantity at 13th Flr	Quantity at 14th Flr	Quantity at 15th Flr	Total	Total SQFT	Average Unit Size SF	Percentage
STU	DIO																					
В0-	-A	548				1	1	1	1	1	1	1	1	1	1	1	1		12	6576		
В0-	- B	547			1	1	1	1	1	1	1	1	1	1	1	1	1	1	14	7658		
В0		563	1	1	1														3	1689		
B0-		572				1	1	1	1	1	1	1	1	1	1	1	1		12	6864		
ubtotal			1	1	2	3	3	3	3	3	3	3	3	3	3	3	3	1	41	22787	556	15.0%
ONE BEI	DROOM		-	•	_													•		22.07	000	10.07
		901				1	1	1	1	1	1	1	1	1	1	1	1		12	0612		
B1-		801				1	1	1	1	1 1	1	1	1	1 1	1 1	1	1		12	9612		
B1-		697				1	1	1	1	1	1	1	1	1	1	1	1		12	8364		
B1-		959			1		1	1	1	1	1	1	1	1	1	1	1	1	13	12467		
B1-		850				1	1	1	1	1	1	1	1	1	1	1	1		12	10200		
B1-I		722			1														1	722		
B1-	-E	805				1	1	1	1	1	1	1	1	1	1	1	1		12	9660		
B1-l	E.1	701			1														1	701		
B1-	-F	736			1	1	1	1	1	1	1	1	1	1	1	1	1	1	14	10304		1
B1-l	F.1	769				1													1	769		
B1-	-G	753		1	1	1	1	1	1	1	1	1	1	1	1	1	1	1	15	11295		
B1-	-H	730		1	1	1	1	1	1	1	1	1	1	1	1	1	1	1	15	10950		
B1		701		1	1	1	1	1	1	1	1	1	1	1	1	1	1	1	15	10515		
B1		799				1	1	1	1	1	1	1	1	1	1	1	1		12	9588		
B1-		923	1	1	1				•			'	•		'				3	2769		
B1-		925	1		1														3	2775		
B1		835	1		1														3	2505		
			- !	1	1																	
B1-		767		4	1														1	767		
B1-		908	1	1	1														3	2724		
B1-	-0	799		1															1	799		
ubtotal			4	8	12	10	10	10	10	10	10	10	10	10	10	10	10	5	149	117486	788	54.6%
TWO BE																						
B2	-A	1095				1	1	1	1	1	1	1	1	1	1	1	1		12	13140		
B2-	!-B	1331				1	1	1	1	1	1	1	1	1	1	1	1		12	15972		
B2-	-c	1038			1	1	1	1	1	1	1	1	1	1	1	1	1	1	14	14532		
B2-	-D	1110				1	1	1	1	1	1	1	1	1	1	1	1	1	13	14430		
B2-I		1127			1														1	1127		
B2-		1152				1	1	1	1	1	1	1	1	1	1	1	1	1	13	14976		
B2		1251	1	1	1														3	3753		
B2-		1028	<u>'</u>	•	1	1	1	1	1	1	1	1	1	1	1	1	1	1	14	14392		
B2		957			1	 '	<u>'</u>	'	<u>'</u>	<u>'</u>	<u>'</u>	<u>'</u>	<u>'</u>	<u>'</u>	<u>'</u>	<u>'</u>	'	'	1	957		
ubtotal	- '	301	1	1	5	6	6	6	6	6	6	6	6	6	6	6	6	4	83	93279	1124	30.4%
uoloidi			1	1	5	-		-	- 6		-		- 6	-	-	-	-	4	03	33213	1124	30.47
otal			6	10	19	19	19	19	19	19	19	19	19	19	19	19	19	10	273			

UNIT TYPE	#UNITS	BIKE PRKG REQD	# BIKE RACI REQD
STUDIOS	42	1	4
1 BED	148	1	14
2 BED	83	1	:
	273		2
GUEST BIKES		1/10 UNITS	28
TOTAL BIKES			30
0.1.50		ТҮРЕ	REQUIRED
GUEST		28	
LONG TERM - INTERIOR REG	90% OF RES - VERT	273	1
LONG TERM - VERTICAL	25% OF TOTAL	0	
		301	3(

	BLDG B - B	BLDG B - BIKE PARKING PROVIDED				
	SITE	BUILDING	BUILDING	BUILDING		
		A -	B - BIKE	B -		
		PARKING	ROOM	EXTERIOR		
		GARAGE				
SHORT TERM	55			0		
LONG TERM - REGULAR						
GROUND FLOOR		40	99	0		
SECOND FLR		20				
THIRD FLOOR		12				
LONG TERM VERTICAL						
GROUND FLOOR			75			
TOTAL	55	72	174	0	301	

OPEN SPA	CE CALCULATIONS	
# UNITS	REQD AREA/ UNIT (SF)	OPEN SPACE REQD (SF)
273	40	10920 SF
LEVEL	TYPE	AREA
GRADE		
LL	BALCONIES	284 SF
1	BALCONIES/ COMMON	1572 SF
2	BALCONIES	679 SF
3	BALCONIES	2042 SF
4	BALCONIES	688 SF
5	BALCONIES	688 SF
6	BALCONIES	688 SF
7	BALCONIES	688 SF
8	BALCONIES	688 SF
9	BALCONIES	688 SF
10	BALCONIES	688 SF
11	BALCONIES	688 SF
12	BALCONIES	688 SF
13	BALCONIES	688 SF
14	BALCONIES	688 SF
15	BALCONIES/ COMMON	3110 SF
TOTAL OP	EN SPACE	15255 SF
	UNITS	273
OUTD	OOR SPACE PER UNIT	56 SF

PROJECT NOTES

- 1. BUILDING A RETAIL/ PARKING GARAGE STRUCTURE LOCATED ON THE WESTERN PORTION OF THE PROJECT SITE. SEE KAHLER SLATER DRAWINGS FOR INFORMATION RELATED TO BUILDING A.
- 2. BUILDING B 15 STORY (ABOVE GRADE PLANE)
 HIGH-RISE RESIDENTIAL BUILDING LOCATED
 ON THE EASTERN PORTION OF THE PROJECT
 SITE. SEE KTGY DRAWINGS FOR
 INFORMATION RELATED TO BUILDING B. SEE
 CODE ANALYSIS FOR HIGH-RISE CODE
 REQUIREMENTS RELATED TO BUILDING B.
 a. A FIRE SEPARATION LINE (FSL) IS UTILIZED
 TO CONTROL THE FIRE RESISTANCE
 RATING OF THE EXTERIOR WALLS
 - ADJACENT TO THE FSL.
 b. OPENING PROTECTIVES ARE REQUIRED AT THE LOWER LEVEL BETWEEN BUILDINGS A
 - c. EXTERIOR WALL FIRE RESISTANCE RATING IS REDUCED ABOVE GRADE PER SECTION 705.8.6, EXCEPTION 1. THE PARKING GARAGE RAMP CONSTRUCTION IS RATED TO AT LEAST 1-HOUR AND EXTENDS MORE THAN 10 FT HORIZONTALLY SUCH THAT OPENING PROTECTIVES IN BUILDING B ABOVE THIS RAMP ELEVATION ARE NOT REQUIRED AND THE RATING OF THE EXTERIOR WALL IS REDUCED TO 0-HOURS ABOVE GRADE OR THE ELEVATION OF THE RAMP.
- 3. EACH BUILDING SHALL BE SEPARATE AND HAVE A UNIQUE BUILDING ADDRESS FOR
- HAVE A UNIQUE BUILDING ADDRESS FOR
 EMERGENCY RESPONSE.

 4. PROVIDE MINIMUM 2" EXPANSION JOINT
 BETWEEN BUILDING A / B. TYPE OF
 EXPANSION JOINT SHALL BE AS REQUIRED TO

PROVIDE WEATHERTIGHT JOINT AT ALL

- BULDING EXTERIOR LOCATIONS.

 5. PROJECT SHALL UTILIZE "FIRE SEPARATION LINE" TO CONTROL OPENINGS WITHIN BUILDINGS A / B. SEE DRAWINGS FOR LOCATION AND EXTENT OF THE FIRE SEPARATION LINE.
- 6. OPENINGS BETWEEN BUILDINGS A / B SHALL BE PROTECTED WITH A 3-HOUR RATED FIRE SHUTTER IN LOCATIONS INDICATED ON THE PLANS. FIRE SHUTTERS SHALL BE CONNECTED TO THE FIRE ALARM FOR EACH BUILDING.

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	I N		

MADISON YARDS HILL FARMS

KTGY Project No: 20200326

Project Contact: Eric Lukacsik

Email: elukacsik@ktgy.com
Principal: Craig Pryde
Project Designer: Demetrios
Stavrianos

Developer



PHONE NO.

MADISON YARDS BLOCK 2 BUILDING B

No.	Date	Description
	11/17/20	ISSUE FOR SIP REVIEW


contractor thoroughly knowledgeable with the building codes and methods of construction should reasonably be aware. Written instructions addressing such

perceived errors or omissions shall be received from the architect prior to the client or client's subcontractors proceeding with the work. The client will be responsible for any defects in construction if these procedures are not followed.

BUILDING B

PROJECT SUMMARY & AREAS

A0-B20

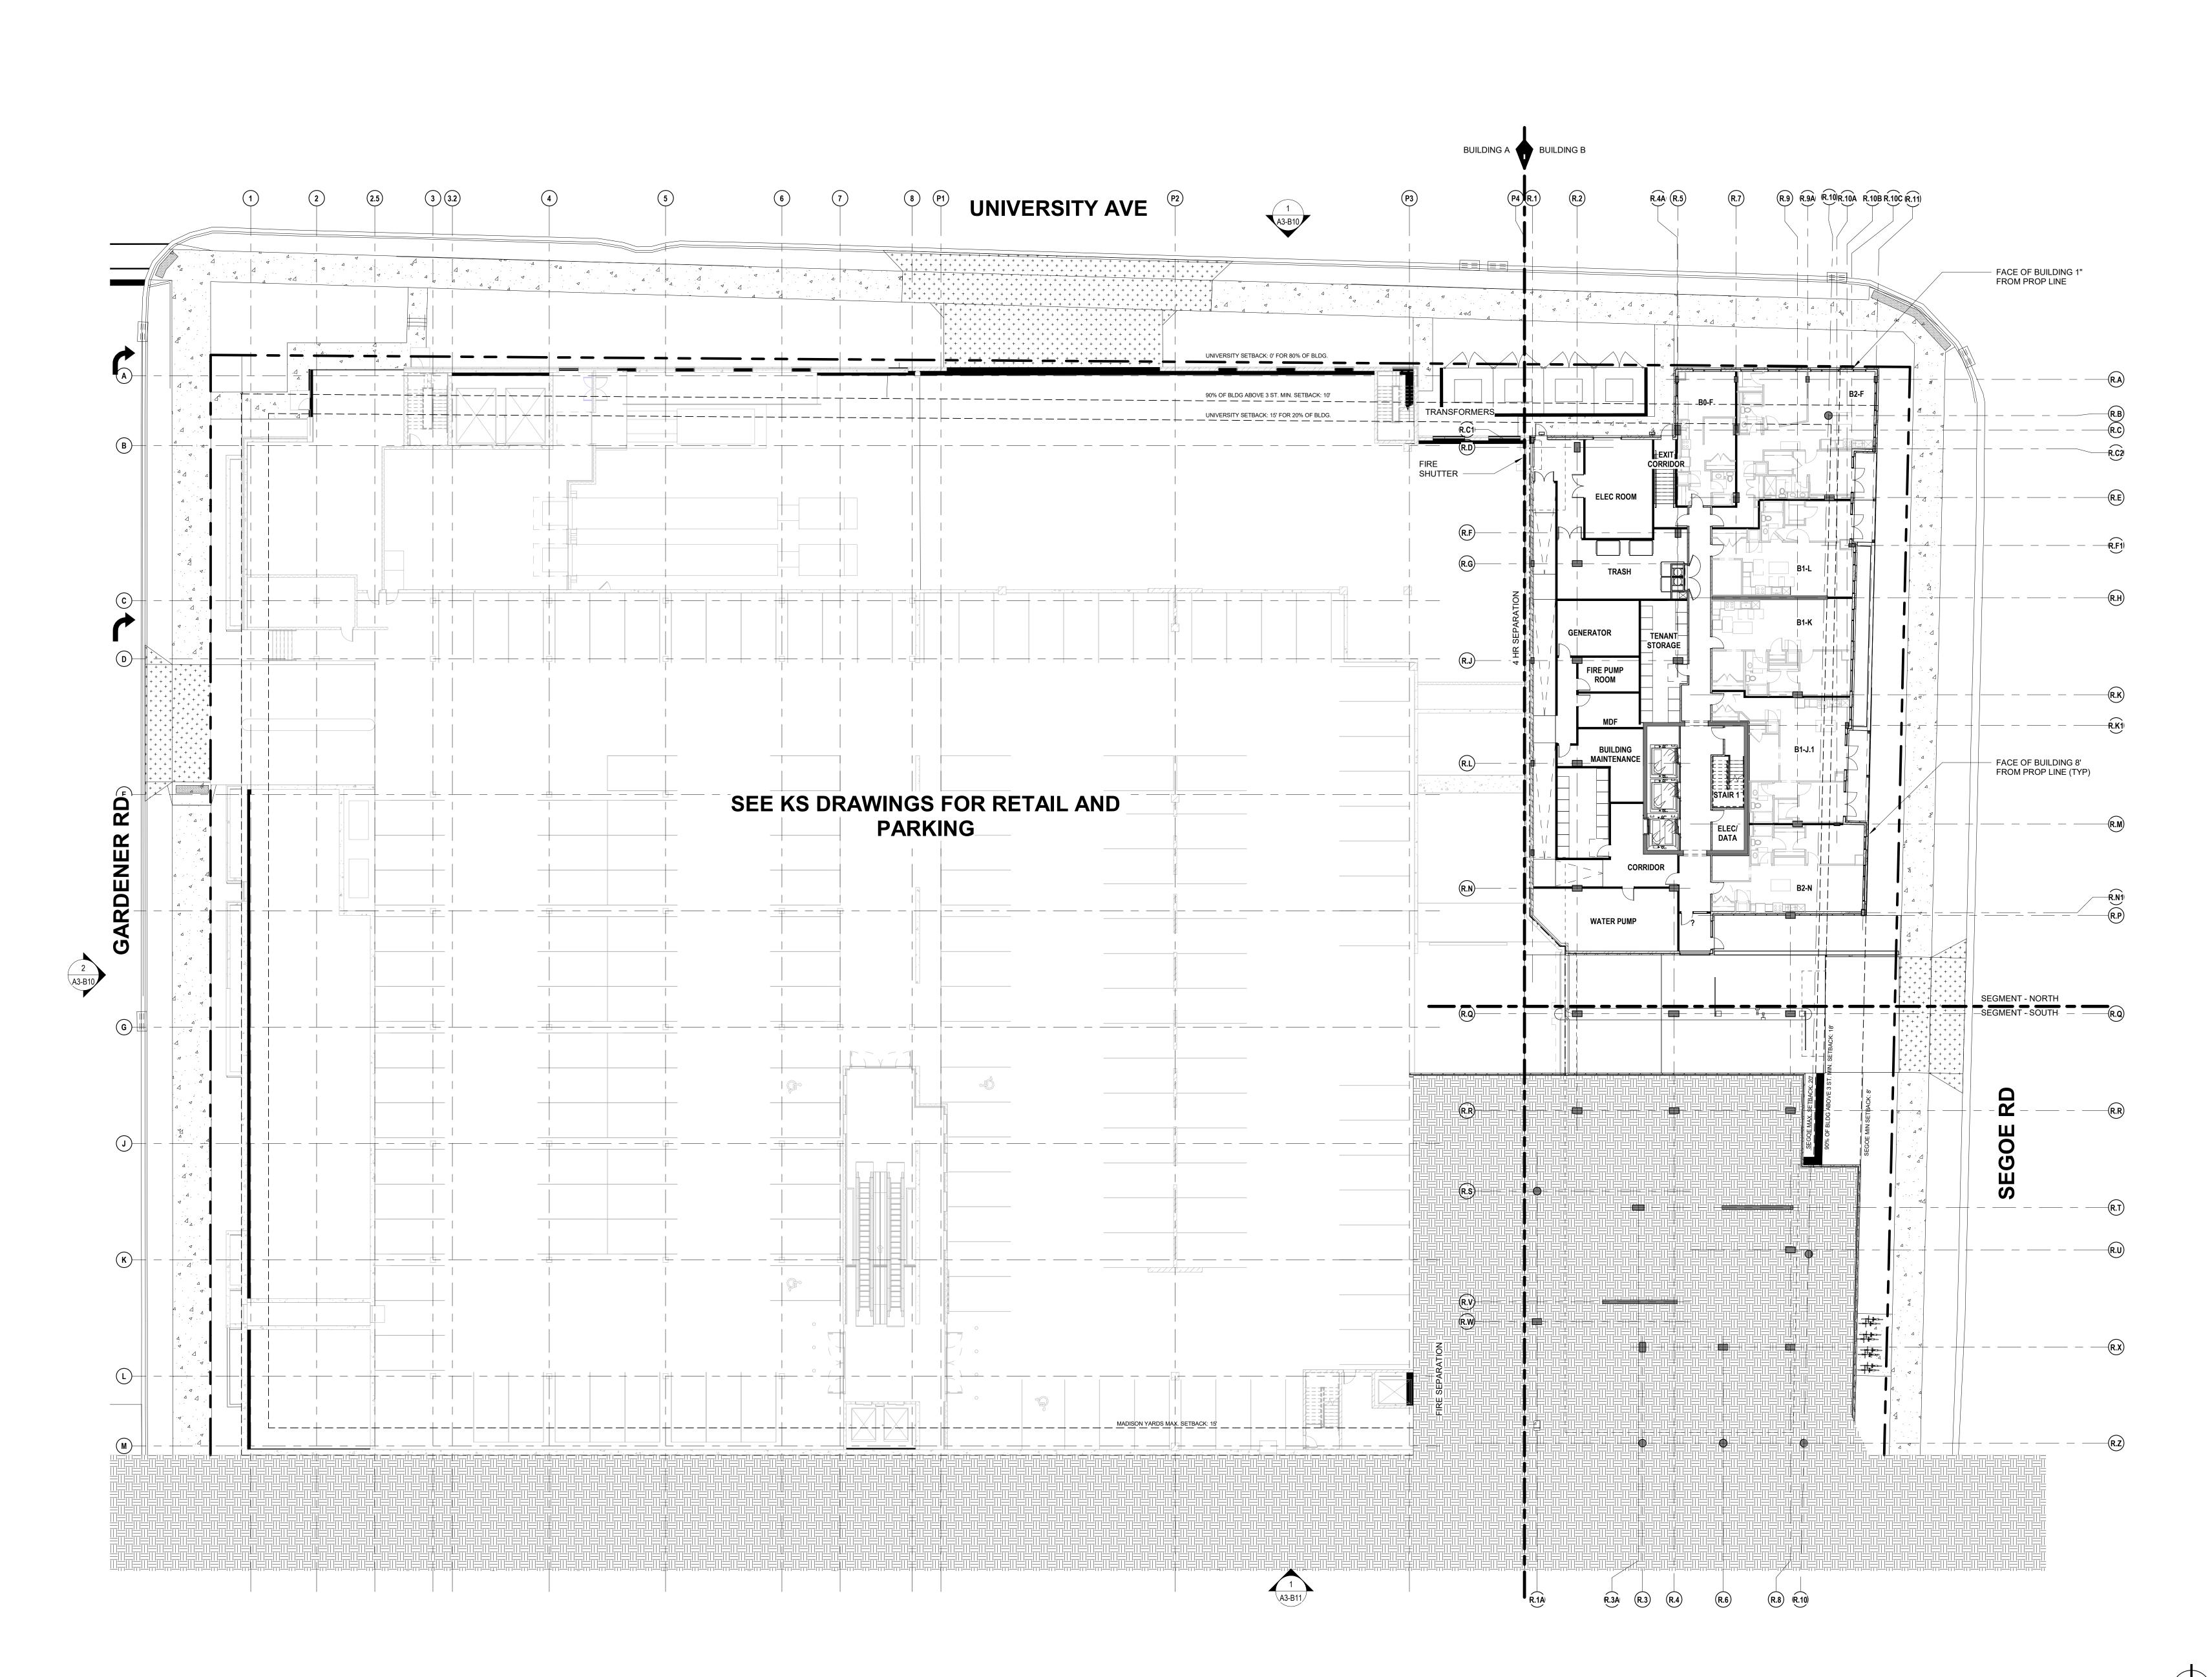





Project Contact: Eric Lukacsik
Email: elukacsik@ktgy.com
Principal: Craig Pryde
Project Designer: Demetrios

Stavrianos

Developer

SMITH Gilbane


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SON YARDS BLOCK 2
BUILDING B

No.	Date	Description
	11/17/20	ISSUE FOR SIP REVIEW

BUILDING B

OVERALL LOWER LEVEL PLAN (REFERENCE)



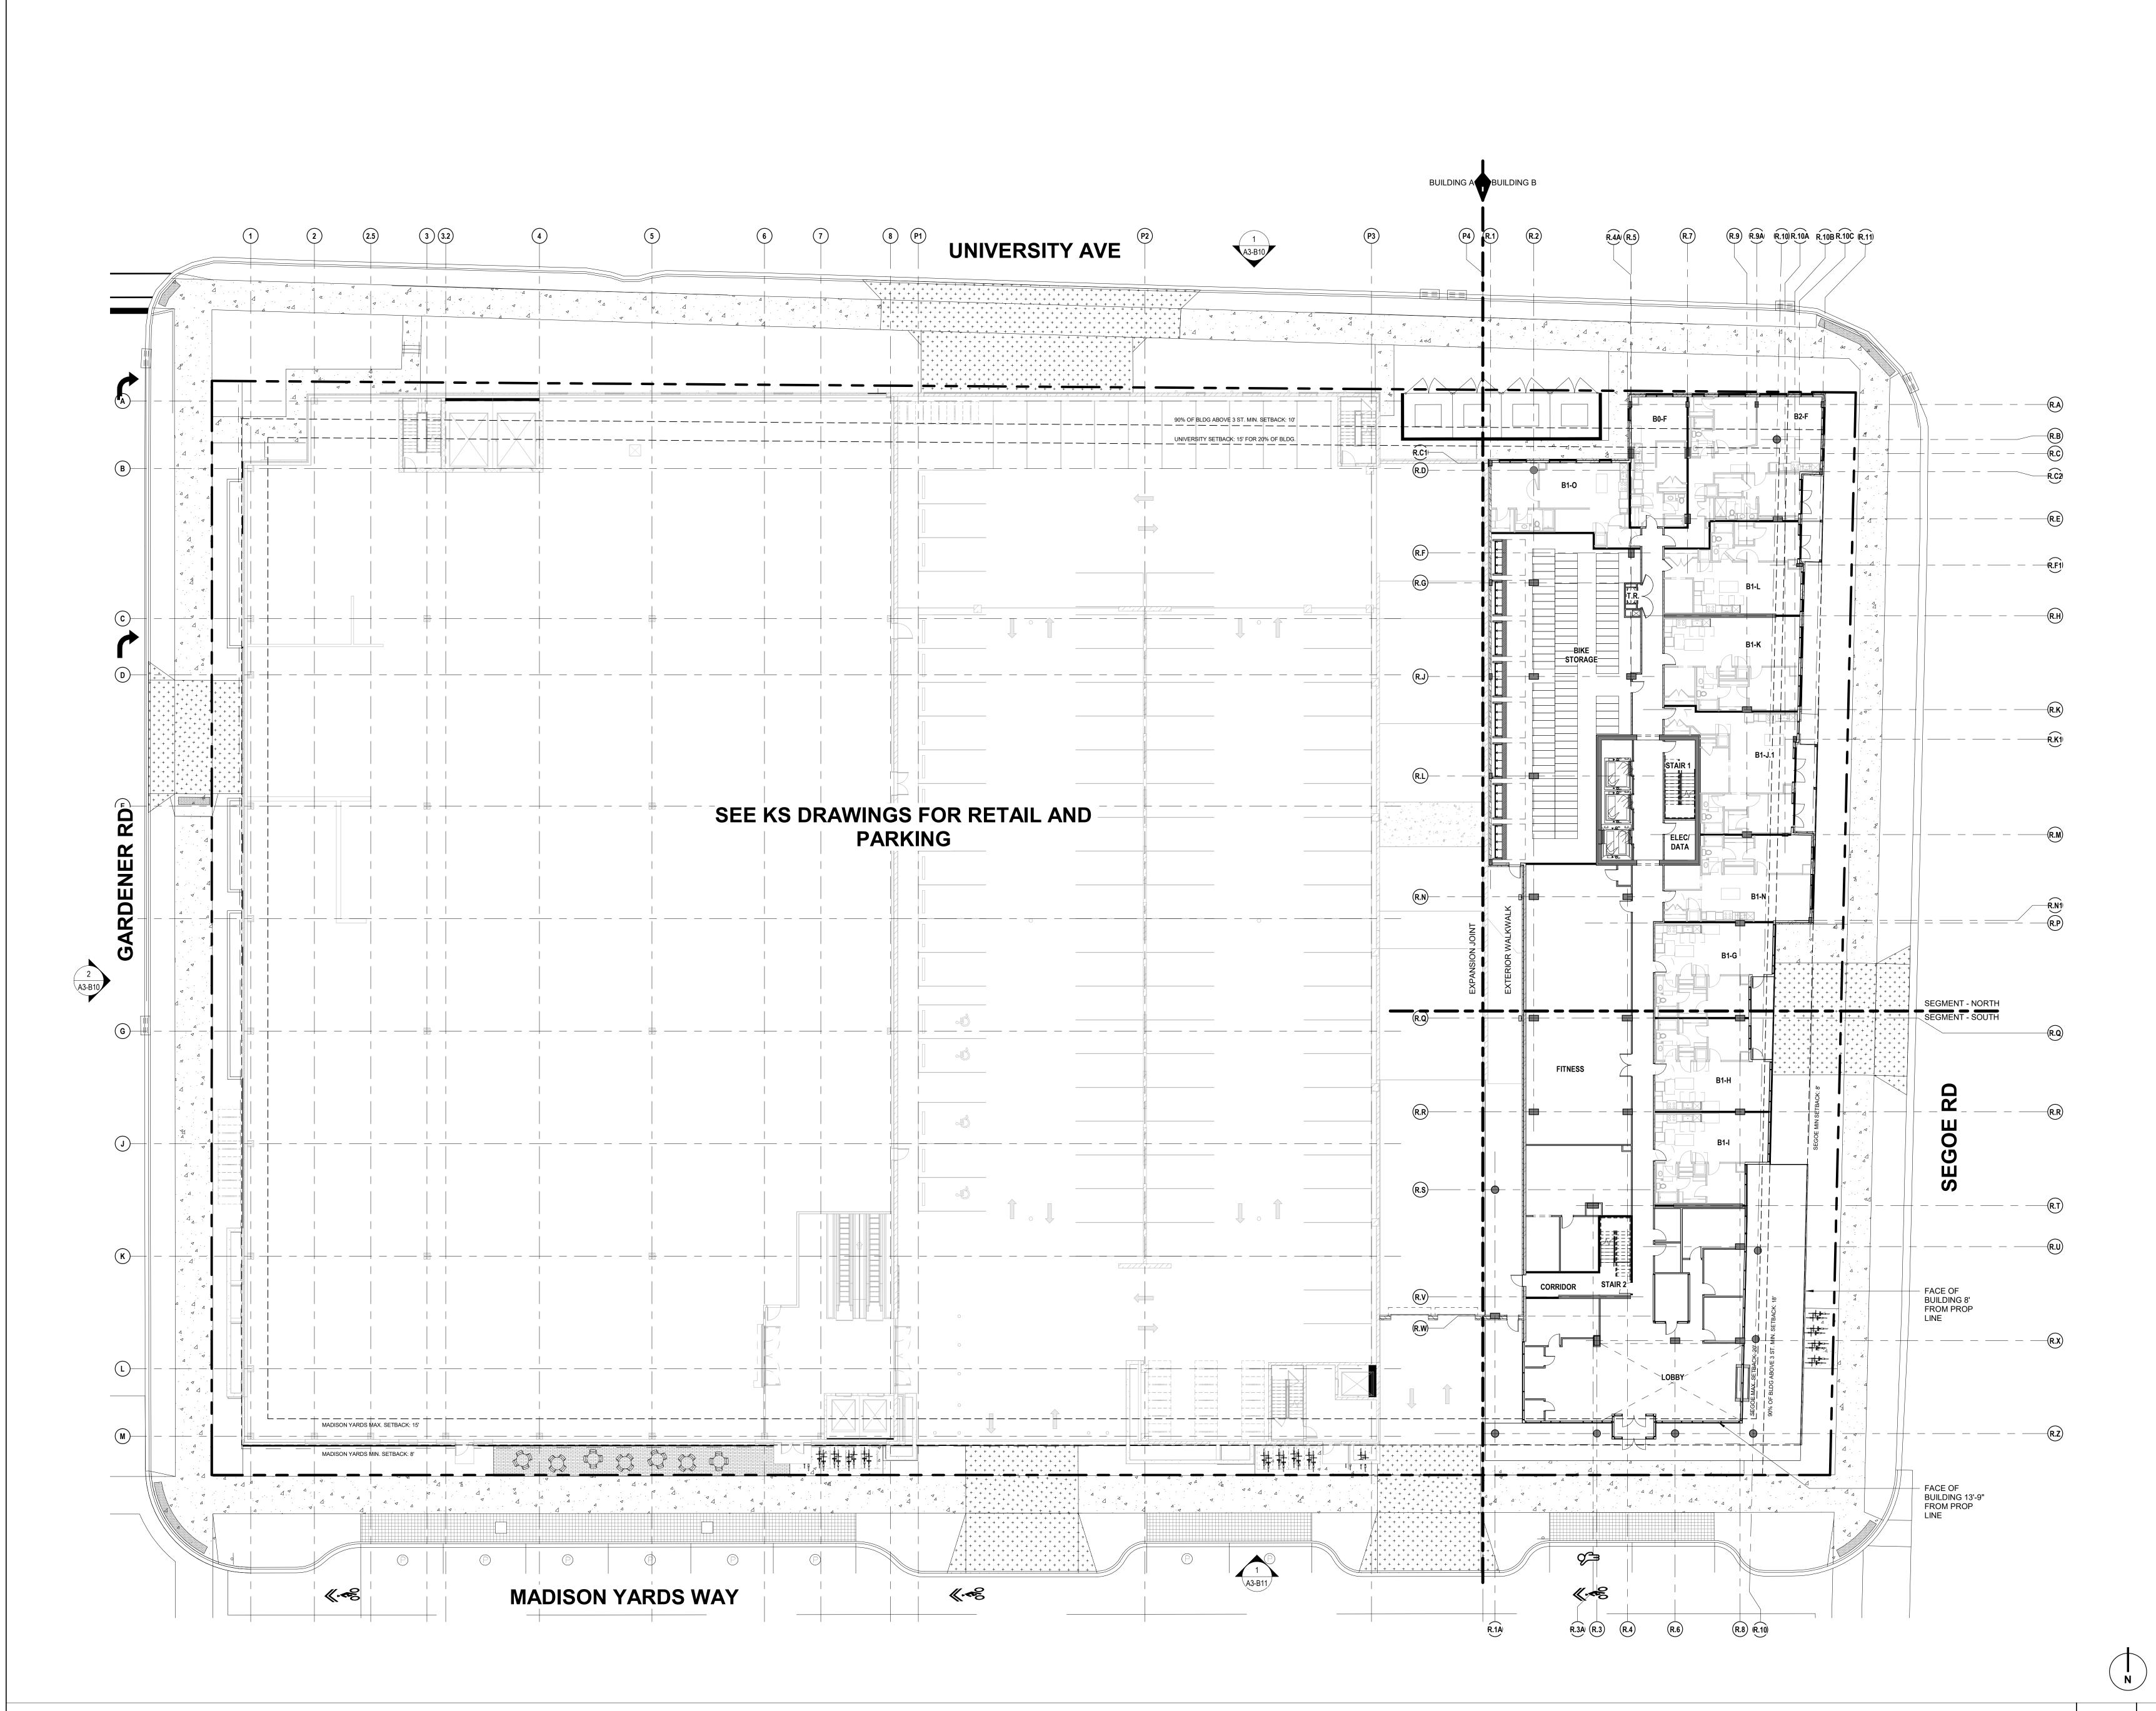



Project Contact: Eric Lukacsik
Email: elukacsik@ktgy.com
Principal: Craig Pryde
Project Designer: Demetrios

Stavrianos

Developer

SMITH Gilbane

PHONE NO.


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BUILDING B

No.	Date	Description
2	11/17/20	ISSUE FOR SIP REVIEW
writing of any per contractor thorou construction sho perceived errors client's subcontra	rceived errors or omission ighly knowledgeable with t uld reasonably be aware. or omissions shall be rece	ring construction to notify the architect in s in the plans and specifications of which a he building codes and methods of Written instructions addressing such eived from the architect prior to the client or work. The client will be responsible for any are not followed.

BUILDING B

OVERALL FIRST FLOOR PLAN (REFERENCE)



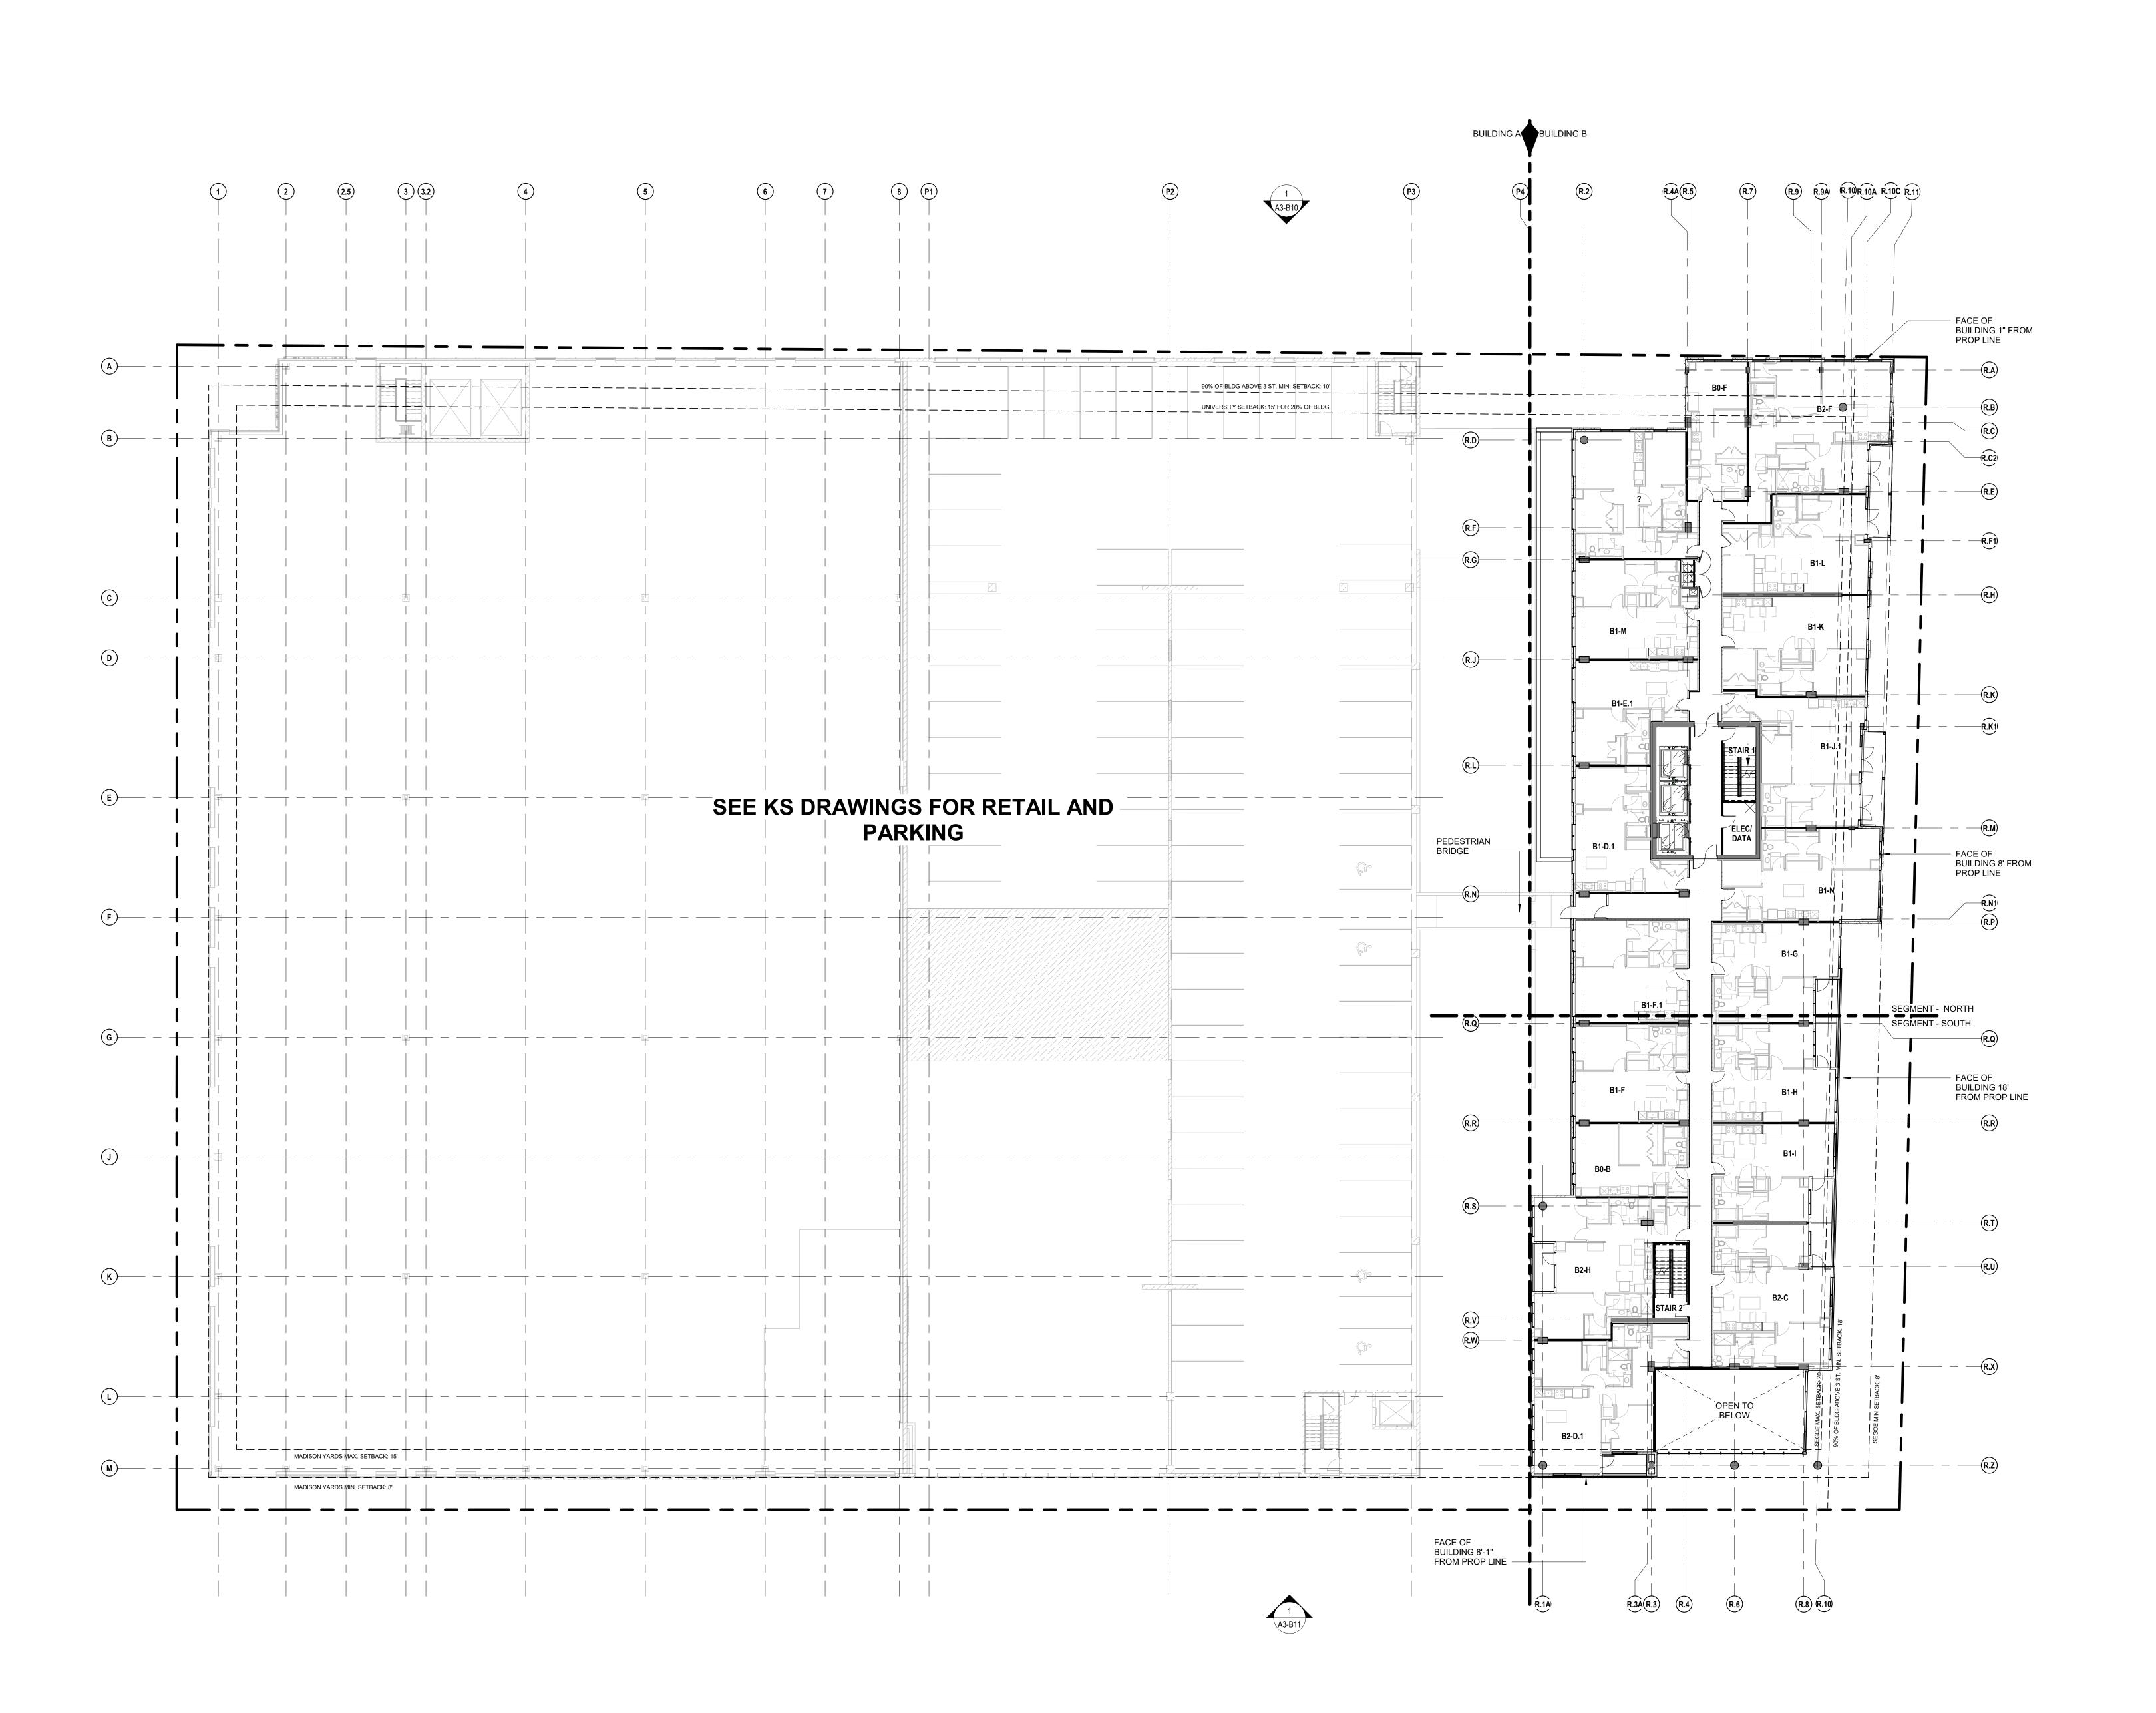



Project Contact: Eric Lukacsik
Email: elukacsik@ktgy.com
Principal: Craig Pryde
Project Designer: Demetrios

Stavrianos

Developer

SMITH Gilbane


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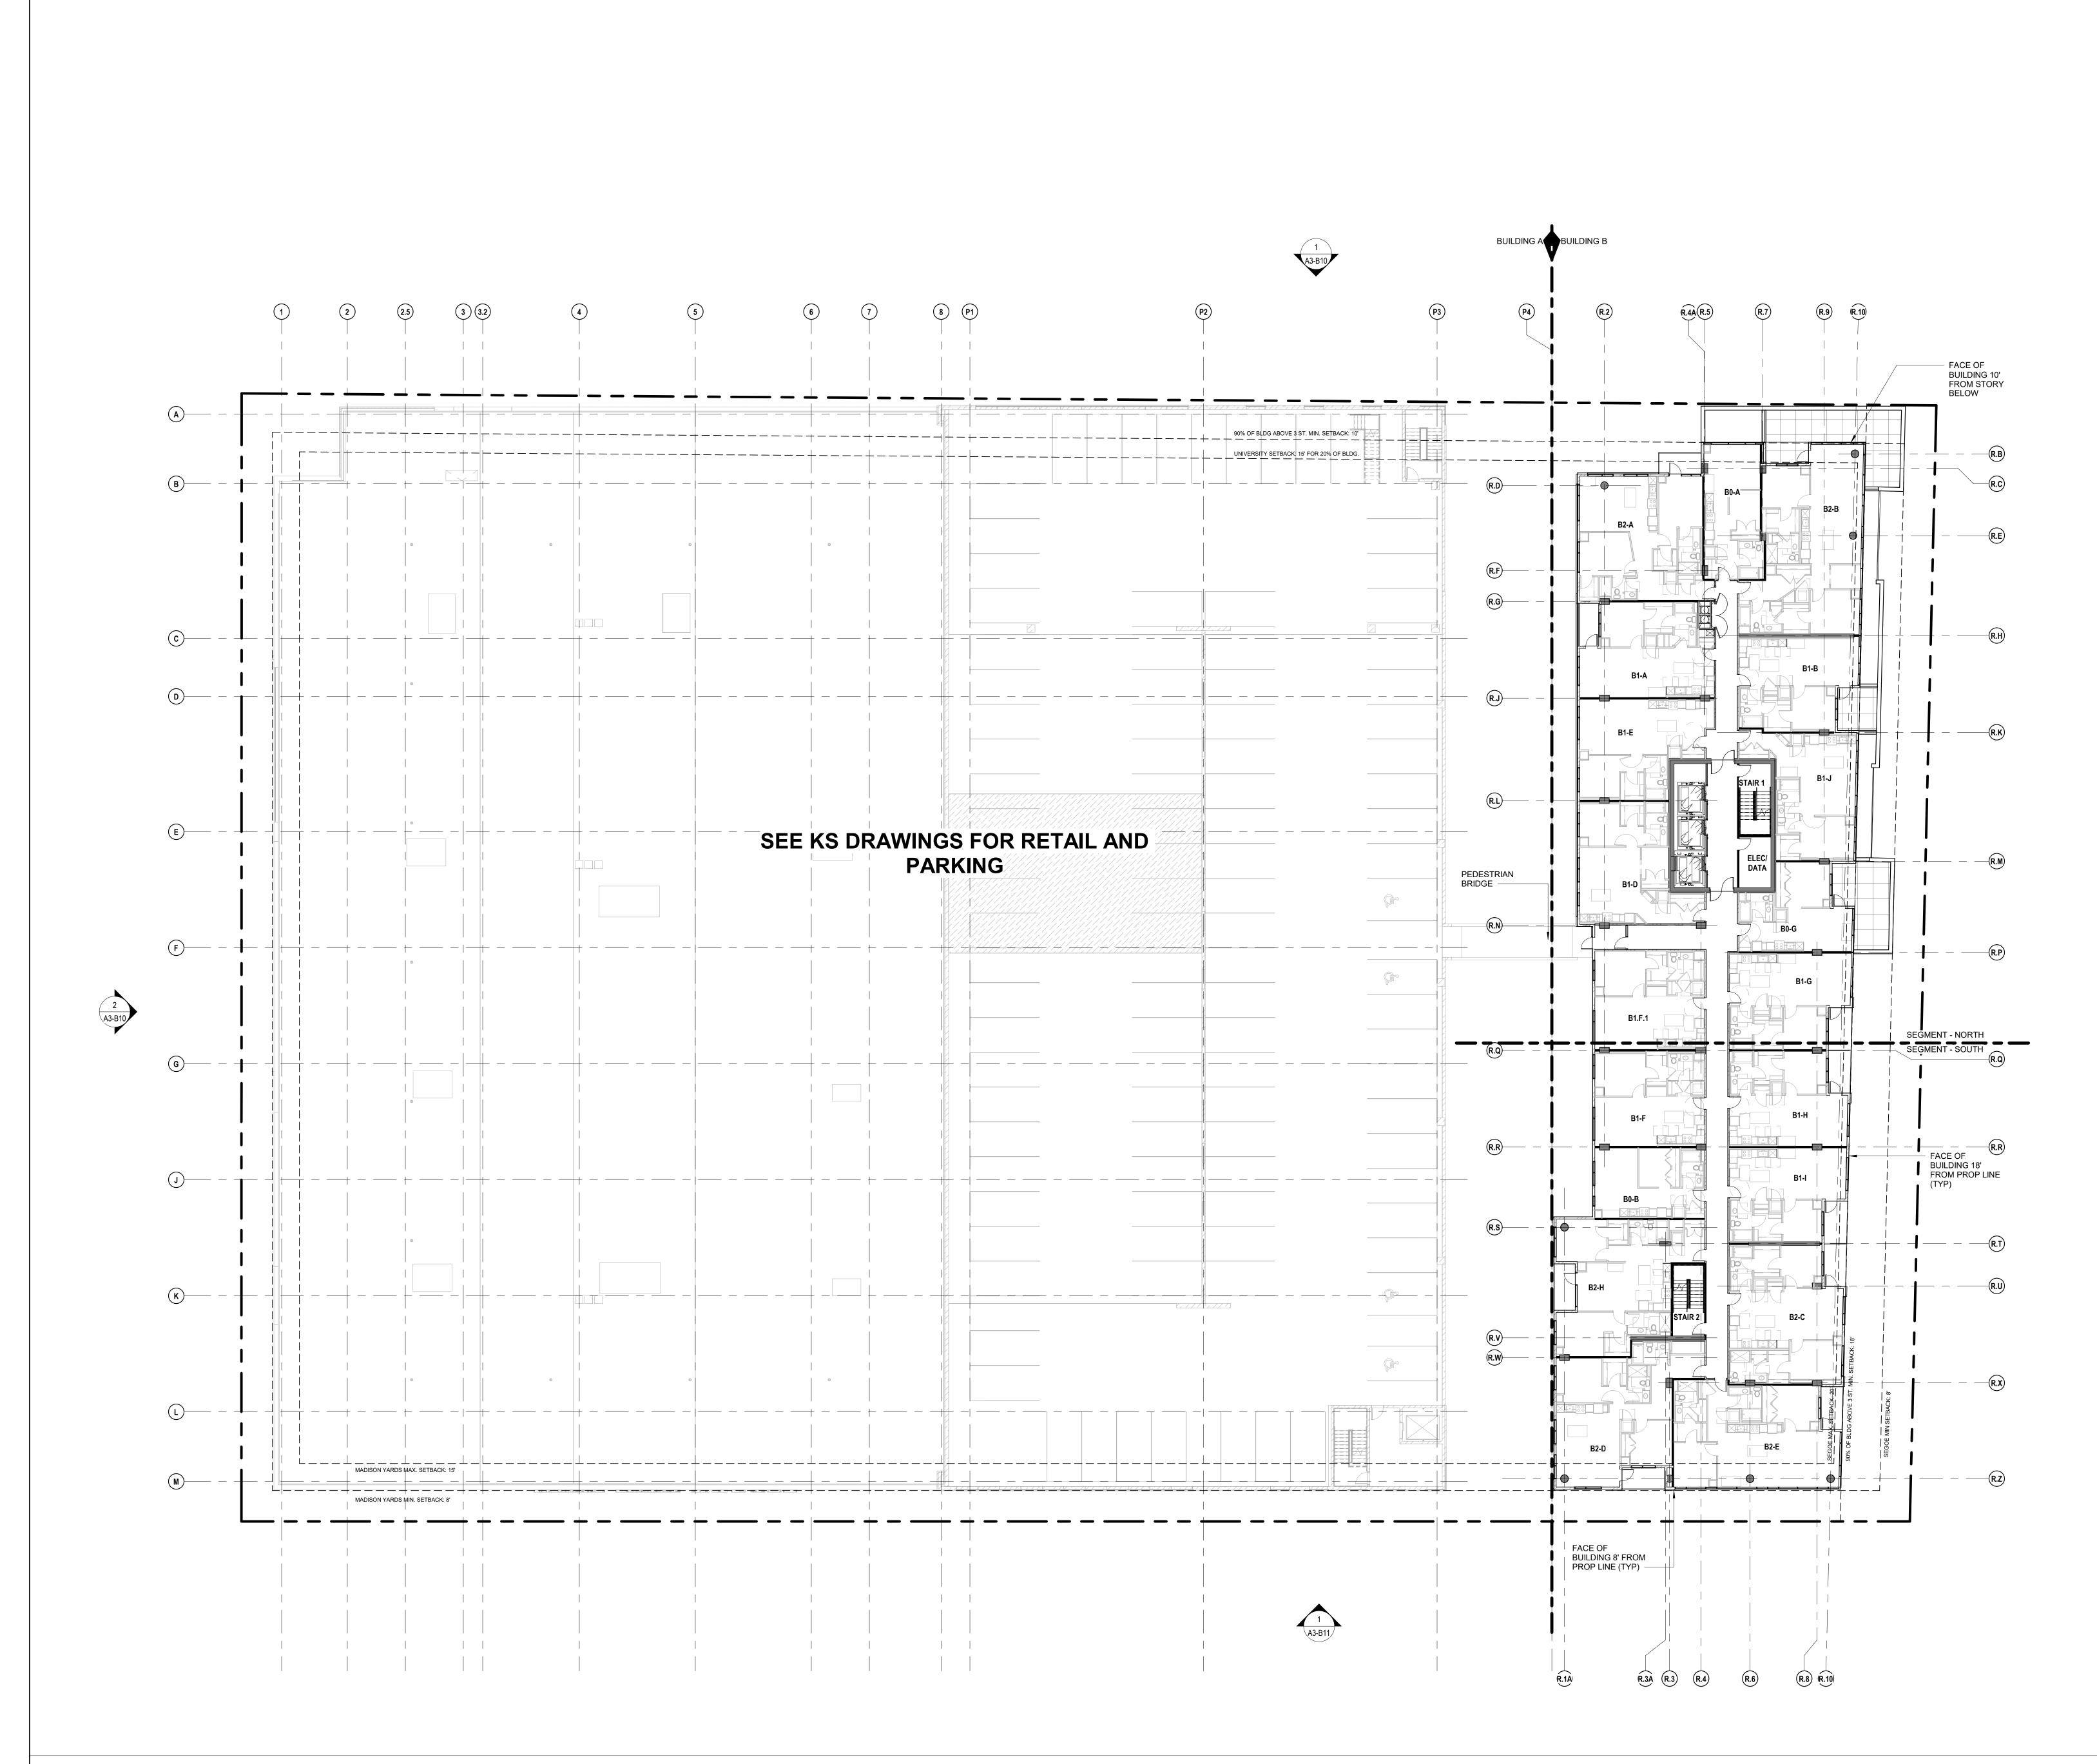
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No.	Date	Description			
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BUILDING B

OVERALL SECOND FLOOR PLAN (REFERENCE)







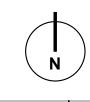

KTGY Project No:20200326Project Contact:Eric LukacsikEmail:elukacsik@ktgy.comPrincipal:Craig Pryde

Stavrianos

Developer

Project Designer:

SMITH Gilbane


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SON YARDS BLOCK 2
BUILDING B

No.	Date	Description
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riting of any per ontractor thorou onstruction show erceived errors	rceived errors or omission ighly knowledgeable with uld reasonably be aware.	uring construction to notify to so in the plans and specificathe building codes and met Written instructions addreseived from the architect price.

BUILDING B

OVERALL THIRD FLOOR PLAN (REFERENCE)



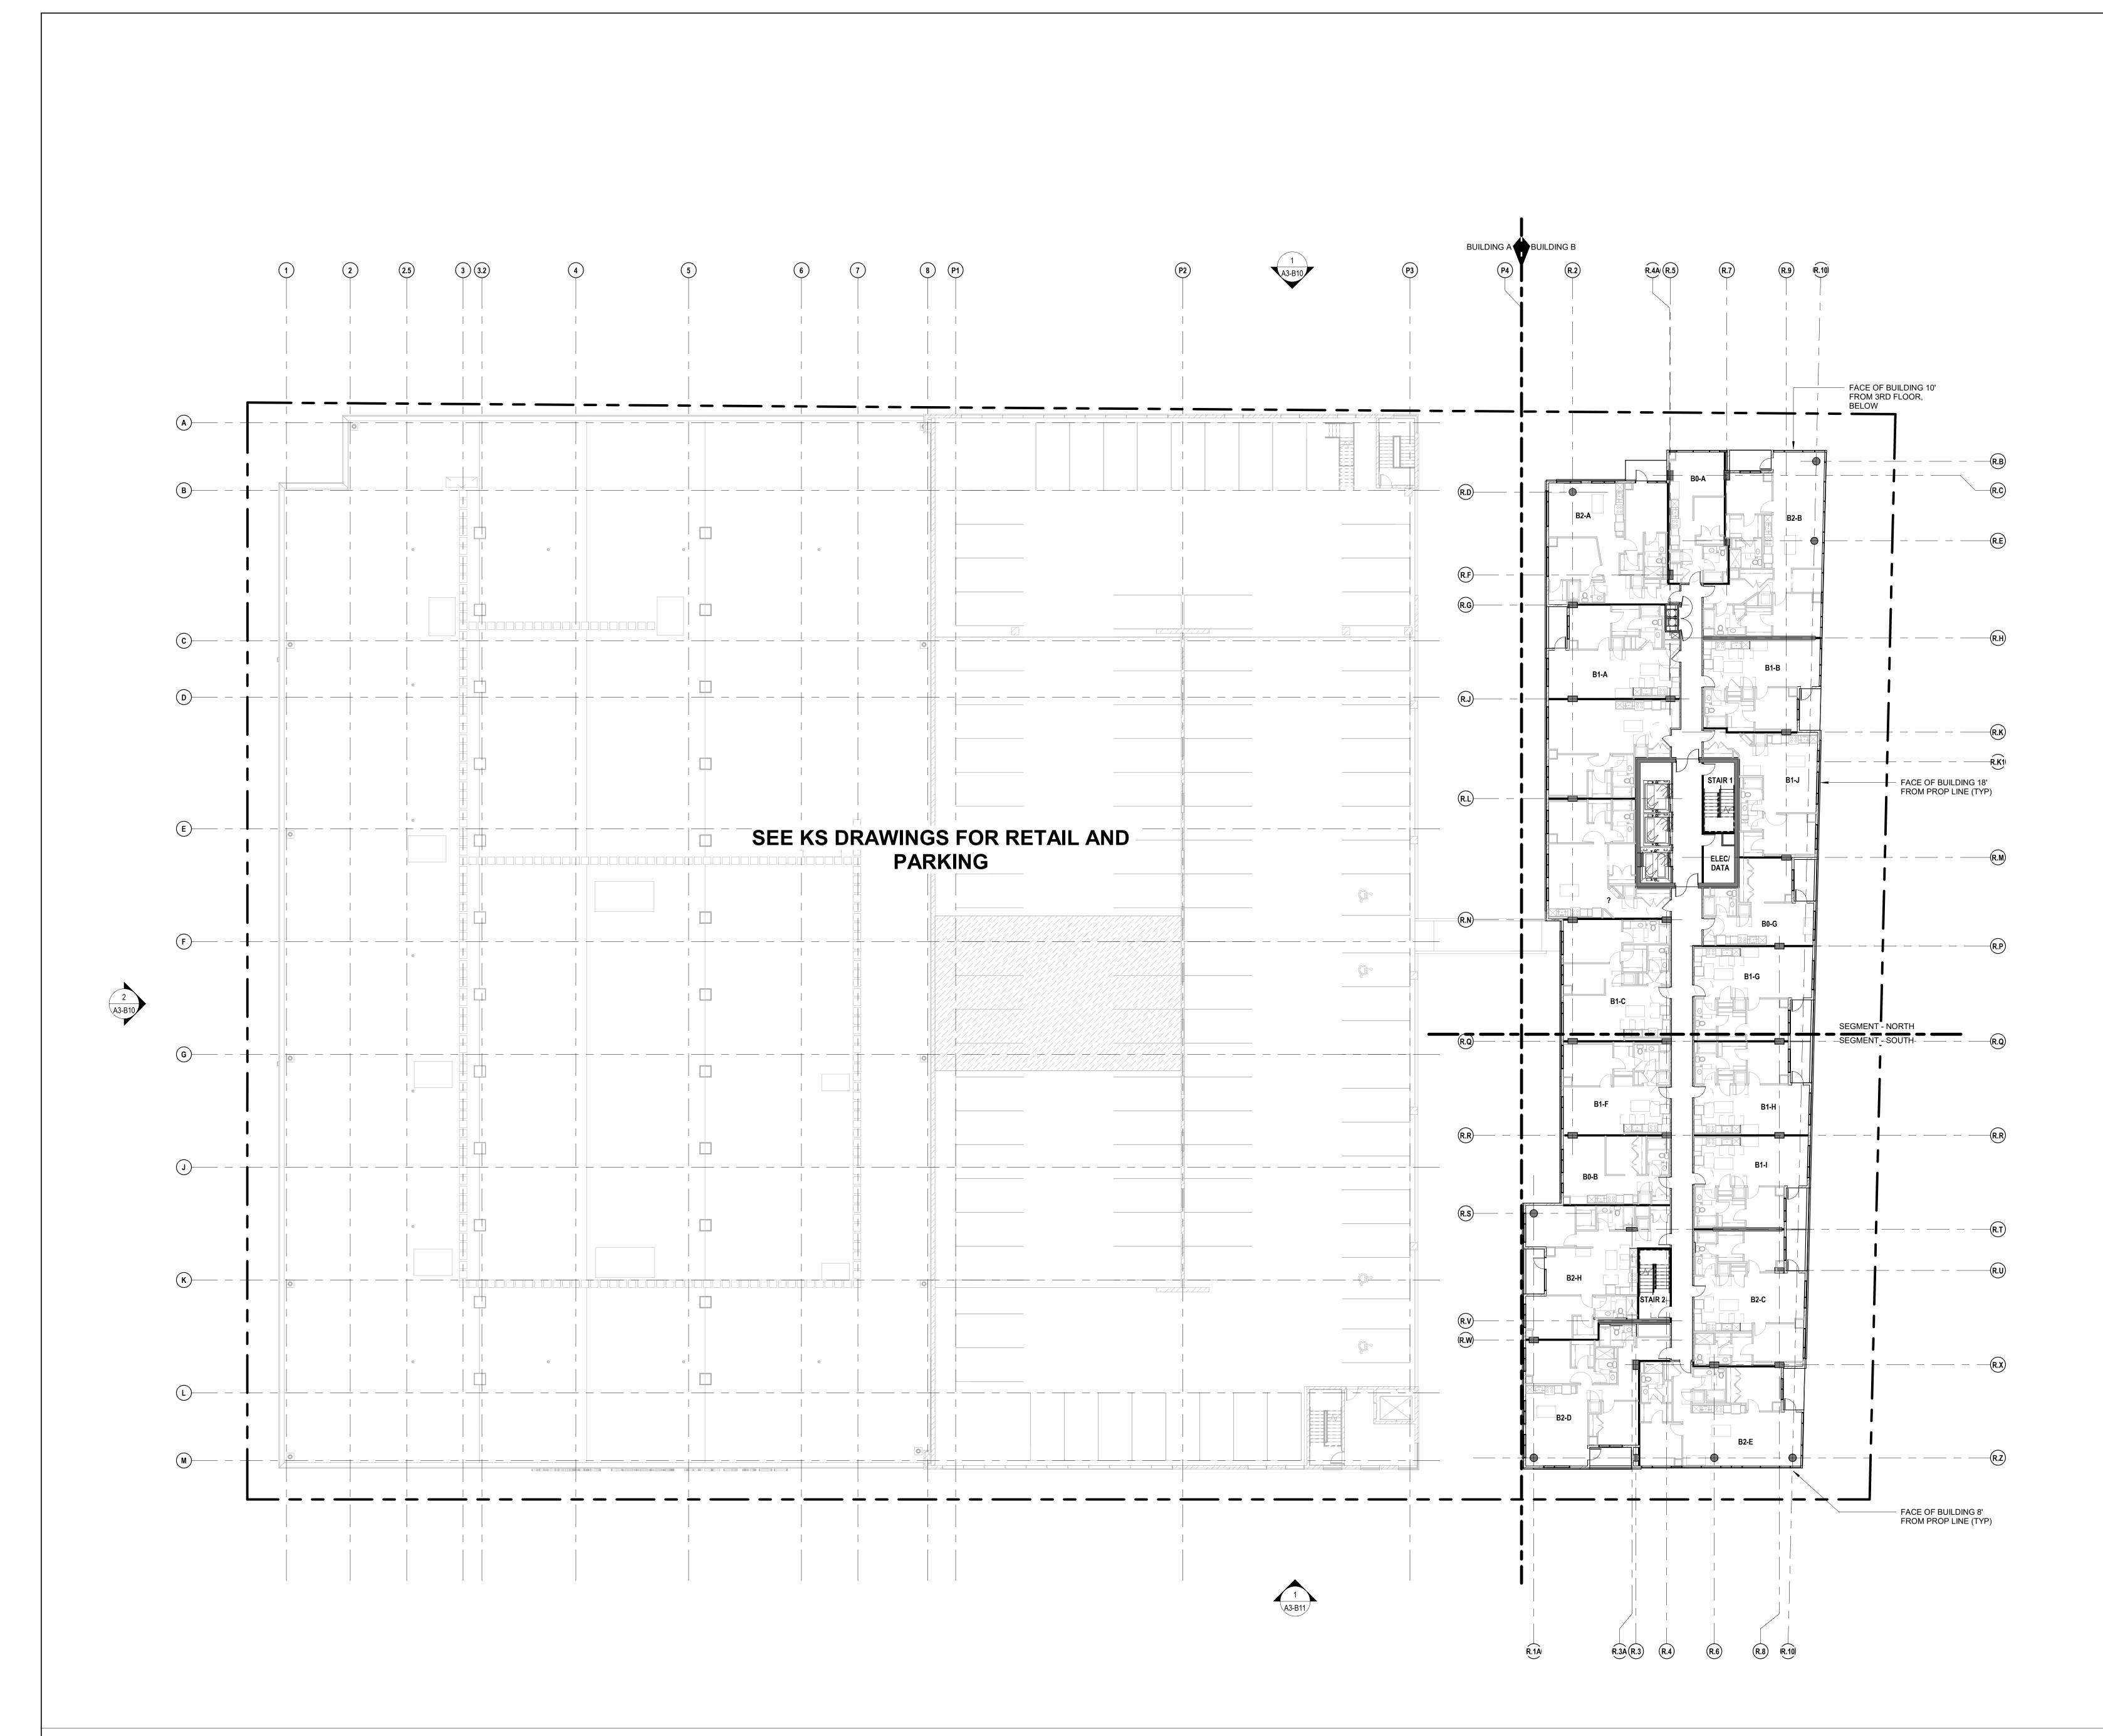



KTGY Project No:20200326Project Contact:Eric LukacsikEmail:elukacsik@ktgy.comPrincipal:Craig Pryde

Demetrios Stavrianos

Developer

Project Designer:

SMITH Gilbane

PHONE NO.

SON YARDS BLOCK 2 BUILDING B

No.	Date	Description
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ing of any pe tractor thoro struction sho	erceived errors or omission ughly knowledgeable with ould reasonably be aware	uring construction to notify the architect in ons in the plans and specifications of which in the building codes and methods of . Written instructions addressing such ceived from the architect prior to the clien

BUILDING B

OVERALL FOURTH FLOOR PLAN (REFERENCE)

BUILDING A BUILDING B A3-B12 (R.9) R.9A (R.10) R.10A R.10B R.10C (R.11) 25' - 9" 15' - 10" 89' - 9 3/8" **EXIT** CORRIDOR 800 _ B2₇F— 006 Ŕ.C2 SHUTTER -**ELEC ROOM** 010 (R.F)— 011 (R.G) $\stackrel{\infty}{\longrightarrow}$ TENANT **GREEN ROOF** STORAGE 005 | 012 TR-0 **GENERATOR** B1-K ¦ 013 STAIR 1 ST1-0 FIRE PUMP ROOM 014 MDF -ELEVATOR-015 LOBBY BUILDING 000 **MAINTENANCE** 016 DATA 001 **TENANT** STORAGE 017 CORRIDOR 018 R.N1 2 R.P. WATER PUMP 019 86' - 5 1/8" **VESIBULE** SEGMENT - NORTH SEGMENT - SOUTH

FLOOR PLAN GENERAL NOTES

- SEE SEGMENT PLANS FOR ADDITIONAL DIMENSIONS, TARGETS AND NOTES.
 ALL DIMENSIONS ARE TO THE FACE OF STUD (INTERIOR), FACE OF SHEATHING (EXTERIOR) OR FACE OF STRUCTURE
- UNLESS OTHERWISE NOTED.

 3. PROVIDE WATERPROOFING OF ELEVATOR PIT FOUNDATION WALLS AND INCLUDE SUMP PIT/ PUMPS FOR WATER DISHARGE.

 4. PROVIDE R-10 RIGID INSULATION ON
- INTERIOR SURFACE OF PERIMETER
 CONCRETE FOUNDATION WALL. INSULATION
 SHALL EXTEND FROM THE BOTTOM OF
 INTERIOR CONCRETE SLAB TO THE TOP OF
 THE FOOTING BUT NOT LESS THAN 4 FT
 BELOW GRADE.
- 5. PROVIDE R-10 RIGID INSULATION AT THE PERIMETER OF ALL INTERIOR SLAB ON GRADE LOCATIONS AT THE EXTERIOR WALL FOR A HORIZONTAL DISTANCE NOT LESS THAN 4 FT FROM THE INTERIOR FACE OF THE EXTERIOR WALL.
- 6. PROVIDE BRICK LEDGE IN EXTERIOR
 FOUNDATION WALL AND STEP WITH
 EXTERIOR FINISH GRADE SO NO
 FOUNDATION WALL IS EXPOSED. USE SOLID
 BRICK AND FULLY MORTARED CAVITY
 BELOW GRADE AND FLASH/ WEEP MASONRY
 CAVITY ABOVE GRADE. STEP FLASHING
- WITH FINISHED GRADE.

 7. FIRE ACCESS LOBBY NOT REQUIRED AT
- LOWER LEVEL (LEVEL OF EXIT DISCHARGE)

 8. STAIR #1 TO DISCHARGE TO BUILDING
 ENTRANCE AT SOUTH END OF LOWER
 LEVEL. INTERIOR AND EXTERIOR WALLS OF
 VESTIBULE SHALL BE ALUM STOREFRONT
 TO ALLOW VISIBILITY TO THE EXTERIOR.

 9. PROVIDE SUSPENDED ACOUSTICAL CEILING
- (9 FT MIN) IN CORRIDOR/ VESTIBULE AREAS OF LOWER LEVEL.

 0. ALL DOOR FRAMES SHALL BE PAINTED.
- 10. ALL DOOR FRAMES SHALL BE PAINTED.

 11. ALL NON-RESIDENTIAL UNIT
- DOORS/FRAMES SHALL BE HOLLOW METAL PAINTED THIS LEVEL.

 12. PROVIDE EMERGENCY LIGHTING AND EXIT
- LIGHTING PER CODE.
- 13. PROVIDE LED CORRIDOR LIGHTING ON OCCUPANCY SENSORS.14. PROVIDE HARD TROWELLED SEALED
- CONCRETE FLOORING IN ALL "BACK OF HOUSE" AREAS THIS LEVEL. 15. PROVIDE STRUCTURED BIKE PARKING FOR
- UP TO 25% OF TOTAL BIKE STORAGE REQUIREMENTS. INSTALL WALL MOUNTED SYSTEM AS INDICATED ON THE PLANS. 16. PROVIDE (2) 3 YARD CAPACITY TRASH
- COMPACTORS/ WITH HOPPER. CHUTES TO HAVE OVERHEAD RATED DISCHARGE DOORS.
- 17. INTERIOR PAINTING;
 A. BACK OF HOUSE PAINT ALL WALLS
- WITH SEMI-GLOSS/ FULL HEIGHT

 B. CORRIDORS EGSHELL TO CEILING OR
 AS NOTED.
- C. UNITS SEE INTERIOR DRAWINGS OR
 DESIGN NARRATIVE
 18. WALL PROTECTION PROVIDE CORNER
 GUARDS AT CORRIDOR IN BACK OF HOUSE
- AREA.

 19. PROVIDE STL PIPE RAILING (PTD) ON BOTH SIDES OF INTERIOR RAMP IN BACK OF
- HOUSE AREA.
 20. PROVIDE SUSPENDED LED LIGHTING IN ALL
 BACK OF HOUSE AREAS ON OCCUPANCY
- SENSORS.
 21. PROVIDE METAL PANEL CEILING ABOVE
 GARAGE ENTRY DRIVE AND LOWER LEVEL
 RESIDENT ENTRY WITH RECESSED LED
 LIGHTING CENTERED ON EACH DRIVE AISLE
 AND ENTRANCE WALKWAY ON 10 FT
- CENTERS

 22. EXPOSED CONCRETE COLUMNS, WALLS AT GARAGE ENTRY DRIVE SHALL BE PAINTED.





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Principal: Craig Pryde
Project Designer: Demetrios

Stavrianos

Developer



PHONE NO.

2

DISON YARDS BLOCK
BUILDING B


writing of any perceived errors or omissions in the plans and specifications of which a contractor thoroughly knowledgeable with the building codes and methods of construction should reasonably be aware. Written instructions addressing such perceived errors or omissions shall be received from the architect prior to the client or client's subcontractors proceeding with the work. The client will be responsible for any

defects in construction if these procedures are not followed.

BUILDING B

BUILDING B LOWER LEVEL PLAN



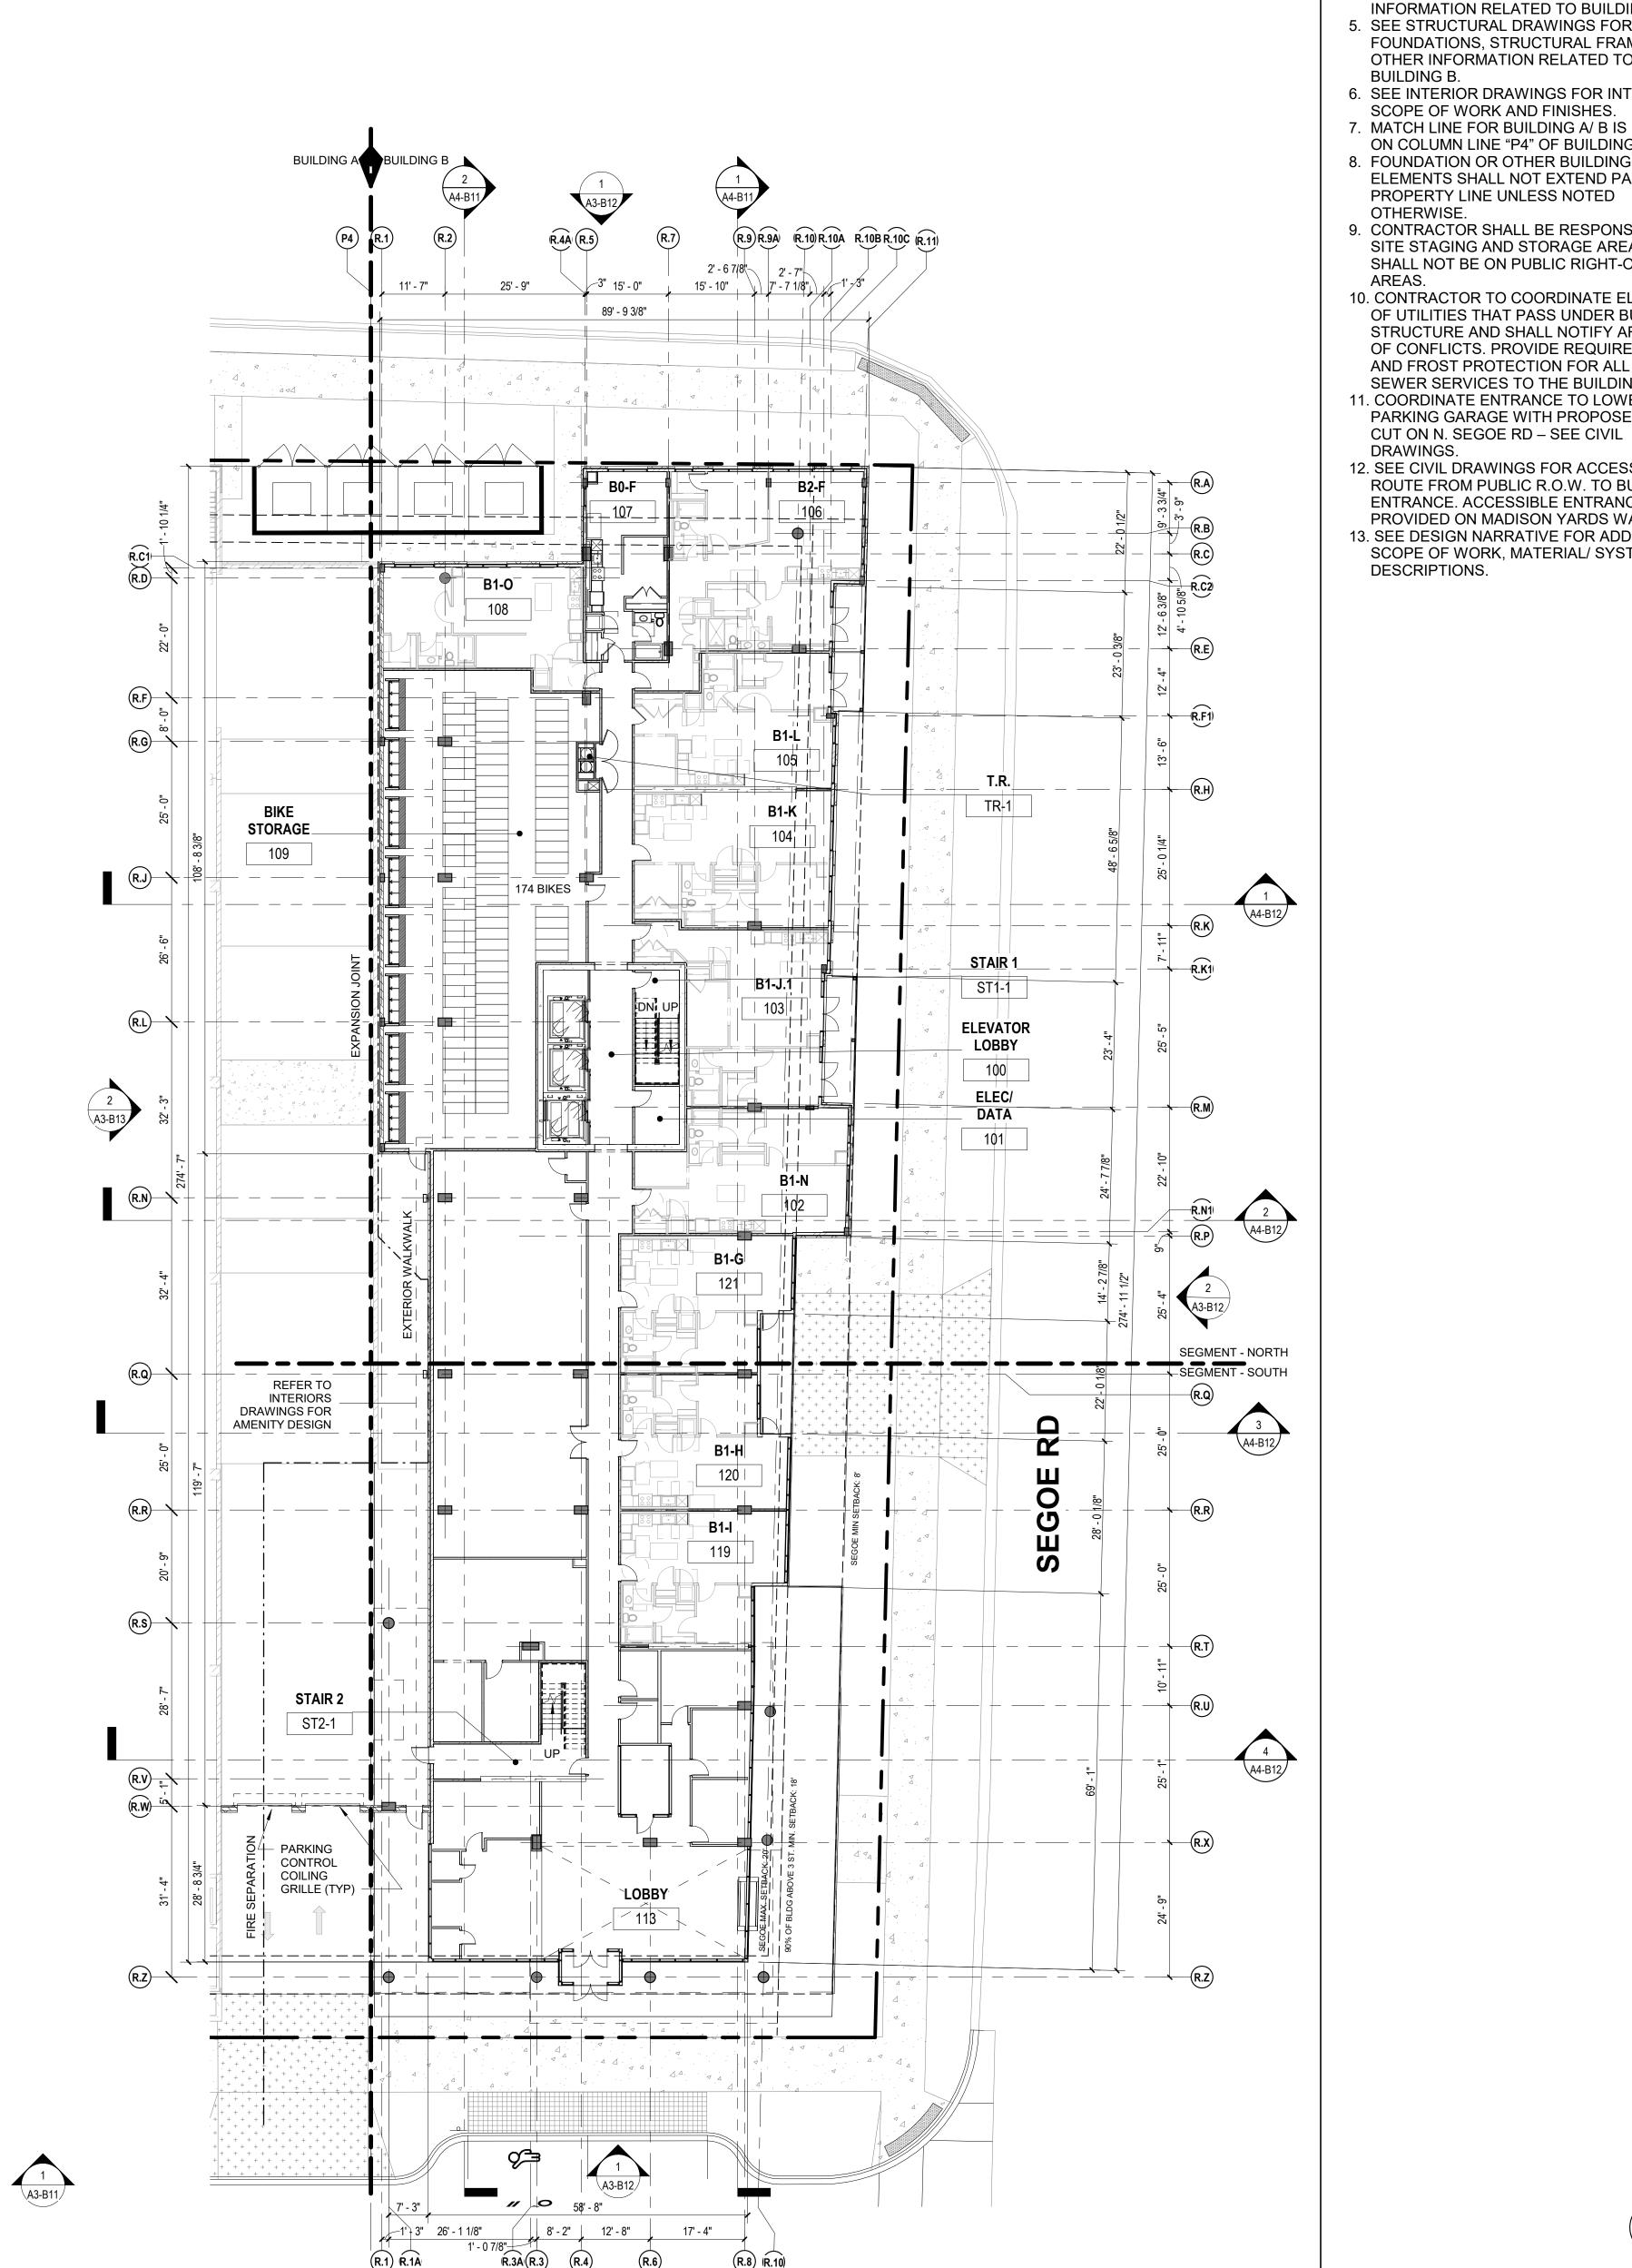

GENERAL NOTES

- 1. SEE CIVIL DRAWINGS FOR GRADE ELEVATIONS AT BUILDING EXTERIOR AND AT
- CONNECTIONS TO EXISTING AREAS. 2. SEE CIVIL DRAWINGS FOR UTILITY CONNECTION LOCATIONS
- 3. SEE CIVIL DRAWINGS FOR SOIL EROSION CONTROL.
- 4. SEE KAHLER SLATER (KS) DRAWINGS FOR INFORMATION RELATED TO BUILDING A. 5. SEE STRUCTURAL DRAWINGS FOR FOUNDATIONS, STRUCTURAL FRAME AND OTHER INFORMATION RELATED TO
- BUILDING B. 6. SEE INTERIOR DRAWINGS FOR INTERIOR
- SCOPE OF WORK AND FINISHES. 7. MATCH LINE FOR BUILDING A/B IS LOCATED
- ON COLUMN LINE "P4" OF BUILDING A. 8. FOUNDATION OR OTHER BUILDING ELEMENTS SHALL NOT EXTEND PAST THE
- PROPERTY LINE UNLESS NOTED OTHERWISE. 9. CONTRACTOR SHALL BE RESPONSIBLE FOR
- SITE STAGING AND STORAGE AREAS AND SHALL NOT BE ON PUBLIC RIGHT-OF-WAY AREAS. 10. CONTRACTOR TO COORDINATE ELEVATION OF UTILITIES THAT PASS UNDER BUILDING B STRUCTURE AND SHALL NOTIFY ARCHITECT
- OF CONFLICTS. PROVIDE REQUIRED COVER AND FROST PROTECTION FOR ALL WATER/ SEWER SERVICES TO THE BUILDING. 11. COORDINATE ENTRANCE TO LOWER LEVEL PARKING GARAGE WITH PROPOSED CURB
- 12. SEE CIVIL DRAWINGS FOR ACCESSIBLE ROUTE FROM PUBLIC R.O.W. TO BUILDING ENTRANCE. ACCESSIBLE ENTRANCE PROVIDED ON MADISON YARDS WAY.
- 13. SEE DESIGN NARRATIVE FOR ADDITIONAL SCOPE OF WORK, MATERIAL/ SYSTEMS DESCRIPTIONS.





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Developer



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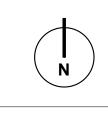
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BUILDING B

BUILDING B FIRST FLOOR PLAN



OVERALL FIRST FLOOR PLAN 1/16" = 1'-0" 1

A2-B10

BUILDING A BUILDING B R.9 R.9A (R.10) 15' - 0" 25' - 9" 80' - 11 1/8" 28' - 1" 52' - 10 1/8" —B0-F− B2-F 208 **GREEN ROOF** R.F (R.G) 205 (R.L)— 222 SEGMENT - NORTH 218

GENERAL NOTES

- SEE CIVIL DRAWINGS FOR GRADE
 ELEVATIONS AT BUILDING EXTERIOR AND AT
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- CONNECTIONS TO EXISTING AREAS.

 2. SEE CIVIL DRAWINGS FOR UTILITY
 CONNECTION LOCATIONS
- SEE CIVIL DRAWINGS FOR SOIL EROSION CONTROL.
 SEE KAHLER SLATER (KS) DRAWINGS FOR
- INFORMATION RELATED TO BUILDING A.
 5. SEE STRUCTURAL DRAWINGS FOR
 FOUNDATIONS, STRUCTURAL FRAME AND
 OTHER INFORMATION RELATED TO
 BUILDING B.
- 6. SEE INTERIOR DRAWINGS FOR INTERIOR SCOPE OF WORK AND FINISHES.
- 7. MATCH LINE FOR BUILDING A/ B IS LOCATED ON COLUMN LINE "P4" OF BUILDING A.
- 8. FOUNDATION OR OTHER BUILDING ELEMENTS SHALL NOT EXTEND PAST THE PROPERTY LINE UNLESS NOTED OTHERWISE.
- 9. CONTRACTOR SHALL BE RESPONSIBLE FOR SITE STAGING AND STORAGE AREAS AND SHALL NOT BE ON PUBLIC RIGHT-OF-WAY AREAS.

10. CONTRACTOR TO COORDINATE ELEVATION

- OF UTILITIES THAT PASS UNDER BUILDING B
 STRUCTURE AND SHALL NOTIFY ARCHITECT
 OF CONFLICTS. PROVIDE REQUIRED COVER
 AND FROST PROTECTION FOR ALL WATER/
 SEWER SERVICES TO THE BUILDING.
- SEWER SERVICES TO THE BUILDING.

 11. COORDINATE ENTRANCE TO LOWER LEVEL PARKING GARAGE WITH PROPOSED CURB CUT ON N. SEGOE RD SEE CIVIL DRAWINGS.
- 12. SEE CIVIL DRAWINGS FOR ACCESSIBLE
 ROUTE FROM PUBLIC R.O.W. TO BUILDING
 ENTRANCE. ACCESSIBLE ENTRANCE
 PROVIDED ON MADISON YARDS WAY.
- 13. SEE DESIGN NARRATIVE FOR ADDITIONAL SCOPE OF WORK, MATERIAL/ SYSTEMS DESCRIPTIONS.





HILL FARMS

Project Contact: Eric Lukacsik
Email: elukacsik@ktgy.com
Principal: Craig Pryde
Project Designer: Demetrios
Stavrianos

KTGY Project No: 20200326

Developer



PHONE NO.

MADISON YARDS BLOCK 2 BUILDING B

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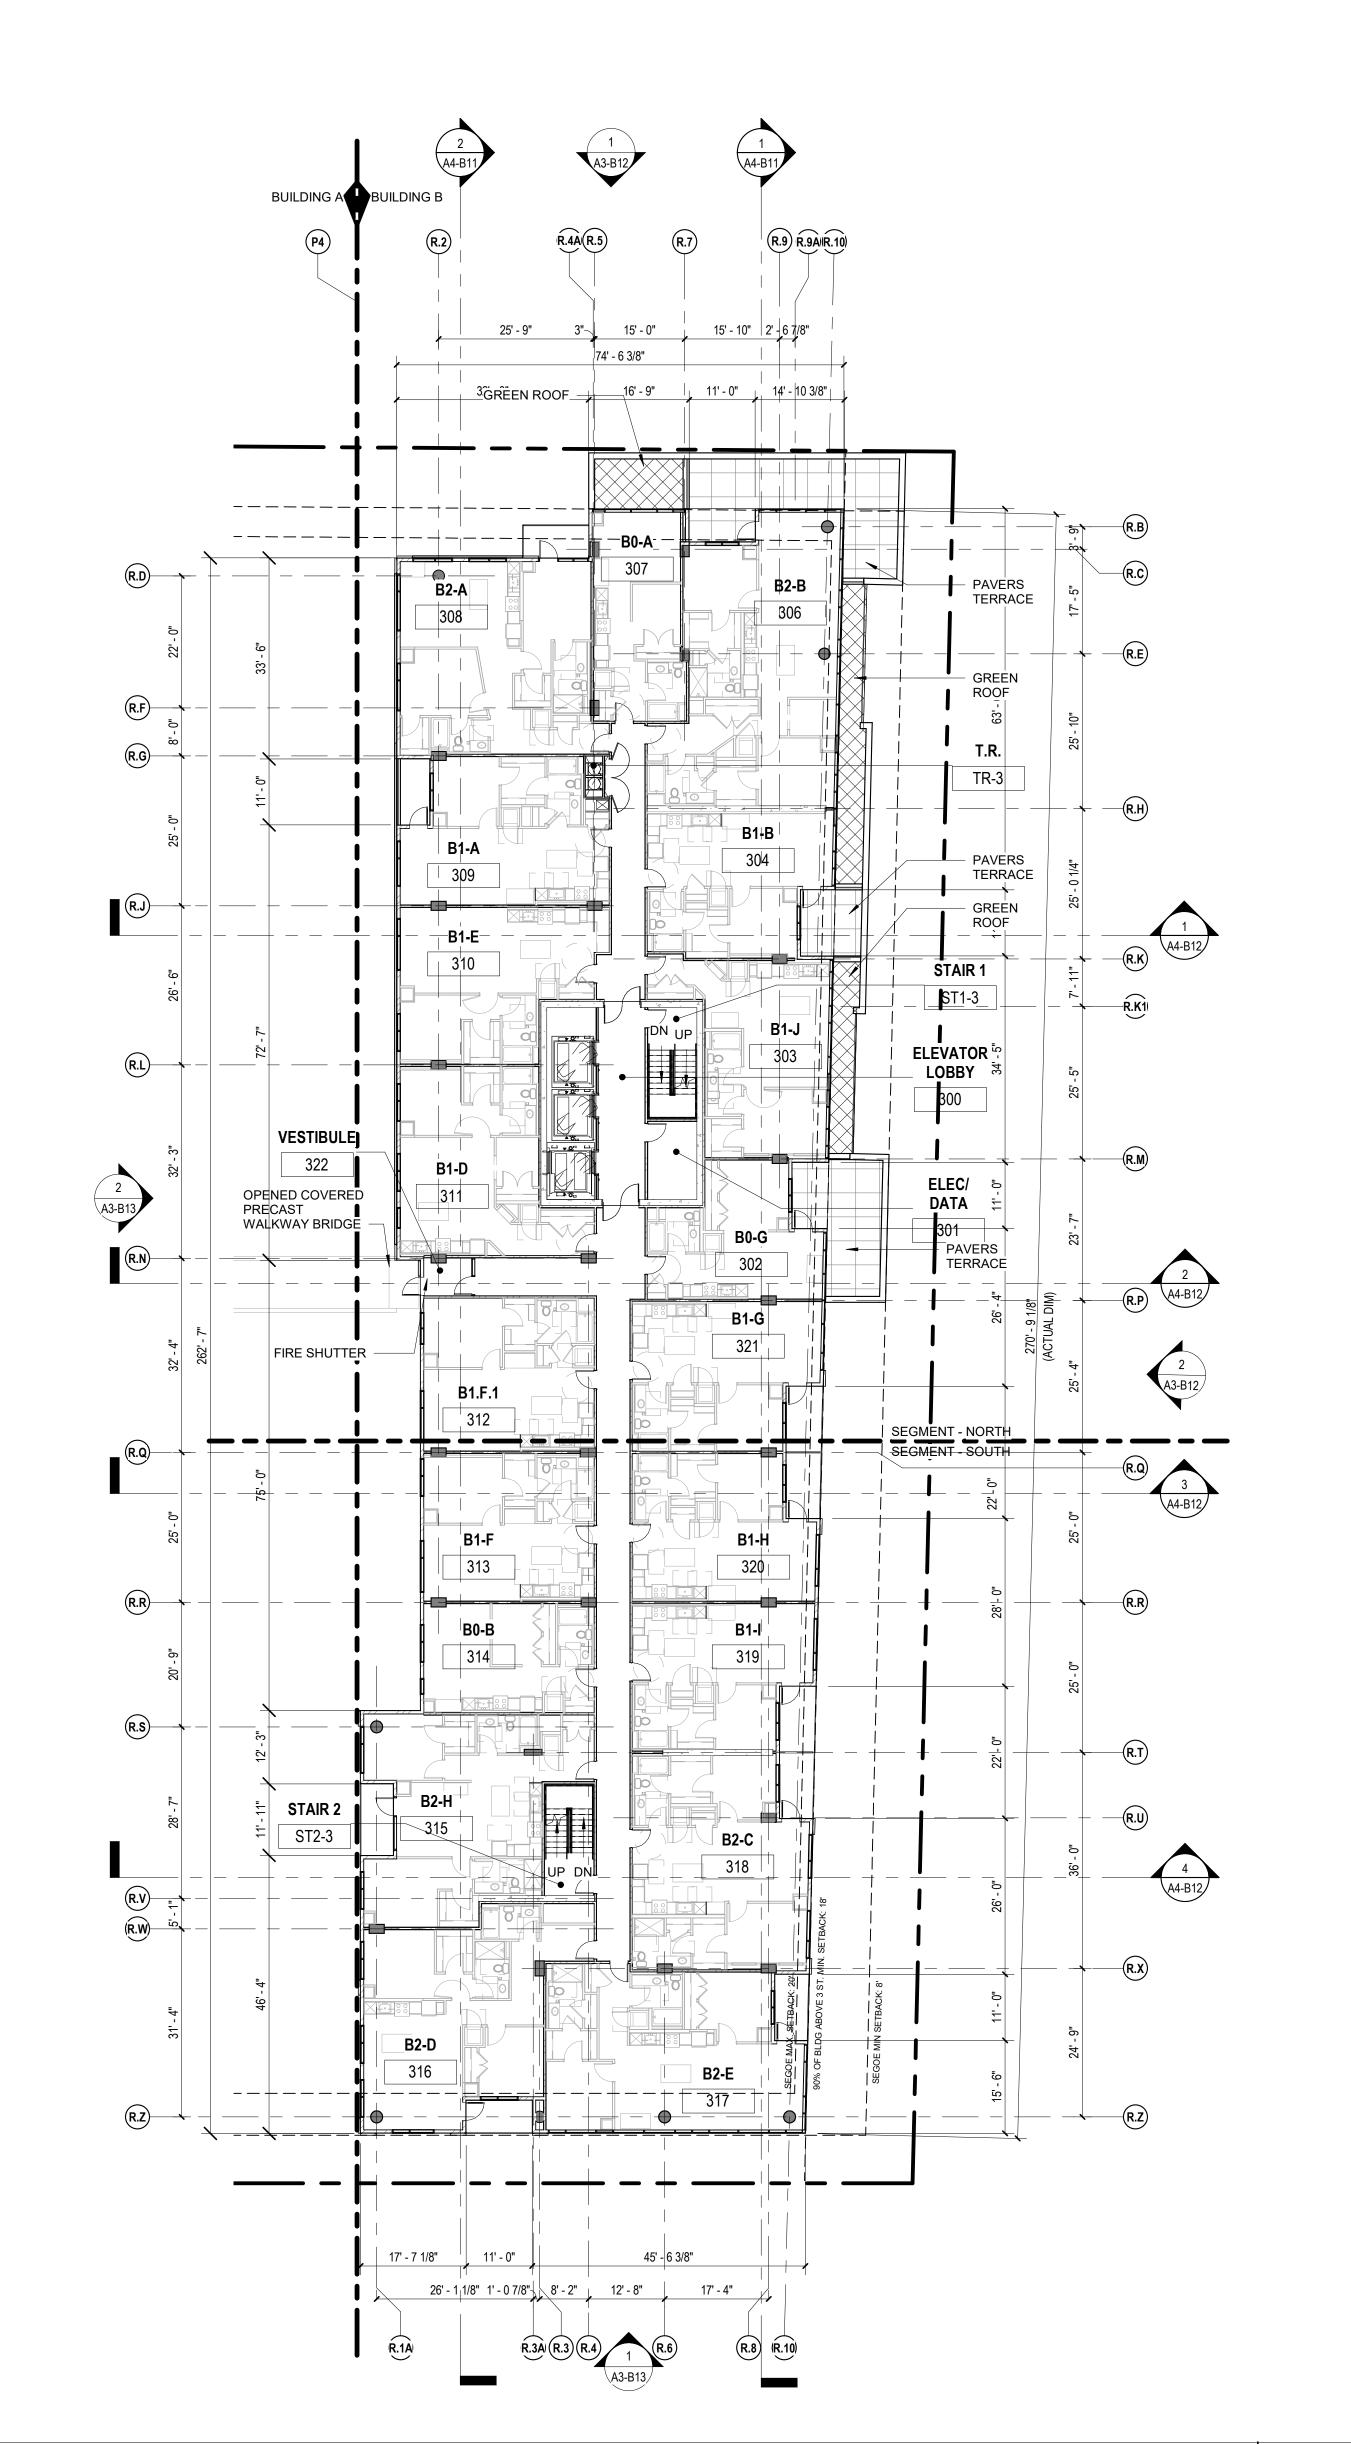
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BUILDING B

OVERALL SECOND FLOOR PLAN 1/16" = 1'-0" 1

BUILDING B SECOND FLOOR PLAN





GENERAL NOTES

- SEE CIVIL DRAWINGS FOR GRADE
 ELEVATIONS AT BUILDING EXTERIOR AND AT
 CONNECTIONS TO EXISTING AREAS
- CONNECTIONS TO EXISTING AREAS.

 2. SEE CIVIL DRAWINGS FOR UTILITY
 CONNECTION LOCATIONS
- 3. SEE CIVIL DRAWINGS FOR SOIL EROSION CONTROL.4. SEE KAHLER SLATER (KS) DRAWINGS FOR
- INFORMATION RELATED TO BUILDING A.

 5. SEE STRUCTURAL DRAWINGS FOR
 FOUNDATIONS, STRUCTURAL FRAME AND
 OTHER INFORMATION RELATED TO
- BUILDING B.

 6. SEE INTERIOR DRAWINGS FOR INTERIOR

 COORE OF WORK AND FINISHED.
- SCOPE OF WORK AND FINISHES.

 7. MATCH LINE FOR BUILDING A/ B IS LOCATED ON COLUMN LINE "P4" OF BUILDING A.
- 8. FOUNDATION OR OTHER BUILDING ELEMENTS SHALL NOT EXTEND PAST THE PROPERTY LINE UNLESS NOTED
- OTHERWISE.

 9. CONTRACTOR SHALL BE RESPONSIBLE FOR SITE STAGING AND STORAGE AREAS AND SHALL NOT BE ON PUBLIC RIGHT-OF-WAY

AREAS.

- 10. CONTRACTOR TO COORDINATE ELEVATION
 OF UTILITIES THAT PASS UNDER BUILDING B
 STRUCTURE AND SHALL NOTIFY ARCHITECT
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 11. COORDINATE ENTRANCE TO LOWER LEVEL PARKING GARAGE WITH PROPOSED CURB CUT ON N. SEGOE RD SEE CIVIL DRAWINGS.
- 12. SEE CIVIL DRAWINGS FOR ACCESSIBLE ROUTE FROM PUBLIC R.O.W. TO BUILDING ENTRANCE. ACCESSIBLE ENTRANCE PROVIDED ON MADISON YARDS WAY.
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Developer



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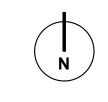
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BUILDING B

BUILDING B THIRD FLOOR PLAN



A3-B12 BUILDING A BUILDING B (R.9)(R.9A) (R.10) 32' - 0" 16' - 9" B0-A 407 406 R.F R.G — [∞] TR-4 (R.J) STAIR 1 DATA 401 (R.N) SEGMENT - NORTH 420[|] 418 STAIR 2 17' - 8" R.1A

GENERAL NOTES

- 1. SEE CIVIL DRAWINGS FOR GRADE ELEVATIONS AT BUILDING EXTERIOR AND AT
- CONNECTIONS TO EXISTING AREAS.

 2. SEE CIVIL DRAWINGS FOR UTILITY
 CONNECTION LOCATIONS
- 3. SEE CIVIL DRAWINGS FOR SOIL EROSION CONTROL.
- 4. SEE KAHLER SLATER (KS) DRAWINGS FOR INFORMATION RELATED TO BUILDING A.
- 5. SEE STRUCTURAL DRAWINGS FOR FOUNDATIONS, STRUCTURAL FRAME AND OTHER INFORMATION RELATED TO BUILDING B.
- 6. SEE INTERIOR DRAWINGS FOR INTERIOR SCOPE OF WORK AND FINISHES.
- 7. MATCH LINE FOR BUILDING A/B IS LOCATED ON COLUMN LINE "P4" OF BUILDING A.
- 8. FOUNDATION OR OTHER BUILDING ELEMENTS SHALL NOT EXTEND PAST THE PROPERTY LINE UNLESS NOTED OTHERWISE.
- 9. CONTRACTOR SHALL BE RESPONSIBLE FOR SITE STAGING AND STORAGE AREAS AND SHALL NOT BE ON PUBLIC RIGHT-OF-WAY AREAS.
- 10. CONTRACTOR TO COORDINATE ELEVATION
 OF UTILITIES THAT PASS UNDER BUILDING B
 STRUCTURE AND SHALL NOTIFY ARCHITECT
 OF CONFLICTS. PROVIDE REQUIRED COVER
 AND FROST PROTECTION FOR ALL WATER/
 SEWER SERVICES TO THE BUILDING.
- SEWER SERVICES TO THE BUILDING.

 11. COORDINATE ENTRANCE TO LOWER LEVEL PARKING GARAGE WITH PROPOSED CURB CUT ON N. SEGOE RD SEE CIVIL DRAWINGS.
- 12. SEE CIVIL DRAWINGS FOR ACCESSIBLE ROUTE FROM PUBLIC R.O.W. TO BUILDING ENTRANCE. ACCESSIBLE ENTRANCE PROVIDED ON MADISON YARDS WAY.
- 13. SEE DESIGN NARRATIVE FOR ADDITIONAL SCOPE OF WORK, MATERIAL/ SYSTEMS DESCRIPTIONS.





HILL FARMS

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Project Designer: Demetrios

Developer



Stavrianos

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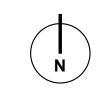
MADISON YARDS BLOCK 2 BUILDING B

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BUILDING B

BUILDING B 4-14 FLOOR PLAN



BUILDING A BUILDING B R.5 R.5A 42' - 7 3/8" **ROOF DECK** 1505 **ROOF TOP** CHILLER 1506 INTERIORS DRAWINGS FOR R.L 1500 1507 1520 (R.S)—— STAIR 2 1518 1 A3-B13

GENERAL NOTES

- SEE CIVIL DRAWINGS FOR GRADE
 ELEVATIONS AT BUILDING EXTERIOR AND AT
 CONNECTIONS TO EXISTING AREAS
- CONNECTIONS TO EXISTING AREAS.

 2. SEE CIVIL DRAWINGS FOR UTILITY
 CONNECTION LOCATIONS
- SEE CIVIL DRAWINGS FOR SOIL EROSION CONTROL.
- SEE KAHLER SLATER (KS) DRAWINGS FOR INFORMATION RELATED TO BUILDING A.
 SEE STRUCTURAL DRAWINGS FOR FOUNDATIONS, STRUCTURAL FRAME AND OTHER INFORMATION RELATED TO
- BUILDING B.

 6. SEE INTERIOR DRAWINGS FOR INTERIOR
- SCOPE OF WORK AND FINISHES.

 7. MATCH LINE FOR BUILDING A/ B IS LOCATED
 ON COLUMN LINE "PA" OF BUILDING A
- ON COLUMN LINE "P4" OF BUILDING A.

 8. FOUNDATION OR OTHER BUILDING
 ELEMENTS SHALL NOT EXTEND PAST THE
- PROPERTY LINE UNLESS NOTED
 OTHERWISE.

 9. CONTRACTOR SHALL BE RESPONSIBLE FOR
 SITE STAGING AND STORAGE AREAS AND
- SHALL NOT BE ON PUBLIC RIGHT-OF-WAY AREAS.

 10. CONTRACTOR TO COORDINATE ELEVATION OF UTILITIES THAT PASS UNDER BUILDING B STRUCTURE AND SHALL NOTIFY ARCHITECT
- OF CONFLICTS. PROVIDE REQUIRED COVER AND FROST PROTECTION FOR ALL WATER/SEWER SERVICES TO THE BUILDING.

 11. COORDINATE ENTRANCE TO LOWER LEVEL PARKING GARAGE WITH PROPOSED CURB CUT ON N. SEGOE RD SEE CIVIL
- DRAWINGS.

 12. SEE CIVIL DRAWINGS FOR ACCESSIBLE
 ROUTE FROM PUBLIC R.O.W. TO BUILDING
 ENTRANCE. ACCESSIBLE ENTRANCE
 PROVIDED ON MADISON YARDS WAY.
- 13. SEE DESIGN NARRATIVE FOR ADDITIONAL SCOPE OF WORK, MATERIAL/ SYSTEMS DESCRIPTIONS.





HILL FARMS

Project Contact: Eric Lukacsik
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Principal: Craig Pryde
Project Designer: Demetrios

KTGY Project No: 20200326

Developer



Stavrianos

PHONE NO.

ADISON YARDS BLOCK 2 BUILDING B

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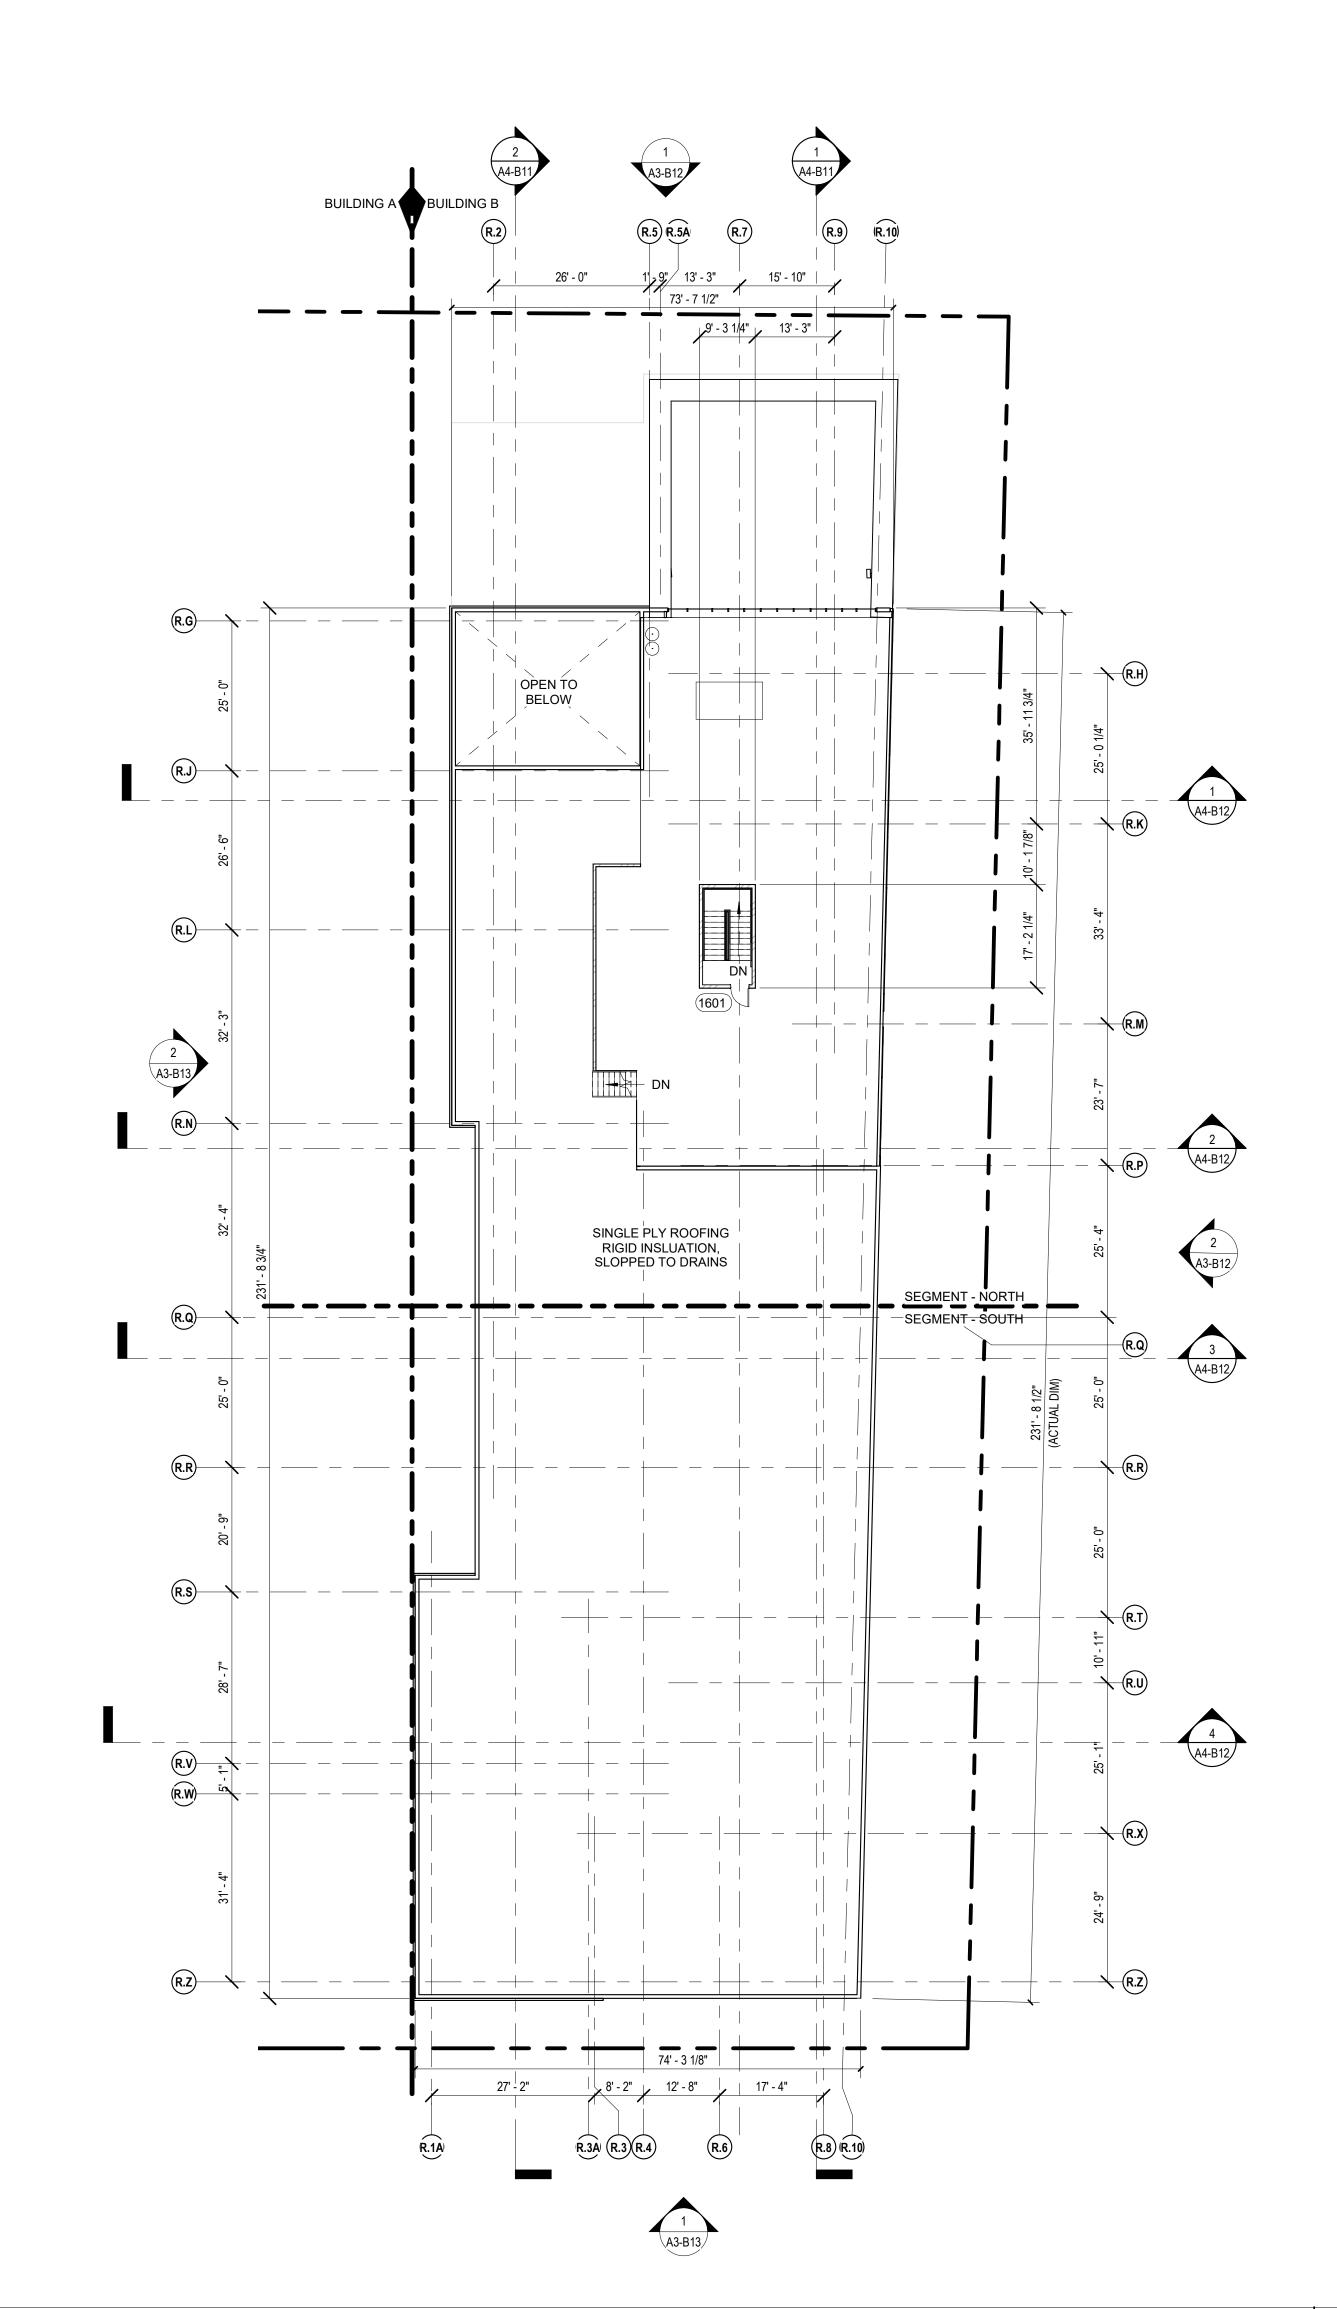
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BUILDING B

 $\binom{1}{N}$

BUILDING B FIFTEENTH FLOOR PLAN







MADISON YARDS HILL FARMS

KTGY Project No: 20200326

Project Contact: Eric Lukacsik
Email: elukacsik@ktgy.com
Principal: Craig Pryde
Project Designer: Demetrios

Developer


SMITH Gilbane

PHONE NO.

ADISON YARDS BLOCK 2
BUILDING B

BUILDING B

BUILDING B ROOF AND PENTHOUSE PLANS

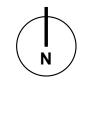



TOP OF ROOF 2 157' - 4" TOP OF ROOF 1 152' - 4" 140' - 4" <u>LEVEL 14</u> 129' - 8" LEVEL 13_120' - 0" LEVEL 12 110' - 4" 91' - 0" LEVEL 9 <u>LEVEL 6</u> 52' - 4" 5TH FLOOR (PARKING) LEVEL 5 42' - 8" 4TH FLOOR (PARKING) 35' - 0" LEVEL 4 LEVEL 3 23' - 4" 3RD FLOOR (PARKING) 23' - 4" <u>LEVEL 2</u> 12' - 8" _ 2ND FLOOR (PARKING) 11' - 8" 1ST FLOOR (GROCER) 0' - 0" LEVEL 1 -1' - 0" LOWER LEVEL RAMP -13' - 0" LOWER LEVEL 1 -12' - 0" RECEIVING DOCK (GROCER) -15' - 4" LOADING DOCK -19' - 4"

ELEVATION NOTES

- . SEE CIVIL DRAWINGS FOR FINISH GRADES. 2. SEE MATERIAL NOTES FOR DESCRIPTION OF MATERIALS PROPOSED. SEE DESIGN NARRATIVE FOR ADDITIONAL INFORMATION.
- 3. BUILDING B: EXTERIOR WALL RATINGS/ PROTECTED OPENINGS: A. NORTH WALL = 0-HOUR/ UNLIMITED
- B. EAST WALL = 0-HOUR/ UNLIMITED
- C. SOUTH WALL = 0-HOUR/ UNLIMITED OPENINGS.
- D. WEST WALL a. 1ST FLOOR – SEE PLAN b. 2ND FLOOR – SEE PLAN c. 3^{RD} FLR -15^{TH} FLR -0-HOUR/
- 705.8.6) 4. EXTERIOR WALL IS INTENDED TO BE A SINGLE SOURCE RESPONSIBILITY AND IS FURTHER DEFINED IN THE DESIGN
- A. WINDOW WALL SYSTEM GLAZED WITI TINTED INSULATED GLASS PANELS INCLUDING OPERABLE WINDOWS. SEE
- DESIGN NARRATIVE/ DRAWINGS FOR SPECIFICATION. B. PROVIDE TEMPERED GLAZING WHERE
- REQUIRED BY CODE. C. WINDOW WALL SYSTEM - GLAZED WITH INSULATED METAL PANEL. SEE DESIGN NARRATIVE/ DRAWINGS FOR COLOR AND
- SPECIFICATION. D. IBC SECTION 1609.4.2 – SURFACE
- ROUGHNESS B E. IBC SECTION 1609.4.3 - EXPOSURE
- CATEGORY C F. DELEGATED DESIGN FOR EXTERIOR WALL ASSEMBLY FOR WIND LOAD
- REQUIREMENTS/ AIR AND WATER CONTINUITY DESIGN. G. TYPICAL EXTERIOR WALL TO BE
- INDEPENDENTLY LABARATORY TESTED FOR AIR INFILTRATION PER ASTM E283, WATER INFILTRATION PER ASTM E331
- AND AAMA 501.1 AT 12 LB/SF. H. INCLUDE THREE FIELD VERIFICATION TESTS PER AAMA 502. 5. A VAPOR RESISTANT AIR AND WATER
- "CLADDING" MATERIALS CONSTRUCTED OVER EXTERIOR SHEATHINGS, MASONRY OR CONCRETE. THE GENERAL ARCHITECT, THE TRANSITIONS OF ALL AIR
- 6. PROVIDE SEALANTS AT ALL CHANGE OF MATERIALS ON THE EXTERIOR WALL IN COLOR AS SELECTED BY THE ARCHITECT. PROVIDE COMPATABILTY TESTING WHERE REQUIRED.
- PROVIDE COPING/ FLASHINGS AT ALL TOP OF WALL AREAS THAT ARE FULLY INTEGRATED WITH THE WALL MATERIAL/ SYSTEM TO PROVIDE A WATERTIGHT ASSEMBLY.
- 8. PROVIDE MATERIALS WITHIN THE EXTERIOR WALL ASSEMBLY THAT ARE COMPLIANT WITH NFPA 285 (MORE THAN 40 FT ABOVE THE GRADE PLANE). PROVIDE FIRE RATED ASSEMBLIES THAT
- COMPLETE THE COMPARTMENTALIZED AREA FOR EACH FLOOR OF THE RESIDENTIAL BUILDING AT THE INTERSECTION OF THE FLOOR ASSEMBLY AND EXTERIOR WALL ASSEMBLY.
- RAILINGS WITH PERFORATED METAL PANELS AND / OR GLASS AS INDICATED ON THE DRAWINGS. RAILINGS SHALL BE TOP MOUNTED TO THE BALCONY DECK AND SHALL BE DELEGATED DESIGN TO MEET
- CODE REQUIREMENTS. 11. ALL UNIT BALCONY DOORS SHALL HAVE ADA THRESHOLDS.
- 12. ALL SOFFITS SHALL BE PRE-FINISHED METAL PANEL SYSTEMS OVER SUPPLEMENTAL FRAMING AND INSULATION
- AS REQUIRED / NOTED. 13. PROVIDE SUPPLEMENTAL STEEL FRAMING SUPPORTS (PTD) AT WINDOW WALL WIND
- SCREEN ON 15TH FLOOR. 14. EXPOSED CONCRETE COLUMNS AT GROUND LEVEL SHALL BE SMOOTH FORM AND PREPARED FOR PAINT FINISH. 15. EXTERIOR SIGNAGE SHALL BE A SEPARATE
- CONTRACT BY OWNER 16. PROVIDE THRU WALL FLASHINGS IN ALL MASONRY VENEER WALLS AT EACH FLOOR
- WITH WEEPS (TOP/ BOTTOM). 17. HOLLOW METAL DOOR FRAMES SHALL BE PAINTED - GLOSS FINISH.
- 18. PROVIDE PRE-FINISHED ARCHITECTURAL METAL LOUVERS AS INDICATED. INTEGRATE LOUVERS INTO THE WINDOW WALL SYSTEM AND PROVIDE SUPPLEMENTAL SUPPORTS AS REQUIRED. A. PROVIDE INSECT SCREENS ON LOUVERS
- TO ENCLOSED SPACES OR CONNECTED TO DUCTWORK. 19. PROVIDE CORRUGATED METAL WALL PANELS AT ROOF LEVEL FOR MECHANICAL SCREENING AND AT STAIR TO ROOF.

Overall North Elevation 1/16" = 1'-0" 1

TERMINATE WALL PANELS INTO ROOFING SYSTEM TO PROVIDE WATERTIGHT ASSEMBLY.





MADISON YARDS HILL FARMS

KTGY Project No: 20200326

Project Contact: Eric Lukacsik elukacsik@ktgy.com Email: Craig Pryde Principal: Project Designer: Demetrios

Developer



Stavrianos

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It is the client's responsibility prior to or during construction to notify the architect i writing of any perceived errors or omissions in the plans and specifications of which a contractor thoroughly knowledgeable with the building codes and methods of $\dot{}$ construction should reasonably be aware. Written instructions addressing such perceived errors or omissions shall be received from the architect prior to the client or client's subcontractors proceeding with the work. The client will be responsible for any

BUILDING B

OVERALL ELEVATIONS

INSULATED METAL PANEL. SEE DESIGN CONTRACTOR IS RESPONSIBLE FOR COLOR AS SELECTED BY THE ARCHITECT. R.3A (R.3) (R.4) TOP OF ROOF 2 157' - 4" TOP OF ROOF 1 152' - 4" THE DRAWINGS. RAILINGS SHALL BE TOP MOUNTED TO THE BALCONY DECK AND LEVEL 15 140' - 4" LEVEL 14 129' - 8" LEVEL 13 120' - 0" LEVEL 12 110' - 4" LEVEL 11 100' - 8" 91' - 0" LEVEL 9 81' - 4" 5TH FLOOR (PARKING) 46' - 8" 4TH FLOOR (PARKING) 35' - 0" 3RD FLOOR (PARKING) LEVEL 2 12' - 8" 2ND FLOOR (PARKING) 11' - 8" 1ST FLOOR (GROCER) 0' - 0" <u>LEVEL 1</u> -1' - 0" AVERAGE GRADE -7' - 6" LOWER LEVEL 1 -12' - 0" LOWER LEVEL RAMP -13' - 0" LOWER LEVEL (PARKING) -14' - 10" RECEIVING DOCK (GROCER) -15' - 4" LOADING DOCK -19' - 4" Overall South Elevation 1/16" = 1'-0" 1

ELEVATION NOTES

- 1. SEE CIVIL DRAWINGS FOR FINISH GRADES. 2. SEE MATERIAL NOTES FOR DESCRIPTION OF MATERIALS PROPOSED. SEE DESIGN
- NARRATIVE FOR ADDITIONAL INFORMATION. 3. BUILDING B: EXTERIOR WALL RATINGS/ PROTECTED OPENINGS:
- A. NORTH WALL = 0-HOUR/ UNLIMITED OPENINGS B. EAST WALL = 0-HOUR/ UNLIMITED
- OPENINGS
- C. SOUTH WALL = 0-HOUR/ UNLIMITED
- **OPENINGS** D. WEST WALL
- a. 1ST FLOOR SEE PLAN b. 2ND FLOOR – SEE PLAN
- c. 3^{RD} FLR 15^{TH} FLR 0-HOUR/ UNLIMITED OPENINGS (SECTION 705.8.6)
- 4. EXTERIOR WALL IS INTENDED TO BE A SINGLE SOURCE RESPONSIBILITY AND IS FURTHER DEFINED IN THE DESIGN NARRATIVE. A. WINDOW WALL SYSTEM - GLAZED WITH
 - TINTED INSULATED GLASS PANELS INCLUDING OPERABLE WINDOWS. SEE DESIGN NARRATIVE/ DRAWINGS FOR SPECIFICATION.
- B. PROVIDE TEMPERED GLAZING WHERE REQUIRED BY CODE. C. WINDOW WALL SYSTEM - GLAZED WITH
- NARRATIVE/ DRAWINGS FOR COLOR AND SPECIFICATION. D. IBC SECTION 1609.4.2 – SURFACE
- ROUGHNESS B. E. IBC SECTION 1609.4.3 – EXPOSURE CATEGORY C
- F. DELEGATED DESIGN FOR EXTERIOR WALL ASSEMBLY FOR WIND LOAD REQUIREMENTS/ AIR AND WATER CONTINUITY DESIGN.
- G. TYPICAL EXTERIOR WALL TO BE INDEPENDENTLY LABARATORY TESTED FOR AIR INFILTRATION PER ASTM E283, WATER INFILTRATION PER ASTM E331 AND AAMA 501.1 AT 12 LB/SF. H. INCLUDE THREE FIELD VERIFICATION
- TESTS PER AAMA 502. 5. A VAPOR RESISTANT AIR AND WATER BARRIER WILL BE REQUIRED BEHIND ALL "CLADDING" MATERIALS CONSTRUCTED OVER EXTERIOR SHEATHINGS, MASONRY OR CONCRETE. THE GENERAL
- COORDINATING AND SUBMITTING TO THE ARCHITECT, THE TRANSITIONS OF ALL AIR AND WATER BARRIER CONDITIONS. 6. PROVIDE SEALANTS AT ALL CHANGE OF MATERIALS ON THE EXTERIOR WALL IN
- PROVIDE COMPATABILTY TESTING WHERE 7. PROVIDE COPING/ FLASHINGS AT ALL TOP OF WALL AREAS THAT ARE FULLY INTEGRATED WITH THE WALL MATERIAL/ SYSTEM TO PROVIDE A WATERTIGHT
- ASSEMBLY. 8. PROVIDE MATERIALS WITHIN THE EXTERIOR WALL ASSEMBLY THAT ARE COMPLIANT WITH NFPA 285 (MORE THAN 40 FT ABOVE
- THE GRADE PLANE). 9. PROVIDE FIRE RATED ASSEMBLIES THAT COMPLETE THE COMPARTMENTALIZED AREA FOR EACH FLOOR OF THE
- RESIDENTIAL BUILDING AT THE INTERSECTION OF THE FLOOR ASSEMBLY AND EXTERIOR WALL ASSEMBLY. 10. PROVIDE PRE-FINISH METAL BALCONY RAILINGS WITH PERFORATED METAL PANELS AND / OR GLASS AS INDICATED ON
- SHALL BE DELEGATED DESIGN TO MEET CODE REQUIREMENTS. 11. ALL UNIT BALCONY DOORS SHALL HAVE
- ADA THRESHOLDS. 12. ALL SOFFITS SHALL BE PRE-FINISHED METAL PANEL SYSTEMS OVER SUPPLEMENTAL FRAMING AND INSULATION
- AS REQUIRED / NOTED. 13. PROVIDE SUPPLEMENTAL STEEL FRAMING SUPPORTS (PTD) AT WINDOW WALL WIND
- SCREEN ON 15[™] FLOOR. 14. EXPOSED CONCRETE COLUMNS AT GROUND LEVEL SHALL BE SMOOTH FORM AND PREPARED FOR PAINT FINISH. 15. EXTERIOR SIGNAGE SHALL BE A SEPARATE
- CONTRACT BY OWNER 16. PROVIDE THRU WALL FLASHINGS IN ALL MASONRY VENEER WALLS AT EACH FLOOR
- WITH WEEPS (TOP/ BOTTOM). 17. HOLLOW METAL DOOR FRAMES SHALL BE PAINTED – GLOSS FINISH. 18. PROVIDE PRE-FINISHED ARCHITECTURAL
- METAL LOUVERS AS INDICATED. INTEGRATE LOUVERS INTO THE WINDOW WALL SYSTEM AND PROVIDE SUPPLEMENTAL SUPPORTS AS REQUIRED. A. PROVIDE INSECT SCREENS ON LOUVERS
- TO ENCLOSED SPACES OR CONNECTED TO DUCTWORK. 19. PROVIDE CORRUGATED METAL WALL
- PANELS AT ROOF LEVEL FOR MECHANICAL SCREENING AND AT STAIR TO ROOF. TERMINATE WALL PANELS INTO ROOFING SYSTEM TO PROVIDE WATERTIGHT ASSEMBLY.





HILL FARMS KTGY Project No: 20200326

Project Contact: Eric Lukacsik elukacsik@ktgy.com Email: Principal: Craig Pryde Project Designer: Demetrios

Developer



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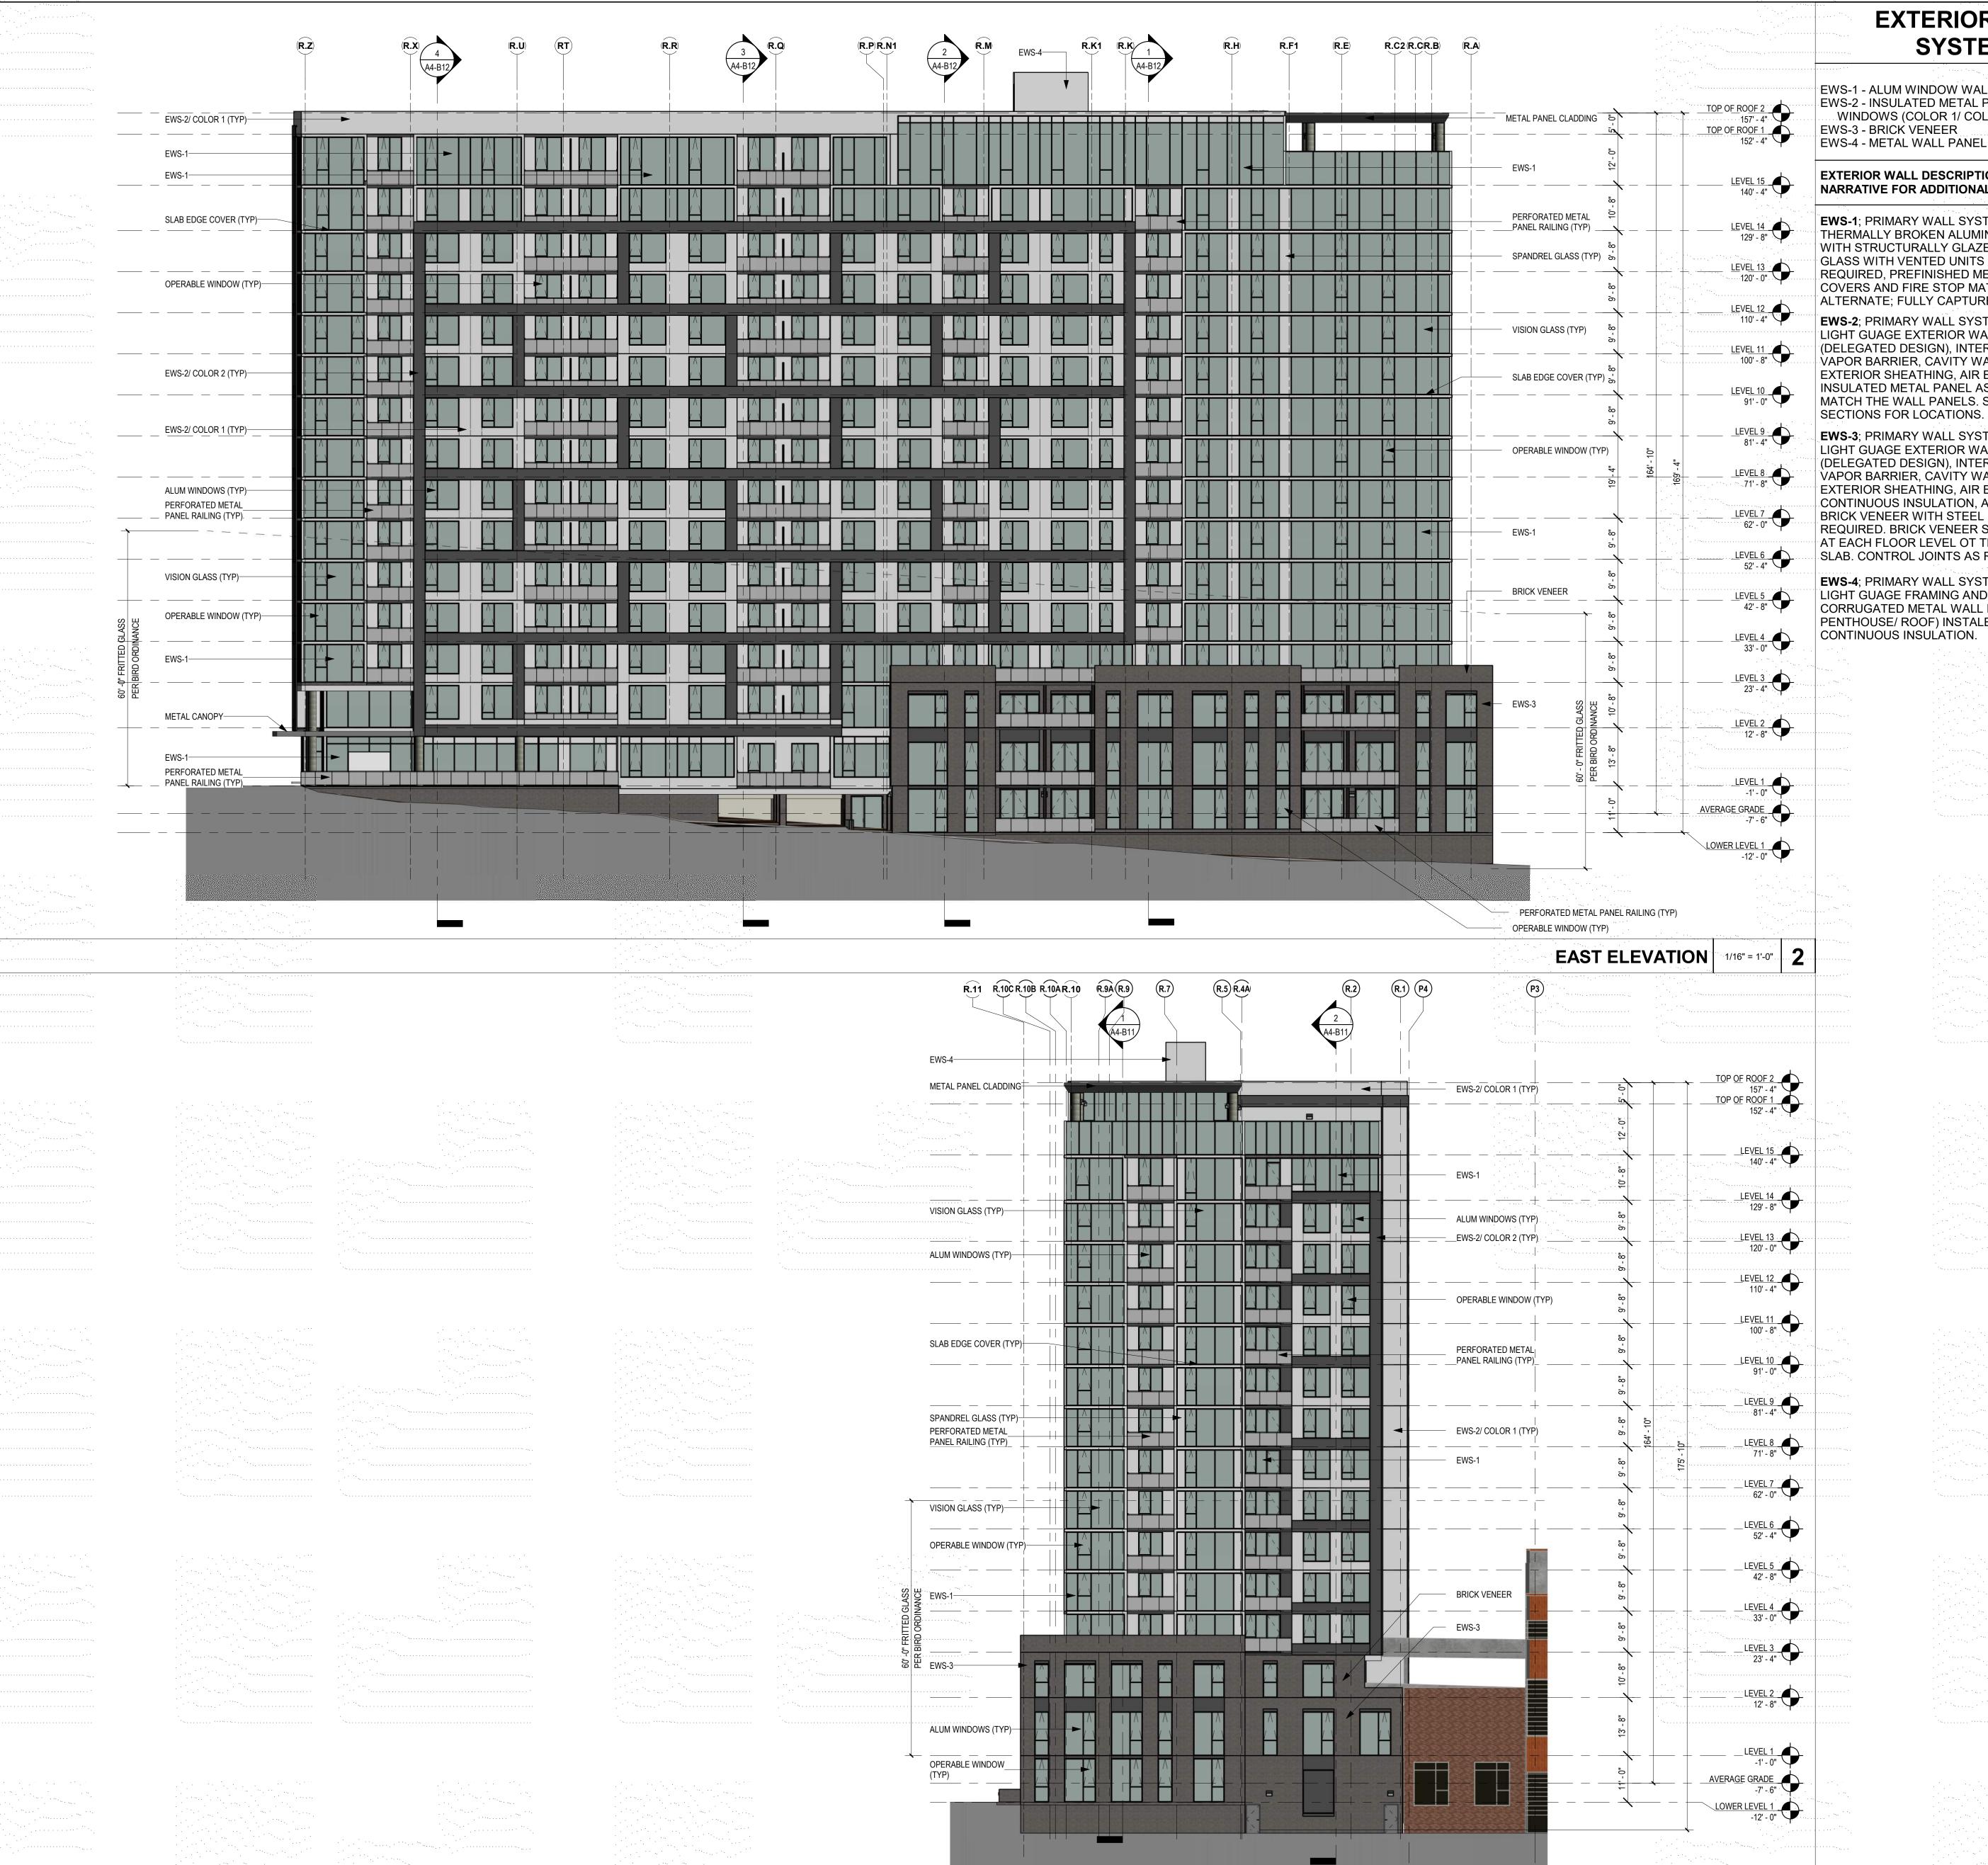
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BUILDING B

OVERALL ELEVATIONS



SYSTEMS

EWS-1 - ALUM WINDOW WALL/ SLAB EDGE COVER EWS-2 - INSULATED METAL PANEL/ ALUM WINDOWS (COLOR 1/ COLOR 2)

EXTERIOR WALL DESCRIPTIONS - SEE DESIGN NARRATIVE FOR ADDITIONAL INFORMATION

EWS-1; PRIMARY WALL SYSTEM CONSISTS OF THERMALLY BROKEN ALUMINUM WINDOW WALL WITH STRUCTURALLY GLAZED 1" INSULATED GLASS WITH VENTED UNITS AS INDICATED/ REQUIRED, PREFINISHED METAL SLAB EDGE **COVERS AND FIRE STOP MATERIAL AT FLOORS** ALTERNATE; FULLY CAPTURED GLAZING SYSTEM.

EWS-2; PRIMARY WALL SYSTEM CONSISTS OF LIGHT GUAGE EXTERIOR WALL FRAMING (DELEGATED DESIGN), INTERIOR DRYWALL VAPOR BARRIER, CAVITY WALL INSULATION EXTERIOR SHEATHING, AIR BARRIER AND INSULATED METAL PANEL AS INDICATED TO MATCH THE WALL PANELS. SEE ELEVATIONS/ SECTIONS FOR LOCATIONS.

EWS-3; PRIMARY WALL SYSTEM CONSISTS OF LIGHT GUAGE EXTERIOR WALL FRAMING (DELEGATED DESIGN), INTERIOR DRYWALL VAPOR BARRIER, CAVITY WALL INSULATION, EXTERIOR SHEATHING, AIR BARRIER, 2" CONTINUOUS INSULATION, AIR CAVITY AND 4" BRICK VENEER WITH STEEL LINTELS AS REQUIRED. BRICK VENEER SHALL BE SUPPORTED AT EACH FLOOR LEVEL OT THE STRUCTURAL SLAB. CONTROL JOINTS AS REQUIRED.

EWS-4; PRIMARY WALL SYSTEM CONSISTS OF LIGHT GUAGE FRAMING AND SHEATHING WITH CORRUGATED METAL WALL PANEL (MECHANICAL PENTHOUSE/ ROOF) INSTALED OVER 2" CONTINUOUS INSULATION.

EXTERIOR WALL

SEE CIVIL DRAWINGS FOR FINISH GRADES 2. SEE MATERIAL NOTES FOR DESCRIPTION OF MATERIALS PROPOSED. SEE DESIGN NARRATIVE FOR ADDITIONAL INFORMATION. 3. BUILDING B: EXTERIOR WALL RATINGS/

PROTECTED OPENINGS: A. NORTH WALL = 0-HOUR/ UNLIMITED **OPENINGS**

ELEVATION NOTES

B. EAST WALL = 0-HOUR/ UNLIMITED **OPENINGS** C. SOUTH WALL = 0-HOUR/ UNLIMITED

OPENINGS.

D. WEST WALL a. 1ST FLOOR – SEE PLAN

b. 2ND FLOOR – SEE PLAN

UNLIMITED OPENINGS (SECTION 705.8.6) 4. EXTERIOR WALL IS INTENDED TO BE A SINGLE SOURCE RESPONSIBILITY AND IS

c. 3^{RD} FLR – 15^{TH} FLR – 0-HOUR/

FURTHER DEFINED IN THE DESIGN NARRATIVE. A. WINDOW WALL SYSTEM - GLAZED WITH TINTED INSULATED GLASS PANELS

INCLUDING OPERABLE WINDOWS. SEE DESIGN NARRATIVE/ DRAWINGS FOR SPECIFICATION. B. PROVIDE TEMPERED GLAZING WHERE

REQUIRED BY CODE C. WINDOW WALL SYSTEM - GLAZED WITH INSULATED METAL PANEL. SEE DESIGN .NARRATIVE/ DRAWINGS FOR COLOR AND

SPECIFICATION. D. IBC SECTION 1609.4.2 – SURFACE ROUGHNESS B

E. IBC SECTION 1609.4.3 – EXPOSURE CATEGORY C F. DELEGATED DESIGN FOR EXTERIOR

WALL ASSEMBLY FOR WIND LOAD REQUIREMENTS/ AIR AND WATER CONTINUITY DESIGN.

G. TYPICAL EXTERIOR WALL TO BE INDEPENDENTLY LABARATORY TESTED FOR AIR INFILTRATION PER ASTM E283, WATER INFILTRATION PER ASTM E331 AND AAMA 501.1 AT 12 LB/SF.

H. INCLUDE THREE FIELD VERIFICATION TESTS PER AAMA 502. 5. A VAPOR RESISTANT AIR AND WATER BARRIER WILL BE REQUIRED BEHIND ALL "CLADDING" MATERIALS CONSTRUCTED

OVER EXTERIOR SHEATHINGS, MASONRY OR CONCRETE. THE GENERAL CONTRACTOR IS RESPONSIBLE FOR ARCHITECT, THE TRANSITIONS OF ALL AIR AND WATER BARRIER CONDITIONS. 6. PROVIDE SEALANTS AT ALL CHANGE OF

COLOR AS SELECTED BY THE ARCHITECT. PROVIDE COMPATABILTY TESTING WHERE REQUIRED. 7. PROVIDE COPING/ FLASHINGS AT ALL TOP OF WALL AREAS THAT ARE FULLY

MATERIALS ON THE EXTERIOR WALL IN

INTEGRATED WITH THE WALL MATERIAL/ SYSTEM TO PROVIDE A WATERTIGHT ASSEMBLY. 8. PROVIDE MATERIALS WITHIN THE EXTERIOR

WALL ASSEMBLY THAT ARE COMPLIANT WITH NFPA 285 (MORE THAN 40 FT ABOVE THE GRADE PLANE). 9. PROVIDE FIRE RATED ASSEMBLIES THAT COMPLETE THE COMPARTMENTALIZED

AREA FOR EACH FLOOR OF THE RESIDENTIAL BUILDING AT THE INTERSECTION OF THE FLOOR ASSEMBLY AND EXTERIOR WALL ASSEMBLY. 10. PROVIDE PRE-FINISH METAL BALCONY

RAILINGS WITH PERFORATED METAL PANELS AND / OR GLASS AS INDICATED ON THE DRAWINGS. RAILINGS SHALL BE TOP MOUNTED TO THE BALCONY DECK AND SHALL BE DELEGATED DESIGN TO MEET CODE REQUIREMENTS.

11. ALL UNIT BALCONY DOORS SHALL HAVE ADA THRESHOLDS.

12. ALL SOFFITS SHALL BE PRE-FINISHED METAL PANEL SYSTEMS OVER SUPPLEMENTAL FRAMING AND INSULATION

AS REQUIRED / NOTED. 13. PROVIDE SUPPLEMENTAL STEEL FRAMING SUPPORTS (PTD) AT WINDOW WALL WIND

SCREEN ON 15TH FLOOR. 14. EXPOSED CONCRETE COLUMNS AT GROUND LEVEL SHALL BE SMOOTH FORM AND PREPARED FOR PAINT FINISH. 15. EXTERIOR SIGNAGE SHALL BE A SEPARATE

CONTRACT BY OWNER 16. PROVIDE THRU WALL FLASHINGS IN ALL MASONRY VENEER WALLS AT EACH FLOOR WITH WEEPS (TOP/ BOTTOM).

17. HOLLOW METAL DOOR FRAMES SHALL BE PAINTED – GLOSS FINISH. 18. PROVIDE PRE-FINISHED ARCHITECTURAL METAL LOUVERS AS INDICATED. INTEGRATE LOUVERS INTO THE WINDOW WALL SYSTEM

AND PROVIDE SUPPLEMENTAL SUPPORTS

AS REQUIRED. A. PROVIDE INSECT SCREENS ON LOUVERS TO ENCLOSED SPACES OR CONNECTED

TO DUCTWORK. 19. PROVIDE CORRUGATED METAL WALL PANELS AT ROOF LEVEL FOR MECHANICAL SCREENING AND AT STAIR TO ROOF. TERMINATE WALL PANELS INTO ROOFING SYSTEM TO PROVIDE WATERTIGHT ASSEMBLY.

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	PRE-FINISHED METAL PANEL	
	ALUMINUM WINDOW WALL	





HILL FARMS

KTGY Project No: 20200326

Project Contact: Eric Lukacsik elukacsik@ktgy.com Email: Craig Pryde Principal: Project Designer: Demetrios Stavrianos

Developer



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BUILDING B

EXTERIOR BUILDING ELEVATOINS



EXTERIOR WALL SYSTEMS

EWS-1 - ALUM WINDOW WALL/ SLAB EDGE COVER EWS-2 - INSULATED METAL PANEL/ ALUM ... WINDOWS (COLOR 1/ COLOR 2).

EXTERIOR WALL DESCRIPTIONS - SEE DESIGN

EWS-1; PRIMARY WALL SYSTEM CONSISTS OF THERMALLY BROKEN ALUMINUM WINDOW WALL WITH STRUCTURALLY GLAZED 1" INSULATED GLASS WITH VENTED UNITS AS INDICATED/ REQUIRED, PREFINISHED METAL SLAB EDGE COVERS AND FIRE STOP MATERIAL AT FLOORS. ALTERNATE: FULLY CAPTURED GLAZING SYSTEM.

EWS-2; PRIMARY WALL SYSTEM CONSISTS OF LIGHT GUAGE EXTERIOR WALL FRAMING (DELEGATED DESIGN), INTERIOR DRYWALL VAPOR BARRIER, CAVITY WALL INSULATION, EXTERIOR SHEATHING, AIR BARRIER AND INSULATED METAL PANEL AS INDICATED TO MATCH THE WALL PANELS. SEE ELEVATIONS/

EWS-3; PRIMARY WALL SYSTEM CONSISTS OF LIGHT GUAGE EXTERIOR WALL FRAMING (DELEGATED DESIGN), INTERIOR DRYWALL VAPOR BARRIER, CAVITY WALL INSULATION, EXTERIOR SHEATHING, AIR BARRIER, 2" CONTINUOUS INSULATION, AIR CAVITY AND 4" BRICK VENEER WITH STEEL LINTELS AS REQUIRED. BRICK VENEER SHALL BE SUPPORTED AT EACH FLOOR LEVEL OT THE STRUCTURAL SLAB. CONTROL JOINTS AS REQUIRED.

EWS-4; PRIMARY WALL SYSTEM CONSISTS OF LIGHT GUAGE FRAMING AND SHEATHING WITH CORRUGATED METAL WALL PANEL (MECHANICAL PENTHOUSE/ ROOF) INSTALED OVER 2"

SOUTH ELEVATION 1/16" = 1'-0" 1

ELEVATION NOTES

- . SEE CIVIL DRAWINGS FOR FINISH GRADES. 2. SEE MATERIAL NOTES FOR DESCRIPTION OF MATERIALS PROPOSED. SEE DESIGN NARRATIVE FOR ADDITIONAL INFORMATION. 3. BUILDING B: EXTERIOR WALL RATINGS/
 - PROTECTED OPENINGS: A. NORTH WALL = 0-HOUR/ UNLIMITED
 - **OPENINGS** B. EAST WALL = 0-HOUR/ UNLIMITED **OPENINGS**
 - C. SOUTH WALL = 0-HOUR/ UNLIMITED OPENINGS. D. WEST WALL
 - a. 1ST FLOOR SEE PLAN b. 2ND FLOOR – SEE PLAN c. 3^{RD} FLR – 15^{TH} FLR – 0-HOUR/ **UNLIMITED OPENINGS (SECTION**
 - 705.8.6) 4. EXTERIOR WALL IS INTENDED TO BE A SINGLE SOURCE RESPONSIBILITY AND IS FURTHER DEFINED IN THE DESIGN NARRATIVE.
 - A. WINDOW WALL SYSTEM GLAZED WITH TINTED INSULATED GLASS PANELS INCLUDING OPERABLE WINDOWS. SEE DESIGN NARRATIVE/ DRAWINGS FOR
 - SPECIFICATION. B. PROVIDE TEMPERED GLAZING WHERE REQUIRED BY CODE
 - C. WINDOW WALL SYSTEM GLAZED WITH INSULATED METAL PANEL. SEE DESIGN .NARRATIVE/ DRAWINGS FOR COLOR AND SPECIFICATION.
 - D. IBC SECTION 1609.4.2 SURFACE .. ROUGHNESS B. E. IBC SECTION 1609.4.3 – EXPOSURE
 - CATEGORY C F. DELEGATED DESIGN FOR EXTERIOR
 - WALL ASSEMBLY FOR WIND LOAD REQUIREMENTS/ AIR AND WATER CONTINUITY DESIGN.
 - G. TYPICAL EXTERIOR WALL TO BE INDEPENDENTLY LABARATORY TESTED FOR AIR INFILTRATION PER ASTM E283, WATER INFILTRATION PER ASTM E331
 - AND AAMA 501.1 AT 12 LB/SF. H. INCLUDE THREE FIELD VERIFICATION TESTS PER AAMA 502. 5. A VAPOR RESISTANT AIR AND WATER
 - BARRIER WILL BE REQUIRED BEHIND ALL "CLADDING" MATERIALS CONSTRUCTED OVER EXTERIOR SHEATHINGS, MASONRY OR CONCRETE. THE GENERAL CONTRACTOR IS RESPONSIBLE FOR COORDINATING AND SUBMITTING TO THE ARCHITECT, THE TRANSITIONS OF ALL AIR
 - PROVIDE SEALANTS AT ALL CHANGE OF MATERIALS ON THE EXTERIOR WALL IN COLOR AS SELECTED BY THE ARCHITECT. PROVIDE COMPATABILTY TESTING WHERE

AND WATER BARRIER CONDITIONS.

- '. PROVIDE COPING/ FLASHINGS AT ALL TOP OF WALL AREAS THAT ARE FULLY INTEGRATED WITH THE WALL MATERIAL/ SYSTEM TO PROVIDE A WATERTIGHT ASSEMBLY.
- 8. PROVIDE MATERIALS WITHIN THE EXTERIOR WALL ASSEMBLY THAT ARE COMPLIANT WITH NFPA 285 (MORE THAN 40 FT ABOVE THE GRADE PLANE).
- 9. PROVIDE FIRE RATED ASSEMBLIES THAT COMPLETE THE COMPARTMENTALIZED AREA FOR EACH FLOOR OF THE RESIDENTIAL BUILDING AT THE INTERSECTION OF THE FLOOR ASSEMBLY
- 10. PROVIDE PRE-FINISH METAL BALCONY RAILINGS WITH PERFORATED METAL PANELS AND / OR GLASS AS INDICATED ON THE DRAWINGS. RAILINGS SHALL BE TOP MOUNTED TO THE BALCONY DECK AND SHALL BE DELEGATED DESIGN TO MEET

AND EXTERIOR WALL ASSEMBLY.

CODE REQUIREMENTS.

- 11. ALL UNIT BALCONY DOORS SHALL HAVE
- ADA THRESHOLDS. 12. ALL SOFFITS SHALL BE PRE-FINISHED
- METAL PANEL SYSTEMS OVER SUPPLEMENTAL FRAMING AND INSULATION AS REQUIRED / NOTED. 13. PROVIDE SUPPLEMENTAL STEEL FRAMING
- SUPPORTS (PTD) AT WINDOW WALL WIND SCREEN ON 15[™] FLOOR. 14. EXPOSED CONCRETE COLUMNS AT GROUND LEVEL SHALL BE SMOOTH FORM
- AND PREPARED FOR PAINT FINISH. 15. EXTERIOR SIGNAGE SHALL BE A SEPARATE CONTRACT BY OWNER
- 16. PROVIDE THRU WALL FLASHINGS IN ALL MASONRY VENEER WALLS AT EACH FLOOR WITH WEEPS (TOP/ BOTTOM). 17. HOLLOW METAL DOOR FRAMES SHALL BE
- PAINTED GLOSS FINISH. 18. PROVIDE PRE-FINISHED ARCHITECTURAL METAL LOUVERS AS INDICATED. INTEGRAT LOUVERS INTO THE WINDOW WALL SYSTEM AND PROVIDE SUPPLEMENTAL SUPPORTS AS REQUIRED.
- A. PROVIDE INSECT SCREENS ON LOUVERS TO ENCLOSED SPACES OR CONNECTED TO DUCTWORK.
- 19. PROVIDE CORRUGATED METAL WALL PANELS AT ROOF LEVEL FOR MECHANICAL SCREENING AND AT STAIR TO ROOF TERMINATE WALL PANELS INTO ROOFING SYSTEM TO PROVIDE WATERTIGHT ASSEMBLY.





HILL FARMS

KTGY Project No: 20200326

Project Contact: Eric Lukacsik elukacsik@ktgy.com Email: Craig Pryde Principal: Project Designer: Demetrios

Developer



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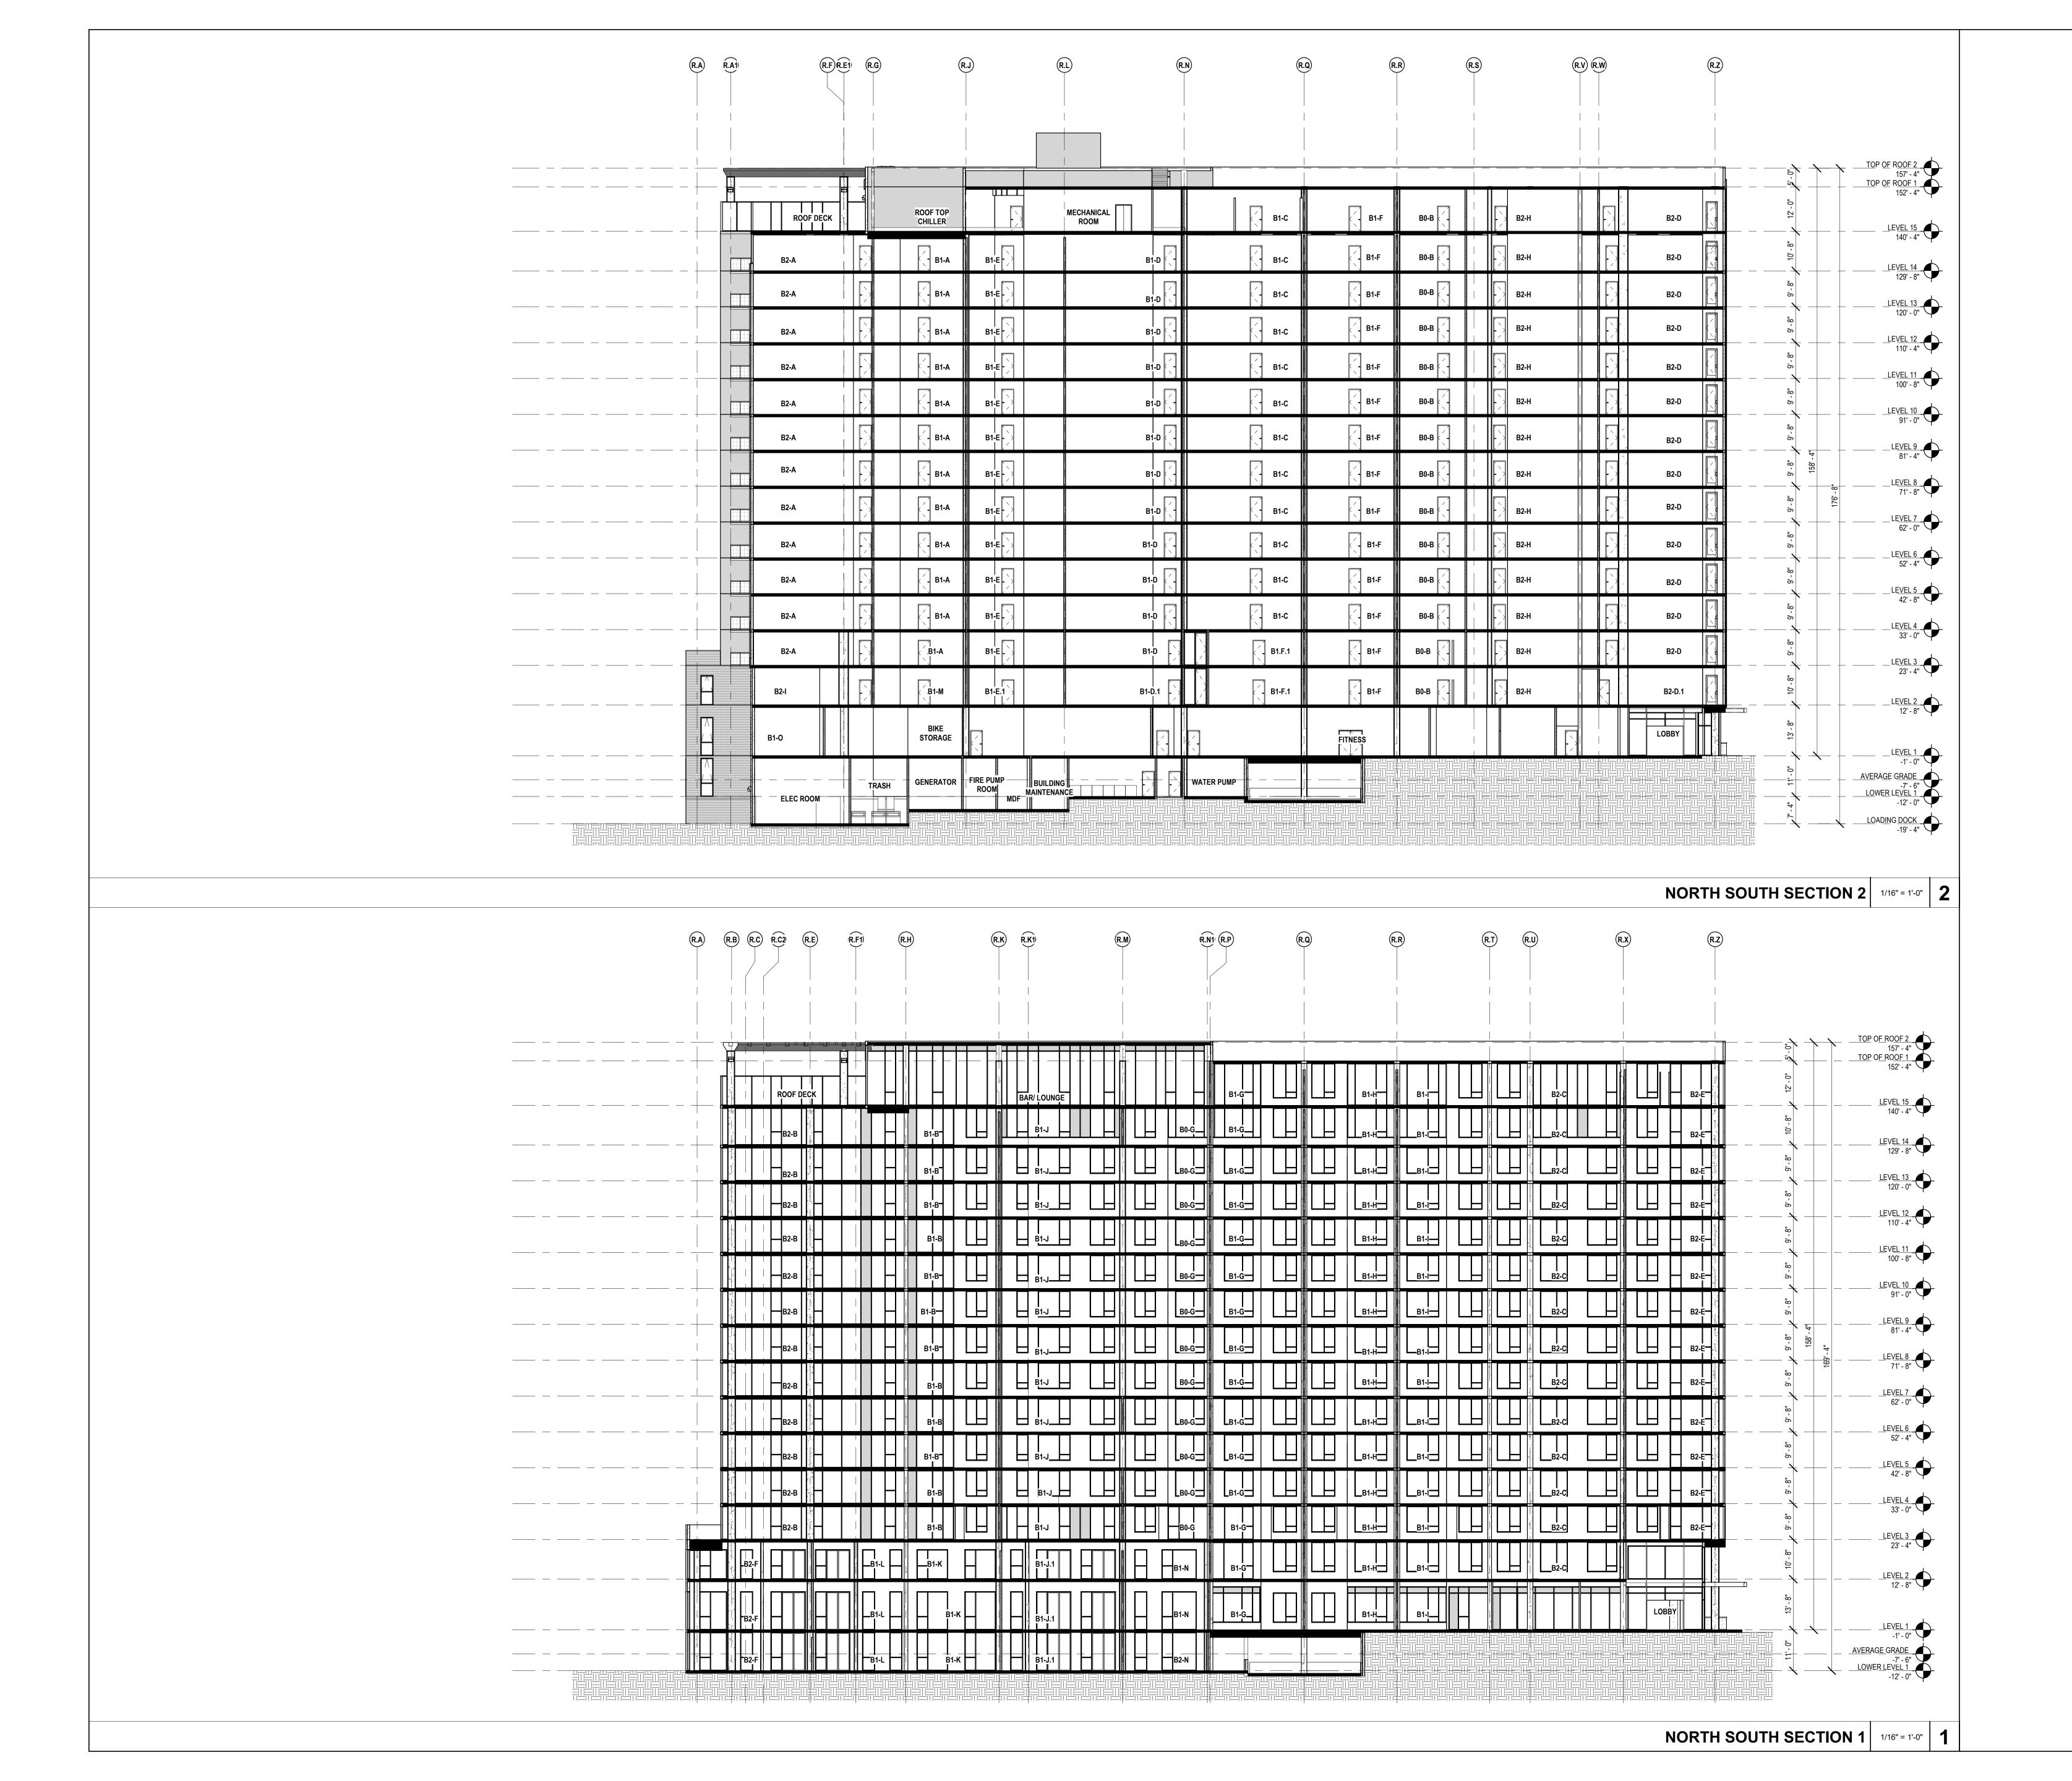
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BUILDING B

EXTERIOR BUILDING ELEVATIONS







Project Contact: Eric Lukacsik
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Principal: Craig Pryde
Project Designer: Demetrios
Stavrianos

Developer



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MADISON YARDS BLOCK 2 BUILDING B


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client's subcontractors proceeding with the work. The client will be responsible for any defects in construction if these procedures are not followed.

BUILDING B

BUILDING SECTIONS

A4-B11



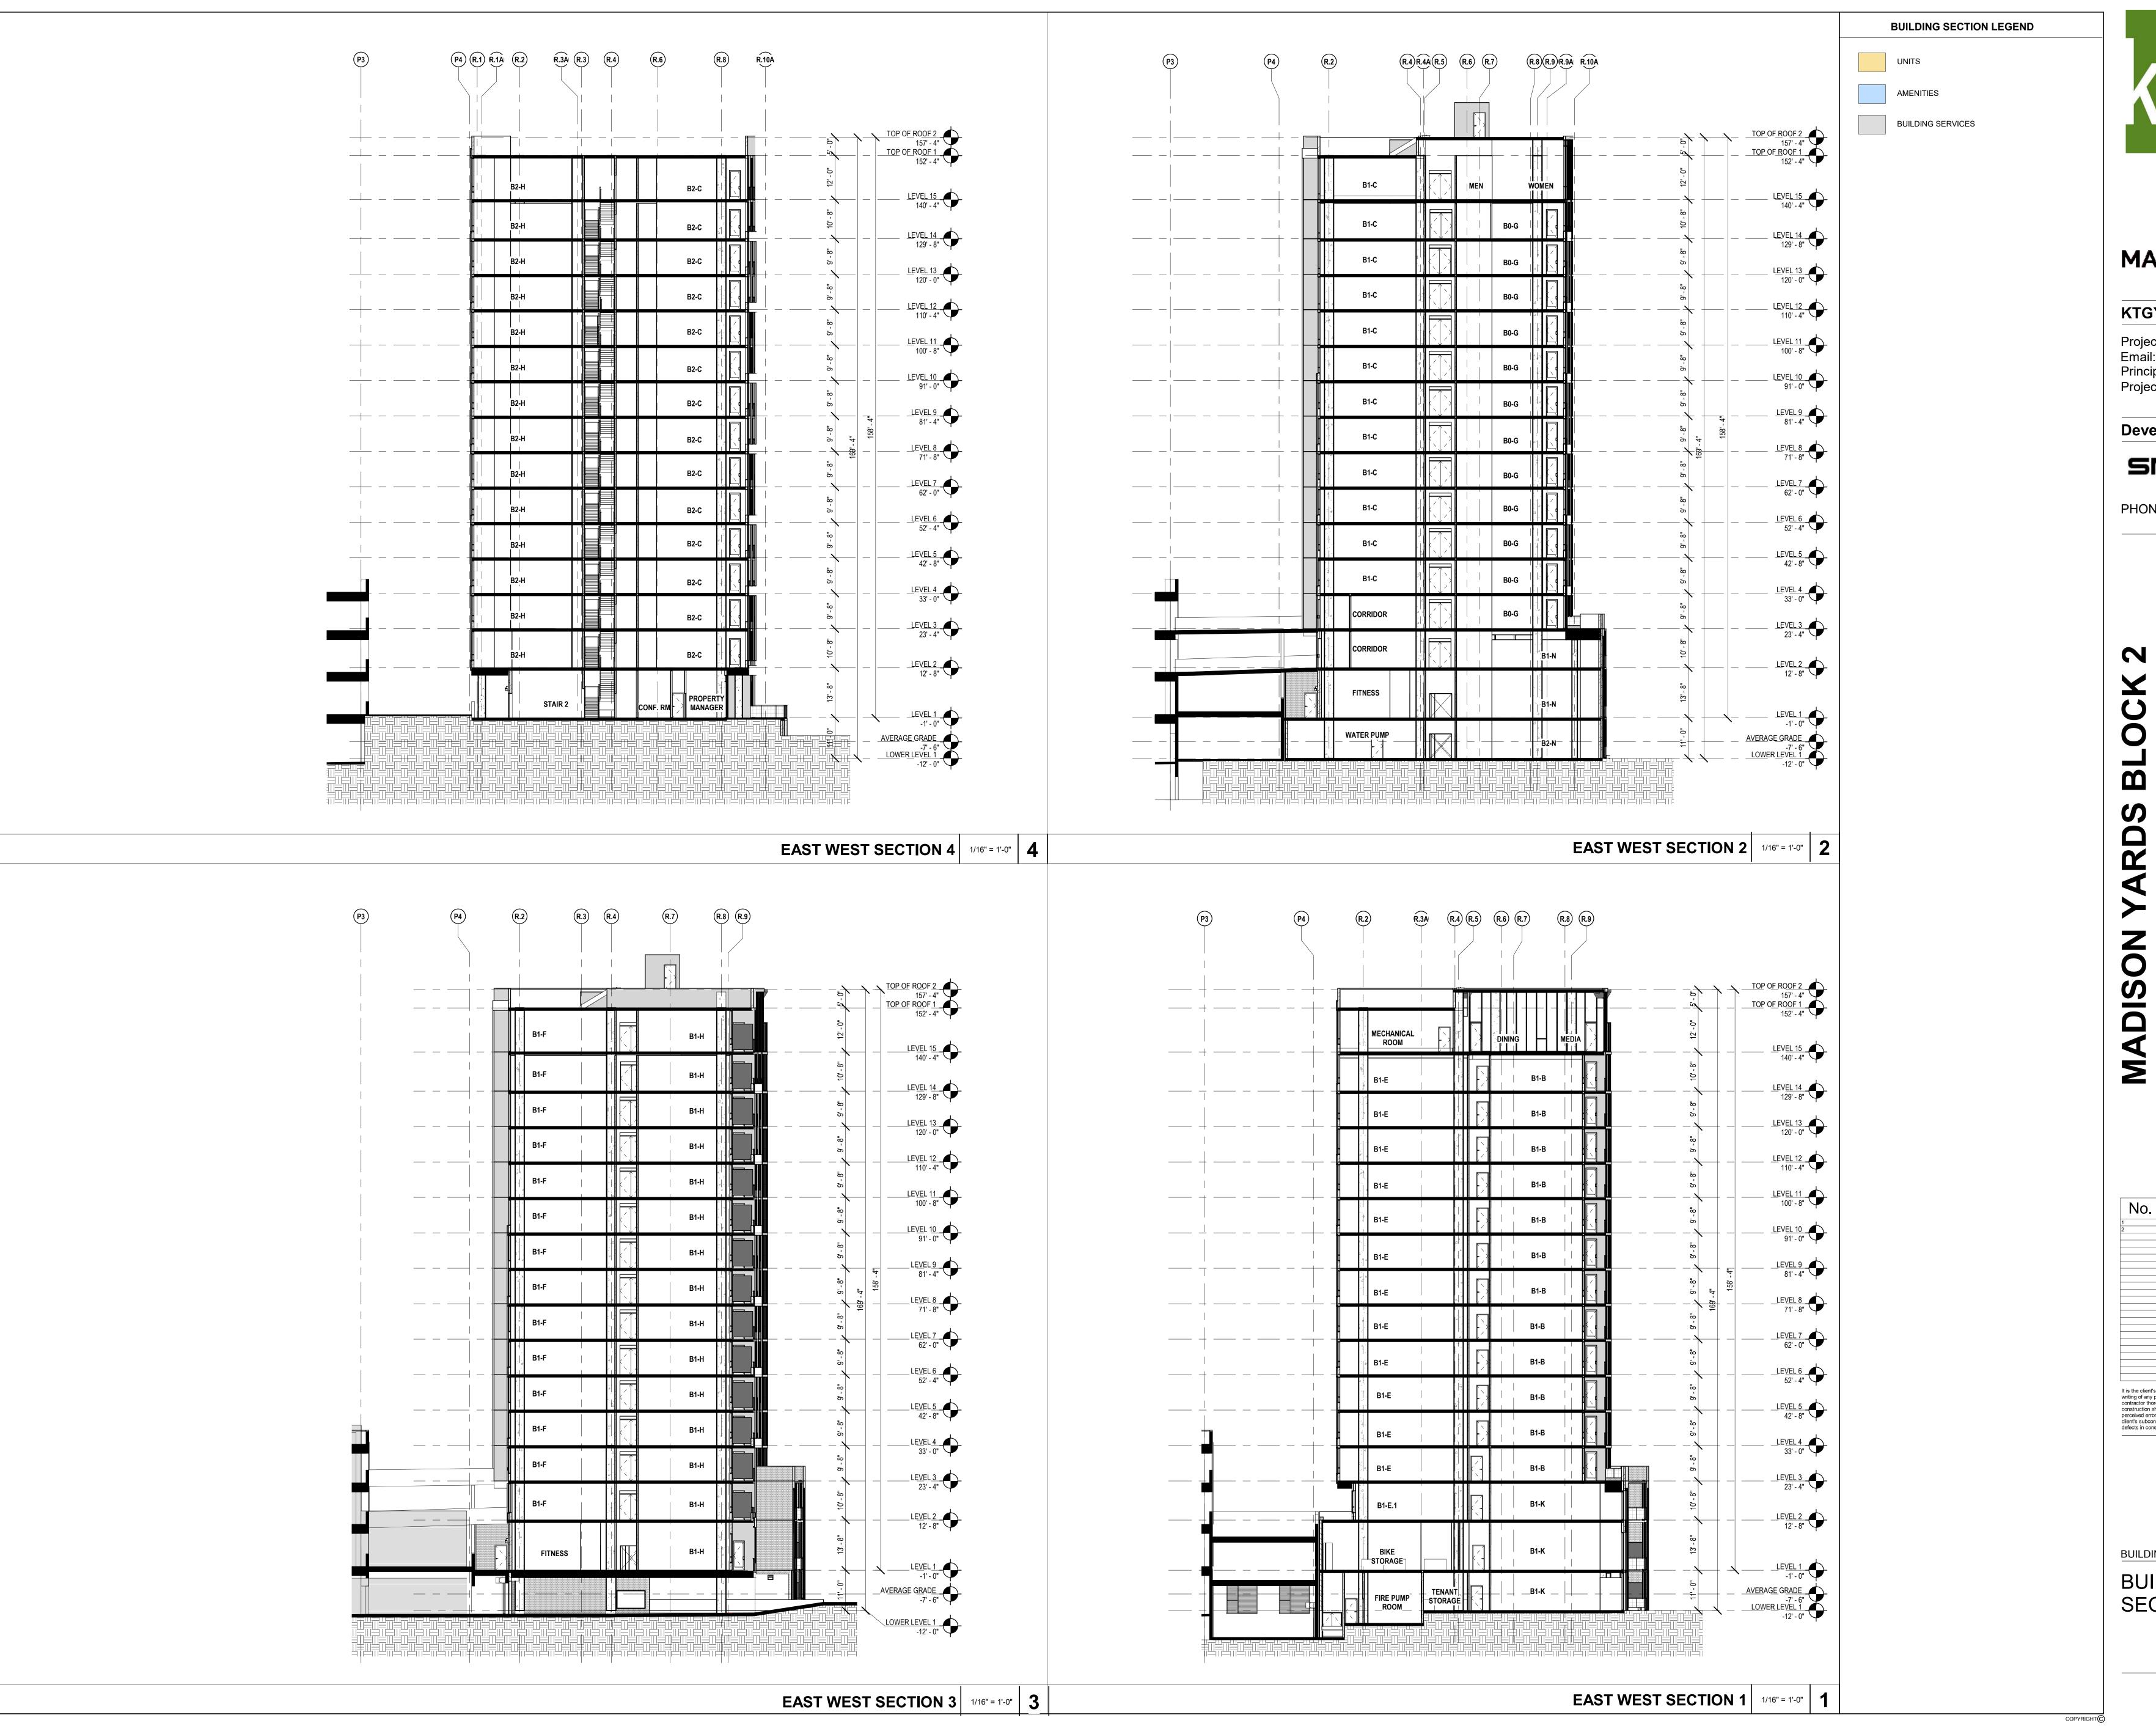



Eric Lukacsik Project Contact: elukacsik@ktgy.com Principal: Craig Pryde Project Designer: Demetrios Stavrianos

HILL FARMS

Developer

SMITH Gilbane


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BUILDING B

BUILDING SECTIONS

A4-B12





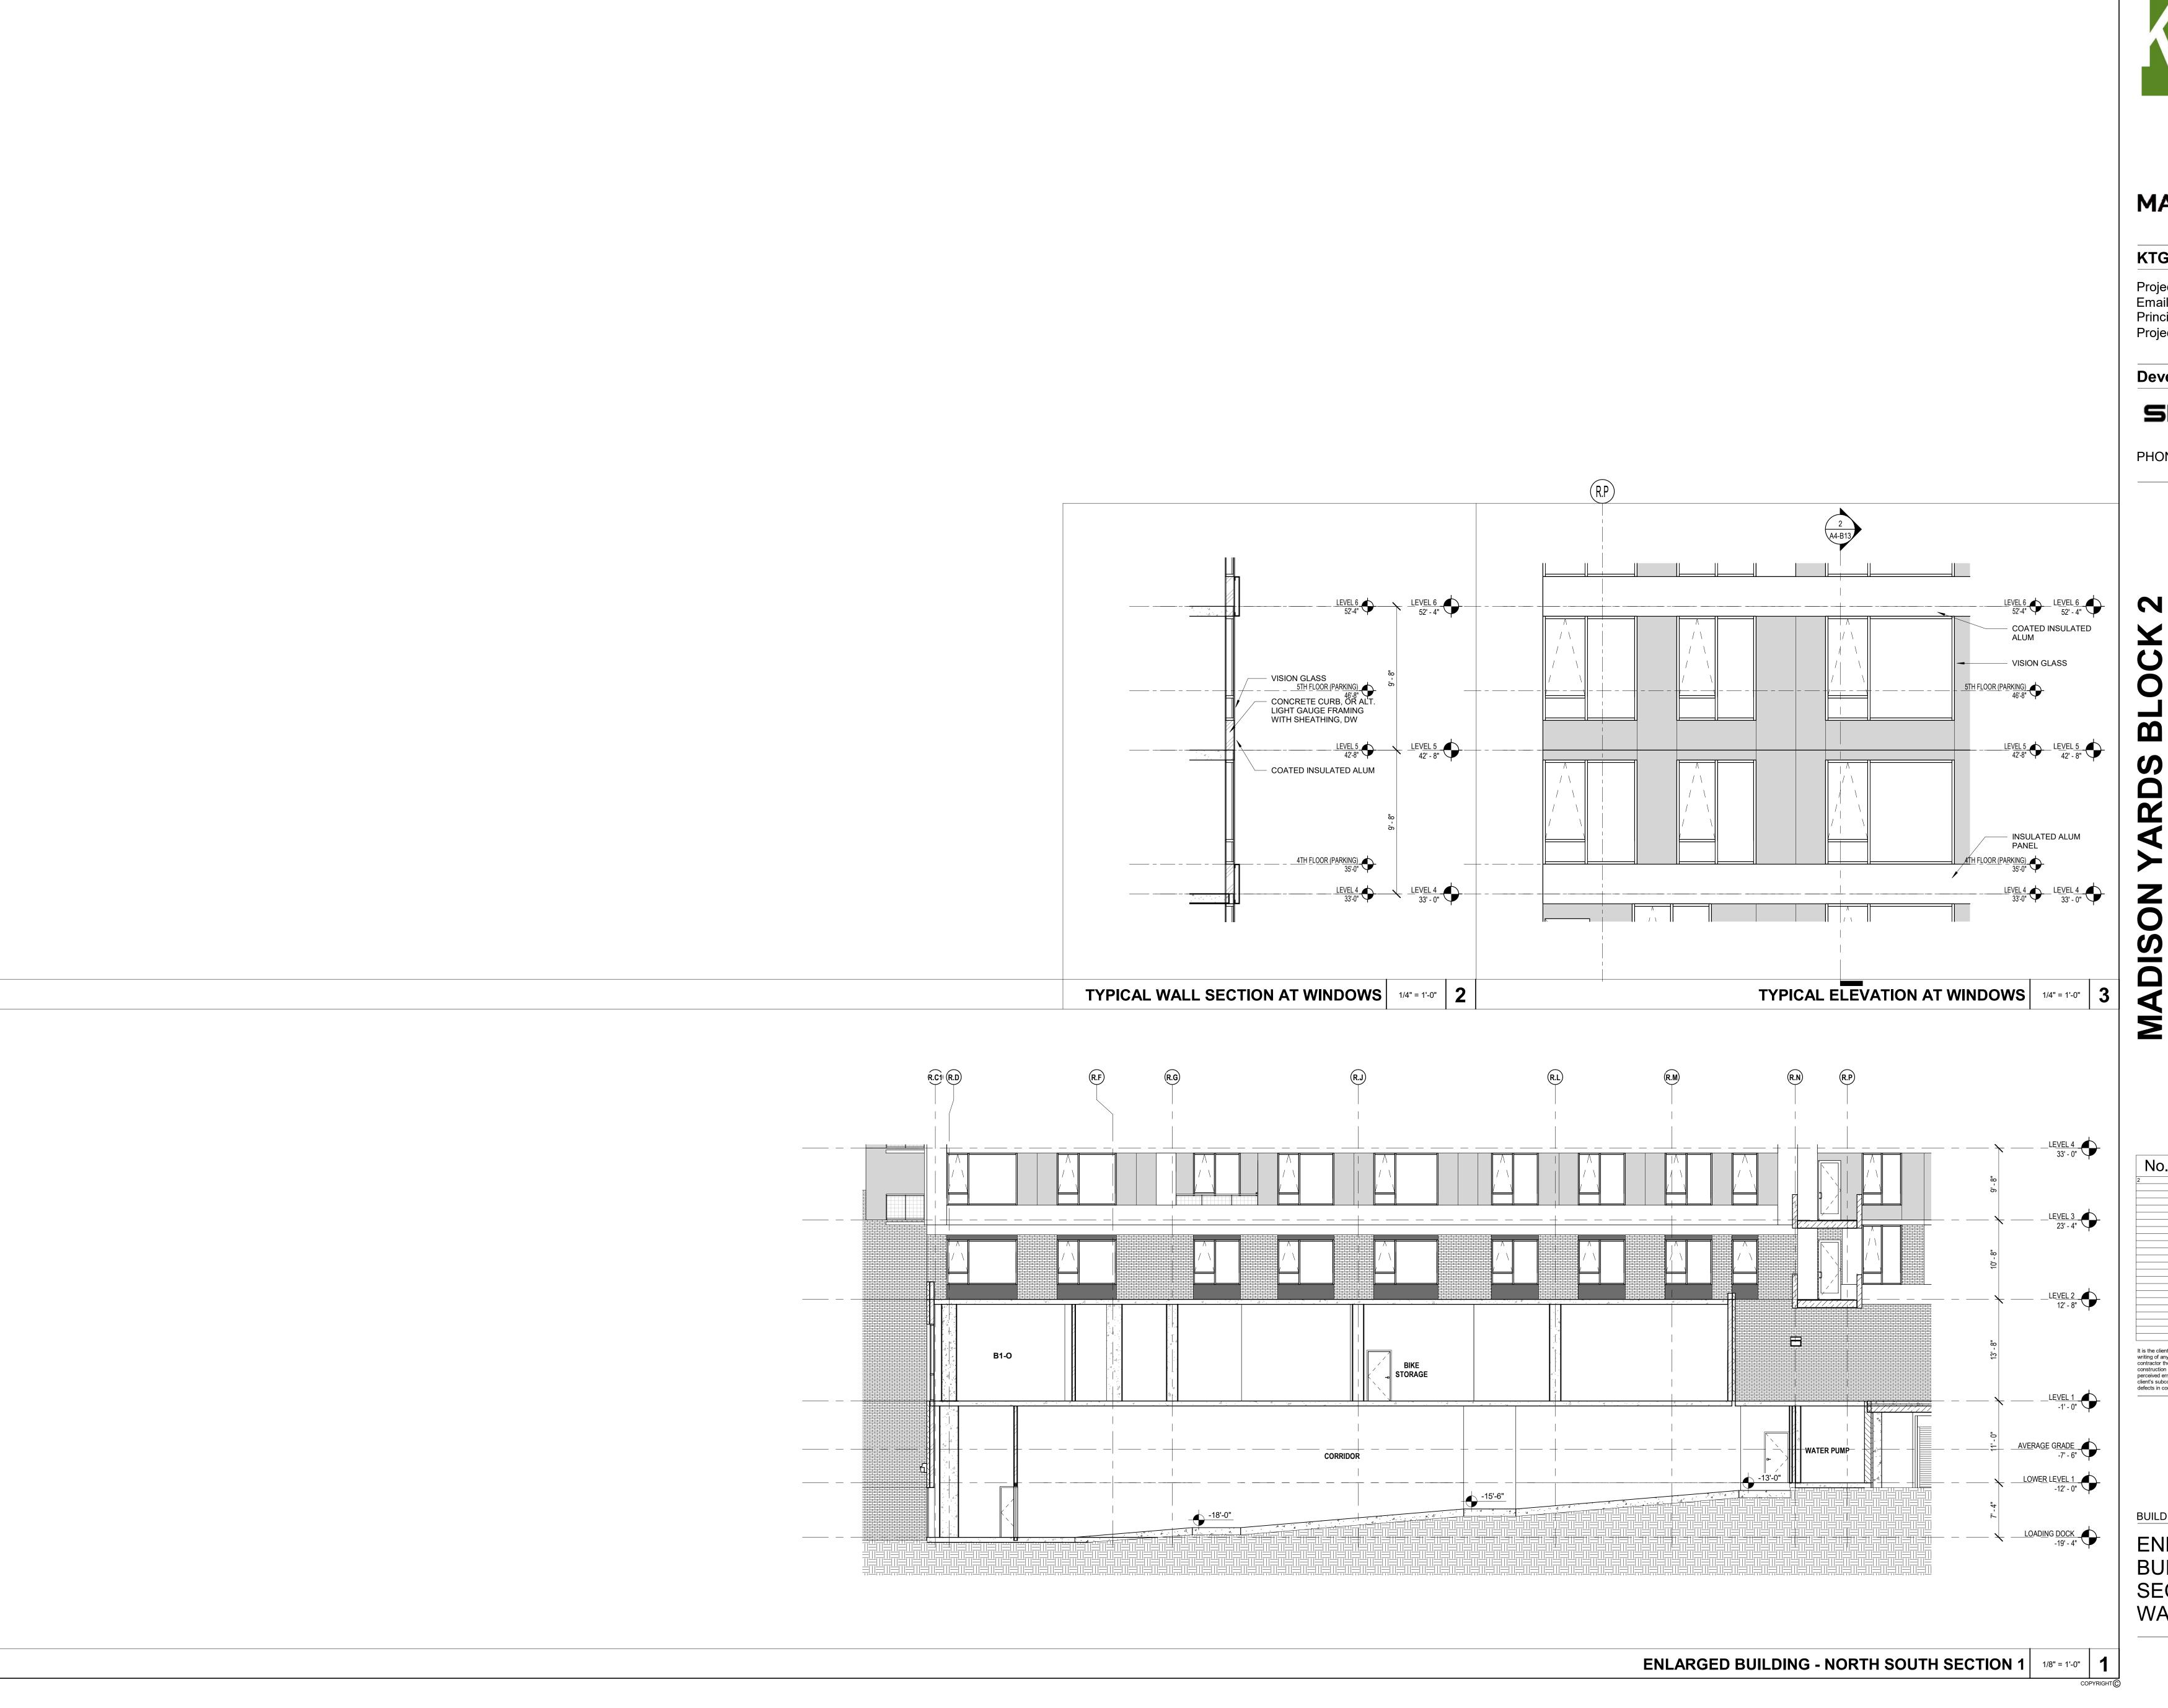

KTGY Project No: 20200326 Project Contact:

ct: Eric Lukacsik elukacsik@ktgy.com Craig Pryde Principal: Project Designer: Demetrios Stavrianos

Developer

SMITH Gilbane

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BUILDING B

ENLARGED BUILDING SECTIONS & TYP WALL SECTIONS

A4-B13



MADISON YARDS
HILL FARMS

KTGY Project No: 20200326

Project Contact: Eric Lukacsik
Email: elukacsik@ktgy.com
Principal: Craig Pryde
Project Designer: Demetrios
Stavrianos

Developer



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BUILDING B



MADISON YARDS HILL FARMS

ect: Eric Lukacsik elukacsik@ktgy.com Craig Pryde ner: Demetrios Stavrianos Project Contact: Email: eluk Principal: Project Designer:

Developer



PHONE NO.



2 MADIS

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Project Contact: Eric Lukacsik
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Principal: Craig Pryde
Project Designer: Demetrios
Stavrianos

Developer

SMITH Gilbane

PHONE NO.

DISON YARDS BLOCK 2
BUILDING B

No. Date Description

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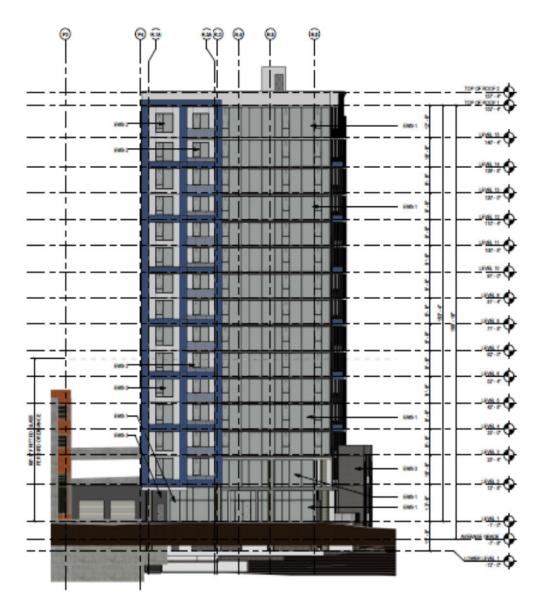
ISON YARDS BLOCK 2
BUILDING B


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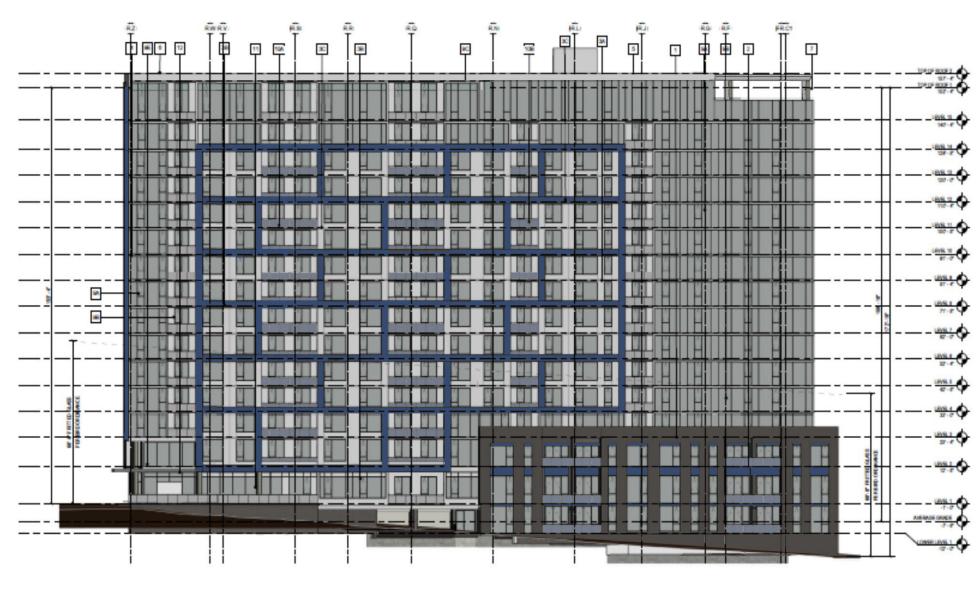
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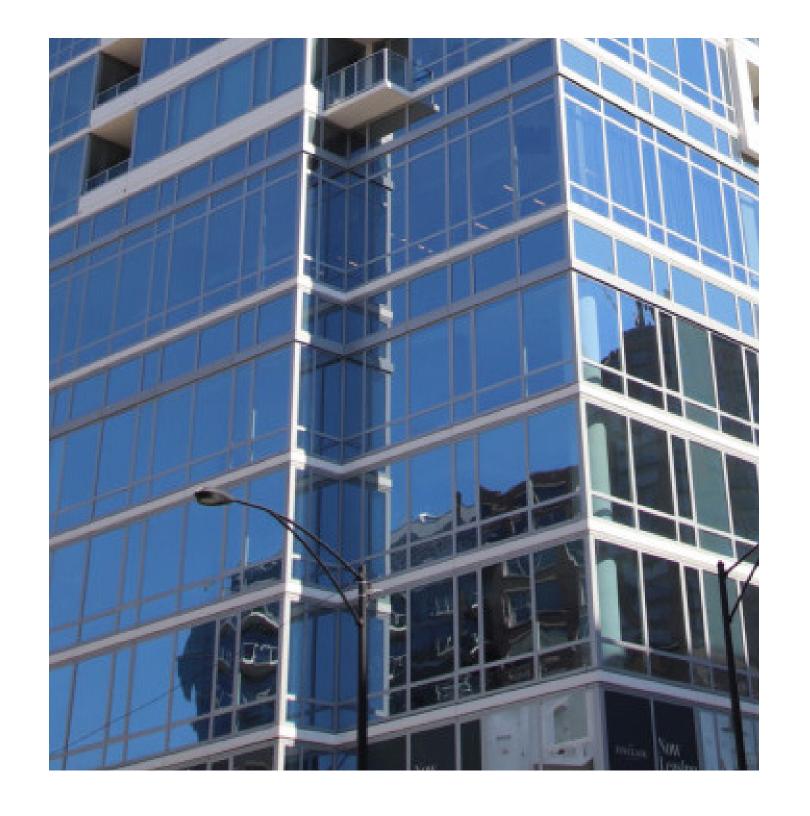



SOUTH ELEVATION


WEST ELEVATION

NORTH ELEVATION

EAST ELEVATION

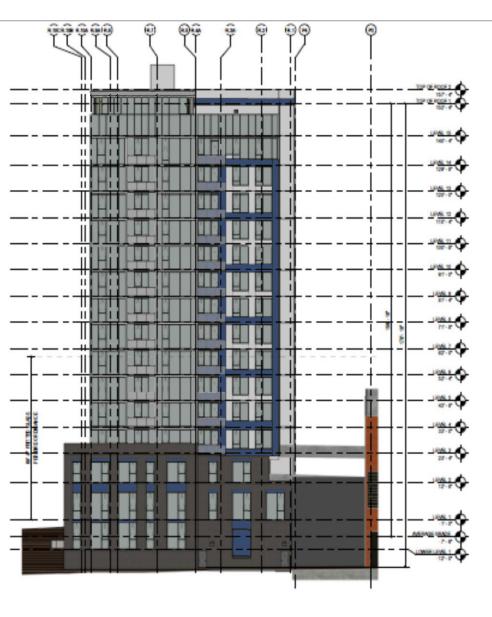

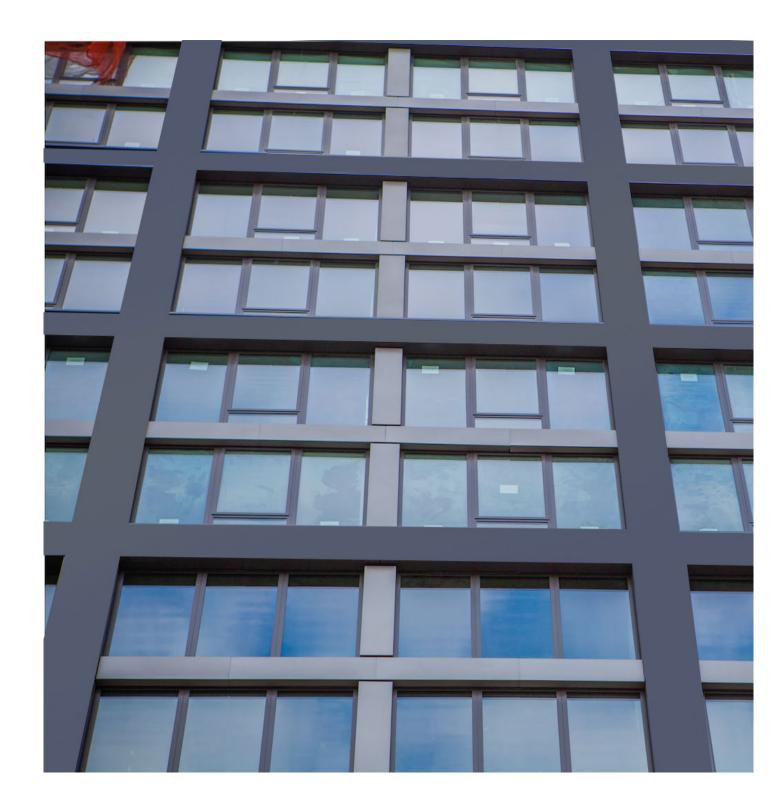

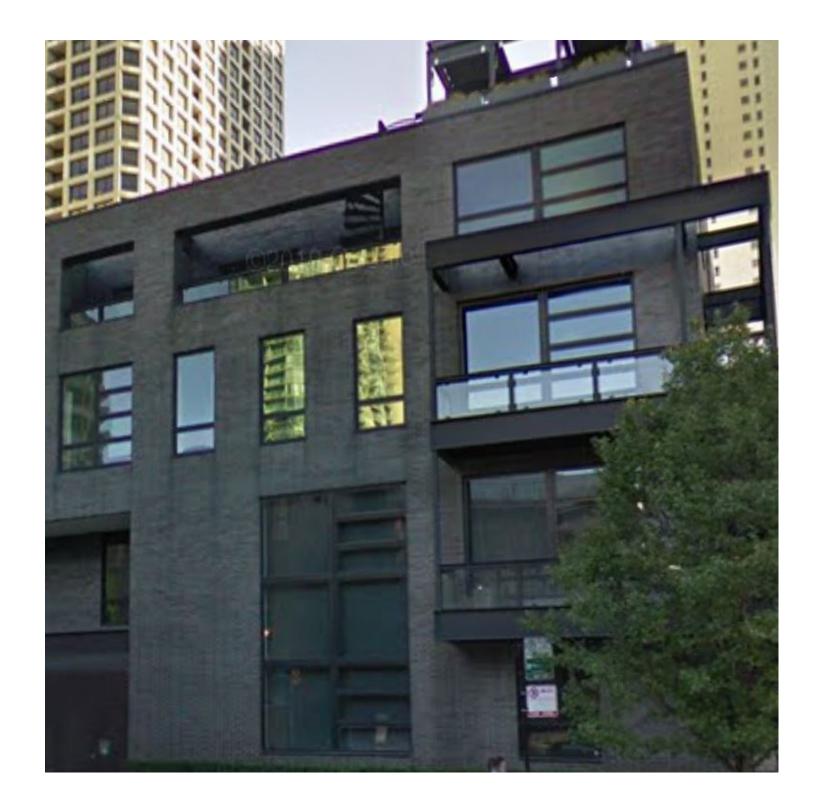



EWS-1 ALUMINUM AND GLASS WINDOW WALL/SLAB EDGE COVER SYSTEM (SIM)

EWS-2 INSULATED METAL PANEL/ALUMINUM WINDOWS (SIM)

EWS-3 BRICK VENEER BASE DETAIL (SIM)

EWS-4 METAL WALL PANEL (SIM)




DECORATIVE LIGHT FIXTURE

AT RESIDENTIAL BALCONY








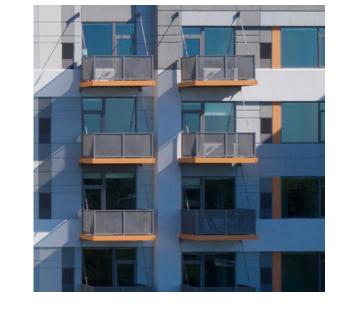



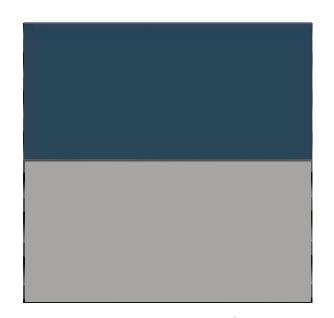

GUARDIAN SunGuard - AG 43 GUARDIAN SunGuard - AG 50

ALUMINUM STOREFRONT AT RETAIL BASE

PREFINISHED PERFORATED METAL PANEL RAILING SYSTEM - DARK GRAY

MODULAR BRICK - GRAY BLEND

METAL WALL PANEL - REGAL BLUE METAL WALL PANEL - CHROME. GRAY





