URBAN DESIGN COMMISSION APPLICATION

UDC

City of Madison Planning Division Madison Municipal Building, Suite 017 215 Martin Luther King, Jr. Blvd. P.O. Box 2985 Madison, WI 53701-2985 (608) 266-4635



Complete all sections of this application, including the desired meeting date and the action requested.

If you need an interpreter, translator, materials in alternate formats or other accommodations to access these forms, please call the phone number above immediately.

FOR OFFICE USE ONLY:								
Paid	Receipt #							
	0/20/2020							
Received by4.								
Aldermanic District								
Zoning District								
Urban Design District _								
Submittal reviewed by								
Legistar #								

1. Project Information

	Address:							
	Title:							
2.	Application Type (check all that	apply) and Requested Date	2					
	UDC meeting date requested							
	New development	Alteration to an existing or	previo	ously-approved development				
	Informational	Initial approval		Final approval				
3.	Project Type							
	Project in an Urban Design Dis	trict	Signa	age				
	Project in the Downtown Core I			Comprehensive Design Review (CDR)				
	Mixed-Use District (UMX), or Mix Project in the Suburban Employ	yment Center District (SEC),		Signage Variance (i.e. modification of signage height, area, and setback)				
	Campus Institutional District (C District (EC)	CI), or Employment Campus		Signage Exception				
	Planned Development (PD)		Other					
	General Development Pla Specific Implementation I	. ,		Please specify				
	Planned Multi-Use Site or Resid	dential Building Complex						
4.	Applicant, Agent, and Property	Owner Information						
	Applicant name		Com	ipany				
	Street address		City,	/State/Zip				
	Telephone			il				
	Project contact person		Com	ipany				
	Street address		City	/State/Zip				
	Telephone		Ema	il				
	Property owner (if not applicant)							
	Street address		City	/State/Zip				
	Telephone		Ema	il				

Urban Design Commission Application (continued)

5. Required Submittal Materials

Application Form

- Letter of Intent
 - If the project is within an Urban Design District, a summary of how the development proposal addresses the district criteria is required
 - For signage applications, a summary of how the proposed signage is consistent with the applicable CDR or Signage Variance review criteria is required.
- Development Plans (Refer to checklist on Page 4 for plan details)
- Filing fee
- Electronic Submittal*
- Notification to the District Alder
 - Please provide an email to the District Alder notifying them that you are filing this UDC application. Please send this
 as early in the process as possible and provide a copy of that email with the submitted application.

Both the paper copies and electronic copies <u>must</u> be submitted prior to the application deadline before an application will be scheduled for a UDC meeting. Late materials will not be accepted. A completed application form is required for each UDC appearance.

For projects also requiring Plan Commission approval, applicants must also have submitted an accepted application for Plan Commission consideration prior to obtaining any formal action (initial or final approval) from the UDC. All plans must be legible when reduced.

*Electronic copies of all items submitted in hard copy are required. Individual PDF files of each item submitted should be compiled on a CD or flash drive, or submitted via email to <u>udcapplications@citvofmadison.com</u>. The email must include the project address, project name, and applicant name. Electronic submittals via file hosting services (such as Dropbox.com) are not allowed. Applicants who are unable to provide the materials electronically should contact the Planning Division at (608) 266-4635 for assistance.

6. Applicant Declarations

- 1. Prior to submitting this application, the applicant is required to discuss the proposed project with Urban Design Commission staff. This application was discussed with <u>Plan Commission Advisory Referal</u> on
- 2. The applicant attests that all required materials are included in this submittal and understands that if any required information is not provided by the application deadline, the application will not be placed on an Urban Design Commission agenda for consideration.

Name of applicant Rod Ripley		\cap	Relationship to pro	perty Owne	r	1	
Authorizing signature of property owner	Ky	2	and an	Date	101	S	20
7. Application Filing Fees		Ì					

Fees are required to be paid with the first application for either initial or final approval of a project, unless the project is part of the combined application process involving the Urban Design Commission in conjunction with Plan Commission and/or Common Council consideration. Make checks payable to City Treasurer. Credit cards may be used for application fees of less than \$1,000.

Please consult the schedule below for the appropriate fee for your request:

- □ Urban Design Districts: \$350 (per §35.24(6) MGO).
- □ Minor Alteration in the Downtown Core District (DC) or Urban Mixed-Use District (UMX) : \$150 (per §33.24(6)(b) MGO)
- □ Comprehensive Design Review: \$500 (per §31.041(3)(d)(1)(a) MGO)
- Minor Alteration to a Comprehensive Sign Plan: \$100 (per §31.041(3)(d)(1)(c) MGO)
- All other sign requests to the Urban Design Commission, including, but not limited to: appeals from the decisions of the Zoning Administrator, requests for signage variances (i.e. modifications of signage height, area, and setback), and additional sign code approvals: \$300 (per §31.041(3)(d)(2) MGO)

A filing fee is not required for the following project applications if part of the combined application process involving both Urban Design Commission and Plan Commission:

- Project in the Downtown Core District (DC), Urban Mixed-Use District (UMX), or Mixed-Use Center District (MXC)
- Project in the Suburban Employment Center District (SEC), Campus Institutional District (CI), or Employment Campus District (EC)
- Planned Development (PD): General Development Plan (GDP) and/or Specific Implementation Plan (SIP)
- Planned Multi-Use Site or Residential Building Complex

M:\PLANNING DIVISION\COMMISSIONS & COMMITTEES\URBAN DESIGN COMMISSION\APPLICATION — FEBRUARY 2020

Each submittal must include fourteen (14) 11" x 17" <u>collated</u> paper copies. Landscape and Lighting plans (if required) must be <u>full-sized and legible</u>. Please refrain from using plastic covers or spiral binding.

Introduction

The City of Madison's Urban Design Commission (UDC) has been created to:

- Encourage and promote high quality in the design of new buildings, developments, remodeling, and additions so as to maintain and improve the established standards of property values within the City.
- Foster civic pride in the beauty and nobler assets of the City, and in all other ways possible assure a functionally efficient and visually attractive City in the future.

Types of Approvals

There are three types of requests considered by the UDC:

- <u>Informational Presentation</u>. Applicants may, at their discretion, request to make an Informational Presentation to the UDC prior to seeking any approvals to obtain early feedback and direction before undertaking detailed design. Applicants should provide details on the context of the site, design concept, site and building plans, and other relevant information to help the UDC understand the proposal and provide feedback. (Does not apply to CDR's or Signage Variance requests)
- <u>Initial Approval</u>. Applicants may, at their discretion, request initial approval of a proposal by presenting preliminary design information. As part of their review, the Commission will provide feedback on the design information that should be addressed at Final Approval stage.
- <u>Final Approval</u>. Applicants may request Final Approval of a proposal by presenting all final project details. Recommendations or concerns expressed by the UDC in the initial approval must be addressed at this time.

Presentations to the Commission

Primarily, the UDC is interested in the appearance and design quality of projects. Emphasis should be given to the site plan, landscape plan, lighting plan, building elevations, exterior building materials, color scheme, and graphics.

When presenting projects to the UDC, applicants must fill out a registration slip provided in the meeting room and present it to the Secretary. Presentations should generally be limited to 5 minutes or as extended by motion by consent of the Commission. The Commission will withhold questions until the end of the presentation.

Applicants are encouraged to consider the use of various graphic presentation material including a locator map, photographs, renderings/model, scale drawings of the proposal in context with adjacent buildings/uses/signs, etc., as may be deemed appropriate to describe the project and its surroundings. Graphics should be mounted on rigid boards so that they may be easily displayed. Applicants/presenters are responsible for all presentation materials, AV equipment and easels.

URBAN DESIGN DEVELOPMENT PLANS CHECKLIST

The items listed below are minimal application requirements for the type of approval indicated. Please note that the UDC and/ or staff may require additional information in order to have a complete understanding of the project.

Providing additional

information beyond these

minimums may generate

from the Commission.

a greater level of feedback

1. Informational Presentation

- Locator Map
- □ Letter of Intent (If the project is within an Urban Design District, a summary of <u>how</u> the development proposal addresses the district criteria is required)
- Contextual site information, including photographs and layout of adjacent buildings/structures
- Site Plan
- □ Two-dimensional (2D) images of proposed buildings or structures.

2. Initial Approval

- Locator Map
- □ Letter of Intent (If the project is within a Urban Design District, a summary of <u>how</u> the development proposal addresses the district criteria is required)
- □ Contextual site information, including photographs and layout of adjacent buildings/ structures
- □ Site Plan showing location of existing and proposed buildings, walks, drives, bike lanes, bike parking, and existing trees over 18" diameter
- □ Landscape Plan and Plant List (*must be legible*)
- Building Elevations in both black & white and color for all building sides (include material callouts)
- D PD text and Letter of Intent (if applicable)

3. Final Approval

All the requirements of the Initial Approval (see above), plus:

- □ Grading Plan
- □ Proposed Signage (if applicable)
- Lighting Plan, including fixture cut sheets and photometrics plan (*must be legible*)
- Utility/HVAC equipment location and screening details (with a rooftop plan if roof-mounted)
- D PD text and Letter of Intent (if applicable)
- □ Samples of the exterior building materials (presented at the UDC meeting)

4. Comprehensive Design Review (CDR) and Variance Requests (Signage applications only)

- Locator Map
- Letter of Intent (a summary of how the proposed signage is consistent with the CDR or Signage Variance criteria is required)
- □ Contextual site information, including photographs of existing signage both on site and within proximity to the project site
- □ Site Plan showing the location of existing signage and proposed signage, dimensioned signage setbacks, sidewalks, driveways, and right-of-ways
- Proposed signage graphics (fully dimensioned, scaled drawings, including materials and colors, and night view)
- □ Perspective renderings (emphasis on pedestrian/automobile scale viewsheds)
- □ Illustration of the proposed signage that meets Ch. 31, MGO compared to what is being requested.
- Graphic of the proposed signage as it relates to what the Ch. 31, MGO would permit

Requirements for All Plan Sheets

- 1. Title block
- 2. Sheet number
- 3. North arrow
- 4. Scale, both written and graphic
- 5. Date
- Fully dimensioned plans, scaled at 1"= 40' or larger

** All plans must be legible, including the full-sized landscape and lighting plans (if required)

> Providing additional information beyond these minimums may generate a greater level of feedback from the Commission.



July 29, 2020



Heather Stouder Department of Planning & Community & Economic Development Madison Municipal Building, Suite 017 215 Martin Luther King Jr. Blvd P.O. Box 2985 Madison, Wisconsin 53701-2985

Re: Letter of Intent Lucky's 1313 Expansion 1313 Regent Street Madison, WI

Ms. Heather Stouder,

The following is submitted together with the plans and application for staff review and sign-off.

Organizational Structure:

Owner/Developer: FCS Plan B, LLC W11579 County Road V #1 Lodi, W1 53555 Phone: 608-279-4163 Contact: Rod Ripley <u>rodripley@gmail.com</u>

Architect:

Knothe & Bruce Architects, LLC 7601 University Avenue, Ste. 201 Middleton, WI 53562 Phone: 608-836-3690 Contact: Kevin Burow <u>kburow@knothebruce.com</u> Engineer: D'Onofrio Kottke & Associates 7530 Westward Way Madison, WI 53717 Phone: 608-833-7530 Contact: Ron Klaas rklaas@donofrio.cc

Landscape D'Onofrio Kottke & Associates Design: 7530 Westward Way Madison, WI 53717 Phone: 608-833-7530 Contact: Matt Saltzberry msaltzberry@donofrio.cc

Introduction:

The proposed project is the expansion of Lucky's 1313 located at 1313 Regent Street and is the culmination of the recent renovation of this property. When the building was converted from a Auto Repair Garage in 2016 it was intended to have a vertical expansion to add housing above the new Brew Pub and Restaurant. Footings were selectively placed within the existing building accordingly in order to accommodate this. The property is zoned TSS - Transitional Shopping Street District and will stay the same.

This proposal will add housing units above and behind the existing building while not increasing the size of the existing Brew Pub. The southern portion of this site is currently used as a parking lot and outdoor volleyball courts. These will be reconfigured to accommodate a basement level of parking and the addition of townhome-style units along Bowen Court.

Letter of Intent – Land Use 1313 Regent Street July 29, 2020 Page 2 of 3

Project Description:

The expansion consists of adding three floors of apartments over the existing building and then bridging across the reconfigured parking lot to connect to additional units being added along Bowen Court. There will be a total of 63 apartment units plus a community space with access to a rooftop patio on the southern side of the property. The building will be a total of four stories along Regent Street and three stories along Bowen Court. The building will include 37 underground parking stalls and 23 surface stalls.

This site is within easy walking distance to the UW Campus and is located directly on a Madison Metro Bus route and is adjacent to other Student Rental Housing.

The building architecture references both the residential and commercial characteristics of the area. The exterior materials will be a combination of masonry to match Lucky's and both horizontal and panel composite siding. The townhome units located along Bowen Court will have direct entry to the units from the exterior and will fit in well with the residential character of that side of the property.

Conditional Use approvals:

The proposed redevelopment requires conditional uses to allow for more than 8 residential units within a mixed-use building, for a building that is 4 stories in height, and also for a building larger than 25,000 sq.ft.. The proposed building's size, scale and use are consistent with the City's Comprehensive Plan for this property, which calls for Neighborhood Mixed Use in 2-4 stories along Regent Street and Low-Medium Residential in 1-3 stories along Bowen Court.

City and Neighborhood Input:

We have met with the City on several occasions for this proposed development including meetings with Staff and attending a DAT Meeting. We have also had meetings with the Alder and the neighborhood to understand their goals and desires with this redevelopment. These discussions have helped shape the overall design of this project.

Site Development Data:

<u>Densiti</u>	es:	
	Lot Area	39,464 / 0.9 acres
	Dwelling Units	63 DU
	Lot Area / D.U.	626 S.F./D.U.
	Density	70 units/acre
	Open Space	6,069 S.F. (2,520 S.F. Min. Required)
	Lot Coverage	33,519 S.F. = 85% (33,544 S.F. 85% Max Required)
Building	<u>g Height:</u>	3 and 4 Stories
Gross	Floor Areas:	
	Residential Area	61,595 S.F.
	Commercial Area	10,377 S.F.
<u>Floor A</u>	Area Ratio	1.82

Letter of Intent – Land Use 1313 Regent Street July 29, 2020 Page 3 of 3

<u>Dwelling Unit Mix:</u>	
Efficiency	49
One Bedroom	37
One Bedroom + Den	3
Two Bedroom	8
Two Bedroom Townhome	5
Total Dwelling Units	63
Vehicle Parking:	
Surface	23 stalls*
<u>Underground</u>	<u>37 stalls</u>
Total	60 stalls
Bicycle Parking:	
Protected and Secure Stalls	63 stalls
Surface Stalls for Visitors	7 stalls
Surface Stalls for Commercial	25 stalls
Total	95 stalls

Project Schedule:

It is anticipated that the construction on this site will start in May 2021 with a final completion of May 2022.

Thank you for your time reviewing our proposal.

Sincerely,

Keni Bun

Kevin Burow, AIA, NCARB, LEED AP Managing Member

From:	Stacey Oehrke
Sent:	Friday, May 15, 2020 3:51 PM
То:	Evers, Tag; mononabayneighborhoodassoc@gmail.com
Cc:	Kevin Burow; vnapresident@gmail.com; kcarlson2@wisc.edu; John Perkins;
	leaj833@gmail.com
Subject:	RE: Lucky's 1313 Regent St Project

Great thank you!

Thank you,

Stacey Oehrke | Permit Specialist | Knothe & Bruce Architects, LLC | Ph: 608.836.3690 (Ex. 115) 7601 University Avenue, Middleton, WI 53562 | <u>soehrke@knothebruce.com</u>

From: Evers, Tag <<u>district13@cityofmadison.com</u>>
Sent: Friday, May 15, 2020 3:12 PM
To: Stacey Oehrke <<u>soehrke@knothebruce.com</u>>; <u>mononabayneighborhoodassoc@gmail.com</u>
Cc: Kevin Burow <<u>KBurow@knothebruce.com</u>>; <u>vnapresident@gmail.com</u>; <u>kcarlson2@wisc.edu</u>; John
Perkins <<u>perkinsj71@gmail.com</u>>; <u>leaj833@gmail.com</u>
Subject: Re: Lucky's 1313 Regent St Project

Hi Stacey,

This project is not in the Monona Bay neighborhood, but rather in Greenbush, on the border of Vilas.

I have folks from VNA and GNA on copy.

Thanks.

Tag Evers DISTRICT 13 ALDER CITY OF MADISON (608) 424-2580 district13@cityofmadison.com

Subscribe to my blog at www.cityofmadison.com/council/district13/blog

From: Stacey Oehrke <<u>soehrke@knothebruce.com</u>>
Sent: Friday, May 15, 2020 2:19 PM
To: Evers, Tag; <u>mononabayneighborhoodassoc@gmail.com</u>; <u>mononabayneighborhoodassoc@gmail.com</u>
Cc: Kevin Burow
Subject: Lucky's 1313 Regent St Project

Caution: This email was sent from an external source. Avoid unknown links and attachments.

Hello,

I would like to take this opportunity to formally notify you we plan on submitting our land use application on June 17, 2020 We are proposing expand the current Lucky's 1313 by adding 50 apartment units above and behind the existing building while also providing approximately 38 underground parking stalls and 24 surface parking stalls.

We look forward to working with you in making this a successful development. If you have any questions please contact Kevin Burow 608-836-3690.

Thank you for your time.

Thank you,

Stacey Oehrke | Permit Specialist | Knothe & Bruce Architects, LLC | Ph: 608.836.3690 (Ex. 115) 7601 University Avenue, Middleton, WI 53562 | <u>soehrke@knothebruce.com</u>



D-Series Size 1 LED Wall Luminaire




d"series

Specifications

Luminaire

Width:	13-3/4" (34.9 cm)	Weight:	12 lbs (5.4 kg)
Depth:	10" (25.4 cm)		
Height:	6-3/8" (16.2 cm)		

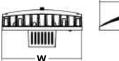


Ordering Information



(16.2 cm)

facts

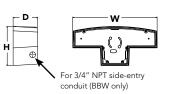

Catalog Number

Notes

Туре

Introduction

The D-Series Wall luminaire is a stylish, fully integrated LED solution for building-mount applications. It features a sleek, modern design and is carefully engineered to provide long-lasting, energy-efficient lighting with a variety of optical and control options for customized performance.

With an expected service life of over 20 years of nighttime use and up to 74% in energy savings over comparable 250W metal halide luminaires, the D-Series Wall is a reliable, low-maintenance lighting solution that produces sites that are exceptionally illuminated.

EXAMPLE: DSXW1 LED 20C 1000 40K T3M MVOLT DDBTXD

DSXW1	LED	ED																
Series	LEI		Drive C	urrent		Color temperature Distribution				ıtion	Voltage	Mounting		Control Options				
DSXW1	LED 10	(one engine)	350 530 700 1000	350 mA 530 mA 700 mA 1000 mA ((1 A) ¹	30K 40K 50K AMBPC	3000 K 4000 K 5000 K Amber phosphor converted	1	T2S T2M T3S T3M T4M TFTM	Type II Short Type II Medium Type III Short Type III Medium Type IV Medium Forward Throw Medium	MVOLT ² 120 ³ 208 ³ 240 ³ 277 ³ 347 ^{3,4} 480 ^{3,4}	Shippe (blank) BBW	ed included Surface mounting bracket Surface- mounted back box (for conduit entry) ⁵	Shipped i PE DMG PIR PIRH PIR1FC3V PIRH1FC3V ELCW	Photoe 0-10v use wit 180° m 180° m Motior ambien Motior ambien Emerge	electric cell, button type ⁶ dimming wires pulled outside fixture (for th an external control, ordered separately) notion/ambient light sensor, <15' mtg ht ¹⁷ notion/ambient light sensor, 15-30' mtg ht ¹⁷ n/ambient sensor, 8-15' mounting height, nt sensor enabled at 1fc ¹⁷ n/ambient sensor, 15-30' mounting height, nt sensor enabled at 1fc ¹⁷ ency battery backup (includes external onent enclosure), CA Title 20 Noncompliant ^{8,9}		
Other Op Shippe SF DF HS SPD	d installe Single fuse Double fus House-side	(120, 277 or 34) e (208, 240 or 48	3,10 ^{3,10}	Shippe BSW VG DDL	Vandal	terrent spikes	Finis DDB DBL DNA DWI	KD (D XD	Dark I Black	al aluminum	DSSXD DDBTXD DBLBXD DNATXD	Textured	l dark bronze	D	WHGXD ISSTXD	Textured white Textured sandstone		

	CCESSORIES	NOTES 1 20C 1000 is not available with PIR, PIRH, PIR1FC3V or PIRH1FC3V. 2 MVOLT driver operates on any line voltage from 120-277V (50/60 Hz).
DSXWHS U	House-side shield (one per light engine)	 Single fuse (SF) requires 120, 277 or 347 voltage option. Double fuse (DF) requires 208, 240 or 480 voltage option. Only available with 20C, 700mA or 1000mA. Not available with PIR or PIRH.
DSXWBSW U DSXW1VG U	Bird-deterrent spikes	 Back box ships installed on fixture. Cannot be field installed. Cannot be ordered as an accessory. Photocontrol (PE) requires 120, 208, 240, 277 or 347 voltage option. Not available with motion/ambient light sensors (PIR or PIRH).
D3XW1V0 0	Vandal guard accessory	 Reference Motion Sensor table on page 3. Cold weather (-20C) rated. Not compatible with conduit entry applications. Not available with BBW mounting option. Not available with fusing. Not available with 347 or 480 voltage options. Emergency components located in back box housing. Emergency mode IES files located on product page at <u>www.lithonia.com</u>

9 Not available with SPD.

10 Not available with ELCW.

- 11 Also available as a separate accessory; see Accessories information.
- 12 Not available with ELCW.



Lumen Output

Lumen values are from photometric tests performed in accordance with IESNA LM-79-08. Data is considered to be representative of the configurations shown, within the tolerances allowed by Lighting Facts. Contact factory for performance data on any configurations not shown here.

	Drive	System	Dist.	3	0K (30	00 K, 7	OCRI)		4	0K (40	00 K, 7	OCRI)			50K (50	000 K, 70	CRI)		AMBP	C (Amber	Phospho	r Converte	ed)
LEDs	Current (mA)	Watts	Туре	Lumens	В	U	G	LPW	Lumens	В	U	G	LPW	Lumens	В	U	G	LPW		В	U	G	LPW
			T2S	1,415	0	0	1	109	1,520	0	0	1	117	1,530	0	0	1	118	894	0	0	1	69
			T2M	1,349	0	0	1	104	1,448	0	0	1	111	1,458	0	0	1	112	852	0	0	1	66
			T3S	1,399	0	0	1	108	1,503	0	0	1	116	1,512	0	0	1	116	884	0	0	1	68
	350mA	13W	T3M	1,385	0	0	1	107	1,488	0	0	1	114	1,497	0	0	1	115	876	0	0	1	67
			T4M	1,357	0	0	1	104	1,458	0	0	1	112	1,467	0	0	1	113	858	0	0		66
			TFTM ASYDF	1,411	0	0	1	109 97	1,515 1,354	0	0	1	117 104	1,525 1,363	0	0	1	117 105	892 797	0	0	1	69
			T2S	2,053	1	0	1	108	2,205	1	0	1	116	2,220	1	0	1	117	1,264	0	0	1	67
			T2M	1,957	1	0	1	103	2,102	1	0	1	111	2,115	1	0	1	111	1,205	0	0	1	63
			T3S	2,031	1	0	1	107	2,181	1	0	1	115	2,194	1	0	1	115	1,250	0	0	1	66
	530 mA	19W	T3M	2,010	1	0	1	106	2,159	1	0	1	114	2,172	1	0	1	114	1,237	0	0	1	65
			T4M	1,970	1	0	1	104	2,115	1	0	1	111	2,129	1	0	1	112	1,212	0	0	1	64
10C			TFTM	2,047	0	0	1	108	2,198	1	0	1	116	2,212	1	0	1	116	1,260	0	0	1	66
			ASYDF T2S	1,831 2,623	1	0	1	96 101	1,966 2,816	1	0	1	103 108	1,978 2,834	1	0	1	104 109	<u>1,127</u> 1,544	0	0	1	59 59
(10 LEDs)			T2M	2,023	1	0	1	96	2,684	1	0	1	103	2,701	1	0	1	105	1,344	0	0	1	57
			T3S	2,593	1	0	1	100	2,785	1	0	1	107	2,802	1	0	1	108	1,527	0	0	1	59
	700 mA	26W	T3M	2,567	1	0	1	99	2,757	1	0	1	106	2,774	1	0	1	107	1,512	0	0	1	58
			T4M	2,515	1	0	1	97	2,701	1	0	1	104	2,718	1	0	1	105	1,481	0	0	1	57
			TFTM	2,614	1	0	1	101	2,808	1	0	1	108	2,825	1	0	1	109	1,539	0	0	1	59
			ASYDF T2S	2,337	1	0	1	90 94	2,510	1	0	1	97	2,525	1	0	1	97	1,376	1	0	1	53
			T2S	3,685 3,512	1	0	1	94	3,957 3,771	1	0	1	101 97	3,982 3,794	1	0	1	102 97	2,235 2,130	1	0	1	57 55
			T3S	3,512	1	0	1	90	3,913	1	0	1	100	3,938	1	0	1	101	2,130	1	0	1	57
	1000 mA	39W	T3M	3,607	1	0	1	92	3,873	1	0	1	99	3,898	1	0	1	100	2,187	1	0	1	56
			T4M	3,534	1	0	2	91	3,796	1	0	2	97	3,819	1	0	2	98	2,143	1	0	1	55
			TFTM	3,673	1	0	1	94	3,945	1	0	1	101	3,969	1	0	1	102	2,228	1	0	1	57
			ASYDF	3,284	1	0	2	84	3,527	1	0	2	90	3,549	1	0	2	91	1,992	1	0	1	51
			T2S	2,820	1	0	1	123	3,028	1	0	1	132	3,047	1	0	1	132	1,777	1	0	1	77
			T2M T3S	2,688	1	0	1	117	2,886 2,994	1	0	1	125 130	2,904 3,014	1	0	1	126 131	<u>1,693</u> 1,757	0	0		74 76
	350mA	23W	T3M	2,760	1	0	1	120	2,965	1	0	1	129	2,983	1	0	1	130	1,739	1	0	1	76
		2511	T4M	2,704	1	0	1	118	2,905	1	0	1	126	2,922	1	0	1	127	1,704	1	0	1	74
			TFTM	2,811	1	0	1	122	3,019	1	0	1	131	3,038	1	0	1	132	1,771	0	0	1	77
			ASYDF	2,514	1	0	1	109	2,699	1	0	1	117	2,716	1	0	1	118	1,584	1	0	1	69
			T2S	4,079	1	0	1	117	4,380	1	0	1	125	4,407	1	0	1	126	2,504	1	0	1	72
			T2M T3S	3,887	1	0	1	111	4,174	1	0	1	119 124	4,201	1	0	1	120 125	2,387	1	0	1	68 71
	530 mA	35W	T3M	4,033 3,993	1	0	2	115	4,331 4,288	1	0	2	124	4,359 4,315	1	0	2	125	2,477 2,451	1	0		70
	550 111	5511	T4M	3,912	1	0	2	112	4,201	1	0	2	120	4,227	1	0	2	123	2,402	1	0	1	69
			TFTM	4,066	1	0	2	116	4,366	1	0	2	125	4,394	1	0	2	126	2,496	1	0	1	71
20C			ASYDF	3,636	1	0	2	104	3,904	1	0	2	112	3,928	1	0	2	112	2,232	1	0	1	64
(20 LEDs)			T2S	5,188	1	0	1	113	5,572	1	0	1	121	5,607	1	0	1	122	3,065	1	0	1	67
			T2M	4,945	1	0	2	108	5,309	1	0	2	115	5,343	1	0	2	116	2,921	1	0	1	64
	700 m A	AGWI	T3S	5,131	1	0	2	112	5,510	1	0	2	120	5,544	1	0	2	121	3,031	1	0	1	66
	700 mA	46W	T3M T4M	5,078 4,975	1	0	2	110 108	5,454 5,343	1	0	2	119 116	5,487 5,376	1	0	2	119 117	3,000 2,939	1	0	1	65
			TFTM	5,172	1	0	2	112	5,554	1	0	2	121	5,589	1	0	2	122	3,055	1	0	1	66
			ASYDF	4,624	1	0	2	101	4,965	1	0	2	108	4,996	1	0	2	109	2,732	1	0	1	59
			T2S	7,204	1	0	2	99	7,736	2	0	2	106	7,784	2	0	2	107	4,429	1	0	1	61
			T2M	6,865	1	0	2	94	7,373	2	0	2	101	7,419	2	0	2	102	4,221	1	0	1	58
			T3S	7,125	1	0	2	98	7,651	1	0	2	105	7,698	1	0	2	105	4,380	1	0	1	60
	1000 mA	73W	T3M	7,052	1	0	2	97	7,573	2	0	2	104	7,620	2	0	2	104	4,335	1	0	2	59
			T4M	6,909	1	0	2	95 98	7,420	1	0	2	102	7,466	1	0	2	102	4,248	1	0	2	58
			TFTM ASYDF	7,182	1	0	2	98 88	7,712 6,896	1	0	2	106 94	7,761 6,938	1	0	2	106 95	<u>4,415</u> 3,947	1	0	2	60 54
			NJIDI'	0,421	1 4	0	1 2	00	0,070	1 4	1 0	נן	74	0,730	<u> </u>	0	ر _ا	75	3,74/		U	1 2	



Performance Data

Lumen Ambient Temperature (LAT) Multipliers

Use these factors to determine relative lumen output for average ambient temperatures from 0-40 $^\circ C$ (32-104 $^\circ F).$

Aml	bient	Lumen Multiplier
0°C	32°F	1.02
10°C	50°F	1.01
20°C	68°F	1.00
25°C	77°F	1.00
30°C	86°F	1.00
40°C	104°F	0.98

Projected LED Lumen Maintenance

Data references the extrapolated performance projections for the **DSXW1 LED 20C 1000** platform in a **25°C ambient**, based on 10,000 hours of LED testing (tested per IESNA LM-80-08 and projected per IESNA TM-21-11).

To calculate LLF, use the lumen maintenance factor that corresponds to the desired number of operating hours below. For other lumen maintenance values, contact factory.

Operating Hours	0	25,000	50,000	100,000
Lumen Maintenance Factor	1.0	0.95	0.93	0.88

Electrical Load


			Current (A)					
LEDs	Drive Current (mA)	System Watts	120V	208V	240V	277V	347V	480V
	350	14 W	0.13	0.07	0.06	0.06	-	-
10C	530	20 W	0.19	0.11	0.09	0.08	-	-
IUC	700	27 W	0.25	0.14	0.13	0.11	-	-
	1000	40 W	0.37	0.21	0.19	0.16	-	-
	350	24 W	0.23	0.13	0.12	0.10	-	-
20C	530	36 W	0.33	0.19	0.17	0.14	-	-
200	700	47 W	0.44	0.25	0.22	0.19	0.15	0.11
	1000	74 W	0.69	0.40	0.35	0.30	0.23	0.17

Motion Sensor Default Settings							
Option	Dimmed State	High Level (when triggered)	Photocell Operation	Dwell Time	Ramp-up Time	Ramp-down Time	
*PIR or PIRH	3V (37%) Output	10V (100%) Output	Enabled @ 5FC	5 min	3 sec	5 min	
PIR1FC3V or PIRH1FC3V	3V (37%) Output	10V (100%) Output	Enabled @ 1FC	5 min	3 sec	5 min	


* for use with site wide Dusk to Dawn control


To see complete photometric reports or download .ies files for this product, visit Lithonia Lighting's D-Series Wall Size 1 homepage.

Isofootcandle plots for the DSXW1 LED 20C 1000 40K. Distances are in units of mounting height (15').

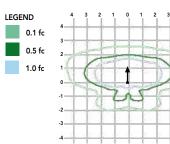


Photometric Diagrams

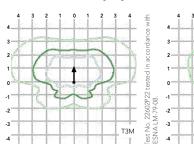

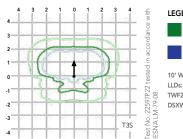

Distribution overlay comparison to 250W metal halide.

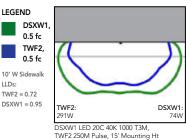

Options and Accessories



T3M (left), ASYDF (right) lenses



T2M Z

HS - House-side shields



BSW - Bird-deterrent spikes







VG - Vandal guard



DDL - Diffused drop lens

FEATURES & SPECIFICATIONS

INTENDED USE

The energy savings, long life and easy-to-install design of the D-Series Wall Size 1 make it the smart choice for building-mounted doorway and pathway illumination for nearly any facility.

CONSTRUCTION

Two-piece die-cast aluminum housing has integral heat sink fins to optimize thermal management through conductive and convective cooling. Modular design allows for ease of maintenance. The LED driver is mounted to the door to thermally isolate it from the light engines for low operating temperature and long life. Housing is completely sealed against moisture and environmental contaminants (IP65).

FINISH

Exterior parts are protected by a zinc-infused Super Durable TGIC thermoset powder coat finish that provides superior resistance to corrosion and weathering. A tightly controlled multi-stage process ensures a minimum 3 mils thickness for a finish that can withstand extreme climate changes without cracking or peeling. Available in textured and non-textured finishes.

OPTICS

Precision-molded proprietary acrylic lenses provide multiple photometric distributions tailored specifically to building mounted applications. Light engines are available in 3000 K (70 min. CRI), 4000 K (70 min. CRI) or 5000 K (70 min. CRI) configurations.

ELECTRICAL

Light engine(s) consist of 10 high-efficacy LEDs mounted to a metal-core circuit board to maximize heat dissipation and promote long life (L88/100,000 hrs at 25°C). Class 1 electronic drivers have a power factor >90%, THD <20%, and a minimum 2.5KV surge rating. When ordering the SPD option, a separate surge protection device is installed within the luminaire which meets a minimum Category C Low (per ANSI/IEEE C62.41.2).

INSTALLATION

Included universal mounting bracket attaches securely to any 4" round or square outlet box for quick and easy installation. Luminaire has a slotted gasket wireway and attaches to the mounting bracket via corrosion-resistant screws.

LISTINGS

CSA certified to U.S. and Canadian standards. Rated for -40°C minimum ambient.

DesignLights Consortium® (DLC) qualified product. Not all versions of this product may be DLC qualified. Please check the DLC Qualified Products List at www.designlights.org/QPL to confirm which versions are qualified.

WARRANTY

Five-year limited warranty. Complete warranty terms located at: www.acuitybrands.com/support/customer-support/terms-and-condition

Note: Actual performance may differ as a result of end-user environment and application. All values are design or typical values, measured under laboratory conditions at 25 °C. Specifications subject to change without notice.



COMMERCIAL OUTDOOR



CITY OF MADISON LANDSCAPE WORKSHEET

Section 28.142 Madison General Ordinance

Project Location /	Address 1313 Regent Street
Name of Project	Lucky's 1313 Expansion
Owner / Contact	Matt Saltzberry, PLA - D'Onofrio Kottke (Landscape Architect)
Contact Phone 6	08-833-7530 Contact Email msaltzberry@donofrio.cc

** Landscape plans for zoning lots greater than ten thousand (10,000) square feet in size MUST be prepared by a registered landscape architect. **

Applicability

The following standards apply to all exterior construction and development activity, including the expansion of existing buildings, structures and parking lots, except the construction of detached single-family and two-family dwellings and their accessory structures. The entire development site must be brought up to compliance with this section unless **all** of the following conditions apply, in which case only the affected areas need to be brought up to compliance:

- (a) The area of site disturbance is less than ten percent (10%) of the entire development site during any ten-(10) year period.
- (b) Gross floor area is only increased by ten percent (10%) during any ten-(10) year period.
- (c) No demolition of a principal building is involved.
- (d) Any displaced landscaping elements must be replaced on the site and shown on a revised landscaping plan.

Landscape Calculations and Distribution

Required landscaped areas shall be calculated based upon the total developed area of the property. Developed area is defined as that area within a single contiguous boundary which is made up of structures, parking, driveways and docking/loading facilities, but excluding the area of any building footprint at grade, land designated for open space uses such as athletic fields, and undeveloped land area on the same zoning lot. There are three methods for calculating landscape points depending on the size of the lot and Zoning District.

(a) For all lots except those described in (b) and (c) below, five (5) landscape points shall be provided for each three hundred (300) square feet of developed area.

Total square footage of developed area _____18,675 SF

Total landscape points required _____311

(b) For lots larger than five (5) acres, points shall be provided at five (5) points per three hundred (300) square feet for the first five (5) developed acres, and one (1) point per one hundred (100) square feet for all additional acres.

Total square footage of developed area _____

Five (5) acres = $\underline{217,800}$ square feet

First five (5) developed acres = 3,630 points

Remainder of developed area

Total landscape points required _____

(c) For the Industrial – Limited (IL) and Industrial – General (IG) districts, one (1) point shall be provided per one hundred (100) square feet of developed area.

Total square footage of developed area

Total landscape points required _____


Tabulation of Points and Credits

Use the table to indicate the quantity and points for all existing and proposed landscape elements.

Plant Type/ Element	Minimum Size at	Points		Existing caping		roposed caping
Plant Type/ Element	Installation	romus	Quantity	Points Achieved	Quantity	Points Achieved
Overstory deciduous tree	2 ¹ / ₂ inch caliper measured diameter at breast height (dbh)	35	-	-	4	140
Tall evergreen tree (i.e. pine, spruce)	5-6 feet tall	35	-	-	-	-
Ornamental tree	1 1/2 inch caliper	15	-	-	-	-
Upright evergreen shrub (i.e. arborvitae)	3-4 feet tall	10	-	-	-	-
Shrub, deciduous	#3 gallon container size, Min. 12"-24"	3	-	-	40	120
Shrub, evergreen	#3 gallon container size, Min. 12"-24"	4	-	-	37	148
Ornamental grasses/ perennials	#1 gallon container size, Min. 8"-18"	2	-	-	84	168
Ornamental/ decorative fencing or wall	n/a	4 per 10 lineal ft.	-	-	-	-
Existing significant specimen tree	Minimum size: 2 ¹ / ₂ inch caliper dbh. *Trees must be within developed area and cannot comprise more than 30% of total required points.	14 per caliper inch dbh. Maximum points per tree: 200	-	-	-	-
Landscape furniture for public seating and/or transit connections	* Furniture must be within developed area, publically accessible, and cannot comprise more than 5% of total required points.	5 points per "seat"	-	-	-	-
Sub Totals				_		576

Total Number of Points Provided _____576

* As determined by ANSI, ANLA- American standards for nursery stock. For each size, minimum plant sizes shall conform to the specifications as stated in the current American Standard for Nursery Stock.

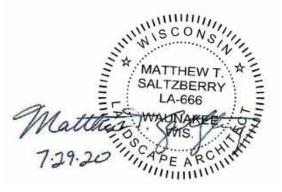

EXISTING PHOTOS LUCKY'S 1313 BREW PUB EXPANSION

1313 Regent Street / Lucky's Brew Pub





Bowen Court / Lucky's Brew Pub Parking Lot, Patio & Volleyball Courts



Bowen Court / Lucky's Brew Pub Parking Lot, Patio & Volleyball Courts




S. Randall Avenue / Lucky's surface parking lot








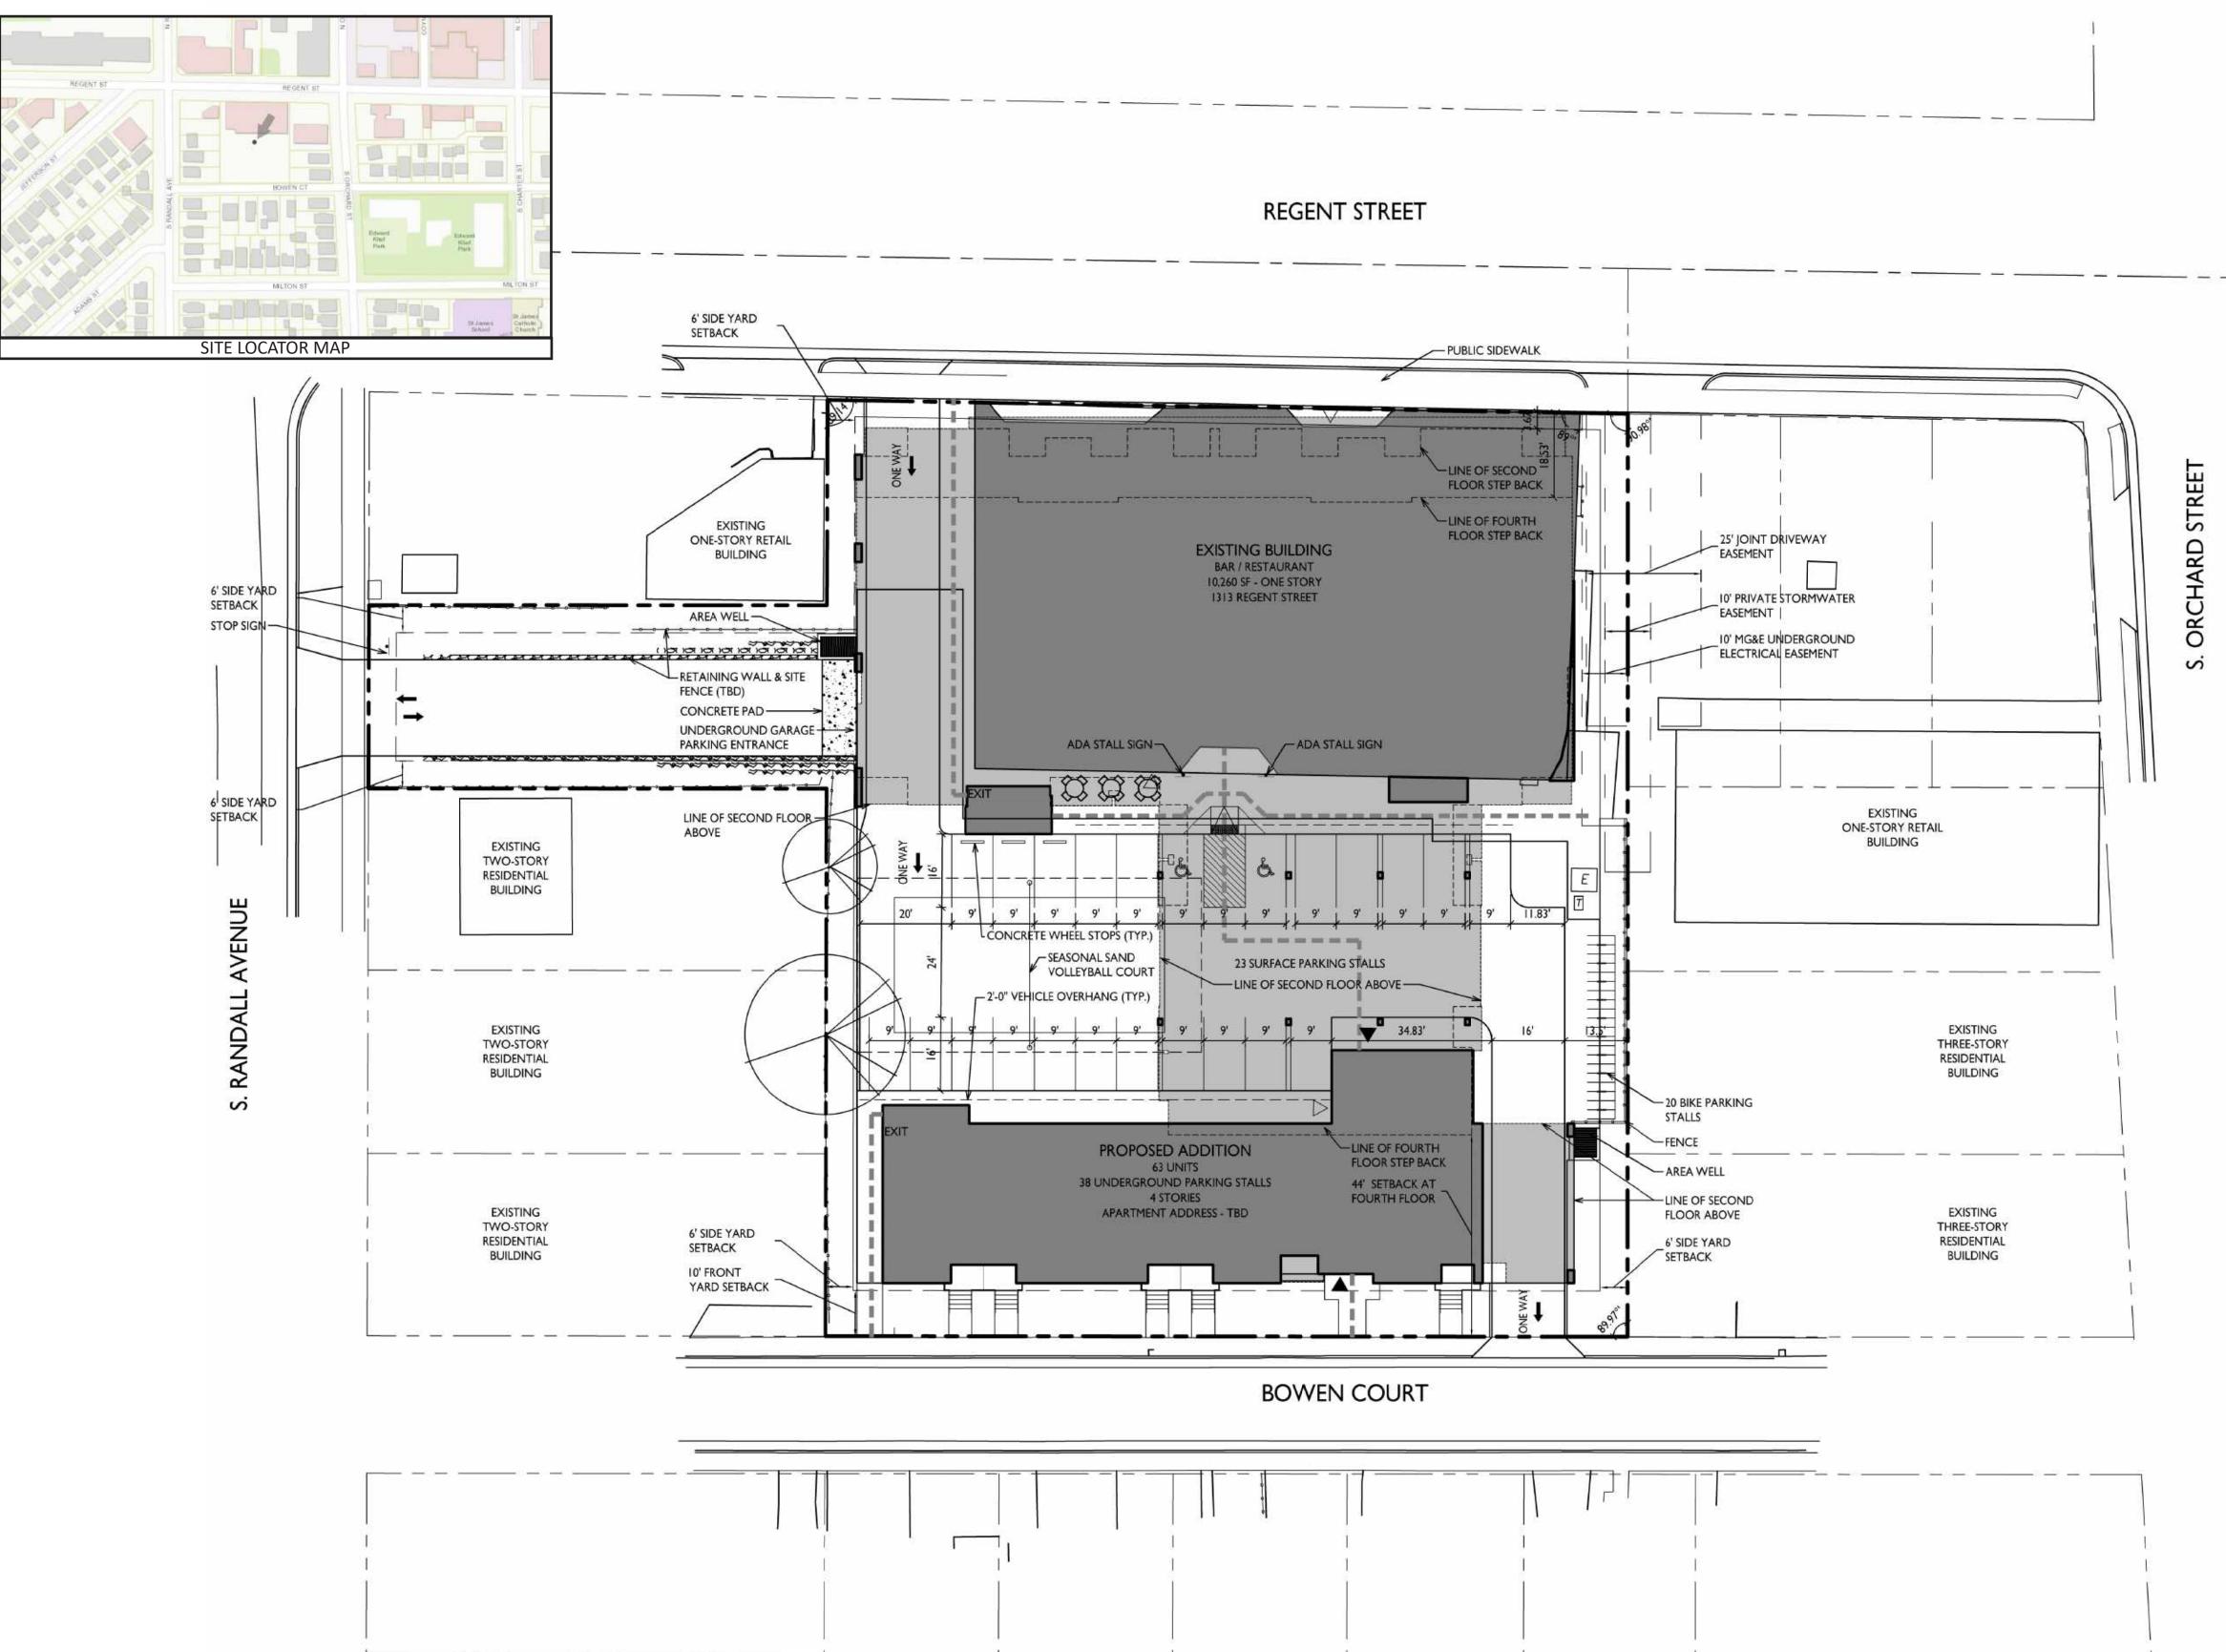



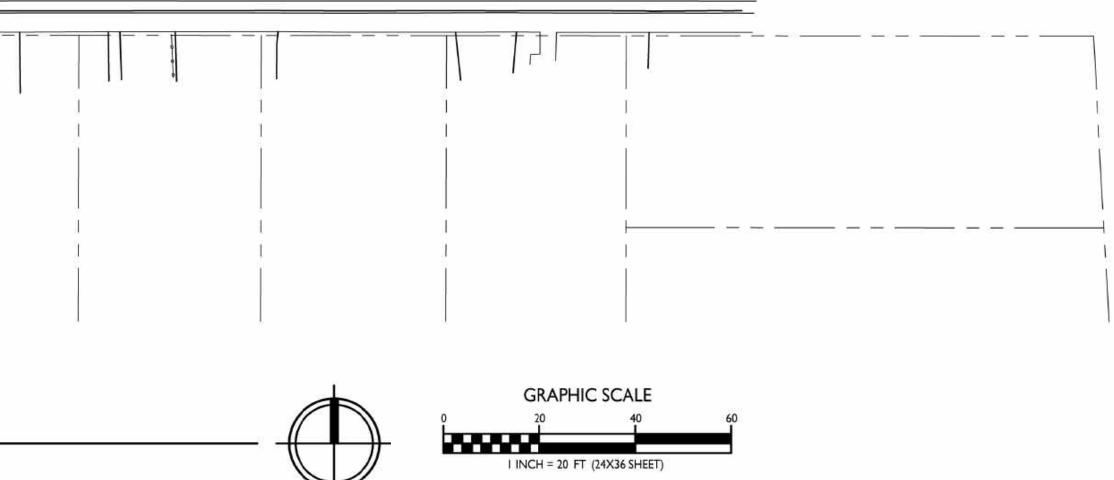

GENERAL NOTES:

I. THE APPLICANT SHALL REPLACE ALL SIDEWALK AND CURB AND GUTTER THAT ABUTS THE PROPERTY THAT IS DAMAGED BY THE CONSTRUCTION, OR ANY SIDEWALK AND CURB AND GUTTER WHICH THE CITY ENGINEER DETERMINES NEEDS TO BE REPLACED BECAUSE IT IS NOT AT A DESIRABLE GRADE, REGARDLESS OF WHETHER THE CONDITION EXISTED PRIOR TO BEGINNING CONSTRUCTION.

2. ALL WORK IN THE PUBLIC RIGHT OF WAY SHALL BE PERFORMED BY A CITY-LICENSED CONTRACTOR.


3. ALL DAMAGE TO THE PAVEMENT ON CITY STREETS, AND ADJACENT TO THIS DEVELOPMENT SHALL BE RESTORED IN ACCORDANCE WITH THE CITY OF MADISON'S PAVEMENT PATCHING CRITERIA.

4. EXISTING STREET TREES SHALL BE PROTECTED. CONTRACTOR SHALL INSTALL TREE PROTECTION FENCING IN THE AREA BETWEEN THE CURB AND SIDEWALK AND EXTEND IT AT LEAST 5 FEET FROM BOTH SIDES OF THE TREE ALONG THE LENGTH OF THE TERRACE. NO EXCAVATION IS PERMITTED WITHIN 5 FEET OF THE OUTSIDE EDGE OF THE TREE TRUNK. IF EXCAVATION WITHIN 5 FEET OF ANY TREE IS NECESSARY, CONTRACTOR SHALL CONTACT CITY FORESTRY (266-4816) PRIOR TO EXCAVATION TO ASSESS THE IMPACT TO THE TREE AND ROOT SYSTEM. TREE PRUNING SHALL BE COORDINATED WITH CITY FORESTRY. TREE PROTECTION SPECIFICATIONS CAN BE FOUND IN SECTION 107.13 OF CITY OF MADISON STANDARD SPECIFICATIONS FOR PUBLIC WORKS CONSTRUCTION.

5. APPROVAL OF PLANS FOR THIS PROJECT DOES NOT INCLUDE ANY APPROVAL TO PRUNE, REMOVE, OR PLANT TREES IN THE PUBLIC RIGHT-OF-WAY. PERMISSION FOR SUCH ACTIVITIES MUST BE OBTAINED FROM THE CITY FORESTER (266-4816).

6. THE PUBLIC RIGHT-OF-WAY IS THE SOLE JURISDICTION OF THE CITY OF MADISON AND IS SUBJECT TO CHANGE AT ANY TIME. NO ITEMS SHOWN ON THIS SITE PLAN IN THE RIGHT-OF-WAY ARE PERMANENT AND MAY NEED TO BE REMOVED AT THE APPLICANTS EXPENSE UPON NOTIFICATION BY THE CITY.

Site Development D	ata:	UPDATED 7-16-2020 dq
Zoning: TSS - Tradition	al Shopping Street	
Densities:		
	Conditional Use	
Lot Area	39,464 S.F./0.9 acres	
Dwelling Units 202 units		
Lot Area / D.U.	626 S.F./unit	
Density	70 units/Acre	
Commercial Area	10,260 S.F.	
Usable Open Space	6,020 S.F. (96S.F./unit)	
Lot Coverage	33,612 S.F. (85%)	
Building Height	4 stories	
Dwelling Unit Mix:	Proposed Addition	
Efficiency	10	
One Bedroom	37	
One Bedroom + Den	3	
Two bedroom	8	
Two Bedroom Townh	ouse 5	
Total Dwelling Units	63	
Vehicle Parking Stalls:		
Underground Garage	37	
Surface	23	
Total	60	
Parking Ratio 0.95 stall	s/unit	
Bicycle Parking:		
Garage - wall mount	9	
Garage - floor mount	54	
Surface-Guest	20	
Total	83	

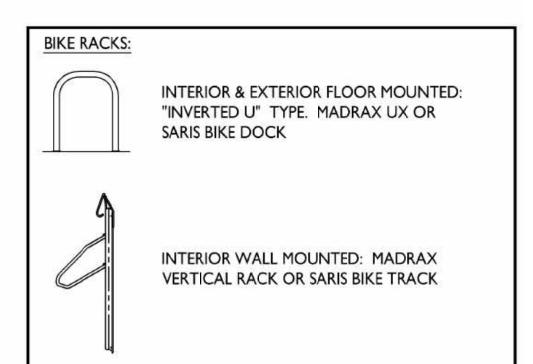



ISSUED Issued for Land Use Submittal - July 29, 2020


PROJECT TITLE Lucky's Site , Development Regent & Randall

1313 Regent Street Madison, Wisconsin SHEET TITLE Site Plan




STATISTICS						
DESCRIPTION	SYMBOL	AVG.	MAX.	MIN.	MAX. / MIN.	AVG. / MIN.
Uncovered Parking Area Lighting	+	0.5 fc	0.8 fc	0.2 fc	4.0:I	2.5:1

LUMI	NAIR	e sc	HEDULE	I			
SYMBOL	LABEL	QTY.	MANUF.	CATALOG	DESCRIPTION	FILE	MOUNTING
	A	3	LITHONIA LIGHTING	DSXW1 LED 10C 350 30K T4M MVOLT HS	DSXWI LED WITH (I) I0 LED LIGHT ENGINE, TYPE 4M OPTIC, 3000K, AT 350mA WITH HOUSE-SIDE SHIELD	DSXWI_LED_10C _350_30K_T4M _MVOLT_HS.ies	MOUNTED ON BUILDING 16'-0" ABOVE GRADE
			EX	CAMPLE LIGHT FI	XTURE DISTRIBU	JR = 0.25 FC JR = 0.5 FC	

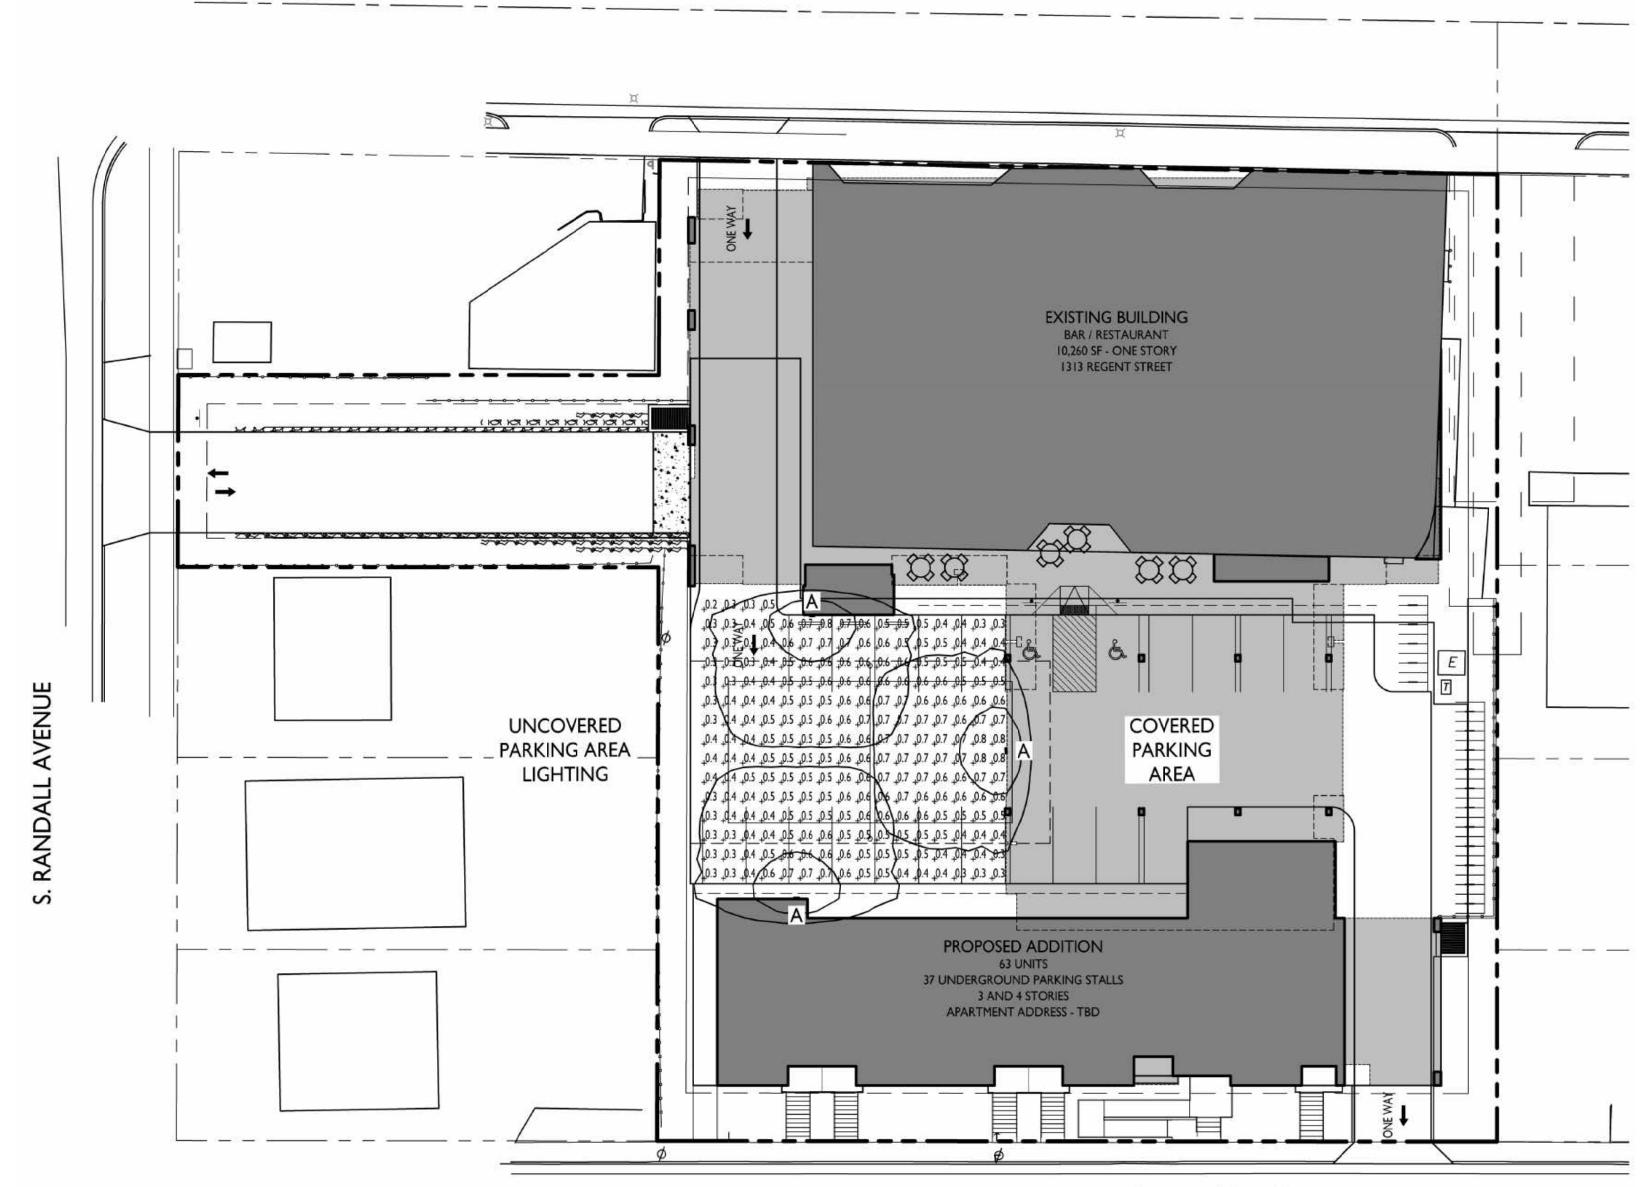




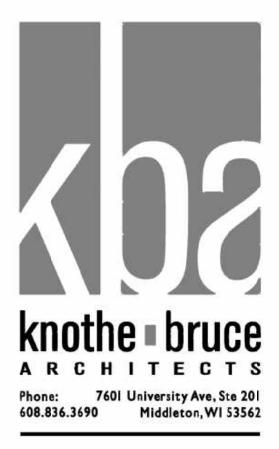

REGENT STREET

BOWEN COURT

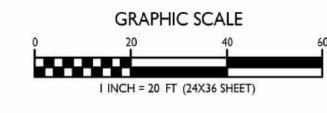


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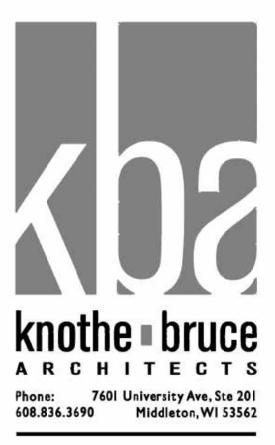
PROJECT TITLE Lucky's 1313 Expansion

1313 Regent Street Madison, Wisconsin SHEET TITLE Site Lighting Plan

SHEET NUMBER

C-1.2 PROJECT NO. 1916



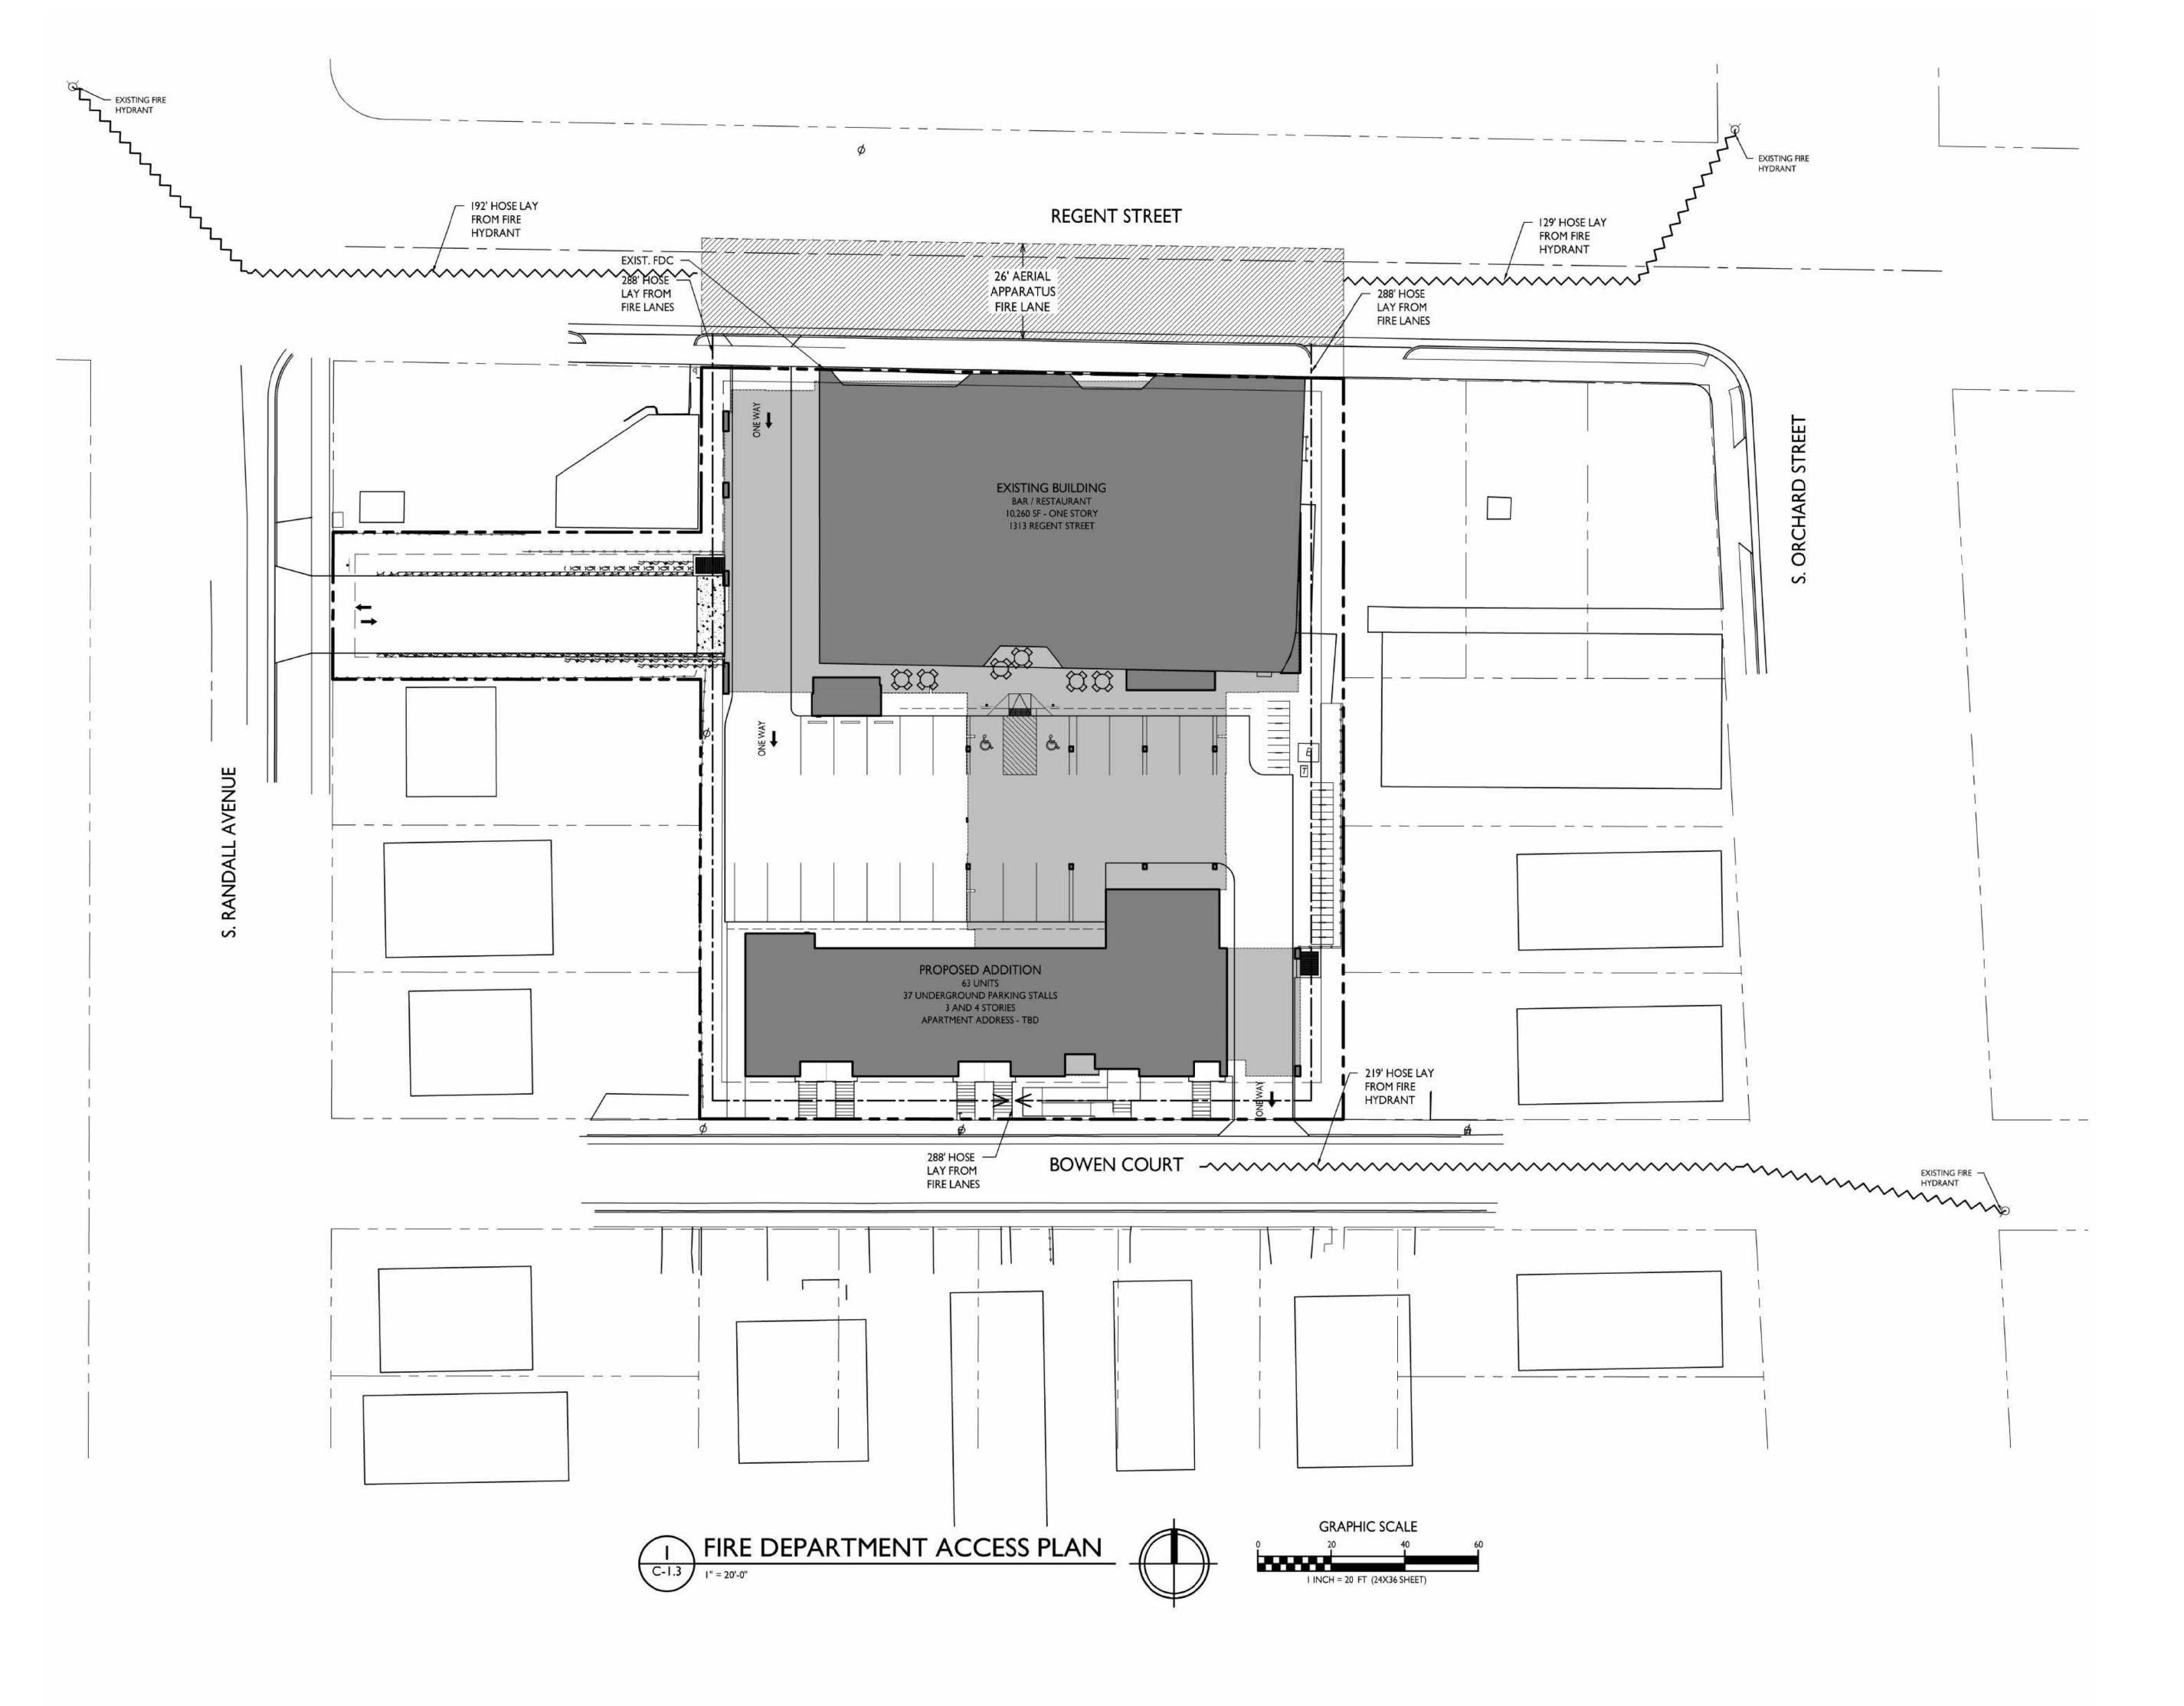


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PROJECT TITLE Lucky's 1313 Expansion

1313 Regent Street Madison, Wisconsin SHEET TITLE Fire Department Access Plan





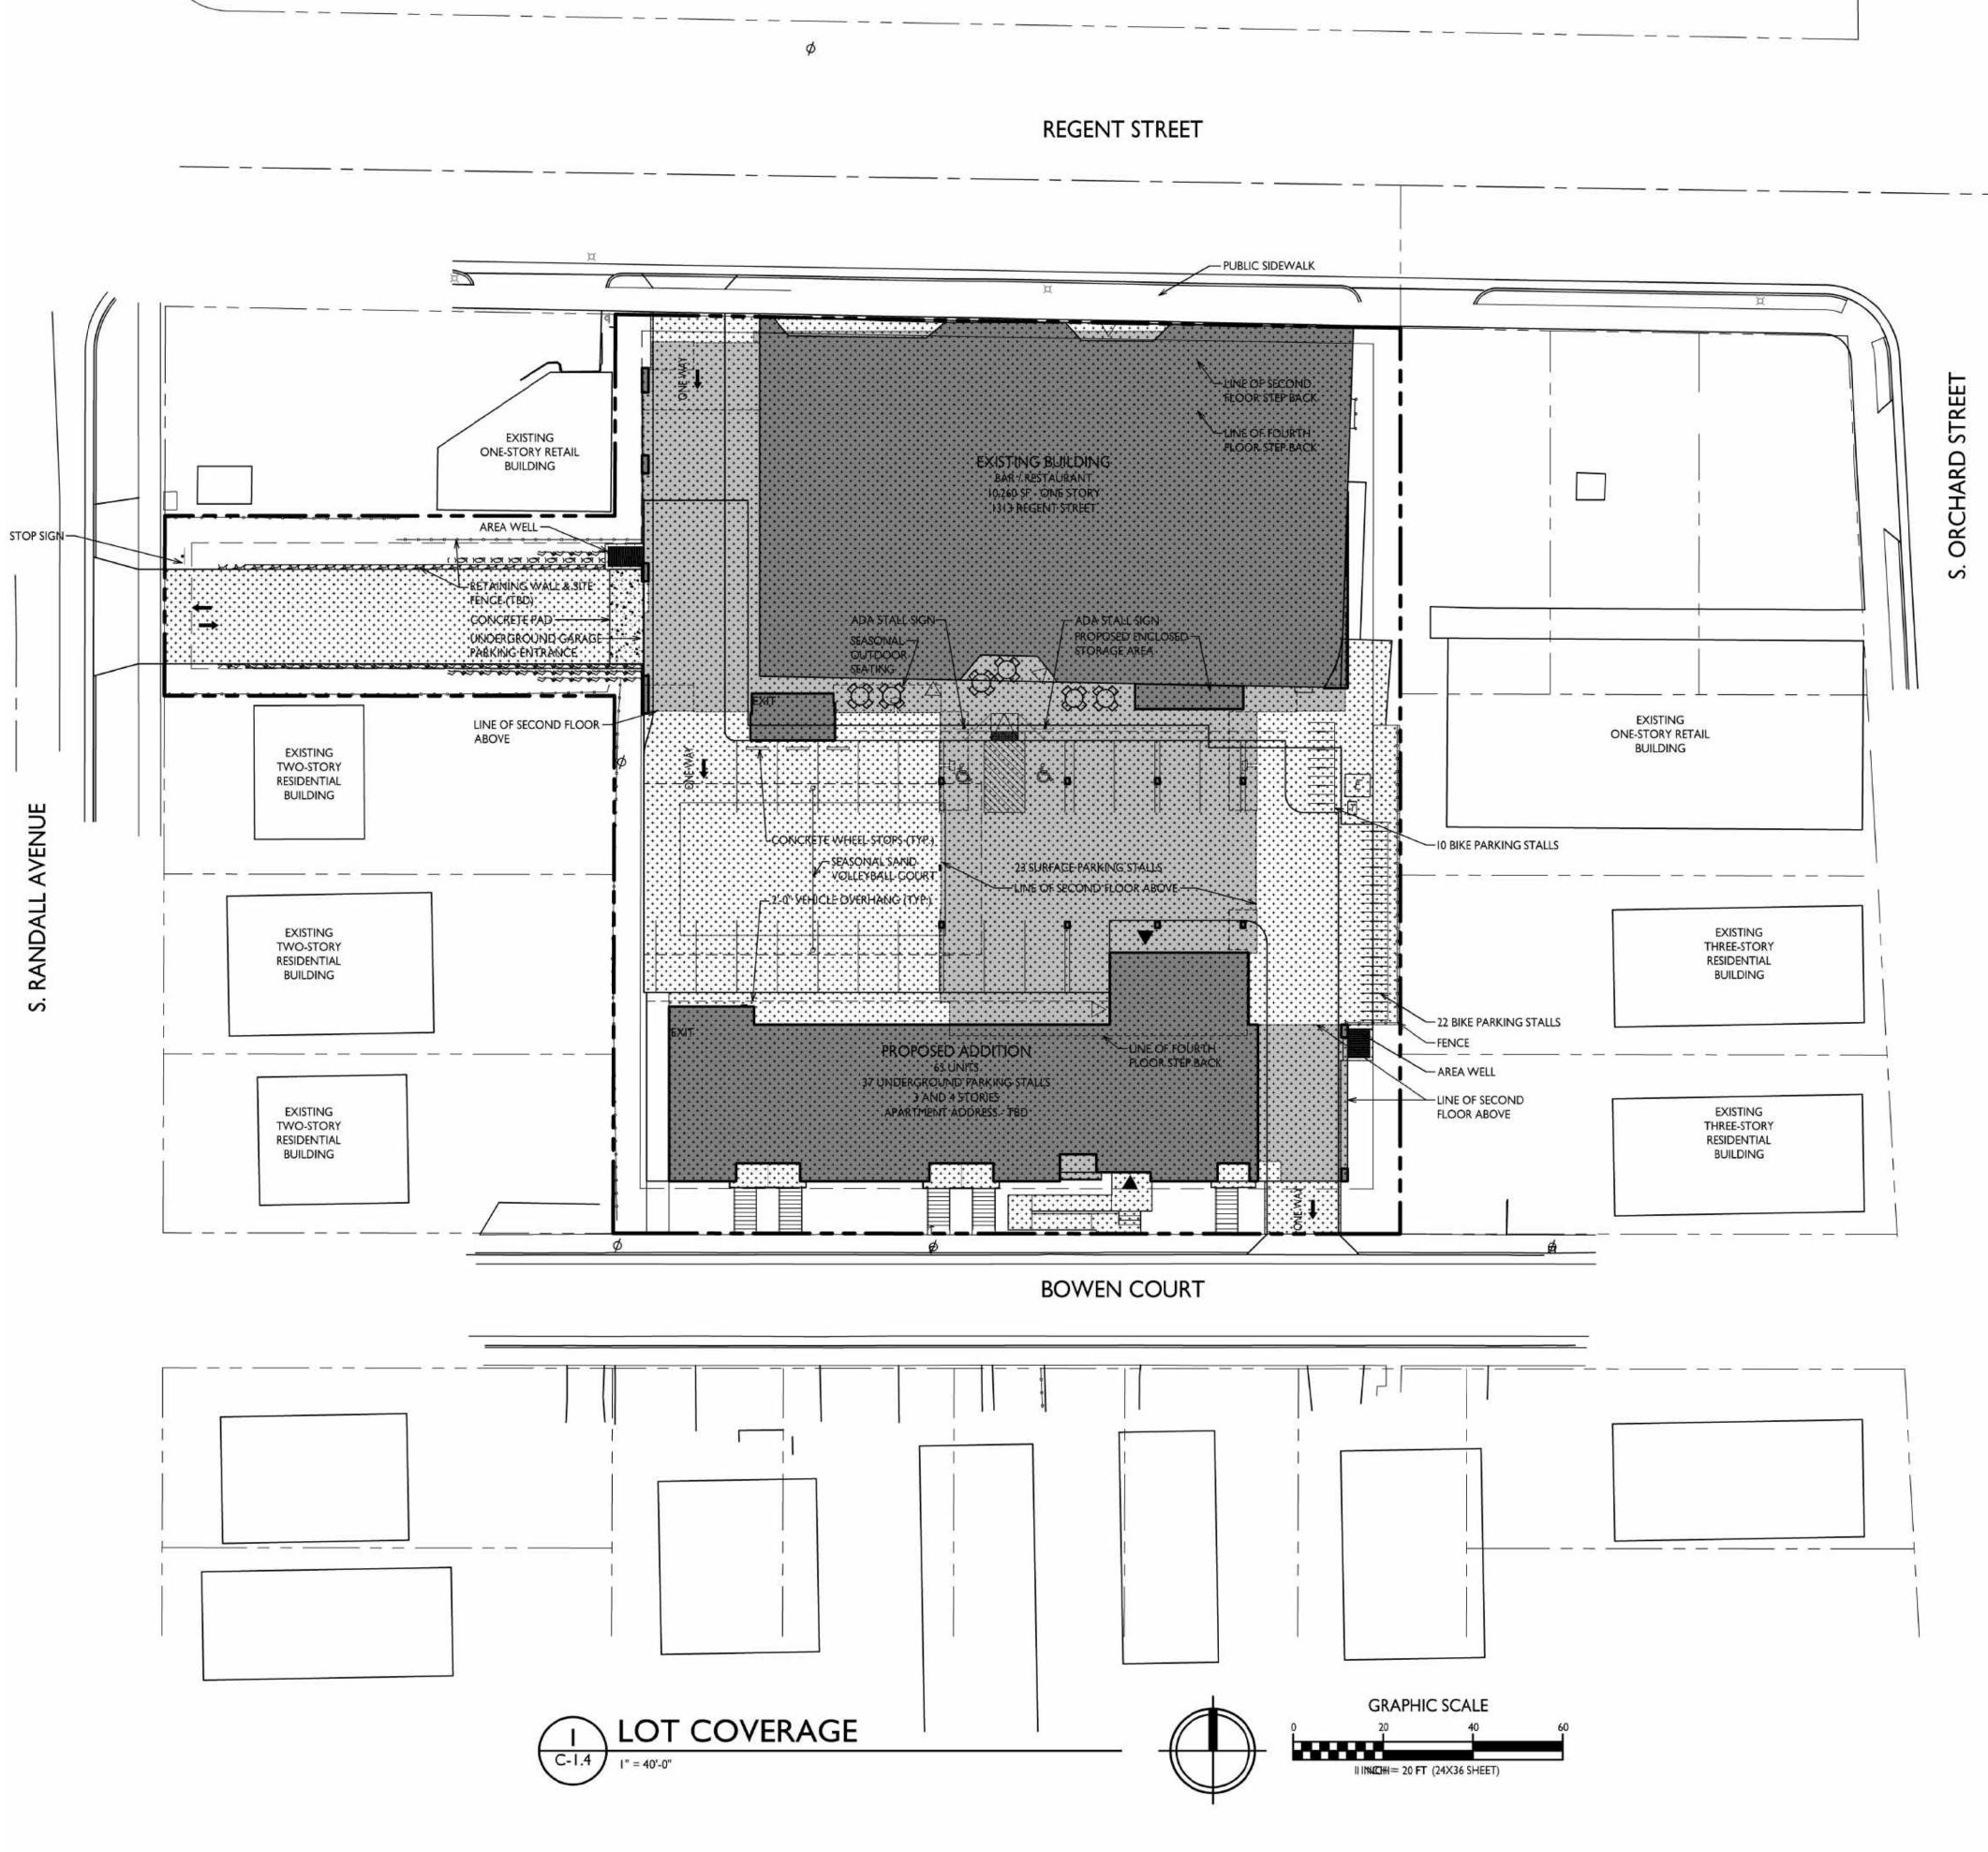

ISSUED Issued for Land Use Submittal - July 29, 2020

PROJECT TITLE Lucky's 1313 Expansion


1313 Regent Street Madison, Wisconsin SHEET TITLE Lot Coverage

SHEET NUMBER



PROJECT NO. 1916 © Knothe & Bruce Architects, LLC

LOT COVERAGE

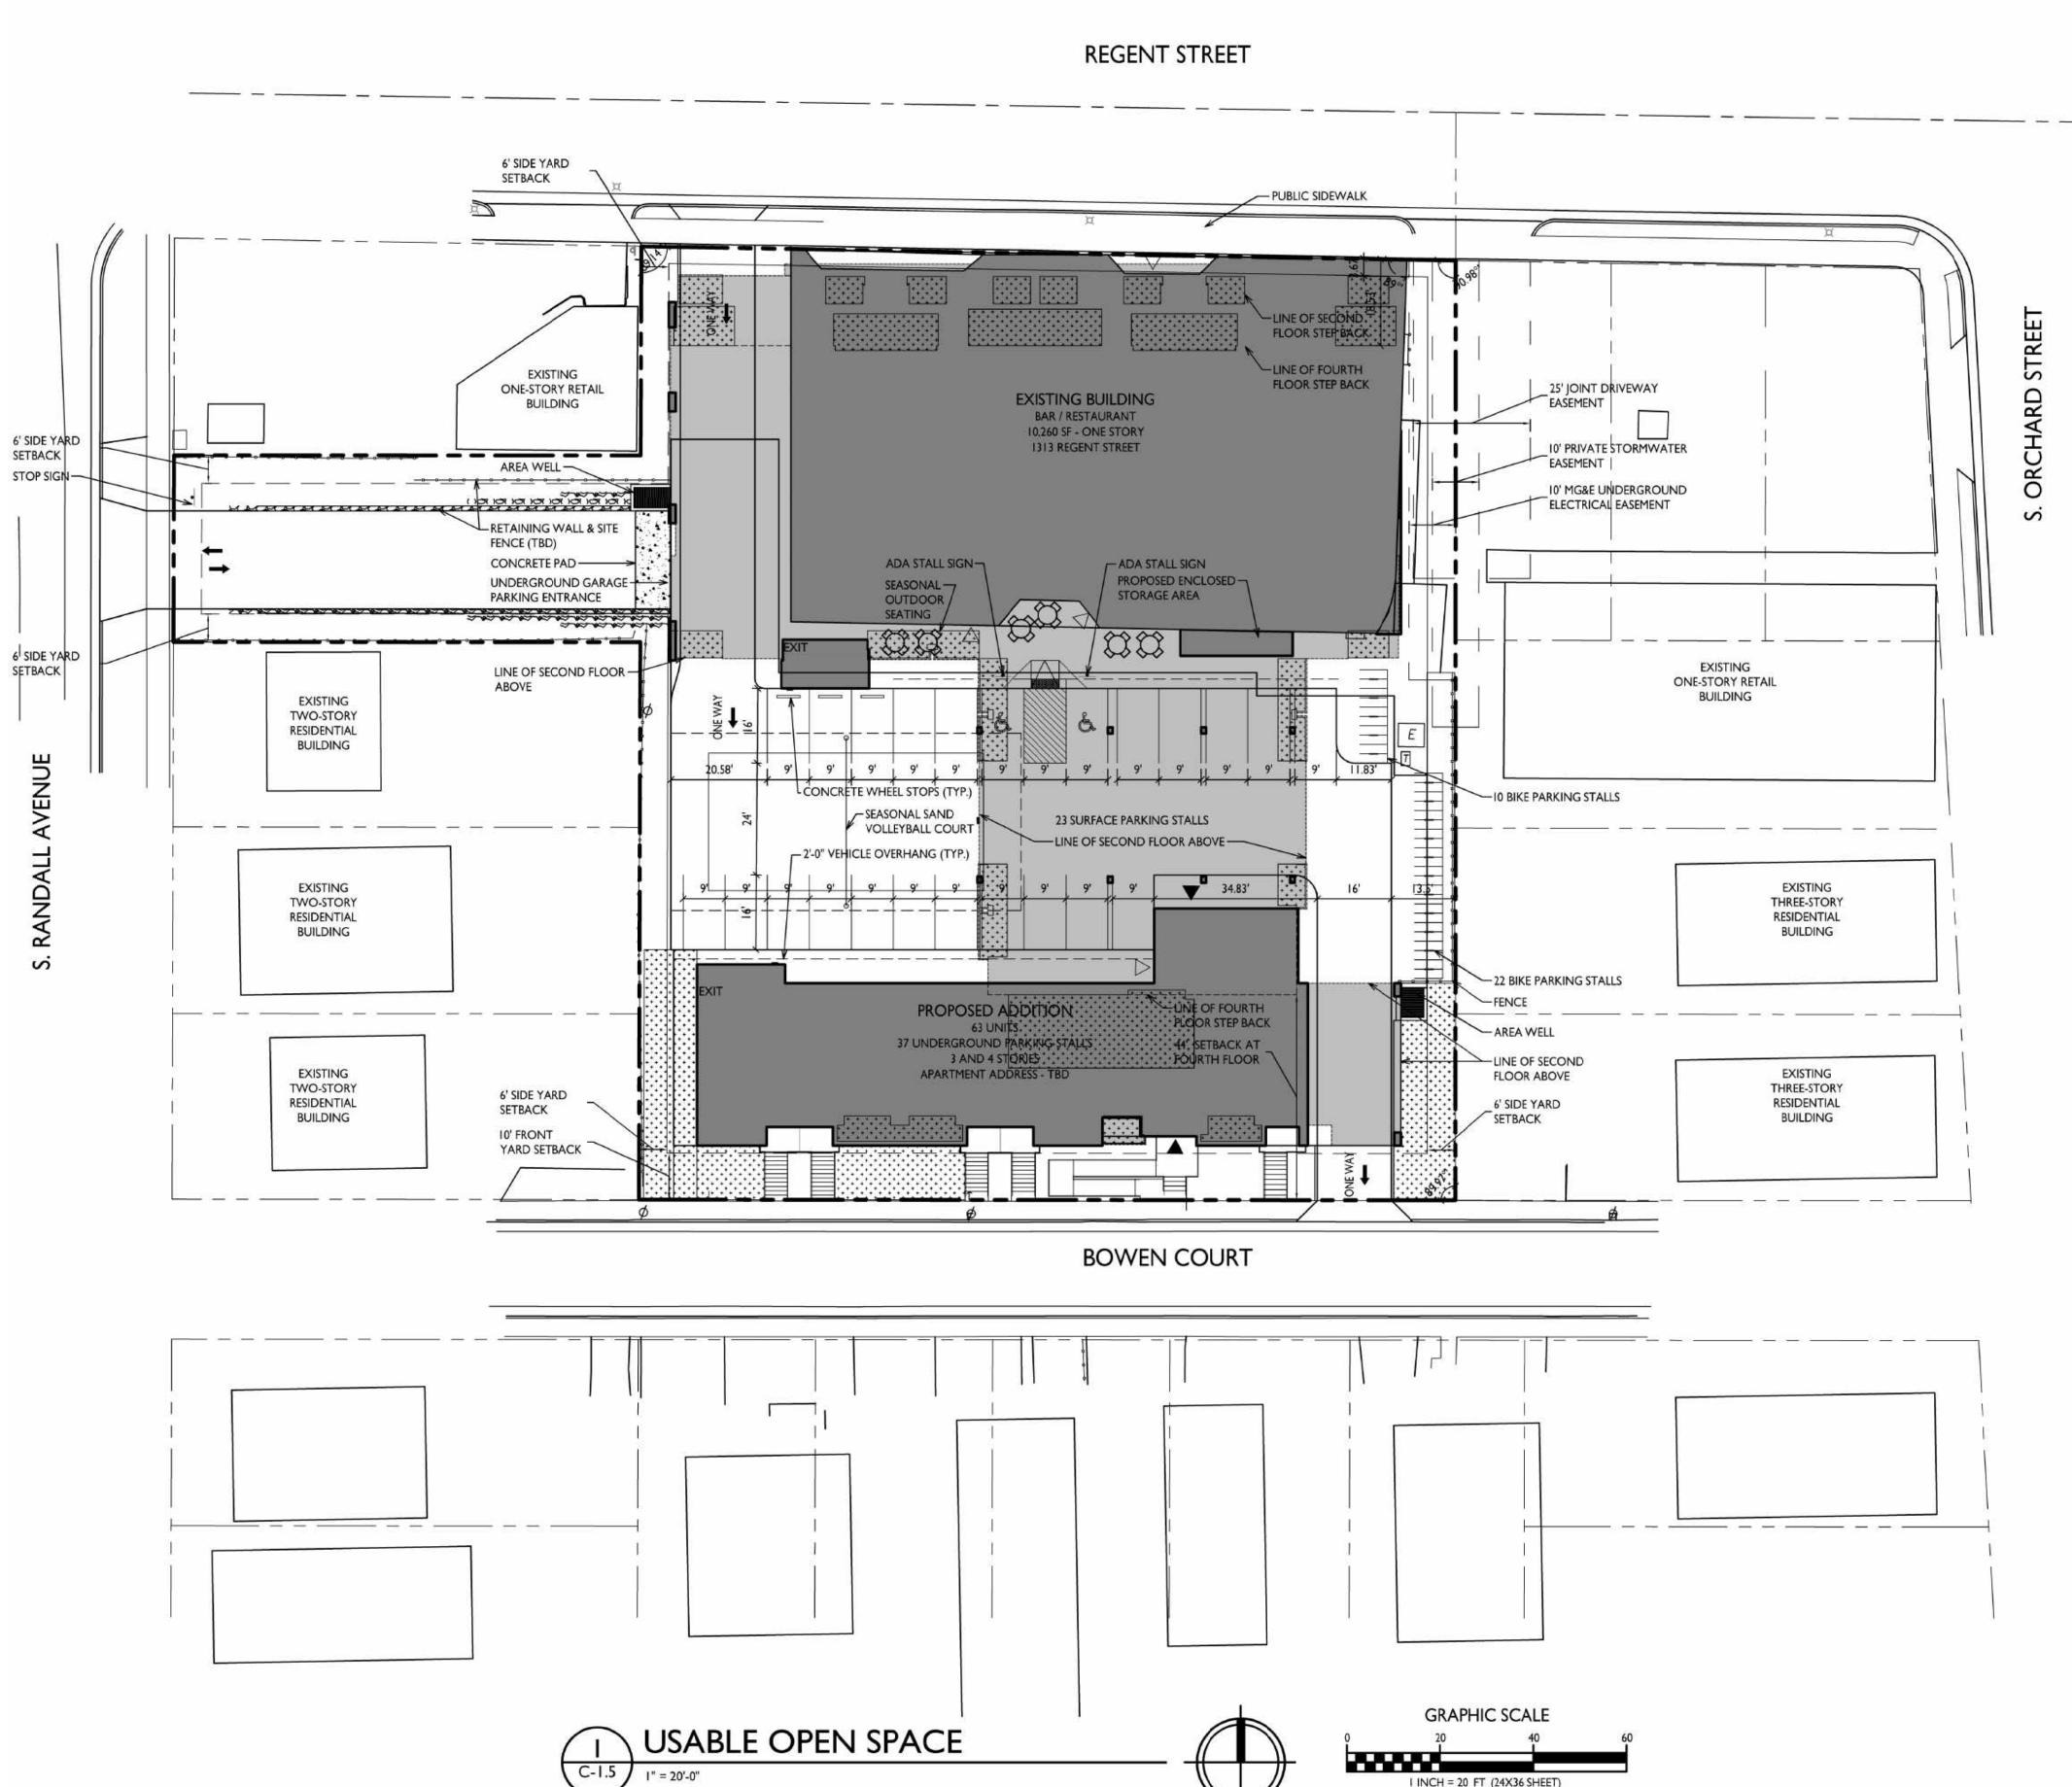ZONING: TSS MAXIMUM LOT COVERAGE: 85% LOT AREA: 39,464 S.F. PROPOSED COVERAGE: 33,519 S.F. / 85% 

I INCH = 20 FT (24X36 SHEET)



USABLE OPEN SPACE


ZONING: TSS REQUIRED OPEN SPACE: 40 S.F. / D.U. **DWELLING UNITS: 63** 40 X 63 = 2,520 S.F. OPEN SPACE REQUIRED OPEN SPACE PROVIDED: ROOF DECK: 636 S.F. PRIVATE BALCONIES: 3,817 S.F. SURFACE: 1,616 S.F. TOTAL: 6,069 S.F.


ISSUED Issued for Land Use Submittal - July 29, 2020


PROJECT TITLE Lucky's 1313 Expansion


1313 Regent Street Madison, Wisconsin SHEET TITLE Usable Open Space



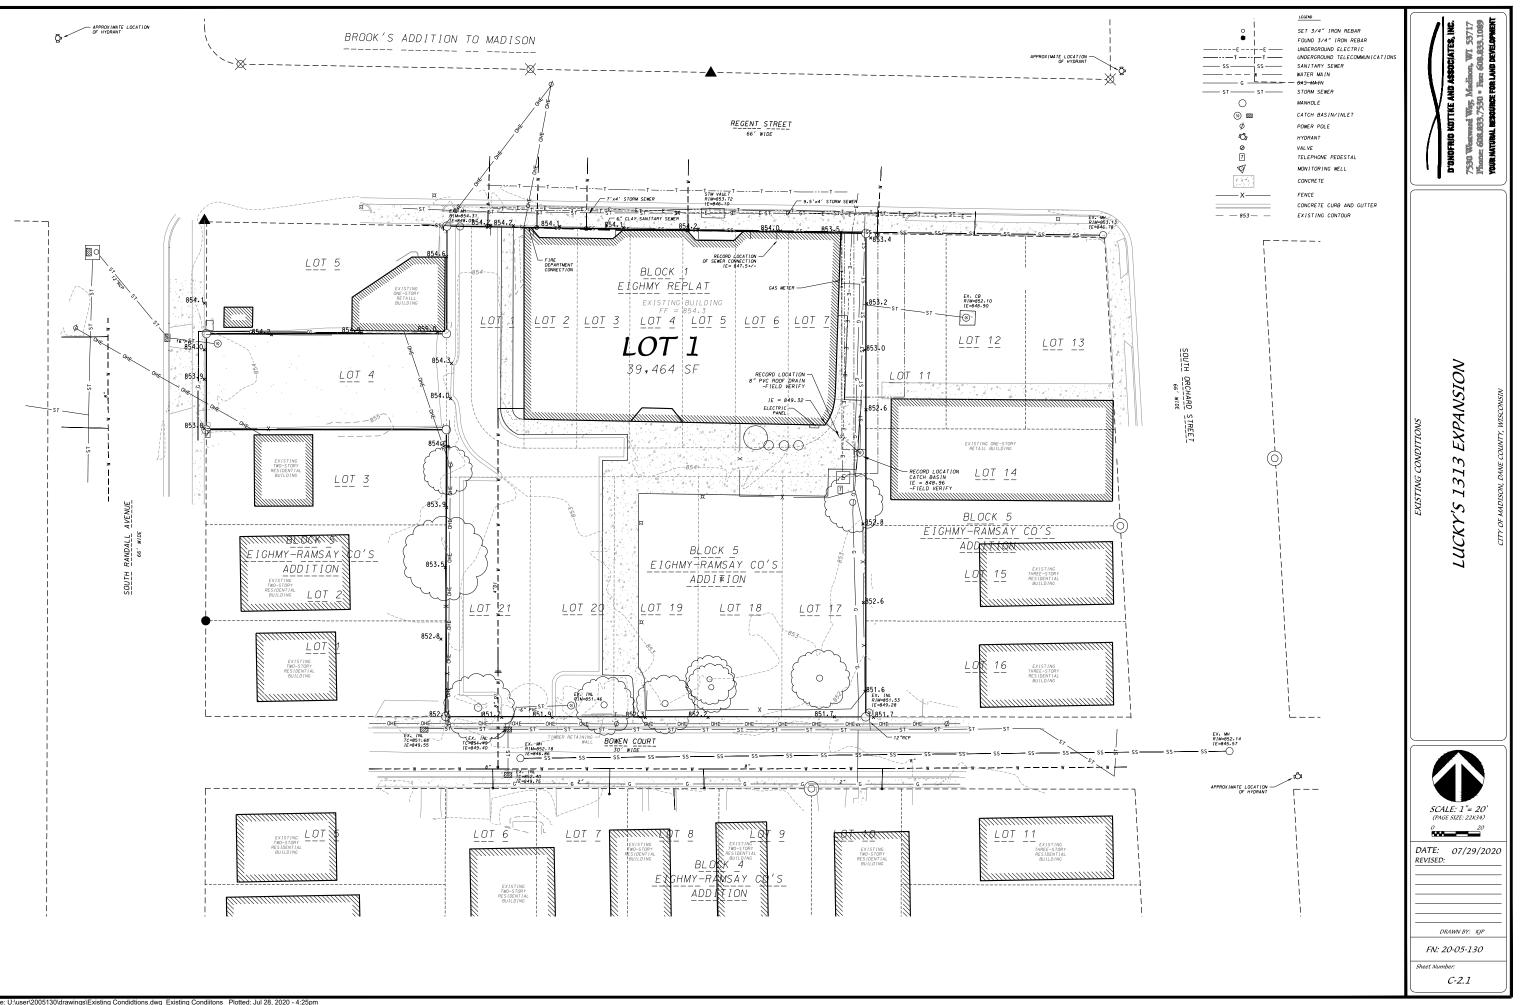

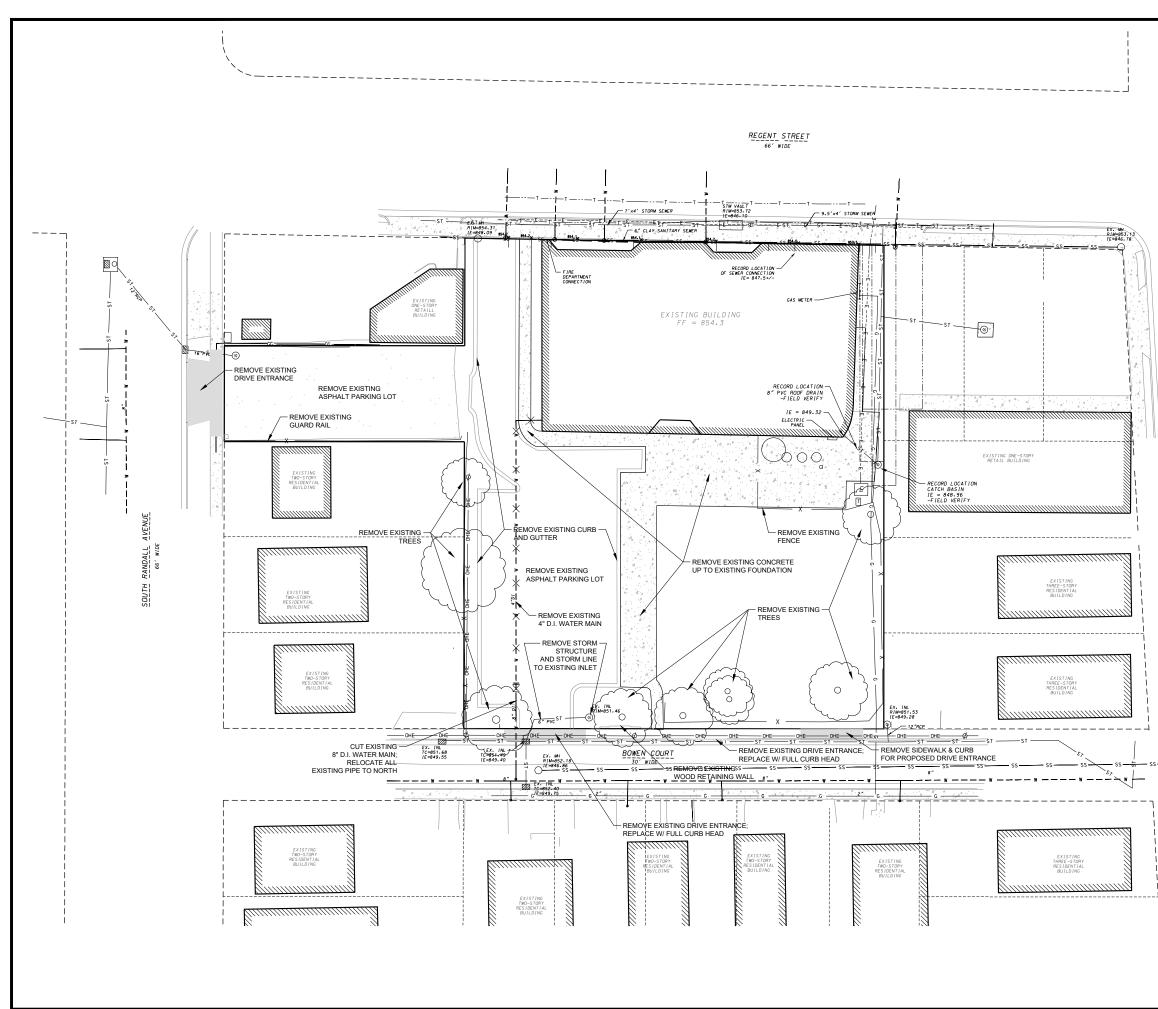

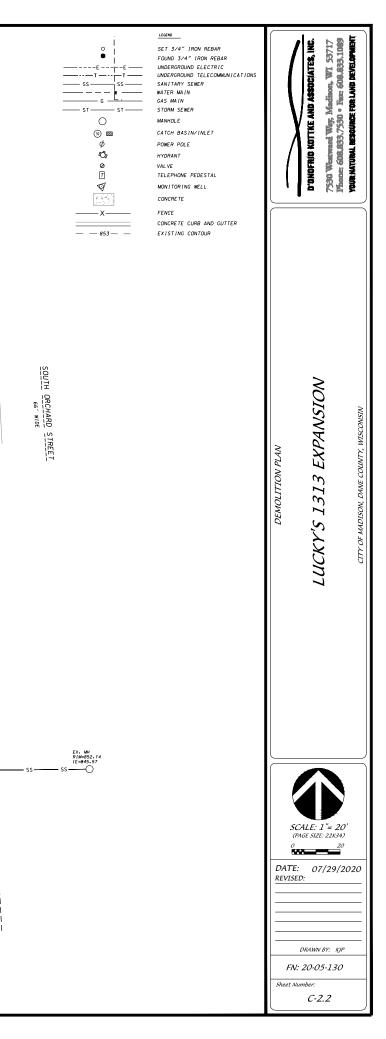

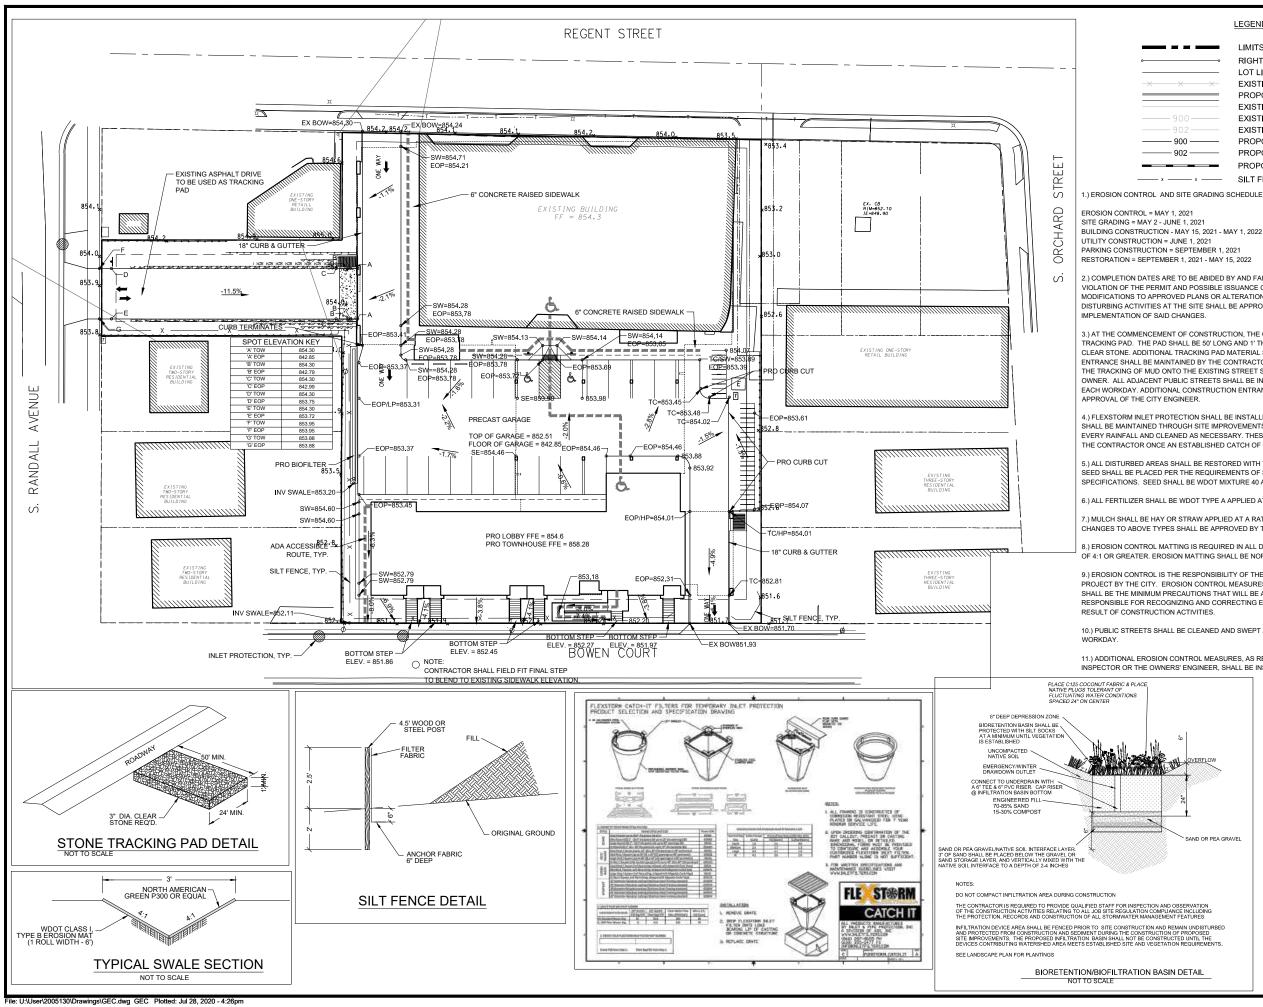

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	— 900 —	
	— 902 —	

LIMITS OF DISTURBANCE RIGHT-OF-WAY LOT LINE EXISTING FENCE PROPOSED CONCRETE CURB & GUTTER EXISTING PAVEMENT EXISTING INDEX CONTOUR EXISTING INTERMEDIATE CONTOUR PROPOSED INDEX CONTOUR PROPOSED INTERMEDIATE CONTOUR PROPOSED STORM SEWER SILT FENCE

2.) COMPLETION DATES ARE TO BE ABIDED BY AND FAILURE TO MEET DEADLINES CONSTITUTES A VIOLATION OF THE PERMIT AND POSSIBLE ISSUANCE OF A STOP WORK ORDER. ANY PROPOSED MODIFICATIONS TO APPROVED PLANS OR ALTERATIONS TO ACCEPTED SEQUENCING OF LAND DISTURBING ACTIVITIES AT THE SITE SHALL BE APPROVED BY THE CITY ENGINEER PRIOR TO

3.) AT THE COMMENCEMENT OF CONSTRUCTION, THE CONTRACTOR SHALL INSTALL THE TRACKING PAD. THE PAD SHALL BE 50' LONG AND 1' THICK, CONSTRUCTED WITH A MINIMUM 3" CLEAR STONE. ADDITIONAL TRACKING PAD MATERIAL SHALL BE INSTALLED AS NEEDED AND THE ENTRANCE SHALL BE MAINTAINED BY THE CONTRACTOR IN A CONDITION THAT WILL PREVENT THE TRACKING OF MUD ONTO THE EXISTING STREET SURFACES AT NO ADDITIONAL COST TO THE OWNER. ALL ADJACENT PUBLIC STREETS SHALL BE INSPECTED AND CLEANED AT THE END OF EACH WORKDAY, ADDITIONAL CONSTRUCTION ENTRANCES MAY BE ALLOWED WITH THE

4.) FLEXSTORM INLET PROTECTION SHALL BE INSTALLED IN ALL STORM INLETS SHOWN AND SHALL BE MAINTAINED THROUGH SITE IMPROVEMENTS. THE FILTER SHALL BE INSPECTED AFTER EVERY RAINFALL AND CLEANED AS NECESSARY. THESE PROTECTIONS SHALL BE REMOVED BY THE CONTRACTOR ONCE AN ESTABLISHED CATCH OF GRASS HAS GROWN IN THE TERRACES.

EXPANSION

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131.

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LUCKY

SCALE: 1"= 20

(PAGE SIZE: 22X34)

DATE: 07/29/2020

DRAWN BY: KIP

C-2.3

FN: 20-05-130

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REVISED:

5.) ALL DISTURBED AREAS SHALL BE RESTORED WITH TOPSOIL. SEED, FERTILIZER, AND MULCH SEED SHALL BE PLACED PER THE REQUIREMENTS OF SECTION 630 IN THE WDOT STANDARD SPECIFICATIONS. SEED SHALL BE WDOT MIXTURE 40 APPLIED AT 2 POUNDS PER 1000 SQUARE

6.) ALL FERTILIZER SHALL BE WDOT TYPE A APPLIED AT 7 POUNDS PER 1000 SQUARE FEET.

7.) MULCH SHALL BE HAY OR STRAW APPLIED AT A RATE OF 2 TONS PER ACRE DISCED IN PLACE. CHANGES TO ABOVE TYPES SHALL BE APPROVED BY THE ENGINEER.

8.) EROSION CONTROL MATTING IS REQUIRED IN ALL DRAINAGEWAYS AND AREAS WITH A SLOPE OF 4:1 OR GREATER. EROSION MATTING SHALL BE NORTH AMERICAN GREEN S150 OR EQUAL.


9.) EROSION CONTROL IS THE RESPONSIBILITY OF THE CONTRACTOR UNTIL ACCEPTANCE OF THIS PROJECT BY THE CITY. EROSION CONTROL MEASURES AS SHOWN ON THE APPROVED PLAN SHALL BE THE MINIMUM PRECAUTIONS THAT WILL BE ALLOWED. THE CONTRACTOR SHALL BE RESPONSIBLE FOR RECOGNIZING AND CORRECTING EROSION CONTROL PROBLEMS THAT ARE A


10.) PUBLIC STREETS SHALL BE CLEANED AND SWEPT AS NECESSARY AT THE END OF EACH

11.) ADDITIONAL EROSION CONTROL MEASURES, AS REQUESTED IN WRITING BY THE CITY INSPECTOR OR THE OWNERS' ENGINEER, SHALL BE INSTALLED WITHIN 24 HOURS.

NOTE:

BOW = BACK OF WALK EOP = EDGE OF PAVEMENT TC = TOP, BACK OF CURB TOW = TOP, BACK OF WALL SW = SIDEWALK

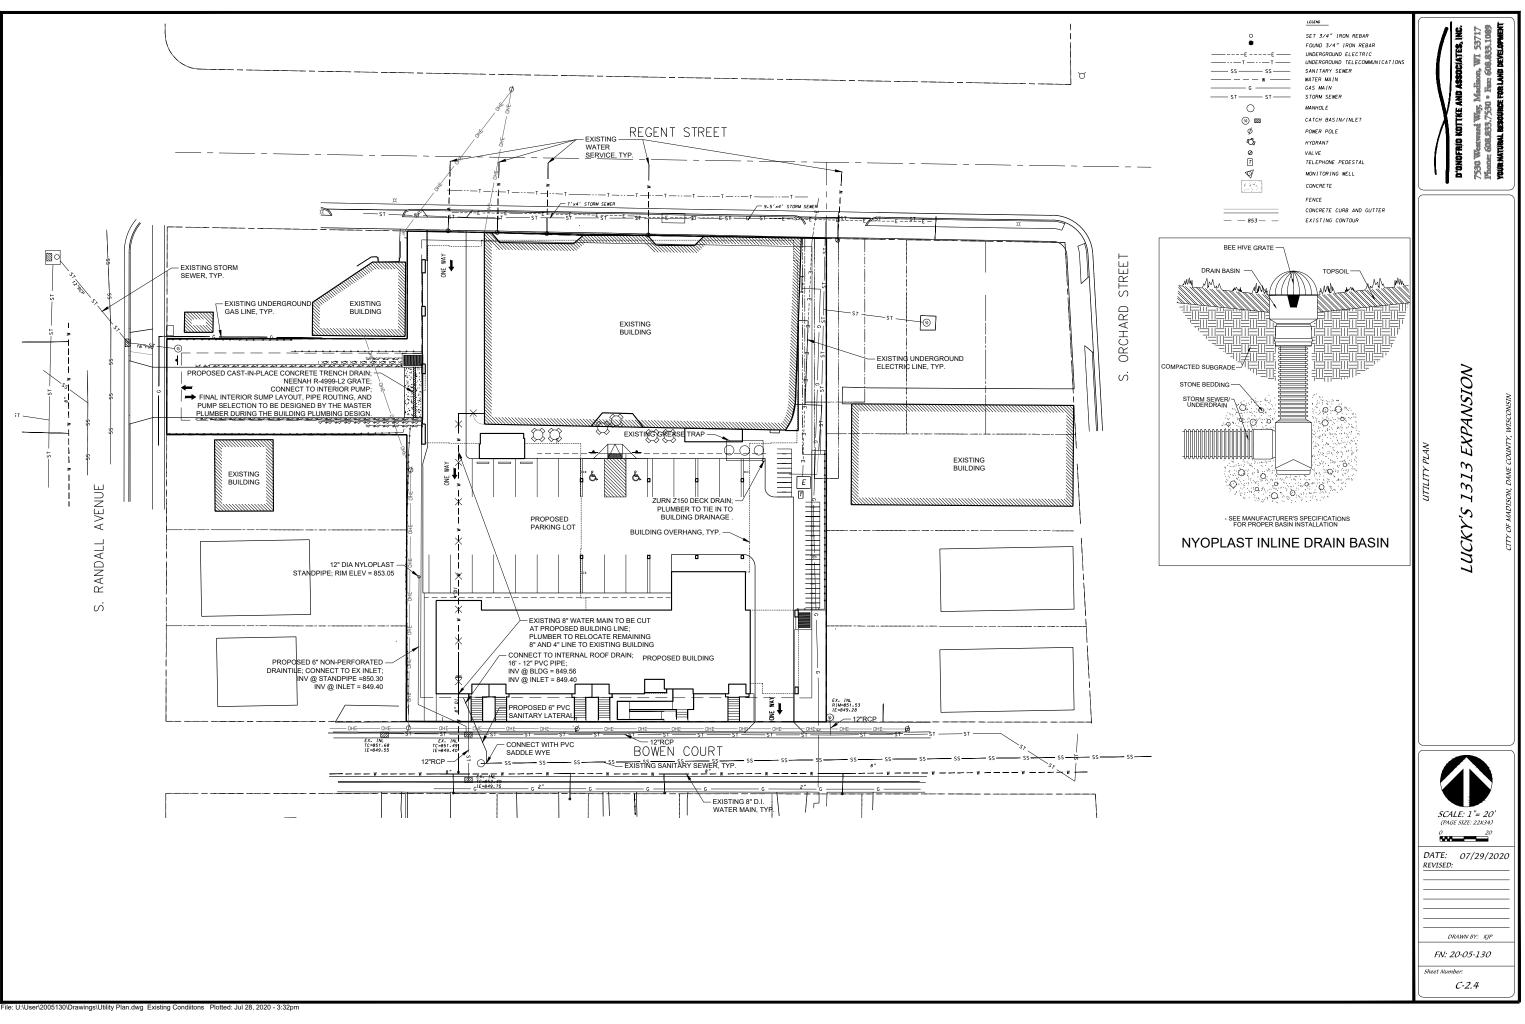

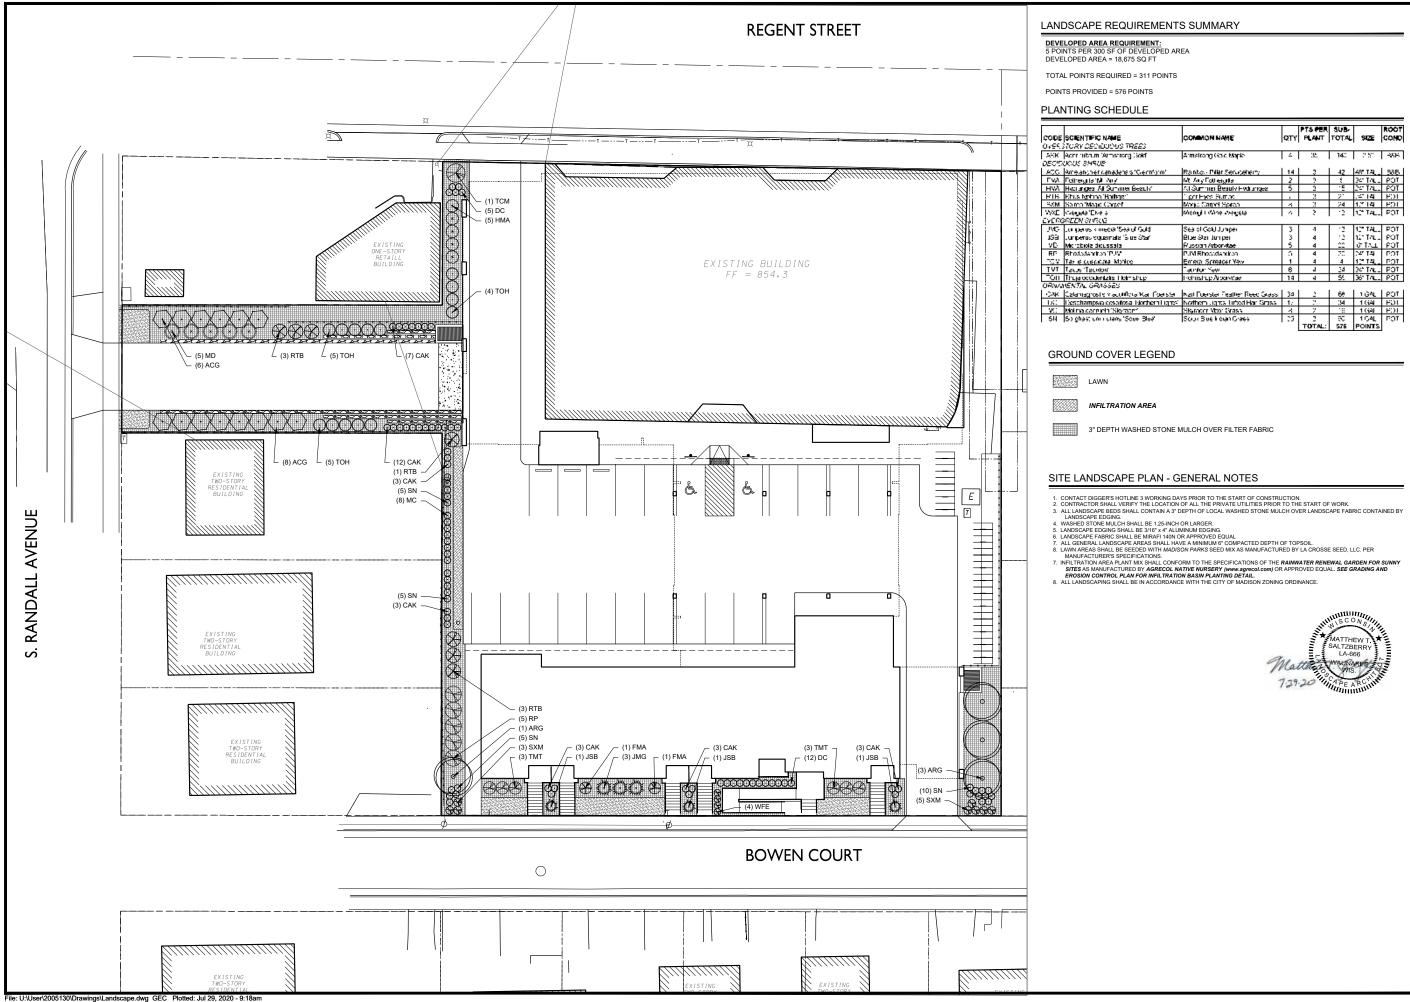

LANDSCAPE REQUIREMENTS SUMMARY

			PTS PER			ROOT
	COMMON NAME	QTY	PLANT	TOTAL.	902E	COND
REE3		-			-	-
g Ciolof	Armstrong Gold Maple	- ⁻	32.	140	2.57	-35E
-						
s'Gentomi	Rainto - Pilar Serviceherry	14	3	42	481 14	385
	Mt. Any Folliesgale	2	,	٤	241 TAUL	POT
(Beauly)	At Summer Beauty Hydrangee	5	2	÷E	241 TALL	FOT
	1 get Eyes Sumat	•	3	21	.414	FOL
	Maga Capel Sprea	4	2	24	1.114	FO1
	Monghi Mine Weigela	4	<i></i>	÷.	10° TALE	POT
		-			-	
NUT GUIS	Sea of Gold Juniper	3	-1	÷	10" TALL	POT
ue Star	Blue Star Juniper	3	4	12	117 TOLL	POT
	Russian Arborytae	5	4	22	OF TALL	FOT
	PJM Rhosodenskop	0	4	75	241.14	POT
ю.	Emeral Spreacer Yew	1	4	4	17174	POT
	Fauntur Yew	6	L	24	24 TAUL	POT
- shup	Fehrishup Arborvitee	14	1	55	361 TALL	POT
оа КанГое се	Nati Fuerster Featter Reed Grass	34	2	68	1 GAL	POT
a Northern Lignes'	Nothern Lighta, Lifted Har, Grasa	17		34	1 (64	FOT
an"	Skynoor Moor Grass	4	- 2	.8	1 (64)	FOL
ču⊳ Bu∛	Soux Bire Ir clan Graee	20	2	50	1.GAL	POT
			TOTAL:	576	POINTS	

3" DEPTH WASHED STONE MULCH OVER FILTER FABRIC


SITE LANDSCAPE PLAN - GENERAL NOTES

I. CONTACT DIGGER'S HOTLINE 3 WORKING DAYS PRIOR TO THE START OF CONSTRUCTION. 2. CONTRACTOR SHALL VERIFY THE LOCATION OF ALL THE PRIVATE UTILITIES PRIOR TO THE START OF WORK.



D'ONOFRIO KOTTKE AND ASSOCIATES, INC.	7530 Wearward Way, Madinon, WI 53717 Phone: 608,833.7530 * Run: 608,833.1089	Your Matural Resource for land development
LANDSCAPE PLAN	LUCKY'S 1313 EXPANSION	CITY OF MADISON, DANE COUNTY, WISCONSIN
REVISED:	их ву: мs 05-130	020



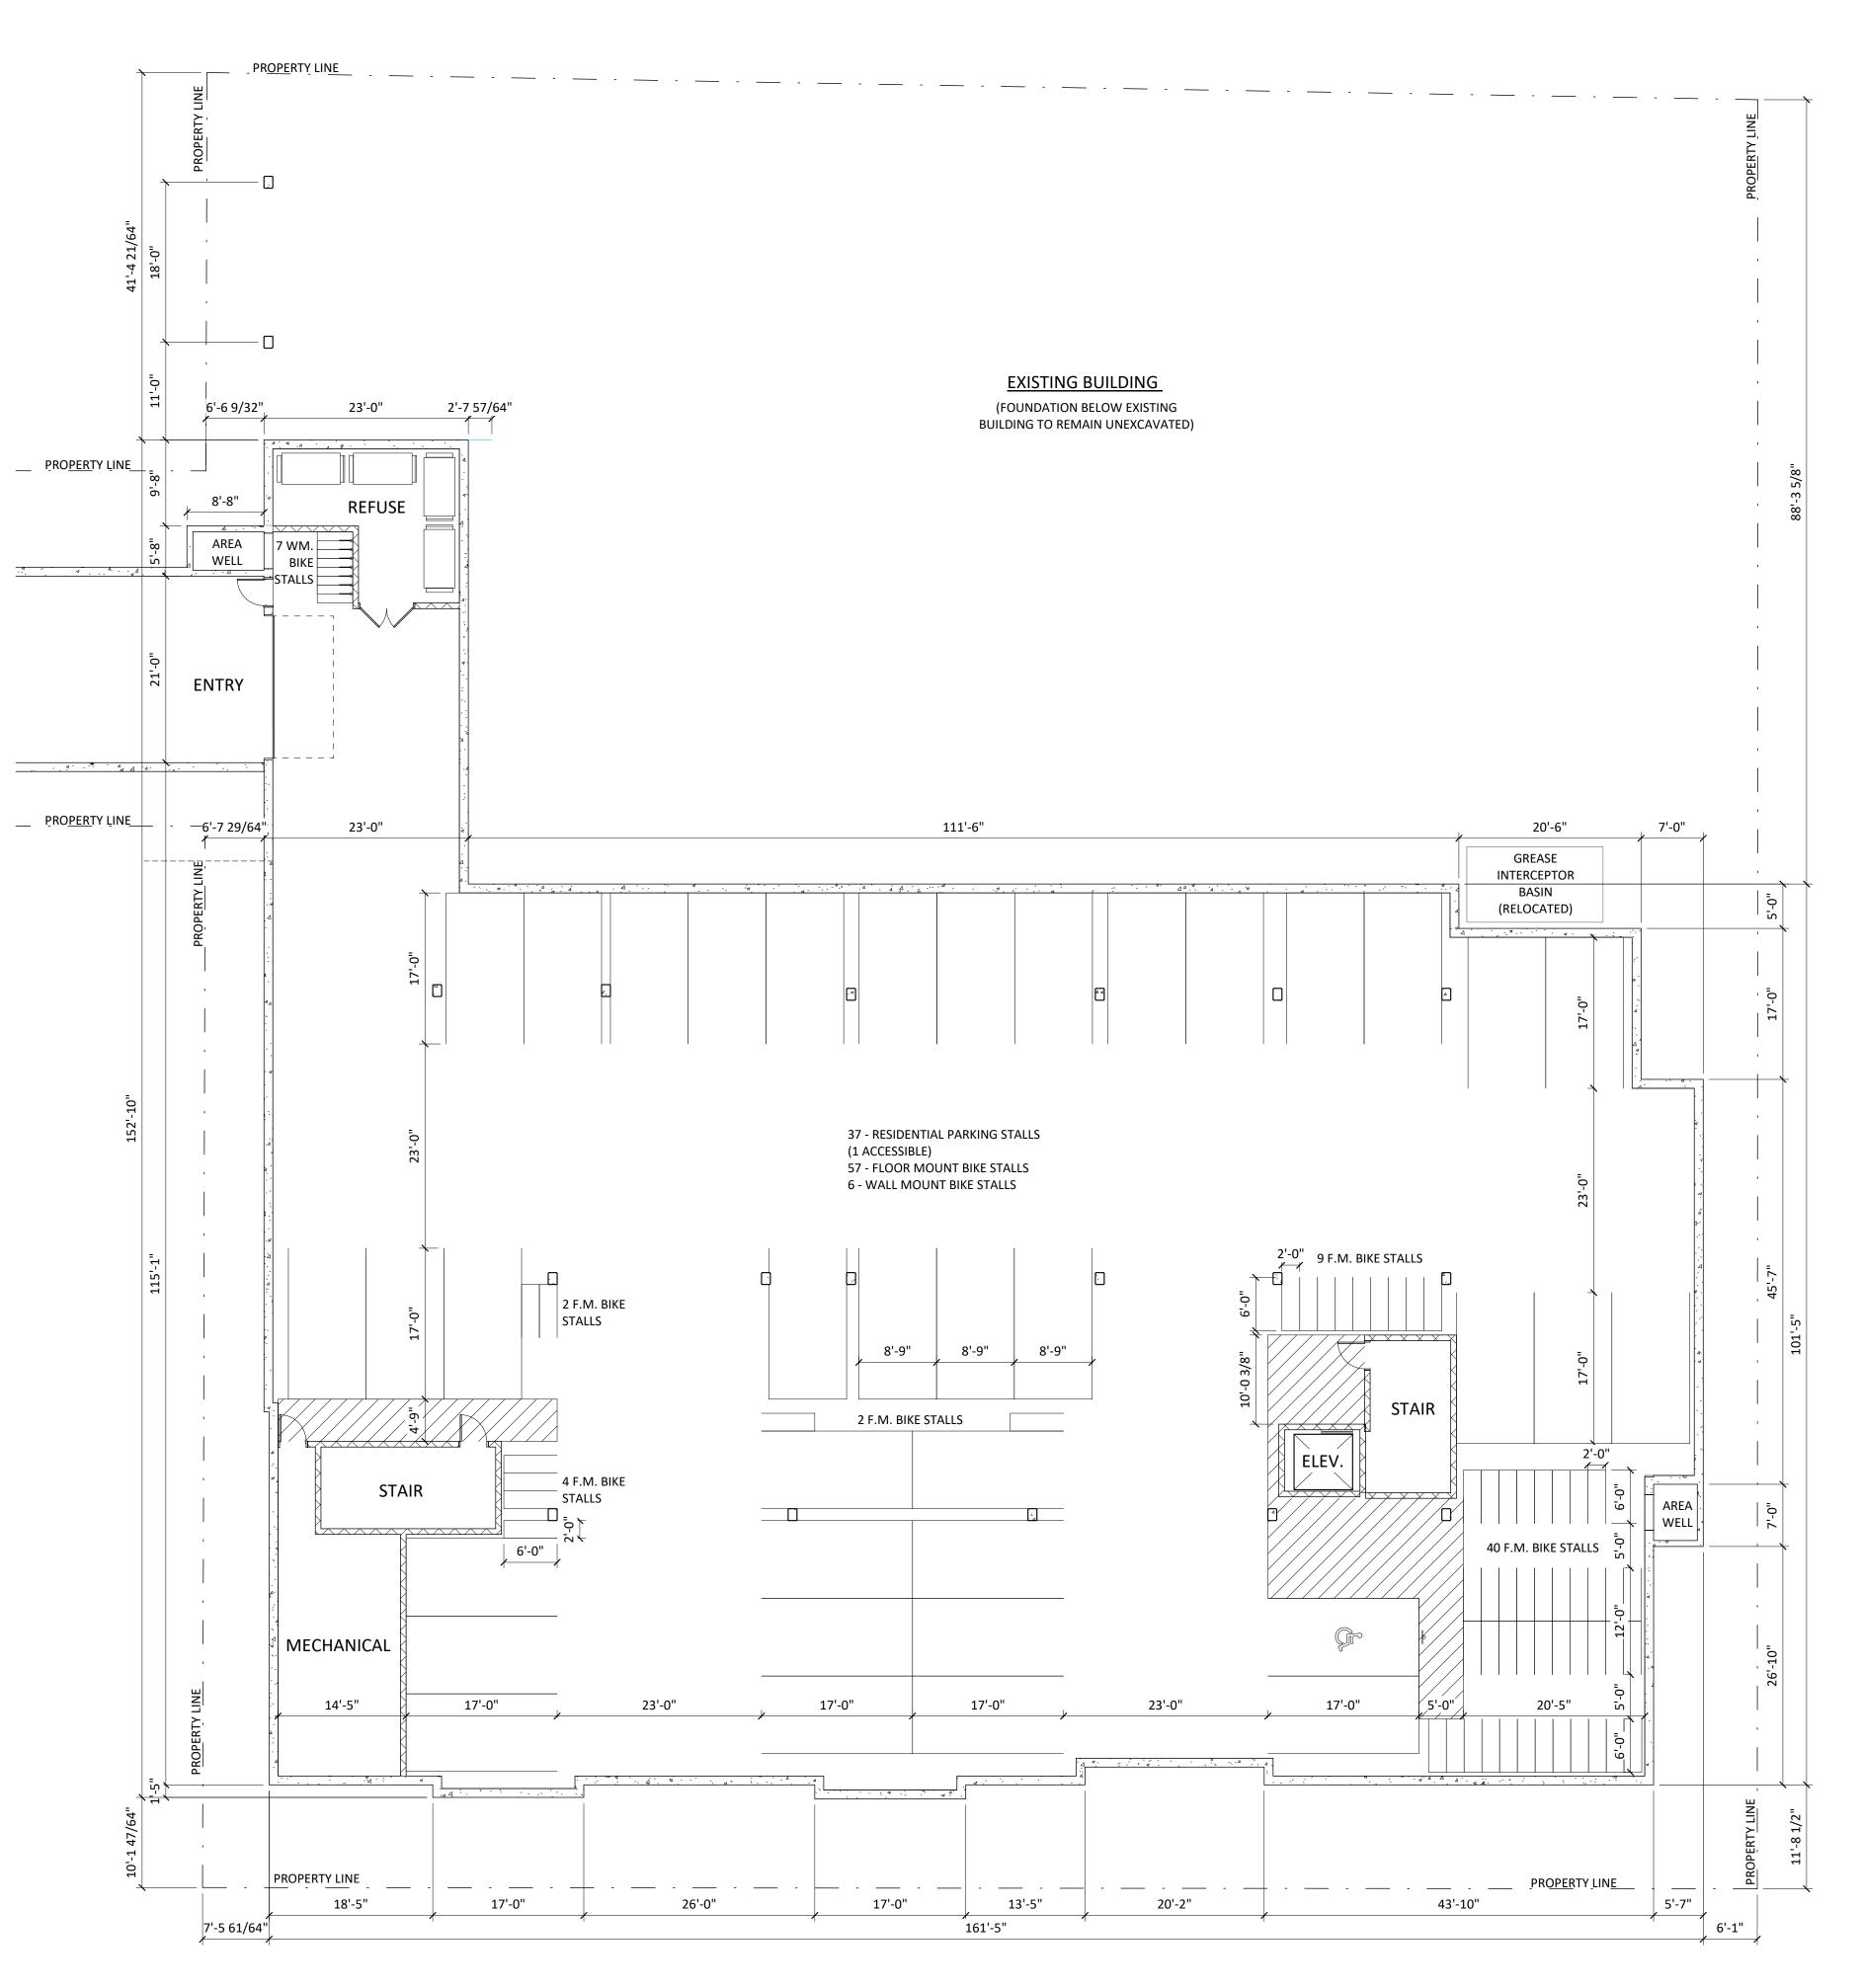



ISSUED Issued for Land Use Submittal - July 29, 2020

PROJECT TITLE LUCKY'S 1313 EXPANSION

1313 REGENT ST. MADISON, WI


SHEET TITLE


BASEMENT

FLOOR PLAN



1 FIRST FLOOR PLAN A-1.1 3/32" = 1'-0"

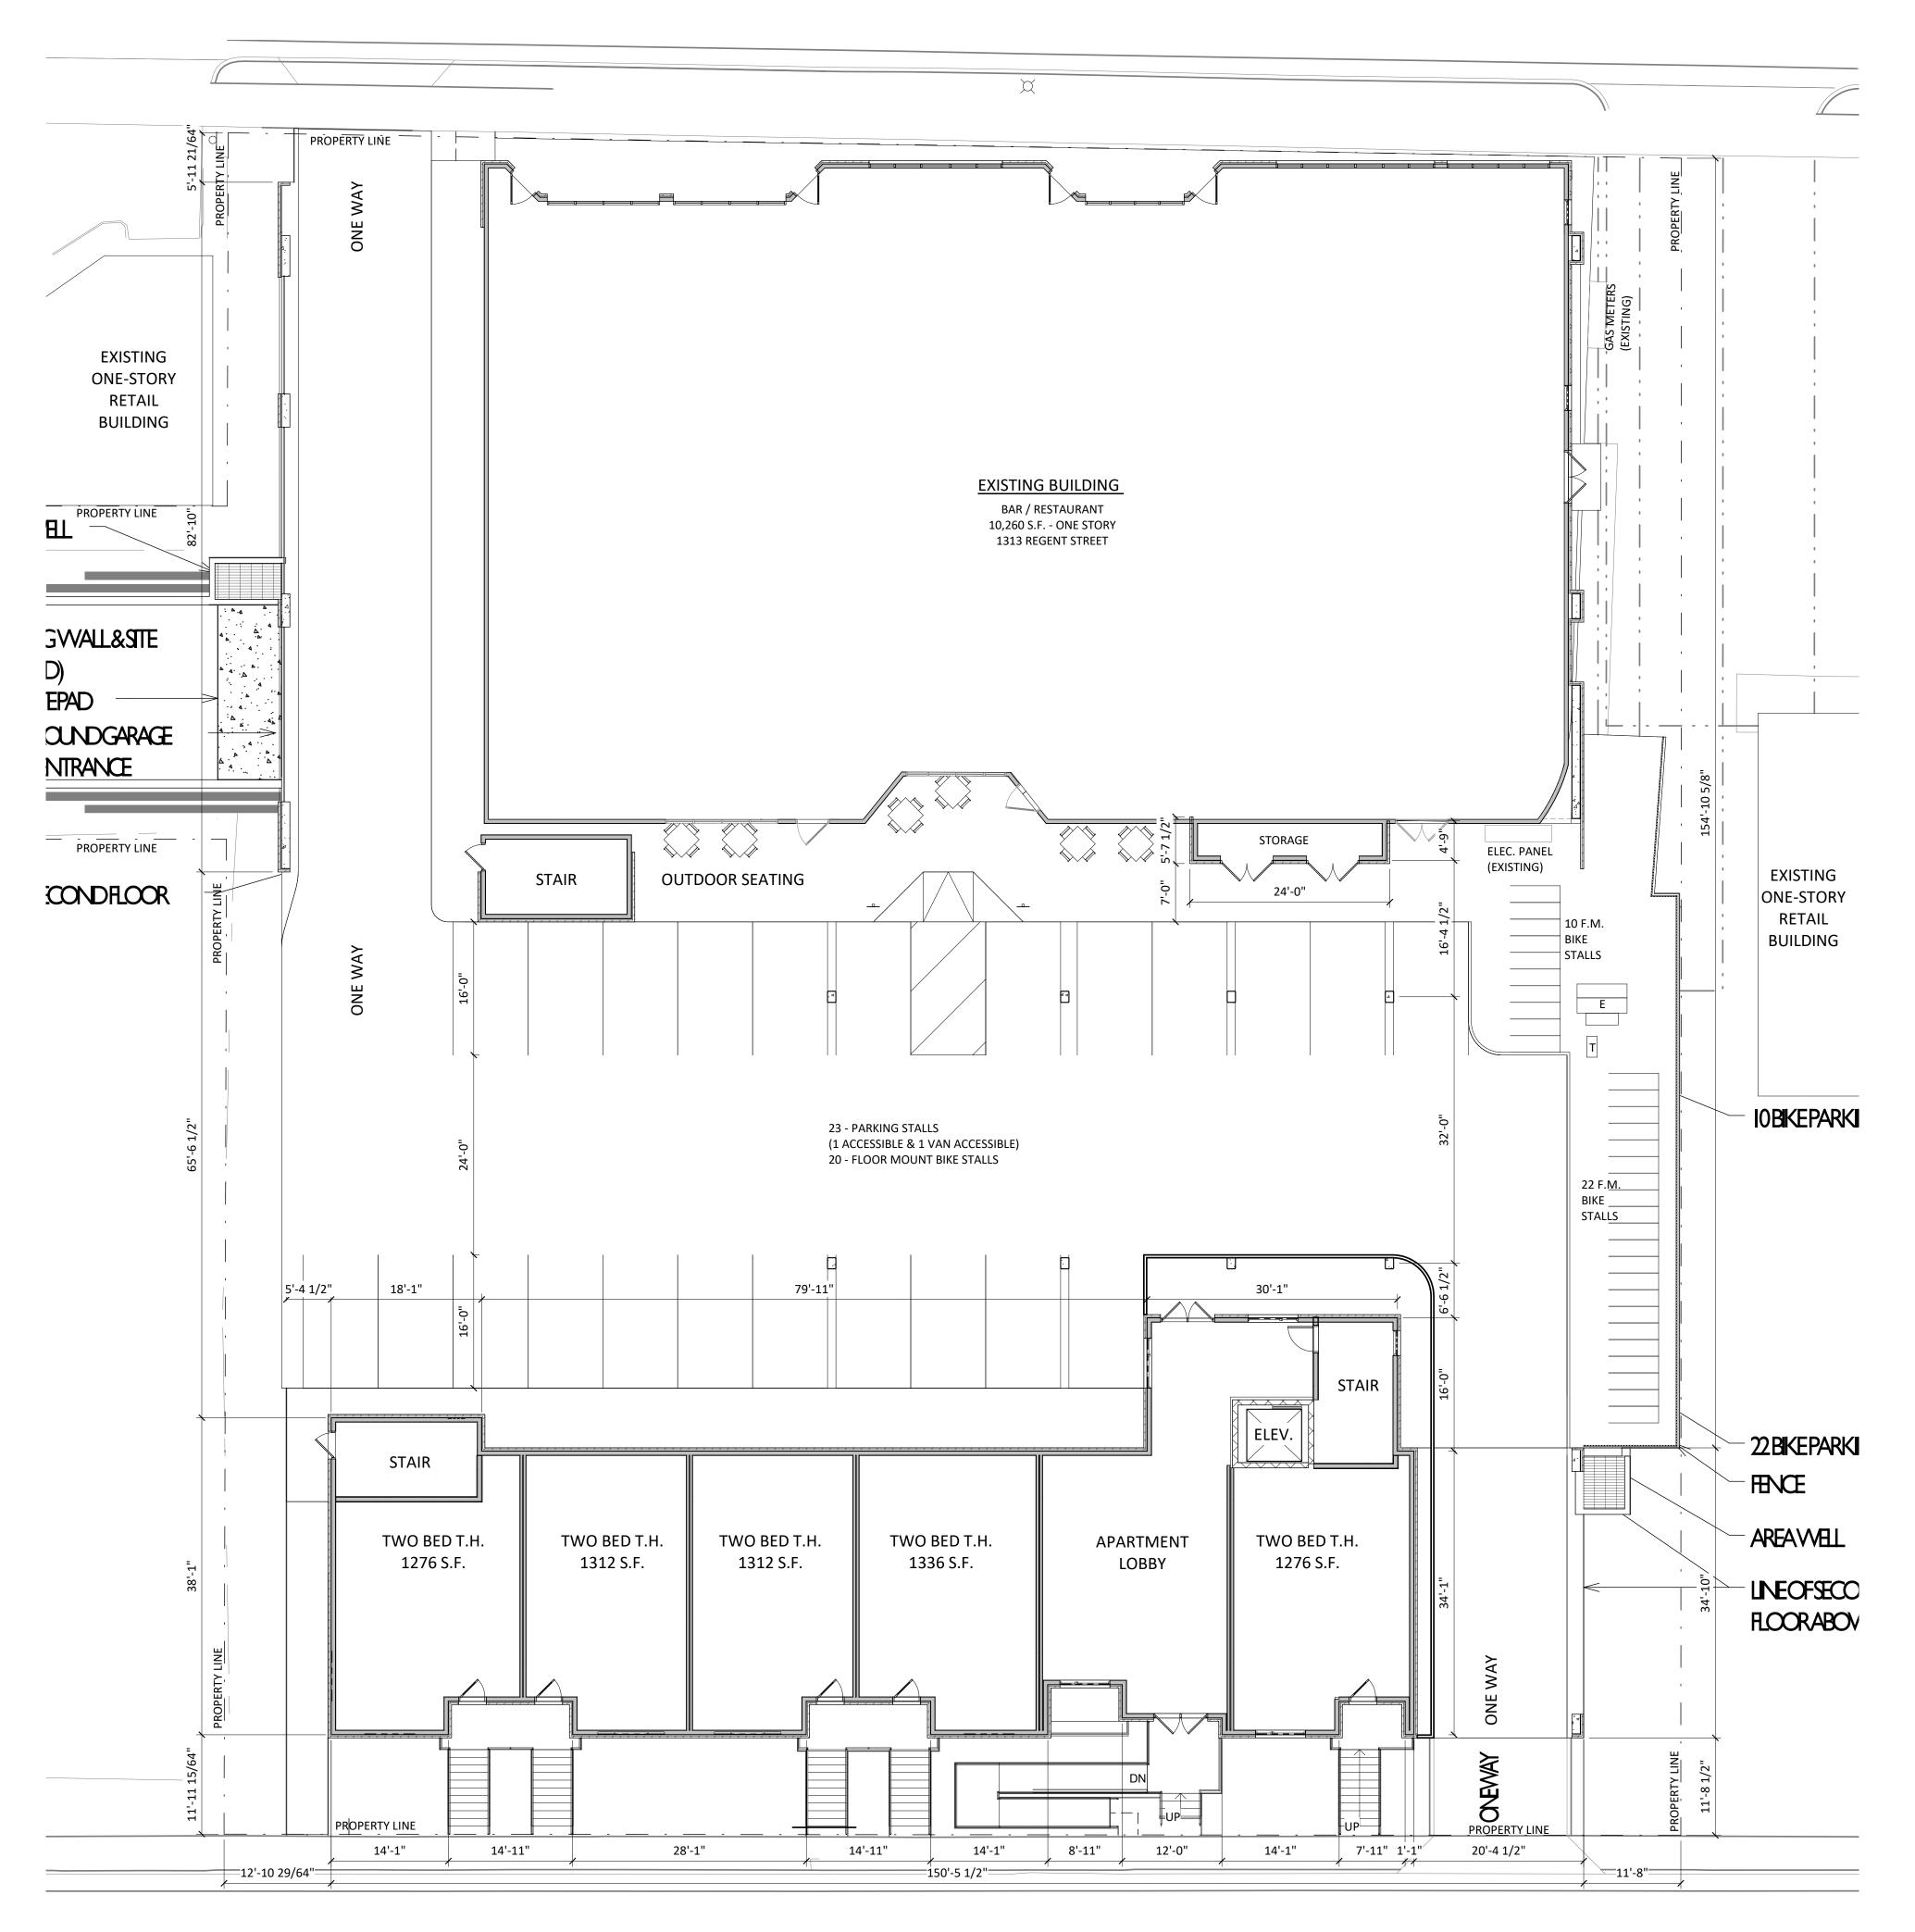

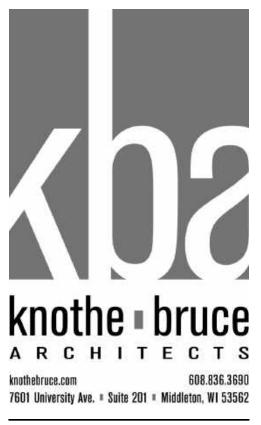

KEY PLAN

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PROJECT TITLE LUCKY'S 1313 EXPANSION


1313 REGENT ST. MADISON, WI

SHEET TITLE FIRST FLOOR

PLAN


SHEET NUMBER

A-1.1 project number 1916 © Knothe & Bruce Architects, LLC

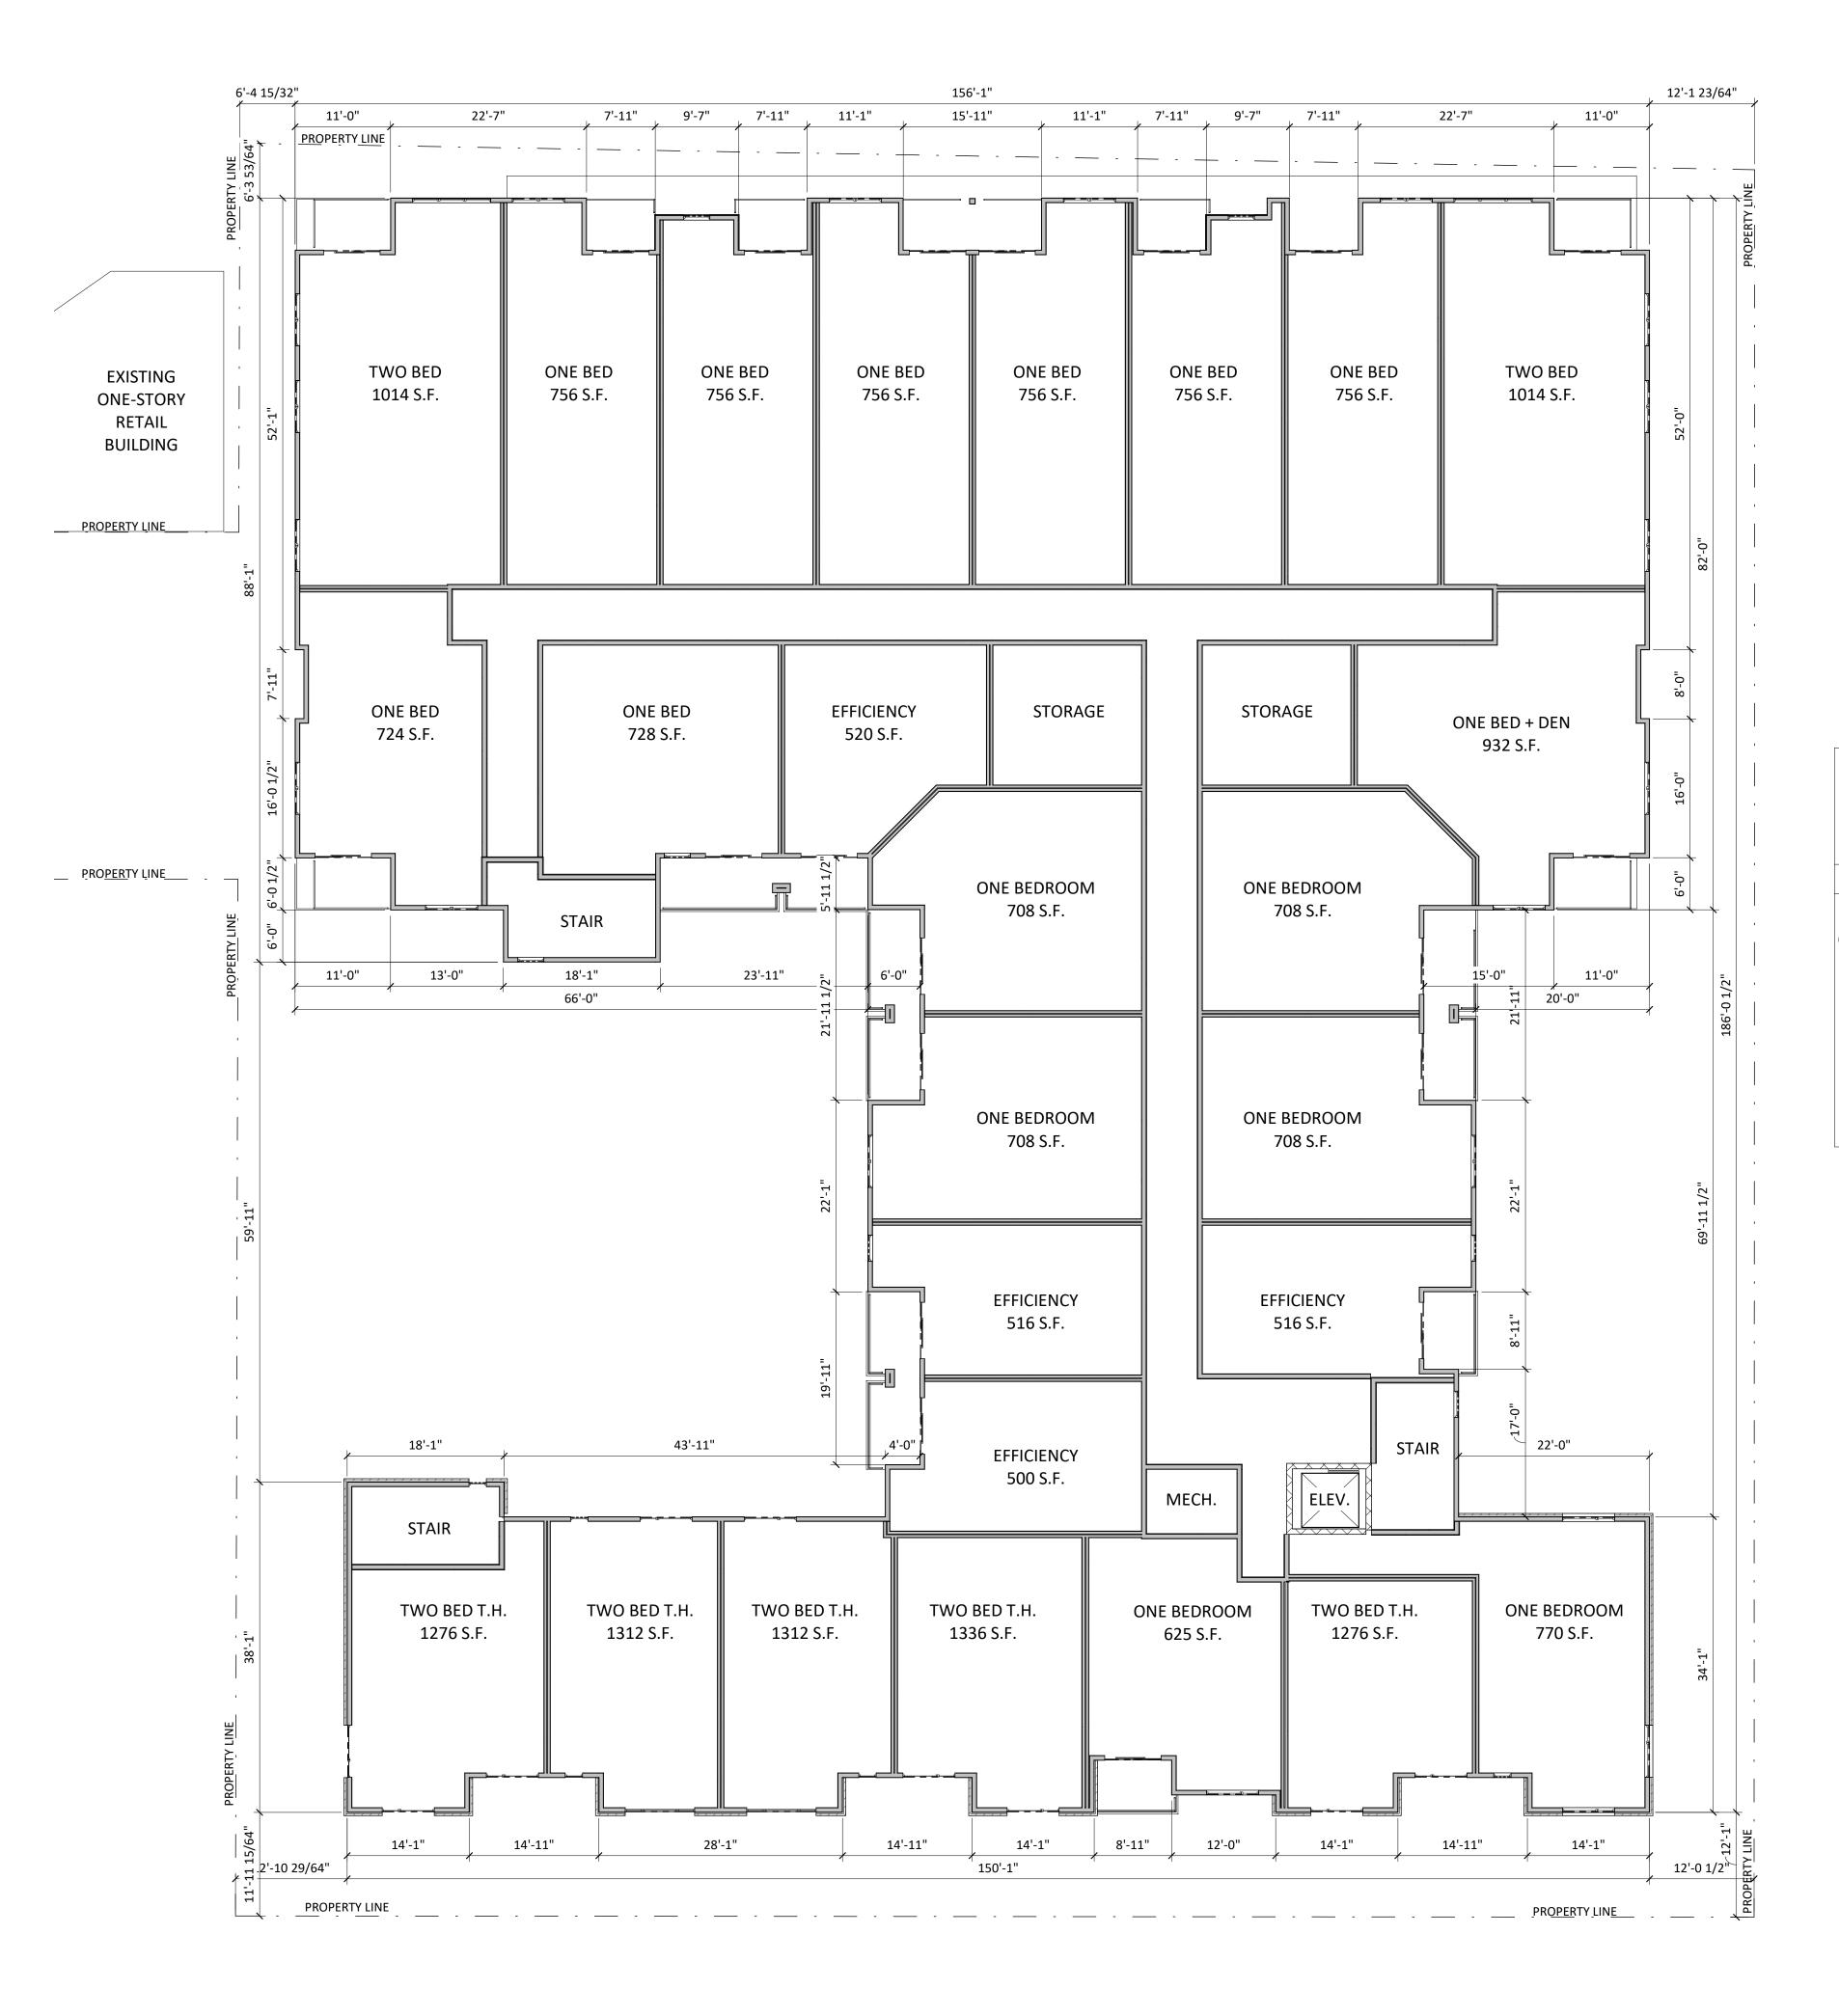





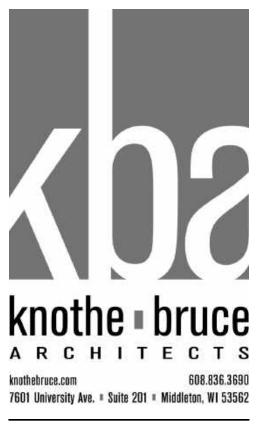

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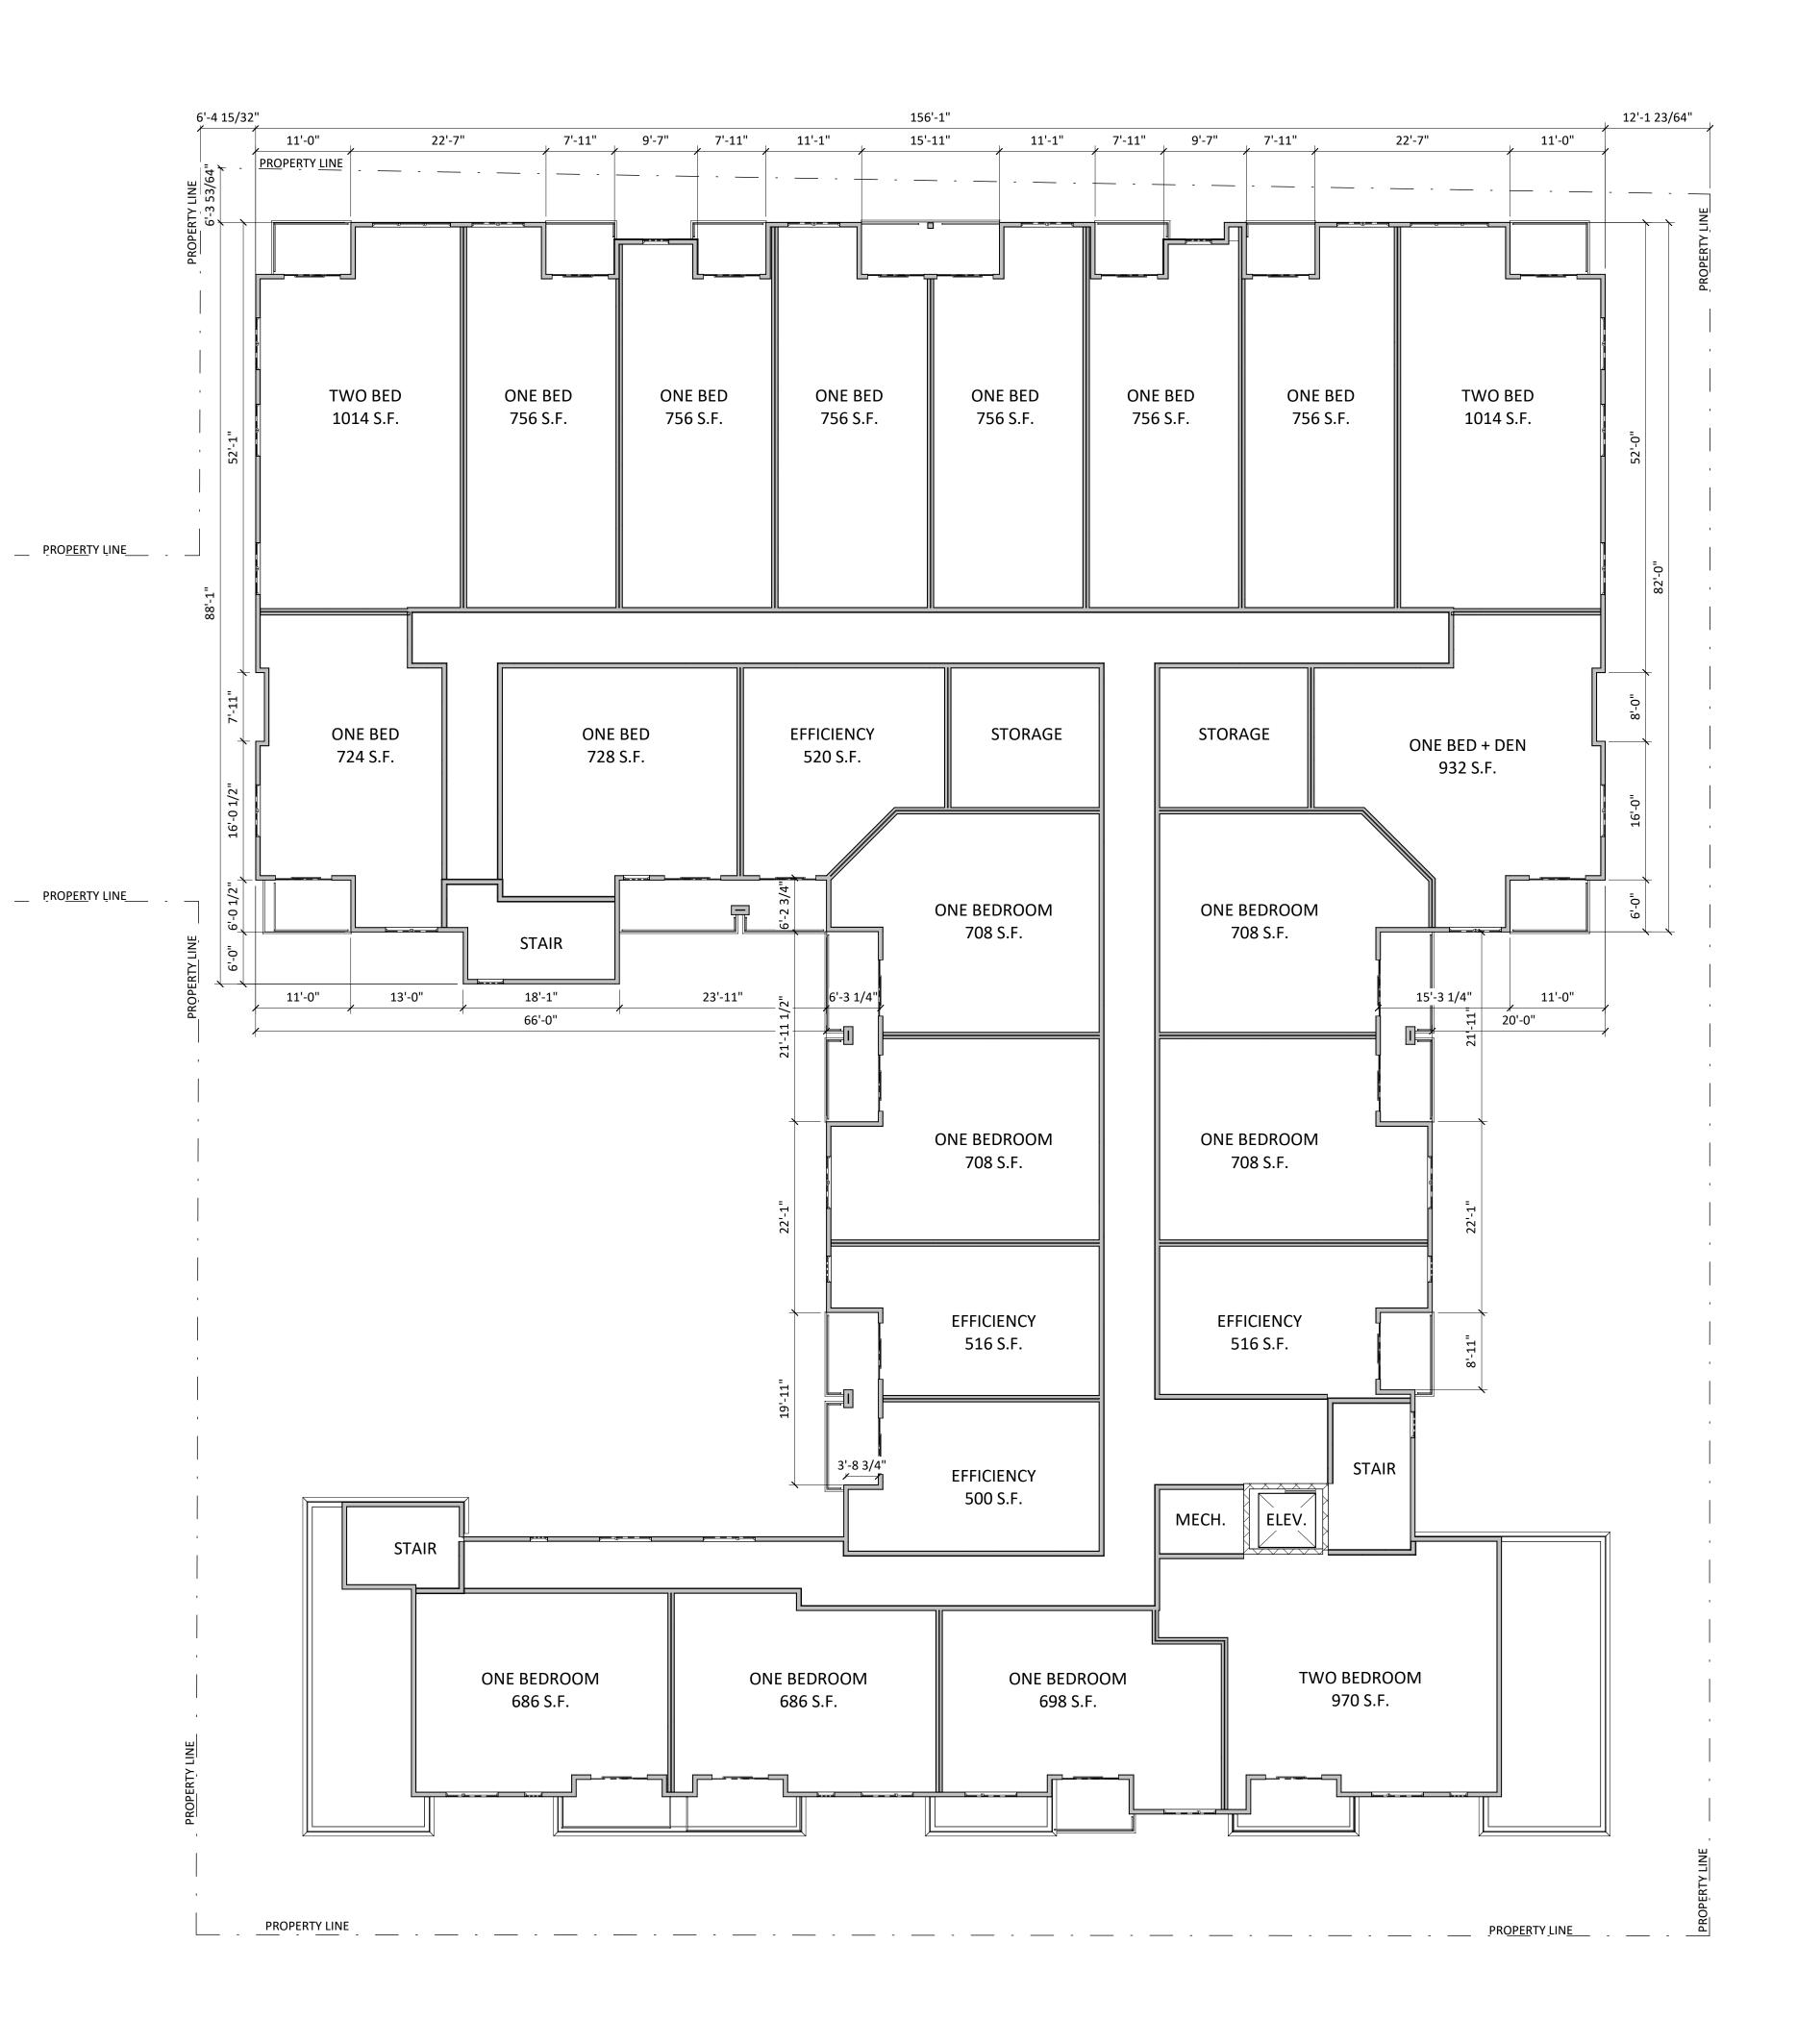
PROJECT TITLE LUCKY'S 1313 EXPANSION


1313 REGENT ST. MADISON, WI

SECOND FLOOR PLAN

A-1.2 project number 1916 © Knothe & Bruce Architects, LLC





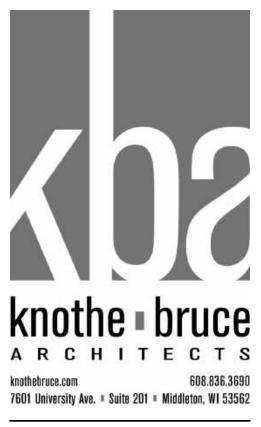

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PROJECT TITLE LUCKY'S 1313 EXPANSION

1313 REGENT ST. MADISON, WI

THIRD FLOOR PLAN

A-1.3 project number 1916 © Knothe & Bruce Architects, LLC







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PROJECT TITLE LUCKY'S 1313 EXPANSION

1313 REGENT ST. MADISON, WI

SHEET TITLE FOURTH FLOOR PLAN

A-1.4 project number 1916 © Knothe & Bruce Architects, LLC







SHEET NUMBER

MADISON, WI SHEET TITLE ROOF PLAN


1313 REGENT ST. MADISON, WI

LUCKY'S 1313 EXPANSION


PROJECT TITLE

ISSUED Issued for Land Use Submittal - July 29, 2020

KEY PLAN

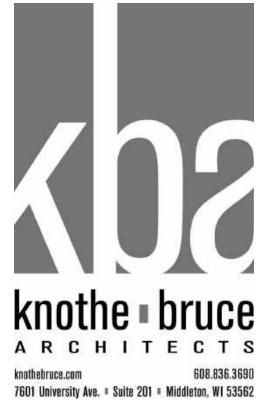



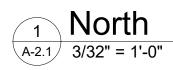





EXTERIOR MATERIAL SCHEDULE				
BUILDING ELEMENT	MANUFACTURER	COLOR		
MINI RIB - METAL PANEL - (#1)	MCELROY METAL	SLATE GRAY		
MEGA RIB - METAL PANEL - (#2)	MCELROY METAL	COLONIAL RED		
MINI RIB - METAL PANEL - (#3-M)	MCELROY METAL	ASH GRAY		
COMPOSITE PANEL SIDING - (#3-P)	JAMES HARDIE	PEARL GRAY		
METAL TRIM - (#T1)	JAMES HARDIE	SLATE GRAY		
METAL TRIM - (#T2)	JAMES HARDIE	COLONIAL RED		
COMPOSITE TRIM - (#T3)	JAMES HARDIE	PEARL GRAY		
MODULAR BRICK VENEER	N/A	MATCH EXISTING		
COMPOSITE WINDOWS	TBD	BLACK		
ALUM. STOREFRONT	N/A	BLACK FRAME / RED DOORS		
METAL DOORS/FRAMES	N/A	BLACK		
STONE SILLS & BANDS	EDWARDS	18-031		
SOFFITS	N/A	CITY SCAPE		
RAILINGS	SUPERIOR	BLACK		

BASEMENT -11'-5 1/2"

ROOF TRUSS

_F<u>OURTH_FLOOR</u> 41'-3 3/4"

THIRD FLOOR 30'-1 7/8"

APT SECOND — <u>FLOOR</u> 19'-0"

EXISTING FIRST

BASEMENT -11'-5 1/2"

(854.28)

0" 🗸

BEARING 50'-3 7/8"



KEY PLAN

ISSUED Issued for Land Use Submittal - July 27, 2020


PROJECT TITLE LUCKY'S 1313 EXPANSION

1313 REGENT ST. MADISON, WI


SHEET TITLE EXTERIOR ELEVATIONS





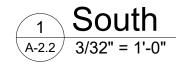



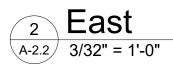

EXTERIOR MATERIAL SCHEDULE		
BUILDING ELEMENT	MANUFACTURER	COLOR
MINI RIB - METAL PANEL - (#1)	MCELROY METAL	SLATE GRAY
MEGA RIB - METAL PANEL - (#2)	MCELROY METAL	COLONIAL RED
MINI RIB - METAL PANEL - (#3-M)	MCELROY METAL	ASH GRAY
COMPOSITE PANEL SIDING - (#3-P)	JAMES HARDIE	PEARL GRAY
METAL TRIM - (#T1)	JAMES HARDIE	SLATE GRAY
METAL TRIM - (#T2)	JAMES HARDIE	COLONIAL RED
COMPOSITE TRIM - (#T3)	JAMES HARDIE	PEARL GRAY
MODULAR BRICK VENEER	N/A	MATCH EXISTING
COMPOSITE WINDOWS	TBD	BLACK
ALUM. STOREFRONT	N/A	BLACK FRAME / RED DOORS
METAL DOORS/FRAMES	N/A	BLACK
STONE SILLS & BANDS	EDWARDS	18-031
SOFFITS	N/A	CITY SCAPE
RAILINGS	SUPERIOR	BLACK



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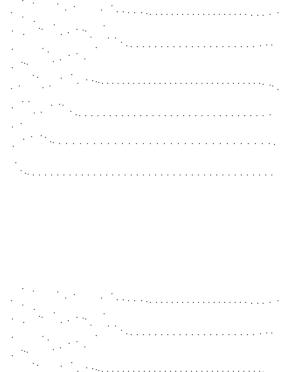


1313 REGENT ST. MADISON, WI


SHEET TITLE EXTERIOR ELEVATIONS



	ROOF TRUSS BEARING 50'-3 7/8"
	F <u>OURTH_FLOOR</u> 41'-3 3/4" ①
	COMPOSITE WINDOWS & PATIO DOORS
	30'-1 7/8" SOLDIER COURSING WINDOW HEADS
	APT SECOND FLOOR 19'-0"
	TH SECOND FLOOR 17'-0"
OPEN DRIVE	6' SIDE YARD SETBACK
	EXISTING FIRST (854.28) 0"
	BASEMENT -11'-5 1/2"



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1North - Rendered ElevationA-2.33/32" = 1'-0"

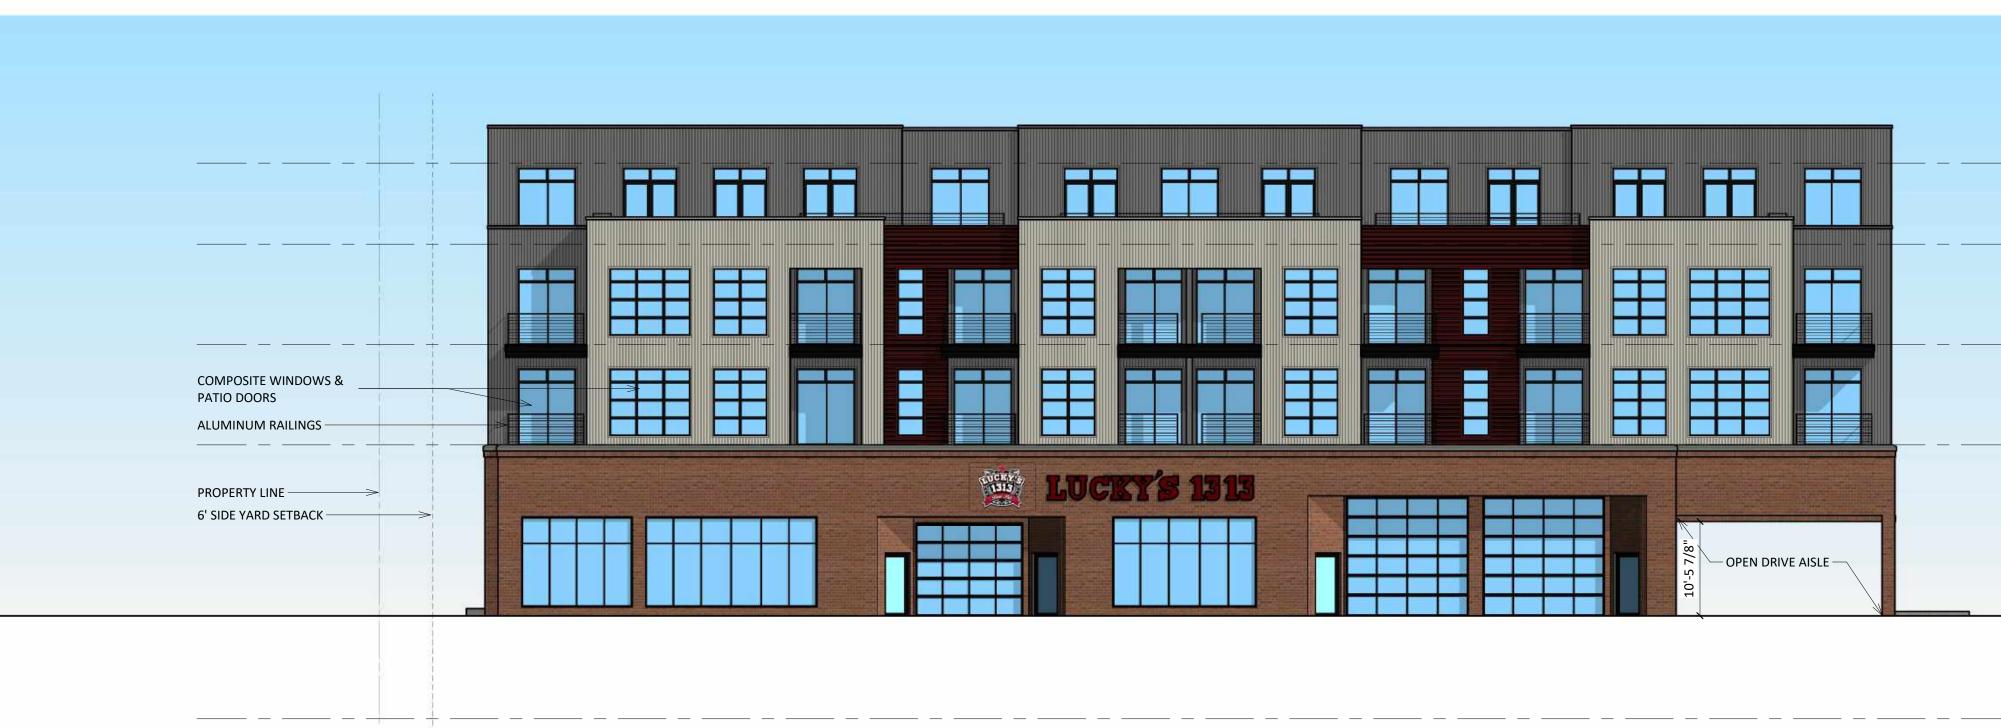

2 West - Rendered Elevation A-23 3/32" = 1'-0" A-3 A-4 A-4

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		ROOF TRUSS	
		BEARING 50'-3 7/8"	
		FOURTH FLOOR 41'-3 3/4"	lengths - brugs
		<u>— — — — — — — — — — — — — — — — — — — </u>	knothe bruce
		APT SECOND FLOOR 19'-0"	7601 University Ave. = Suite 201 = Middleton, WI 53562
		19-0-	
1CC International Internationa		EXISTING FIRST (854.28) 0"	
		BASEMENT -11'-5 1/2"	
		-11'-5 1/2" 🗢	
			ISSUED Issued for Land Use Submittal - July 27, 2020
		ROOF TRUSS	
		BEARING 50'-3 7/8" METAL TRIM COMPOSITE PANELS	
		ALUMINUM RAILINGS	
		SOLDIER COURSING WINDOW HEADS COMPOSITE WINDOWS 	
		CAST STONE SILLS APT SECOND FLOOR 19'-0"	
		19'-0" TH SECOND FLOOR 17'-0"	PROJECT TITLE LUCKY'S 1313
		PROPERTY LINE 10' FRONT YARD SETBACK	EXPANSION
		$ \begin{array}{c} $	
	,	<u>BASEMENT</u> -11'-5 1/2"	
			1313 REGENT ST.
			MADISON, WI
	· · · · · · · · · · · · · · · · · · ·		SHEET TITLE RENDERED
MINI RIB - METAL PANEL - (#1)	MANUFACTURER MCELROY METAL	SLATE GRAY	EXTERIOR
MEGA RIB - METAL PANEL - (#2)	MCELROY METAL	COLONIAL RED ASH GRAY	ELEVATIONS
MINI RIB - METAL PANEL - (#3-M) COMPOSITE PANEL SIDING - (#3-P)	MCELROY METAL JAMES HARDIE		
COMPOSITE PANEL SIDING - (#3-P) METAL TRIM - (#T1)	JAMES HARDIE JAMES HARDIE	PEARL GRAY SLATE GRAY	
COMPOSITE PANEL SIDING - (#3-P)	JAMES HARDIE		SHEET NUMBER
COMPOSITE PANEL SIDING - (#3-P) METAL TRIM - (#T1) METAL TRIM - (#T2) COMPOSITE TRIM - (#T3) MODULAR BRICK VENEER	JAMES HARDIE JAMES HARDIE JAMES HARDIE JAMES HARDIE N/A	SLATE GRAY COLONIAL RED PEARL GRAY MATCH EXISTING	SHEET NUMBER
COMPOSITE PANEL SIDING - (#3-P) METAL TRIM - (#T1) METAL TRIM - (#T2) COMPOSITE TRIM - (#T3)	JAMES HARDIE JAMES HARDIE JAMES HARDIE JAMES HARDIE N/A TBD N/A	SLATE GRAY COLONIAL RED PEARL GRAY	SHEET NUMBER
COMPOSITE PANEL SIDING - (#3-P) METAL TRIM - (#T1) METAL TRIM - (#T2) COMPOSITE TRIM - (#T3) MODULAR BRICK VENEER COMPOSITE WINDOWS ALUM. STOREFRONT METAL DOORS/FRAMES	JAMES HARDIE JAMES HARDIE JAMES HARDIE JAMES HARDIE N/A TBD N/A N/A	SLATE GRAY COLONIAL RED PEARL GRAY MATCH EXISTING BLACK BLACK FRAME / RED.DOORS BLACK	SHEET NUMBER A-2.3
COMPOSITE PANEL SIDING - (#3-P) METAL TRIM - (#T1) METAL TRIM - (#T2) COMPOSITE TRIM - (#T3) MODULAR BRICK VENEER COMPOSITE WINDOWS ALUM. STOREFRONT	JAMES HARDIE JAMES HARDIE JAMES HARDIE JAMES HARDIE N/A TBD N/A	SLATE GRAY COLONIAL RED PEARL GRAY MATCH EXISTING BLACK BLACK FRAME / RED.DOORS	SHEET NUMBER A-2.3 PROJECT NUMBER 1916


	\rightarrow	
	9'-0 1/8"	
	-8	/
	11'-1 7/8"	
	"8/	
	11'-1 7/8"	
	-0	
		25'-0"
	13'-0"	
6' SIDE YARD SETBACK ———		>
UNDERGROUND PARKING	4'-0"	
ENTRANCE (BEYOND)	4	
	1/2"	
	11'-5 1/2"	

1 South - Rendered Elevation A-2.4 3/32" = 1'-0"



• • • • • • • • • • • • • • • • • • • •	endered Elevation						
A-2.4 3/32" = 1'-0"							
n de la composition d la composition de la c la composition de la c			a di serena 1997 - Antonio Antonio antonio antonio antonio antonio antonio 1997 - Antonio antonio 1997 - Antonio a	i de la composición d la composición de la c	n film and an	EXTERIO	OR MATERIAL S
		· · · · · · · · · · · · · · · · · · ·				BUILDING ELEMENT	MANUFACTURER
						MINI RIB - METAL PANEL - (#1)	MCELROY METAL
						MEGA RIB - METAL PANEL - (#2)	MCELROY METAL
						MINI RIB - METAL PANEL - (#3-M)	MCELROY METAL
						COMPOSITE PANEL SIDING - (#3-P)	JAMES HARDIE
						METAL TRIM - (#T1)	JAMES HARDIE
						METAL TRIM - (#T2)	JAMES HARDIE
						COMPOSITE TRIM - (#T3)	JAMES HARDIE
						MODULAR BRICK VENEER	N/A
						COMPOSITE WINDOWS	ТВО
						ALUM. STOREFRONT	.N/A
						METAL DOORS/FRAMES	N/A
**	· ·	· ····	· ·		с. Малтана с страна с	STONE SILLS & BANDS	EDWARDS
						SOFFITS	N/A
						RAILINGS	SUPERIOR



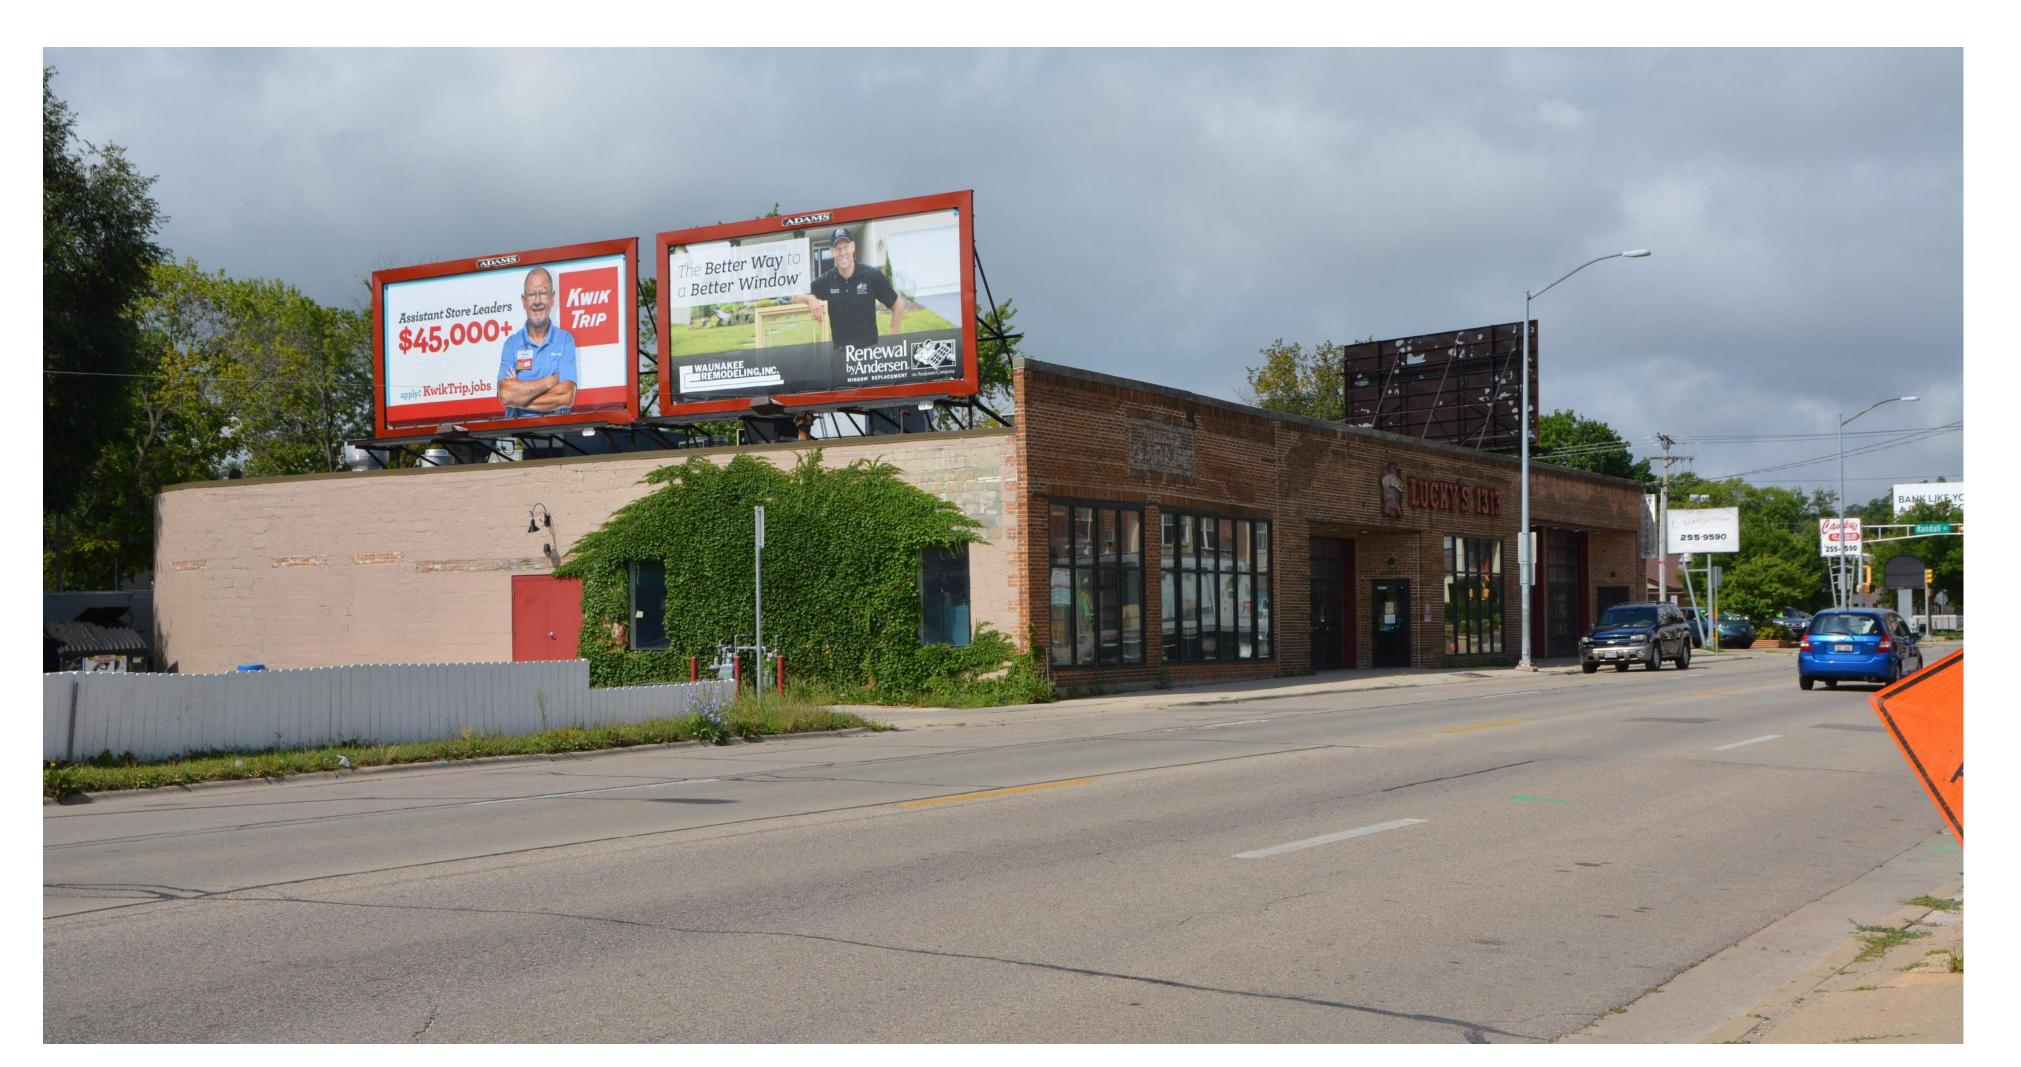




Existing Building along Regent Street





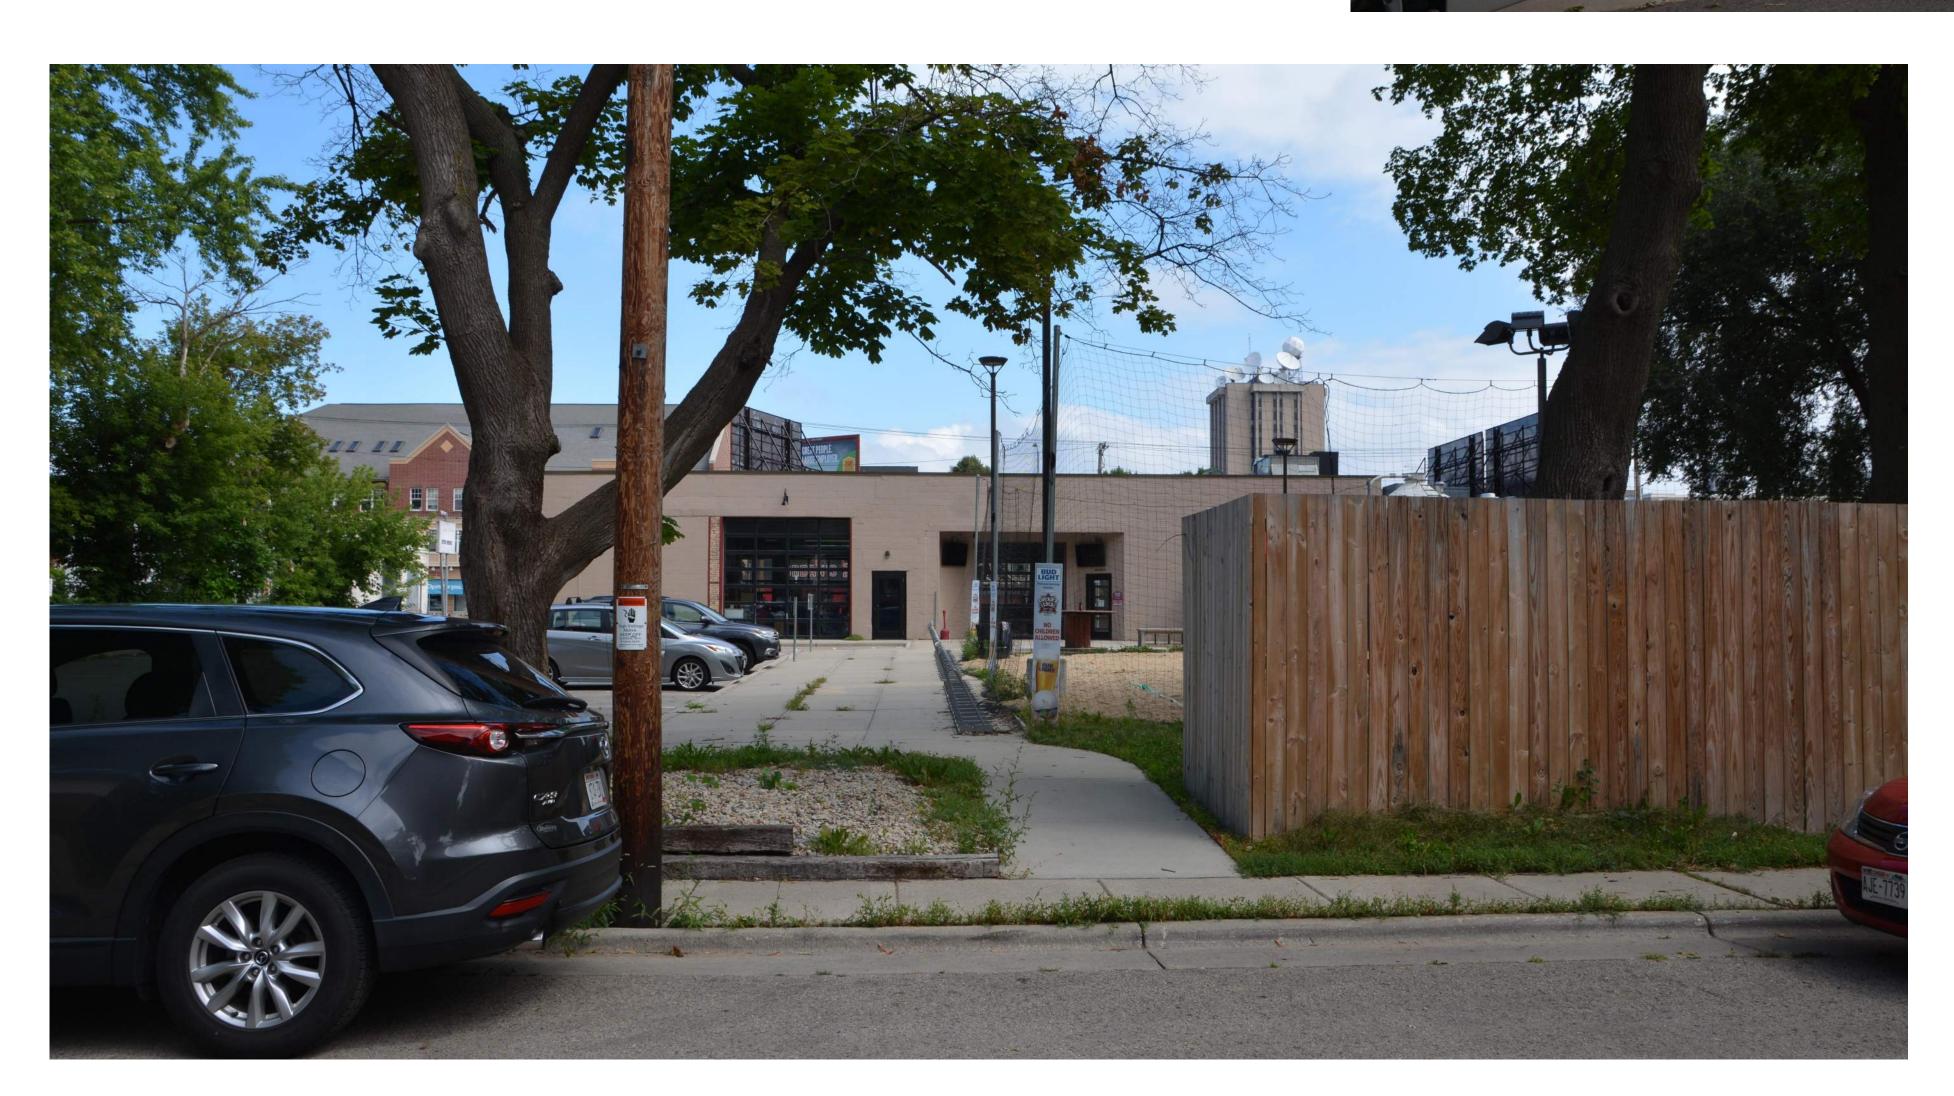



Existing Building along Bowen Court
















LUCKY'S 1313 REGENT ST. MADISON, WI RENDERED PERSPECTIVE OCTOBER 14, 2020






LUCKY'S 1313 REGENT ST. MADISON, WI RENDERED PERSPECTIVE OCTOBER 14, 2020



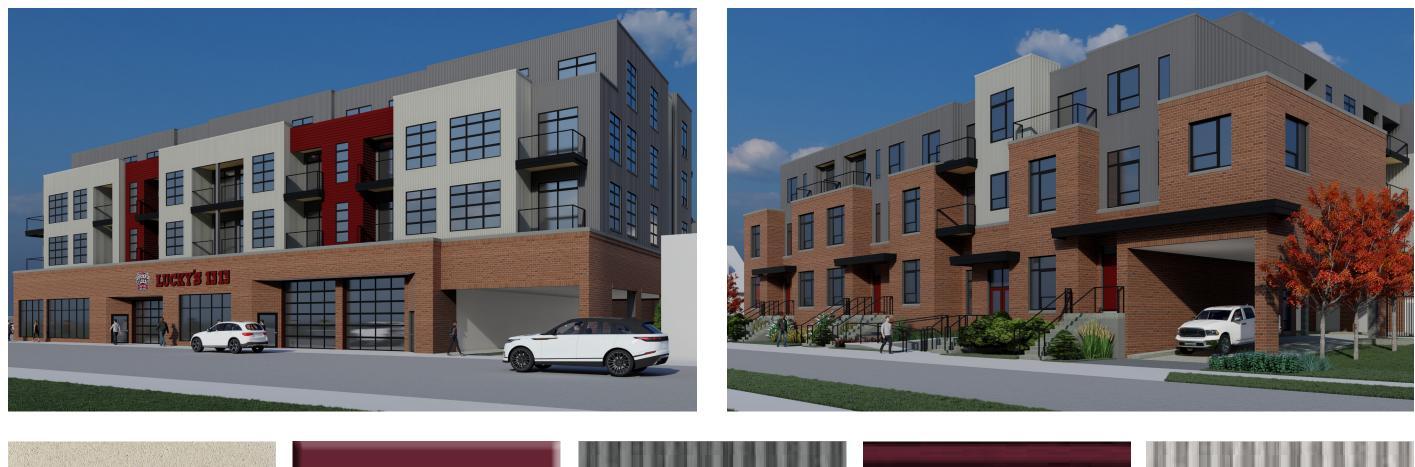

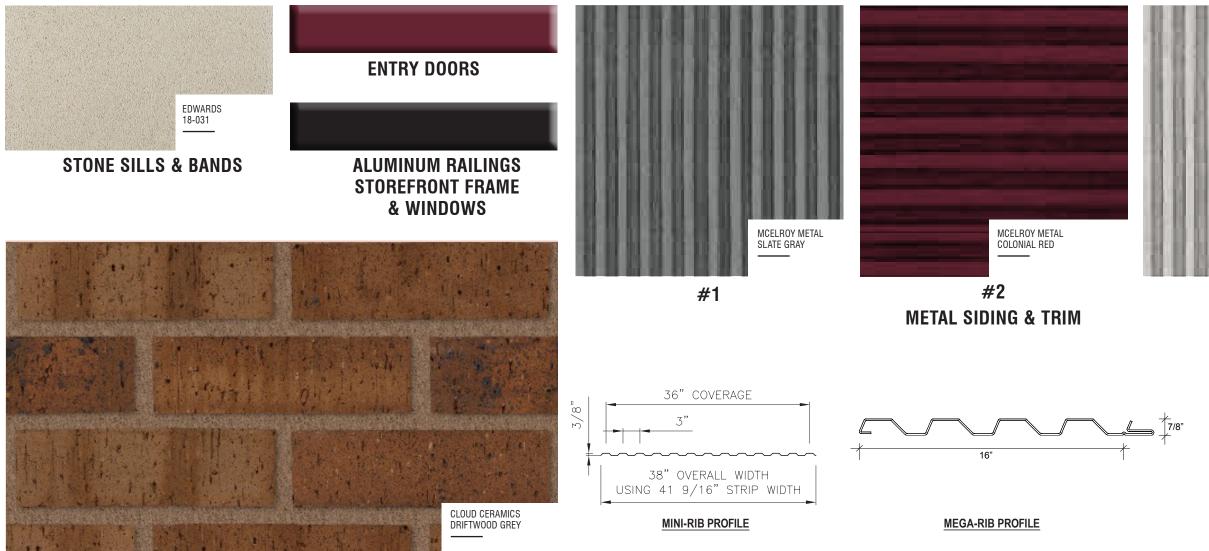

BRICK VENEER



#3

MATERIALS LUCKY'S EXPANSION 1313 REGENT STREET MADISON,WI OCTOBER 21, 2020










1 North - Rendered Elevation



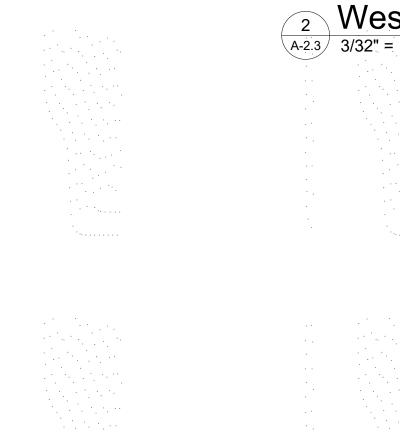




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EXTERIO	R MATERIA
BUILDING ELEMENT	MANUFACTURER
COMPOSITE LAP SIDING - (#1) - 4"	JAMES HARDIE
COMPOSITE PANEL SIDING - (#2)	JAMES HARDIE
COMPOSITE LAP SIDING - (#3-S) - ALT WIDTH	JAMES HARDIE
COMPOSITE PANEL SIDING - (#3-P)	JAMES HARDIE
COMPOSITE TRIM - (#T1)	JAMES HARDIE
COMPOSITE TRIM - (#T2)	JAMES HARDIE
COMPOSITE TRIM - (#T3)	JAMES HARDIE
MODULAR BRICK VENEER	N/A
COMPOSITE WINDOWS	TBD
ALUM. STOREFRONT	N/A
METAL DOORS/FRAMES	N/A
STONE SILLS & BANDS	EDWARDS
SOFFITS	N/A
RAILINGS	SUPERIOR


BLACK

BLACK 18-031

BLACK

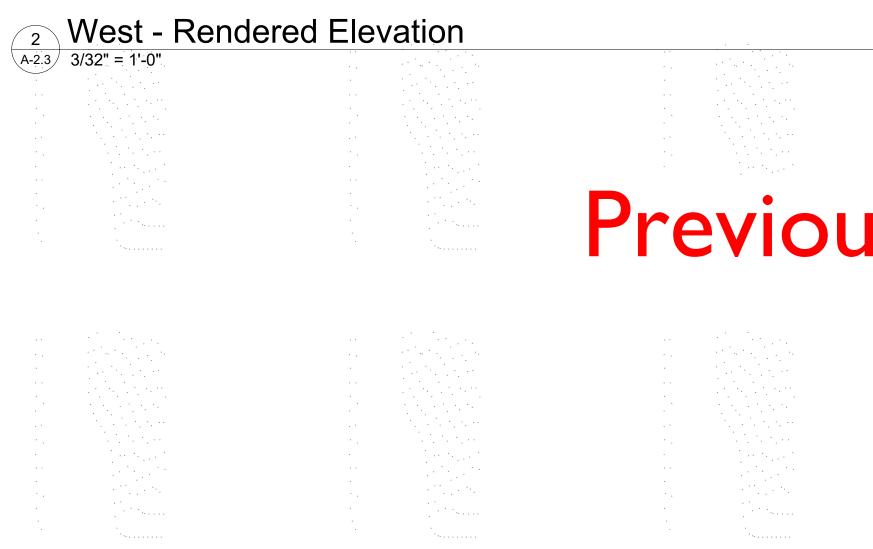CITY SCAPE

BLACK FRAME / RED DOORS

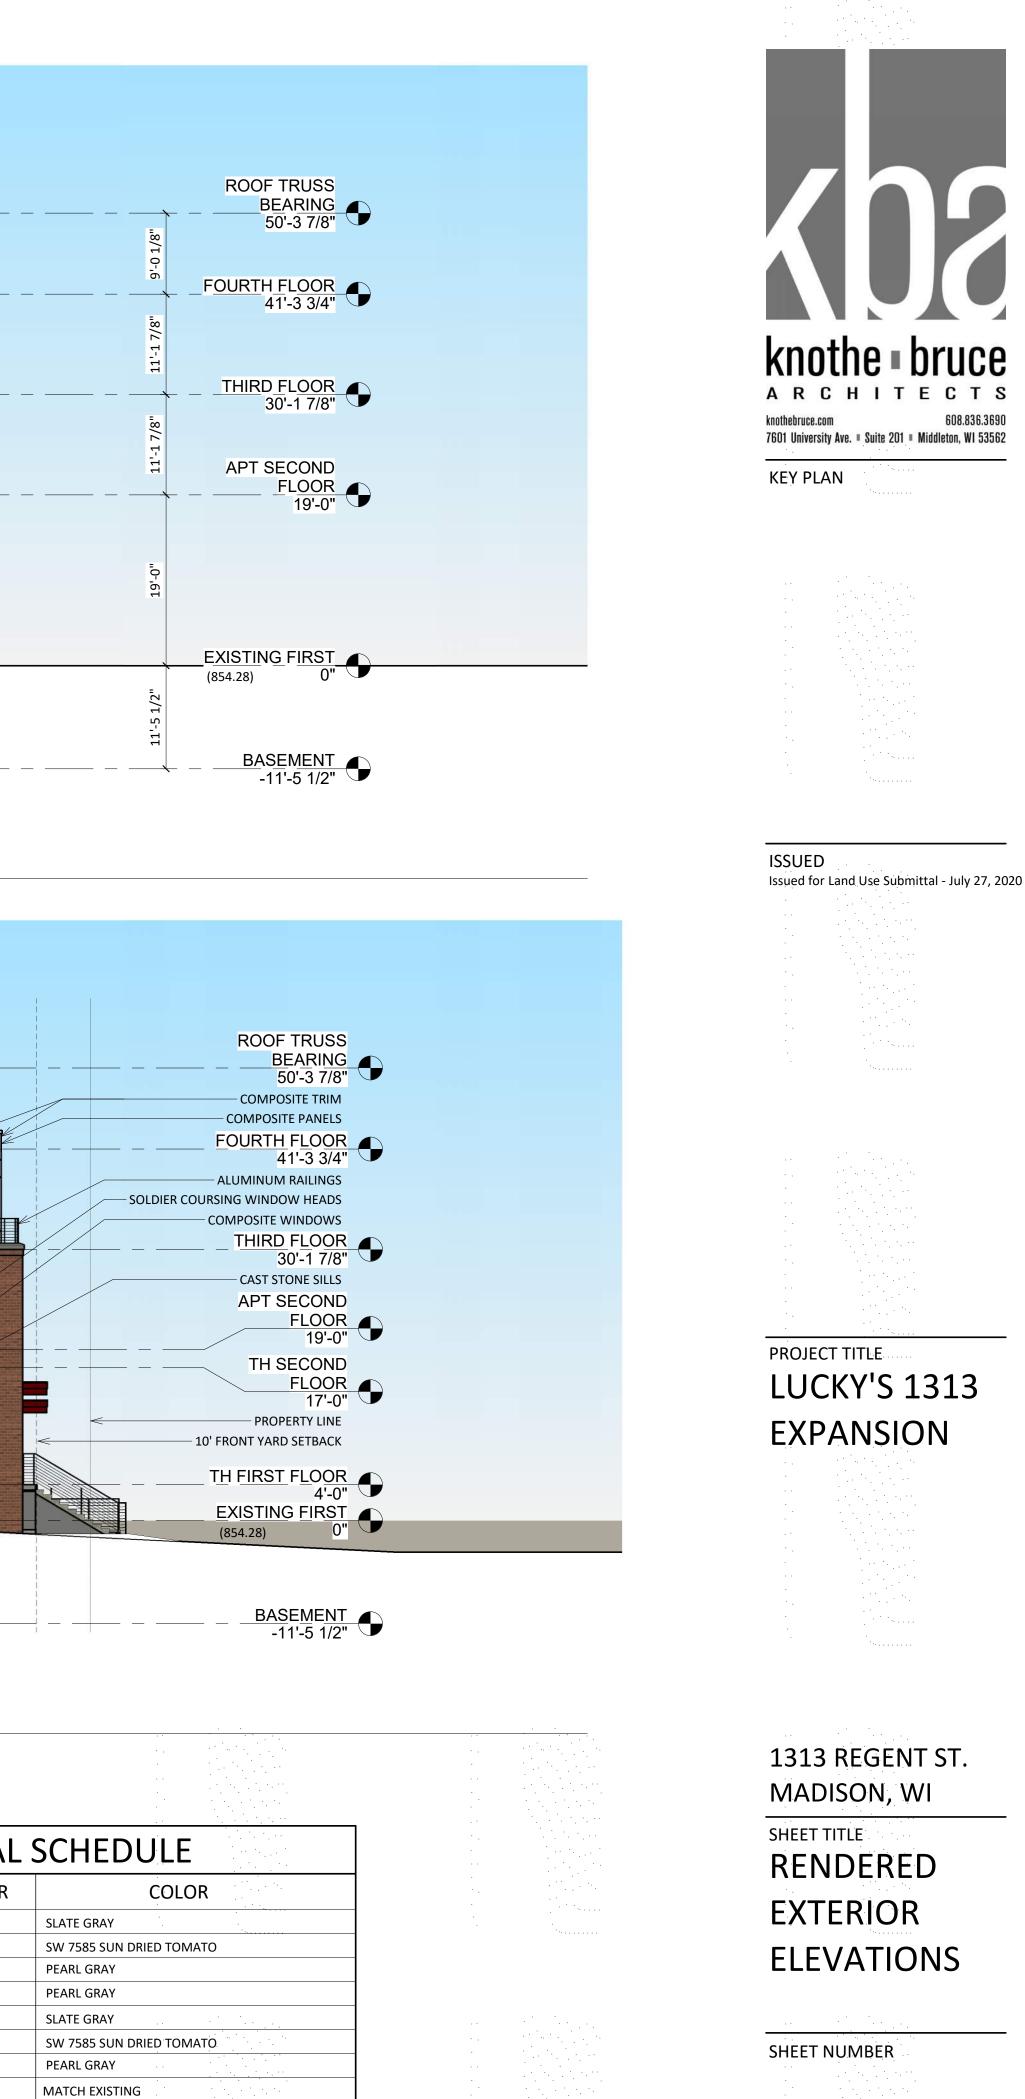


A-2.3 PROJECT NUMBER 1916 © Knothe & Bruce Architects, LLC

	,	
	=	
	9'-0 1/8"	
	6	
	-	
	11'-1 7/8"	
	11.	1
	7/8"	I I I
	11'-1 7/8"	
	+0 	25'-0"
		5
	13'-0"	
6' SIDE YARD SETBACK		>
UNDERGROUND PARKING		
	4'-0"	
	=	
	11'-5 1/2"	
	11-	







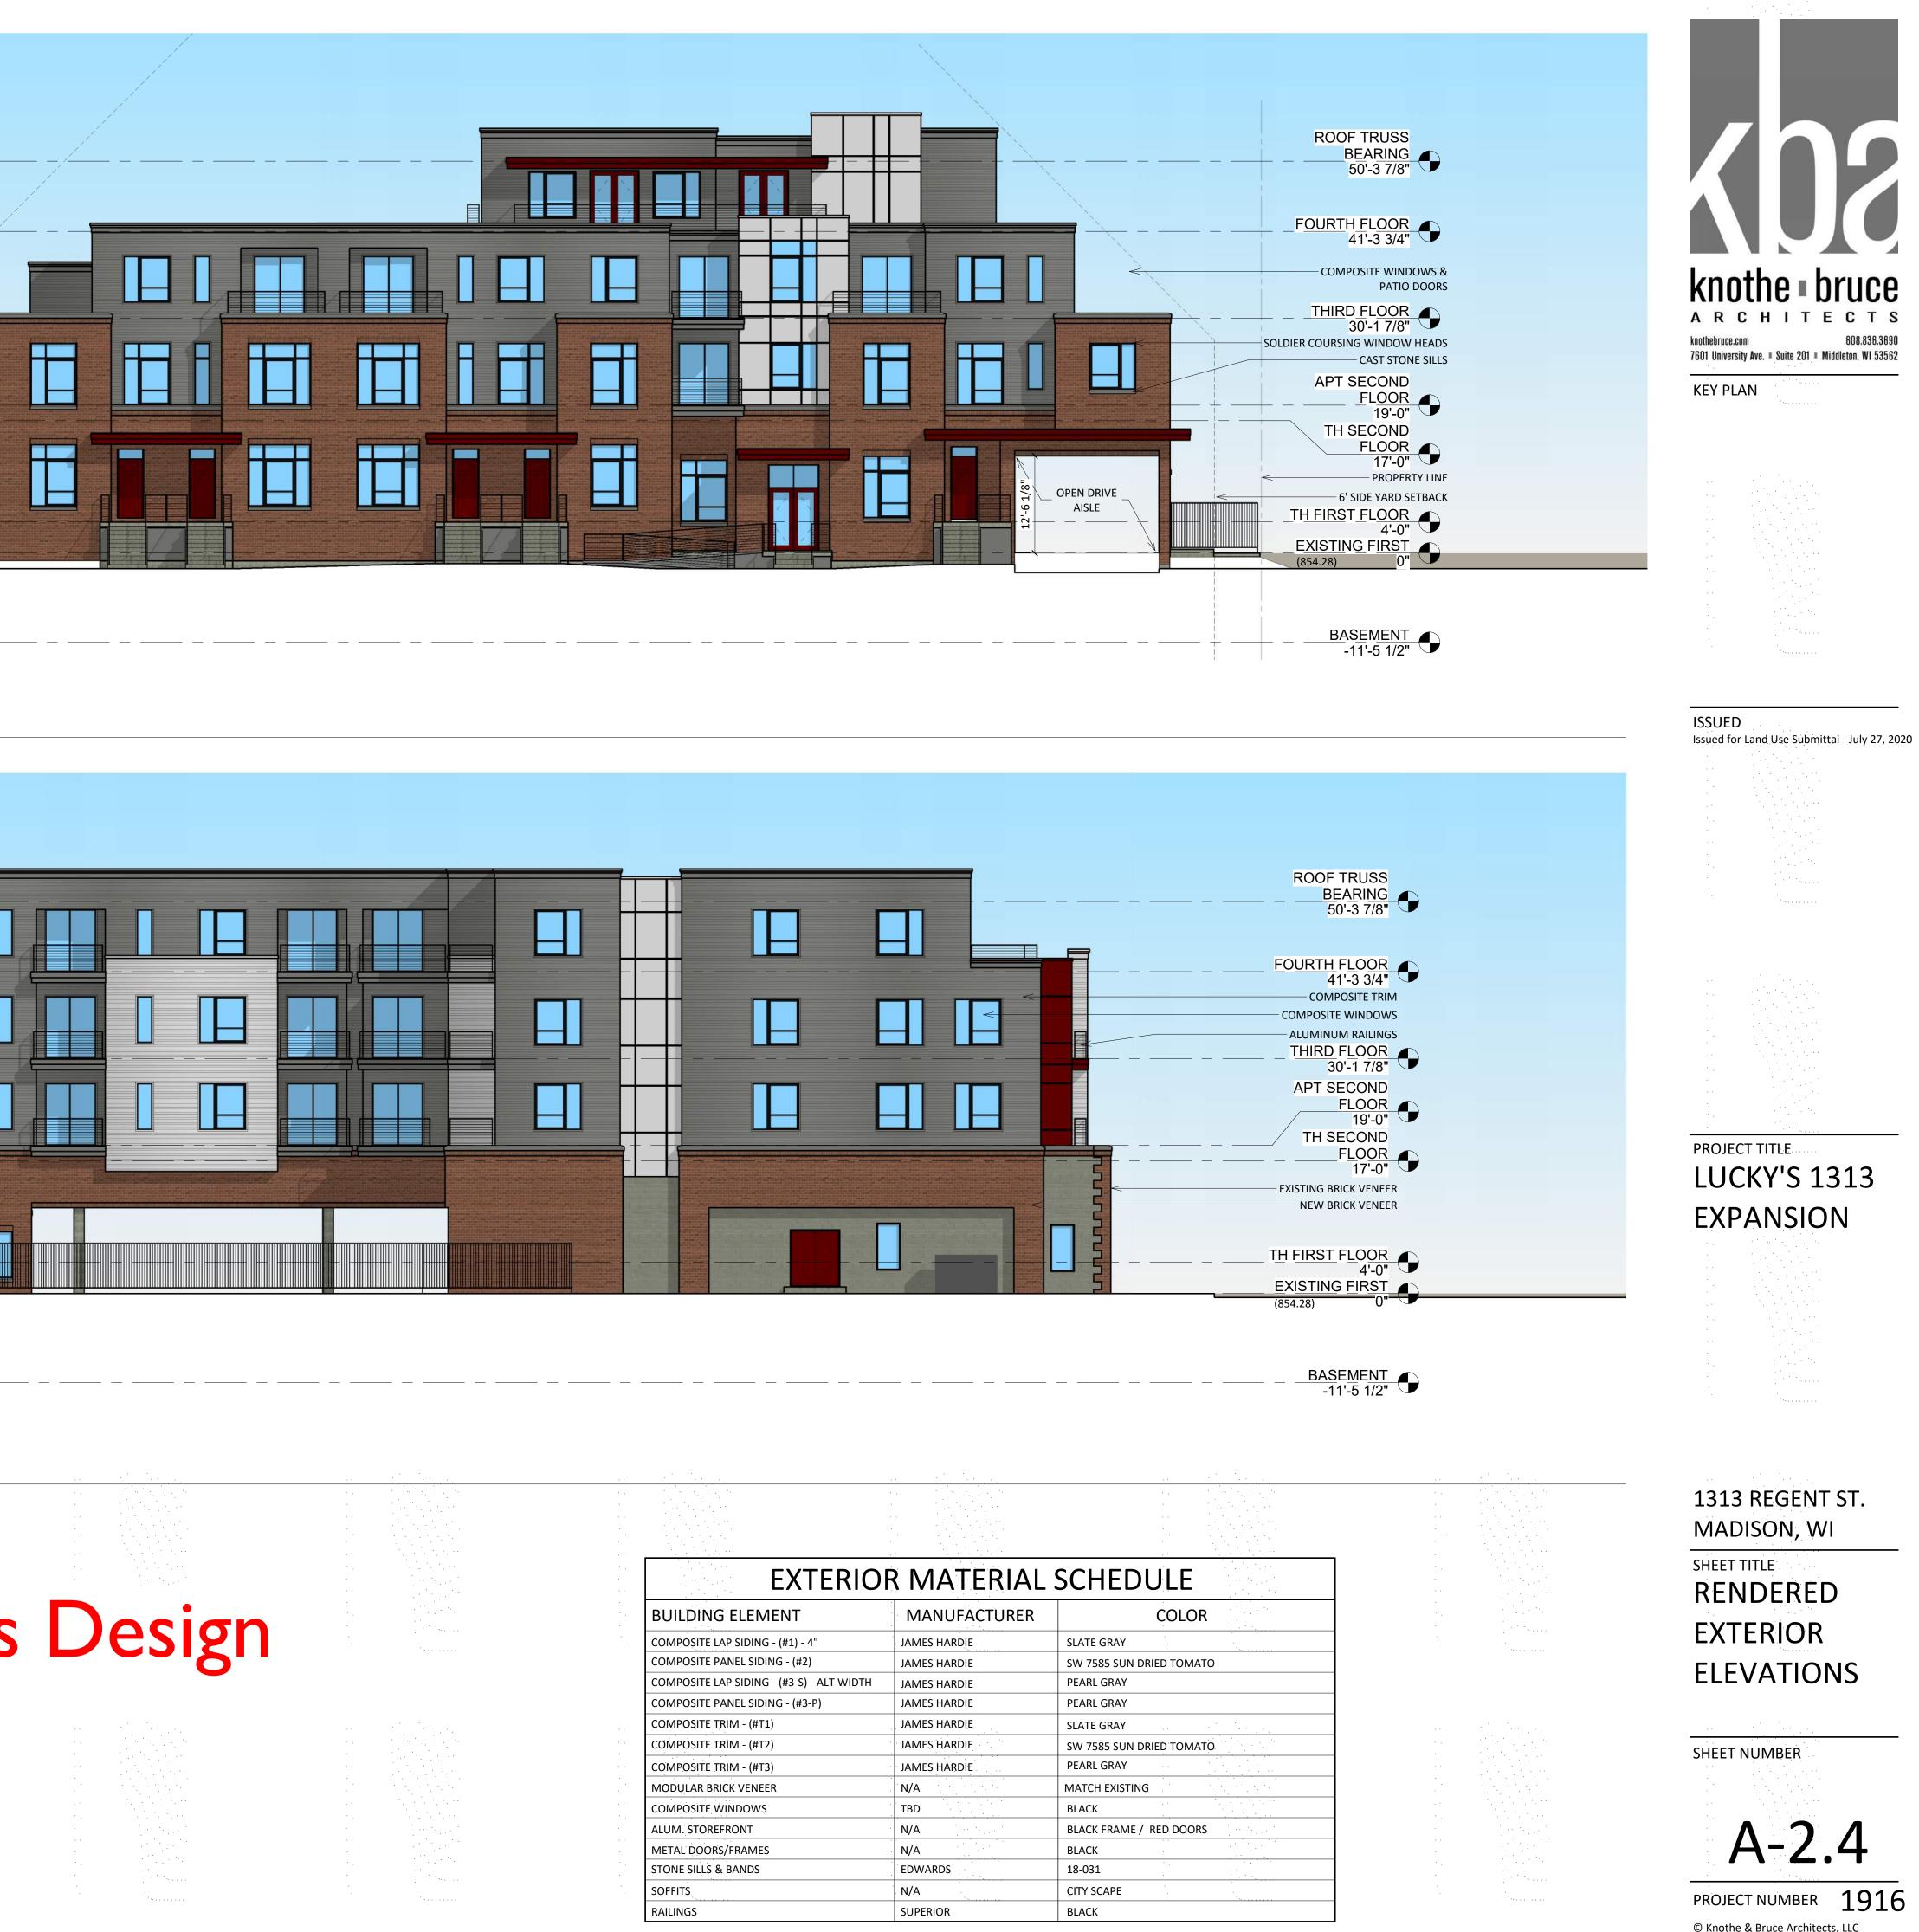

Previous Design









Previous Design



LUCKY'S 1313 REGENT ST. MADISON, WI RENDERED PERSPECTIVE OCTOBER 05, 2020





Previous Design

LUCKY'S 1313 REGENT ST. MADISON, WI RENDERED PERSPECTIVE OCTOBER 05, 2020







