URBAN DESIGN COMMISSION APPLICATION

City of Madison Planning Division Madison Municipal Building, Suite 017 215 Martin Luther King, Jr. Blvd. P.O. Box 2985 Madison, WI 53701-2985 (608) 266-4635



Complete all sections of this application, including the desired meeting date and the action requested.

If you need an interpreter, translator, materials in alternate formats or other accommodations to access these forms, please call the phone number above immediately.

FOR	OFFICE	USE	ONIY:

Paid	Receipt #	
Date received		
Received by		
Aldermanic District	RECEIVED	9/16/2020
Zoning District		11:48 a.m.
Urban Design District		
Submittal reviewed by		
Legistar #		

1. Project Information

	Address:		
	Title:		
C	Application Type (sheet) all that	annly) and Deguasted Date	
Ζ.	Application Type (check all that		
	UDC meeting date requested		
	New development	0	r previously-approved development
	Informational	Initial approval	Final approval
3.	Project Type		
	Project in an Urban Design Dis	strict #7	Signage
	Project in the Downtown Core		Comprehensive Design Review (CDR)
	Mixed-Use District (UMX), or Mix Project in the Suburban Emplo		Signage Variance (i.e. modification of signage height, area, and setback)
	Campus Institutional District (District (EC)		Signage Exception
	Planned Development (PD)		Other
	General Development Pla Specific Implementation		Please specify
	Planned Multi-Use Site or Resi	idential Building Complex	
4.	Applicant, Agent, and Property	Owner Information	
			Company
			City/State/Zip
			Email
	Project contact person		Company
	Street address		City/State/Zip
	Telephone		Email
	Property owner (if not applicant)	
	Street address		City/State/Zip
	Telephone		Email
M:\	Planning Division\Commissions & Committees\Ur	BAN DESIGN COMMISSION\APPLICATION — F	EBRUARY 2020 PAGE 1 OF

Urban Design Commission Application (continued)

5. Required Submittal Materials

- Application Form
- Letter of Intent
 - If the project is within an Urban Design District, a summary of how the development proposal addresses the district criteria is required
 - For signage applications, a summary of how the proposed signage is consistent with the applicable CDR or Signage Variance review criteria is required.
- Development Plans (Refer to checklist on Page 4 for plan details)
- □ Filing fee
- Electronic Submittal*
- **D** Notification to the District Alder
 - Please provide an email to the District Alder notifying them that you are filing this UDC application. Please send this as early in the process as possible and provide a copy of that email with the submitted application.

Both the paper copies and electronic copies <u>must</u> be submitted prior to the application deadline before an application will be scheduled for a UDC meeting. Late materials will not be accepted. A completed application form is required for each UDC appearance.

For projects also requiring Plan Commission approval, applicants must also have submitted an accepted application for Plan Commission consideration prior to obtaining any formal action (initial or final approval) from the UDC. All plans must be legible when reduced.

*Electronic copies of all items submitted in hard copy are required. Individual PDF files of each item submitted should be compiled on a CD or flash drive, or submitted via email to <u>udcapplications@cityofmadison.com</u>. The email must include the project address, project name, and applicant name. Electronic submittals via file hosting services (such as Dropbox.com) are not allowed. Applicants who are unable to provide the materials electronically should contact the Planning Division at (608) 266-4635 for assistance.

6. Applicant Declarations

- 1. Prior to submitting this application, the applicant is required to discuss the proposed project with Urban Design Commission staff. This application was discussed with <u>Janine Glaeser</u> on 07/16/2020
- The applicant attests that all required materials are included in this submittal and understands that if any required information is not provided by the application deadline, the application will not be placed on an Urban Design Commission agenda for consideration.

Name of applicant Joe Krupp

Authorizing signature of property owner

Relationship to property ^{Owner}

7. Application Filing Fees

Fees are required to be paid with the first application for either initial or final approval of a project, unless the project is part of the combined application process involving the Urban Design Commission in conjunction with Plan Commission and/or Common Council consideration. Make checks payable to City Treasurer. Credit cards may be used for application fees of less than \$1,000.

Please consult the schedule below for the appropriate fee for your request:

- Urban Design Districts: \$350 (per §35.24(6) MGO).
- □ Minor Alteration in the Downtown Core District (DC) or Urban Mixed-Use District (UMX) : \$150 (per §33.24(6)(b) MGO)
- □ Comprehensive Design Review: \$500 (per §31.041(3)(d)(1)(a) MGO)
- □ Minor Alteration to a Comprehensive Sign Plan: \$100 (per §31.041(3)(d)(1)(c) MGO)
- □ All other sign requests to the Urban Design Commission, including, but not limited to: appeals from the decisions of the Zoning Administrator, requests for signage variances (i.e. modifications of signage height, area, and setback), and additional sign code approvals: \$300 (per §31.041(3)(d)(2) MGO)

A filing fee is not required for the following project applications if part of the combined application process involving both Urban Design Commission and Plan Commission:

Date 09/15/2020

- Project in the Downtown Core District (DC), Urban Mixed-Use District (UMX), or Mixed-Use Center District (MXC)
- Project in the Suburban Employment Center District (SEC), Campus Institutional District (CI), or Employment Campus District (EC)
- Planned Development (PD): General Development
 Plan (GDP) and/or Specific Implementation Plan (SIP)
- Planned Multi-Use Site or Residential Building Complex

Each submittal must include fourteen (14) 11" x 17" <u>collated</u> paper copies. Landscape and Lighting plans (if required) must be <u>full-sized and legible</u>. Please refrain from using plastic covers or spiral binding.

URBAN DESIGN DEVELOPMENT PLANS CHECKLIST

The items listed below are minimal application requirements for the type of approval indicated. Please note that the UDC and/ or staff may require additional information in order to have a complete understanding of the project.

Providing additional

information beyond these

minimums may generate

from the Commission.

a greater level of feedback

1. Informational Presentation

- Locator Map
- □ Letter of Intent (If the project is within an Urban Design District, a summary of <u>how</u> the development proposal addresses the district criteria is required)
- Contextual site information, including photographs and layout of adjacent buildings/structures
- Site Plan
- □ Two-dimensional (2D) images of proposed buildings or structures.

2. Initial Approval

- Locator Map
- □ Letter of Intent (If the project is within a Urban Design District, a summary of <u>how</u> the development proposal addresses the district criteria is required)
- □ Contextual site information, including photographs and layout of adjacent buildings/ structures
- □ Site Plan showing location of existing and proposed buildings, walks, drives, bike lanes, bike parking, and existing trees over 18" diameter
- □ Landscape Plan and Plant List (*must be legible*)
- Building Elevations in both black & white and color for all building sides (include material callouts)
- D PD text and Letter of Intent (if applicable)

3. Final Approval

All the requirements of the Initial Approval (see above), plus:

- □ Grading Plan
- □ Proposed Signage (if applicable)
- Lighting Plan, including fixture cut sheets and photometrics plan (*must be legible*)
- Utility/HVAC equipment location and screening details (with a rooftop plan if roof-mounted)
- D PD text and Letter of Intent (if applicable)
- □ Samples of the exterior building materials (presented at the UDC meeting)

4. Comprehensive Design Review (CDR) and Variance Requests (Signage applications only)

- Locator Map
- Letter of Intent (a summary of how the proposed signage is consistent with the CDR or Signage Variance criteria is required)
- □ Contextual site information, including photographs of existing signage both on site and within proximity to the project site
- □ Site Plan showing the location of existing signage and proposed signage, dimensioned signage setbacks, sidewalks, driveways, and right-of-ways
- Proposed signage graphics (fully dimensioned, scaled drawings, including materials and colors, and night view)
- □ Perspective renderings (emphasis on pedestrian/automobile scale viewsheds)
- □ Illustration of the proposed signage that meets Ch. 31, MGO compared to what is being requested.
- Graphic of the proposed signage as it relates to what the Ch. 31, MGO would permit

Requirements for All Plan Sheets

- 1. Title block
- 2. Sheet number
- 3. North arrow
- 4. Scale, both written and graphic
- 5. Date
- Fully dimensioned plans, scaled at 1"= 40' or larger

** All plans must be legible, including the full-sized landscape and lighting plans (if required)

> Providing additional information beyond these minimums may generate a greater level of feedback from the Commission.

UUL

September 16, 2020

Ms. Heather Stouder Director, Planning Division Department of Planning, Community & Economic Development 215 Martin Luther King Jr. Blvd., Ste 017 Madison, Wisconsin 53703

Re: Letter of Intent – Conditional Use and CSM Approval 1224 South Park Street KBA Project # 2031

Ms. Heather Stouder:

The following is submitted together with the plans and application for Urban Design Commission and Plan Commission consideration of approval.

Organizational structure:

Owner:	Prime Urban Properties 1952 Atwood Ave Madison, WI 53704 (608) 233-6000 Contact: Joe Krupp Joe@primeurbanproperties.com	Architect:	Knothe & Bruce Architects, LLC 7601 University Avenue, Ste 201 Middleton, WI 53562 (608) 836-3690 Contact: Kevin Burow <u>kburow@knothebruce.com</u>
Civil Engineer:	JSD Professional Services, Inc 161 Horizon Dr, #101 Verona, WI 53593 (608) 848-5060 Contact: Kevin Yeska <u>kevin.yeska@jsdinc.com</u>	Landscape Architect:	JSD Professional Services, Inc 161 Horizon Dr, #101 Verona, WI 53593 (608) 848-5060 Contact: Kevin Yeska <u>kevin.yeska@jsdinc.com</u>

Introduction:

The site is located at 1224 S Park Street on Madison's near south side and is currently the site of a onestory commercial building with a surface parking lot. The proposed development entails the demolition of the existing building and surface parking and the construction of a new five-story mixed-use building with approximately 4,000 sq.ft. of commercial space, 62 apartment units, and a total of 78 enclosed and surface parking spaces.

The site is currently zoned Commercial Corridor - Transitional District (CC-T) and is also located within Urban Design District 7. This application requests the following approvals: 1) demolition approval for the existing structure, and 2) the conditional-use approvals required for the mixed-use development.





Letter of Intent – September 16, 2020 – Conditional Use 1224 S Park St - Madison, WI Page 2 of 4

Project Description:

The project provides much needed housing along a major corridor leading to Downtown Madison. The site is directly on the Bus Lines and will allow for easy access to many areas of the City. The existing building is predominantly vacant so the site will be better utilized as a mixed-use property in order to provide additional housing units for the City of Madison. As part of this project we are also creating an outdoor gathering space on the second-floor level with a rooftop patio adjacent to the Community Room and above the enclosed parking garage in the building.

The exterior materials will be a combination of masonry on a majority of the façade along with composite siding and a cast stone base. The architecture is contemporary and urban with a high level of detailing in the masonry.

City and Neighborhood Input:

We have met with the City on several occasions for this proposed development including meetings with Staff, attending a DAT Meeting, and presenting at UDC for an informational presentation. These discussions have helped to shape this submittal.

This site is within the Bay Creek Neighborhood Association and we have met with them on several occasions. Prior to that we also had initial meetings with Alder Tag Evers. These were all productive discussions that have led to enhancements to our proposed development.

Demolition Standards

We believe that the demolition standards can be met. The proposed development is compatible with the City's Comprehensive Plan and this site was proposed for new construction in 2019 and a demolition permit was approved at that time.

A Re-use and Recycling Plan will be submitted prior to the deconstruction of the existing commercial structure.

CSM Approval

As part of the development proposal for 1224 S Park Street, a CSM is included to combine the existing three lots (1204, 1214, and 1224 S Park Street) into one contiguous parcel comprised of 0.591 acres. The CSM includes the dedication of a three-foot sidewalk easement along S Park Street to increase the width of the existing five-foot terrace to eight feet as well as the dedication of a 10-foot wide multi-use path easement along the property's rear lot line. While not being constructed as part of this development proposal, when constructed the future multi-use path will straddle the site's rear property line, providing connectivity to High Street and the city's larger trail system.

Conditional Use Approvals:

The proposed redevelopment requires conditional uses to allow for a mixed-use building exceeding 40,000 sq.ft. in size, and for a residential building with more than 8 units. The proposed building's size, scale, and use are consistent with the City's Comprehensive Plan which calls for Regional Mixed-Use (RMU) on this property by being five stories tall and providing high-density residential.

Conformance with UDD No. 7 Requirements

The project has been designed to generally conform to the guidelines set in the Urban Design District Number 7 and the following items have been incorporated into the design of the proposed project:

- The building has been placed 10' back from the property line on Park Street in accordance with the guidelines and direction from City Staff.
- All of the commercial space along with the building lobby face Park Street and have direct connections to the public sidewalk.
- The exterior design of the building utilizes low-maintenance materials via the use of masonry, cast stone, and composite siding. These materials are also harmonious with the adjacent buildings in this area. All elevations have a high level of detailing and use of the same materials such that there are no lesser quality facades or views from surrounding properties.
- The building entries have canopies over them along with large doors and windows to enhance the pedestrian character of the street.
- Any mechanical equipment located on the roof will not be visible from adjacent properties and any ground mounted equipment will be screened with landscaping.
- The parking areas are contained within or below the building such that any lighting will be directed downward and there will be no glare onto adjacent properties.
- The building has a step back that occurs at the fifth floor level based on the feedback we received at the UDC Informational presentation and with this the fifth floor level is not visible from the street directly in front of the building.
- The trash receptacles are located within the enclosed parking garage area and are not visible from the exterior.
- By having all the parking areas contained within and below the building they are screened from view of the neighboring properties.
- The landscaping plan has been designed with numerous plantings around the proposed building and we have also enhanced the landscaping directly in front of the building in order to create a pleasant experience as you approach the building.
- The outdoor plaza area is also well landscaped and provides an enjoyable outdoor amenity for all the residents of the building.

Site Development Data:

Densities:	
Lot Area	25,703 s.f. / .59 acres
Dwelling Units	62
Density	105 units/acre
Open Space	12,276 s.f. (12,160 s.f. Required)
Lot Coverage	19,051 s.f. / 74% (21,847 s.f. / 85% Max)
Building Height:	4 to 5 Stories / 60'
Gross Floor Area:	
Residential Area:	60,642 s.f.
Commercial Area:	4,062 s.f.
Parking:	<u>31,288 s.f.</u>
Total Building Area:	95,992 s.f.
Floor Area Ratio	3.73
Dwelling Unit Mix:	
Efficiency	12
One Bedroom	36

Letter of Intent – September 16, 2020 – Conditional Use 1224 S Park St - Madison, WI Page 4 of 4

	<u>Two Bedroom</u>	14
	Total Dwelling Units	62
<u>Vehicle</u>	Parking:	
	Surface:	9 stalls
	Enclosed:	69 stalls
	Total	78 stalls
	Parking Ratio:	I.26 stalls / d.u.
D : 1	D 11	
Bicycle	Parking:	
	Surface Commercial:	4
	Surface Guest	6
	Basement; Floor Mount:	46
	Basement; Wall Mount:	<u> 6</u>
	Total:	72

Project Schedule:

It is anticipated that construction will start in the Spring of 2021 and be completed in the Spring of 2022.

Thank you for your time reviewing our proposal.

Sincerely,

Keni Bun

Kevin Burow, AIA, NCARB, LEED AP Managing Member

From:	Stacey Oehrke
Sent:	Friday, July 31, 2020 8:21 AM
То:	'Evers, Tag'; 'Carrie Rothburd'; 'leftpaintedtoenail@hotmail.com';
	smba@smba-madison.org
Cc:	Kevin Burow; Zoning
Subject:	30 Day Notice - 1224 S Park St
Attachments:	1224 S Park Street - Concept Plan - R.pdf

Hello Alder Evers and the Bay Creek Neighborhood Association,

I would like to take this opportunity to formally notify you of a new proposed development in your neighborhood. Attached are the conceptual plans for the proposed redevelopment of 1224 S Park Street. We are proposing a 3-5 story, mixed-use building with Commercial Space on the first floor and approximately 60 apartment units above. There will be underground parking along with parking at the first floor level. The site currently has a 1 story commercial building with surface parking and some lower level parking accessed off of High Street. We intend to make a submittal on September 2nd to begin the process for the required Land Use approvals from the City of Madison and look forward to working with you as we develop the designs for this project.

If you have any questions please contact Kevin Burow: kburow@knothebruce.com

Thank you for your time.

Thank you,

Stacey Oehrke | Permit Specialist | Knothe & Bruce Architects, LLC | Ph: 608.836.3690 (Ex. 115) 7601 University Avenue, Middleton, WI 53562 | <u>soehrke@knothebruce.com</u>



City of Madison Fire Department

314 W Dayton Street, Madison, WI 53703-2506 Phone: 608-266-4420 • Fax: 608-267-1100 • E-mail: fire@cityofmadison.com

Project Address: 1224 S PARK ST

Contact Name & Phone #: KEVIN BUROW 608-836-3690

FIRE APPARATUS ACCESS AND FIRE HYDRANT WORKSHEET

 Is the building completely protected by an NFPA 13 or 13R automatic fire sprinkler system? If non-sprinklered, fire lanes extend to within 150-feet of all portions of the exterior wall? If sprinklered, fire lanes are within 250-feet of all portions of the exterior wall? 	X Yes Yes X Yes	No No No	N/A N/A N/A
 2. Is the fire lane constructed of concrete or asphalt, designed to support a minimum load of 85,000 lbs? a) Is the fire lane a minimum unobstructed width of at least 20-feet? b) Is the fire lane unobstructed with a vertical clearance of at least 13½-feet? c) Is the minimum inside turning radius of the fire lane at least 28-feet? d) Is the grade of the fire lane not more than a slope of 8%? e) Is the fire lane posted as fire lane? (Provide detail of signage.) f) Is a roll-able curb used as part of the fire lane? (Provide detail of curb.) g) Is part of a sidewalk used as part of the required fire lane? (Must support +85,000 lbs.) 	X Yes X Yes X Yes X Yes X Yes Yes Yes Yes Yes	□ No □ No □ No □ No □ No ■ No ■ No ■ No	□ N/A □ N/A □ N/A □ N/A □ N/A □ N/A □ N/A
3. Is the fire lane obstructed by security gates or barricades? If yes:a) Is the gate a minimum of 20-feet clear opening?b) Is an approved means of emergency operations installed, key vault, padlock or key switch?	☐ Yes ☐ Yes ☐ Yes	X No No No	N/A N/A N/A
4. Is the Fire lane dead-ended with a length greater than 150-feet? If yes, does the area for turning around fire apparatus comply with IFC D103?	Yes Yes	X No No	N/A N/A
5. Is any portion of the building to be used for high-piled storage in accordance with IFC Chapter 3206.6 If yes, see IFC 3206.6 for further requirements.	Yes	X No	N/A
6. Is any part of the building greater than 30-feet above the grade plane?	X Yes	🗌 No	N/A
 If yes, answer the following questions: a) Is the aerial apparatus fire lane parallel to one entire side of the building and covering at least 25% of the perimeter? b) Is the near edge of the aerial apparatus fire lane between 15' and 30' from the building? c) Are there any overhead power or utility lines located across the aerial apparatus fire lane? d) Are there any tree canopies expected to grow across the aerial fire lane? (Based on mature canopy width of tree species) 	X Yes X Yes X Yes Yes	☐ No ☐ No ☐ No X No	□ N/A □ N/A □ N/A □ N/A
e) Does the aerial apparatus fire lane have a minimum unobstructed width of 26-feet?f) Is the space between the aerial lane and the building free of trees exceeding 20' in heights?	X Yes Yes	🗌 No 🔀 No	□ N/A □ N/A
7. Are all portions of the required fire lanes within 500-feet of at least (2) hydrants?	X Yes	No	N/A
 Note: Distances shall be measured along the path of the hose lay as it comes off the fire apparatus. a) Is the fire lane at least 26' wide for at least 20-feet on each side of the hydrants? b) Is there at least 40' between a hydrant and the building? c) Are the hydrant(s) setback no less than 5-feet nor more than 10-feet from the curb or edge of the street or fire lane? 	X Yes X Yes X Yes	☐ No ☐ No ☐ No	□ N/A □ N/A □ N/A
 d) Are hydrants located in parking lot islands a minimum of 3½-feet from the hydrant to the curb? e) Are there no obstructions, including but not limited to: power poles, trees, bushes, fences, posts located, or grade changes exceeding 1½-feet, within 5-feet of a fire hydrant? 	Yes Yes	🗙 No 🗌 No	□ N/A □ N/A

Attach an additional sheet if further explanation is required for any answers.

This worksheet is based on MGO 34.503 and IFC 2015 Edition Chapter 5 and Appendix D; please see the codes for further information.



Specifications

Width:

Height:

Depth:

Weight:







Catalog Number Notes

Туре

iit the Tab key or mouse over the page to see all interactive elements.

Introduction

LIL LED is a compact and energy efficient wall luminaire ideal for replacing small incandescent and CFL luminaires. Photocell and battery pack options make LIL LED great for installations above doors, balconies, garage or warehouse entrances, and security applications. Whether directly mounting to a recessed junction box, or using the back box accessory for conduit entry/through wiring, LIL LED has you covered!

Ordering Information

Standard

5-1/8"

2-3/4"

1.5 lbs

5'

EXAMPLE: LIL LED 40K MVOLT WH

LIL LED					
Series	Color Temperature	Voltage	Controls	Mounting	Finish
LIL LED	30K 3000 K 40K 4000 K	MVOLT 120 / 277V ¹	(blank) None PE MVOLT button photocell ^{1,2} EL Battery pack ²	(blank) None BB Back box accessory for conduit wiring ³	DDBTXD Textured dark bronze WH White

Accessories Ordered and shipped separately.			
LIL LED BB DDBTXD	Back box for conduit entry applications, dark bronze - CI Code *249WXH		
LIL LED BB WH	Back box for conduit entry applications, white - CI Code *249WXJ		

With Battery

Pack(EL)

5-7/8"

6-1/8"

4-1/4"

3 lbs

FEATURES & SPECIFICATIONS

INTENDED USE

The versatility of LIL LED combines a sleek, compact profile with photocell and emergency battery pack options to provide a great solution for wall mount applications. LIL LED is ideal for replacing up to 100W incandescent or 32W CFL luminaires in installations above doors, balconies, garage or warehouse entrances, and security applications. It can also be used for decorative and general lighting in outdoor environments.

CONSTRUCTION

Aluminum housing with white or textured dark bronze paint for lasting durability. The polycarbonate lens creates uniform light distribution, and it is UV resistant - great for outdoor environments!

OPTICS

Light engines are available in 3000K and 4000K CCTs. See Lighting Facts label and photometry reports for specific fixture performance.

ELECTRICAL

LED technology provides long operating life (L70/50,000 hours at 25°C). Electronic drivers have a power factor >90% and THD <20% and a minimum 2.5kV surge rating.

NOTES

1. MVOLT driver operates on 120V and 277V (50/60Hz).

- 2. PE and EL cannot be ordered together.
- Optional accessory for conduit entry wiring. Can be ordered with the luminaire or separately. Shipped separately. BB option is not available with emergency battery pack (EL) version.

INSTALLATION

Easily mounts to recessed junction boxes or for surface mounting and conduit entry — with the back box with two 1/2" threaded conduit entry hubs.

This luminaire is mounted with the lens facing down. Neutral wire is required for three phase input.

LISTINGS

UL Listed to U.S. and Canadian safety standards for wet locations. Rated for -40° C minimum to 40° C maximum ambient temperature. Battery pack versions are rated to 0° C minimum. Tested in accordance with IESNA LM-79 and LM-80 standards.

DesignLights Consortium® (DLC) qualified product. Not all versions of this product may be DLC qualified. Please check the DLC Qualified Products List at www.designlights.org/QPL to confirm which versions are qualified.

Eligible to be submitted for Title 20 and Title 24 compliance.

WARRANTY

5-year limited warranty. Complete warranty terms located at: www.acuitybrands.com/CustomerResources/Terms_and_conditions.aspx

Note: Actual performance may differ as a result of end-user environment and application. All values are design or typical values, measured under laboratory conditions at 25°C. Specifications subject to change without notice.



One Lithonia Way • Conyers, Georgia 30012 • Phone: 800.705.7378 • www.lithonia.com © 2017-2019 Acuity Brands Lighting, Inc. All rights reserved.

Lumen Output

Lumen values are from photometric tests performed in accordance with IESNA LM-79-08. Data is considered to be representative of the configurations shown, within the tolerances allowed by Lighting Facts.

Model Number	ССТ	Rated Power	Lumens	LPW
LIL LED	3000K	8.4W	800	95

Electrical Load

		Input current at given input voltage (amps)			
Model Number	Rated Power	120V	208V	240V	277V
LIL LED	8.4W	0.07	0.04	0.03	0.03

Projected LED Lumen Maintenance


Data references the extrapolated performance projections in a **25°C ambient**, based on 10,000 hours of LED testing (tested per IESNA LM-80-08 and projected per IESNA TM-21-11).

To calculate LLF, use the lumen maintenance factor that corresponds to the desired number of operating hours below. For other lumen maintenance values, contact factory.

Operating Hours	0	25,000	50,000
LIL LED	1.00	0.92	0.85

Photometric Diagrams

To see complete photometric reports or download .ies files for this product, visit the Lithonia Lighting LIL LED homepage. Tested in accordance with IESNA LM-79 and LM-80 standards

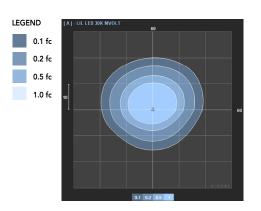


Accessories


LIL LED BBW DDBTXD LIL LED BBW WH Back box for conduit entry applications, dark bronze Back box for conduit entry applications, white







Dimensions

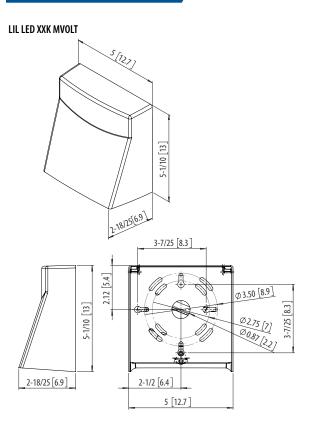

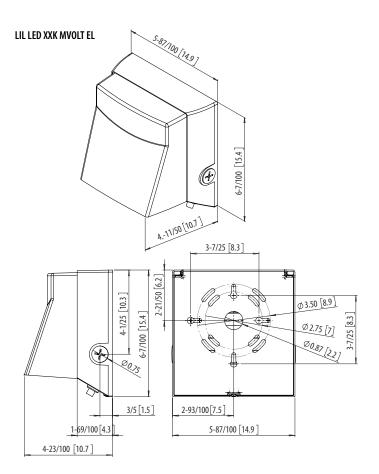



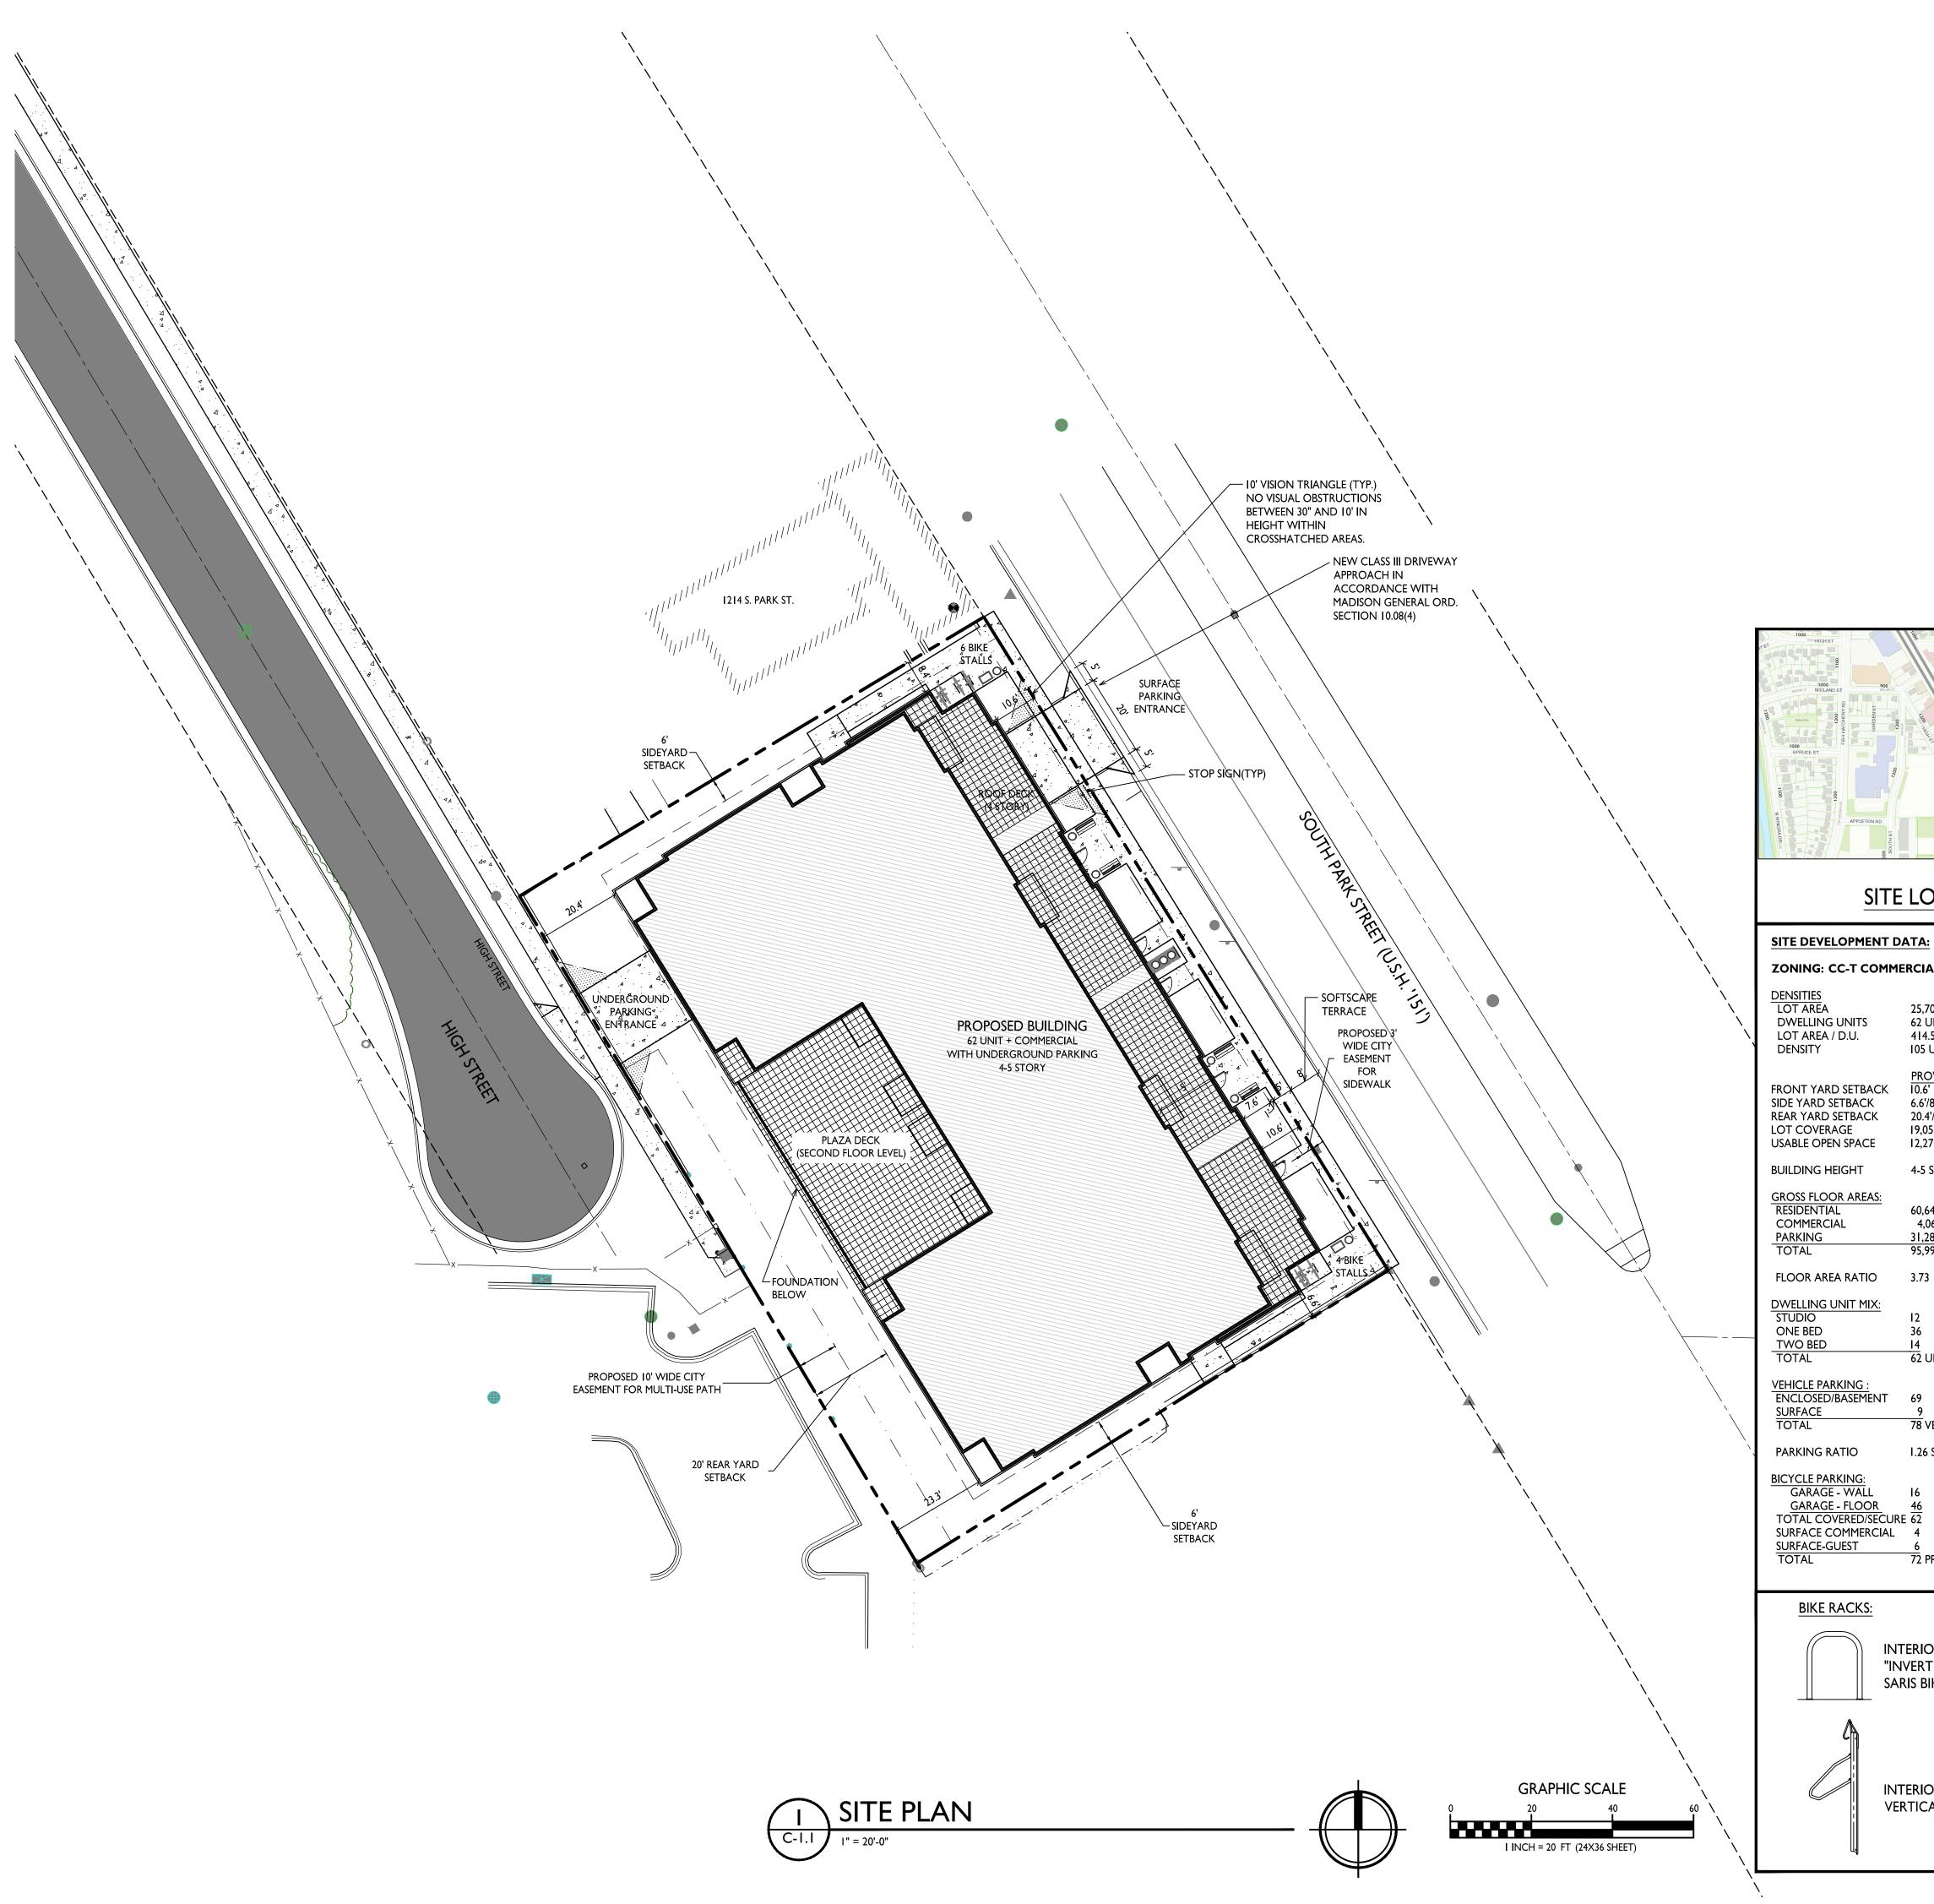

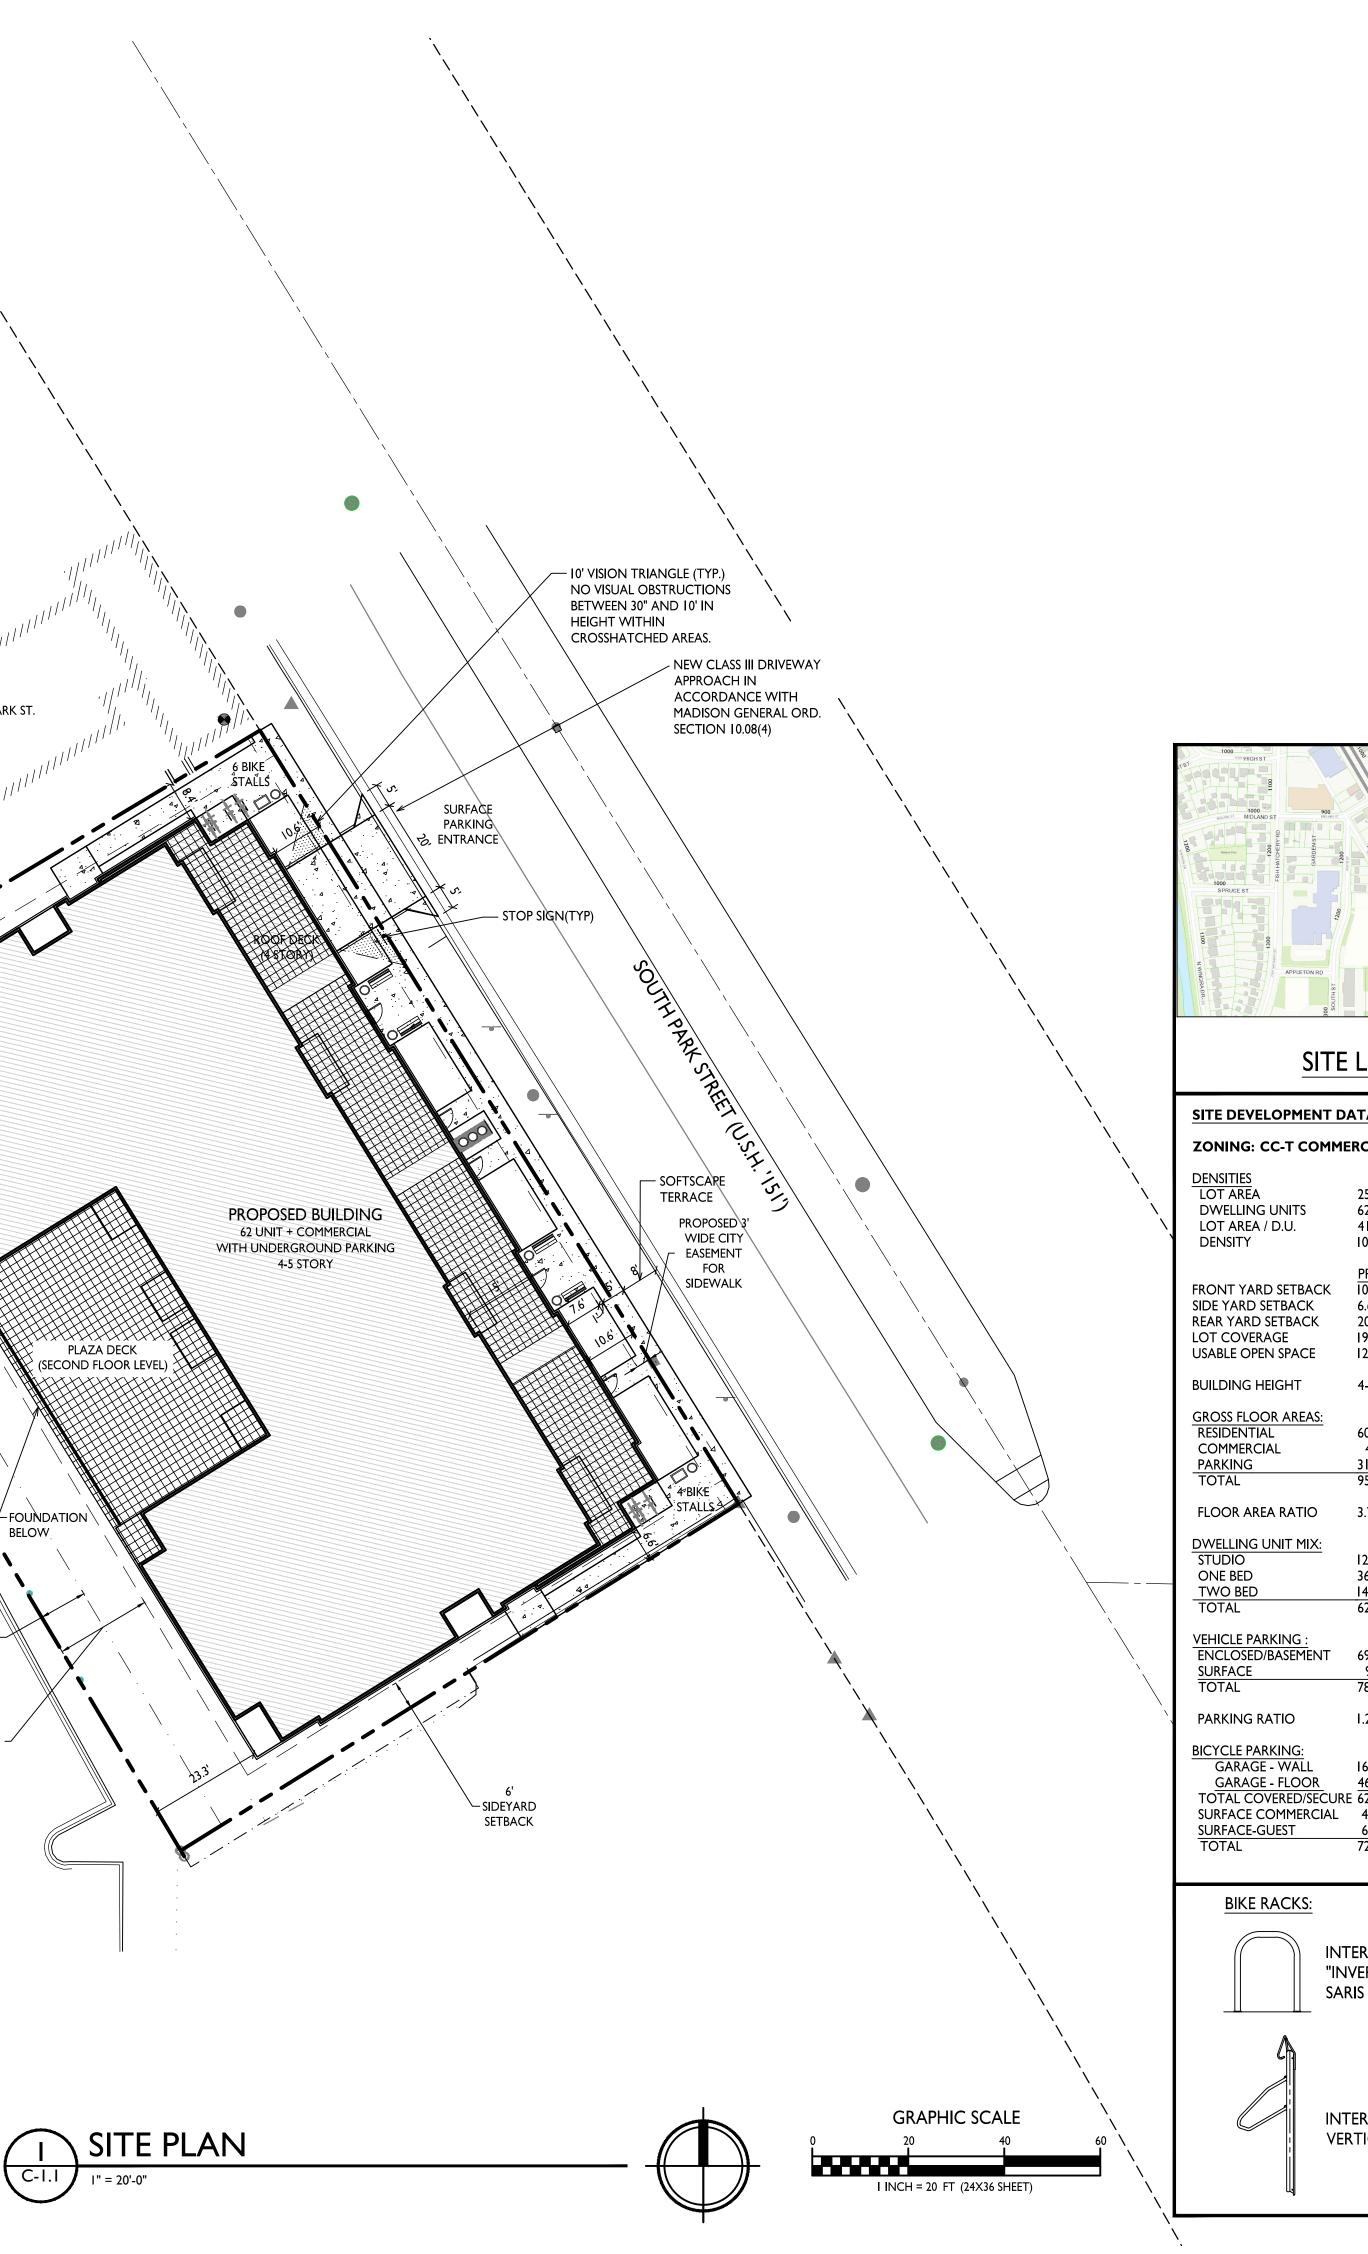

	FOO EMERSON ST
Contractory 138	
W OLIN AVE	700 600 W CAN ANY W OLIN AVE
N 1111 13	IS ADDO
	SPRUCE ST - CEDAR STALLEY SPRUCE ST - CEDAR S
1118	
CEDAR ST	CEDAR ST & CEDAR ST
	BELO CEDAR ST-PINE STALLEY

SITE LOCATOR MAP

ZONING: CC-T COMMERCIAL CORRIDOR TRANSITIONAL DISTRICT

. (85% MAX.)

,703 S.F./.59 ACRES	
UNITS	
4.5 S.F./UNIT	
5 UNITS/ACRE	

ROVIDED	REQUIRE
.6'	25' MAX.
6'/8.25'	6' MIN.
).4'/23.3'	20' MIN.
,051 S.F. (74%)	21,847 S.F
,276 S.F. `	12,160 S.F.


4-5 STORIES/48'-60' 5 STORIES/68'

60,642 S.F. 4,062 S.F. 31,288 S.F. 95,992 S.F.

62 UNITS

78 VEHICLE STALLS

1.26 STALLS/UNIT

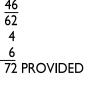

62 RESIDENTIAL 2 (1/2,000 S.F.) 6 (10% OF UNITS) 70 MIN. REQUIRED

INTERIOR & EXTERIOR FLOOR MOUNTED: "INVERTED U" TYPE. MADRAX UX OR SARIS BIKE DOCK

INTERIOR WALL MOUNTED: MADRAX VERTICAL RACK OR SARIS BIKE TRACK

SHEET INDEX	X
C-1.1	SITE PLAN
C-1.2	SITE LIGHTING
C-1.3	FIRE DEPARTMENT ACCESS
C-1.4	LOT COVERAGE
C-1.5	USABLE OPEN SPACE
I OF I	EXISTING CONDITIONS
C-1.0	DEMOLITION PLAN
C-2.0	SITE PLAN
C-2.1	SITE PLAN - DIMENSIONED
C-3.0	GRADING & EROSION CONTROL PLAN
C-3.1	DETAILED GRADING PLAN
C-4.0	UTILITY PLAN
C-5.0	SITE CONSTRUCTION DETAILS
L-1.0	LANDSCAPE PLAN
L-1.1	2ND FLOOR PLAZA LANDSCAPE PLAN
L-2.0	LANDSCAPE DETAILS & NOTES
A-1.0	BASEMENT PLAN
A-1.1	FIRST FLOOR PLAN
A-1.2	SECOND FLOOR PLAN
A-1.3	THIRD FLOOR PLAN
A-1.4	FOURTH FLOOR PLAN
A-1.5	FIFTH FLOOR PLAN
A-1.6	ROOF PLAN
A-2.1	ELEVATIONS
A-2.2	ELEVATIONS
A-2.3	COLORED ELEVATIONS
A-2.4	COLORED ELEVATIONS
	RENDERINGS

GENERAL NOTES:

I. THE APPLICANT SHALL REPLACE ALL SIDEWALK AND CURB AND GUTTER THAT ABUTS THE PROPERTY THAT IS DAMAGED BY THE CONSTRUCTION, OR ANY SIDEWALK AND CURB AND GUTTER WHICH THE CITY ENGINEER DETERMINES NEEDS TO BE REPLACED BECAUSE IT IS NOT AT A DESIRABLE GRADE, REGARDLESS OF WHETHER THE CONDITION EXISTED PRIOR TO BEGINNING CONSTRUCTION.

2. ALL WORK IN THE PUBLIC RIGHT OF WAY SHALL BE PERFORMED BY A CITY-LICENSED CONTRACTOR.

3. ALL DAMAGE TO THE PAVEMENT ON CITY STREETS, AND ADJACENT TO THIS DEVELOPMENT SHALL BE RESTORED IN ACCORDANCE WITH THE CITY OF MADISON'S PAVEMENT PATCHING CRITERIA.

4. ALL PROPOSED STREET TREE REMOVALS WITHIN THE RIGHT OF WAY SHALL BE REVIEWED BY CITY FORESTRY BEFORE THE PLAN COMMISSION MEETING. STREET TREE REMOVALS REQUIRE APPROVAL AND A TREE REMOVAL PERMIT ISSUED BY CITY FORESTRY. ANY STREET TREE REMOVALS REQUESTED AFTER THE DEVELOPMENT PLAN IS APPROVED BY THE PLAN COMMISSION OR THE BOARD OF PUBLIC WORKS AND CITY FORESTRY WILL REQUIRE A MINIMUM OF A 72-HOUR REVIEW PERIOD WHICH SHALL INCLUDE THE NOTIFICATION OF THE ALDERPERSON WITHIN WHO'S DISTRICT IS AFFECTED BY THE STREET TREE REMOVAL(S) PRIOR TO A TREE REMOVAL PERMIT BEING ISSUED.

5. AS DEFINED BY THE SECTION 107.13 OF CITY OF MADISON STANDARD SPECIFICATIONS FOR PUBLIC WORKS CONSTRUCTION: NO EXCAVATION IS PERMITTED WITHIN 5 FEET OF THE TRUNK OF THE STREET TREE OR WHEN CUTTING ROOTS OVER 3 INCHES IN DIAMETER. IF EXCAVATION IS NECESSARY, THE CONTRACTOR SHALL CONTACT MADISON CITY FORESTRY (266-4816) PRIOR TO EXCAVATION. CITY OF MADISON FORESTRY PERSONNEL SHALL ASSESS THE IMPACT TO THE TREE AND TO ITS ROOT SYSTEM PRIOR TO WORK COMMENCING. TREE PROTECTION SPECIFICATIONS CAN BE FOUND ON THE FOLLOWING WEBSITE: HTTPS://WWW.CITYOFMADISON.COM/BUSINESS/PW/SPECS.CFM

6.CONTRACTOR SHALL TAKE PRECAUTIONS DURING CONSTRUCTION TO NOT DISFIGURE, SCAR, OR IMPAIR THE HEALTH OF ANY STREET TREE. CONTRACTOR SHALL OPERATE EQUIPMENT IN A MANNER AS TO NOT DAMAGE THE BRANCHES OF THE STREET TREE(S). THIS MAY REQUIRE USING SMALLER EQUIPMENT AND LOADING AND UNLOADING MATERIALS IN A DESIGNATED SPACE AWAY FROM TREES ON THE CONSTRUCTION SITE. ANY DAMAGE OR INJURY TO EXISTING STREET TREES (EITHER ABOVE OR BELOW GROUND) SHALL BE REPORTED IMMEDIATELY TO CITY FORESTRY AT 266-4816. PENALTIES AND REMEDIATION SHALL BE REQUIRED.


7.SECTION 107.13(G) OF CITY OF MADISON STANDARD SPECIFICATIONS FOR PUBLIC WORKS CONSTRUCTION ADDRESSES SOIL COMPACTION NEAR STREET TREES AND SHALL BE FOLLOWED BY CONTRACTOR. THE STORAGE OF PARKED VEHICLES, CONSTRUCTION EQUIPMENT, BUILDING MATERIALS, REFUSE, EXCAVATED SPOILS OR DUMPING OF POISONOUS MATERIALS ON OR AROUND TREES AND ROOTS WITHIN FIVE (5) FEET OF THE TREE OR WITHIN THE PROTECTION ZONE IS PROHIBITED.

8.0N THIS PROJECT, STREET TREE PROTECTION ZONE FENCING IS REQUIRED. THE FENCING SHALL BE ERECTED BEFORE THE DEMOLITION, GRADING OR CONSTRUCTION BEGINS. THE FENCE SHALL INCLUDE THE ENTIRE WIDTH OF TERRACE AND, EXTEND AT LEAST 5 FEET ON BOTH SIDES OF THE OUTSIDE EDGE OF THE TREE TRUNK. DO NOT REMOVE THE FENCING TO ALLOW FOR DELIVERIES OR EQUIPMENT ACCESS THROUGH THE TREE PROTECTION ZONE.

9. STREET TREE PRUNING SHALL BE COORDINATED WITH MADISON FORESTRY AT A MINIMUM OF TWO WEEKS PRIOR TO THE START OF CONSTRUCTION FOR THIS PROJECT. ALL PRUNING SHALL FOLLOW THE AMERICAN NATIONAL STANDARDS INSTITUTE (ANSI) A300 - PART I STANDARDS FOR PRUNING.

10. APPROVAL OF PLANS FOR THIS PROJECT DOES NOT INCLUDE ANY APPROVAL TO PRUNE, REMOVE, OR PLANT TREES IN THE PUBLIC RIGHT-OF-WAY. PERMISSION FOR SUCH ACTIVITIES MUST BE OBTAINED FROM THE CITY FORESTER (266-4816).

II. THE PUBLIC RIGHT-OF-WAY IS THE SOLE JURISDICTION OF THE CITY OF MADISON AND IS SUBJECT TO CHANGE AT ANY TIME. NO ITEMS SHOWN ON THIS SITE PLAN IN THE RIGHT-OF-WAY ARE PERMANENT AND MAY NEED TO BE REMOVED AT THE APPLICANTS EXPENSE UPON NOTIFICATION BY THE CITY.

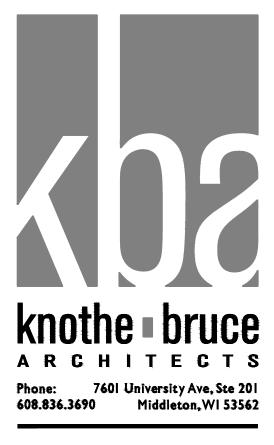

ISSUED Issued for Land Use & UDC - Sept. 16, 2020

PROJECT TITLE PARK STREET DEVELOPMENT


1224 S. Park Street Madison, Wisconsin SHEET TITLE Site Plan


SHEET NUMBER




203 I PROJECT NO. © Knothe & Bruce Architects, LLC


STATISTICS					
DESCRIPTION	SYMBOL	AVG.	MAX.	MIN.	MAX. / M
Underground Parking Entrance Lightin	ng +	I.3 fc	5.2 fc	0.1 fc	52.0:I
LUMINAIRE SCHEDULE					
SYMBOL LABEL QTY. MANUF.	CATALOG	DES	CRIPTION	N	FILE
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EXAMPL	E LIGHT FIXT	URE [DISTRI	BUTIC	DN
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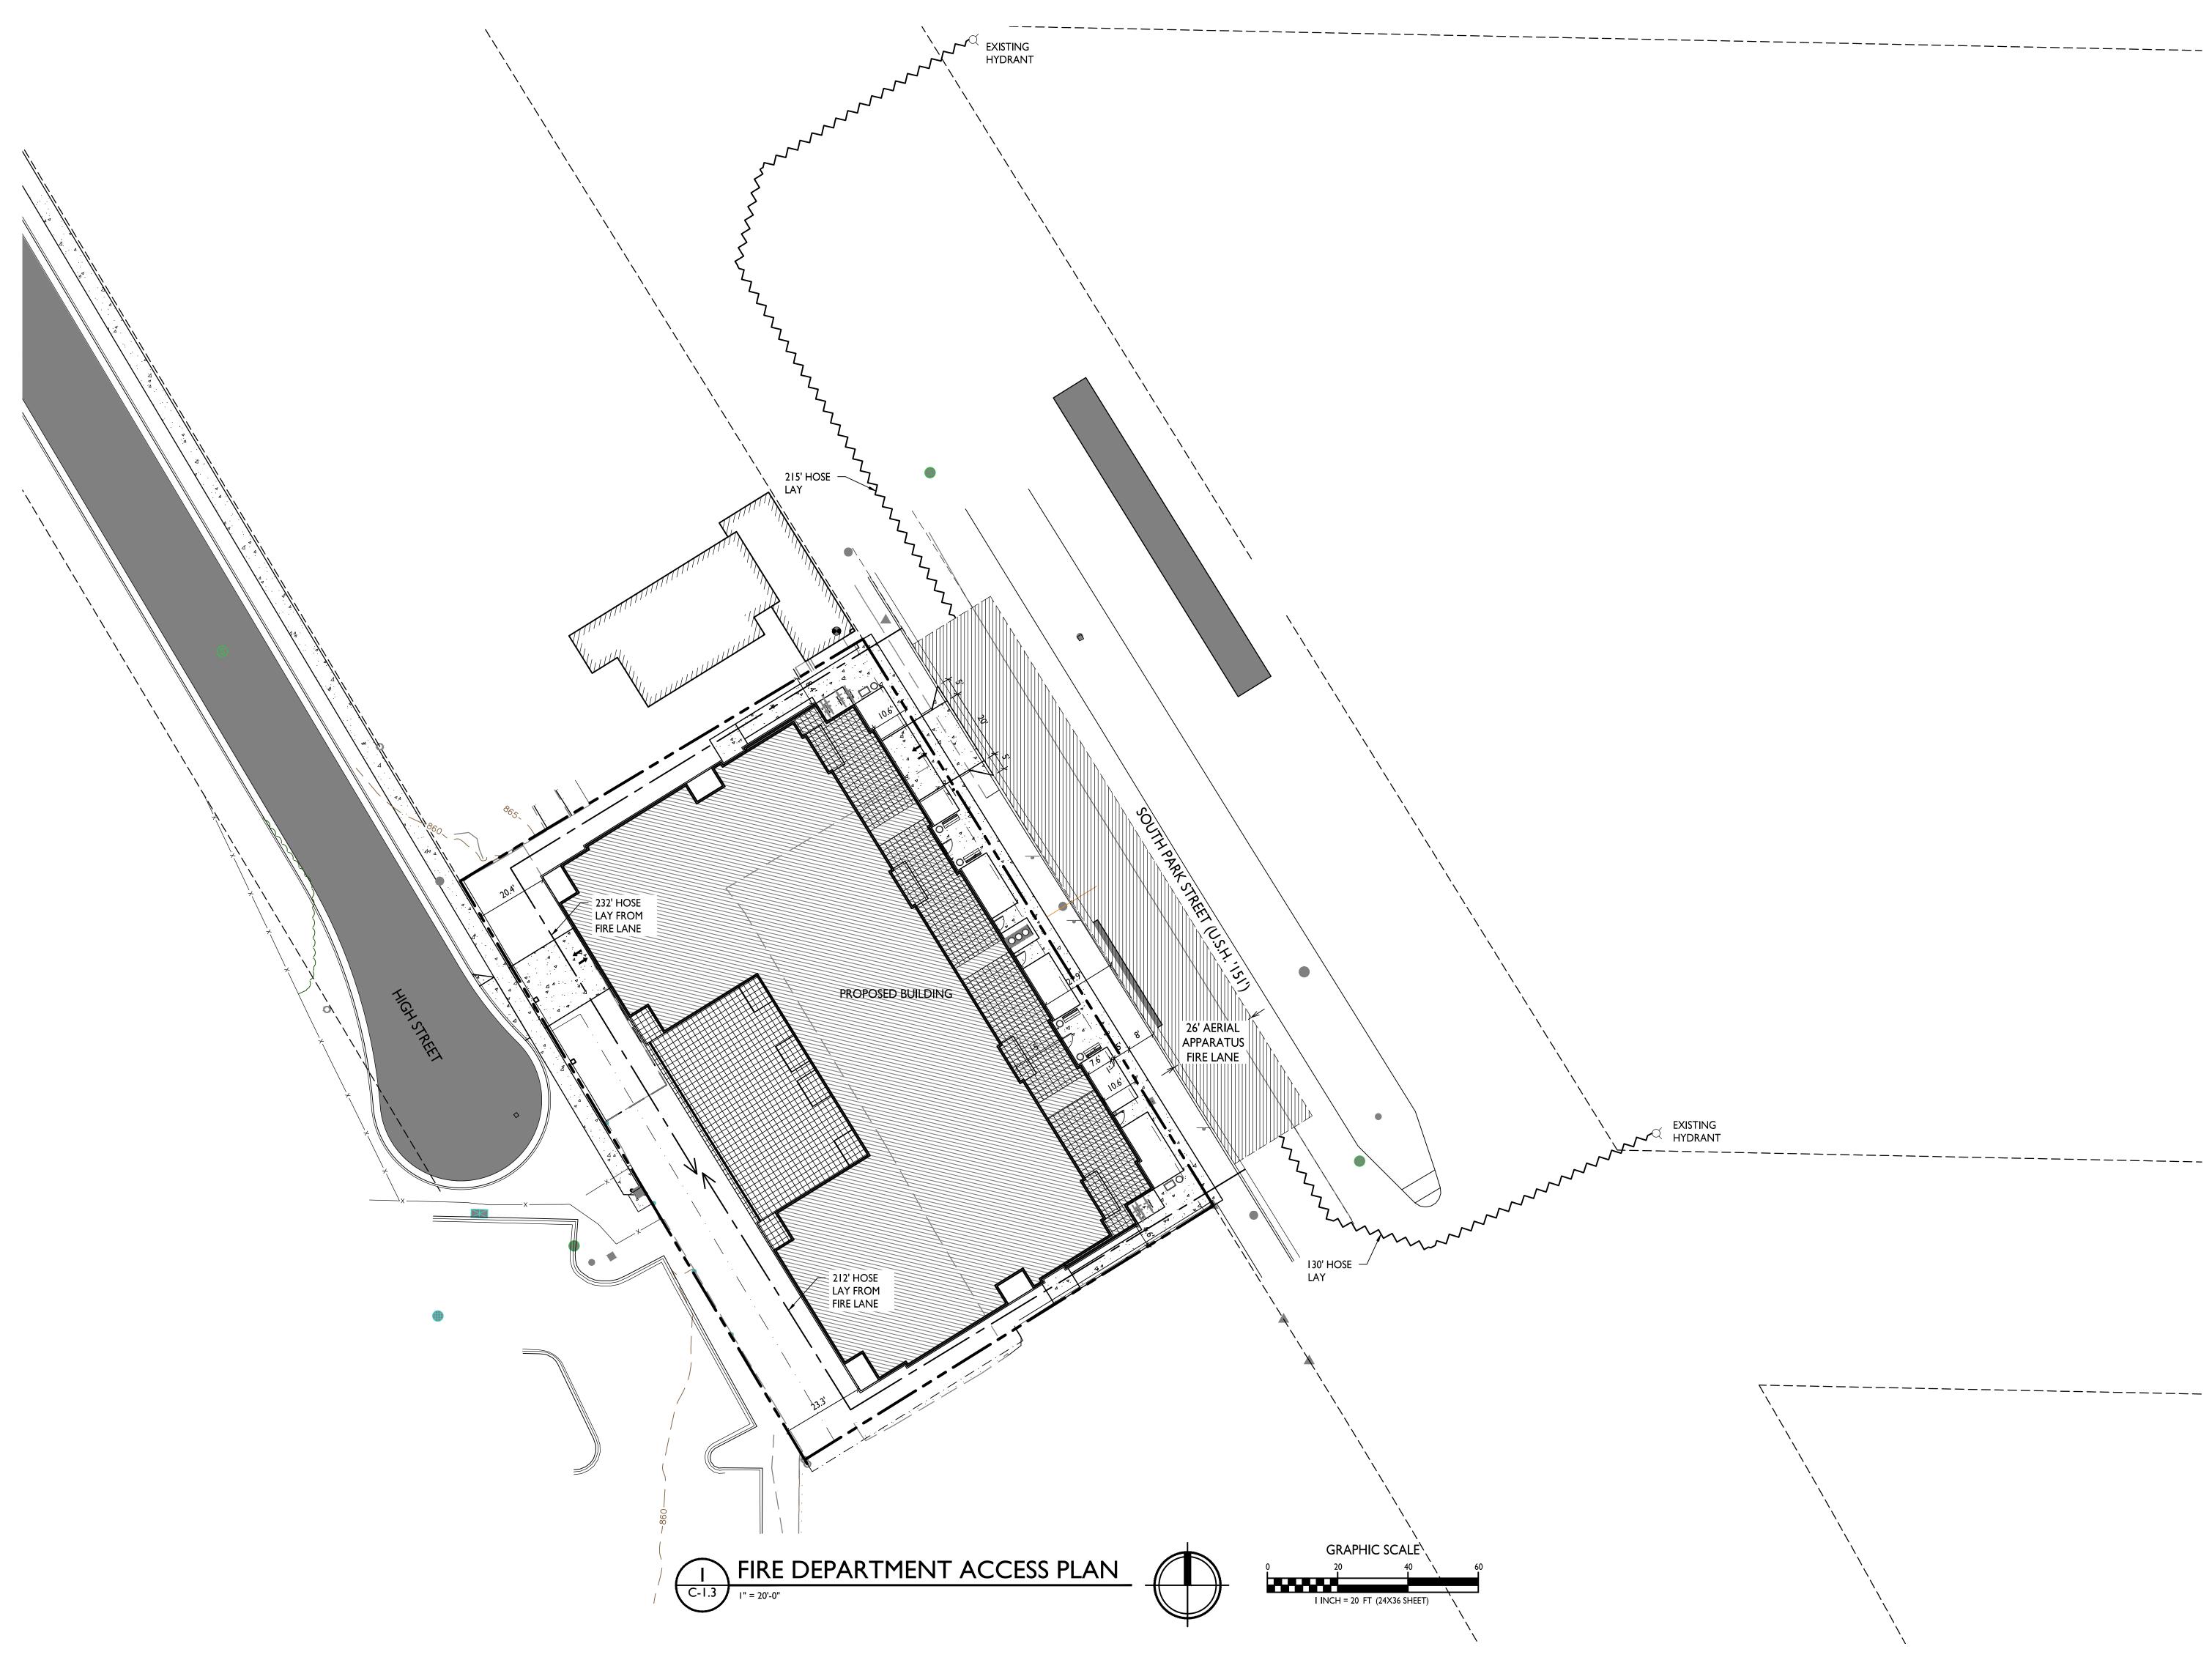
PROJECT TITLE PARK STREET DEVELOPMENT

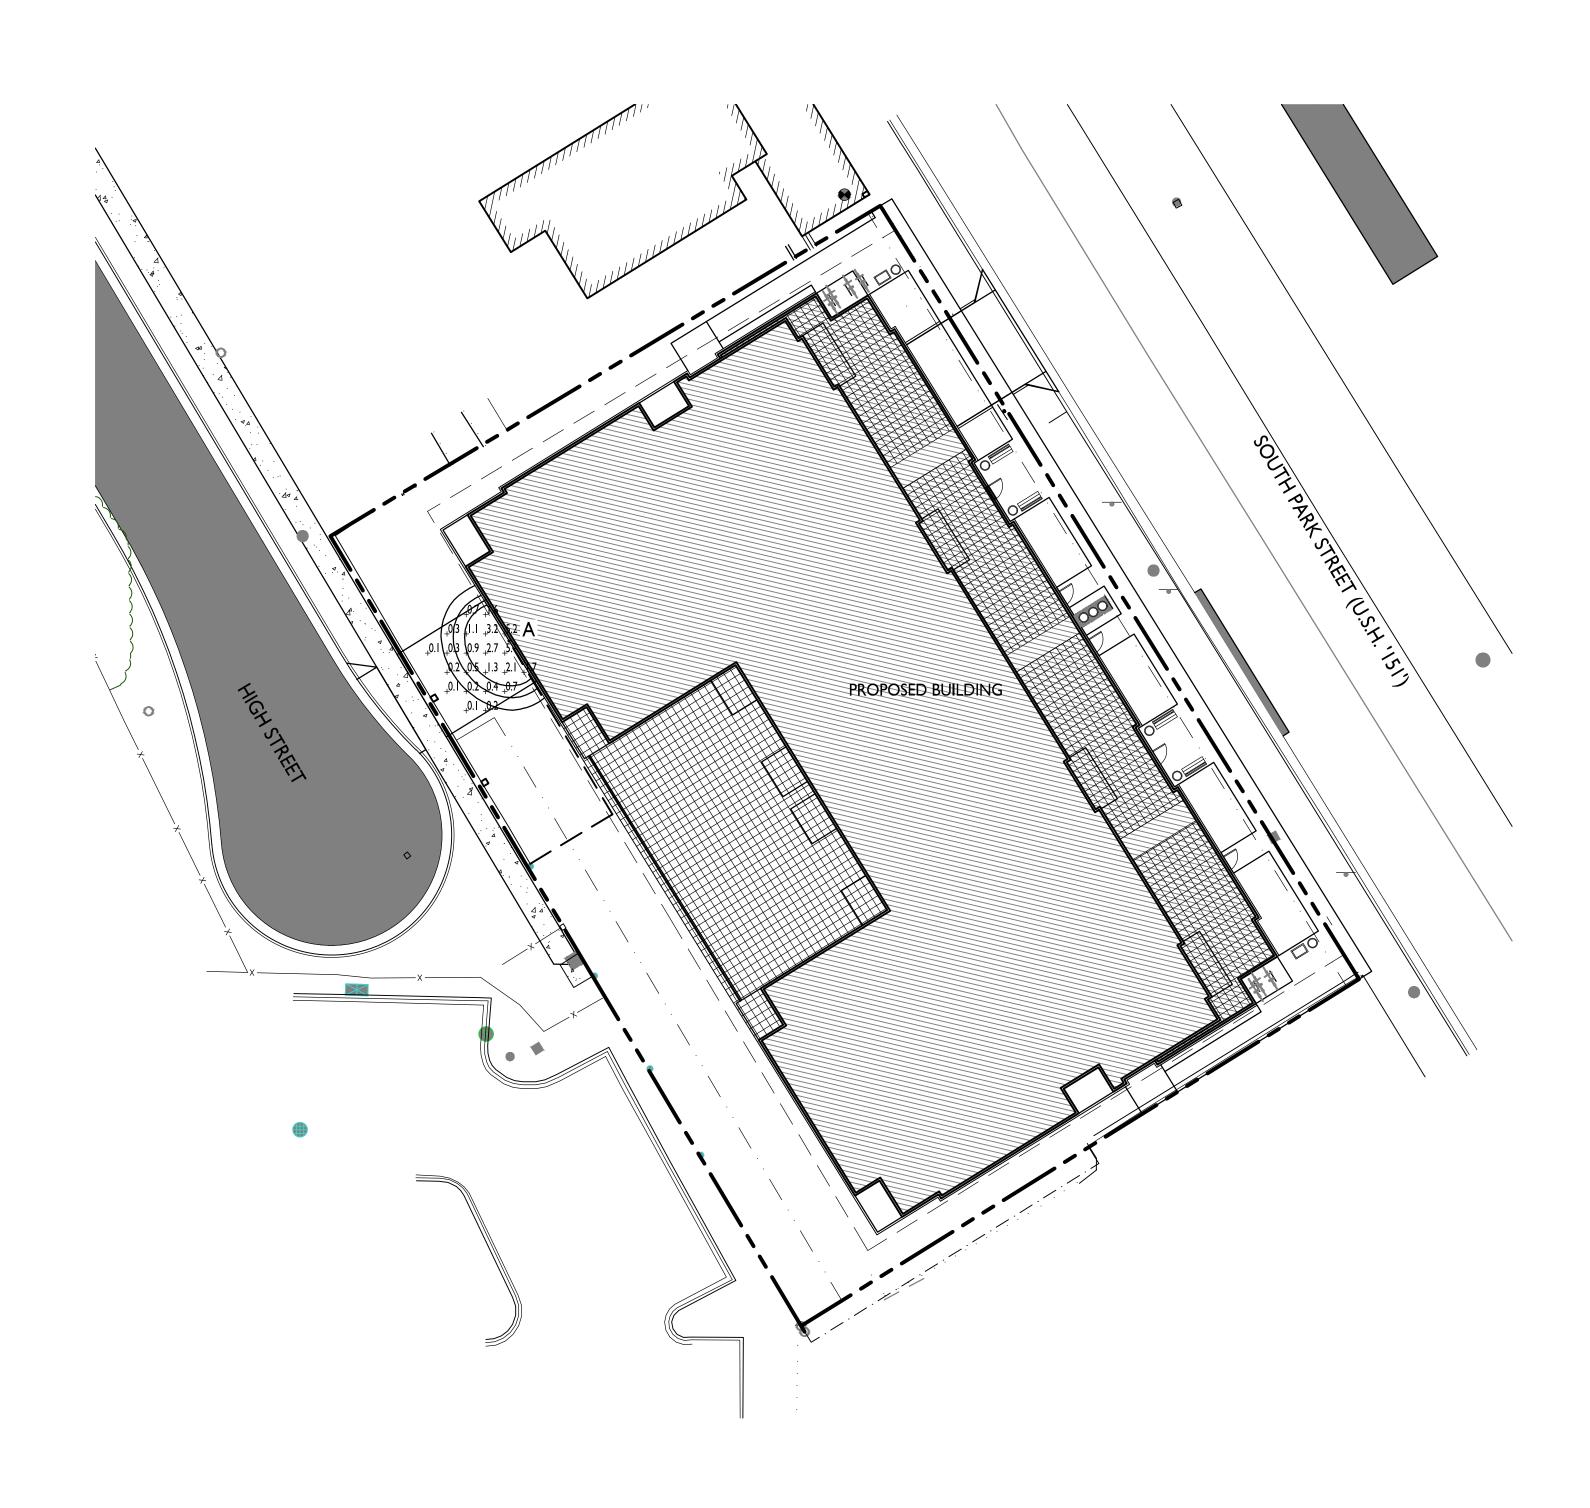
1224 S. Park Street Madison, Wisconsin ^{SHEET TITLE} **Site Lighting Plan**

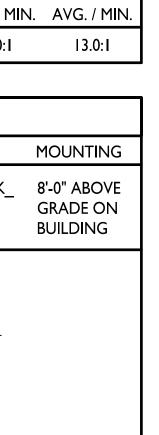SHEET NUMBER

C-1.2 PROJECT NO. 203 I © Knothe & Bruce Architects, LLC

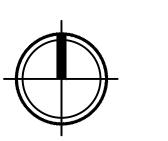GRAPHIC SCALE 0 20 40 60 I INCH = 20 FT (24×36 SHEET)

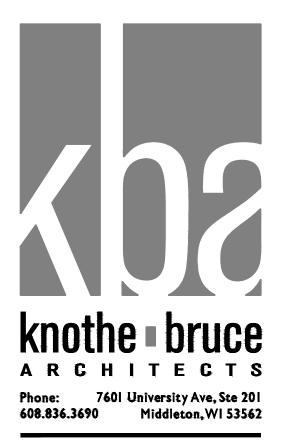

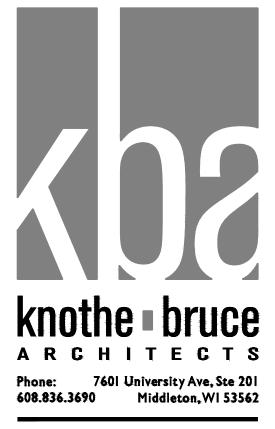

ISSUED Issued for Land Use & UDC- September 16, 2020

PROJECT TITLE PARK STREET DEVELOPMENT


1224 S. Park Street Madison, Wisconsin SHEET TITLE Fire Department Access Plan


SHEET NUMBER

C-I.3 PROJECT NO. 203 I

© Knothe & Bruce Architects, LLC

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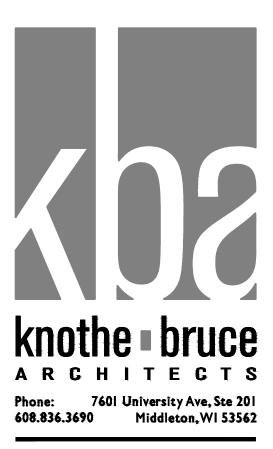


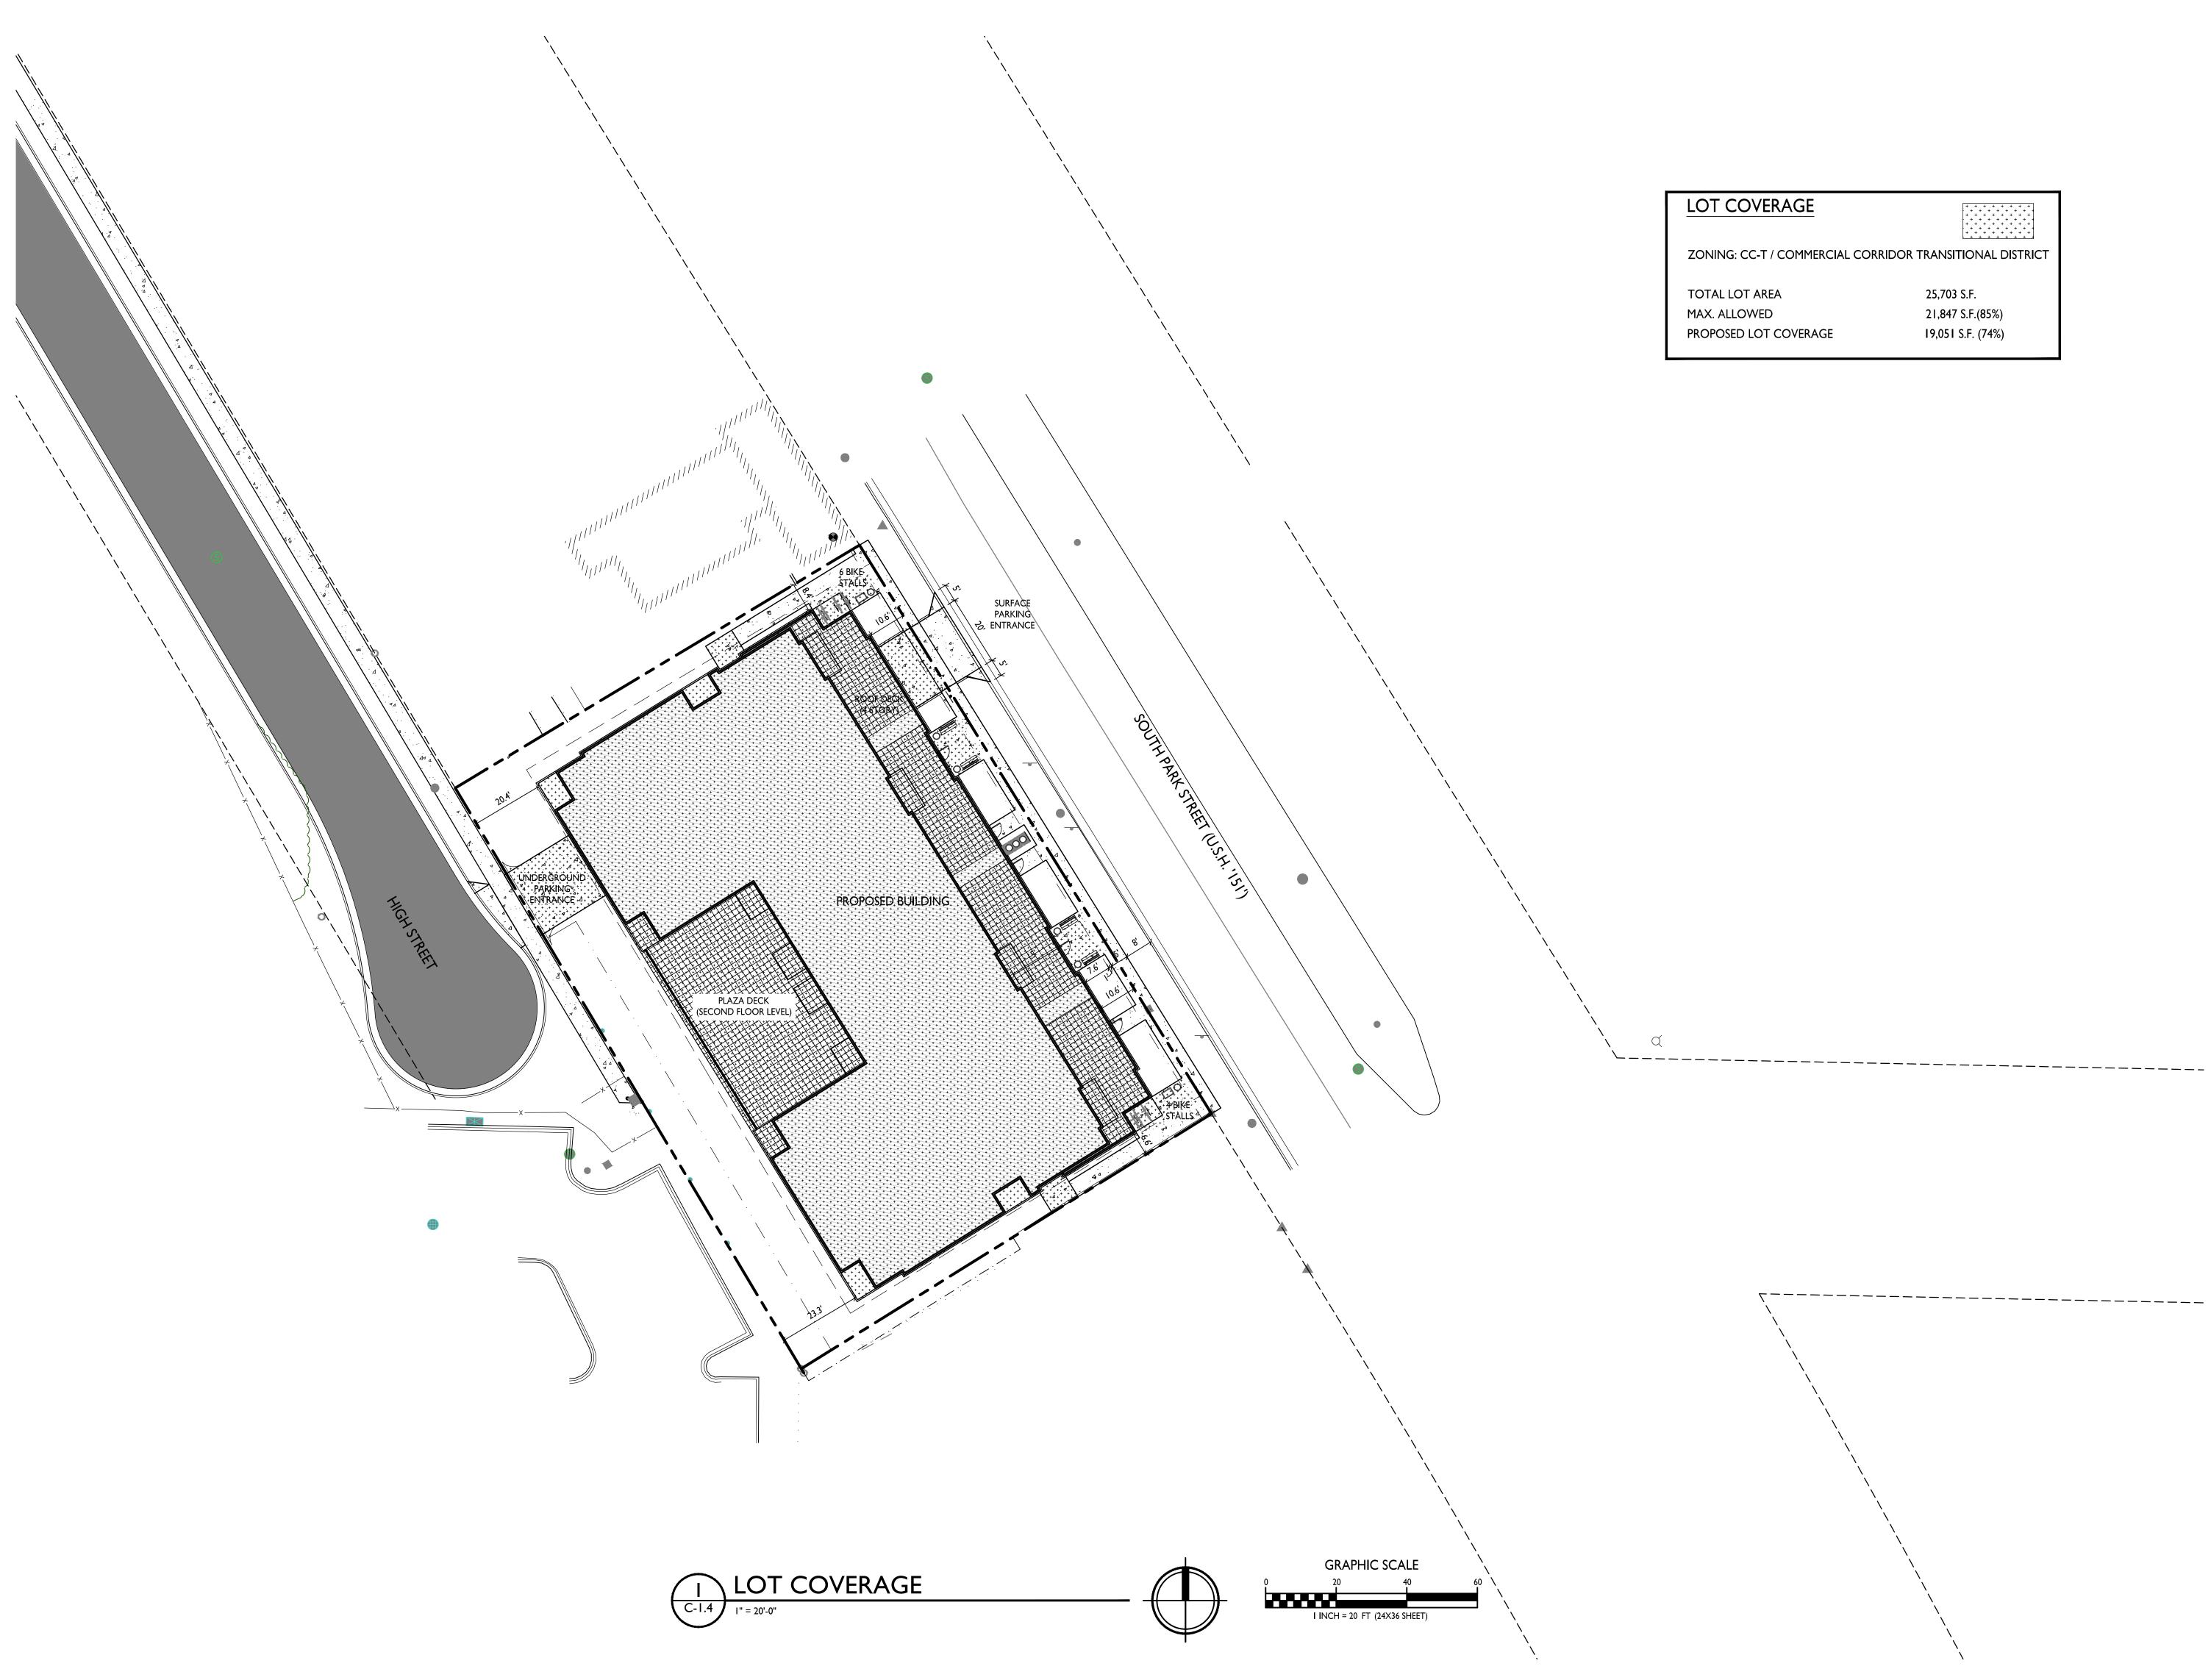LOT COVERAGE

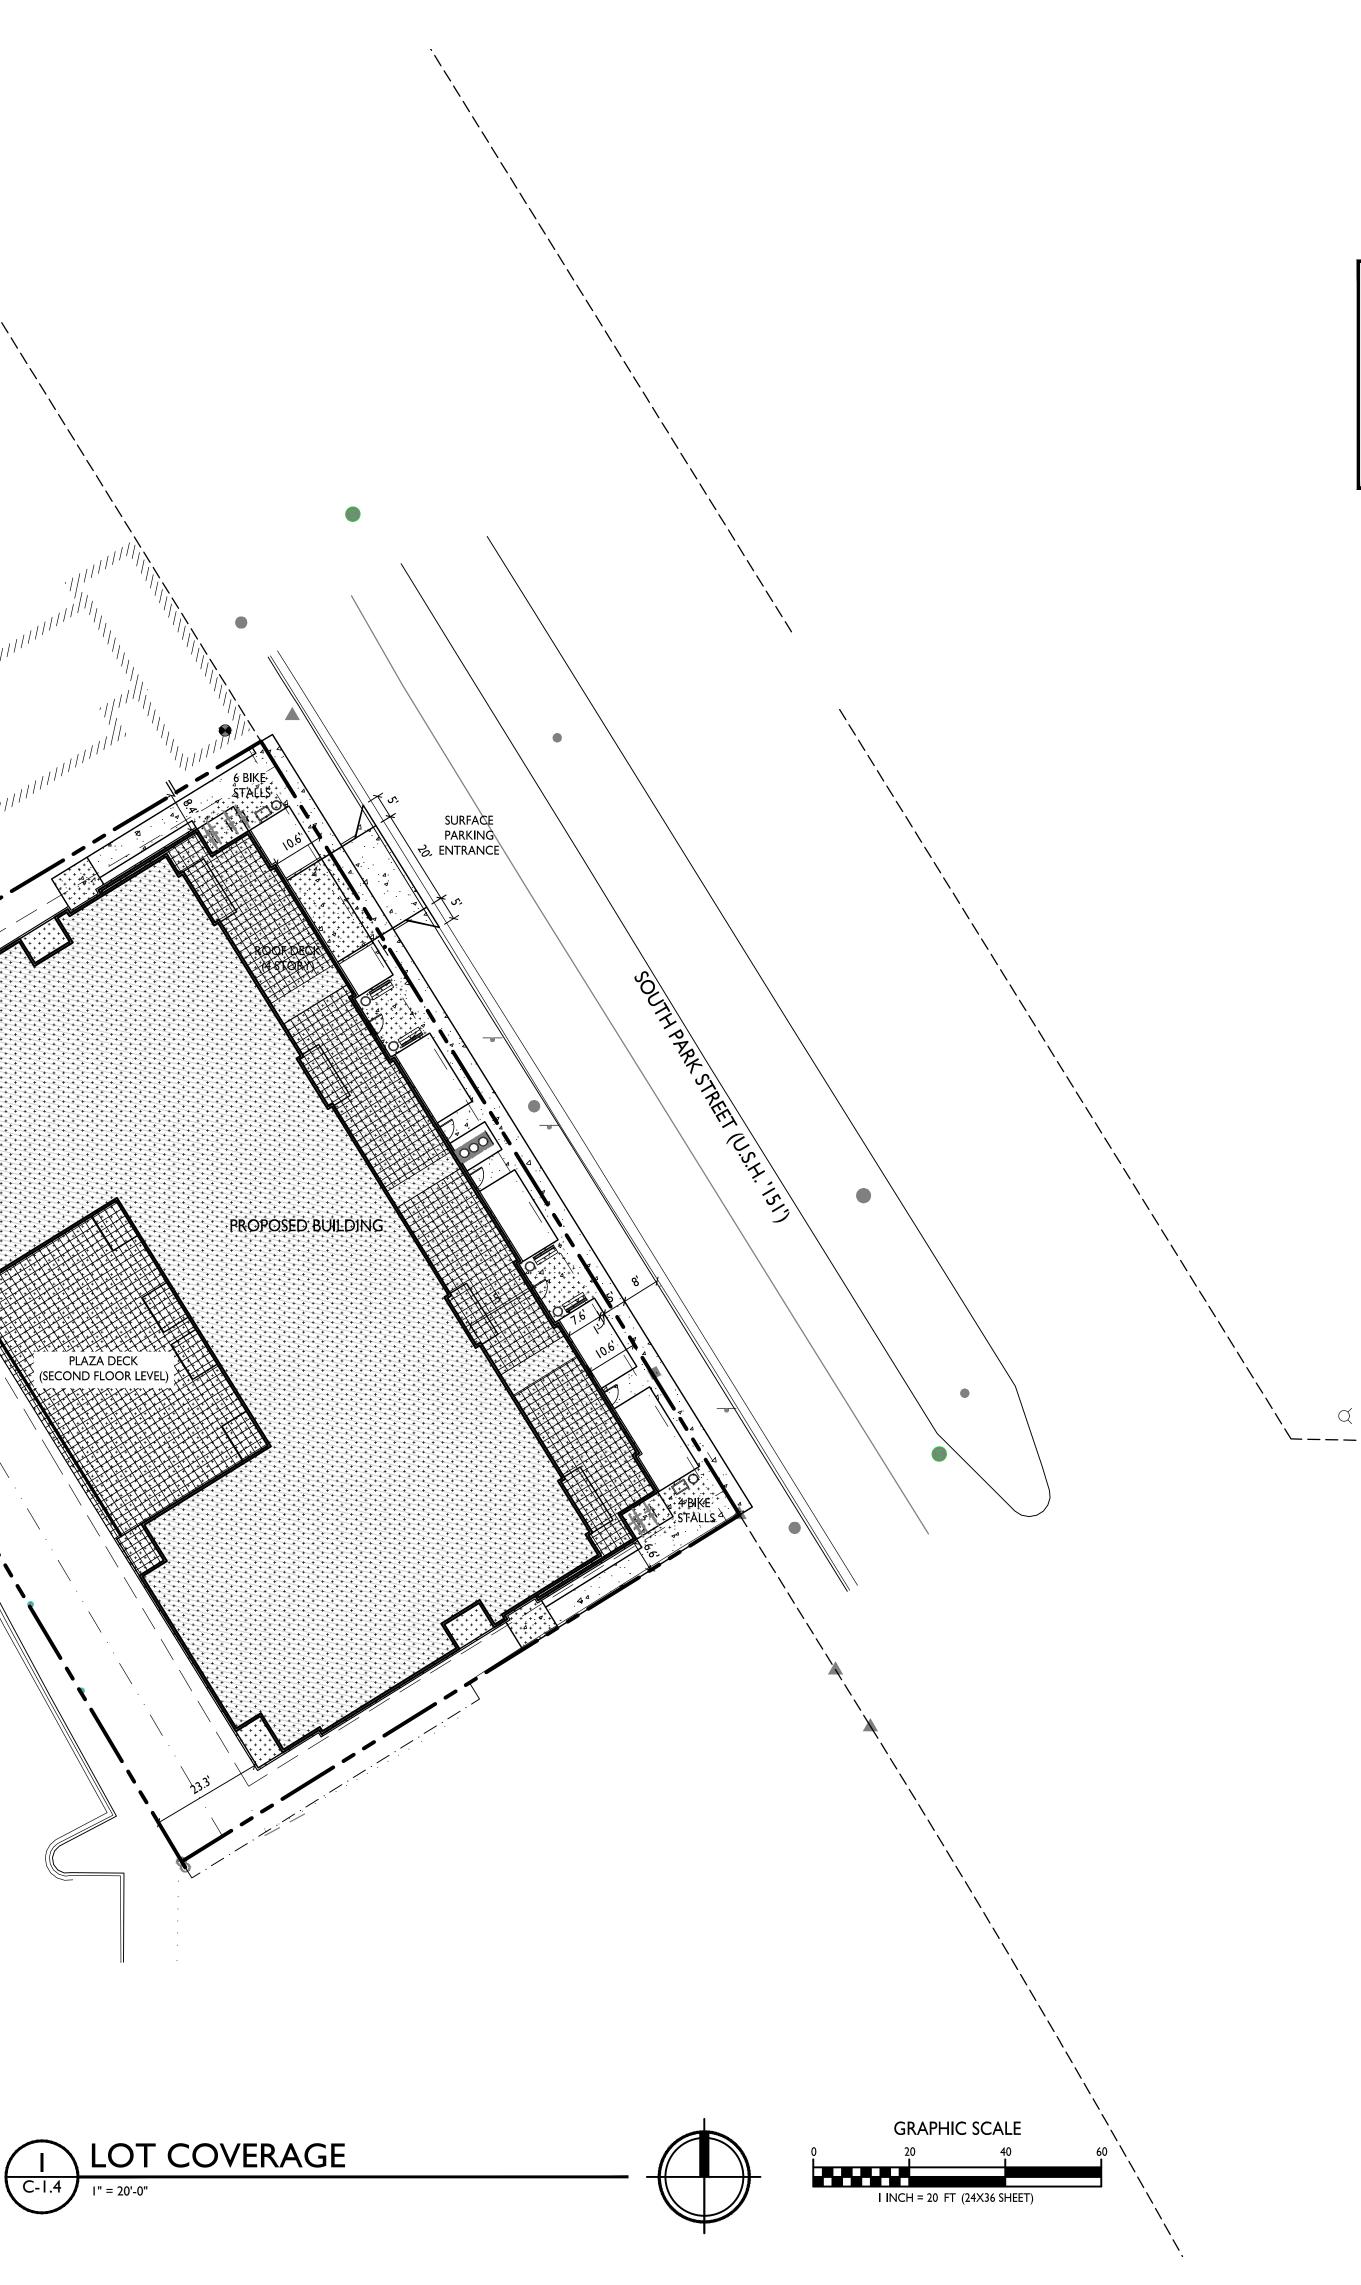ZONING: CC-T / COMMERCIAL CORRIDOR TRANSITIONAL DISTRICT

TOTAL LOT AREA MAX. ALLOWED PROPOSED LOT COVERAGE 25,703 S.F. 21,847 S.F.(85%) 19,051 S.F. (74%)

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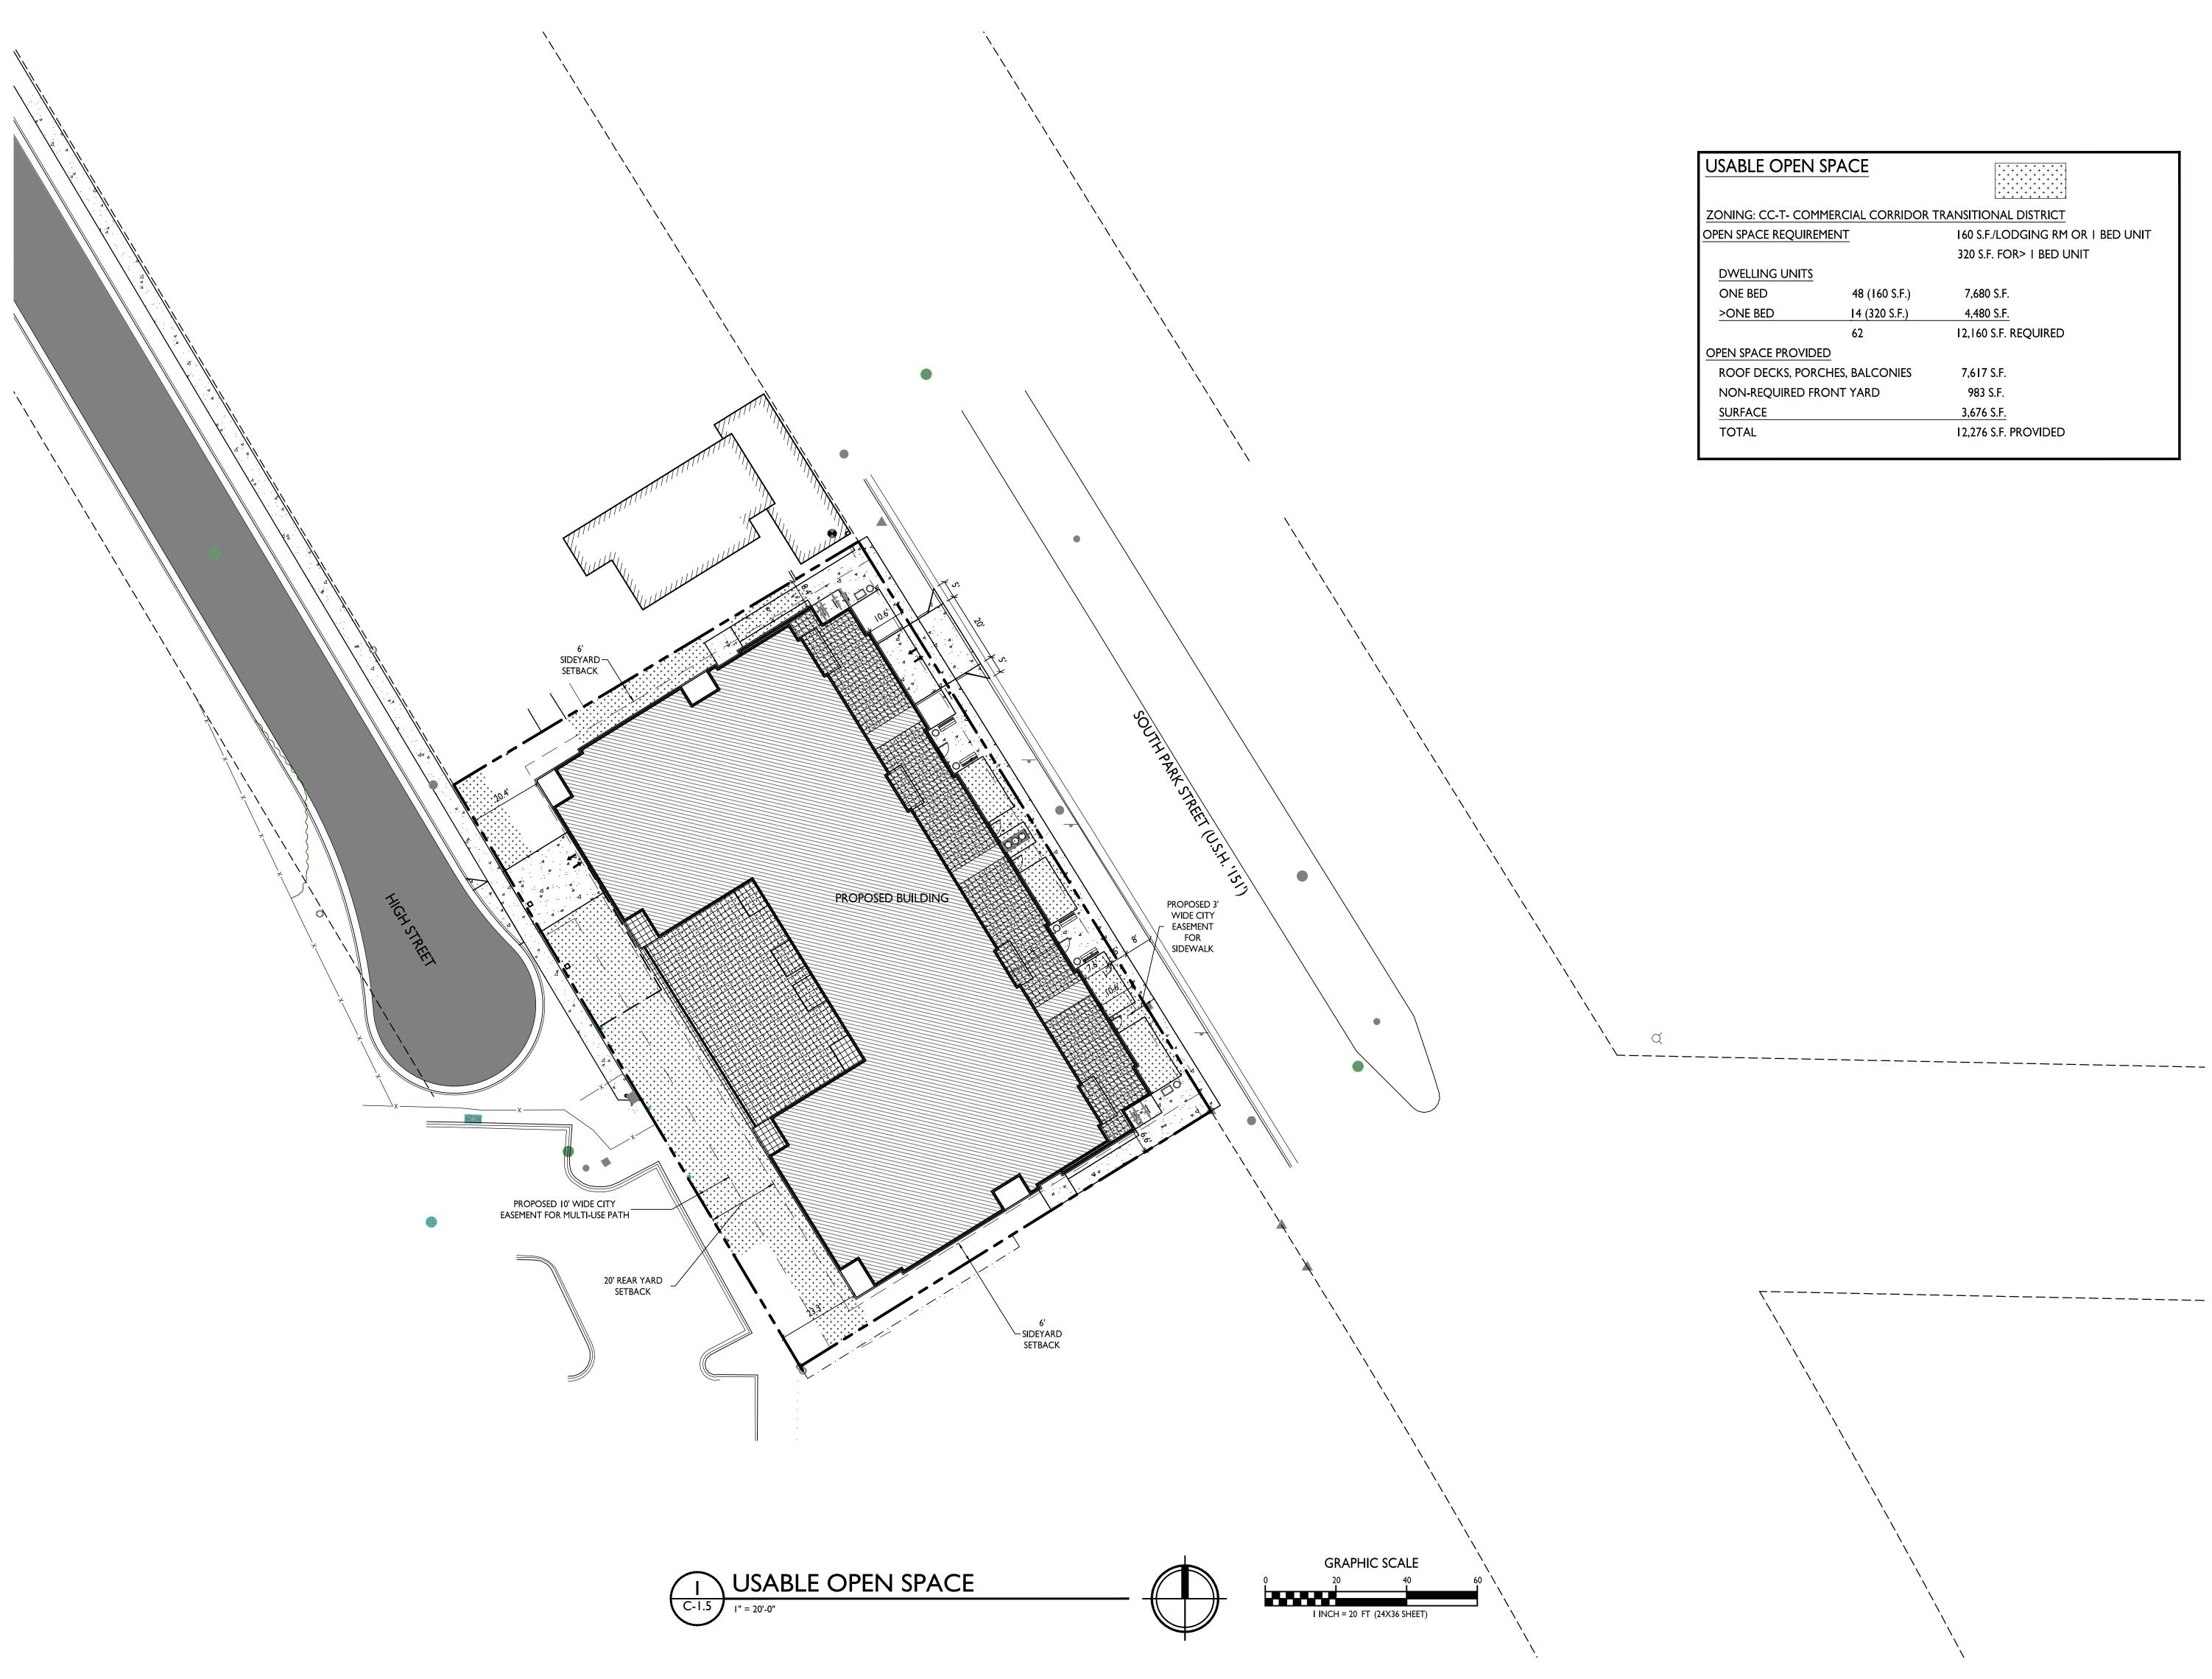
PROJECT TITLE
PARK STREET DEVELOPMENT


1224 S. Park Street Madison, Wisconsin SHEET TITLE Lot Coverage

SHEET NUMBER

C-1.4 PROJECT NO.

203 I © Knothe & Bruce Architects, LLC



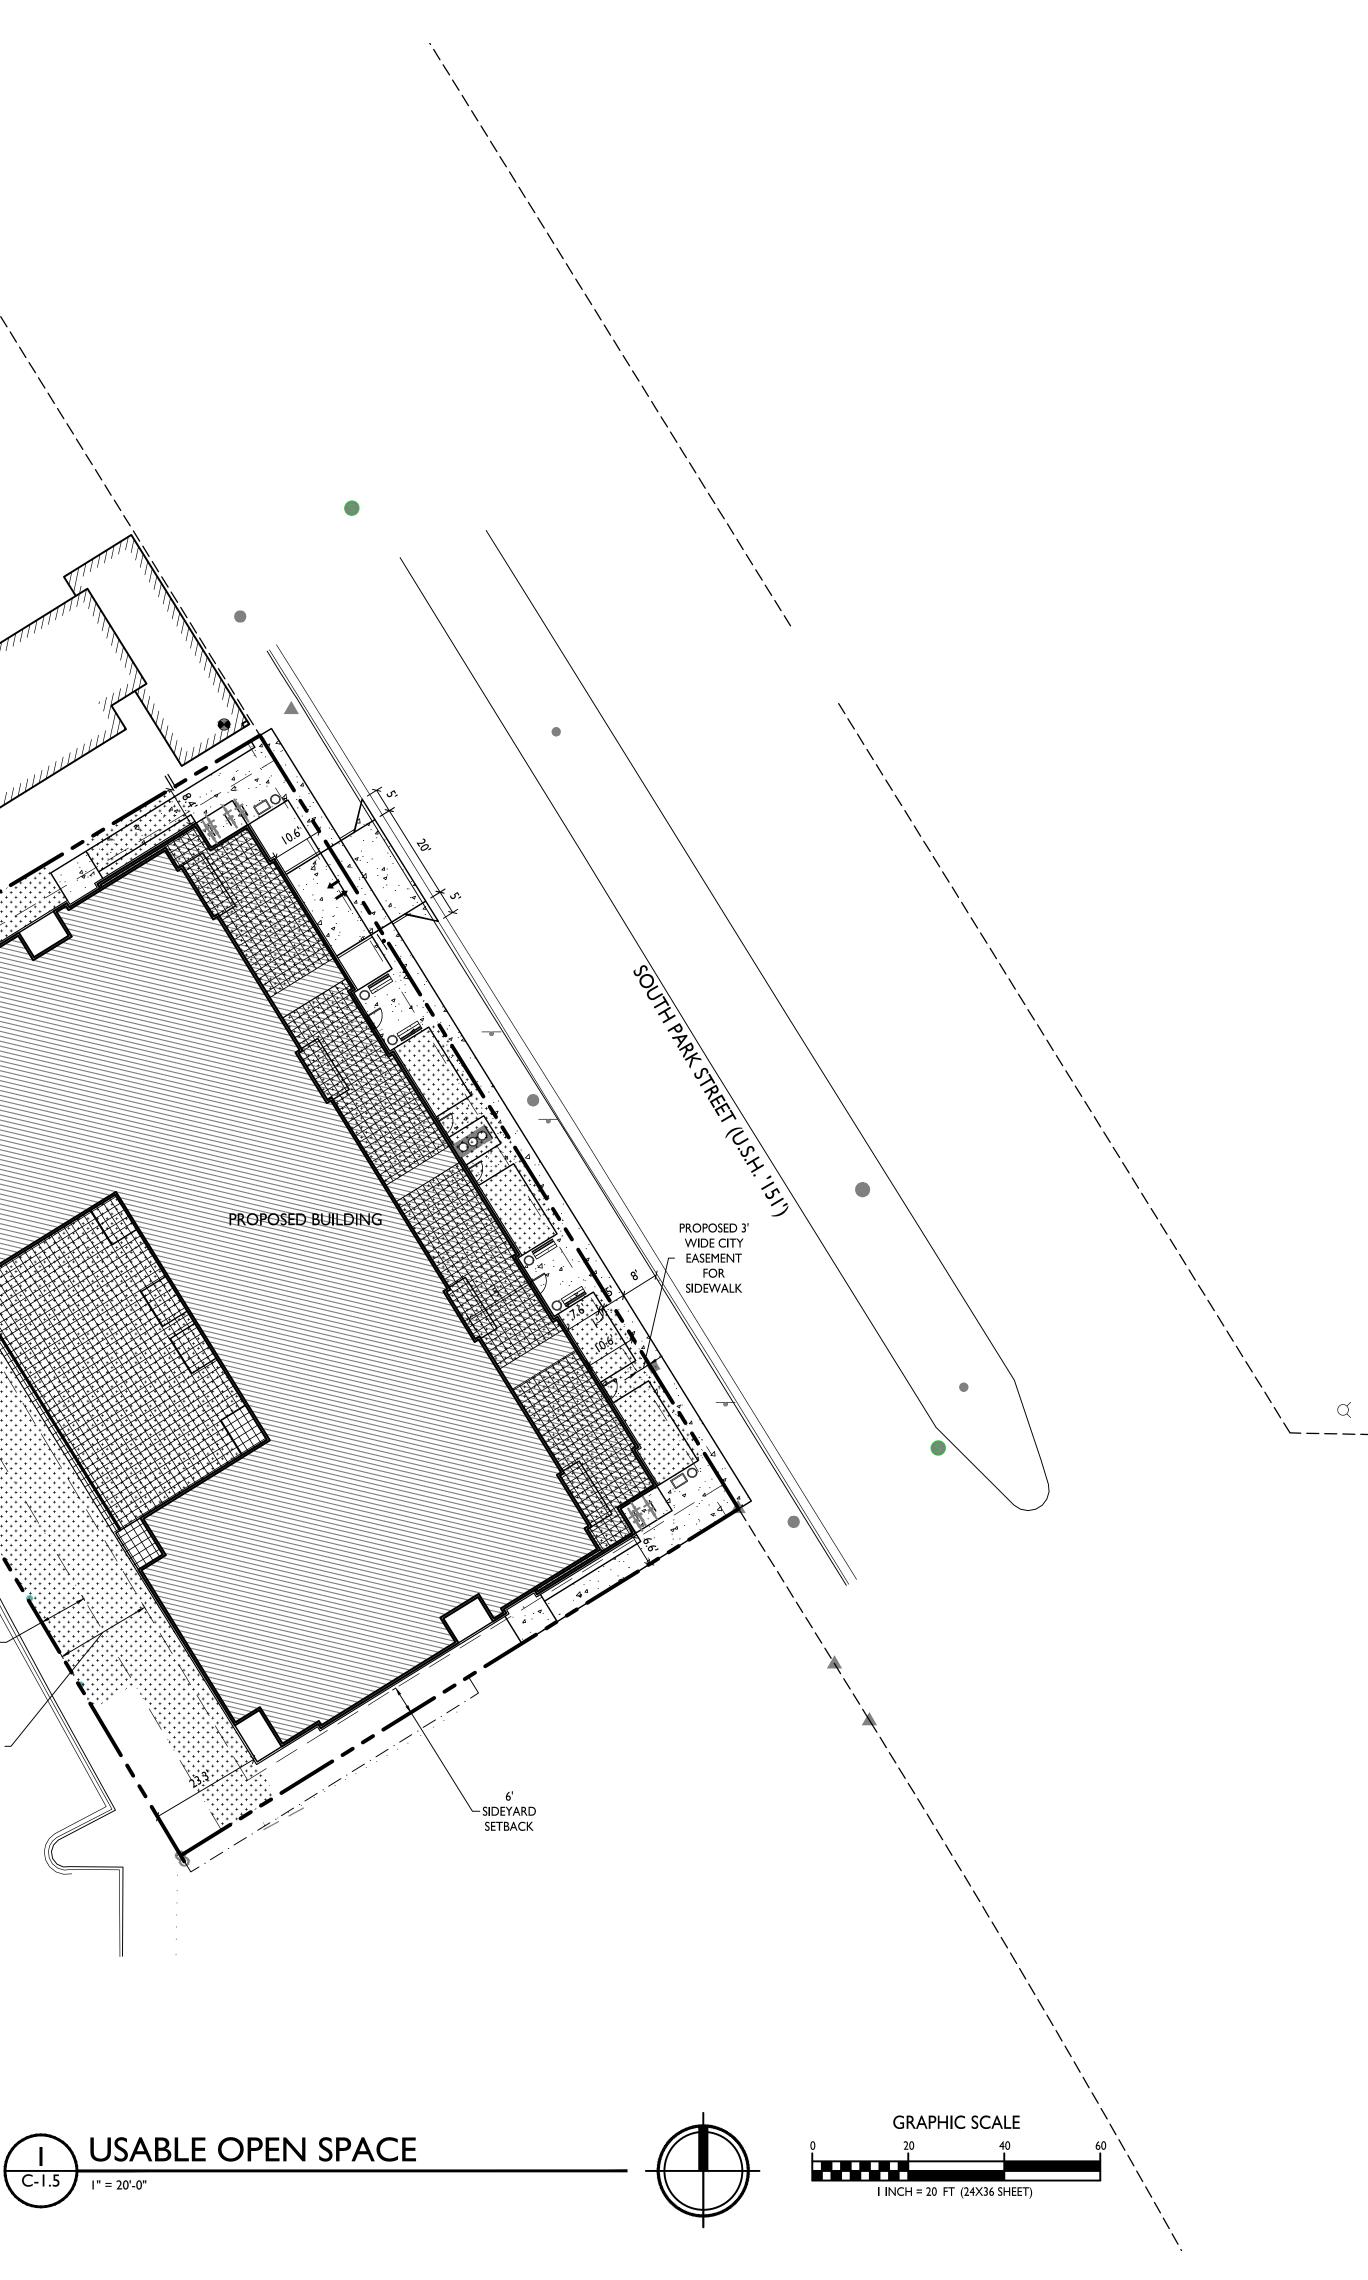

USABLE OPEN SPACE		$\begin{array}{cccccccccccccccccccccccccccccccccccc$
		$\begin{array}{cccccccccccccccccccccccccccccccccccc$
ZONING: CC-T- COM	IMERCIAL CORRIDOR	TRANSITIONAL DISTRICT
OPEN SPACE REQUIRE	MENT	160 S.F./LODGING RM OR 1 BED UNIT
		320 S.F. FOR> I BED UNIT
DWELLING UNITS		
ONE BED	48 (160 S.F.)	7,680 S.F.
>ONE BED	14 (320 S.F.)	4,480 S.F.
	62	12,160 S.F. REQUIRED
OPEN SPACE PROVID	ED	
ROOF DECKS, POR	CHES, BALCONIES	7,617 S.F.
NON-REQUIRED FRONT YARD		983 S.F.
SURFACE		3,676 S.F.
TOTAL		12,276 S.F. PROVIDED

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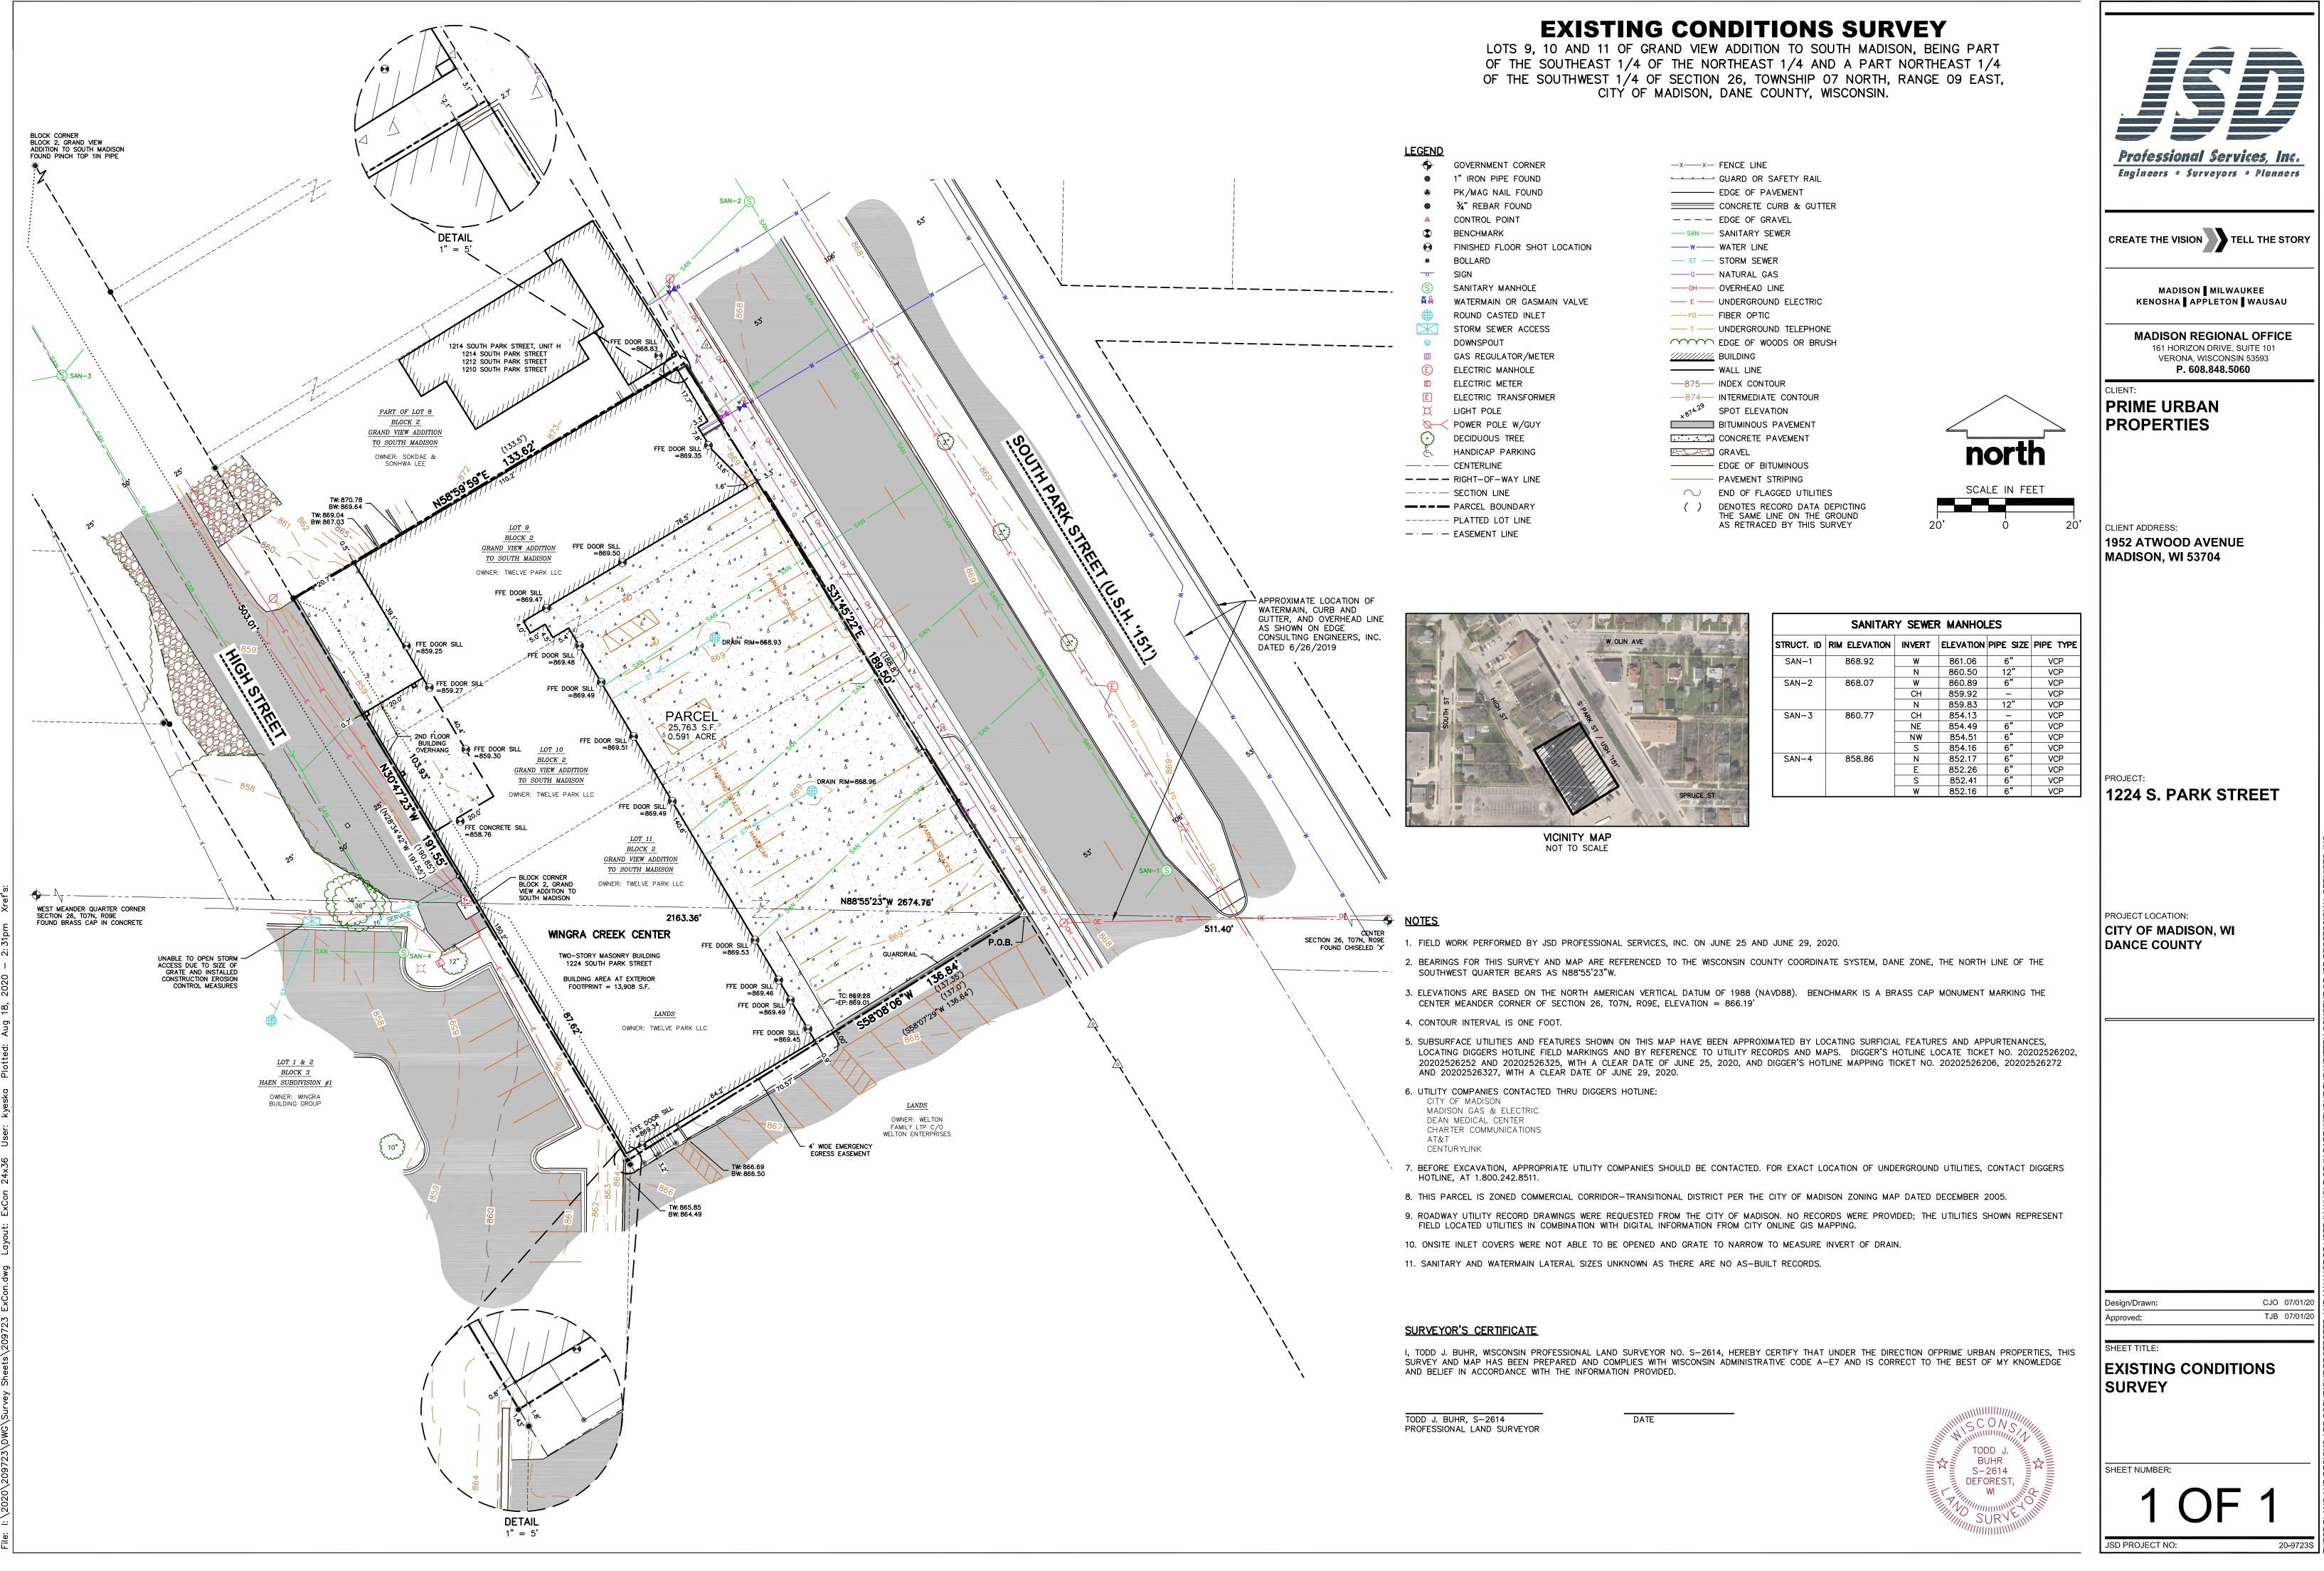
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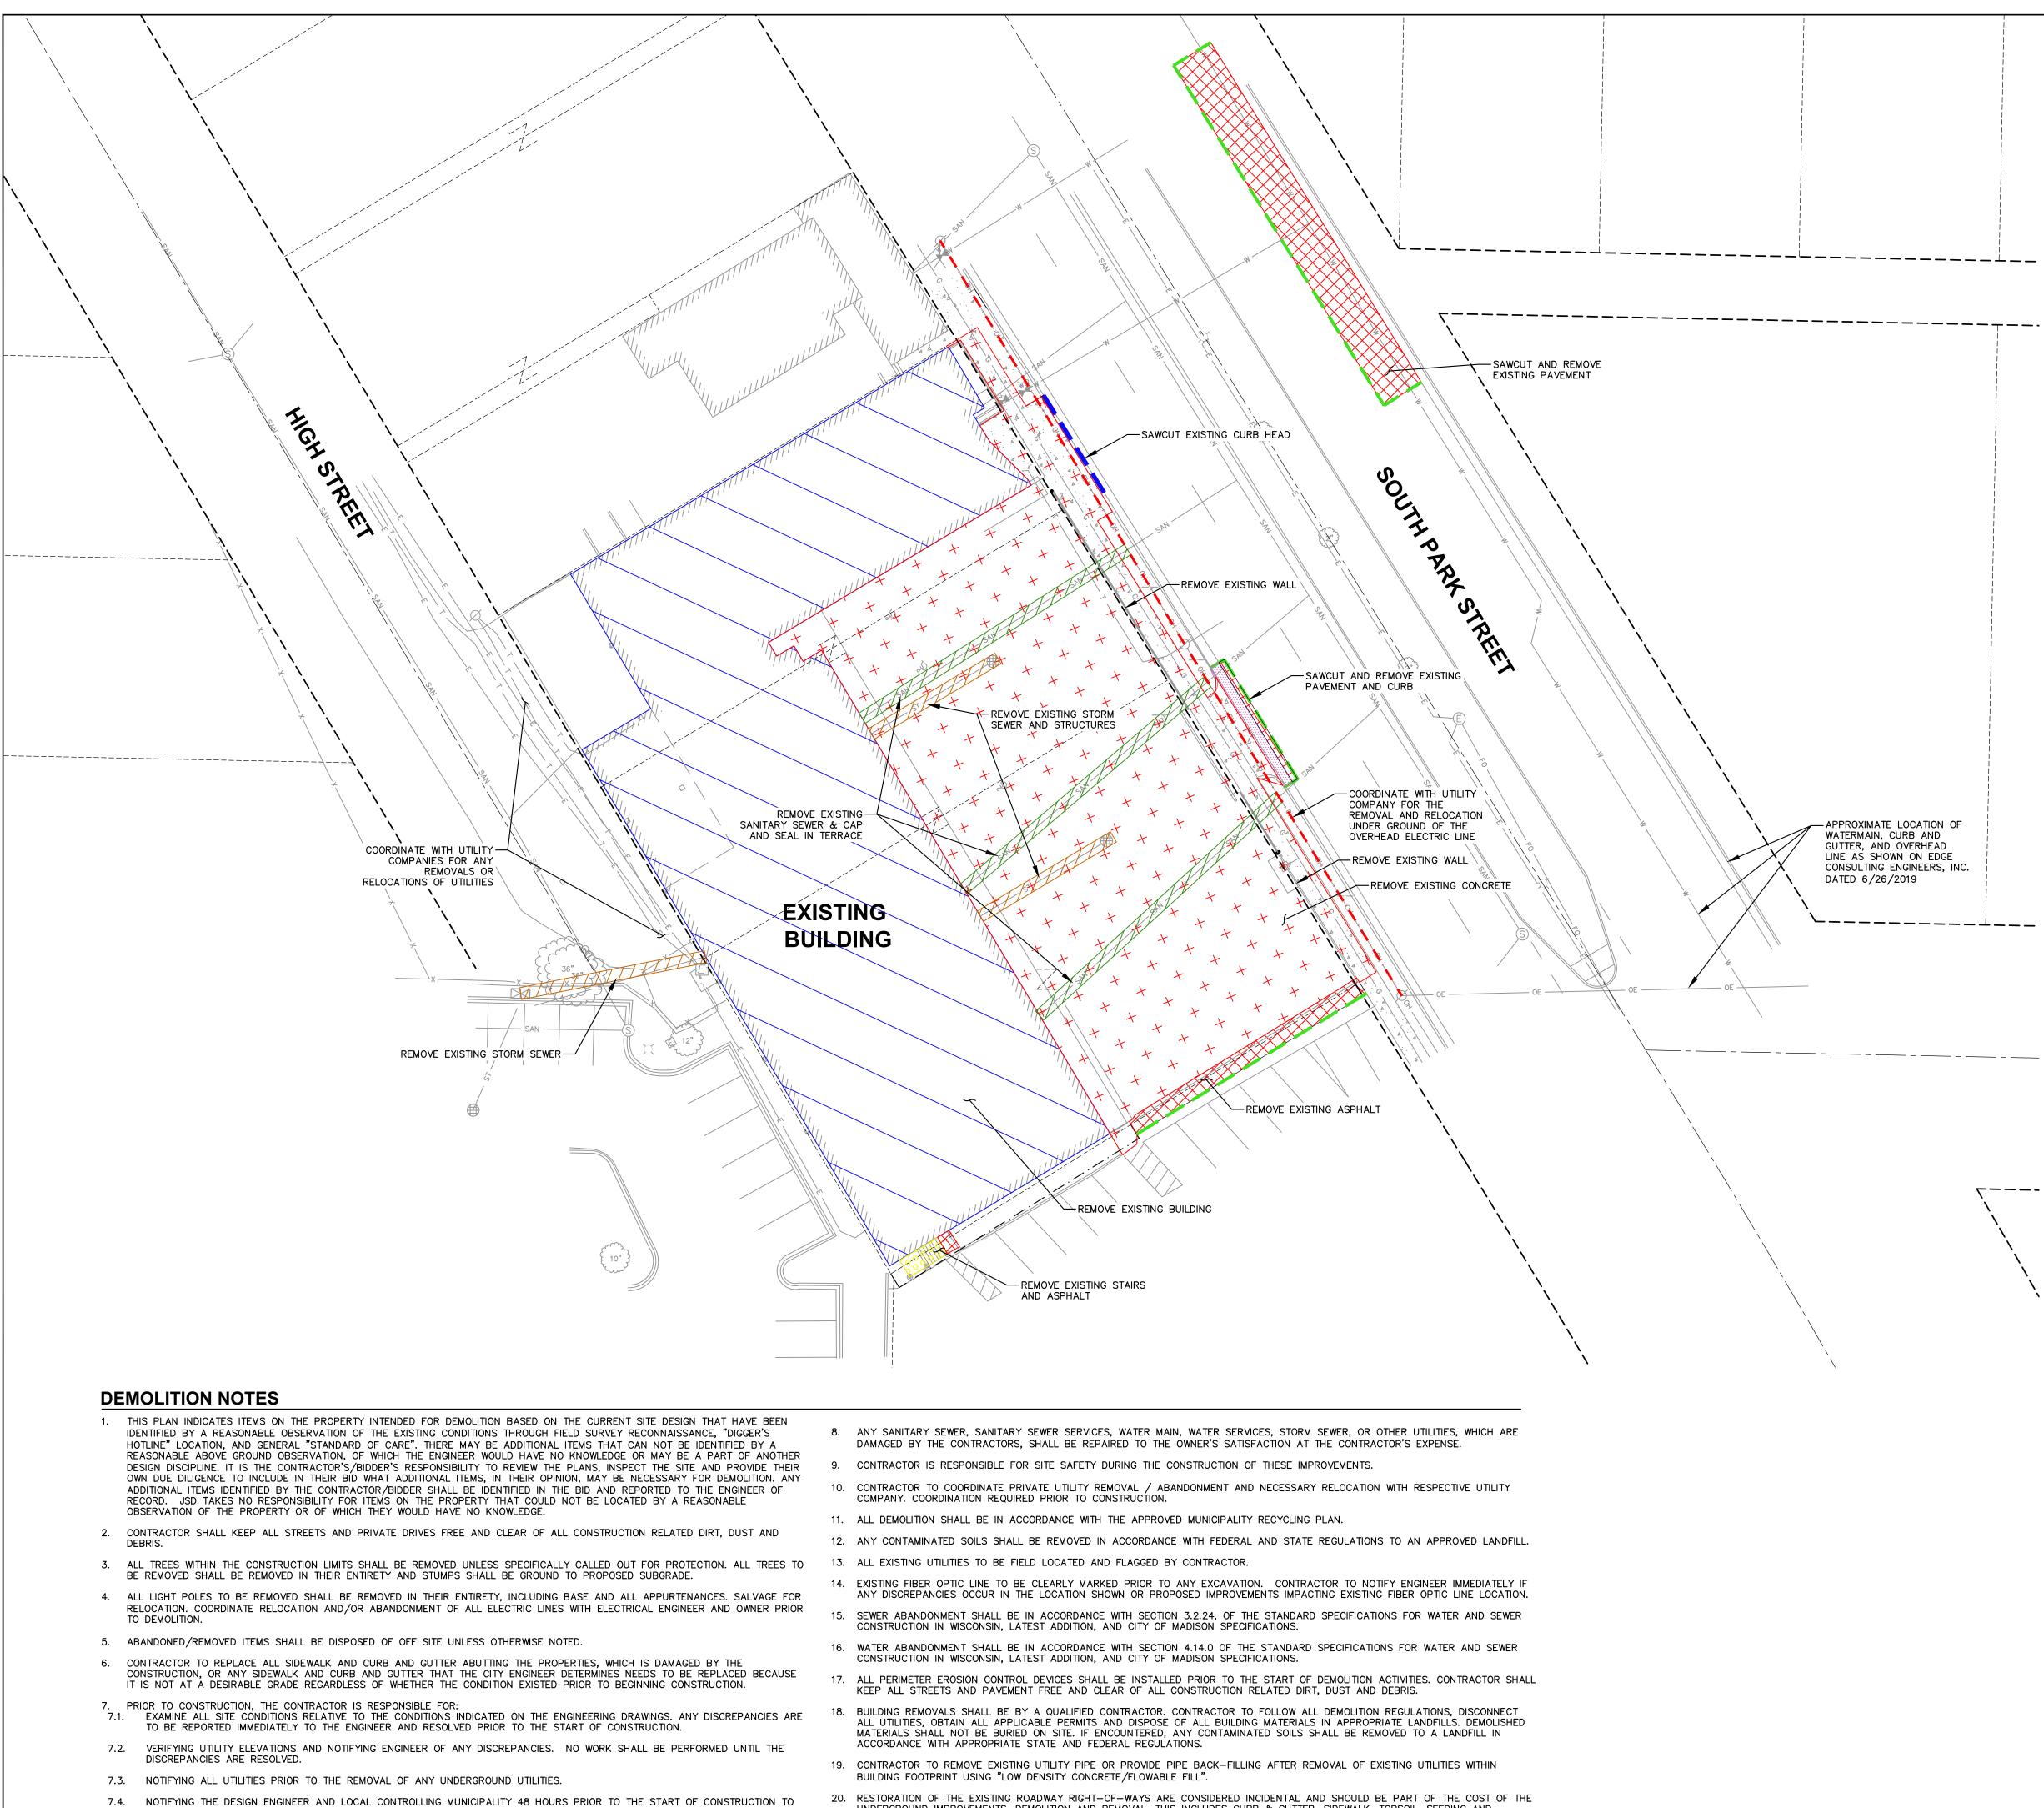
Issued for Land Use & UDC- September 16, 2020

PROJECT TITLE PARK STREET DEVELOPMENT

1224 S. Park Street Madison, Wisconsin SHEET TITLE Usable Open Space

C-1.5 PROJECT NO. 203 I © Knothe & Bruce Architects, LLC





ARRANGE FOR APPROPRIATE CONSTRUCTION INSPECTION.

UNDERGROUND IMPROVEMENTS, DEMOLITION AND REMOVAL. THIS INCLUDES CURB & GUTTER, SIDEWALK, TOPSOIL, SEEDING AND MULCHING.

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PROPERTY LINE RIGHT-OF-WAY EASEMENT LINE SAWCUT ASPHALT AND CURB REMOVAL OF OVERHEAD ELECTRIC SAWCUT CURB HEAD REMOVE EXISTING BUILDING REMOVE EXISTING CONCRETE REMOVE EXISTING ASPHALT REMOVE EXISTING CURB AND GUT REMOVE EXISTING STAIRS REMOVE EXISTING SANITARY SEWE REMOVE EXISTING STORM SEWER


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Toll Free (800) 242-8511

JSD PROJECT NO:

		onal Services, Inc. Surveyors • Planners
CRE	ATE THE V	ISION TELL THE STOR
	APPLETO	MILWAUKEE WAUSAU N KENOSHA CHICAGO COEUR D'ALENE
	161 HC VER	DN REGIONAL OFFICE DRIZON DRIVE, SUITE 101 DNA, WISCONSIN 53593 P. 608.848.5060
	IME UF	RBAN TIES, LLC
195	IT ADDRESS 2 ATWOO DISON, W	DD AVENUE
PROJECT: 1224 SOUTH PARK STREET		
MA	ect locatio DISON, W NE COUN	/I
PLAN #112345678	MODIFICATION Date: 07.23.20 08.19.20 09.16.20	ONS: Description: DAT PRESENTATION UDC INFORMATIONAL LAND USE - UDC SUBMITTAL
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	n/Drawn: oved:	Μ
- whuc	T TITLE:	ION PLAN
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20-9723



LEGEND

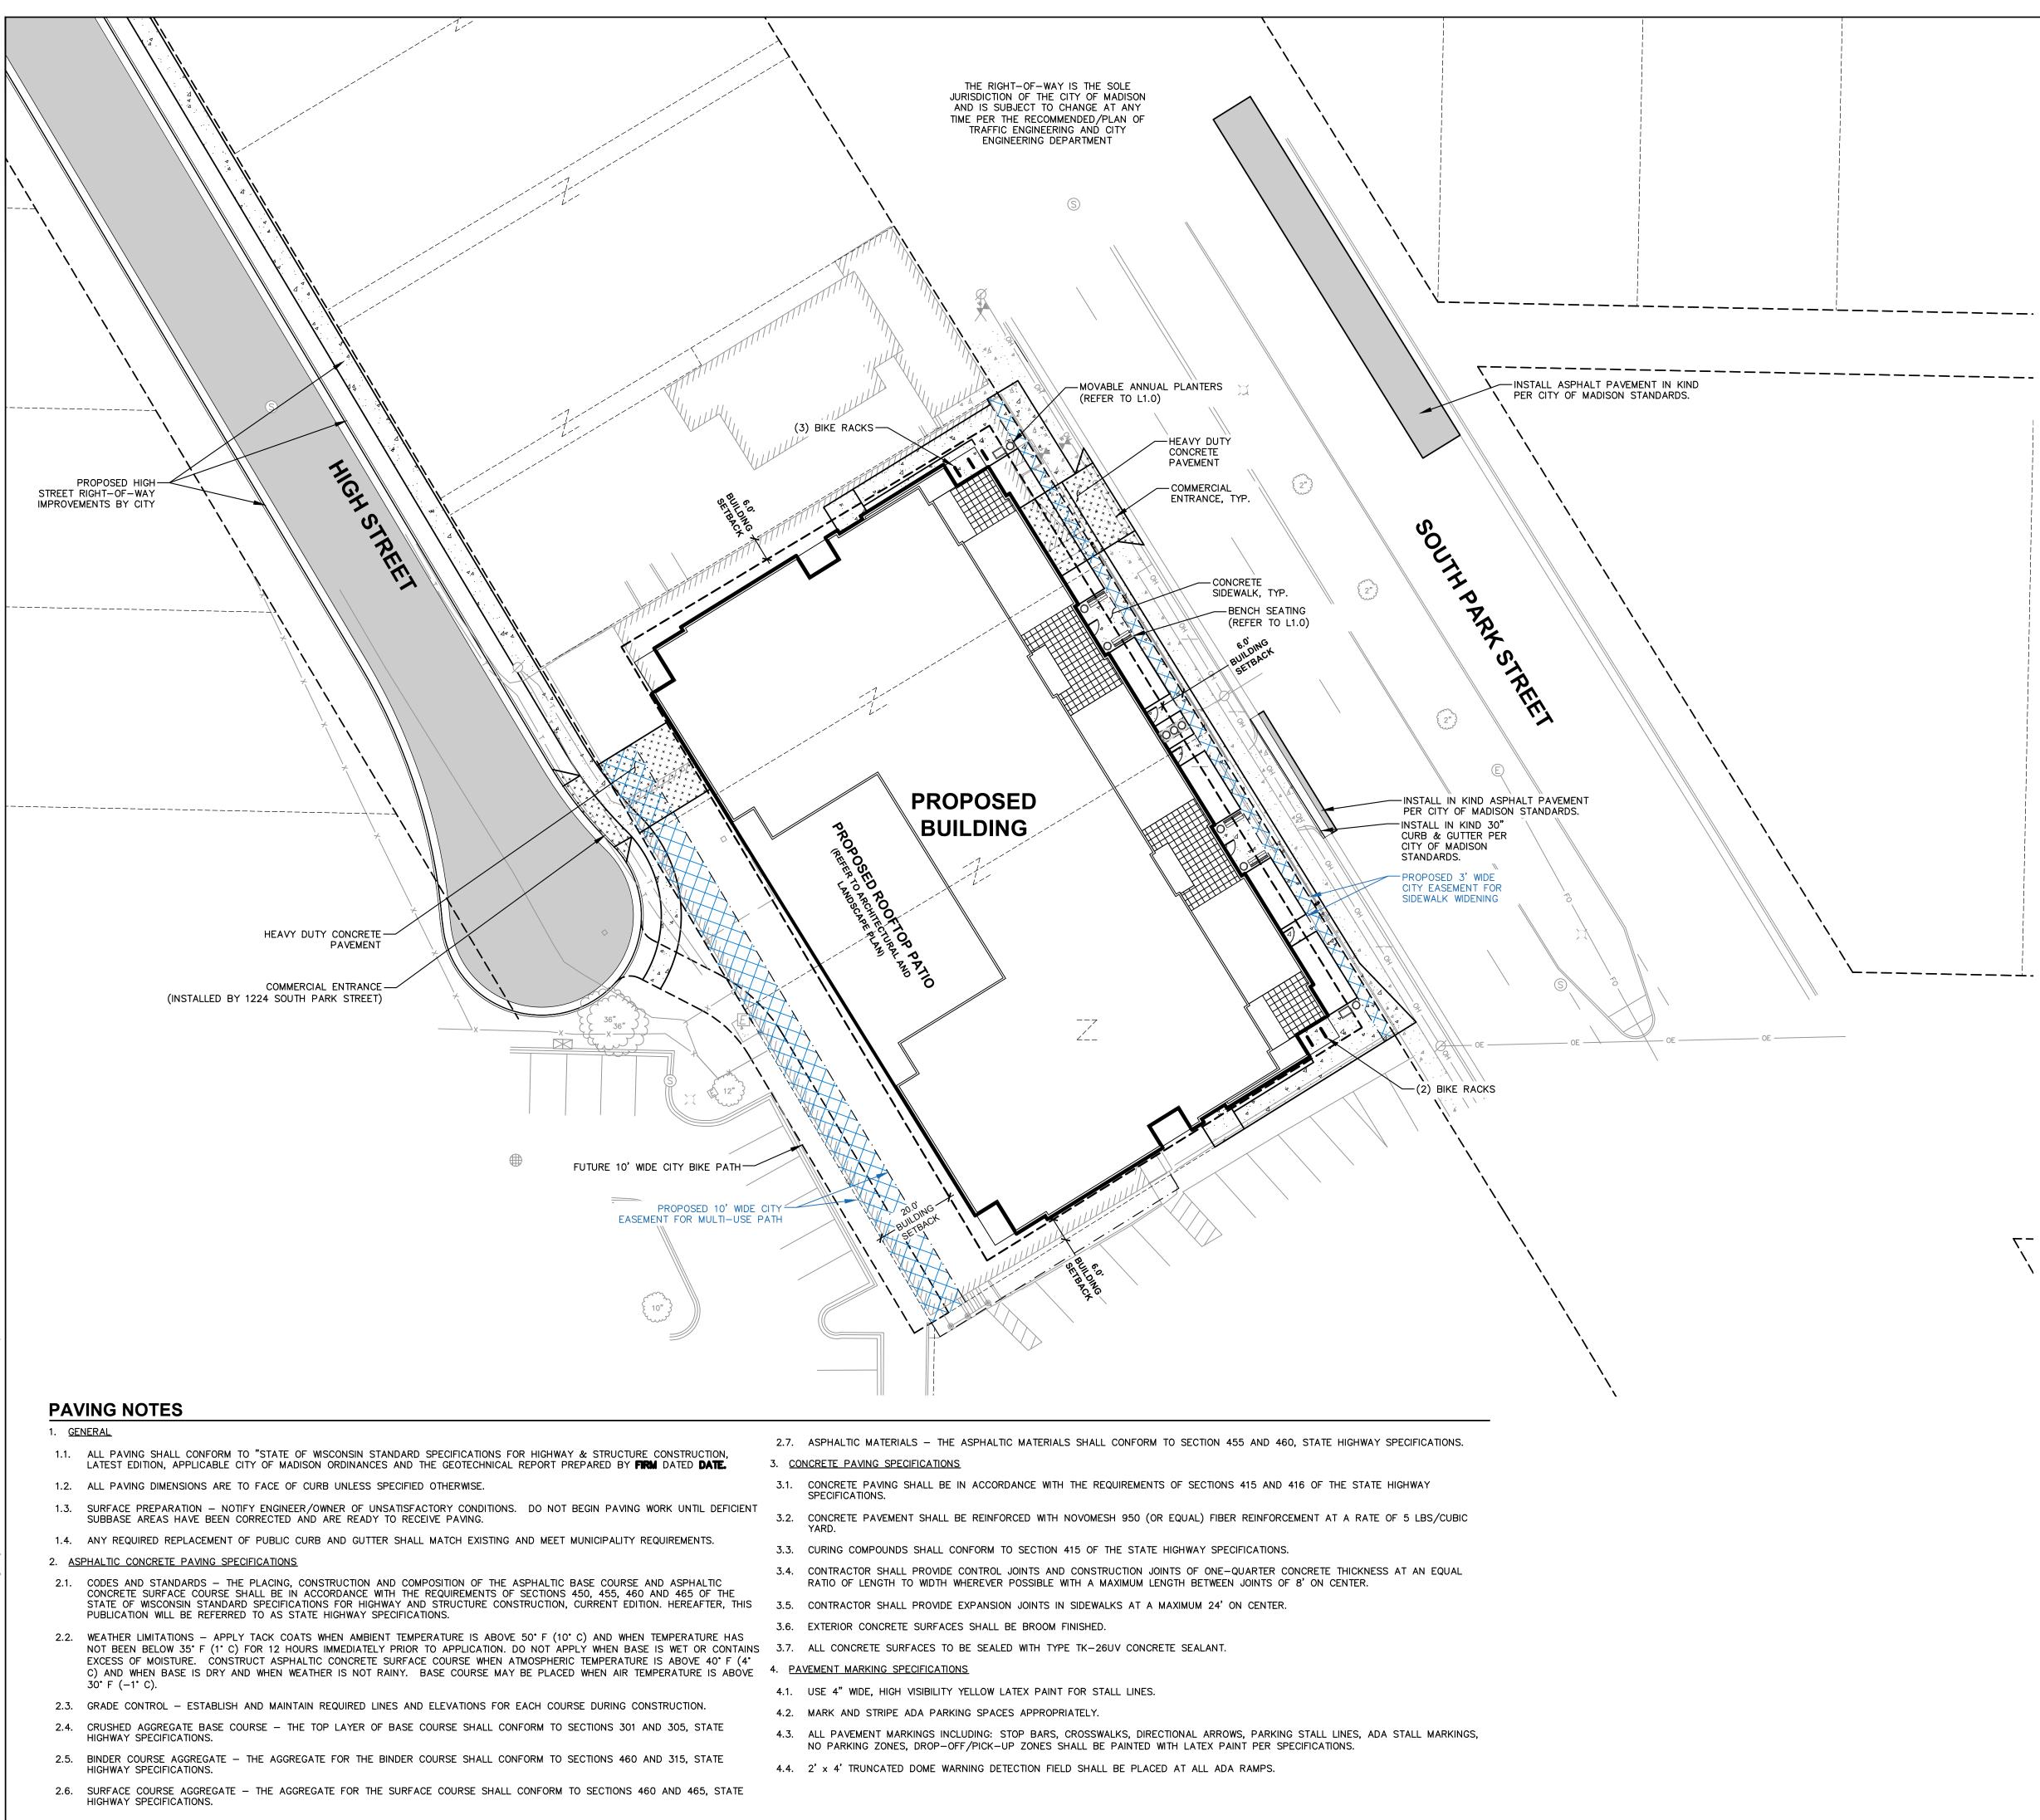PROPERTY LINE $-\cdot - \cdot - \cdot - \cdot - \cdot - = EASEMENT LINE$

BUILDING OUTLINE EDGE OF PAVEMENT STANDARD CURB AND GUTTER 8" CONCRETE RIBBON CURB ASPHALT PAVEMENT CONCRETE PAVEMENT HEAVY DUTY CONCRETE PAVEMENT BIKE RACK

SITE INFORMATION B	LOCK
SITE ADDRESS	1224 PARK STREET
PROPERTY ACREAGE	0.591 ACRES
NUMBER OF BUILDING STORIES	5
TOTAL BUILDING SQUARE FOOTAGE	TBD
GROSS BUILDING SQUARE FOOTAGE	TBD
NUMBER OF PARKING STALLS	
SURFACE	0
UNDERGROUND	
LARGE	TBD
ACCESSIBLE	TBD
TOTAL UNDERGROUND	TBD
NUMBER OF EXTERIOR BICYCLE STALLS:	6 (3 RACKS)
EXISTING VS. PROPOSED SITE COVERAGE	
EXISTING IMPERVIOUS SURFACE AREA	25,421 SF
EXISTING PERVIOUS SURFACE AREA	342 SF
EXISTING IMPERVIOUS SURFACE AREA RATIO	0.99
PROPOSED IMPERVIOUS SURFACE AREA	19,823 SF
PROPOSED PERVIOUS SURFACE AREA	5,940 SF
PROPOSED IMPERVIOUS SURFACE AREA RATIO	0.77

north

SCALE IN FEET

Toll Free (800) 242-8511

JSD PROJECT NO:



20-9723



LEGEND

— — — — — — — — RIGHT-OF-WAY - · - · · - · - · - EASEMENT LINE

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7-

PROPERTY LINE BUILDING OUTLINE ---- BUILDING SETBACK LINE EDGE OF PAVEMENT STANDARD CURB AND GUTTER 8" CONCRETE RIBBON CURB ASPHALT PAVEMENT CONCRETE PAVEMENT HEAVY DUTY CONCRETE PAVEMENT BIKE RACK

north


SCALE IN FEET

Toll Free (800) 242-8511

JSD PROJECT NO:

	al Services, Inc. Burveyors • Planners			
APPLETON	TELL THE STORY			
MADISON 161 HORIZ VERONA	REGIONAL OFFICE CON DRIVE, SUITE 101 A, WISCONSIN 53593 608.848.5060			
CLIENT: PRIME URE PROPERTI				
	CLIENT ADDRESS: 1952 ATWOOD AVENUE MADISON, WI 53704			
PROJECT: 1224 SOUT STREET	1224 SOUTH PARK			
PROJECT LOCATION: MADISON, WI DANE COUNTY				
# Date: Description: 1 07.23.20 DAT PRESENTATION 2 08.19.20 UDC INFORMATIONAL 3 09.16.20 LAND USE - UDC SUBMITTAL 4				
SHEET TITLE: SITE PLAN DIMENSION				
SHEET NUMBER:				


20-9723

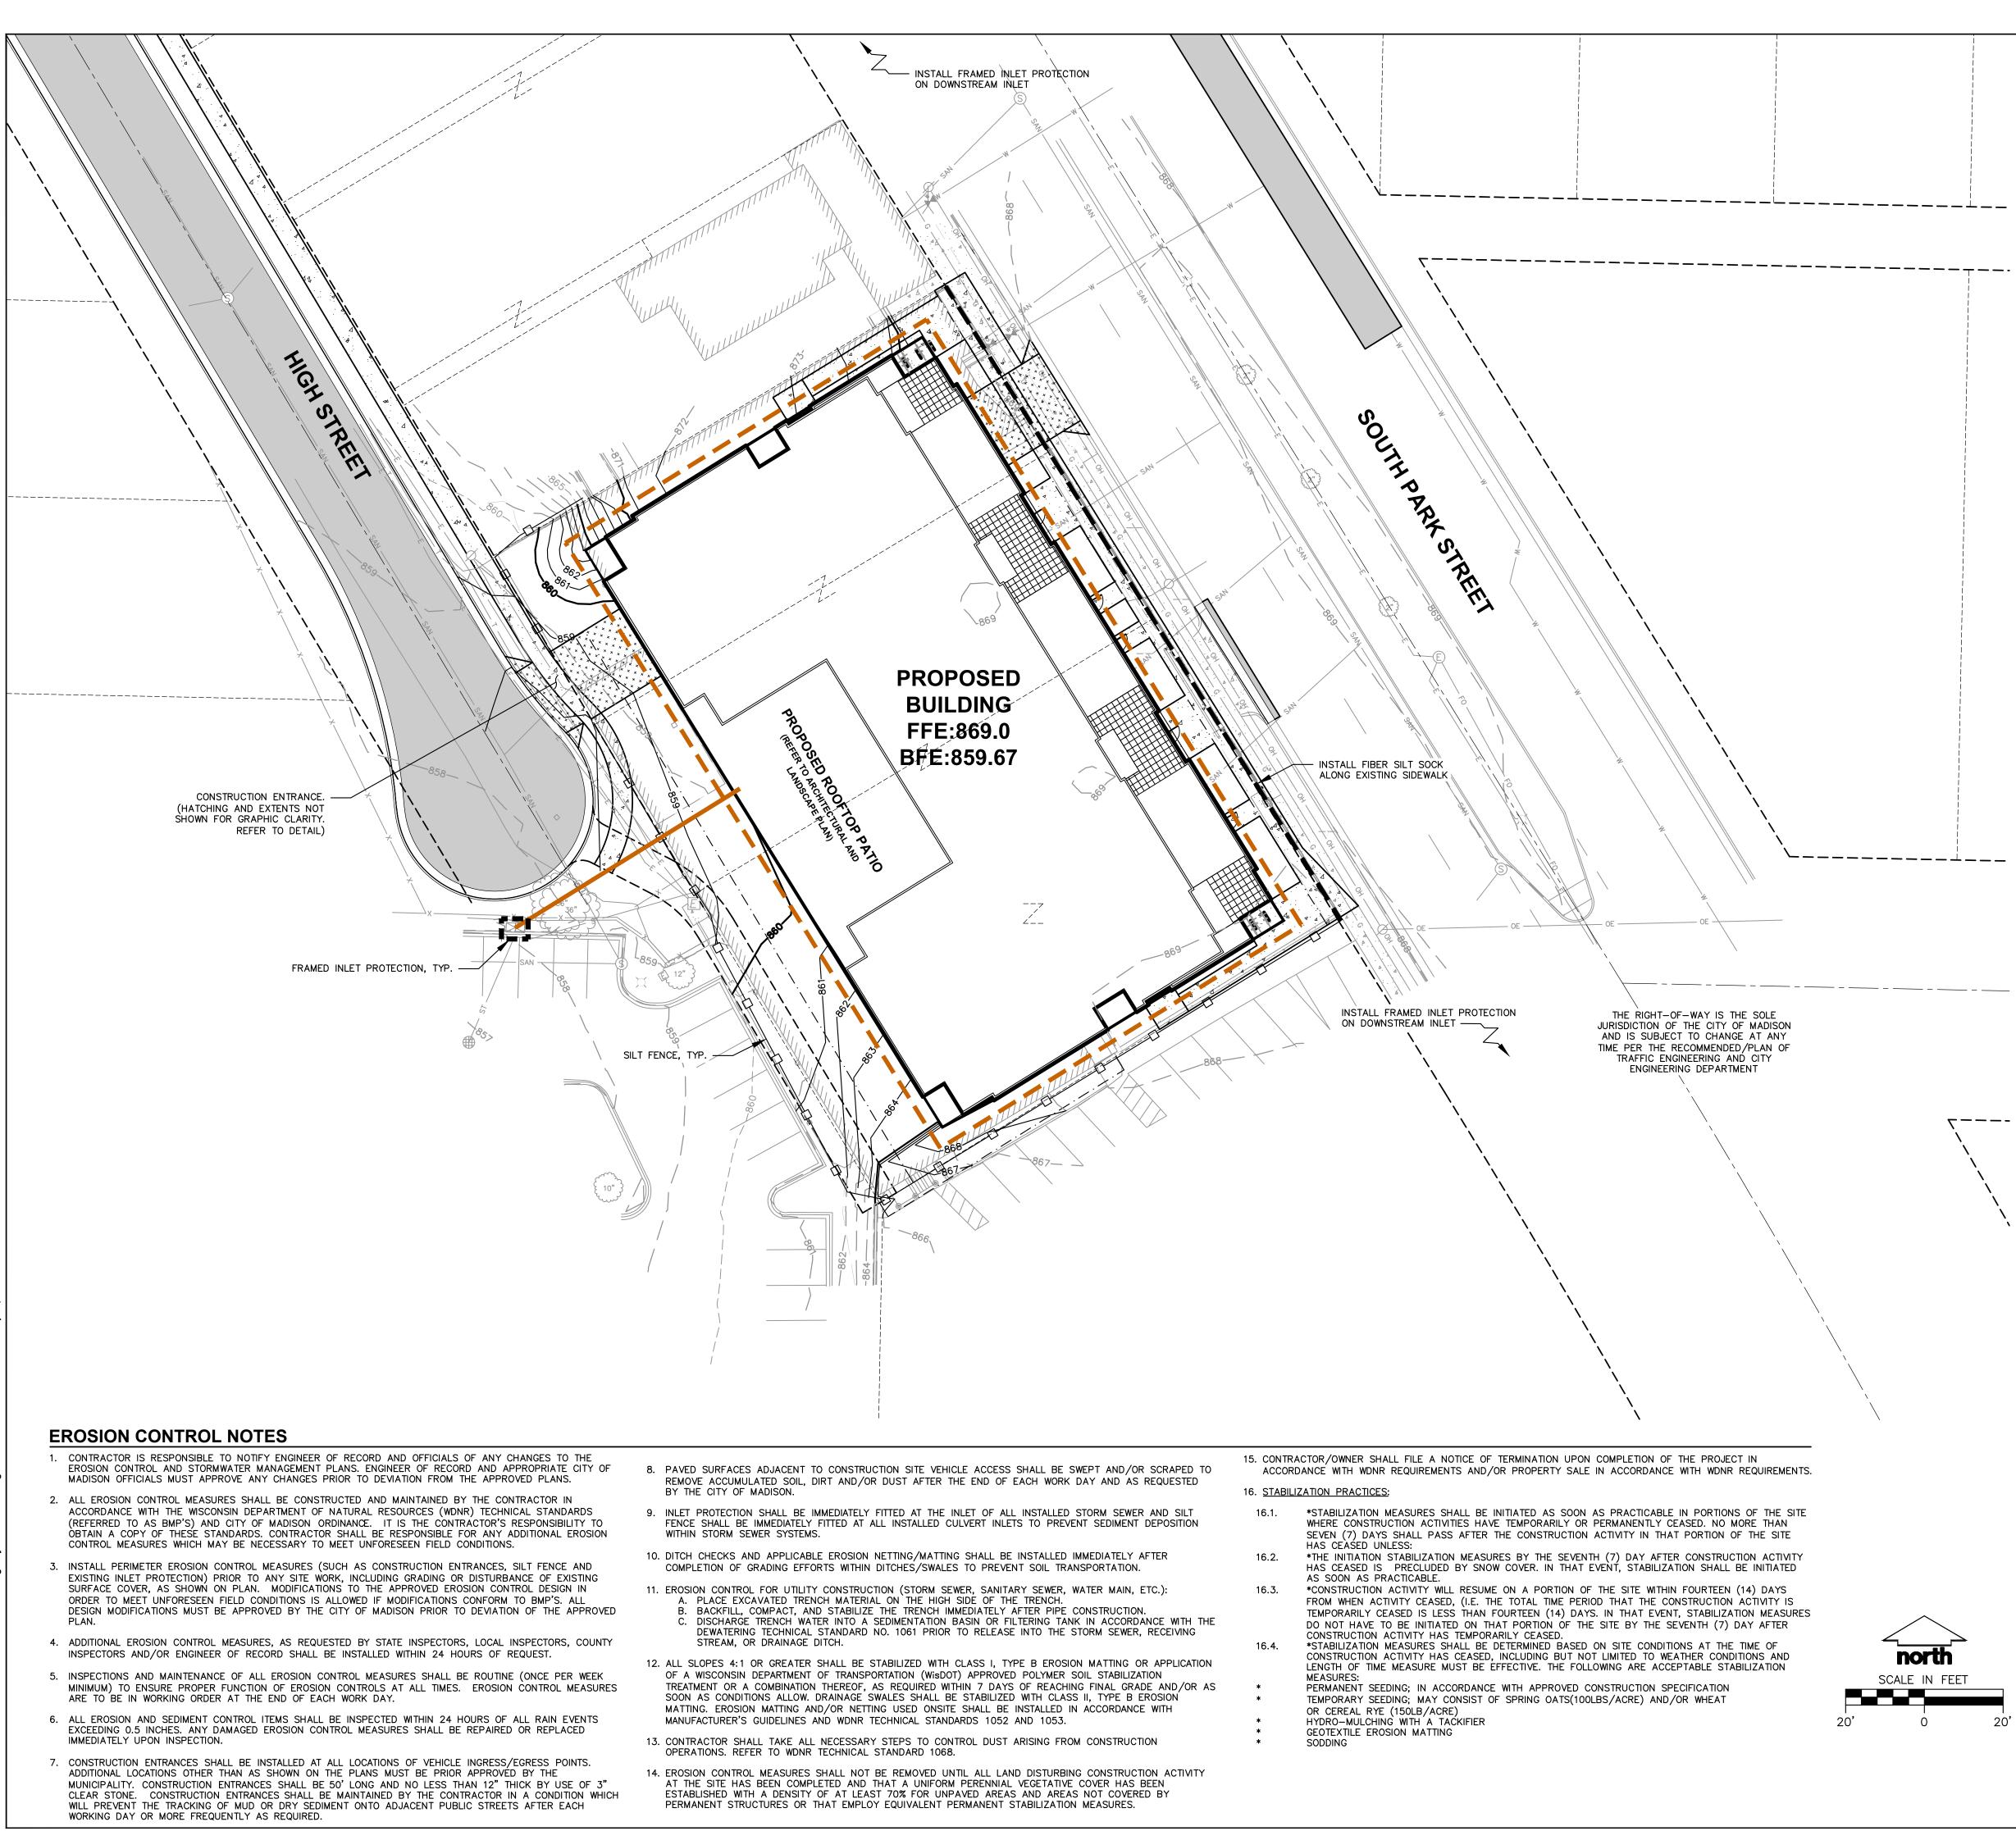

LEGEND PROPERTY LINE - · - · · - · - · - EASEMENT LINE BUILDING OUTLINE EDGE OF PAVEMENT STANDARD CURB AND GUTTER REJECT CURB AND GUTTER Professional Services, Inc. ASPHALT PAVEMENT Engineers • Surveyers • Planners HEAVY DUTY ASPHALT PAVEMENT CONCRETE PAVEMENT HEAVY DUTY CONCRETE PAVEMENT PROPOSED 1 FOOT CONTOUR CREATE THE VISION TELL THE STORY PROPOSED 5 FOOT CONTOUR EXISTING 1 FOOT CONTOUR MADISON MILWAUKEE WAUSAU APPLETON KENOSHA CHICAGO DRAINAGE DIRECTION COEUR D'ALENE ---- GRADE BREAK MADISON REGIONAL OFFICE RETAINING WALL 161 HORIZON DRIVE, SUITE 101 VERONA, WISCONSIN 53593 RAILING P. 608.848.5060 FENCE CLIENT PRIME URBAN FIBER SILT SOCK PROPERTIES, LLC CONSTRUCTION ENTRANCE EROSION MATTING INLET PROTECTION **CLIENT ADDRESS:** 1952 ATWOOD AVENUE **MADISON, WI 53704 GRADING AND SEEDING NOTES** 1. HIGH STREET GRADING BASED OFF OF PRELIMINARY CITY CENTERLINE PROFILE GRADES. 2. ALL PROPOSED GRADES SHOWN ARE FINISHED GRADES. CONTRACTOR SHALL VERIFY ALL GRADES, MAKE SURE ALL AREAS DRAIN PROPERLY AND SHALL REPORT ANY DISCREPANCIES TO THE ENGINEER PRIOR TO CONSTRUCTION. 3. CONTRACTOR SHALL ASSUME SOLE RESPONSIBILITY FOR COMPUTATIONS OF ALL GRADING QUANTITIES. WHILE JSD **1224 SOUTH PARK** PROFESSIONAL SERVICES, INC. ATTEMPTS TO PROVIDE A COST EFFECTIVE APPROACH TO BALANCE EARTHWORK, GRADING DESIGN IS STREET BASED ON MANY FACTORS, INCLUDING SAFETY, AESTHETICS, AND COMMON ENGINEERING STANDARDS OF CARE. THEREFORE, NO GUARANTEE CAN BE MADE FOR A BALANCED SITE. 4. PARKING LOT AND DRIVEWAY ELEVATIONS ARE PAVEMENT GRADES. NOT TOP OF CURB GRADES, UNLESS OTHERWISE NOTED. 5. ANY WORK WITHIN RIGHT-OF-WAY SHALL BE PROPERLY PERMITTED AND COORDINATED WITH THE APPROPRIATE OFFICIALS PRIOR TO COMMENCEMENT OF ANY CONSTRUCTION ACTIVITIES. ALL GRADING WITHIN RIGHT-OF-WAY IS SUBJECT TO APPROVAL BY SAID **PROJECT LOCATION:** OFFICIALS. MADISON, WI 6. CONTRACTOR SHALL PROVIDE NOTICE TO THE MUNICIPALITY IN ADVANCE OF ANY SOIL DISTURBING ACTIVITIES, IN ACCORDANCE WITH DANE COUNTY MUNICIPAL REQUIREMENTS. 7. ALL DISTURBED AREAS SHALL BE SODDED AND/OR SEEDED AND MULCHED IMMEDIATELY FOLLOWING GRADING ACTIVITIES. SOD/SEED ----MIX TO BE IN ACCORDANCE WITH LANDSCAPE PLAN. 8. CONTRACTOR SHALL WATER ALL NEWLY SODDED/SEEDED AREAS DURING THE SUMMER MONTHS WHENEVER THERE IS A 7 DAY LAPSE WITH NO SIGNIFICANT RAINFALL. 9. CONTRACTOR TO DEEP TILL ALL COMPACTED PERVIOUS SURFACES PRIOR TO SODDING AND/OR SEEDING AND MULCHING. 10. ALL SLOPES 20% OR GREATER SHALL BE TEMPORARY SEEDED, MULCHED, OR OTHER MEANS OF COVER PLACED ON THEM WITHIN 2 WEEKS OF DISTURBANCE. 11. ALL EXPOSED SOIL AREAS THAT WILL NOT BE BROUGHT TO FINAL GRADE OR ON WHICH LAND DISTURBING ACTIVITIES WILL NOT BE PERFORMED FOR A PERIOD GREATER THAN 30 DAYS AND REQUIRE VEGETATIVE COVER FOR LESS THAN 1 YEAR, REQUIRE TEMPORARY AN MODIFICATIONS: SEEDING FOR EROSION CONTROL. SEEDING FOR EROSION CONTROL SHALL BE IN ACCORDANCE WITH WDNR TECHNICAL STANDARD 1059 Description: AND CITY OF MADISON ORDINANCE. 07.23.20 DAT PRESENTATION 08.19.20 UDC INFORMATIONAL CONSTRUCTION SEQUENCING 09.16.20 LAND USE - UDC SUBMITTAL INSTALL PERIMETER SILT FENCE, INLET PROTECTION AND TEMPORARY CONSTRUCTION ENTRANCE. 2. STRIP AND STOCKPILE TOPSOIL, INSTALL SILT FENCE AROUND PERIMETER OF STOCKPILE. 3. CONDUCT ROUGH GRADING EFFORTS AND INSTALL CHECK DAMS WITHIN DRAINAGE DITCHES AS NEEDED. 4. INSTALL UTILITY PIPING AND STRUCTURES, IMMEDIATELY INSTALL INLET PROTECTION. COMPLETE FINAL GRADING, INSTALLATION OF GRAVEL BASE COURSES, PLACEMENT OF CURBS, PAVEMENTS, WALKS, ETC. 6. PLACE TOPSOIL AND IMMEDIATELY STABILIZE DISTURBED AREAS WITH EROSION CONTROL MEASURES AS INDICATED ON PLANS. ign/Drawn: 7. EROSION CONTROLS SHALL NOT BE REMOVED UNTIL SITE IS FULLY Approved STABILIZED OR 70% VEGETATIVE COVER IS ESTABLISHED. CONTRACTOR MAY MODIFY SEQUENCING AFTER ITEM NO. 1 AS NEEDED TO COMPLETE CONSTRUCTION IF EROSION CONTROLS ARE MAINTAINED IN ACCORDANCE WITH THE CONSTRUCTION SITE EROSION GRADING AND EROSION CONTROL REQUIREMENTS. CONTROL PLAN north SCALE IN FEE HEET NUMBER: Toll Free (800) 242-8511

20-9723


JSD PROJECT NO:

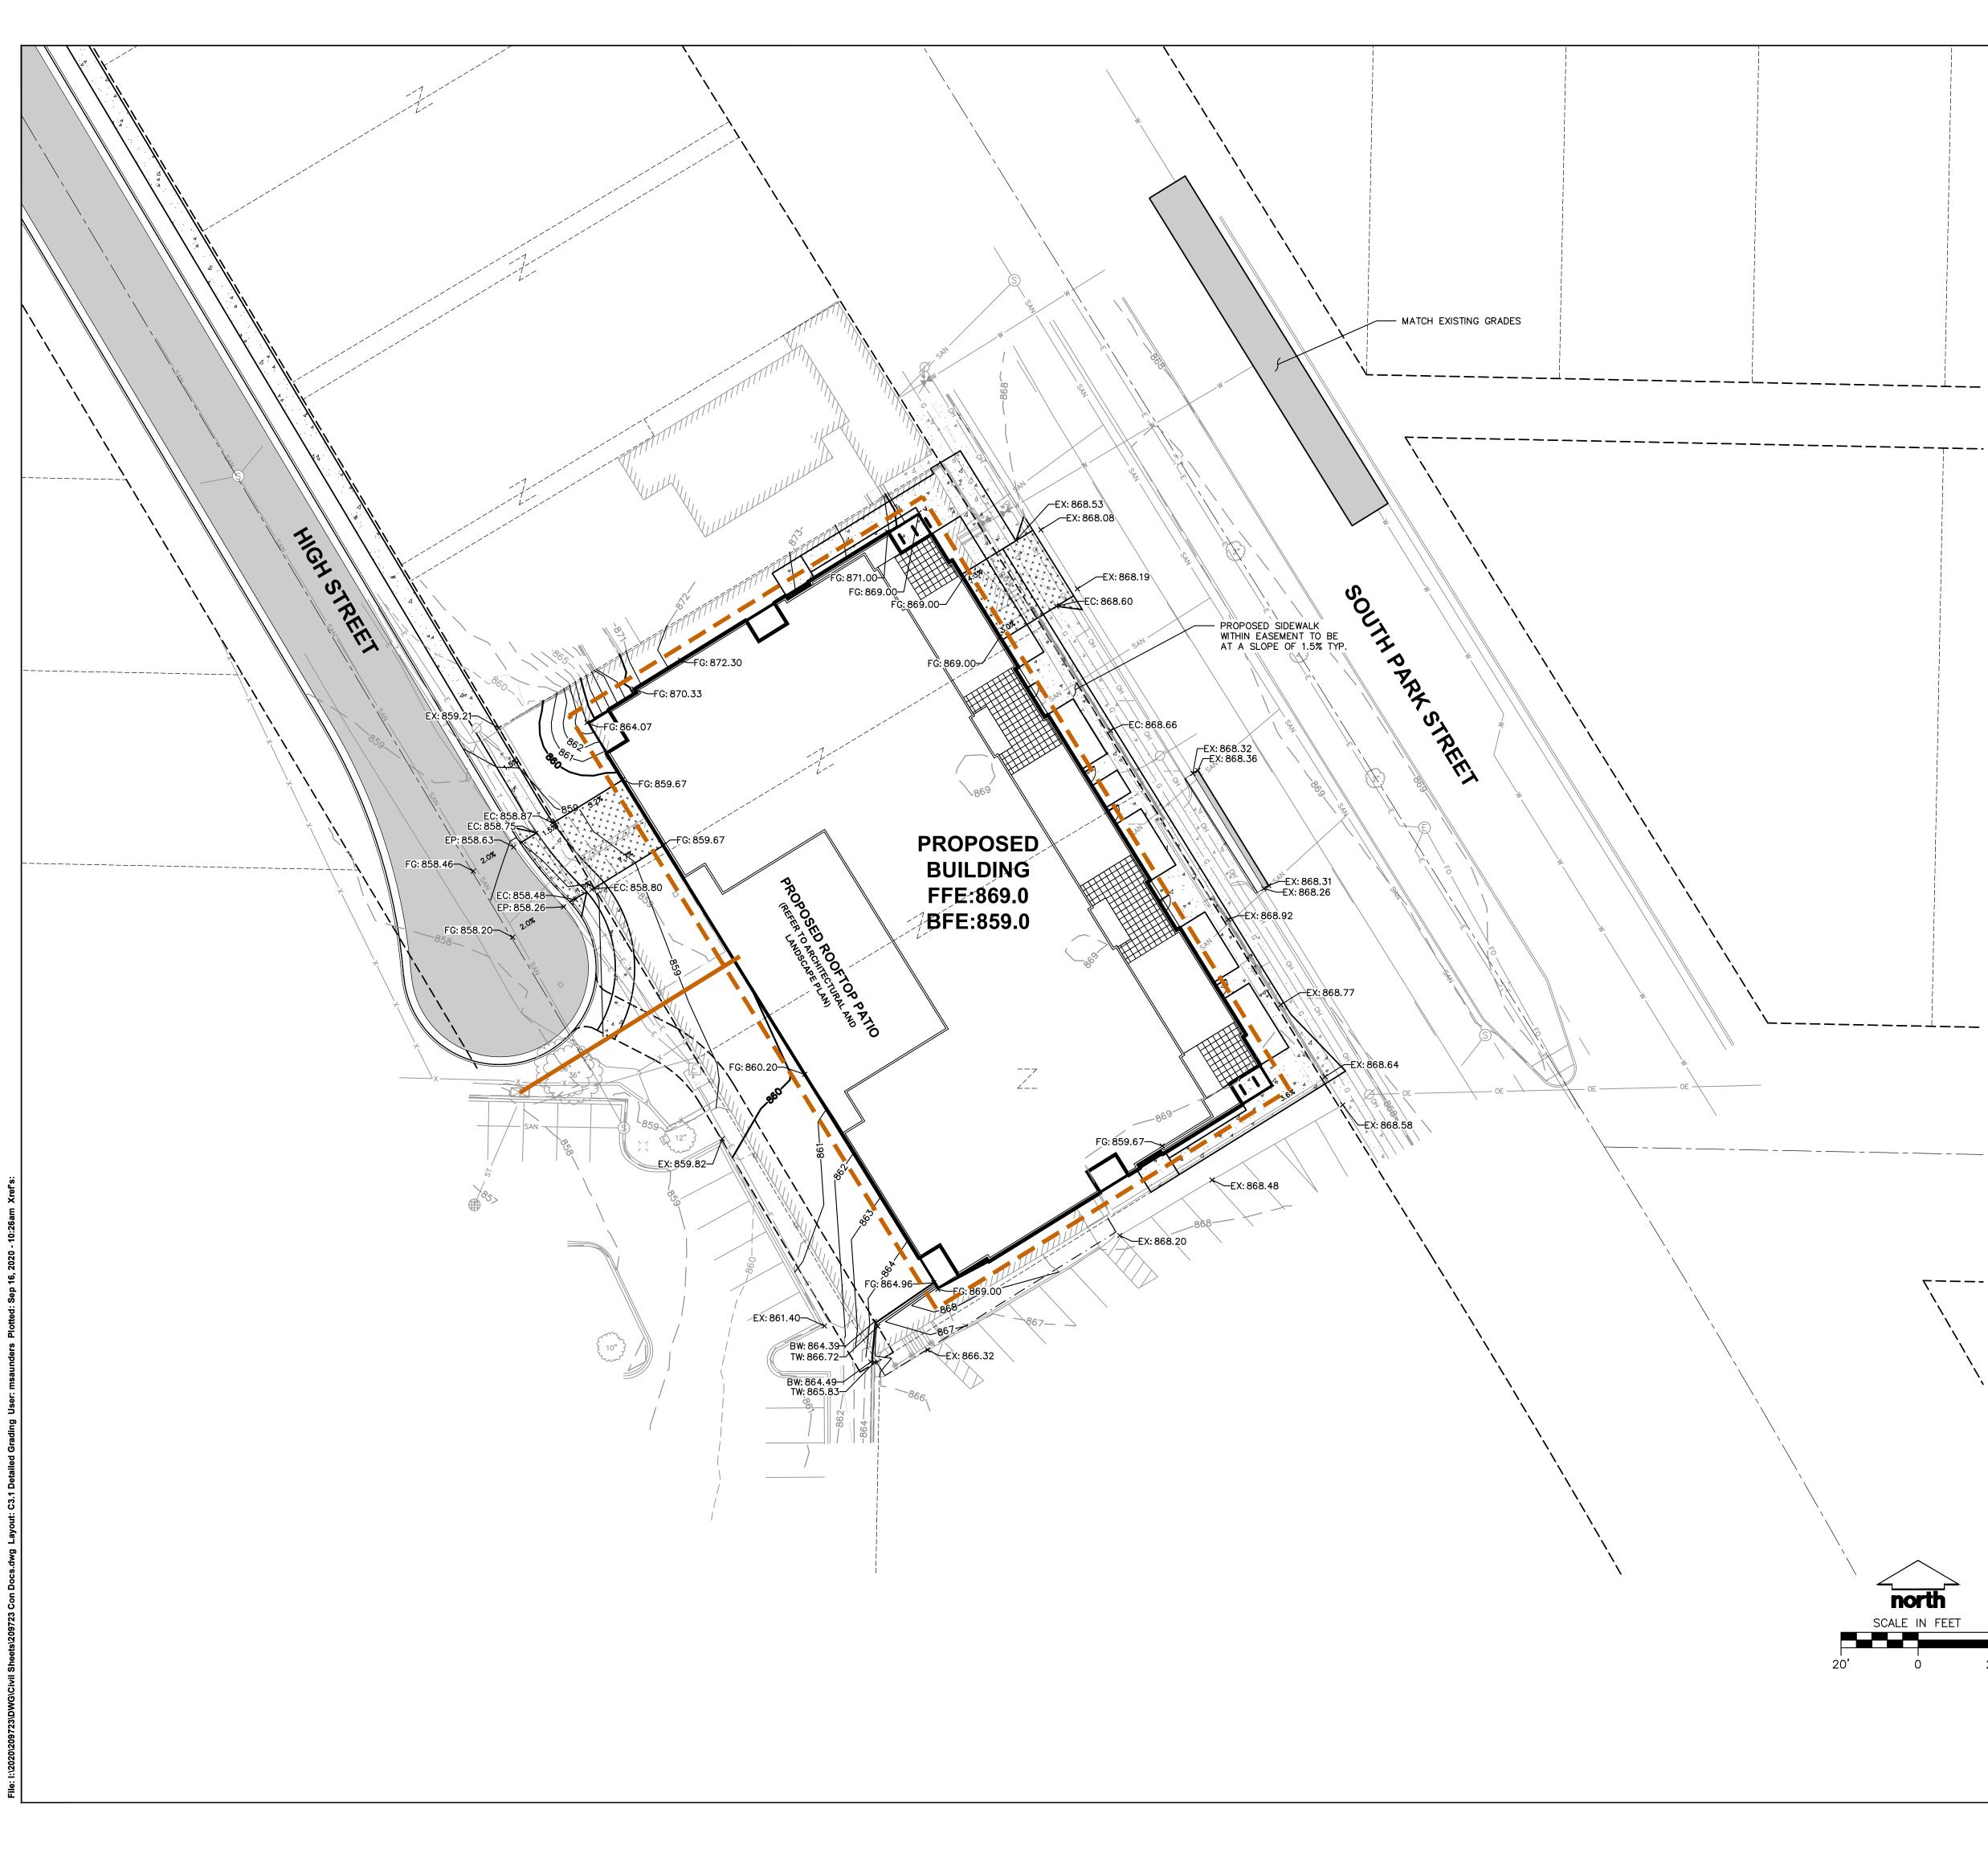

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PROPERTY LINE RIGHT-OF-WAY EASEMENT LINE BUILDING OUTLINE EDGE OF PAVEMENT STANDARD CURB AND GUTTER REJECT CURB AND GUTTER ASPHALT PAVEMENT HEAVY DUTY ASPHALT PAVEMENT CONCRETE PAVEMENT HEAVY DUTY CONCRETE PAVEMENT PROPOSED 1 FOOT CONTOUR PROPOSED 5 FOOT CONTOUR EXISTING 1 FOOT CONTOUR EXISTING 5 FOOT CONTOUR DRAINAGE DIRECTION GRADE BREAK RETAINING WALL RAILING FENCE SPOT ELEVATION EP - EDGE OF PAVEMENT FG - FINISH GRADE EC - EDGE OF CONCRETE BOC - BACK OF CURB EX - MATCH EXISTING GRADE HP - HIGH POINT SW - SIDEWALK



PROJECT LOCATION: MADISON, WI DANE COUNTY
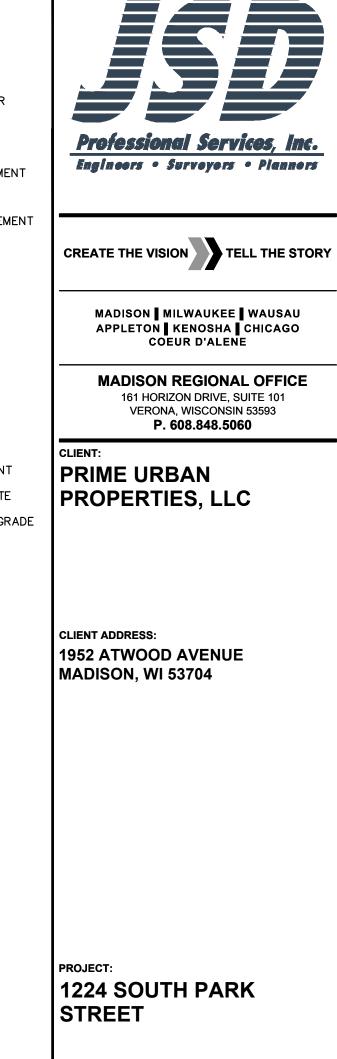
> PLAN MODIFICATIONS: Date: Description: 07.23.20 DAT PRESENTATION 08.19.20 UDC INFORMATIONAL 09.16.20 LAND USE - UDC SUBMITTAL Design/Drawn:


SHEET TITLE: DETAILED GRADING PLAN


Approved:

SHEET NUMBER:






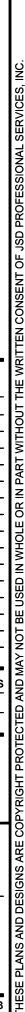

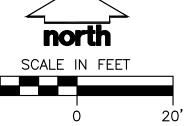

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BEDDING AND COVER MATERIAL - BEDDING AND COVER MATERIAL SHALL CONFORM TO THE APPROPRIATE SECTIONS OF THE "STANDARD SPECIFICATION" WITH THE FOLLOWING MODIFICATION: "COVER MATERIAL SHALL BE THE SAME AS USED FOR BEDDING AND SHALL CONFORM TO SECTION 8.43.2 (A). BEDDING AND COVER MATERIAL SHALL BE PLACED IN A MINIMUM OF THREE SEPARATE LIFTS, OR AS REQUIRED TO INSURE ADEQUATE COMPACTING OF THESE MATERIALS, WITH ONE LIFT OF

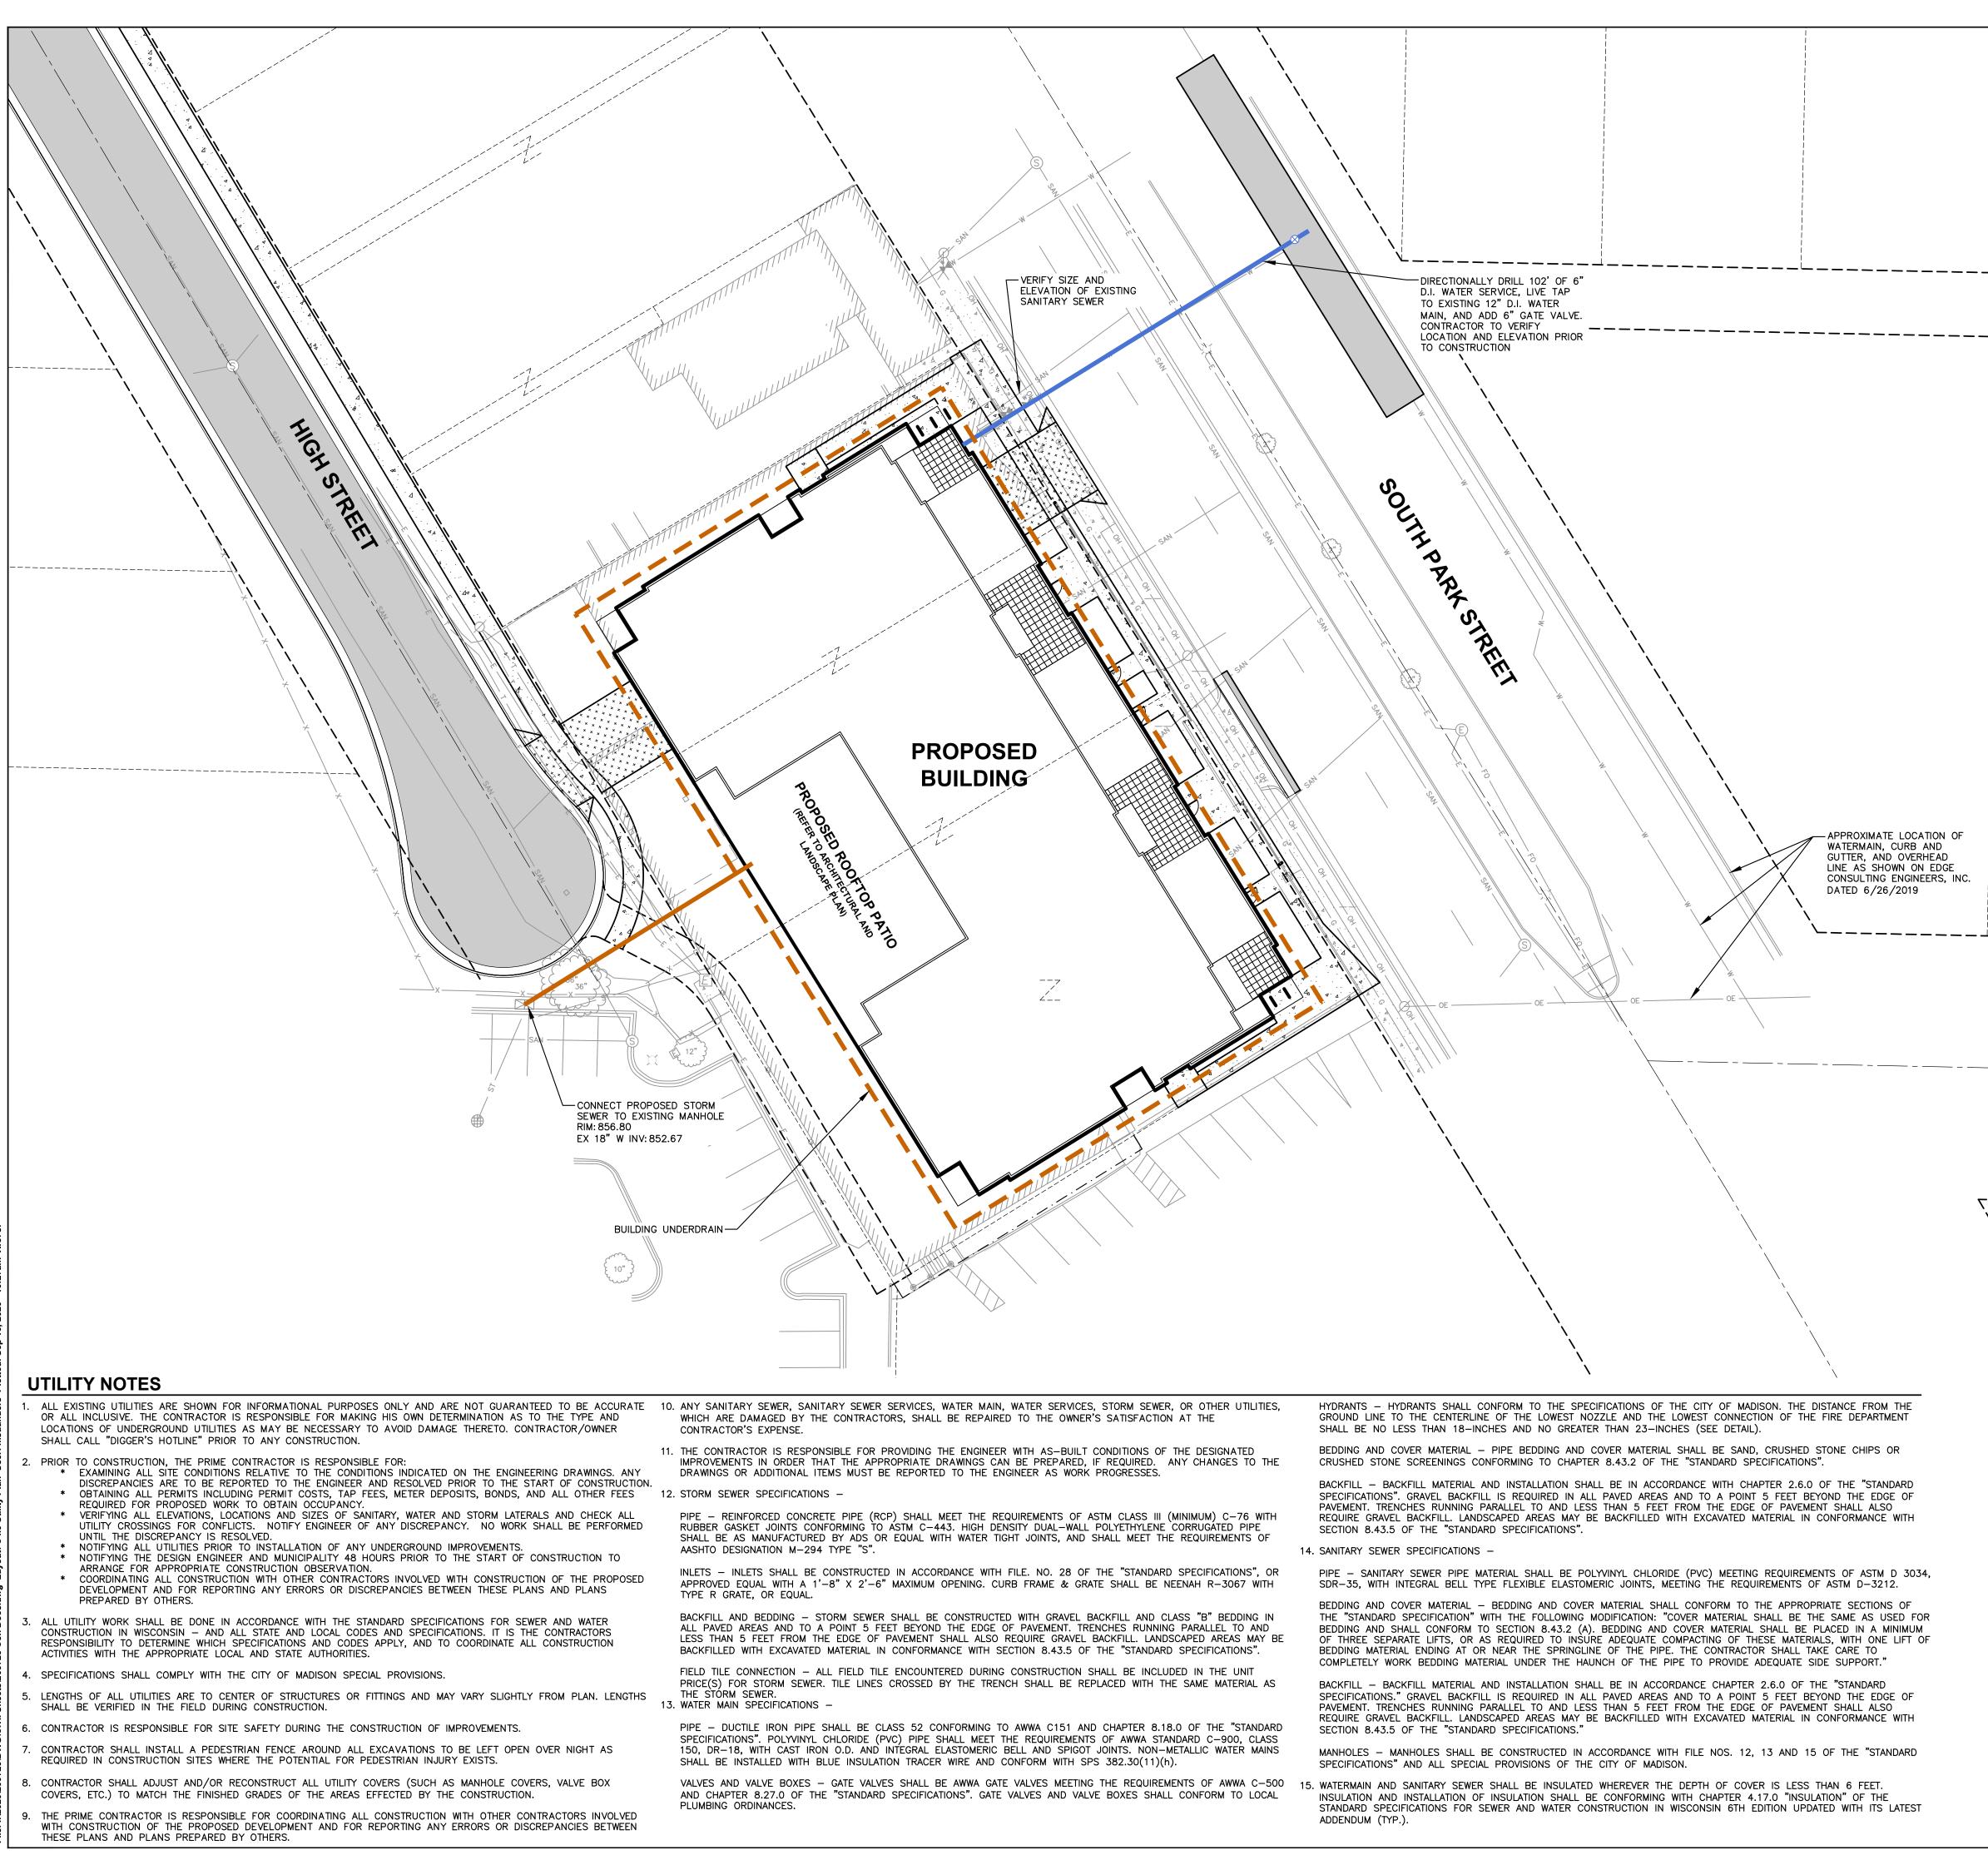
SPECIFICATIONS." GRAVEL BACKFILL IS REQUIRED IN ALL PAVED AREAS AND TO A POINT 5 FEET BEYOND THE EDGE OF REQUIRE GRAVEL BACKFILL. LANDSCAPED AREAS MAY BE BACKFILLED WITH EXCAVATED MATERIAL IN CONFORMANCE WITH


STANDARD SPECIFICATIONS FOR SEWER AND WATER CONSTRUCTION IN WISCONSIN 6TH EDITION UPDATED WITH ITS LATEST

1			
		PROPERTY LINE RIGHT-OF-WAY EASEMENT LINE BUILDING OUTLINE EDGE OF PAVEMENT STANDARD CURB AND GUTTER REJECT CURB AND GUTTER ASPHALT PAVEMENT CONCRETE PAVEMENT HEAVY DUTY CONCRETE PAVEMENT RETAINING WALL RAILING FENCE	Image: Create the vision Tell the story
	SS W 00	SANITARY SEWER WATERMAIN STORM SEWER	MADISON MILWAUKEE WAUSAU APPLETON KENOSHA CHICAGO COEUR D'ALENE MADISON REGIONAL OFFICE 161 HORIZON DRIVE, SUITE 101 VERONA, WISCONSIN 53593 P. 608.848.5060 CLIENT:
			CLIENT PRIME URBAN PROPERTIES, LLC CLIENT ADDRESS: 1952 ATWOOD AVENUE MADISON, WI 53704
			PROJECT: 1224 SOUTH PARK STREET PROJECT LOCATION: MADISON, WI
			DANE COUNTY PLAN MODIFICATIONS: # Date: 1 07.23.20 2 08.19.20
		SCALE IN FEET	3 09.16.20 LAND USE - UDC SUBMITTAL 4
	20' DIGE Toll	SCALE IN FEET 0 20' ERS HOTLINE Free (800) 242-8511	sheet number: C4.0

20-9723

JSD PROJECT NO:

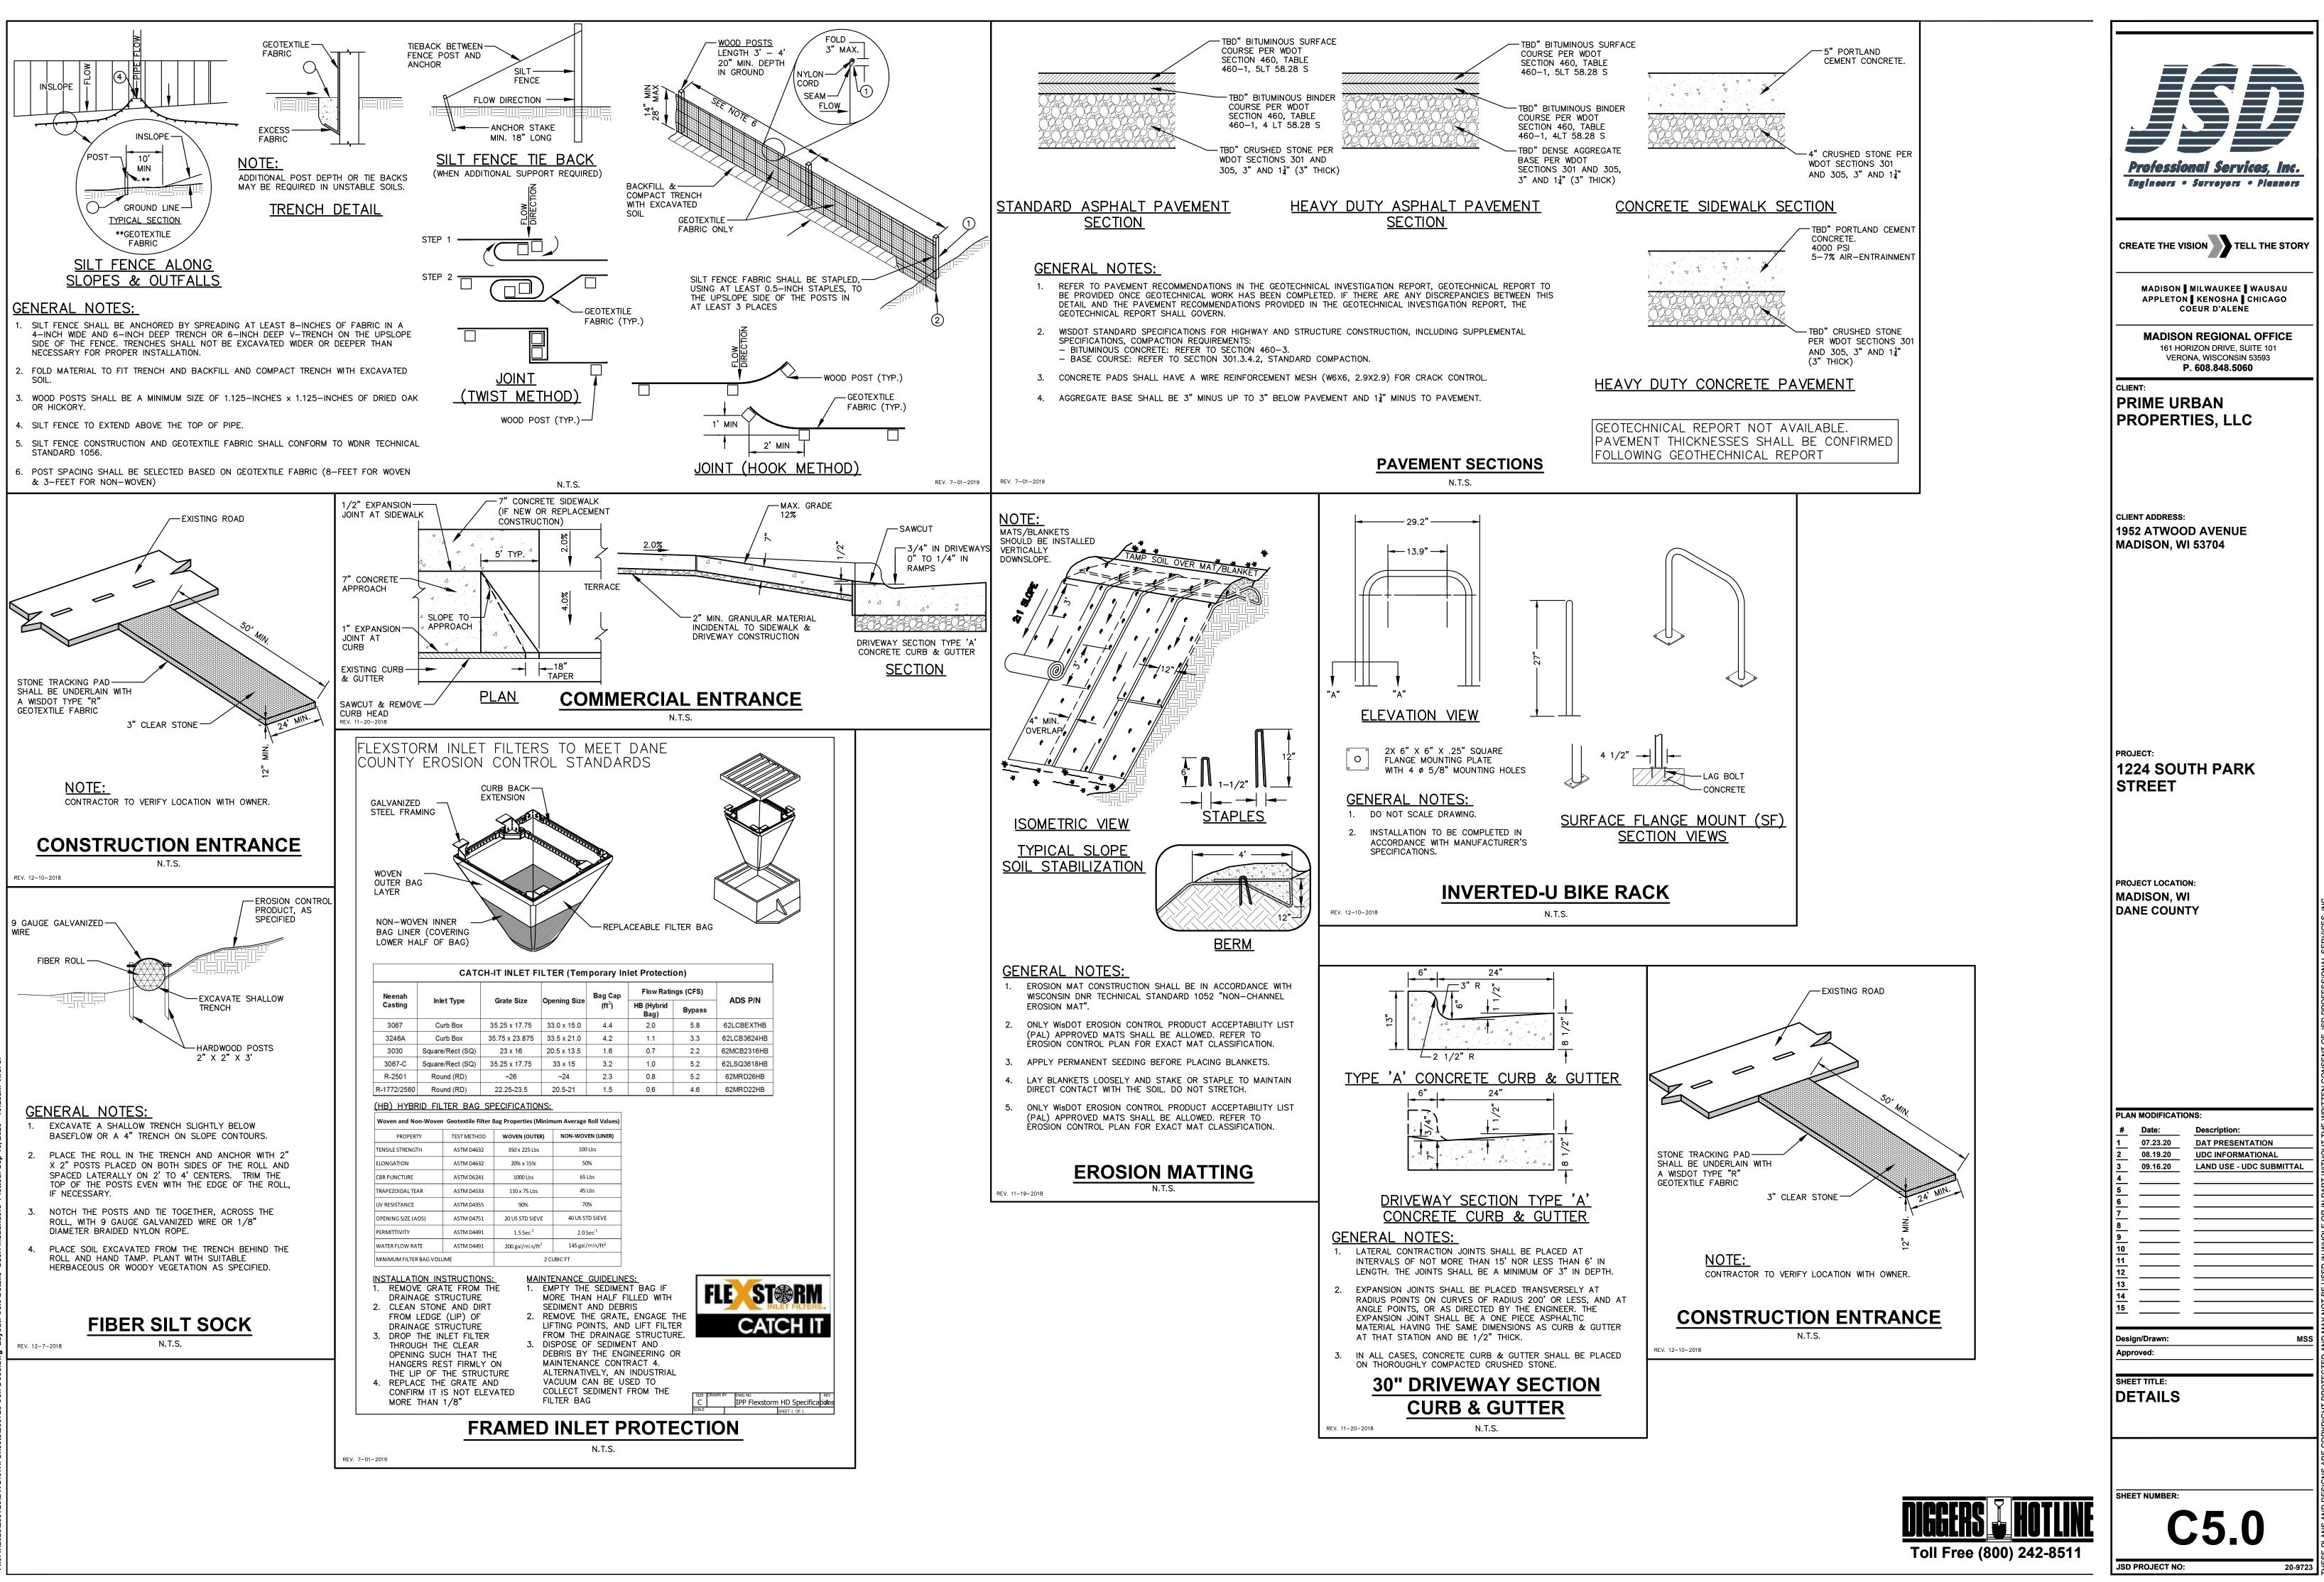

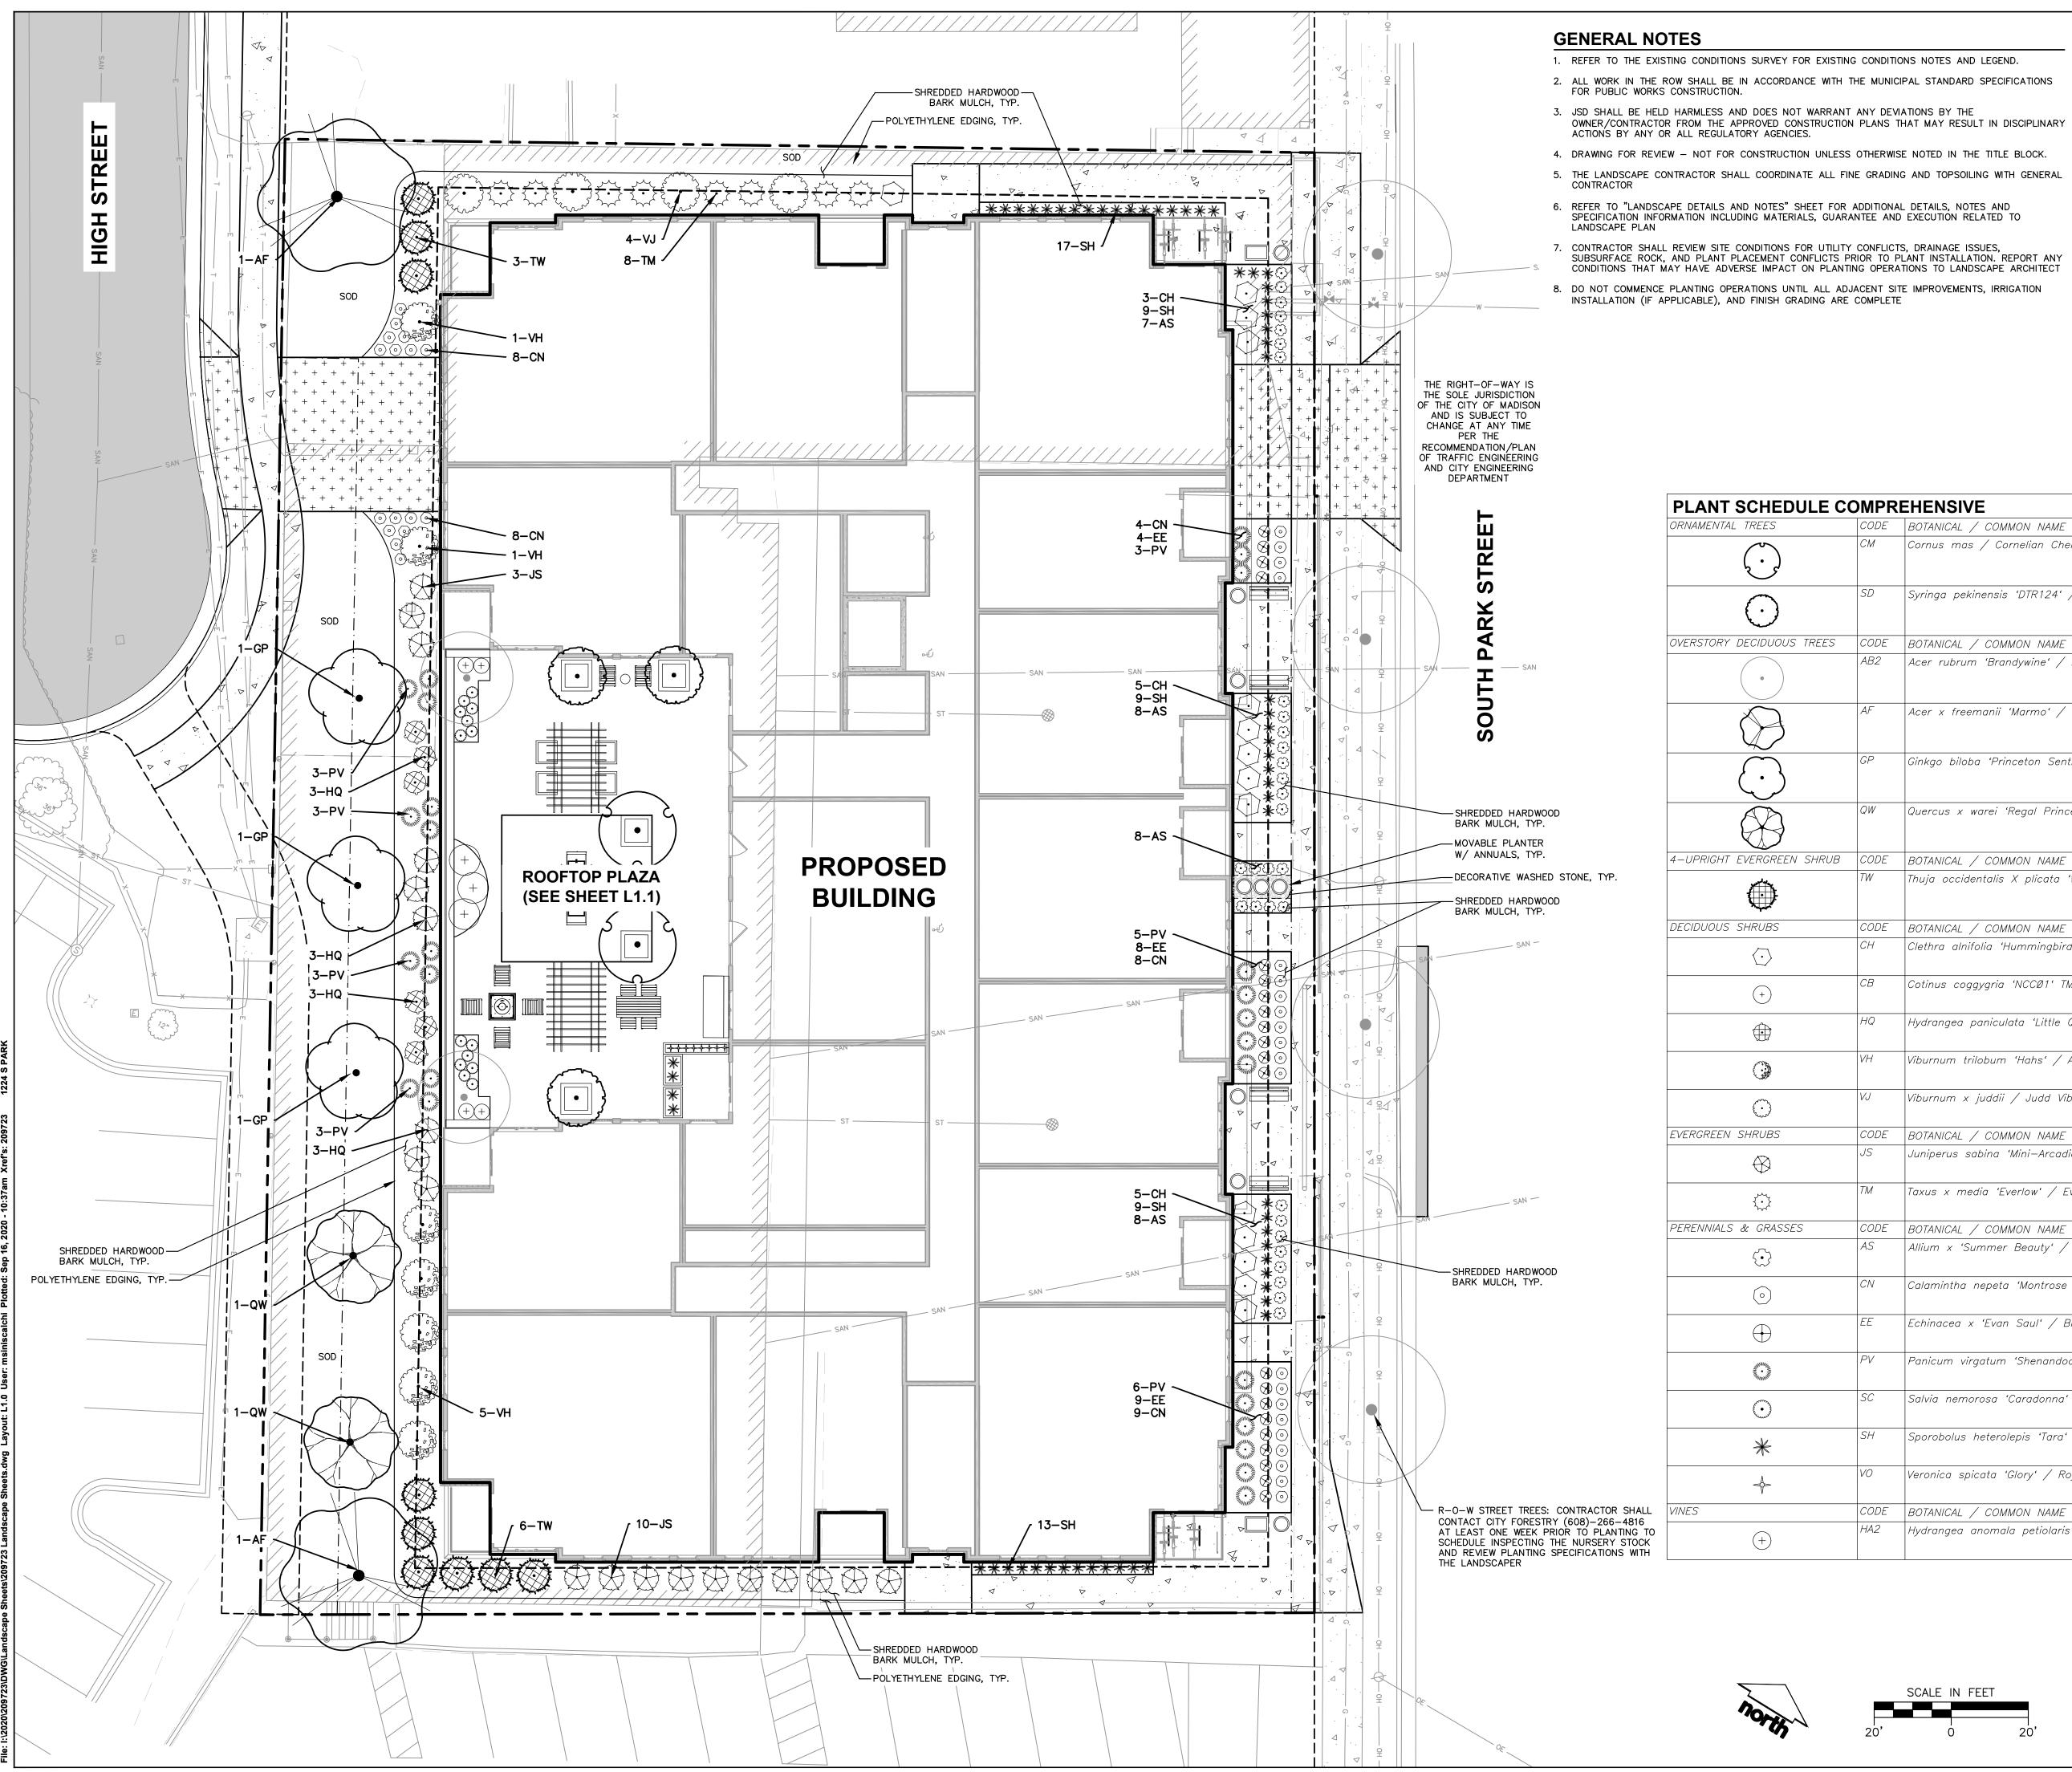


ING CONDITIONS NOTES AND LEGEND.
THE MUNICIPAL STANDARD SPECIFICATIONS
NT ANY DEVIATIONS BY THE ION PLANS THAT MAY RESULT IN DISCIPLINARY

LEGEND	
	PROPERTY LINE
	RIGHT-OF-WAY
_ · _ · _ · _ · _ · _ · _	EASEMENT LINE
	BUILDING OUTLINE
	BUILDING OVERHANG
	EDGE OF PAVEMENT
	STANDARD CURB AND GUTTER
	REJECT CURB AND GUTTER
	ASPHALT PAVEMENT
•••••	HEAVY DUTY ASPHALT PAVEMENT
	CONCRETE PAVEMENT
+ $+$ $+$ $+$ $+$ $+$ $+$ $+$ $+$ $+$	HEAVY DUTY CONCRETE PAVEMENT
SS	SANITARY SEWER
W	WATERMAIN
	STORM SEWER
SAN	EXISTING SANITARY SEWER
W	EXISTING WATERMAIN
ST	EXISTING STORM SEWER
	RETAINING WALL

BIKE RACK POLYETHYLENE EDGING

	CODE	BOTANICAL / COMMON NAME	QTY
	СМ	Cornus mas / Cornelian Cherry Dogwood	2
	SD	Suringa polyingnois (DTD124) / Summer Charme Dallie Liter	3
		Syringa pekinensis 'DTR124' / Summer Charm Pekin Lilac	
	CODE	BOTANICAL / COMMON NAME	QTY
	AB2	Acer rubrum 'Brandywine' / Brandywine Red Maple	2
	AF	Acer x freemanii 'Marmo' / Marmo Freeman Maple	2
	/ 1/	Acer x freemann marno / marno freeman maple	
	GP	Ginkgo biloba 'Princeton Sentry' / Princeton Sentry Gingko	3
	QW	Quercus x warei 'Regal Prince' / Regal Prince Oak	2
7	CODE	BOTANICAL / COMMON NAME	QTY
ر 			
	TW	Thuja occidentalis X plicata 'Wintergreen' / Wintergreen Arborvitae	9
	CODE	BOTANICAL / COMMON NAME	QTY
	СН	Clethra alnifolia 'Hummingbird' / Hummingbird Summersweet	14
	СВ	Cotinus coggygria 'NCCØ1' TM / Winecraft Black Smoke Tree	3
	HQ	lludennen neninulata (Little Quiel, Eiro). / Little Quiel, Eiro Lludennen	6
		Hydrangea paniculata 'Little Quick Fire' / Little Quick Fire Hydrangea	
	VH	Viburnum trilobum 'Hahs' / American Cranberrybush	7
	171		4
	VJ	Viburnum x juddii / Judd Viburnum	4
	CODE	BOTANICAL / COMMON NAME	QTY
	JS	Juniperus sabina 'Mini–Arcadia' / Mini Arcadia Juniper	19
	TM	Taxus x media 'Everlow' / Everlow Yew	8
	CODE	BOTANICAL / COMMON NAME	QTY
		BOTANICAL / COMMON NAME	
	AS	Allium x 'Summer Beauty' / Summer Beauty Allium	31
	CN	Calamintha nepeta 'Montrose White' / Montrose White Catmint	37
	EE	Echinacea x 'Evan Saul' / Big Sky Sundown Coneflower	21
	PV	Panicum virgatum 'Shenandoah' / Shenandoah Switch Grass	26
		 	20
	SC	Salvia nemorosa 'Caradonna' / Cardonna Perennial Salvia	14
			61
	SH	Sporobolus heterolepis 'Tara' / Prairie Dropseed	61
	VO	Veronica spicata 'Glory' / Royal Candles Speedwell	8
	CODE	BOTANICAL / COMMON NAME	QTY
	HA2	Hydrangea anomala petiolaris / Climbing Hydrangea	4
	1		

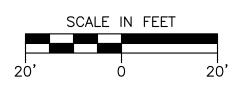






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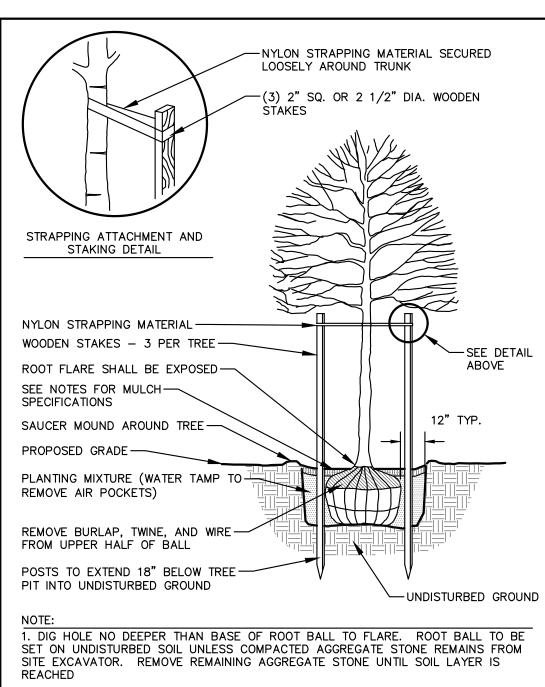
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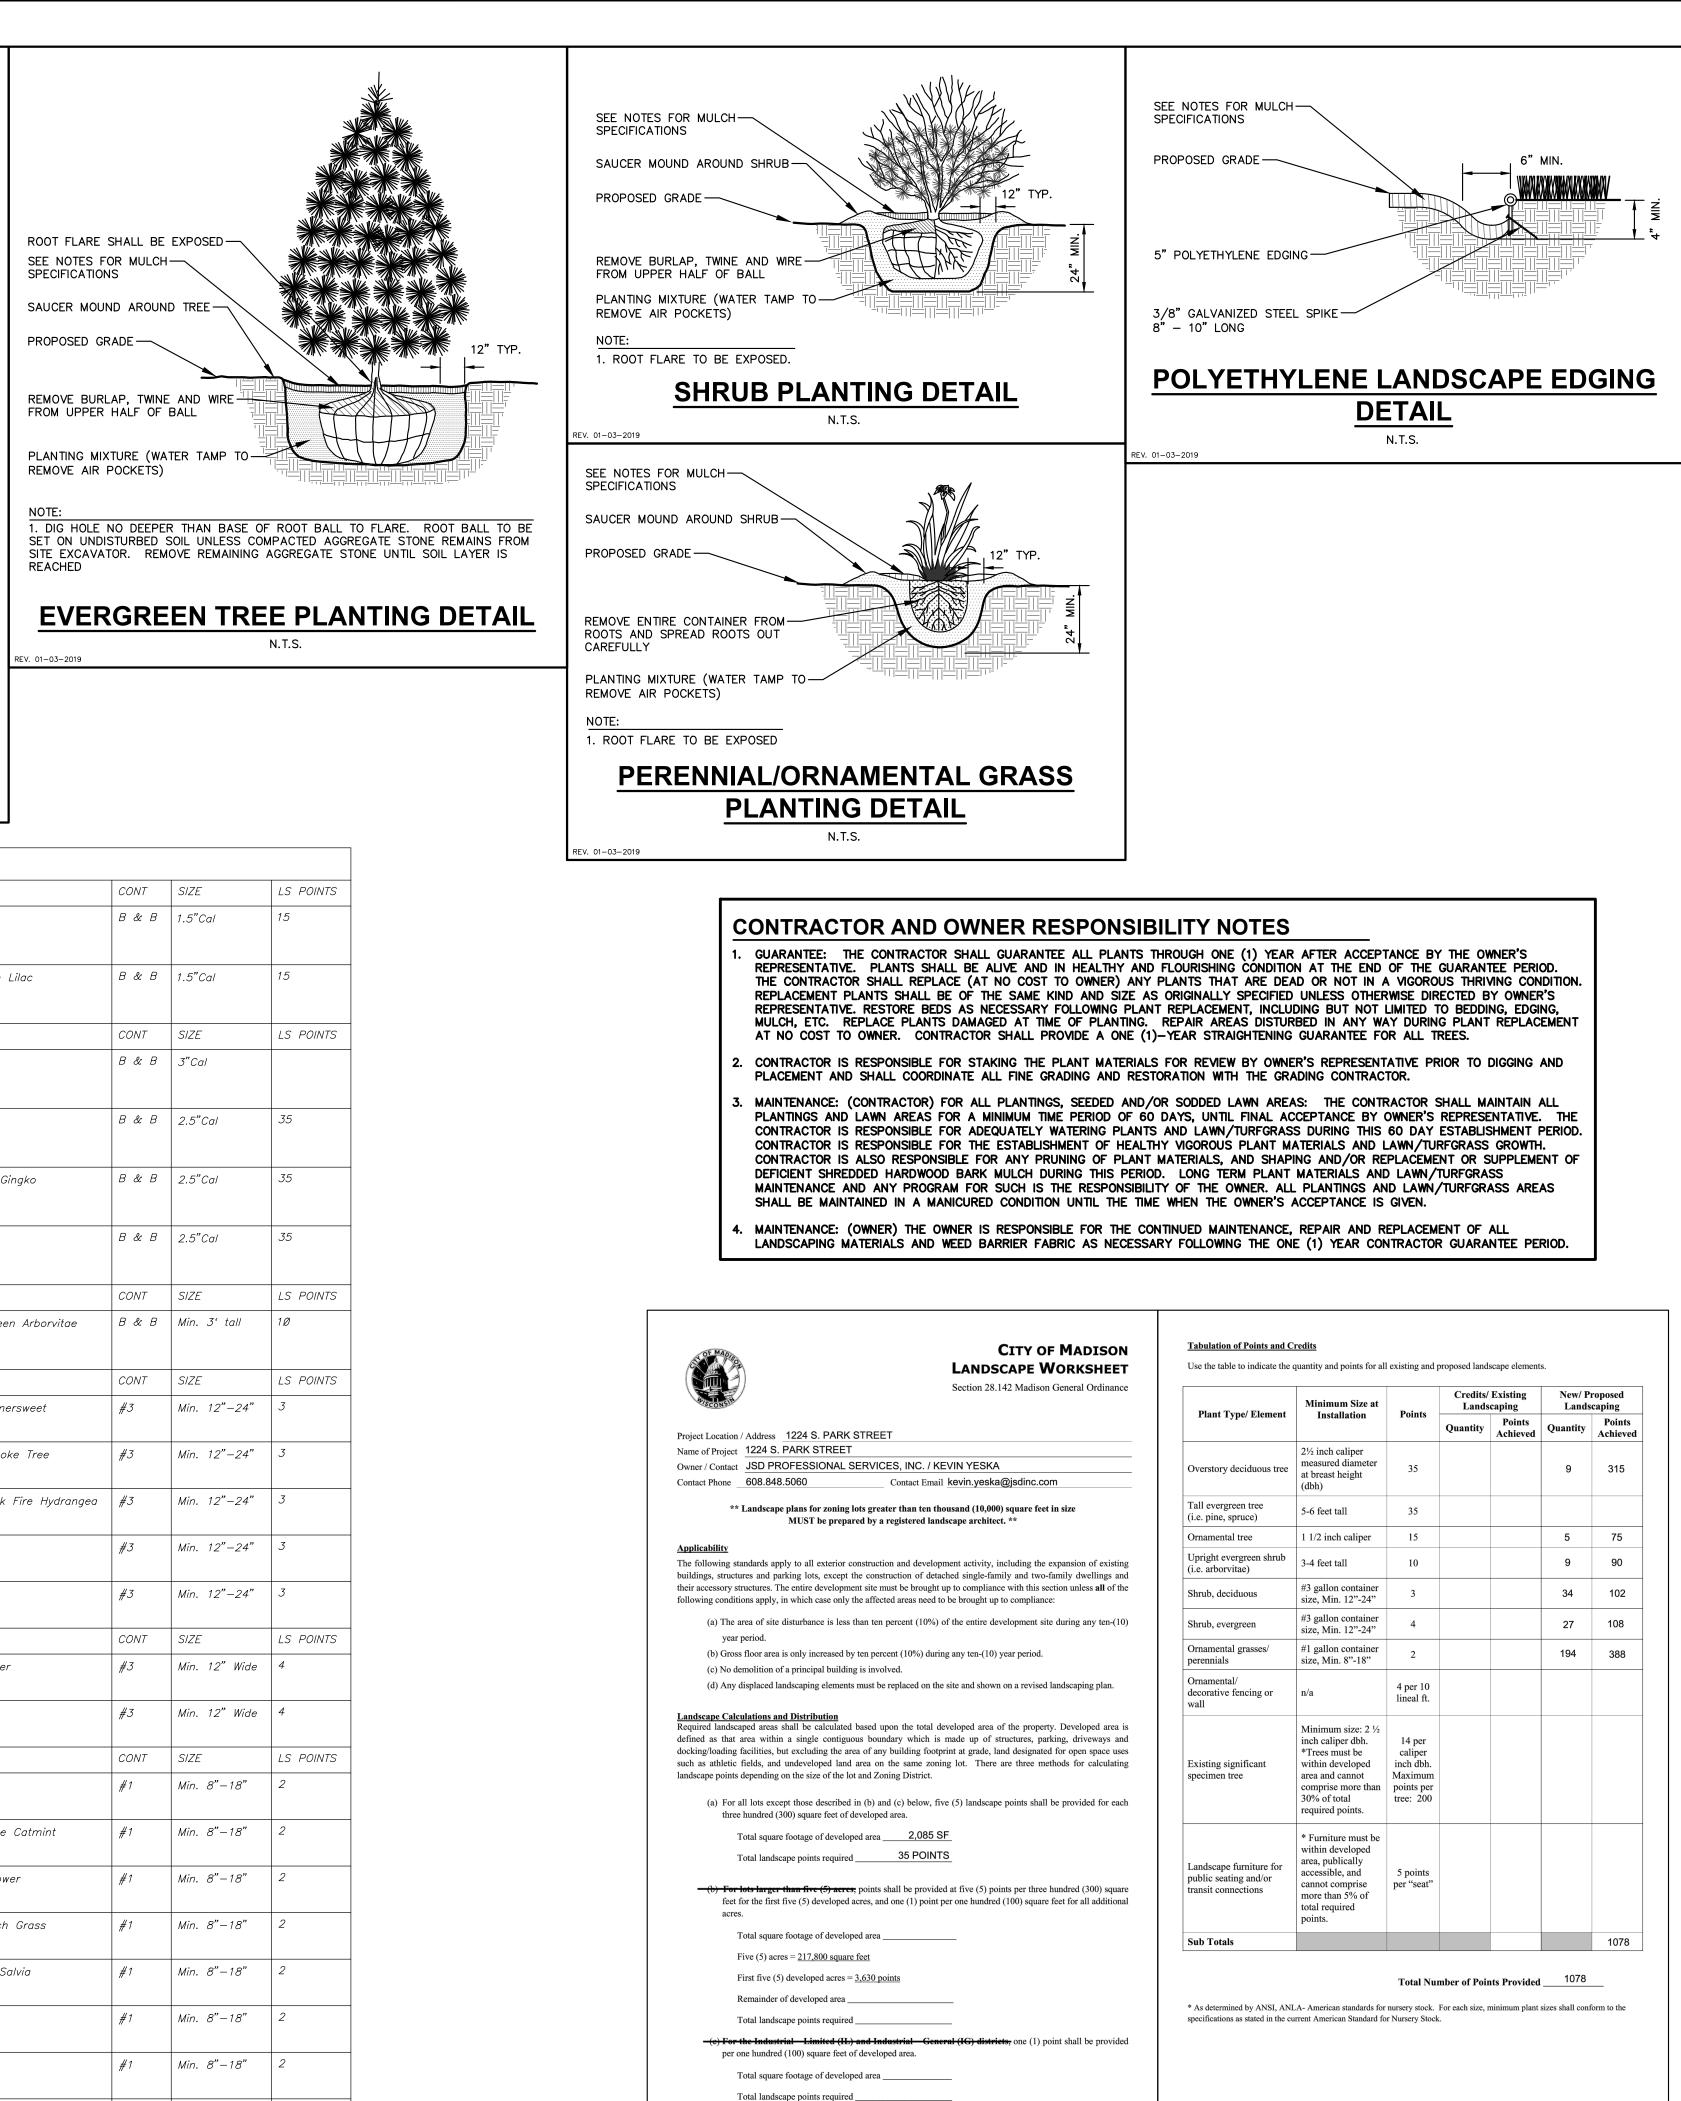


PLANT SCHEDULE ROOFTOP PLAZA					
ORNAMENTAL TREES	QTY	BOTANICAL / COMMON NAME	CONT	SIZE	LS POINTS
	2	Cornus mas / Cornelian Cherry Dogwood	B & B	1.5"Cal	15
\bigcirc	3	Syringa pekinensis 'DTR124' / Summer Charm Pekin Lilac	B & B	1.5"Cal	15
OVERSTORY DECIDUOUS TREES	QTY	BOTANICAL / COMMON NAME	CONT	SIZE	LS POINTS
(+)	2	Acer rubrum 'Brandywine' / Brandywine Red Maple	B & B	3"Cal	
DECIDUOUS SHRUBS	QTY	BOTANICAL / COMMON NAME	CONT	SIZE	LS POINTS
\odot	3	Cotinus coggygria 'NCCØ1' TM / Winecraft Black Smoke Tree	#3	Min. 12"—24"	3
PERENNIALS & CRASSES	QTY	BOTANICAL / COMMON NAME	CONT	SIZE	LS POINTS
\$	14	Salvia nemorosa 'Caradonna' / Cardonna Perennial Salvia	#1	Min. 8"-18"	2
(+)	4	Sporobolus heterolepis 'Tara' / Prairie Dropseed	#1	Min. 8"-18"	2
	8	Veronica spicata 'Glory' / Royal Candles Speedwell	#1	Min. 8"-18"	2
VINES	QTY	BOTANICAL / COMMON NAME	CONT	SIZE	LS POINTS
	4	Hydrangea anomala petiolaris / Climbing Hydrangea	#3	Min. 12"-24"	2

		Surveyors • Planners
CR	EATE THE VI	TELL THE STORY
	APPLETON	MILWAUKEE WAUSAU KENOSHA CHICAGO OEUR D'ALENE
	161 HO VERC	N REGIONAL OFFICE DRIZON DRIVE, SUITE 101 DNA, WISCONSIN 53593 P. 608.848.5060
	RIME UF	RBAN FIES, LLC
195	NT ADDRESS: 52 ATWOC DISON, W	D AVENUE
12 ST	REET	TH PARK
MA	JECT LOCATIC DISON, W NE COUN	1
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$\frac{1}{2}$ $\frac{3}{4}$	07.23.20 08.19.20 09.16.20	DAT PRESENTATION UDC INFORMATIONAL LAND USE - UDC SUBMITTAL
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<u>14</u> <u>15</u>		
Appr SHEI 2N		MWS/SCD KJY OR ROOFTOP ANDSCAPE PLAN
SHE	ET NUMBER:	_1.1
100	PROJECT NO:	20-9723

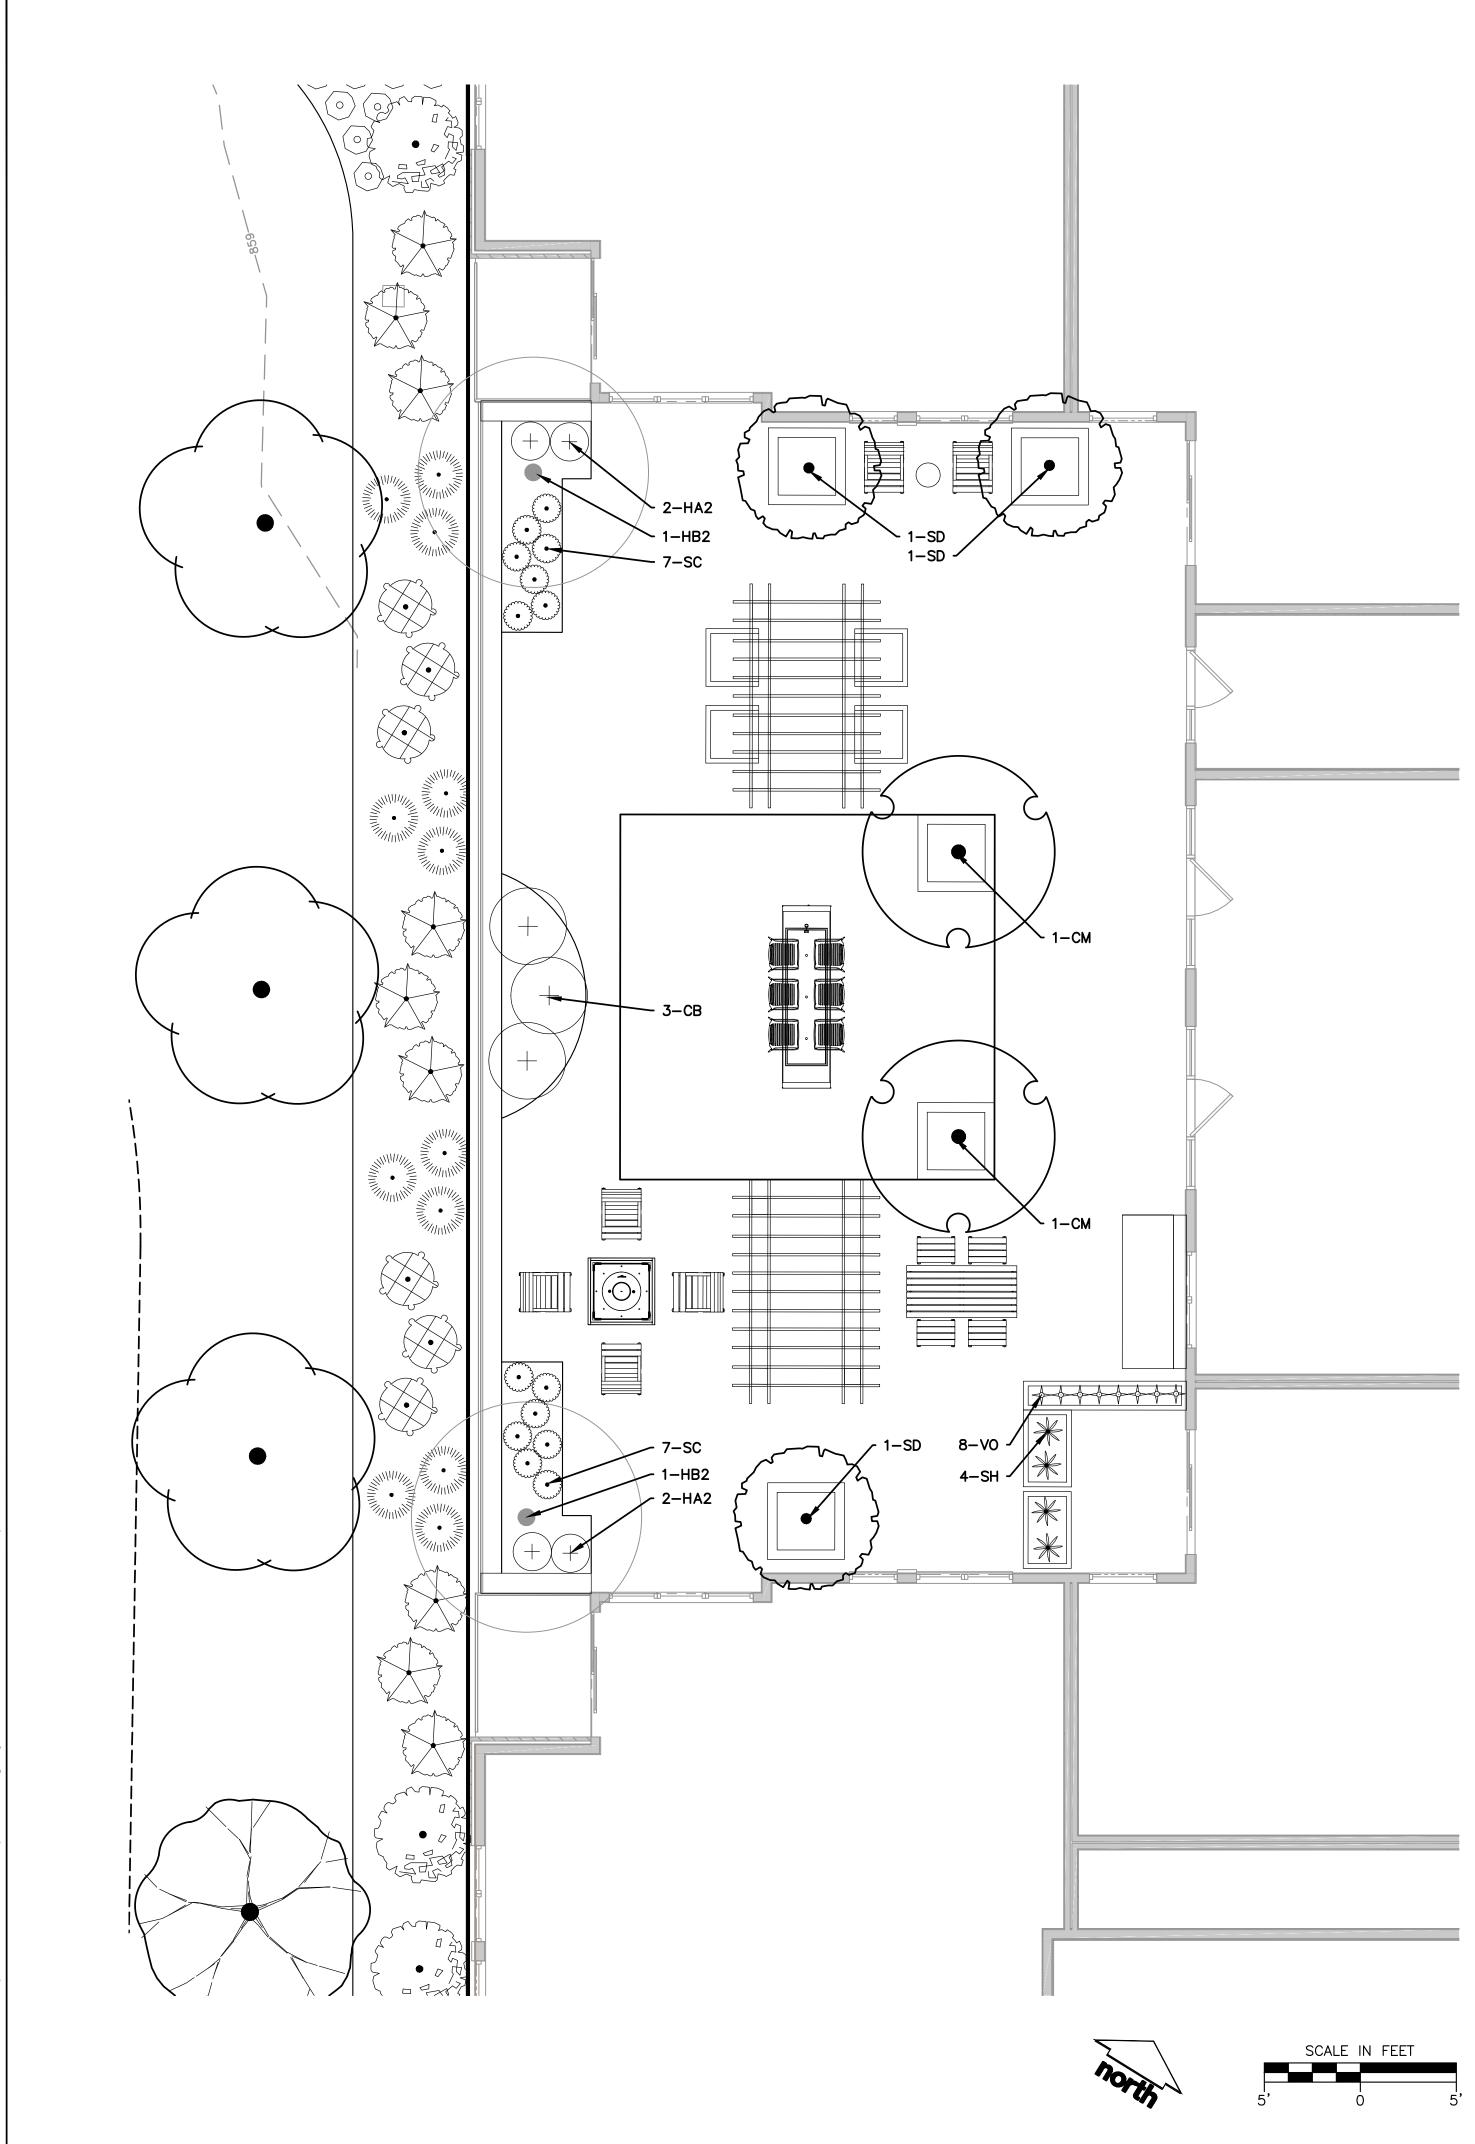





2. REMOVE NYLON STRAPPING WITHIN 9-18 MONTHS FOLLOWING

INSTALLATION

DECIDUOUS TREE PLANTING DETAIL N.T.S.

REV	. 01-04-2018	,

PLANT SCHEDULE COMPREHE	NSIVE

ORNAMENTAL TREES	QTY	BOTANICAL / COMMON NAME	CONT	SIZE	LS POINTS
	2	Cornus mas / Cornelian Cherry Dogwood	B & B	1.5"Cal	15
\odot	3	Syringa pekinensis 'DTR124' / Summer Charm Pekin Lilac	B & B	1.5"Cal	15
OVERSTORY DECIDUQUS TREES	QTY	BOTANICAL / COMMON NAME	CONT	SIZE	LS POINTS
	2	Acer rubrum 'Brandywine' / Brandywine Red Maple	B & B	3"Cal	
(\cdot)	2	Acer x freemanii 'Marmo' / Marmo Freeman Maple	B & B	2.5"Cal	35
$\overline{(2)}$	3	Ginkgo biloba 'Princeton Sentry' / Princeton Sentry Gingko	B & B	2.5"Cal	35
	2	Quercus x warei 'Regal Prince' / Regal Prince Oak	B & B	2.5"Cal	35
4–UPRIGHT EVERGREEN SHRUB	QTY	BOTANICAL / COMMON NAME	CONT	SIZE	LS POINTS
$\langle \cdot \rangle$	9	' Thuja occidentalis X plicata 'Wintergreen' / Wintergreen Arborvitae	B & B	Min. 3' tall	1Ø
(+) DECIDUOUS SHRUBS	QTY	BOTANICAL / COMMON NAME	CONT	SIZE	LS POINTS
	14	Clethra alnifolia 'Hummingbird' / Hummingbird Summersweet	#3	Min. 12"-24"	3
	3	Cotinus coggygria 'NCCØ1' TM / Winecraft Black Smoke Tree	#3	Min. 12"-24"	3
<u>له ۲</u>	6	Hydrangea paniculata 'Little Quick Fire' / Little Quick Fire Hydrangea	#3	Min. 12"-24"	3
₩ J.L.	7	Viburnum trilobum 'Hahs' / American Cranberrybush	#3	Min. 12"-24"	3
	4	Viburnum x juddii / Judd Viburnum	#3	Min. 12"-24"	3
EVERGREEN SHRUBS	QTY	BOTANICAL / COMMON NAME	CONT	SIZE	LS POINTS
\bigcirc	19	Juniperus sabina 'Mini—Arcadia' / Mini Arcadia Juniper	#3	Min. 12" Wide	4
\oplus	8	Taxus x media 'Everlow' / Everlow Yew	#3	Min. 12" Wide	4
PERENNIALS & CRASSES	QTY	BOTANICAL / COMMON NAME	CONT	SIZE	LS POINTS
\odot	31	Allium x 'Summer Beauty' / Summer Beauty Allium	#1	Min. 8"-18"	2
*	37	Calamintha nepeta 'Montrose White' / Montrose White Catmint	#1	Min. 8"-18"	2
÷	21	Echinacea x 'Evan Saul' / Big Sky Sundown Coneflower	#1	Min. 8"—18"	2
+	26	Panicum virgatum 'Shenandoah' / Shenandoah Switch Grass	#1	Min. 8"—18"	2
	14	Salvia nemorosa 'Caradonna' / Cardonna Perennial Salvia	#1	Min. 8"-18"	2
	61	Sporobolus heterolepis 'Tara' / Prairie Dropseed	#1	Min. 8"—18"	2
	8	Veronica spicata 'Glory' / Royal Candles Speedwell	#1	Min. 8"-18"	2
VINES	QTY	BOTANICAL / COMMON NAME	CONT	SIZE	LS POINTS
	4	Hydrangea anomala petiolaris / Climbing Hydrangea	#3	Min. 12"—24"	2

10/2013

GENERAL NOTES

- GENERAL: ALL WORK IN THE R-O-W AND PUBLIC EASEMENTS SHALL BE IN ACCORDANCE WITH LOCAL MUNICIPAL REQUIREMENTS. JSD SHALL BE HELD HARMLESS AND DOES NOT WARRANT ANY DEVIATIONS BY THE OWNER/CONTRACTOR FROM THE APPROVED CONSTRUCTION PLANS THAT MAY RESULT IN DISCIPLINARY ACTIONS BY ANY OR ALL REGULATORY AGENCIES. LOCATE ALL UTILITIES PRIOR TO CONSTRUCTION. THE CONTRACTOR IS RESPONSIBLE FOR REPAIRING ANY DAMAGE DONE TO UTILITIES. CONTRACTOR MUST CALL 1-800-242-8511 FOR UTILITY LOCATIONS AT LEAST THREE DAYS PRIOR TO DIGGING. HAND DIG AND INSTALL ALL PLANTS THAT ARE NEAR EXISTING UTILITIES. PROTECT PREVIOUSLY INSTALLED WORK OF OTHER TRADES. CONTRACTOR IS RESPONSIBLE FOR STAKING THE PLANT MATERIALS FOR REVIEW BY OWNER PRIOR TO DIGGING AND PLACEMENT AND SHALL COORDINATE ALL FINE GRADING AND RESTORATION WITH THE GRADING CONTRACTOR.
- DELIVERY AND HANDLING: DO NOT DELIVER MORE PLANT MATERIALS THAN CAN BE PLANTED IN ONE DAY, UNLESS ADEQUATE, APPROPRIATE AND SECURE STORAGE IS PROVIDED AND APPROVED BY OWNER'S REPRESENTATIVE. AT ALL TIMES, PROTECT ALL PLANT MATERIALS FROM WIND AND DIRECT SUN. DELIVER PLANTS WITH LEGIBLE IDENTIFICATION LABELS. PROTECT PLANTS DURING DELIVERY AND DO NOT PRUNE PRIOR TO DELIVERY. ALL TREES AND SHRUBS SHALL BE PLANTED ON THE DAY OF DELIVERY: IF THIS IS NOT POSSIBLE. PROTECT THE PLANT MATERIALS NOT PLANTED BY STORING THEM IN A SHADED, SECURE AREA, PROTECTING THE ROOT MASS WITH WET SOIL, MULCH, HAY OR OTHER SUITABLE MEDIUM. CONTRACTOR TO KEEP ALL PLANT MATERIALS ADEQUATELY WATERED TO PREVENT ROOT DESICCATION. DO NOT REMOVE CONTAINER GROWN STOCK FROM CONTAINERS BEFORE TIME OF PLANTING. DO NOT PICK UP CONTAINER OR BALLED PLANTS BY STEM OR ROOTS. ALL PLANTS SHALL BE LIFTED AND HANDLED FROM THE BOTTOM OF THE CONTAINER OR BALL. PERFORM ACTUAL PLANTING ONLY WHEN WEATHER AND SOIL CONDITIONS ARE SUITABLE IN ACCORDANCE WITH LOCALLY ACCEPTED BEST HORTICULTURAL PRACTICES.
- MATERIALS PLANTS: ALL PLANTS SHALL CONFORM TO THE LATEST VERSION OF THE AMERICAN STANDARD FOR NURSERY STOCK ANSI Z60.1. PLANTS SHALL BE TRUE TO SPECIES AND VARIETY SPECIFIED AND NURSERY GROWN IN ACCORDANCE WITH GOOD HORTICULTURAL PRACTICES UNDER CLIMATIC CONDITIONS SIMILAR TO THOSE IN THE LOCALITY OF THE PROJECT FOR AT LEAST 2 YEARS. PLANTS SHALL BE FRESHLY DUG (DURING THE MOST RECENT FAVORABLE HARVEST SEASON). PLANTS SHALL BE SO TRAINED IN DEVELOPMENT AND APPEARANCE AS TO BE UNQUESTIONABLY SUPERIOR IN FORM, COMPACTNESS, AND SYMMETRY. PLANTS SHALL BE SOUND, HEALTHY, VIGOROUS, WELL BRANCHED AND DENSELY FOLIATED WHEN IN LEAF, AND FREE OF DISEASE AND INSECTS (ADULT EGGS, PUPAE OR LARVAE). THEY SHALL HAVE HEALTHY, WELL-DEVELOPED ROOT SYSTEMS AND SHALL BE FREE FROM PHYSICAL DAMAGE OR OTHER CONDITIONS THAT WOULD PREVENT THRIVING GROWTH OR PREMATURE MORTALITY. PLANTS SHALL BE OF THE HIGHEST QUALITY, POSSESS TYPICAL GROWTH HABITS AND FORM FOR THEIR SPECIES AND BE FREE OF INJURY. PARKWAY TREES AND PARKING LOT TREES SHALL HAVE A MINIMUM BRANCHING HEIGHT OF SIX (6) FEET ABOVE THE GROUND TO ALLOW ADEQUATE VISUAL AND PHYSICAL CLEARANCE.
- 4. PRUNING: THE CONTRACTOR SHALL PRUNE ALL TREES AND REPAIR ANY INJURIES THAT OCCURRED DURING THE PLANTING PROCESS. DOUBLE LEADERS, DEAD BRANCHES, AND LIMBS DAMAGED OR BROKEN DURING THE PLANTING PROCESS, SHALL BE PRUNED. THIS SHALL BE THE ONLY PRUNING ALLOWED AT PLANTING. PRUNING SHALL CONFORM TO THE LATEST VERSION OF THE AMERICAN STANDARD FOR TREE CARE OPERATIONS, ANSI A300. PRUNE TREES IN ACCORDANCE WITH NAA GUIDELINES. DO NOT TOP TREES. PRUNE SHRUBS ACCORDING TO STANDARD HORTICULTURAL PRACTICES. ON CUTS OVER 3/4" IN DIAMETER AND BRUISES OR SCARS ON BARK, TRACE THE INJURED CAMBIUM LAYER BACK TO LIVING TISSUE AND REMOVE. SMOOTH AND SHAPE WOUNDS SO AS NOT TO RETAIN WATER. TREAT THE AREA WITH AN APPROVED INCONSPICUOUS LATEX BASED ANTISEPTIC TREE PAINT, IF PRUNING OCCURS "IN SEASON". DO NOT PRUNE ANY OAK TREES DURING THE MONTHS FROM APRIL TO OCTOBER.
- 5. CLEANUP: THE WORK AREA SHALL BE KEPT SAFE AND NEAT AT ALL TIMES. DISPOSED OF EXCESS SOIL. REMOVE ALL CUTTINGS AND WASTE MATERIALS. SOIL AND BRANCHES. BIND AND WRAP THESE MATERIALS, ANY REJECTED PLANTS, AND ANY OTHER DEBRIS RESULTING FROM ALL PLANTING TASKS AND PROMPTLY CLEAN UP AND REMOVE FROM THE PROJECT SITE. UNDER NO CIRCUMSTANCES SHALL THE ACCUMULATION OF SOIL, BRANCHES OR OTHER DEBRIS BE ALLOWED UPON A PUBLIC PROPERTY IN SUCH A MANNER AS TO RESULT IN A PUBLIC SAFETY HAZARD OR DAMAGE. LIKEWISE, UNDER NO CIRCUMSTANCES SHALL ANY DEBRIS OR INCIDENTAL MATERIALS BE ALLOWED UPON ADJACENT PRIVATE PROPERTY.
- 6. ANY SUBSTITUTIONS IN PLANT TYPE, LOCATION, OR SIZE SHALL BE APPROVED BY LANDSCAPE ARCHITECT PRIOR TO INSTALLATION.
- 7. CONTRACTOR TO VERIFY PLANT MATERIAL QUANTITIES AND SQUARE FOOTAGES. QUANTITIES SHOWN ON PLAN TAKE PRECEDENCE OVER THOSE ON SCHEDULE.

SODDING NOTES

MATERIALS - SOD: DISTURBED LAWN AREAS LABELED ON PLAN AS SUCH, SHALL RECEIVE 6" OF TOPSOIL AND A PREMIUM GRADE TURFGRASS SOD. ONLY IMPROVED TYPES OF SOD (ELITE) ARE ACCEPTABLE. TURFGRASS SHALL BE MACHINE CUT AT A UNIFORM THICKNESS OF .60 INCH, PLUS OR MINUS .25 INCH, AT TIME OF CUTTING. MEASUREMENT FOR THICKNESS SHALL EXCLUDE TOP GROWTH AND THATCH. LARGE ROLL TURFGRASS SOD SHALL BE CUT TO THE SUPPLIER'S STANDARD WIDTH (36-48 INCHES) AND LENGTH. BROKEN PADS AND TORN OR UNEVEN ENDS WILL NOT BE ACCEPTABLE, STANDARD SIZE SECTIONS OF TURGRASS SOD SHALL BE STRONG ENOUGH SO THAT THEY CAN BE PICKED UP AND HANDLED WITHOUT DAMAGE. TURFGRASS SOD SHALL NOT BE HARVESTED OR TRANSPLANTED WHEN MOISTURE CONTENT IS EXCESSIVELY DRY OR WET, AS THIS MAY ADVERSELY AFFECT ITS SURVIVAL. POST-PLANT IRRIGATION WILL BE NECESSARY TO ENSURE SOD STAYS ALIVE AND ROOTS INTO SOIL. THE CONTRACTOR IS RESPONSIBLE FOR WATERING SOD UNTIL TIME OF ACCEPTANCE BY THE OWNER. TURFGRASS SOD SHALL BE HARVESTED, DELIVERED, AND INSTALLED/TRANSPLANTED WITHIN A PERIOD OF 24 HOURS. TURFGRASS SOD SHALL BE RELATIVELY FREE OF THATCH, UP TO 0.5 INCH ALLOWABLE (UNCOMPRESSED). TURFGRASS SOD SHALL BE REASONABLY FREE (10 WEEDS/100 SQ. FT.) OF DISEASES, NEMATODES AND SOIL-BORNE INSECTS. ALL TURFGRASS SOD SHALL BE FREE OF GRASSY AND BROAD LEAF WEEDS AND WEED SEED. THE SOD SUPPLIER SHALL MAKE RECOMMENDATIONS TO THE CONTRACTOR REGARDING WATERING SCHEDULE. THE WATERING SCHEDULE SHOULD BEGIN IMMEDIATELY AFTER SOD IS INSTALLED.


LANDSCAPE MATERIAL NOTES


- MATERIALS PLANTING MIXTURE: ALL HOLES EXCAVATED FOR TREES, SHRUBS, PERENNIALS AND ORNAMENTAL GRASSES SHALL BE BACKFILLED WITH TWO (2) PARTS TOPSOIL, ONE (1) PART SAND AND ONE (1) PART COMPOST. SOIL MIXTURE SHALL BE WELL BLENDED PRIOR TO INSTALLATION.
- MATERIALS TOPSOIL: TOPSOIL TO BE CLEAN, FRIABLE LOAM FROM A LOCAL SOURCE, FREE FROM STONES OR DEBRIS OVER 3/4" IN DIAMETER, AND FREE FROM TOXINS OR OTHER DELETERIOUS MATERIALS. TOPSOIL SHALL HAVE A pH VALUE BETWEEN 6 AND 7. TOPSOIL AND PLANTING SOIL SHALL BE TESTED TO ENSURE CONFORMANCE WITH THESE SPECIFICATIONS AND SHALL BE AMENDED TO MEET THESE SPECIFICATIONS. PROVIDE TEST RESULTS TO OWNER'S REPRESENTATIVE PRIOR TO PLACEMENT. DO NOT PLACE FROZEN OR MUDDY TOPSOIL. APPLY SOIL AMENDMENTS TO ALL LANDSCAPE AREAS PER SOIL TEST.
- MATERIALS SHREDDED HARDWOOD BARK MULCH: ALL PLANTING AREAS LABELED ON PLAN SHALL RECEIVE CERTIFIED WEED FREE SHREDDED HARDWOOD BARK MULCH INSTALLED TO A MINIMUM AND CONSISTENT DEPTH OF 3-INCHES. SHREDDED HARDWOOD BARK MULCH SIZE & COLOR TO BE APPROVED BY OWNER'S REPRESENTATIVE PRIOR TO INSTALLATION. FERTILIZER SHALL BE IN ACCORDANCE WITH APPLICABLE LOCAL, COUNTY AND STATE REQUIREMENTS. SHREDDED HARDWOOD BARK MULCH AREAS SHALL NOT RECEIVE WOVEN WEED BARRIER FABRIC.
- 4. MATERIALS STONE MULCH: PLANTING AREA LABELED ON PLAN ADJACENT TO PARK STREET SIDEWALK SHALL RECEIVE A MINIMUM AND CONSISTENT 3" DEPTH OF 1-1/2" MISSISSIPPI RIVER STONE
- MATERIALS TREE & SHRUB RINGS: ALL TREES AND/OR SHRUBS PLANTED IN SEEDED LAWN AREAS TO BE INSTALLED WITH A MINIMUM 4' DIAMETER SHREDDED HARDWOOD BARK MULCH TREE RING SPREAD TO A CONSISTENT DEPTH OF 3-INCHES. ALL TREE RINGS SHOULD BE INSTALLED WITH A 5" DEPTH SHOVEL CUT EDGE, ANGLED 45 DEGREES INTO SOIL AT A 5' DIAMETER ABOUT THE CENTER OF THE TREE PLANTING. A PRE-EMERGENT GRANULAR HERBICIDE WEED-PREVENTER SHOULD BE MIXED WITH MULCH USED TO INSTALL TREE RING AS WELL AS TOPICALLY APPLIED TO COMPLETED INSTALLATION OF TREE RING.
- 6. MATERIALS POLYETHYLENE EDGING: EDGING SHALL BE 5" DEEP, POLYETHYLENE EDGING. OWNER'S REPRESENTATIVE SHALL APPROVE PRODUCT SPECIFICATION PROVIDED BY LANDSCAPE CONTRACTOR.
- 7. MATERIALS ALUMINUM EDGING: PERMALOC "PERMASTRIP", COLOR: MILL FINISH, 3/16"X4", 6063 ALUMINUM ALLOY



Professional Services, Inc. Engineers · Surveyors · Planners
CREATE THE VISION TELL THE STORY MADISON MILWAUKEE WAUSAU Appleton KENOSHA CHICAGO COEUR D'ALENE COEUR D'ALENE CHICAGO MADISON REGIONAL OFFICE 161 HORIZON DRIVE, SUITE 101 VERONA, WISCONSIN 53593 P. 608.848.5060 CLIENT: PRIME URBAN PRIME URBAN CLIENT:
CLIENT ADDRESS: 1952 ATWOOD AVENUE MADISON, WI 53704
PROJECT LOCATION: MADISON, WI DANE COUNTY
Date: Description: 1 07.23.20 DAT PRESENTATION 2 08.19.20 UDC INFORMATIONAL 3 09.16.20 LAND USE - UDC SUBMITTAL 4
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Design/Drawn: MWS Approved: KJY SHEET TITLE: LANDSCAPE DETAILS & NOTES
SHEET NUMBER:

20-9723

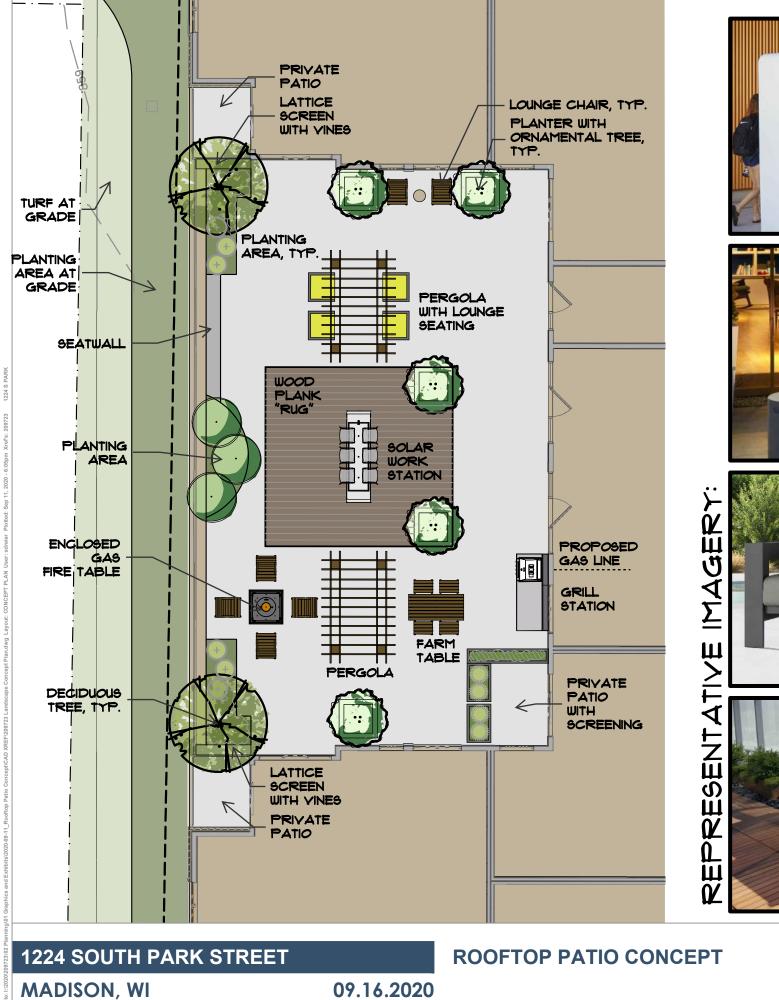


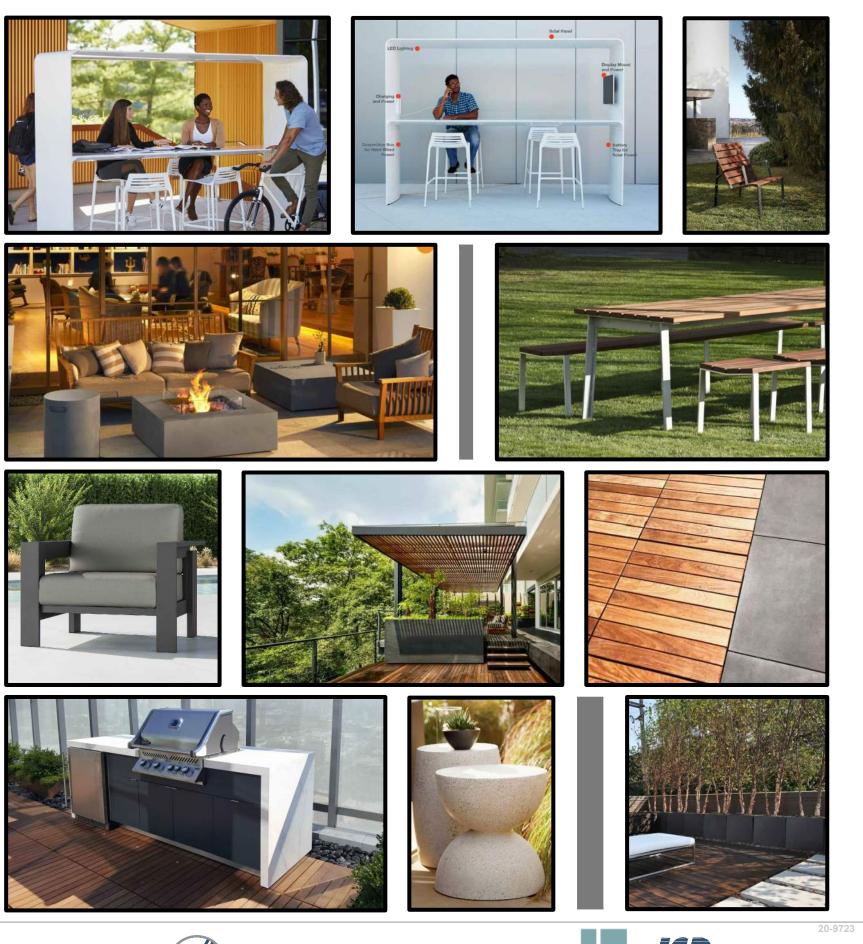








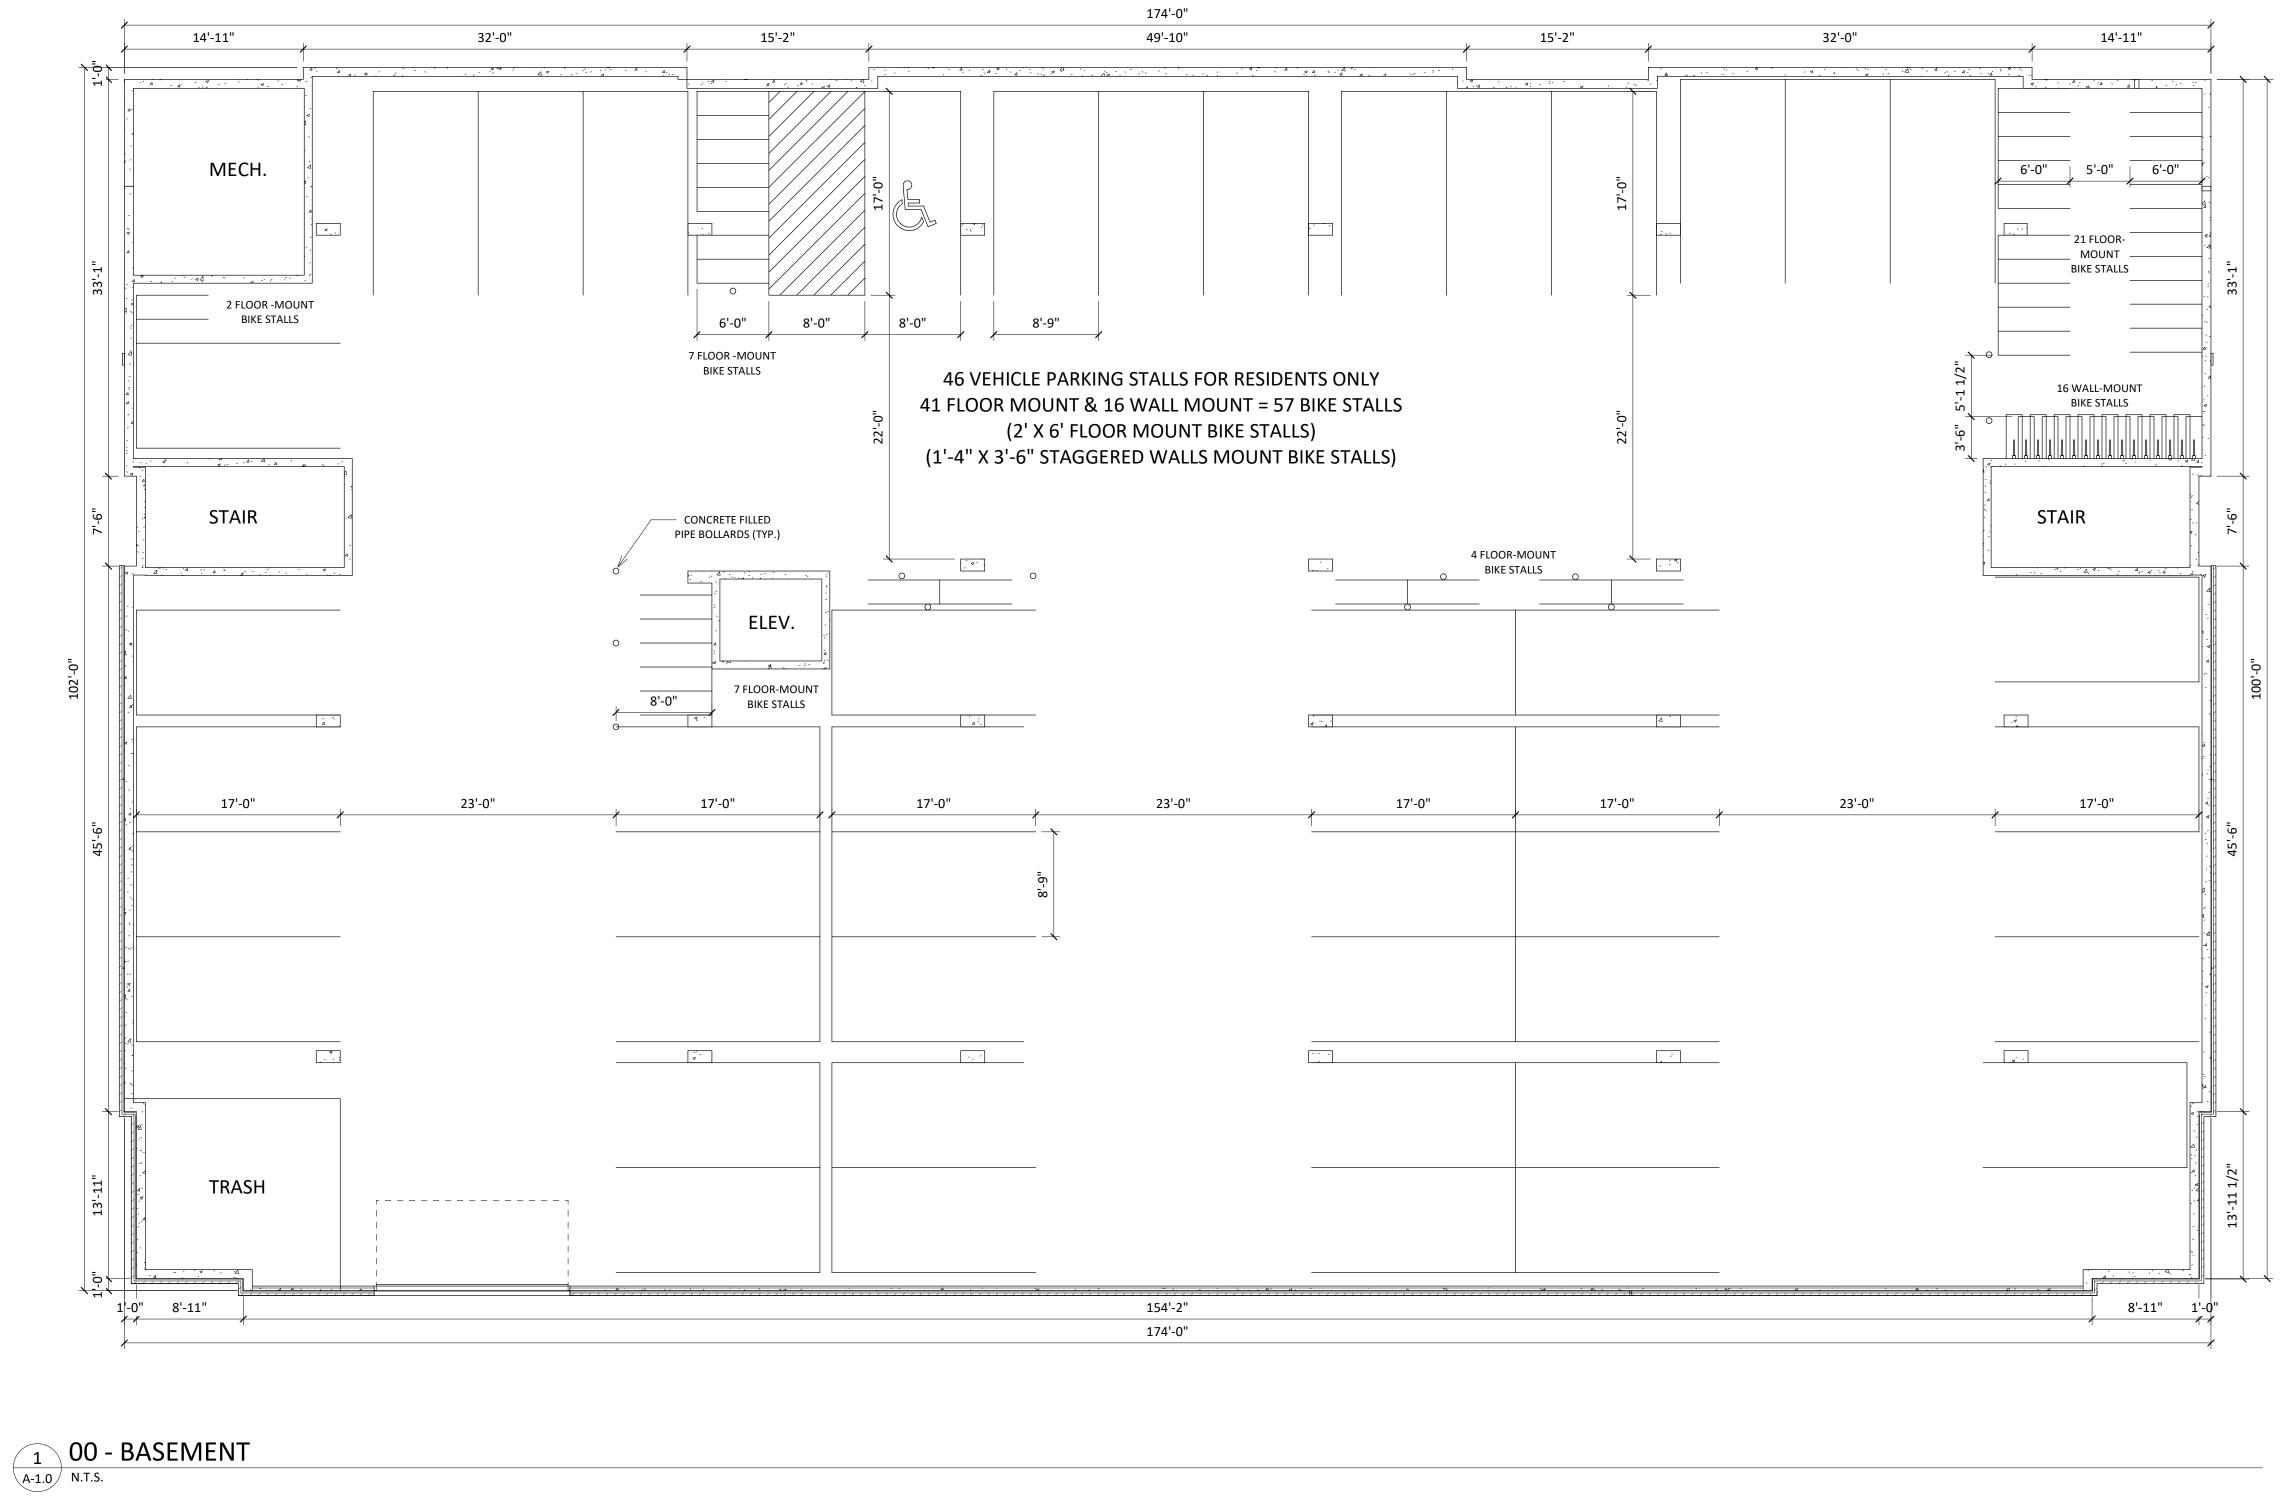

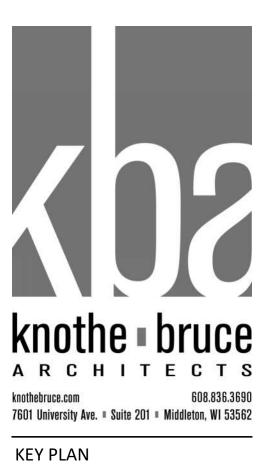


ISSUED 09/16/20

PROJECT TITLE PARK STREET DEVELOPMENT

1224 S Park St Madison, WI SHEET TITLE

BASEMENT FLOOR PLAN



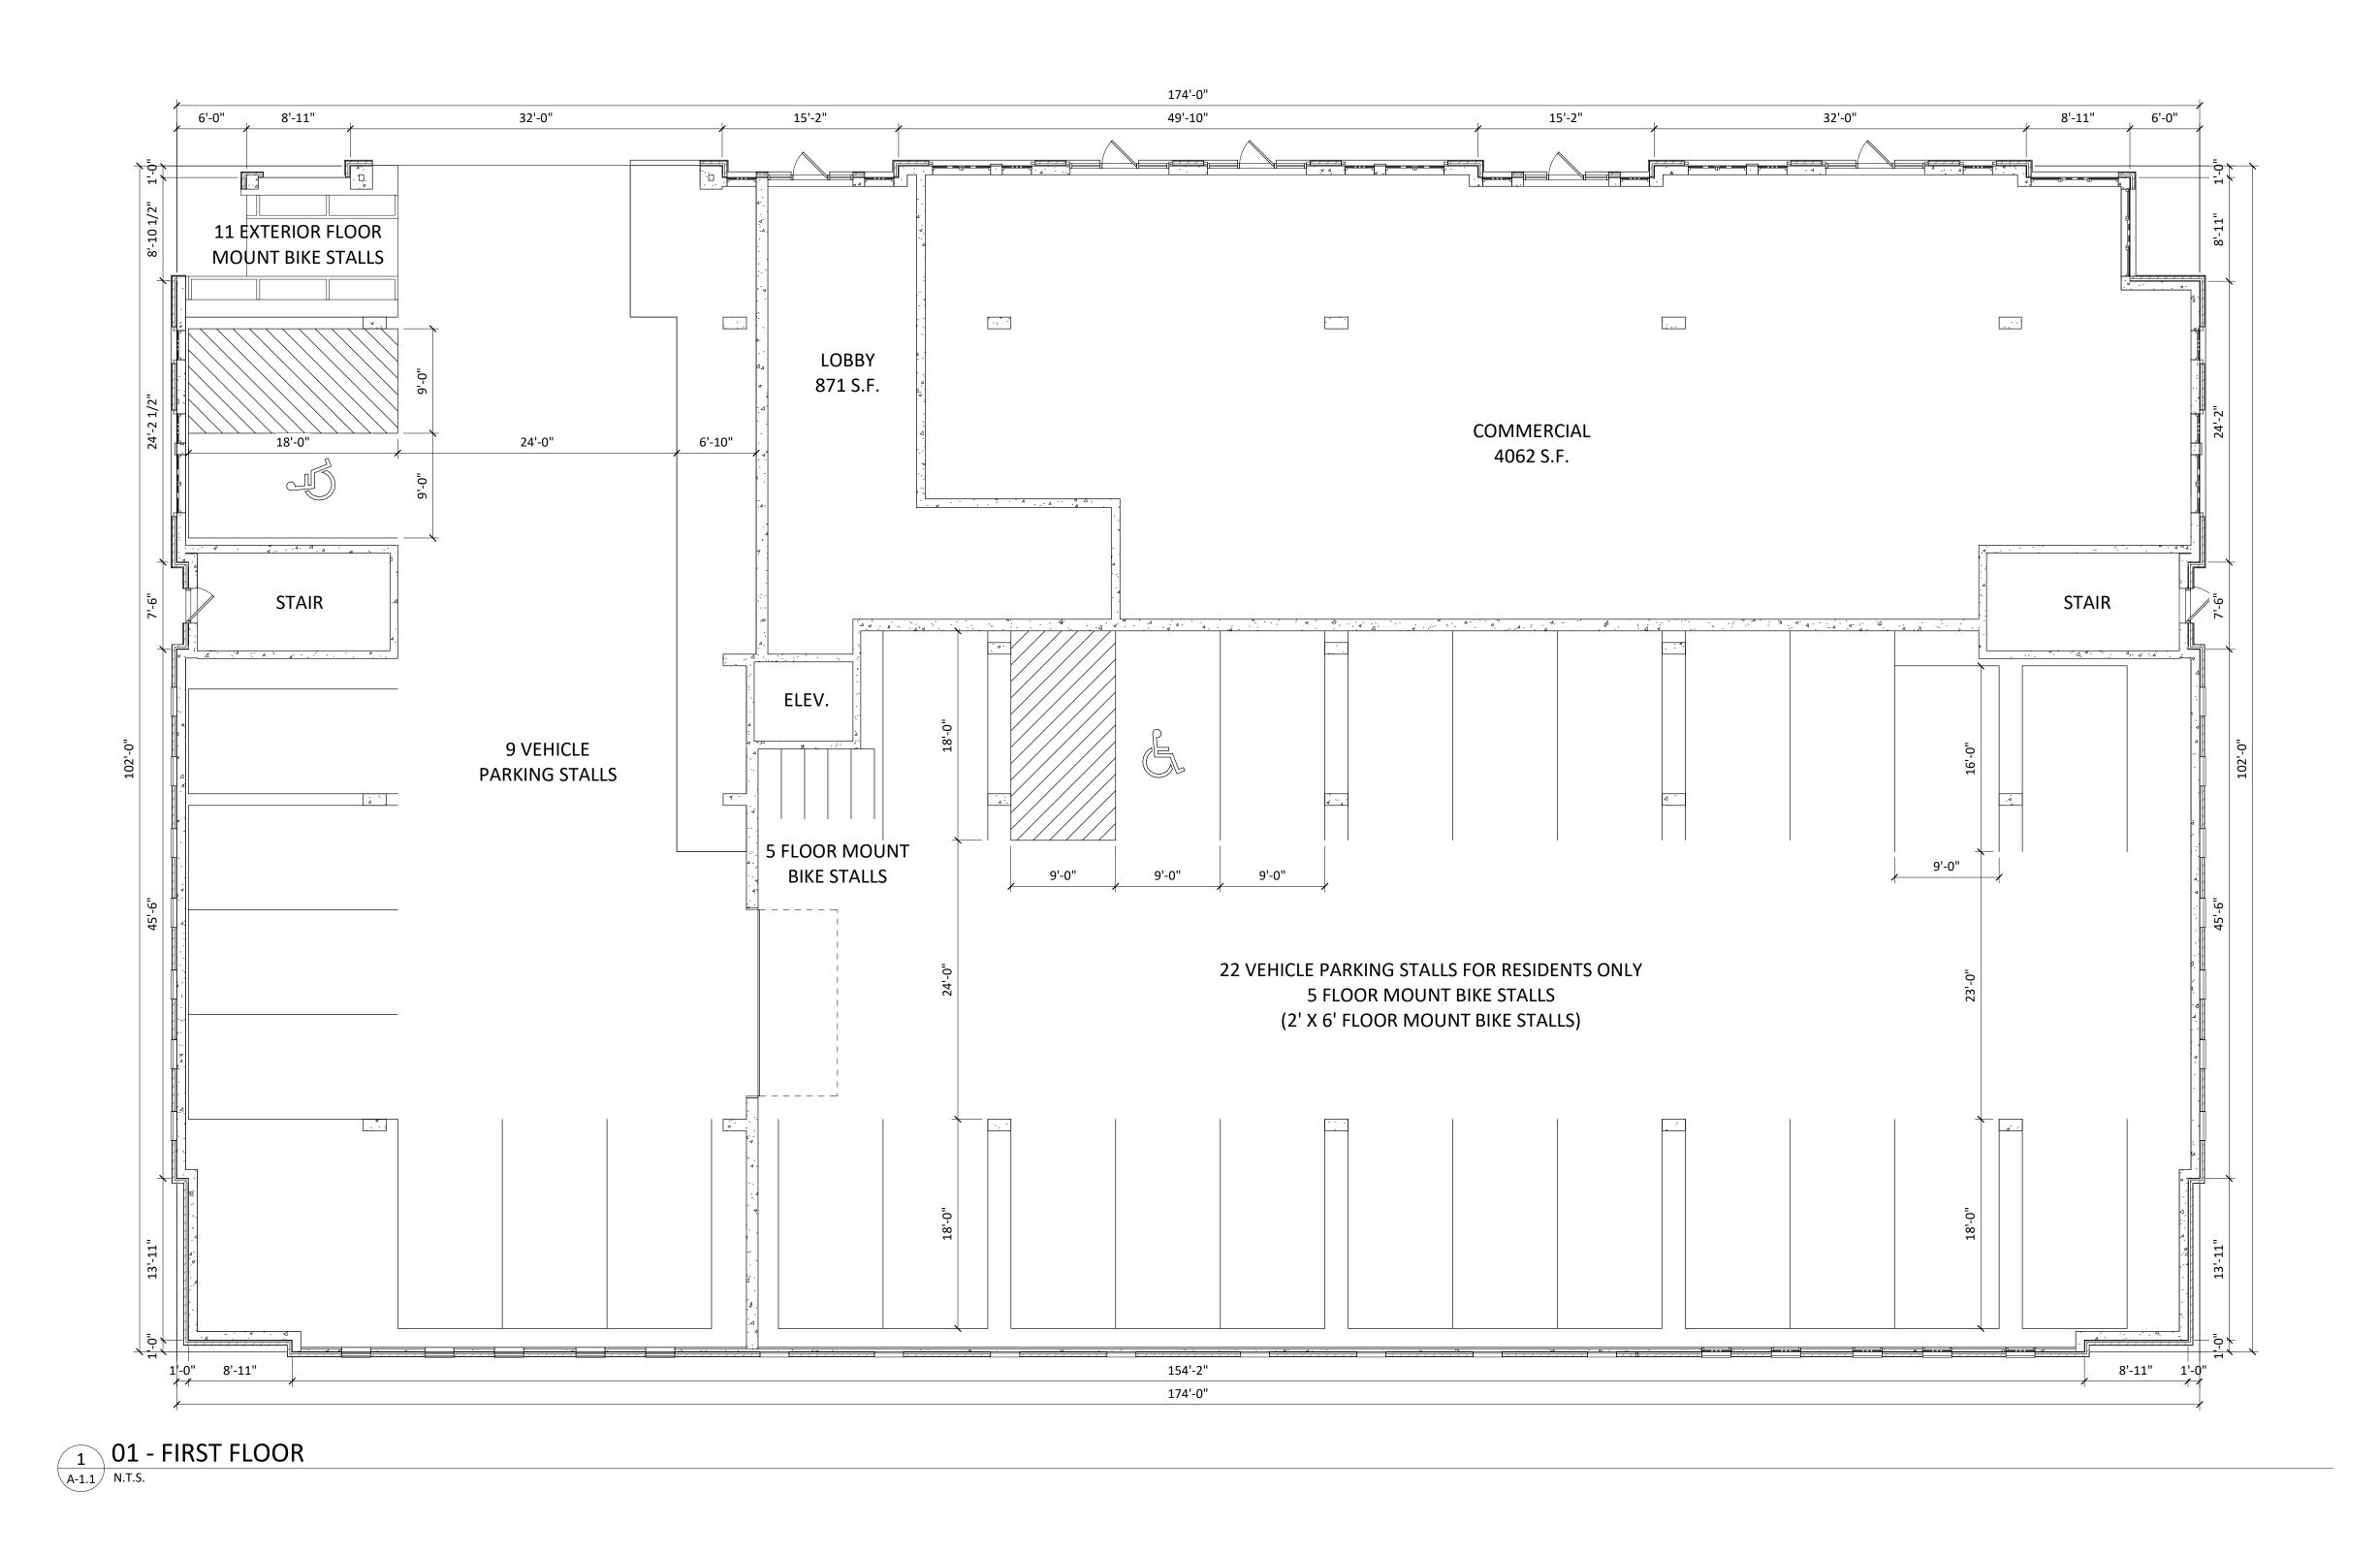



PROJECT TITLE PARK STREET DEVELOPMENT

1224 S Park St Madison, WI SHEET TITLE FIRST FLOOR PLAN









PROJECT TITLE PARK STREET DEVELOPMENT

1224 S Park St Madison, WI SHEET TITLE SECOND FLOOR PLAN










PROJECT TITLE PARK STREET DEVELOPMENT

1224 S Park St Madison, WI SHEET TITLE THIRD FLOOR PLAN








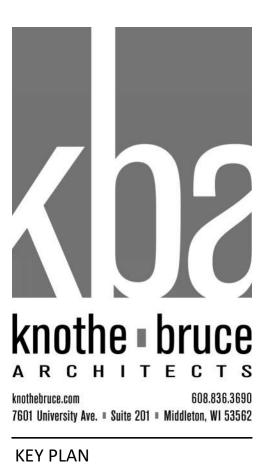


PROJECT TITLE PARK STREET DEVELOPMENT

1224 S Park St Madison, WI SHEET TITLE FOURTH FLOOR PLAN

A-1.4 PROJECT NUMBER 2031 © Knothe & Bruce Architects, LLC

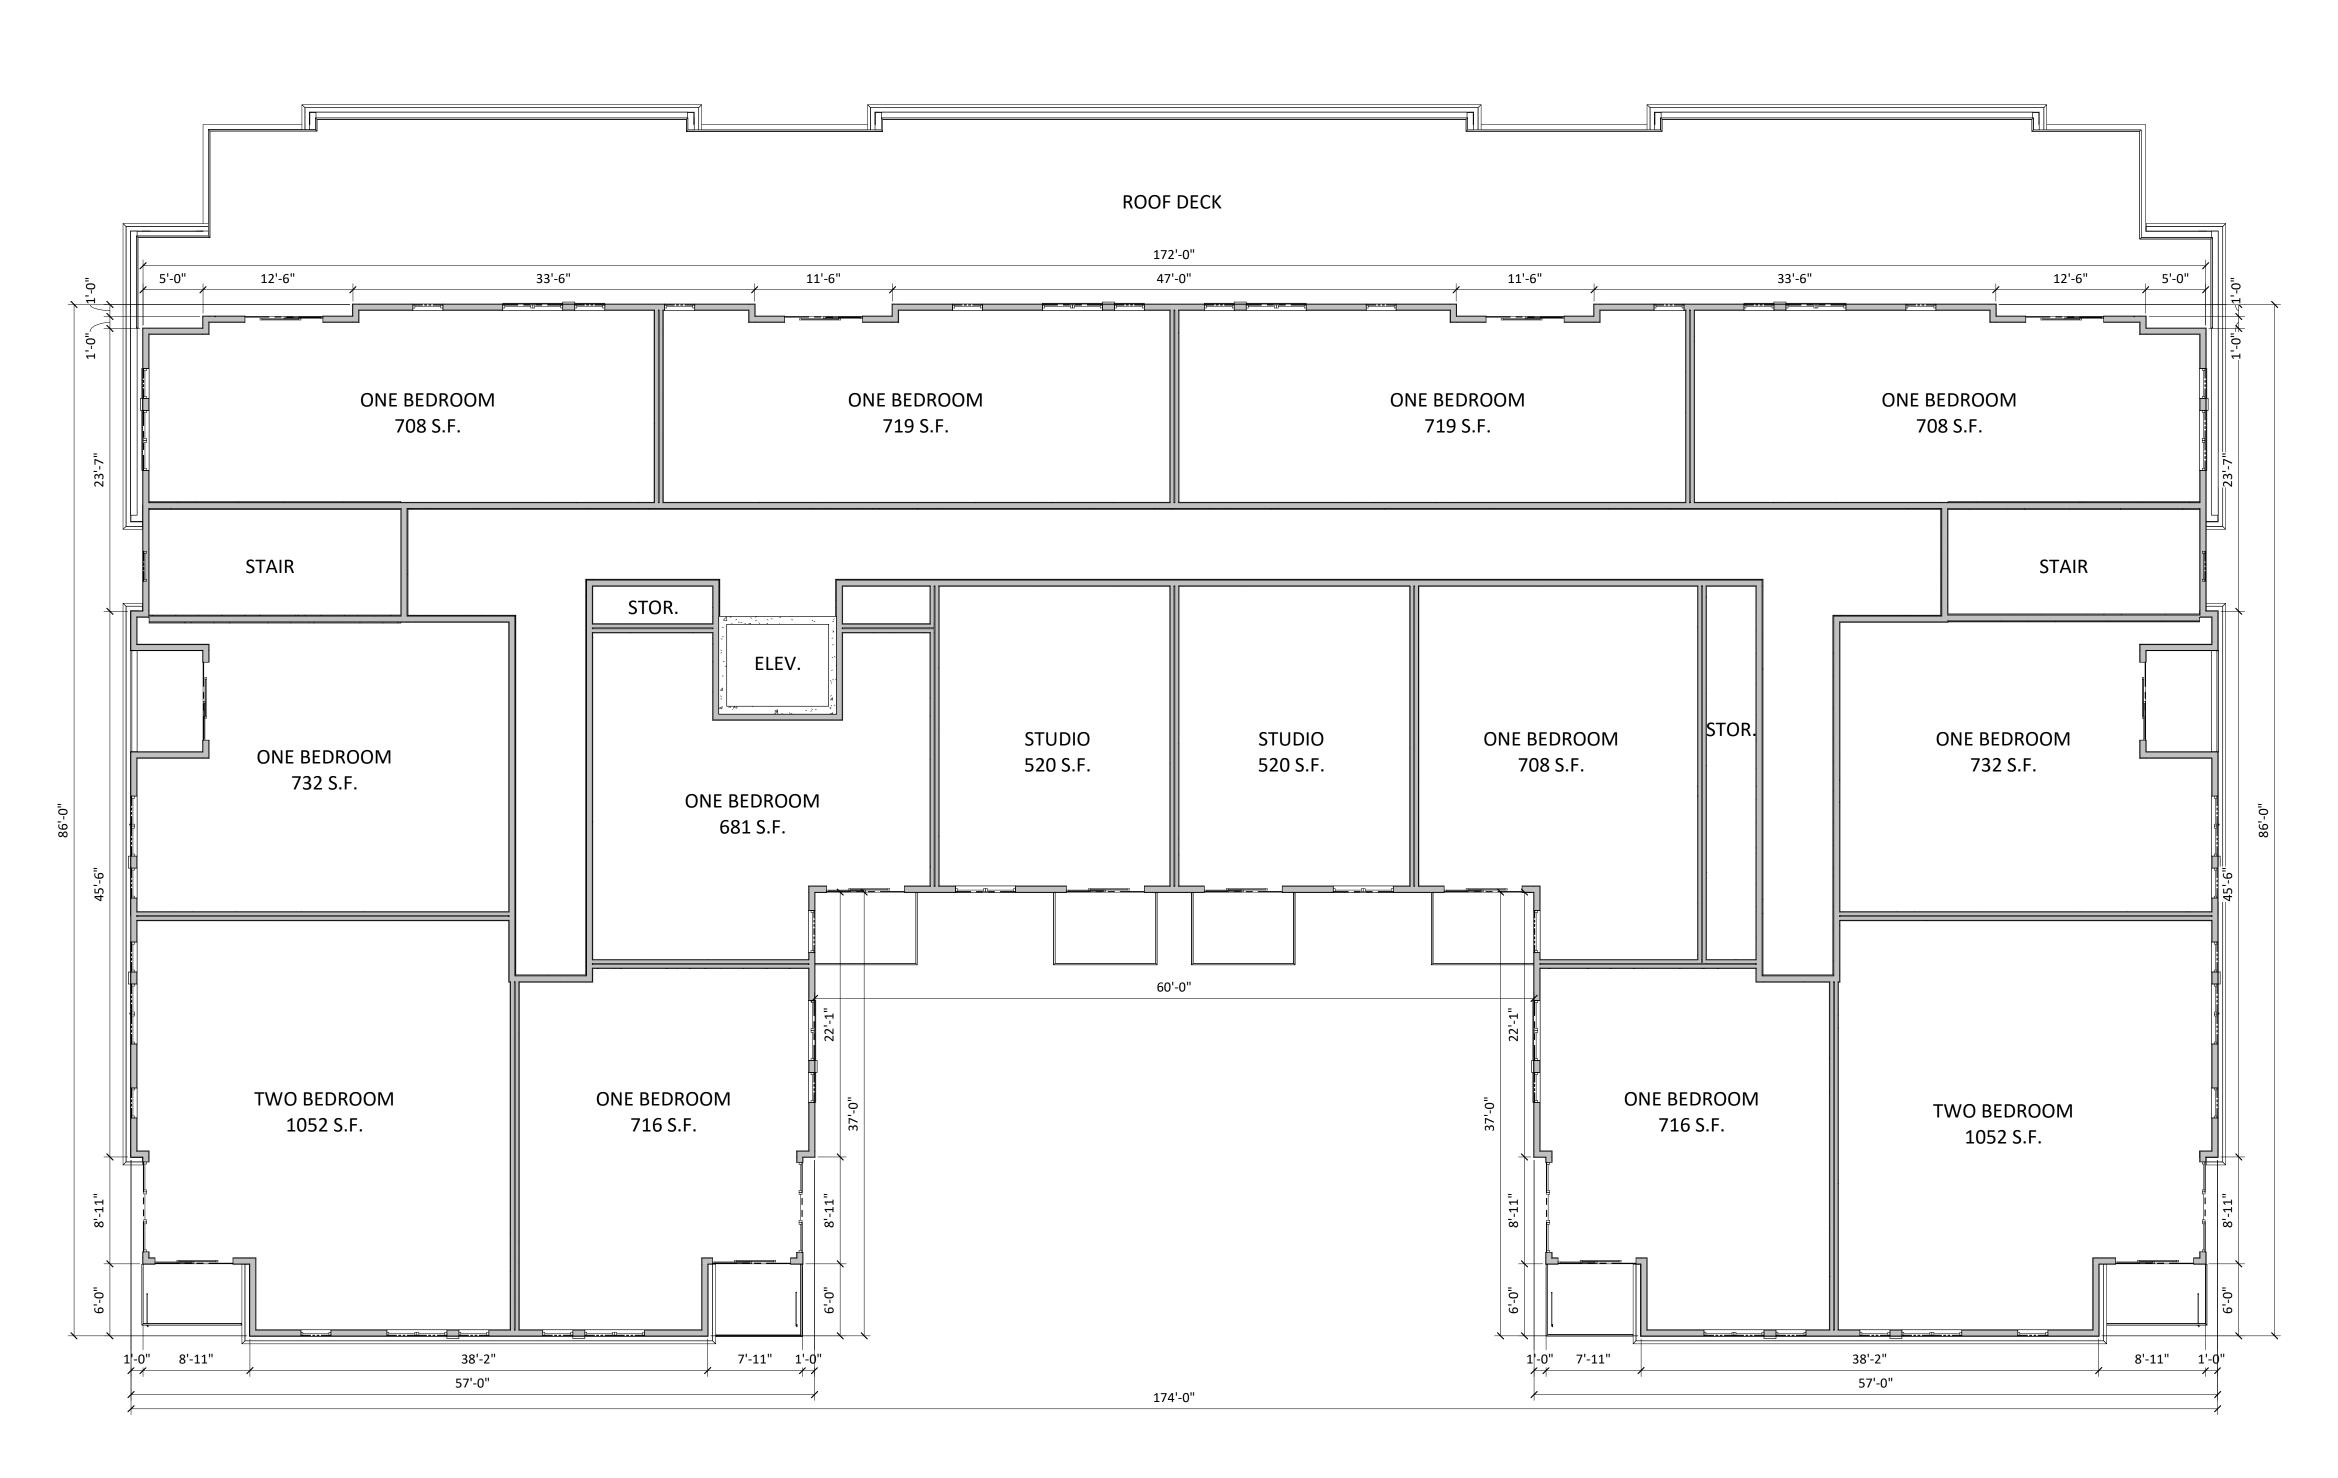

1 05 - FIFTH FLOOR A-1.5 N.T.S.

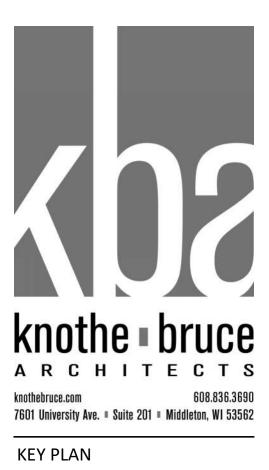


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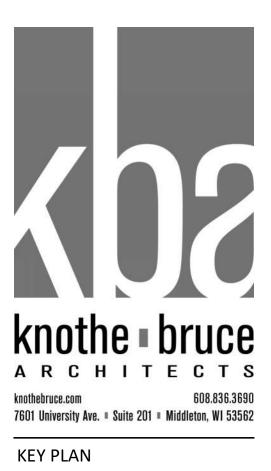
1224 S Park St Madison, WI SHEET TITLE FIFTH FLOOR

PLAN







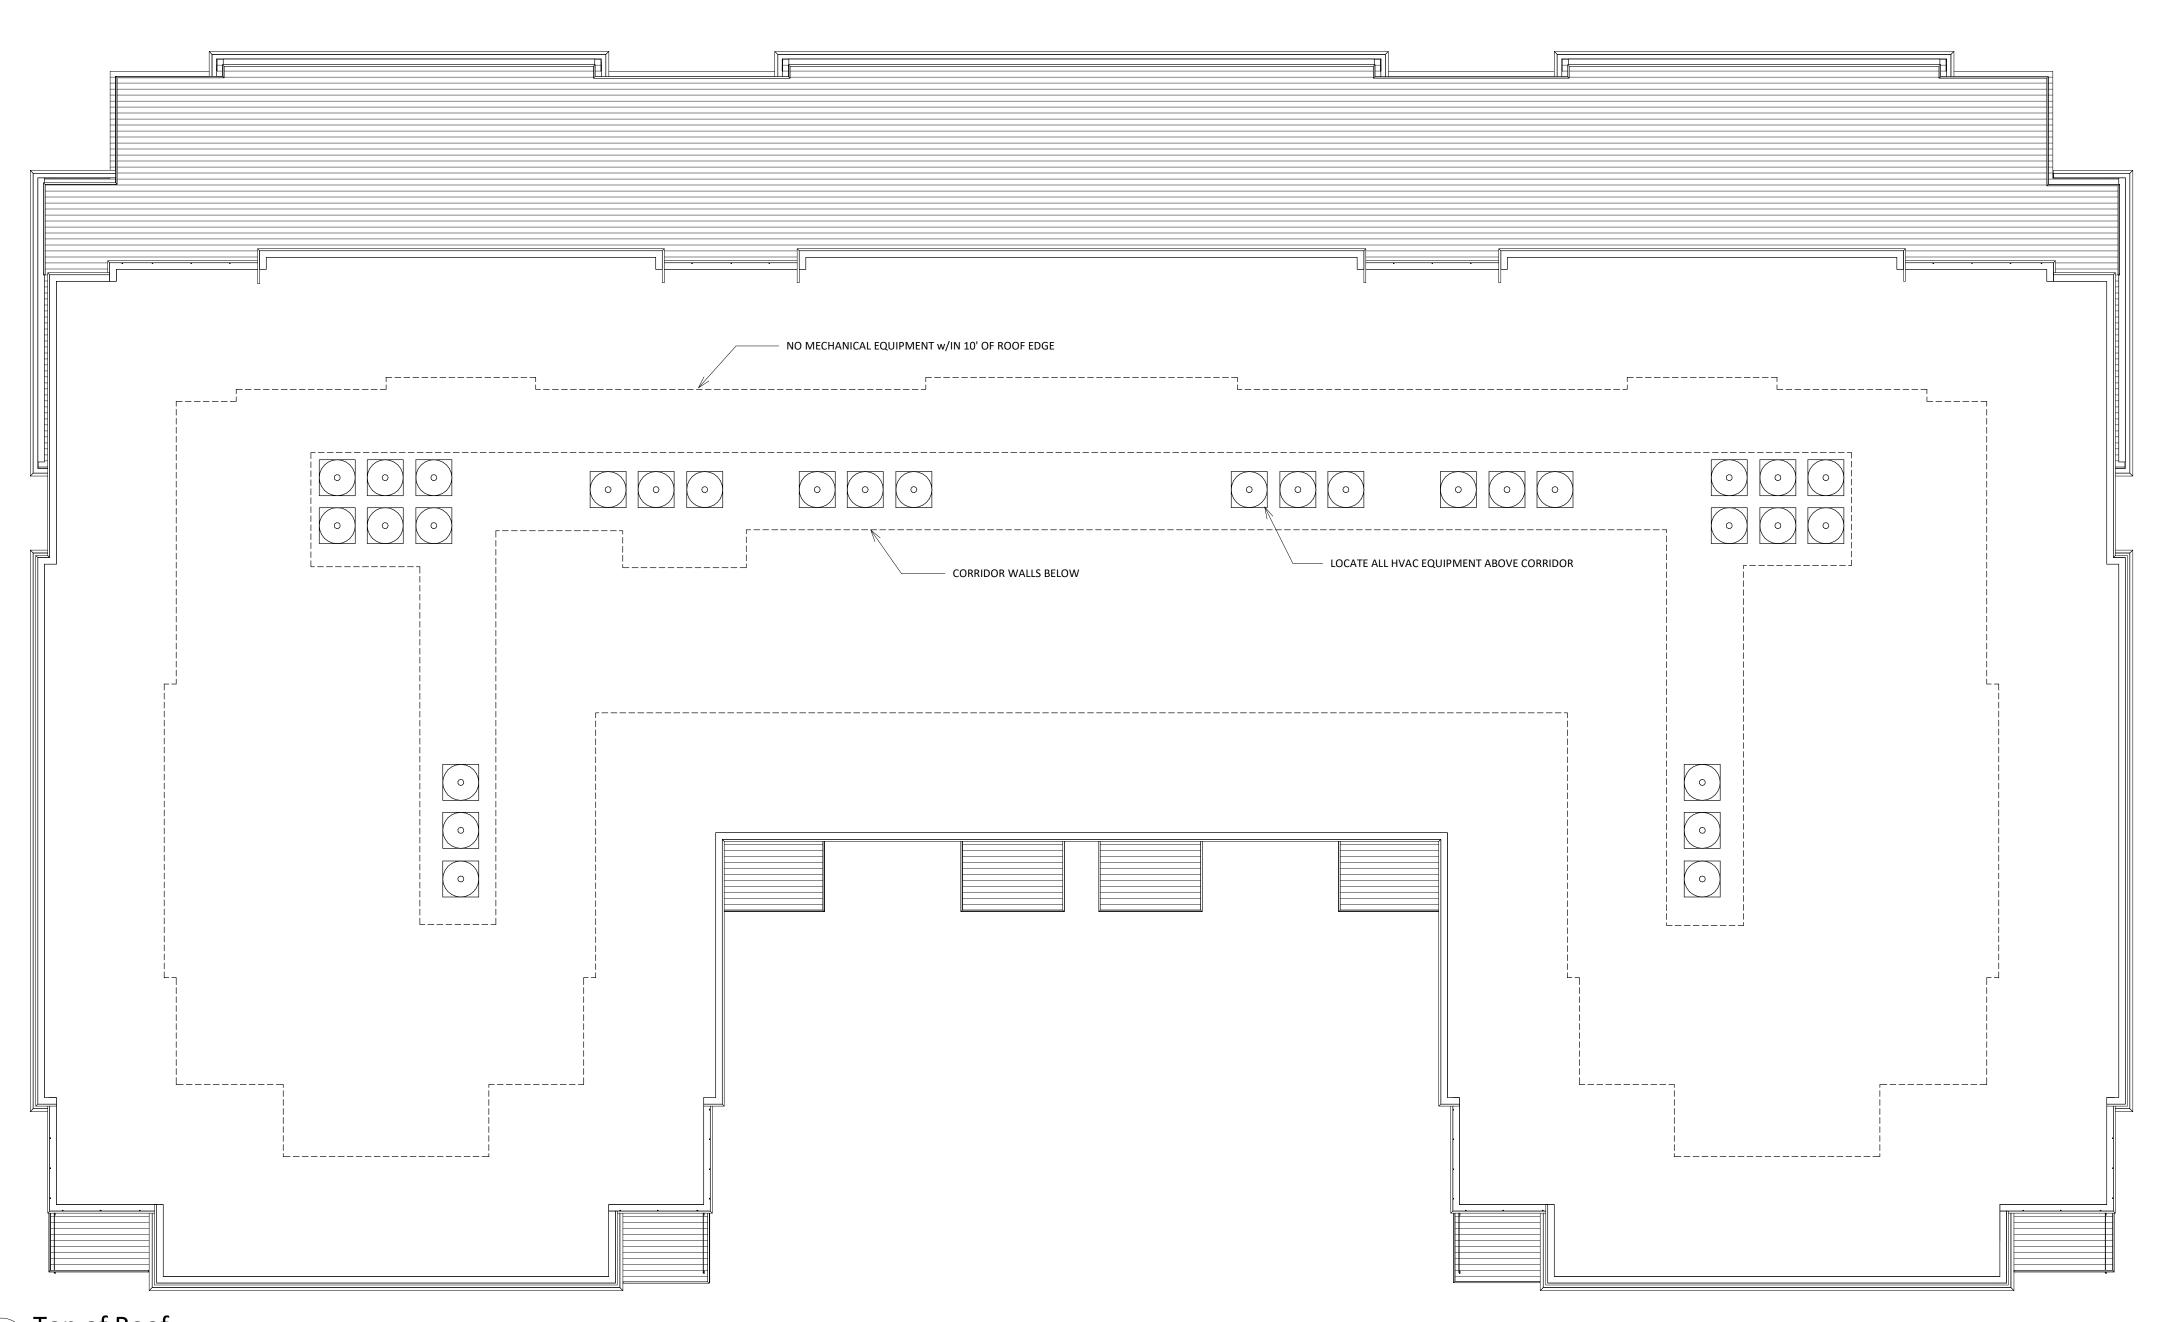

ISSUED 09/16/20

PROJECT TITLE PARK STREET DEVELOPMENT


1224 S Park St Madison, WI SHEET TITLE ROOF PLAN


A-1.6 PROJECT NUMBER 2031 © Knothe & Bruce Architects, LLC





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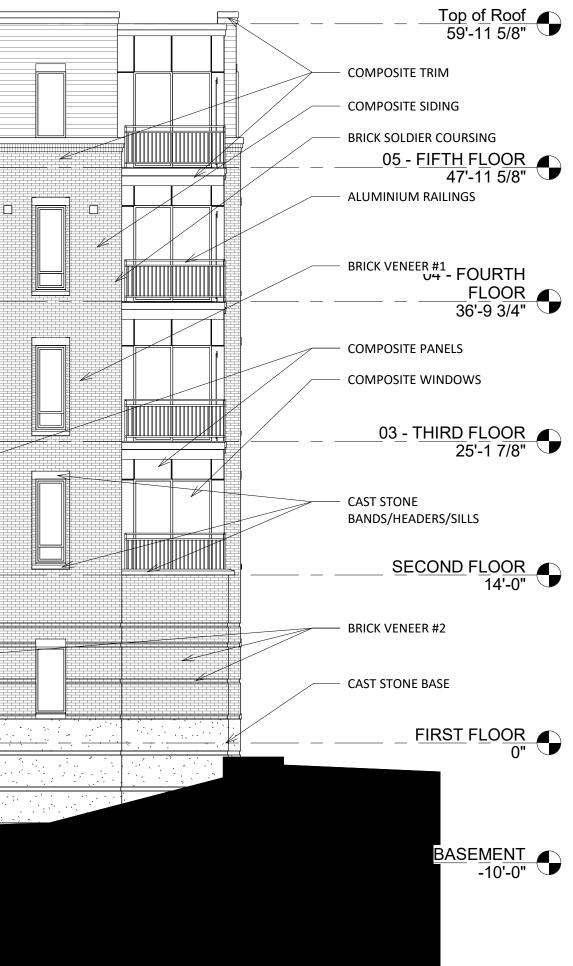
PROJECT TITLE PARK STREET DEVELOPMENT

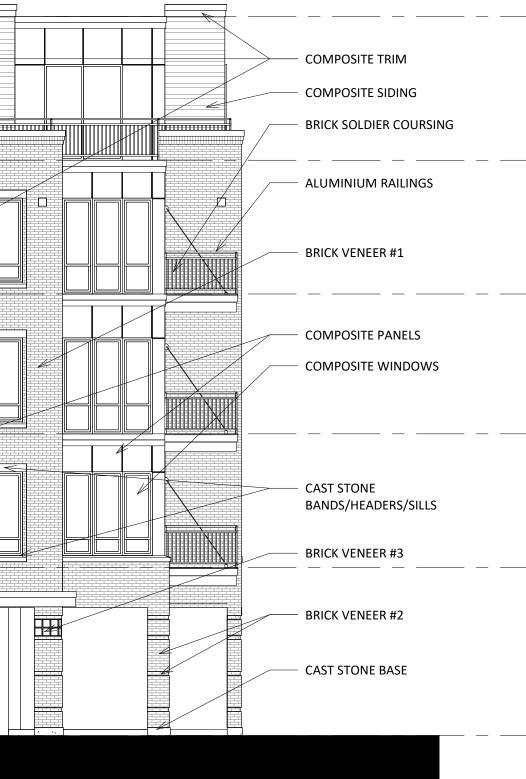1224 S Park St Madison, WI

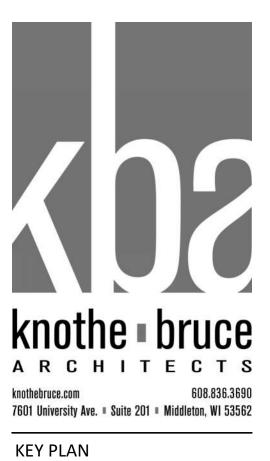EXTERIOR ELEVATIONS


SHEET NUMBER





<u>Top of Roof</u>			
05 - FIFTH FLOOR			
04 - FOURTH			
FLOOR 36'-9 3/4"			
03 - THIRD FLOOR 25'-1 7/8"			
<u>SECOND_FLOOR</u> 14'-0"			
FIRST_FLOOR			
BASEMENT			
East N.T.S.			
<u>Top of Roof</u> 59'-11 5/8"	 		
59-11 5/8"			
<u>05 - FIFTH FLOOR</u> 47'-11 5/8"			
04 - FOURTH			
<u>FLOOR</u> 36'-9 3/4"			
<u>03 -</u> T <u>HIRD FLOOR</u> 25'-1 7/8"			
<u>SECOND FLOOR</u> 14'-0"			
FIRST_FLOOR 0"			
BASEME <u>NT</u> -10'-0"			
West			



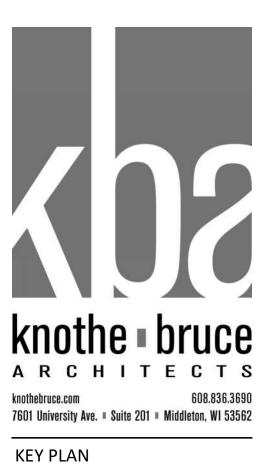

ISSUED 09/16/20

PROJECT TITLE PARK STREET DEVELOPMENT

1224 S Park St Madison, WI

SHEET TITLE EXTERIOR ELEVATIONS

SHEET NUMBER

















ISSUED 09/08/20


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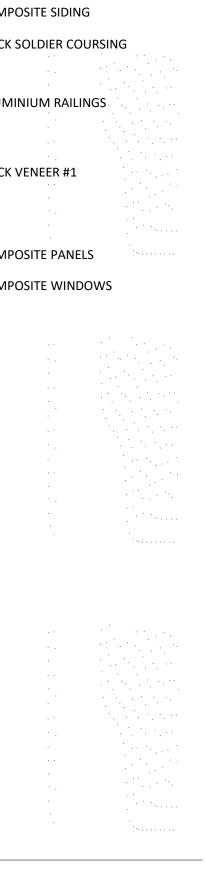
1224 S Park St Madison, WI


SHEET TITLE EXTERIOR **ELEVATIONS -**COLORED

SHEET NUMBER A-2.3 project number 2031 © Knothe & Bruce Architects, LLC







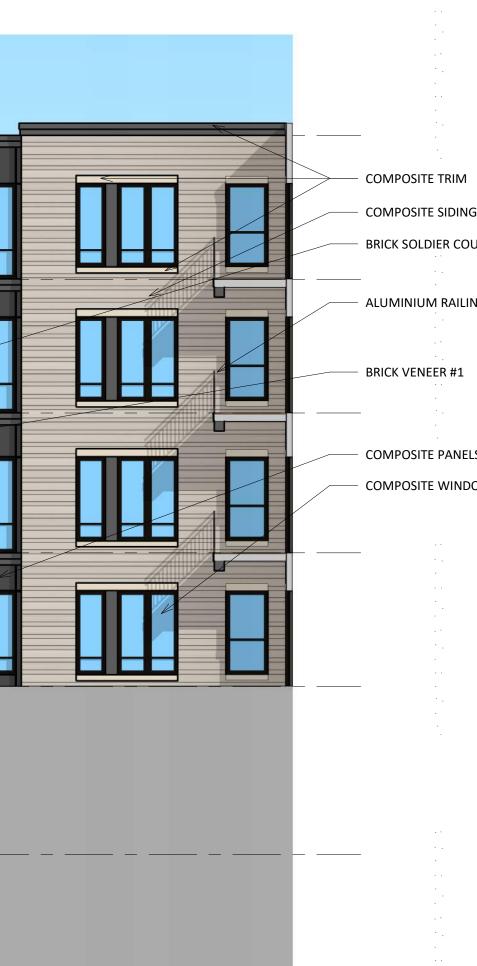

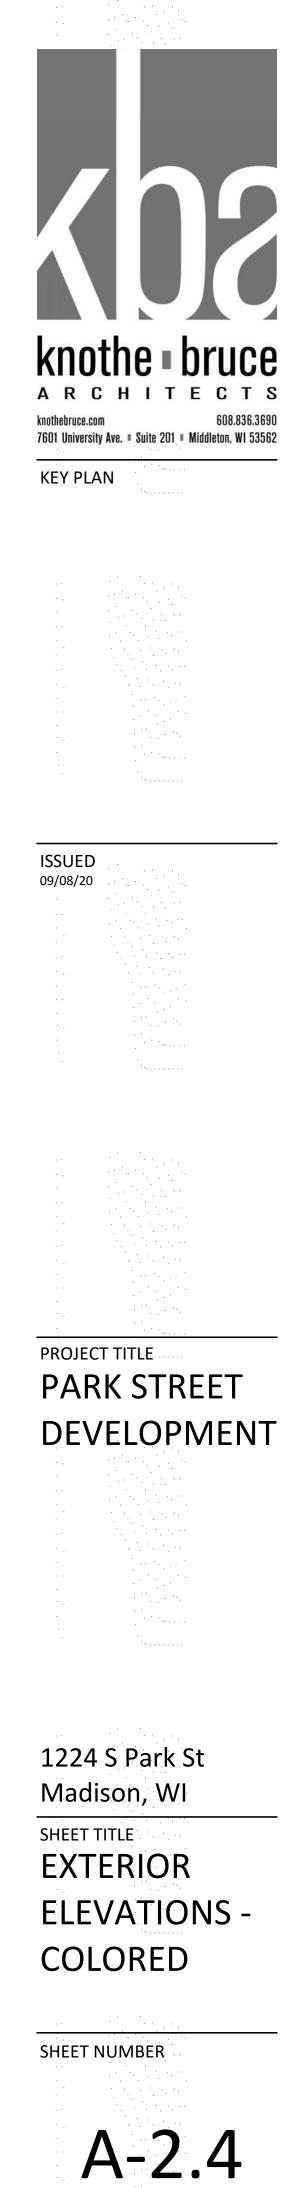


PROJECT NUMBER 2031 © Knothe & Bruce Architects, LLC

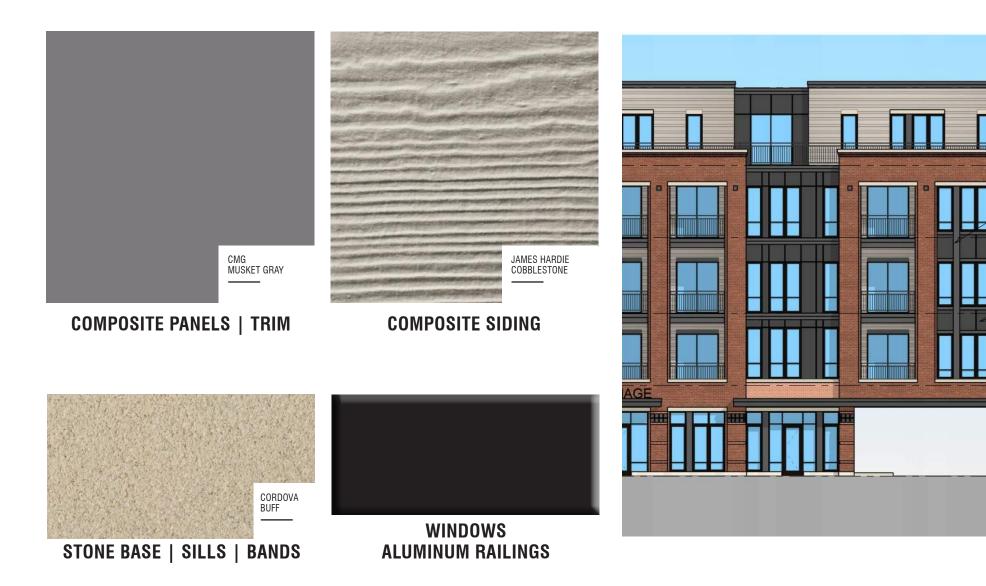

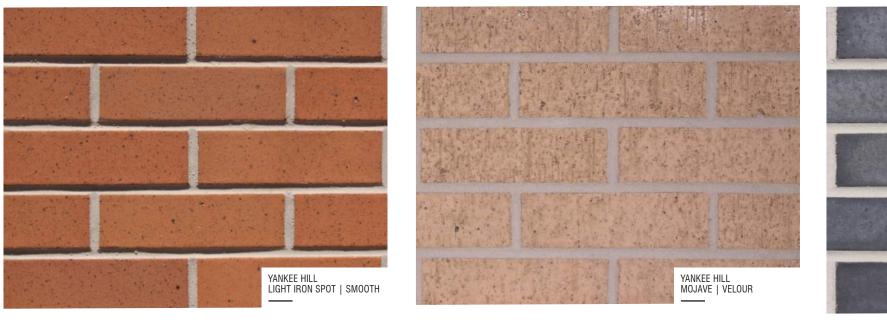

BRICK VENEER #1

BRICK VENEER #2

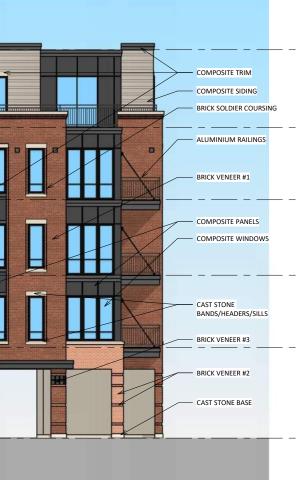



BRICK VENEER #3

MATERIAL BOARD PARK STREET DEVELOPMENT knothe bruce

1224 S. PARK ST. MADISON,WI SEPTEMBER 16, 2020



























