

UTILITY NOTES:

ALL WATER MAIN CONSTRUCTION AND CONNECTIONS SHALL BE IN COMPLIANCE WITH THE CITY OF MADISON AND WISCONSIN DEPARTMENT OF SAFETY AND PROFESSIONAL SERVICES STANDARDS.

PLUMBER SHALL VERIFY SANITARY LATERAL AND WATER SERVICE SIZE TO PROPOSED BUILDINGS

THE LENGTHS OF ALL UTILITIES ARE TO CENTER OF STRUCTURES OR FITTINGS AND MAY VARY SLIGHTLY FROM THE PLAN. LENGTHS SHALL BE VERIFIED IN THE FIELD DURING CONSTRUCTION.

ALL WATER SERVICES SHALL BE BURIED TO A DEPTH OF 6.5 FEET. THE DEPTH IS DEFINED AS THE DISTANCE BETWEEN THE FINISHED GRADE ELEVATION AND THE TOP OF WATER SERVICE.

MAINTAIN AN 8 FOOT MINIMUM HORIZONTAL SEPARATION DISTANCE BETWEEN PUBLIC SANITARY SEWER, WATER MAIN AND STORM SEWER. PROVIDE 18" MINIMUM VERTICAL SEPARATION WHERE SEWER CROSSES OVER WATER MAIN AND PROVIDE 12" MINIMUM VERTICAL SEPARATION WHERE WATER MAIN CROSSES OVER SEWER.

ANY UTILITIES WHICH ARE DAMAGED BY THE CONTRACTOR SHALL BE REPAIRED TO THE OWNER'S SATISFACTION AT THE CONTRACTOR'S EXPENSE.

ALL UNDERGROUND EXTERIOR NON-METALLIC SEWERS/MAINS AND WATER SERVICES/MAINS MUST BE PROVIDED WITH TRACER WIRE OR OTHER METHODS IN ORDER TO BE LOCATED IN ACCORDANCE WITH 182.0715(2r) OF STATE STATUTES.

THE PROPOSED ELECTRIC, TELEPHONE AND GAS UTILITY LOCATIONS ARE NOT SHOWN. ACTUAL LOCATIONS AND DESIGN SHALL BE COMPLETED BY OTHERS. ANY DAMAGE TO MCKENNA BLVD WILL REQUIRE PATCHING IN ACCORDANCE WITH THE CITY ENGINEERING STREET PATCHING CRITERIA.

THE CONTRACTOR SHALL VERIFY ALL EXISTING UTILITY LOCATIONS, SIZES, MATERIALS, AND ELEVATIONS PRIOR TO CONSTRUCTION.

SANITARY SEWER SHALL BE PVC ASTM D3034, SDR 35 UNLESS INDICATED OTHERWISE.

ALL STORM SEWER SHALL BE HDPE SMOOTH WALL INTERIOR CORRUGATED PIPE AS MANUFACTURED BY ADS OR APPROVED EQUAL. PIPE SHALL HAVE WATERTIGHT JOINTS AND SHALL MEET THE REQUIREMENTS OF AASHTO M-294, TYPE S.


THE CONTRACTOR SHALL OBTAIN A CONNECTION PERMIT AND EXCAVATION PERMIT PRIOR TO COMMENCING THE WATER SERVICE CONSTRUCTION. CATCH BASINS AND INLETS SHALL BE CONCRETE AND CONSTRUCTED IN ACCORDANCE WITH THE CITY OF MADISON STANDARD SPECIFICATIONS OR APPROVED EQUAL.

ALL WORK IN THE PUBLIC RIGHT—OF—WAY SHALL BE PERFORMED BY A PRE—APPROVED CONTRACTOR AUTHORIZED TO WORK IN THE

THE CONTRACTOR SHALL REPLACE ALL DAMAGED SIDEWALK AND



4604 Siggelkow Road, Suite A; McFarland, Wisconsin 53558 Phone (608) 838-7750; Fax (608) 838-7752

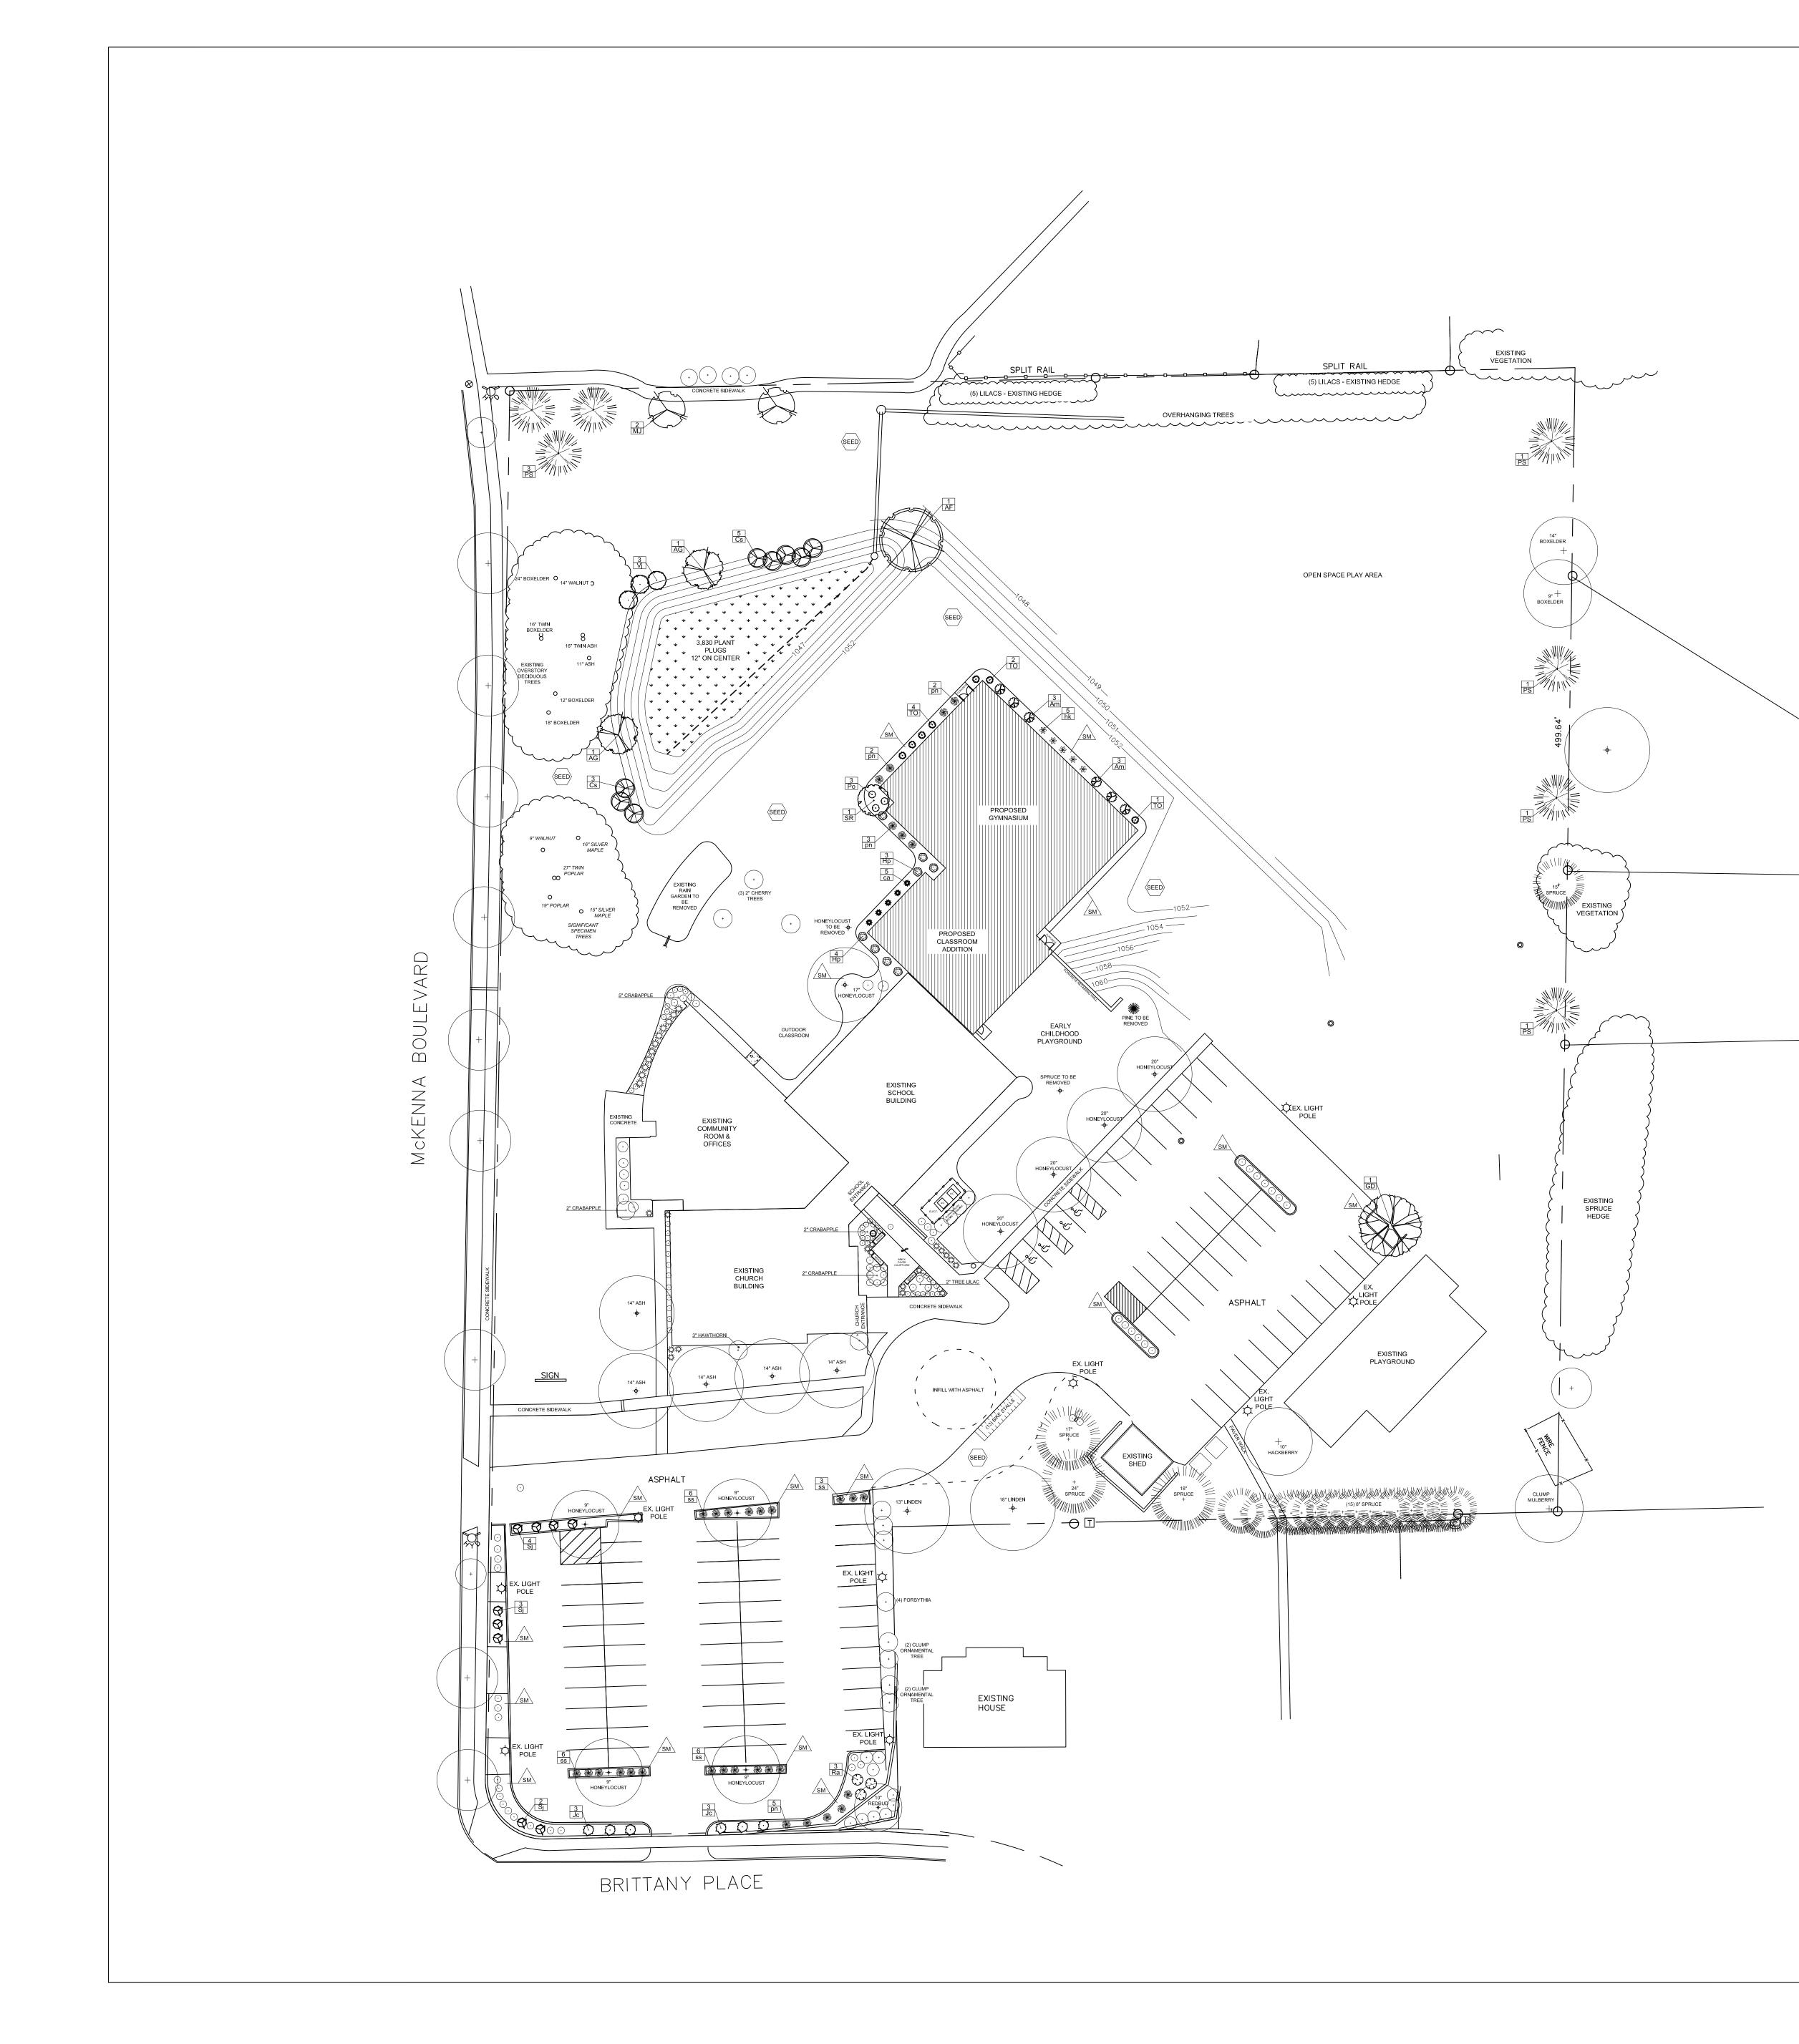

PLANT LIST

KEY	SCIENTIFIC NAME	COMMON NAME	QTY	SIZE	ROOT	STEN
	DECIDUOUS TREES					
AF	Acer x freemanii 'Jefersred'	Autumn Blaze Maple	1	2"	B&B	
GD	Gymnocldus dioicus 'Espresso-JFS'	Espresso Kentucky Coffeetree	1	2"	B&B	
	1	T		1		1
	ORNAMENTAL TREES					
AG	Amelanchier x grandiflora 'Autumn Brilliance'	Autumn Brilliance Serviceberry	2	6'	B&B	clum
MJ	Malus 'Jewelcole'	Red Jewel Crabapple	2	2"	B&B	
SR	Syringa reticulata 'Ivory Silk'	Ivory Silk Japanese Tree Lilac	1	2"	B&B	
	EVERGREEN TREES					
PS	Pinus strobus	Eastern White Pine	7	6'	B&B	
TO	Thuja occidentalis 'Smaragd'	Emerald Arborvitae	7	5'	B&B	
			1	1	1	
	EVERGREEN SHRUBS					
Jc	Juniperus chinensis 'Daub's Frosted'	Daub's Frosted Juniper	6	#5	Cont.	
		1				1
	DECIDUOUS SHRUBS					
Am	Aronia melanocarpa 'Morton'	Iroquois Beauty Chokeberry	6	#3	Cont.	
Cs	Cornus sericea 'Isanti'	Isanti Red Twig Dogwood	8	#5	Cont.	
Нр	Hydrangea paniculata 'Jane'	Little Lime Hydrangea	7	#3	Cont.	
Ро	Physocarpus opulifolius 'Donnolley'	Little Devil Ninebark	3	#5	Cont.	
Ra	Rhus aromatica 'Gro-Low'	Gro-Low Sumac	3	#2	Cont.	
Sj	Spirea japonica 'Neon Flash'	Neon Flash Spirea	9	#2	Cont.	
Vj	Viburnum dentatum 'Ralph Senior'	Autumn Jazz Arrowwood Viburnum	3	#5	Cont.	
	ORNAMENTAL GRASSES & PERENNIALS	1				
<u></u>	Calamagrostis x acutiflora 'Karl Foerster'	Karl Foerster Feather Reed Grass	5	#1	Cont.	
ca hk	Hosta 'Krossa Regal'	Kan Foerster Feather Reed Grass Krossa Regal Hosta	5	#1	Cont.	
pn	Panicum virgatum 'Northwind'	Northwind Switch Grass	5 12	#1	Cont.	
P''			14	"'		

SM Capitol Washed Stone / Vinyl edge in all areas around buildings

WM Brown Dyed Wood Mulch / Shovel cut edge

SEED Premium sunny seed blend with straw mat. (Class 1 Type B single net)

LANDSCAPE NOTES:

• Refer to Grading & Erosion Control Plan for final contour information.

 Individual tree and shrub groupings in lawn areas to receive wood mulch rings with shovel cut edge.

• Vinyl edge is Dimex EdgePro polyvinyl edging or equivalent

• Parking lot islands are Capitol Washed Stone with weed fabric

BIO-RETENTION BASIN:


Plant plugs to be planted at one plug per square foot. Plugs to be plant stock named in the wet prairie mix from Agrecol Corporation or approved eqivalent. A minimum of 10 different plant species to be installed.

STREET TREE NOTE:

Contractor shall install tree protection fencing in the area between the curb and sidewalk and extend it at least 5 feet from both sides of the tree along the length of the terrace. No excavation is permitted within 5 feet of the outside edge of a tree trunk. If excavation within 5 feet of any tree is necessary, contractor shall contact City Forestry (266-4816) prior to excavation to assess the impact to the tree and root system. Tree pruning shall be coordinated with City Forestry prior to the start of construction. Tree protection specifications can be found in section 107.13 of *City of Madison Standard Specifications for Public Works* Construction -


http://www.cityofmadison.com/business/pw/documents/StdSpecs/2013/Part1.pdf. Any tree removals that are required for construction after the development plan is approved will require at least a 72 hour wait period before a tree removal permit can be issued by Forestry, to notify the Alderperson of the change in the tree plan.


City of Madison, WI Landscape Workshee	t				
OUR REDEEMER LUTHERAN CHURCH + SCH	OOL				
					LANDSCAPE POINTS
LOT LARGER THAN 5 ACRES	SQUARE FEET				REQUIRED
Total Developed Area					3761
255,689 (lot) - 24,805 (building footprints)	230,884				
		CRED	TS / EXISTING	NEW	/PROPOSED
PLANT TYPE / ELEMENT	POINT VALUE	QUANTITY	POINTS ACHIEVED	QUANTITY	POINTS ACHIEVED
Overstory Deciduous	35	27	945	2	70
Tall Evergreen Tree	35	19	665	7	245
Ornamental Tree	15	13	195	5	75
Upright Evergreen Shrub (i.e. arborvitae)	10		0	7	70
Shrub, deciduous	3	70	210	39	117
Shrub, evergreen	4	9	36	6	24
Ornamental Grasses/Perennials	2	85	170	43	86
Ornamental/Decorative Fencing or Wall					
(4pts / 10LF)	4		0		0
Existing Significant Specimen Tree (UP					
TO 30% OF TOTAL)	14	66	924		0
Landscape Furniture for public seating					
and/or transit connections	5		0		0
SUB TOTALS			3145		687
			TOTAL POINTS PROVI	DED	3832

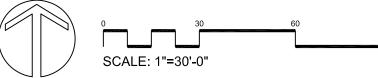





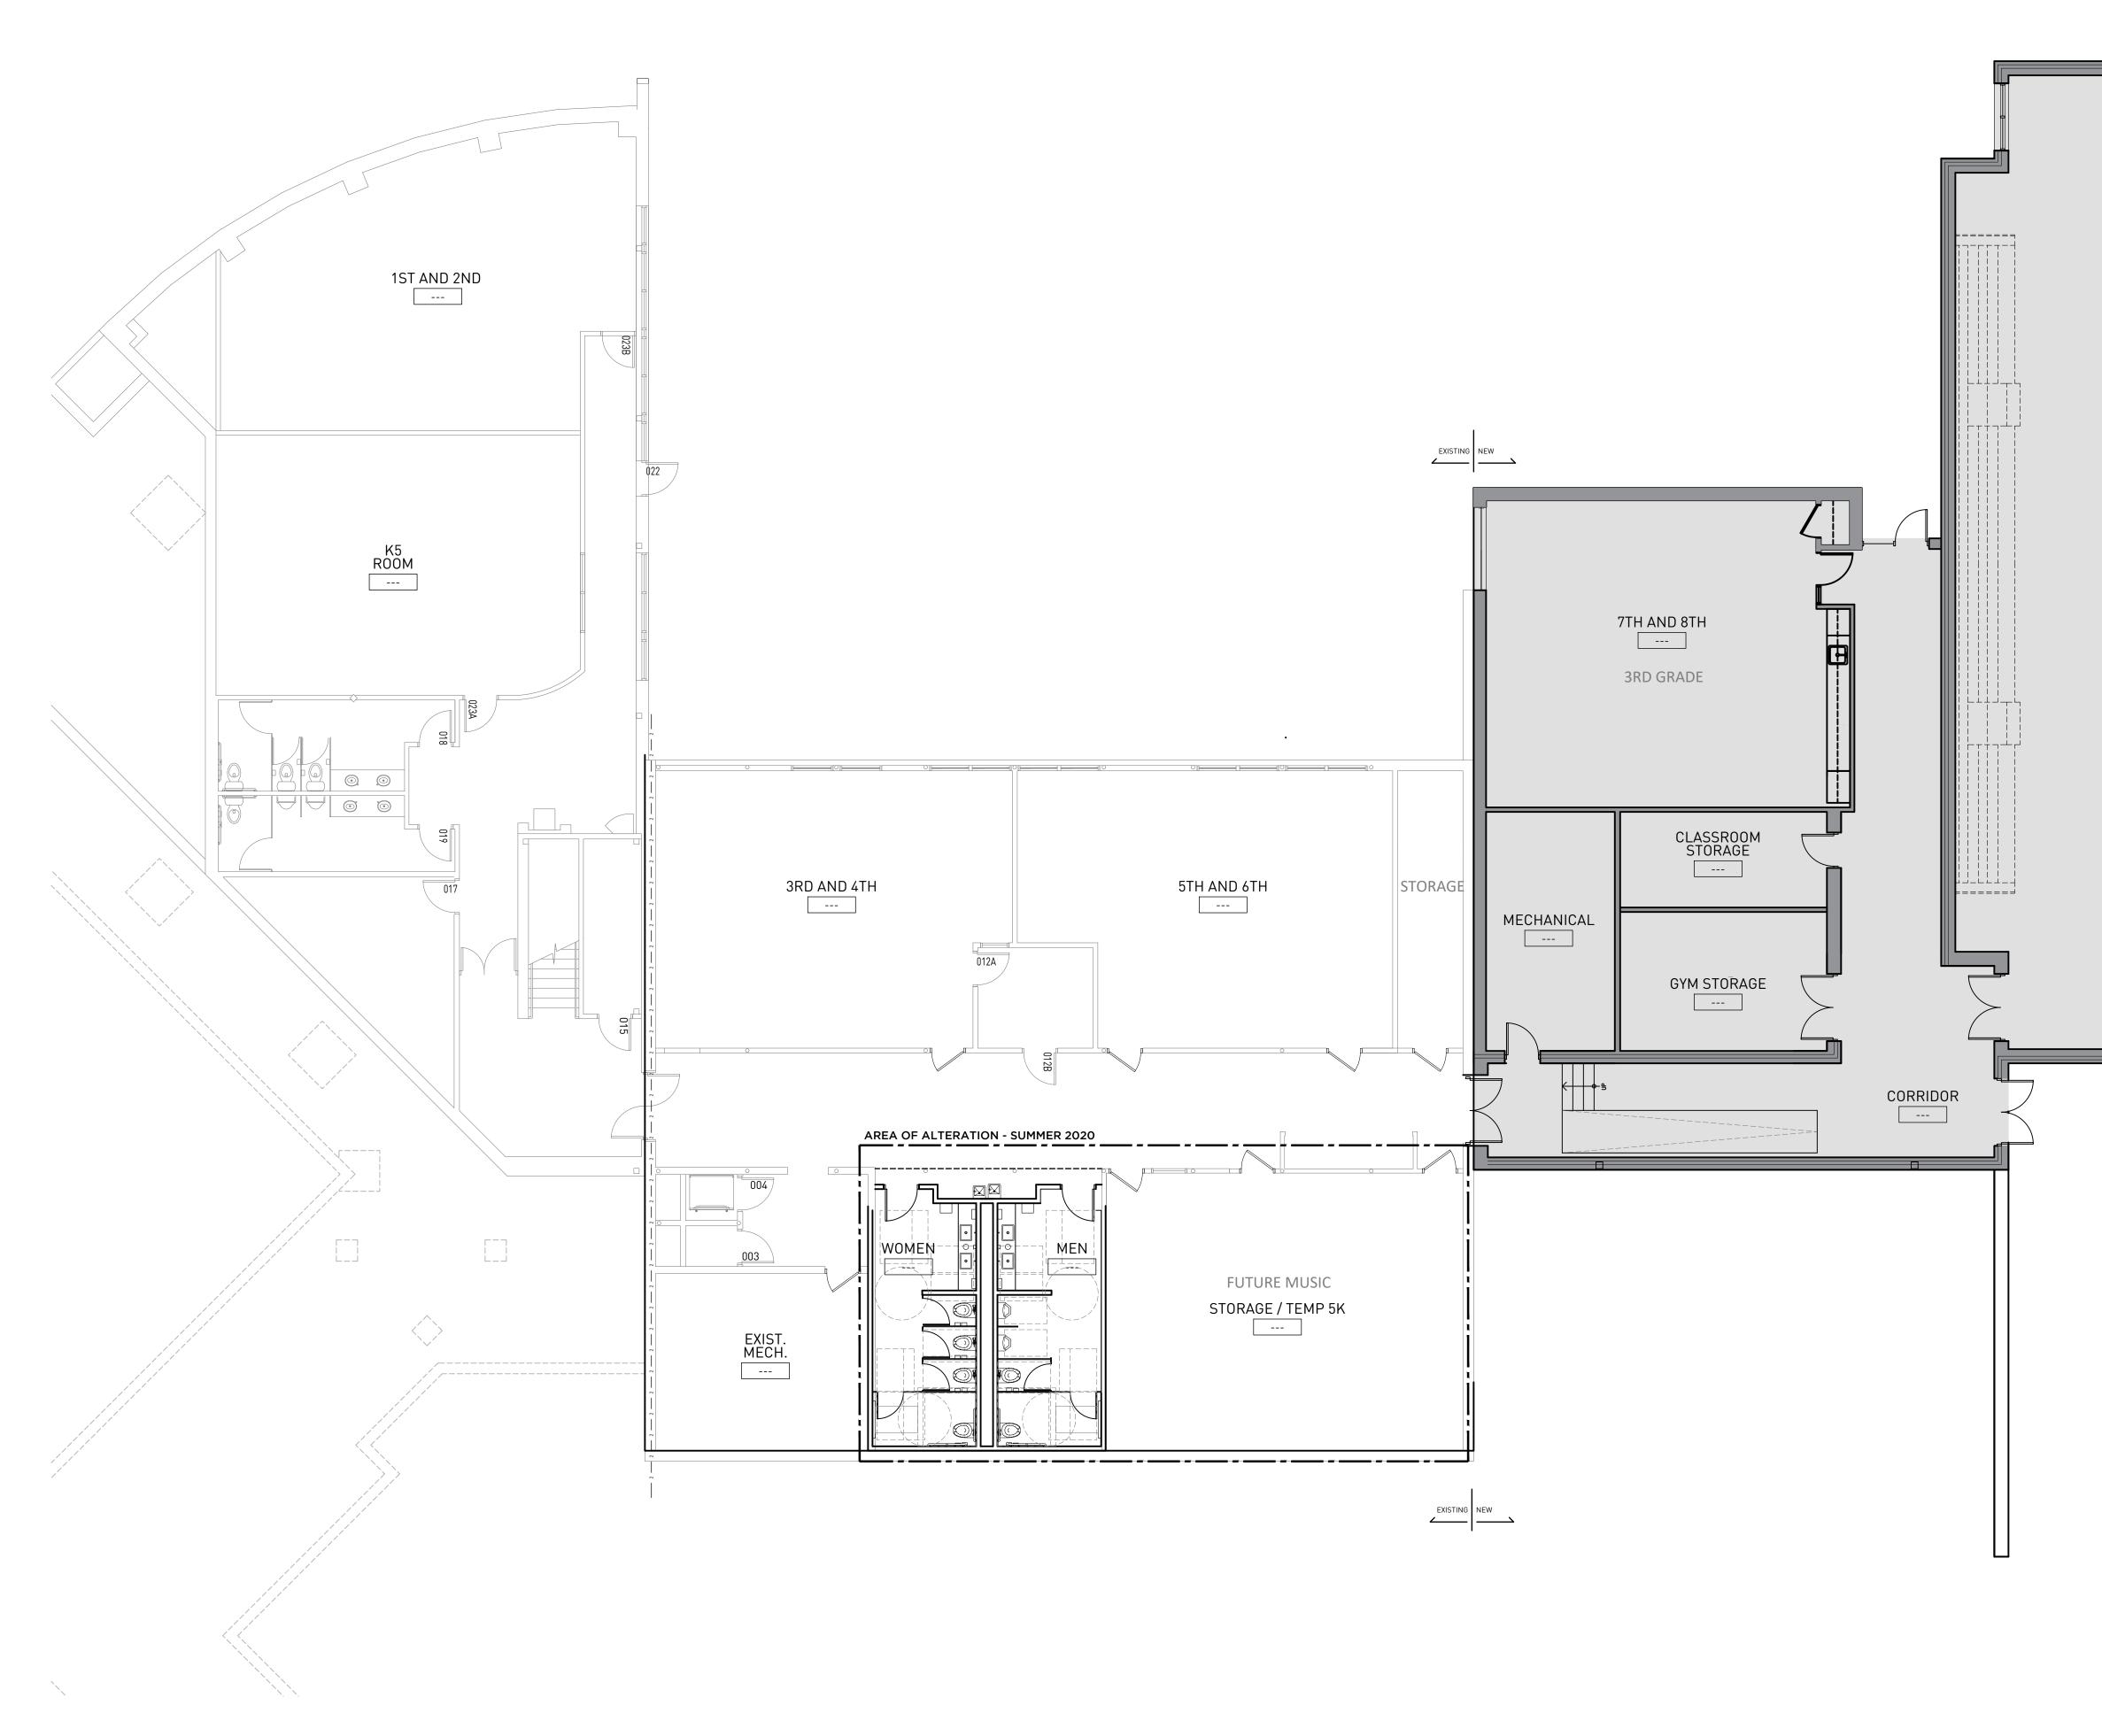

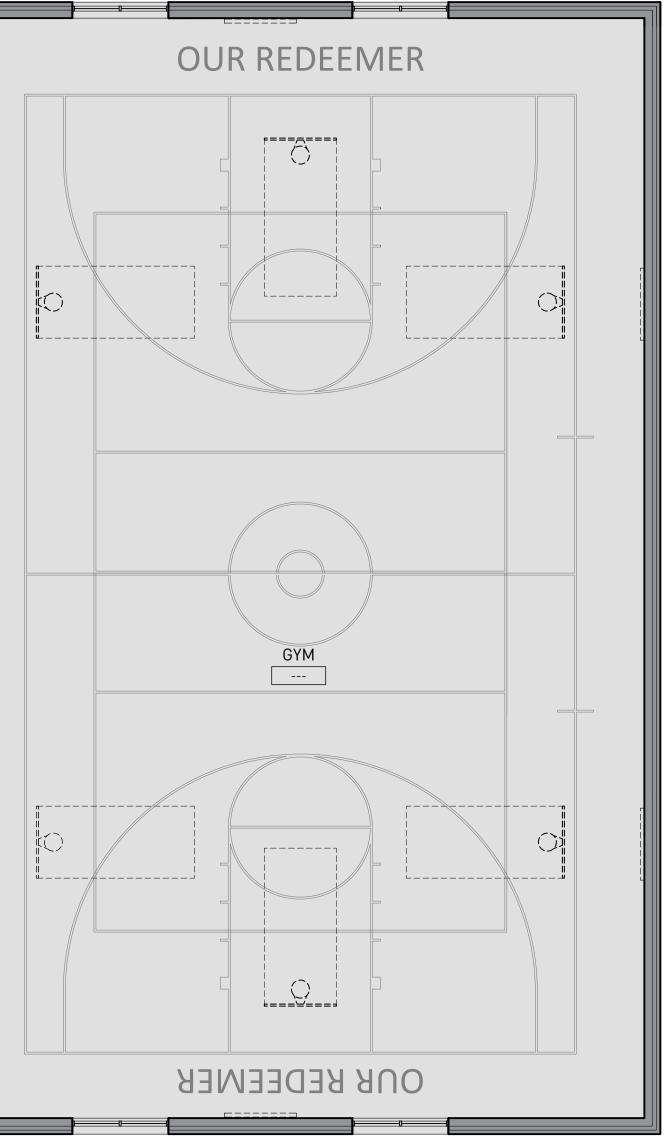





(414) 254 0498 TREDOGROUP.COM

PROJECT NAME **OUR REDEEMER** 1701 MCKENNA BLVD. MADISON, WI, 53711



DRAWING ISSUE HISTORY -- --- ---

SET TYPE SCHEMATIC DESIGN

19019

DATE

09-16-2020


SHEET TITLE

SHEET NUMBER

A100

FLOOR PLANS

AA PROJECT NUMBER

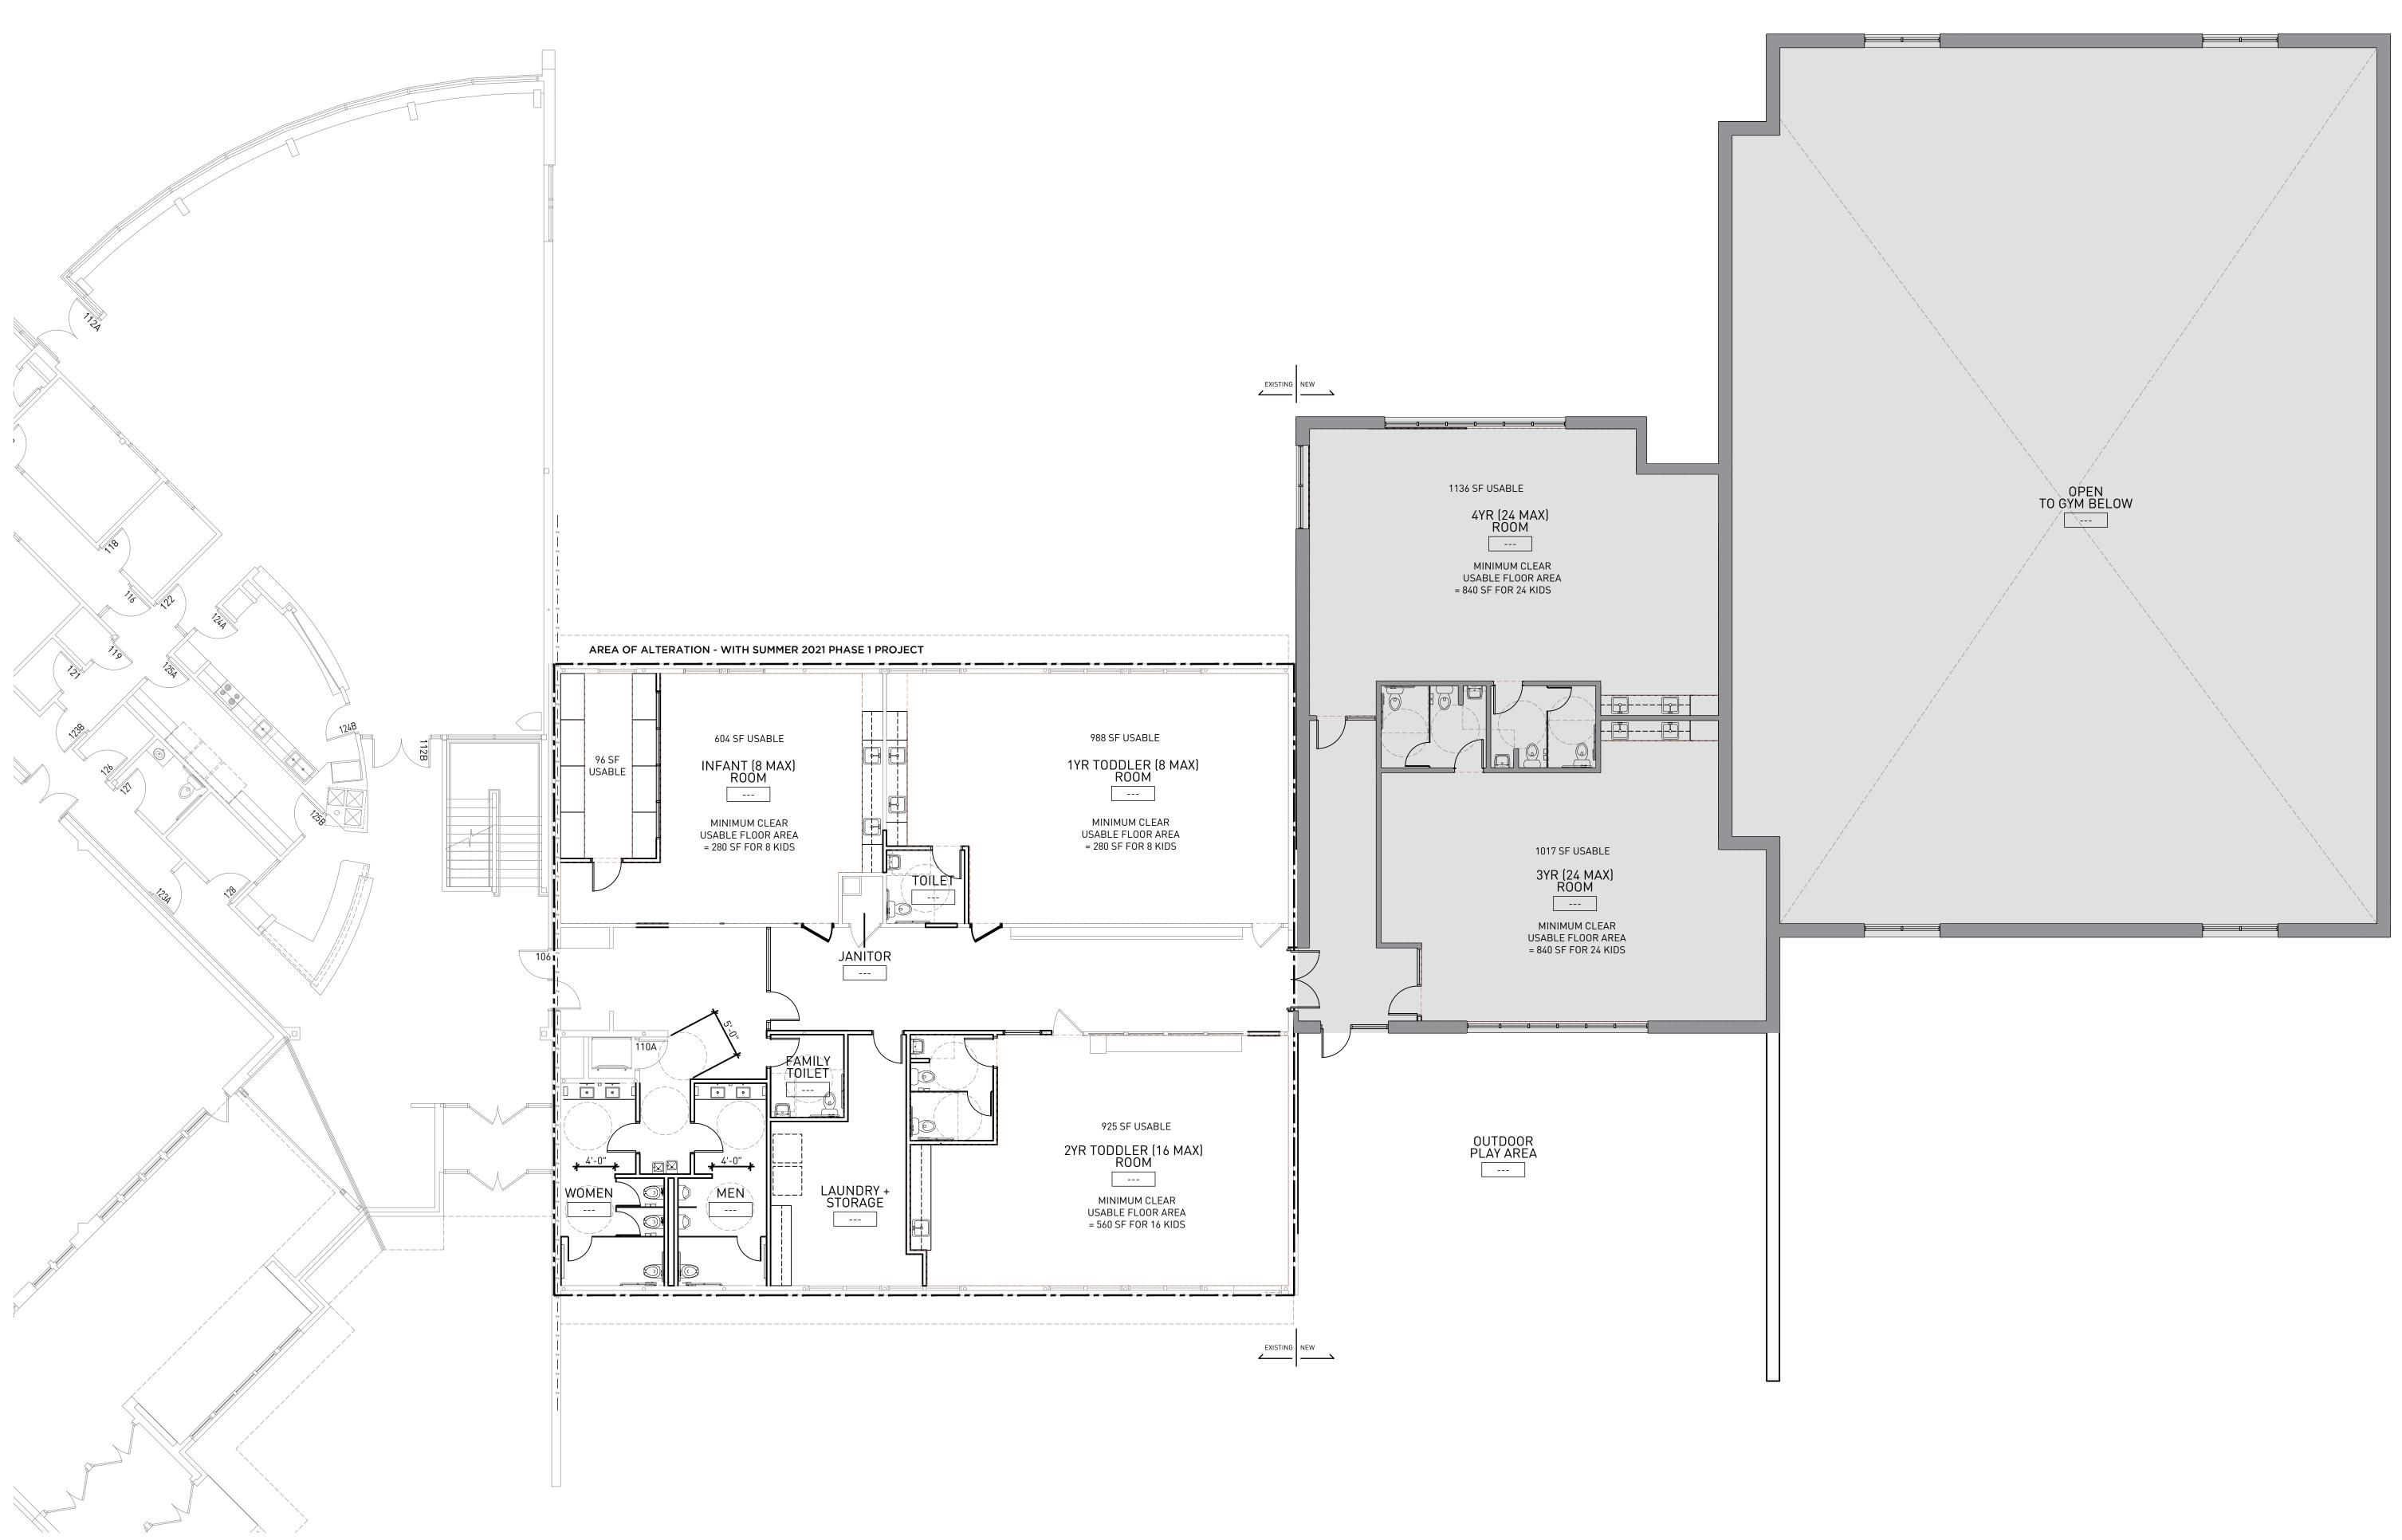





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DRAWING ISSUE HISTORY -- --- ---

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DATE


09-16-2020

SHEET TITLE

SHEET NUMBER

A101

FLOOR PLANS

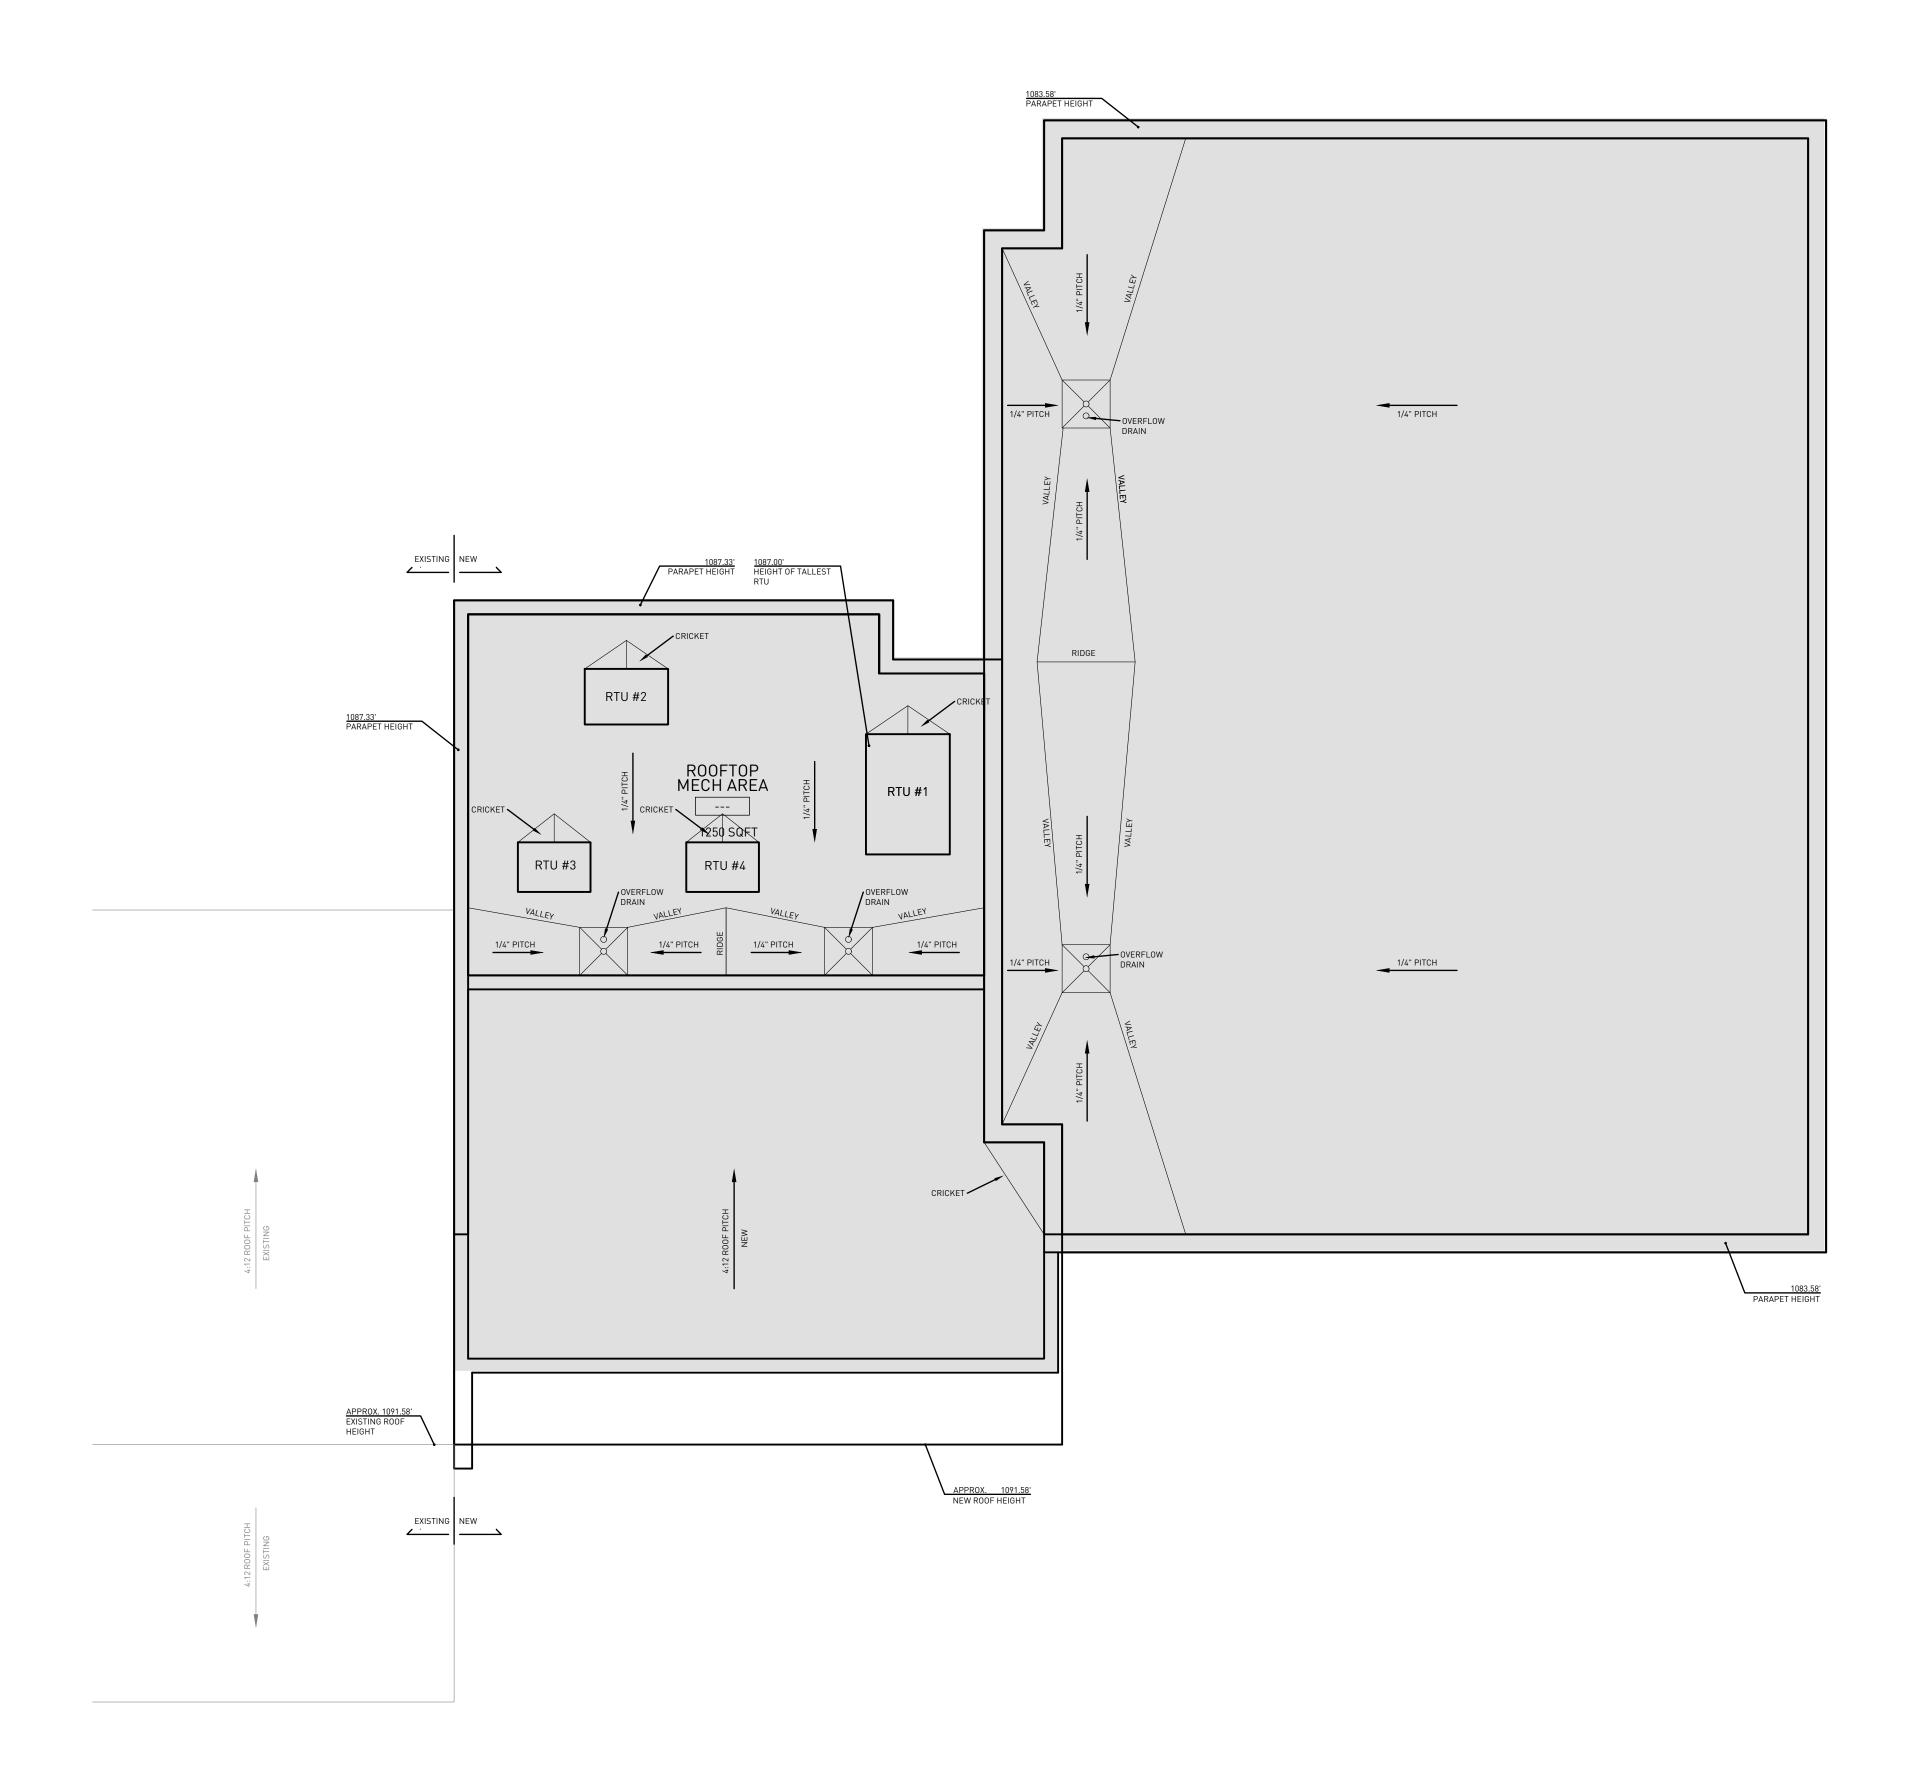



SCALE - 1/8" = 1'-0"



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DRAWING ISSUE HISTORY

SET TYPE SCHEMATIC DESIGN

AA PROJECT NUMBER

19019

DATE


09-16-2020


sheet title ROOF PLAN

SHEET NUMBER

A102




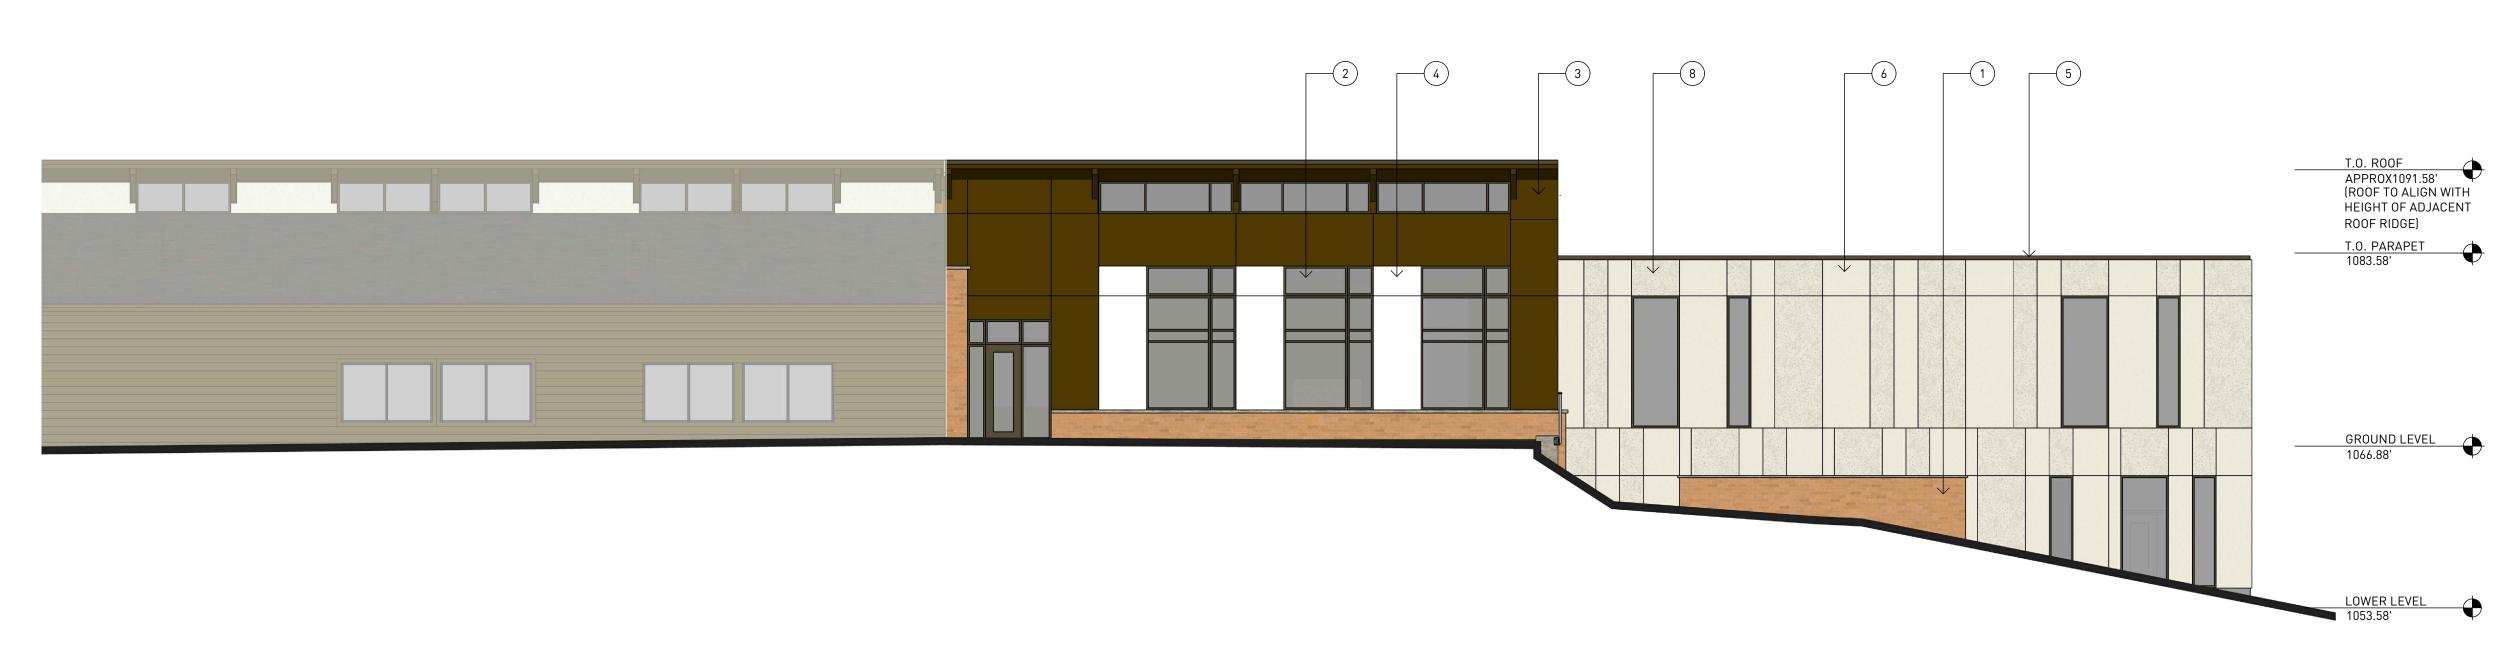

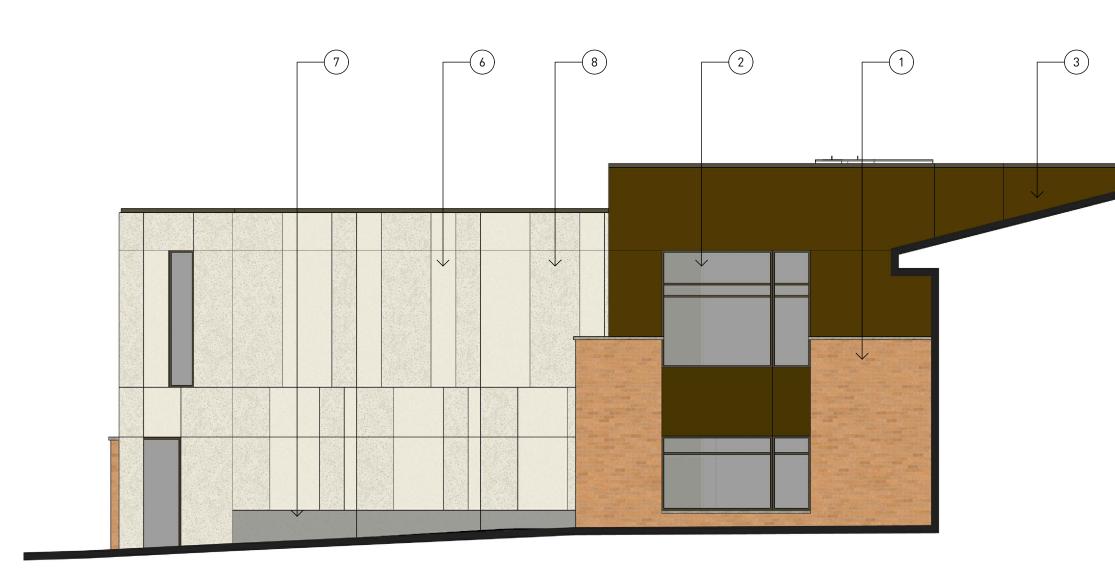

O1 PLAN EAST _____

02 PLAN SOUTH ELEVATION

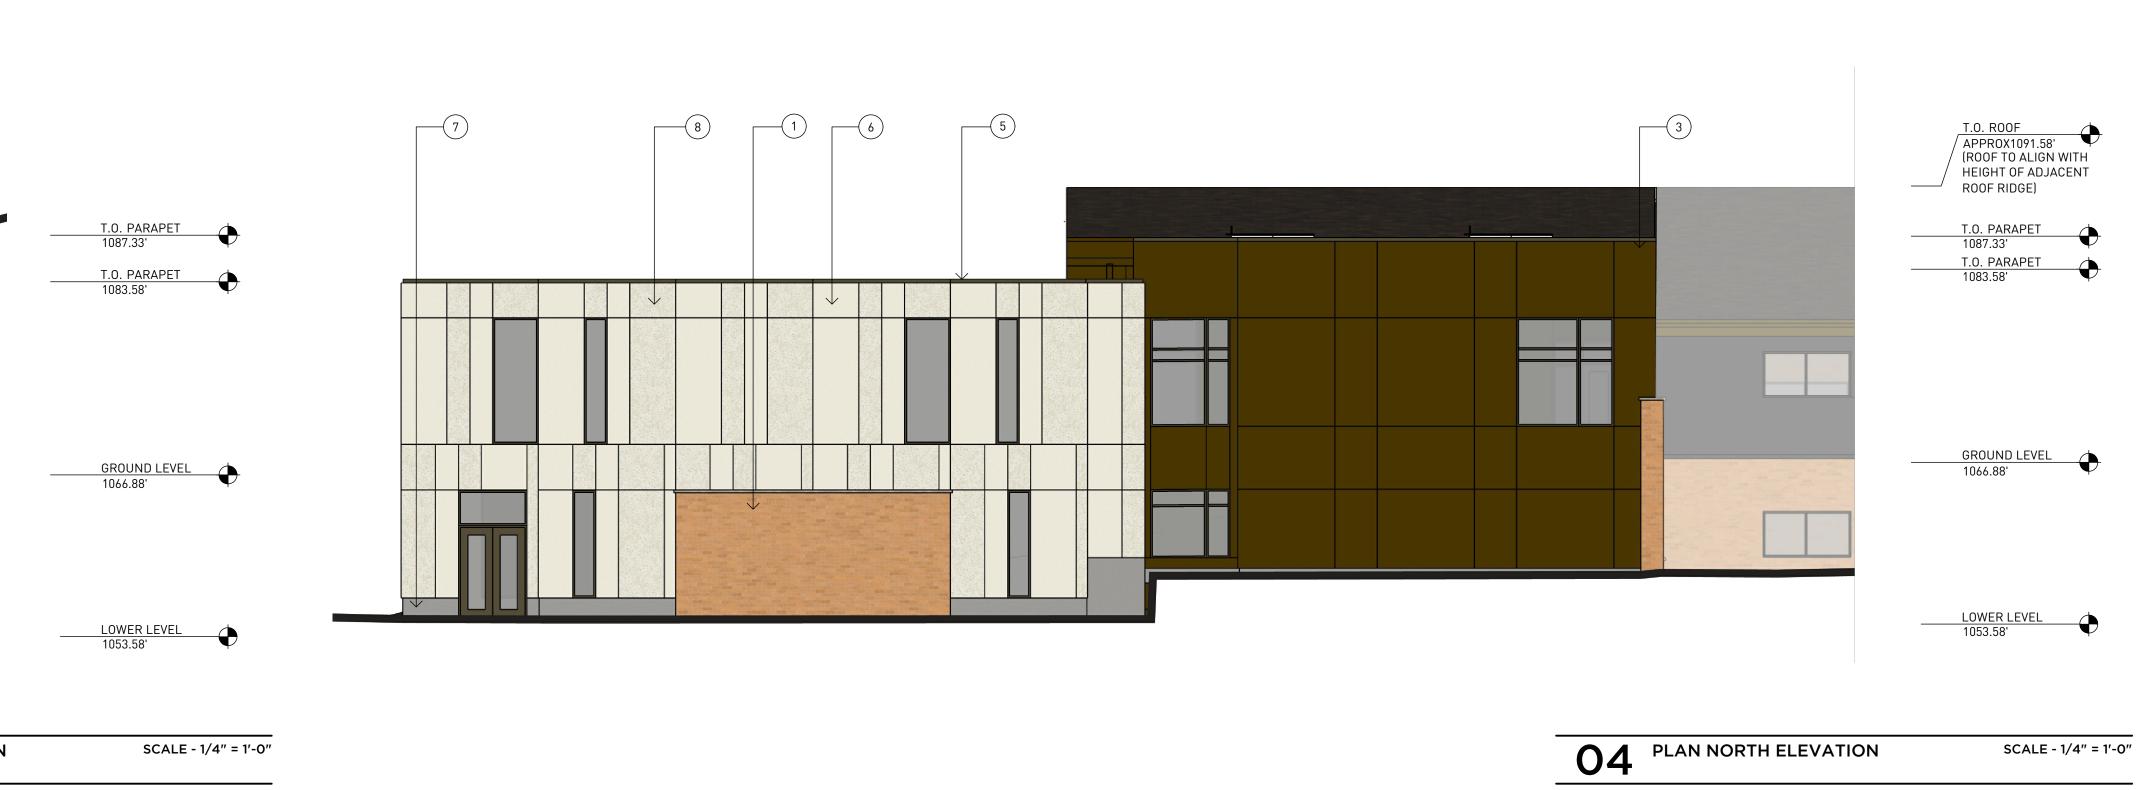

03 PLAN WEST ELEVATION SCALE - 1/4" = 1'-0"

T.O. PARAPET

SCALE - 1/4" = 1'-0"

T.O. ROOF APPROX1091.58' (ROOF TO ALIGN WITH HEIGHT OF ADJACENT ROOF RIDGE)

SCALE - 1/4" = 1'-0"

LOWER LEVEL 053.58'

GROUND LEVEL () 1066.88'

ROOF RIDGE) T.O. PARAPET 1083.58'

T.O. ROOF APPROX1091.58' (ROOF TO ALIGN WITH HEIGHT OF ADJACENT

ELEVATION KEYED NOTES

- BRICK MASONRY. COLOR : MATCH EXISTING
 ALUMINUM STOREFRONT SYSTEM. COLOR: TBD
 CEMENT BOARD PANEL SYSTEM. COLOR #1 TBD
 CEMENT BOARD PANEL SYSTEM. COLOR #2 TBD
 METAL COPING. COLOR: TBD
 PRECAST CONCRETE FLAT TEXTURE. COLOR : NATURAL
 PRECAST CONCRETE FLAT TEXTURE. COLOR : STAINED
 PRECAST CONCRETE EXPOSED AGGREGATE TEXTURE. COLOR : NATURAL
 CAST CONCRETE: COLOR NATURAL





219 N MILWAUKEE ST SUITE 630 MILWAUKEE WISCONSIN 53202 (414) 254 0498 TREDOGROUP.COM





DRAWING ISSUE HISTORY -- --- ---

SET TYPE SCHEMATIC DESIGN AA PROJECT NUMBER

19019

DATE

09-16-2020


SHEET TITLE

BUILDING ELEVATIONS

SHEET NUMBER

A200

SCALE - 1/4" = 1'-0"

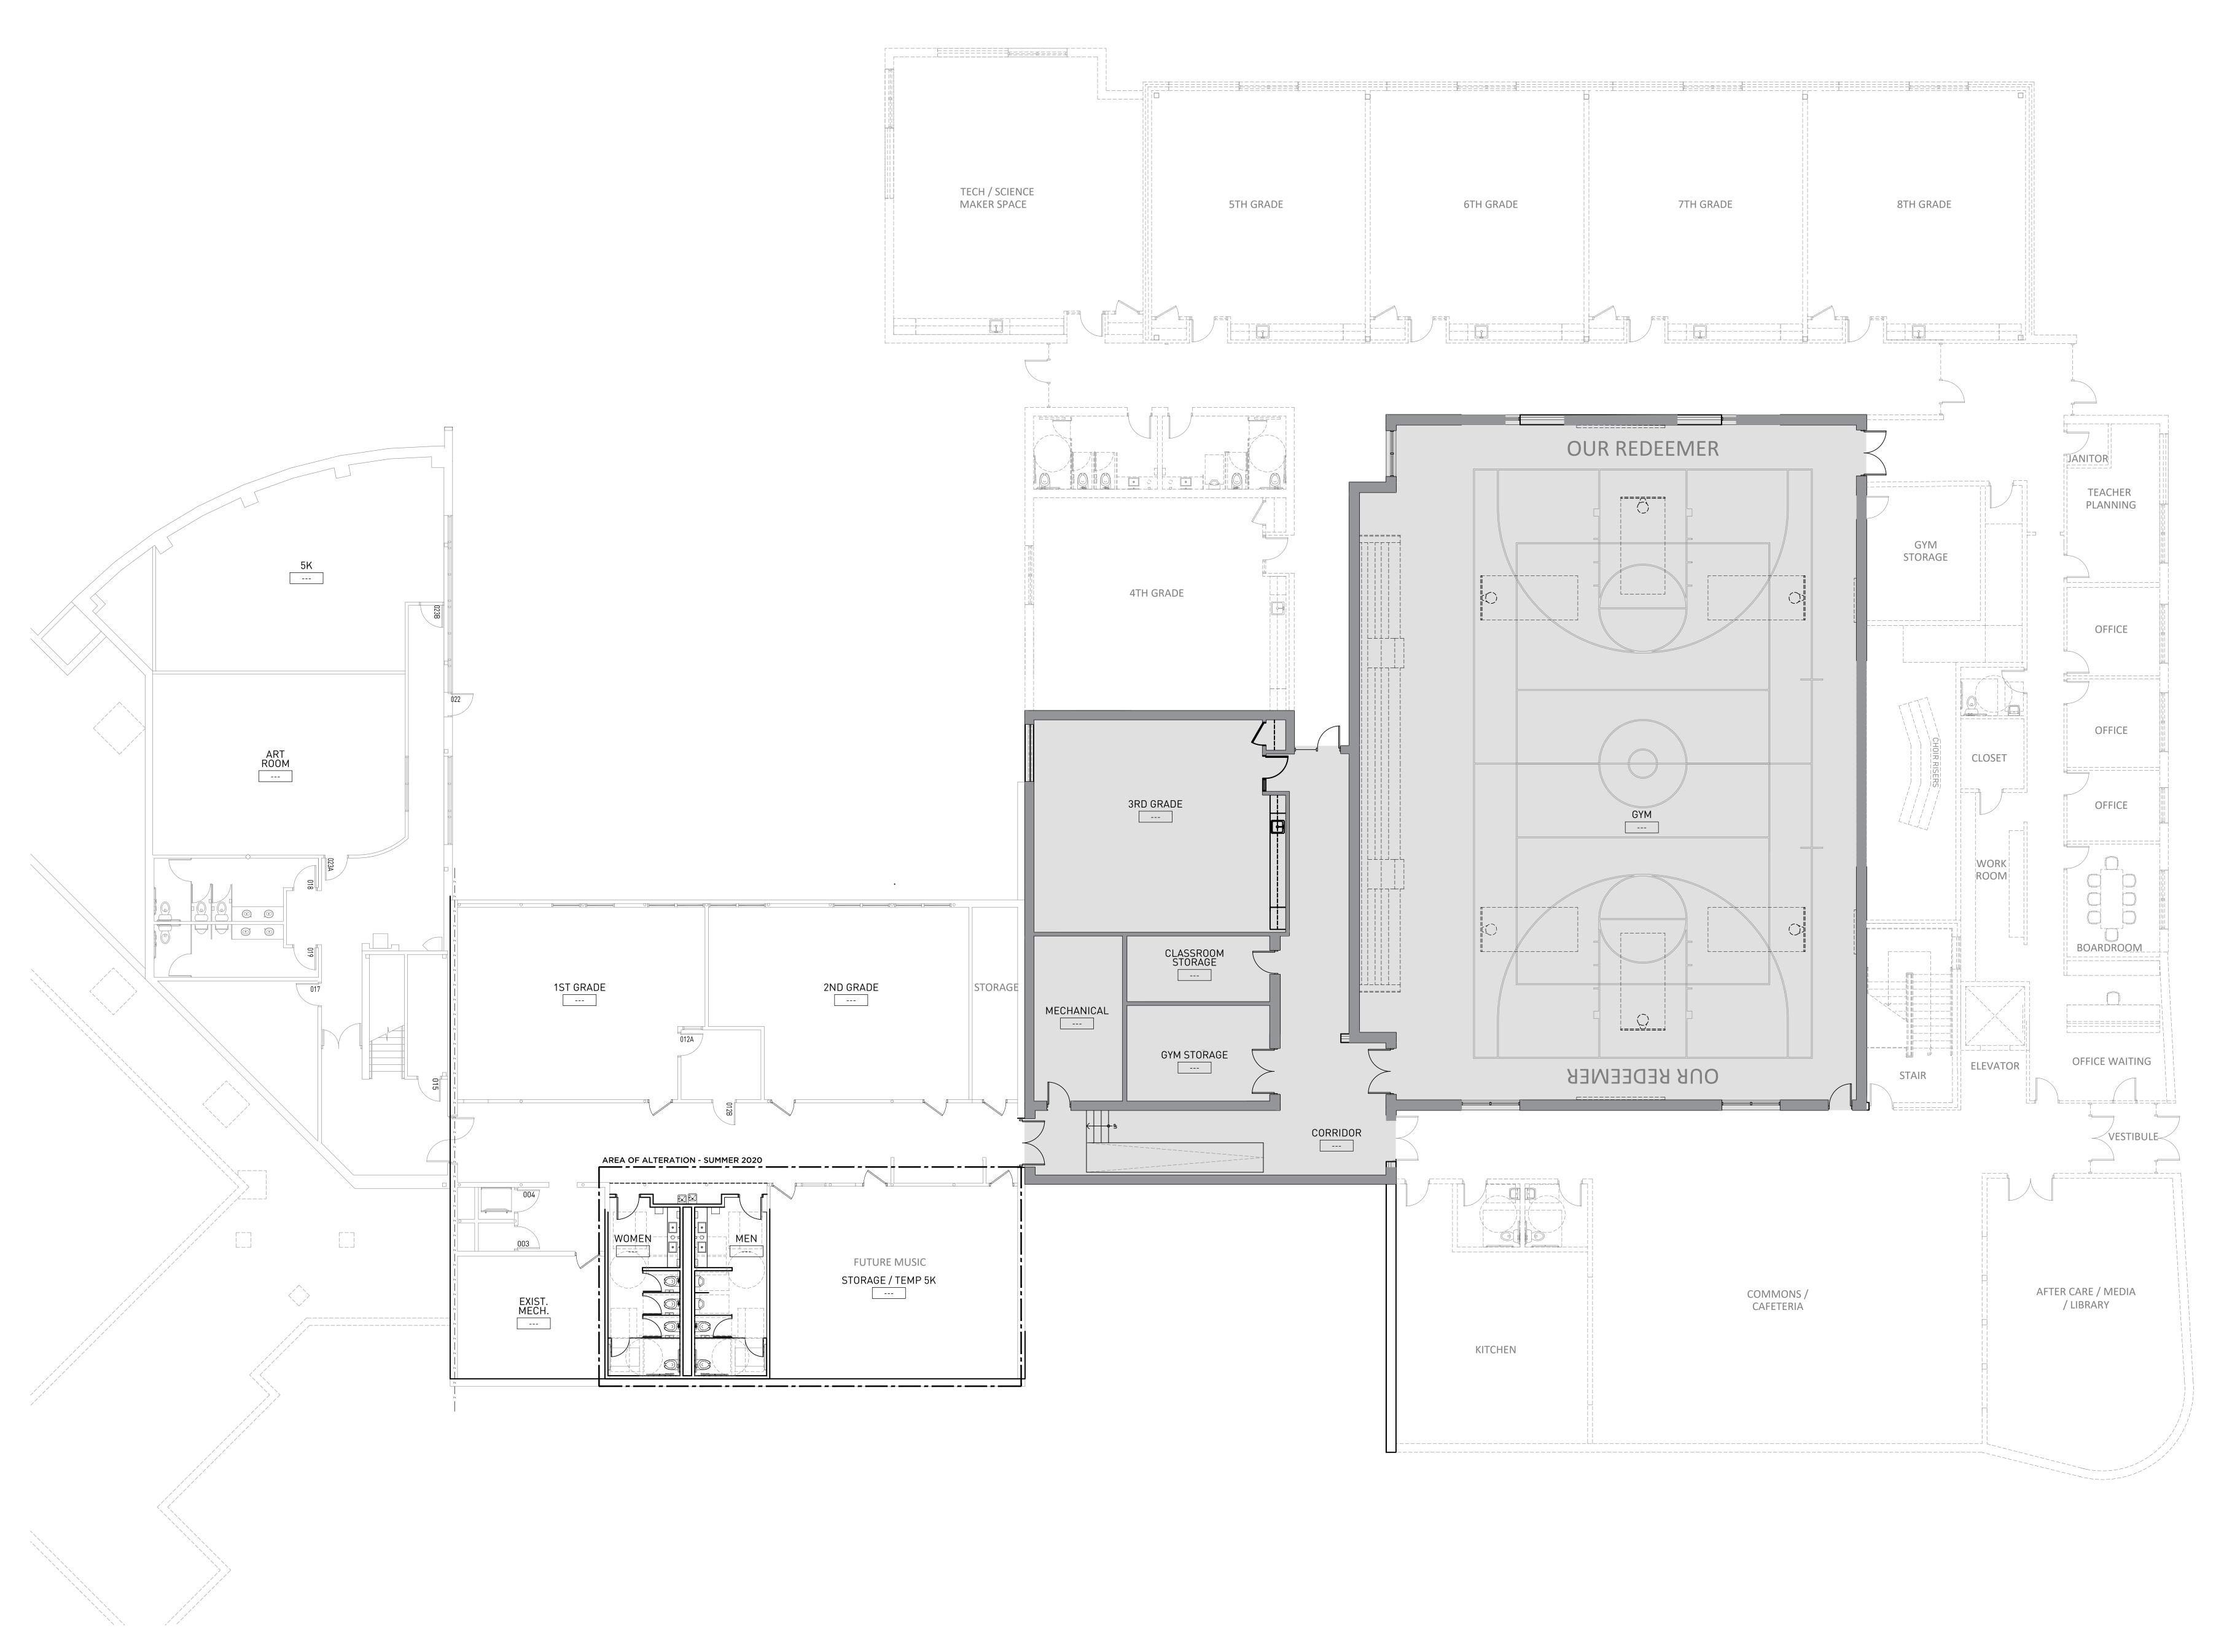

01 LOWER FLOOR PLAN FUTURE PHASE



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project name **OUR REDEEMER** 1701 MCKENNA BLVD. MADISON, WI, 53711



DRAWING ISSUE HISTORY

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set type SCHEMATIC DESIGN


aa project number 19019


рате 09-16-2020

sheet title FLOOR PLANS

SHEET NUMBER



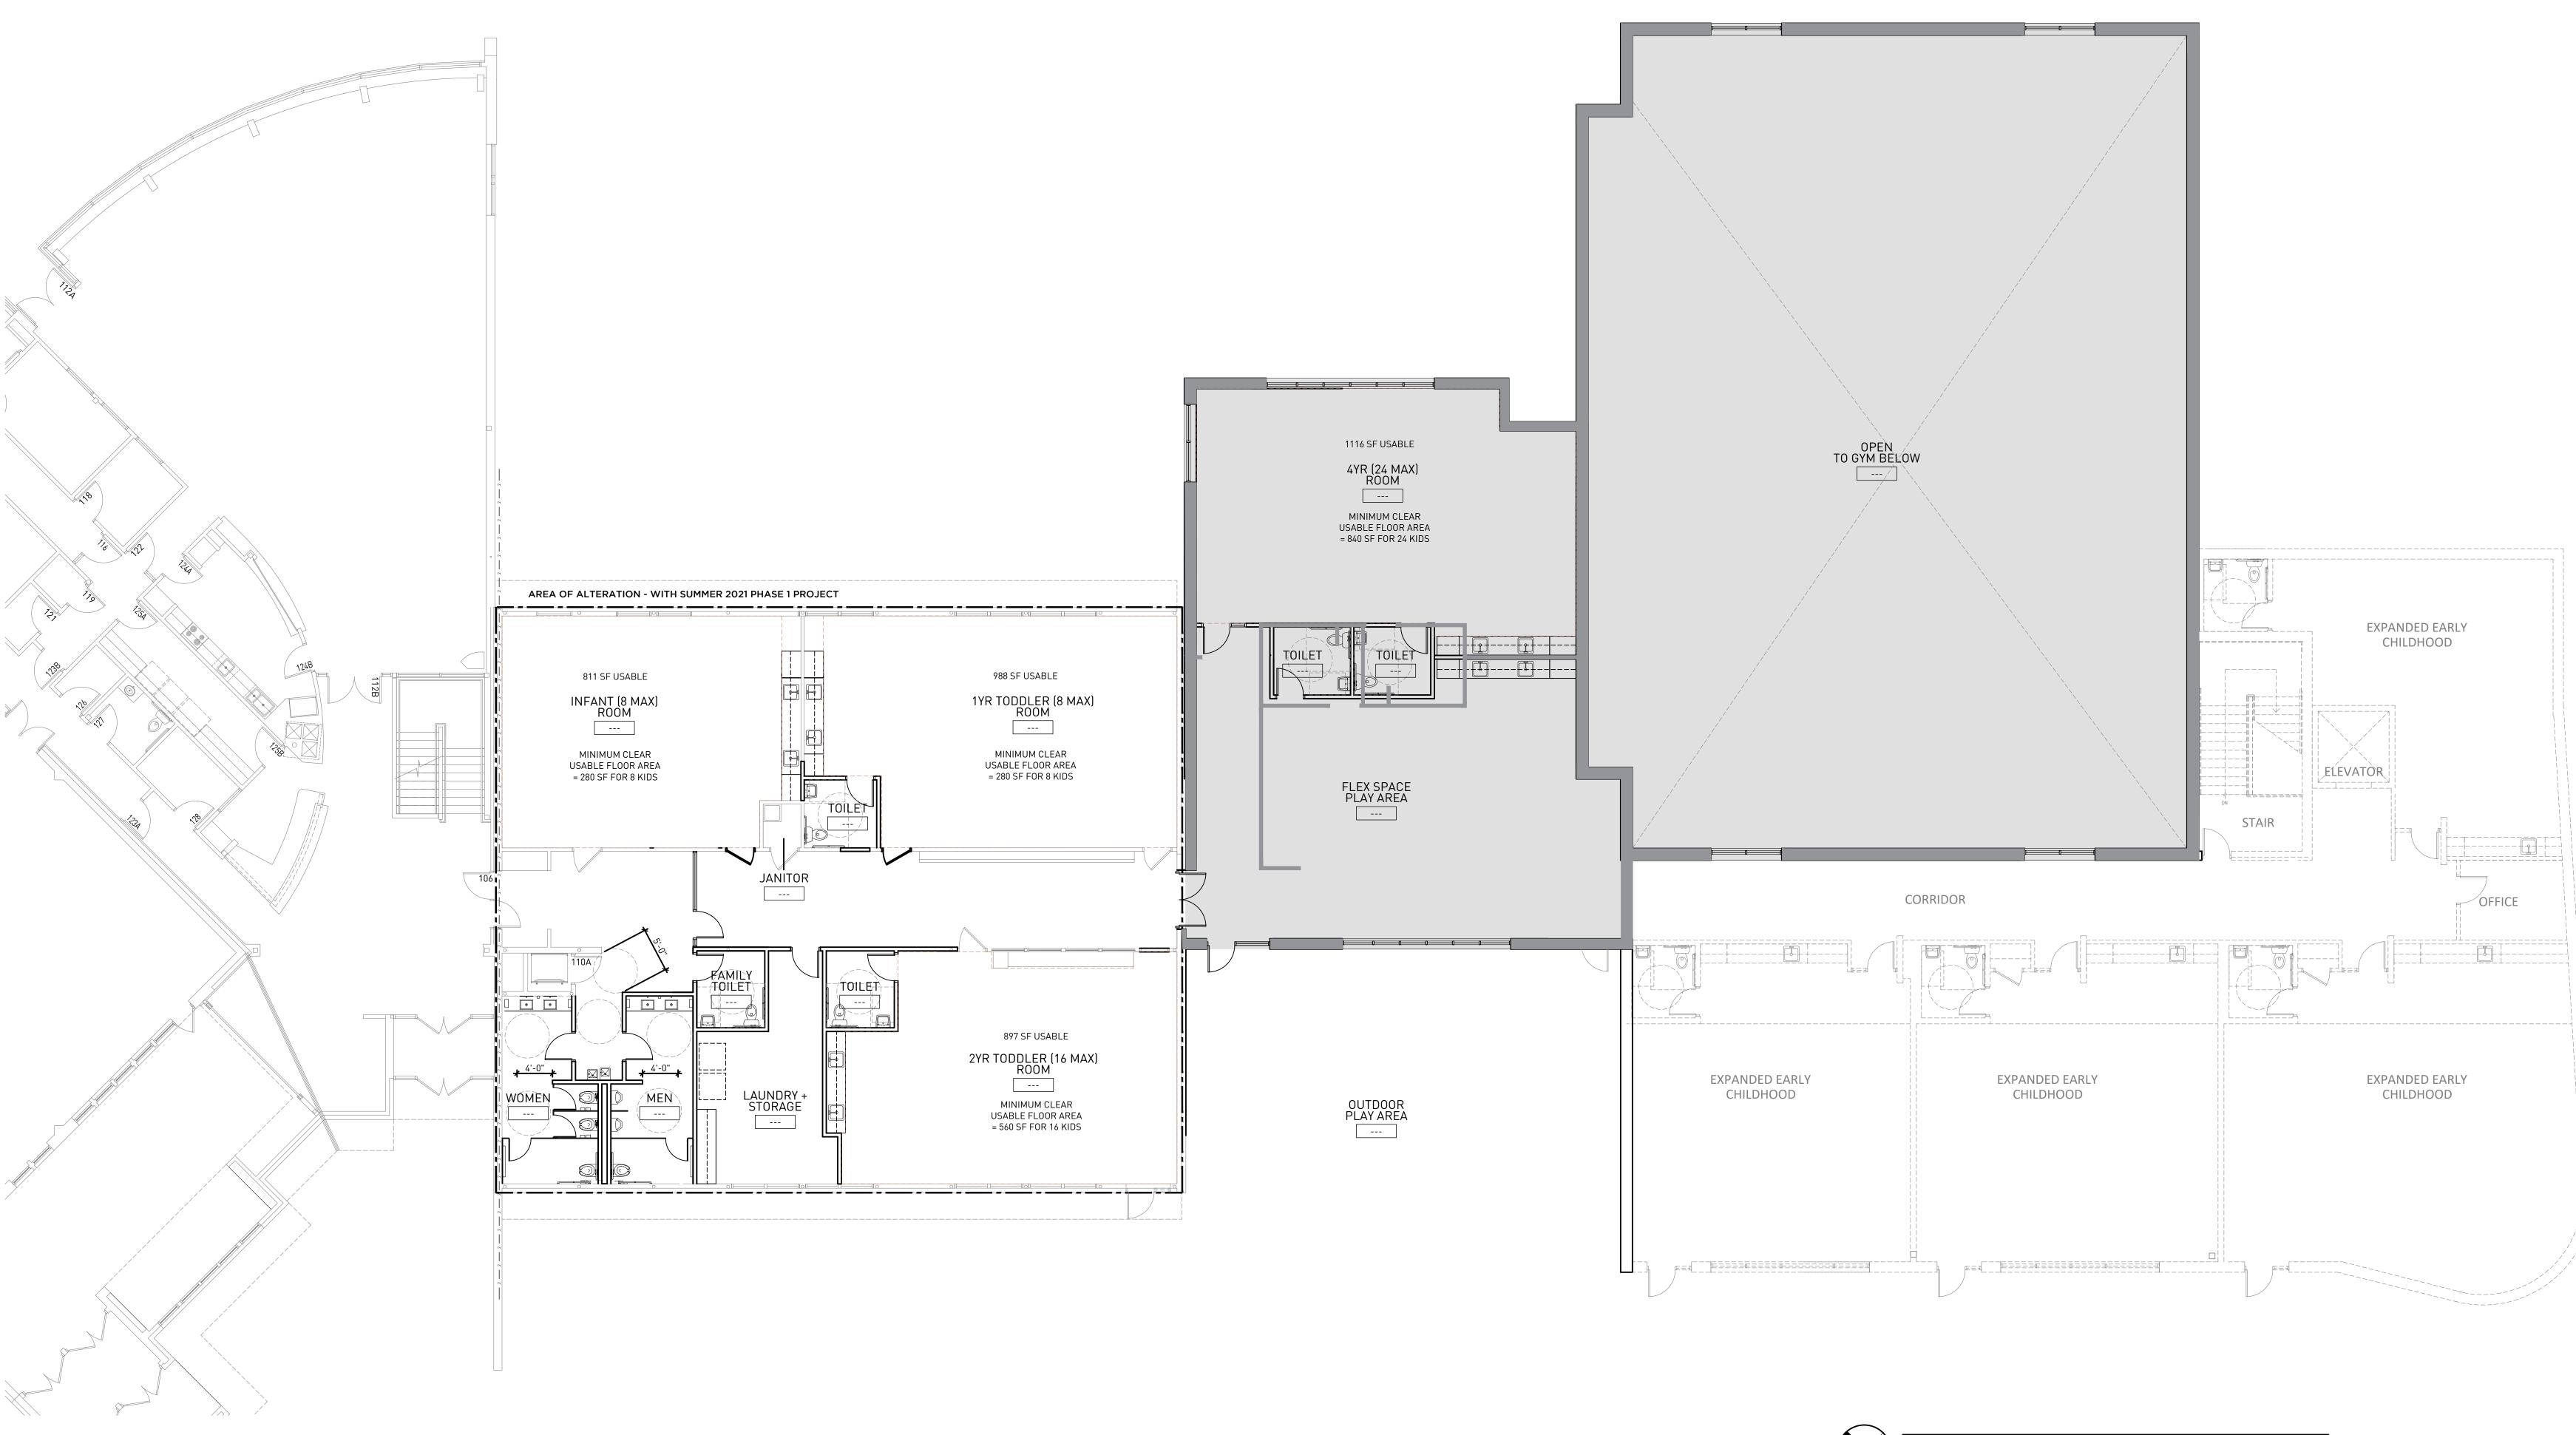

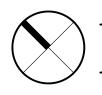

O1 FIRST FLOOR PLAN FUTURE PHASE SCALE - 1/8" = 1'-0"



53202 (414) 254 0498 TREDOGROUP.COM

project name **OUR REDEEMER** 1701 MCKENNA BLVD. MADISON, WI, 53711



DRAWING ISSUE HISTORY

set type SCHEMATIC DESIGN

aa project number 19019

19019

d a t e 09-16-2020

sheet title FLOOR PLANS sheet number





Staff Person

Department of Planning & Community & Economic Development 215 Martin Luther King Jr Blvd, Suite 017 Madison, WI 53703 Phone: 266-4551 Email: Zoning@cityofmadison.com

Parking Lot / Site Plan Approval Application Checklist

Instructions: Please complete this form and submit it with all the materials necessary for a parking lot plan review and approval. Check boxes for the items submitted that apply to your project. If you are not sure about what to show or submit, call the appropriate agency (*see Box G*). Once your application is accepted, staff will review, approve and return your application materials within 7 working days or sooner.

Site Address <u>1701</u> <u>McKENNA BLVO</u> <u>MADISO</u> Contact Person <u>CHRIS</u> <u>HODGES</u> QUAME Contact Person Address <u>4604</u> <u>SIGGLEKOW</u> <u>RD</u> , <u>5014</u>	N WI 5- ENGINSERIN E A, MOP	B711 Phone/FAX E 2608) 838 ARLAND WI 5	-7750 3558
 Project Type (check one): New Alteration Project Type (check one): New Alteration These items must be included with an application: Scaled drawing(s): 1" = 20' or similar: 5 set N/A PDF copy of plans on non-returnable CD, USB Flash Drive, or emailed to zoning@cityofmadison.com Conditional Use or PD/SIP approval letter (if applicable) Driveway Opening Permit application A A A A A A A A A A A A A A A A A A A	 D. Parking layou drawing(s). 25. Dimensions 26. Location of 22. 27. Location of 22. 29. Location of 23. 30. Bicycle park E. "Off-property drawing(s): 31. Trees, poles, 32. Medians (if a 33. Driveway of 34. Distance to 133. 	ut information that must be See Example Plan W: of parking stalls and drive aisles accessible parking stalls accessible parking stall signs t width of accessibility ramps <i>E</i> loading facilities ing rack locations, spaces, and ra y" information that must be signs in the right-of-way (<i>if appli</i>	on your (ck detail shown on your licable) (if applicable) !/ (A line
 12. Elevations of existing and proposed site to City datum 13. Elevation of top of curb 14. Storm sewers or drainage pattern (See Example Plan Y) 15. Proposed driveway radii 16. Type of surface on driveway, approach and lot (grass, landscaping, concrete, bituminous paving, mulch, etc.) 17. Location of existing and proposed impervious surfaces 18. Means of separation between parking lot and sidewalk or adjoining property 	G. Questions: Ca	all City Staff for help.	266-4551
19. Tree islands		Setbacks	
20. Screening or landscaping (See Example Plan X)		Landscaping	
21. On-site fire hydrants		Occupancy	
	TRAFFIC	Parking lot geometrics	266-4761
C. Information about the structures that must be shown on	ENGINEERING	0 0	
your drawing:	ENGINEERING	Drainage	266-4751
	ENGENEERING	Land disturbing activity	200-4/31
22. Existing structures (footprints and dimensions)			
23. Proposed structures (footprints and dimensions)		Soil erosion	
24. Setbacks and distance to lot lines (front, rear and sides)	FIRE	Fire hydrants / access	266-4484
	BUILDING	Parking lot lighting	266-4551

8/18/15

F:\Plcommon\ZONING\Zoning Document Warehouse\Parking Lot Site Plan Packet\Pkg Lot_Site Plan Checklist 8-18-15.doc



CITY OF MADISON LANDSCAPE WORKSHEET

Section 28.142 Madison General Ordinance

Project Location /	Address 1701 McKenna Blvd	, Madison, WI
Name of Project	Our Redeemer Lutheran Churc	ch and School
Owner / Contact	Contact: Brad Fregien, Olson	Toon Landscaping, Inc.
Contact Phone (6	608)827-9401	Contact Email brad@olsontoon.com

** Landscape plans for zoning lots greater than ten thousand (10,000) square feet in size MUST be prepared by a registered landscape architect. **

Applicability

The following standards apply to all exterior construction and development activity, including the expansion of existing buildings, structures and parking lots, except the construction of detached single-family and two-family dwellings and their accessory structures. The entire development site must be brought up to compliance with this section unless **all** of the following conditions apply, in which case only the affected areas need to be brought up to compliance:

- (a) The area of site disturbance is less than ten percent (10%) of the entire development site during any ten-(10) vear period.
- (b) Gross floor area is only increased by ten percent (10%) during any ten-(10) year period.
- (c) No demolition of a principal building is involved.
- (d) Any displaced landscaping elements must be replaced on the site and shown on a revised landscaping plan.

Landscape Calculations and Distribution

Required landscaped areas shall be calculated based upon the total developed area of the property. Developed area is defined as that area within a single contiguous boundary which is made up of structures, parking, driveways and docking/loading facilities, but excluding the area of any building footprint at grade, land designated for open space uses such as athletic fields, and undeveloped land area on the same zoning lot. There are three methods for calculating landscape points depending on the size of the lot and Zoning District.

(a) For all lots except those described in (b) and (c) below, five (5) landscape points shall be provided for each three hundred (300) square feet of developed area.

Total square footage of developed area

Total landscape points required

(b) For lots larger than five (5) acres, points shall be provided at five (5) points per three hundred (300) square feet for the first five (5) developed acres, and one (1) point per one hundred (100) square feet for all additional acres.

Total square footage of developed area 230,884 sq ft

Five (5) acres = $\underline{217,800}$ square feet

First five (5) developed acres = 3,630 points

Remainder of developed area $\underline{13,084}$ sq ft / $\underline{100} = \underline{131}$ points

Total landscape points required <u>3,761 points</u>

(c) For the Industrial – Limited (IL) and Industrial – General (IG) districts, one (1) point shall be provided per one hundred (100) square feet of developed area.

Total square footage of developed area

Total landscape points required _____

Tabulation of Points and Credits

Use the table to indicate the quantity and points for all existing and proposed landscape elements.

Diant Trung/ Element	Minimum Size at	Points	Credits/ Existing Landscaping		New/ Proposed Landscaping	
Plant Type/ Element Installation		Points	Quantity	Points Achieved	Quantity	Points Achieved
Overstory deciduous tree	2 ¹ / ₂ inch caliper measured diameter at breast height (dbh)	35	27	945	2	70
Tall evergreen tree (i.e. pine, spruce)	5-6 feet tall	35	19	665	7	245
Ornamental tree	1 1/2 inch caliper	15	13	195	5	75
Upright evergreen shrub (i.e. arborvitae)	3-4 feet tall	10			7	70
Shrub, deciduous	#3 gallon container size, Min. 12"-24"	3	70	210	39	117
Shrub, evergreen	#3 gallon container size, Min. 12"-24"	4	9	36	6	24
Ornamental grasses/ perennials	#1 gallon container size, Min. 8"-18"	2	85	170	43	86
Ornamental/ decorative fencing or wall	n/a	4 per 10 lineal ft.				
Existing significant specimen tree	Minimum size: 2 ¹ / ₂ inch caliper dbh. *Trees must be within developed area and cannot comprise more than 30% of total required points.	14 per caliper inch dbh. Maximum points per tree: 200	5 trees, 66 caliper inches	924		
Landscape furniture for public seating and/or transit connections	* Furniture must be within developed area, publically accessible, and cannot comprise more than 5% of total required points.	5 points per "seat"				
Sub Totals				3145		687

Total Number of Points Provided 3832 points

* As determined by ANSI, ANLA- American standards for nursery stock. For each size, minimum plant sizes shall conform to the specifications as stated in the current American Standard for Nursery Stock.



City of Madison Fire Department

314 W Dayton Street, Madison, WI 53703-2506 Phone: 608-266-4420 • Fax: 608-267-1100 • E-mail: fire@cityofmadison.com

Project Address: 1701 McKenna Blvd

Contact Name & Phone #: Ryan Quam, 608-838-7750

FIRE APPARATUS ACCESS AND FIRE HYDRANT WORKSHEET

 Is the building completely protected by an NFPA 13 or 13R automatic fire sprinkler system? If non-sprinklered, fire lanes extend to within 150-feet of all portions of the exterior wall? If sprinklered, fire lanes are within 250-feet of all portions of the exterior wall? 	X Yes Yes X Yes	☐ No ☐ No ☐ No	□ N/A
 2. Is the fire lane constructed of concrete or asphalt, designed to support a minimum load of 85,000 lbs? a) Is the fire lane a minimum unobstructed width of at least 20-feet? b) Is the fire lane unobstructed with a vertical clearance of at least 13½-feet? c) Is the minimum inside turning radius of the fire lane at least 28-feet? d) Is the grade of the fire lane not more than a slope of 8%? e) Is the fire lane posted as fire lane? (Provide detail of signage.) f) Is a roll-able curb used as part of the fire lane? (Provide detail of curb.) g) Is part of a sidewalk used as part of the required fire lane? (Must support +85,000 lbs.) 	 Yes X Yes X Yes X Yes X Yes Yes Yes Yes Yes Yes 	□ No □ No □ No □ No □ No X No X No X No	 N/A N/A N/A N/A N/A N/A N/A N/A N/A
3. Is the fire lane obstructed by security gates or barricades? If yes:a) Is the gate a minimum of 20-feet clear opening?b) Is an approved means of emergency operations installed, key vault, padlock or key switch?	☐ Yes ☐ Yes ☐ Yes	X No No No	N/A X N/A X N/A
4. Is the Fire lane dead-ended with a length greater than 150-feet? If yes, does the area for turning around fire apparatus comply with IFC D103?	Yes Yes	X No No	N/A X N/A
5. Is any portion of the building to be used for high-piled storage in accordance with IFC Chapter 3206.6 If yes, see IFC 3206.6 for further requirements.	Yes	x No	N/A
6. Is any part of the building greater than 30-feet above the grade plane?	Yes	No	N/A
 If yes, answer the following questions: a) Is the aerial apparatus fire lane parallel to one entire side of the building and covering at least 25% of the perimeter? b) Is the near edge of the aerial apparatus fire lane between 15' and 30' from the building? c) Are there any overhead power or utility lines located across the aerial apparatus fire lane? d) Are there any tree canopies expected to grow across the aerial fire lane? (Based on mature canopy width of tree species) 	☐ Yes ☐ Yes ☐ Yes ☐ Yes	 □ No □ No □ No □ No 	□ N/A □ N/A □ N/A □ N/A
e) Does the aerial apparatus fire lane have a minimum unobstructed width of 26-feet?f) Is the space between the aerial lane and the building free of trees exceeding 20' in heights?	Yes Yes	□ No □ No	□ N/A □ N/A
7. Are all portions of the required fire lanes within 500-feet of at least (2) hydrants?	X Yes	No No	N/A
 7. Are all portions of the required fire lanes within 500-feet of at least (2) hydrants? Note: Distances shall be measured along the path of the hose lay as it comes off the fire apparatus. a) Is the fire lane at least 26' wide for at least 20-feet on each side of the hydrants? b) Is there at least 40' between a hydrant and the building? c) Are the hydrant(s) setback no less than 5-feet nor more than 10-feet from the curb or edge of the street or fire lane? 	X Yes X Yes X Yes Yes	□ No □ No □ No □ No	□ N/A □ N/A □ N/A x N/A

Attach an additional sheet if further explanation is required for any answers.

This worksheet is based on MGO 34.503 and IFC 2015 Edition Chapter 5 and Appendix D; please see the codes for further information.



City of Madison Fire Department

314 W Dayton Street, Madison, WI 53703-2506 Phone: 608-266-4420 • Fax: 608-267-1100 • E-mail: fire@cityofmadison.com

Project Address: 1701 McKenna Blvd

Contact Name & Phone #: Ryan Quam, 608-838-7750

FIRE APPARATUS ACCESS AND FIRE HYDRANT WORKSHEET

 Is the building completely protected by an NFPA 13 or 13R automatic fire sprinkler system? If non-sprinklered, fire lanes extend to within 150-feet of all portions of the exterior wall? If sprinklered, fire lanes are within 250-feet of all portions of the exterior wall? 	X Yes Yes X Yes	☐ No ☐ No ☐ No	□ N/A
 2. Is the fire lane constructed of concrete or asphalt, designed to support a minimum load of 85,000 lbs? a) Is the fire lane a minimum unobstructed width of at least 20-feet? b) Is the fire lane unobstructed with a vertical clearance of at least 13½-feet? c) Is the minimum inside turning radius of the fire lane at least 28-feet? d) Is the grade of the fire lane not more than a slope of 8%? e) Is the fire lane posted as fire lane? (Provide detail of signage.) f) Is a roll-able curb used as part of the fire lane? (Provide detail of curb.) g) Is part of a sidewalk used as part of the required fire lane? (Must support +85,000 lbs.) 	 Yes X Yes X Yes X Yes X Yes Yes Yes Yes Yes Yes 	□ No □ No □ No □ No □ No X No X No X No	 N/A N/A N/A N/A N/A N/A N/A N/A N/A
3. Is the fire lane obstructed by security gates or barricades? If yes:a) Is the gate a minimum of 20-feet clear opening?b) Is an approved means of emergency operations installed, key vault, padlock or key switch?	☐ Yes ☐ Yes ☐ Yes	X No No No	N/A X N/A X N/A
4. Is the Fire lane dead-ended with a length greater than 150-feet? If yes, does the area for turning around fire apparatus comply with IFC D103?	Yes Yes	X No No	N/A X N/A
5. Is any portion of the building to be used for high-piled storage in accordance with IFC Chapter 3206.6 If yes, see IFC 3206.6 for further requirements.	Yes	x No	N/A
6. Is any part of the building greater than 30-feet above the grade plane?	Yes	No	N/A
 If yes, answer the following questions: a) Is the aerial apparatus fire lane parallel to one entire side of the building and covering at least 25% of the perimeter? b) Is the near edge of the aerial apparatus fire lane between 15' and 30' from the building? c) Are there any overhead power or utility lines located across the aerial apparatus fire lane? d) Are there any tree canopies expected to grow across the aerial fire lane? (Based on mature canopy width of tree species) 	☐ Yes ☐ Yes ☐ Yes ☐ Yes	 □ No □ No □ No □ No 	□ N/A □ N/A □ N/A □ N/A
e) Does the aerial apparatus fire lane have a minimum unobstructed width of 26-feet?f) Is the space between the aerial lane and the building free of trees exceeding 20' in heights?	Yes Yes	□ No □ No	□ N/A □ N/A
7. Are all portions of the required fire lanes within 500-feet of at least (2) hydrants?	X Yes	No No	N/A
 7. Are all portions of the required fire lanes within 500-feet of at least (2) hydrants? Note: Distances shall be measured along the path of the hose lay as it comes off the fire apparatus. a) Is the fire lane at least 26' wide for at least 20-feet on each side of the hydrants? b) Is there at least 40' between a hydrant and the building? c) Are the hydrant(s) setback no less than 5-feet nor more than 10-feet from the curb or edge of the street or fire lane? 	X Yes X Yes X Yes Yes	□ No □ No □ No □ No	□ N/A □ N/A □ N/A x N/A

Attach an additional sheet if further explanation is required for any answers.

This worksheet is based on MGO 34.503 and IFC 2015 Edition Chapter 5 and Appendix D; please see the codes for further information.