URBAN DESIGN COMMISSION APPLICATION



City of Madison **Planning Division** Madison Municipal Building, Suite 017



FOR OFFICE USE ONLY: __ Receipt # __ Date received _____ Received by __ 8/12/2020 2:47 p.m. Aldermanic District Zoning District Urban Design District ___ Submittal reviewed by Legistar # ____

215 Martin Luther King, Jr. Blvd. P.O. Box 2985 Madison, WI 53701-2985 (608) 266-4635 Complete all sections of this application, including the desired meeting date and the action requested. If you need an interpreter, translator, materials in alternate formats or other accommodations to access these forms, please call the phone number above immediately. 1. Project Information Address: 1701 Wright St. Title: Madison College Truax Campus - Pool & Fitness Renovation 2. Application Type (check all that apply) and Requested Date UDC meeting date requested September 23 (or next available) New development Alteration to an existing or previously-approved development Informational Initial approval Final approval 3. Project Type Project in an Urban Design District Signage Project in the Downtown Core District (DC), Urban Comprehensive Design Review (CDR) Mixed-Use District (UMX), or Mixed-Use Center District (MXC) Signage Variance (i.e. modification of signage height, \mathbf{V} Project in the Suburban Employment Center District (SEC), area, and setback) Campus Institutional District (CI), or Employment Campus Signage Exception District (EC) Planned Development (PD) Other ☐ General Development Plan (GDP) Please specify ☐ Specific Implementation Plan (SIP)

_	p.e	Public Building Project
☐ Planned Multi	-Use Site or Residential Building Complex	
. Applicant, Agent	, and Property Owner Information	
Applicant name	Fred Brechlin, AIA	Company Madison College - Planning & Construction
Street address	1701 Wright St.	City/State/Zip Madison, WI 53704
Telephone	608-246-6837	Email FBrechlin@madisoncollege.edu
Project contact pe	erson Justin Frahm, Project Consultant	Company JSD Professional Services, Inc.
Street address	161 Horizon Dr. Suite #101	City/State/Zip Verona, WI 53593
Telephone	715-298-6330	Email justin.frahm@jsdinc.com
Property owner (i	f not applicant) Same	
Street address		City/State/Zip
Telephone		Email
:\PLANNING DIVISION\COMMISS	IONS & COMMITTEES\URBAN DESIGN COMMISSION\APPLICATION	— FEBRUARY 2020 PAGE 1 OF 4

5. Re	quired Submittal Materials		
Ø	Application Form)	an aragonias Saston, Sondar areas anticorias no recipila defenda qua astor
V	Letter of Intent		Each submittal must include
	 If the project is within an Urban Design District, a s development proposal addresses the district criteria is 		fourteen (14) 11" x 17" collated paper copies. Landscape and
	 For signage applications, a summary of how the proportent with the applicable CDR or Signage Variance review 		Lighting plans (if required) must be <u>full-sized and legible</u> .
V	Development Plans (Refer to checklist on Page 4 for plan	details)	Please refrain from using plastic covers or spiral binding.
V	Filing fee	}	Dental and the second of the second s
V	Electronic Submittal*		
V	Notification to the District Alder		
	 Please provide an email to the District Alder notifying as early in the process as possible and provide a copy 		
Bot sch	th the paper copies and electronic copies <u>must</u> be submitted eduled for a UDC meeting. Late materials will not be accepted. A	prior to the application de completed application form	adline before an application will be is required for each UDC appearance
	projects also requiring Plan Commission approval, applicants mussideration prior to obtaining any formal action (initial or final ap		
cor pro not	ectronic copies of all items submitted in hard copy are requipiled on a CD or flash drive, or submitted via email to ude spiect address, project name, and applicant name. Electronic tallowed. Applicants who are unable to provide the materic 6-4635 for assistance.	applications@cityofmadiso submittals via file hosting s	<u>n.com</u> . The email must include the services (such as Dropbox.com) are
6. Ap	plicant Declarations		
1.	Prior to submitting this application, the applicant is re Commission staff. This application was discussed wit July 30 & August 10, 2020		posed project with Urban Design or
2.	The applicant attests that all required materials are included is not provided by the application deadline, the application consideration.		
Name	of applicant Justin Frahm	Relationship to prope	erty Consultant to Owner
	orizing signature of property owner	12 / /\	Date 8 12 20
7. Ap	plication Filing Fees		
of t Cor	es are required to be paid with the first application for either the combined application process involving the Urban Desi mmon Council consideration. Make checks payable to City T an \$1,000.	ign Commission in conjunc	tion with Plan Commission and/or
Ple	ase consult the schedule below for the appropriate fee for y	your request:	
	Urban Design Districts: \$350 (per §35.24(6) MGO).	A filing fee is not red	quired for the following project
	Minor Alteration in the Downtown Core District (DC) or Urban Mixed-Use District (UMX): \$150 (per §33.24(6)(b) MGO)	applications if part of t	he combined application process Design Commission and Plan
	Comprehensive Design Review: \$500 (per §31.041(3)(d)(1)(a) MGO)		ntown Core District (DC), Urban /IX), or Mixed-Use Center District (MXC)
	Minor Alteration to a Comprehensive Sign Plan: \$100 (per §31.041(3)(d)(1)(c) MGO)		Suburban Employment Center pus Institutional District (CI), or
	All other sign requests to the Urban Design	Employment Camp	

Planned Development (PD): General Development

Plan (GDP) and/or Specific Implementation Plan (SIP)

Planned Multi-Use Site or Residential Building Complex

Commission, including, but not limited to: appeals

from the decisions of the Zoning Administrator,

requests for signage variances (i.e. modifications of signage height, area, and setback), and additional sign

code approvals: \$300 (per §31.041(3)(d)(2) MGO)

URBAN DESIGN COMMISSION APPROVAL PROCESS



Introduction

The City of Madison's Urban Design Commission (UDC) has been created to:

- Encourage and promote high quality in the design of new buildings, developments, remodeling, and additions so as to maintain and improve the established standards of property values within the City.
- Foster civic pride in the beauty and nobler assets of the City, and in all other ways possible assure a functionally efficient and visually attractive City in the future.

Types of Approvals

There are three types of requests considered by the UDC:

- Informational Presentation. Applicants may, at their discretion, request to make an Informational Presentation to the
 UDC prior to seeking any approvals to obtain early feedback and direction before undertaking detailed design. Applicants
 should provide details on the context of the site, design concept, site and building plans, and other relevant information
 to help the UDC understand the proposal and provide feedback. (Does not apply to CDR's or Signage Variance requests)
- <u>Initial Approval</u>. Applicants may, at their discretion, request initial approval of a proposal by presenting preliminary design information. As part of their review, the Commission will provide feedback on the design information that should be addressed at Final Approval stage.
- <u>Final Approval</u>. Applicants may request Final Approval of a proposal by presenting all final project details. Recommendations or concerns expressed by the UDC in the initial approval must be addressed at this time.

Presentations to the Commission

Primarily, the UDC is interested in the appearance and design quality of projects. Emphasis should be given to the site plan, landscape plan, lighting plan, building elevations, exterior building materials, color scheme, and graphics.

When presenting projects to the UDC, applicants must fill out a registration slip provided in the meeting room and present it to the Secretary. Presentations should generally be limited to 5 minutes or as extended by motion by consent of the Commission. The Commission will withhold questions until the end of the presentation.

Applicants are encouraged to consider the use of various graphic presentation material including a locator map, photographs, renderings/model, scale drawings of the proposal in context with adjacent buildings/uses/signs, etc., as may be deemed appropriate to describe the project and its surroundings. Graphics should be mounted on rigid boards so that they may be easily displayed. Applicants/presenters are responsible for all presentation materials, AV equipment and easels.

URBAN DESIGN DEVELOPMENT PLANS CHECKLIST



The items listed below are minimal application requirements for the type of approval indicated. Please note that the UDC and/or staff may require additional information in order to have a complete understanding of the project.

1. Info	rma	tional Presentation						
		Letter of Intent (If the project is within an Urban Design District, a summary of how the development proposal addresses the district criteria is required) Contextual site information, including photographs and layout of adjacent buildings/structures Site Plan Two-dimensional (2D) images of proposed buildings or structures.		Providing additional information beyond these minimums may generate a greater level of feedback from the Commission.	*** the	 Titl She Non Sca Dat Full at 1 All pla 	le l	t number n arrow , both written and graphic dimensioned plans, scaled = 40' or larger s must be legible, including ed landscape and lighting
2. Initi	al Ap	pproval						
	X	Locator Map Letter of Intent (If the project is within a l	Irh	aan Dasign District a summar	v of I)		
	A	the development proposal addresses the			y 01 <u>1</u>	<u>IOW</u>		
	X	Contextual site information, including phot structures	og.	raphs and layout of adjacent b	uildii	ngs/		Providing additional information beyond these
	X	Site Plan showing location of existing and lanes, bike parking, and existing trees over			ives,	bike		minimums may generate a greater level of feedback
	X	Landscape Plan and Plant List (must be leg	ibl	e)				from the Commission.
	X	Building Elevations in both black & white material callouts)	ar	nd color for all building sides	(incl	ude		
		PD text and Letter of Intent (if applicable)				J		
3. Fina	I Ар _і	proval						
All t	he re	equirements of the Initial Approval (see abo	ve), <u>plus</u> :				
	X	Grading Plan						
		Proposed Signage (if applicable)						
	X	Lighting Plan, including fixture cut sheets	and	d photometrics plan (must be	legib	le) To b	Эе	Provided
	X	Utility/HVAC equipment location and screen	eni	ng details (with a rooftop plar	n if ro	oń-mo	ur	nted) To be Provided
		PD text and Letter of Intent (if applicable)						
	X	Samples of the exterior building materials	(pı	resented at the UDC meeting)				
4. Con	prel	nensive Design Review (CDR) and Varian	ce	Requests (<u>Signage applicati</u>	ons c	only)		
		Locator Map						
		Letter of Intent (a summary of <u>how</u> the propo	sec	d signage is consistent with the C	CDR o	r Signa	ge	Variance criteria is required
		Contextual site information, including ph project site	otc	ographs of existing signage bo	oth o	n site	ar	nd within proximity to the
		Site Plan showing the location of existing s driveways, and right-of-ways	ign	age and proposed signage, di	mens	sioned	si	gnage setbacks, sidewalks
		Proposed signage graphics (fully dimensio	ne	d, scaled drawings, including r	matei	rials an	ıd	colors, and night view)
		Perspective renderings (emphasis on pede	estr	rian/automobile scale viewshe	eds)			

☐ Illustration of the proposed signage that meets Ch. 31, MGO compared to what is being requested.

☐ Graphic of the proposed signage as it relates to what the Ch. 31, MGO would permit



Madison Regional Office 161 Horizon Drive, Suite 101 Verona, WI 53593 608.848.5060

August 12, 2020

Ms. Janine Glaeser Director, Urban Design Commission 215 Martin Luther King Jr. Blvd. Madison, WI 53703

RE: Letter of Intent

UDC Initial-Final Approval Request Madison College – 1701 Wright St. – Pool & Fitness Renovation (JSD Project #: 20-9825)

Ms. Janine Glaeser:

On behalf of Madison College, the following is submitted together with plans and application for staff, Urban Design Commission's consideration of Initial-Final approval for this project.

Team Contacts:

Owner: Madison College Architect: Assemblage Architects

Attn: Fred Brechlin, AIA

Attn: Hamid Noughani
1701 Wright St.

Attn: Hamid Noughani
7427 Elmwood Ave.

Madison, WI 53704 Middleton, WI 53562

Survey & JSD Professional Services, Inc. **Landscape** JSD Professional Services, Inc.

Engineer: Attn: Justin Frahm Design: Attn: Justin Frahm

7402 Stone Ridge Dr. Suite 4
7402 Stone Ridge Dr. Suite 4

Weston, WI 54476 Weston, WI 54476

Project Overview:

The project consists of renovating the indoor pool building at Madison College Truax Campus to a fitness center. Renovations include replacing the roof structure, and other structural modifications to accommodate the new use, as well as providing a photovoltaic platform to expand the buildings current PV system.

The building exterior will be modified to reflect the College's on-going program to update the building's envelope, introducing better insulation, solar control, materials consistent with previous improvements and approvals at the main campus building, and improved fenestration.

This project also improves the Gym exterior envelope, linking the gateway renovation with the fitness renovation. There will also be a new vestibule addition (approximately 360 SF), which is the only addition of SF to the building.



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Exterior (site) improvements include limited demolition of adjacent sidewalks with existing connections to be maintained and restored in proposed plans. A limited amount of landscape will be removed per the demolition plan and will be replaced in kind (points) within proposed plans. All existing building and sidewalk connections will be preserved and maintained.

Project Schedule

The project / building renovation is scheduled to begin in fall of 2020.


Thank you for considering this proposal. Please do not hesitate to reach out if you have questions.

Respectfully submitted,

Justin Frahm, ASLA Project Consultant

Cell: 608-220-7583

Email: justin.frahm@jsdinc.com

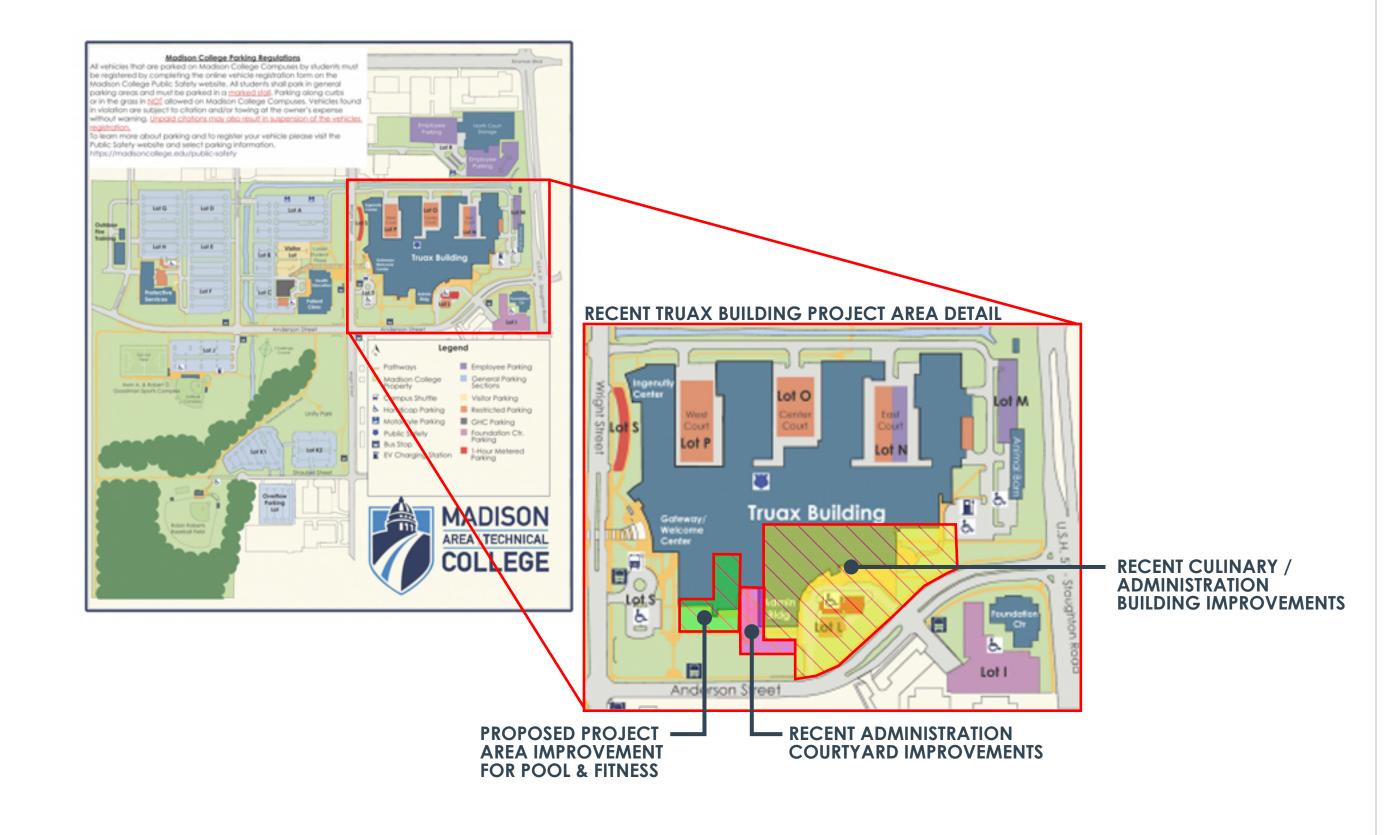







POOL AND FITNESS EXTERIOR BUILDING AREA



POOL AND FITNESS PROJECT AREA



RECENT ADJACENT ADMIN COURTYARD BUILDING AND SITE IMPROVEMENTS



RECENT ADMINSTRATION BUILDING EXTERIOR IMPROVEMENTS



EXISTING SITE PHOTGRAPHS


MADISON, WI

DATE 08.12.2020



Professional Services, Inc.

• Engineers • Surveyors • Planners

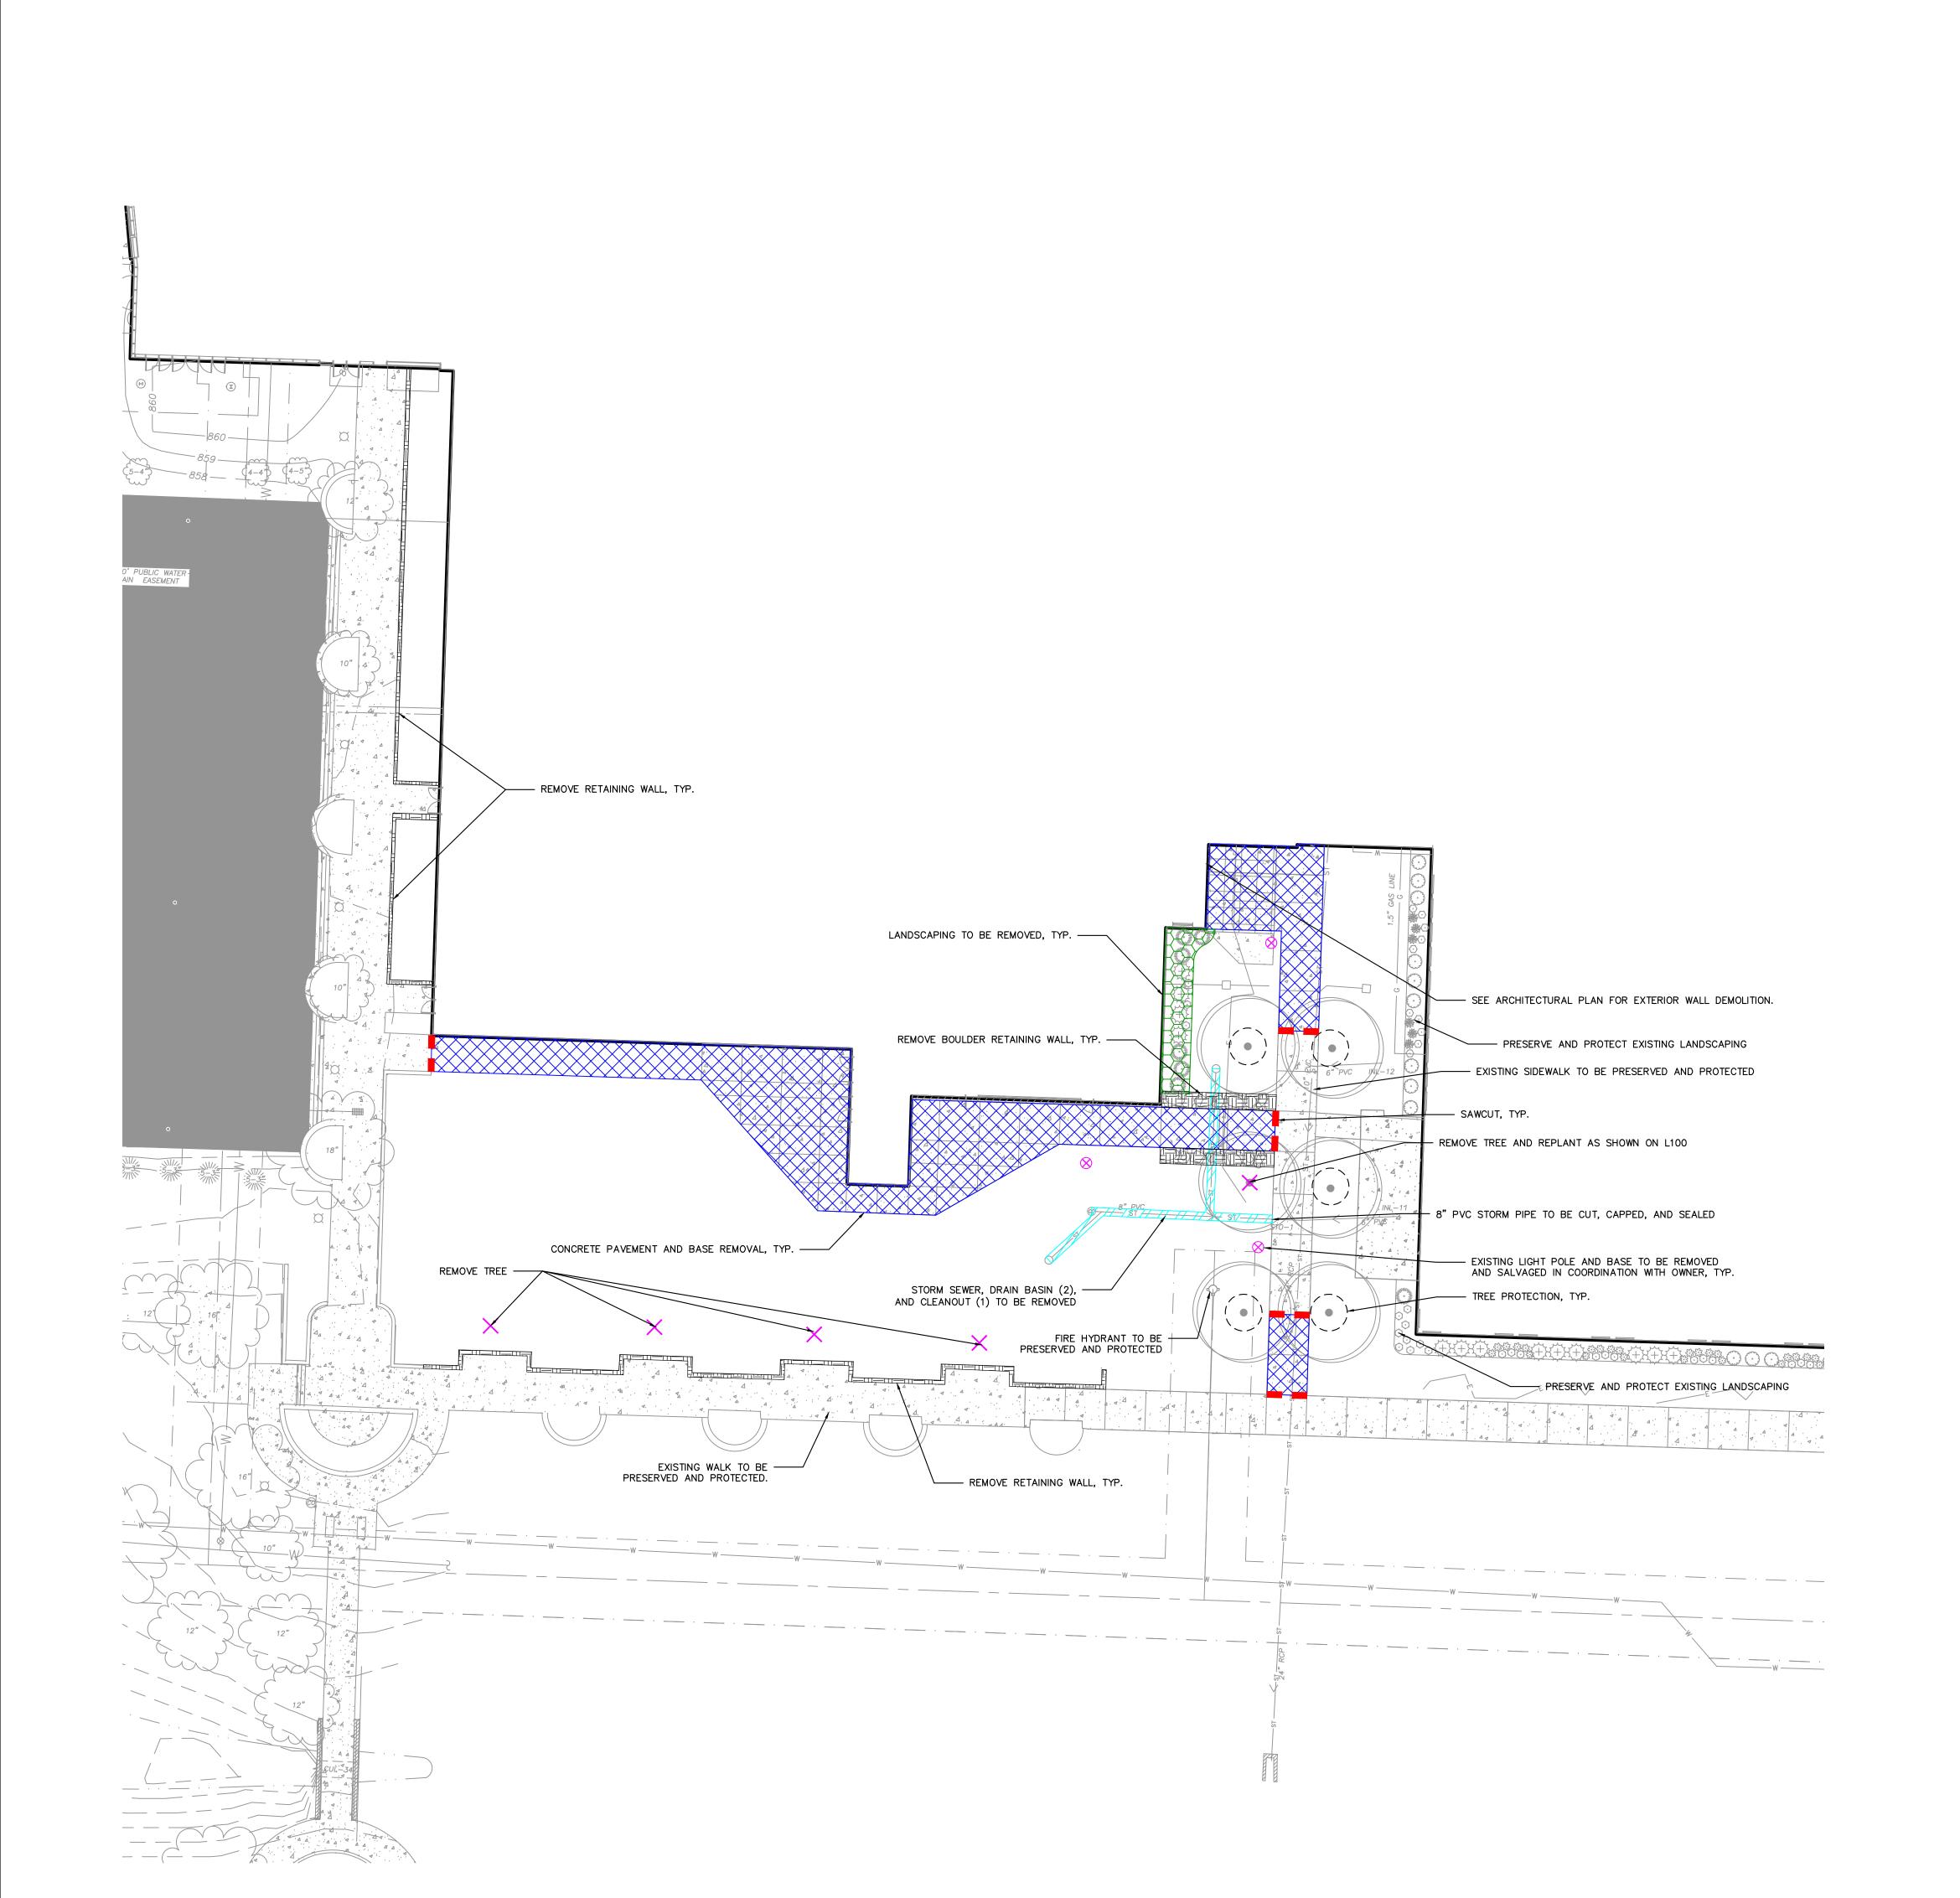

GENERAL NOTES

- 1. REFER TO THE EXISTING CONDITIONS SURVEY FOR EXISTING CONDITIONS NOTES AND LEGENDS.
- 2. ALL WORK IN THE ROW AND/OR PUBLIC EASEMENTS SHALL BE IN ACCORDANCE WITH THE STANDARD SPECIFICATIONS FOR SEWER & WATER CONSTRUCTION IN WISCONSIN AND MUNICIPAL REQUIREMENTS.
- 3. EXISTING GRADE SPOT ELEVATIONS SHOWN FOR INFORMATIONAL PURPOSES. DURING CONSTRUCTION MATCH EXISTING GRADES AT CONSTRUCTION LIMITS.
- 4. NO SITE GRADING OUTSIDE OR DOWNSLOPE OF PROPOSED SILT FENCE LOCATION. NO LAND DISTURBANCE BEYOND PROPERTY LINES.
- 5. JSD SHALL BE HELD HARMLESS AND DOES NOT WARRANT ANY DEVIATIONS BY THE OWNER/CONTRACTOR FROM THE APPROVED CONSTRUCTION PLANS THAT MAY RESULT IN DISCIPLINARY ACTIONS BY ANY OR ALL REGULATORY AGENCIES.

DEMOLITION NOTES

- 1. THIS PLAN INDICATES ITEMS ON THE PROPERTY INTENDED FOR DEMOLITION BASED ON THE CURRENT SITE DESIGN THAT HAVE BEEN IDENTIFIED BY A REASONABLE OBSERVATION OF THE EXISTING CONDITIONS THROUGH FIELD SURVEY RECONNAISSANCE, "DIGGER'S HOTLINE" LOCATION, AND GENERAL "STANDARD OF CARE". THERE MAY BE ADDITIONAL ITEMS THAT CAN NOT BE IDENTIFIED BY A REASONABLE ABOVE GROUND OBSERVATION, OF WHICH THE ENGINEER WOULD HAVE NO KNOWLEDGE OR MAY BE A PART OF ANOTHER DESIGN DISCIPLINE. IT IS THE CONTRACTOR'S /BIDDER'S RESPONSIBILITY TO REVIEW THE PLANS, INSPECT THE SITE AND PROVIDE THEIR OWN DUE DILIGENCE TO INCLUDE IN THEIR BID WHAT ADDITIONAL ITEMS, IN THEIR OPINION, MAY BE NECESSARY FOR DEMOLITION. ANY ADDITIONAL ITEMS IDENTIFIED BY THE CONTRACTOR/BIDDER SHALL BE IDENTIFIED IN THE BID AND REPORTED TO THE ENGINEER OF RECORD. JSD TAKES NO RESPONSIBILITY FOR ITEMS ON THE PROPERTY THAT COULD NOT BE LOCATED BY A REASONABLE OBSERVATION OF THE PROPERTY OR OF WHICH THEY WOULD HAVE NO
- 2. CONTRACTOR SHALL KEEP ALL STREETS AND PRIVATE DRIVES FREE AND CLEAR OF ALL CONSTRUCTION RELATED DIRT, DUST AND DEBRIS.
- 3. ALL TREES WITHIN THE CONSTRUCTION LIMITS SHALL BE REMOVED UNLESS SPECIFICALLY CALLED OUT FOR PROTECTION. ALL TREES TO BE REMOVED SHALL BE REMOVED IN THEIR ENTIRETY AND
- STUMPS SHALL BE GROUND TO PROPOSED SUBGRADE. 4. ALL LIGHT POLES TO BE REMOVED SHALL BE REMOVED IN THEIR ENTIRETY, INCLUDING BASE AND ALL APPURTENANCES. SALVAGE FOR RELOCATION. COORDINATE RELOCATION AND/OR ABANDONMENT
- OF ALL ELECTRIC LINES WITH ELECTRICAL ENGINEER AND OWNER PRIOR TO DEMOLITION. 5. ABANDONED/REMOVED ITEMS SHALL BE DISPOSED OF OFF SITE UNLESS OTHERWISE NOTED.
- 6. CONTRACTOR TO REPLACE ALL SIDEWALK AND CURB AND GUTTER ABUTTING THE PROPERTIES, WHICH IS DAMAGED BY THE CONSTRUCTION, OR ANY SIDEWALK AND CURB AND GUTTER THAT THE CITY ENGINEER DETERMINES NEEDS TO BE REPLACED BECAUSE IT IS NOT AT A DESIRABLE GRADE REGARDLESS OF WHETHER THE CONDITION EXISTED PRIOR TO BEGINNING CONSTRUCTION.
- 7. PRIOR TO CONSTRUCTION, THE CONTRACTOR IS RESPONSIBLE FOR:
 7.1. EXAMINE ALL SITE CONDITIONS RELATIVE TO THE CONDITIONS INDICATED ON THE ENGINEERING DRAWINGS. ANY DISCREPANCIES ARE TO BE REPORTED IMMEDIATELY TO THE ENGINEER AND RESOLVED PRIOR TO THE START OF CONSTRUCTION.
- 7.2. VERIFYING UTILITY ELEVATIONS AND NOTIFYING ENGINEER OF ANY DISCREPANCIES. NO WORK
- SHALL BE PERFORMED UNTIL THE DISCREPANCIES ARE RESOLVED.
- 7.3. NOTIFYING ALL UTILITIES PRIOR TO THE REMOVAL OF ANY UNDERGROUND UTILITIES. 7.4. NOTIFYING THE DESIGN ENGINEER AND LOCAL CONTROLLING MUNICIPALITY 48 HOURS PRIOR TO
- 8. ANY SANITARY SEWER, SANITARY SEWER SERVICES, WATER MAIN, WATER SERVICES, STORM SEWER, OR OTHER UTILITIES, WHICH ARE DAMAGED BY THE CONTRACTORS, SHALL BE REPAIRED TO THE OWNER'S SATISFACTION AT THE CONTRACTOR'S EXPENSE.
- 9. CONTRACTOR IS RESPONSIBLE FOR SITE SAFETY DURING THE CONSTRUCTION OF THESE IMPROVEMENTS.
- 10. CONTRACTOR TO COORDINATE PRIVATE UTILITY REMOVAL / ABANDONMENT AND NECESSARY RELOCATION WITH RESPECTIVE UTILITY COMPANY. COORDINATION REQUIRED PRIOR TO CONSTRUCTION.

THE START OF CONSTRUCTION TO ARRANGE FOR APPROPRIATE CONSTRUCTION INSPECTION.

- 11. ALL DEMOLITION SHALL BE IN ACCORDANCE WITH THE APPROVED MUNICIPALITY RECYCLING PLAN.
- 12. ANY CONTAMINATED SOILS SHALL BE REMOVED IN ACCORDANCE WITH FEDERAL AND STATE REGULATIONS TO AN APPROVED LANDFILL.
- 13. ALL EXISTING UTILITIES TO BE FIELD LOCATED AND FLAGGED BY CONTRACTOR.
- 14. EXISTING FIBER OPTIC LINE TO BE CLEARLY MARKED PRIOR TO ANY EXCAVATION. CONTRACTOR TO NOTIFY ENGINEER IMMEDIATELY IF ANY DISCREPANCIES OCCUR IN THE LOCATION SHOWN OR PROPOSED IMPROVEMENTS IMPACTING EXISTING FIBER OPTIC LINE LOCATION.
- 15. SEWER ABANDONMENT SHALL BE IN ACCORDANCE WITH SECTION 3.2.24, OF THE STANDARD SPECIFICATIONS FOR WATER AND SEWER CONSTRUCTION IN WISCONSIN, LATEST ADDITION, AND CITY OF MADISON SPECIFICATIONS.
- 16. WATER ABANDONMENT SHALL BE IN ACCORDANCE WITH SECTION 4.14.0 OF THE STANDARD SPECIFICATIONS FOR WATER AND SEWER CONSTRUCTION IN WISCONSIN, LATEST ADDITION, AND CITY OF MADISON SPECIFICATIONS.
- 17. ALL PERIMETER EROSION CONTROL DEVICES SHALL BE INSTALLED PRIOR TO THE START OF DEMOLITION ACTIVITIES. CONTRACTOR SHALL KEEP ALL STREETS AND PAVEMENT FREE AND CLEAR OF ALL CONSTRUCTION RELATED DIRT, DUST AND DEBRIS.
- 18. BUILDING REMOVALS SHALL BE BY A QUALIFIED CONTRACTOR. CONTRACTOR TO FOLLOW ALL DEMOLITION REGULATIONS, DISCONNECT ALL UTILITIES, OBTAIN ALL APPLICABLE PERMITS AND DISPOSE OF ALL BUILDING MATERIALS IN APPROPRIATE LANDFILLS. DEMOLISHED MATERIALS SHALL NOT BE BURIED ON SITE. IF ENCOUNTERED, ANY CONTAMINATED SOILS SHALL BE REMOVED TO A LANDFILL IN ACCORDANCE WITH APPROPRIATE STATE AND FEDERAL REGULATIONS.
- 19. CONTRACTOR TO REMOVE EXISTING UTILITY PIPE OR PROVIDE PIPE BACK-FILLING AFTER REMOVAL OF EXISTING UTILITIES WITHIN BUILDING FOOTPRINT USING "LOW DENSITY CONCRETE/FLOWABLE FILL".
- 20. RESTORATION OF THE EXISTING ROADWAY RIGHT—OF—WAYS ARE CONSIDERED INCIDENTAL AND SHOULD BE PART OF THE COST OF THE UNDERGROUND IMPROVEMENTS, DEMOLITION AND REMOVAL. THIS INCLUDES CURB & GUTTER, SIDEWALK, TOPSOIL, SEEDING AND MULCHING.



— · — · — · — · — EASEMENT LINE

DEMOLITION - SAWCUT DEMOLITION - REMOVAL OF UTILITIES


DEMOLITION - REMOVAL OF RETAINING WALL

DEMOLITION - REMOVAL OF LANDSCAPE BEDDING

DEMOLITION - REMOVAL OF CONCRETE SURFACES



TREE REMOVAL LIGHT POLE AND BASE REMOVAL AND SALVAGE FOR REUSE PROTECT EXISTING TREE

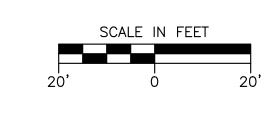









MADISON █ MILWAUKEE █ WAUSAU APPLETON █ KENOSHA █ CHICAGO COEUR D'ALENE

MADISON REGIONAL OFFICE
161 HORIZON DRIVE, SUITE 101 VERONA, WISCONSIN 53593 P. 608.848.5060

MADISON



MADISON COLLEGE TRUAX BUILDING FITNESS RENOVATION

Madison, Wisconsin

|Issued for: UDC INITIAL-FINAL 08-12-2020 Issue date: AA Project No.: RFB20-XYZ MC Project No.:

DATE REVISION

assemblage ARCHITECTS 7433 Elmwood Avenue Middleton, WI 53562 T 608.827.5047

FITNESS RENOVATION


SCALE

AS NOTED SHEET TITLE

DEMOLITION PLAN

SHEET NUMBER

C100

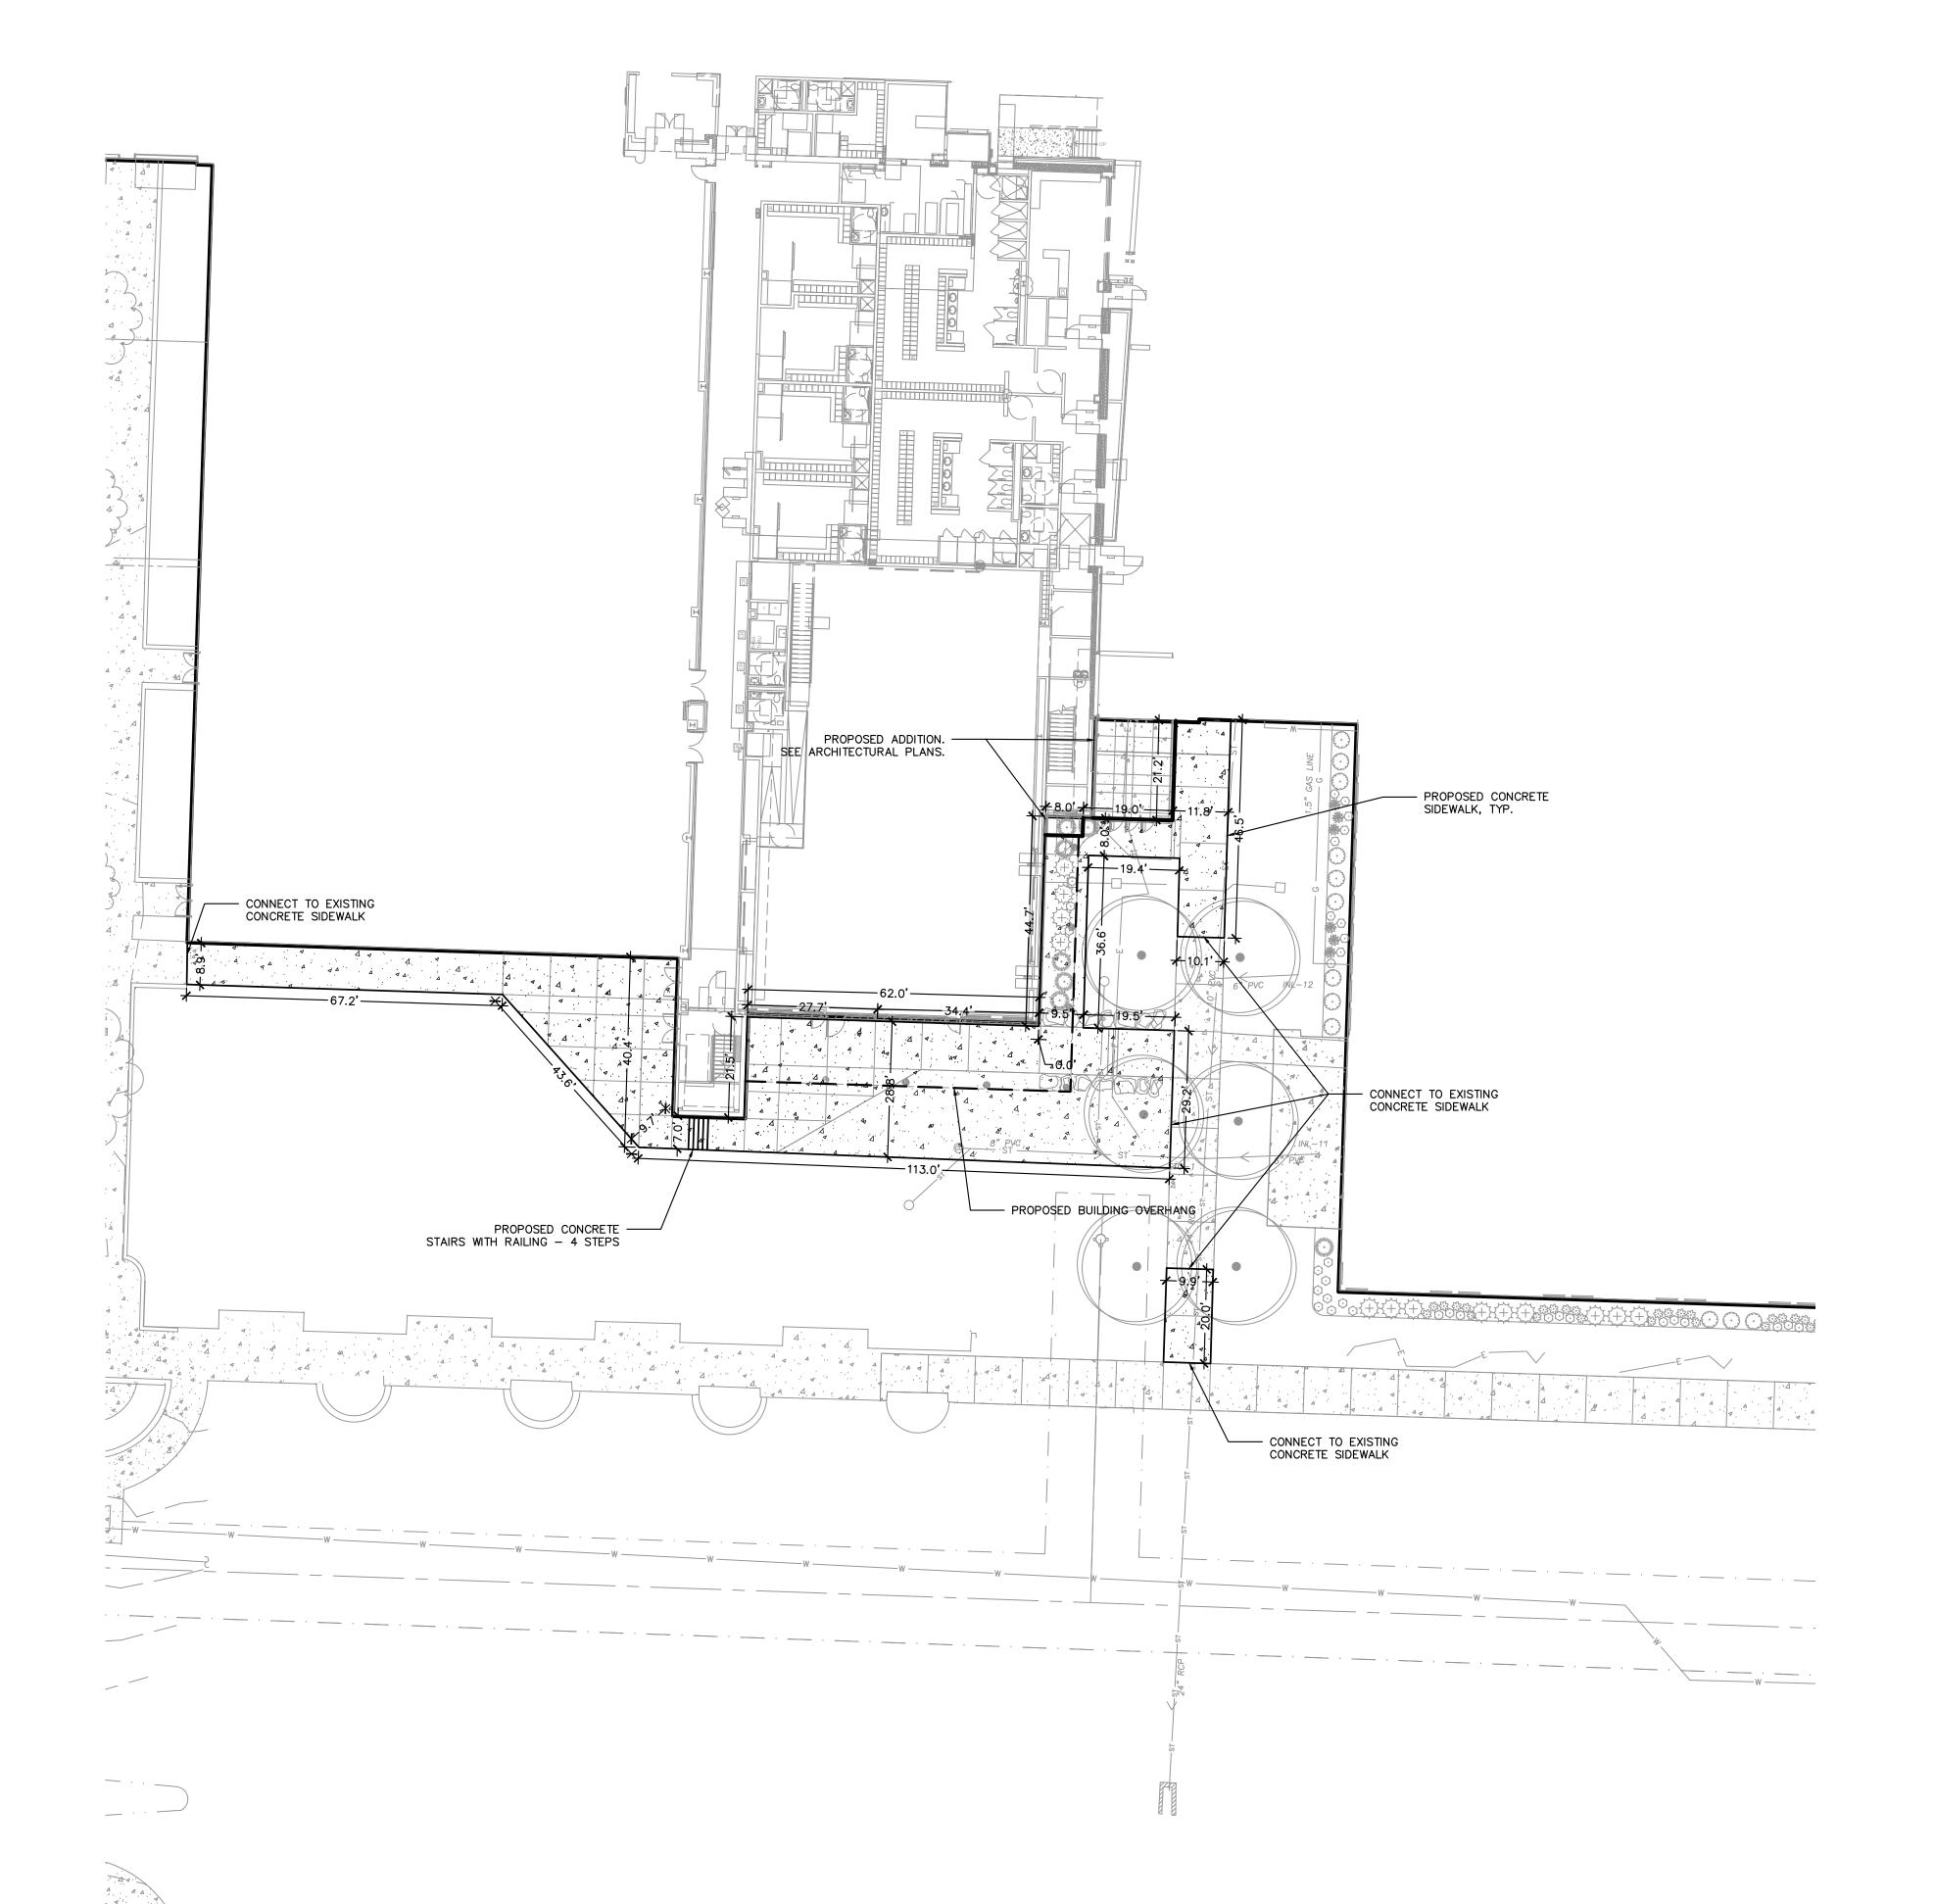

GENERAL NOTES

- 1. REFER TO THE EXISTING CONDITIONS SURVEY FOR EXISTING CONDITIONS NOTES AND LEGENDS.
- 2. ALL WORK IN THE ROW AND/OR PUBLIC EASEMENTS SHALL BE IN ACCORDANCE WITH THE STANDARD SPECIFICATIONS FOR SEWER & WATER CONSTRUCTION IN WISCONSIN AND MUNICIPAL REQUIREMENTS.
- 3. EXISTING GRADE SPOT ELEVATIONS SHOWN FOR INFORMATIONAL PURPOSES. DURING CONSTRUCTION MATCH EXISTING GRADES AT CONSTRUCTION LIMITS.
- 4. NO SITE GRADING OUTSIDE OR DOWNSLOPE OF PROPOSED SILT FENCE LOCATION. NO LAND DISTURBANCE BEYOND PROPERTY LINES.
- 5. JSD SHALL BE HELD HARMLESS AND DOES NOT WARRANT ANY DEVIATIONS BY THE OWNER/CONTRACTOR FROM THE APPROVED CONSTRUCTION PLANS THAT MAY RESULT IN DISCIPLINARY ACTIONS BY ANY OR ALL REGULATORY AGENCIES.

PAVING NOTES

- GENERAL
- 1.1. ALL PAVING SHALL CONFORM TO "STATE OF WISCONSIN STANDARD SPECIFICATIONS FOR HIGHWAY & STRUCTURE CONSTRUCTION, LATEST EDITION AND APPLICABLE CITY OF MADISON ORDINANCES.
- 1.2. ALL PAVING DIMENSIONS ARE TO FACE OF CURB UNLESS SPECIFIED OTHERWISE.
- 1.3. SURFACE PREPARATION NOTIFY ENGINEER/OWNER OF UNSATISFACTORY CONDITIONS. DO NOT BEGIN PAVING WORK UNTIL DEFICIENT SUBBASE AREAS HAVE BEEN CORRECTED AND ARE READY
- 1.4. ANY REQUIRED REPLACEMENT OF PUBLIC CURB AND GUTTER SHALL MATCH EXISTING AND MEET MUNICIPALITY REQUIREMENTS.
- 2. CONCRETE PAVING SPECIFICATIONS 2.1. CONCRETE PAVING SHALL BE IN ACCORDANCE WITH THE REQUIREMENTS OF SECTIONS 415 AND 416 OF THE STATE HIGHWAY SPECIFICATIONS.
- 2.2. CONCRETE PAVEMENT SHALL BE REINFORCED WITH NOVOMESH 950 (OR EQUAL) FIBER REINFORCEMENT AT A RATE OF 5 LBS/CUBIC YARD.
- 2.3. CURING COMPOUNDS SHALL CONFORM TO SECTION 415 OF THE STATE HIGHWAY SPECIFICATIONS. 2.4. CONTRACTOR SHALL PROVIDE CONTROL JOINTS AND CONSTRUCTION JOINTS OF ONE-QUARTER
- MAXIMUM LENGTH BETWEEN JOINTS OF 8' ON CENTER. 2.5. CONTRACTOR SHALL PROVIDE EXPANSION JOINTS IN SIDEWALKS AT A MAXIMUM 24' ON CENTER.

CONCRETE THICKNESS AT AN EQUAL RATIO OF LENGTH TO WIDTH WHEREVER POSSIBLE WITH A

- 2.6. EXTERIOR CONCRETE SURFACES SHALL BE BROOM FINISHED. 2.7. ALL CONCRETE SURFACES TO BE SEALED WITH TYPE TK-26UV CONCRETE SEALANT.
- 3. PAVEMENT MARKING SPECIFICATIONS
- 3.1. 2' x 4' TRUNCATED DOME WARNING DETECTION FIELD SHALL BE PLACED AT ALL ADA RAMPS.

SITE ADDRESS	1701 WRIGHT STRE	EE.
BUILDING ADDITION SQUARE FOOTAGE	400	SI
PROPOSED NEW IMPERVIOUS SITE COVERAGE		
BUILDING ADDITION REPLACING PERVIOUS	40	SI
NEW SIDEWALK REPLACING PERVIOUS	1,845	SI
TOTAL NEW IMPERVIOUS ADDITION	1,885	SI
TOTAL SITE DISTURBANCE	18,500	SI

LEGEND

	RIGHT-OF-WAY
	EASEMENT LINE
	BUILDING OUTLINE
	BUILDING OVERHANG
	BUILDING SETBACK LINE
	PAVEMENT SETBACK LINE
	EDGE OF PAVEMENT
	STANDARD CURB AND GU
	REJECT CURB AND GUTTI
\\\\\\\\\\\\\\\\\\\\\\\\\\\\\\\\\\\\\	MOUNTABLE CURB AND C
	8" CONCRETE RIBBON CL
	ASPHALT PAVEMENT
	HEAVY DUTY ASPHALT P
4 A A A	CONCRETE PAVEMENT

PROPERTY LINE

TBACK LINE /EMENT JRB AND GUTTER AND GUTTER CURB AND GUTTER

ASPHALT PAVEMENT HEAVY DUTY CONCRETE PAVEMENT STORMWATER MANAGEMENT AREA

LIGHT POLE (REFER TO PHOTOMETRIC PLAN) ADA PARKING SIGN

FLAG POLE

SAWCUT EXISTING PAVEMENT

BOLLARD WITH ADA PARKING SIGN BIKE RACK











MADISON █ MILWAUKEE █ WAUSAU APPLETON █ KENOSHA █ CHICAGO COEUR D'ALENE

MADISON REGIONAL OFFICE
161 HORIZON DRIVE, SUITE 101 VERONA, WISCONSIN 53593
P. 608.848.5060

MADISON



MADISON COLLEGE TRUAX BUILDING

Bid Pkg No.:

Madison, Wisconsin

FITNESS RENOVATION

Issued for: UDC INITIAL-FINAL 08-12-2020 Issue date: AA Project No.: RFB20-XYZ MC Project No.:

REVISION DATE

FITNESS RENOVATION assemblage ARCHITECTS 7433 Elmwood Avenue Middleton, WI 53562

T 608.827.5047


SCALE

AS NOTED SHEET TITLE

SITE PLAN

SHEET NUMBER

C200

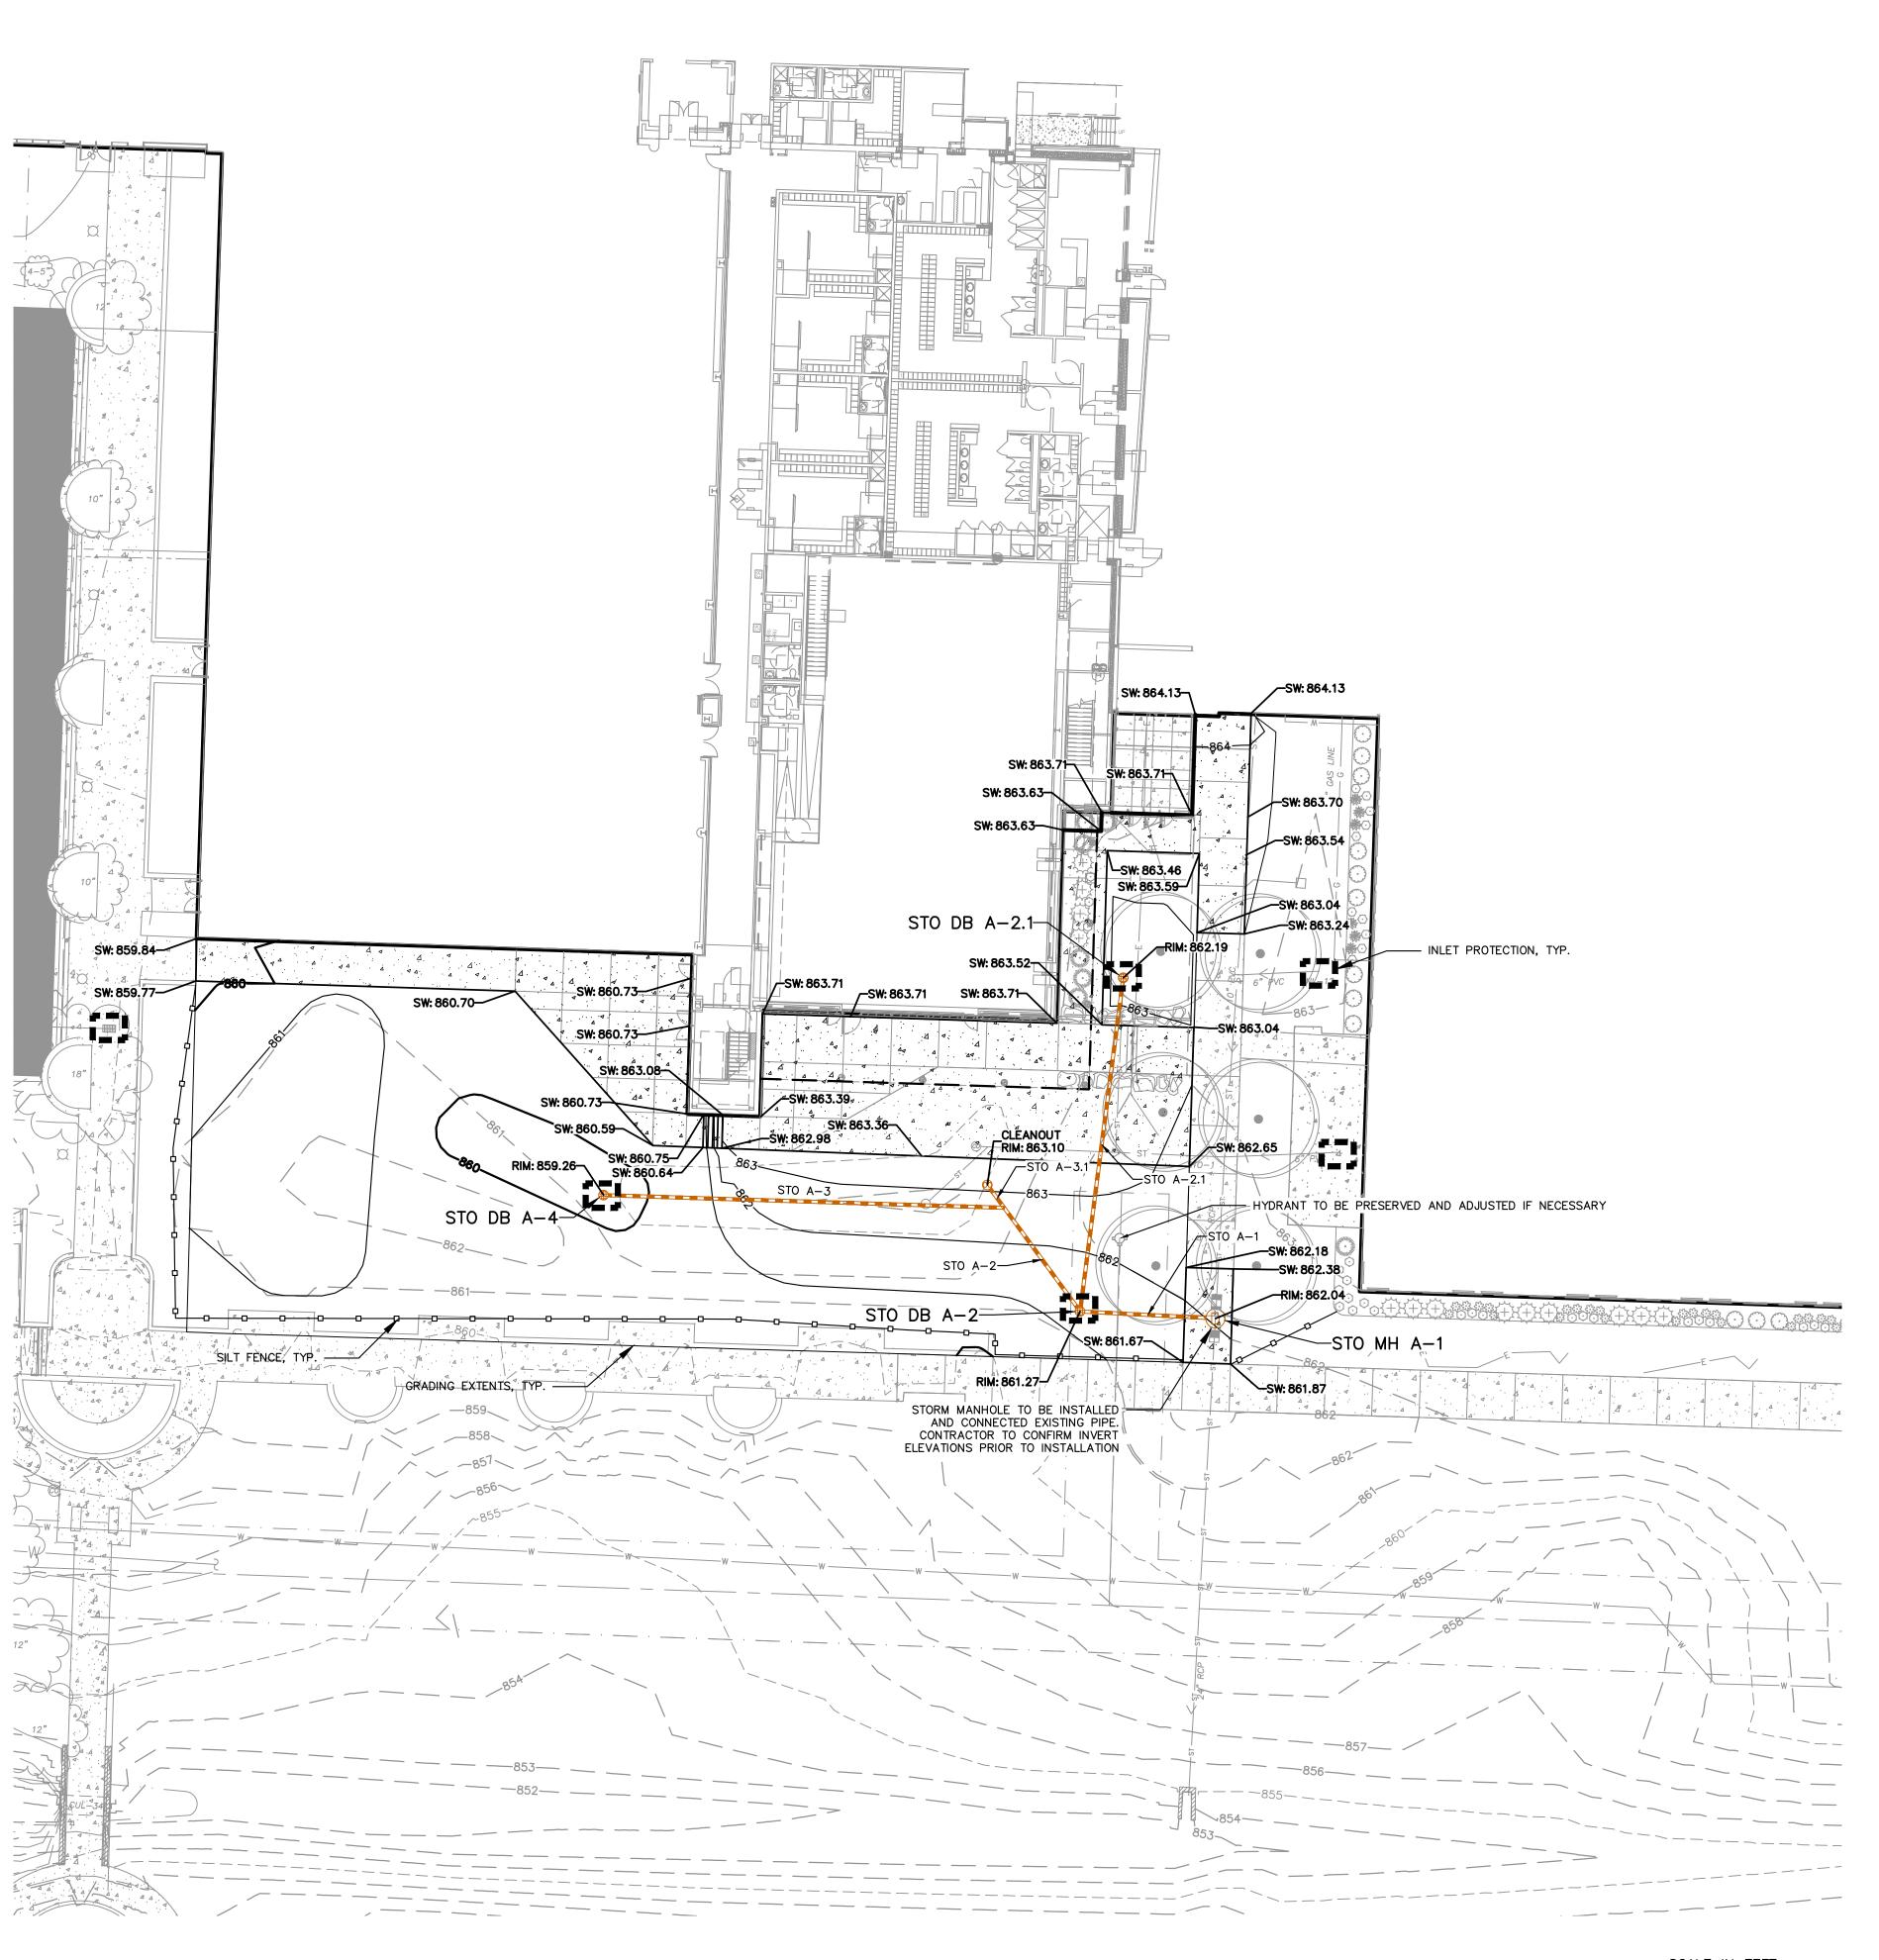

		PROPOSED STRU	JCTURES T	ABLE	
LABEL	RIM EL. (FT)	INVERT EL. (FT)	DEPTH (FT)	STRUCTURE DESC.	FRAME & GRATE
STO DB A-2	861.27	NW INV: 856.39 (8") N INV: 856.39 (8") E INV: 856.29 (8")	5.0	24 IN DB	SEE DETAIL
STO DB A-2.1	862.19	S INV: 857.81 (8")	4.4	24 IN DB	SEE DETAIL
STO DB A-4	859.26	E INV: 857.50 (8")	1.8	24 IN DB	SEE DETAIL
STO MH A-1	857.57	W INV: 855.72 (8") N INV: 853.71 (24") S INV: 853.71 (24")	3.9	48 IN MH (FLAT)	R-1550 SOLID LID

			PROPO	SED PIPES TA	BLE		
LABEL	ТО	FROM	LENGTH	INVERT EL. (FT)	DISCHARGE EL. (FT)	SLOPE	SIZE & MATERIAL
STO A-1	STO MH A-1	STO DB A-2	29'	855.72	856.29	2.00%	8 IN PVC
STO A-2	STO DB A-2	STO-4	27'	856.39	856.66	1.00%	8 IN PVC
STO A-2.1	STO DB A-2	STO DB A-2.1	71'	856.39	857.81	2.00%	8 IN PVC
STO A-3	STO-4	STO DB A-4	84'	856.66	857.50	1.00%	8 IN PVC
STO A-3.1	STO-4	CLEANOUT	5'	856.66	856.71	1.00%	8 IN PVC

EROSION CONTROL NOTES

- 1. CONTRACTOR IS RESPONSIBLE TO NOTIFY ENGINEER OF RECORD AND OFFICIALS OF ANY CHANGES TO THE EROSION CONTROL AND STORMWATER MANAGEMENT PLANS, ENGINEER OF RECORD AND APPROPRIATE CITY OF MADISON OFFICIALS MUST APPROVE ANY CHANGES PRIOR TO DEVIATION FROM
- 2. ALL EROSION CONTROL MEASURES SHALL BE CONSTRUCTED AND MAINTAINED BY THE CONTRACTOR IN ACCORDANCE WITH THE WISCONSIN DEPARTMENT OF NATURAL RESOURCES (WDNR) TECHNICAL STANDARDS (REFERRED TO AS BMP'S) AND CITY OF MADISON ORDINANCE. IT IS THE CONTRACTOR'S RESPONSIBILITY TO OBTAIN A COPY OF THESE STANDARDS. CONTRACTOR SHALL BE RESPONSIBLE FOR ANY ADDITIONAL EROSION CONTROL MEASURES WHICH MAY BE NECESSARY TO MEET UNFORESEEN FIELD CONDITIONS.
- 5. INSTALL PERIMETER EROSION CONTROL MEASURES (SUCH AS CONSTRUCTION ENTRANCES, SILT FENCE AND EXISTING INLET PROTECTION) PRIOR TO ANY SITE WORK, INCLUDING GRADING OR DISTURBANCE OF EXISTING SURFACE COVER. AS SHOWN ON PLAN. MODIFICATIONS TO THE APPROVED EROSION CONTROL DESIGN IN ORDER TO MEET UNFORESEEN FIELD CONDITIONS IS ALLOWED IF MODIFICATIONS CONFORM TO BMP'S. ALL DESIGN MODIFICATIONS MUST BE APPROVED BY THE CITY OF MADISON PRIOR TO DEVIATION OF THE APPROVED PLAN.
- 4. ADDITIONAL EROSION CONTROL MEASURES, AS REQUESTED BY STATE INSPECTORS, LOCAL INSPECTORS, COUNTY INSPECTORS AND/OR ENGINEER OF RECORD SHALL BE INSTALLED WITHIN 24 HOURS OF
- 5. INSPECTIONS AND MAINTENANCE OF ALL EROSION CONTROL MEASURES SHALL BE ROUTINE (ONCE PER WEEK MINIMUM) TO ENSURE PROPER FUNCTION OF EROSION CONTROLS AT ALL TIMES. EROSION CONTROL MEASURES ARE TO BE IN WORKING ORDER AT THE END OF EACH WORK DAY.
- 6. ALL EROSION AND SEDIMENT CONTROL ITEMS SHALL BE INSPECTED WITHIN 24 HOURS OF ALL RAIN EVENTS EXCEEDING 0.5 INCHES. ANY DAMAGED EROSION CONTROL MEASURES SHALL BE REPAIRED OR REPLACED IMMEDIATELY UPON INSPECTION.
- 7. CONSTRUCTION ENTRANCES SHALL BE INSTALLED AT ALL LOCATIONS OF VEHICLE INGRESS/EGRESS POINTS. ADDITIONAL LOCATIONS OTHER THAN AS SHOWN ON THE PLANS MUST BE PRIOR APPROVED BY THE MUNICIPALITY. CONSTRUCTION ENTRANCES SHALL BE 50' LONG AND NO LESS THAN 12" THICK BY USE OF 3" CLEAR STONE. CONSTRUCTION ENTRANCES SHALL BE MAINTAINED BY THE CONTRACTOR IN A CONDITION WHICH WILL PREVENT THE TRACKING OF MUD OR DRY SEDIMENT ONTO ADJACENT PUBLIC STREETS AFTER EACH WORKING DAY OR MORE FREQUENTLY AS REQUIRED.
- 8. PAVED SURFACES ADJACENT TO CONSTRUCTION SITE VEHICLE ACCESS SHALL BE SWEPT AND/OR SCRAPED TO REMOVE ACCUMULATED SOIL, DIRT AND/OR DUST AFTER THE END OF EACH WORK DAY AND AS REQUESTED BY THE CITY OF MADISON.
- 9. INLET PROTECTION SHALL BE IMMEDIATELY FITTED AT THE INLET OF ALL INSTALLED STORM SEWER AND SILT FENCE SHALL BE IMMEDIATELY FITTED AT ALL INSTALLED CULVERT INLETS TO PREVENT SEDIMENT DEPOSITION WITHIN STORM SEWER SYSTEMS.
- 10. INSTALL EROSION CONTROLS ON THE DOWNSTREAM SIDE OF STOCKPILES. IF STOCKPILE REMAINS UNDISTURBED FOR MORE THAN SEVEN (7) DAYS, TEMPORARY SEEDING AND STABILIZATION IN ACCORDANCE WITH BEST MANAGEMENT PRACTICES IS REQUIRED. IF DISTURBANCE OCCURS BETWEEN NOVEMBER 15TH AND MAY 15TH, THE MULCHING SHALL BE PERFORMED BY HYDRO-MULCHING WITH A
- 11. DITCH CHECKS AND APPLICABLE EROSION NETTING/MATTING SHALL BE INSTALLED IMMEDIATELY AFTER COMPLETION OF GRADING EFFORTS WITHIN DITCHES/SWALES TO PREVENT SOIL TRANSPORTATION. 12. EROSION CONTROL FOR UTILITY CONSTRUCTION (STORM SEWER, SANITARY SEWER, WATER MAIN, ETC.): A. PLACE EXCAVATED TRENCH MATERIAL ON THE HIGH SIDE OF THE TRENCH. B. BACKFILL, COMPACT, AND STABILIZE THE TRENCH IMMEDIATELY AFTER PIPE CONSTRUCTION.

. DISCHARGE TRENCH WATER INTO A SEDIMENTATION BASIN OR FILTERING TANK IN ACCORDANCE WITH THE DEWATERING TECHNICAL STANDARD NO. 1061 PRIOR TO RELEASE INTO THE STORM

- SEWER, RECEIVING STREAM, OR DRAINAGE DITCH. 13. ALL SLOPES 4:1 OR GREATER SHALL BE STABILIZED WITH CLASS I, TYPE B EROSION MATTING OR APPLICATION OF A WISCONSIN DEPARTMENT OF TRANSPORTATION (WisDOT) APPROVED POLYMER SOIL STABILIZATION TREATMENT OR A COMBINATION THEREOF, AS REQUIRED WITHIN 7 DAYS OF REACHING FINAL GRADE AND/OR AS SOON AS CONDITIONS ALLOW. DRAINAGE SWALES SHALL BE STABILIZED WITH CLASS II. TYPE B EROSION MATTING. EROSION MATTING AND/OR NETTING USED ONSITE SHALL BE INSTALLED IN ACCORDANCE WITH MANUFACTURER'S GUIDELINES AND WDNR TECHNICAL STANDARDS
- 14. CONTRACTOR SHALL TAKE ALL NECESSARY STEPS TO CONTROL DUST ARISING FROM CONSTRUCTION OPERATIONS. REFER TO WDNR TECHNICAL STANDARD 1068.
- 15. EROSION CONTROL MEASURES SHALL NOT BE REMOVED UNTIL ALL LAND DISTURBING CONSTRUCTION ACTIVITY AT THE SITE HAS BEEN COMPLETED AND THAT A UNIFORM PERENNIAL VEGETATIVE COVER HAS BEEN ESTABLISHED WITH A DENSITY OF AT LEAST 70% FOR UNPAVED AREAS AND AREAS NOT COVERED BY PERMANENT STRUCTURES OR THAT EMPLOY EQUIVALENT PERMANENT STABILIZATION
- 16. CONTRACTOR/OWNER SHALL FILE A NOTICE OF TERMINATION UPON COMPLETION OF THE PROJECT IN ACCORDANCE WITH WDNR REQUIREMENTS AND/OR PROPERTY SALE IN ACCORDANCE WITH WDNR

17. STABILIZATION PRACTICES:

- *STABILIZATION MEASURES SHALL BE INITIATED AS SOON AS PRACTICABLE IN PORTIONS OF THE SITE WHERE CONSTRUCTION ACTIVITIES HAVE TEMPORARILY OR PERMANENTLY CEASED. NO MORE THAN SEVEN (7) DAYS SHALL PASS AFTER THE CONSTRUCTION ACTIVITY IN THAT PORTION OF THE SITE HAS CEASED UNLESS:
- *THE INITIATION STABILIZATION MEASURES BY THE SEVENTH (7) DAY AFTER CONSTRUCTION ACTIVITY HAS CEASED IS PRECLUDED BY SNOW COVER. IN THAT EVENT, STABILIZATION SHALL BE INITIATED AS SOON AS PRACTICABLE. *CONSTRUCTION ACTIVITY WILL RESUME ON A PORTION OF THE SITE WITHIN FOURTEEN (14)
- DAYS FROM WHEN ACTIVITY CEASED, (I.E. THE TOTAL TIME PERIOD THAT THE CONSTRUCTION ACTIVITY IS TEMPORARILY CEASED IS LESS THAN FOURTEEN (14) DAYS. IN THAT EVENT, STABILIZATION MEASURES DO NOT HAVE TO BE INITIATED ON THAT PORTION OF THE SITE BY THE SEVENTH (7) DAY AFTER CONSTRUCTION ACTIVITY HAS TEMPORARILY CEASED. *STABILIZATION MEASURES SHALL BE DETERMINED BASED ON SITE CONDITIONS AT THE TIME
- OF CONSTRUCTION ACTIVITY HAS CEASED, INCLUDING BUT NOT LIMITED TO WEATHER CONDITIONS AND LENGTH OF TIME MEASURE MUST BE EFFECTIVE. THE FOLLOWING ARE ACCEPTABLE STABILIZATION MEASURES: * PERMANENT SEEDING; IN ACCORDANCE WITH APPROVED CONSTRUCTION SPECIFICATION * TEMPORARY SEEDING; MAY CONSIST OF SPRING OATS(100LBS/ACRE) AND/OR WHEAT OR CEREAL RYE (150LB/ACRE) * HYDRO-MULCHING WITH A TACKIFIER * GEOTEXTILE EROSION MATTING

CONSTRUCTION SEQUENCING

- 1. INSTALL PERIMETER SILT FENCE, INLET PROTECTION AND TEMPORARY CONSTRUCTION ENTRANCE.
- 2. STRIP AND STOCKPILE TOPSOIL, INSTALL SILT FENCE AROUND PERIMETER OF STOCKPILE. 3. CONDUCT ROUGH GRADING EFFORTS AND INSTALL CHECK DAMS WITHIN DRAINAGE DITCHES AS
- 4. INSTALL UTILITY PIPING AND STRUCTURES, IMMEDIATELY INSTALL INLET PROTECTION.
- COMPLETE FINAL GRADING, INSTALLATION OF GRAVEL BASE COURSES, PLACEMENT OF CURBS, PAVEMENTS, WALKS, ETC.
- 7. EROSION CONTROLS SHALL NOT BE REMOVED UNTIL SITE IS FULLY STABILIZED OR 70% VEGETATIVE
- COVER IS ESTABLISHED. CONTRACTOR MAY MODIFY SEQUENCING AFTER ITEM NO. 1 AS NEEDED TO COMPLETE CONSTRUCTION IF EROSION CONTROLS ARE MAINTAINED IN ACCORDANCE WITH THE CONSTRUCTION SITE EROSION CONTROL REQUIREMENTS.

6. PLACE TOPSOIL AND IMMEDIATELY STABILIZE DISTURBED AREAS WITH EROSION CONTROL MEASURES

GENERAL NOTES

- 1. REFER TO THE EXISTING CONDITIONS SURVEY FOR EXISTING CONDITIONS NOTES AND LEGENDS.
- 2. ALL WORK IN THE ROW AND/OR PUBLIC EASEMENTS SHALL BE IN ACCORDANCE WITH THE STANDARD SPECIFICATIONS FOR SEWER & WATER CONSTRUCTION IN WISCONSIN AND MUNICIPAL REQUIREMENTS.
- 3. EXISTING GRADE SPOT ELEVATIONS SHOWN FOR INFORMATIONAL PURPOSES. DURING CONSTRUCTION MATCH EXISTING GRADES AT CONSTRUCTION LIMITS.
- 4. NO SITE GRADING OUTSIDE OR DOWNSLOPE OF PROPOSED SILT FENCE LOCATION. NO LAND DISTURBANCE BEYOND PROPERTY LINES.
- 5. JSD SHALL BE HELD HARMLESS AND DOES NOT WARRANT ANY DEVIATIONS BY THE OWNER/CONTRACTOR FROM THE APPROVED CONSTRUCTION PLANS THAT MAY RESULT IN DISCIPLINARY ACTION'S BY ANY OR ALL REGULATORY AGENCIES.

GRADING AND SEEDING NOTES

- 1. ALL PROPOSED GRADES SHOWN ARE FINISHED GRADES. CONTRACTOR SHALL VERIFY ALL GRADES, MAKE SURE ALL AREAS DRAIN PROPERLY AND SHALL REPORT ANY DISCREPANCIES TO THE ENGINEER PRIOR TO CONSTRUCTION.
- 2. CONTRACTOR SHALL ASSUME SOLE RESPONSIBILITY FOR COMPUTATIONS OF ALL GRADING QUANTITIES. WHILE JSD PROFESSIONAL SERVICES, INC. ATTEMPTS TO PROVIDE A COST EFFECTIVE APPROACH TO BALANCE EARTHWORK, GRADING DESIGN IS BASED ON MANY FACTORS, INCLUDING SAFETY, AESTHETICS, AND COMMON ENGINEERING STANDARDS OF CARE. THEREFORE, NO GUARANTEE CAN BE MADE FOR A BALANCED SITE.
- 5. PARKING LOT AND DRIVEWAY ELEVATIONS ARE PAVEMENT GRADES, NOT TOP OF CURB GRADES, UNLESS OTHERWISE NOTED.
- 4. ANY WORK WITHIN RIGHT-OF-WAY SHALL BE PROPERLY PERMITTED AND COORDINATED WITH THE APPROPRIATE OFFICIALS PRIOR TO COMMENCEMENT OF ANY CONSTRUCTION ACTIVITIES. ALL GRADING WITHIN RIGHT-OF-WAY IS SUBJECT TO APPROVAL BY SAID OFFICIALS.
- 5. CONTRACTOR SHALL PROVIDE NOTICE TO THE MUNICIPALITY IN ADVANCE OF ANY SOIL DISTURBING ACTIVITIES, IN ACCORDANCE WITH MUNICIPAL REQUIREMENTS.
- 6. ALL DISTURBED AREAS SHALL BE SODDED AND OR SEEDED AND MULCHED IMMEDIATELY FOLLOWING GRADING ACTIVITIES. SOD/SEED MIX TO BE IN ACCORDANCE WITH LANDSCAPE PLAN.
- 7. CONTRACTOR SHALL CHISEL-PLOW OR DEEP TILL WITH DOUBLE TINES ALL STORMWATER MANAGEMENT FACILITIES JUST PRIOR TO SODDING AND/OR SEEDING AND MULCHING TO PROMOTE INFILTRATION.
- 8. CONTRACTOR SHALL WATER ALL NEWLY SODDED/SEEDED AREAS DURING THE SUMMER MONTHS WHENEVER THERE IS A 7 DAY LAPSE WITH NO SIGNIFICANT RAINFALL.
- 9. CONTRACTOR TO DEEP TILL ALL COMPACTED PERVIOUS SURFACES PRIOR TO SODDING AND/OR
- 10. ALL SLOPES 20% OR GREATER SHALL BE TEMPORARY SEEDED, MULCHED, OR OTHER MEANS OF COVER PLACED ON THEM WITHIN 2 WEEKS OF DISTURBANCE.
- 11. ALL EXPOSED SOIL AREAS THAT WILL NOT BE BROUGHT TO FINAL GRADE OR ON WHICH LAND DISTURBING ACTIVITIES WILL NOT BE PERFORMED FOR A PERIOD GREATER THAN 30 DAYS AND REQUIRE VEGETATIVE COVER FOR LESS THAN 1 YEAR, REQUIRE TEMPORARY SEEDING FOR EROSION CONTROL. SEEDING FOR EROSION CONTROL SHALL BE IN ACCORDANCE WITH WDNR TECHNICAL

UTILITY NOTES

SEEDING AND MULCHING.

STANDARD 1059 AND CITY OF MADISON ORDINANCE.

- 1. ALL EXISTING UTILITIES ARE SHOWN FOR INFORMATIONAL PURPOSES ONLY AND ARE NOT GUARANTEED TO BE ACCURATE OR ALL INCLUSIVE. THE CONTRACTOR IS RESPONSIBLE FOR MAKING HIS OWN DETERMINATION AS TO THE TYPE AND LOCATIONS OF UNDERGROUND UTILITIES AS MAY BE NECESSARY TO AVOID DAMAGE THERETO. CONTRACTOR/OWNER SHALL CALL "DIGGER'S HOTLINE" PRIOR TO ANY CONSTRUCTION.
- 2. PRIOR TO CONSTRUCTION, THE PRIME CONTRACTOR IS RESPONSIBLE FOR: * EXAMINING ALL SITE CONDITIONS RELATIVE TO THE CONDITIONS INDICATED ON THE ENGINEERING DRAWINGS. ANY DISCREPANCIES ARE TO BE REPORTED TO THE ENGINEER AND RESOLVED PRIOR TO THE START OF CONSTRUCTION. * OBTAINING ALL PERMITS INCLUDING PERMIT COSTS, TAP FEES, METER DEPOSITS, BONDS, AND ALL OTHER FEES REQUIRED FOR PROPOSED WORK TO OBTAIN OCCUPANCY.

* VERIFYING ALL ELEVATIONS, LOCATIONS AND SIZES OF SANITARY, WATER AND STORM LATERALS


* COORDINATING ALL CONSTRUCTION WITH OTHER CONTRACTORS INVOLVED WITH CONSTRUCTION

OF THE PROPOSED DEVELOPMENT AND FOR REPORTING ANY ERRORS OR DISCREPANCIES

- AND CHECK ALL UTILITY CROSSINGS FOR CONFLICTS. NOTIFY ENGINEER OF ANY DISCREPANCY. NO WORK SHALL BE PERFORMED UNTIL THE DISCREPANCY IS RESOLVED. NOTIFYING ALL UTILITIES PRIOR TO INSTALLATION OF ANY UNDERGROUND IMPROVEMENTS. * NOTIFYING THE DESIGN ENGINEER AND MUNICIPALITY 48 HOURS PRIOR TO THE START OF CONSTRUCTION TO ARRANGE FOR APPROPRIATE CONSTRUCTION OBSERVATION.
- BETWEEN THESE PLANS AND PLANS PREPARED BY OTHERS. 3. ALL UTILITY WORK SHALL BE DONE IN ACCORDANCE WITH THE STANDARD SPECIFICATIONS FOR SEWER AND WATER CONSTRUCTION IN WISCONSIN - AND ALL STATE AND LOCAL CODES AND SPECIFICATIONS.
- IT IS THE CONTRACTORS RESPONSIBILITY TO DETERMINE WHICH SPECIFICATIONS AND CODES APPLY, AND TO COORDINATE ALL CONSTRUCTION ACTIVITIES WITH THE APPROPRIATE LOCAL AND STATE
- 4. SPECIFICATIONS SHALL COMPLY WITH THE CITY OF MADISON SPECIAL PROVISIONS. 5. LENGTHS OF ALL UTILITIES ARE TO CENTER OF STRUCTURES OR FITTINGS AND MAY VARY SLIGHTLY
- FROM PLAN. LENGTHS SHALL BE VERIFIED IN THE FIELD DURING CONSTRUCTION. 6. CONTRACTOR IS RESPONSIBLE FOR SITE SAFETY DURING THE CONSTRUCTION OF IMPROVEMENTS.
- 7. CONTRACTOR SHALL INSTALL A PEDESTRIAN FENCE AROUND ALL EXCAVATIONS TO BE LEFT OPEN OVER NIGHT AS REQUIRED IN CONSTRUCTION SITES WHERE THE POTENTIAL FOR PEDESTRIAN INJURY
- 8. CONTRACTOR SHALL ADJUST AND/OR RECONSTRUCT ALL UTILITY COVERS (SUCH AS MANHOLE COVERS, VALVE BOX COVERS, ETC.) TO MATCH THE FINISHED GRADES OF THE AREAS EFFECTED BY THE
- 9. THE PRIME CONTRACTOR IS RESPONSIBLE FOR COORDINATING ALL CONSTRUCTION WITH OTHER CONTRACTORS INVOLVED WITH CONSTRUCTION OF THE PROPOSED DEVELOPMENT AND FOR REPORTING
- ANY ERRORS OR DISCREPANCIES BETWEEN THESE PLANS AND PLANS PREPARED BY OTHERS. 10. ANY SANITARY SEWER, SANITARY SEWER SERVICES, WATER MAIN, WATER SERVICES, STORM SEWER, OR OTHER UTILITIES, WHICH ARE DAMAGED BY THE CONTRACTORS, SHALL BE REPAIRED TO THE OWNER'S SATISFACTION AT THE CONTRACTOR'S EXPENSE.
- 11. THE CONTRACTOR IS RESPONSIBLE FOR PROVIDING THE ENGINEER WITH AS-BUILT CONDITIONS OF THE DESIGNATED IMPROVEMENTS IN ORDER THAT THE APPROPRIATE DRAWINGS CAN BE PREPARED, IF REQUIRED. ANY CHANGES TO THE DRAWINGS OR ADDITIONAL ITEMS MUST BE REPORTED TO THE ENGINEER AS WORK PROGRESSES. 12. STORM SEWER SPECIFICATIONS -
- PIPE PVC SHALL CONFORM TO ASTM D-3034 WITH SOLVENT WELD OR ELASTOMETRIC JOINTS. PIPE SHALL BE SDR-35, UNLESS OTHEWISE NOTED.
- INLETS INLETS SHALL BE CONSTRUCTED IN ACCORDANCE WITH FILE. NO. 28 OF THE "STANDARD SPECIFICATIONS", OR APPROVED EQUAL WITH A 1'-8" X 2'-6" MAXIMUM OPENING. CURB FRAME & GRATE SHALL BE NEENAH R-3067 WITH TYPE R GRATE, OR EQUAL. BACKFILL AND BEDDING — STORM SEWER SHALL BE CONSTRUCTED WITH GRAVEL BACKFILL AND CLASS

"B" BEDDING IN ALL PAVED AREAS AND TO A POINT 5 FEET BEYOND THE EDGE OF PAVEMENT.

- TRENCHES RUNNING PARALLEL TO AND LESS THAN 5 FEET FROM THE EDGE OF PAVEMENT SHALL ALSO REQUIRE GRAVEL BACKFILL. LANDSCAPED AREAS MAY BE BACKFILLED WITH EXCAVATED MATERIAL IN CONFORMANCE WITH SECTION 8.43.5 OF THE "STANDARD SPECIFICATIONS". MANHOLE FRAMES AND COVERS - MANHOLE FRAMES AND COVERS SHALL BE NEENAH R-1642 WITH
- TYPE "B" SELF SEALING LIDS, NON-ROCKING OR EQUAL. FIELD TILE CONNECTION — ALL FIELD TILE ENCOUNTERED DURING CONSTRUCTION SHALL BE INCLUDED IN THE UNIT PRICE(S) FOR STORM SEWER. TILE LINES CROSSED BY THE TRENCH SHALL BE REPLACED WITH THE SAME MATERIAL AS THE STORM SEWER.

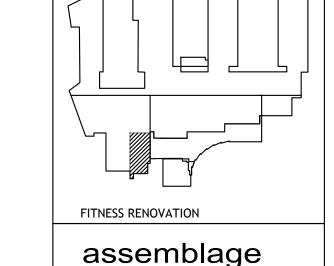

ARCHITECTS

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MADISON

MADISON COLLEGE

FITNESS RENOVATION

Madison, Wisconsin

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AA Project No.:

MC Project No.:

|Bid Pkg No.:

REVISION

Issued for: UDC INITIAL-FINAL

08-12-2020

2020-03

DATE

RFB20-XYZ

TRUAX BUILDING

LEGEND PROPERTY LINE

---- RIGHT-OF-WAY ----- EASEMENT LINE BUILDING OUTLINE ---- BUILDING OVERHANG REJECT CURB AND GUTTER MOUNTABLE CURB AND GUTTER

EDGE OF PAVEMENT STANDARD CURB AND GUTTER 8" CONCRETE RIBBON CURB ASPHALT PAVEMENT HEAVY DUTY ASPHALT PAVEMENT CONCRETE PAVEMENT

4 4 4 HEAVY DUTY CONCRETE PAVEMENT

-----960------- PROPOSED 5 FOOT CONTOUR — — ·959· — — EXISTING 1 FOOT CONTOUR DRAINAGE DIRECTION — — — GRADE BREAK STORMWATER MANAGEMENT AREA RETAINING WALL BOULDER WALL

RAILING

∕− FG: XXX.XX

RIP-RAP CONSTRUCTION ENTRANCE EROSION MATTING TURF REINFORCEMENT MATTING EP - EDGE OF PAVEMENT



DITCH CHECK INLET PROTECTION

S SANITARY SEWER D STORM SEWER

8'x4'x2" INSULATION (PLAN VIEW) 8'x4'x2" INSULATION (PROFILE VIEW)

FG - FINISH GRADE EC - EDGE OF CONCRET

HP - HIGH POINT SW - SIDEWALK

BOC - BACK OF CURB

MATCH - MATCH EXISTING GRADE





MADISON | MILWAUKEE | WAUSAU APPLETON KENOSHA CHICAGO COEUR D'ALENE

> **MADISON REGIONAL OFFICE** 161 HORIZON DRIVE, SUITE 101 VERONA, WISCONSIN 53593 P. 608.848.5060

SHEET NUMBER


GRADING, UTILITY, &


EROSION CONTROL PLAN


SCALE


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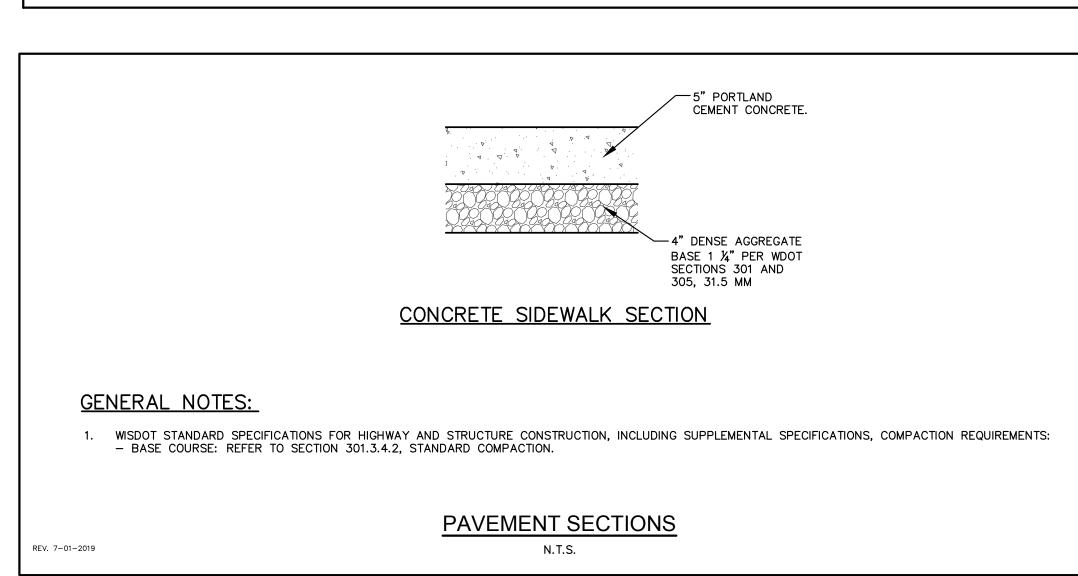
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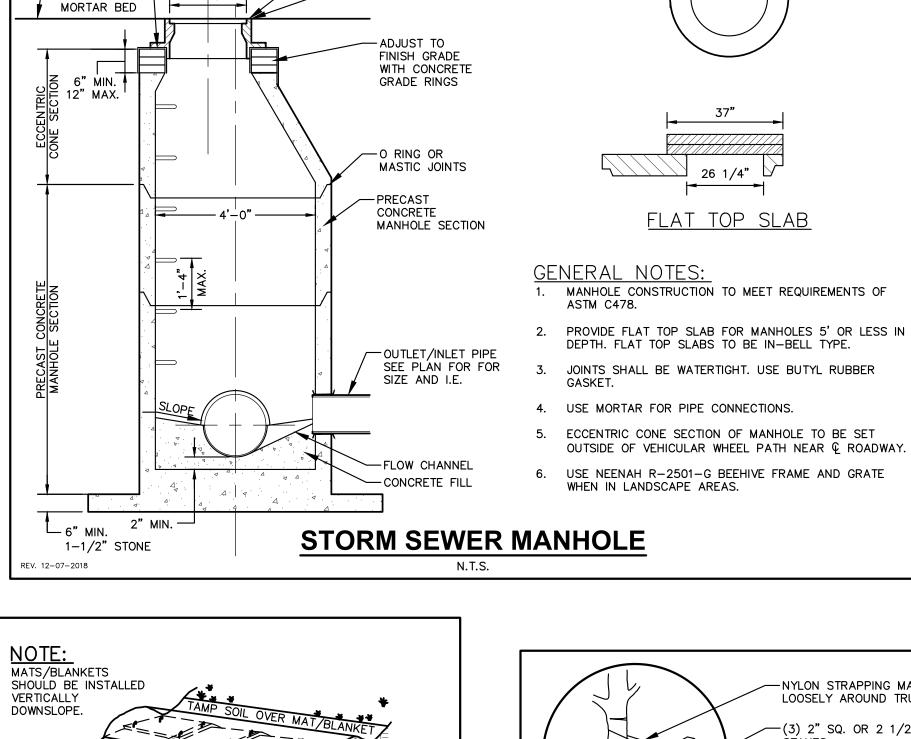




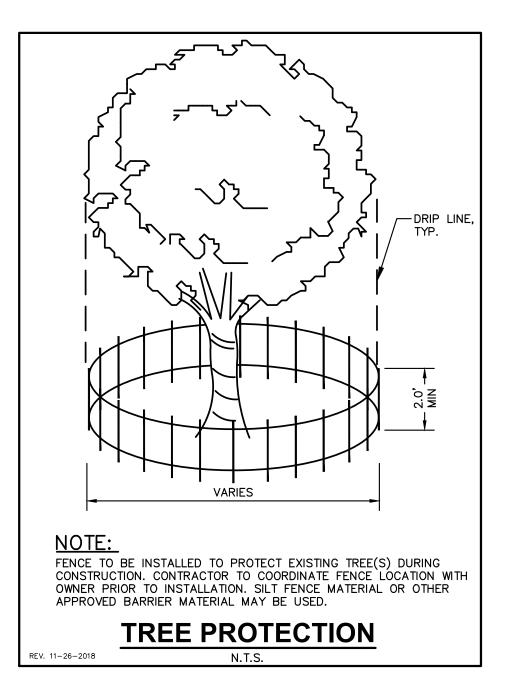

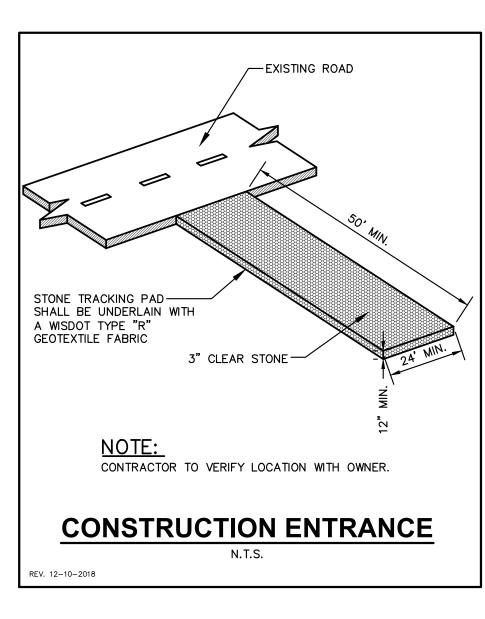

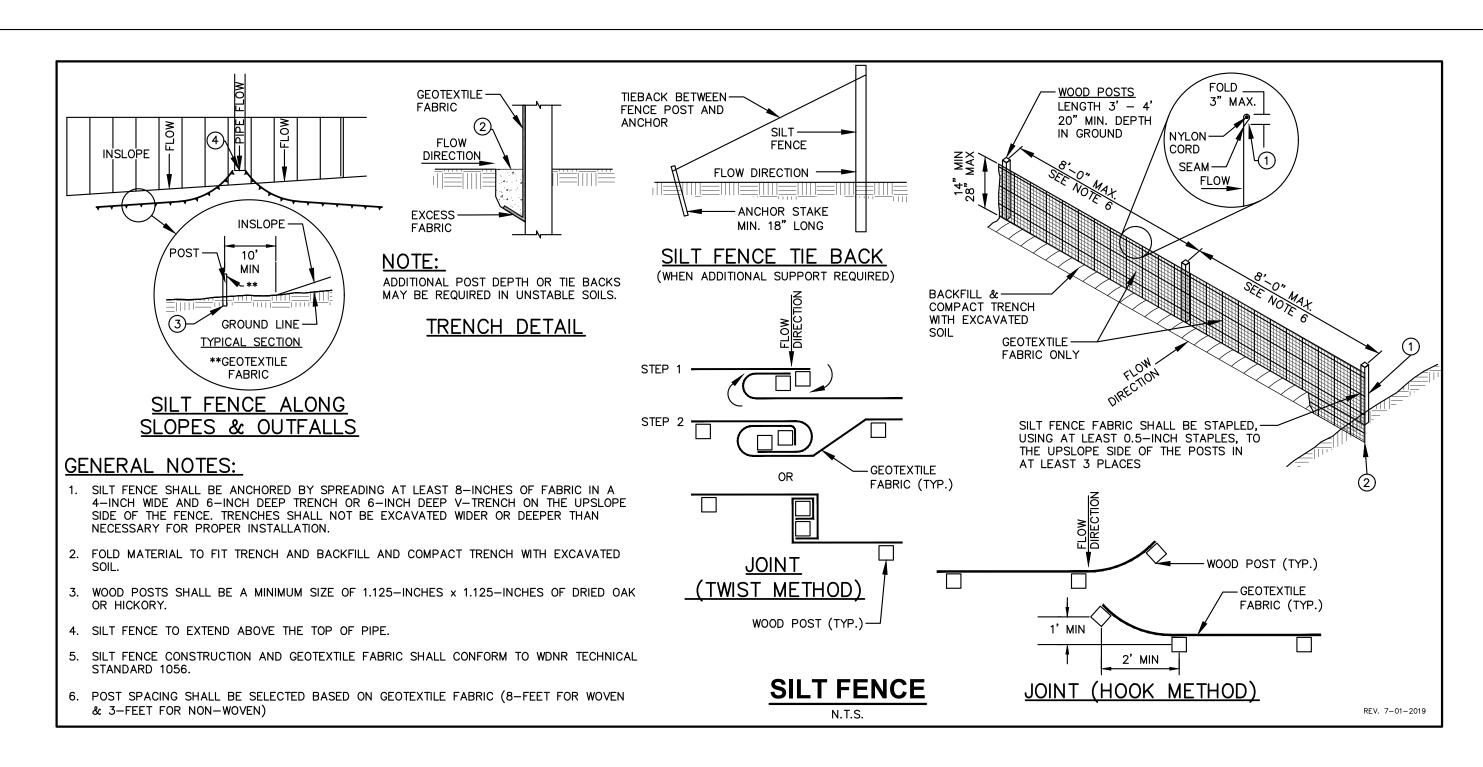

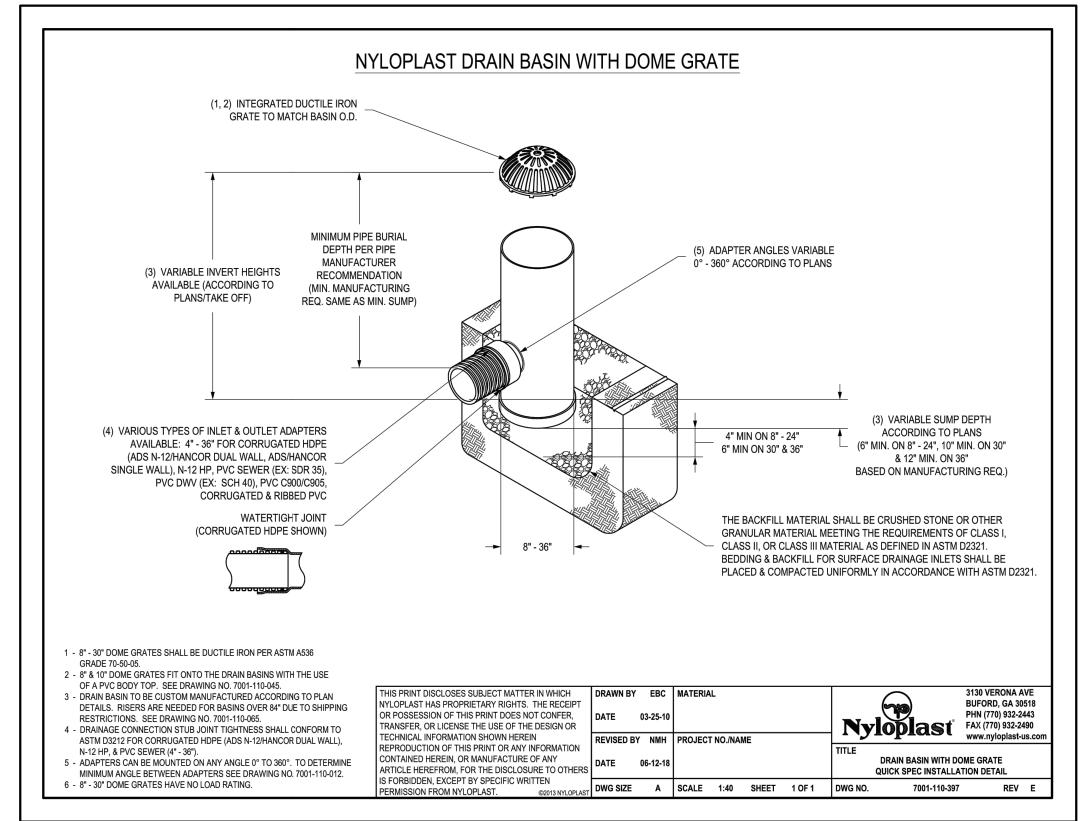

STAPLES

<u>BERM</u>

EROSION MAT CONSTRUCTION SHALL BE IN ACCORDANCE WITH WISCONSIN DNR TECHNICAL STANDARD 1052 "NON-CHANNEL

2. ONLY WISDOT EROSION CONTROL PRODUCT ACCEPTABILITY LIST

4. LAY BLANKETS LOOSELY AND STAKE OR STAPLE TO MAINTAIN DIRECT CONTACT WITH THE SOIL. DO NOT STRETCH.

5. ONLY WISDOT EROSION CONTROL PRODUCT ACCEPTABILITY LIST (PAL) APPROVED MATS SHALL BE ALLOWED. REFER TO EROSION CONTROL PLAN FOR EXACT MAT CLASSIFICATION.

EROSION MATTING

(PAL) APPROVED MATS SHALL BE ALLOWED. REFER TO EROSION CONTROL PLAN FOR EXACT MAT CLASSIFICATION.

3. APPLY PERMANENT SEEDING BEFORE PLACING BLANKETS.

-FRAME AND GRATE SEE STORM

SCH. SHEET C-XX

SEE PLANS

STRUCTURE Q

ROADWAY (

GRADE

SET FRAME IN


ISOMETRIC VIEW


TYPICAL SLOPE

SOIL STABILIZATION

GENERAL NOTES:

EROSION MAT".

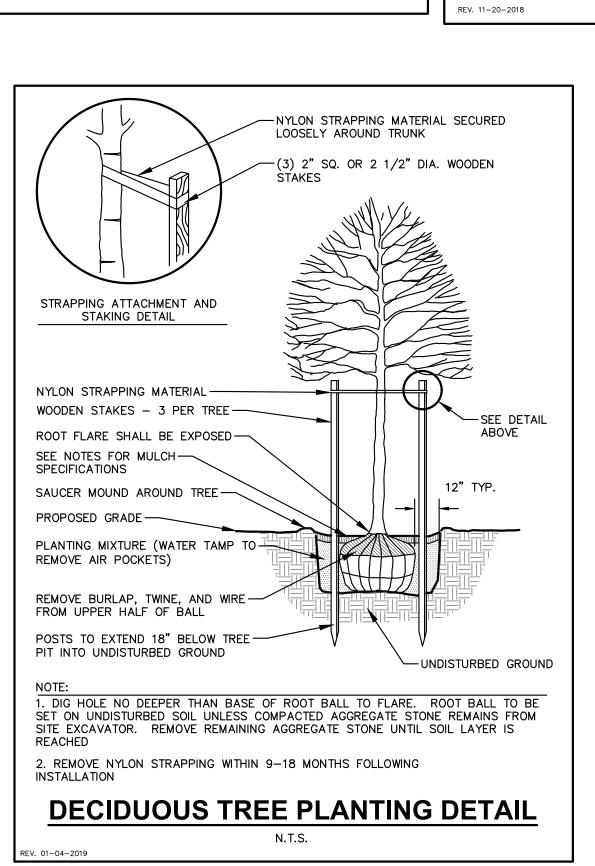

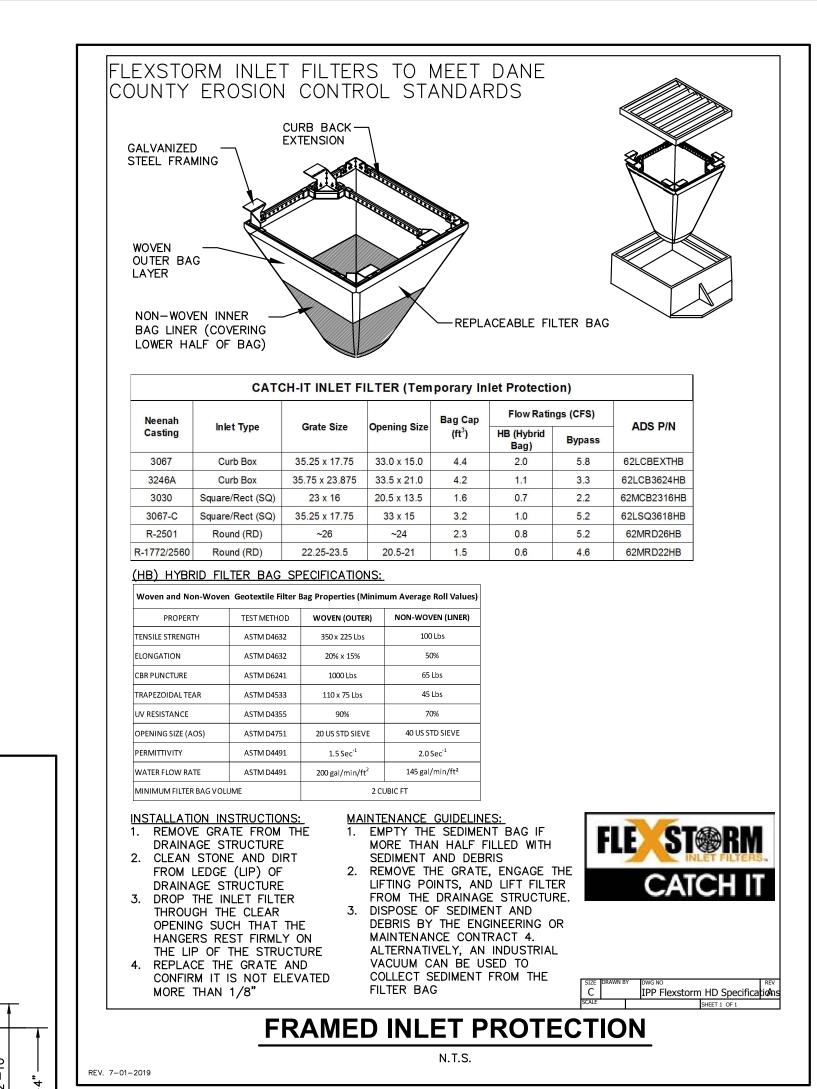

MAXIMUM DISTANCE BETWEEN

POSTS - 3'-8"

COMPRESSIBLE

1'-0" 11" = 3'-6" 11" 1'-0"

4 TREADS @

CENTER AND/OR EQUALLY SPACE

INTERMEDIATE

COMPRESSIBLE FILLER

1/2" RAD.—— NOSINGS SLOPE

GRANULAR FILL

WITH #4 REBAR @

8" O.C. EACH WAY

ALL TREADS 1/4"

6" MIN. COMPACTED -

1"x2"x12 GA. GALVANIZED PAINTED

CONCRETE STAIRS W/

HANDRAIL

N.T.S.


SQUARE STEEL TUBE RAILING -

NON-SHRINK GROUT & BEVEL

EMBED 5" MINIMUM INTO

GROUT UP TOWARD POSTS.

CONCRETE. GROUT WITH

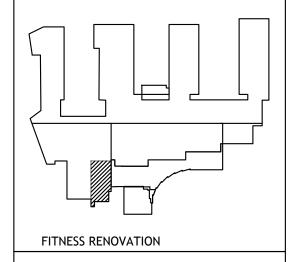

MADISON

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TRUAX BUILDING

AREA TECHNICAL

assemblage ARCHITECTS 7433 Elmwood Avenue

Middleton, WI 53562

T 608.827.5047

SCALE

AS NOTED

SHEET TITLE

SHEET NUMBER

DETAILS

Toll Free (800) 242-8511



CREATE THE VISION TELL THE STORY

MADISON MILWAUKEE WAUSAU
APPLETON KENOSHA CHICAGO
COEUR D'ALENE


MADISON REGIONAL OFFICE

161 HORIZON DRIVE, SUITE 101

VERONA, WISCONSIN 53593

P. 608.848.5060

C400

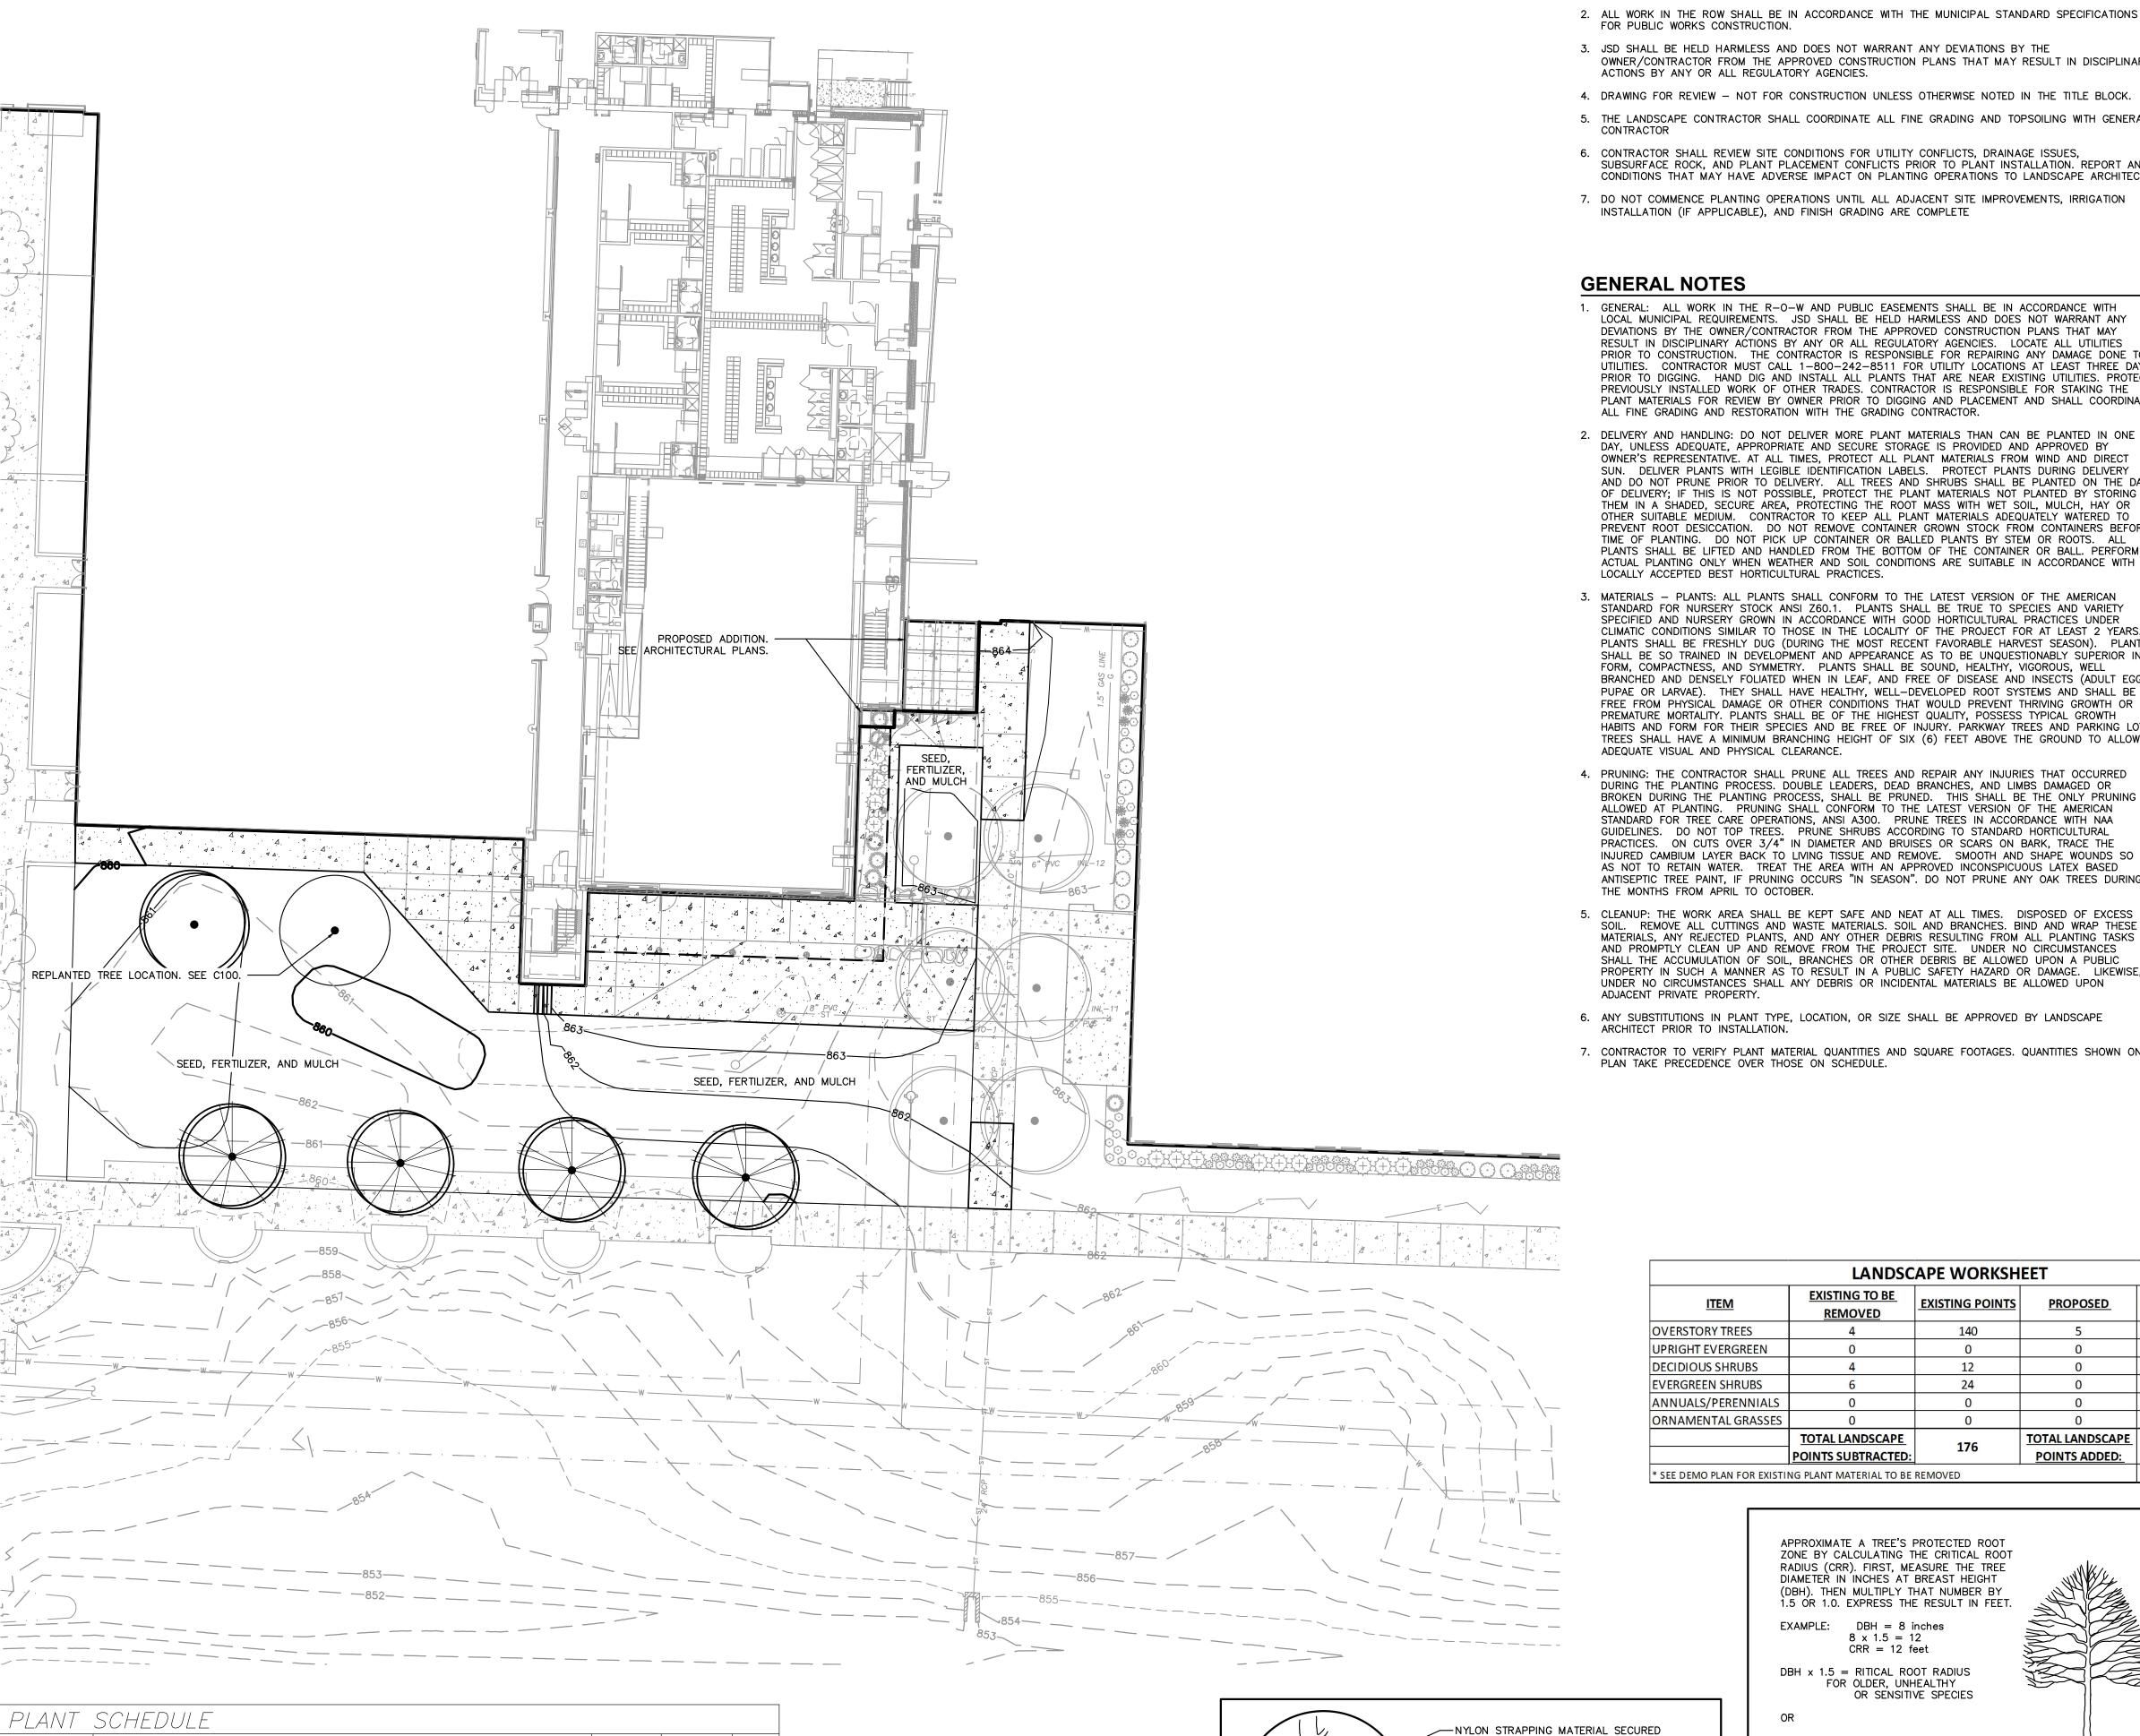

BOTANICAL / COMMON NAME

| Acer truncatum x A. platanoides 'Warrenred' / Pacific Sunset Maple

B & B | 2.5"Cal

Gymnocladus dioica 'Espresso' / Kentucky Coffeetree

GENERAL NOTES

- 1. REFER TO THE EXISTING CONDITIONS SURVEY FOR EXISTING CONDITIONS NOTES AND LEGEND.
- 3. JSD SHALL BE HELD HARMLESS AND DOES NOT WARRANT ANY DEVIATIONS BY THE OWNER/CONTRACTOR FROM THE APPROVED CONSTRUCTION PLANS THAT MAY RESULT IN DISCIPLINARY ACTION'S BY ANY OR ALL REGULATORY AGENCIES.
- 4. DRAWING FOR REVIEW NOT FOR CONSTRUCTION UNLESS OTHERWISE NOTED IN THE TITLE BLOCK.
- 5. THE LANDSCAPE CONTRACTOR SHALL COORDINATE ALL FINE GRADING AND TOPSOILING WITH GENERAL
- SUBSURFACE ROCK, AND PLANT PLACEMENT CONFLICTS PRIOR TO PLANT INSTALLATION. REPORT ANY CONDITIONS THAT MAY HAVE ADVERSE IMPACT ON PLANTING OPERATIONS TO LANDSCAPE ARCHITECT
- 7. DO NOT COMMENCE PLANTING OPERATIONS UNTIL ALL ADJACENT SITE IMPROVEMENTS, IRRIGATION INSTALLATION (IF APPLICABLE), AND FINISH GRADING ARE COMPLETE

GENERAL NOTES

LOOSELY AROUND TRUNK

STRAPPING ATTACHMENT AND STAKING DETAIL

NYLON STRAPPING MATERIAL-

SAUCER MOUND AROUND TREE

PLANTING MIXTURE (WATER TAMP TO-

REMOVE BURLAP, TWINE, AND WIRE FROM UPPER HALF OF BALL

POSTS TO EXTEND 18" BELOW TREE PIT INTO UNDISTURBED GROUND

1. DIG HOLE NO DEEPER THAN BASE OF ROOT BALL TO FLARE. ROOT BALL TO BE SET ON UNDISTURBED SOIL UNLESS COMPACTED AGGREGATE STONE REMAINS FROM SITE EXCAVATOR. REMOVE REMAINING AGGREGATE STONE UNTIL SOIL LAYER IS

DECIDUOUS TREE PLANTING DETAIL

2. REMOVE NYLON STRAPPING WITHIN 9-18 MONTHS FOLLOWING INSTALLATION

SEE NOTES FOR MULCH-

SPECIFICATIONS

PROPOSED GRADE -

REMOVE AIR POCKETS)

WOODEN STAKES - 3 PER TREE ROOT FLARE SHALL BE EXPOSED - 3) 2" SQ. OR 2 1/2" DIA. WOODEN

12" TYP.

-UNDISTURBED GROUND

EV. 01-04-2019

- 1. GENERAL: ALL WORK IN THE R-O-W AND PUBLIC EASEMENTS SHALL BE IN ACCORDANCE WITH LOCAL MUNICIPAL REQUIREMENTS. JSD SHALL BE HELD HARMLESS AND DOES NOT WARRANT ANY DEVIATIONS BY THE OWNER/CONTRACTOR FROM THE APPROVED CONSTRUCTION PLANS THAT MAY RESULT IN DISCIPLINARY ACTIONS BY ANY OR ALL REGULATORY AGENCIES. LOCATE ALL UTILITIES PRIOR TO CONSTRUCTION. THE CONTRACTOR IS RESPONSIBLE FOR REPAIRING ANY DAMAGE DONE TO UTILITIES. CONTRACTOR MUST CALL 1-800-242-8511 FOR UTILITY LOCATIONS AT LEAST THREE DAYS PRIOR TO DIGGING. HAND DIG AND INSTALL ALL PLANTS THAT ARE NEAR EXISTING UTILITIES. PROTECT PREVIOUSLY INSTALLED WORK OF OTHER TRADES. CONTRACTOR IS RESPONSIBLE FOR STAKING THE PLANT MATERIALS FOR REVIEW BY OWNER PRIOR TO DIGGING AND PLACEMENT AND SHALL COORDINATE ALL FINE GRADING AND RESTORATION WITH THE GRADING CONTRACTOR.
- 2. DELIVERY AND HANDLING: DO NOT DELIVER MORE PLANT MATERIALS THAN CAN BE PLANTED IN ONE DAY, UNLESS ADEQUATE, APPROPRIATE AND SECURE STORAGE IS PROVIDED AND APPROVED BY OWNER'S REPRESENTATIVE. AT ALL TIMES, PROTECT ALL PLANT MATERIALS FROM WIND AND DIRECT SUN. DELIVER PLANTS WITH LEGIBLE IDENTIFICATION LABELS. PROTECT PLANTS DURING DELIVERY AND DO NOT PRUNE PRIOR TO DELIVERY. ALL TREES AND SHRUBS SHALL BE PLANTED ON THE DAY OF DELIVERY: IF THIS IS NOT POSSIBLE, PROTECT THE PLANT MATERIALS NOT PLANTED BY STORING THEM IN A SHADED, SECURE AREA, PROTECTING THE ROOT MASS WITH WET SOIL, MULCH, HAY OR OTHER SUITABLE MEDIUM. CONTRACTOR TO KEEP ALL PLANT MATERIALS ADEQUATELY WATERED TO PREVENT ROOT DESICCATION. DO NOT REMOVE CONTAINER GROWN STOCK FROM CONTAINERS BEFORE TIME OF PLANTING. DO NOT PICK UP CONTAINER OR BALLED PLANTS BY STEM OR ROOTS. ALL PLANTS SHALL BE LIFTED AND HANDLED FROM THE BOTTOM OF THE CONTAINER OR BALL. PERFORM ACTUAL PLANTING ONLY WHEN WEATHER AND SOIL CONDITIONS ARE SUITABLE IN ACCORDANCE WITH
- 3. MATERIALS PLANTS: ALL PLANTS SHALL CONFORM TO THE LATEST VERSION OF THE AMERICAN STANDARD FOR NURSERY STOCK ANSI Z60.1. PLANTS SHALL BE TRUE TO SPECIES AND VARIETY SPECIFIED AND NURSERY GROWN IN ACCORDANCE WITH GOOD HORTICULTURAL PRACTICES UNDER CLIMATIC CONDITIONS SIMILAR TO THOSE IN THE LOCALITY OF THE PROJECT FOR AT LEAST 2 YEARS. PLANTS SHALL BE FRESHLY DUG (DURING THE MOST RECENT FAVORABLE HARVEST SEASON). PLANTS SHALL BE SO TRAINED IN DEVELOPMENT AND APPEARANCE AS TO BE UNQUESTIONABLY SUPERIOR IN FORM, COMPACTNESS, AND SYMMETRY. PLANTS SHALL BE SOUND, HEALTHY, VIGOROUS, WELL BRANCHED AND DENSELY FOLIATED WHEN IN LEAF, AND FREE OF DISEASE AND INSECTS (ADULT EGGS, PUPAE OR LARVAE). THEY SHALL HAVE HEALTHY, WELL-DEVELOPED ROOT SYSTEMS AND SHALL BE FREE FROM PHYSICAL DAMAGE OR OTHER CONDITIONS THAT WOULD PREVENT THRIVING GROWTH OR PREMATURE MORTALITY. PLANTS SHALL BE OF THE HIGHEST QUALITY, POSSESS TYPICAL GROWTH HABITS AND FORM FOR THEIR SPECIES AND BE FREE OF INJURY. PARKWAY TREES AND PARKING LOT TREES SHALL HAVE A MINIMUM BRANCHING HEIGHT OF SIX (6) FEET ABOVE THE GROUND TO ALLOW ADEQUATE VISUAL AND PHYSICAL CLEARANCE.
- 4. PRUNING: THE CONTRACTOR SHALL PRUNE ALL TREES AND REPAIR ANY INJURIES THAT OCCURRED DURING THE PLANTING PROCESS. DOUBLE LEADERS, DEAD BRANCHES, AND LIMBS DAMAGED OR BROKEN DURING THE PLANTING PROCESS, SHALL BE PRUNED. THIS SHALL BE THE ONLY PRUNING ALLOWED AT PLANTING. PRUNING SHALL CONFORM TO THE LATEST VERSION OF THE AMERICAN STANDARD FOR TREE CARE OPERATIONS, ANSI A300. PRUNE TREES IN ACCORDANCE WITH NAA GUIDELINES. DO NOT TOP TREES. PRUNE SHRUBS ACCORDING TO STANDARD HORTICULTURAL PRACTICES. ON CUTS OVER 3/4" IN DIAMETER AND BRUISES OR SCARS ON BARK, TRACE THE INJURED CAMBIUM LAYER BACK TO LIVING TISSUE AND REMOVE. SMOOTH AND SHAPE WOUNDS SO AS NOT TO RETAIN WATER. TREAT THE AREA WITH AN APPROVED INCONSPICUOUS LATEX BASED ANTISEPTIC TREE PAINT, IF PRUNING OCCURS "IN SEASON". DO NOT PRUNE ANY OAK TREES DURING THE MONTHS FROM APRIL TO OCTOBER.
- 5. CLEANUP: THE WORK AREA SHALL BE KEPT SAFE AND NEAT AT ALL TIMES. DISPOSED OF EXCESS SOIL. REMOVE ALL CUTTINGS AND WASTE MATERIALS. SOIL AND BRANCHES. BIND AND WRAP THESE MATERIALS. ANY REJECTED PLANTS, AND ANY OTHER DEBRIS RESULTING FROM ALL PLANTING TASKS AND PROMPTLY CLEAN UP AND REMOVE FROM THE PROJECT SITE. UNDER NO CIRCUMSTANCES PROPERTY IN SUCH A MANNER AS TO RESULT IN A PUBLIC SAFETY HAZARD OR DAMAGE. LIKEWISE, UNDER NO CIRCUMSTANCES SHALL ANY DEBRIS OR INCIDENTAL MATERIALS BE ALLOWED UPON ADJACENT PRIVATE PROPERTY.
- 6. ANY SUBSTITUTIONS IN PLANT TYPE, LOCATION, OR SIZE SHALL BE APPROVED BY LANDSCAPE ARCHITECT PRIOR TO INSTALLATION.
- 7. CONTRACTOR TO VERIFY PLANT MATERIAL QUANTITIES AND SQUARE FOOTAGES. QUANTITIES SHOWN ON PLAN TAKE PRECEDENCE OVER THOSE ON SCHEDULE.

SEEDING NOTES

MATERIALS - TURFGRASS SEED: DISTURBED LAWN AREAS LABELED ON PLAN AS SUCH, SHALL RECEIVE 6" OF TOPSOIL AND EARTH CARPET'S "MADISON PARKS" GRASS SEED, OR EQUIVALENT AS APPROVED BY THE OWNER'S REPRESENTATIVE, INSTALLED PER MANUFACTURER'S RECOMMENDATIONS. IN ADDITION TO TURFGRASS SEED, ANNUAL RYE SHALL BE APPLIED TO ALL DISTURBED AREAS AT A RATE OF 1 1/2 LBS PER 1000 SQUARE FEET. FERTILIZE AND MULCH PER MANUFACTURER'S RECOMMENDATIONS.

LANDSCAPE MATERIAL NOTES

MULCH SHALL BE CERTIFIED NOXIOUS WEED SEED-FREE

MATERIALS - PLANTING MIXTURE: ALL HOLES EXCAVATED FOR TREES, SHRUBS, PERENNIALS AND ORNAMENTAL GRASSES SHALL BE BACKFILLED WITH TWO (2) PARTS TOPSOIL, ONE (1) PART SAND AND ONE (1) PART COMPOST. SOIL MIXTURE SHALL BE WELL BLENDED PRIOR TO INSTALLATION.

- MATERIALS TOPSOIL: TOPSOIL TO BE CLEAN, FRIABLE LOAM FROM A LOCAL SOURCE, FREE FROM STONES OR DEBRIS OVER 3/4" IN DIAMETER, AND FREE FROM TOXINS OR OTHER DELETERIOUS MATERIALS. TOPSOIL SHALL HAVE A DH VALUE BETWEEN 6 AND 7. TOPSOIL AND PLANTING SOIL SHALL BE TESTED TO ENSURE CONFORMANCE WITH THESE SPECIFICATIONS AND SHALL BE AMENDED TO MEET THESE SPECIFICATIONS. PROVIDE TEST RESULTS TO OWNER'S REPRESENTATIVE PRIOR TO PLACEMENT. DO NOT PLACE FROZEN OR MUDDY TOPSOIL. APPLY SOIL AMENDMENTS TO ALL LANDSCAPE AREAS PER SOIL TEST.
- 3. MATERIALS SHREDDED HARDWOOD BARK MULCH: ALL PLANTING AREAS LABELED ON PLAN SHALL RECEIVE CERTIFIED WEED FREE SHREDDED HARDWOOD BARK MULCH INSTALLED TO A MINIMUM AND CONSISTENT DEPTH OF 3-INCHES. SHREDDED HARDWOOD BARK MULCH SIZE & COLOR TO BE APPROVED BY OWNER'S REPRESENTATIVE PRIOR TO INSTALLATION. FERTILIZER SHALL BE IN ACCORDANCE WITH APPLICABLE LOCAL, COUNTY AND STATE REQUIREMENTS. SHREDDED HARDWOOD BARK MULCH AREAS SHALL NOT RECEIVE WOVEN WEED BARRIER FABRIC.
- 4. MATERIALS TREE & SHRUB RINGS: ALL TREES AND/OR SHRUBS PLANTED IN SEEDED LAWN AREAS TO BE INSTALLED WITH A MINIMUM 4' DIAMETER SHREDDED HARDWOOD BARK MULCH TREE RING SPREAD TO A CONSISTENT DEPTH OF 3-INCHES. ALL TREE RINGS SHOULD BE INSTALLED WITH A 5" DEPTH SHOVEL CUT EDGE, ANGLED 45 DEGREES INTO SOIL AT A 5' DIAMETER ABOUT THE CENTER OF THE TREE PLANTING. A PRE-EMERGENT GRANULAR HERBICIDE WEED-PREVENTER SHOULD BE MIXED WITH MULCH USED TO INSTALL TREE RING AS WELL AS TOPICALLY APPLIED TO COMPLETED
- 5. MATERIALS TREE PROTECTION: ALL TREES TO BE INSTALLED WITH LDPE TREE GUARDS AS MANUFACTURED BY A.M. LEONARD HORTICULTURAL TOOL & SUPPLY CO., OR APPROVED EQUAL.
- MATERIALS (ALTERNATE 1): TREE WATERING BAGS: ALL TREES TO BE INSTALLED WITH ONE (1) WATER BAG. PRODUCT TO BE "TREE GATOR ORIGINAL SLOW RELEASE WATERING BAG," PRODUCT NO. 98183-R OR APPROVED EQUAL. INSTALL IN ACCORDANCE WITH MANUFACTURER'S RECOMMENDATIONS.
- 7. MATERIALS (ALTERNATE 2): ROOT WATERING SYSTEM: ALL TREES TO BE INSTALLED WITH TWO (2) DEEP TREE ROOT WATER AERATION/WATERING TUBES. PRODUCT TO BE "ROOTWELL PRO-318, OR APPROVED EQUAL. INSTALL IN ACCORDANCE WITH MANUFACTURER'S RECOMMENDATIONS. CARE SHALL BE TAKEN TO AVOID DAMAGE TO TREE ROOT BALL.

CONTRACTOR AND OWNER RESPONSIBILITY NOTES

GUARANTEE: THE CONTRACTOR SHALL GUARANTEE ALL PLANTS THROUGH ONE (1) YEAR AFTER ACCEPTANCE BY THE OWNER'S REPRESENTATIVE. PLANTS SHALL BE ALIVE AND IN HEALTHY AND FLOURISHING CONDITION AT THE END OF THE GUARANTEE PERIOD. THE CONTRACTOR SHALL REPLACE (AT NO COST TO OWNER) ANY PLANTS THAT ARE DEAD OR NOT IN A VIGOROUS THRIVING CONDITION. REPLACEMENT PLANTS SHALL BE OF THE SAME KIND AND SIZE AS ORIGINALLY SPECIFIED UNLESS OTHERWISE DIRECTED BY OWNER'S REPRESENTATIVE. RESTORE BEDS AS NECESSARY FOLLOWING PLANT REPLACEMENT, INCLUDING BUT NOT LIMITED TO BEDDING, EDGING, MULCH, ETC. REPLACE PLANTS DAMAGED AT TIME OF PLANTING. REPAIR AREAS DISTURBED IN ANY WAY DURING PLANT REPLACEMENT AT NO COST TO OWNER. CONTRACTOR SHALL PROVIDE A ONE (1)-YEAR STRAIGHTENING GUARANTEE FOR ALL TREES.

CONTRACTOR IS RESPONSIBLE FOR STAKING THE PLANT MATERIALS FOR REVIEW BY OWNER'S REPRESENTATIVE PRIOR TO DIGGING AND PLACEMENT AND SHALL COORDINATE ALL FINE GRADING AND RESTORATION WITH THE GRADING CONTRACTOR.

MAINTENANCE: (CONTRACTOR) FOR ALL PLANTINGS AND SEEDED LAWN AREAS: THE CONTRACTOR

- SHALL MAINTAIN ALL PLANTINGS AND LAWN AREAS FOR A MINIMUM TIME PERIOD OF 60 DAYS, UNTIL FINAL ACCEPTANCE BY OWNER'S REPRESENTATIVE. THE CONTRACTOR IS RESPONSIBLE FOR ADEQUATELY WATERING PLANTS AND LAWN/TURFGRASS DURING THIS 60 DAY ESTABLISHMENT PERIOD. CONTRACTOR IS RESPONSIBLE FOR THE ESTABLISHMENT OF HEALTHY VIGOROUS PLANT MATERIALS AND LAWN/TURFGRASS GROWTH. CONTRACTOR IS ALSO RESPONSIBLE FOR ANY PRUNING OF PLANT MATERIALS. AND SHAPING AND/OR REPLACEMENT OR SUPPLEMENT OF DEFICIENT SHREDDED HARDWOOD BARK MULCH DURING THIS PERIOD. LONG TERM PLANT MATERIALS AND LAWN/TURFGRASS MAINTENANCE AND ANY PROGRAM FOR SUCH IS THE RESPONSIBILITY OF THE OWNER. ALL PLANTINGS AND LAWN/TURFGRASS AREAS SHALL BE MAINTAINED IN A MANICURED
- MAINTENANCE: (OWNER) THE OWNER IS RESPONSIBLE FOR THE CONTINUED MAINTENANCE, REPAIR AND REPLACEMENT OF ALL LANDSCAPING MATERIALS AND WEED BARRIER FABRIC AS NECESSARY FOLLOWING THE ONE (1) YEAR CONTRACTOR GUARANTEE PERIOD.


PROPERTY LINE ---- RIGHT-OF-WAY


BUILDING OUTLINE


CONDITION UNTIL THE TIME WHEN THE OWNER'S ACCEPTANCE IS GIVEN.

LEGEND

	LANDSC	APE WORKSH	EET	
	EXISTING TO BE REMOVED	EXISTING POINTS	PROPOSED	PROPOSED POINTS
	4	140	5	175
V	0	0	0	0
	4	12	0	0
5	6	24	0	0
ALS	0	0	0	0
SES	0	0	0	0
•	TOTAL LANDSCAPE	176	TOTAL LANDSCAPE	175

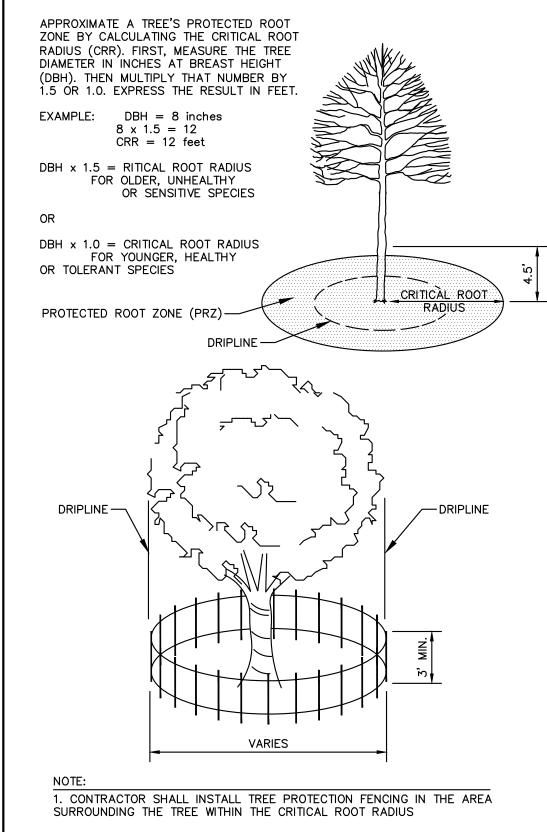

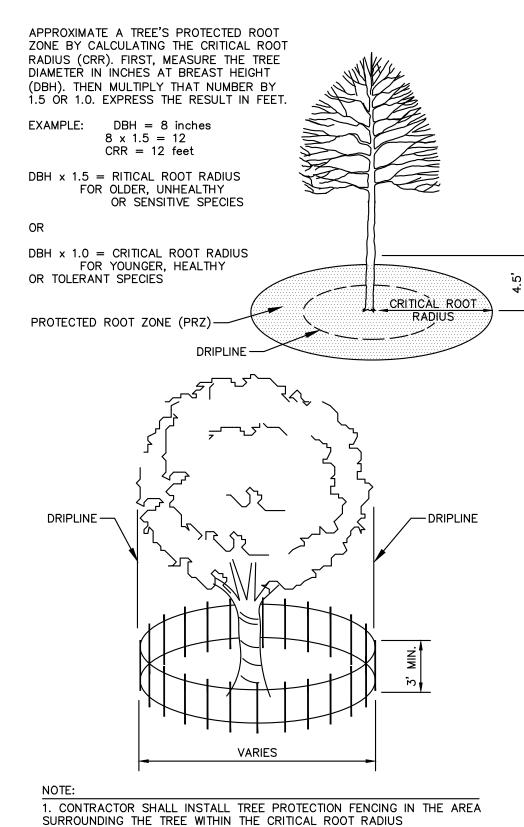

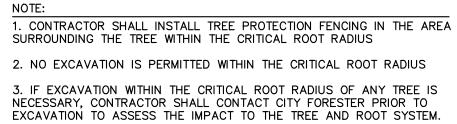

TREE PROTECTION DETAIL









MADISON | MILWAUKEE | WAUSAU APPLETON KENOSHA CHICAGO
COEUR D'ALENE

> MADISON REGIONAL OFFICE 161 HORIZON DRIVE, SUITE 101 VERONA, WISCONSIN 53593 P. 608.848.5060

MADISON




MADISON COLLEGE TRUAX BUILDING

FITNESS RENOVATION Madison, Wisconsin

Issued for: UDC INITIAL-FINAL 08-12-2020 Issue date: AA Project No.: RFB20-XYZ MC Project No.:

|Bid Pkg No.:

DATE

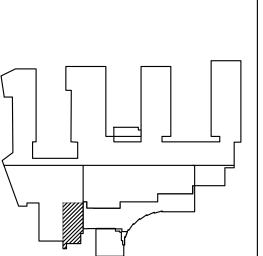


FITNESS RENOVATION assemblage

ARCHITECTS 7433 Elmwood Avenue Middleton, WI 53562 T 608.827.5047

SCALE AS NOTED

SHEET TITLE LANDSCAPE PLAN

SHEET NUMBER

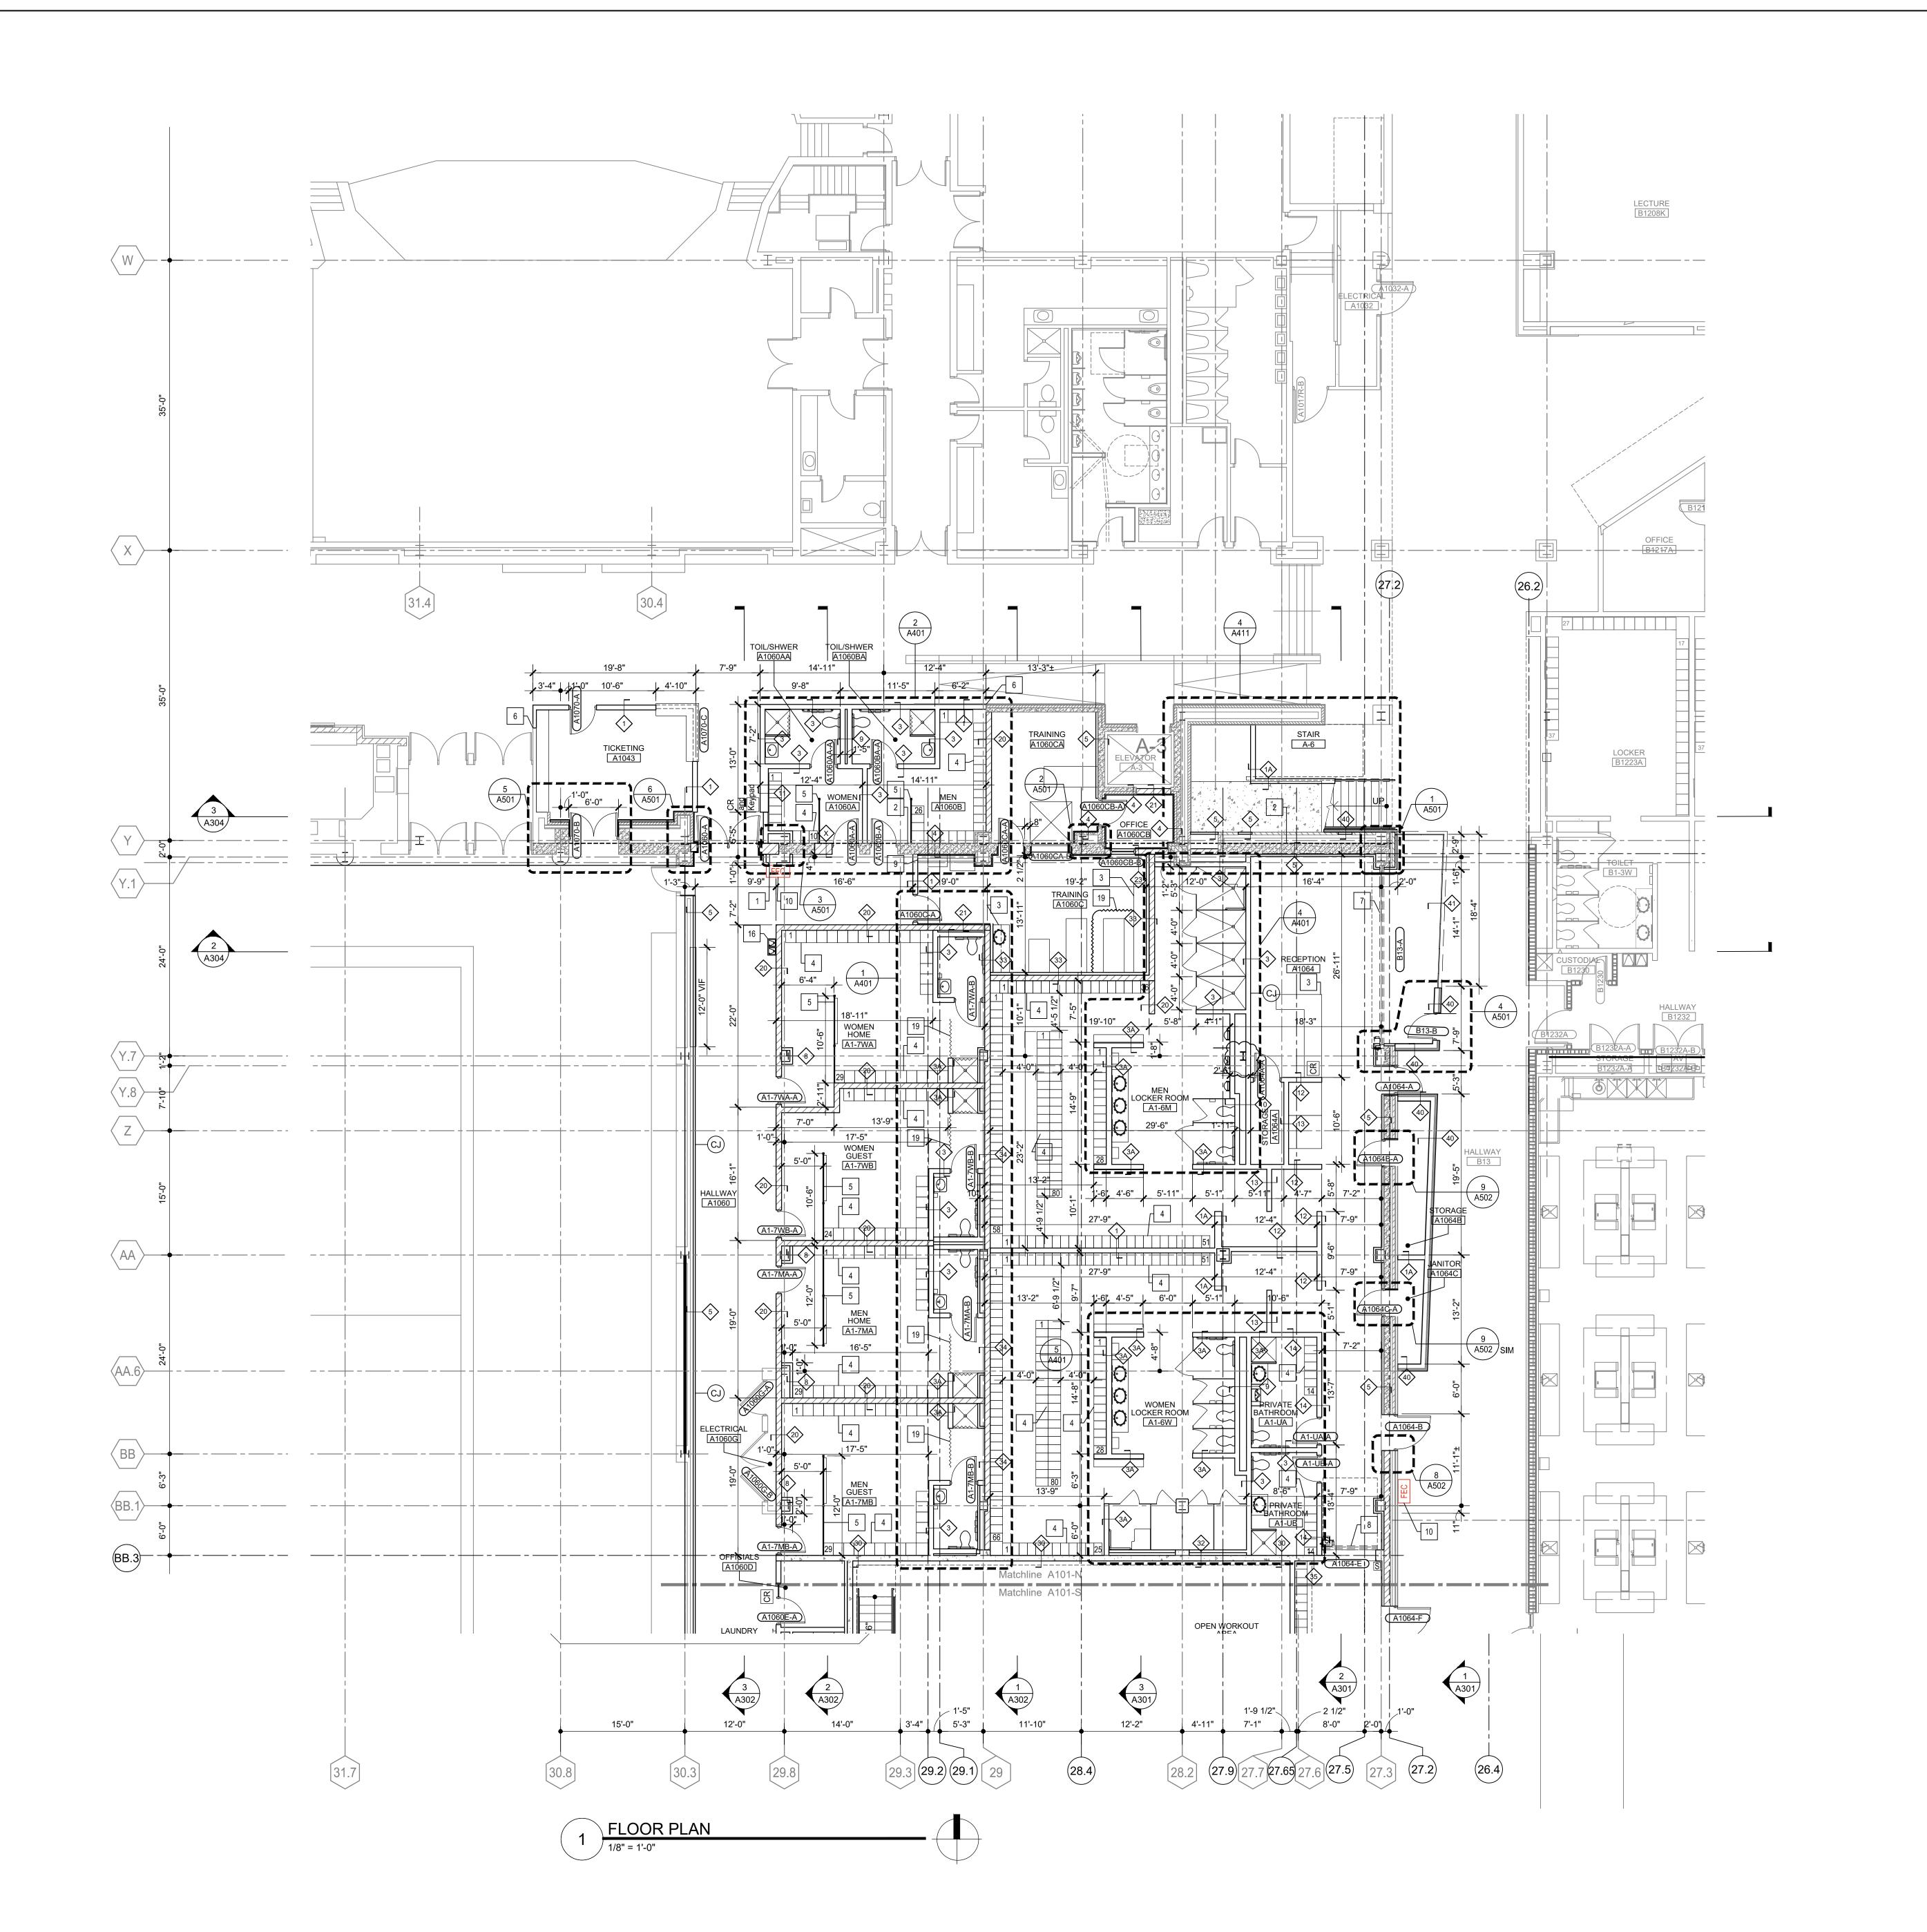

DETAILS

DEVICES.

PLAN KEY:

OTHERWISE NOTED.

OTHER TRADES AND DOCUMENTS.

5. REFER TO DRAWING A601 FOR PARTITION TYPES AND

6. REFER TO PROJECT'S GENERAL REQUIREMENTS FOR

ACCOMMODATE CASEWORK, EQUIPMENT AND OTHER

11. REFER TO FINISH PLAN AND SCHEDULE FOR INTERIOR

PROJECT CONSTRUCTION SEQUENCING.

7. DIMENSIONS ARE TO FINISHED FACE UNLESS

8. REFER TO ROOM FINISH SCHEDULE FOR FINAL

9. PROVIDE BLOCKING AND REINFORCING TO

10. COORDINATE OWNER SUPPLIED EQUIPMENT.

 REFER TO DRAWING XXX FOR GENERAL NOTES.
 REFER TO ALL DRAWINGS INCLUDING ALL OTHER DISCIPLINES FOR ADDITIONAL GENERAL NOTES, ABBREVIATIONS AND SYMBOLS.
3. GC SHALL COORDINATE MECHANICAL, ELECTRICAL,

PLUMBING ROOF, WALL SLEEVE AND SHAFTS WITH 4. FIRST FLOOR ELEVATION IS ASSUMED 100'-0" IN THESE

MADISON

MADISON COLLEGE FINISHES. PREP SURFACES TO RECEIVE FINAL FINISH. TRUAX BUILDING

FITNESS CENTER PROJECT

Madison, Wisconsin

(251A) DOOR NUMBER - L PARTITION TYPE TAG REFER TO DOOR SCHEDULE

01 WINDOW TAG

16 SPECIFIC NOTE

SPECIFIC PLAN NOTES: X

ELEVATION

1. INFILL RATED WALL OPENING, REFER TO PARTITION TYPES

2. 1" EXPANSION JOINT 3. CASEWORK, REFER TO INTERIOR ELEVATIONS

4. LOCKERS, REFER TO INTERIOR ELEVATIONS AND

ENLARGED PLANS

5. MODULAR RESIN PARTITION 6. ALIGN NEW PARTITION FLUSH WITH EXISTING

ADJACENT PARTITION COILING FIRE SHUTTER

8. SECTIONAL OVERHEAD DOOR

9. TRENCH DRAIN, REFER TO PLUMBING

10. RECESSED FIRE EXTINGUISHER CABINET

11. WASHER AND DRYER 12. TILE SHOWER, REFER TO DETAIL XXXX

13. CLEAR MAPLE SLAT SYSTEM, REFER TO INTERIOR **ELEVATIONS**

14. ARCHITECTURAL CAST IN PLACE CONCRETE

15. INSTALL EXISTING RECEPTION DESK 16. HIGH/LOW DRINKING FOUNTAIN

17. SHOE MOUNTED GLASS GUARD RAIL


18. LINEN CHUTE DOOR 19. PRIVACY CURTAIN AND TRACK

20. TILE SHOWER, REFER TO DETAIL XXXX 21. INFILL FLOOR AT STAIRS, REFER TO DETAIL XXXX

Issued for: **BID SET** 0x-xy-2020 Issue date:

AA Project No.: RFB21-001 MC Project No.: Bid Pkg No.:

REVISION

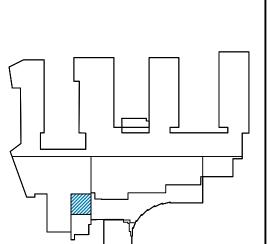

assemblage

FITNESS RENOVATION

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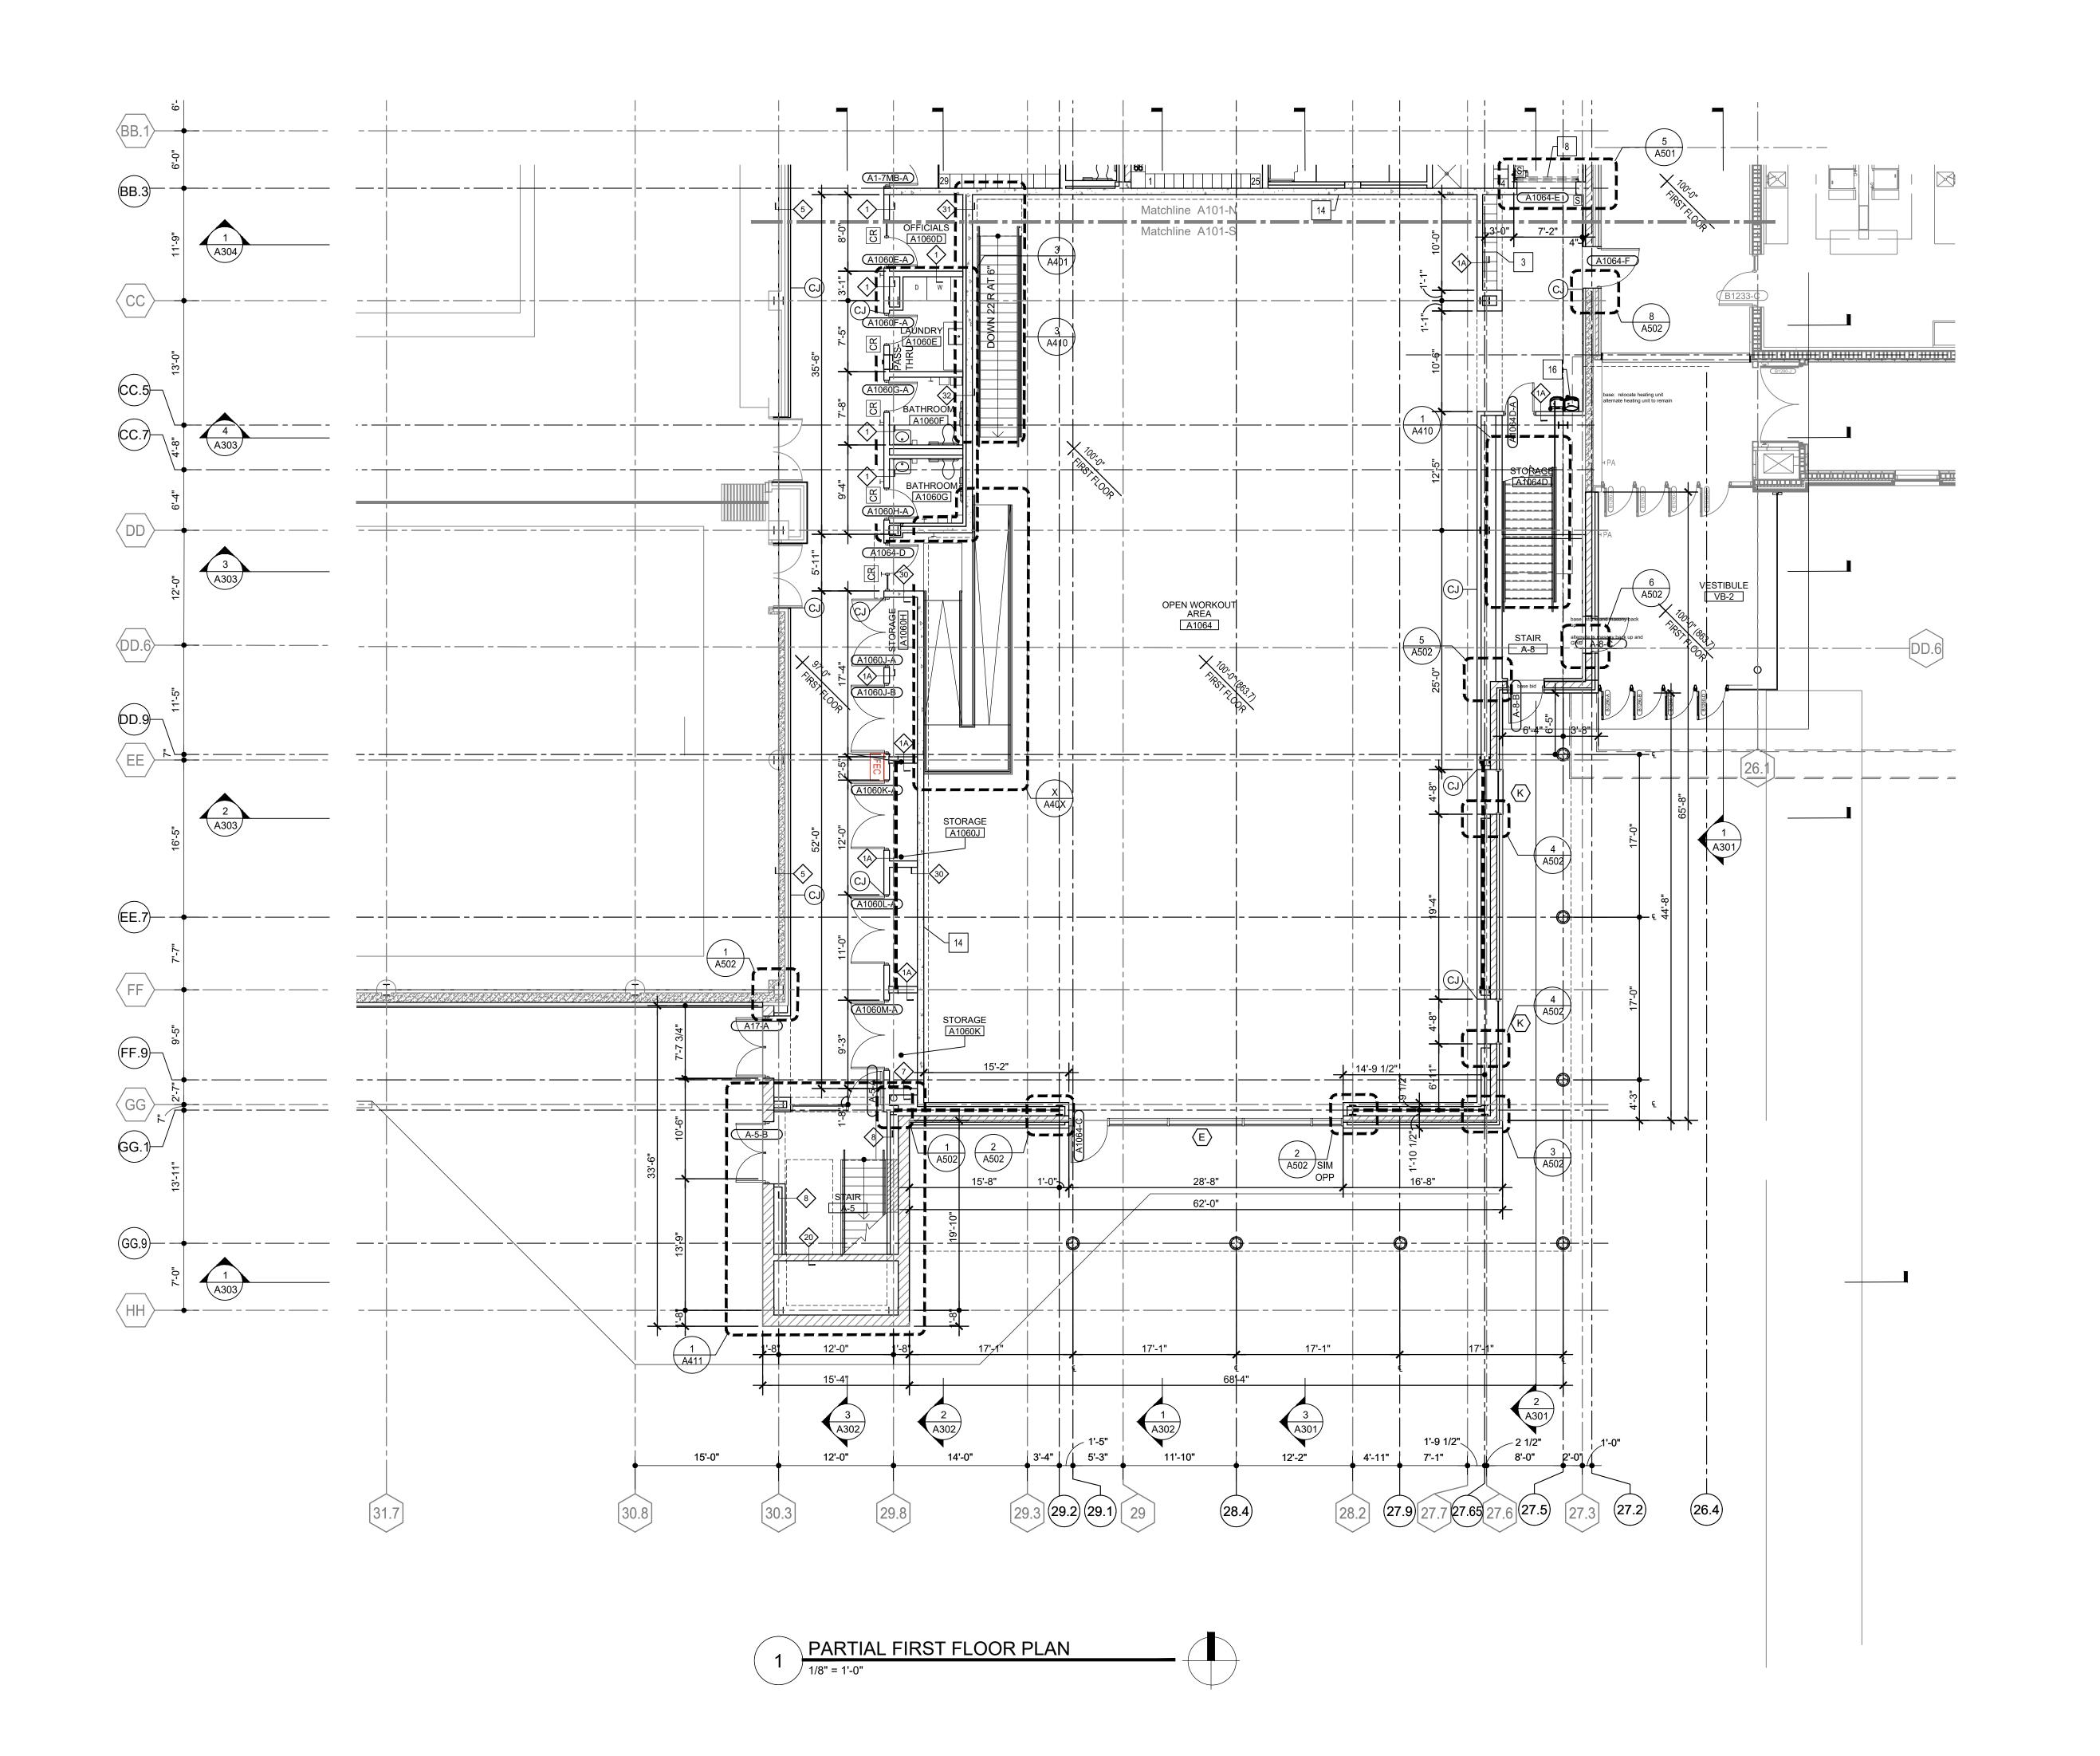
SCALE

SHEET TITLE

PARTIAL FIRST FLOOR PLAN - NORTH

SHEET NUMBER

A101-N



- REFER TO DRAWING XXX FOR GENERAL NOTES.
 REFER TO ALL DRAWINGS INCLUDING ALL OTHER
- DISCIPLINES FOR ADDITIONAL GENERAL NOTES,
 ABBREVIATIONS AND SYMBOLS.
- 3. GC SHALL COORDINATE MECHANICAL, ELECTRICAL, PLUMBING ROOF, WALL SLEEVE AND SHAFTS WITH OTHER TRADES AND DOCUMENTS.

ACCOMMODATE CASEWORK, EQUIPMENT AND OTHER

- 4. FIRST FLOOR ELEVATION IS ASSUMED 100'-0" IN THESE DRAWINGS.5. REFER TO DRAWING A601 FOR PARTITION TYPES AND
- 5. REFER TO DRAWING A601 FOR PARTITION TYP
 DETAILS

 6. REFER TO PROJECT'S GENERAL REQUIREMEN
- REFER TO PROJECT'S GENERAL REQUIREMENTS FOR
 PROJECT CONSTRUCTION SEQUENCING.
 DIMENSIONS ARE TO FINISHED FACE UNITESS.
- 7. DIMENSIONS ARE TO FINISHED FACE UNLESS
 OTHERWISE NOTED.
- OTHERWISE NOTED.

 8. REFER TO ROOM FINISH SCHEDULE FOR FINAL FINISHES. PREP SURFACES TO RECEIVE FINAL FINISH.

 9. PROVIDE BLOCKING AND REINFORCING TO
- DEVICES.

 10. COORDINATE OWNER SUPPLIED EQUIPMENT.

 11. REFER TO FINISH PLAN AND SCHEDULE FOR INTERIOR

(251A) DOOR NUMBER - REFER TO DOOR SCHEDULE

ELEVATION

PLAN KEY:

01 WINDOW TAG

16 SPECIFIC NOTE

SPECIFIC PLAN NOTES: X

1. INFILL RATED WALL OPENING, REFER TO
PARTITION TYPES

- 1" EXPANSION JOINT
 CASEWORK, REFER TO INTERIOR ELEVATIONS
- LOCKERS, REFER TO INTERIOR ELEVATIONS AND ENLARGED PLANS
- 5. MODULAR RESIN PARTITION
- 6. ALIGN NEW PARTITION FLUSH WITH EXISTING
- ADJACENT PARTITION
 7. COILING FIRE SHUTTER
- 8. SECTIONAL OVERHEAD DOOR
- 9. TRENCH DRAIN, REFER TO PLUMBING10. RECESSED FIRE EXTINGUISHER CABINET
- 11. WASHER AND DRYER
- 12. TILE SHOWER, REFER TO DETAIL XXXX13. CLEAR MAPLE SLAT SYSTEM, REFER TO INTERIOR
- ELEVATIONS

 14. ARCHITECTURAL CAST IN PLACE CONCRETE
- 15. INSTALL EXISTING RECEPTION DESK16. HIGH/LOW DRINKING FOUNTAIN
- 17. SHOE MOUNTED GLASS GUARD RAIL
- 17. SHOE MOUNTED GLASS GUA18. LINEN CHUTE DOOR
- 19. PRIVACY CURTAIN AND TRACK
- 20. TILE SHOWER, REFER TO DETAIL XXXX
- 21. INFILL FLOOR AT STAIRS, REFER TO DETAIL XXXX

MADISON AREA | TECHNICAL

MADISON

MADISON COLLEGE TRUAX BUILDING

FITNESS CENTER PROJECT

Aadison Wisconsin

Madison, Wisconsin

Issued for:

Issue date:

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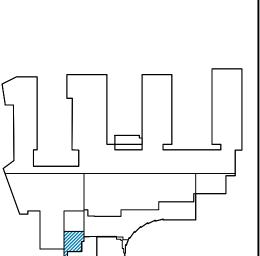
AA Project No.:

MC Project No.:

RFB21-001

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Bid Pkg No.:



FITNESS RENOVATION

assemblage ARCHITECTS 7433 Elmwood Avenue Middleton, WI 53562 T 608.827.5047

SCALE


SHEET TITLE

1/8" = 1'-0

PARTIAL FIRST FLOOR PLAN -

SHEET NUMBER

A101-S

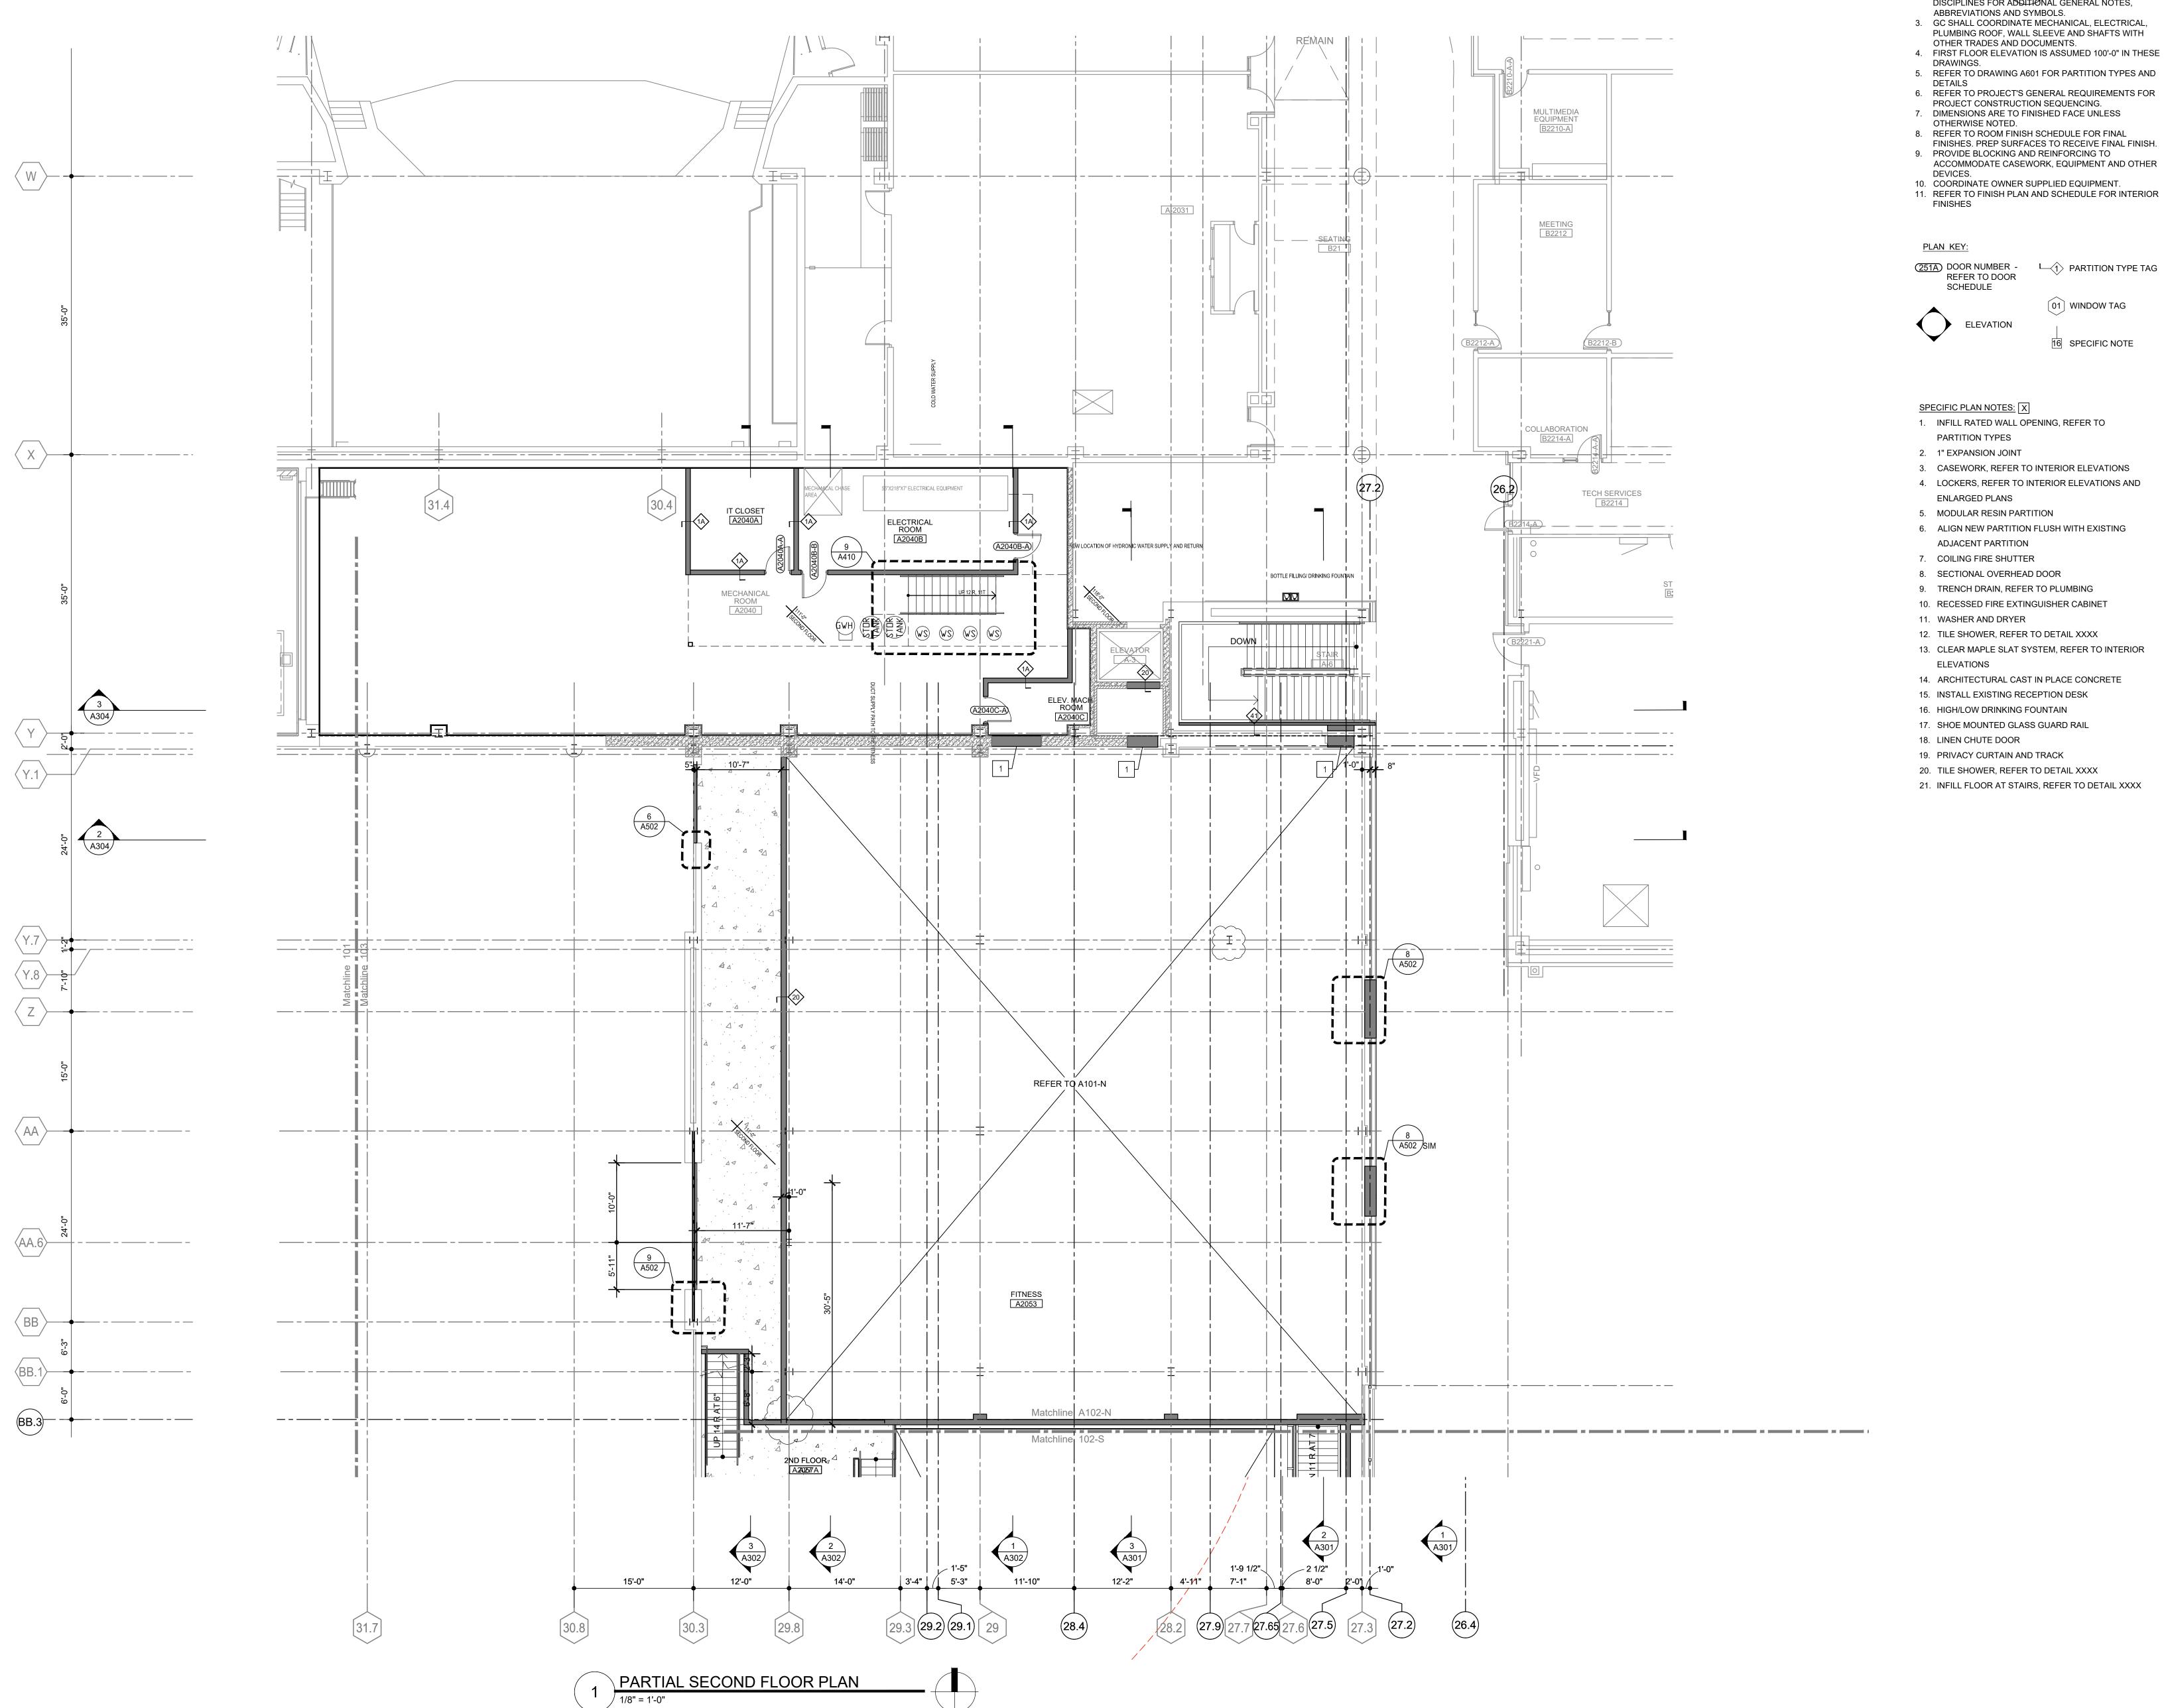

1. REFER TO DRAWING XXX FOR GENERAL NOTES. 2. REFER TO ALL DRAWINGS INCLUDING ALL OTHER

DISCIPLINES FOR ADDITIONAL GENERAL NOTES, ABBREVIATIONS AND SYMBOLS.

3. GC SHALL COORDINATE MECHANICAL, ELECTRICAL, PLUMBING ROOF, WALL SLEEVE AND SHAFTS WITH OTHER TRADES AND DOCUMENTS. 4. FIRST FLOOR ELEVATION IS ASSUMED 100'-0" IN THESE

5. REFER TO DRAWING A601 FOR PARTITION TYPES AND

DETAILS 6. REFER TO PROJECT'S GENERAL REQUIREMENTS FOR

PROJECT CONSTRUCTION SEQUENCING. 7. DIMENSIONS ARE TO FINISHED FACE UNLESS

9. PROVIDE BLOCKING AND REINFORCING TO ACCOMMODATE CASEWORK, EQUIPMENT AND OTHER DEVICES. 10. COORDINATE OWNER SUPPLIED EQUIPMENT. 11. REFER TO FINISH PLAN AND SCHEDULE FOR INTERIOR

PLAN KEY:

(251A) DOOR NUMBER - L PARTITION TYPE TAG REFER TO DOOR SCHEDULE

01 WINDOW TAG

16 SPECIFIC NOTE

SPECIFIC PLAN NOTES: X 1. INFILL RATED WALL OPENING, REFER TO PARTITION TYPES

2. 1" EXPANSION JOINT 3. CASEWORK, REFER TO INTERIOR ELEVATIONS

4. LOCKERS, REFER TO INTERIOR ELEVATIONS AND **ENLARGED PLANS**

5. MODULAR RESIN PARTITION 6. ALIGN NEW PARTITION FLUSH WITH EXISTING

ADJACENT PARTITION COILING FIRE SHUTTER

8. SECTIONAL OVERHEAD DOOR 9. TRENCH DRAIN, REFER TO PLUMBING

10. RECESSED FIRE EXTINGUISHER CABINET

11. WASHER AND DRYER

13. CLEAR MAPLE SLAT SYSTEM, REFER TO INTERIOR

ELEVATIONS 14. ARCHITECTURAL CAST IN PLACE CONCRETE

15. INSTALL EXISTING RECEPTION DESK 16. HIGH/LOW DRINKING FOUNTAIN

17. SHOE MOUNTED GLASS GUARD RAIL

18. LINEN CHUTE DOOR

20. TILE SHOWER, REFER TO DETAIL XXXX

21. INFILL FLOOR AT STAIRS, REFER TO DETAIL XXXX

MADISON



MADISON COLLEGE TRUAX BUILDING

FITNESS CENTER PROJECT

Madison, Wisconsin

Issued for: **BID SET** 0x-xy-2020

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1/8" = 1'-0"


SCALE

SHEET TITLE

PARTIAL SECOND FLOOR PLAN - NORTH

SHEET NUMBER

A102-N

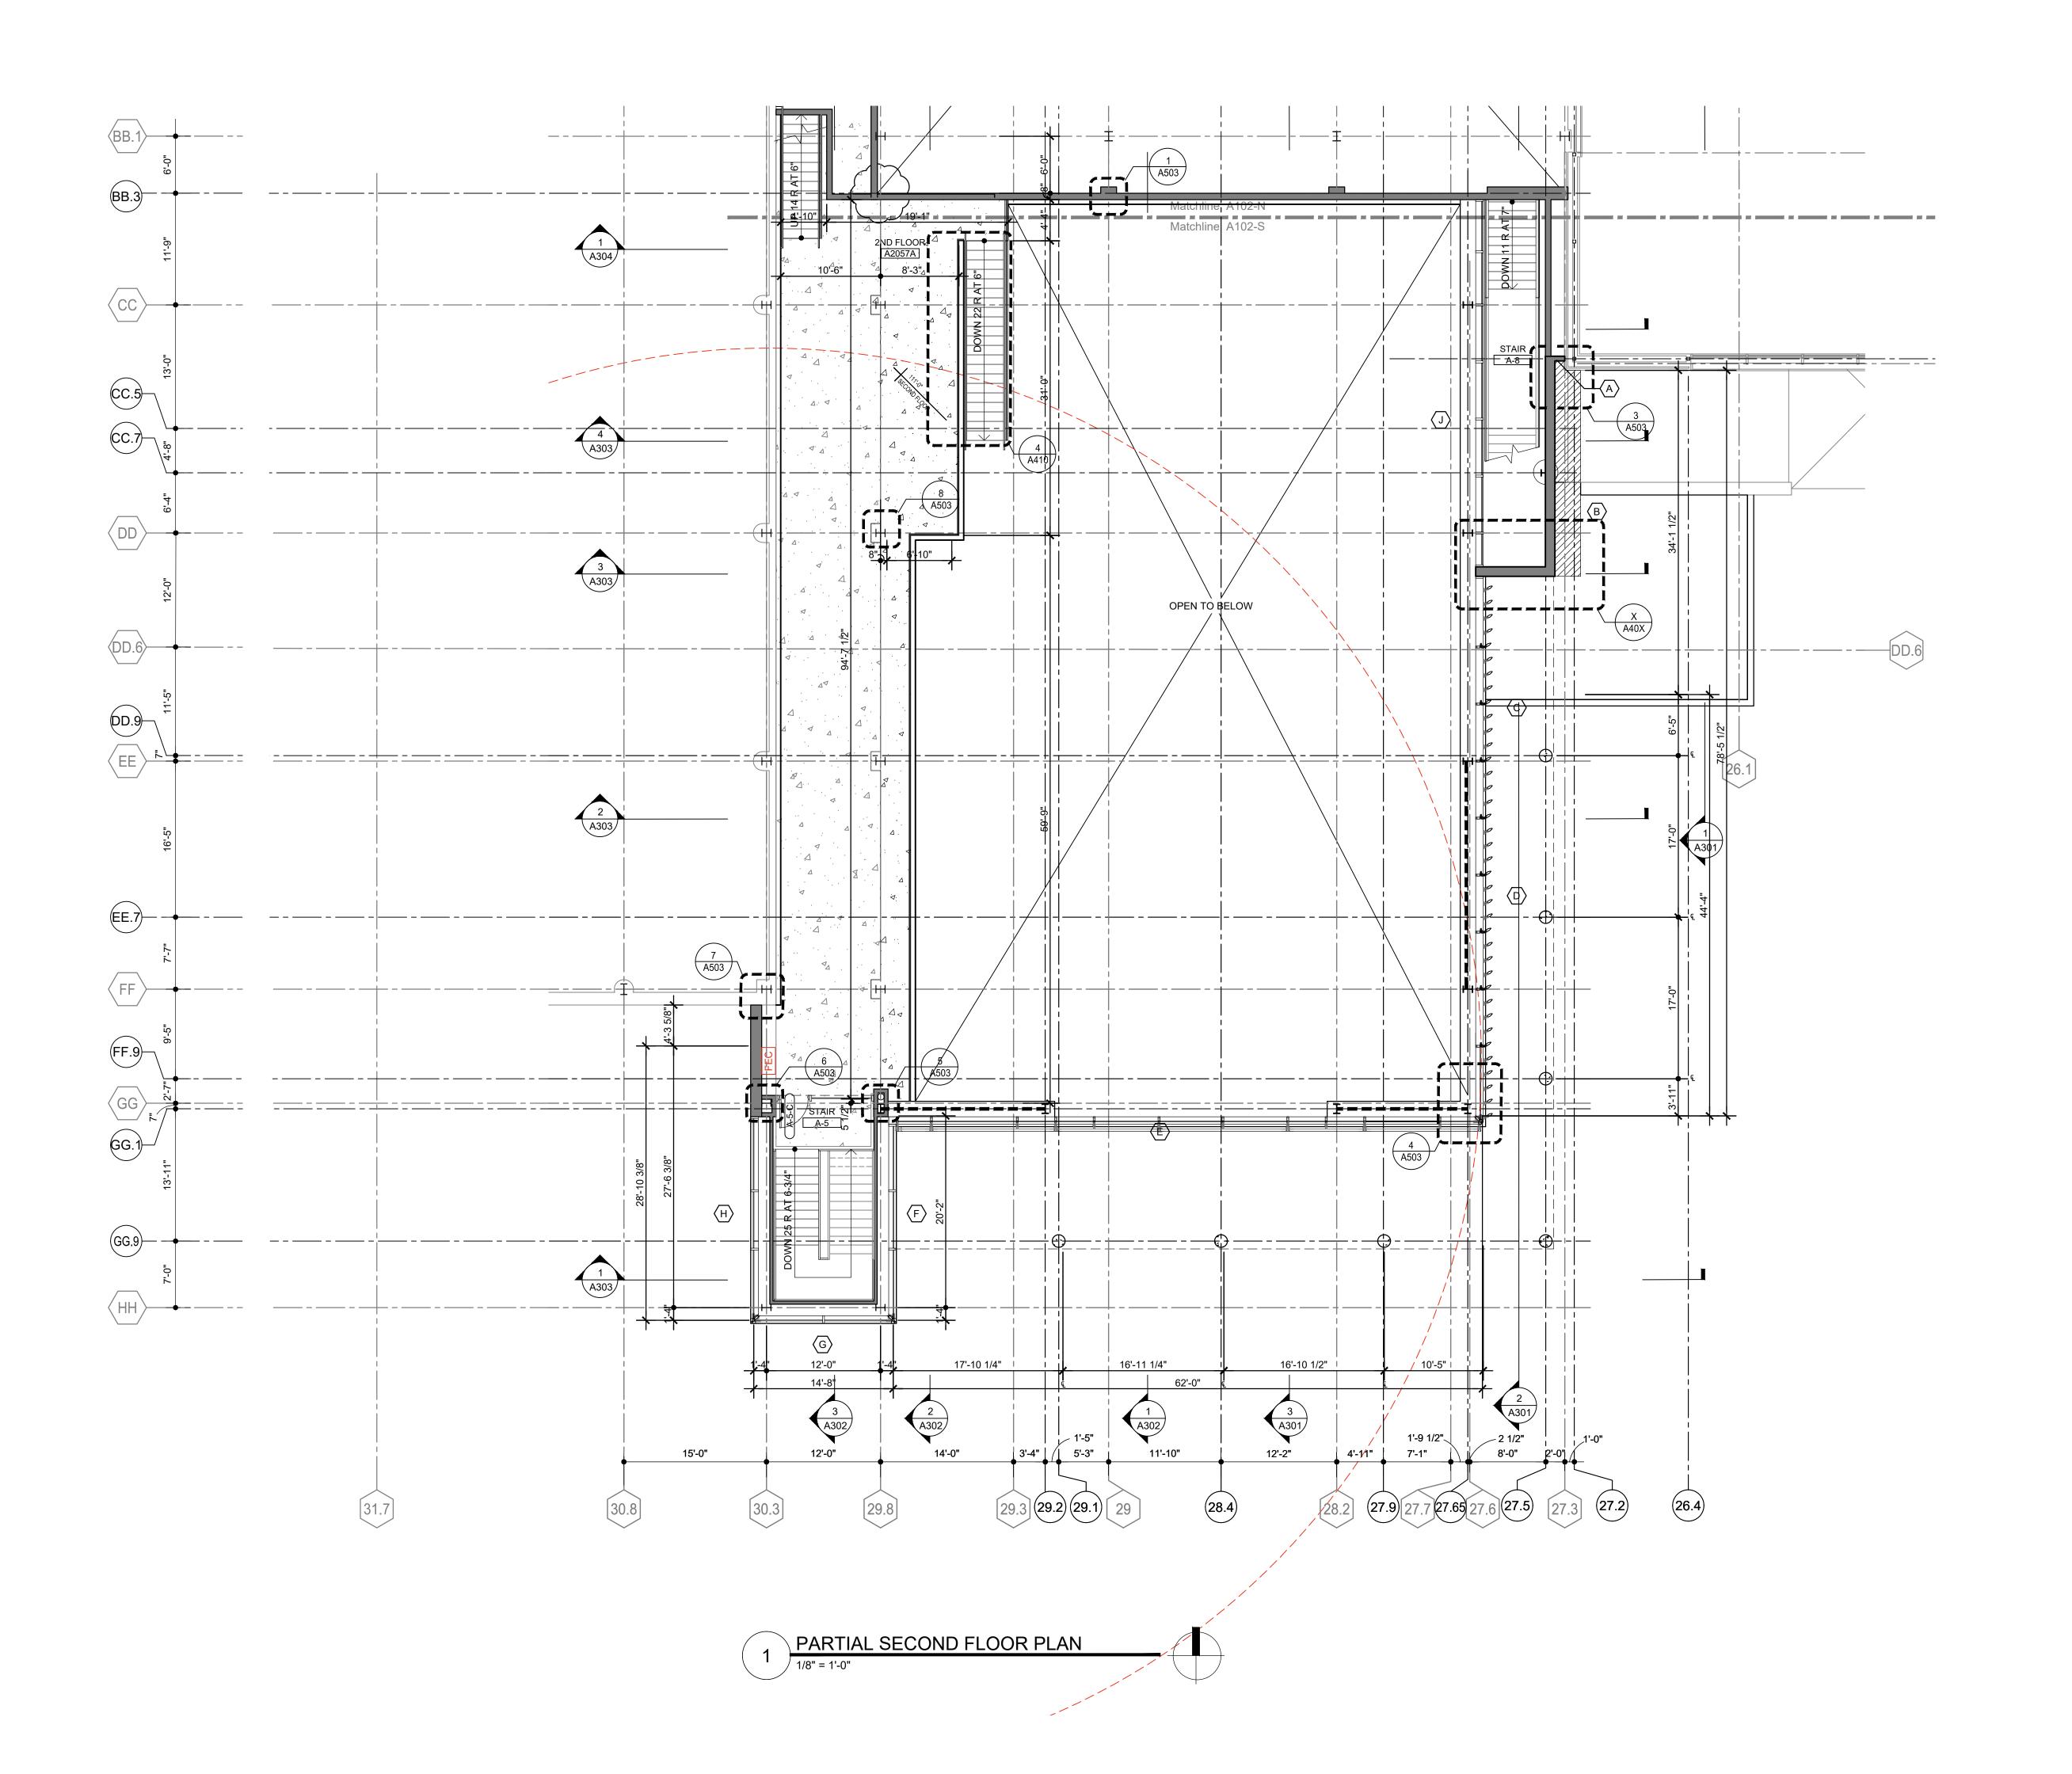

- 1. REFER TO DRAWING XXX FOR GENERAL NOTES. 2. REFER TO ALL DRAWINGS INCLUDING ALL OTHER
- DISCIPLINES FOR ADDITIONAL GENERAL NOTES, ABBREVIATIONS AND SYMBOLS.
- 3. GC SHALL COORDINATE MECHANICAL, ELECTRICAL, PLUMBING ROOF, WALL SLEEVE AND SHAFTS WITH OTHER TRADES AND DOCUMENTS.
- 4. FIRST FLOOR ELEVATION IS ASSUMED 100'-0" IN THESE DRAWINGS.
- 5. REFER TO DRAWING A601 FOR PARTITION TYPES AND DETAILS
- 6. REFER TO PROJECT'S GENERAL REQUIREMENTS FOR PROJECT CONSTRUCTION SEQUENCING.
- 7. DIMENSIONS ARE TO FINISHED FACE UNLESS OTHERWISE NOTED.
- 8. REFER TO ROOM FINISH SCHEDULE FOR FINAL FINISHES. PREP SURFACES TO RECEIVE FINAL FINISH. 9. PROVIDE BLOCKING AND REINFORCING TO
- DEVICES. 10. COORDINATE OWNER SUPPLIED EQUIPMENT. 11. REFER TO FINISH PLAN AND SCHEDULE FOR INTERIOR

FINISHES

ACCOMMODATE CASEWORK, EQUIPMENT AND OTHER

PLAN KEY:

251A) DOOR NUMBER - L_1 PARTITION TYPE TAG REFER TO DOOR SCHEDULE

01 WINDOW TAG **ELEVATION**

16 SPECIFIC NOTE

SPECIFIC PLAN NOTES: X

 INFILL RATED WALL OPENING, REFER TO PARTITION TYPES

- 2. 1" EXPANSION JOINT 3. CASEWORK, REFER TO INTERIOR ELEVATIONS
- 4. LOCKERS, REFER TO INTERIOR ELEVATIONS AND
- ENLARGED PLANS 5. MODULAR RESIN PARTITION
- 6. ALIGN NEW PARTITION FLUSH WITH EXISTING ADJACENT PARTITION
- COILING FIRE SHUTTER
- 8. SECTIONAL OVERHEAD DOOR
- 9. TRENCH DRAIN, REFER TO PLUMBING 10. RECESSED FIRE EXTINGUISHER CABINET
- 11. WASHER AND DRYER
- 12. TILE SHOWER, REFER TO DETAIL XXXX 13. CLEAR MAPLE SLAT SYSTEM, REFER TO INTERIOR
- **ELEVATIONS** 14. ARCHITECTURAL CAST IN PLACE CONCRETE
- 15. INSTALL EXISTING RECEPTION DESK
- 16. HIGH/LOW DRINKING FOUNTAIN 17. SHOE MOUNTED GLASS GUARD RAIL
- 18. LINEN CHUTE DOOR
- 19. PRIVACY CURTAIN AND TRACK
- 20. TILE SHOWER, REFER TO DETAIL XXXX 21. INFILL FLOOR AT STAIRS, REFER TO DETAIL XXXX

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TRUAX BUILDING FITNESS CENTER PROJECT

| Madison, Wisconsin

Issued for: **BID SET** 0x-xy-2020 Issue date: AA Project No.: RFB21-001 MC Project No.:

REVISION DATE

Bid Pkg No.:

FITNESS RENOVATION


assemblage ARCHITECTS 7433 Elmwood Avenue Middleton, WI 53562 T 608.827.5047


SHEET TITLE

PARTIAL SECOND FLOOR PLAN - SOUTH

SHEET NUMBER


A102-S

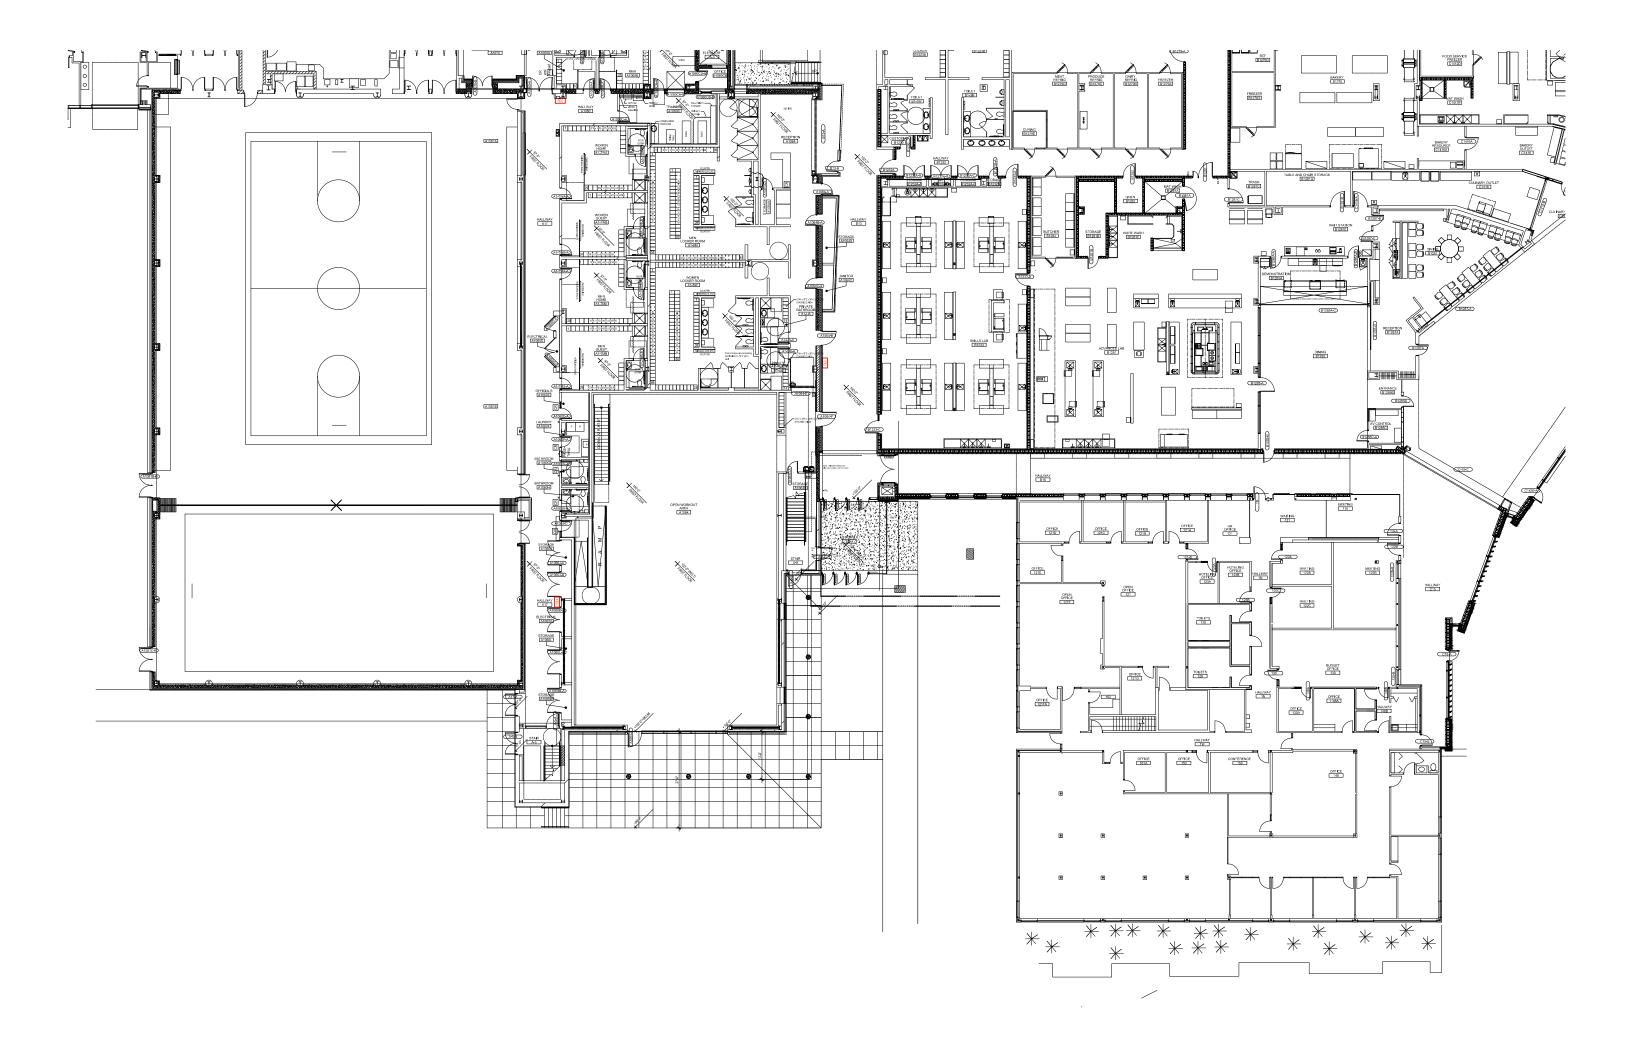


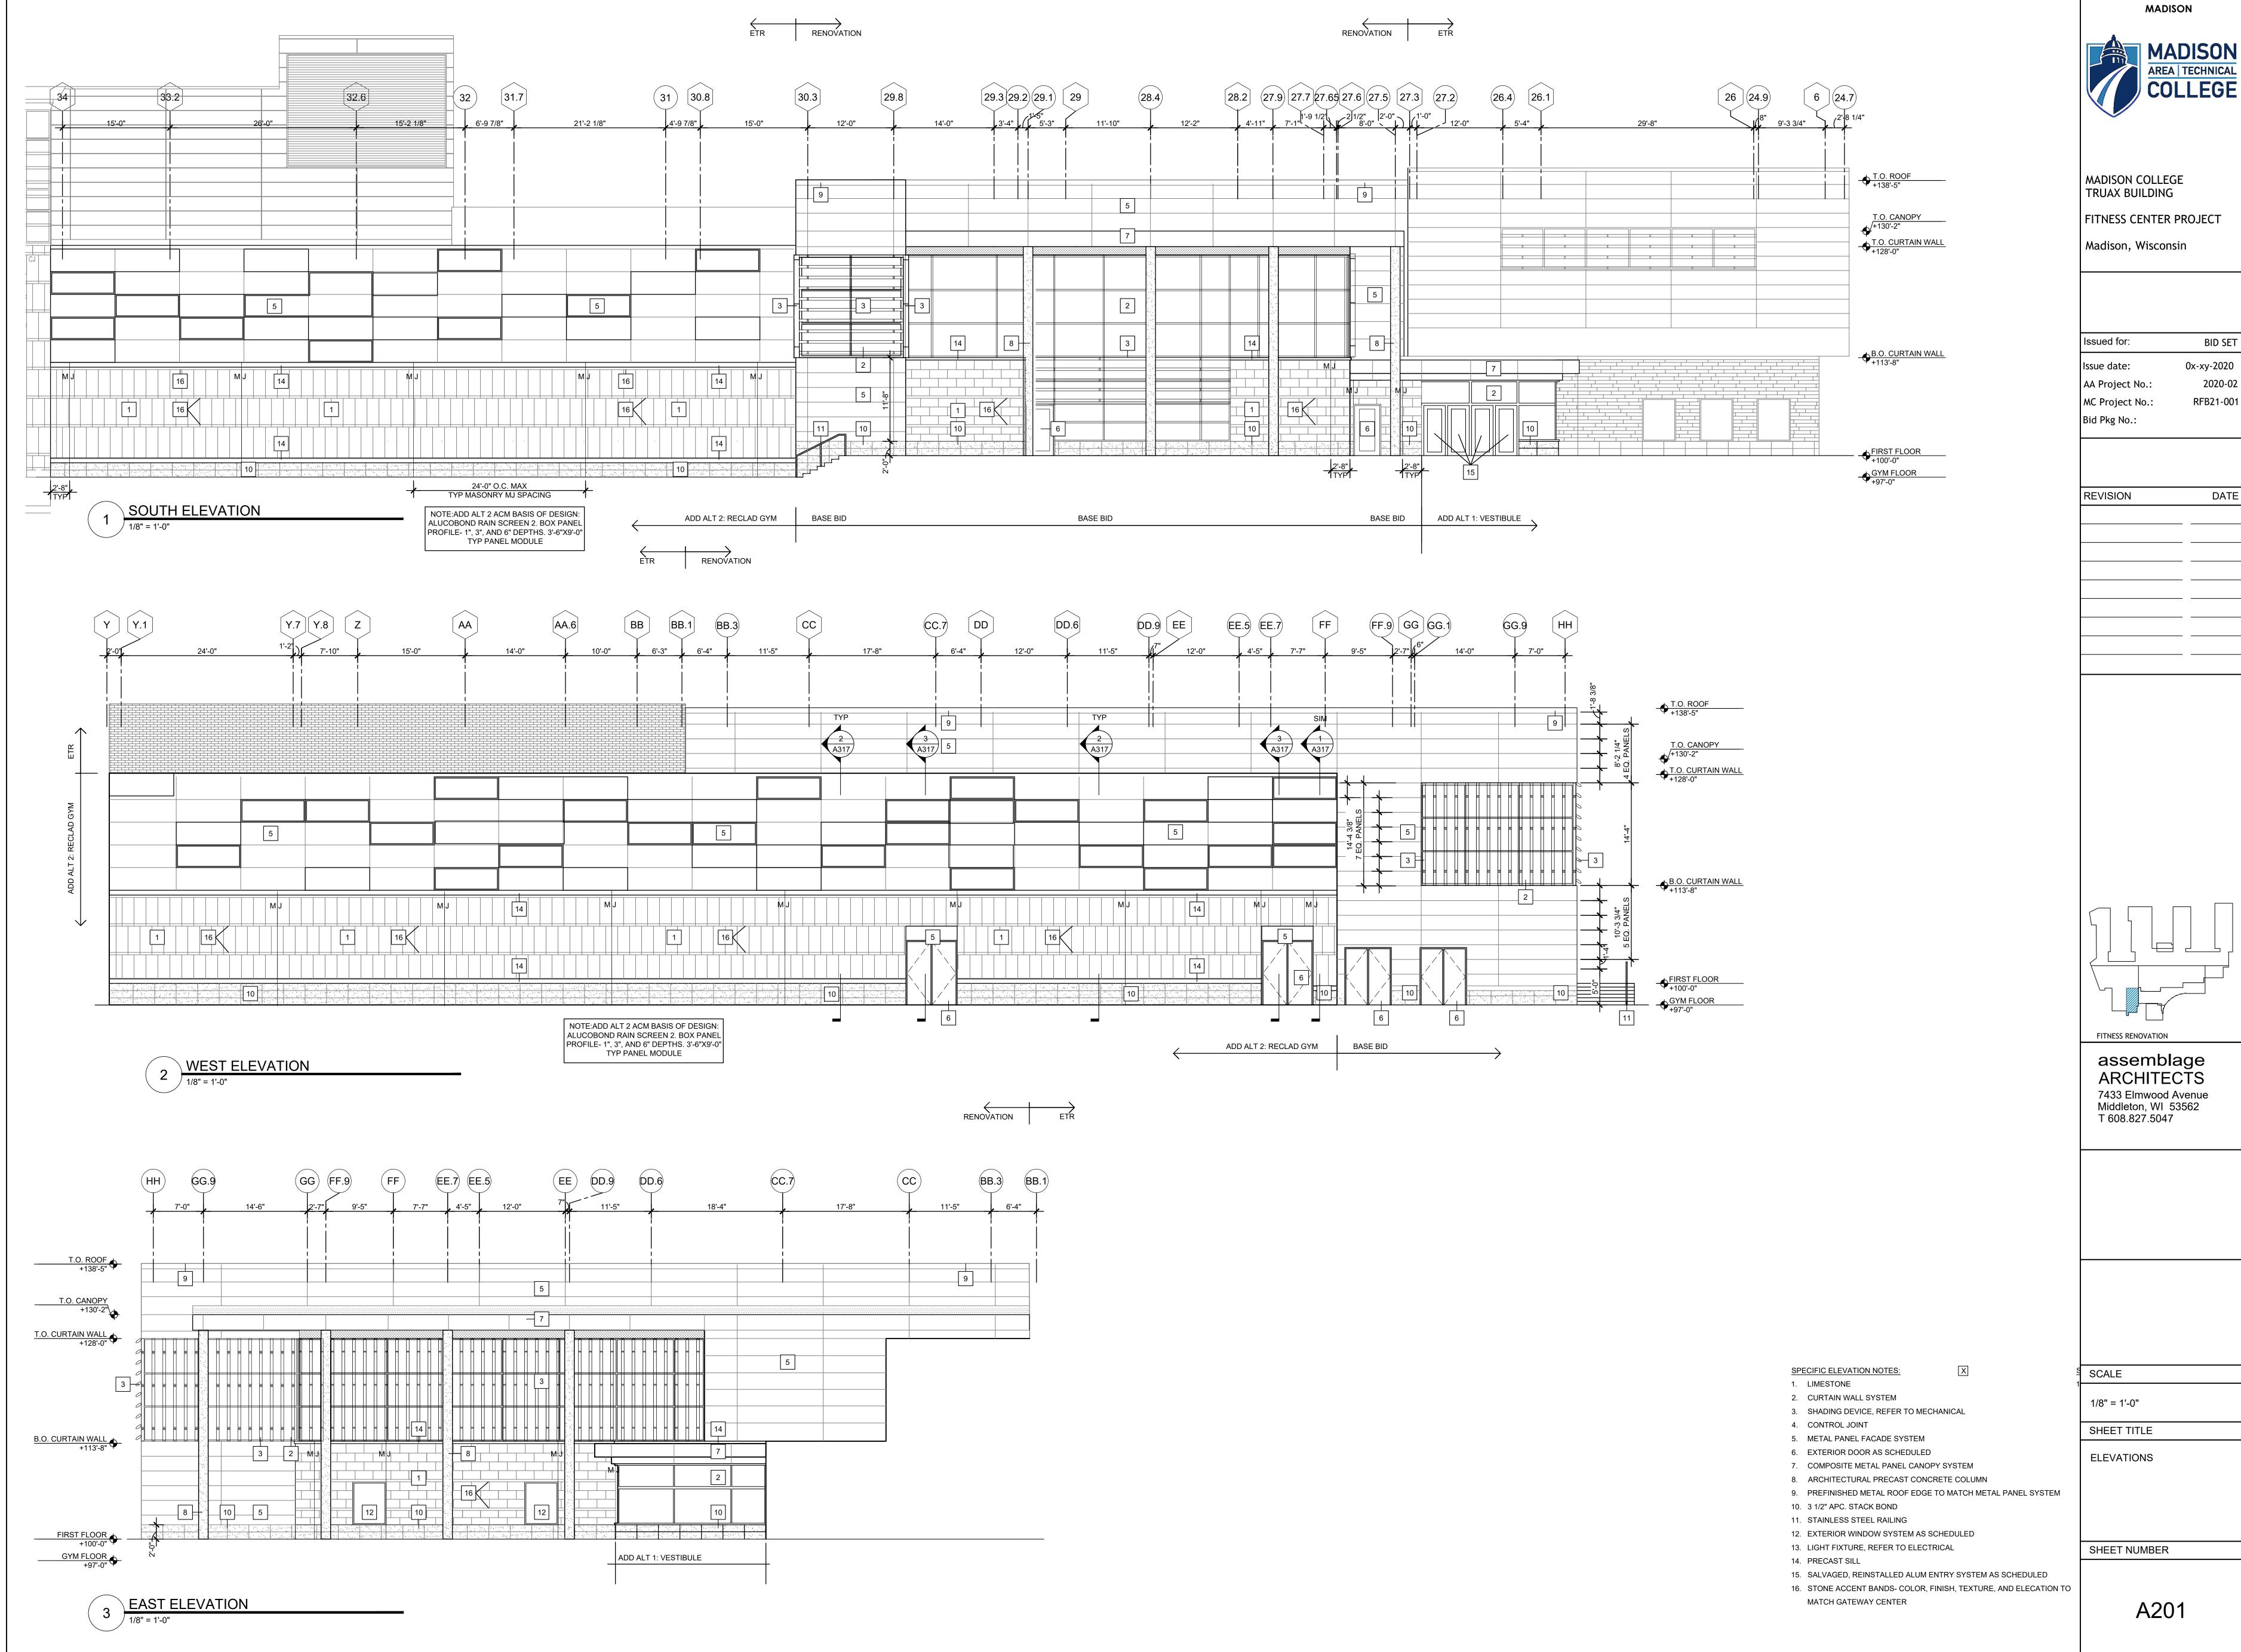

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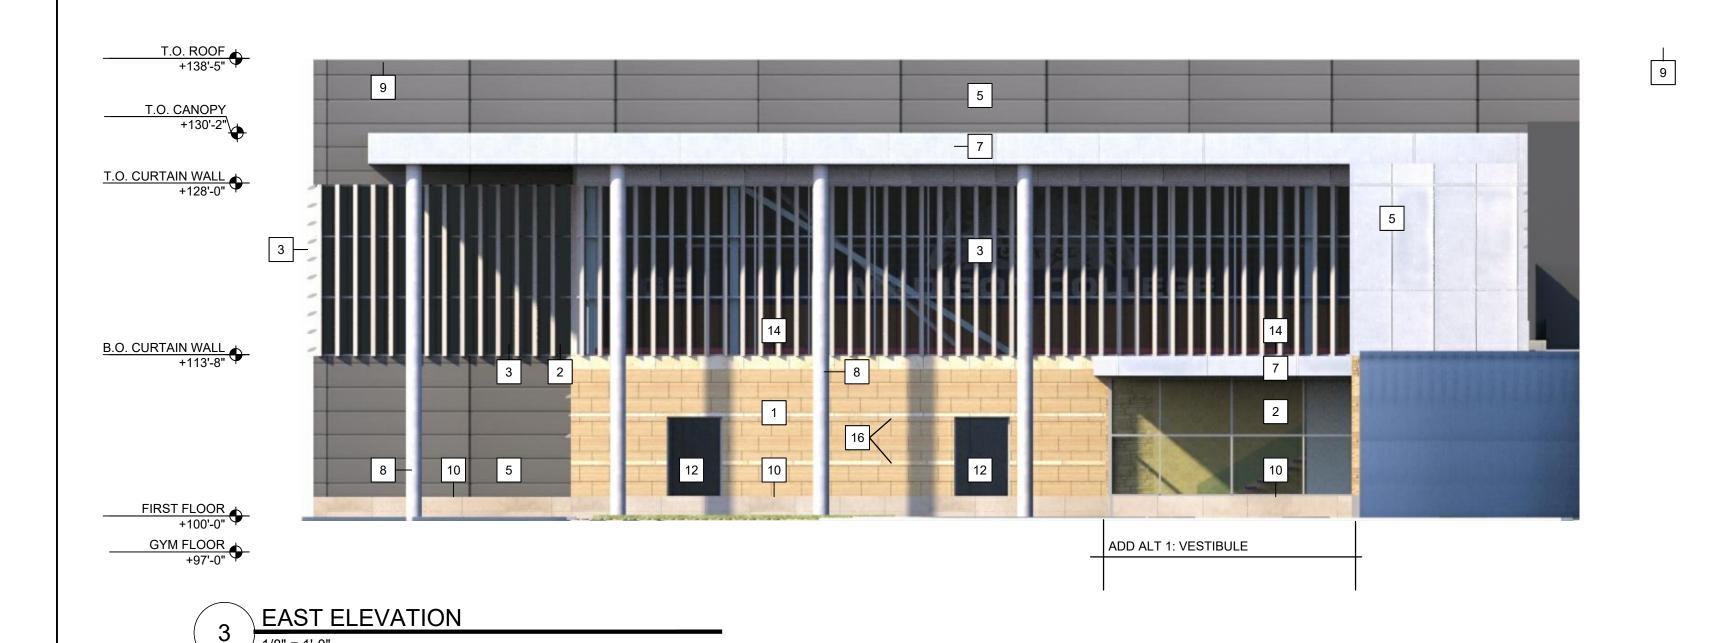
0x-xy-2020 2020-02 RFB21-001



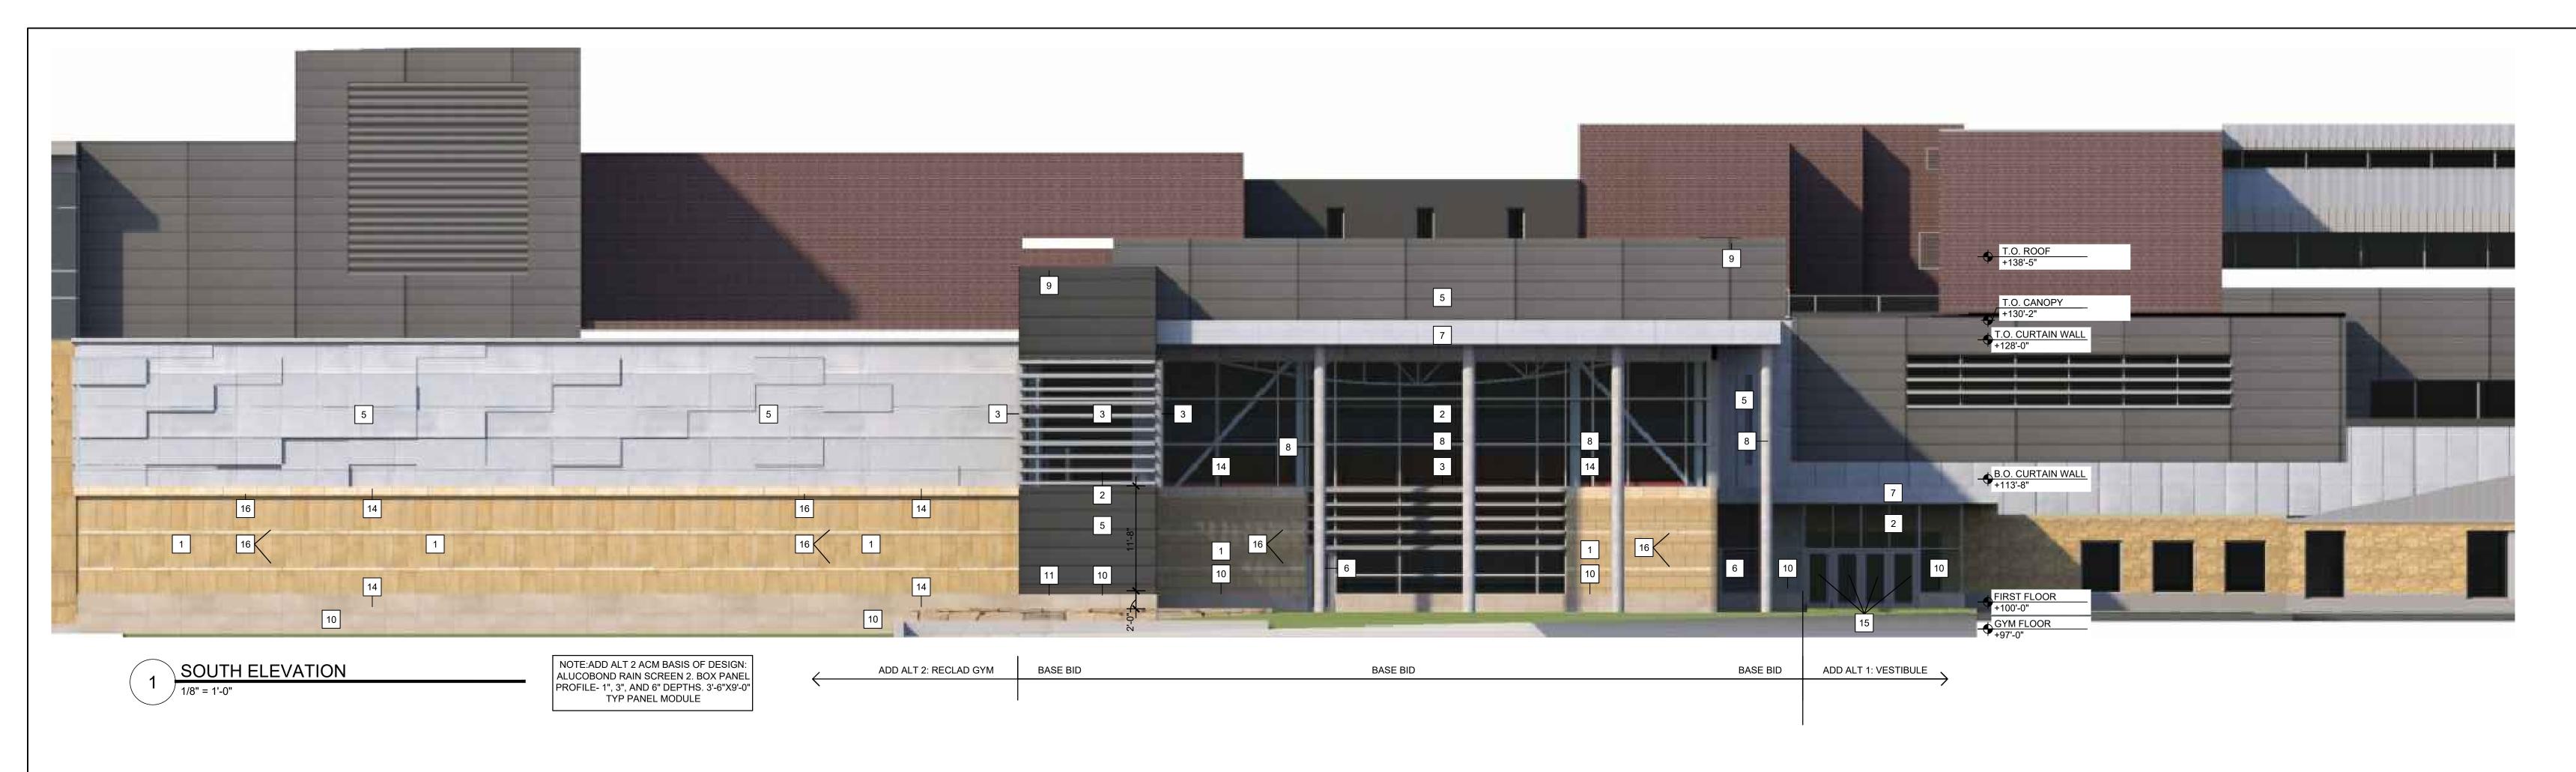

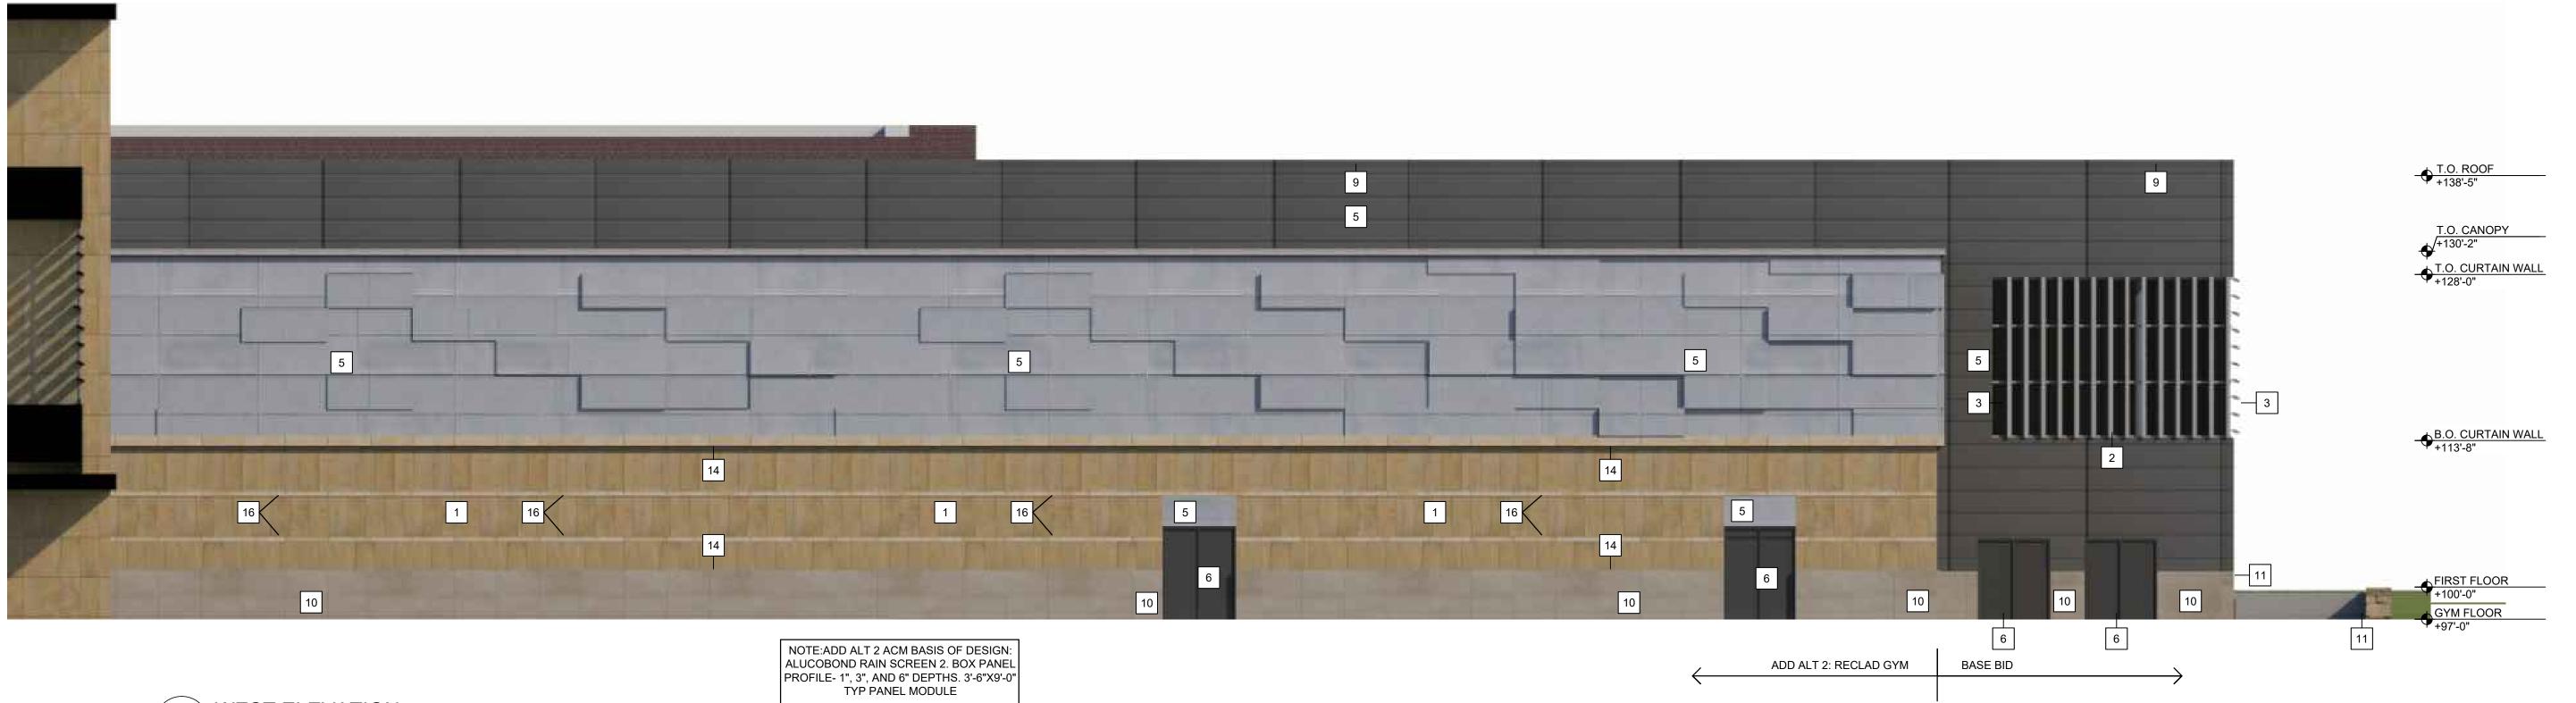2 WEST ELEVATION

1/8" = 1'-0"



1. LIMESTONE

2. CURTAIN WALL SYSTEM

3. SHADING DEVICE, REFER TO MECHANICAL

4. CONTROL JOINT

5. METAL PANEL FACADE SYSTEM

6. EXTERIOR DOOR AS SCHEDULED 7. COMPOSITE METAL PANEL CANOPY SYSTEM

8. ARCHITECTURAL PRECAST CONCRETE COLUMN 9. PREFINISHED METAL ROOF EDGE TO MATCH METAL PANEL SYSTEM

10. 3 1/2" APC. STACK BOND 11. STAINLESS STEEL RAILING

12. EXTERIOR WINDOW SYSTEM AS SCHEDULED

13. LIGHT FIXTURE, REFER TO ELECTRICAL

14. PRECAST SILL 15. SALVAGED, REINSTALLED ALUM ENTRY SYSTEM AS SCHEDULED

16. STONE ACCENT BANDS- COLOR, FINISH, TEXTURE, AND ELECATION TO MATCH GATEWAY CENTER

MADISON



MADISON COLLEGE TRUAX BUILDING

Madison, Wisconsin

FITNESS CENTER PROJECT

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SCALE

1/8" = 1'-0"

SHEET TITLE

ELEVATIONS

SHEET NUMBER

A201