6003, 6019, 6035, 6015 GEMINI DRIVE GRAND VIEW COMMONS BLOCK B MADISON, WI 53718




UDC FINAL SUBMITTAL

AUGUST 12, 2020





JLA PROJECT NUMBER: 20-0302

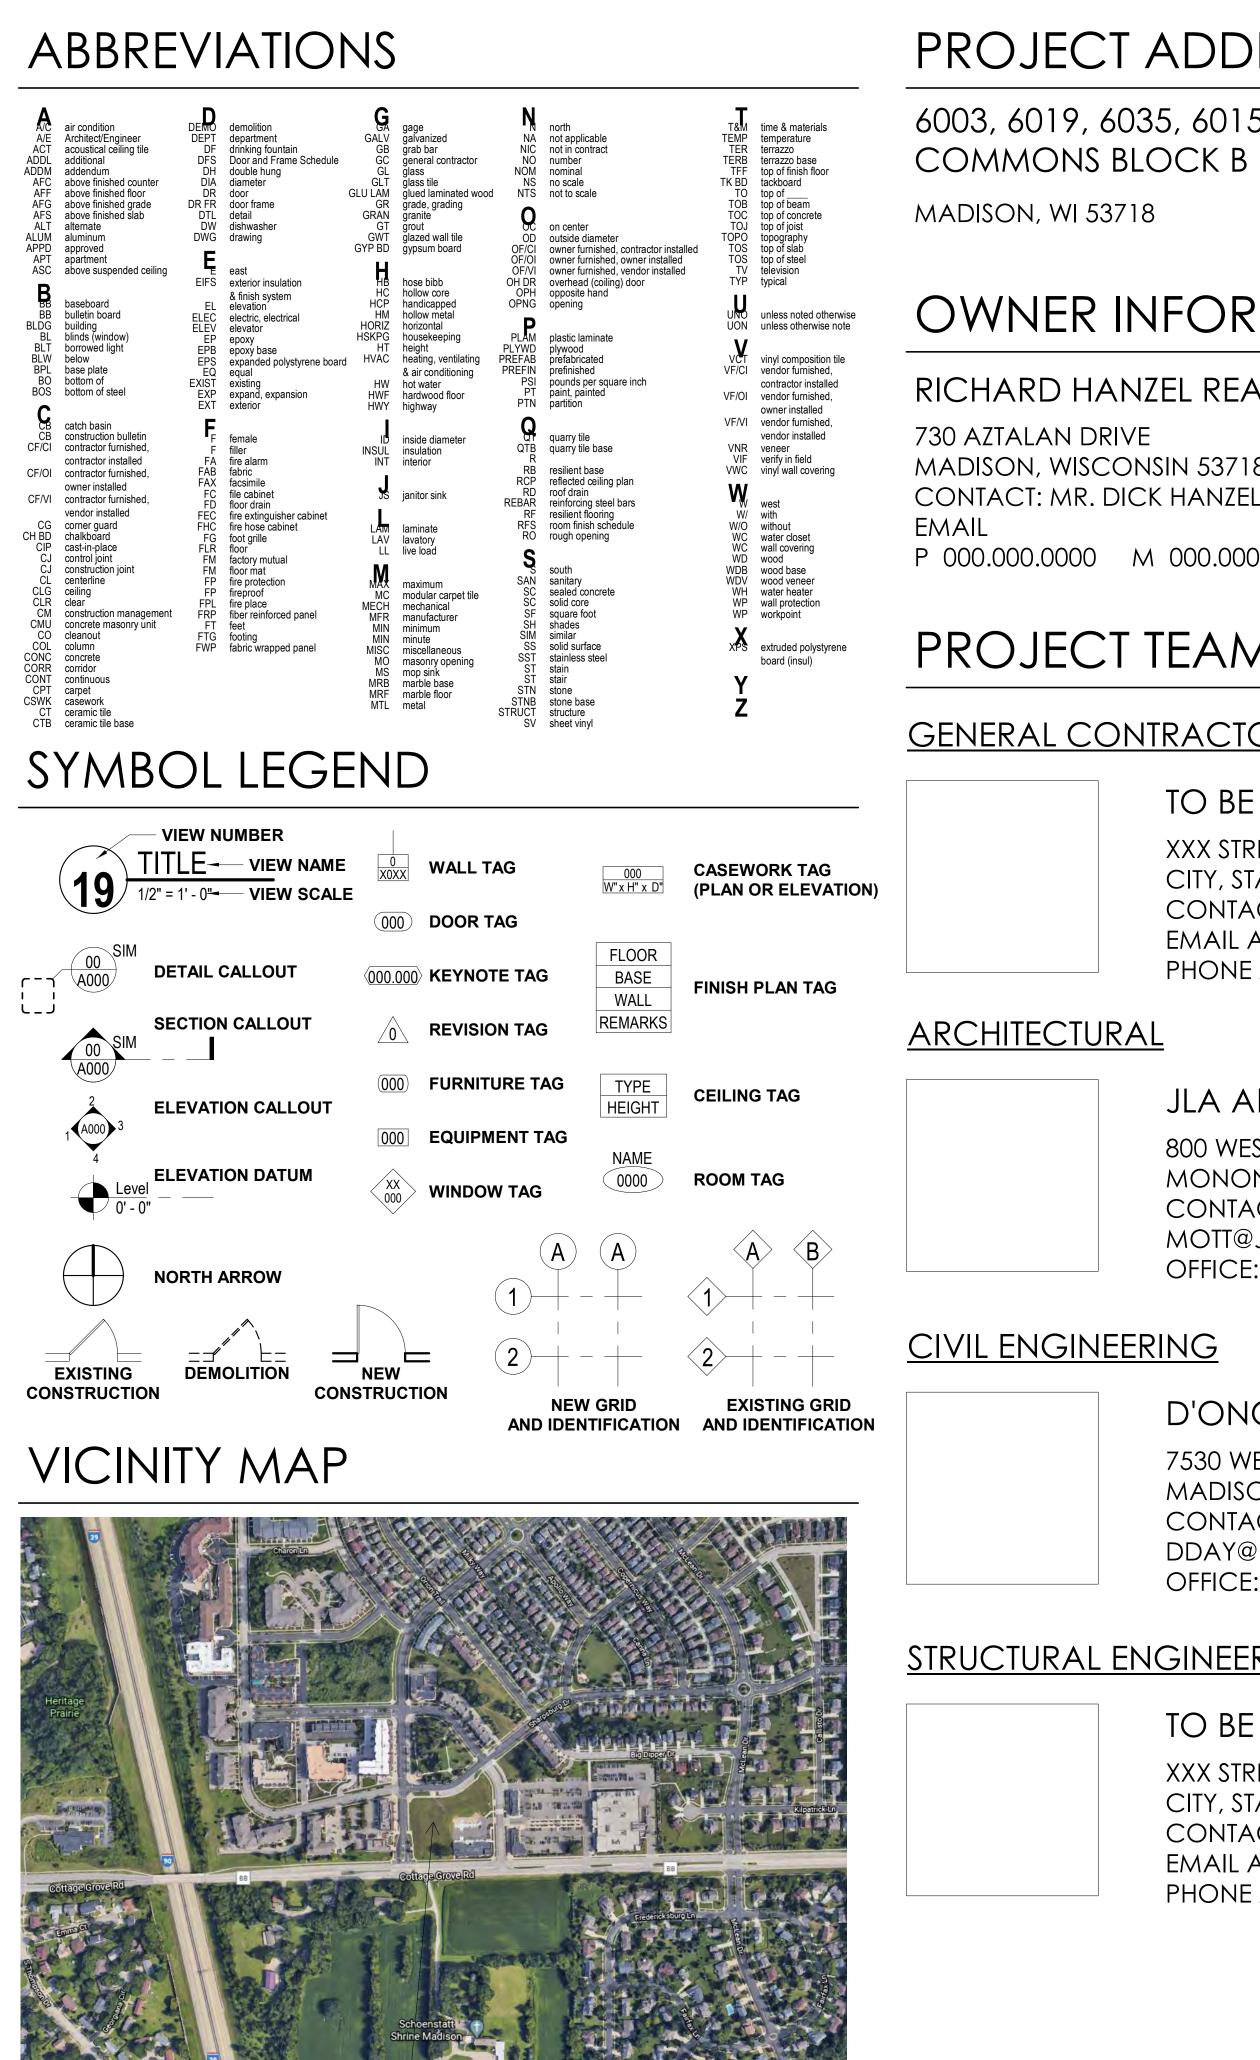

PROJECT LOCATION -

PROJECT ADDRESS

6003, 6019, 6035, 6015 GEMINI DRIVE GRAND VIEW COMMONS BLOCK B

OWNER INFORMATION

RICHARD HANZEL REAL-ESTATE SERVICES

MADISON, WISCONSIN 53718

P 000.000.0000 M 000.0000

PROJECT TEAM

GENERAL CONTRACTOR

TO BE DETERMINED

XXX STREET NAME CITY, STATE, ZIP CODE CONTACT: MR. XX XX EMAIL ADDRESS PHONE AND FAX

JLA ARCHITECTS & PLANNERS

800 WEST BROADWAY - SUITE 200 MONONA, WISCONSIN 53713 CONTACT: MR. MARC OTT MOTT@JLA-AP.COM OFFICE: 608.241.9500 DIRECT: 608.442.3867

D'ONOFRIO KOTTKE AND ASSOCIATES

7530 WESTWARD WAY MADISON, WISCONSIN 53717 CONTACT: MR. DAN DAY DDAY@DONOFRIO.CC OFFICE: 608.833.7530

STRUCTURAL ENGINEERING

TO BE DETERMINED

XXX STREET NAME CITY, STATE, ZIP CODE CONTACT: MR. XX XX EMAIL ADDRESS PHONE AND FAX

SET ISSUE

UDC FINAL SUBMITTAL AUGUST 12, 2020

SHEET INDEX

SHEET DISCIPLINE AN	DNUMBER
GENERAL	
G000	COVER
G 0 0 1	INDEX SHEET
ARCHITECTURAL SITE	
A \$ 1 0 0	ARCHITECTURAL SITE LA
CIVIL	
C100	EXISTING CONDITIONS N
C101	SITE PLAN
C102	GRADING & EROSION CC
C103	UTILITY PLAN
C104	SITE DETAILS
C105	FIRE ACCESS PLAN
CIVIL - LANDSCAPE	
L100	LANDSCAPE PLAN
L100	LANDSCAPE PLAN
L100 CIVIL - SITE LIGHTINC	
CIVIL - SITE LIGHTING	
	j
CIVIL – SITE LIGHTINC ES	j
CIVIL - SITE LIGHTING	j
CIVIL – SITE LIGHTINC ES ARCHITECTURAL A099	LIGHTING LAYOUT
CIVIL – SITE LIGHTING ES ARCHITECTURAL A099 A100	LIGHTING LAYOUT
CIVIL – SITE LIGHTING ES ARCHITECTURAL A099 A100 A101	LIGHTING LAYOUT LOWER LEVEL 2 PLAN LOWER LEVEL 1 PLAN
CIVIL – SITE LIGHTINC ES ARCHITECTURAL A099 A100 A101 A102	LIGHTING LAYOUT LOWER LEVEL 2 PLAN LOWER LEVEL 1 PLAN FIRST FLOOR PLAN
CIVIL – SITE LIGHTINC ES ARCHITECTURAL A099 A100 A101 A102 A104	LIGHTING LAYOUT LOWER LEVEL 2 PLAN LOWER LEVEL 2 PLAN FIRST FLOOR PLAN SECOND FLOOR PLAN FOURTH FLOOR PLAN
CIVIL - SITE LIGHTINC ES ARCHITECTURAL A099 A100 A101 A102 A104 A105	LIGHTING LAYOUT LOWER LEVEL 2 PLAN LOWER LEVEL 2 PLAN FIRST FLOOR PLAN SECOND FLOOR PLAN FOURTH FLOOR PLAN
CIVIL - SITE LIGHTINC ES ARCHITECTURAL A099 A100 A101 A102 A104 A105 A106	LIGHTING LAYOUT LOWER LEVEL 2 PLAN LOWER LEVEL 1 PLAN FIRST FLOOR PLAN SECOND FLOOR PLAN FOURTH FLOOR PLAN FIFTH & SIXTH FLOOR PL
CIVIL - SITE LIGHTINC ES ARCHITECTURAL A099 A100 A101 A102 A104 A105 A106 A110	LIGHTING LAYOUT LOWER LEVEL 2 PLAN LOWER LEVEL 2 PLAN FIRST FLOOR PLAN SECOND FLOOR PLAN FOURTH FLOOR PLAN FIFTH & SIXTH FLOOR PLAN SIXTH FLOOR PLAN
CIVIL - SITE LIGHTING ES ARCHITECTURAL A099 A100 A101 A102 A104 A105 A106 A110 A200	LIGHTING LAYOUT LOWER LEVEL 2 PLAN LOWER LEVEL 2 PLAN FIRST FLOOR PLAN SECOND FLOOR PLAN FOURTH FLOOR PLAN FIFTH & SIXTH FLOOR PI SIXTH FLOOR PLAN ROOF PLAN
CIVIL - SITE LIGHTINC ES ARCHITECTURAL A099 A100 A101 A102 A104 A104 A105 A106 A110 A200 A201	LIGHTING LAYOUT LIGHTING LAYOUT LOWER LEVEL 2 PLAN LOWER LEVEL 1 PLAN FIRST FLOOR PLAN SECOND FLOOR PLAN FOURTH FLOOR PLAN FIFTH & SIXTH FLOOR PI SIXTH FLOOR PLAN ROOF PLAN EXTERIOR ELEVATIONS
CIVIL - SITE LIGHTINC ES ARCHITECTURAL A099 A100 A101 A102 A104 A105 A106 A110 A200 A201 A210	LIGHTING LAYOUT LOWER LEVEL 2 PLAN LOWER LEVEL 2 PLAN LOWER LEVEL 1 PLAN FIRST FLOOR PLAN SECOND FLOOR PLAN FOURTH FLOOR PLAN FIFTH & SIXTH FLOOR PI SIXTH FLOOR PLAN ROOF PLAN EXTERIOR ELEVATIONS EXTERIOR ELEVATIONS
CIVIL – SITE LIGHTINC ES ARCHITECTURAL	LIGHTING LAYOUT LOWER LEVEL 2 PLAN LOWER LEVEL 2 PLAN LOWER LEVEL 1 PLAN FIRST FLOOR PLAN SECOND FLOOR PLAN FOURTH FLOOR PLAN FOURTH FLOOR PLAN FIFTH & SIXTH FLOOR PL SIXTH FLOOR PLAN ROOF PLAN EXTERIOR ELEVATIONS EXTERIOR ELEVATIONS EXTERIOR MATERIALS
CIVIL - SITE LIGHTING ES ARCHITECTURAL A099 A100 A101 A102 A104 A105 A106 A110 A200 A201 A210 A210 A220	LIGHTING LAYOUT LIGHTING LAYOUT LOWER LEVEL 2 PLAN LOWER LEVEL 1 PLAN FIRST FLOOR PLAN SECOND FLOOR PLAN FOURTH FLOOR PLAN FOURTH FLOOR PLAN FIFTH & SIXTH FLOOR PI SIXTH FLOOR PLAN ROOF PLAN EXTERIOR ELEVATIONS EXTERIOR ELEVATIONS EXTERIOR MATERIALS EXTERIOR IMAGES
CIVIL - SITE LIGHTINC ES ARCHITECTURAL A099 A100 A101 A102 A104 A104 A105 A106 A110 A200 A201 A210 A220 A221	LIGHTING LAYOUT LIGHTING LAYOUT LOWER LEVEL 2 PLAN LOWER LEVEL 1 PLAN FIRST FLOOR PLAN SECOND FLOOR PLAN FOURTH FLOOR PLAN FOURTH FLOOR PLAN FIFTH & SIXTH FLOOR PI SIXTH FLOOR PLAN ROOF PLAN EXTERIOR ELEVATIONS EXTERIOR ELEVATIONS EXTERIOR MATERIALS EXTERIOR IMAGES EXTERIOR IMAGES

EXTERIOR IMAGES


EXTERIOR IMAGES EXTERIOR IMAGES


A 2 2 7 Grand total: 30


A 2 2 5

A 2 2 6

	JLA ARCHITECTS
AYOUT PLAN MAP & DEMOLITION PLAN	MADISON : MILWAUKEE jla-ap.com
ONTROL PLAN	JLA PROJECT NUMBER:20-0302
PLAN	
	6003, 6019, 6035, 6015 GEMINI DRIVE GRAND VIEW COMMONS BLOCK B
	UDC FINAL SUBMITTAL
	PROGRESS DOCUMENTS These documents reflect progress and intent and may be subject to change, including additional detail. These are not final construction documents and should not be used for final bidding or construction-related purposes.
	DATE OF ISSUANCE AUGUST 12, 2020 REVISION SCHEDULE MARK DESCRIPTION
	SHEET TITLE
	INDEX SHEET
	sheet number

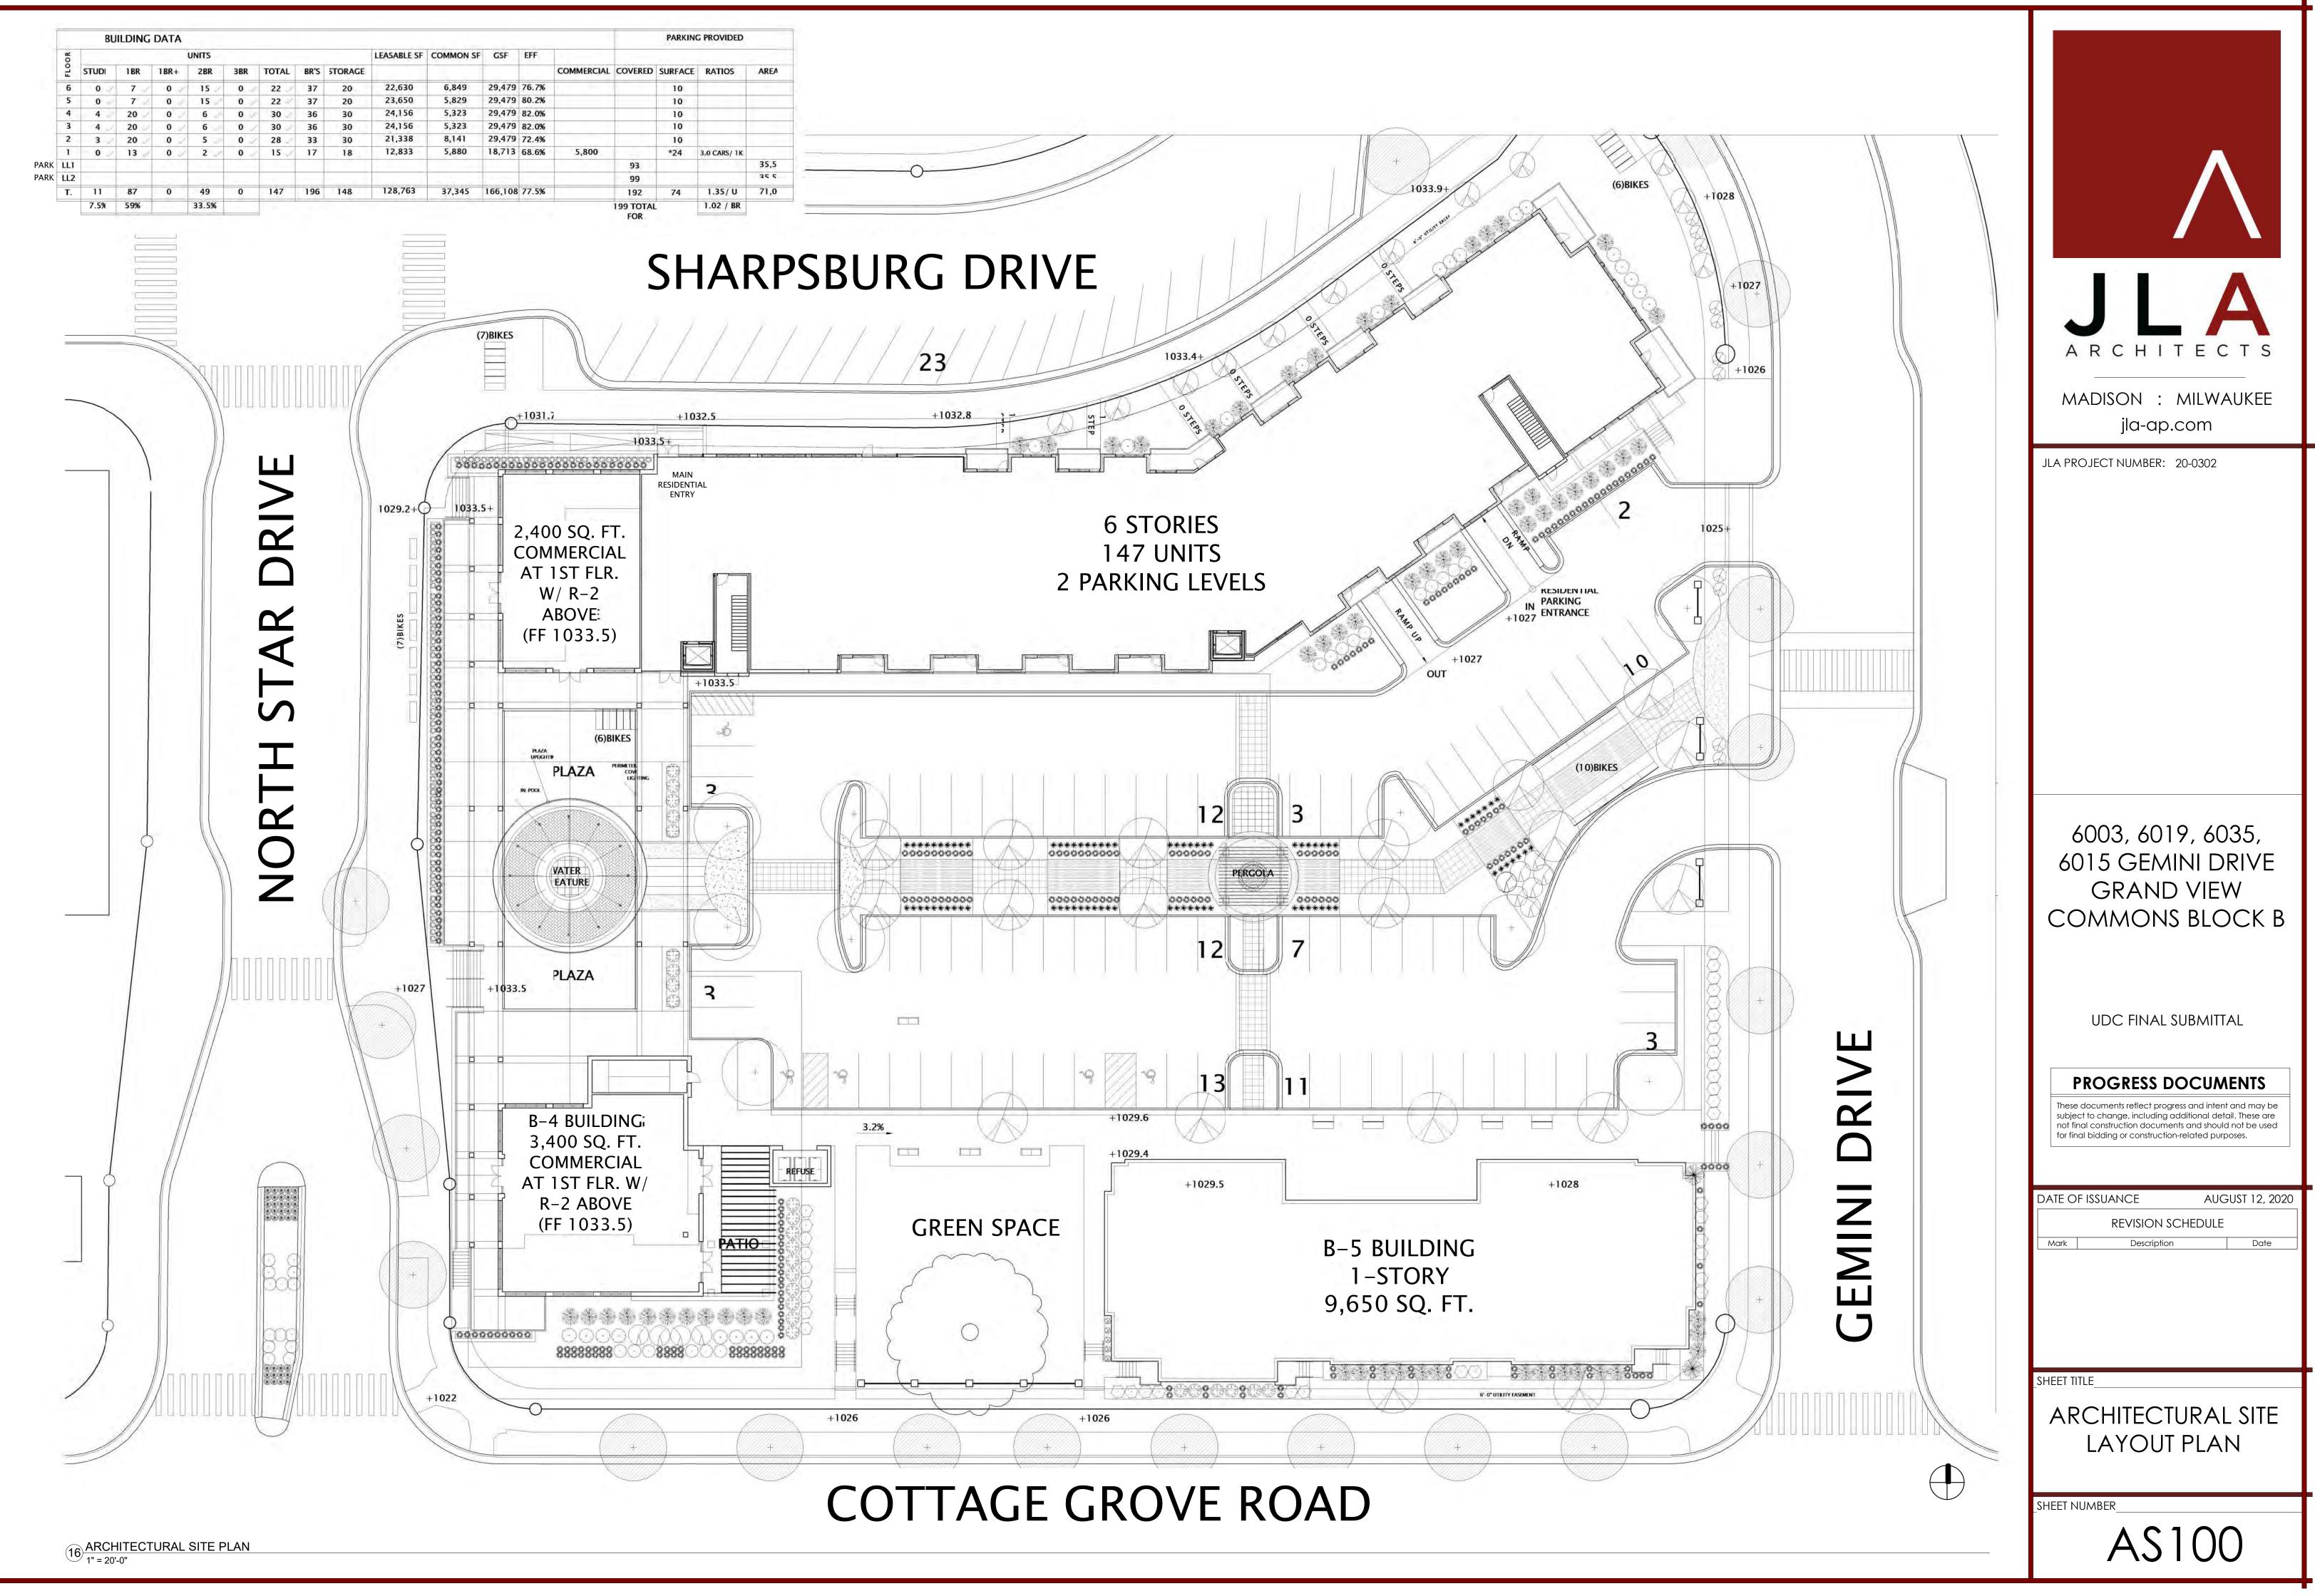

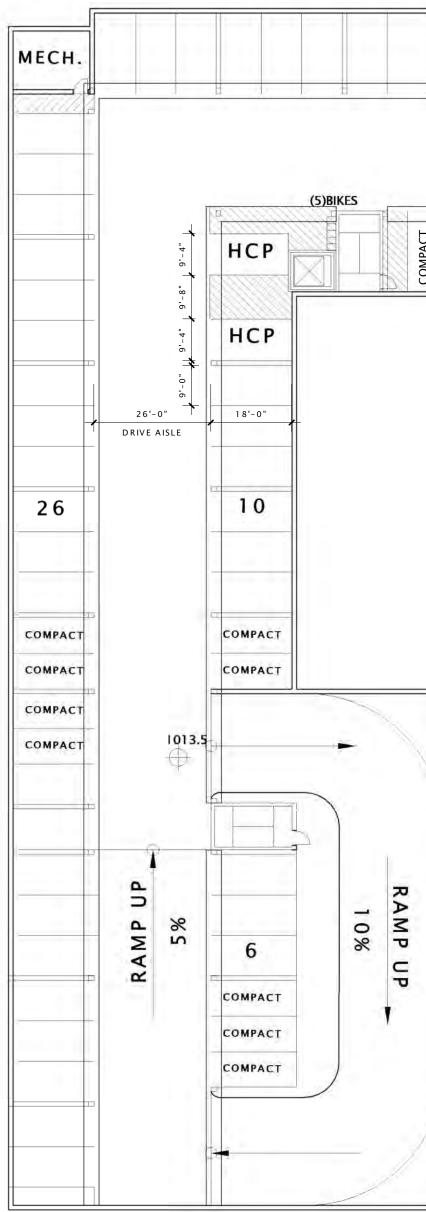


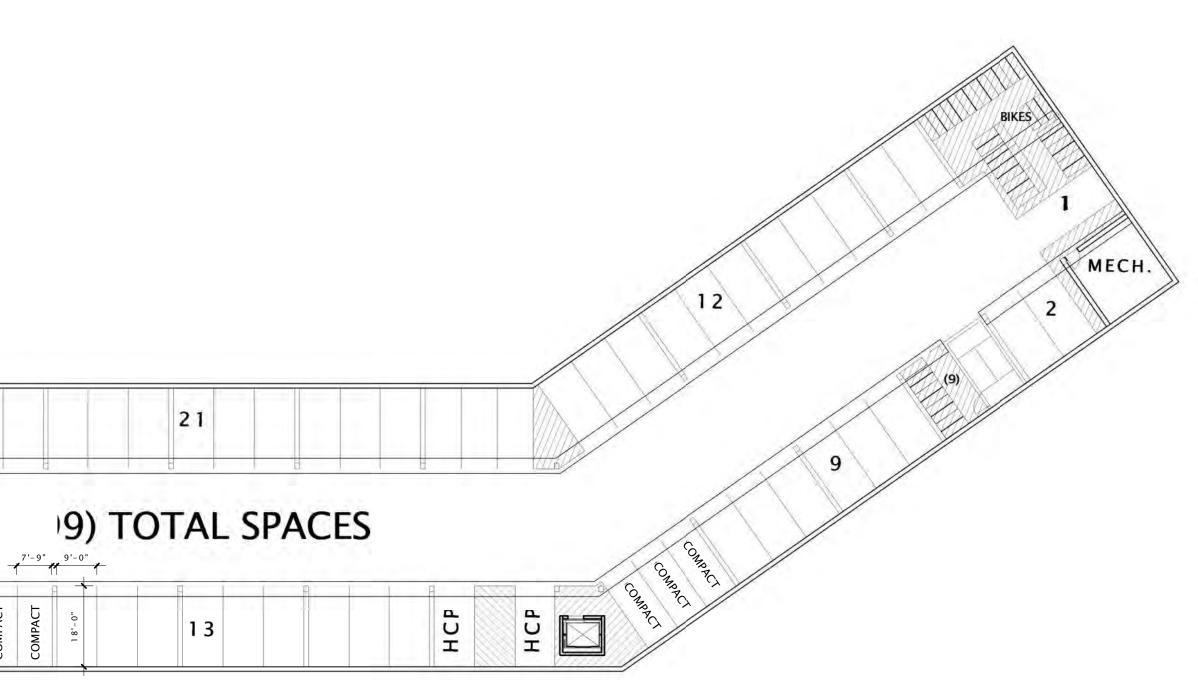




ARCHITECTS MADISON : MILWAUKEE jla-ap.com
JLA PROJECT NUMBER: 20-0302
6003, 6019, 6035,
6015 GEMINI DRIVE GRAND VIEW
COMMONS BLOCK B
udc final submittal
PROGRESS DOCUMENTS These documents reflect progress and intent and may be subject to change, including additional detail. These are not final construction documents and should not be used
for final bidding or construction-related purposes.
DATE OF ISSUANCE AUGUST 12, 2020 REVISION SCHEDULE Mark
Mark Description Date
SHEET TITLE
LUVVLINLLVLLZTLAIN
A099

\square	
\square	

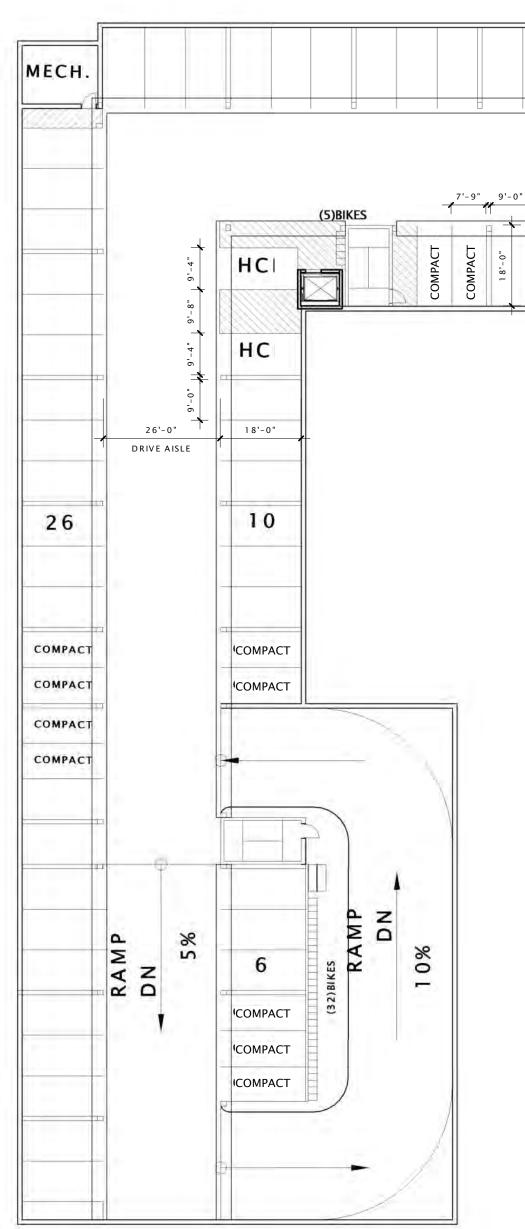

(17) LOWER LEVEL 1 PLAN 3/64" = 1'-0"

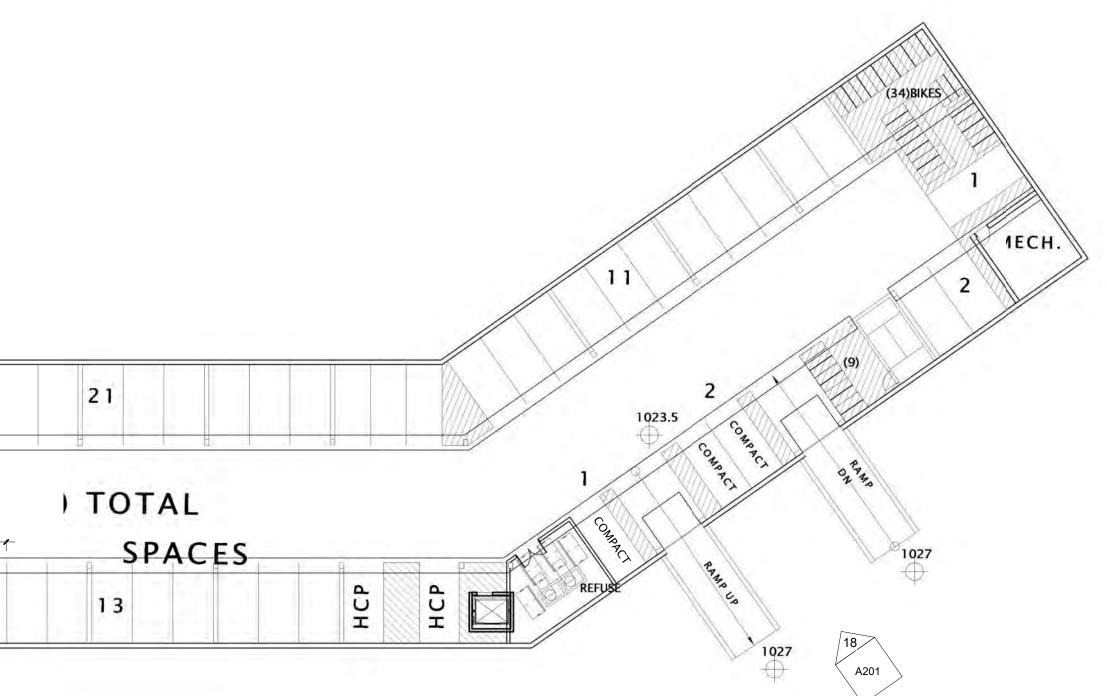

16 A201

6 A201	
--------	--

								<u>\</u>
A R	С	Н	1	Т	E	c	Т	S

MADISON : MILWAUKEE jla-ap.com

JLA PROJECT NUMBER: 20-0302

6003, 6019, 6035, 6015 GEMINI DRIVE GRAND VIEW COMMONS BLOCK B

UDC FINAL SUBMITTAL

PROGRESS DOCUMENTS

These documents reflect progress and intent and may be subject to change, including additional detail. These are not final construction documents and should not be used for final bidding or construction-related purposes.

DATE OF ISSUANCE		AUGUST 12, 2020
	REVISION S	CHEDULE
Mark	Description	Date


SHEET TITLE



A100

 \bigoplus

SHEET NUMBER

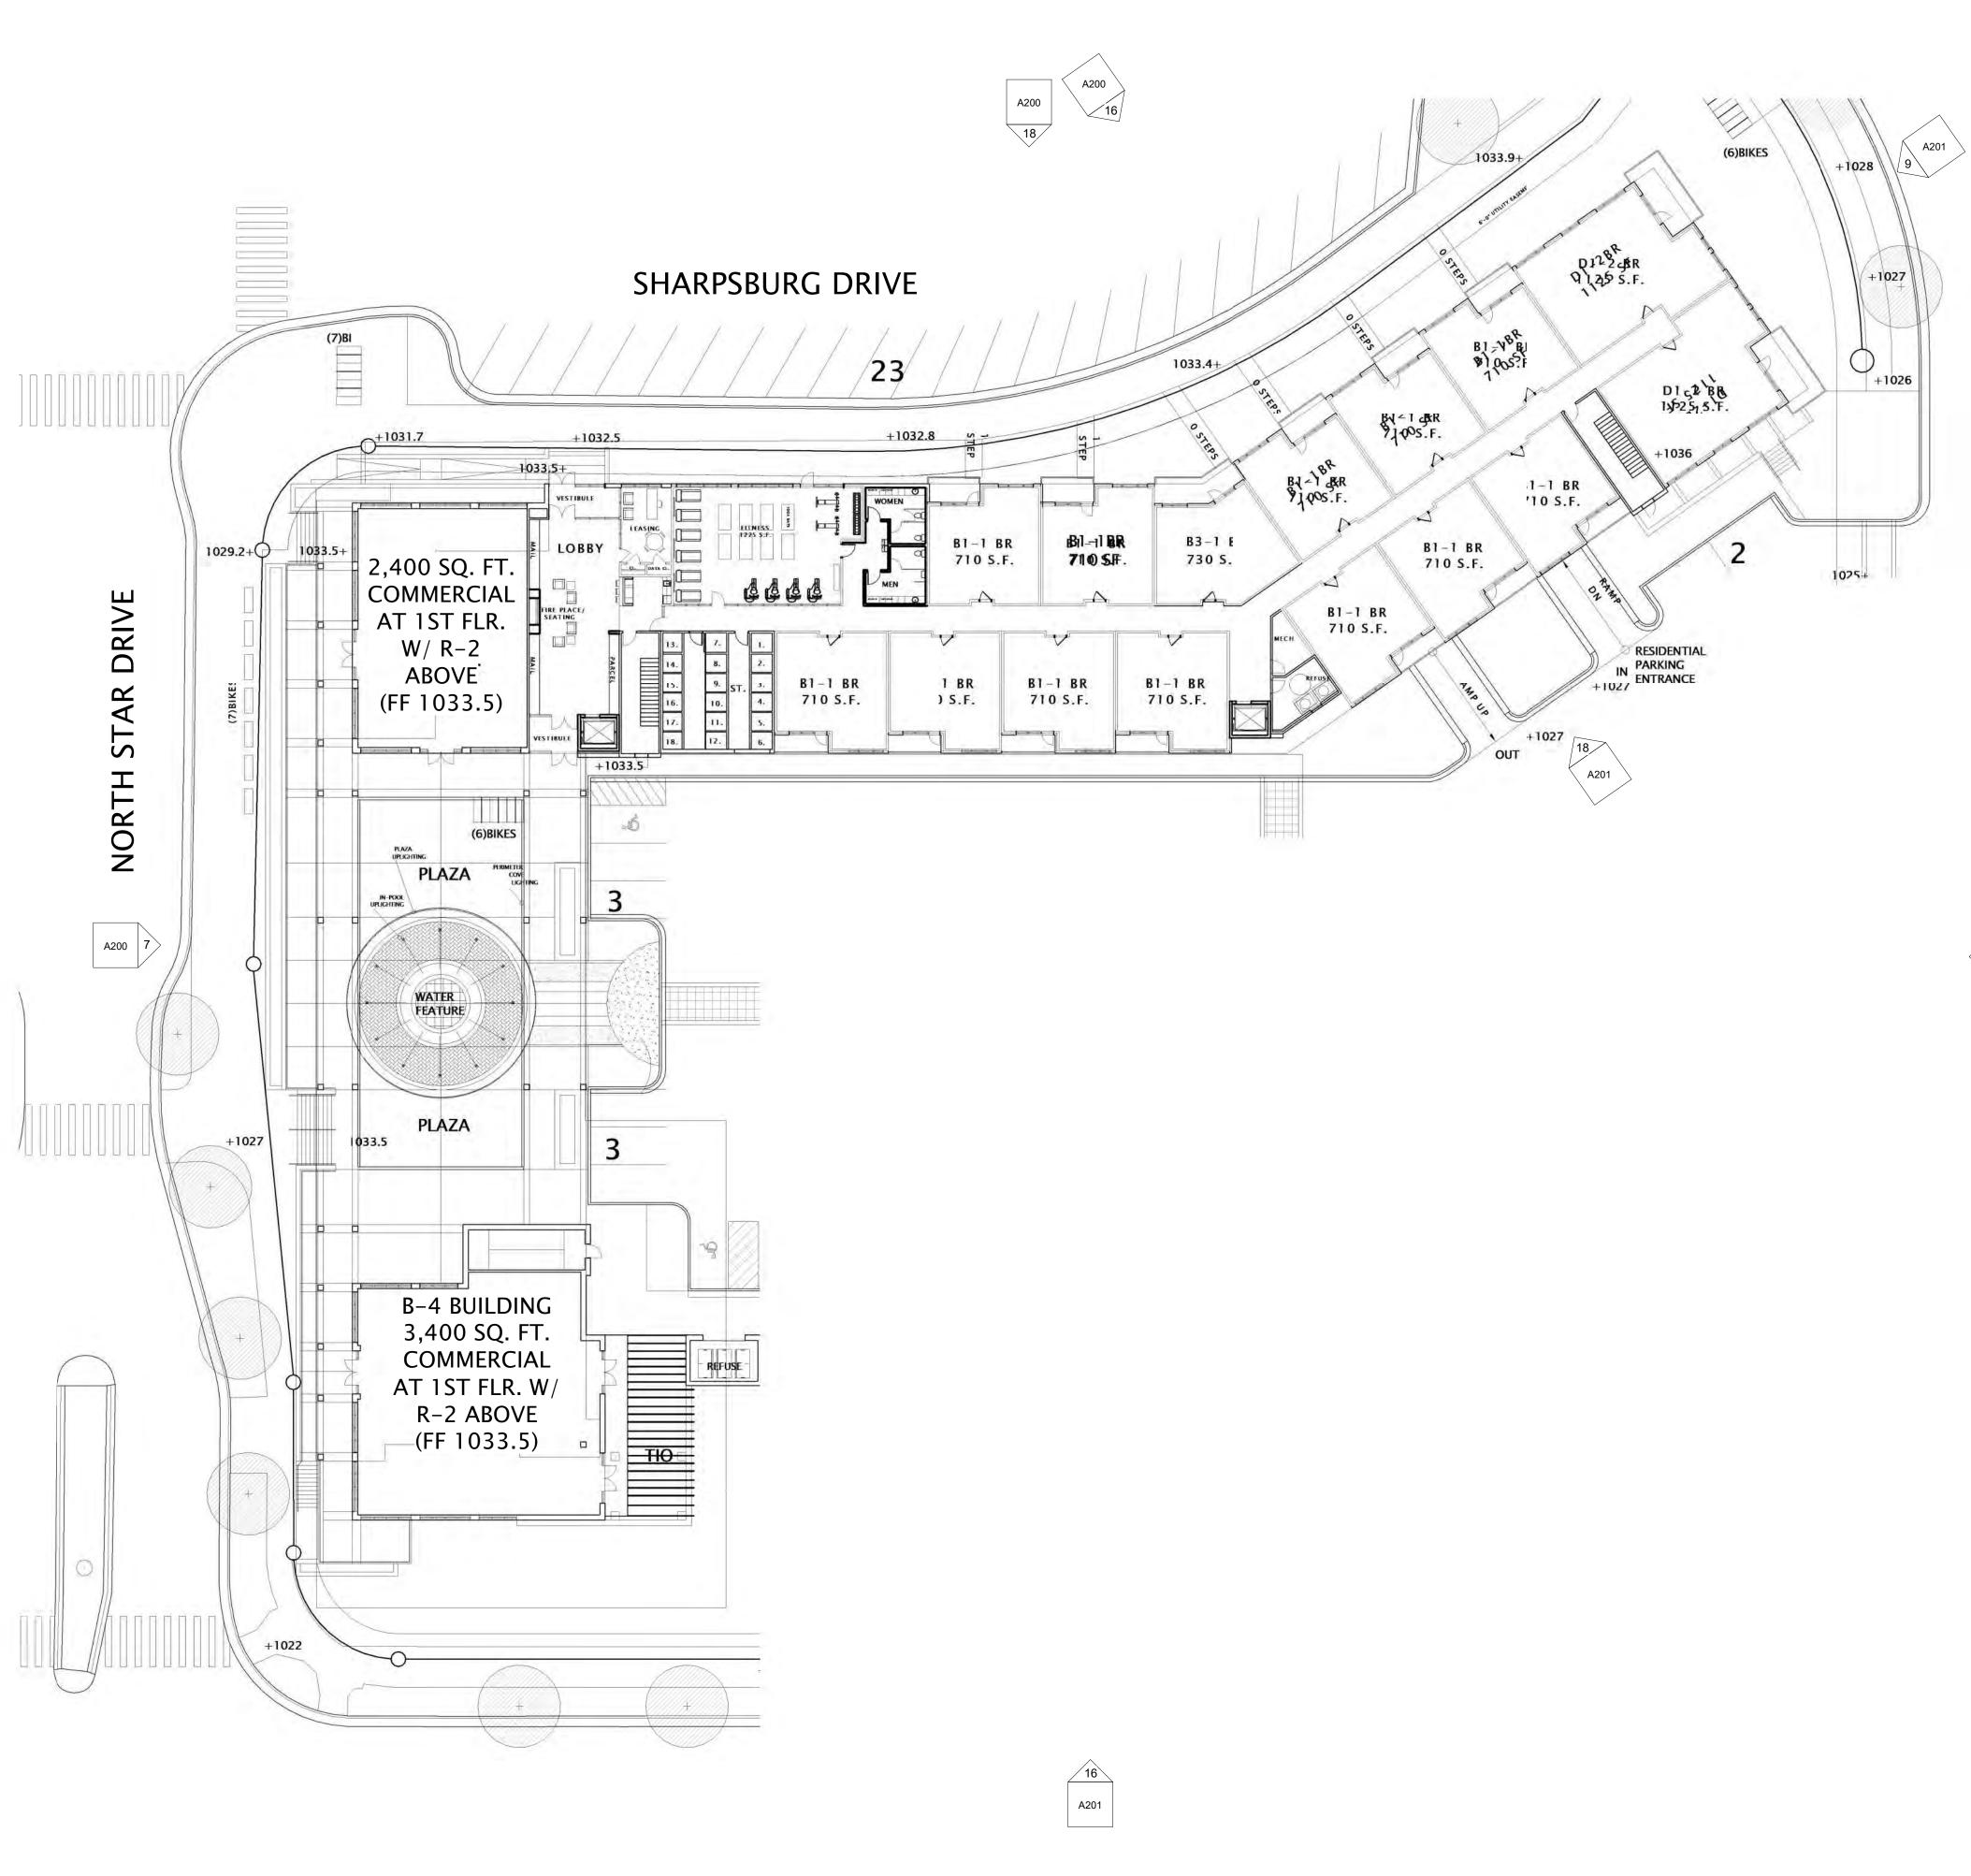

6 A201



JLA PROJECT NUMBER: 20-0302

6003, 6019, 6035, 6015 GEMINI DRIVE GRAND VIEW COMMONS BLOCK B

udc final submittal

PROGRESS DOCUMENTS

These documents reflect progress and intent and may be subject to change, including additional detail. These are not final construction documents and should not be used for final bidding or construction-related purposes.


DATE O	f ISSUANCE	AUGUST 12, 2020
	REVISION SC	HEDULE
Mark	Description	Date

SHEET TITLE


FIRST FLOOR PLAN

_sheet number_____

17 <u>SECOND FLOOR PLAN</u> 3/64" = 1'-0"

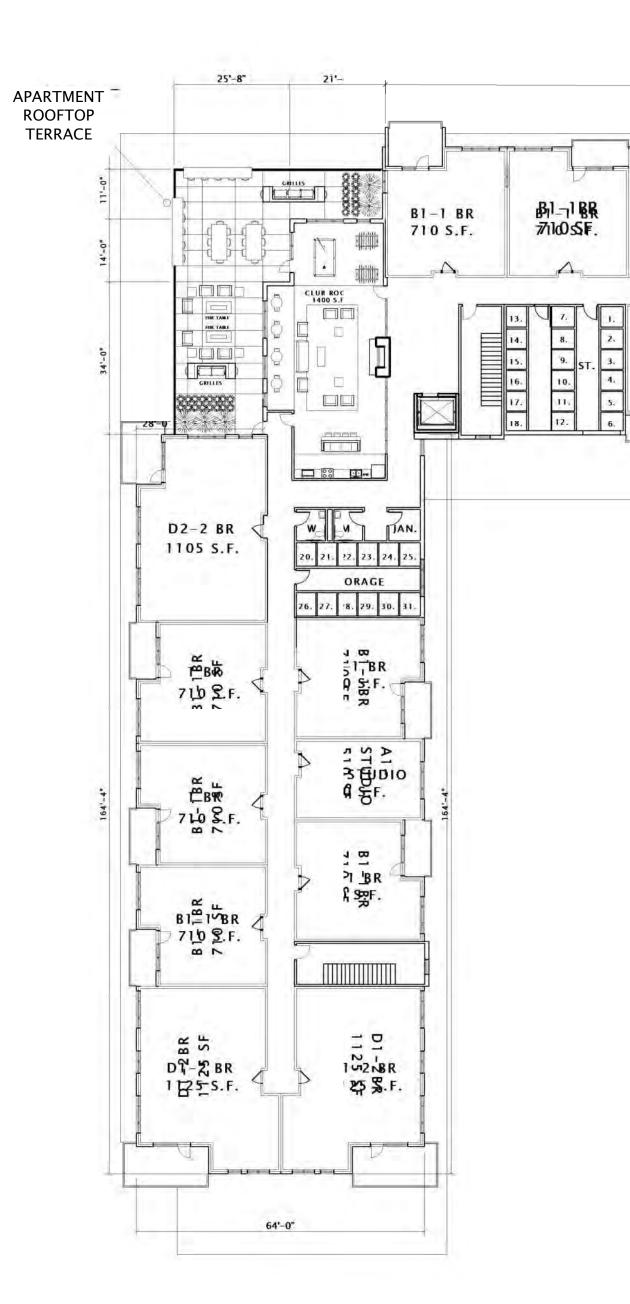



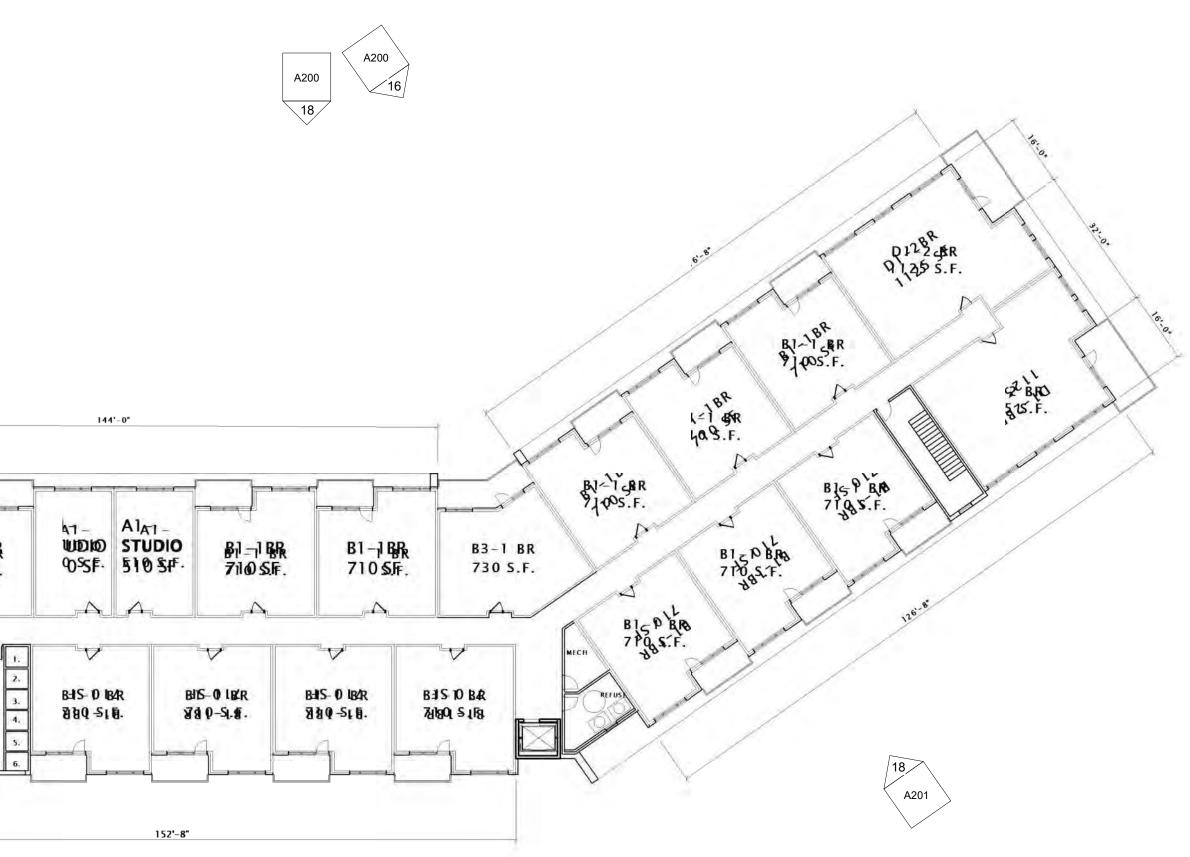







JLA PROJECT NUMBER: 20-0302

6 A201

6003, 6019, 6035, 6015 GEMINI DRIVE GRAND VIEW COMMONS BLOCK B

udc final submittal

PROGRESS DOCUMENTS

These documents reflect progress and intent and may be subject to change, including additional detail. These are not final construction documents and should not be used for final bidding or construction-related purposes.


DATE O	F ISSUANCE AUC	GUST 12, 2020
	REVISION SCHEDULE	
Mark	Description	Date

SHEET TITLE

SECOND FLOOR
PLAN

A102

_SHEET NUMBER___

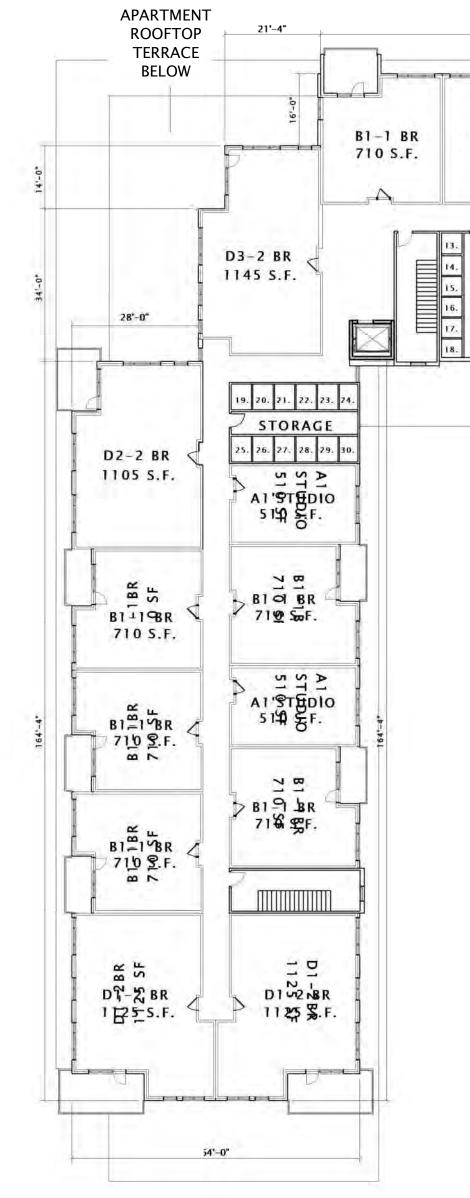

A200 7

17 THIRD & FOURTH FLOOR PLAN 3/64" = 1'-0"









MADISON : MILWAUKEE jla-ap.com

JLA PROJECT NUMBER: 20-0302

6 A201

6003, 6019, 6035, 6015 GEMINI DRIVE GRAND VIEW COMMONS BLOCK B

udc final submittal

PROGRESS DOCUMENTS


These documents reflect progress and intent and may be subject to change, including additional detail. These are not final construction documents and should not be used for final bidding or construction-related purposes.

DATE OF ISSUANCE		AUGUST 12, 2020
	REVISION SC	CHEDULE
Mark	Description	Date

SHEET TITLE


THIRD & FOURTH FLOOR PLAN

SHEET NUMBER____

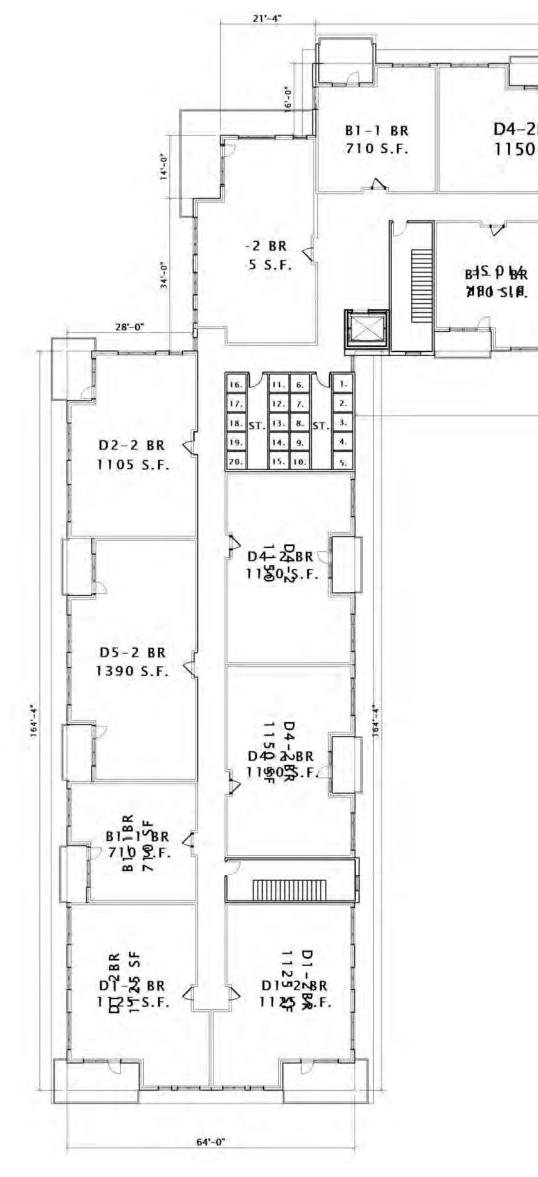



17 FIFTH & SIXTH FLOOR PLAN 3/64" = 1'-0"

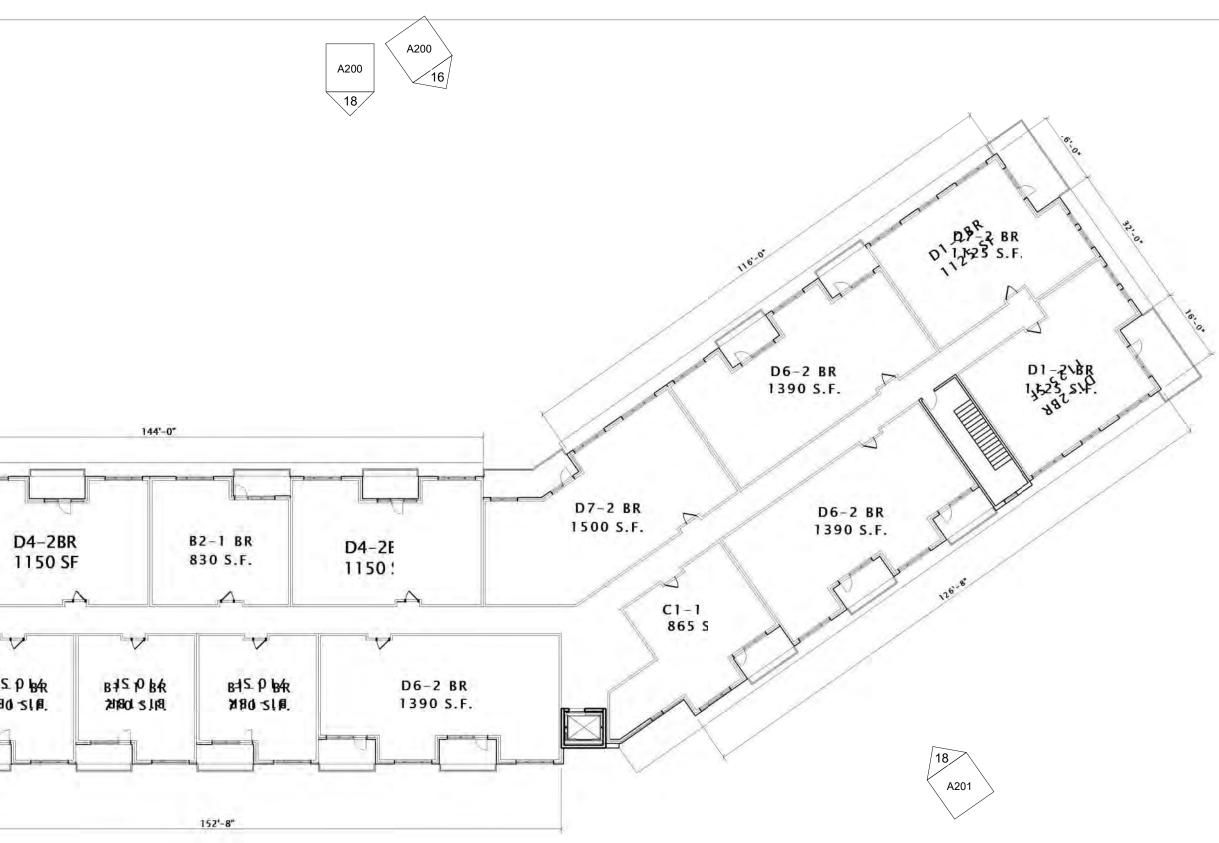

16 A201



6 A201



jla-ap.com

JLA PROJECT NUMBER: 20-0302

6003, 6019, 6035, 6015 GEMINI DRIVE GRAND VIEW COMMONS BLOCK B

UDC FINAL SUBMITTAL

PROGRESS DOCUMENTS


These documents reflect progress and intent and may be subject to change, including additional detail. These are not final construction documents and should not be used for final bidding or construction-related purposes.


DATE OF ISSUANCE		AUGUST 12, 2020
	REVISION SC	CHEDULE
Mark	Description	Date

SHEET TITLE


FIFTH & SIXTH FLOOR PLAN

SHEET NUMBER____

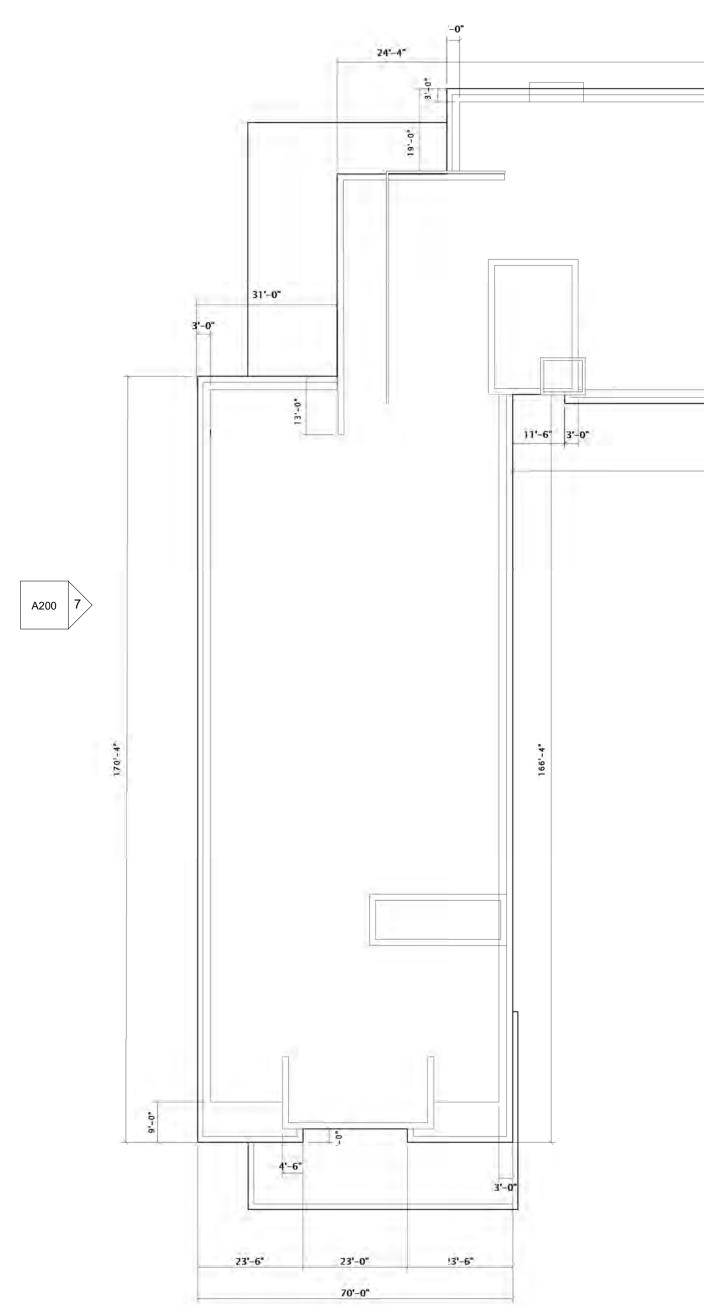

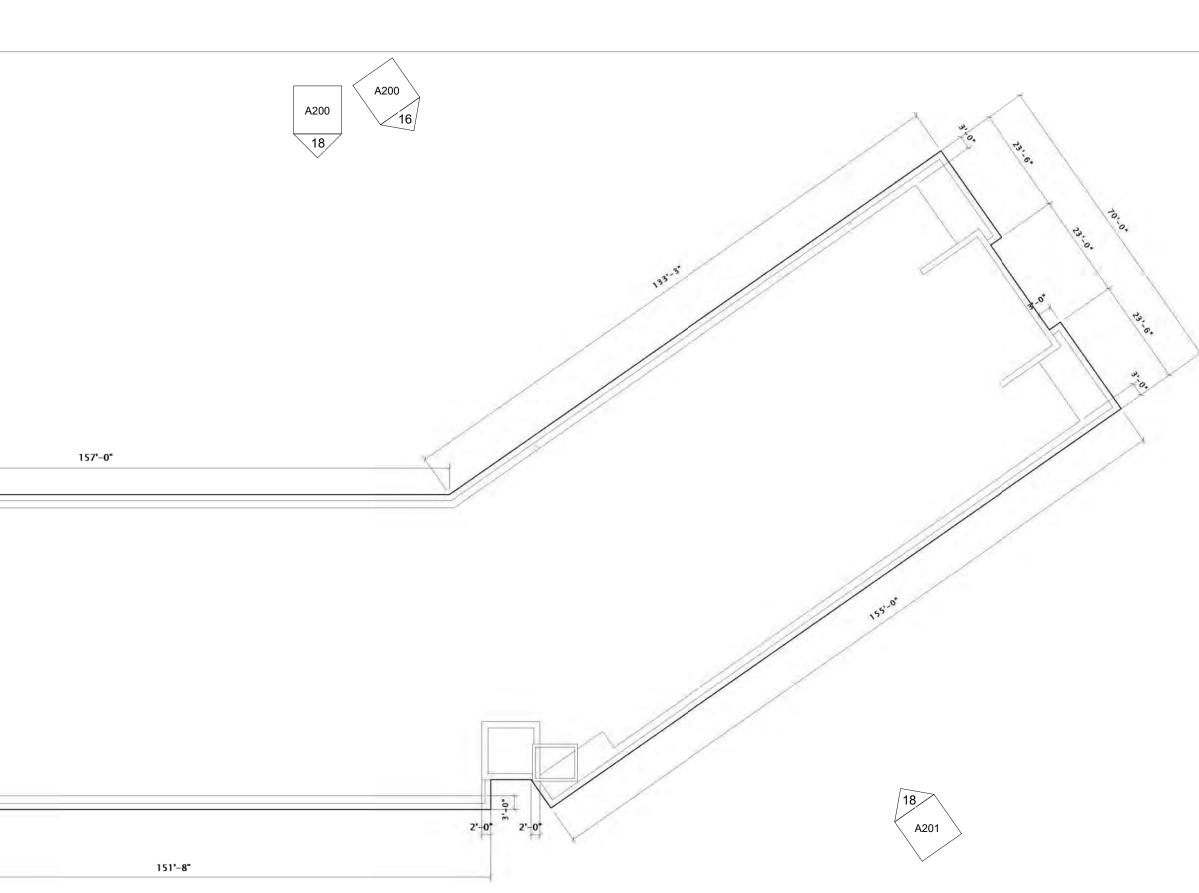



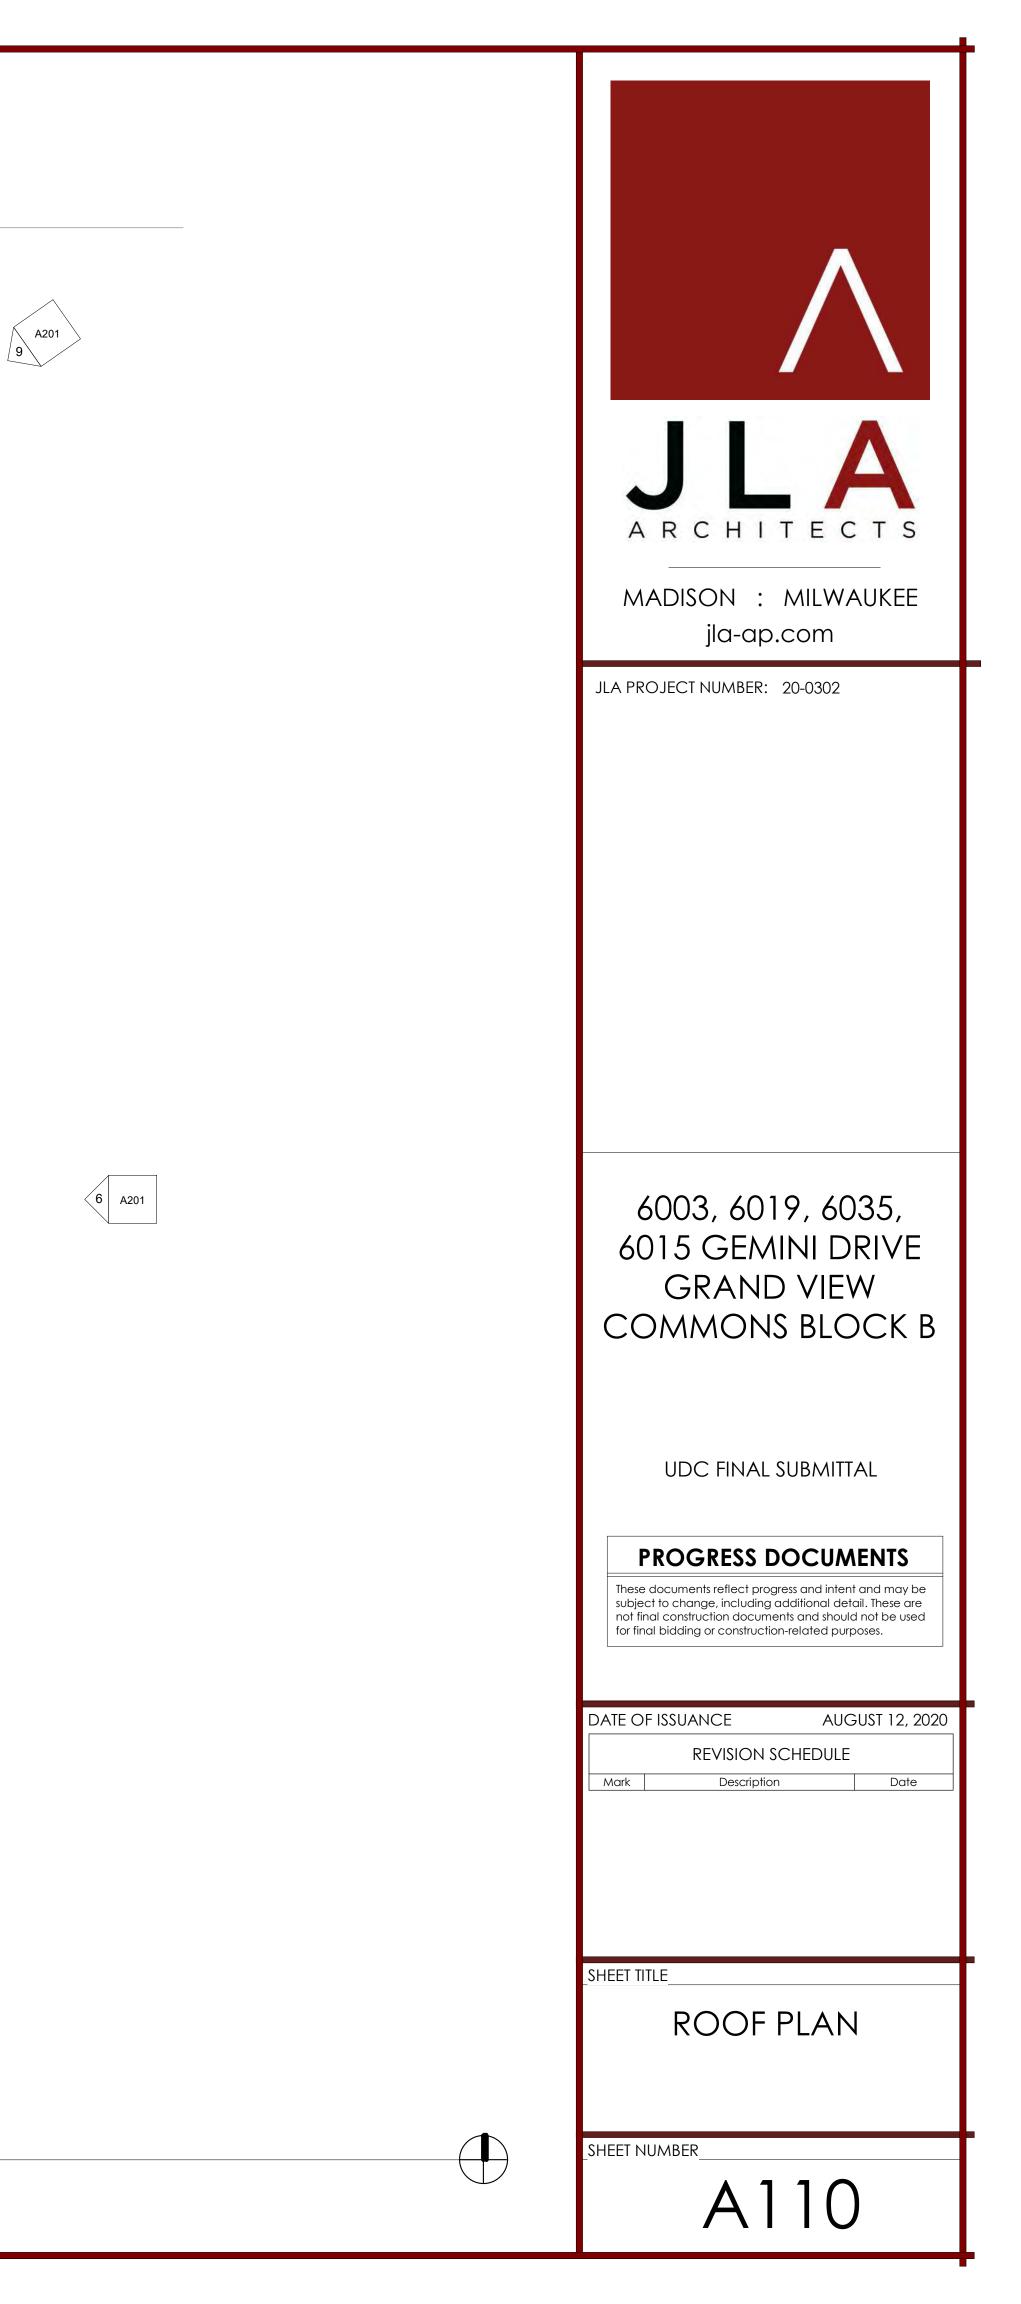







	VINTE WINDOWS & PATIO DOORS	Pella Impervia		varies
	PREFINISHED METAL RAILING	Quigley	Metal/Wire Mesh Guardrails - Black	varie
	STOREFRONT	Kawneer	Black	varies
			PREFINISHED COMPOSITE PANEL -	
WOOD GRAIN / LAP SIDING		MPOSITE TRIM – I DOD GRAIN	METAL RAILING WOOD GRAIN	WOOD
				-
		SIGNAGE /		la ale pie
			AND LOGO 9 0 0 1	
				the start of the s
				· .
				- *.
		MPOSITE PANEL -	– STOREFRONT – FIELDSTONE – ENT	RY CANOP
LAP SIDING PRECAST	- VENEER WO	OD GRAIN		SIGNAGE
CONCRE	TE SILL			*.
1/16" = 1'-0".				
				* .
	POSE			··.
		💻 . 🔳		

material	company	style / color	size
FIELDSTONE VENEER	United Brick	Fond Du Lac Field Stone - Harvest Blend	varie
MORTAR	Mortar Technologies	W-289	n/a
COMPOSITE LAP SIDING	Hardie Plank	Aged Pewter	7"x14
COMPOSIT PANEL SIDING	Hardie Panel	Aged Pewter - Smooth	46"x
COMPOSITE PANEL - WOOD GRAIN	Nichiha	Vintage Wood - Cedar	18"x
COMPOSITE FASCIA- WOOD GRAIN	Nichiha	Vintage Wood - Cedar	varie
VINYL WINDOWS & PATIO DOORS	Pella Impervia	Casement - Black	varie
PREFINISHED METAL RAILING	Quigley	Metal/Wire Mesh Guardrails - Black	varie
STOREFRONT	Kawneer	Black	varie

08/12/2020 Material Selection

COMPOSITE PANEL – WOOD GRAIN	COMPOSITE PANEL SIDING	- COMPOSITE LAP SIDING	COMPOSITE PANEL - WOOD GRAIN	PREFINISHED METAL RAILING	G VINYL WINDOW W/ COMPOSITE TRIM – WOOD GRAIN	COMPOSITE FASCIA - WOOD GRAIN	COMPOSITE
SIGNAGE AND LOO	GO						
						Grandview Commons To	vn Center
- FIELDSTONE VENEER	PERGOLA STOP	EFRONT FIELDS VENEER		COMPOSITE PANEL WOOD GRAIN	- SCULPTURAL PLAZA FEATURE	PREFINISHI METAL RAI	

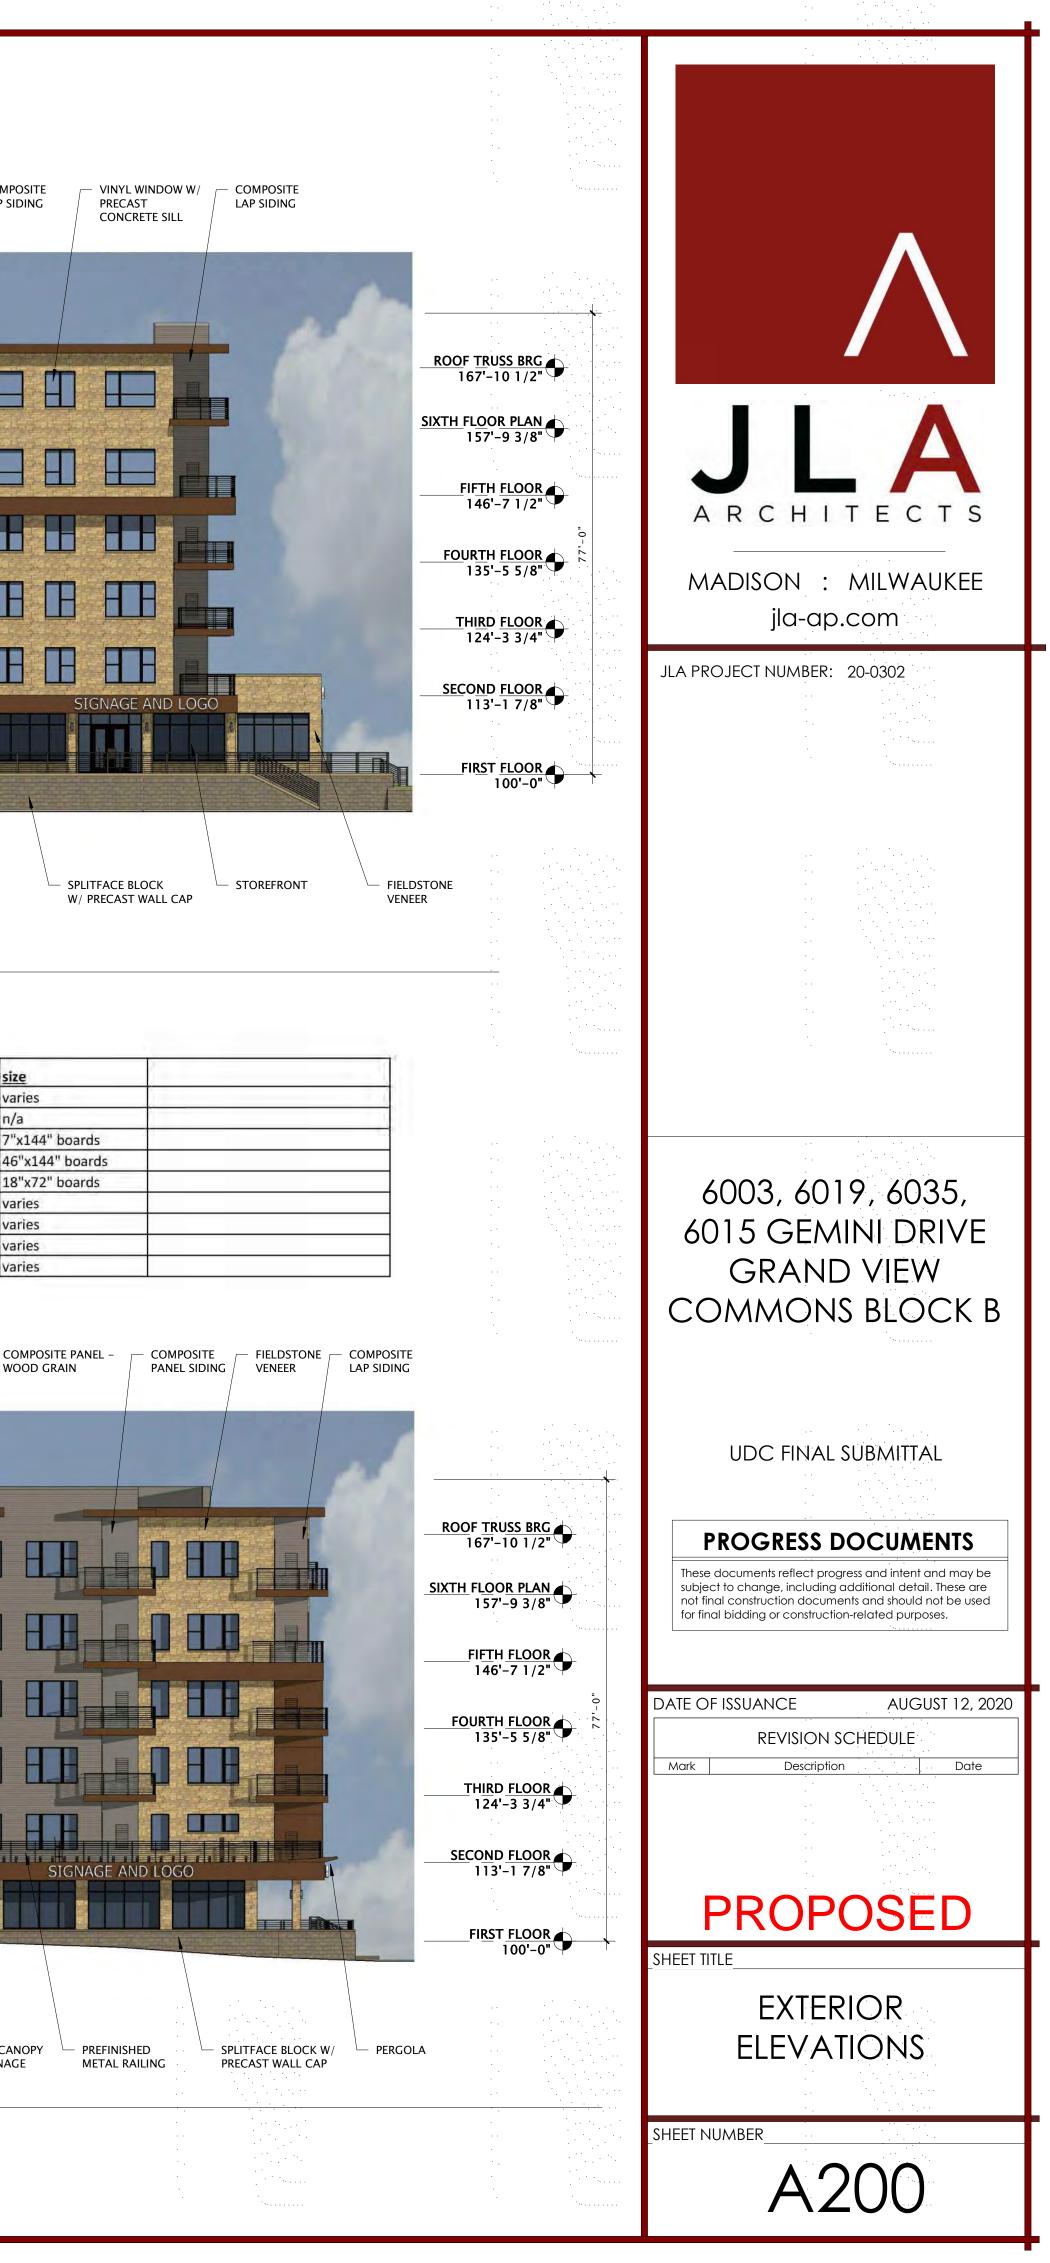

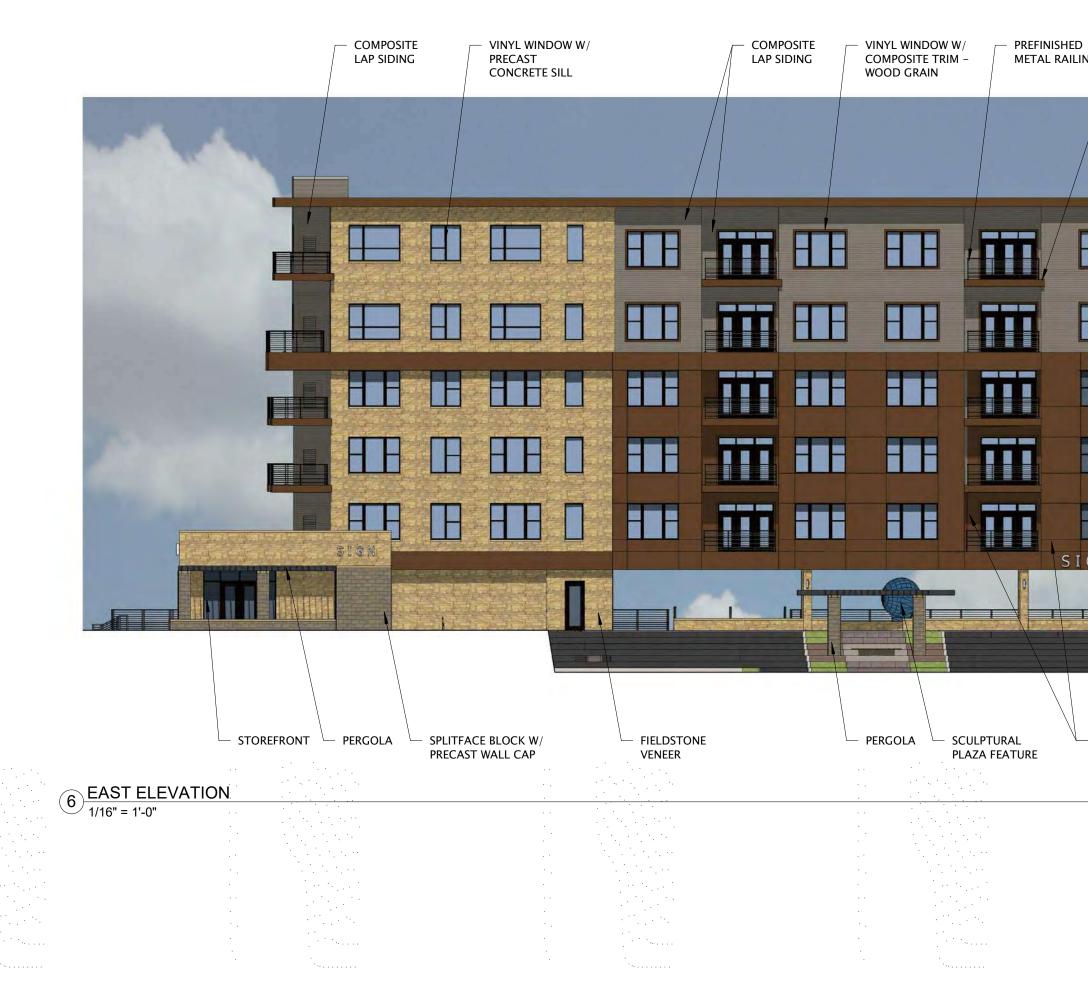



D COMPOSITE FASCIA – – LING WOOD GRAIN	COMPOSITE LAP SIDING		COMPOSITE WOOD GRAI
		ROOF_TRUSS BRG 167'-10 1/2" SIXTH FLOOR PLAN 157'-9 3/8" FIFTH FLOOR 146'-7 1/2"	
		FOURTH FLOOR 135'-5 5/8" THIRD FLOOR 124'-3 3/4" SECOND FLOOR 113'-1 7/8"	
COMPOSITE PANEL- WOOD GRAIN		FIRST_FLOOR 100'-0" LOWER LEVEL 1 90'-0"	FIELDSTO

9 NORTHEAST ELEVATION 1/16" = 1'-0"

08/12/2020 Material Selection

material	company	style / color	siz
FIELDSTONE VENEER	United Brick	Fond Du Lac Field Stone - Harvest Blend	var
MORTAR	Mortar Technologies	W-289	n/a
COMPOSITE LAP SIDING	Hardie Plank	Aged Pewter	7"x
COMPOSIT PANEL SIDING	Hardie Panel	Aged Pewter - Smooth	46'
COMPOSITE PANEL - WOOD GRAIN	Nichiha	Vintage Wood - Cedar	18'
COMPOSITE FASCIA- WOOD GRAIN	Nichiha	Vintage Wood - Cedar	var
VINYL WINDOWS & PATIO DOORS	Pella Impervia	Casement - Black	var
PREFINISHED METAL RAILING	Quigley	Metal/Wire Mesh Guardrails - Black	var
STOREFRONT	Kawneer	Black	var

OMPOSITE FASCIA - COMPOSITE OOD GRAIN LAP SIDING	VINYL WINDOW W/ COMPOSITE TRIM – WOOD GRAIN	FIELDSTONE VENEER	FIELDSTONE VENEER	/	COMPOSITE LAP SIDING	VINYL WINDOW W/ COMPOSITE TRIM – WOOD GRAIN	COMPOSITE FASCIA WOOD GRAIN
							Å
		S I G N A G					
		GE					
		A N D	A N D				
		L O G O					
			F				
COMPOSITE FASCIA – PREFINISHED VOOD GRAIN METAL RAILING	COMPOSITE SIDING - WOOD GRAIN	PERGOLA		SIDING W/ P CON	L WINDOW OVERHE RECAST GARAGE CRETE SILL		COMPOSITE PAN WOOD GRAIN
		PC	18 SOUTHEAST EI			· · · · · · ·	




SIGNAGE AND LOGO	
	Grandview Commons Town Center

7 WEST ELEVATION 1/16" = 1'-0"


	HHH		
		HE	


16 NORTHWEST ELEVATION 1/16" = 1'-0"

material	company	style / color	size
FIELDSTONE VENEER	United Brick	Fond Du Lac Field Stone - Harvest Blend	varies
MORTAR	Mortar Technologies	W-289	n/a
COMPOSITE LAP SIDING	Hardie Plank	Aged Pewter	7"x14
COMPOSIT PANEL SIDING	Hardie Panel	Aged Pewter - Smooth	46"x1
COMPOSITE PANEL - WOOD GRAIN	Nichiha	Vintage Wood - Cedar	18"x7
COMPOSITE FASCIA- WOOD GRAIN	Nichiha	Vintage Wood - Cedar	varies
VINYL WINDOWS & PATIO DOORS	Pella Impervia	Casement - Black	varies
PREFINISHED METAL RAILING	Quigley	Metal/Wire Mesh Guardrails - Black	varies
STOREFRONT	Kawneer	Black	varies

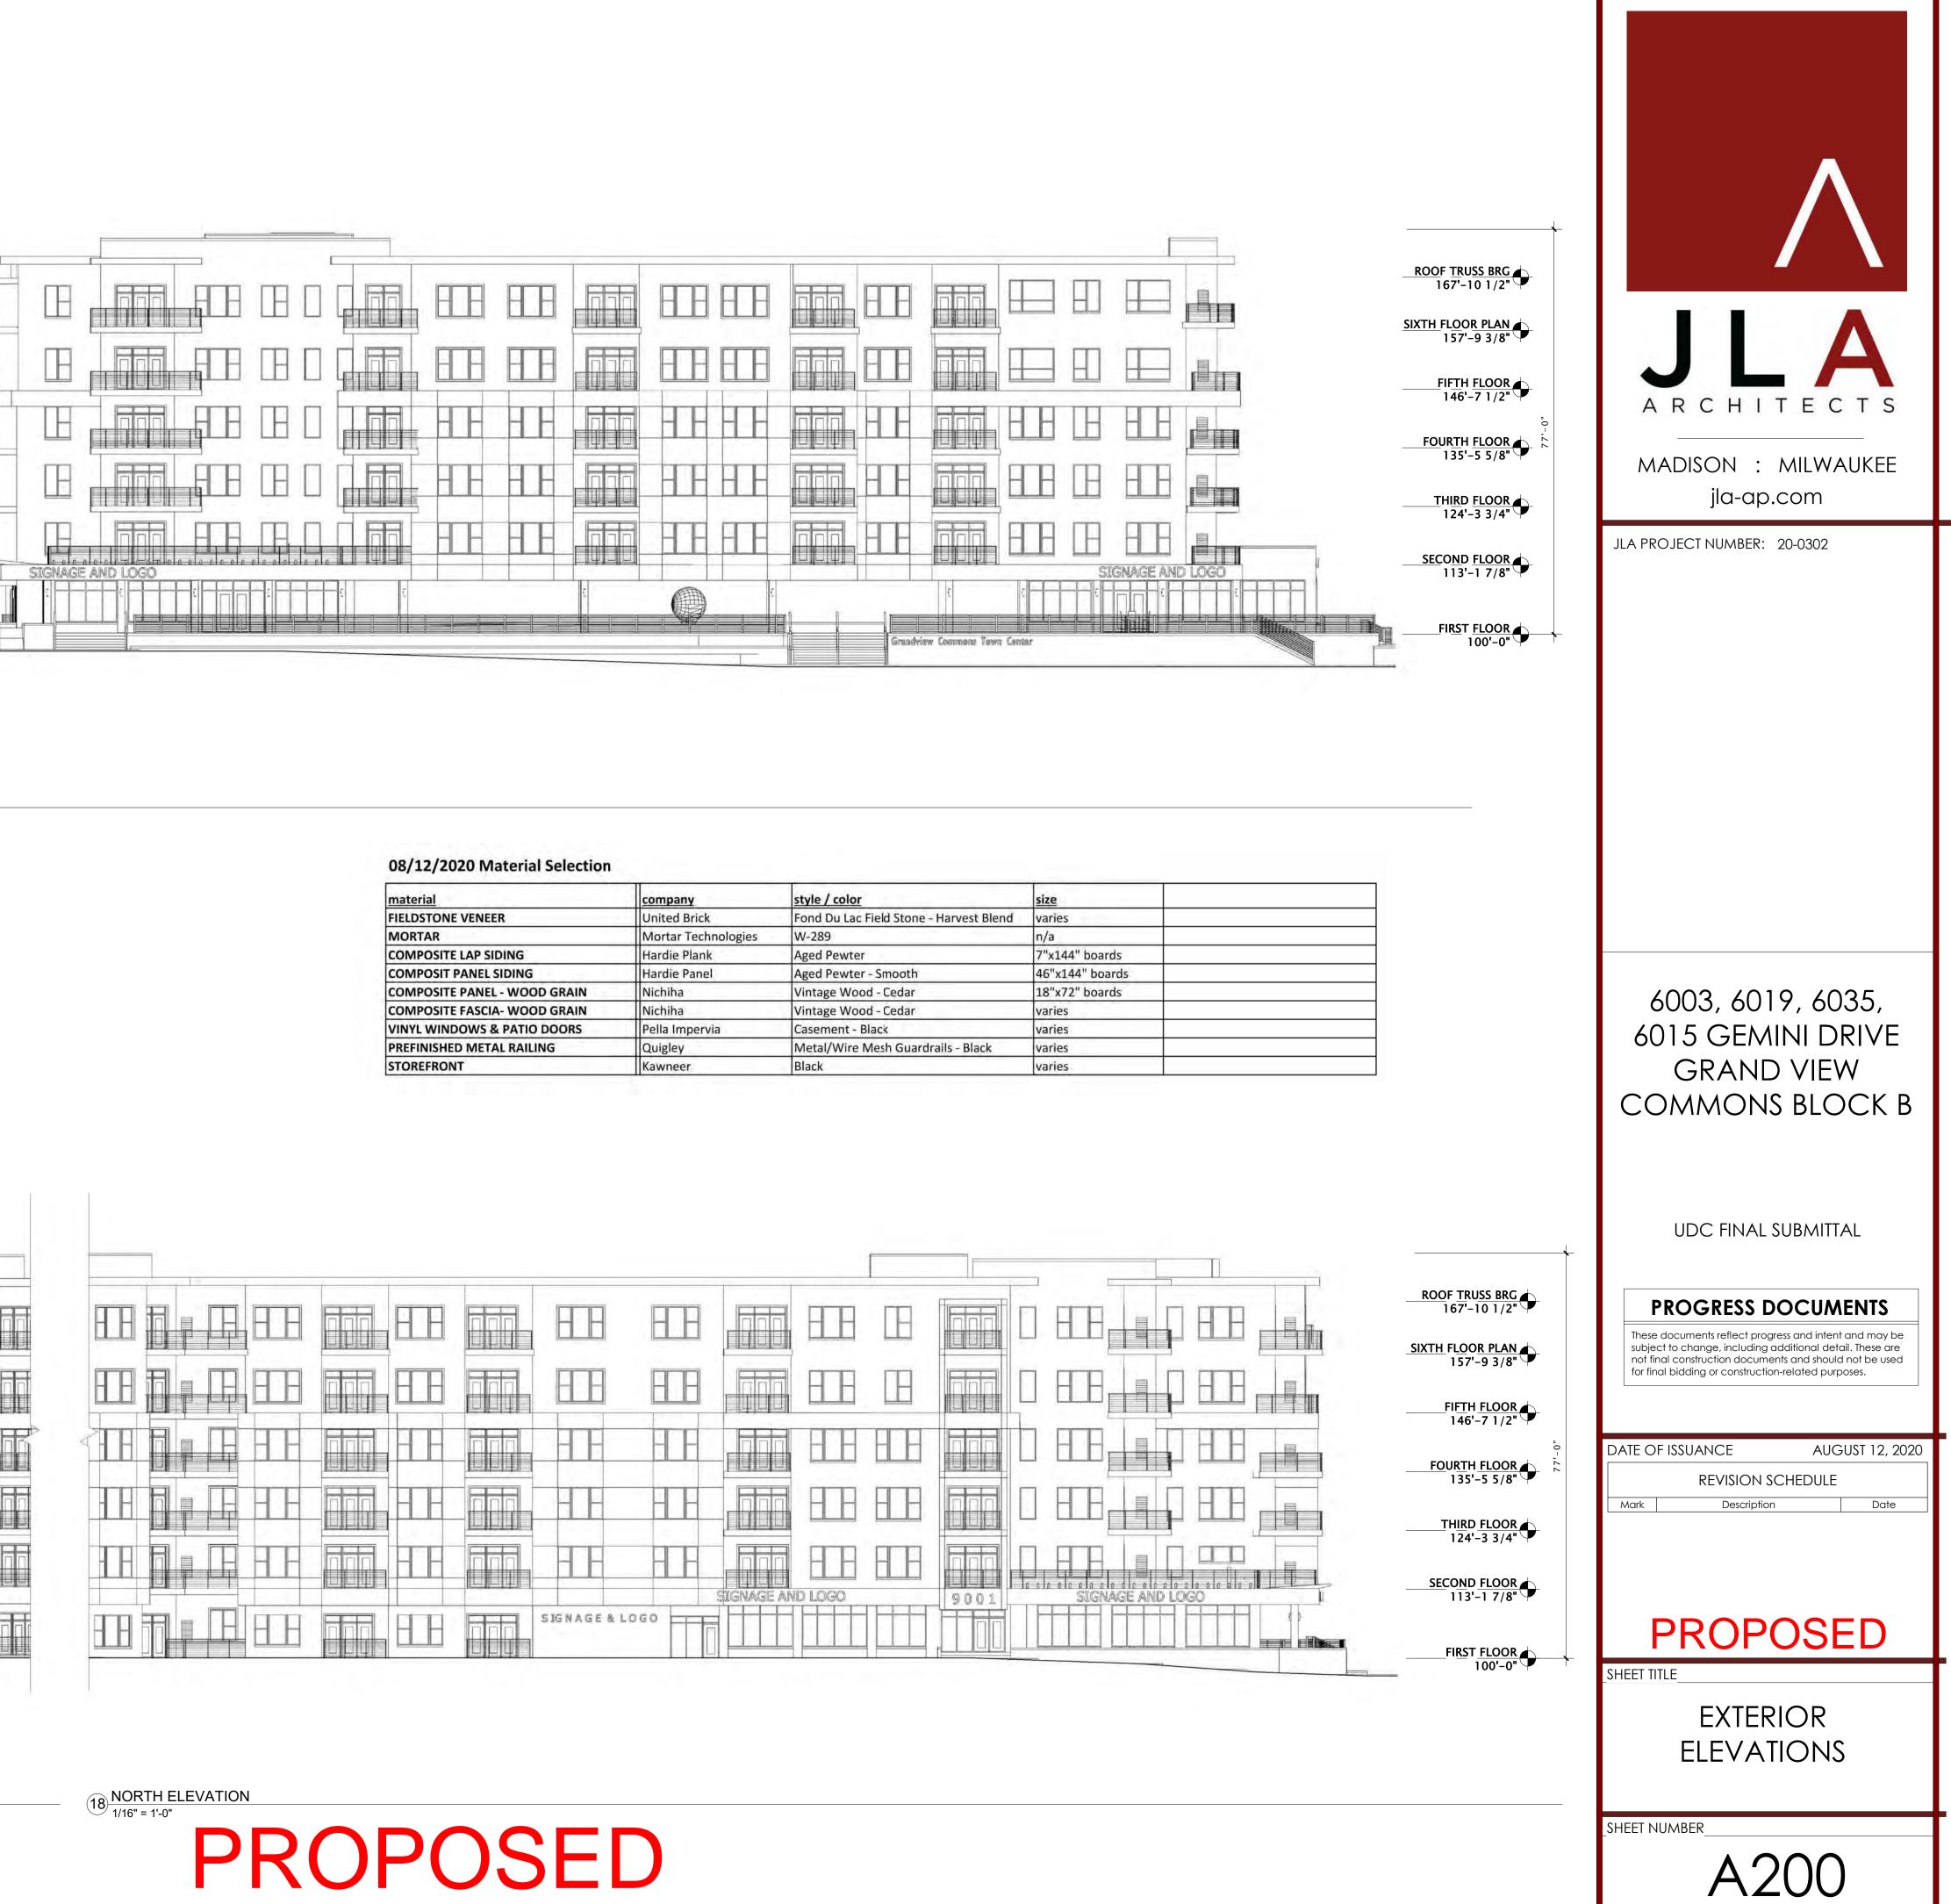



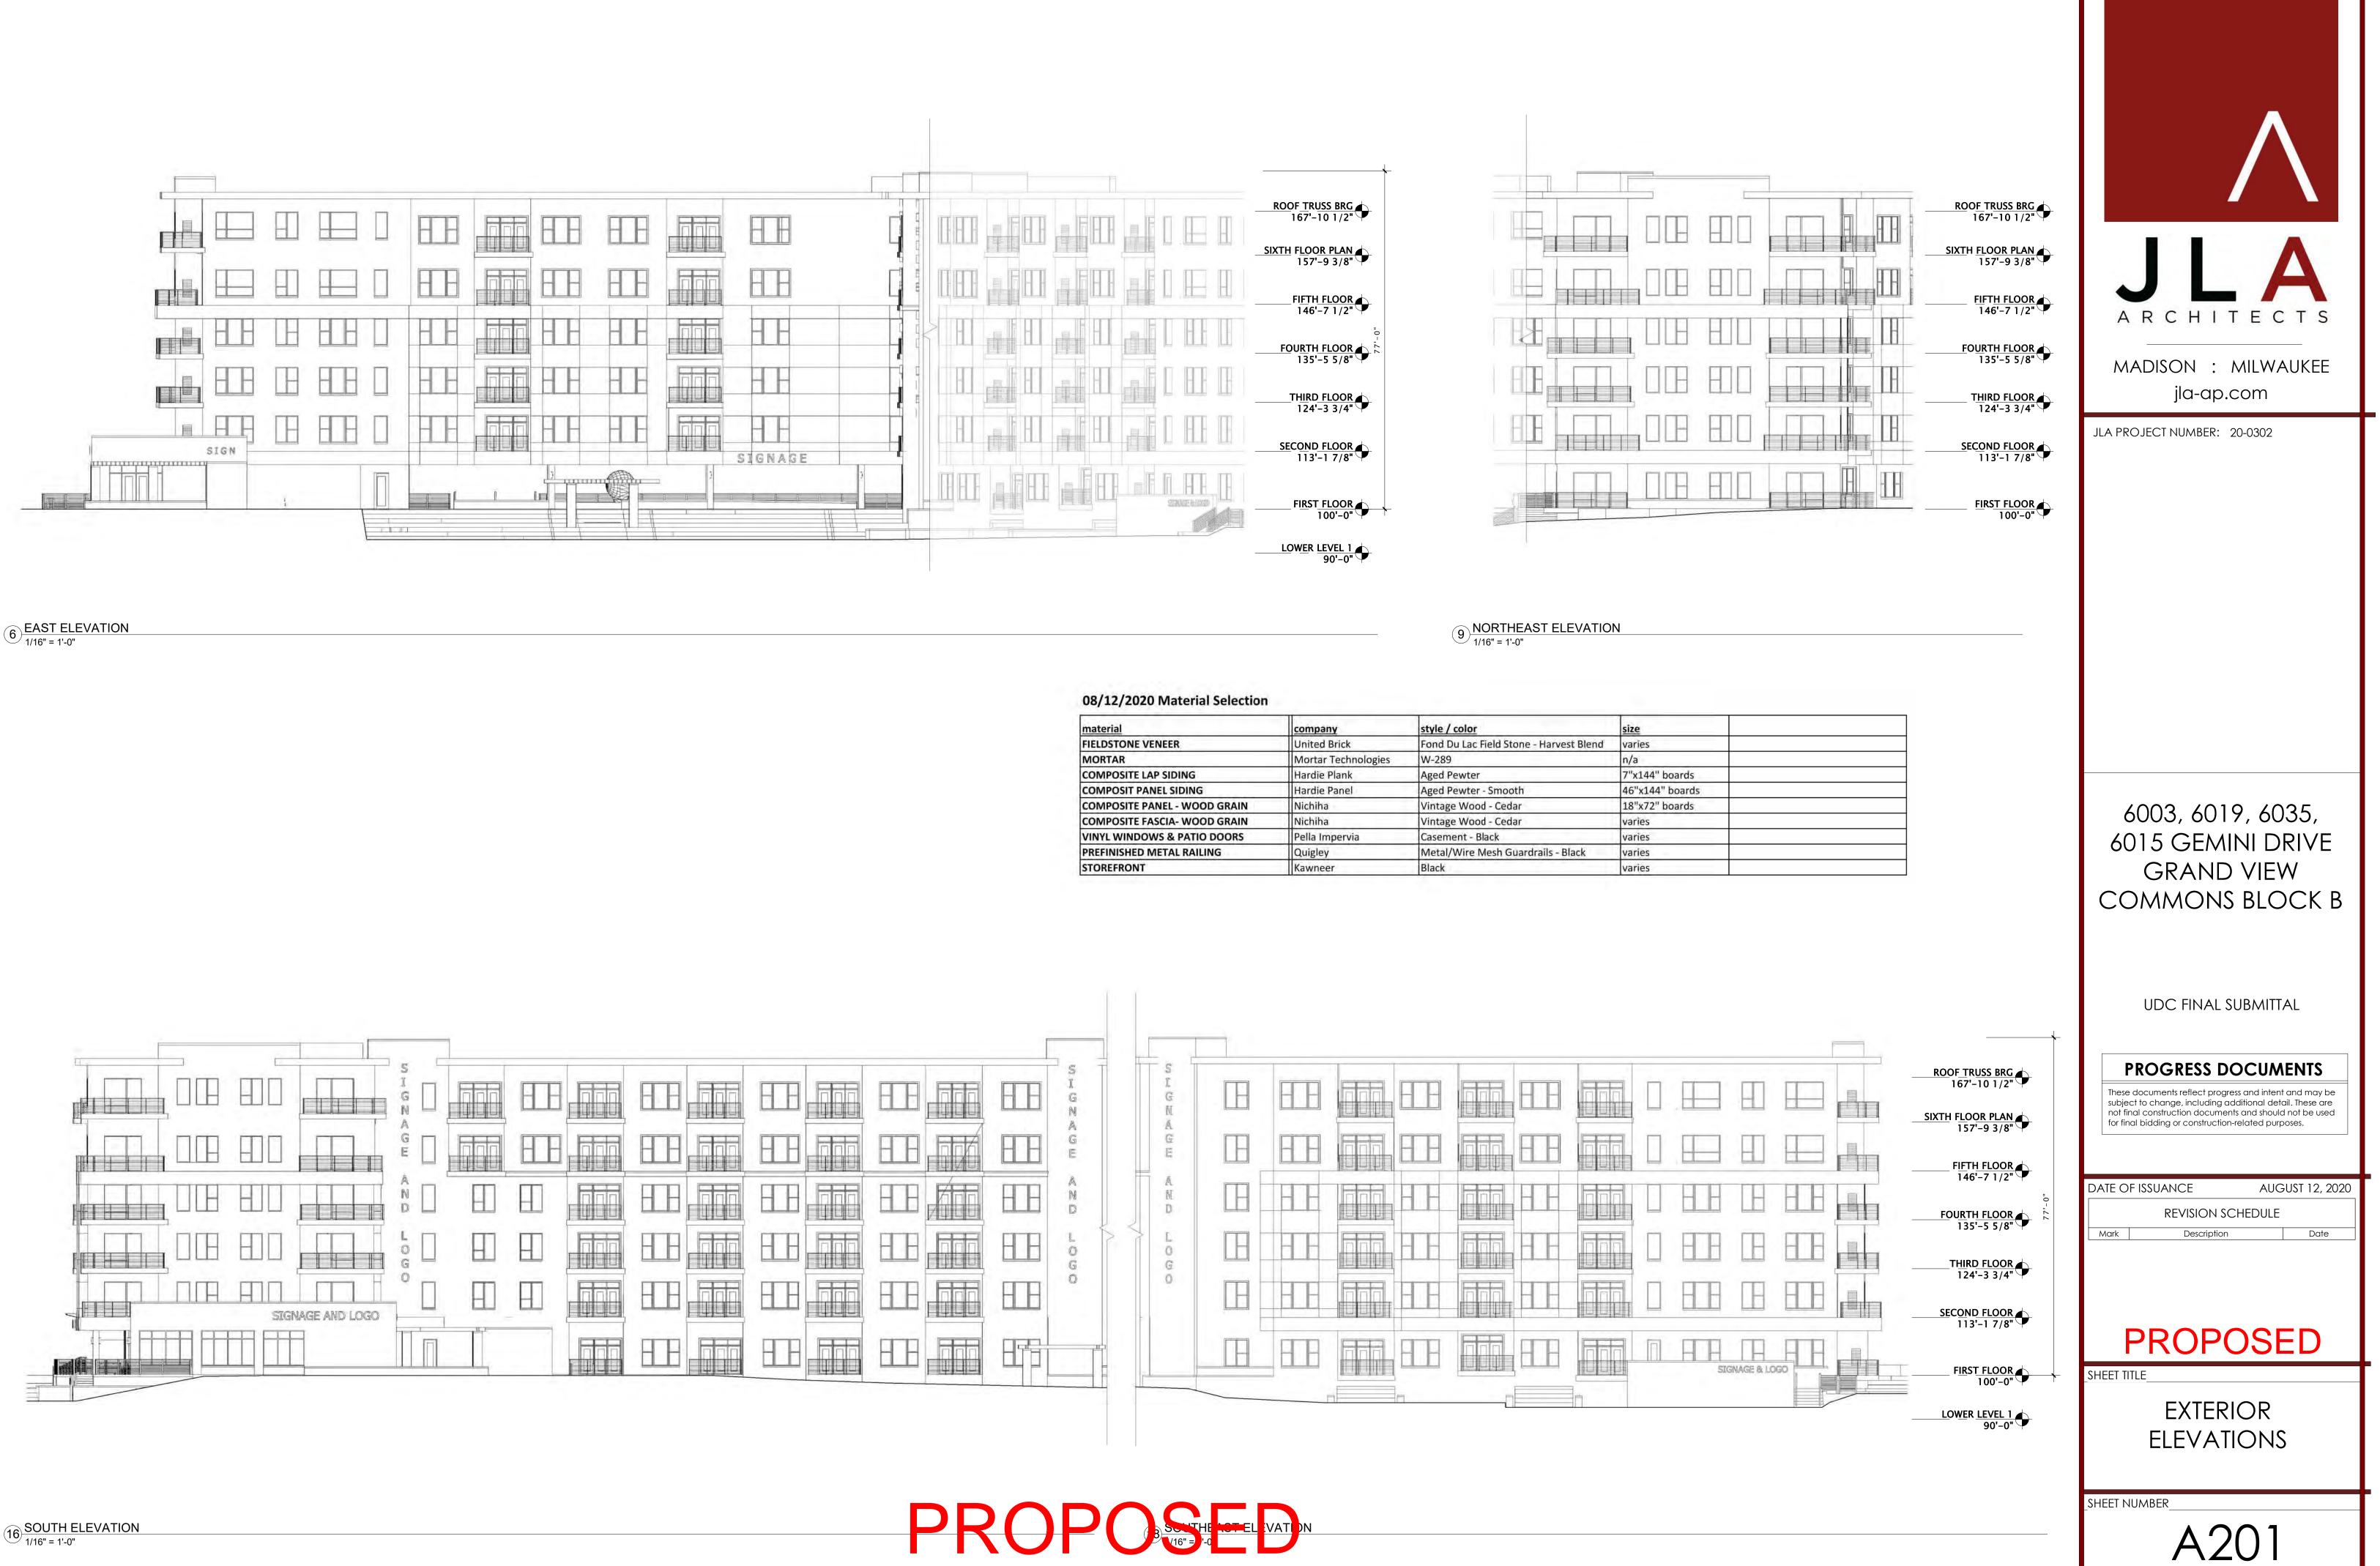

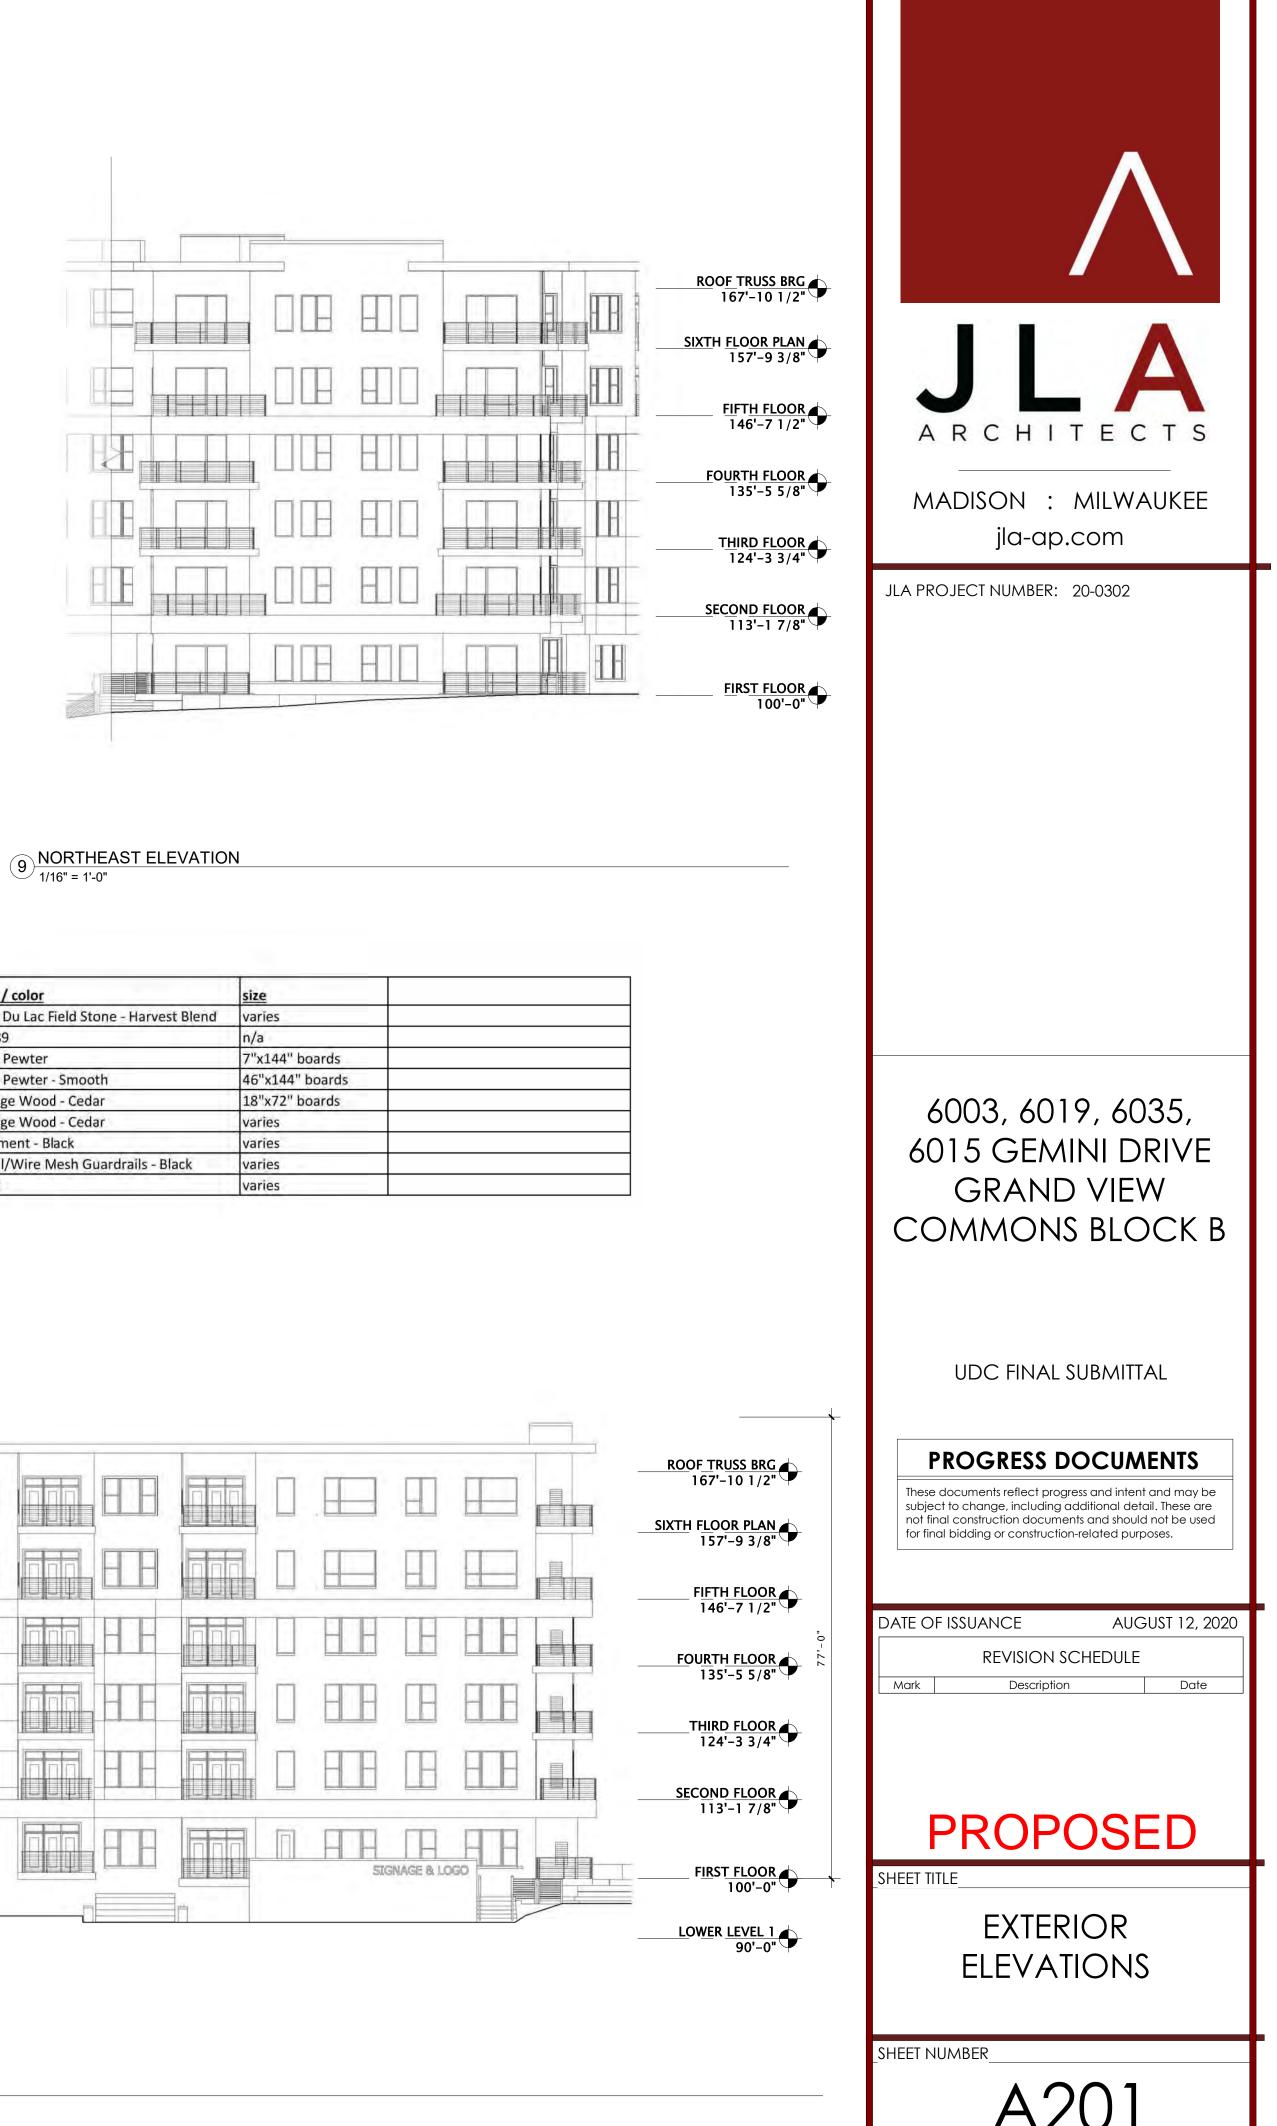

material	company	style / color	siz
FIELDSTONE VENEER	United Brick	Fond Du Lac Field Stone - Harvest Blend	va
MORTAR	Mortar Technologies	W-289	n/
COMPOSITE LAP SIDING	Hardie Plank	Aged Pewter	7"
COMPOSIT PANEL SIDING	Hardie Panel	Aged Pewter - Smooth	46
COMPOSITE PANEL - WOOD GRAIN	Nichiha	Vintage Wood - Cedar	18
COMPOSITE FASCIA- WOOD GRAIN	Nichiha	Vintage Wood - Cedar	va
VINYL WINDOWS & PATIO DOORS	Pella Impervia	Casement - Black	va
PREFINISHED METAL RAILING	Quigley	Metal/Wire Mesh Guardrails - Black	va
STOREFRONT	Kawneer	Black	va



VIEW FROM NORTH STAR DRIVE & SHARPSBURG DRIVE

PROPOSED



MADISON : MILWAUKEE jla-ap.com

JLA PROJECT NUMBER: 20-0302

6003, 6019, 6035, 6015 GEMINI DRIVE GRAND VIEW COMMONS BLOCK B

UDC FINAL SUBMITTAL

PROGRESS DOCUMENTS

SUANCE	AUGUST 12, 2020
REVISION SCH	EDULE
Description	Date
ROPC	SED
	<i>N</i> AGES
BER	
	\mathbf{D}
AZA	20
	REVISION SCH Description



VIEW FROM NORTH STAR DRIVE & COTTAGE GROVE ROAD

PROPOSED



jla-ap.com

JLA PROJECT NUMBER: 20-0302

6003, 6019, 6035, 6015 GEMINI DRIVE GRAND VIEW COMMONS BLOCK B

UDC FINAL SUBMITTAL

PROGRESS DOCUMENTS

DATE OF IS	SUANCE	AUGUST 12, 2020
	REVISION SC	HEDULE
Mark	Description	Date
	ROPC	JSED
SHEET TITLE		
	TERIOR I	
		MAGES
SHEET NUM		
		• -
	Δク	21



VIEW FROM COTTAGE GROVE ROAD & GEMINI DRIVE

PROPOSED



MADISON : MILWAUKEE jla-ap.com

JLA PROJECT NUMBER: 20-0302

6003, 6019, 6035, 6015 GEMINI DRIVE GRAND VIEW COMMONS BLOCK B

UDC FINAL SUBMITTAL

PROGRESS DOCUMENTS

DATE OF ISS	DATE OF ISSUANCE AUGUST 12, 202				
REVISION SCHEDULE					
Mark	Description		Date		
PROPOSED					
SHEET TITLE					
EXTERIOR IMAGES					
SHEET NUM	BER				
Α'/'/					
	/ \		-		



VIEW FROM GEMINI DRIVE

PROPOSED





MADISON : MILWAUKEE jla-ap.com

JLA PROJECT NUMBER: 20-0302

6003, 6019, 6035, 6015 GEMINI DRIVE GRAND VIEW COMMONS BLOCK B

UDC FINAL SUBMITTAL

PROGRESS DOCUMENTS

DATE OF ISSUANCE AUGUST 12, 20					
REVISION SC	HEDULE				
Mark Description	Date				
PROPOSED					
SHEET TITLE					
Exterior Images					
_SHEET NUMBER					
	0 2				
AZ	ZJ				



VIEW FROM GEMINI DRIVE & SHARPSBURG DRIVE

PROPOSED



MADISON : MILWAUKEE jla-ap.com


JLA PROJECT NUMBER: 20-0302

6003, 6019, 6035, 6015 GEMINI DRIVE GRAND VIEW COMMONS BLOCK B

udc final submittal

PROGRESS DOCUMENTS

DATE OF IS	DATE OF ISSUANCE AUGUST 12, 2020			
	REVISION SC	HEDULE		
Mark	Description	Date		
P	ROPC	JSED		
SHEET TITLE				
FX ⁻	TERIOR I	MAGES		
_SHEET NUM	1BER			
	ΔΟ	24		
		∠ 4		

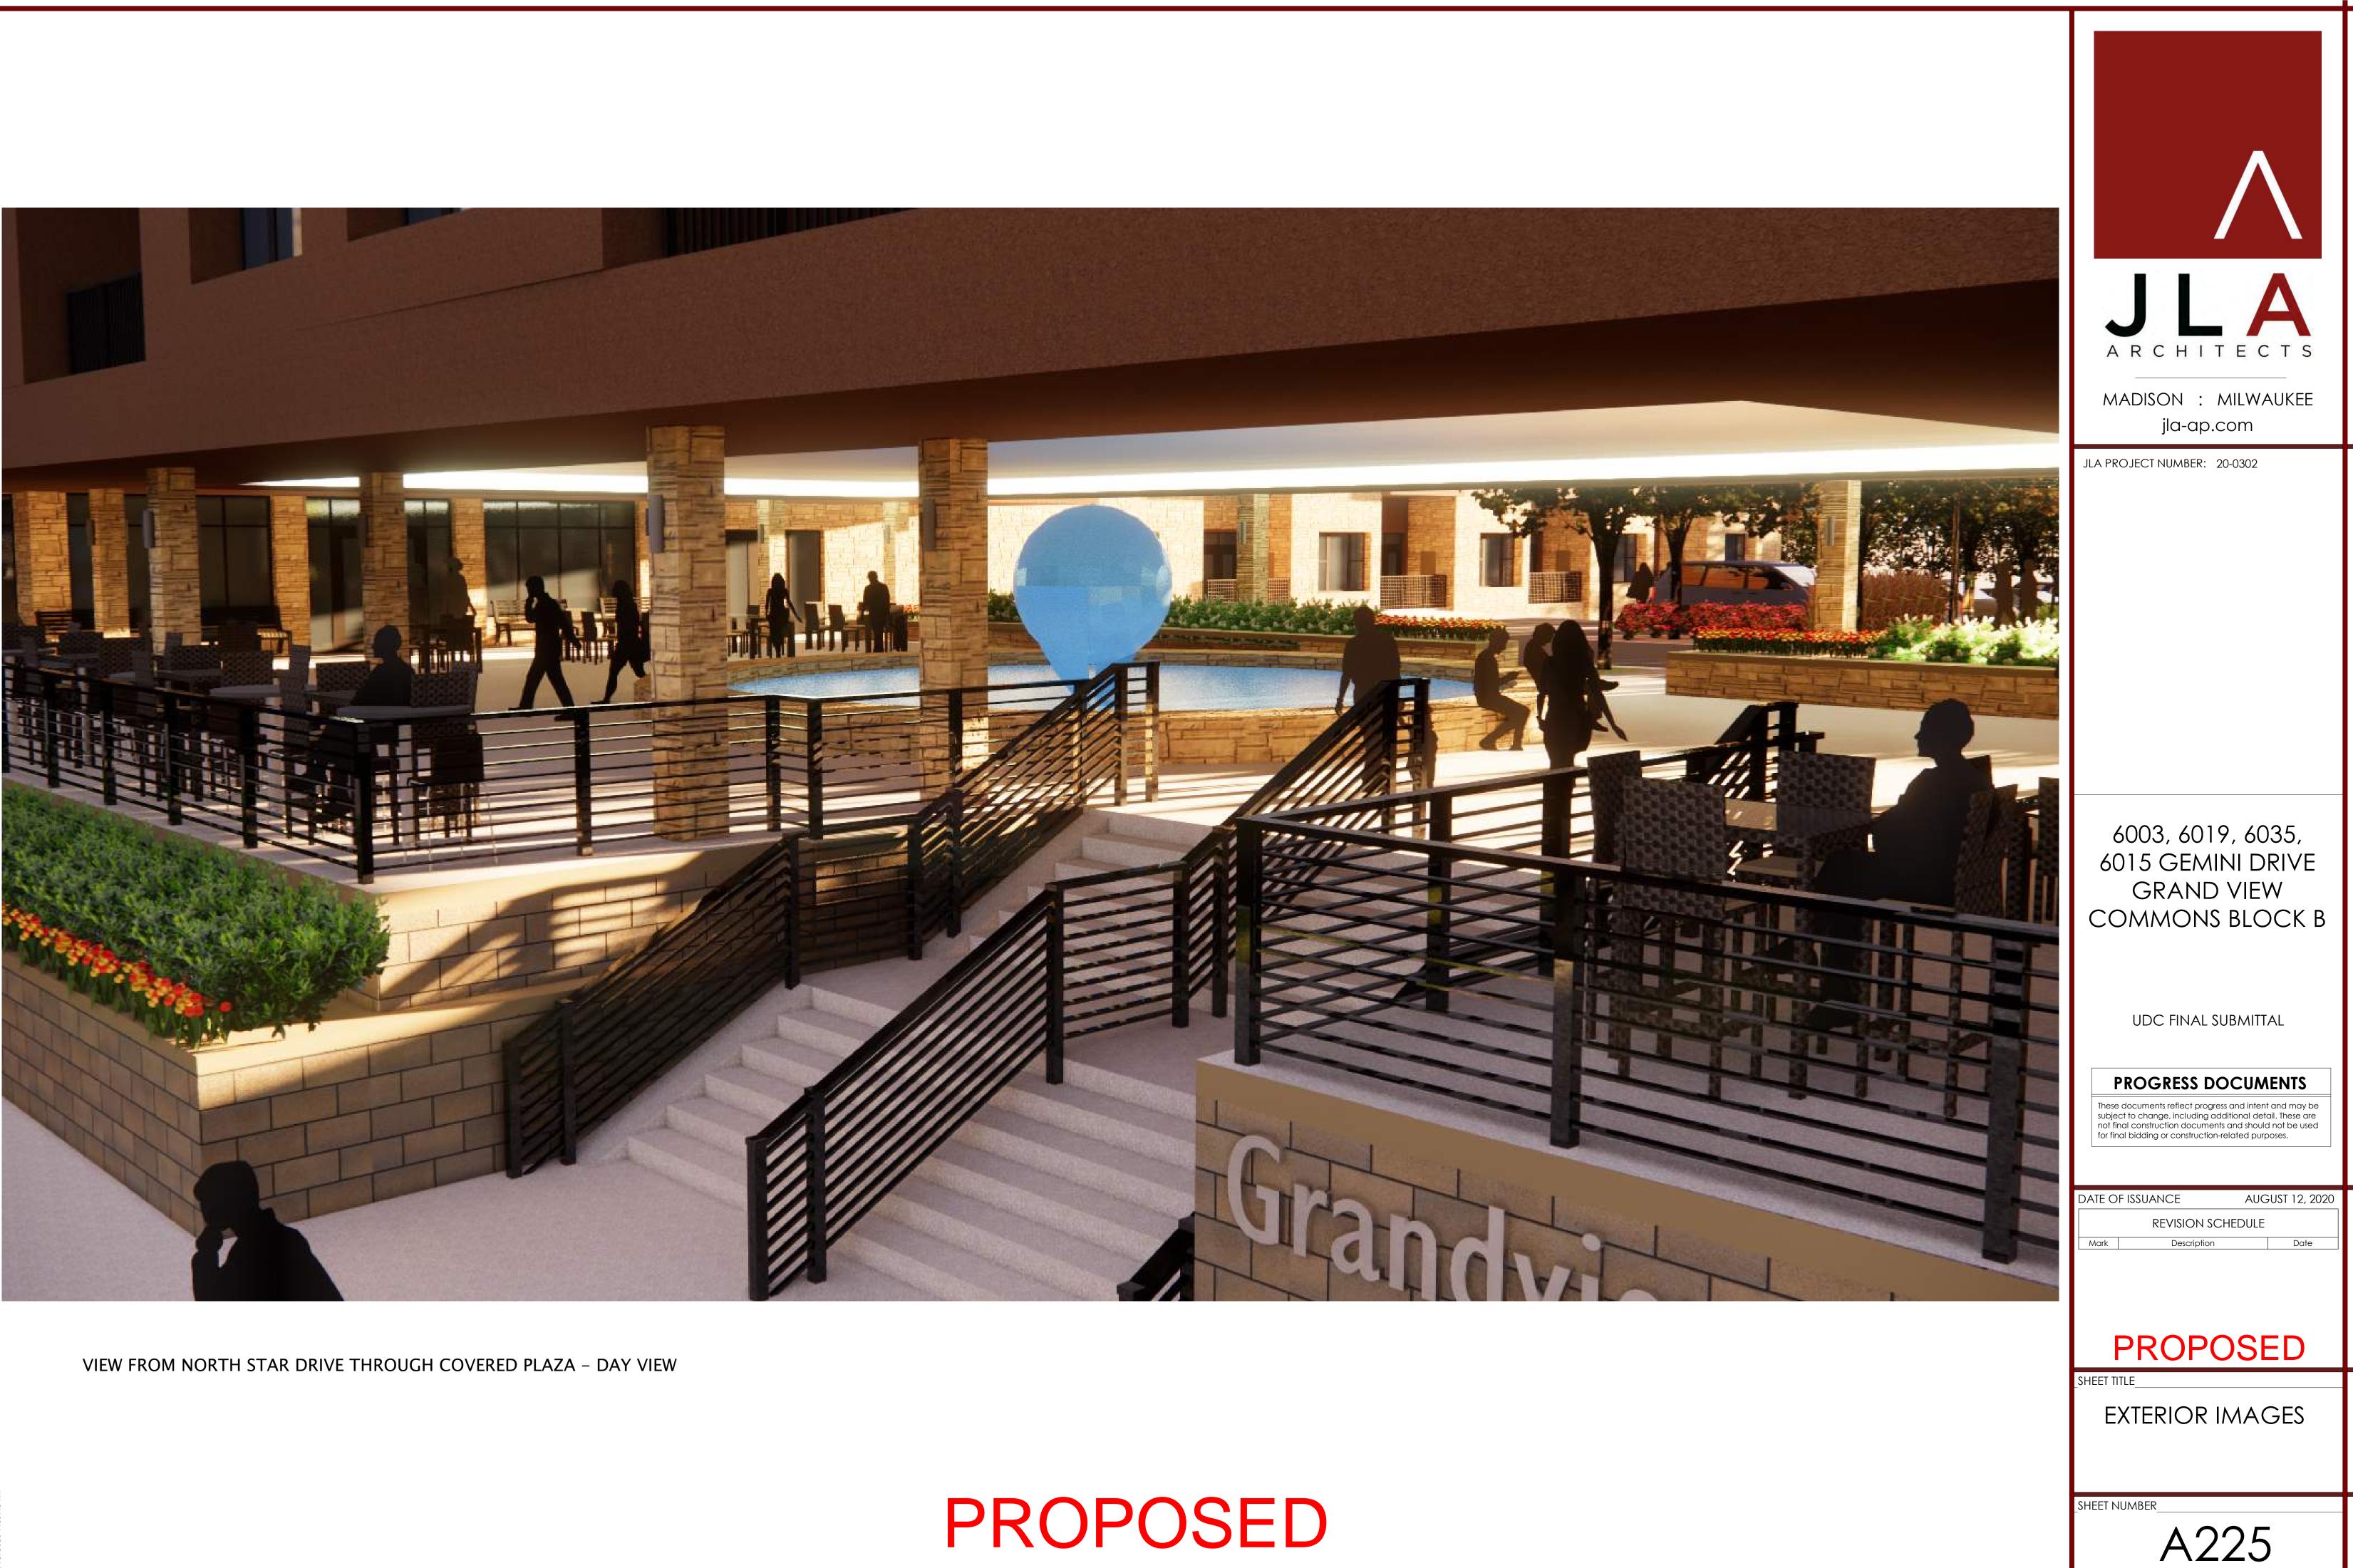

PROPOSED



PROPOSED



jla-ap.com

JLA PROJECT NUMBER: 20-0302

6003, 6019, 6035, 6015 GEMINI DRIVE GRAND VIEW COMMONS BLOCK B

UDC FINAL SUBMITTAL

PROGRESS DOCUMENTS

DATE OF	- ISSUANCE	AUGUST 12, 2020			
REVISION SCHEDULE					
Mark	Description	Date			
	PROPC	JSED			
SHEET TIT	īLE				
Exterior Images					
_SHEET NI	UMBER				
		77			
	⊢ ⊢ L	∠ /			



08/12/2020 Material Selection

material	company	style / color	size	
FIELDSTONE VENEER	United Brick	Fond Du Lac Field Stone - Harvest Blend	varies	
MORTAR	Mortar Technologies	W-289	n/a	
COMPOSITE LAP SIDING	Hardie Plank	Aged Pewter	7"x144" boards	
COMPOSIT PANEL SIDING	Hardie Panel	Aged Pewter - Smooth	46"x144" boards	
COMPOSITE PANEL - WOOD GRAIN	Nichiha	Vintage Wood - Cedar	18"x72" boards	
COMPOSITE FASCIA- WOOD GRAIN	Nichiha	Vintage Wood - Cedar	varies	
VINYL WINDOWS & PATIO DOORS	Pella Impervia	Casement - Black	varies	
PREFINISHED METAL RAILING	Quigley	Metal/Wire Mesh Guardrails - Black	varies	
STOREFRONT	Kawneer	Black	varies	



6003, 6019, 6035, 6015 GEMINI DRIVE GRAND VIEW COMMONS BLOCK B

UDC FINAL SUBMITTAL


PROGRESS DOCUMENTS


These documents reflect progress and intent and may be subject to change, including additional detail. These are not final construction documents and should not be used for final bidding or construction-related purposes.

DATE OF ISSUANCE AUGUST 12, 20				
REVISION SCHEDULE				
Mark	Description	Date		
	PROPO	SED		
SHEET TI	TLE			
EX	IERIOR MA	TERIALS		


A210


SHEET NUMBER

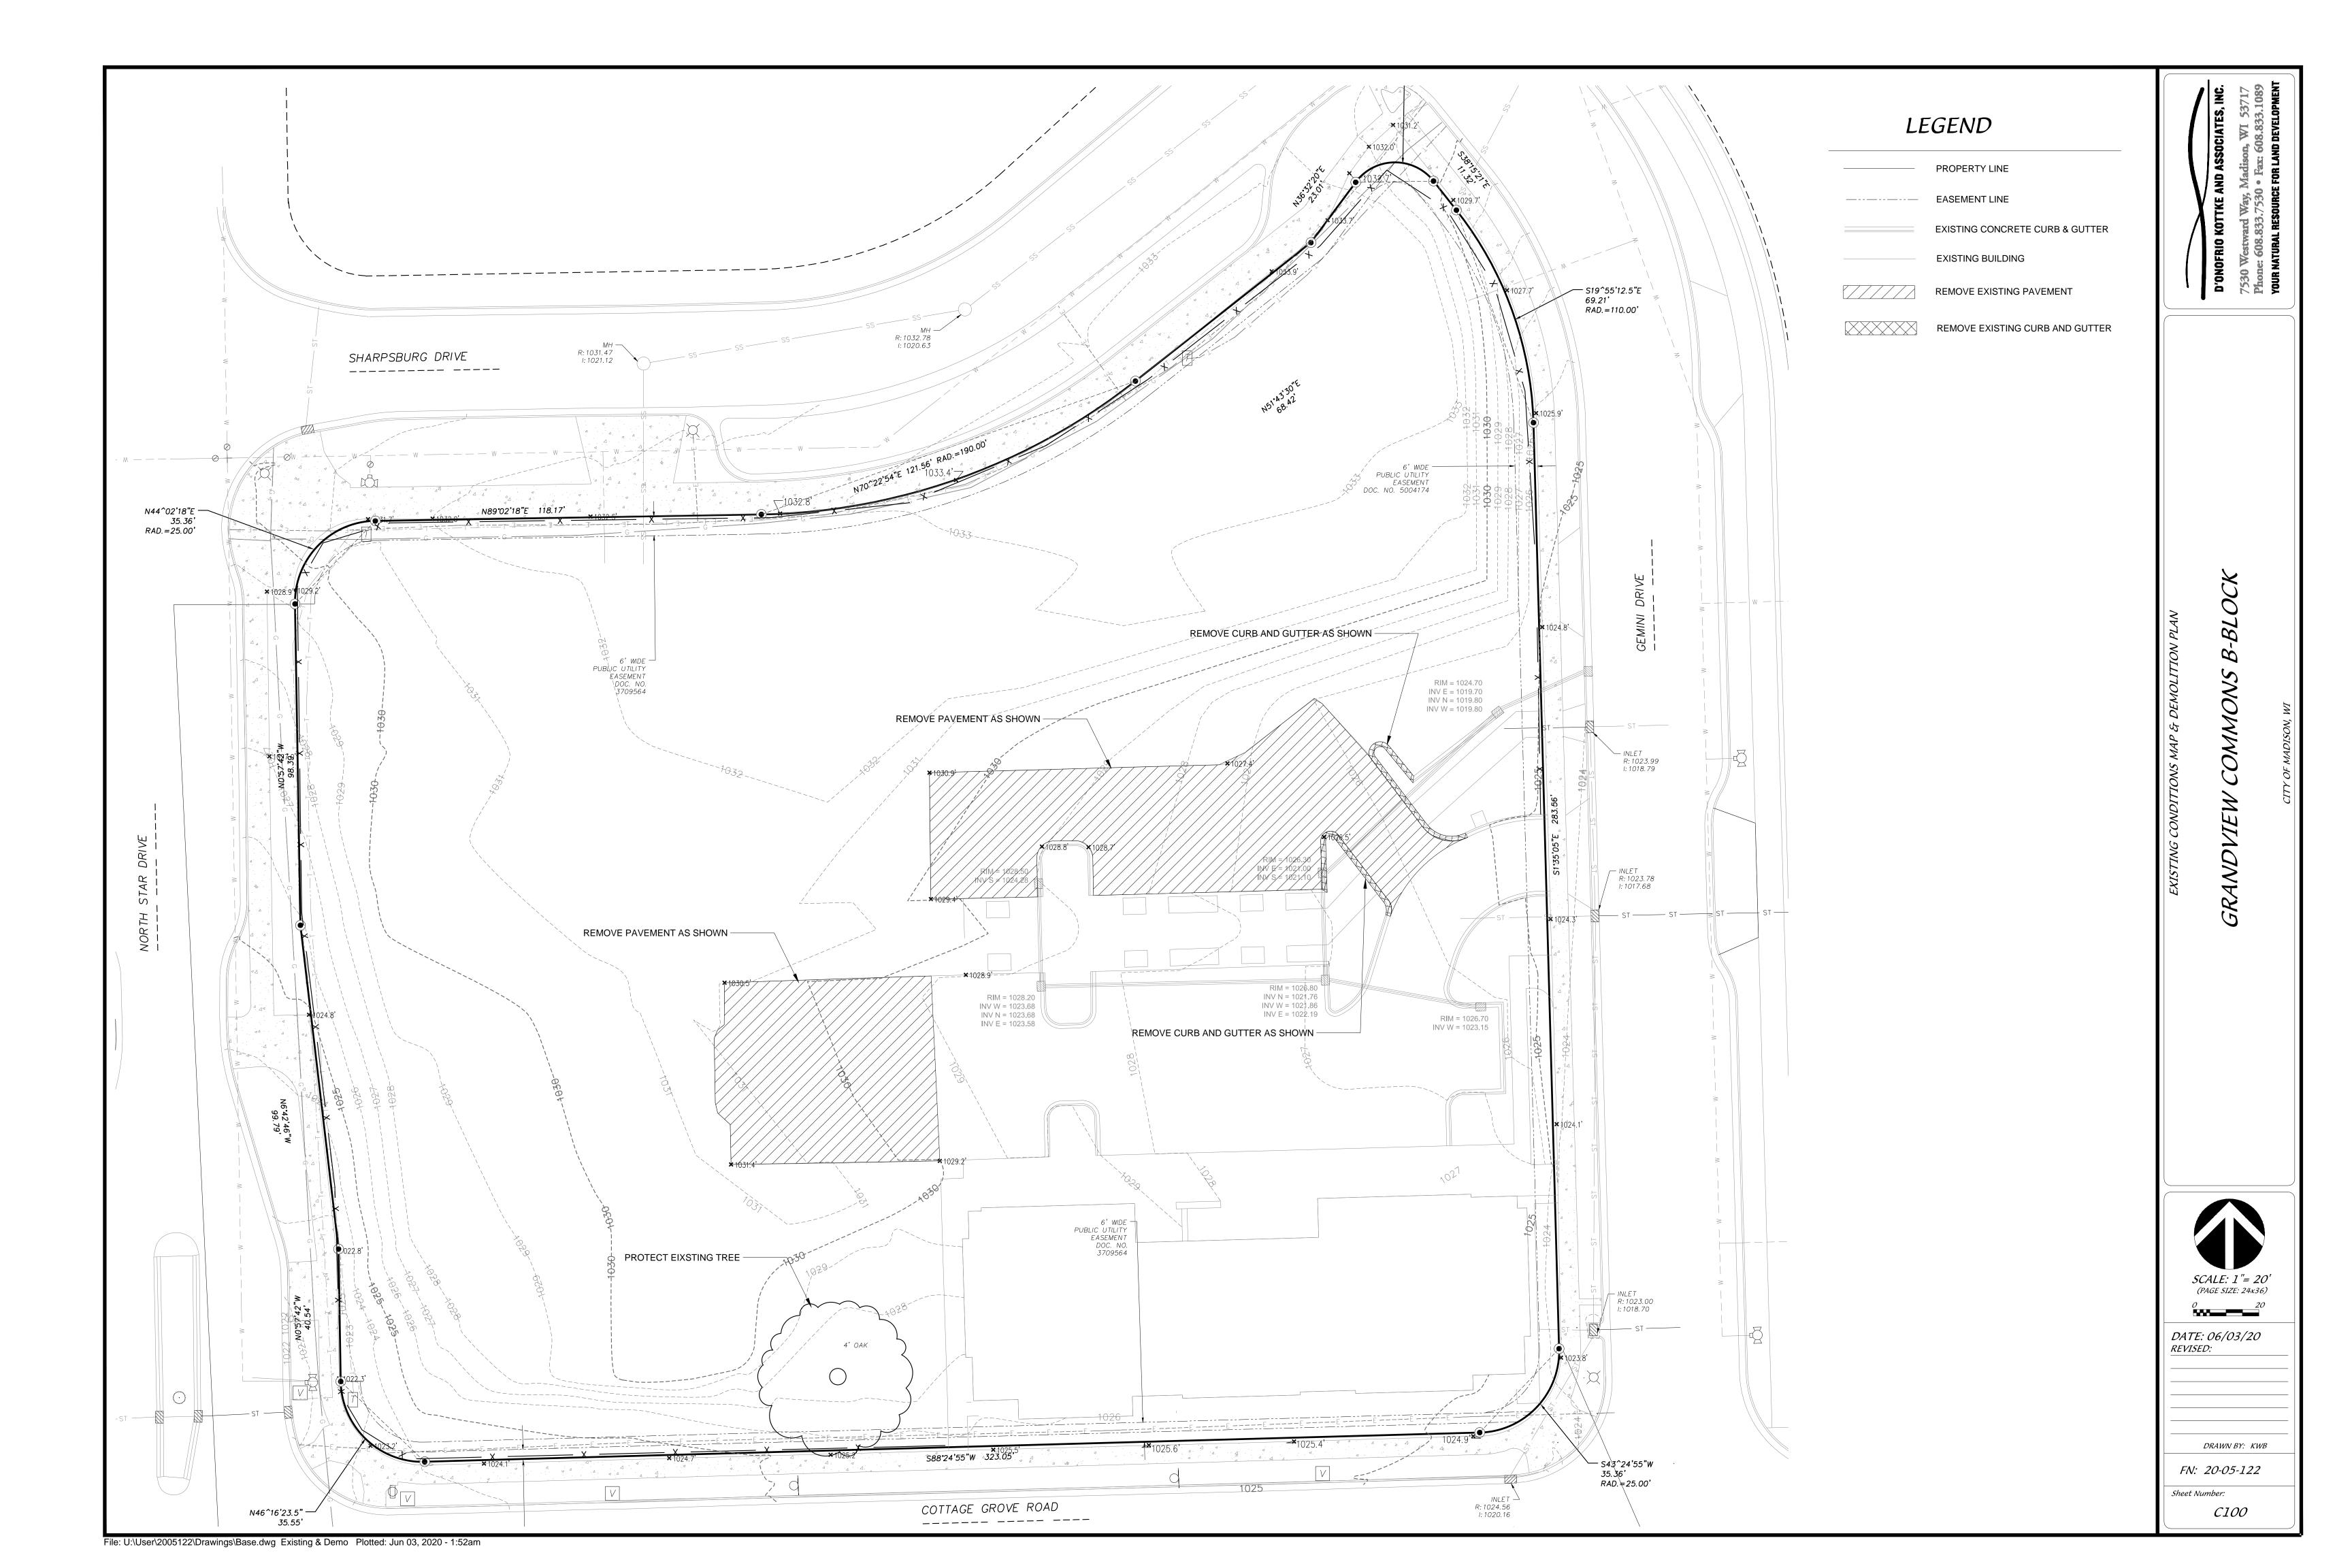

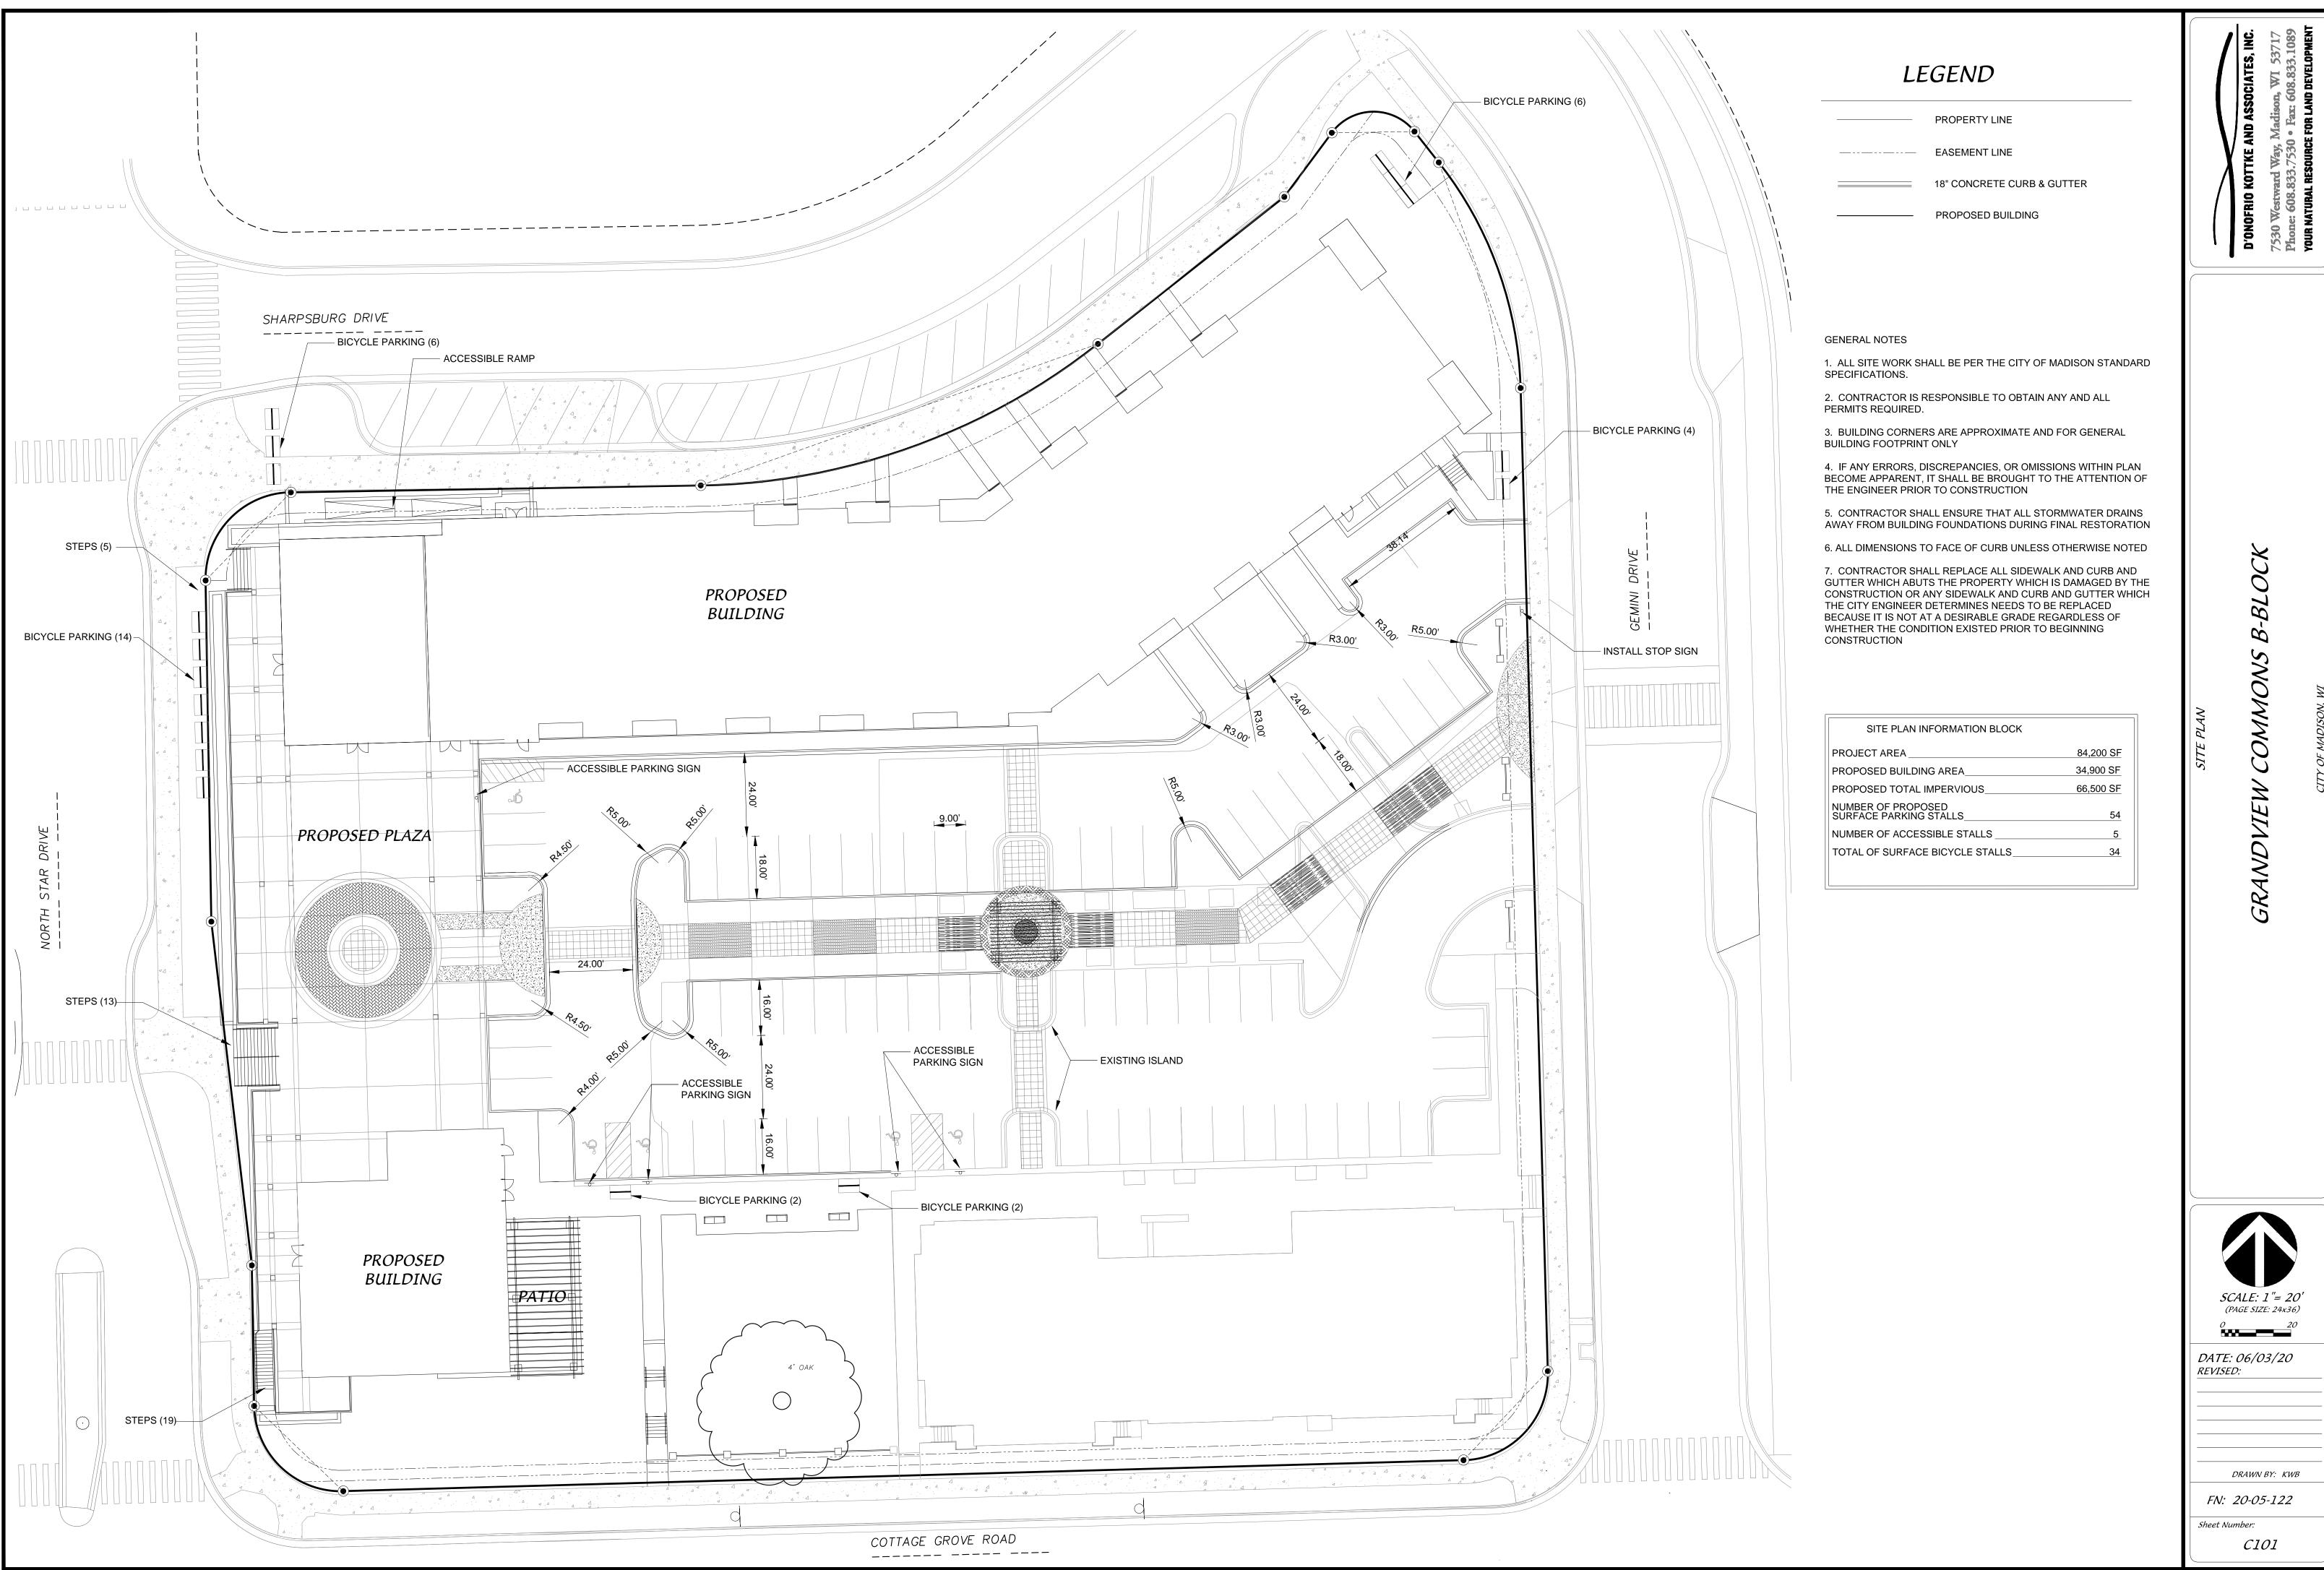


File: U:\User\2005122\Drawings\Base.dwg Site Plan Plotted: Jun 03, 2020 - 1:42am

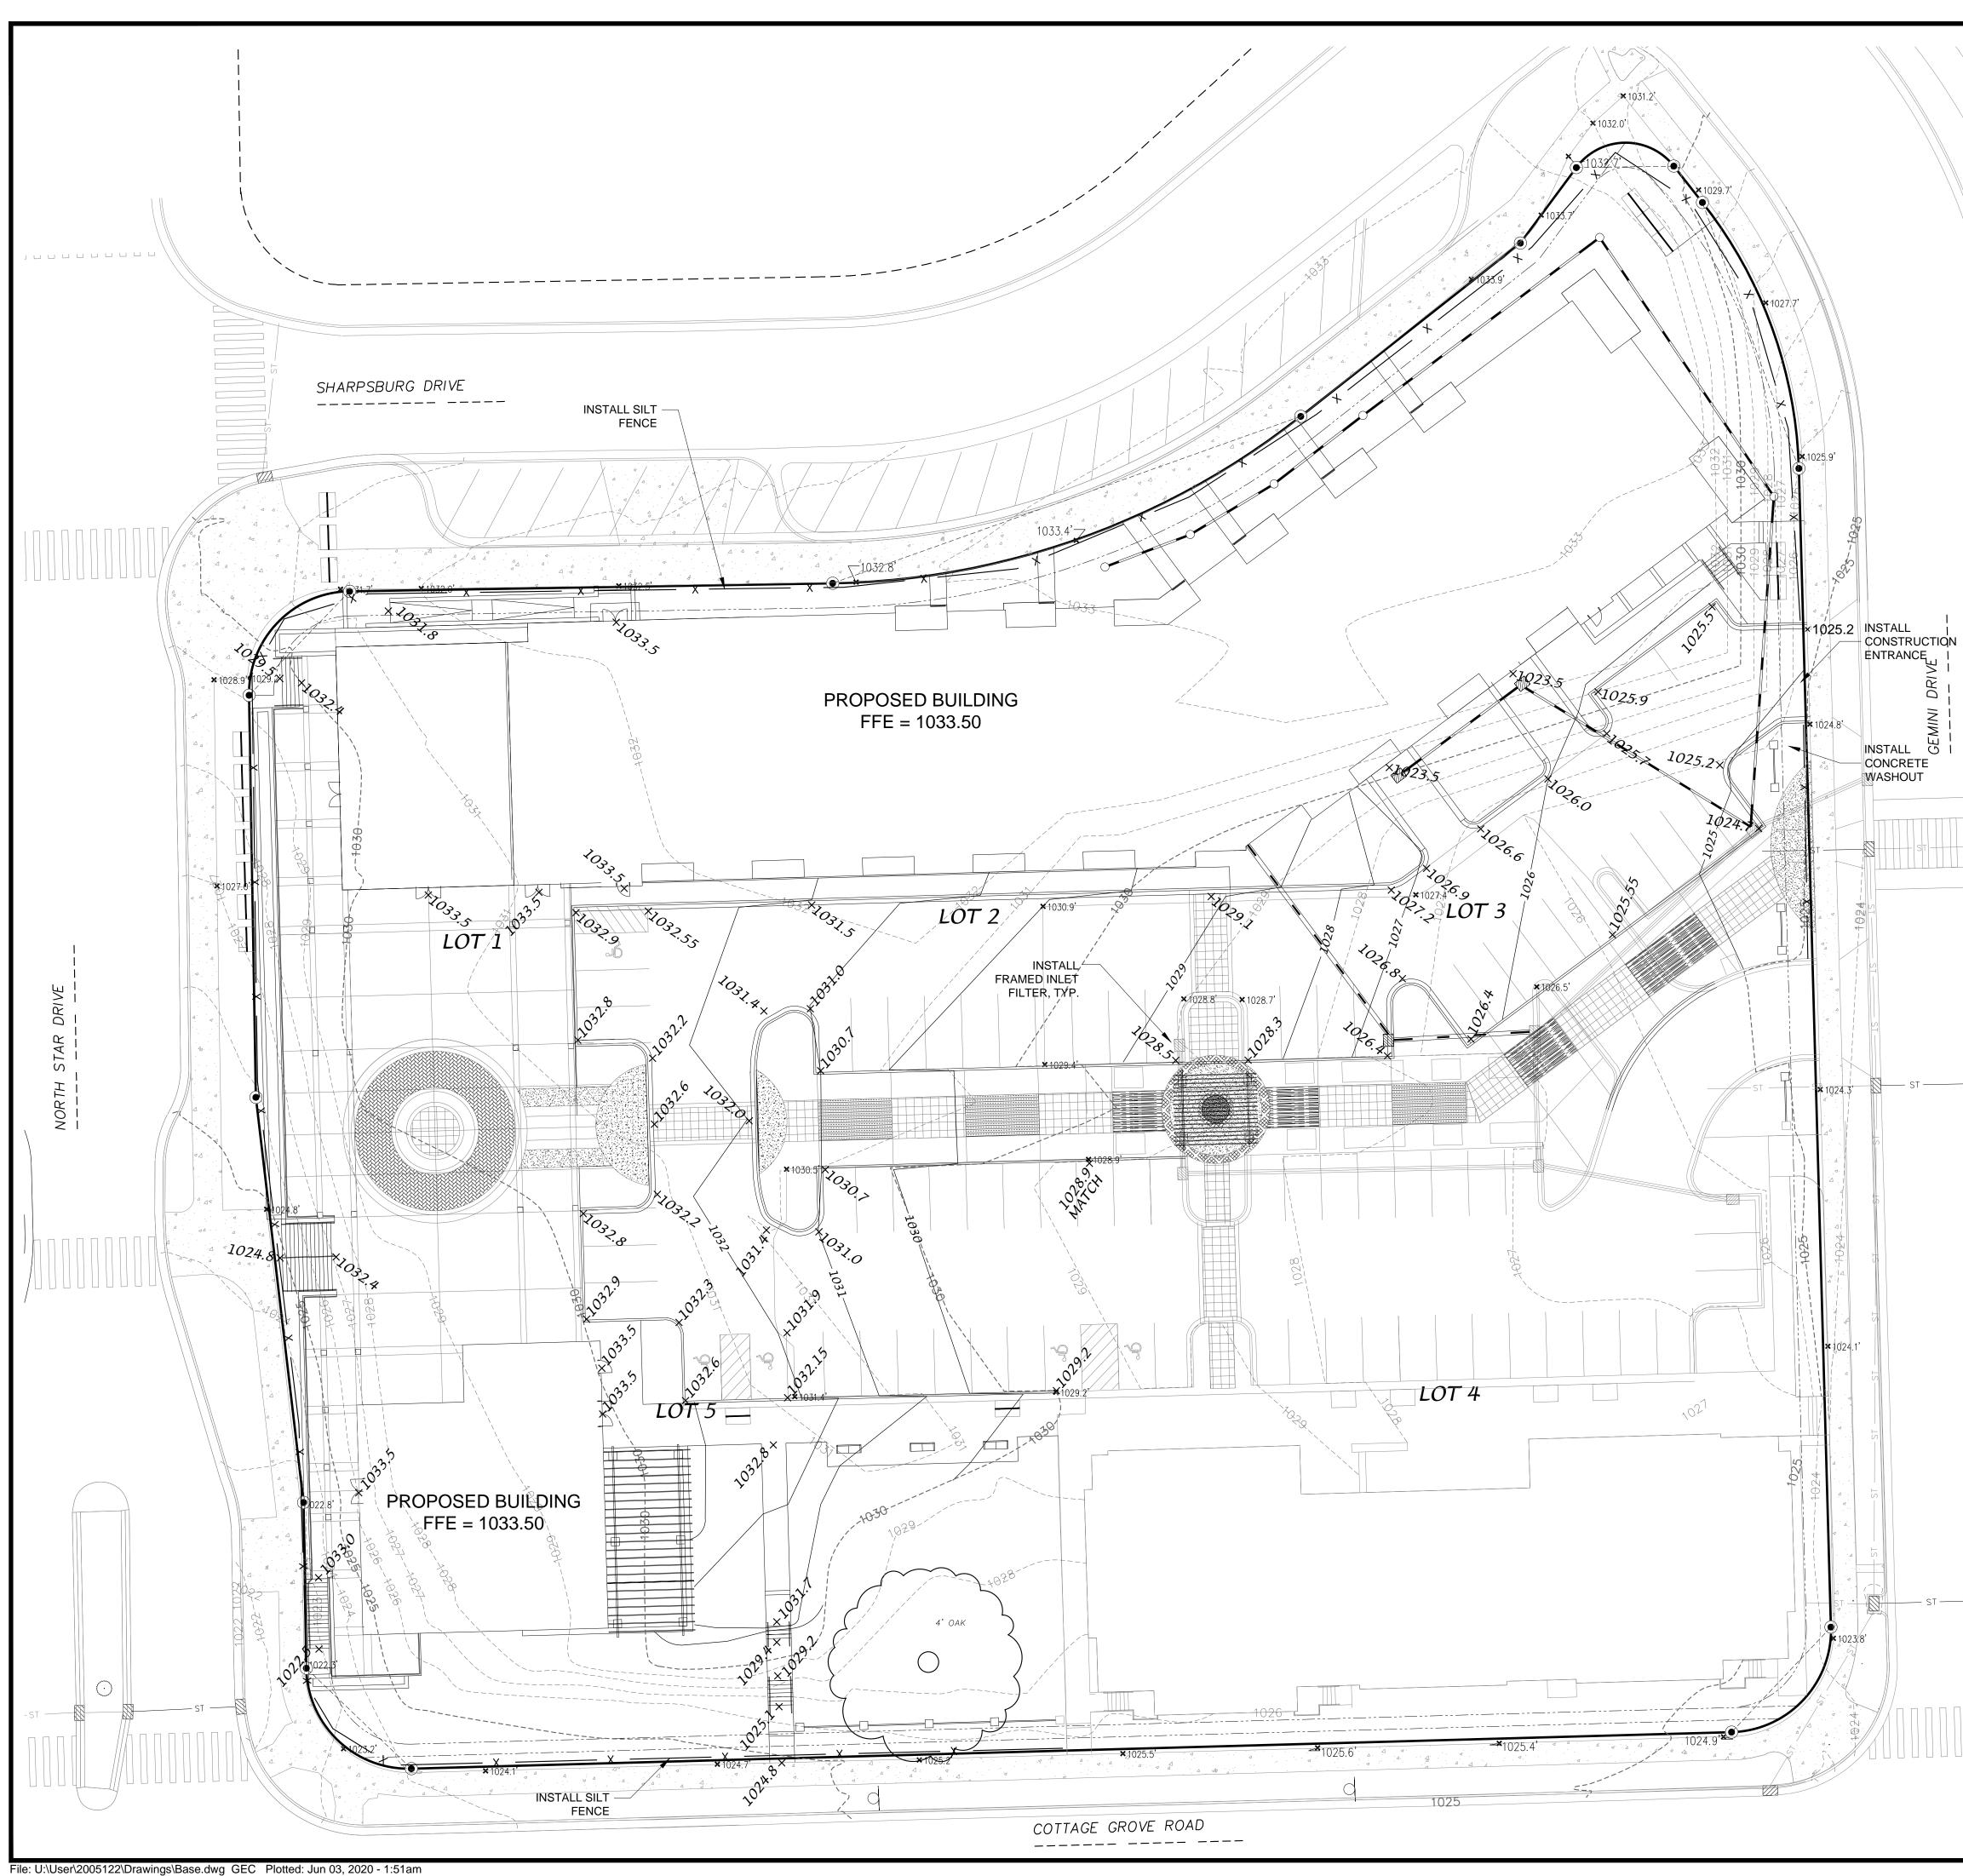


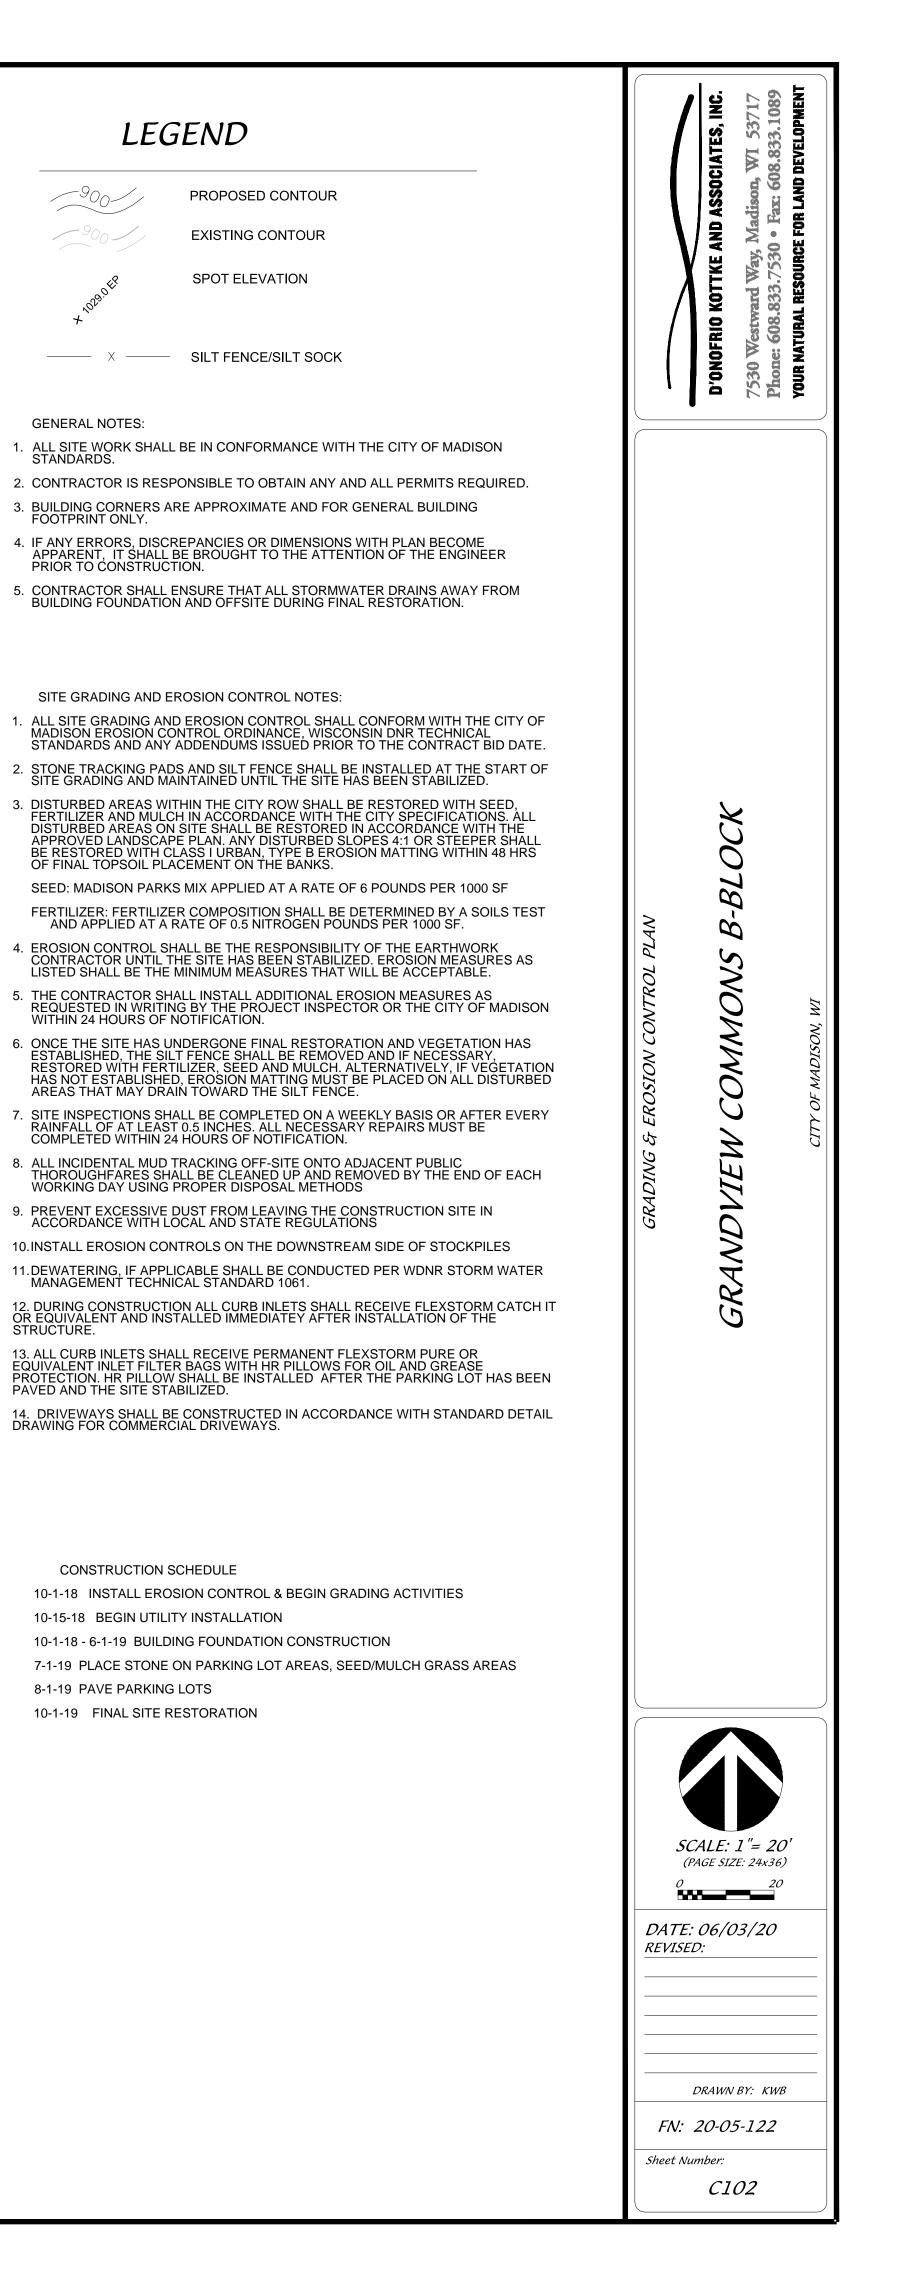


_____ ST _____ ST ____

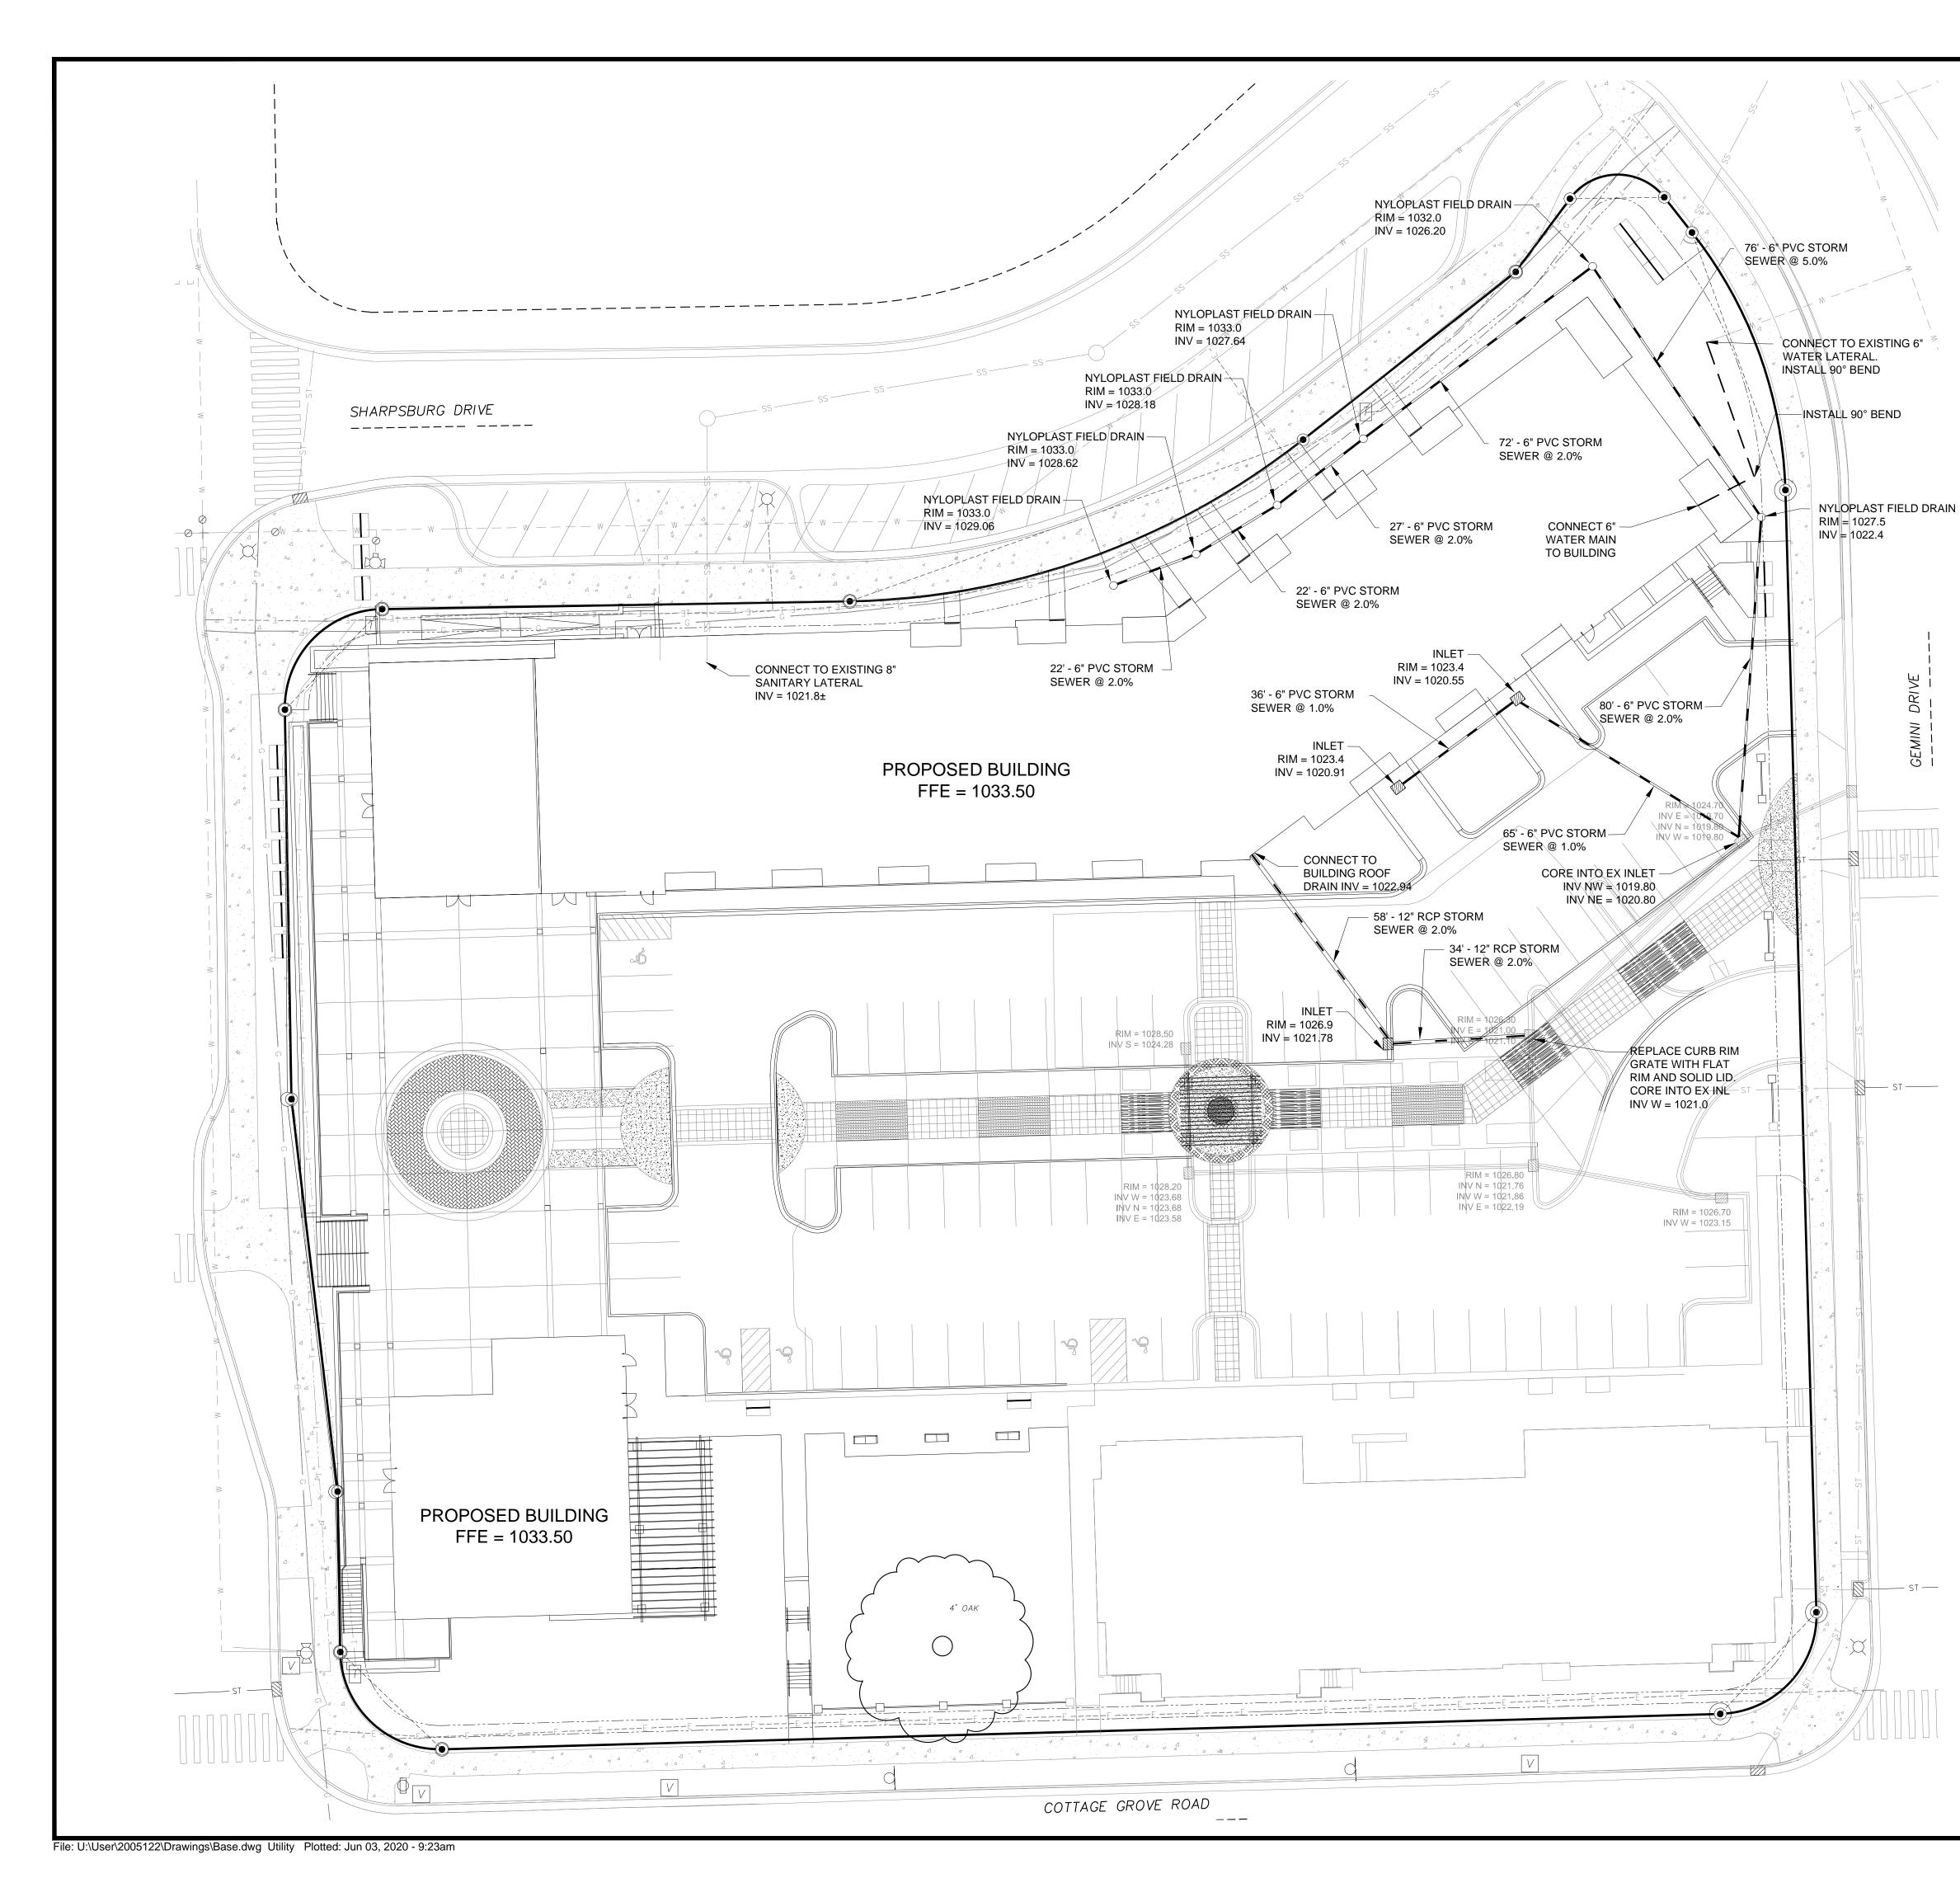

LEGEND 18" CONCRETE CURB & GUTTER PROPOSED BUILDING PROPOSED STORM SEWER PROPOSED SANITARY SEWER PROPOSED WATERMAIN	D'ONOFRIO KOTTKE AND ASSOCIATES, INC. 7530 Westward Way, Madison, W1 53717 Phone: 608.833.7530 • Fax: 608.833.1089 Your natural resource for land development
<section-header><section-header><section-header><list-item><list-item><list-item><list-item><list-item><list-item></list-item></list-item></list-item></list-item></list-item></list-item></section-header></section-header></section-header>	UTILITY PLAN GRANDVIEW COMMONS B-BLOCK
	Image: constraint of the second state of the second sta

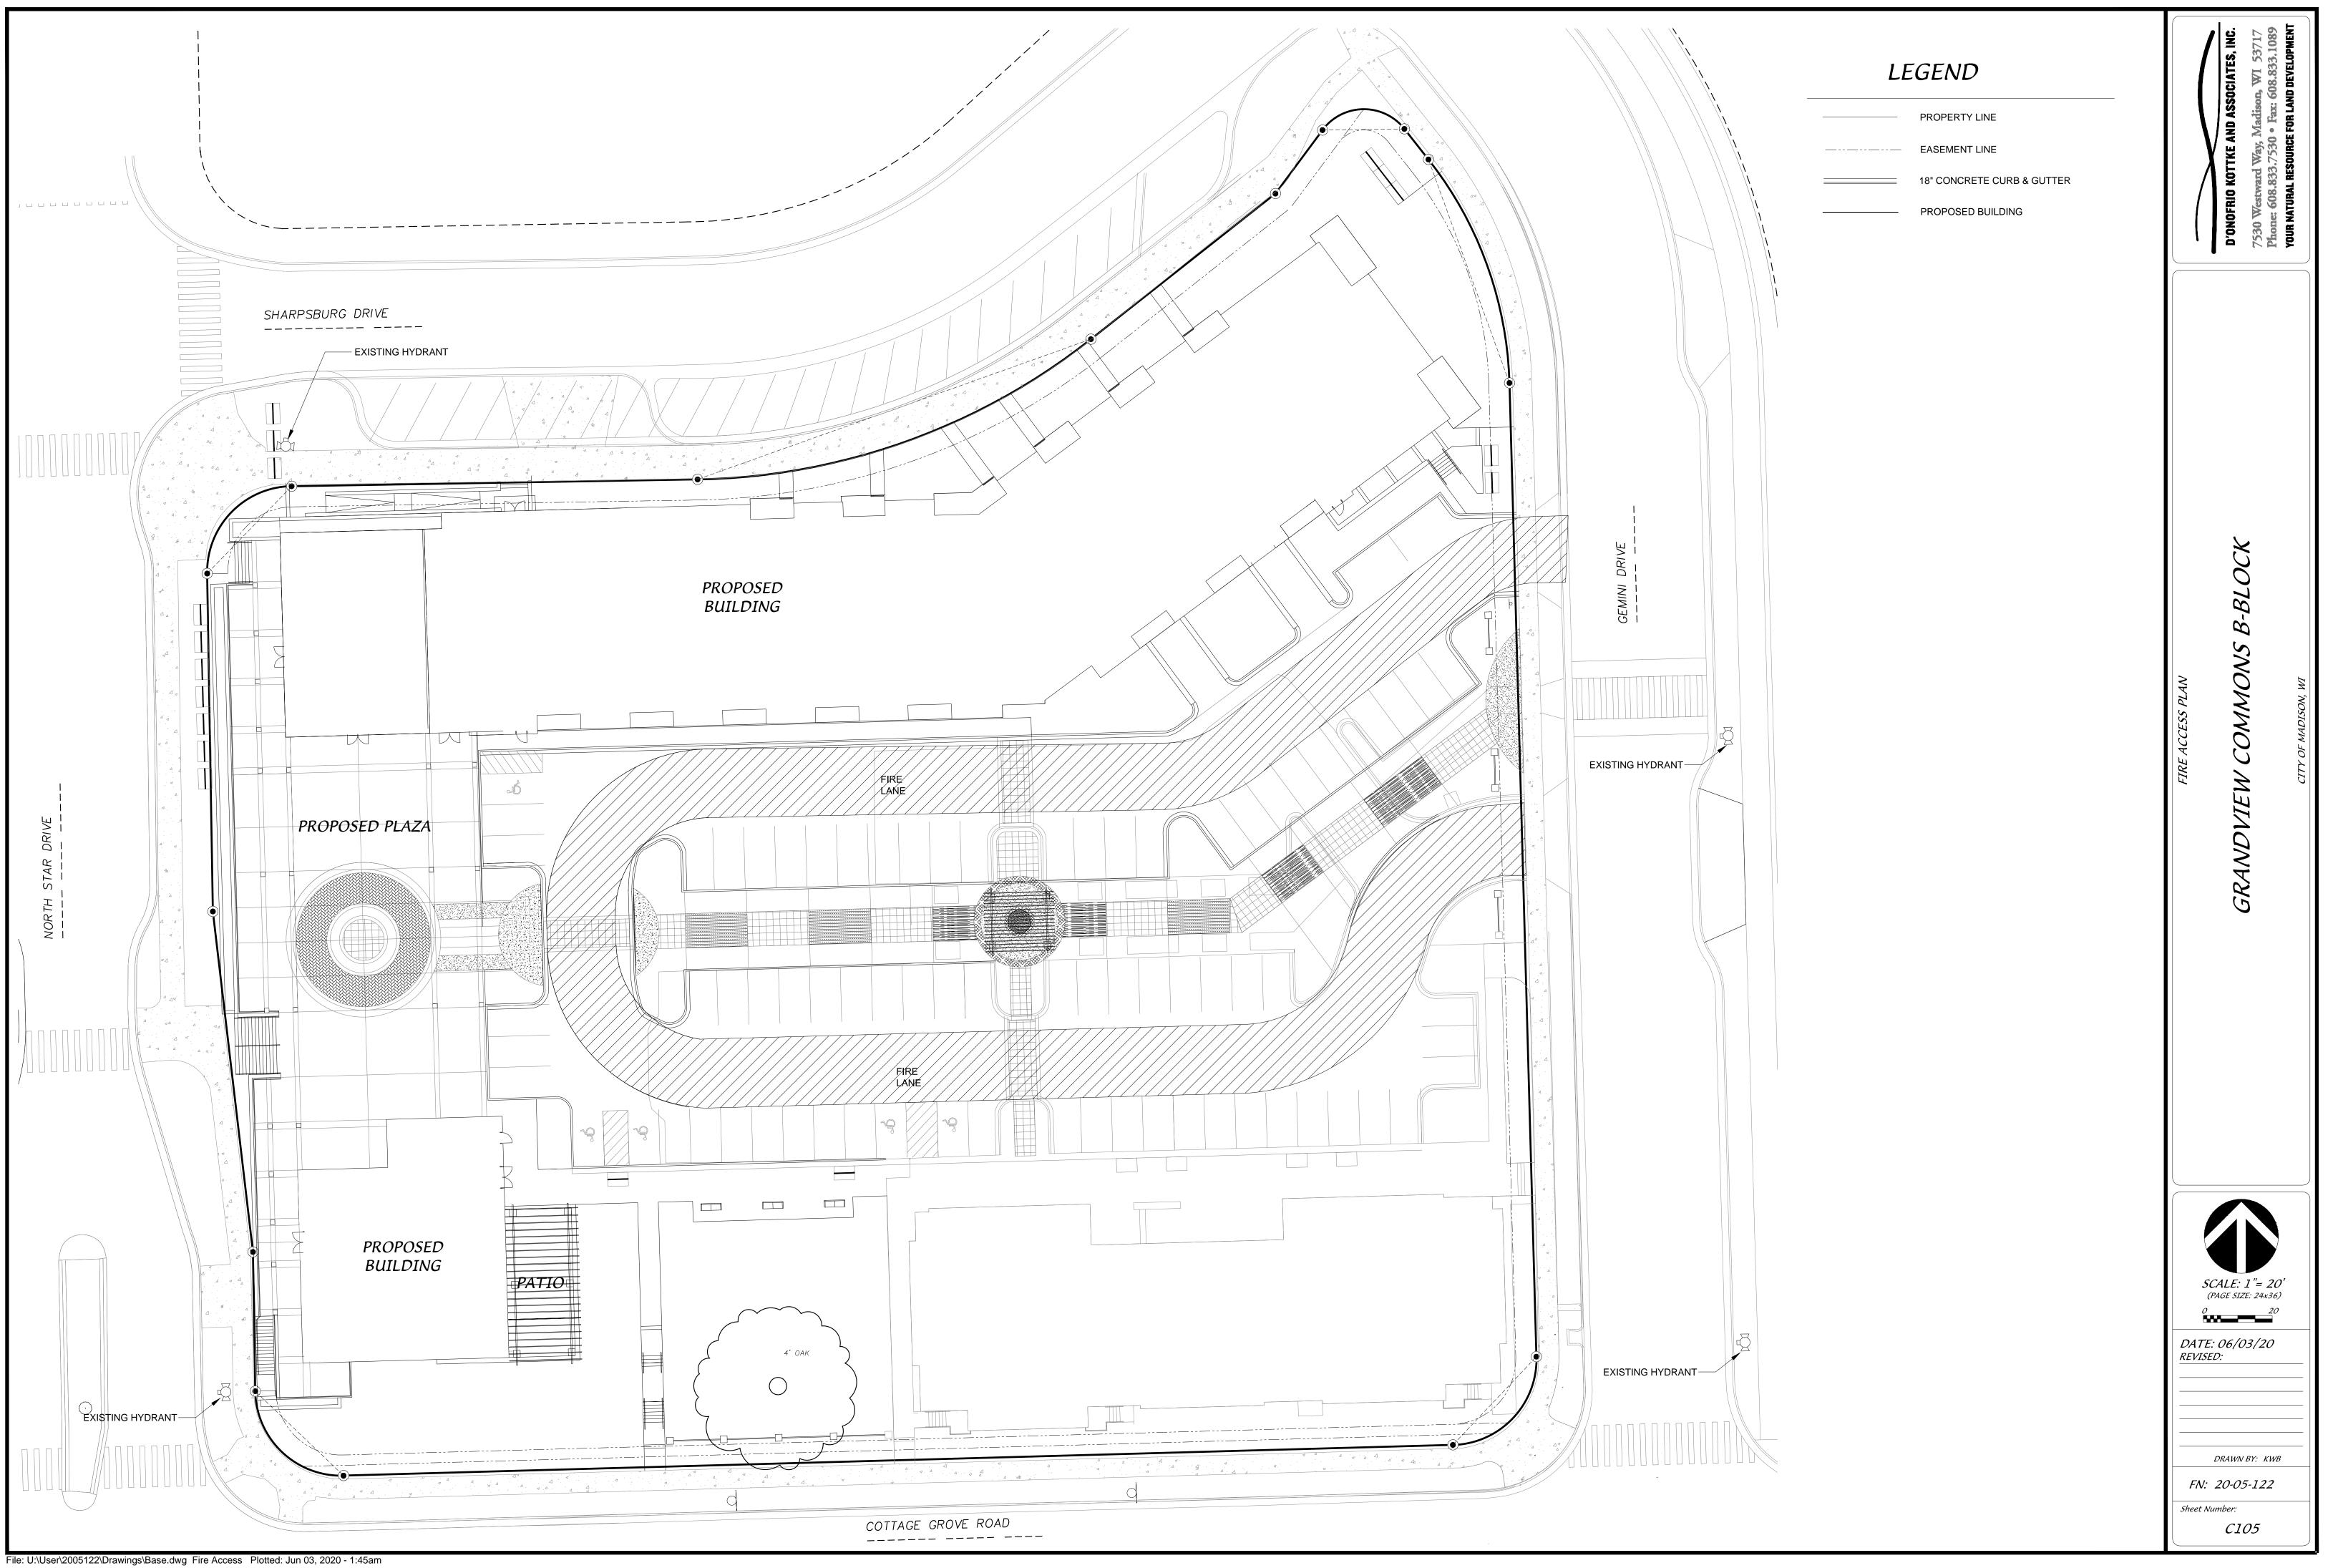

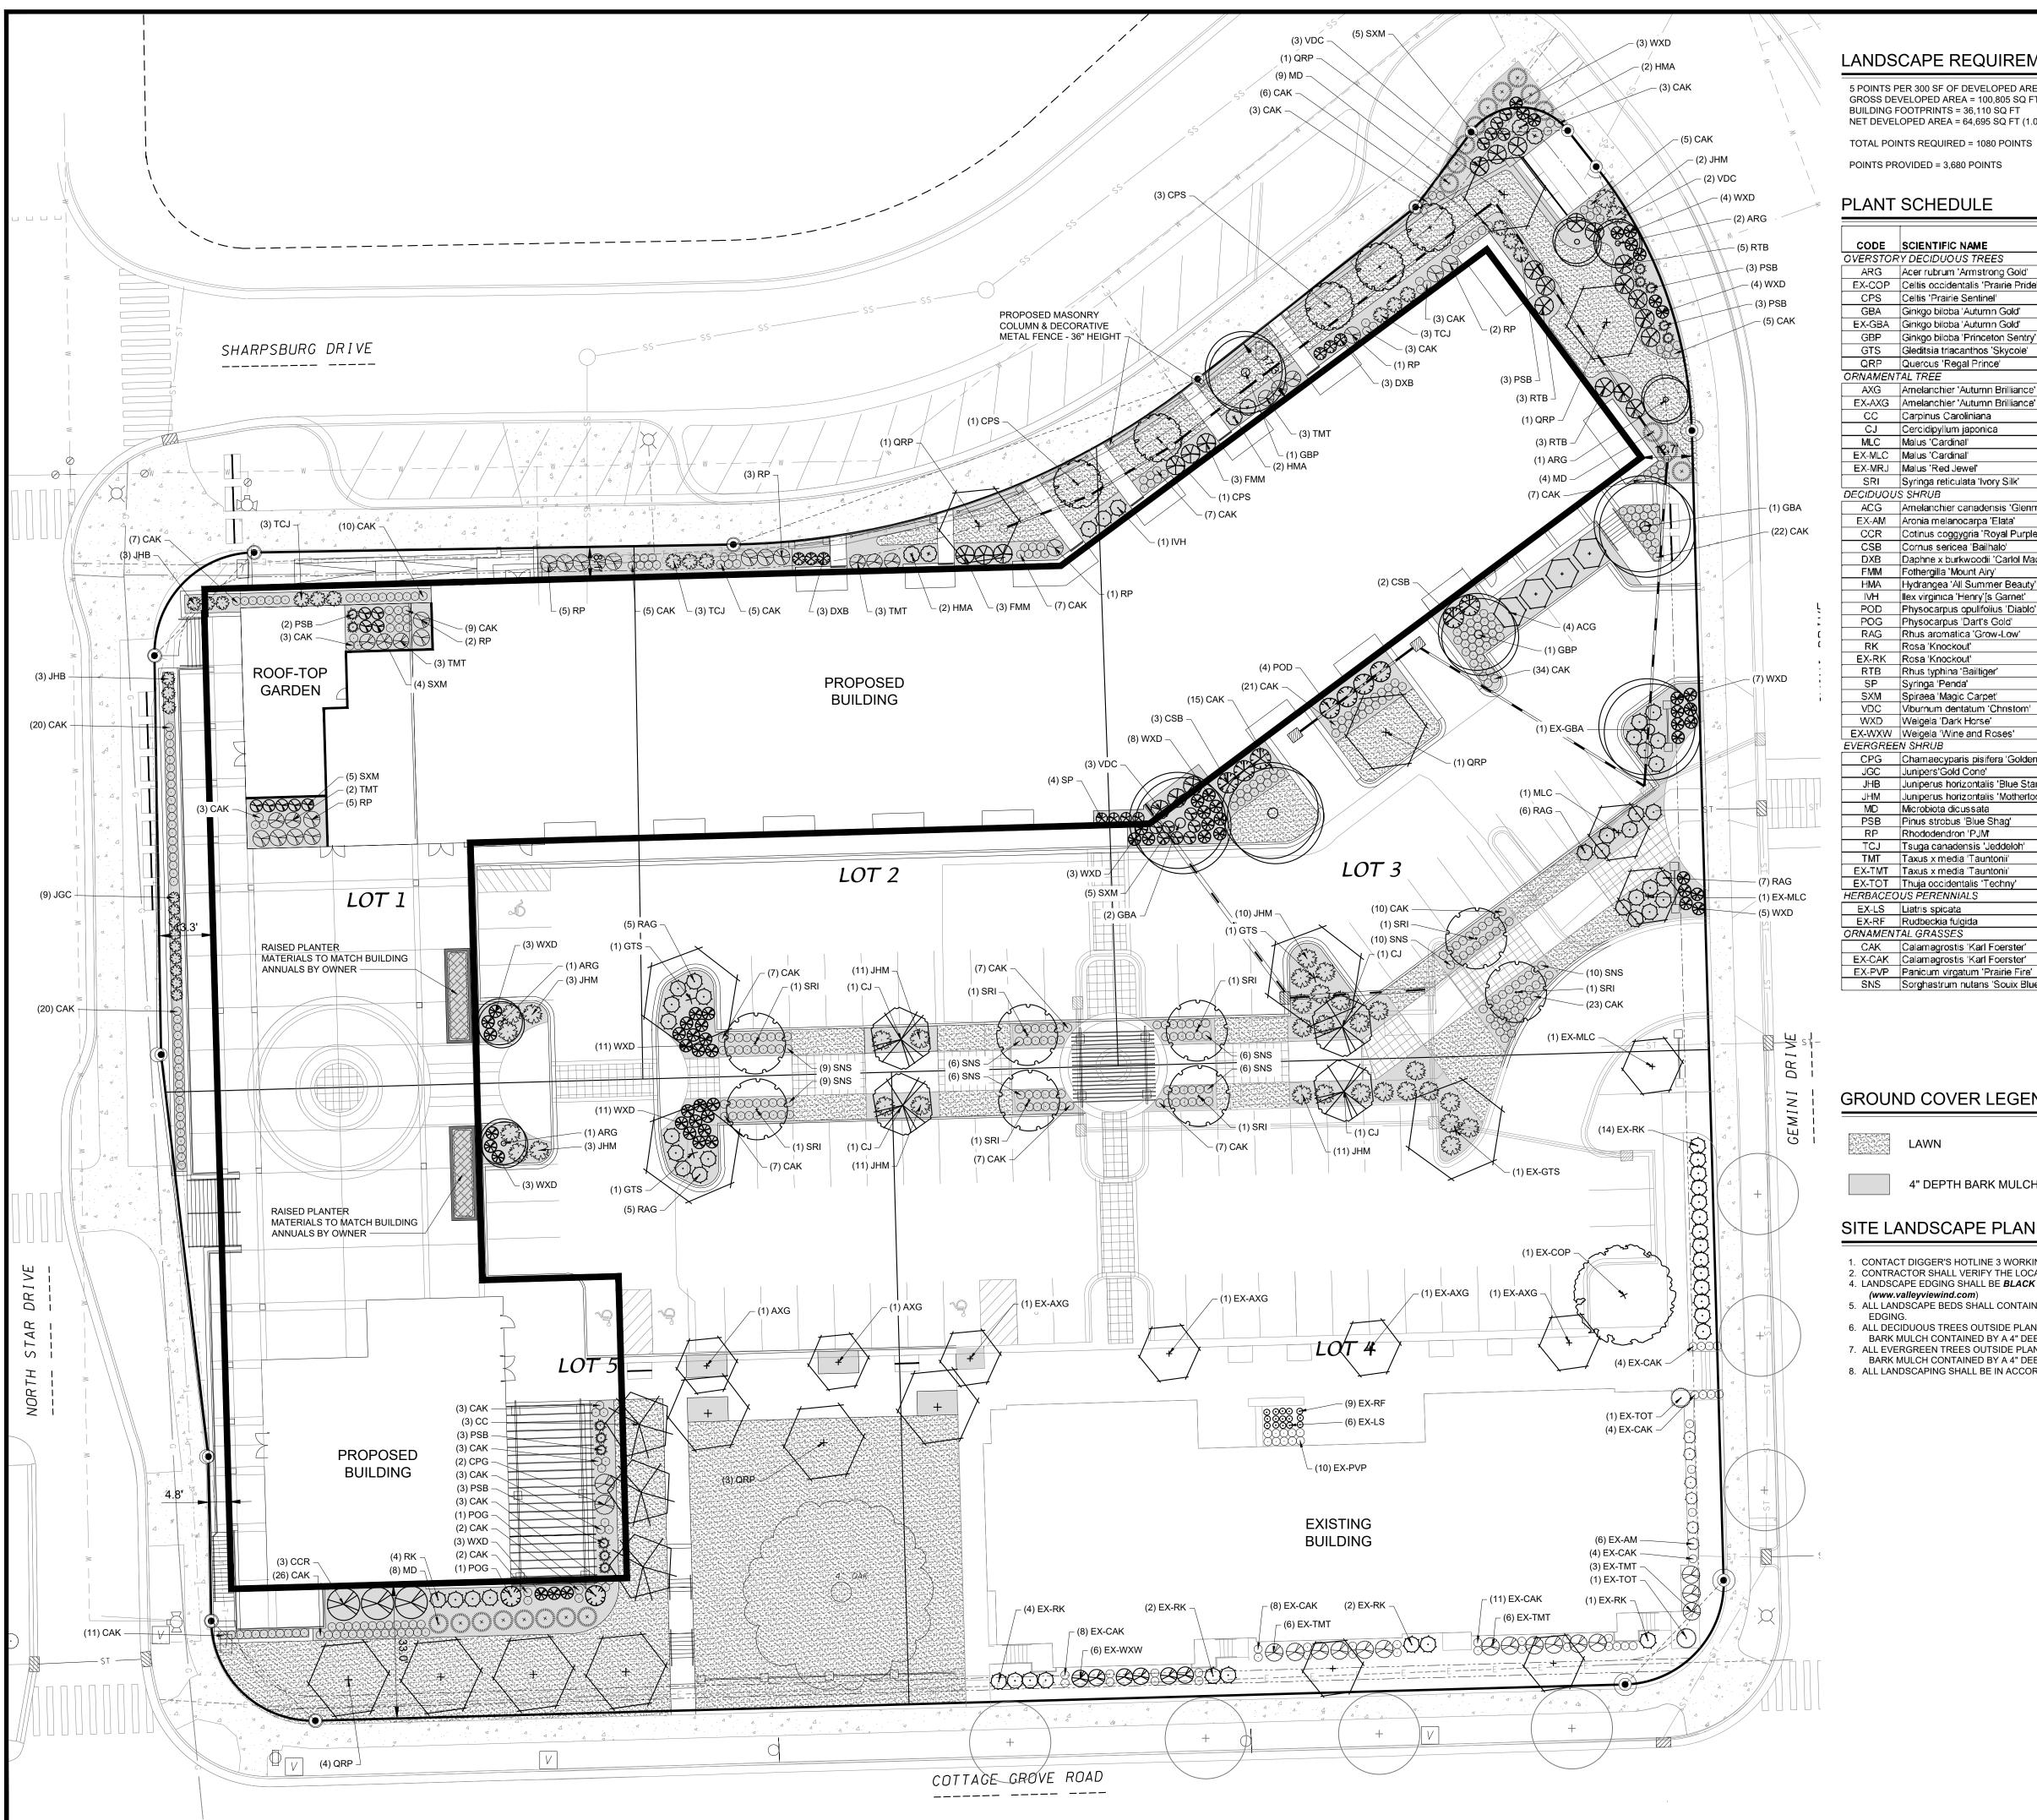

File: U:\User\2005122\Drawings\Landscape.dwg GEC Plotted: Aug 12, 2020 - 9:58am

LANDSCAPE REQUIREMENTS SUMMARY

5 POINTS PER 300 SF OF DEVELOPED AREA GROSS DEVELOPED AREA = 100,805 SQ FT BUILDING FOOTPRINTS = 36,110 SQ FT NET DEVELOPED AREA = 64,695 SQ FT (1.05 ACRE)

POINTS PROVIDED = 3,680 POINTS

PLANT SCHEDULE

		PTS PER S		SUB-	UB- ROOT		1	
SCIENTIFIC NAME	COMMON NAME	QTY		TOTAL	SIZE	COND	NOTES	
/ DECIDUOUS TREES								
Acer rubrum 'Armstrong Gold'	Armstrong Gold Maple	5	35	175	2.5"	B&B		
Celtis occidentalis 'Prairie Pride'	Prairie Pride Hackberry	1	35	35	2.5"		Existing	
Celtis 'Prairie Sentinel'	Prairie Sentinal Hackberry	5	35	175	2.5"	B&B	Entoning	
Ginkgo biloba 'Autumn Gold'	Autumn Gold Ginkgo	3	35	105	2.5"	B&B		
Ginkgo biloba 'Autumn Gold'	Autumn Gold Ginkgo	1	35	35	2.5	DQD	Eviating	
							Existing	
Ginkgo biloba 'Princeton Sentry'	Princeton Sentry Ginkgo	2	35	70	2.5"	B&B		
Gleditsia triacanthos 'Skycole'	Skyline Honeylocust	4	35	140	2.5"	B&B		
Quercus 'Regal Prince'	Regal Prince Oak	11	35	385	2.5"	B&B		
AL TREE								
Amelanchier 'Autumn Brilliance'	Autumn Brilliance Serviceberry	2	15	30	1.5"	B&B		
Amelanchier 'Autumn Brilliance'	Autumn Brilliance Serviceberry	4	15	60	1.5"		Existing	
Carpinus Caroliniana	Musclewood	3	15	45	1.5"	B&B		
Cercidipyllum japonica	Katsura Tree	4	15	60	1.5"	B&B		
Malus 'Cardinal'	Cardinal Crabapple	1	15	15	1.5"	B&B		
Malus 'Cardinal'	Cardinal Crabapple	2	15	30	1.5"		Existing	
Malus 'Red Jewel'	Red Jewel Crabapple	2	15	30	1.5"		Existing	
Syringa reticulata 'Ivory Silk'	Ivory Silk Lilac	8	15	120	1.5"		Existing	
SHRUB				120	1.7		сланну	
	Baisbow Dillos Convinghors		2	10	40"			
Amelanchier canadensis 'Glennform'	Rainbow Pillar Serviceberry	4	3	12	48"	B&B	—	
Aronia melanocarpa 'Elata'	Black Beauty Chokeberry	6	3	18			Existing	
Cotinus coggygria 'Royal Purple'	Royal Purple Smoke Bush	3	3	9	24" TALL	POT		
Cornus sericea 'Bailhalo'	Ivory Halo Dogwood	5	3	15	24" TALL	POT		
Daphne x burkwoodii 'Carlol Mackie'	Carol Mackie Daphne	6	3	18	24" TALL	POT		
Fothergilla 'Mount Airy'	Mount Airy Fothergilla	6	3	18	24" TALL	POT		
Hydrangea 'All Summer Beauty'	All Summer Beauty Hydrangea	6	3	18	24" TALL	POT		
llex virginica 'Henry'[s Garnet'	Henry's Garnet Sweetspire	3	3	9	24" TALL	POT		
Physocarpus opulifolius 'Diablo'	Diablo Ninebark	4	3	12	24" TALL	POT		
Physocarpus 'Dart's Gold'	Dart's Gold Ninebark	2	3	6	24" TALL	POT		
Rhus aromatica 'Grow-Low'	Grow Low Sumac	29	3	87	24" TALL	POT		
Rosa 'Knockouť	Knockout Rose	4	3	12	24" TALL	POT		
Rosa 'Knockout'	Knockout Rose	23	3	69			Existing	
Rhus typhina 'Bailtiger'	Tiger Eyes Sumac	11	3	33	24" TALL	POT		
Syringa 'Penda'	Penda Lilac	4	3	12	24" TALL	POT		
Spiraea 'Magic Carpet'	Magic Carpet Spirea	21	3	63	24" TALL	POT		
Viburnum dentatum 'Christom'	Blue Muffin Viburnum	8	3	24	24" TALL	POT		
Weigela 'Dark Horse'	Dark Horse Weigela	61	3	183	24" TALL	POT		
Weigela 'Wine and Roses'	Wine and Roses Weigela	6	3	18			Existing	
I SHRUB	· •			•				
Chamaecyparis pisifera 'Golden Mop'	Golden Mop False Cypress	2	4	8	24" TALL	POT		
Junipers'Gold Cone'	Gold Cone Juniper	9	4	36	24" TALL	POT		
Juniperus horizontalis 'Blue Star'	Blue Star Juniper	6	4	24	24" TALL	POT		
Juniperus horizontalis 'Motherlode'	Motherloade Juniper	33	4	132	24" TALL	POT		
Microbiota dicussata	Russian Arborvitae	20	4	80	24" TALL	POT		
Pinus strobus 'Blue Shag'	Blue Shag Eastern White Pine	13	4	52	24" TALL	POT		
Rhododendron 'PJM	PJM Rhododendron	19	4	76	24" TALL	POT		
Tsuga canadensis 'Jeddeloh'	Jeddeloh Hemlock	12	4	48	24" TALL	POT		
Taxus x media 'Tauntonii'	Taunton Yew	11	4	44	24" TALL	POT		
Taxus x media 'Tauntonii'	Taunton Yew	15	4	60			Existing	
Thuja occidentalis 'Techny'	Techny Arborvitae	2	4	8			Existing	
JS PERENNIALS	1. Contract and and a	<u> </u>		, v	1		CASSING	
	Blazing Star	6	2	12			Existing	
Liatris spicata Rudbeckia fulcida	Early Bird Gold Black Eyed Susan	9	2	12				
Rudbeckia fulgida	TEAHY DITU GUIU DIACK EYEQ SUSAN	9	4	10			Existing	
AL GRASSES	Kad Faaratas Faaihas Daaid A	0.57		744	4.001			
Calamagrostis 'Karl Foerster'	Karl Foerster Feather Reed Grass	357	2	714	1 GAL	POT		
Calamagrostis 'Karl Foerster' Karl Foerster Feather Reed Grass		39	2	78	1 GAL	POT		
		10	2	20	1 GAL	POT		
Sorghastrum nutans 'Souix Blue'	Souix Blue Indian Grass	62	2 TOTAL:	124	1 GAL POINTS	POT		
				3680				

GROUND COVER LEGEND


LAWN

4" DEPTH BARK MULCH

SITE LANDSCAPE PLAN - GENERAL NOTES

1. CONTACT DIGGER'S HOTLINE 3 WORKING DAYS PRIOR TO THE START OF CONSTRUCTION. 2. CONTRACTOR SHALL VERIFY THE LOCATION OF ALL THE PRIVATE UTILITIES PRIOR TO THE START OF WORK. 4. LANDSCAPE EDGING SHALL BE **BLACK DIAMOND** VINYL EDGING AS MANUFACTURED BY **VALLEY VIEW INDUSTRIES**

5. ALL LANDSCAPE BEDS SHALL CONTAIN A 4" DEPTH OF SHREDDED HARDWOOD BARK MULCH CONTAINED BY LANDSCAPE 6. ALL DECIDUOUS TREES OUTSIDE PLANTING BEDS SHALL HAVE A 4' DIAMETER CIRCLE OF 4" DEPTH SHREDDED HARDWOOD BARK MULCH CONTAINED BY A 4" DEEP TRENCH CUT EDGE. 7. ALL EVERGREEN TREES OUTSIDE PLANTING BEDS SHALL HAVE A 8' DIAMETER CIRCLE OF 3" DEPTH SHREDDED HARDWOOD BARK MULCH CONTAINED BY A 4" DEEP TRENCH CUT EDGE. 8. ALL LANDSCAPING SHALL BE IN ACCORDANCE WITH THE CITY OF MADISON ZONING ORDINANCE.

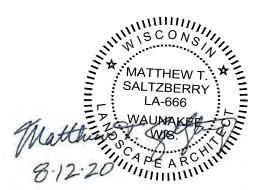



BL $\boldsymbol{\mathcal{B}}$ S \mathcal{O} O7 Z \mathcal{Q}

< $\mathbf{A}_{\mathbf{i}}$

Ŕ

9

×

 \cup

0





DATE: 08/12/20 REVISED:

DRAWN BY: MS

FN: 20-05-122

Sheet Number: *L100*