# **LAND USE APPLICATION - INSTRUCTIONS & FORM**



City of Madison Planning Division Madison Municipal Building, Suite 017 215 Martin Luther King, Jr. Blvd. P.O. Box 2985



FOR OFFICE USE ONLY:		
Paid	Rec	ceipt #
Date received		
Received by		
☐ Original Submittal		Revised Submittal
Parcel #		
Aldermanic District		
Zoning District		
Special Requirements		
Review required by		
□ UDC		PC
☐ Common Council		Other
Reviewed By		

Madison, WI 53701-2985 (608) 266-4635	Received by			
(008) 200-4055	☐ Original Submittal ☐ Revised Submittal			
	Parcel #			
All Land Use Applications must be filed with the	Aldermanic District			
Zoning Office at the above address.	Zoning District			
This completed form is required for all applications for Plan Commission review except subdivisions	Special Requirements			
or land divisions, which should be filed using the	Review required by			
Subdivision Application found on the City's web site.	□ UDC □ PC			
(http://www.cityofmadison.com/development-services- center/documents/SubdivisionApplication.pdf)	☐ Common Council ☐ Other			
	Reviewed By			
APPLICATION FORM				
1. Project Information				
Address:				
Title:				
2. This is an application for (check all that apply)				
Zoning Map Amendment (Rezoning) from				
Major Amendment to an Approved Planned Develo	opment-General Development Plan (PD-GDP) Zoning			
Major Amendment to an Approved Planned Develo				
Review of Alteration to Planned Development (PD)				
Conditional Use or Major Alteration to an Approve Demolition Permit	d Conditional Use			
Other requests				
3. Applicant, Agent and Property Owner Information	1			
Applicant name	Company			
Street address	City/State/Zip			
Telephone	Email			
Project contact person	Company			
Street address	City/State/Zip			
Telephone	Email			
Property owner (if not applicant)				
Street address	City/State/Zip			
	Email			
AAA Daaranaa Daaraa Cooraa aa Cooraa	Dags 2 of			

# LAND USE APPLICATION - INSTRUCTIONS & FORM



#### 4. Required Submittal Materials

Pursuant to Section 28.181(4), MGO, no application is complete unless all required information is included and all application fees have been paid. The Zoning Administrator may reject an incomplete application. Use this checklist to prepare a complete Land Use Application. Note: Not all development plan materials listed below are required for all applications. Submittal materials are as determined by staff. Those application types which have specific additional submittal requirements, as noted below, are outlined in Land Use Application Form LND-B (https://www.cityofmadison.com/dpced/bi/documents/LUAChecklist.pdf).

Req.	Required Submittal Information	Contents	No. of Copies	<b>✓</b>
	Filing Fee (\$ 950 )	Refer to the Fee Schedule on Page 6. Make checks payable to City Treasurer.	1	
	Land Use Application	Forms must include the property owner's authorization.	1	
	Legal Description (For Zoning Map Amendments only)	Legal description of the property, complete with the proposed zoning districts and project site area in square feet and acres.	1	
	Pre-Application Notification	Proof of written 30-day notification to alder, neighborhood association, and business associations. In addition, Demolitions require posting notice of the requested demolition to the City's Demolition Listserv at least 30 days prior to submitting an application. For more information, see Page 1 of this application.	1	
	Letter of Intent (LOI)	Narrative description of the proposal in detail, including, but not limited to, the existing site conditions, project schedule, phasing plan, proposed uses, hours of operation, number of employees, gross square footage, number of units and bedrooms, public subsidy requested, project team, etc.	28	
		** When submitting, you must collate the Letters of Intent with the Development Plans		
	Development Plans	Twenty-Eight (28) <u>legible</u> & <u>scaled</u> 11" x 17" copies, collated and stapled.	28	
	Site Plan			
	Survey or site plan of existing conditions	** When submitting, you must collate the Letters of Intent with the Development Plans **		
	Grading Plan			
	Utility Plan	For a detailed list of the content requirements for each of these plan sheets,		
	Landscape Plan and Landscape Worksheet	please see Land Use Application Form LND-B (https://www.cityofmadison.com/dpced/bi/documents/LUAChecklist.pdf)		
	Building Elevations			
	Roof and Floor Plans			
	Fire Access Plan and Fire Access Worksheet			
	Supplemental Requirements (Based on Application Type)	Additional materials are required for the following application types noted below. Please see Land Use Application Form LND-B ( <a href="https://www.cityofmadison.com/dpced/bi/documents/LUAChecklist.pdf">https://www.cityofmadison.com/dpced/bi/documents/LUAChecklist.pdf</a> ) for a detailed list of the submittal requirements for these application types.  The following Conditional Use Applications:  Lakefront Developments  Development within Downtown Core (DC) and Urban Mixed-Use (UMX) Zoning Districts  Zoning Map Amendments (i.e. Rezonings)  Planned Development General Development Plans (GDPs) / Planned Development Specific Implementation Plans (SIPs)	Include in Plan Set as required	
	Digital Copies of all Submitted Materials	Digital copies of all items, submitted in hard copy are required. All development plan set sheets must be scalable to full- and half-size sheets. Individual PDF files of each item submitted should be compiled on a CD or flash drive, or in an email to pcapplications@cityofmadison.com. The email must include the project address, project name, and applicant name. Electronic submittals via file hosting services (such as <a href="Dropbox.com">Dropbox.com</a> ) are not allowed. Applicants who are unable to provide the materials electronically should contact the Planning Division at (608) 266-4635 for assistance.	1	

# LAND USE APPLICATION - INSTRUCTIONS & FORM



APPLICATION FORM (CONTINUED)	
5. Project Description	
Provide a brief description of the project and all proposed uses	of the site:
Proposed Dwelling Units by Type (if proposing more than 8 un	its):
Efficiency: 8 1-Bedroom: 13 2-Bedroom:	
Density (dwelling units per acre): Lot Si	
Proposed On-Site Automobile Parking Stalls by Type (if application)	able):
Surface Stalls: Under-Building/Str	uctured:18
Proposed On-Site Bicycle Parking Stalls by Type (if applicable):	
Indoor: 24 Outdoor: 4	
Scheduled Start Date: Pla	nned Completion Date:
6 Applicant Declarations	
6. Applicant Declarations	
<b>Pre-application meeting with staff</b> . Prior to preparation of this the proposed development and review process with Zoning a	
Planning staff	Date
Zoning staff	Date
Demolition Listserv (https://www.cityofmadison.com/developm	nentCenter/demolitionNotification/notificationForm.cfm).
Public subsidy is being requested (indicate in letter of inte	nt)
<b>Pre-application notification</b> : The zoning code requires tha neighborhood and business associations in writing no lat	
of the pre-application notification or any correspondence neighborhood association(s), business association(s), AND	ce granting a waiver is required. List the alderperson,
District Alder	Date
Neighborhood Association(s)	
Business Association(s)	
Business/issociation(s)	Butc
The applicant attests that this form is accurately completed and	all required materials are submitted:
Name of applicant	Relationship to property
Authorizing signature of property owner	Relationship to property
Authorizing signature of property owner	Date /// 20

May 6, 2020 Updated August 17, 2020 knothe bruce

Ms. Heather Stouder
Director, Planning Division
City of Madison Department of Planning & Community & Economic Development
215 Martin Luther King Jr. Blvd., Ste 017
Madison, Wisconsin 53703

Re: Letter of Intent

817-821 Williamson St KBA Project # 2003

Ms. Heather Stouder:

The following is submitted together with the plans and application for the staff and Plan Commission's consideration of approval.

#### **Organizational structure:**

Owner: John Fontain Inc

P.O. Box 694 Madison, WI 53701 608-279-7962

Contact: Brandon Cook

<u>Johnfontainrealty@gmail.com</u>

Engineer: Burse Surveying & Engineering, Inc.

2801 International Lane, Ste. 101

Madison, WI 53704 Phone: 608-250-9263 Fax: 608-250-9266 Contact: Peter Fortlage

pfortlage@bse-inc.net

Architect: Knothe & Bruce Architects, LLC

7601 University Avenue, Ste 201

Middleton, WI 53562

608-836-3690

Contact: Kevin Burow kburow@knothebruce.com

Landscape Paul Skidmore Landscape Architect

13 Red Maple Trail Middleton, WI 53717 (608) 826-0032

Contact: Paul Skidmore paulskidmore@tds.net

#### **Introduction:**

This proposed development involves the redevelopment of 817-821 Williamson Street, by removing an existing one-story commercial building and surface parking lot and constructing a new three-story mixed-use building. This site is zoned TSS (Traditional Shopping Street) and is located within the Third Lake Ridge historic district. There will be a total of 24 apartment units and approximately 830 sq.ft. of commercial space. There will also be 17 underground parking stalls for residential use.

Design:

#### **Project Description:**

As part of this project the underlying land that the existing and the proposed building will sit on needs to be combined into one lot. The size of this lot will not be out of place with the irregularly sized lots in this block and also within the nearby blocks in Third Lake Ridge. Given that the existing building was built across the lot lines and has existed as such for many years, this has been functioning as a single lot already.

Letter of Intent – Land Use 817-821 Williamson Street May 6, 2020 Page 2 of 3

The proposed building has been designed to be in context with the neighboring structures while not trying to look like a false historic structure. The front façade will be all masonry with storefront glass at the first floor level and the apartments above have taller windows. The garage entry is set back 59'-0' from the front façade and is lowered down in grade so it is not a primary feature for this building. By recessing the garage entry back almost 60' from the street, the overall massing at the street is reduced and thus compatible with the surrounding structures. It also maintains the existing rhythm on this block with buildings with driveways located along many of them.

The overall height of this building with a flat roof is in context with the tall 2-3 story gabled roof structures that are on this block which are set higher above the sidewalk given the increasing grades of this 800 block of Williamson St. The properties located behind this building on Jenifer St. are also set approximately a full story above the sidewalk grade on Williamson St. so this height will be compatible with them as well. The use of a flat roof is also compatible with several other commercial and multifamily buildings located on Williamson Street and especially with those located directly across the street.

#### **City and Neighborhood Input:**

We have met with the City on several occasions for this proposed development including meetings with Staff and attending a DAT Meeting and this input has helped shape this proposed development. A neighborhood meeting was also held which was led by Kevin Firchow and Alder Marsha Rummel.

#### **Demolition Standards**

The structure to be removed was constructed well outside of the period of significance for the Third Lake Ridge historic district (1850-1929) and has no historic significance to this area. It is also out of character and is not a landmark structure, nor is it of an uncommon or unusual design or method of construction, and as such should meet the demolition criteria. A Re-use and Recycling Plan will be submitted prior to the deconstruction of the existing commercial structure.

#### **Conditional Use approvals:**

The proposed redevelopment requires a conditional use to allow for a residential building with more than 8 units. The proposed building's size, scale and use are consistent with the City's Comprehensive Plan for this property, which calls for Neighborhood Mixed Use in 2-4 stories.

#### **Site Development Data:**

**Densities:** 

Lot Area 12,870 S.F. / .29 acres

Dwelling Units 24 DU
Lot Area / D.U. 536 S.F./D.U.
Density 81 units/acre

Open Space 3,677 S.F. (960 S.F. Min. Required)
Open Space / Unit Lot Coverage 1,53 S.F./Unit (40 S.F./Unit Required)
9,015 S.F. = 70% of total lot (85% Max.)

Building	<u>Height:</u>	3 S	tories

#### **Gross Floor Areas:**

Residential Area	19,806 S.F.
Commercial Area	802 S.F.
Garage Parking Area	6,997 S.F.
Gross Area	27,605 S.F.

#### Floor Area Ratio 2.14

#### **Dwelling Unit Mix:**

Efficiency	11
One Bedroom	10
Two Bedroom	3
Total Dwelling Units	24

#### Vehicle Parking:

Surface	0 stalls
<u>Underground</u>	17 stalls
Total	17 stalls

#### **Bicycle Parking:**

Protected and Secure Surface Stalls	24 stalls
Surface Stalls for Visitors	3 stalls
Surface Stalls for Commercial	l stalls
Total	28 stalls

#### **Project Schedule:**

It is anticipated that the construction on this site will start in Fall 2020 with a final completion of Summer 2021.

Thank you for your time reviewing our proposal.

Sincerely,

Kevin Burow, AIA, NCARB, LEED AP

Keni Bu

Managing Member

#### **Denise Salimes**

**From:** Denise Salimes

Sent: Wednesday, February 26, 2020 5:12 PM

To: MNABoard@marquette-neighborhood.org; Rummel, Marsha
Cc: Kevin Burow; Stacey Oehrke (soehrke@knothebruce.com)

**Subject:** 817 Williamson Street - 30 day notification

Hello Alder Marsha Rummel, Anita Krasno & Katherine Davey,

On behalf of John Fontain Exchange and Knothe & Bruce Architects I would like to take this opportunity to formally notify you of our plan to submit a Land Use application on April 1, 2020 for a 3-story mixed-use development at 817 Williamson Street. The existing building will be demolished.

We look forward to working with you in making this a successful development. If you have any questions please contact Kevin Burow at 608-836-3690.

#### Thank you,

Denise Salimes I Knothe & Bruce Architects, LLC I Ph: 608.836.3690 ext:111 7601 University Avenue, Middleton, WI 53562 dsalimes@knothebruce.com

#### **DEMO PHOTOS**

#### 817-821 Williamson St

#### Exterior photos:





#### Exterior Photos:





Interior Photos



#### Interior Photos:




















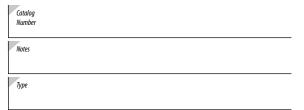

Hit the Tab key or mouse over the page to see all interactive element

#### **Specifications**

var til	Standard	With Battery Pack(EL) 5-7/8"
Width:	J	3773
Height:	5-1/8"	6-1/8"
Depth:	2-3/4"	4-1/4"
Weight:	1.5 lbs	3 lbs

#### Introduction

LIL LED is a compact and energy efficient wall luminaire ideal for replacing small incandescent and CFL luminaires. Photocell and battery pack options make LIL LED great for installations above doors, balconies, garage or warehouse entrances, and security applications. Whether directly mounting to a recessed junction box, or using the back box accessory for conduit entry/through wiring, LIL LED has you covered!

**EXAMPLE: LIL LED 40K MVOLT WH** 

#### **Ordering Information**

LIL LED					
Series	Color Temperature	Voltage	Controls	Mounting	Finish
LIL LED	<b>30K</b> 3000 K <b>40K</b> 4000 K	<b>MVOLT</b> 120 / 277V <sup>1</sup>	(blank) None PE MVOLT button photocell 1.2 EL Battery pack 2	(blank) None BB Back box accessory for conduit wiring <sup>3</sup>	DDBTXD Textured dark bronze WH White

#### Accessories

Ordered and shipped separately.

LIL LED BB DDBTXD

Back box for conduit entry applications, dark bronze - CI Code \*249WXH

LIL LED BB WH

Back box for conduit entry applications, white - CI Code \*249WXJ

#### NOTES

- 1. MVOLT driver operates on 120V and 277V (50/60Hz).
- 2. PE and EL cannot be ordered together.
- Optional accessory for conduit entry wiring. Can be ordered with the luminaire or separately. Shipped separately. BB option is not available with emergency battery pack (EL) version.

#### **FEATURES & SPECIFICATIONS**

#### INTENDED USE

The versatility of LIL LED combines a sleek, compact profile with photocell and emergency battery pack options to provide a great solution for wall mount applications. LIL LED is ideal for replacing up to 100W incandescent or 32W CFL luminaires in installations above doors, balconies, garage or warehouse entrances, and security applications. It can also be used for decorative and general lighting in outdoor environments.

#### CONSTRUCTION

Aluminum housing with white or textured dark bronze paint for lasting durability. The polycarbonate lens creates uniform light distribution, and it is UV resistant - great for outdoor environments!

#### **OPTICS**

Light engines are available in 3000K and 4000K CCTs. See Lighting Facts label and photometry reports for specific fixture performance.

#### ELECTRICA

LED technology provides long operating life (L70/50,000 hours at 25°C). Electronic drivers have a power factor >90% and THD <20% and a minimum 2.5kV surge rating.

#### INSTALLATION

Easily mounts to recessed junction boxes or for surface mounting and conduit entry — with the back box with two 1/2" threaded conduit entry hubs.

This luminaire is mounted with the lens facing down. Neutral wire is required for three phase input.

#### LISTINGS

UL Listed to U.S. and Canadian safety standards for wet locations. Rated for -40° C minimum to 40° C maximum ambient temperature. Battery pack versions are rated to 0° C minimum. Tested in accordance with IESNA LM-79 and LM-80 standards.

 $\label{lem:decomposition} Design Lights Consortium @ (DLC) \ qualified \ product. \ Not \ all \ versions \ of this \ product \ may \ be \ DLC \ qualified. \ Please \ check \ the \ DLC \ Qualified \ Products \ List \ at \ www.designlights.org/QPL \ to \ confirm \ which \ versions \ are \ qualified.$ 

Eligible to be submitted for Title 20 and Title 24 compliance.

#### WARRANTY

5-year limited warranty. Complete warranty terms located at: www.acuitybrands.com/CustomerResources/Terms\_and\_conditions.aspx

**Note:** Actual performance may differ as a result of end-user environment and application. All values are design or typical values, measured under laboratory conditions at 25°C. Specifications subject to change without notice.



#### **Performance Data**

#### **Lumen Output**

Lumen values are from photometric tests performed in accordance with IESNA LM-79-08. Data is considered to be representative of the configurations shown, within the tolerances allowed by Lighting Facts.

Model Number	ССТ	Rated Power	Lumens	LPW
LIL LED	3000K	8.4W	800	95

#### **Electrical Load**

		Input co	ırrent at given	input voltage	(amps)
Model Number	Rated Power	120V	208V	240V	277V
LIL LED	8.4W	0.07	0.04	0.03	0.03

#### **Projected LED Lumen Maintenance**


Data references the extrapolated performance projections in a 25°C ambient, based on 10,000 hours of LED testing (tested per IESNA LM-80-08 and projected per IESNA TM-21-11).

To calculate LLF, use the lumen maintenance factor that corresponds to the desired number of operating hours below. For other lumen maintenance values, contact factory.

Operating Hours	0	25,000	50,000
LIL LED	1.00	0.92	0.85

#### **Photometric Diagrams**

To see complete photometric reports or download .ies files for this product, visit the Lithonia Lighting LIL LED homepage. Tested in accordance with IESNA LM-79 and LM-80 standards

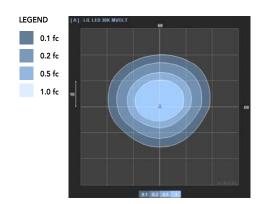

#### **Accessories**

LIL LED BBW DDBTXD Ba

 $Back\ box\ for\ conduit\ entry\ applications,\ dark\ bronze$ 


LIL LED BBW WH


Back box for conduit entry applications, white





#### **Dimensions**

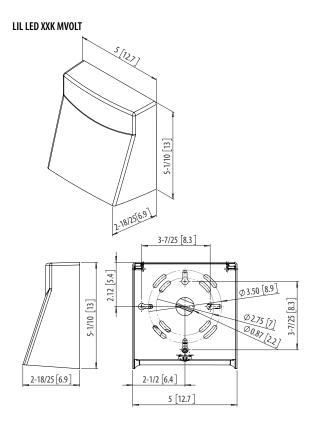

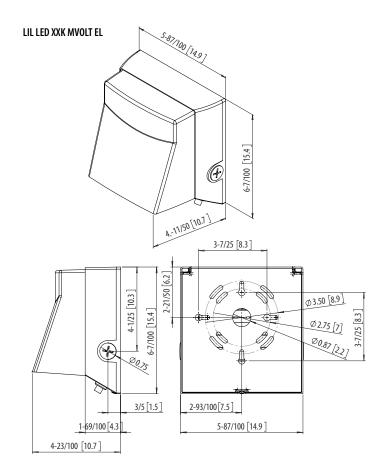



# **City of Madison Fire Department**

314 W Dayton Street, Madison, WI 53703-2506

Phone: 608-266-4420 • Fax: 608-267-1100 • E-mail: fire@cityofmadison.com


<b>Project Address:</b>	817-821 V	Villiamson St.
Contact Name & P.	hone #:	Kevin Burow 608-836-3690


#### FIRE APPARATUS ACCESS AND FIRE HYDRANT WORKSHEET

1. Is the building completely protected by an NFPA 13 or 13R automatic fire sprinkler system?  If non-sprinklered, fire lanes extend to within 150-feet of all portions of the exterior wall?  If sprinklered, fire lanes are within 250-feet of all portions of the exterior wall?	X Yes Yes X Yes	☐ No ☐ No ☐ No	N/A N/A N/A
<ul> <li>2. Is the fire lane constructed of concrete or asphalt, designed to support a minimum load of 85,000 lbs? <ul> <li>a) Is the fire lane a minimum unobstructed width of at least 20-feet?</li> <li>b) Is the fire lane unobstructed with a vertical clearance of at least 13½-feet?</li> <li>c) Is the minimum inside turning radius of the fire lane at least 28-feet?</li> <li>d) Is the grade of the fire lane not more than a slope of 8%?</li> <li>e) Is the fire lane posted as fire lane? (Provide detail of signage.)</li> <li>f) Is a roll-able curb used as part of the fire lane? (Provide detail of curb.)</li> <li>g) Is part of a sidewalk used as part of the required fire lane? (Must support +85,000 lbs.)</li> </ul> </li> </ul>	X Yes X Yes X Yes X Yes Yes Yes Yes Yes Yes	☐ No	<ul> <li>N/A</li> <li>N/A</li> <li>N/A</li> <li>N/A</li> <li>N/A</li> <li>N/A</li> <li>N/A</li> <li>N/A</li> <li>N/A</li> </ul>
3. Is the fire lane obstructed by security gates or barricades? If yes:  a) Is the gate a minimum of 20-feet clear opening?  b) Is an approved means of emergency operations installed, key vault, padlock or key switch?	Yes Yes Yes	No   No   No	N/A N/A N/A
4. Is the Fire lane dead-ended with a length greater than 150-feet?  If yes, does the area for turning around fire apparatus comply with IFC D103?	Yes Yes	X No	□ N/A ▼ N/A
5. Is any portion of the building to be used for high-piled storage in accordance with IFC Chapter 3206.6 If yes, see IFC 3206.6 for further requirements.	Yes	X No	□ N/A
6. Is any part of the building greater than 30-feet above the grade plane?			
	X Yes	☐ No	N/A
If yes, answer the following questions:  a) Is the aerial apparatus fire lane parallel to one entire side of the building and covering at least 25% of the perimeter? It is covering one entire side but is shy of the 25%  b) Is the near edge of the aerial apparatus fire lane between 15' and 30' from the building?  c) Are there any overhead power or utility lines located across the aerial apparatus fire lane? (Based on mature)		☐ No	<ul> <li>N/A</li> <li>N/A</li> <li>N/A</li> <li>N/A</li> <li>N/A</li> </ul>
If yes, answer the following questions:  a) Is the aerial apparatus fire lane parallel to one entire side of the building and covering at least 25% of the perimeter? It is covering one entire side but is shy of the 25%  b) Is the near edge of the aerial apparatus fire lane between 15' and 30' from the building?  c) Are there any overhead power or utility lines located across the aerial apparatus fire lane?	☐ Yes  X Yes ☐ Yes	☐ No ☐ No ☑ No ☑ No	□ N/A □ N/A □ N/A
If yes, answer the following questions:  a) Is the aerial apparatus fire lane parallel to one entire side of the building and covering at least 25% of the perimeter? It is covering one entire side but is shy of the 25%  b) Is the near edge of the aerial apparatus fire lane between 15' and 30' from the building?  c) Are there any overhead power or utility lines located across the aerial apparatus fire lane?  d) Are there any tree canopies expected to grow across the aerial fire lane? (Based on mature canopy width of tree species)  e) Does the aerial apparatus fire lane have a minimum unobstructed width of 26-feet?	<ul> <li>☐ Yes</li> <li>☒ Yes</li> <li>☐ Yes</li> <li>☐ Yes</li> <li>☒ Yes</li> </ul>	<ul><li> No</li><li> No</li><li> No</li><li> No</li><li> No</li><li> No</li></ul>	<ul> <li>N/A</li> <li>N/A</li> <li>N/A</li> <li>N/A</li> <li>N/A</li> </ul>
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Attach an additional sheet if further explanation is required for any answers.

This worksheet is based on MGO 34.503 and IFC 2015 Edition Chapter 5 and Appendix D; please see the codes for further information.



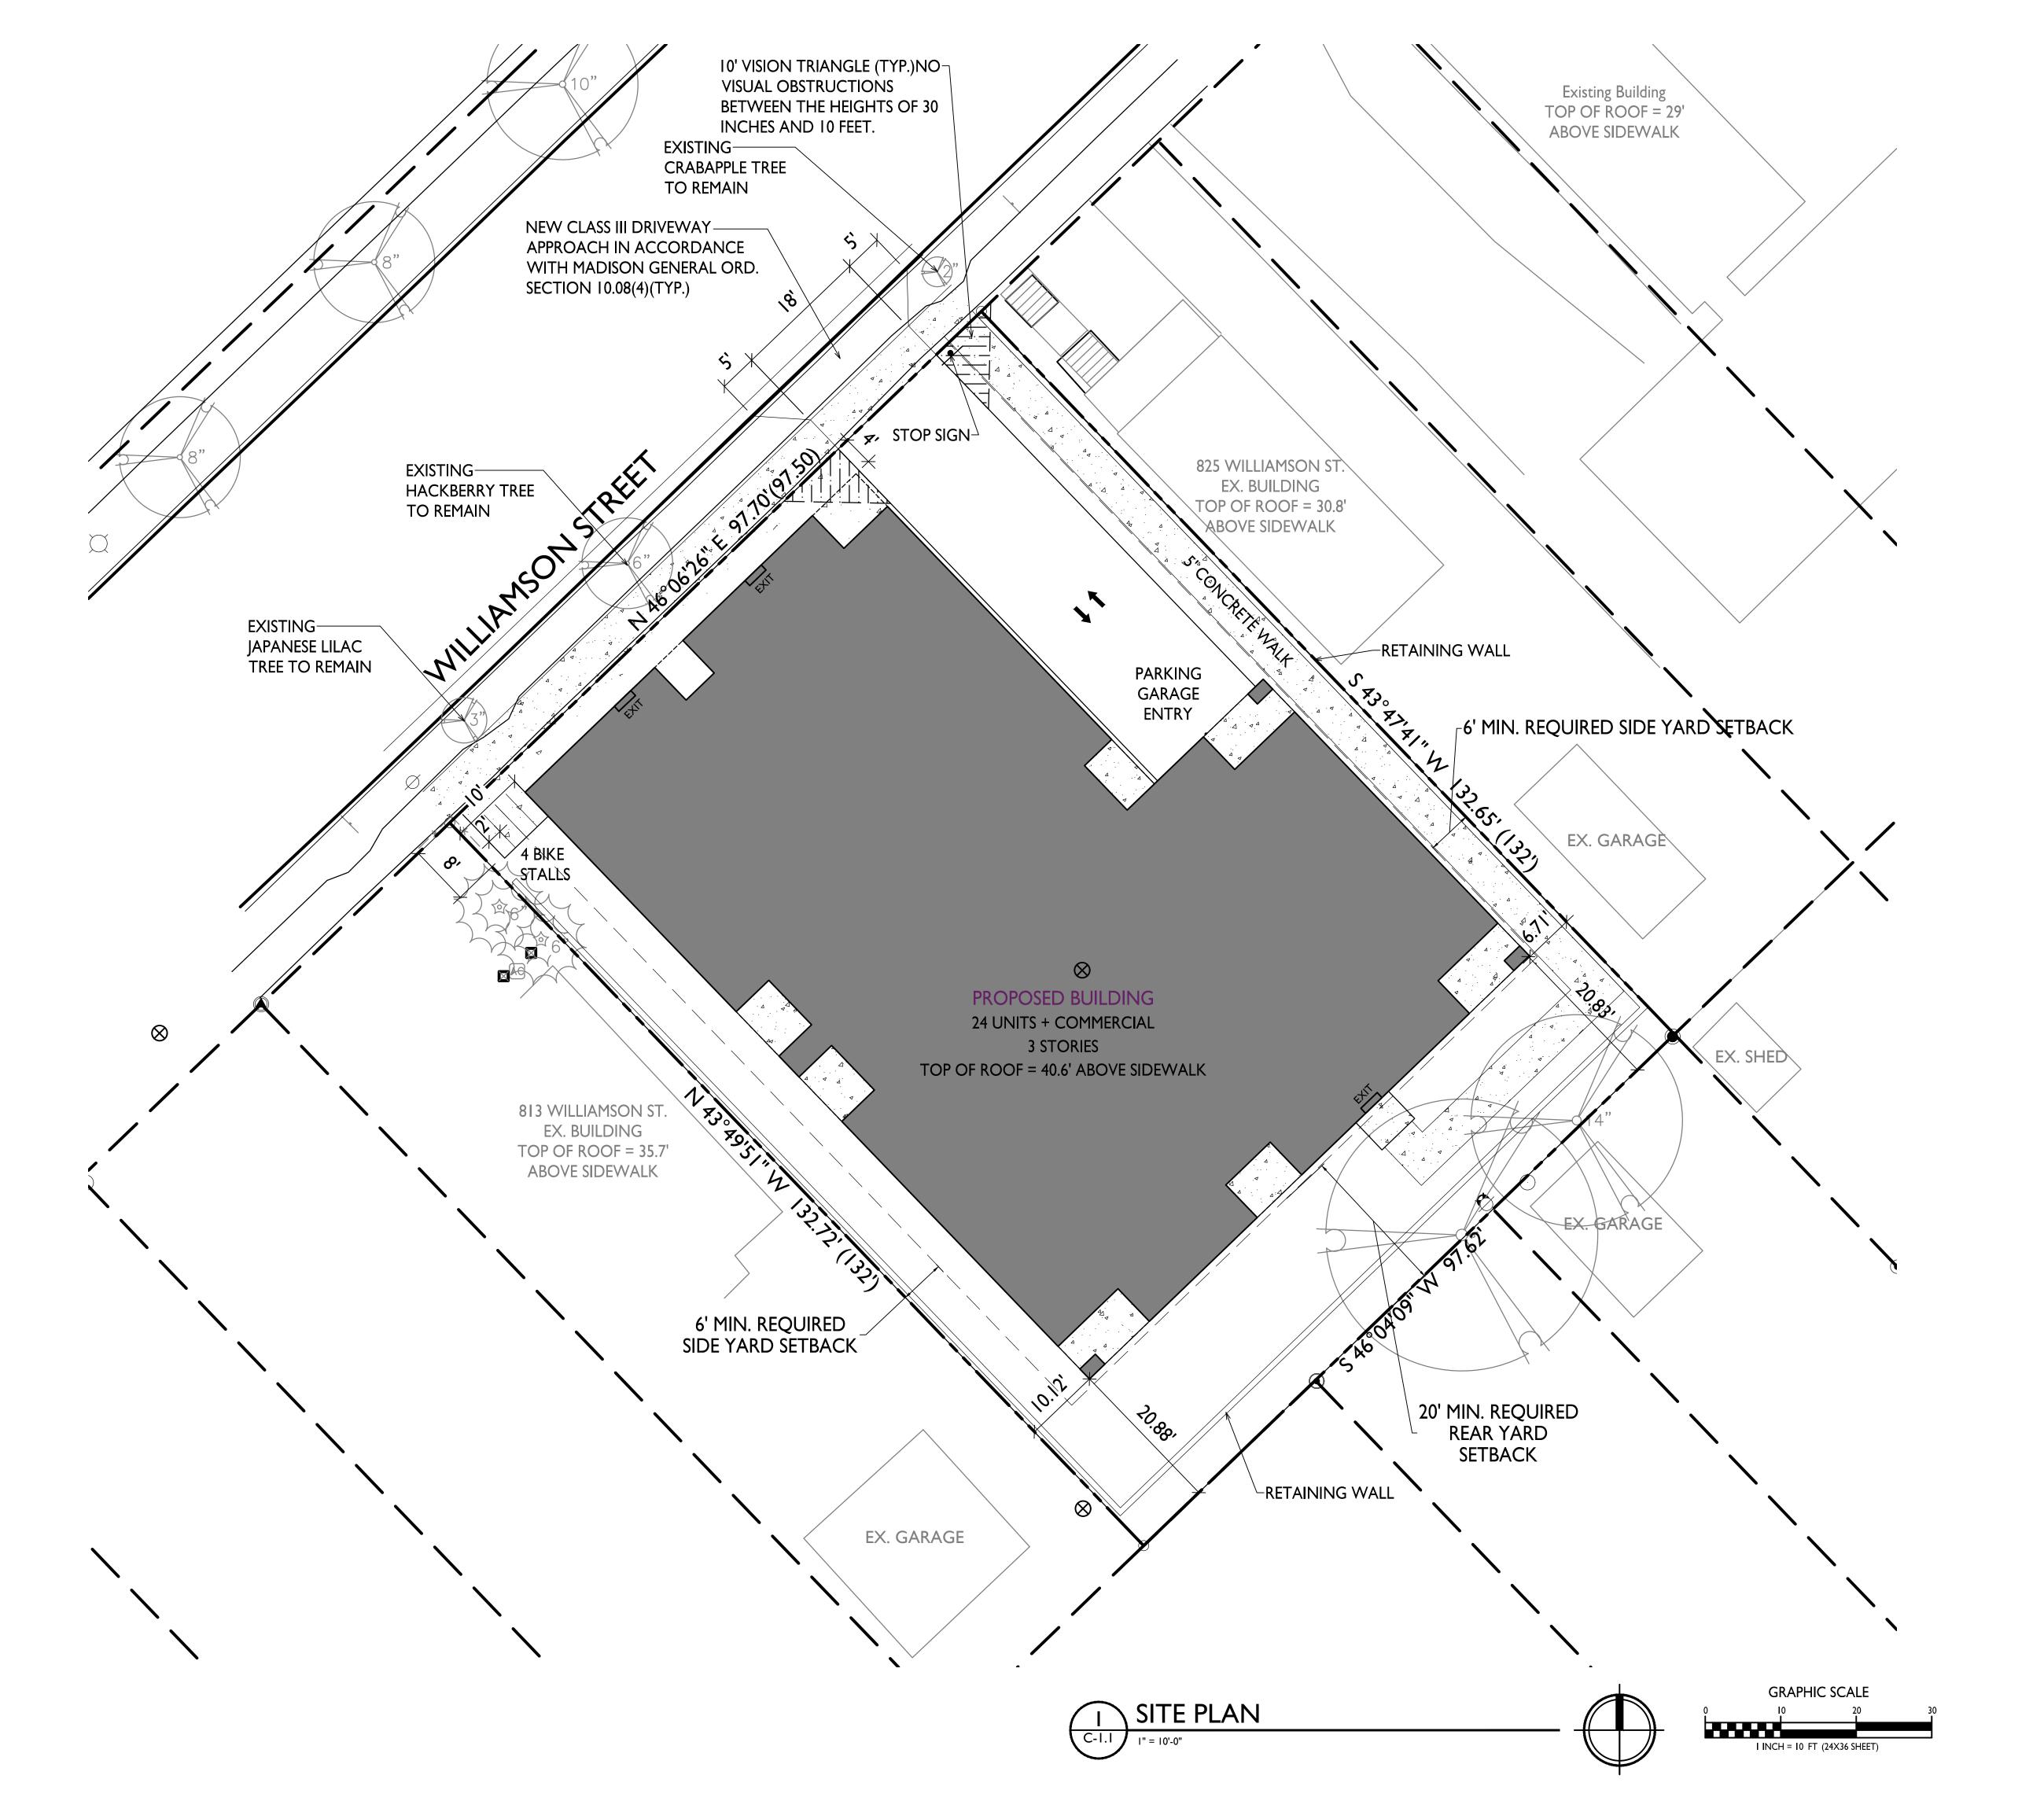

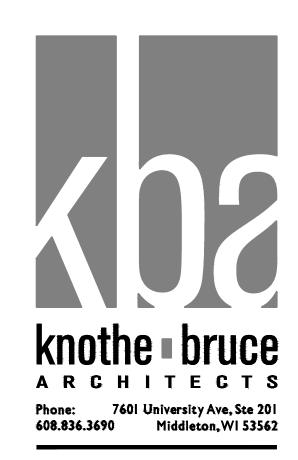Issued for Land Use Submittal - May 6, 2020 Issued for Landmarks - August 04, 2020 Issued for Land Use Submittal - August 17, 2020

PROJECT TITLE John Fontain Development

817-821 Williamson St Madison, Wisconsin SHEET TITLE Site Plan

SHEET NUMBER


C-I.I

PROJECT NO.

2003

STATISTICS						
DESCRIPTION	SYMBOL	AVG.	MAX.	MIN.	MAX. / MIN.	AVG. / MIN.
Parking Garage Entrance Lighting	+	1.4 fc	5.9 fc	0.1 fc	59.0:I	14.0:1

LUMINAIR	E SC	CHEDULE				
SYMBOL LABEL	QTY.	MANUF.	CATALOG	DESCRIPTION	FILE	MOUNTING
A	I	LITHONIA LIGHTING	LIL LED 30K MVOLT	LIL LED WALLPACK (STANDARD)	LIL_LED_30K_MVOLT.ies	8'-0" ABOVE GRADE ON BUILDING
		EXA	AMPLE LIGHT FI	ISOLUX CON	TOUR = 0.25 FC TOUR = 0.5 FC TOUR = 1.0 FC	

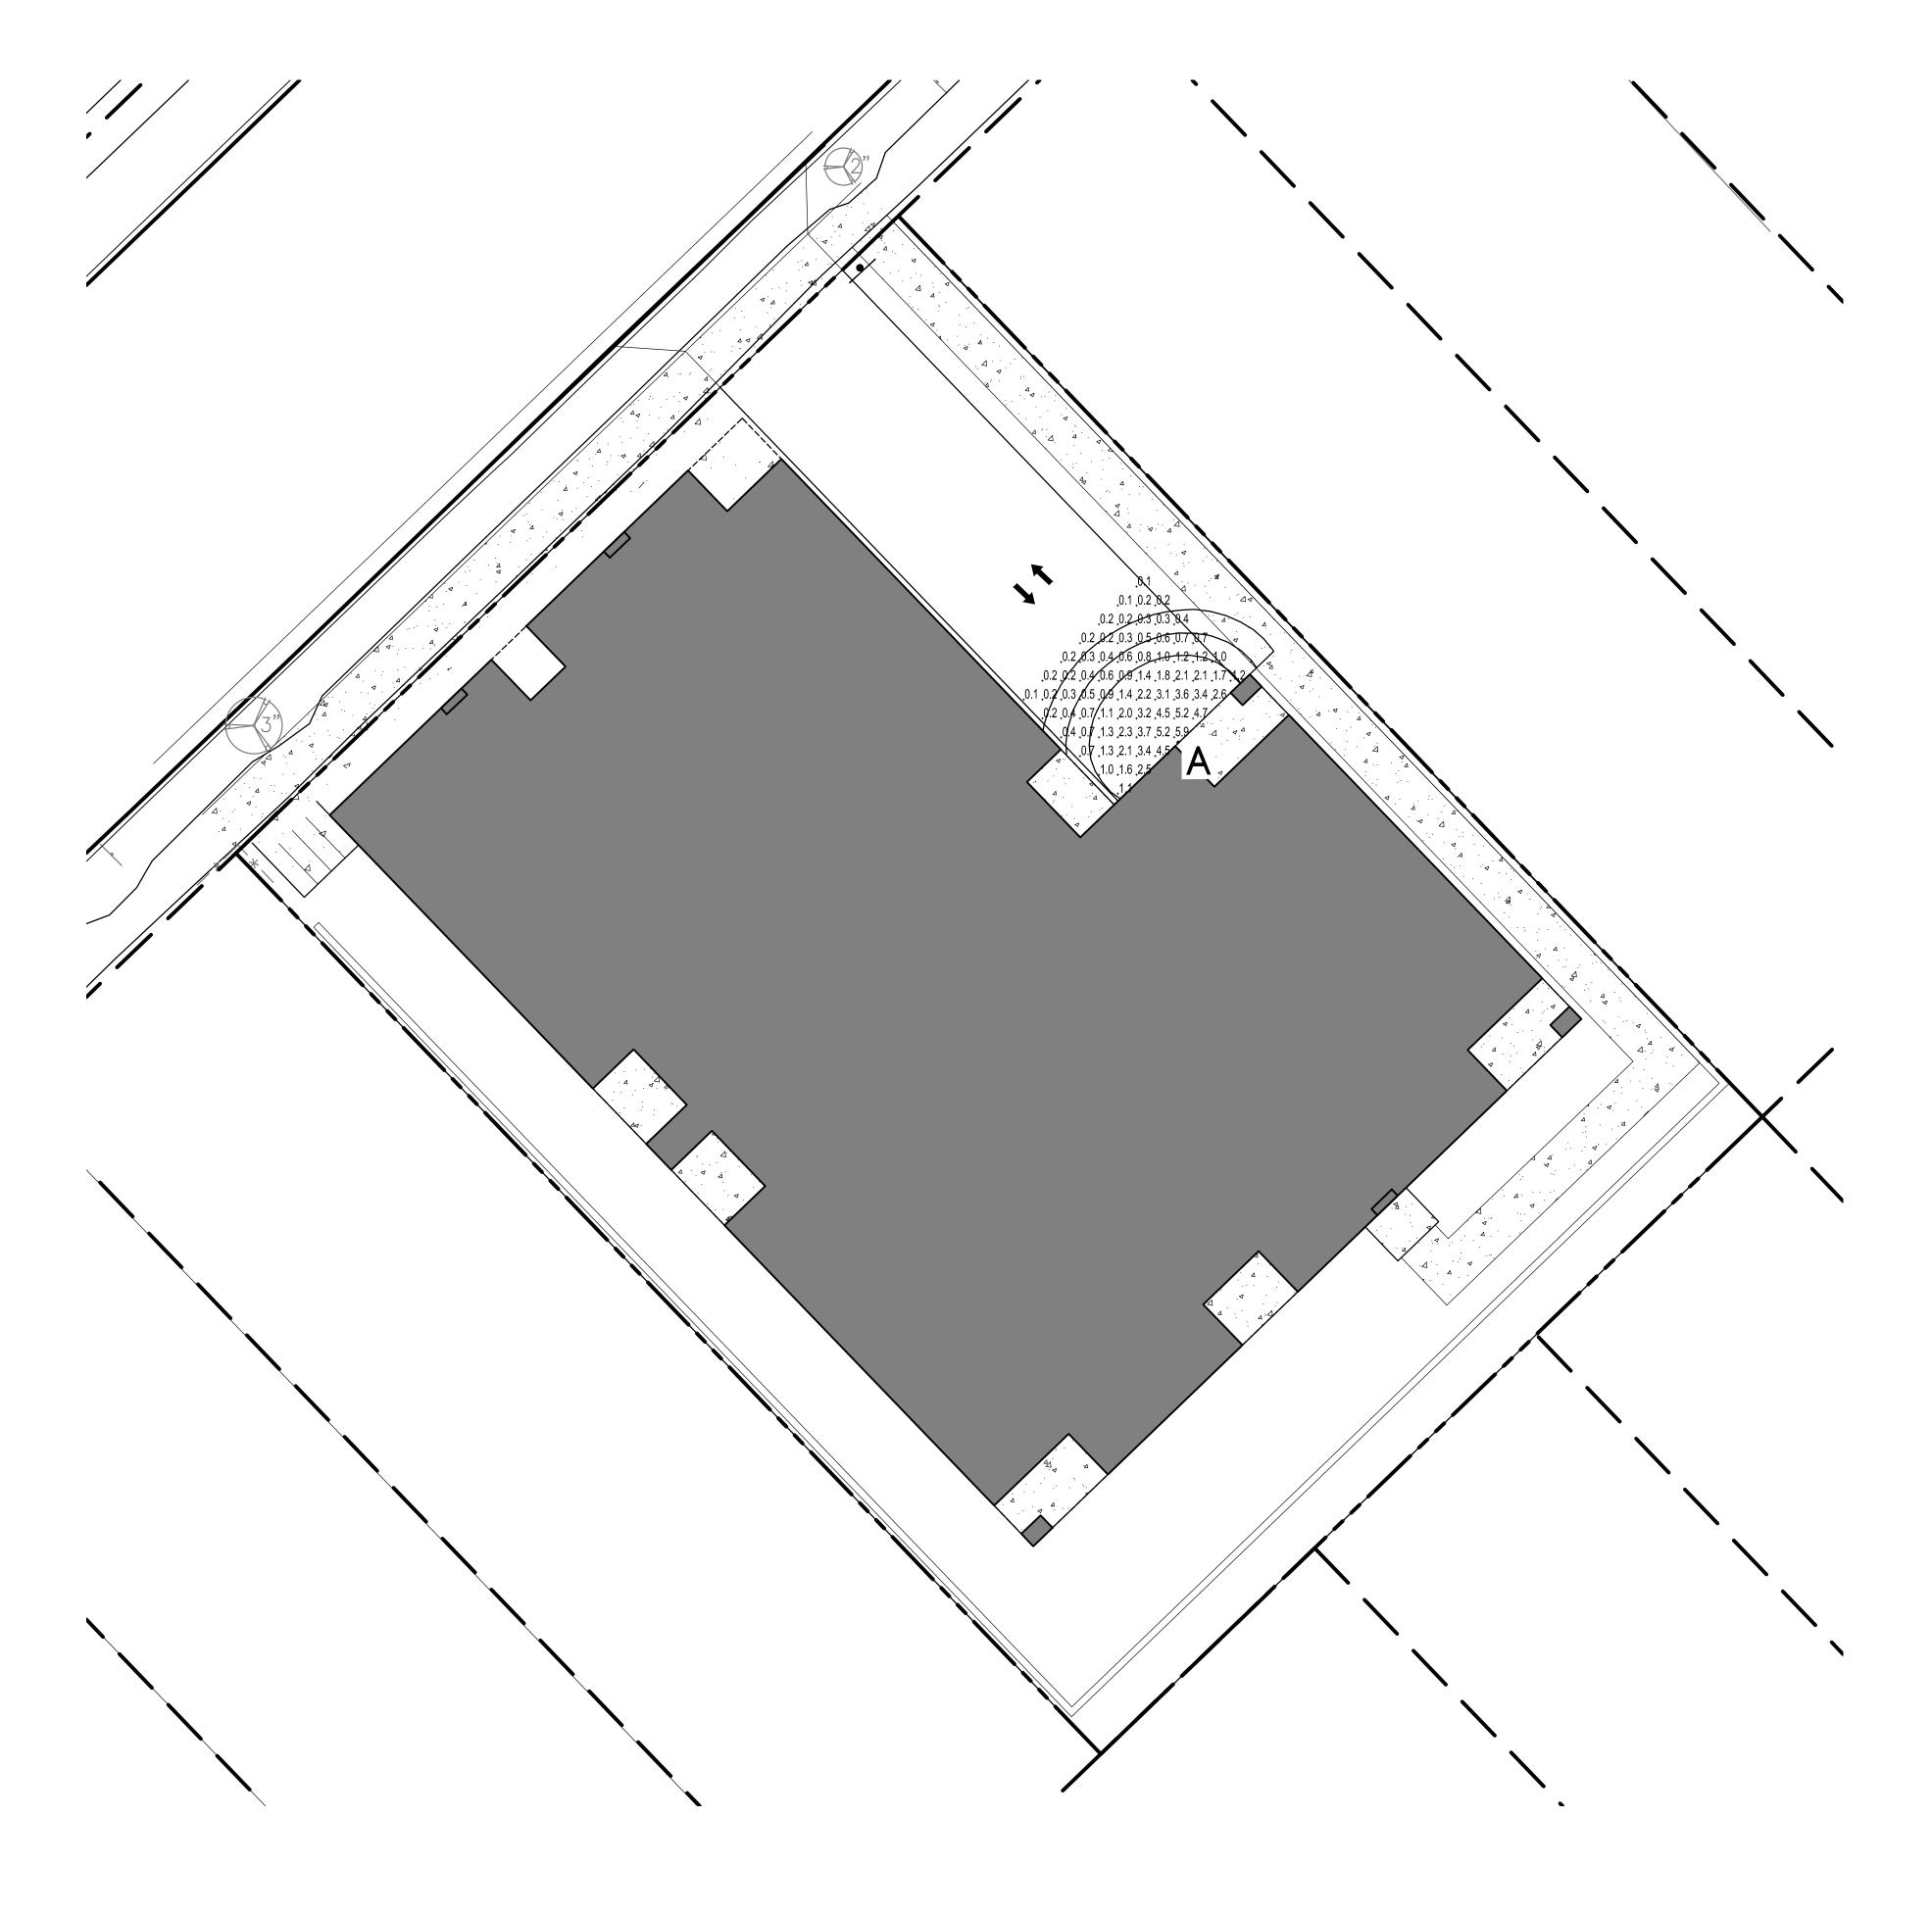

SITE LIGHTING PLAN

| C-1.2 | 1" = 10'-0"

GRAPHIC SCALE

I INCH = I0 FT (24X36 SHEET)



Issued for Land Use Submittal - May 6, 2020 Issued for Land Use Submittal - August 17, 2020

John Fontain
Development


817-821 Williamson St Madison, Wisconsin Site Lighting Plan

SHEET NUMBER

C-1.2

2003

PROJECT NO. © Knothe & Bruce Architects, LLC

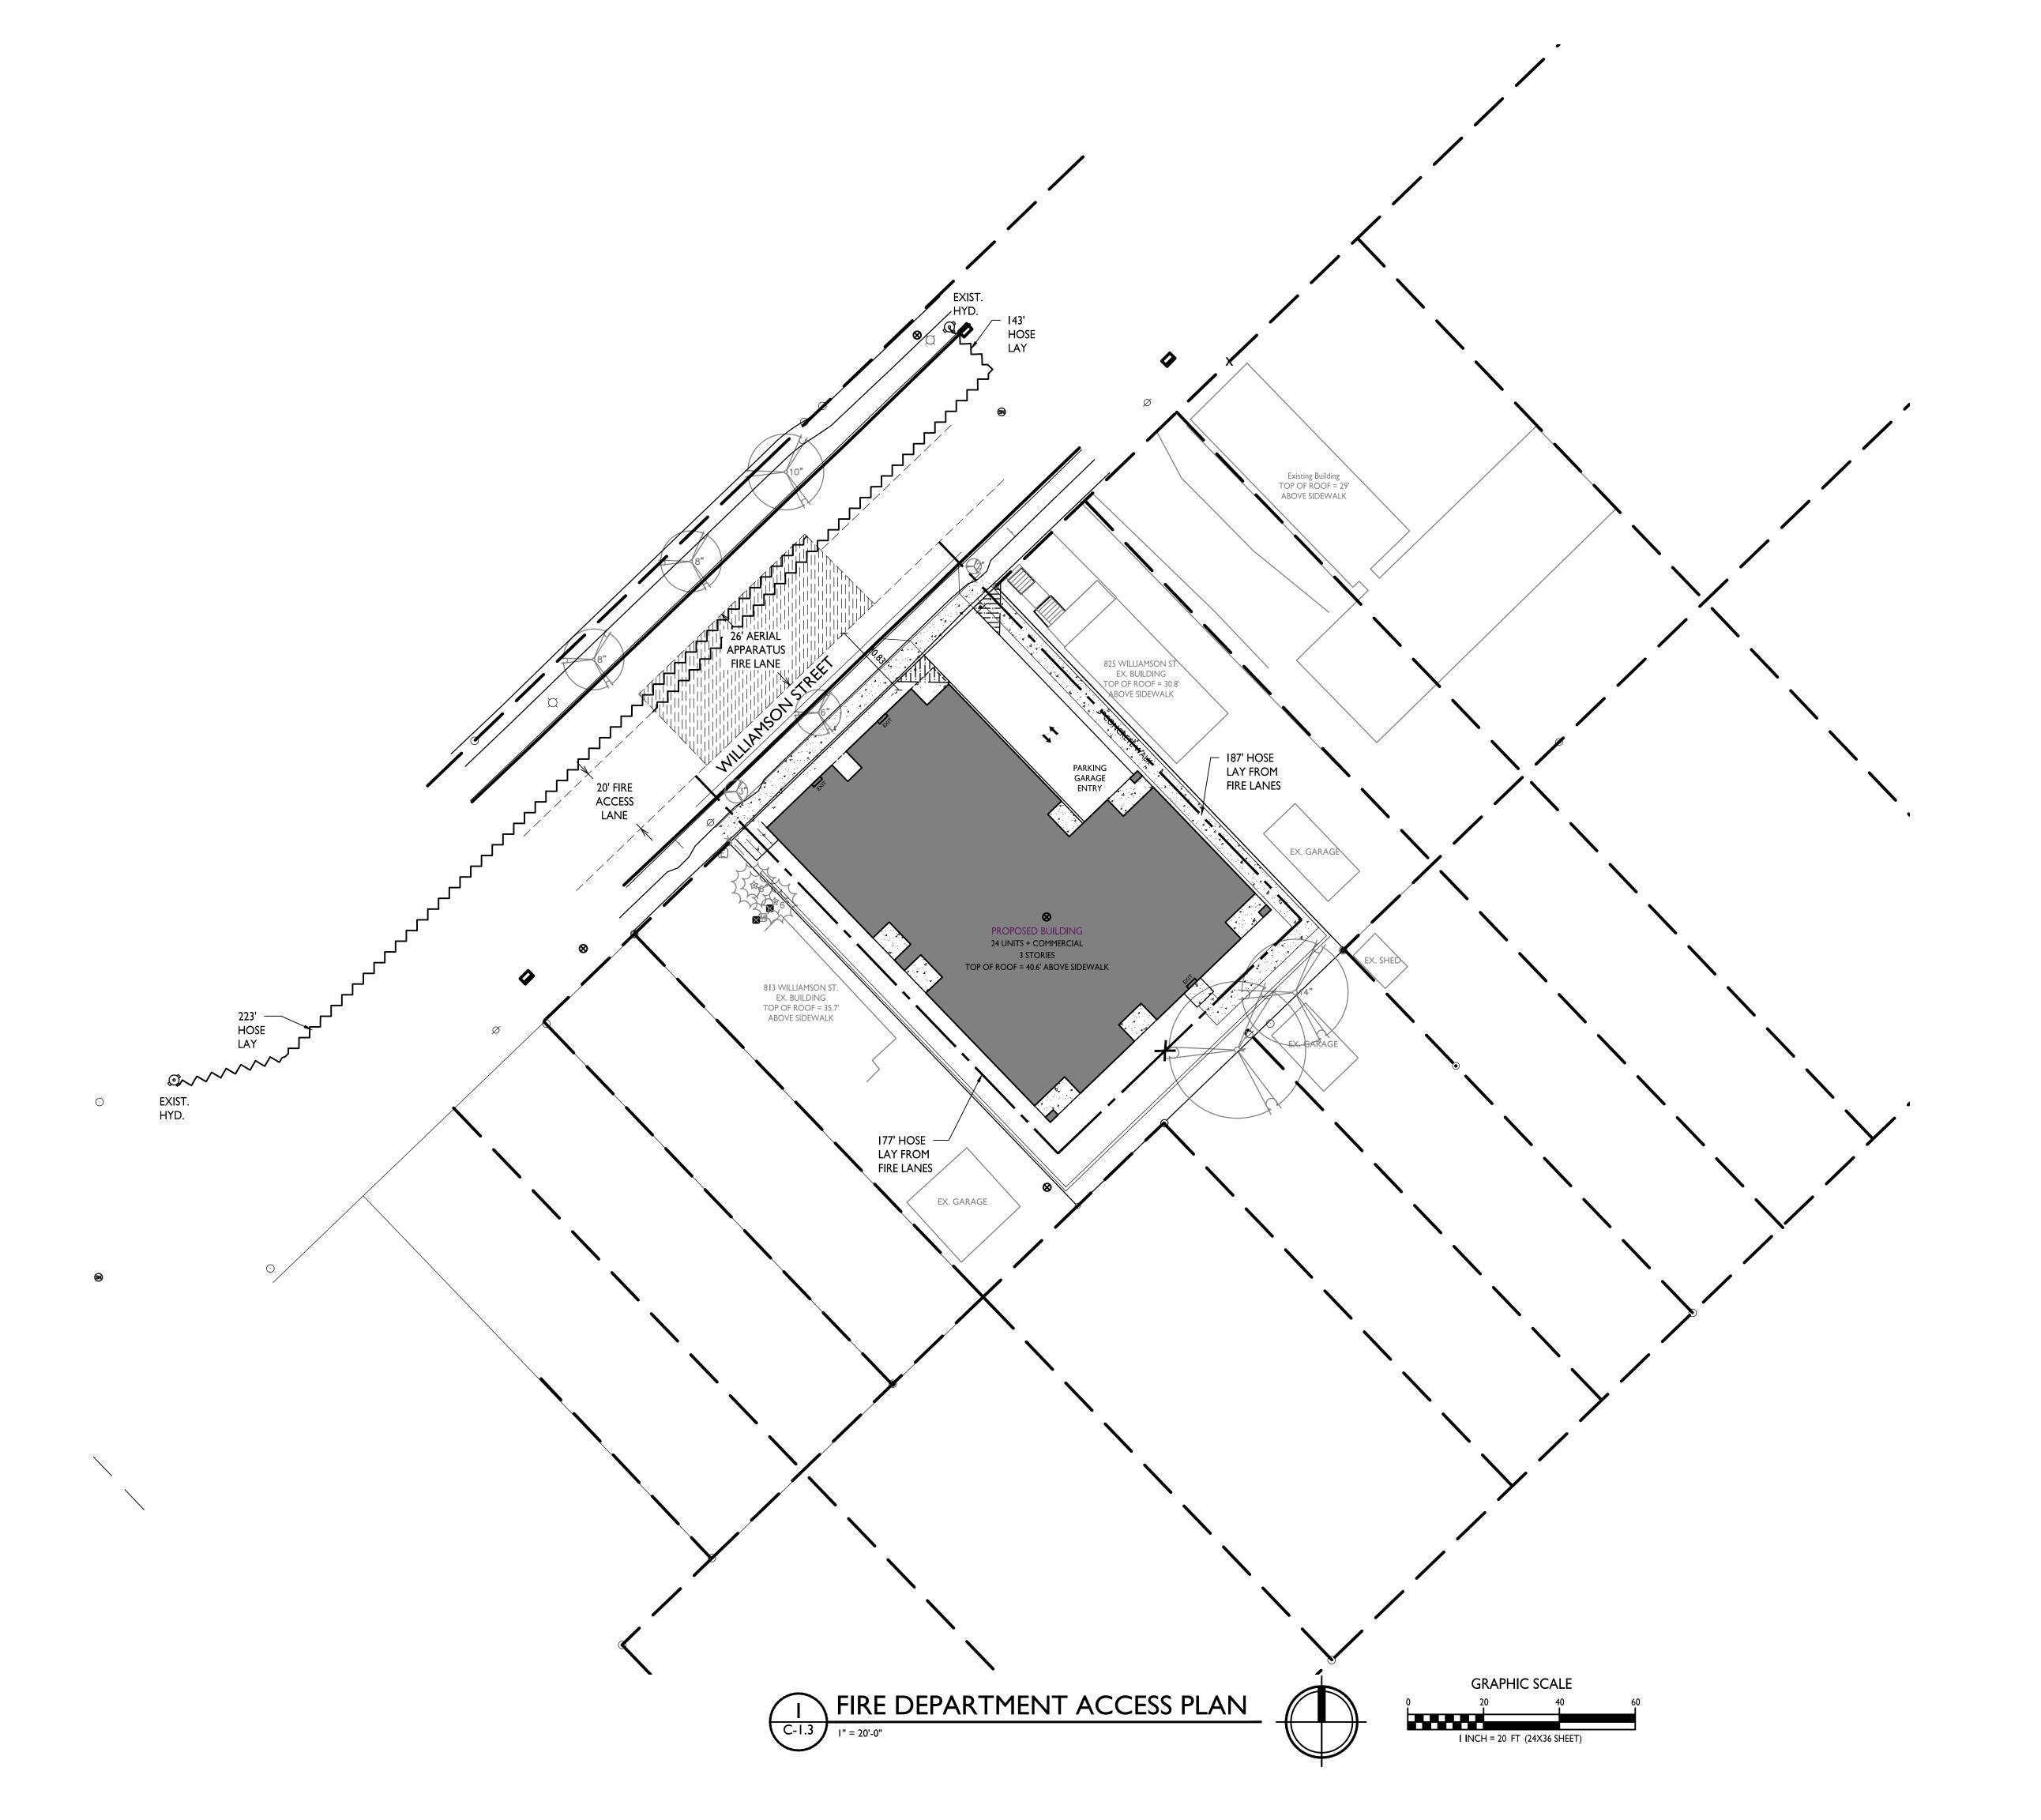



Issued for Land Use Submittal - May 6, 2020 Issued for Land Use Submittal - August 17, 2020


John Fontain
Development


817-821 Williamson St Madison, Wisconsin SHEET TITLE Fire Department Access Plan

SHEET NUMBER

C-1.3

PROJECT NO.

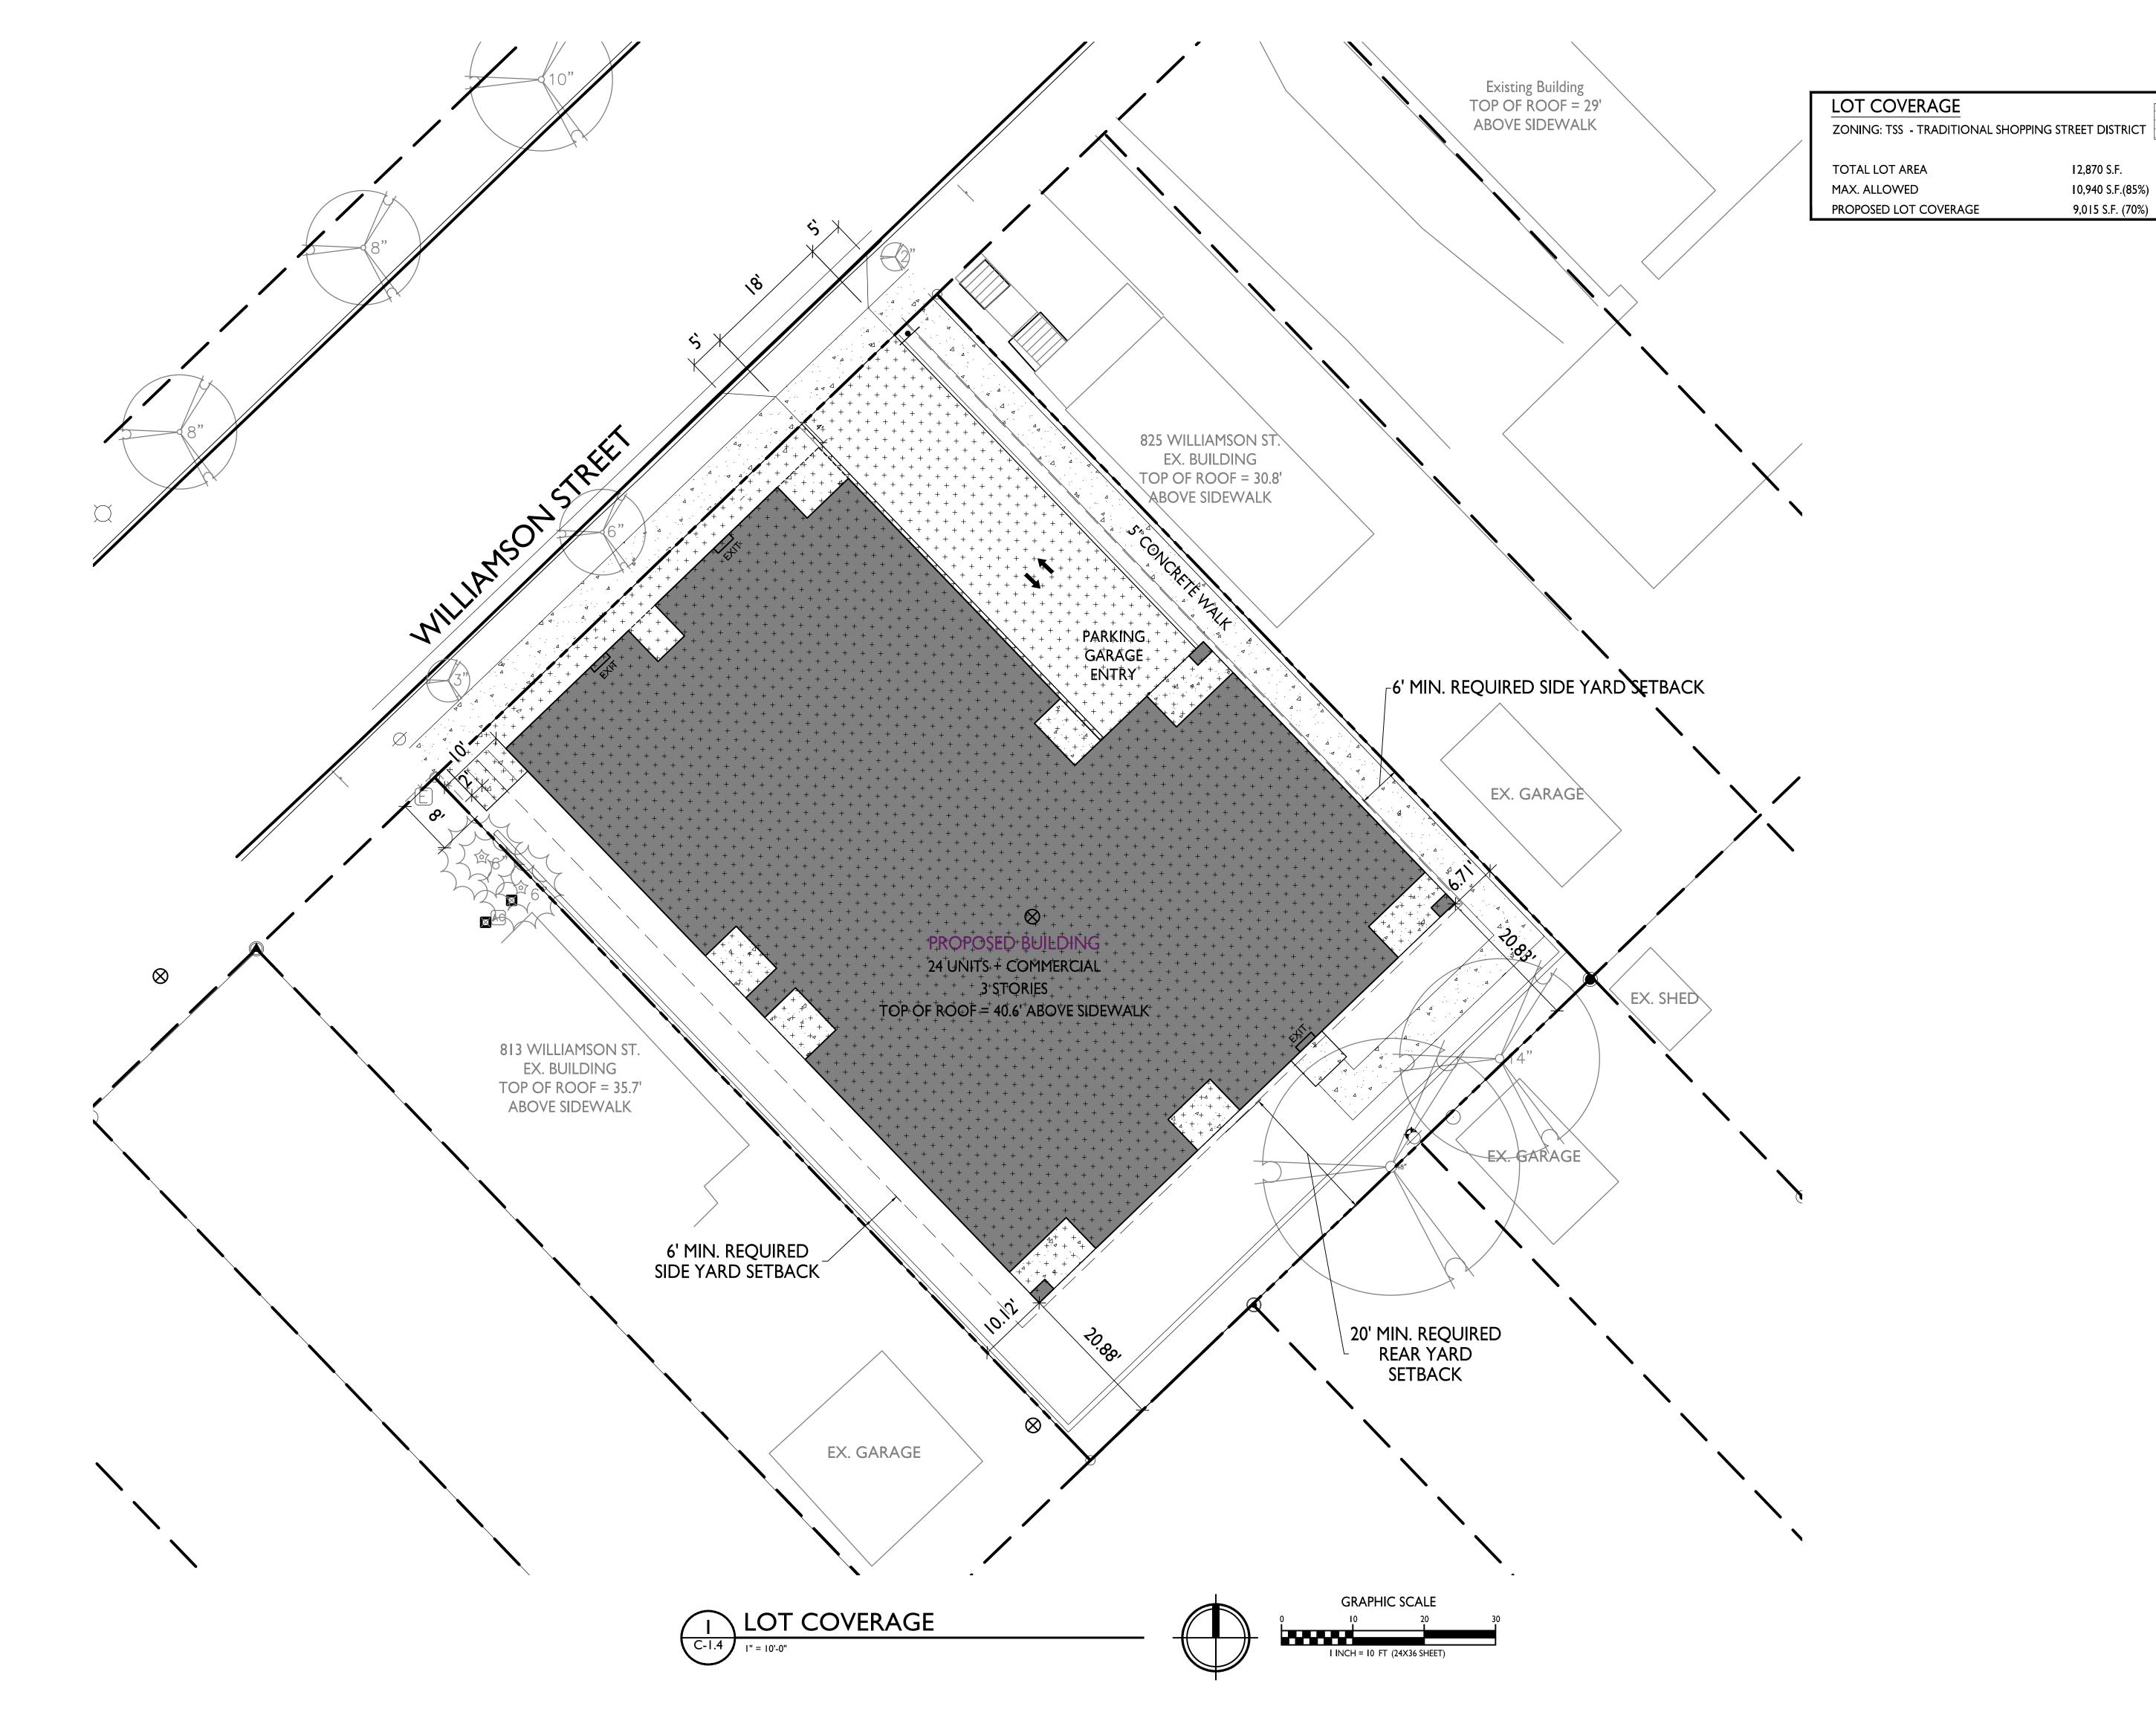

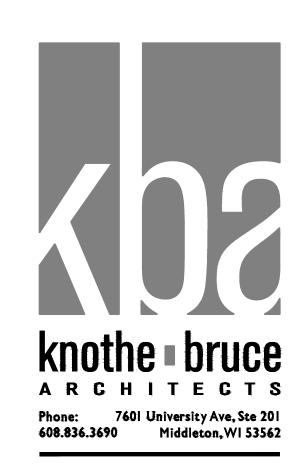

Issued for Land Use Submittal - May 6, 2020 Issued for Land Use Submittal - August 17, 2020


PROJECT TITLE John Fontain Development

817-821 Williamson St Madison, Wisconsin SHEET TITLE Lot Coverage

SHEET NUMBER

PROJECT NO.

2003

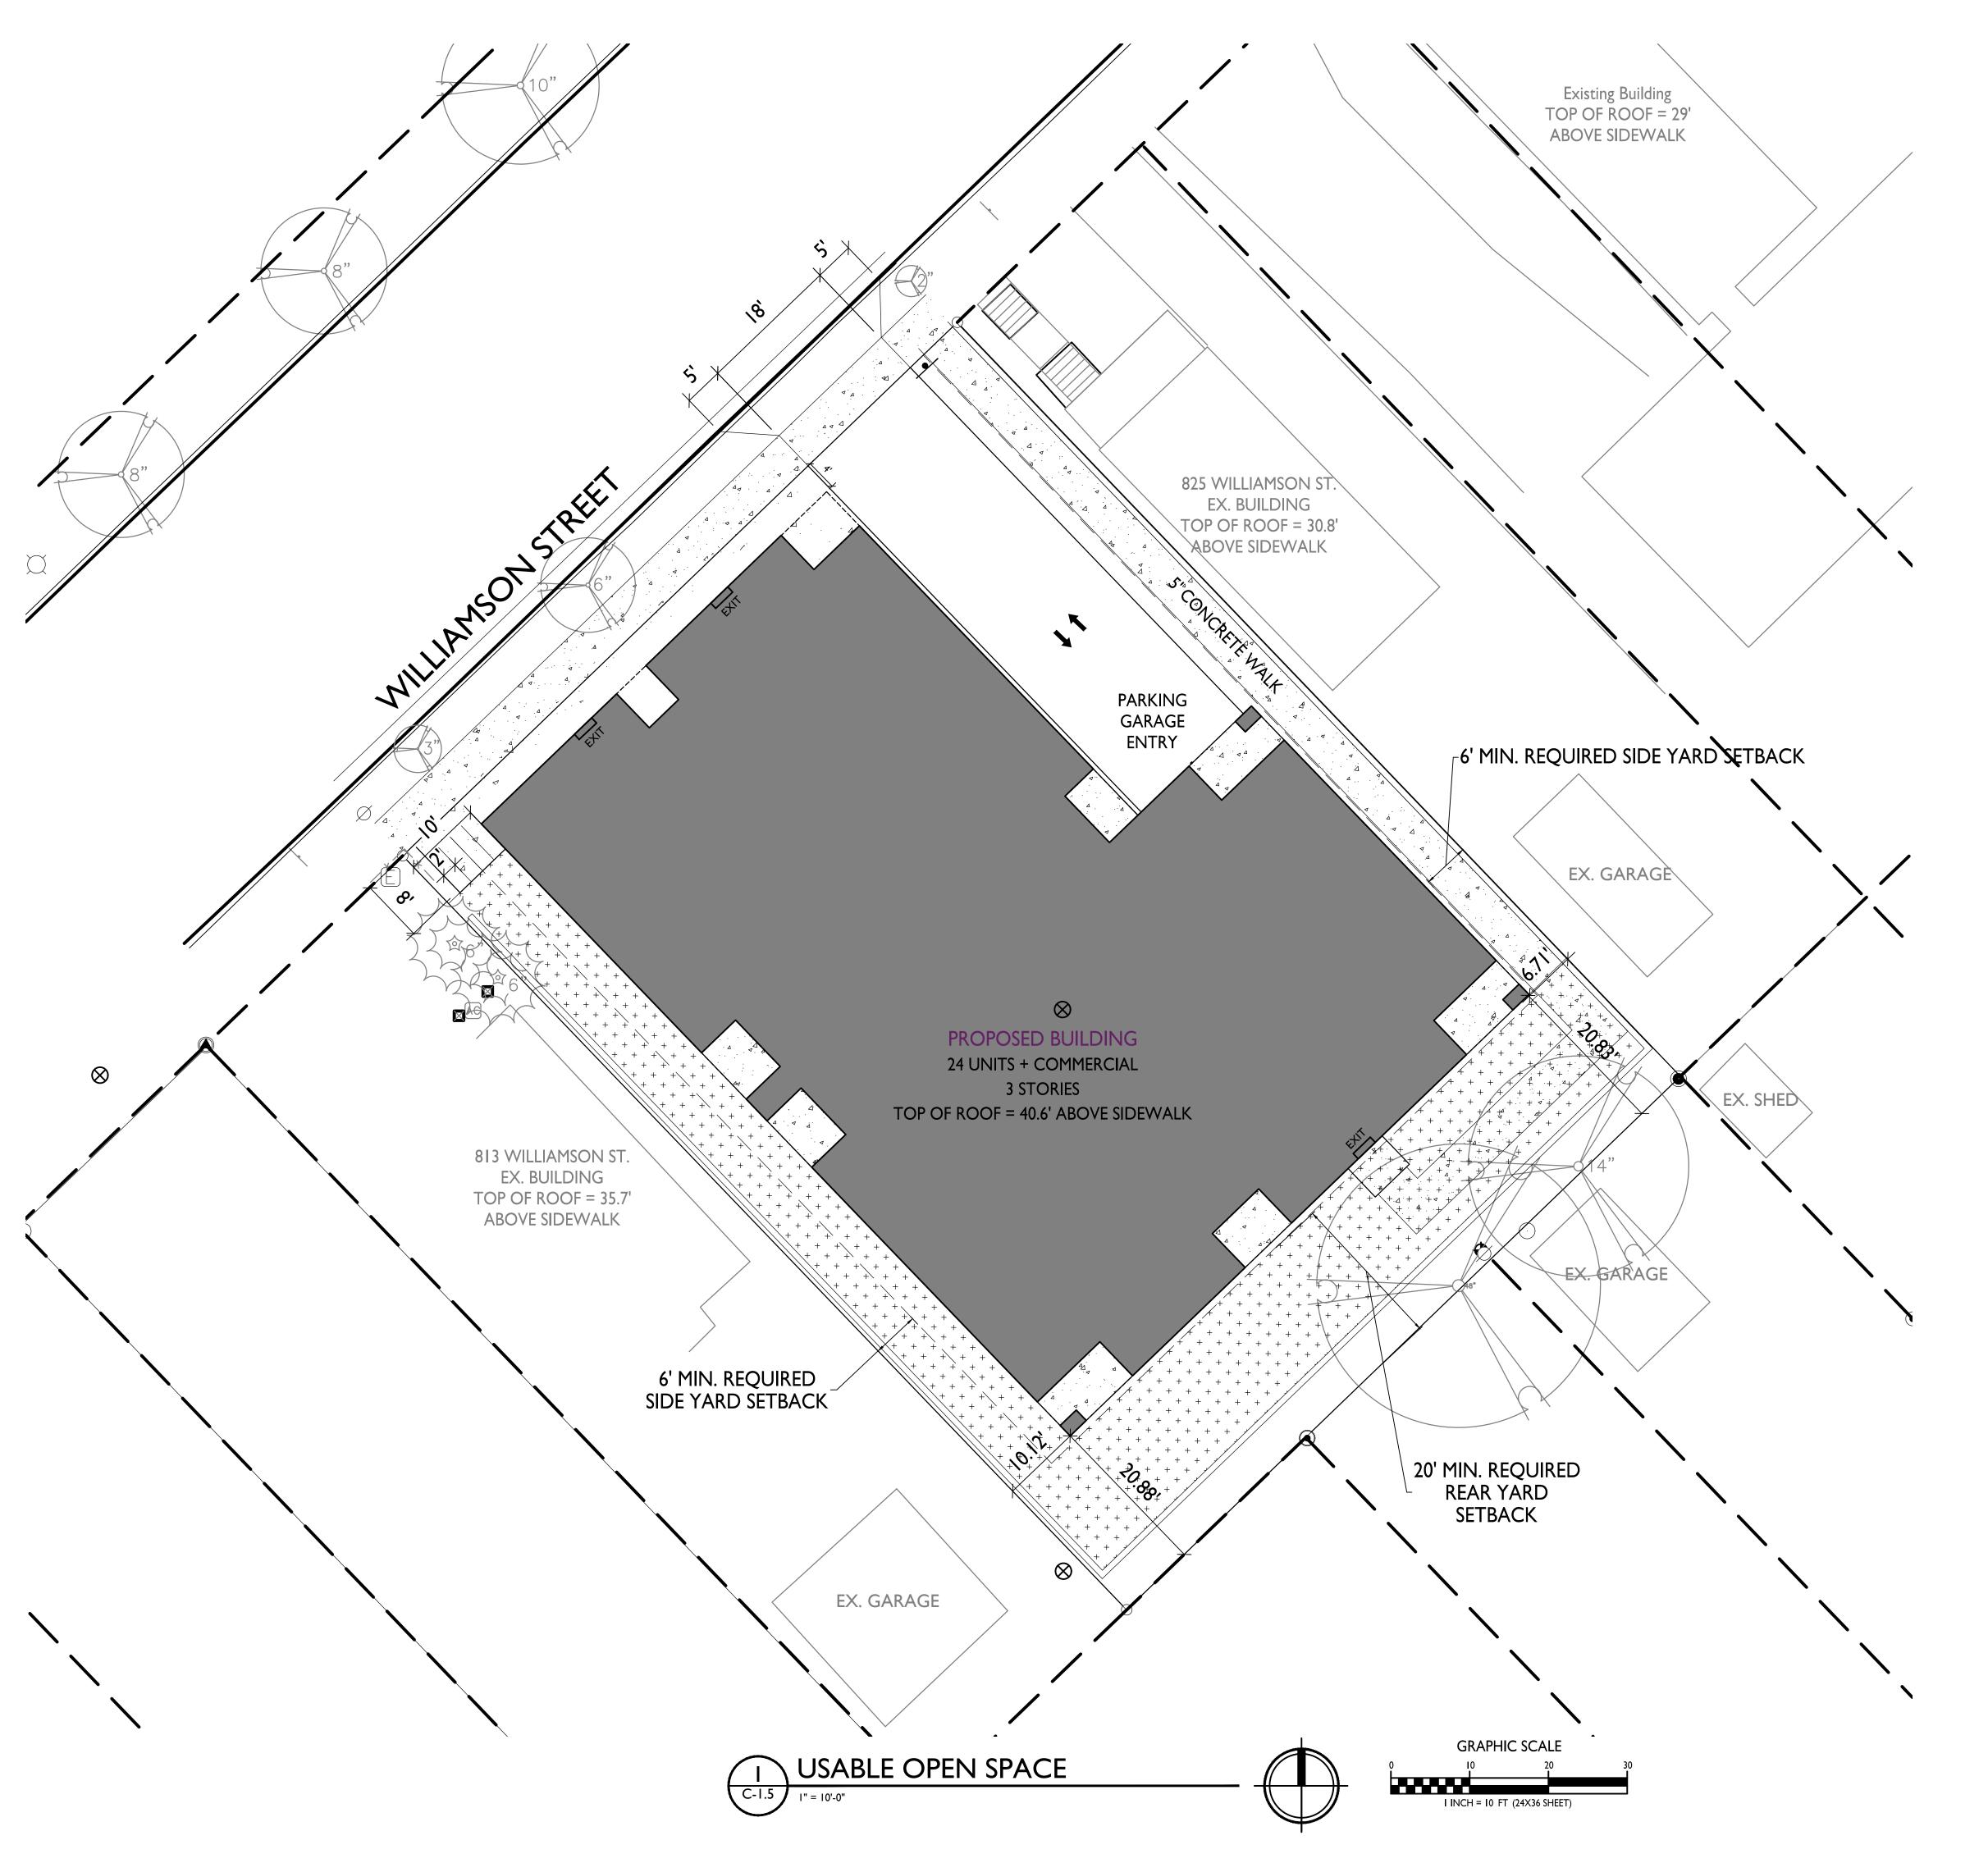

USABLE OPEN SPACE

ZONING: TSS - TRADITIONAL SHOPPING STREET DISTRICT


OPEN SPACE REQUIREMENT 40 S.F / UNIT
DWELLING UNITS 24

960 S.F. REQUIRED

OPEN SPACE PROVIDED

ROOF DECK 240 S.F. BALCONIES 18 X 60 S.F. = 1,080 S.F.

SURFACE2,357 S.F.TOTAL3,677 S.F. PROVIDED

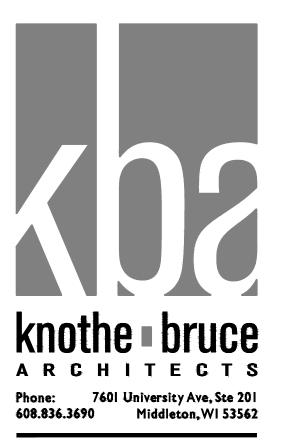

ISSUED

Issued for Land Use Submittal - May 6, 2020 Issued for Land Use Submittal - August 17, 2020

John Fontain
Development

817-821 Williamson St Madison, Wisconsin SHEET TITLE Usable Open Space

SHEET NUMBER

C-1.5

PROJECT NO.

2003

#### **GENERAL NOTES:**

- 1. ALL PRIVATE UTILITIES (GAS, ELECTRIC, AND TELECOMMUNICATIONS) SERVING EXISTING BUILDINGS SCHEDULED FOR DEMOLITION TO BE ABANDONED OR REMOVED BY CORRESPONDING UTILITY COMPANY.
- 2. IT IS THE CONTRACTOR'S RESPONSIBILITY TO VERIFY THE LOCATION OF UNDERGROUND UTILITIES. UTILITIES WERE LOCATED BY OBSERVED EVIDENCE, MARKINGS PROVIDED BY DIGGER'S HOTLINE, AND RECORD DRAWINGS FROM THE CITY OF MADISON.
- 3. CONTRACTOR SHALL VERIFY THE SIZE, TYPE, SLOPE, AND INVERTS OF ALL EXISTING STORM AND SANITARY LATERALS CALLED OUT TO BE CONNECTED TO, CONTRACTOR SHALL SUBMIT THE INFORMATION ON THE PIPES TO THE CITY INSPECTOR AND PROJECT CIVIL ENGINEER.
- 4. ANY SIDEWALK, CURB, OR OTHER PUBLIC PROPERTY DAMAGED AS PART OF THE CONSTRUCTION OF THE UTILITIES AND BUILDING SHALL BE REPLACED IN-KIND PER THE CITY OF MADISON STANDARD SPECIFICATIONS.
- 5. THE RIGHT-OF-WAY IS THE SOLE JURISDICTION OF THE CITY OF MADISON AND IS SUBJECT TO CHANGE AT ANY TIME PER THE RECOMMENDATION/PLAN OF THE CITY.
- 6. CONTRACTOR SHALL INSTALL TREE PROTECTION FENCING IN THE AREA BETWEEN THE CURB AND SIDEWALK AND EXTEND IT AT LEAST 5 FEET FROM BOTH SIDES OF THE TREE ALONG THE LENGTH OF THE TERRACE. NO EXCAVATION IS PERMITTED WITHIN 5 FEET OF THE OUTSIDE EDGE OF A TREE TRUNK. IF EXCAVATION WITHIN 5 FEET OF ANY TREE IS NECESSARY, CONTRACTOR SHALL CONTACT CITY FORESTRY (266-4816) PRIOR TO EXCAVATION TO ASSESS THE IMPACT TO THE TREE AND ROOT SYSTEM. TREE PRUNING SHALL BE COORDINATED WITH CITY FORESTRY PRIOR TO THE START OF CONSTRUCTION. TREE PROTECTION SPECIFICATIONS CAN BE FOUND IN SECTION 107.13 OF CITY OF MADISON STANDARD SPECIFICATIONS FOR PUBLIC WORKS CONSTRUCTION http://www.cityofmadison.com/business/pw/documents/stdspecs/2018/part1.pdf. ANY TREE REMOVALS THAT ARE REQUIRED FOR CONSTRUCTION AFTER THE DEVELOPMENT PLAN IS APPROVED WILL REQUIRE AT LEAST A 72 HOUR WAIT PERIOD BEFORE A TREE REMOVAL PERMIT CAN BE ISSUED BY FORESTRY, TO NOTIFY THE ALDER OF THE CHANGE IN THE TREE PLAN.

### **DEMOLITION NOTES:**

- THE CONTRACTOR IS RESPONSIBLE FOR THE DEMOLITION, REMOVAL, AND DISPOSING IN A LOCATION APPROVED BY ALL GOVERNING AUTHORITIES, OF ALL STRUCTURES, PADS, WALLS, FLUMES, FOUNDATIONS, PARKING DRIVES, DRAINAGE, STRUCTURES, UTILITIES, ETC., SUCH THAT THE IMPROVEMENTS SHOWN ON THE REMAINING PLANS CAN BE CONSTRUCTED. ALL FACILITIES TO BE REMOVED SHALL BE UNDERCUT TO SUITABLE MATERIAL AND BROUGHT TO GRADE WITH SUITABLE COMPACTED FILL MATERIAL PER THE SPECIFICATIONS.
- 2. THE CONTRACTOR IS RESPONSIBLE FOR OBTAINING ALL PERMITS REQUIRED FOR DEMOLITION AND DISPOSAL.
- THE CONTRACTOR SHALL COORDINATE WITH THE RESPECTIVE UTILITY COMPANIES PRIOR TO THE REMOVAL AND/OR RELOCATION OF UTILITIES. THE CONTRACTOR SHALL COORDINATE WITH THE UTILITY COMPANY CONCERNING PORTIONS OF WORK WHICH MAY BE PERFORMED BY THE UTILITY COMPANY FORCING ANY FEES WHICH ARE TO BE PAID TO THE UTILITY COMPANY FOR THEIR SERVICES. THE DEVELOPER IS RESPONSIBLE FOR PAYING ALL FEES AND CHARGES.
- THE LOCATIONS OF ALL EXISTING UTILITIES SHOWN ON THIS PLAN HAVE BEEN DETERMINED FROM THE BEST INFORMATION AVAILABLE AND ARE GIVEN FOR THE CONVENIENCE OF THE CONTRACTOR. THE ENGINEER ASSUMES NO RESPONSIBILITY FOR THEIR ACCURACY. PRIOR TO THE START OF ANY DEMOLITION ACTIVITY, THE CONTRACTOR SHALL NOTIFY THE UTILITY COMPANIES FOR ONSITE LOCATIONS OF EXISTING UTILITIES. NOTIFY THE ENGINEER OF ANY DISCREPANCIES.
- ALL EXISTING SEWERS, PIPING, AND UTILITIES SHOWN ARE NOT TO BE INTERPRETED AS THE EXACT LOCATION, OR AS THE ONLY OBSTACLES THAT MAY OCCUR ON THE SITE. VERIFY EXISTING CONDITIONS AND PROCEED WITH CAUTION AROUND ANY ANTICIPATED FEATURES. GIVE NOTICE TO ALL UTILITY COMPANIES REGARDING DESTRUCTION AND REMOVAL OF ALL SERVICE LINES BEFORE PROCEEDING WITH THE WORK, UTILITIES DETERMINED TO BE ABANDONED AND LEFT IN PLACE SHALL BE GROUTED IF UNDER BUILDINGS.
- ELECTRICAL, TELEPHONE, CABLE, WATER, FIBER OPTIC CABLE, AND/OR GAS LINES NEEDING TO BE REMOVED OR RELOCATED SHALL BE COORDINATED WITH THE AFFECTED UTILITY COMPANY. ADEQUATE TIME SHALL BE PROVIDED FOR RELOCATION AND CLOSE COORDINATION WITH THE UTILITY COMPANY IS NECESSARY TO PROVIDE A SMOOTH TRANSITION IN UTILITY SERVICE.
- CONTRACTOR SHALL PROTECT THE PUBLIC AT ALL TIMES WITH FENCING, BARRICADES, ENCLOSURES, COVERED WALKWAYS, ETC. CONTRACTOR SHALL SUBMIT THEIR STREET OCCUPANCY PLAN TO TRAFFIC ENGINEERING FOR APPROVAL
- PRIOR TO DEMOLITION OCCURRING, ALL APPLICABLE EROSION CONTROL DEVICES ARE TO BE INSTALLED.
- THE CONTRACTOR MAY LIMIT SAWCUT AND PAVEMENT REMOVAL TO ONLY THOSE AREAS WHERE IT IS REQUIRED AS SHOWN ON THESE CONSTRUCTION PLANS, BUT IF ANY DAMAGE IS INCURRED ON ANY OF THE SURROUNDING PAVEMENT, ETC. THE CONTRACTOR SHALL BE RESPONSIBLE FOR ITS REMOVAL AND REPAIR IN KIND.
- DAMAGE TO ALL EXISTING CONDITIONS TO REMAIN WILL BE REPLACED AT THE CONTRACTOR'S EXPENSE:
- 11. CONTINUOUS ACCESS SHALL BE MAINTAINED FOR THE SURROUNDING PROPERTIES AT ALL TIMES DURING DEMOLITION OF THE EXISTING FACILITIES.

# <u>SITE PLAN NOTES:</u>

- PAVEMENT DESIGN SHALL BE PER THE RECOMMENDATION OF THE SOILS CONSULTANT.
- THE RIGHT-OF-WAY IS THE SOLE JURISDICTION OF THE CITY OF MADISON AND IS SUBJECT TO CHANGE AT ANY TIME PER THE RECOMMENDATION/PLAN OF TRAFFIC ENGINEERING AND CITY ENGINEERING DEPARTMENTS.
- TRAFFIC CONTROL SIGNAGE SHALL BE IN ACCORDANCE WITH FEDERAL, STATE, COUNTY, CITY, AND LOCAL CODE, WHICHEVER HAS JURISDICTION.
- CITY SIDEWALK AND CURB DAMAGED IN THE COURSE OF CONSTRUCTION TO BE REPLACED PER GRADING PLAN AND PER CITY OF MADISON STANDARD SPECIFICATIONS.
- NEW APRONS SHALL BE CONSTRUCTED AND PLACED IN CONFORMANCE WITH THE CITY OF MADISON STANDARD DETAIL 3.02 FOR COMMERCIAL OPENINGS.

# GRADING PLAN NOTES:

ALL GRADES ARE FINISH ELEVATION UNLESS NOTED OTHERWISE

#### EROSION CONTROL NOTES/SPECIFICATIONS:

- EROSION CONTROL DEVICES AND/OR STRUCTURES SHALL BE INSTALLED PRIOR TO CLEARING AND GRUBBING OPERATIONS. THESE SHALL BE PROPERLY MAINTAINED FOR MAXIMUM EFFECTIVENESS UNTIL VEGETATION IS RE-ESTABLISHED.
- EROSION CONTROL IS THE RESPONSIBILITY OF THE CONTRACTOR UNTIL ACCEPTANCE OF THIS PROJECT, EROSION CONTROL MEASURES AS SHOWN SHALL BE THE MINIMUM PRECAUTIONS THAT WILL BE ALLOWED. THE CONTRACTOR SHALL BE RESPONSIBLE FOR RECOGNIZING AND CORRECTING ALL EROSION CONTROL PROBLEMS THAT ARE THE RESULT OF CONSTRUCTION ACTIVITIES. ADDITIONAL EROSION CONTROL MEASURES, AS REQUESTED IN WRITING BY THE STATE OR LOCAL INSPECTORS, OR THE DEVELOPER'S ENGINEER, SHALL BE INSTALLED WITHIN 24
- ALL EROSION CONTROL MEASURES AND STRUCTURES SERVING THE SITE MUST BE INSPECTED AT LEAST WEEKLY OR WITHIN 24 HOURS OF THE TIME 0.5 INCHES OF RAIN IS PRODUCED. ALL MAINTENANCE WILL FOLLOW AN INSPECTION WITHIN 24 HOURS. INSPECTION SCHEDULE AND RECORD KEEPING SHALL COMPLY WITH NR 216.46(9), WIS. ADM. CODE AND CITY OF MADISON REPORTING REQUIREMENTS.
- CONSTRUCTION ENTRANCES PROVIDE A STONE TRACKING PAD AT EACH POINT OF ACCESS. INSTALL ACCORDING TO WDNR STANDARD 1057 REFER TO WDNR'S STORMWATER WEB PAGE OF TECHNICAL STANDARDS AT: HTTP://DNR.WI.GOV/TOPIC/STORMWATER/STANDARDS/CONST\_STANDARDS.HTML. THE TRACKING PAD MUST BE MAINTAINED IN A CONDITION THAT PREVENTS THE TRACKING OF MATERIAL ONTO THE PUBLIC STREET.
- TEMPORARY STABILIZATION USING ANIONIC POLYMER. AFTER NOVEMBER 1, 2020, ANIONIC POLYACRYLAMIDE WILL BE APPLIED TO ALL DISTURBED AREAS WHERE THE MUNICIPALITY'S ENGINEER OR WDNR REPRESENTATIVES DEEM STABILIZATION AND/OR EROSION TO BE PROBLEMATIC. APPLICATION OF POLYACRYLAMIDE WILL BE ACCORDING TO WDNR CONSERVATION PRACTICE STANDARD 1050, EROSION CONTROL LAND APPLICATION OF ANIONIC POLYACRYLAMIDE. REFER TO WDNR'S STORMWATER WEB PAGE OF TECHNICAL STANDARDS AT: HTTP://DNR.WI.GOV/TOPIC/STORMWATER/STANDARDS/CONST\_STANDARDS.HTML
- SOIL STOCKPILES A ROW OF SILT FENCE PLACED DOWNSLOPE AND AT LEAST 10 FEET AWAY FROM THE STOCKPILE SHALL PROTECT ALL STOCKPILES. SOIL STOCKPILES THAT ARE INACTIVE FOR MORE THAN 14 CONSECUTIVE DAYS SHALL BE STABILIZED WITH SEED & MULCH, EROSION MAT, POLYMER, OR COVERED WITH TARPS OR SIMILAR MATERIAL. NO STOCKPILE SHALL BE PLACED WITHIN 20 FEET OF A DRAINAGE WAY.
- DEWATERING WATER PUMPED FROM THE SITE SHALL BE TREATED BY USING A TEMPORARY SEDIMENTATION BASIN, PORTABLE DEWATERING BASIN, GEOTEXTILE BAG, OR AN EQUIVALENT DEVICE. SHOW ON THE PLAN THE ANTICIPATED LOCATIONS OF DEWATERING ACTIVITY, AND PROVIDE AN ENGINEERING DETAIL OF THE DEWATERING SYSTEM. DEVISES SHALL COMPLY WITH WONR TECHNICAL STANDARD 1061 FOUND AT: HTTP://DNR.WI.GOV/TOPIC/STORMWATER/STANDARDS/CONST\_STANDARDS.HTML THIS WATER SHALL BE DISCHARGED IN A MANNER THAT DOES NOT INDUCE EROSION OF THE SITE OR ADJACENT PROPERTY.

TYPE I BAG SIZE (SQ-FT)
25
50
75

- STORM SEWER INLETS PROVIDE WOOT TYPE D "CATCHALL" INLET PROTECTION OR EQUIVALENT, REFER TO WOOT PRODUCT ACCEPTABILITY LIST AT: HTTP://WWW.DOT.WISCONSIN.GOV/BUSINESS/ENGRSERV/PAL.HTM. INLET PROTECTION SHALL BE INSTALLED PRIOR TO THE STORM SEWER SYSTEM RECEIVING SITE RUNOFF. OTHER THAN FOR PERFORMING MAINTENANCE, THESE DEVICES SHALL NOT BE REMOVED UNTIL SITE STABILIZATION IS COMPLETE.
- BUILDING AND WASTE MATERIALS SHALL BE PREVENTED FROM RUNNING-OFF THE SITE AND ENTERING WATERS OF THE STATE IN CONFORMANCE WITH NR151.12(6M).
- NO SOLID MATERIAL SHALL BE DISCHARGED OR DEPOSITED INTO WATERS OF THE STATE IN VIOLATION OF CH. 30 OR 31 OF THE WISCONSIN STATE STATUTES OR 33 USC 1344 PERMITS.
- EROSION CONTROL DEVICES SHALL ADHERE TO THE TECHNICAL STANDARDS FOUND AT: HTTP://DNR.WI.GOV/RUNOFF/STORMWATER/TECHSTDS.HTM AND COMPLY WITH ALL CITY OF MADISON ORDINANCES.
- 12. ALL DEBRIS TRACKED ONTO PUBLIC STREETS SHALL BE SWEPT OR SCRAPED CLEAN BY THE END OF EACH WORKDAY
- 13. ALL BUILDING AND WASTE MATERIAL SHALL BE HANDLED PROPERLY TO PREVENT RUNOFF OF THESE MATERIALS OFF OF THE SITE.
- 14. ALL DISTURBED AREAS, EXCEPT PAVED AREAS, SHALL RECEIVE A MINIMUM OF FOUR (4) INCHES OF TOPSOIL, FERTILIZER, SEED, AND MULCH, SEED MIXTURES SHALL BE SELECTED APPROPRIATE TO THE INTENDED FUNCTION. A QUALIFIED LANDSCAPING CONTRACTOR, LANDSCAPE ARCHITECT OR NURSERY CAN BE CONSULTED FOR RECOMMENDATIONS. SEEDING RATES SHALL BE BASED ON POUNDS OR OUNCES OF PURE LIVE SEED PER ACRE AND SHALL BE PROVIDED BY THE SEED SUPPLIER. FERTILIZER CAN BE APPLIED TO HELP PROMOTE GROWTH, BUT A SOIL TEST IS RECOMMENDED TO DETERMINE THE TYPE AND AMOUNT OF FERTILIZER TO BE APPLIED. ALL SEEDING AND RESTORATION SHALL BE IN CONFORMANCE TO WDNR TECHNICAL STANDARD 1059 FOUND AT HTTP://DNR.WI.GOV/TOPIC/STORMWATER/STANDARDS/CONST\_STANDARDS.HTML. SEEDING AND SODDING MAY ONLY BE USED FROM MAY 1ST TO SEPTEMBER 15TH OF ANY YEAR. TEMPORARY SEED SHALL BE USED AFTER SEPTEMBER 15. IF TEMPORARY SEEDING IS USED, A PERMANENT COVER SHALL ALSO BE REQUIRED AS PART OF THE FINAL SITE STABILIZATION.
- 15. FOR THE FIRST SIX (6) WEEKS AFTER THE INITIAL STABILIZATION OF A DISTURBED AREA, WATERING SHALL BE PERFORMED WHENEVER MORE THAN SEVEN (7) DAYS OF DRY WEATHER ELAPSE.

## **EMERGENCY CONTACT**


**BRANDON COOK** JOHN FONTAIN REALTY P O BOX 694 MADISON, WI 53701 608-807-8982

# <u>SCHEDULE</u>

JULY 13, 2020

JULY 13, 2020	EXISTING BUILDING DEMOLITION START.
AUGUST 10, 2020	BUILDING EXCAVATION COMPLETE.
AUGUST 10, 2020	INSTALL MULCH ON DISTURBED AREAS OUTSIDE OF BUILDING FOOTPRINT.
MAY 15, 2021	FOUNDATION AND FIRST FLOOR COMPLETE. KEEP MULCH ON DISTURBED AREAS.
SEPTEMBER 20, 2021	BUILDING COMPLETE.
SEPTEMBER 20, 2021	REMOVAL OF ASPHALT SURROUNDING BUILDING.
SEPTEMBER 28, 2021	ASPHALT REPLACED AROUND BUILDING.

SILT FENCE AND CONSTRUCTION ENTRANCE INSTALLED.

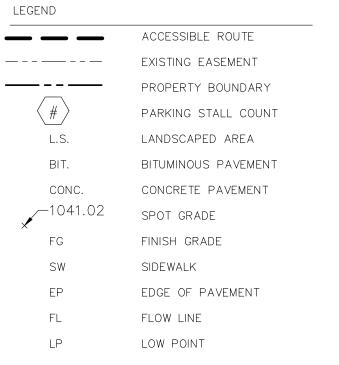

HIGH POINT TOP OF CURB TOP OF WALL BOTTOM OF WALL BOW BACK OF WALK FOW FRONT OF WALK EXPOSURE PROPOSED SANITARY SEWER ----- SAN -----

PROPOSED STORM SEWER PROPOSED DRAIN TILE PROPOSED WATER LATERAL -\\\\ UTILITY LINE DEMOLITION TREE REMOVAL EXISTING MINOR CONTOUR  $- - \cdot 1041 \cdot - -$ EXISTING MAJOR CONTOUR —— 1040 — — PROPOSED MINOR CONTOUR <del>------</del>1041-----PROPOSED MAJOR CONTOUR 

PROPOSED SWALE/DITCH ACCESSIBLE PARKING SIGN VISION TRIANGLE (NO VISUAL OBSTRUCTIONS BETWEEN HEIGHTS OF 30" AND 10')

PROPOSED RIDGE LINE

CONSTRUCTION ENTRANCE ---- X ----- SAW CUT / REMOVAL LIMITS DISTURBANCE LIMITS — — — — SILT FENCE CHECK DAM DIVERSION BERM

INLET PROTECTION

\_\_ \_ USLE FLOW PATH

▶ ◀

 $\Phi$ S Ontain F. On Box 694 Son, WI 53 ON **—**  $\sqsubseteq$ 

SHEET LIST TABLE SHEET NUMBER SHEET TITLE C001 CIVIL DETAILS C100 EXISTING CONDITIONS C300 EROSION CONTROL CIVIL SITE PLAN C400 C500 GRADING PLAN C600 UTILITY PLAN



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Dial (800) 242-851



MLB MLB D BY: C RB 3Y: C RB D BY: P D F ED:

PROJECT #: BSE2240 PLOT DATE: 05/05/2020 **REVISION DATES:** 

02/28/202 PC SUBMITTAL 05/06/2020 CIVIL DETAILS


ISSUE DATES:


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DRAWING NUMBER

and Engineering, Inc.

C001



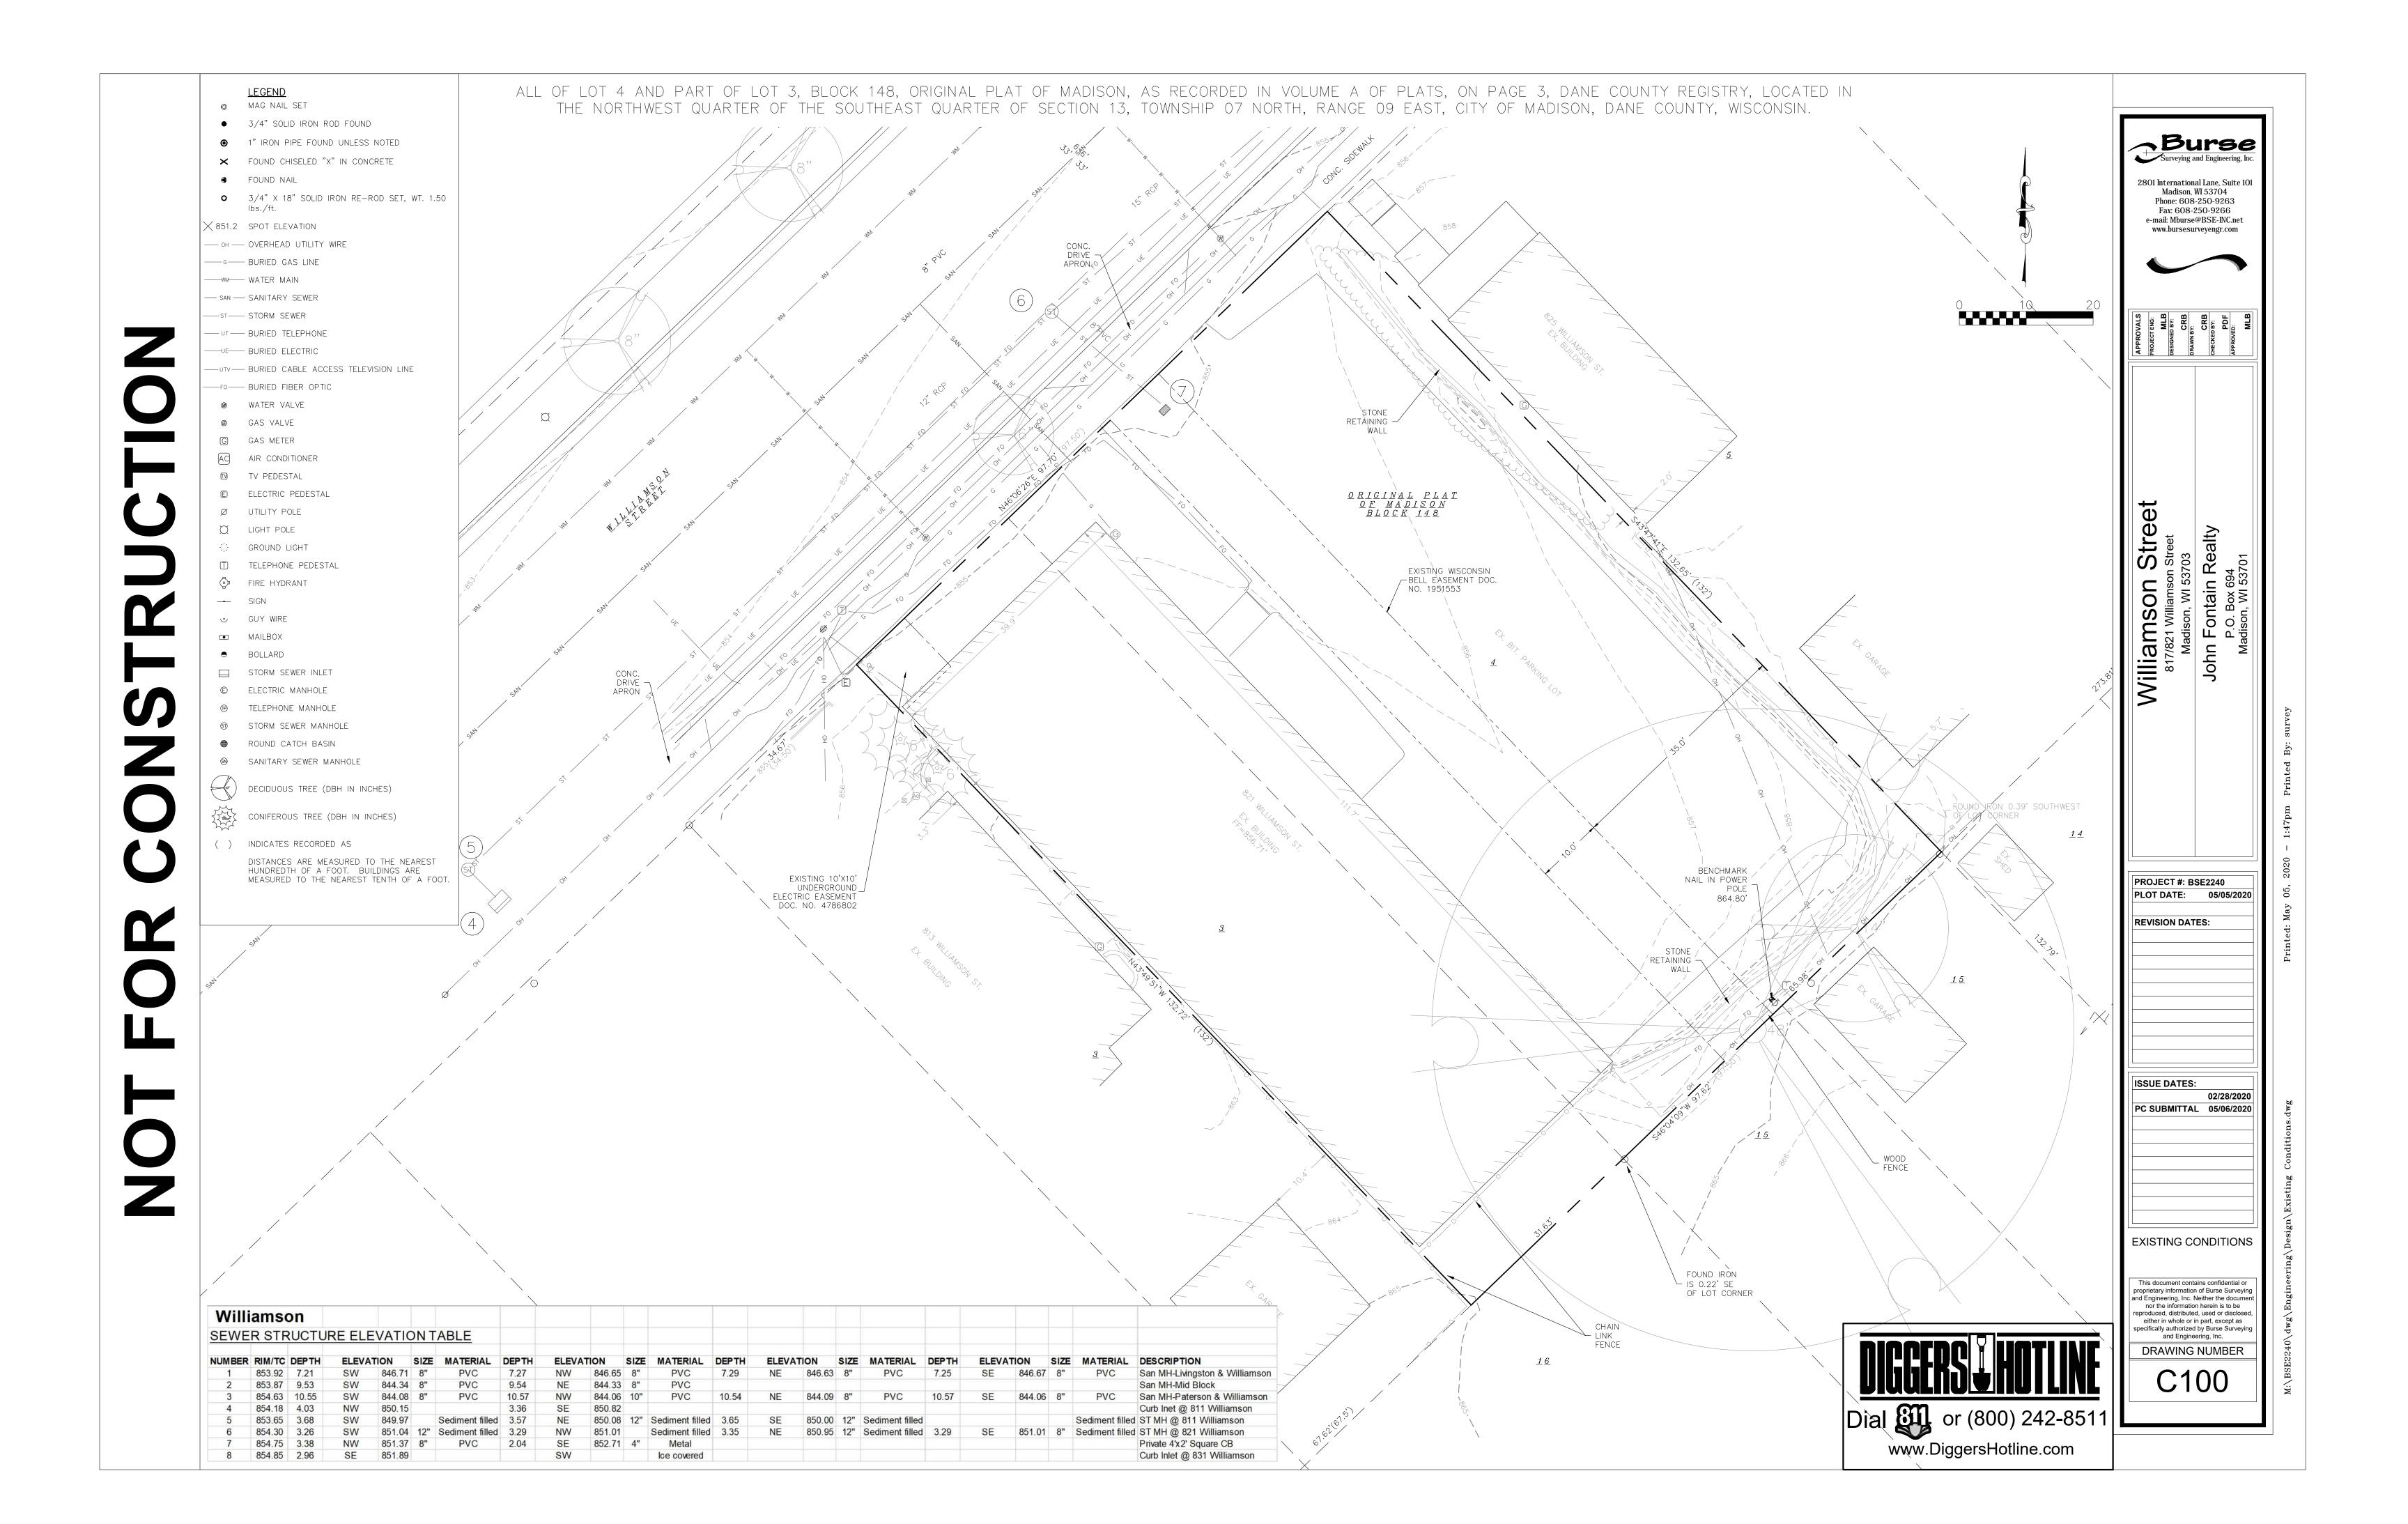

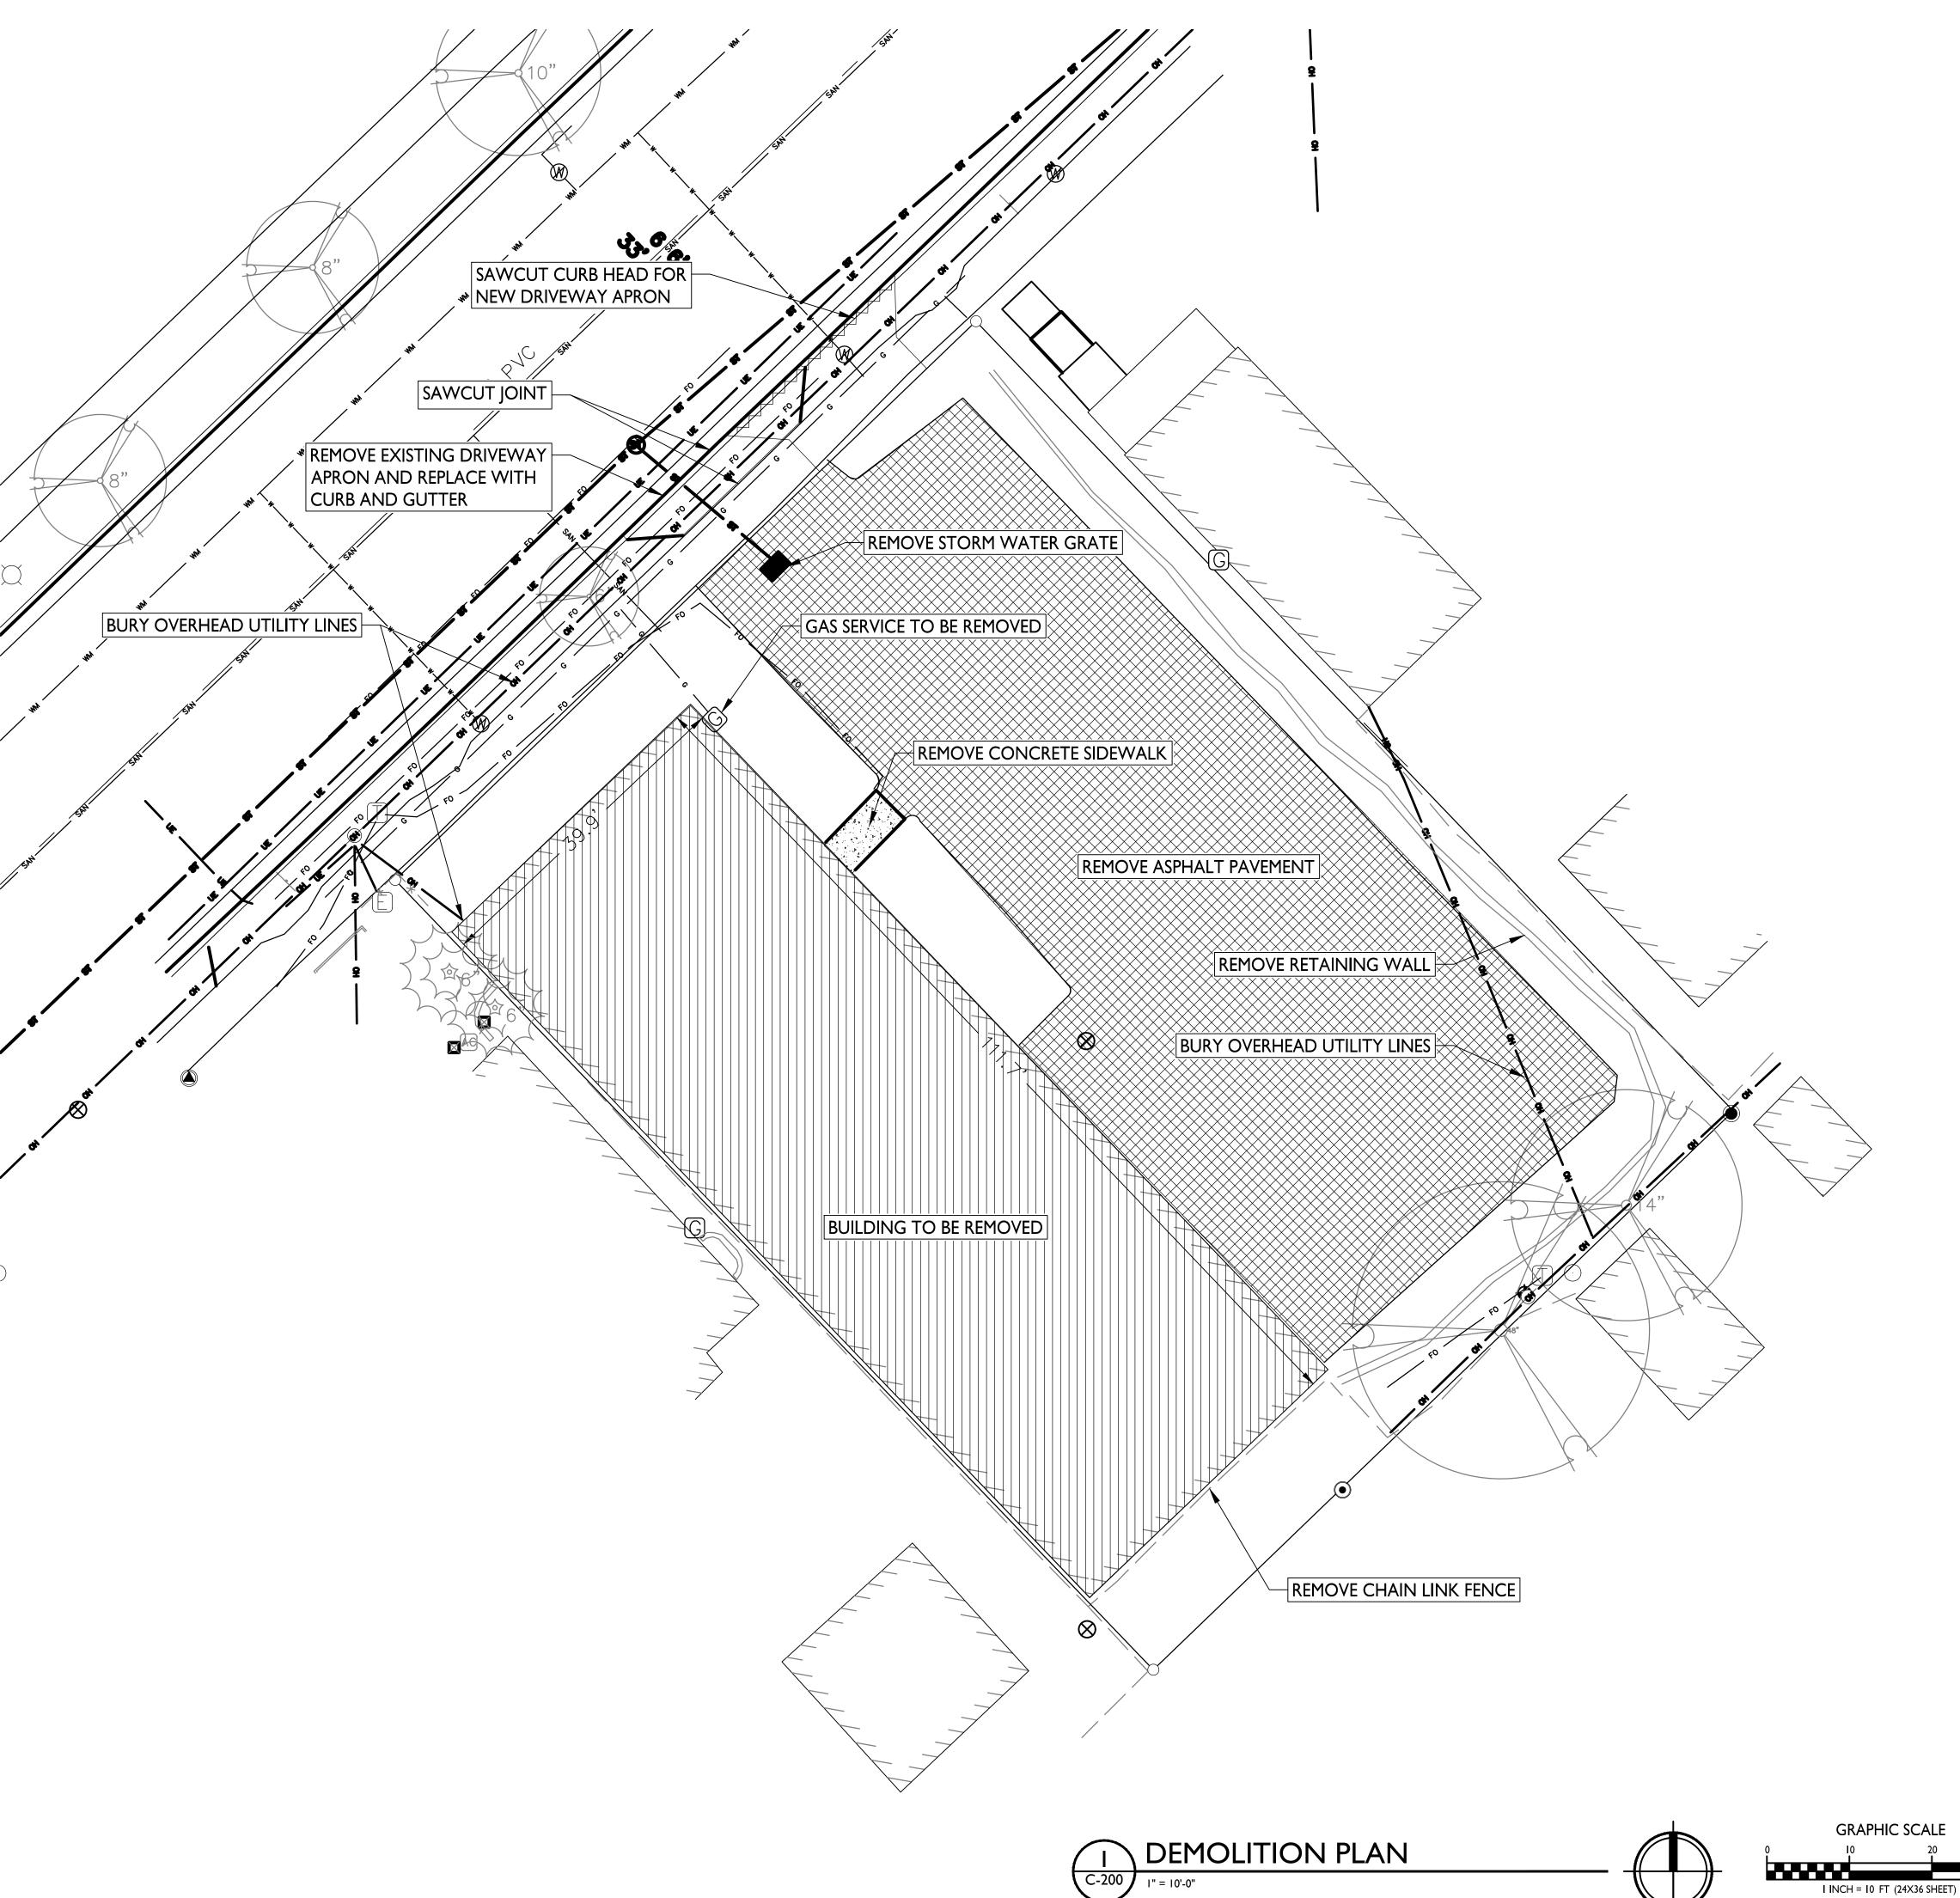

DEMOLITION PLAN LEGEND

CURB & GUTTER REMOVAL

CONCRETE REMOVAL

BUILDING REMOVAL

----- SAWCUT

UTILITY STRUCTURE REMOVAL

ST UTILITY LINE REMOVAL

TREE REMOVAL

Issued for Land Use Submittal - May 6, 2020

John Fontain
Development

817-821 Williamson St Madison, Wisconsin SHEET TITLE

Demolition Plan

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ONLY AND HAVE NOT BEEN INDEPENDENTLY VERIFIED BY THE OWNER OR ITS REPRESENTATIVE. THE CONTRACTOR SHALL BE RESPONSIBLE FOR

DETERMINING THE EXACT LOCATION OF ALL EXISTING UTILITIES WHETHER THEY ARE SHOWN ON

THESE PLANS OR NOT, BEFORE COMMENCING WORK,

AND SHALL BE FULLY RESPONSIBLE FOR ANY AND ALL

DAMAGES WHICH MIGHT BE CAUSED BY THE CONTRACTOR'S FAILURE TO EXACTLY LOCATE AND PRESERVE ANY AND ALL UTILITIES.

THE LOCATION OF EXISTING UTILITIES, BOTH UNDERGROUND AND OVERHEAD ARE APPROXIMATE


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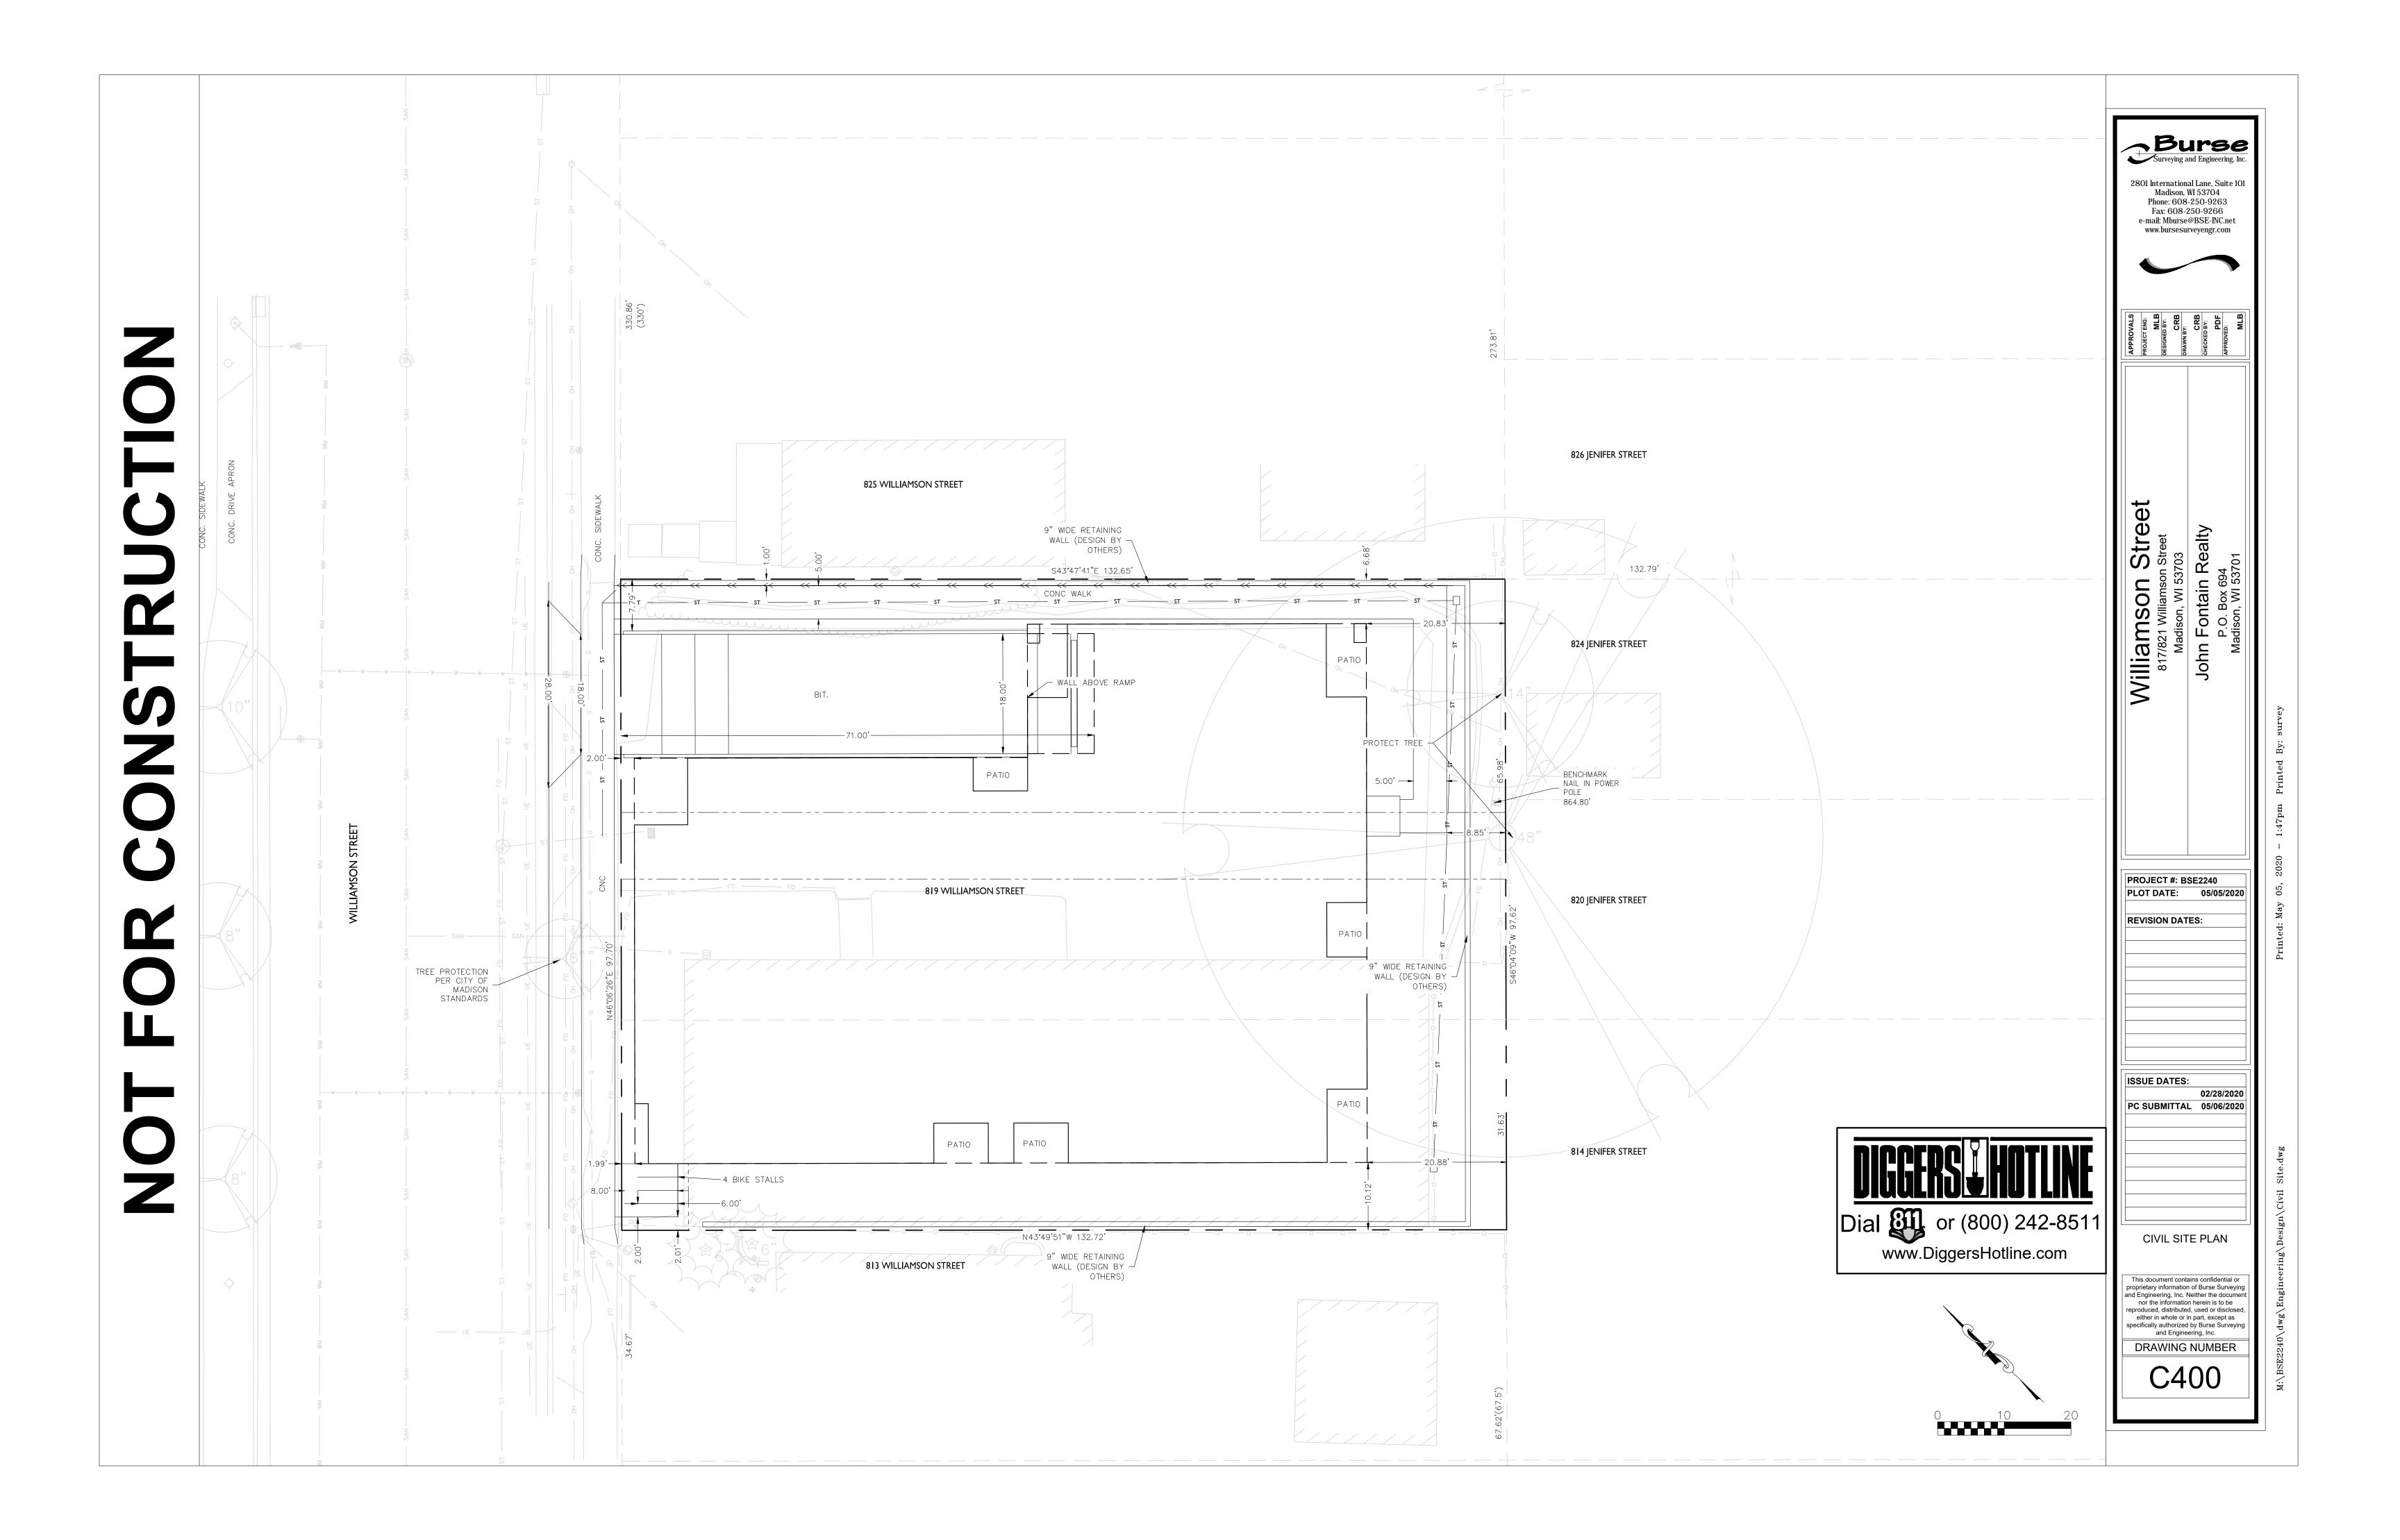
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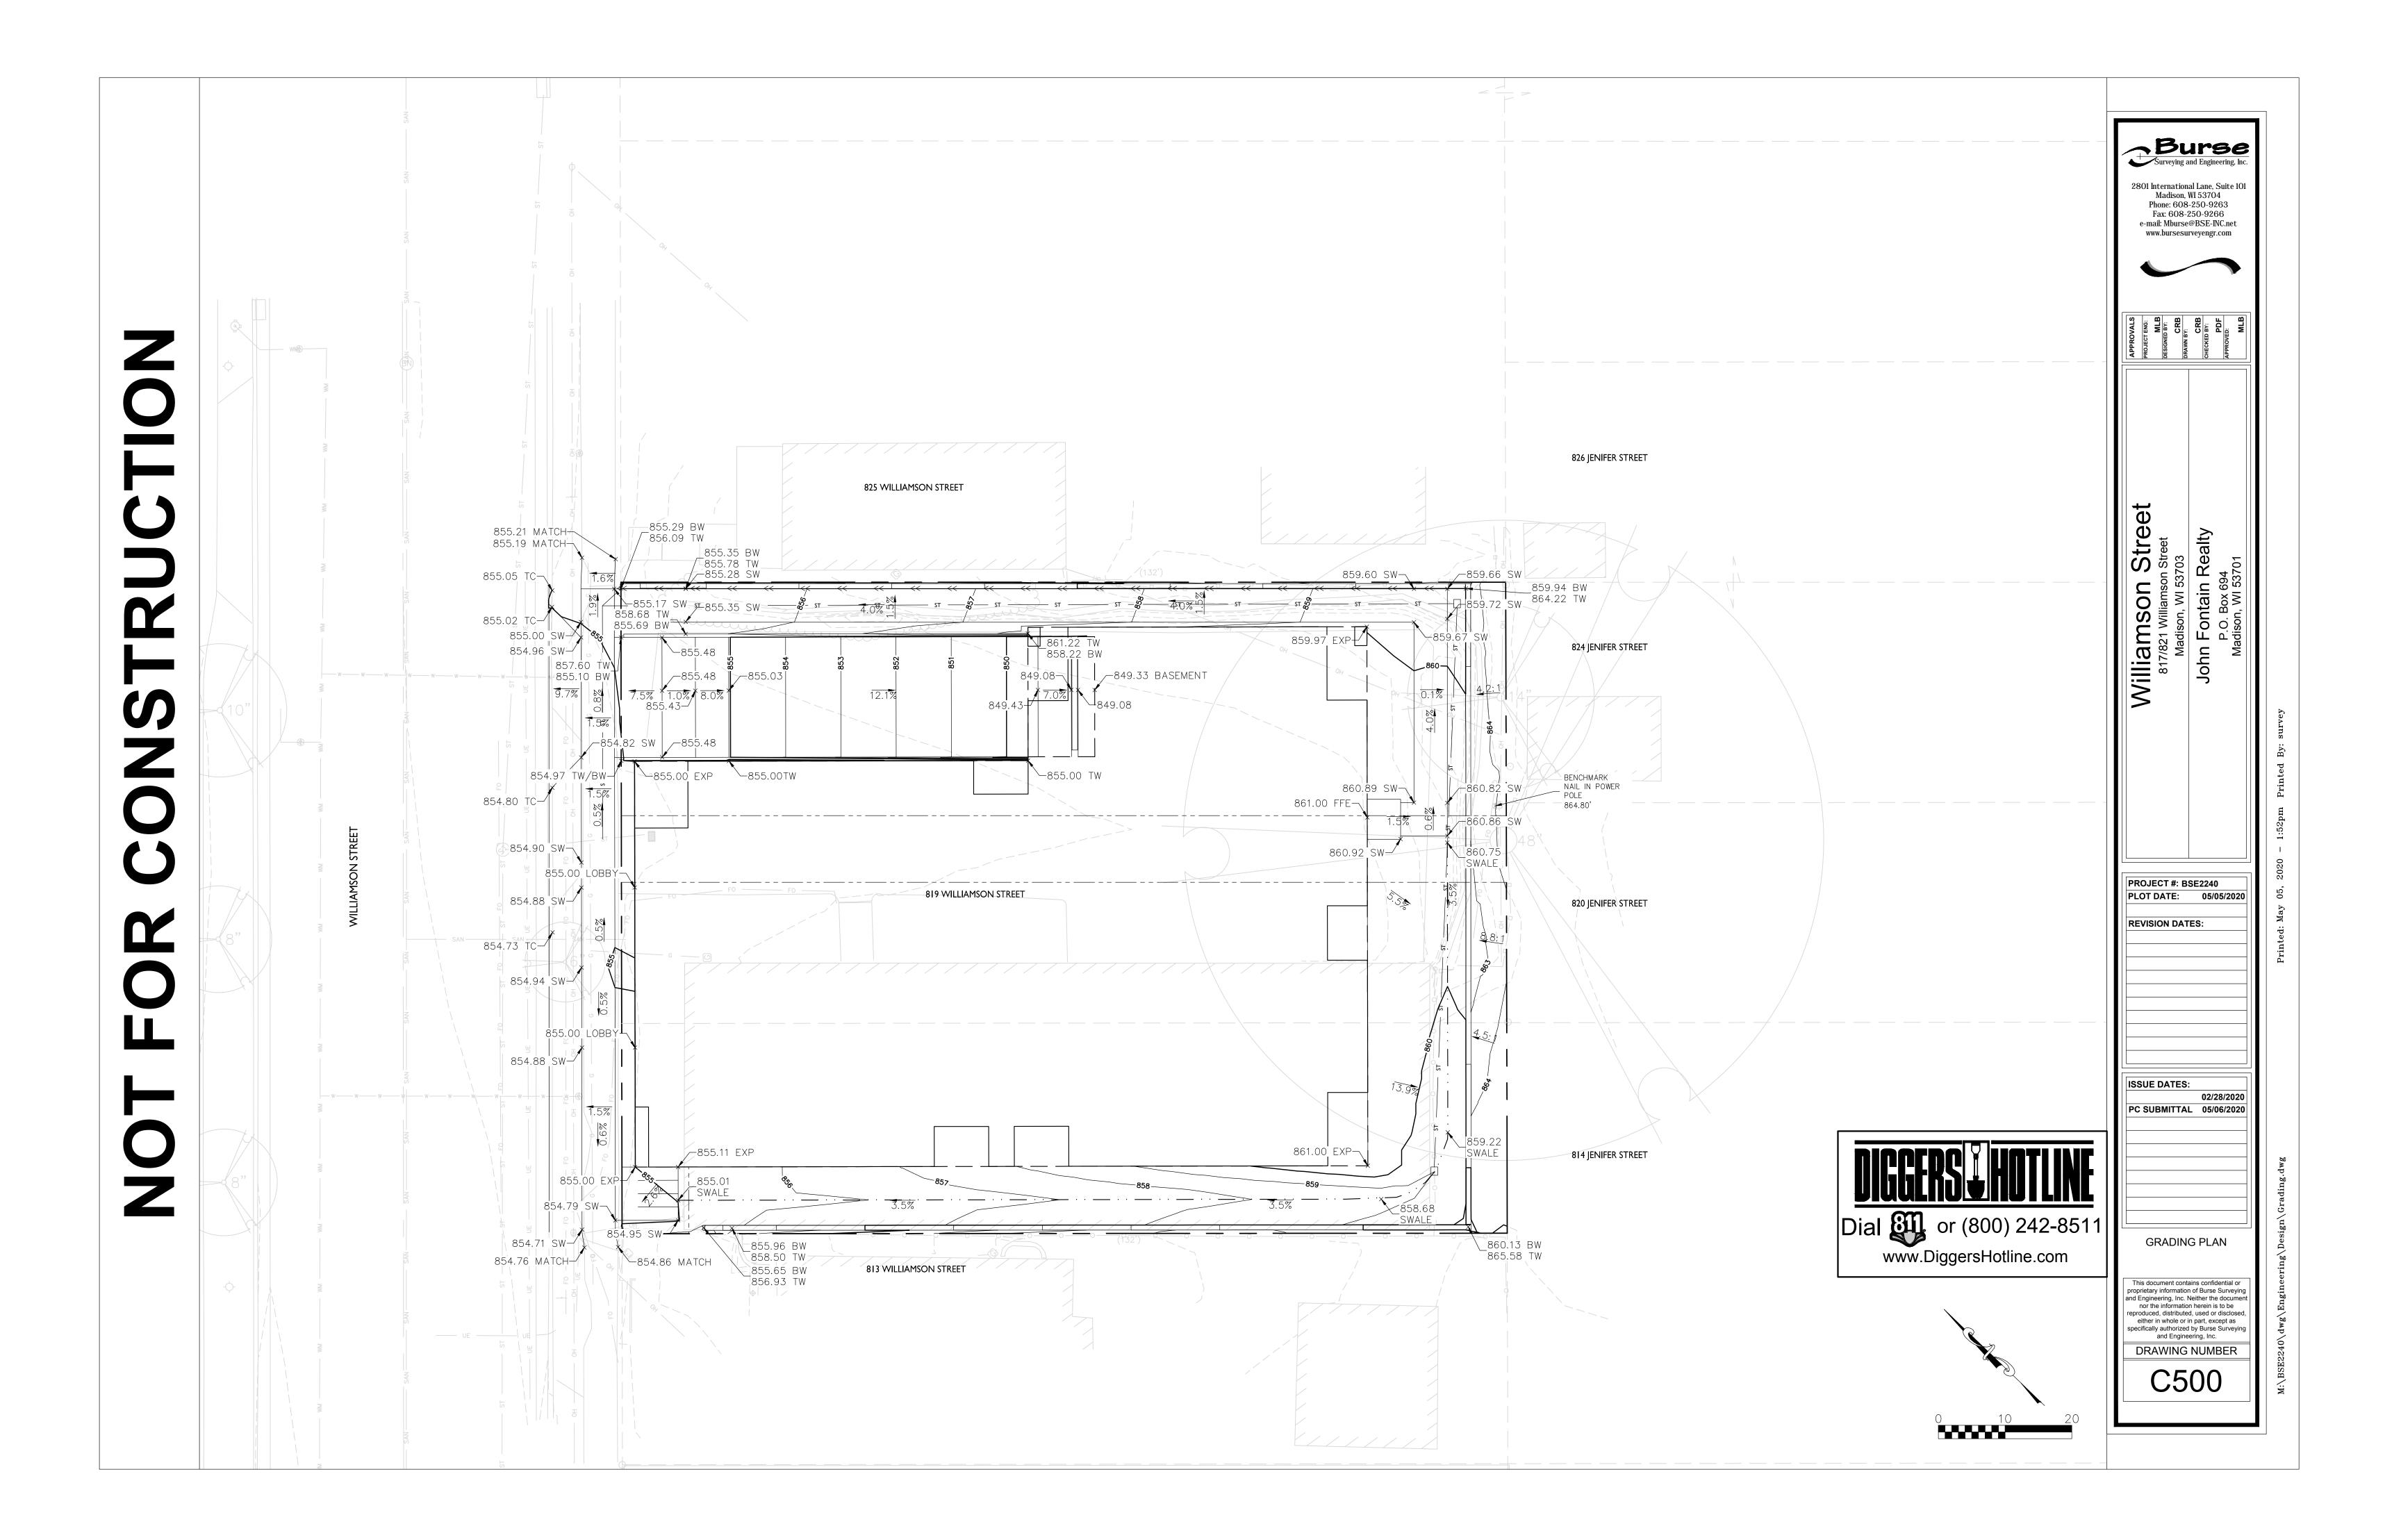
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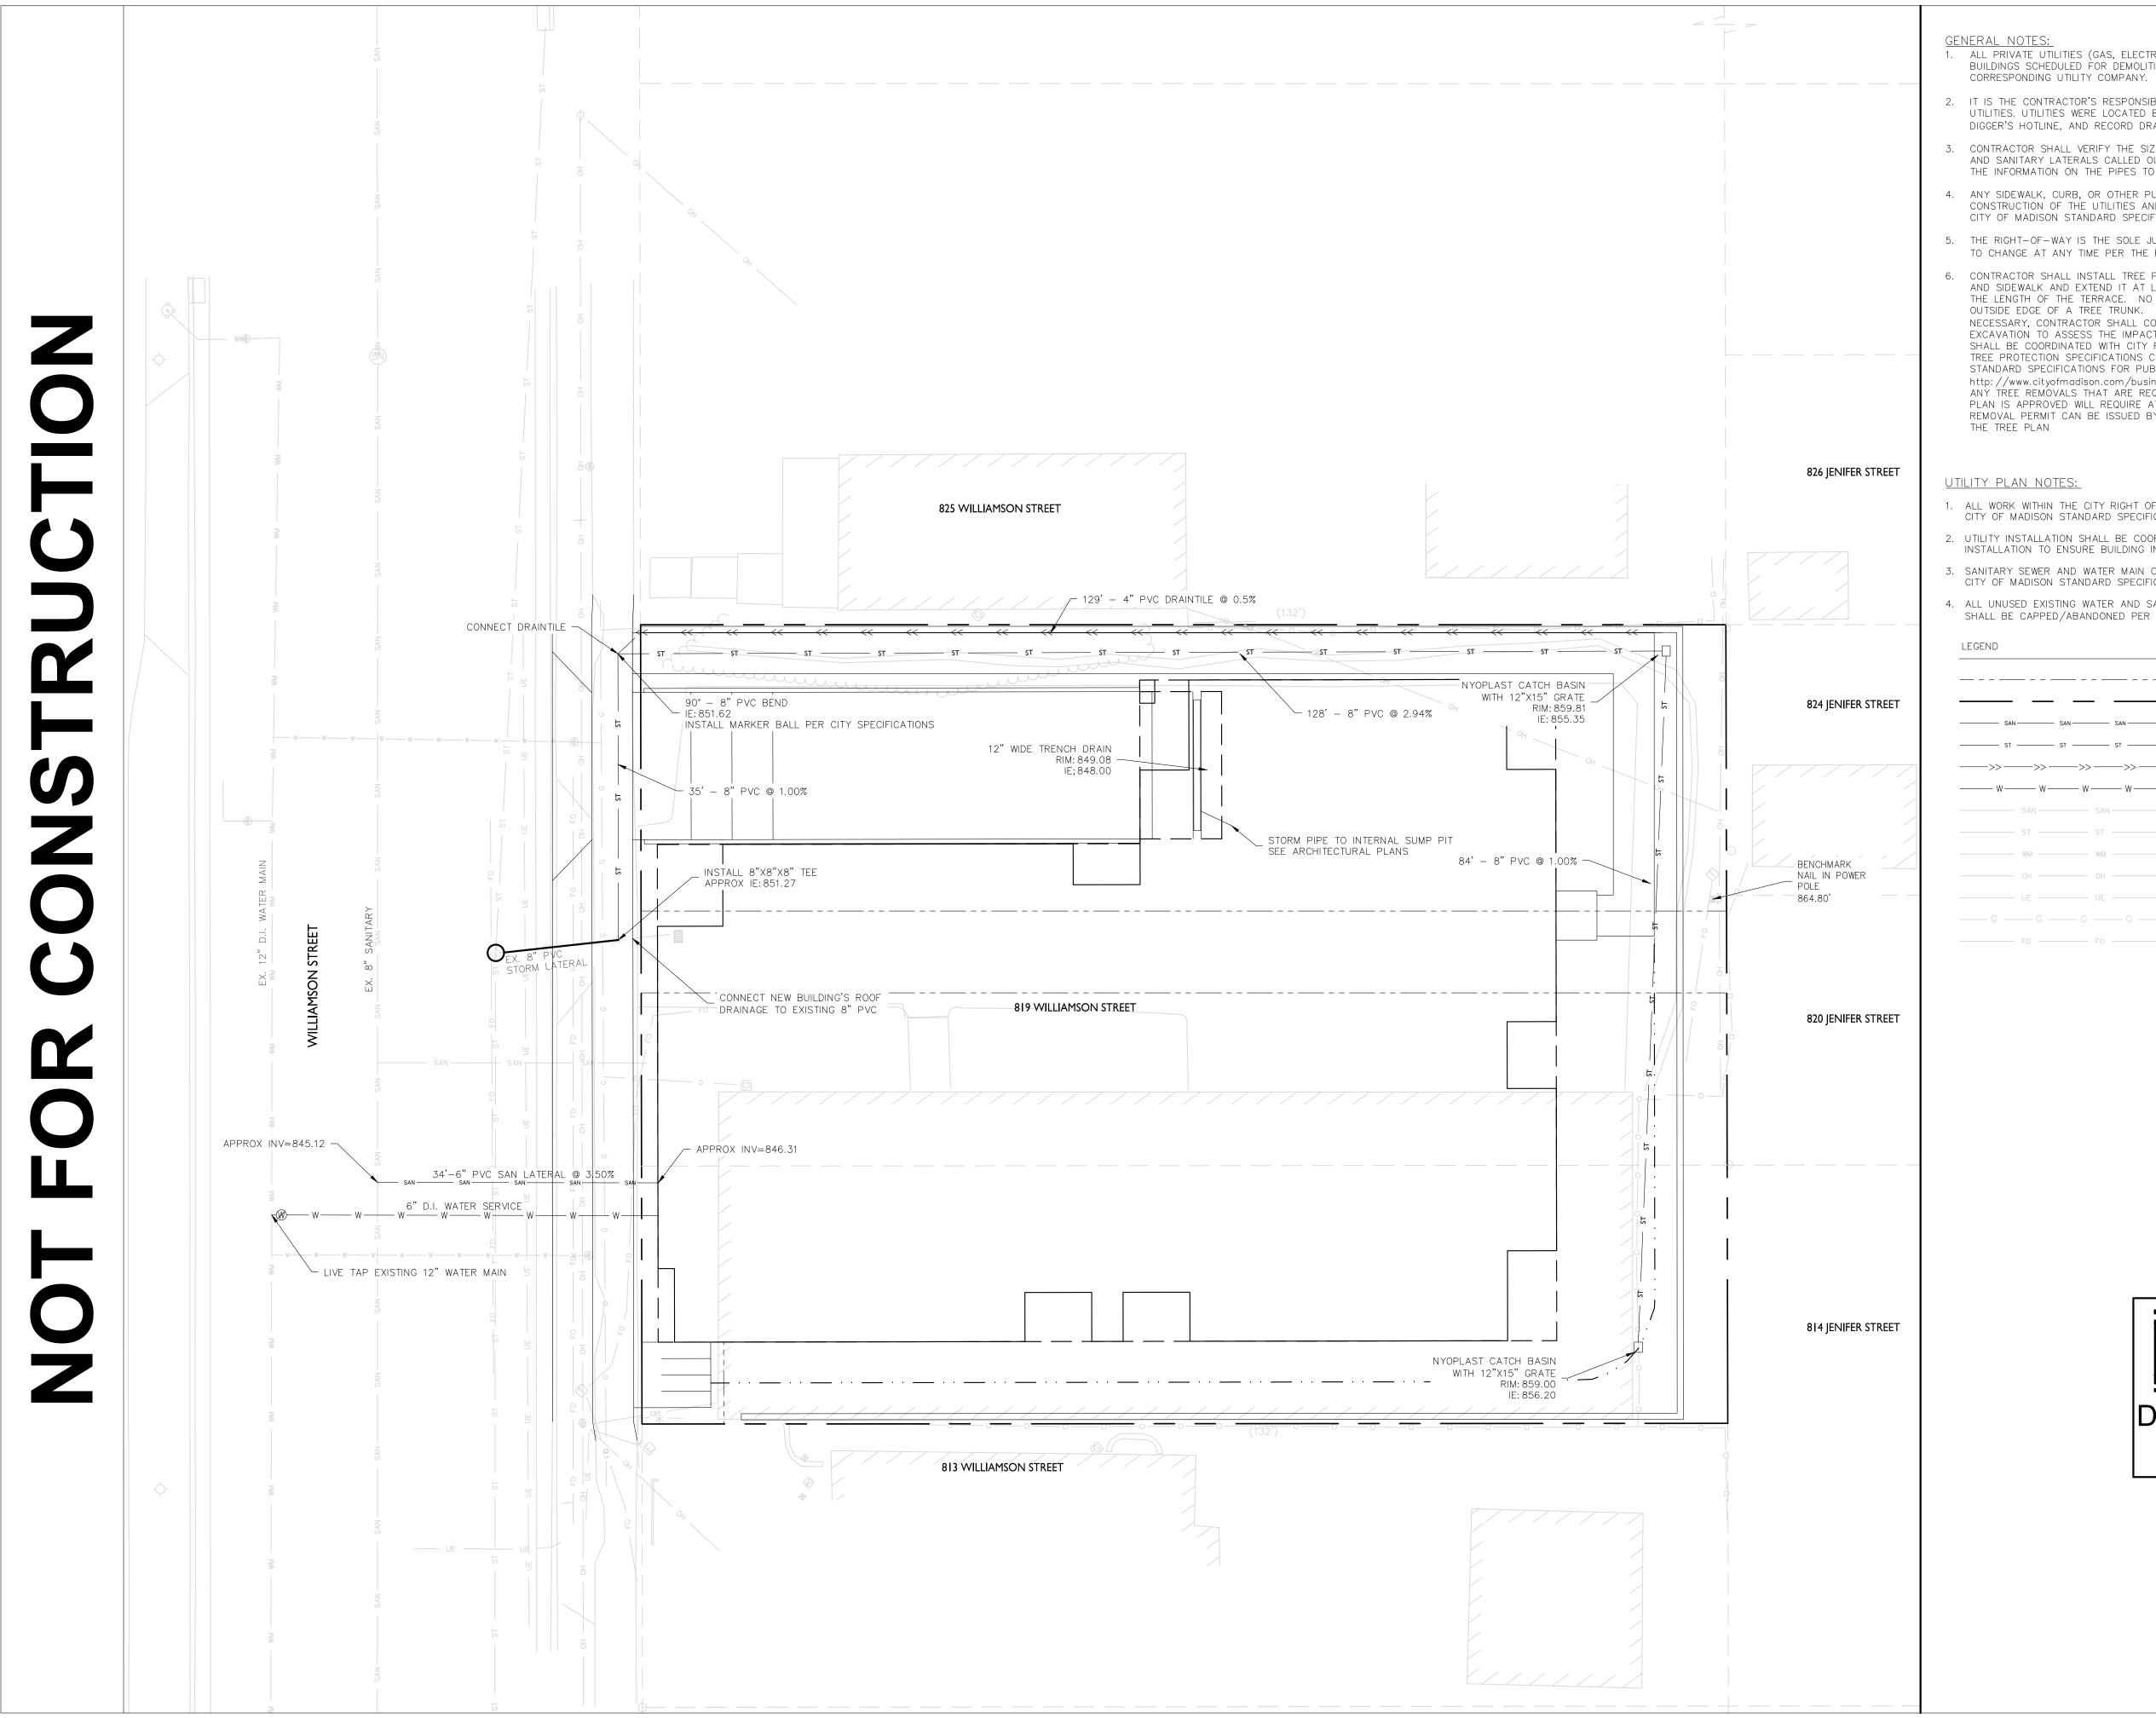
PROJECT NO.

2003







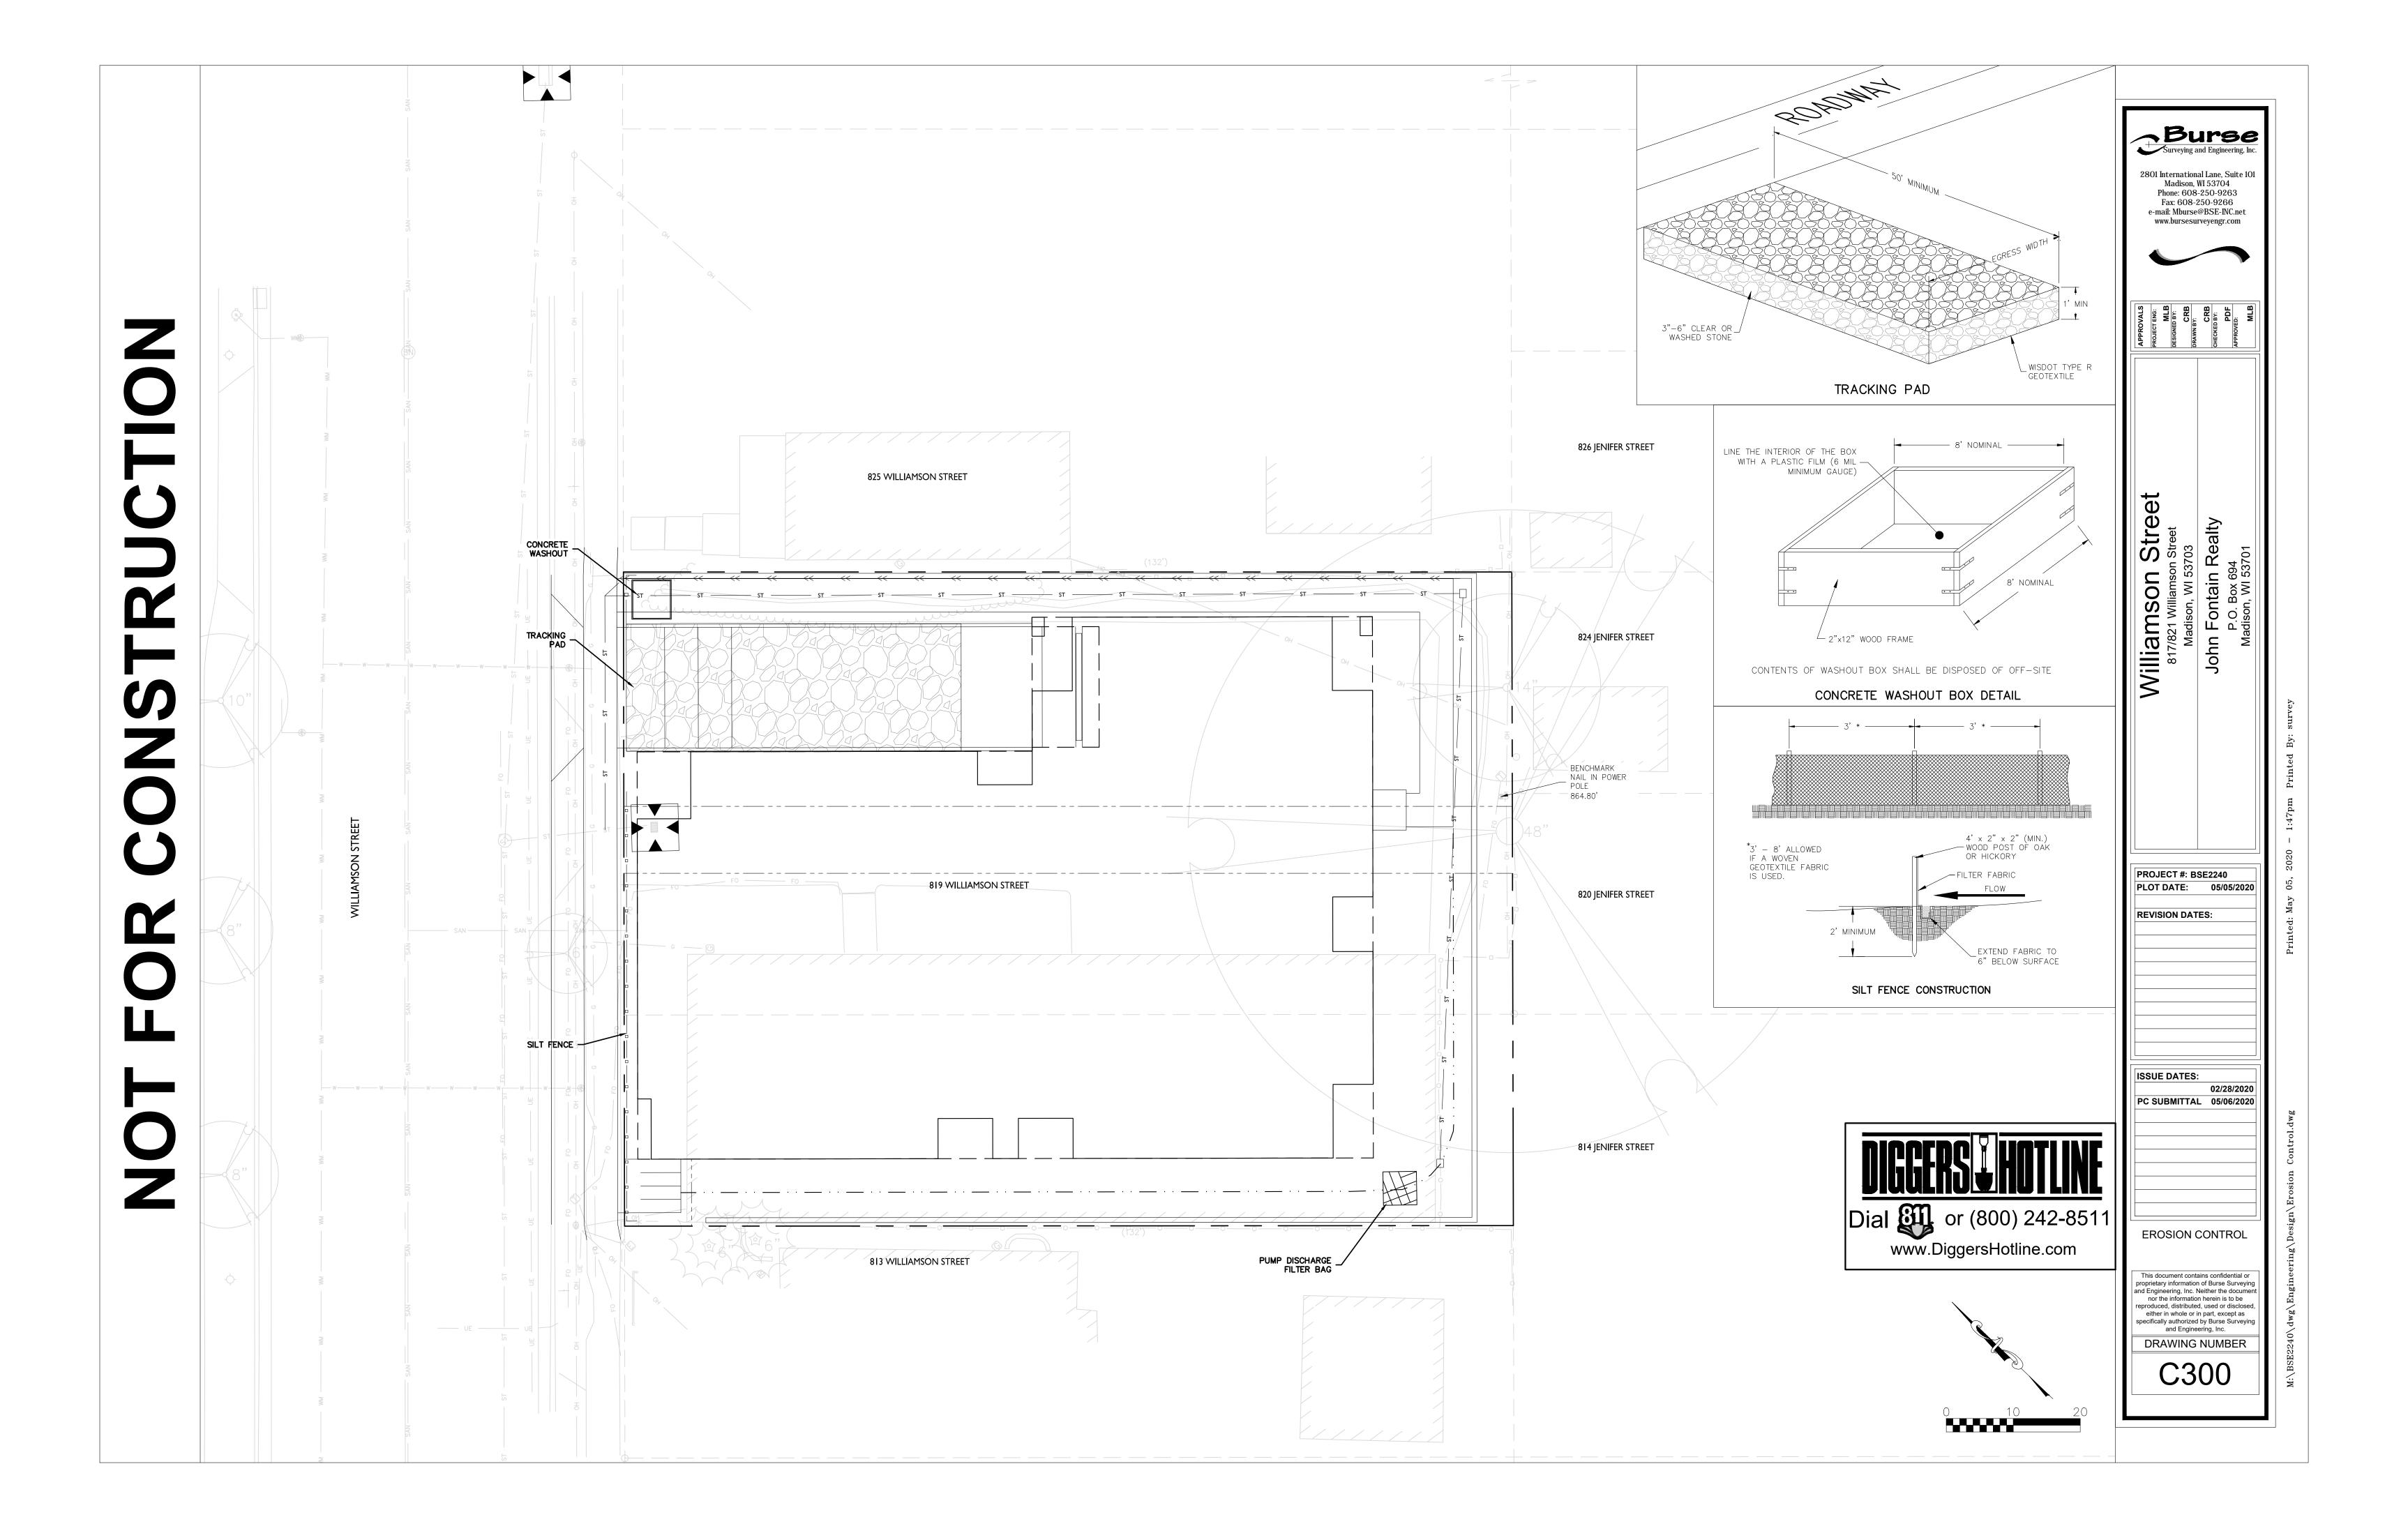

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- 1. ALL WORK WITHIN THE CITY RIGHT OF WAY AND EASEMENTS SHALL BE COMPLIANT WITH THE CITY OF MADISON STANDARD SPECIFICATIONS CURRENT AT THE TIME OF CONSTRUCTION.
- 2. UTILITY INSTALLATION SHALL BE COORDINATED WITH ENGINEER AT LEAST 4 WEEKS PRIOR TO INSTALLATION TO ENSURE BUILDING INSPECTION APPROVAL IS OBTAINED.
- 3. SANITARY SEWER AND WATER MAIN CONSTRUCTION AND MATERIALS SHALL CONFORM WITH THE CITY OF MADISON STANDARD SPECIFICATIONS.

ALL UNUSED EXIST	ING WATER AND S	Sanitary laterals si	ERVING THE SUBJECT PROPERTY
SHALL BE CAPPED	/ABANDONED PER	THE CITY OF MADISO	N STANDARD SPECIFICATIONS.

				 EXISTING EASEMENT
				 PROPERTY BOUNDARY
— SAN		SAN —	— SAN ——	 PROPOSED SANITARY SEWER
— sт -		ST	— st ——	 PROPOSED STORM SEWER
>>	>>-	>>	>> -	 PROPOSED DRAINTILE
- W	—— w —	w	—— W —	 PROPOSED WATER LATERAL
	SAN	SA	N	EXISTING SANITARY SEWER
	ST —	ST		EXISTING STORM SEWER
	WM	WN	Λ	EXISTING WATER MAIN
	он —	OH	-	EXISTING OVERHEAD FACILITY
	UE	UE		EXISTING UNDERGROUND ELECTRIC
G —	— G –	—— G —	— G –	EXISTING BURIED GAS
	FO	FC	) ———	EXISTING FIBER OPTIC

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Willia 817

PROJECT #: BSE2240 PLOT DATE: 05/05/2020

**REVISION DATES:** 


ISSUE DATES: 02/28/2020

PC SUBMITTAL 05/06/2020

UTILITY PLAN

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DRAWING NUMBER C600

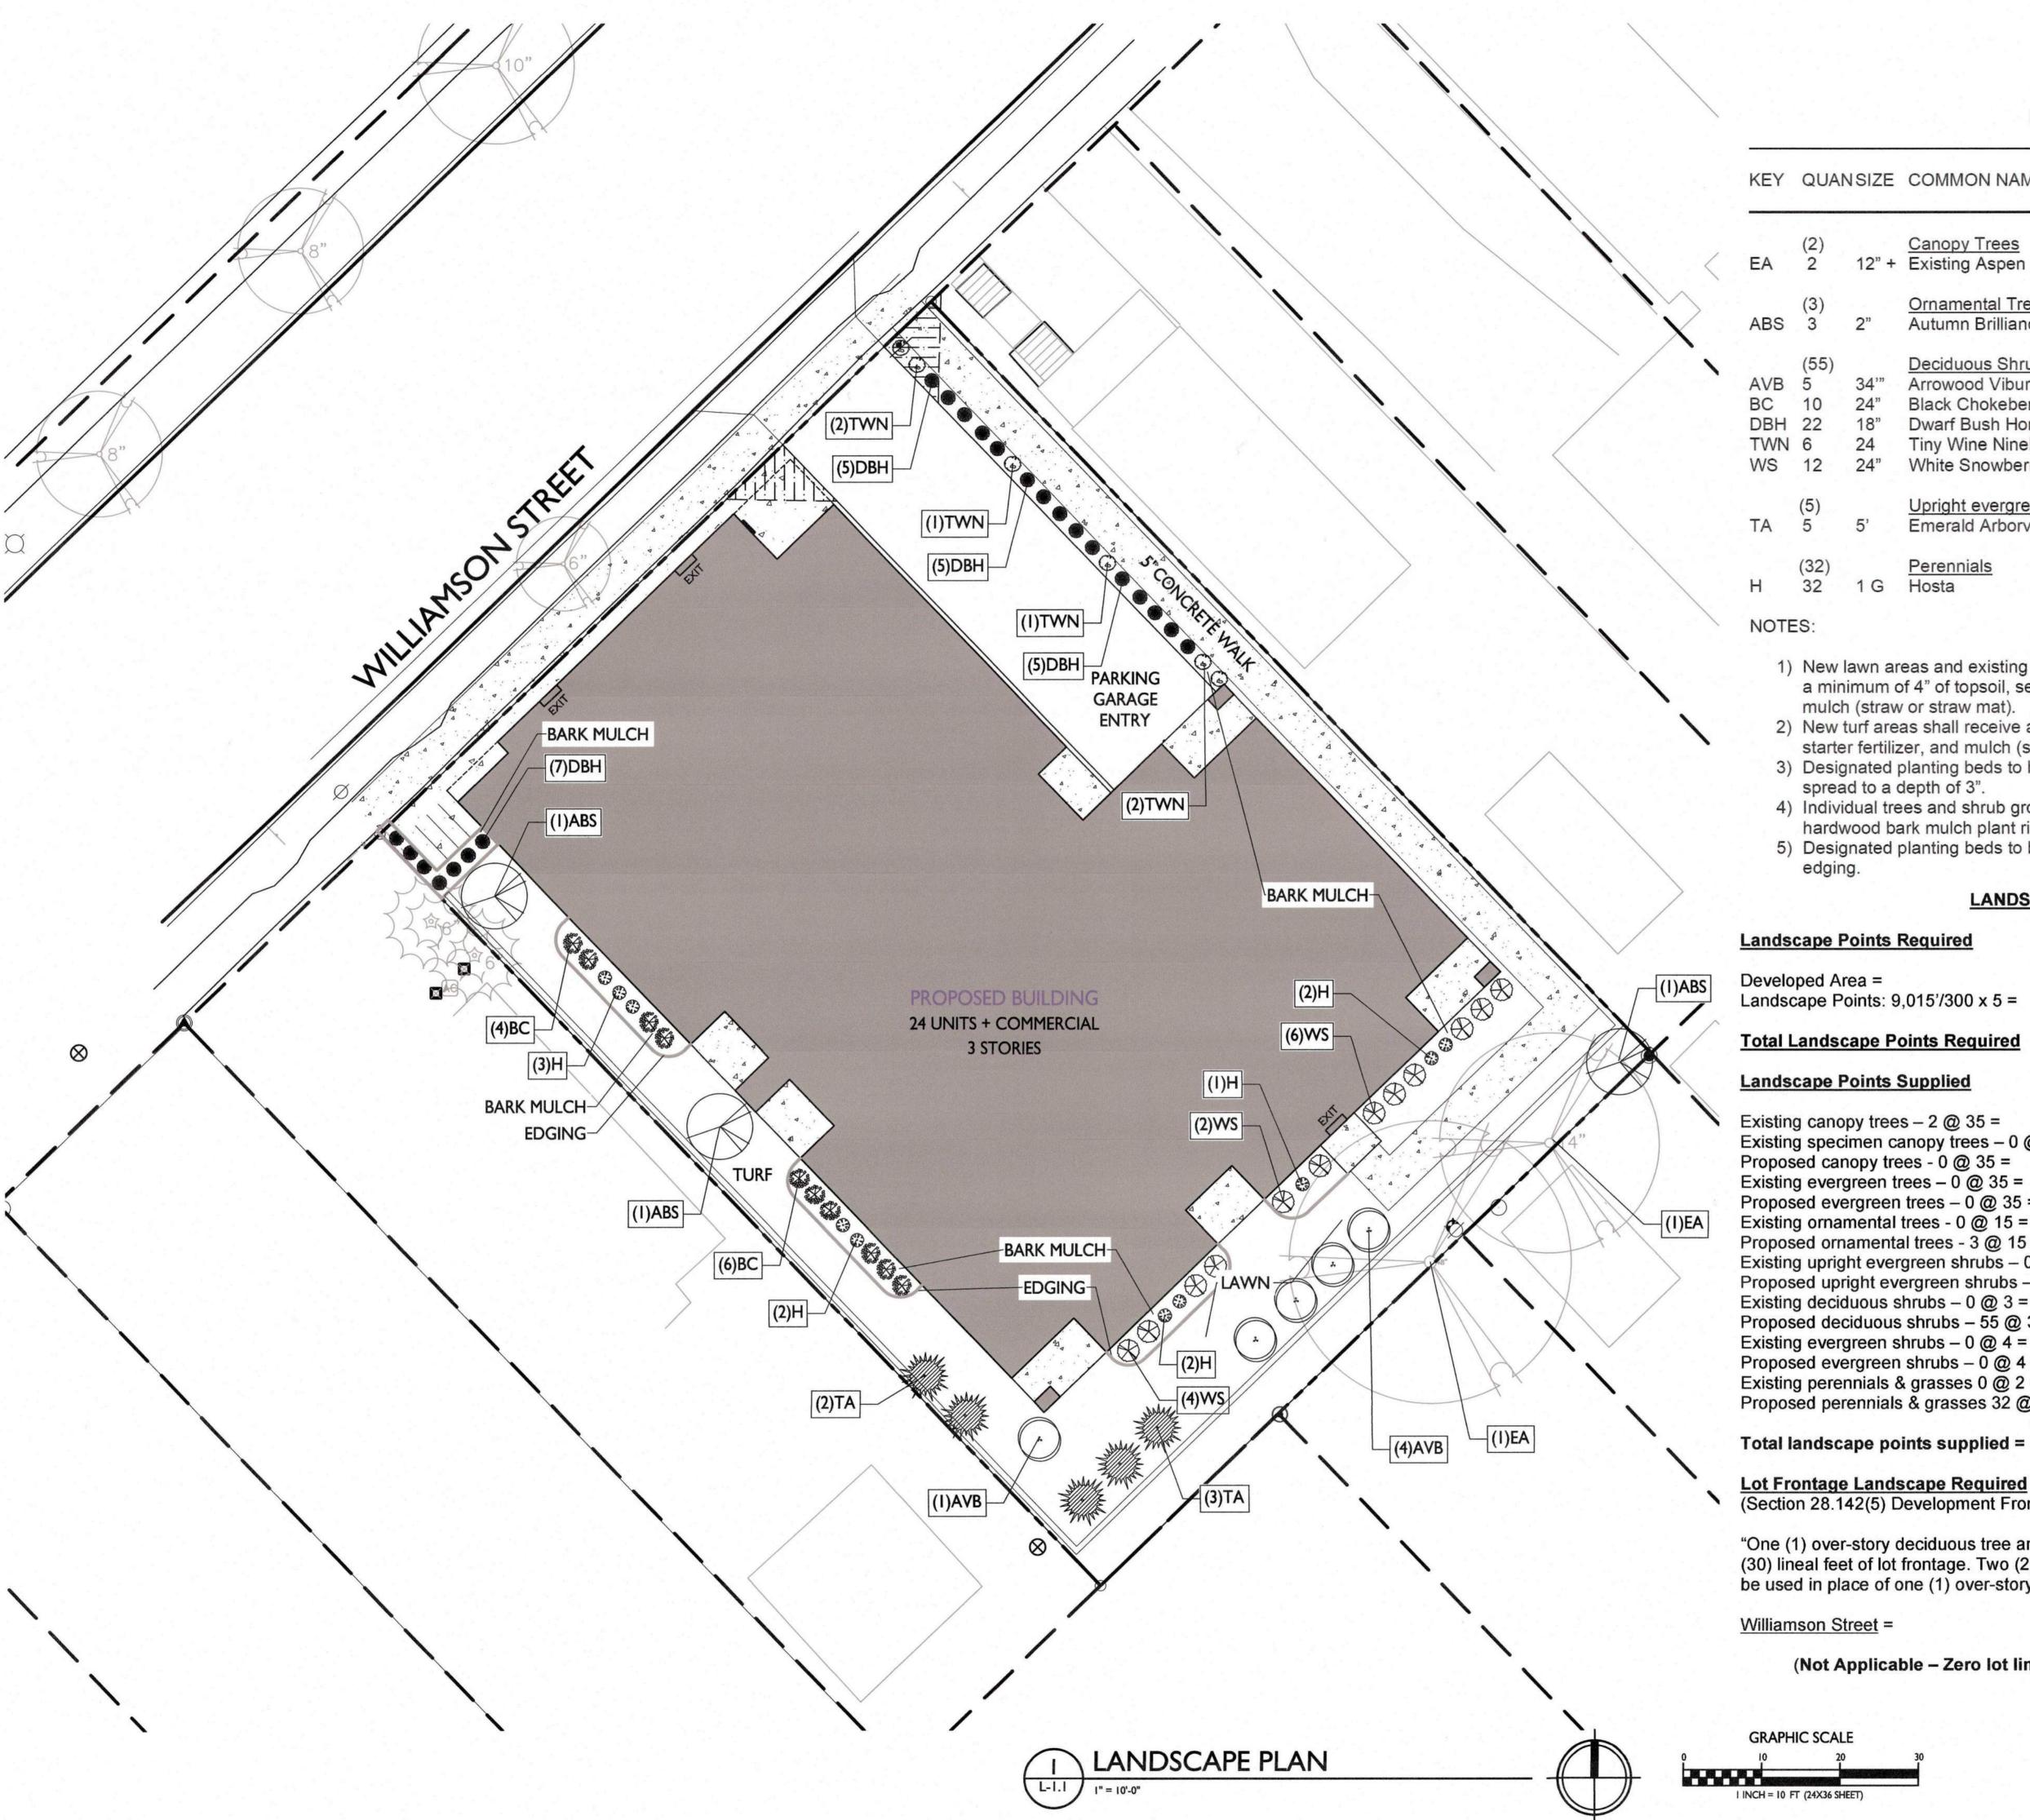

# **PLANT LIST**

				and the second s
KEY	QUAN	ISIZE	COMMON NAME	ROOT
	(2)		Canopy Trees	
EA	2	12" +	Existing Aspen	EX
	(3)		Ornamental Trees	
ABS	3	2"	Autumn Brilliance Serviceberry	BB
	(55)		Deciduous Shrubs	
AVB	5	34"	Arrowood Viburnum	BB
ВС	10	24"	Black Chokeberry	Pot
DBH	22	18"	Dwarf Bush Honeysuckle	Pot
TWN	6	24	Tiny Wine Ninebark	Pot
WS	12	24"	White Snowberry	Pot
	(5)		Upright evergreen Shrubs	
TA	5	5'	Emerald Arborvitae	ВВ
	(32)		Perennials	
Н	32	1 G	Hosta	BB

# ARCHITECTS

Issued for Land Use Submittal - May 6, 2020

# NOTES:

- 1) New lawn areas and existing lawn areas disturbed by construction shall receive a minimum of 4" of topsoil, seed (Madison Parks mix), starter fertilizer, and mulch (straw or straw mat).
- 2) New turf areas shall receive a minimum of 4" of topsoil, seed (no mow turf mix), starter fertilizer, and mulch (straw or straw mat).
- 3) Designated planting beds to be mulched with #2 shredded hardwood bark spread to a depth of 3".
- 4) Individual trees and shrub groupings in lawn areas to receive shredded hardwood bark mulch plant rings (4' diameter) spread to a depth of 3"
- 5) Designated planting beds to be separated from lawn areas with 5" black vinyl

# LANDSCAPE WORKSHEET

# **Landscape Points Required**

Developed Area =	9,015 SF
Landscape Points: 9,015'/300 x 5 =	150 points
Total Landscape Points Required	<u>150 points</u>

# **Landscape Points Supplied**

Existing canopy trees – 2 @ 35 =	70 points
Existing specimen canopy trees – 0 @ 200 =	0 points
Proposed canopy trees - 0 @ 35 =	0 points
Existing evergreen trees – 0 @ 35 =	0 points
Proposed evergreen trees – 0 @ 35 =	0 points
Existing ornamental trees - 0 @ 15 =	0 points
Proposed ornamental trees - 3 @ 15 =	45 points
Existing upright evergreen shrubs – 0 @ 10 =	0 points
Proposed upright evergreen shrubs – 5 @ 10 =	50 points
Existing deciduous shrubs – 0 @ 3 =	0 points
Proposed deciduous shrubs – 55 @ 3 =	165 points
Existing evergreen shrubs – 0 @ 4 =	0 points
Proposed evergreen shrubs – 0 @ 4 =	0 points
Existing perennials & grasses 0 @ 2 =	0 points
Proposed perennials & grasses 32 @ 2 =	64 points
Total landscape points supplied =	394 points

Lot Frontage Landscape Required
(Section 28.142(5) Development Frontage Landscaping)

"One (1) over-story deciduous tree and five (5) shrubs shall be planted for each thirty (30) lineal feet of lot frontage. Two (2) ornamental trees or two (2) evergreen trees may be used in place of one (1) over-story deciduous tree."

Williamson Street =

98 LF

(Not Applicable - Zero lot line - no planting areas along lot frontage.)

**GRAPHIC SCALE** I INCH = 10 FT (24X36 SHEET)

John Fontain Development

PROJECT TITLE




817-821 Williamson St Madison, Wisconsin

Landscape Plan

SHEET NUMBER

PROJECT NO.

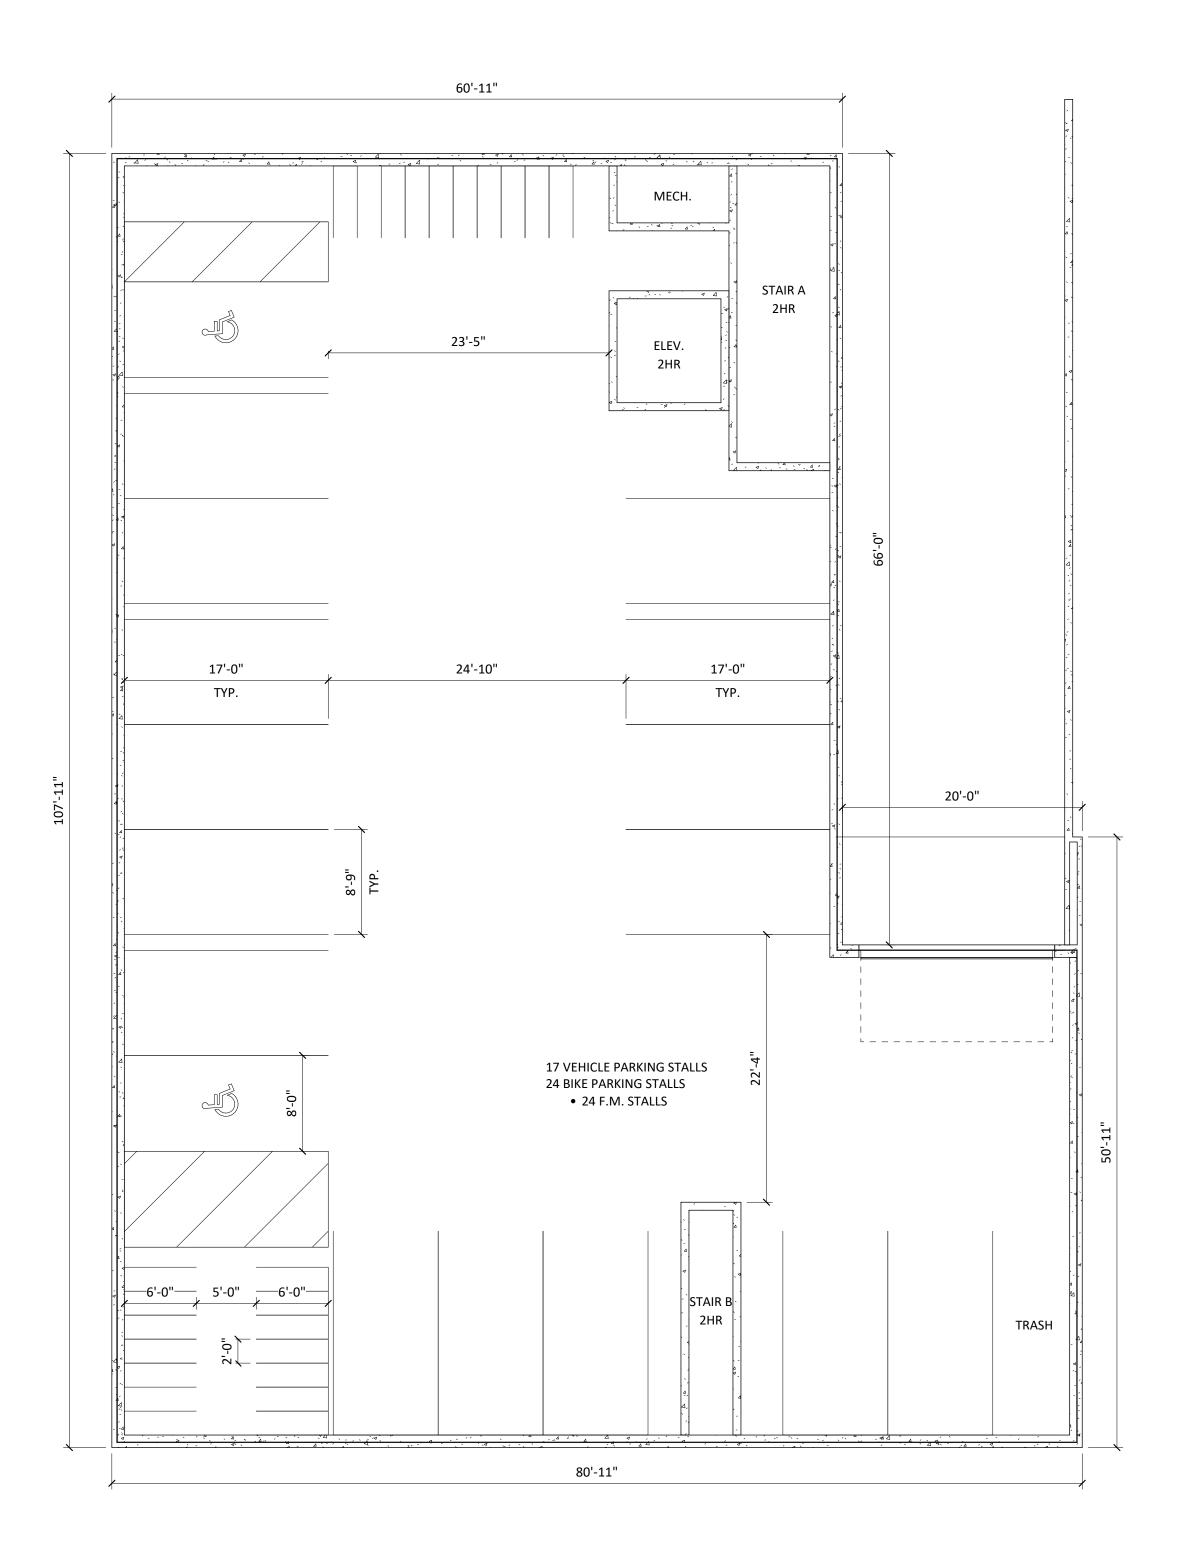

1 BASEMENT FLOOR PLAN
A-1.0 1/8" = 1'-0"

knothe bruce

A R C H I T E C T S

knothebruce.com 608.836.3690
7601 University Ave. Suite 201 Middleton, WI 53562

KEY PLAN

ISSUED Issued for Landmarks - August 04, 2020

PROJECT TITLE

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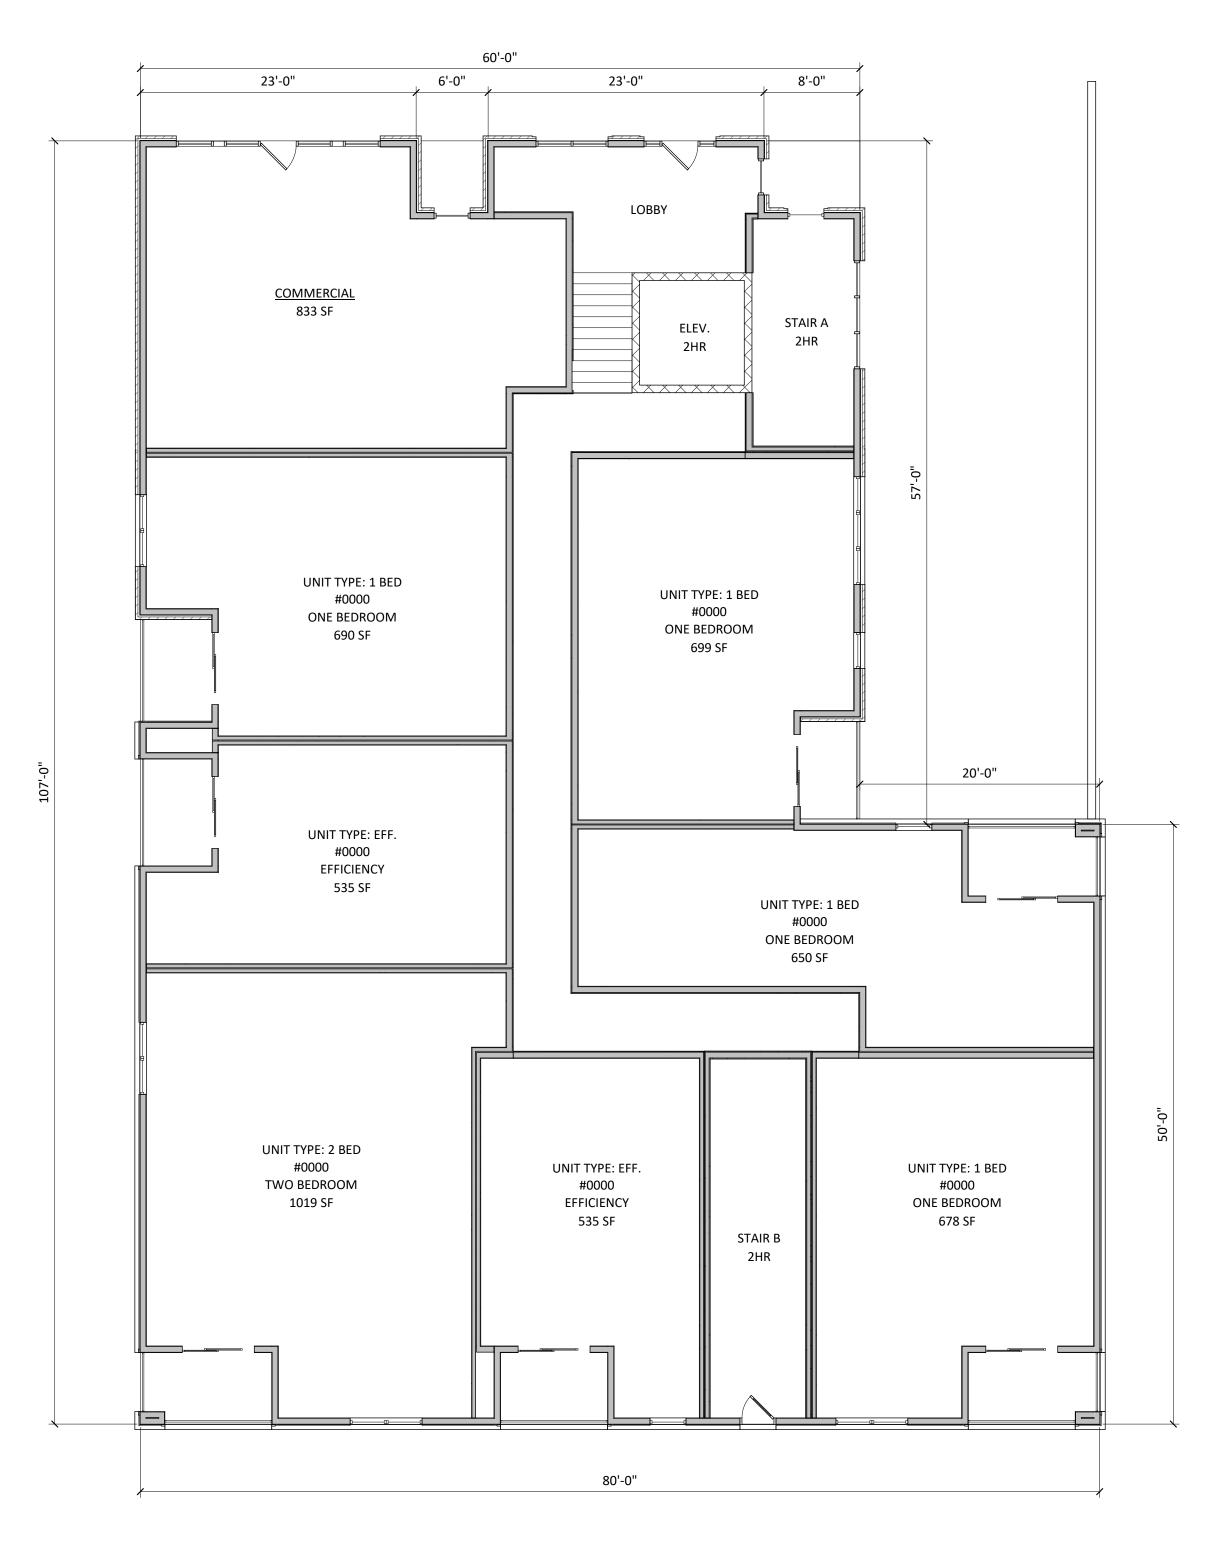
817-821 Williamson Street, Madison Wisconsin

BASEMENT FLOOR PLAN

SHEET NUMBER

A-1.0

PROJECT NUMBER 2003



1 FIRST FLOOR PLAN
A-1.1 1/8" = 1'-0"

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ARCHITECTS

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608.836.3690
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PROJECT TITLE


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SHEET TITLE
FIRST FLOOR
PLAN

SHEET NUMBER

A-1.1



1 SECOND FLOOR PLAN
A-1.2 1/8" = 1'-0"

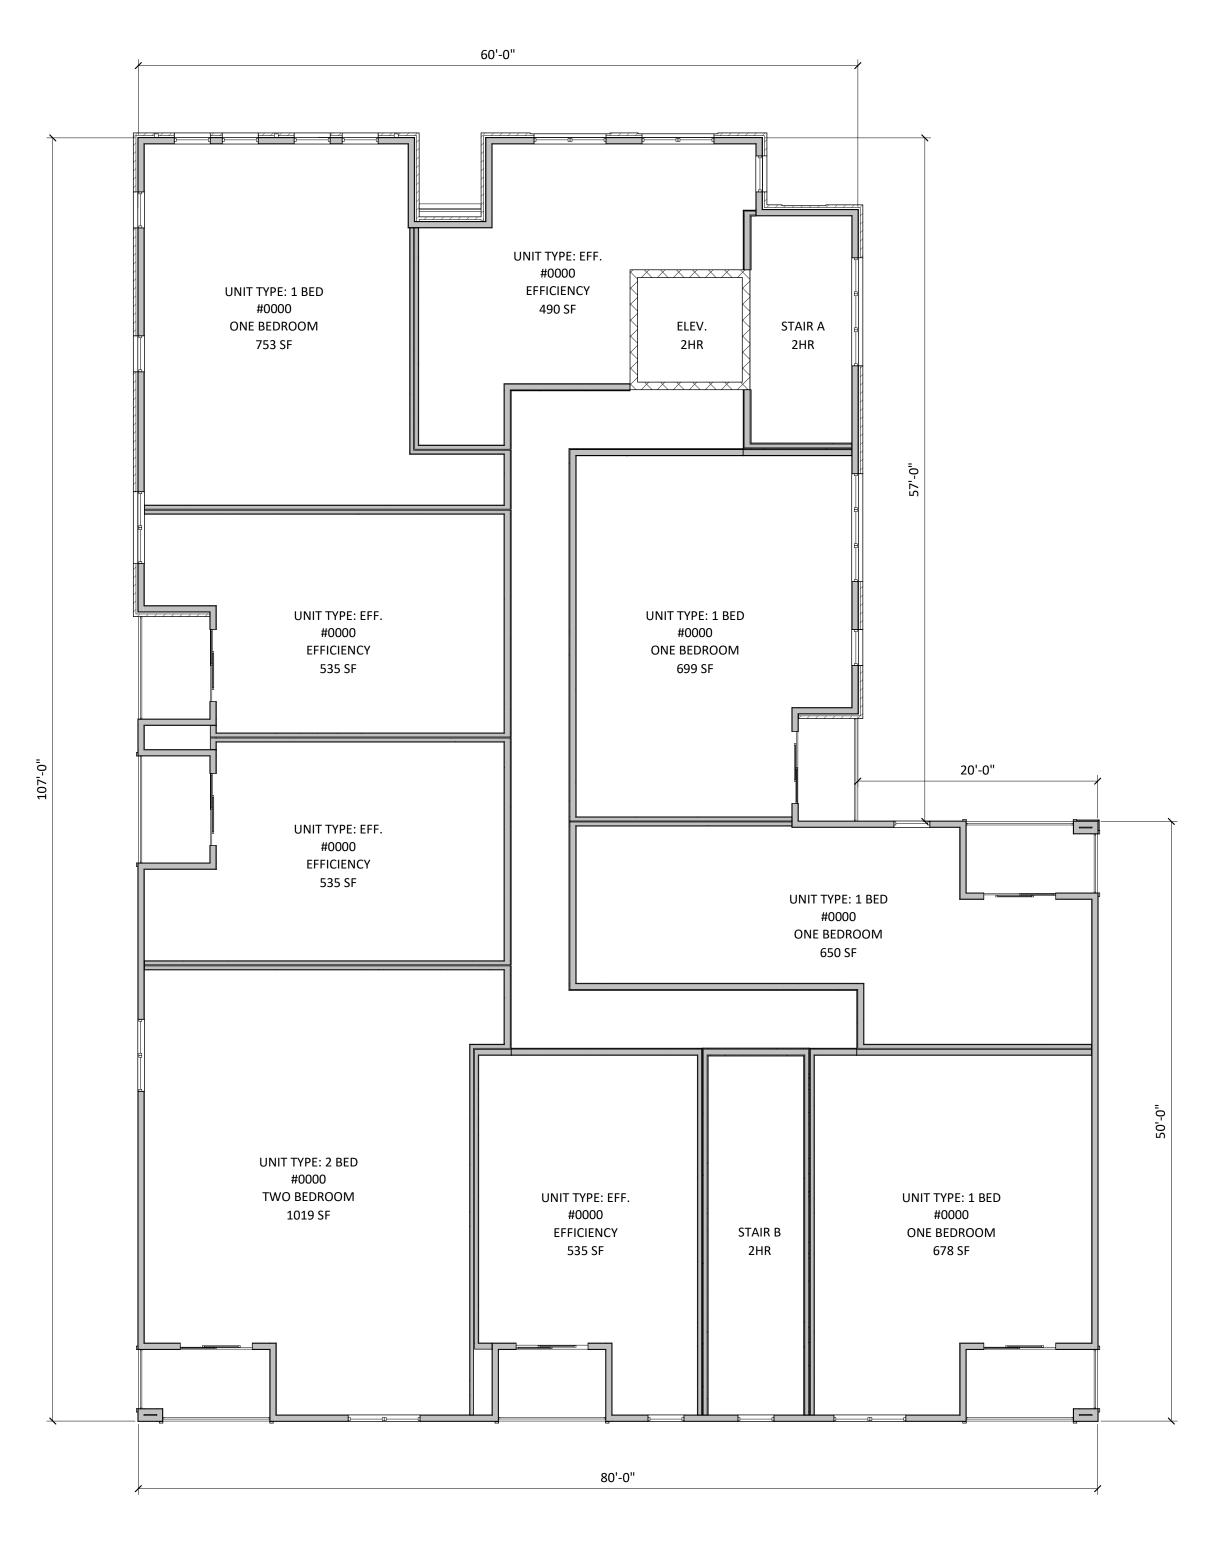

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PROJECT TITLE


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SHEET TITLE
SECOND FLOOR
PLAN

SHEET NUMBER

A-1.2



THIRD FLOOR PLAN

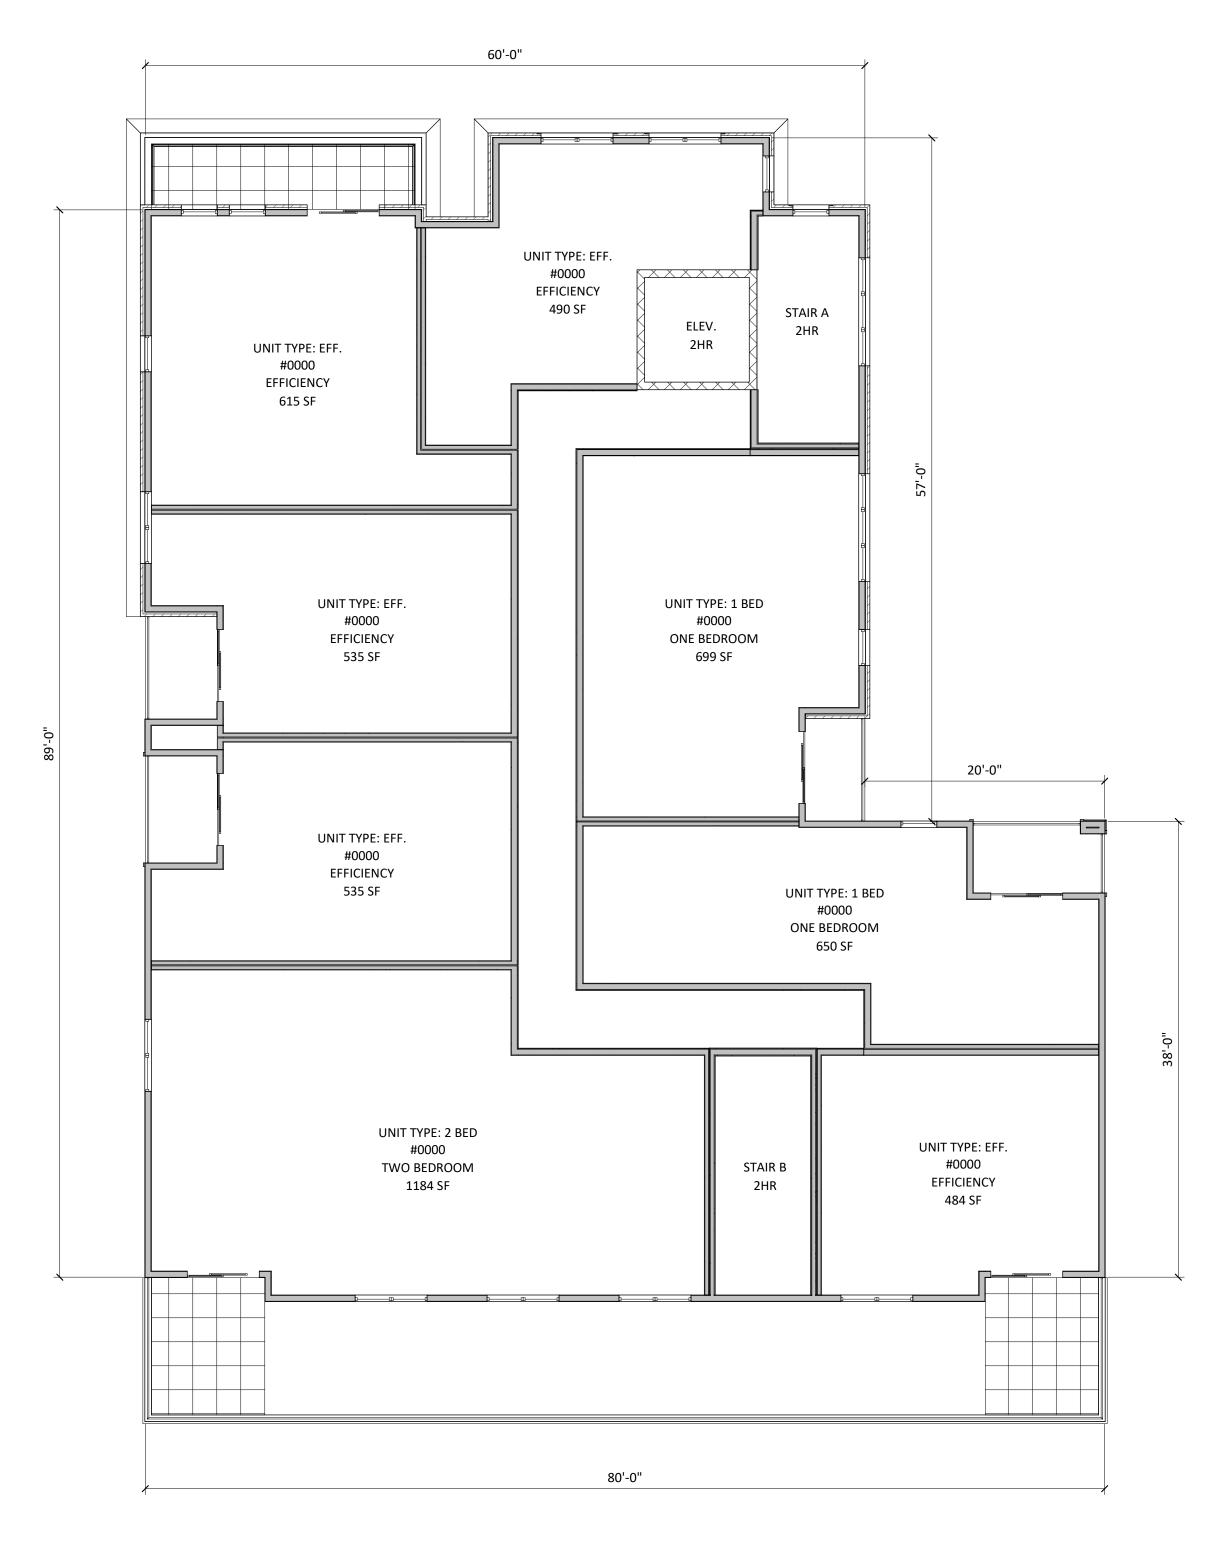1/8" = 1'-0"



KEY PLAN

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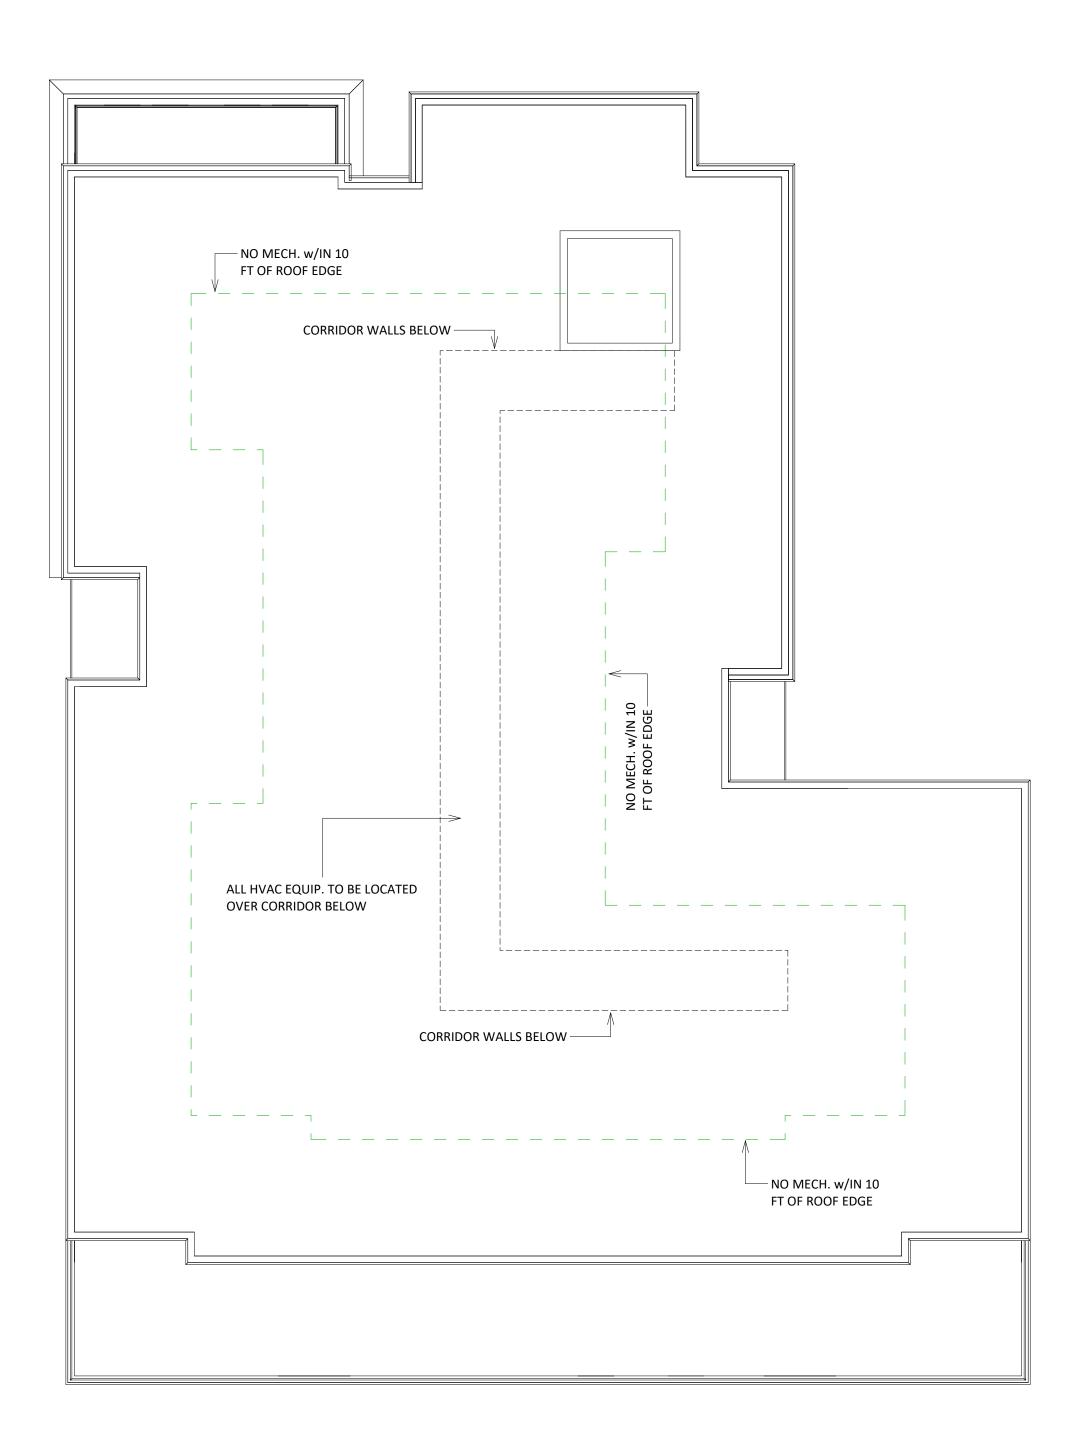
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THIRD FLOOR
PLAN

SHEET NUMBER

A-1.3







KEY PLAN

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PROJECT TITLE

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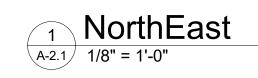
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SHEET TITLE
ROOF PLAN

SHEET NUMBER


A-1.4





2 NorthWest A-2.1 1/8" = 1'-0"



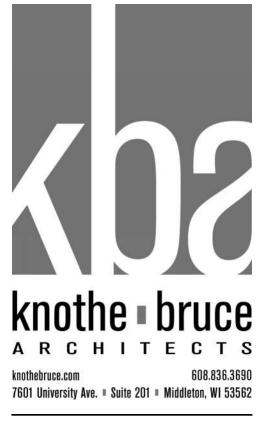

**KEY PLAN** 

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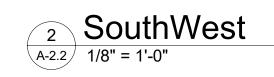
ELEVATIONS

SHEET NUMBER

A-2.1









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Wisconsin

SHEET TITLE
EXTERIOR

**ELEVATIONS** 

SHEET NUMBER



NorthEast COLORED

1/8" = 1'-0"



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KEY PLAN

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SHEET TITLE
EXTERIOR
ELEVATIONS -

SHEET NUMBER

COLORED

A-2.3





2 SouthWest COLORED

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**KEY PLAN** 

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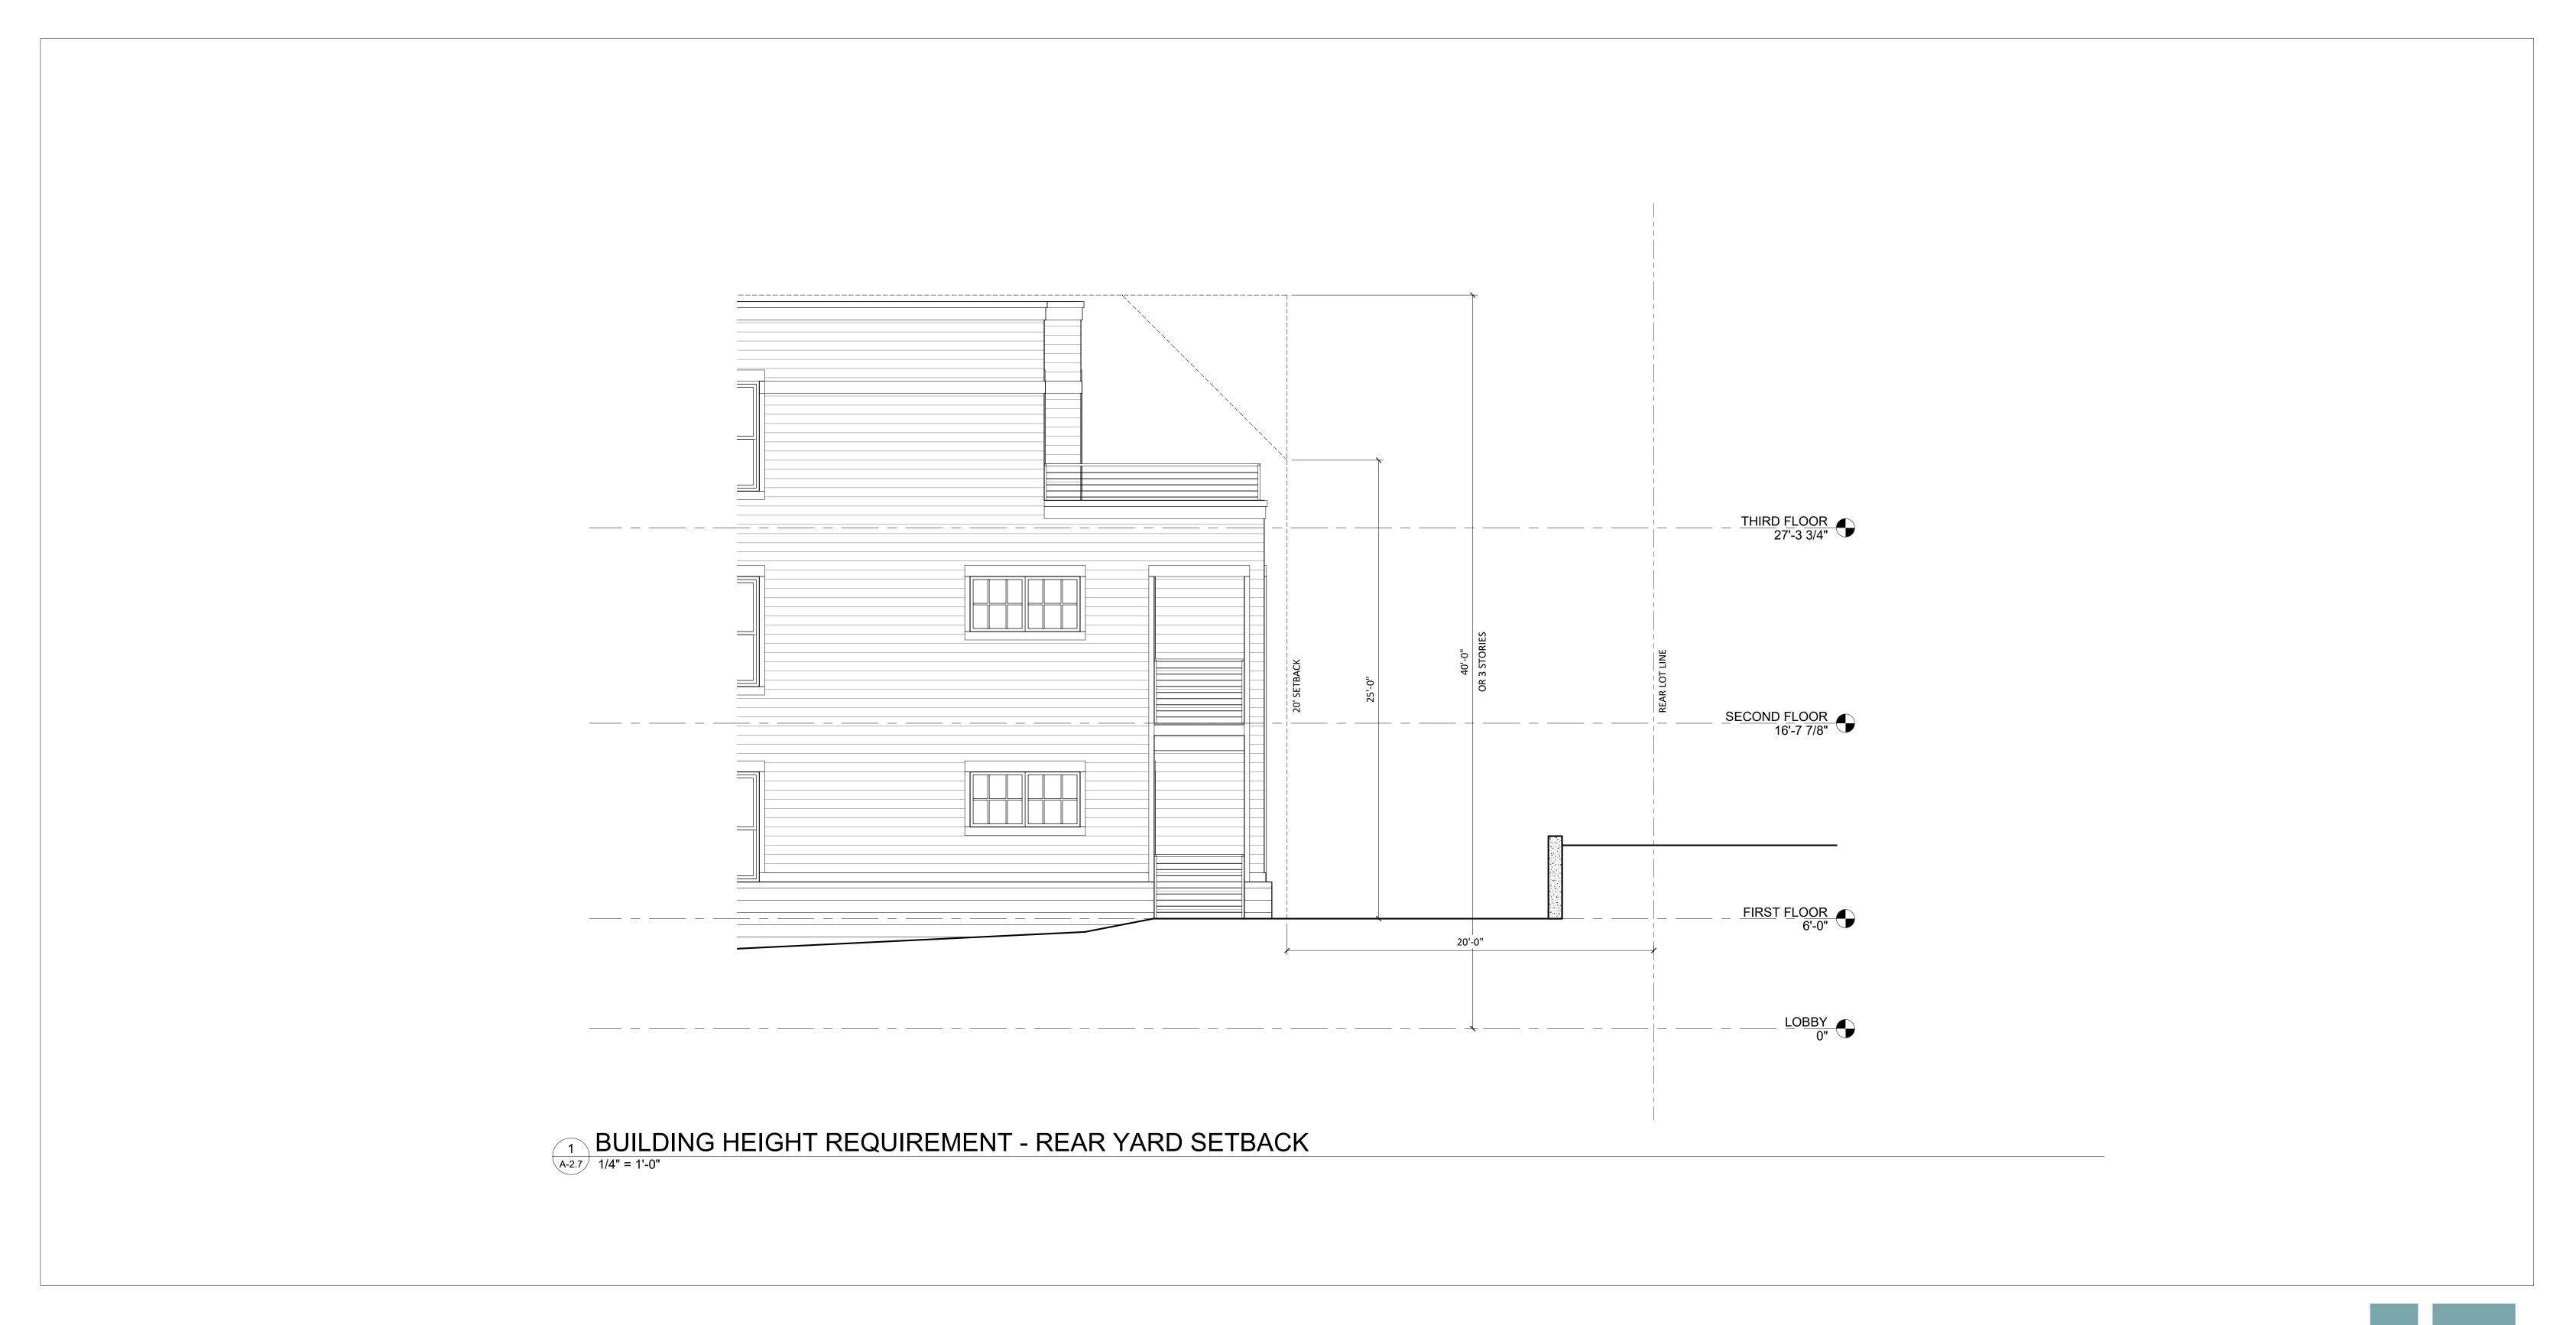
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Wisconsin
SHEET TITLE
EXTERIOR

ELEVATIONS -COLORED

SHEET NUMBER

A-2.4



# John Fontain Development

817-821 Williamson Street, Madison Wisconsin Building Height Requirements Diagram











