

# **City of Madison Fire Department**

314 W Dayton Street, Madison, WI 53703-2506

Phone: 608-266-4420 • Fax: 608-267-1100 • E-mail: fire@cityofmadison.com

<b>Project Address:</b>	1313 Reger	nt St / Lucky's
Contact Name & Ph	one #:	Kevin Burow 608-836-3690

### FIRE APPARATUS ACCESS AND FIRE HYDRANT WORKSHEET

1. Is the building completely protected by an NFPA 13 or 13R automatic fire sprinkler system?  If non-sprinklered, fire lanes extend to within 150-feet of all portions of the exterior wall?  If sprinklered, fire lanes are within 250-feet of all portions of the exterior wall?	X Yes Yes Yes	No No X No	N/A N/A N/A
<ul> <li>2. Is the fire lane constructed of concrete or asphalt, designed to support a minimum load of 85,000 lbs? <ul> <li>a) Is the fire lane a minimum unobstructed width of at least 20-feet?</li> <li>b) Is the fire lane unobstructed with a vertical clearance of at least 13½-feet?</li> <li>c) Is the minimum inside turning radius of the fire lane at least 28-feet?</li> <li>d) Is the grade of the fire lane not more than a slope of 8%?</li> <li>e) Is the fire lane posted as fire lane? (Provide detail of signage.)</li> <li>f) Is a roll-able curb used as part of the fire lane? (Provide detail of curb.)</li> <li>g) Is part of a sidewalk used as part of the required fire lane? (Must support +85,000 lbs.)</li> </ul> </li> </ul>	X Yes	No   No   No   No   No   No   No   No	N/A   N/A   N/A   N/A   N/A   N/A   N/A   N/A
3. Is the fire lane obstructed by security gates or barricades? If yes:  a) Is the gate a minimum of 20-feet clear opening?  b) Is an approved means of emergency operations installed, key vault, padlock or key switch?	☐ Yes ☐ Yes ☐ Yes	X No No No	N/A N/A N/A N/A
4. Is the Fire lane dead-ended with a length greater than 150-feet?  If yes, does the area for turning around fire apparatus comply with IFC D103?	Yes Yes	X No No	N/A N/A
5. Is any portion of the building to be used for high-piled storage in accordance with IFC Chapter 3206.6 If yes, see IFC 3206.6 for further requirements.	Yes	X No	□ N/A
6. Is any part of the building greater than 30-feet above the grade plane?	X Yes	☐ No	□ N/A
If yes, answer the following questions:  a) Is the aerial apparatus fire lane parallel to one entire side of the building and covering at least 25% of the perimeter?  b) Is the near edge of the aerial apparatus fire lane between 15' and 30' from the building?  c) Are there any overhead power or utility lines located across the aerial apparatus fire lane?  d) Are there any tree canopies expected to grow across the aerial fire lane? (Based on mature canopy width of tree species)	X Yes X Yes Yes Yes	☐ No ☐ No ☒ No ☒ No ☒ No	<ul> <li>N/A</li> <li>N/A</li> <li>N/A</li> <li>N/A</li> </ul>
If yes, answer the following questions:  a) Is the aerial apparatus fire lane parallel to one entire side of the building and covering at least 25% of the perimeter?  b) Is the near edge of the aerial apparatus fire lane between 15' and 30' from the building?  c) Are there any overhead power or utility lines located across the aerial apparatus fire lane?  d) Are there any tree canopies expected to grow across the aerial fire lane? (Based on mature canopy width of tree species)  e) Does the aerial apparatus fire lane have a minimum unobstructed width of 26-feet?	X Yes X Yes Yes Yes X Yes	<ul><li>No</li><li>No</li><li>No</li><li>No</li><li>No</li><li>No</li></ul>	<ul> <li>N/A</li> <li>N/A</li> <li>N/A</li> <li>N/A</li> <li>N/A</li> </ul>
If yes, answer the following questions:  a) Is the aerial apparatus fire lane parallel to one entire side of the building and covering at least 25% of the perimeter?  b) Is the near edge of the aerial apparatus fire lane between 15' and 30' from the building?  c) Are there any overhead power or utility lines located across the aerial apparatus fire lane?  d) Are there any tree canopies expected to grow across the aerial fire lane? (Based on mature canopy width of tree species)  e) Does the aerial apparatus fire lane have a minimum unobstructed width of 26-feet?  f) Is the space between the aerial lane and the building free of trees exceeding 20' in heights?  7. Are all portions of the required fire lanes within 500-feet of at least (2) hydrants?	X Yes X Yes Yes Yes	☐ No ☐ No ☒ No ☒ No ☒ No	<ul><li> N/A</li><li> N/A</li><li> N/A</li><li> N/A</li></ul>
If yes, answer the following questions:  a) Is the aerial apparatus fire lane parallel to one entire side of the building and covering at least 25% of the perimeter?  b) Is the near edge of the aerial apparatus fire lane between 15' and 30' from the building?  c) Are there any overhead power or utility lines located across the aerial apparatus fire lane?  d) Are there any tree canopies expected to grow across the aerial fire lane? (Based on mature canopy width of tree species)  e) Does the aerial apparatus fire lane have a minimum unobstructed width of 26-feet?  f) Is the space between the aerial lane and the building free of trees exceeding 20' in heights?	X Yes X Yes Yes Yes Yes X Yes X Yes	☐ No ☐ No ☒ No ☒ No ☒ No ☐ No ☐ No ☐ No	<ul> <li>N/A</li> <li>N/A</li> <li>N/A</li> <li>N/A</li> <li>N/A</li> <li>N/A</li> <li>N/A</li> </ul>

Attach an additional sheet if further explanation is required for any answers.

This worksheet is based on MGO 34.503 and IFC 2015 Edition Chapter 5 and Appendix D; please see the codes for further information.

# EXISTING PHOTOS LUCKY'S 1313 BREW PUB EXPANSION

## 1313 Regent Street / Lucky's Brew Pub









Bowen Court / Lucky's Brew Pub Parking Lot, Patio & Volleyball Courts





## Bowen Court / Lucky's Brew Pub Parking Lot, Patio & Volleyball Courts





## S. Randall Avenue / Lucky's surface parking lot











# CITY OF MADISON LANDSCAPE WORKSHEET

Section 28.142 Madison General Ordinance

Project Location / Address 131	13 Regent Street			
Name of Project Lucky's 131	3 Expansion			
Owner / Contact Matt Saltzberry	,, PLA - D'Onofrio Kott	ke (Landscape Archite	ect)	
Contact Phone 608-833-7530		Contact Email msa	altzberry@donofrio.cc	
	ns for zoning lots gre UST be prepared by		nd (10,000) square feet in be architect. **	size
Applicability The following standards apply to buildings, structures and parking their accessory structures. The enfollowing conditions apply, in whether the standards apply in which is apply to the standards apply to the standar	g lots, except the constitute development site	struction of detached must be brought up to	single-family and two-fam compliance with this section	nily dwellings and
(a) The area of site distu	rbance is less than ter	n percent (10%) of the	e entire development site d	uring any ten-(10)
year period.				
(b) Gross floor area is on	ly increased by ten per	rcent (10%) during an	y ten-(10) year period.	
(c) No demolition of a pr	incipal building is inv	olved.		
(d) Any displaced landsc	aping elements must b	e replaced on the site	and shown on a revised lan	dscaping plan.
three hundred (300) s	nose described in (b) a square feet of develope	and (c) below, five (5) ed area.	) landscape points shall be	provided for each
I otal square foot	age of developed area			
Total landscape p	points required3	<u> </u>		
			five (5) points per three hur ne hundred (100) square fee	
Total square foot	age of developed area			
Five (5) acres = $\frac{1}{2}$	217,800 square feet			
First five (5) dev	eloped acres = $3,630 \text{ g}$	points		
Remainder of de	veloped area			
Total landscape p	points required			
	- Limited (IL) and In		<b>IG)</b> districts, one (1) point	t shall be provided
Total square foot	age of developed area	·		
Total landscape p	points required			

10/2013


### **Tabulation of Points and Credits**

Use the table to indicate the quantity and points for all existing and proposed landscape elements.

Plant Tyme/ Floriant	Plant Type/ Element Installation Points		Credits/ Existing Landscaping		New/ Proposed Landscaping	
Plant Type/ Element	Installation	Points	Quantity	Points Achieved	Quantity	Points Achieved
Overstory deciduous tree	2½ inch caliper measured diameter at breast height (dbh)	35	-	-	4	140
Tall evergreen tree (i.e. pine, spruce)	5-6 feet tall	35	-	-	-	-
Ornamental tree	1 1/2 inch caliper	15	-	-	-	-
Upright evergreen shrub (i.e. arborvitae)	3-4 feet tall	10	-	-	-	-
Shrub, deciduous	#3 gallon container size, Min. 12"-24"	3	-	-	40	120
Shrub, evergreen	#3 gallon container size, Min. 12"-24"	4	-	-	37	148
Ornamental grasses/ perennials	#1 gallon container size, Min. 8"-18"	2	-	-	84	168
Ornamental/ decorative fencing or wall	n/a	4 per 10 lineal ft.	-	-	-	-
Existing significant specimen tree	Minimum size: 2 ½ inch caliper dbh. *Trees must be within developed area and cannot comprise more than 30% of total required points.	14 per caliper inch dbh. Maximum points per tree: 200	-	-	-	-
Landscape furniture for public seating and/or transit connections	* Furniture must be within developed area, publically accessible, and cannot comprise more than 5% of total required points.	5 points per "seat"	-	-	-	-
Sub Totals				-		576


Total Number of Points Provided	576	
Lotal Number of Points Provided	0.0	

<sup>\*</sup> As determined by ANSI, ANLA- American standards for nursery stock. For each size, minimum plant sizes shall conform to the specifications as stated in the current American Standard for Nursery Stock.

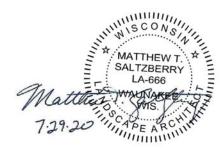

# φ

#### REGENT STREET

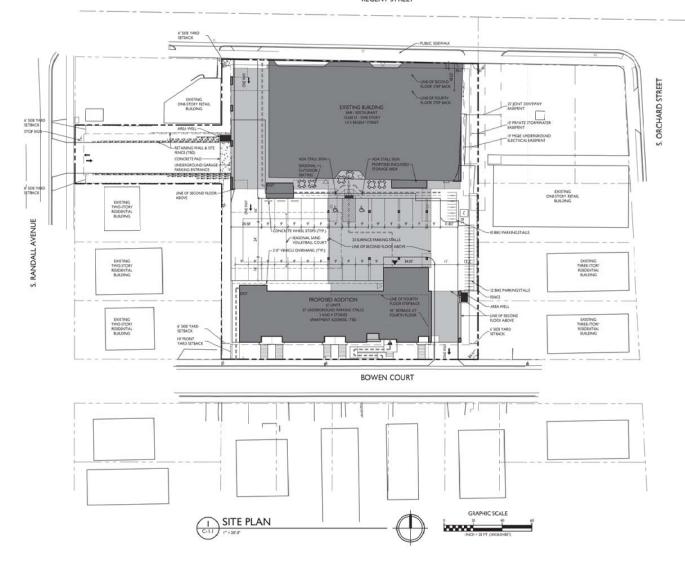

#### GENERAL NOTES:

I. THE APPLICANT SHALL REPLACE ALL SDIVAUX AND CURB AND GUTTER THAT BAUTS THE PROPERT THAT IS CAMPAGED BY THE CONSTRUCTION, OR ANY SIDEWAYS, AND CURB AND GUTTER WHICH THE CITY REGISTER DETERMENTS HERE IS THE REPLACED RECAUSE IT IS NOT AT A DESPARAÇE GUADL RECARDLESS OF WHETHER THE CONDITION EXISTED PRIOR TO REGISTERIOR CONSTRUCTION.

2. ALL WORK IN THE PUBLIC RIGHT OF WAY SHALL BE PERFORMED BY A CITY-LICENSED CONTRACTOR.

3. ALL DAMAGE TO THE PAVEMENT ON CITY STREETS, AND ADJACENT TO THIS DEVELOPMENT SHALL BE RISTORED IN ACCORDANCE WITH THE CITY OF MADISON'S PAVEMENT PATCHING CRITERIA.

4 DISTING STREET FIRES SHALL BE ROTICETED. CONTRACTOR SHALL BRITALL TER ROTICETON THE RAW AS STRIKEN IN THE CURS MO ADMINISTRATING THE ROTICE OF THE RAW AS STRIKEN IN THE CURS MO ADMINISTRATION OF THE TRACE AND DECONATION AS REPORTED WITHERS STEED OF ANY THEIR SHEED SHAP CONTRACTOR SHALL CONNECT WHITE SHEET OF ANY THEIR SHEED SHAP THEIR SHEED SHAP THEIR SHEET ON THE SHEET OF THE

S. APPROVAL OF PLANS FOR THIS PROJECT DOIS NOT INCLUDE ANY APPROVAL TO PRUNE, REMOVE OR PLANT TREES IN THE RUBLIC RIGHTLOF-WAY, PREMISSION FOR SUCH ACTIVITIES MUST BE OBTAINED FROM THE CITY FORESTER (346-918).

IS THE PUBLIC RIGHT-OF-WAY IS THE SOLE JURIDICTION OF THE CITY OF MADISON AND IS SUBJECT TO CHANCE AT ANY THE. NO ITEMS SHOWN ON THIS SITE PLAN IN THE RIGHT-OF-WAY ARE PERMANENT AND MAY NEED TO BE RIMOVED AT THE APPLICANTS EXPENSE UPON NOTIFICATION BY THE CITY.



BIKE RACKS:



ISSUED

PROJECT TITLE
Lucky's 1313
Expansion

Madison, Wisconsin
SHEET TITLE
Site Plan


SHEET NUMBER

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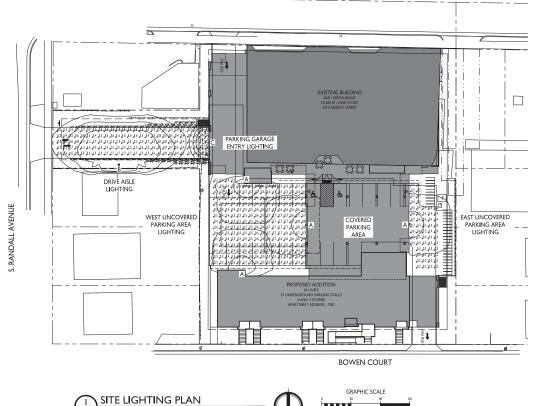
OJECT NO. 1916
Knothe & Bruce Architects, LLC



#### REGENT STREET

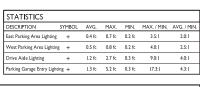

SYMBOL	LABEL	QTY	. MANUF.	CATALOG	DESCRIPTION	FILE	MOUNTING
_	Α	4	LITHONIA LIGHTING	DSXWI LED IOC 350 30K T4M MVOLT HS	DSXWI LED WITH (I) 10 LED LIGHT ENGINE, TYPE 4M OPTIC, 3000K, AT 350mA WITH HOUSE-SIDE SHIELD	DSXWI_LED_I0C _350_30K_T4M _MVOLT_HS.ies	MOUNTED ON BUILDING 16'-0' ABOVE GRADE
	В	1	LITHONIA LIGHTING	DSX0 LED PI 30K BLC MVOLT	DSX0 LED PI 30K BLC MVOLT	DSX0_LED_PI_30K_ BLC_MVOLT.ies	16'-0" POLE ON FLUSH CONC. BASE
	С	1	LITHONIA LIGHTING	LIL LED 30K MVOLT	LIL WALLPACK (STANDARD)	LIL_LED_30K_ MVOLT_HS.ies	MOUNTED ON BUILDING 8'-0" ABOVE GRADE
				EXAMPLE LIGHT F	IXTURE DISTRIBUTI	ON	
					ISOLUX CONTOUR ISOLUX CONTOUR ISOLUX CONTOUR LIGHT FIXTURE	= 0.5 FC	




Lucky's 1313 Expansion

Issued for Land Use Submittal - July 29, 2020

1313 Regent Street Madison, Wisconsin Site Lighting Plan

SHEET NUMBER

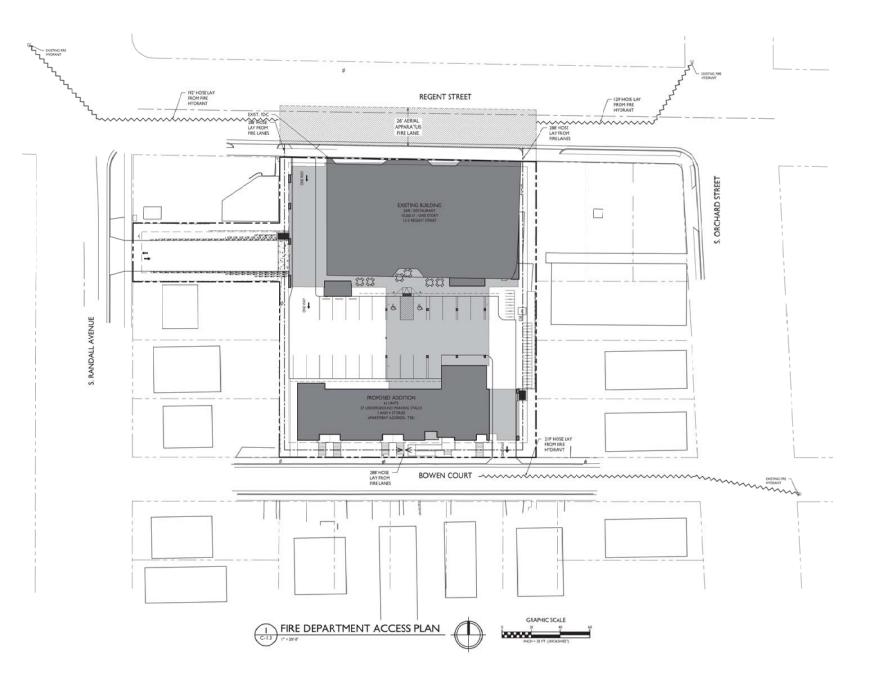



PROJECT TITLE
Lucky's 1313
Expansion

1313 Regent Street
Madison, Wisconsin
SHEET TITLE
Fire Department
Access Plan


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C-1.3

PROJECT NO. 191

## -----

#### REGENT STREET

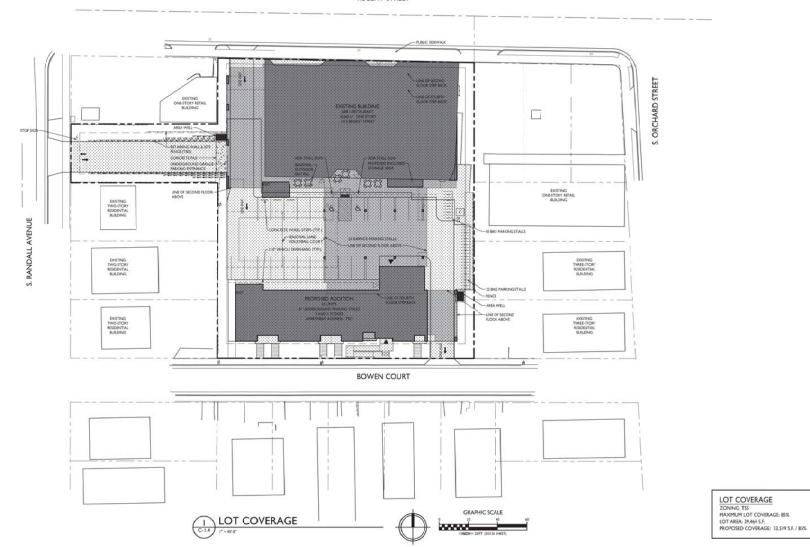

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Those 748 University Avs. 5x 201
Hiddetex.NU3354

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PROJECT TITLE
Lucky's 1313
Expansion


1313 Regent Street
Madison, Wisconsin
SHEET TITLE
Lot Coverage

SHEET NUMBER

C-1.4

OJECT NO. 19

#### REGENT STREET

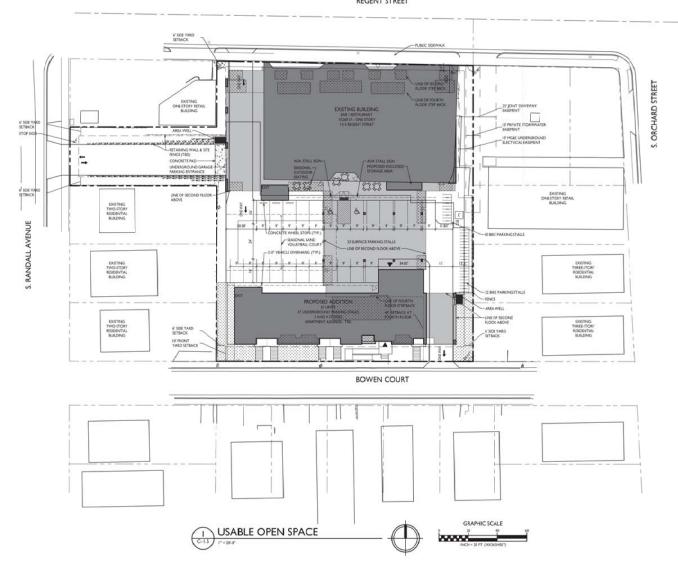



USABLE OPEN SPACE
ZONING: TSS
REQUIRED OPEN SPACE: 40 S.F./ D.U.
DWELLING UNITS: 63
40 X.61 = 1,230 S.F. OPEN SPACE REQUIRED
OPEN SPACE PROVIDED:
ROOF DECK: 636 S.F.
PRIVATE BACKONIES: 3,817 S.F.

SURFACE: 1,616 S.F. TOTAL: 6,069 S.F.

ISSUED


PROJECT TITLE
Lucky's 1313
Expansion


Madison, Wisconsin
SHEET TITLE
Usable Open
Space


SHEET NUMBER


C-1.5


OJECT NO. 1916

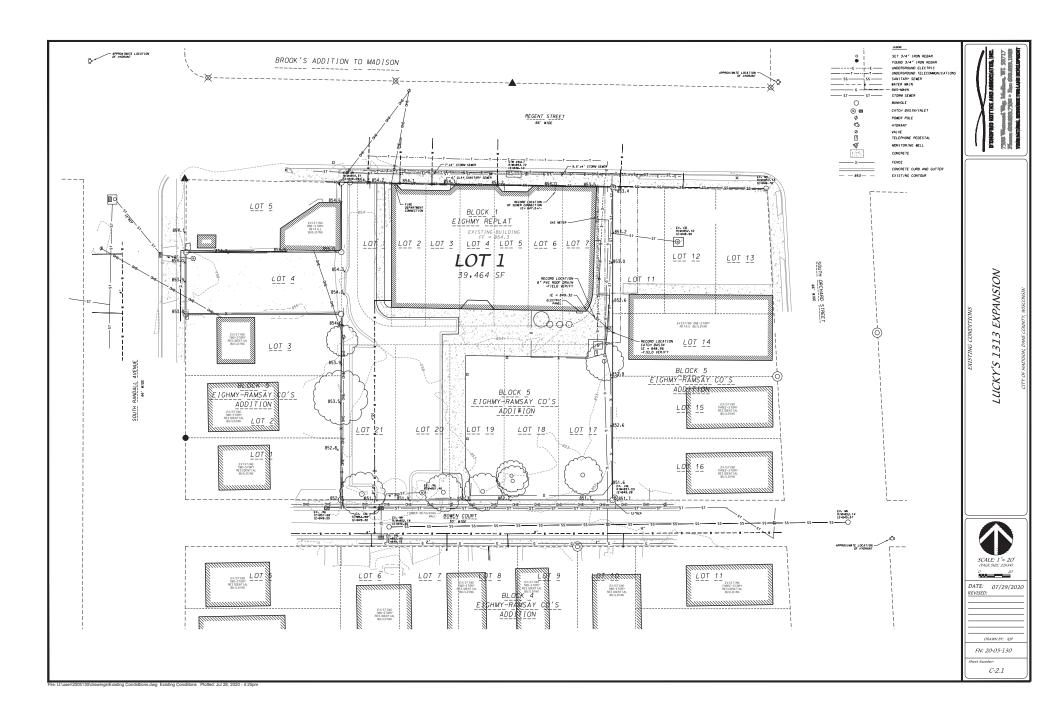


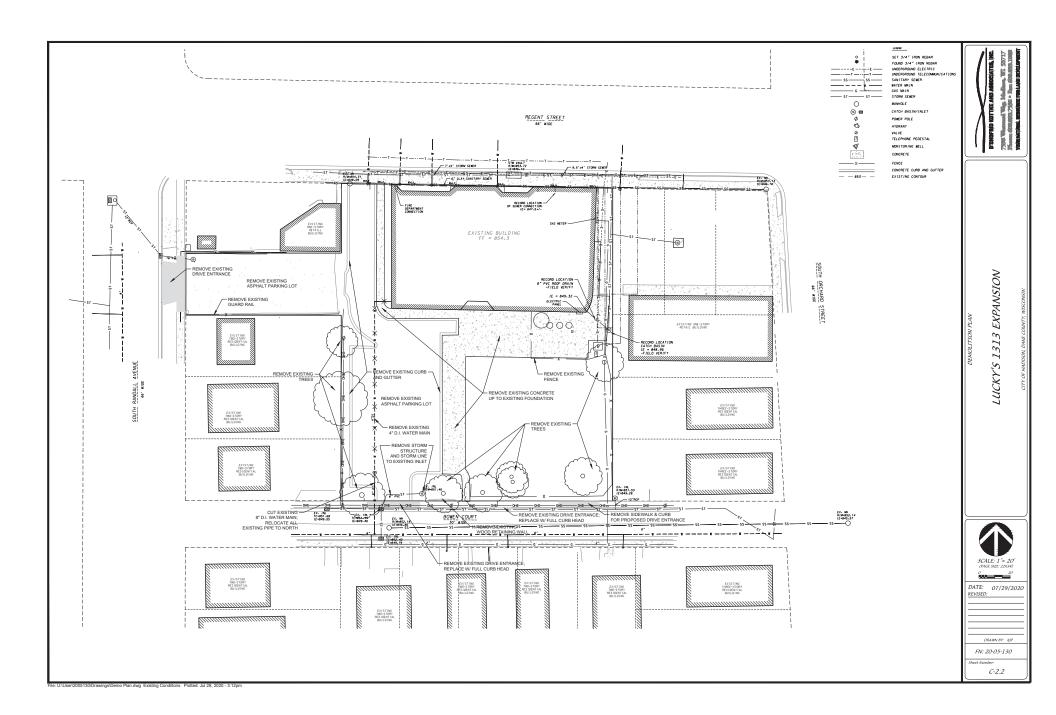

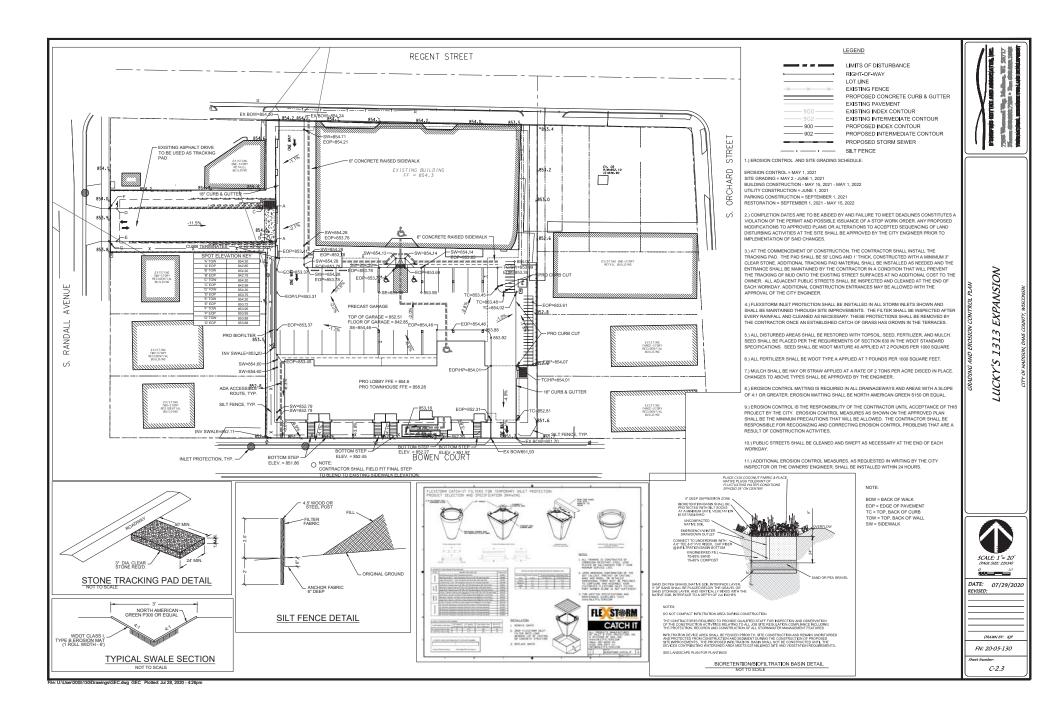

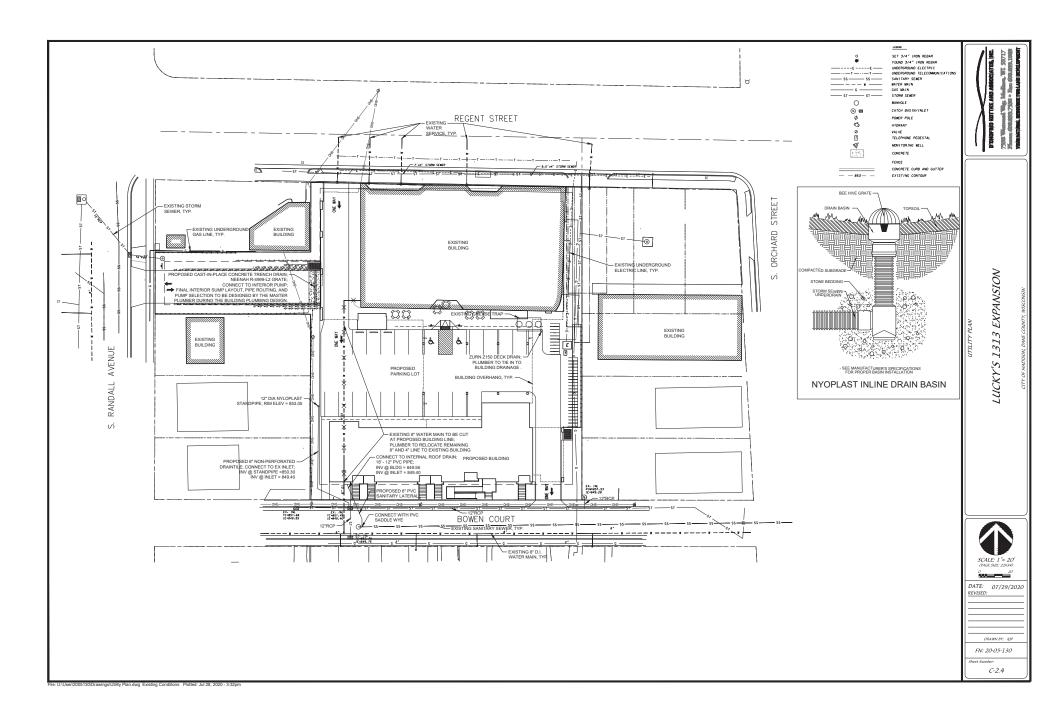

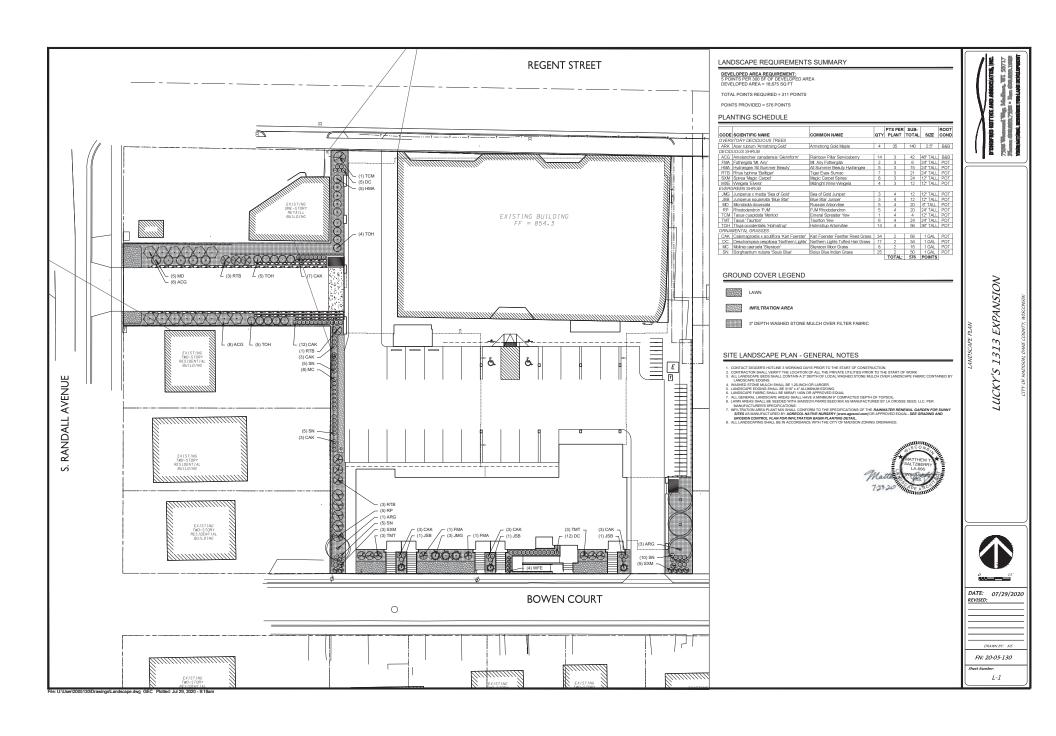

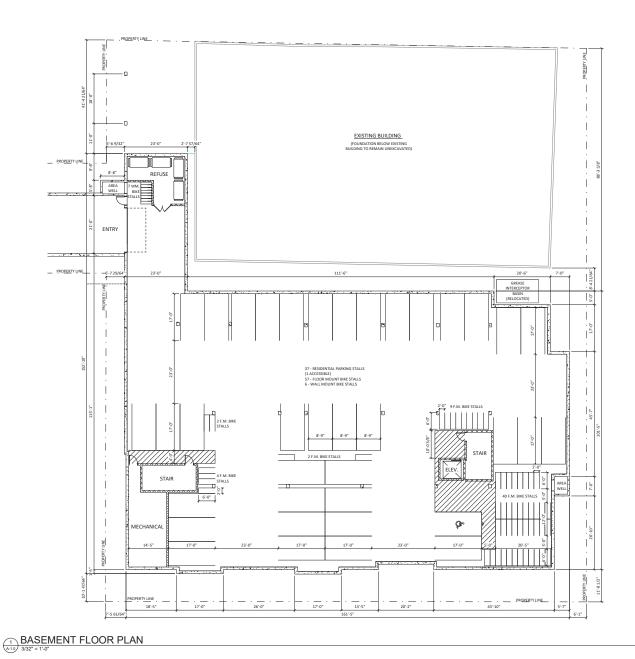




PROJECT TITLE
LUCKY'S 1313
EXPANSION

1313 REGENT ST. MADISON, WI

SHEET TITLE
BASEMENT
FLOOR PLAN

SHEET NUMBER

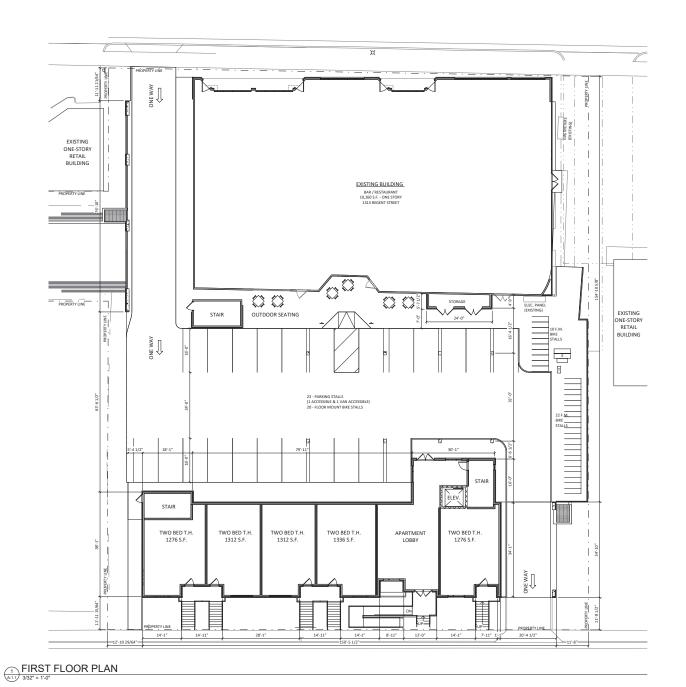




PROJECT TITLE
LUCKY'S 1313
EXPANSION

1313 REGENT ST. MADISON, WI

FIRST FLOOR PLAN

SHEET NUMBER

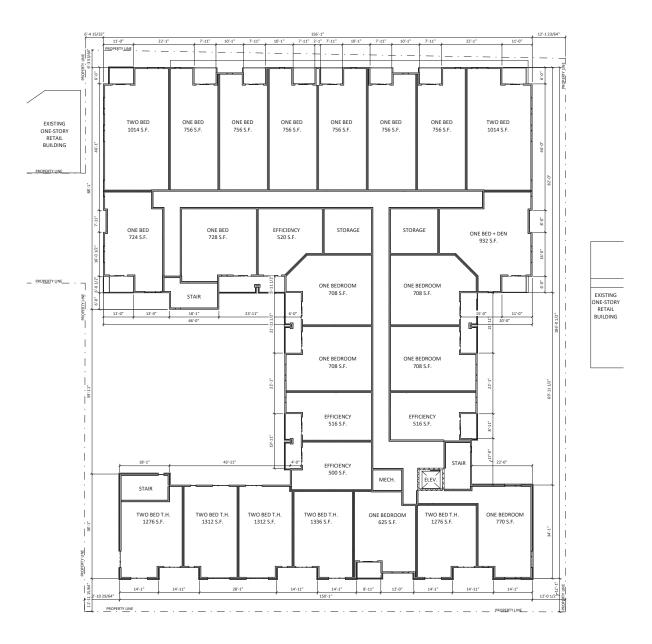




PROJECT TITLE
LUCKY'S 1313
EXPANSION

1313 REGENT ST. MADISON, WI

SHEET TITLE
SECOND FLOOR
PLAN

SHEET NUMBER

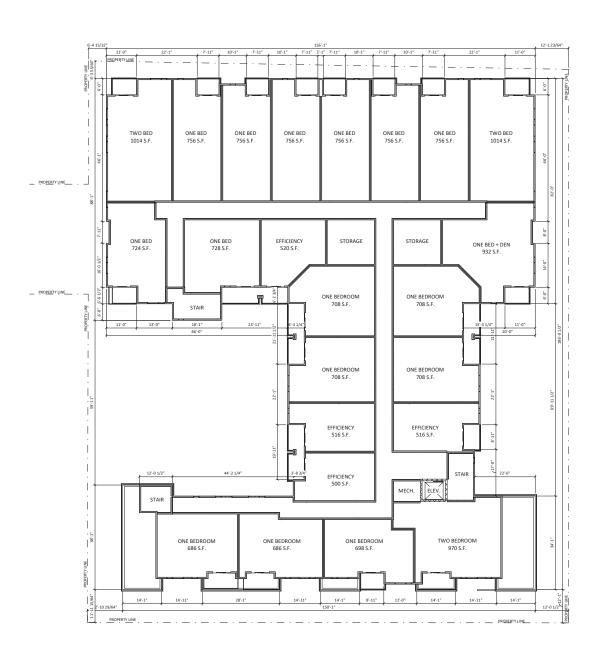




PROJECT TITLE
LUCKY'S 1313
EXPANSION

1313 REGENT ST. MADISON, WI

SHEET TITLE
THIRD FLOOR
PLAN

SHEET NUMBER

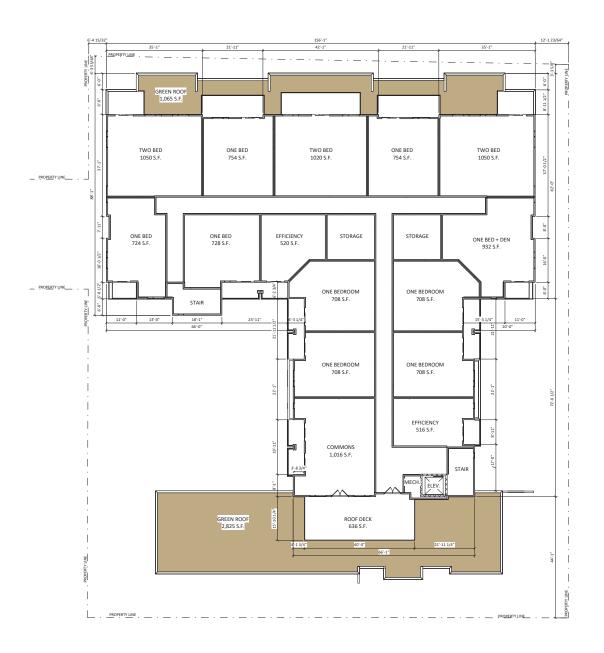



PROJECT TITLE
LUCKY'S 1313
EXPANSION

1313 REGENT ST. MADISON, WI

SHEET TITLE
FOURTH FLOOR
PLAN

SHEET NUMBER

PROJECT NUMBER 1916





PROJECT TITLE LUCKY'S 1313 **EXPANSION** 

1313 REGENT ST. MADISON, WI SHEET TITLE ROOF PLAN

SHEET NUMBER







EXTERIOR MATERIAL SCHEDULE				
BUILDING ELEMENT	MANUFACTURER	COLOR		
COMPOSITE LAP SIDING - (#1) - 4"	JAMES HARDIE	SLATE GRAY		
COMPOSITE LAP SIDING - (#2) - CUSTOM WIDTH	JAMES HARDIE	SW 7585 SUN DRIED TOMATO		
COMPOSITE PANEL SIDING - (#3)	JAMES HARDIE	ARCTIC WHITE		
COMPOSITE TRIM - (#T1)	JAMES HARDIE	SLATE GRAY		
COMPOSITE TRIM - (#T2)	JAMES HARDIE	SW 7585 SUN DRIED TOMATO		
COMPOSITE TRIM - (#T3)	JAMES HARDIE	ARCTIC WHITE		
MODULAR BRICK VENEER	N/A	MATCH EXISTING		
VINYL WINDOWS	VISIONS	WHITE		
ALUM. STOREFRONT	N/A	WHITE FRAME / RED DOORS		
METAL DOORS/FRAMES	N/A	SW 6126 - NAVAJO WHITE		
STONE SILLS & BANDS	EDWARDS	COLOR TO MATCH STONE VENEER		
SOFFITS & FASCIA	N/A	SW 6126 - NAVAJO WHITE		
RAILINGS	SUPERIOR	BLACK		



PROJECT TITLE
LUCKY'S 1313
EXPANSION

1313 REGENT ST. MADISON, WI

EXTERIOR ELEVATIONS

SHEET NUMBER

PROJECT NUMBER 1916



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PROJECT TITLE
LUCKY'S 1313
EXPANSION

1313 REGENT ST. MADISON, WI

SHEET TITLE
EXTERIOR
ELEVATIONS

SHEET NUMBER

PROJECT NUMBER 1916

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1 South A-2.2 3/32" = 1'-0"



2 East A-2.2 3/32" = 1'-0

EXTERIOR MATERIAL SCHEDULE				
BUILDING ELEMENT	MANUFACTURER	COLOR		
COMPOSITE LAP SIDING - (#1) - 4"	JAMES HARDIE	SLATE GRAY		
COMPOSITE LAP SIDING - (#2) - CUSTOM WIDTH	JAMES HARDIE	SW 7585 SUN DRIED TOMATO		
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COMPOSITE TRIM - (#T2)	JAMES HARDIE	SW 7585 SUN DRIED TOMATO		
COMPOSITE TRIM - (#T3)	JAMES HARDIE	ARCTIC WHITE		
MODULAR BRICK VENEER	N/A	MATCH EXISTING		
VINYL WINDOWS	VISIONS	WHITE		
ALUM. STOREFRONT	N/A	WHITE FRAME / RED DOORS		
METAL DOORS/FRAMES	N/A	SW 6126 - NAVAJO WHITE		
STONE SILLS & BANDS	EDWARDS	COLOR TO MATCH STONE VENEER		
SOFFITS & FASCIA	N/A	SW 6126 - NAVAJO WHITE		
RAILINGS	SUPERIOR	BLACK		



North - Rendered Elevation

COMPOSIT RAMES

West - Rendered Elevation

EXTERIOR MATERIAL SCHEDULE				
BUILDING ELEMENT	MANUFACTURER	COLOR		
COMPOSITE LAP SIDING - (#1) - 4"	JAMES HARDIE	SLATE GRAY		
COMPOSITE LAP SIDING - (#2) - CUSTOM WIDTH	JAMES HARDIE	SW 7585 SUN DRIED TOMATO		
COMPOSITE PANEL SIDING - (#3)	JAMES HARDIE	ARCTIC WHITE		
COMPOSITE TRIM - (#T1)	JAMES HARDIE	SLATE GRAY		
COMPOSITE TRIM - (#T2)	JAMES HARDIE	SW 7585 SUN DRIED TOMATO		
COMPOSITE TRIM - (#T3)	JAMES HARDIE	ARCTIC WHITE		
MODULAR BRICK VENEER	N/A	MATCH EXISTING		
VINYL WINDOWS	VISIONS	WHITE		
ALUM. STOREFRONT	N/A	WHITE FRAME / RED DOORS		
METAL DOORS/FRAMES	N/A	SW 6126 - NAVAJO WHITE		
STONE SILLS & BANDS	EDWARDS	COLOR TO MATCH STONE VENEER		
SOFFITS & FASCIA	N/A	SW 6126 - NAVAJO WHITE		
RAILINGS	SUPERIOR	BLACK		

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Institute and MERIANA
MINISTRA \* Anio 201 \* Mathem M 3350.
KEY PLAN

ISSUED Issued for Land Use Submittal - July 27, 2020

PROJECT TITLE
LUCKY'S 1313
EXPANSION

1313 REGENT ST.
MADISON, WI
SHEET TITLE

RENDERED EXTERIOR ELEVATIONS

SHEET NUMBER



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A R C H I T E C T S
Intelligence (as - 1 th of the color of the colo

South - Rendered Elevation

ROOF TRUSS

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ISSUED

PROJECT TITLE
LUCKY'S 1313
EXPANSION

East - Rendered Elevation

EXTERIOR	R MATERIAL	SCHEDULE
BUILDING ELEMENT	MANUFACTURER	COLOR
COMPOSITE LAP SIDING - (#1) - 4"	JAMES HARDIE	SLATE GRAY
COMPOSITE LAP SIDING - (#2) - CUSTOM WIDTH	JAMES HARDIE	SW 7585 SUN DRIED TOMATO
COMPOSITE PANEL SIDING - (#3)	JAMES HARDIE	ARCTIC WHITE
COMPOSITE TRIM - (#T1)	JAMES HARDIE	SLATE GRAY
COMPOSITE TRIM - (#T2)	JAMES HARDIE	SW 7585 SUN DRIED TOMATO
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ALUM. STOREFRONT	N/A	WHITE FRAME / RED DOORS
METAL DOORS/FRAMES	N/A	SW 6126 - NAVAJO WHITE
STONE SILLS & BANDS	EDWARDS	COLOR TO MATCH STONE VENEER
SOFFITS & FASCIA	N/A	SW 6126 - NAVAJO WHITE
RAILINGS	SUPERIOR	BLACK

1313 REGENT ST. MADISON, WI

RENDERED EXTERIOR ELEVATIONS

SHEET NUMBER

A-2.4
PROJECT NUMBER 1916

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