

City of Madison Fire Department

314 W Dayton Street, Madison, WI 53703-2506

Phone: 608-266-4420 • Fax: 608-267-1100 • E-mail: fire@cityofmadison.com


Project Address: 133 E Lak	eside St, Madison WI	
Contact Name & Phone #:	Kevin Burow 608-836-3690	

FIRE APPARATUS ACCESS AND FIRE HYDRANT WORKSHEET

1. Is the building completely protected by an NFPA 13 or 13R automatic fire sprinkler system? If non-sprinklered, fire lanes extend to within 150-feet of all portions of the exterior wall? If sprinklered, fire lanes are within 250-feet of all portions of the exterior wall?	X Yes Yes Yes	No No No	N/A N/A N/A
2. Is the fire lane constructed of concrete or asphalt, designed to support a minimum load of 85,000 lbs? a) Is the fire lane a minimum unobstructed width of at least 20-feet? b) Is the fire lane unobstructed with a vertical clearance of at least 13½-feet? c) Is the minimum inside turning radius of the fire lane at least 28-feet? d) Is the grade of the fire lane not more than a slope of 8%? e) Is the fire lane posted as fire lane? (Provide detail of signage.) f) Is a roll-able curb used as part of the fire lane? (Provide detail of curb.) g) Is part of a sidewalk used as part of the required fire lane? (Must support +85,000 lbs.)	X Yes	No	 N/A
3. Is the fire lane obstructed by security gates or barricades? If yes: a) Is the gate a minimum of 20-feet clear opening? b) Is an approved means of emergency operations installed, key vault, padlock or key switch?	☐ Yes ☐ Yes ☐ Yes	No No No	N/A N/A N/A
4. Is the Fire lane dead-ended with a length greater than 150-feet? If yes, does the area for turning around fire apparatus comply with IFC D103?	Yes Yes	X No	□ N/A ▼ N/A
5. Is any portion of the building to be used for high-piled storage in accordance with IFC Chapter 3206.6 If yes, see IFC 3206.6 for further requirements.	Yes	X No	□ N/A
6. Is any part of the building greater than 30-feet above the grade plane?	X Yes	☐ No	□ N/A
If yes, answer the following questions: a) Is the aerial apparatus fire lane parallel to one entire side of the building and covering at least 25% of the perimeter? b) Is the near edge of the aerial apparatus fire lane between 15' and 30' from the building? c) Are there any overhead power or utility lines located across the aerial apparatus fire lane? d) Are there any tree canopies expected to grow across the aerial fire lane? (Based on mature canopy width of tree species)	X Yes X Yes Yes Yes	☐ No ☐ No ☑ No ☑ No ☑ No	□ N/A □ N/A □ N/A □ N/A
If yes, answer the following questions: a) Is the aerial apparatus fire lane parallel to one entire side of the building and covering at least 25% of the perimeter? b) Is the near edge of the aerial apparatus fire lane between 15' and 30' from the building? c) Are there any overhead power or utility lines located across the aerial apparatus fire lane? d) Are there any tree canopies expected to grow across the aerial fire lane? (Based on mature	X Yes X Yes Yes Yes	☐ No ☐ No ☑ No ☑ No	□ N/A □ N/A □ N/A
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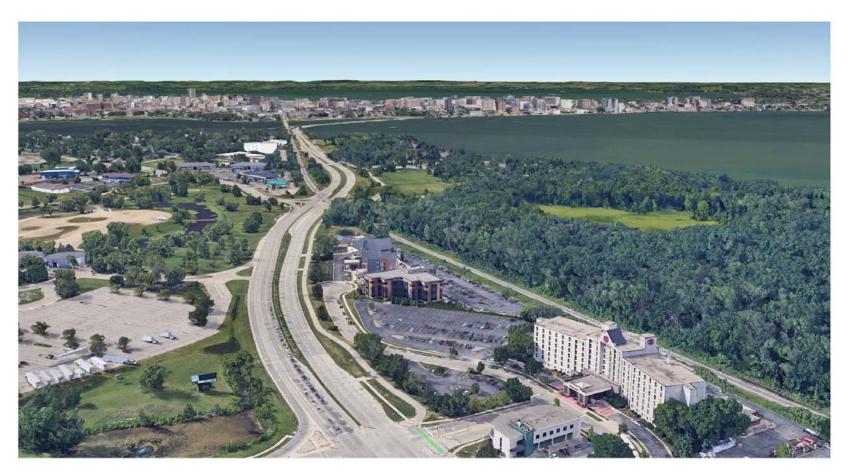
Attach an additional sheet if further explanation is required for any answers.

This worksheet is based on MGO 34.503 and IFC 2015 Edition Chapter 5 and Appendix D; please see the codes for further information.

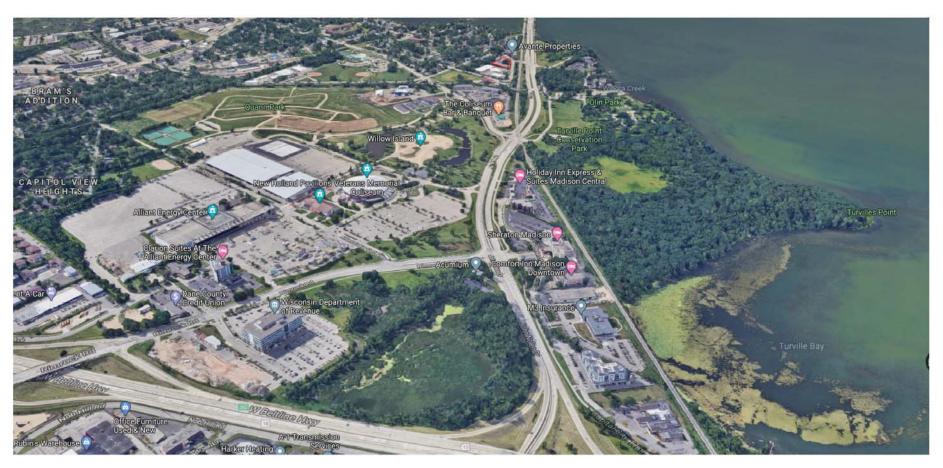


AERIAL VIEW OF JOHN NOLEN CORRIDOR





JOHN NOLEN AERIAL - FAR CONTEXT



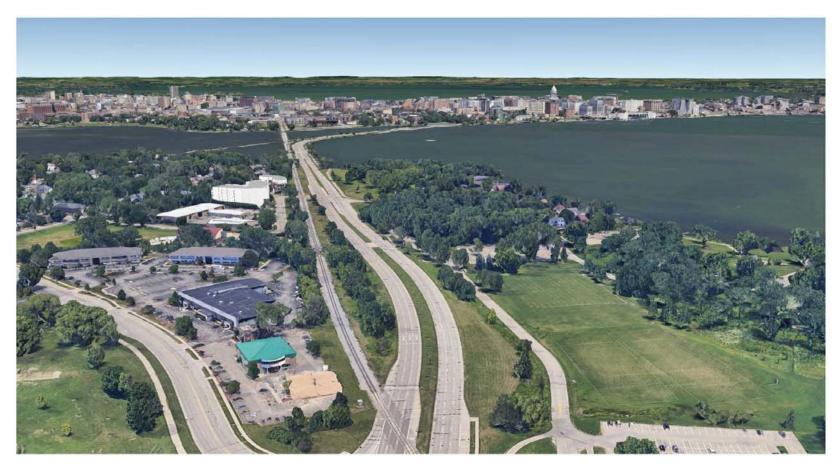

JOHN NOLEN AERIAL - MID CONTEXT





SITE CONTEXT AERIAL








ADJACENT BUILDINGS ALONG JOHN NOLEN CORRIDOR



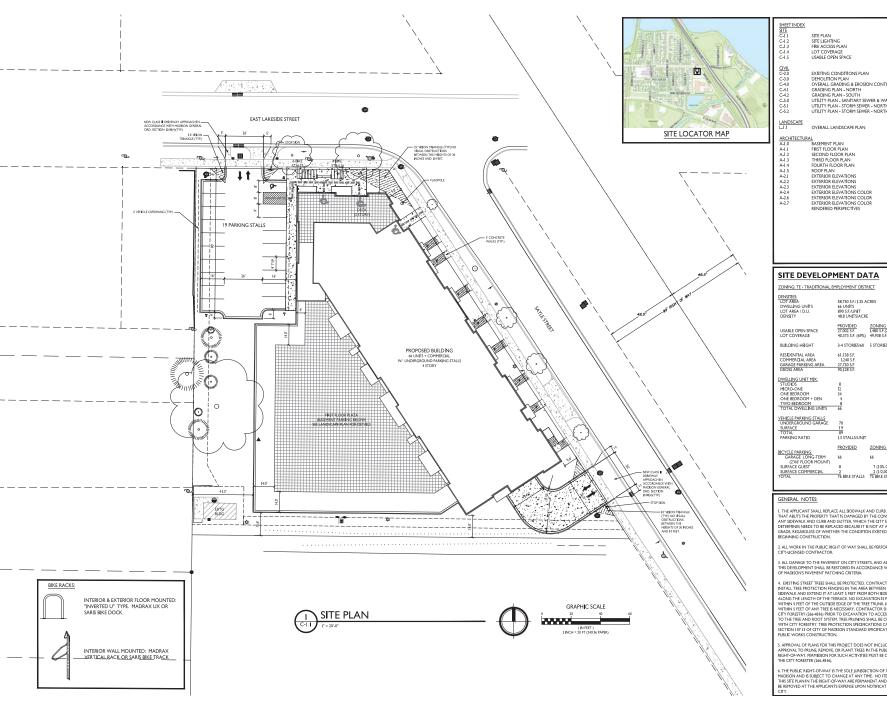



ISSUED Issued for Land Use & UDC - May 6, 2020 Issued for UDC Submittal - July 15, 2020

SITE DEVELOPMENT DATA

SITE PLAN SITE LIGHTING FIRE ACCESS PLAN LOT COVERAGE USABLE OPEN SPACE

EXISTING CONDITIONS PLAN

ZONING: TE - TRADITIONAL EMPLOYMENT DISTRICT

DWELLING UNITS LOT AREA / D.U. DENSITY

58,750 S.F./1.35 ACRES 66 UNITS 890 S.F./UNIT 48.8 UNITS/ACRE

PROVIDED ZONING REQUIREMENTS 1,480 S.F.(20 S.F./BEDROOM 40,373 S.F. (69%) 49,938 S.F. (85% MAX.)

BUILDING HEIGHT

3-4 STORIES/60 5 STORIES/68

GARAGE PARKING AREA GROSS AREA DWELLING UNIT MIX:
STUDIOS
MICRO-ONE
ONE BEDROOM
ONE BEDROOM + DEN
TWO BEDROOM
TOTAL DWELLING UNITS

VEHICLE PARKING STALLS UNDERGROUND GARAGE

PARKING RATIO PROVIDED ZONING REQUIREMENTS

BICYCLE PARKING:
GARAGE LONG-TERM
(2'X6' FLOOR MOUNT)
SURFACE GUEST
SURFACE COMMERCIAL
TOTAL 8 7 (10% OF TOTAL UNITS 2 2 (1/2,000 S.F. OR 2 MIN.) 76 BIKE STALLS 75 BIKE STALLS REQ'D

GENERAL NOTES:

I. THE APPLICANT SHALL REPLACE ALL SIDEWALK AND CURB AND GUTTER THAT ABLIST THE PROPERTY THAT'S DAMAGED BY THE CONSTBUCTION, OR ANY SIDEWALK AND CURB AND GUTTER, WHICH THE CITY PICKINERS DETERMINES NEEDS TO BE REPLACED BECAUSE IT IS NOT AT A DESIRABLE GANDE, REGARDLESS OF WHETHER THE CONDITION EMISTED PRIOR TO BEGINNING CONSTRUCTION.

2. ALL WORK IN THE PUBLIC RIGHT OF WAY SHALL BE PERFORMED BY A CITY-LICENSED CONTRACTOR.

3. ALL DAMAGE TO THE PAVEMENT ON CITY STREETS, AND ADJACENT TO THIS DEVELOPMENT SHALL BE RESTORED IN ACCORDANCE WITH THE CITY OF MADISON'S PAVEMENT PATCHING CRITERIA.

4. BUSTING STREET TREE SHALL BY ROTIECTED. CONTRACTOR SHALL BITGAL TREE PROTECTED HE ROTIECTED. THE ARIA BETWEEN THE CURB AND AND THE REPORT OF THE REPORT OF THE CURB AND AND THE SHARE CONTRACTOR. ON ECONOMINON SHEET OF THE OUTSIDE EDGE OF THE TIME TRUNK, IF ECCUATION WITHIN SHEET OF THE OUTSIDE EDGE OF THE TIME TRUNK, IF ECCUATION WITHIN SHEET OF ANY THESE INCESSARY CONTRACTORS BULL CONTRACTOR TO THE SHEET OF THE SHALL CONTRACTOR TO THE SHEET OF THE SHALL OF THE SHEET OF THE SHALL BY COORDINATES OF T

5. APPROVAL OF PLANS FOR THIS PROJECT DOES NOT INCLUDE ANY APPROVAL TO PRUNE, REMOVE, OR PLANT TREES IN THE PUBLIC RIGHT-OF-WAY, PREMISSION FOR SUCH ACTIVITIES MUST BE OBTAINED FROM THE CITY FORESTER (266-4816).

6. THE PUBLIC RIGHT-OF-WAY IS THE SOLE JURISDICTION OF THE CITY OF MADISON AND IS SUBJECT TO CHANGE AT ANY TIME. NO TIEMS SHOWN OI THIS STEP AND IN THE BIGHT-OF-WAY ARE PERMANENT AND MAY NEED TO BE REMOVED AT THE APPLICANTS EXPENSE UPON NOTIFICATION BY THE

133 E Lakeside Street Madison, WI

SHEET TITLE Site Plan

THE POST

SHEET NUMBER

1971





SITE LIGHTING PLAN



ISSUED
Issued for Land Use & UDC - May 6, 2020




133 E Lakeside Street

Madison, WI
SHEET TITLE
Site Lighting Plan


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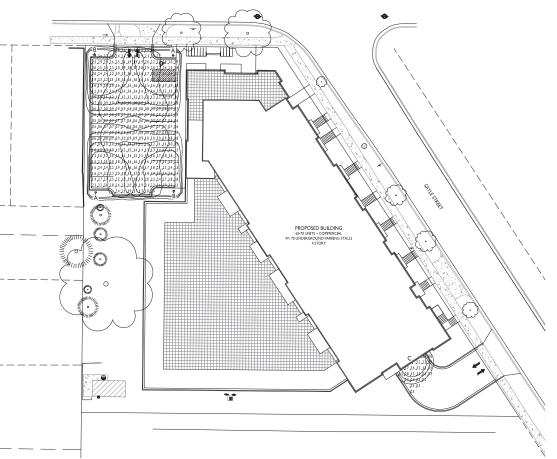
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PROJECT NO.	197
© 2013 Knothe &	Bruce Architects, L





			CHEDULE MANUF.	CATALOG	DESCRIPTION	FILE	MOUNTING
	Α	2	LITHONIA LIGHTING	DSX0 LED PI 30K LCCO MVOLT	DSX0 LED PJ 30K LCCO MVOLT	DSX0_LED_PI_30K_ LCCO_MVOLT.ies	16'-0" POLE ON 2'-0" TALL CONC. BASE
	В	2	LITHONIA LIGHTING	DSX0 LED PI 30K RCCO MVOLT	DSX0 LED PJ 30K RCCO MVOLT	DSX0_LED_P1_30K_ RCCO_MVOLT.ies	16'-0" POLE ON 2'-0" TALL CONC. BASE
	С	I	LITHONIA LIGHTING	LJL LED 30K MVOLT	LIL WALLPACK (STANDARD)	LIL_LED_30K_MVOLT.ies	8'-0" ABOVE GRADE ON BUILDING
EXAMPLE LIGHT FIXTURE DISTRIBUTION							
ISOLUX CONTOUR = 0.5 FC							

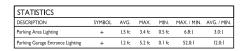


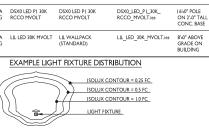


(IN FEET) I INCH = 20 FT (24X36 PAPER)

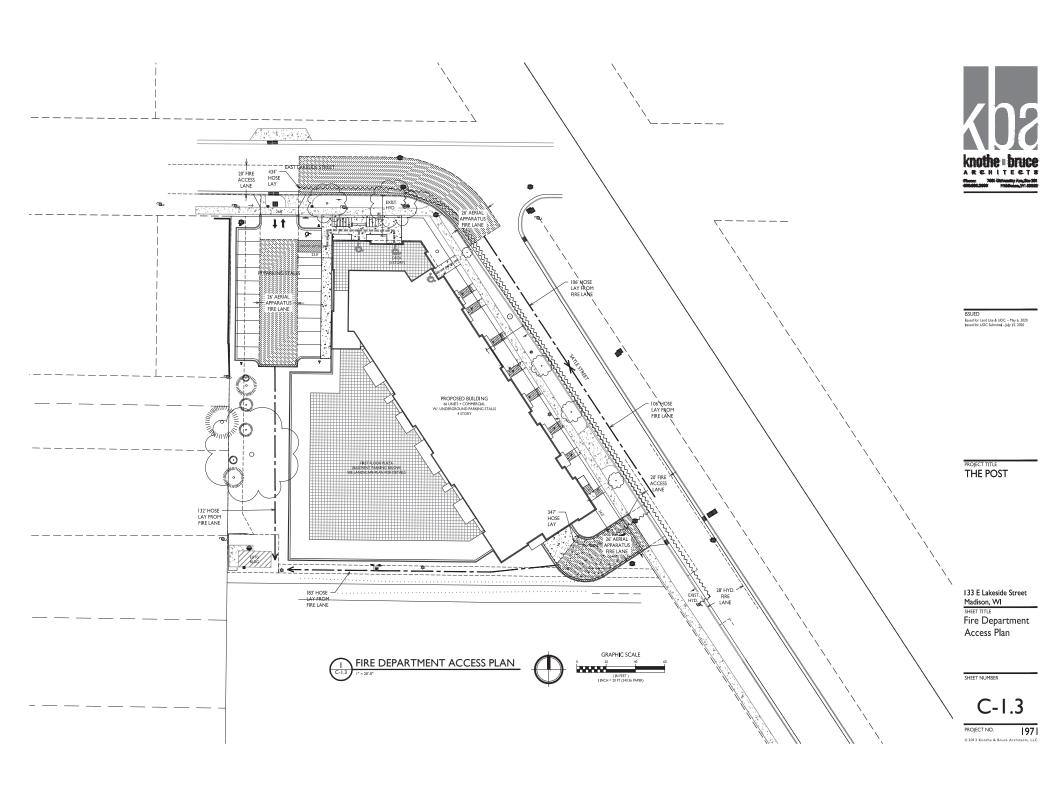


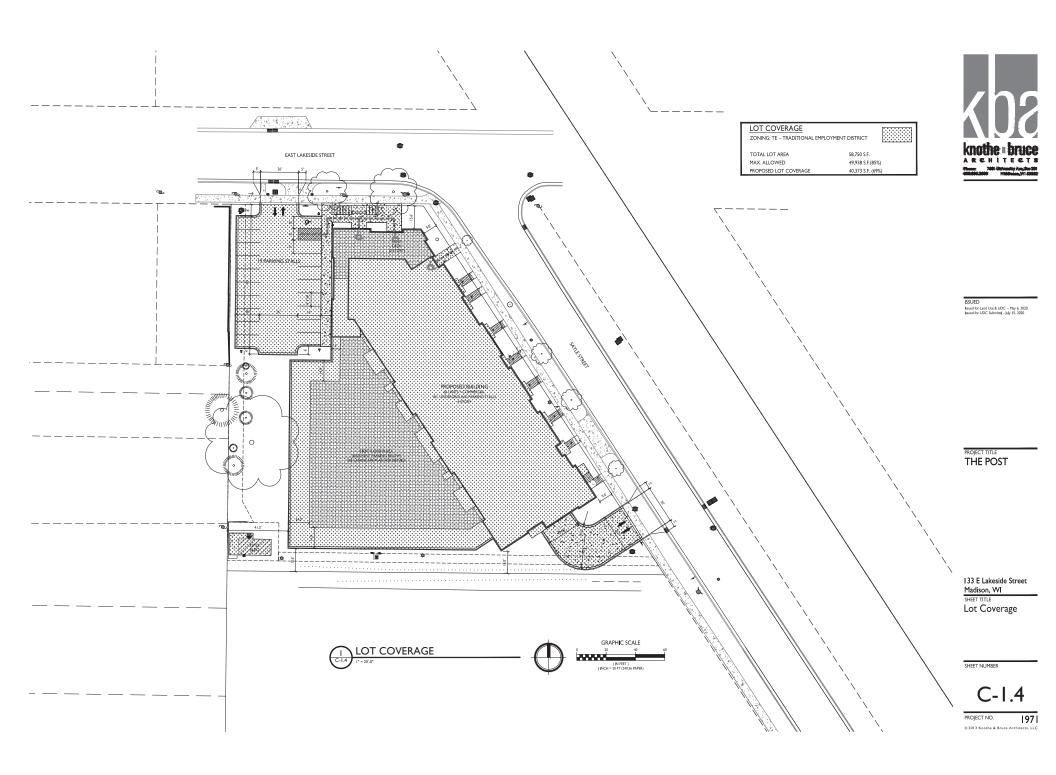

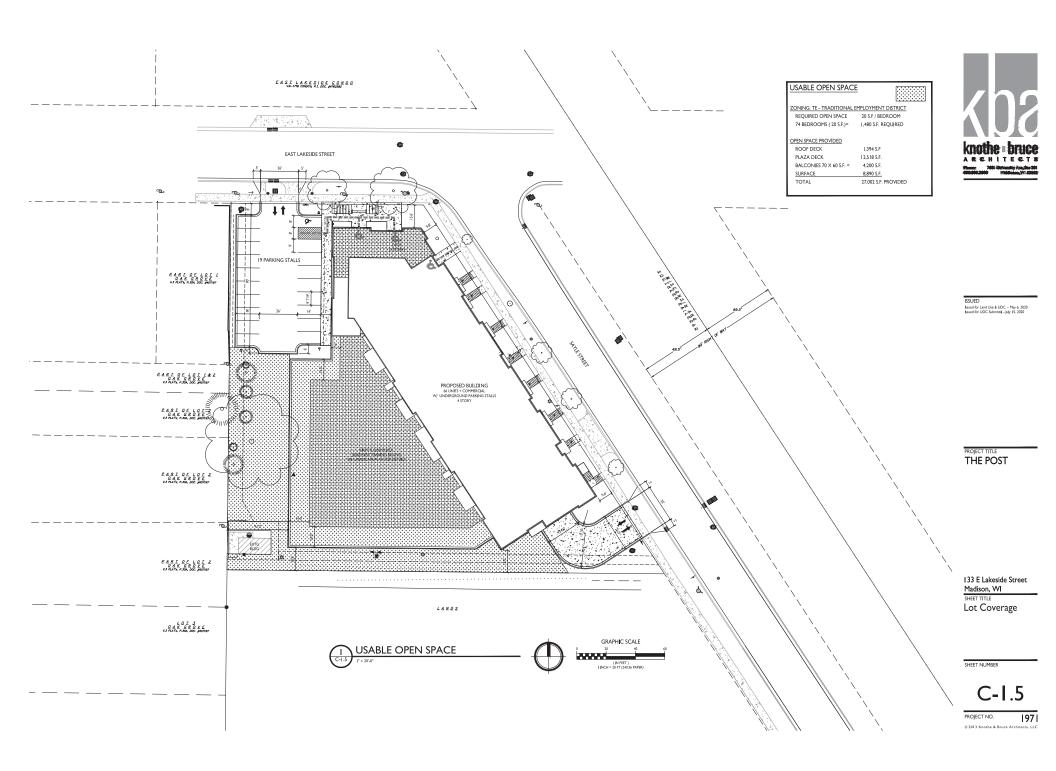


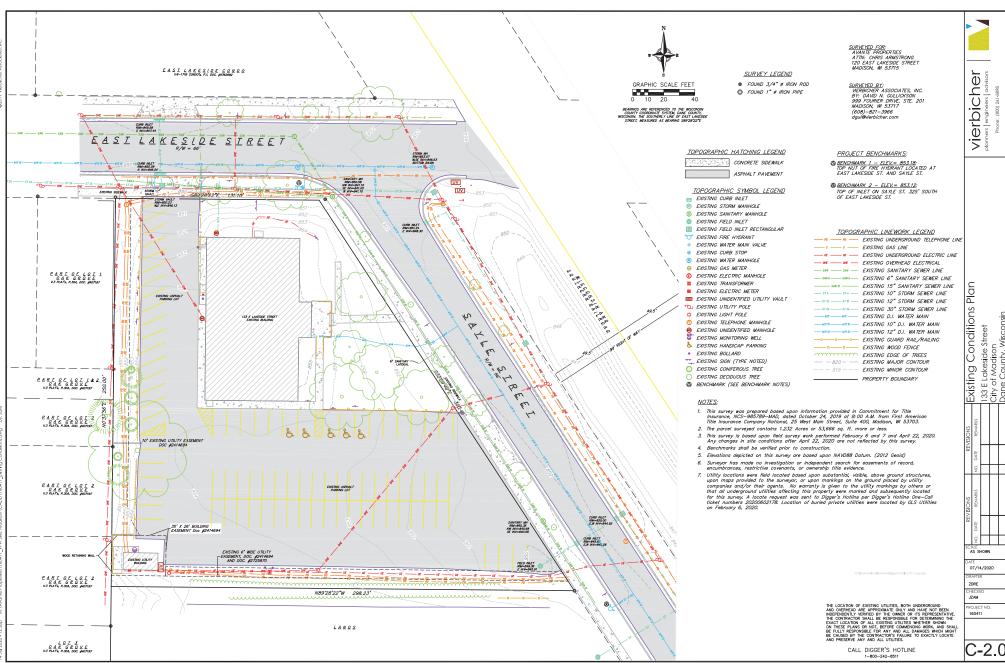



133 E Lakeside Street City of Madison Dane County, Wiscons 07/14/2020 ZORE PO JECT NO

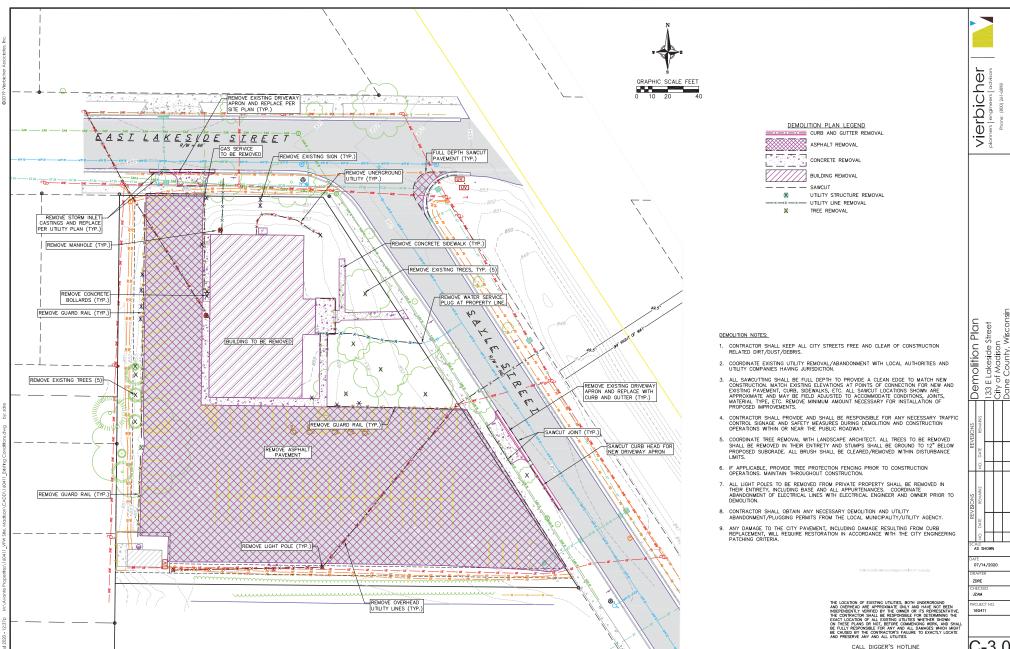



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GENERAL NOTES

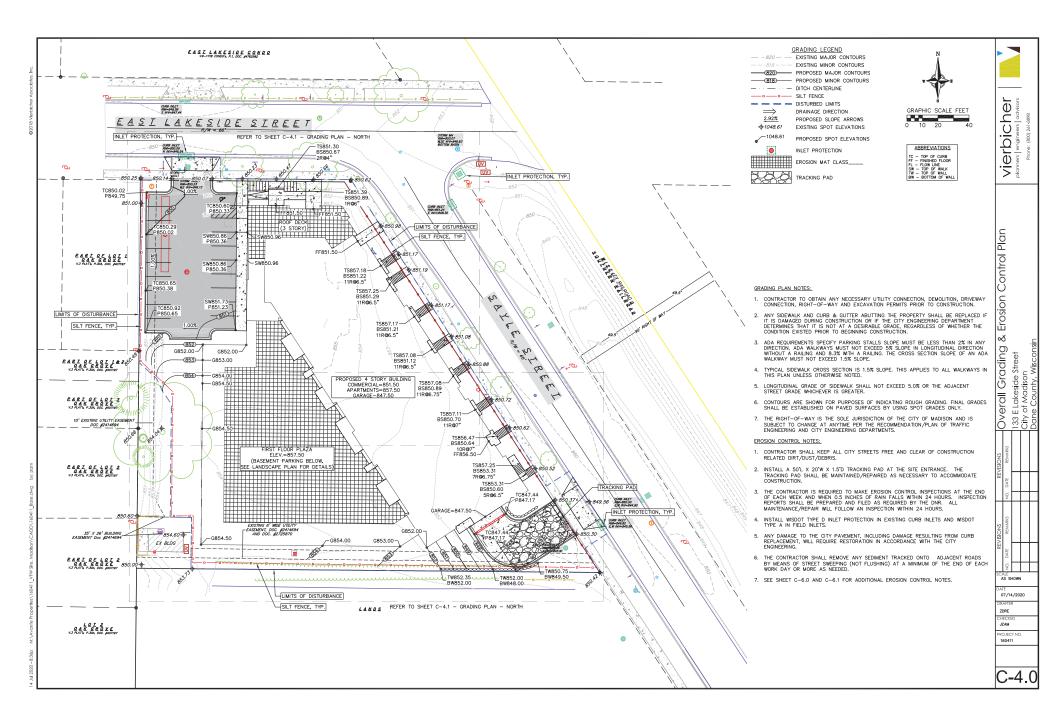Plant Material List

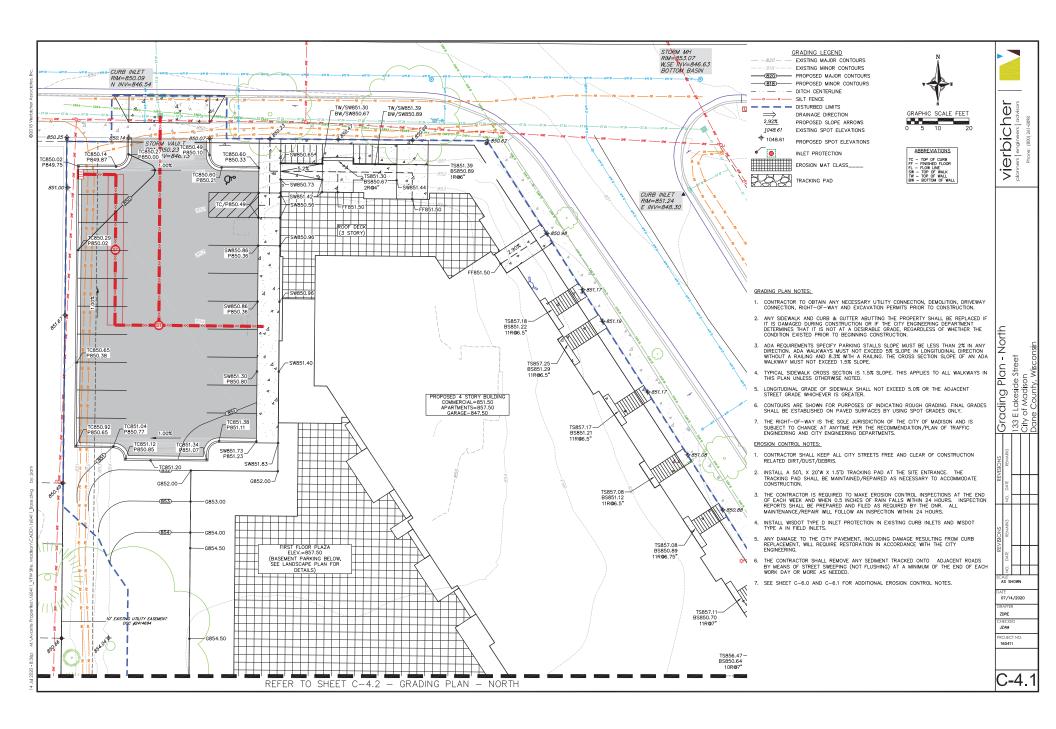Broadleaf Dec	iduous			
Quantity	Code Name	Common Name	Scientific Name	Planting Size
3	RPM	Redpointe Red Maple	Acer Rubrum 'frank Jr.'	2" B&B
4	AHH	Amer Hornbeam	Carpinus Caroliniana	2 I/2" B&B
1	CHB	Common Hackberry	Celtis Occidentalis	2" B&B
3	TCHT	Thnls Cockspur Hawthorn (tf)	Crataegus Crus-Galli Var Iner (tf)	2" B&B
5	GPO	Green Pillar Pin Oak	Quercus Palustris 'pringreen'	2" B&B
1	RO	Red Oak	Quercus Rubra	2 I/2" B&B
Conifer Everg	reen			
Quantity	Code Name	Common Name	Scientific Name	Planting Size
19	MBJ	Mountbatten Juniper	Juniperus Chinen 'mountbatten'	5' B&B
3	DAR	Danica Arborvitae	Thuja Occidentalis 'danica'	#3 CONT.
Perennial				
Quantity	Code Name	Common Name	Scientific Name	Planting Size
43	KFG	Karl Foerster's Feather Reed Grass	Calamagrostis Acutiflora 'karl Foerster'	#I CONT.
12	SBOG	Sapphire Blue Oat Grass	Helictotrichon Sempervirens 'saphirsprudel'	#I CONT.
25	GBES	Goldsturm Black-Eyed Susan	Rudbeckia Ful Var Sullivan 'goldsturm'	#I CONT.
79	PRD	Prairie Dropseed	Sporobolus Heterolepis	#I CONT.
Shrub				
Quantity	Code Name	Common Name	Scientific Name	Planting Size
21	GBC	Glossy Black Chokeberry	Aronia Melanocarpa Var Elata	#5 CONT.
14	TWN	Tiny Wine Ninebark	Physocarpus Opulifolius 'smpotw'	#3 CONT.
15	LJAV	Little Joe Arwd Viburnum	Viburnum Dentatum 'klmseventeen'	#5 CONT.
10	NV	Nannyberry Viburnum	Viburnum Lentago	4' B&B

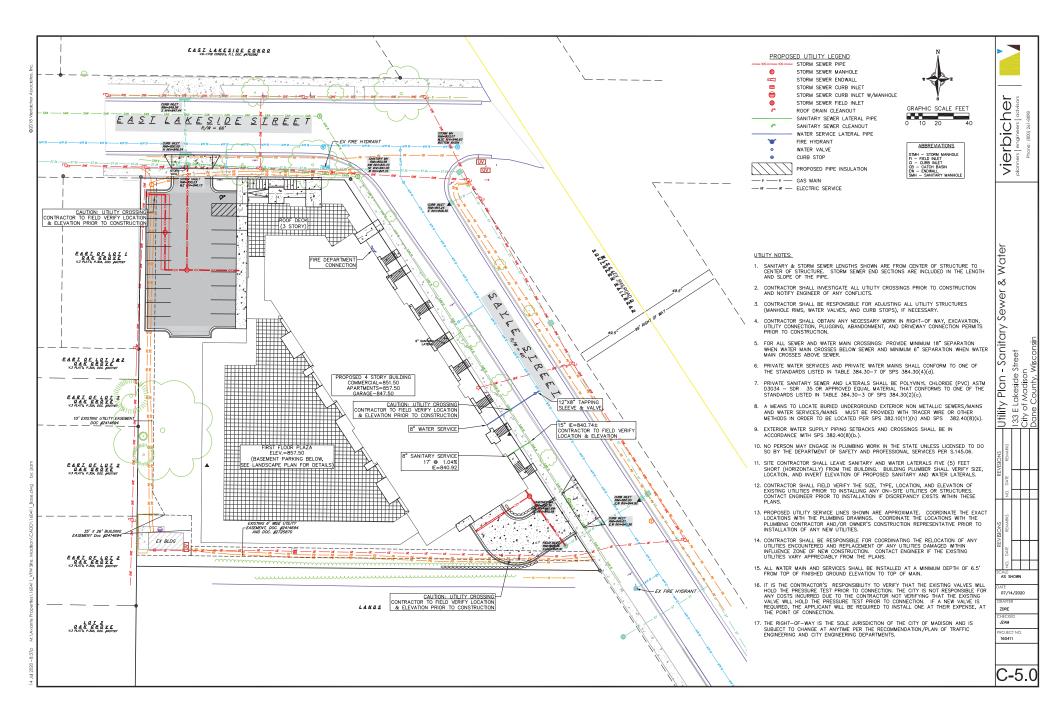MADISON LANDSCAPE WORKSHEET

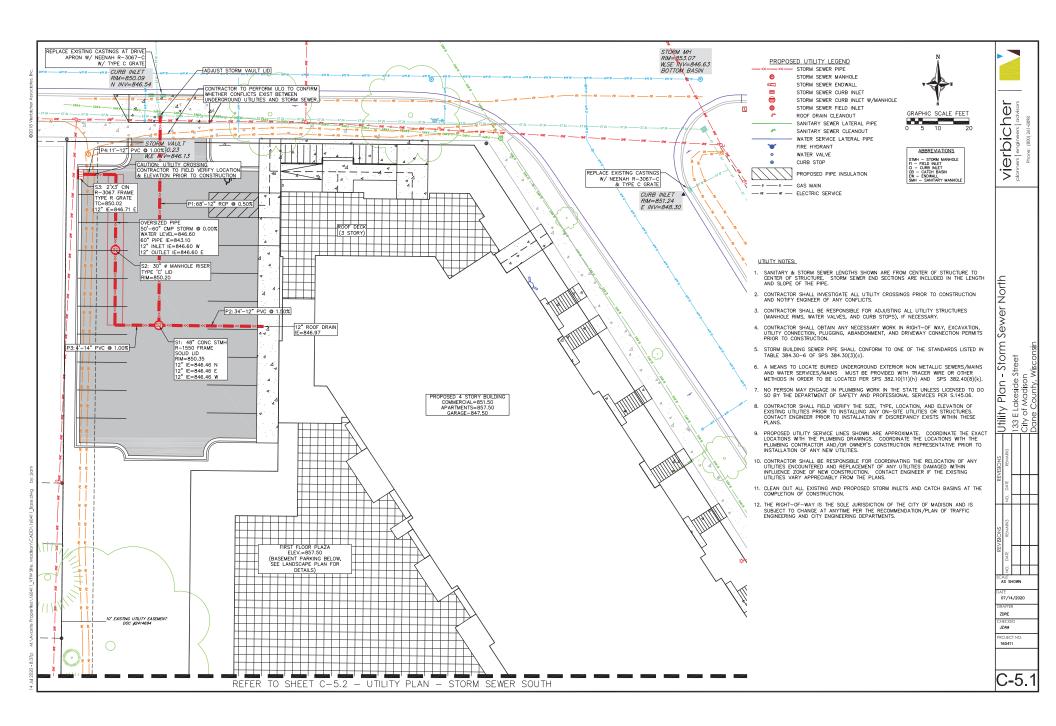	Point	N	EW	EXIS	TING	
PLANT TYPE or ELEMENT	Value	Qty.	Points Achieved	Qty.	Points Achieved	
Overstory Deciduous Tree : 2-1/2" (dbh)	35	14	420	- 1	35	
Tall Evergreen Tree : 5-6 feet tall	35	0	0	2	70	
Ornamental Tree : I-I/2" Caliper (dbh)	15	3	45			
Upright Evergreen Shrub : 3-4 feet tall	10	19	190			
Shrub, deciduous : 3 gallon / 12"-24"	3	60	180			
Shrub, evergreen : 3 gallon / 12"-24"	4	3	12			
Ornamental grass/perennial :l gallon / 8"-18"	2	159	318			
Ornamental / Decorative fencing or wall	4 per 10 l.f.					
Existing significant specimen tree	l 4 per Cal. In.					TOTAL
Landscape furniture for public seating and /or transit connections	5 per 'seat'					POINTS PROVIDED
	Sub	Totals	1.165	+	105	= 1270

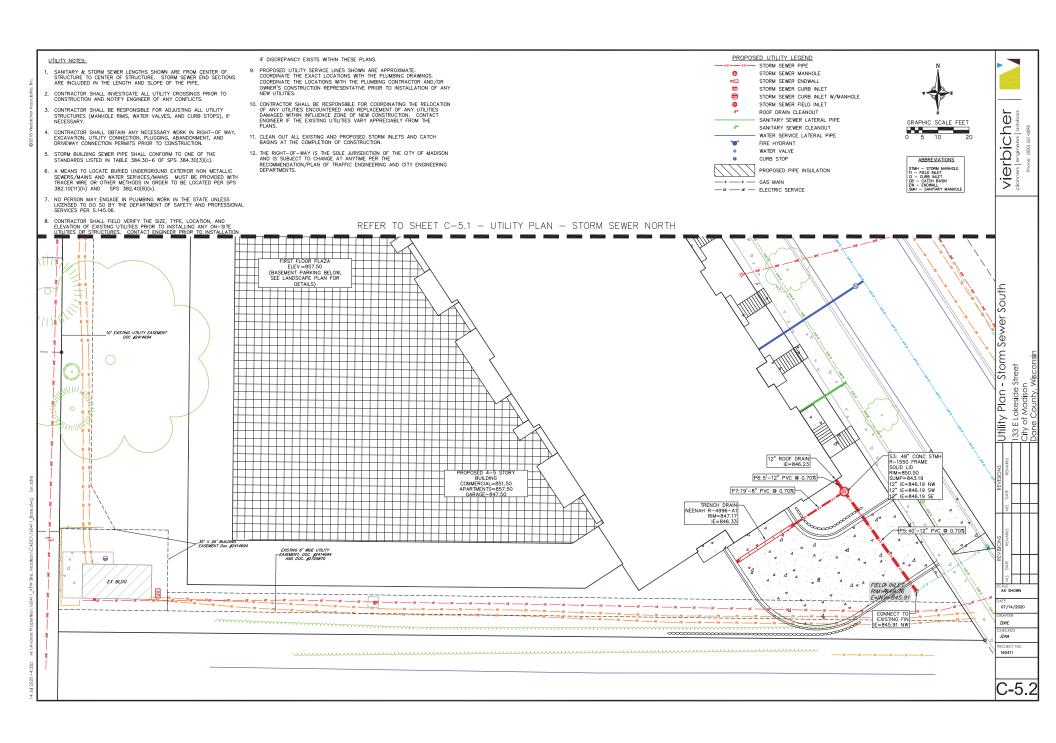Street Frontage Landscape Required
Street Frontage =
Street Frontage Landscape Supplied
Proposed Canopy Trees = 15.5 Proposed Shrubs = 82





LANDSCAPE ARCHITECTS
LANDSCAPE CONTRACTOR:
280 PARAMETER STREET
P.O. BOX & 503301
TEL (660) 383 - 7041
FAX (603) 383 - 5046

133 EAST LAKESIDE STREET 133 EAST LAKESIDE STREET MADISON, WISCONSIN 53715

Checked By: SS Drawn By: 5/01/20 RS

Revised: 7/15/20 RS Revised: ----Revised: Revised: Revised:

Revised: Revised: Revised: Revised: Revised: Revised:

L-1.1








PROJECT TITLE
THE POST

133 E. Lakeside Street Madison, WI

SHEET TITLE
BASEMENT
FLOOR PLAN

SHEET NUMBER

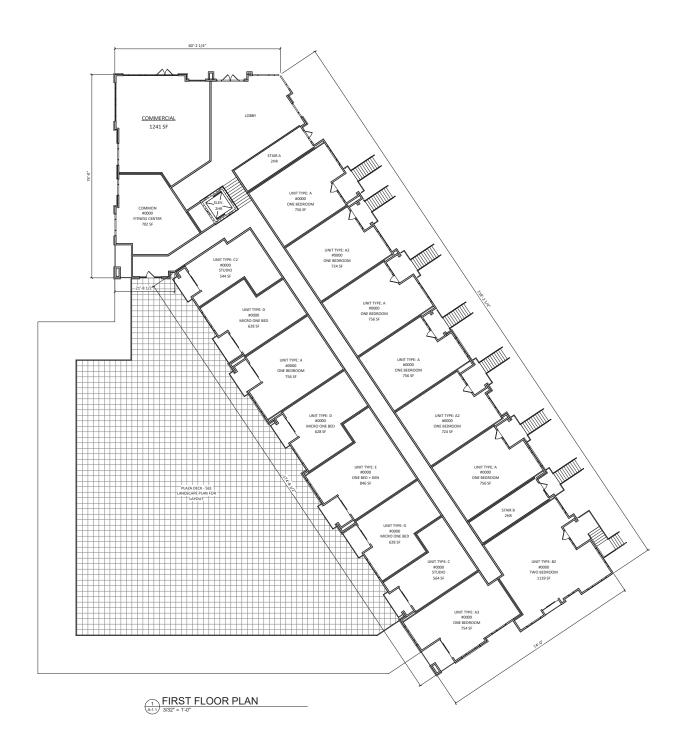



PROJECT TITLE
THE POST

133 E. Lakeside Street Madison, WI SHEET TITLE FIRST FLOOR PLAN

SHEET NUMBER





PROJECT TITLE
THE POST

133 E. Lakeside
Street Madison, WI
SHEET TITLE
SECOND FLOOR
PLAN

SHEET NUMBER

A-1.2

PROJECT NUMBER 1971
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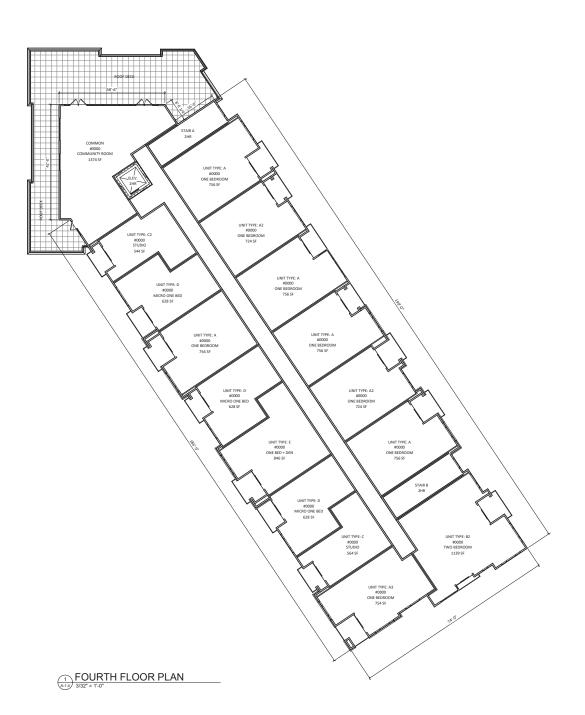




PROJECT TITLE
THE POST

133 E. Lakeside Street Madison, WI SHEET TITLE THIRD FLOOR PLAN

SHEET NUMBER






PROJECT TITLE
THE POST

133 E. Lakeside Street Madison, WI SHEET TITLE FOURTH FLOOR PLAN

SHEET NUMBER

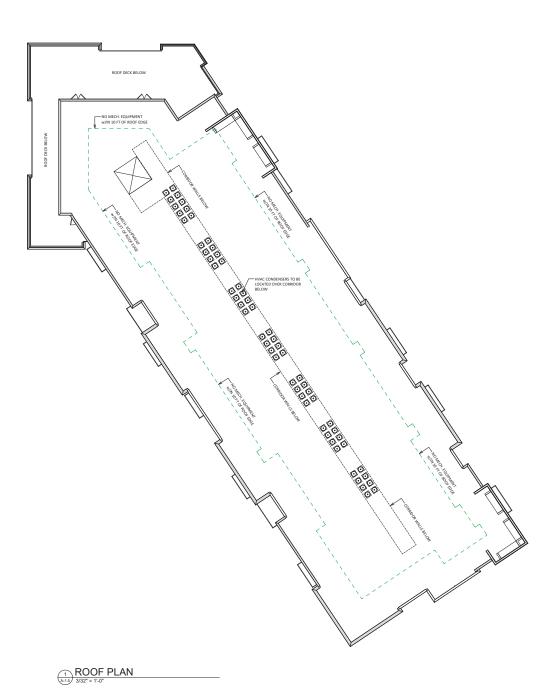



PROJECT TITLE
THE POST

133 E. Lakeside Street Madison, WI SHEET TITLE ROOF PLAN

SHEET NUMBER



NORTH EAST ELEVATION

1/8" = 1'-0"

ALMANUM STORERONT

ALMANUM STORE

PROJECT TITLE
THE POST

133 E. Lakeside
Street Madison, WI

SHEET TITLE
EXTERIOR
ELEVATIONS

SHEET NUMBER

A-2.1

PROJECT NUMBER 1971

EXTERIOR MATERIAL SCHEDULE				
BUILDING ELEMENT MANUFACTURER COLOR				
ACM PANEL - (#1)	COATED METALS GROUP	BONE WHITE		
ACM PANEL - (#2)	COATED METALS GROUP	SLATE GRAY		
4" HORIZONTAL PANEL - (#3)	LONGBOARD	DARK CHERRY		
BRICK VENEER	INTERSTATE BRICK	ASH - MODULAR		
COMPOSITE WINDOWS	TBD	BLACK		
ALUM. STOREFRONT	TBD	BLACK		
ALUMINUM RAILINGS W/ GLASS PANEL	TBD	BLACK RAILING - REFLECTIVE GLASS PANEL		





THEO FLOOR

SECOND FLOOR

SECO

EXTERIOR MATERIAL SCHEDULE				
BUILDING ELEMENT MANUFACTURER COLOR				
ACM PANEL - (#1)	COATED METALS GROUP	BONE WHITE		
ACM PANEL - (#2)	COATED METALS GROUP	SLATE GRAY		
4" HORIZONTAL PANEL - (#3)	LONGBOARD	DARK CHERRY		
BRICK VENEER	INTERSTATE BRICK	ASH - MODULAR		
COMPOSITE WINDOWS	TBD	BLACK		
ALUM. STOREFRONT	TBD	BLACK		
ALUMINUM RAILINGS W/ GLASS PANEL	TBD	BLACK RAILING - REFLECTIVE GLASS PANEL		

PROJECT TITLE
THE POST

133 E. Lakeside
Street Madison, WI


SHEET TITLE
EXTERIOR
ELEVATIONS


SHEET NUMBER

A-2.2

PROJECT NUMBER 1971



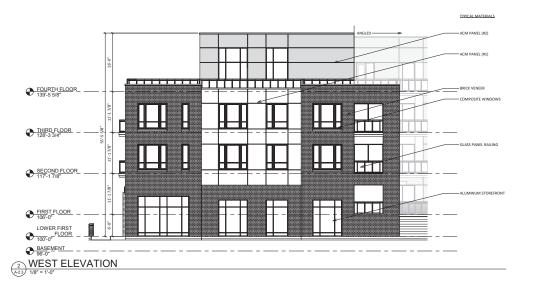

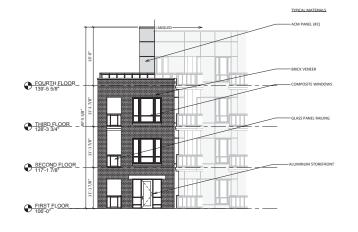

	⊕ BASEMENT
1	SOUTH ELEVATION
A-2.3	1/8" = 1'-0"

EXTERIOR MATERIAL SCHEDULE			
BUILDING ELEMENT MANUFACTURER COLOR			
ACM PANEL - (#1)	COATED METALS GROUP	BONE WHITE	
ACM PANEL - (#2)	COATED METALS GROUP	SLATE GRAY	
4" HORIZONTAL PANEL - (#3)	LONGBOARD	DARK CHERRY	
BRICK VENEER	INTERSTATE BRICK	ASH - MODULAR	
COMPOSITE WINDOWS	TBD	BLACK	
ALUM. STOREFRONT	TBD	BLACK	
ALUMINUM RAILINGS W/ GLASS PANEL	TBD	BLACK RAILING - REFLECTIVE GLASS PANEL	

PROJECT TITLE
THE POST

133 E. Lakeside Street Madison, WI SHEET TITLE EXTERIOR ELEVATIONS

SHEET NUMBER



knothebrace.com 608.838.3890 2601 University Ave. + Suite 201 + Middleton, W1 53562 KEY PLAN

NORTH EAST ELEVATION - COLOR



EXTERIOR MATERIAL SCHEDULE				
BUILDING ELEMENT	MANUFACTURER	COLOR		
ACM PANEL - (#1)	COATED METALS GROUP	BONE WHITE		
ACM PANEL - (#2)	COATED METALS GROUP	SLATE GRAY		
4" HORIZONTAL PANEL - (#3)	LONGBOARD	DARK CHERRY		
BRICK VENEER	INTERSTATE BRICK	ASH - MODULAR		
COMPOSITE WINDOWS	TBD	BLACK		
ALUM. STOREFRONT	TBD	BLACK		
ALUMINUM RAILINGS W/ GLASS PANEL	TBD	BLACK RAILING - REFLECTIVE GLASS PANEL		

PROJECT TITLE THE POST

133 E. Lakeside Street Madison, WI SHEET TITLE **EXTERIOR ELEVATIONS -**COLOR

SHEET NUMBER





PROJECT TITLE
THE POST

THE POST

133 E. Lakeside Street Madison, WI SHEETTITLE EXTERIOR ELEVATIONS -COLOR

SHEET NUMBER

A-2.5


PROJECT NUMBER 1971



EXTERIOR MATERIAL SCHEDULE				
BUILDING ELEMENT	MANUFACTURER	COLOR		
ACM PANEL - (#1)	COATED METALS GROUP	BONE WHITE		
ACM PANEL - (#2)	COATED METALS GROUP	SLATE GRAY		
4" HORIZONTAL PANEL - (#3)	LONGBOARD	DARK CHERRY		
BRICK VENEER	INTERSTATE BRICK	ASH - MODULAR		
COMPOSITE WINDOWS	TBD	BLACK		
ALUM. STOREFRONT	TBD	BLACK		
ALUMINUM RAILINGS W/ GLASS PANEL	TBD	BLACK RAILING - REFLECTIVE GLASS PANEL		





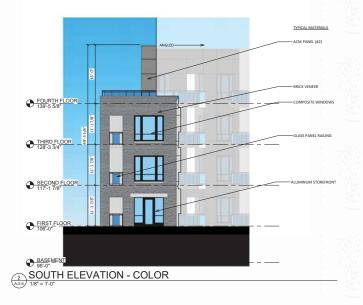

PROJECT TITLE				
PROJECT TITLE				
	PROJE	CT TI	TLE	

BUILDING ELEMENT	MANUFACTURER	COLOR	
ACM PANEL - (#1)	COATED METALS GROUP	BONE WHITE	
ACM PANEL - (#2)	COATED METALS GROUP	SLATE GRAY	
1" HORIZONTAL PANEL - (#3)	LONGBOARD	DARK CHERRY	
BRICK VENEER	INTERSTATE BRICK	ASH - MODULAR	
COMPOSITE WINDOWS	TBD	BLACK	
ALUM. STOREFRONT	TBD	BLACK	
ALUMINUM RAILINGS W/ GLASS PANEL	TBD	BLACK RAILING - REFLECTIVE GLASS PANEL	

133 E. Lakeside Street Madison, WI SHEET TITLE EXTERIOR ELEVATIONS -COLOR

SHEET NUMBER

A-2.6
PROJECT NUMBER 1971



Knothe • bruce





























SPRING - 12PM

SPRING - 4PM







SUMMER - 7AM

SUMMER - 12PM

SUMMER - 5PM





















WINTER - 9AM

WINTER - 12PM

WINTER - 3PM

