LAND USE APPLICATION - INSTRUCTIONS & FORM



City of Madison Planning Division Madison Municipal Building, Suite 017 215 Martin Luther King, Jr. Blvd. P.O. Box 2985 Madison, WI 53701-2985 (608) 266-4635



FOR OFFICE USE ONLY:	
Paid Rec	ceipt #
Date received	
Received by	
☐ Original Submittal ☐	Revised Submittal
Parcel #	RECEIVED
Aldermanic District	
Zoning District	
Special Requirements	12:23 p.m.
Review required by	
□ UDC □	PC
□ Common Council □	Other
Reviewed By	

	Parcel #
All Land Use Applications must be filed with the	Aldermanic District
Zoning Office at the above address.	Zoning District
This completed form is required for all applications	Special Requirements 12:23 p.m.
for Plan Commission review except subdivisions or land divisions, which should be filed using the	Review required by
Subdivision Application found on the City's web site.	_
(http://www.cityofmadison.com/development-services-	□ UDC □ PC □ Common Council □ Other
center/documents/SubdivisionApplication.pdf)	
	Reviewed By
APPLICATION FORM	
1. Project Information	
Address:	
Title:	
2. This is an application for (check all that apply)	
Zoning Map Amendment (Rezoning) from	to
	lopment-General Development Plan (PD-GDP) Zoning
Major Amendment to an Approved Planned Deve	•
Review of Alteration to Planned Development (PD	
Conditional Use or Major Alteration to an Approve	ed Conditional Use
Demolition Permit	
Other requests	
3. Applicant, Agent and Property Owner Informatio	ın
	Company
Street address	City/State/Zip
	Email
Project contact person	Company
Street address	City/State/Zip
Telephone	Email
Property owner (if not applicant)	
Street address	City/State/Zip
Telephone	Email
M:\Planning Division\Commissions & Committees\Plan Commission\Administration\Af	PPLICATION - MARCH 2019 PAGE 3 OF 6

LAND USE APPLICATION - INSTRUCTIONS & FORM



4. Required Submittal Materials

Pursuant to Section 28.181(4), MGO, no application is complete unless all required information is included and all application fees have been paid. The Zoning Administrator may reject an incomplete application. Use this checklist to prepare a complete Land Use Application. Note: Not all development plan materials listed below are required for all applications. Submittal materials are as determined by staff. Those application types which have specific additional submittal requirements, as noted below, are outlined in Land Use Application Form LND-B (https://www.cityofmadison.com/dpced/bi/documents/LUAChecklist.pdf).


Req.	Required Submittal Information	Contents	No. of Copies	✓
	Filing Fee (\$ 1150)	Refer to the Fee Schedule on Page 6. Make checks payable to City Treasurer.	1	
	Land Use Application	Forms must include the property owner's authorization.	1	
	Legal Description (For Zoning Map Amendments only)	Legal description of the property, complete with the proposed zoning districts and project site area in square feet and acres.	1	
	Pre-Application Notification	Proof of written 30-day notification to alder, neighborhood association, and business associations. In addition, Demolitions require posting notice of the requested demolition to the City's Demolition Listserv at least 30 days prior to submitting an application. For more information, see Page 1 of this application.		
	Letter of Intent (LOI)	Narrative description of the proposal in detail, including, but not limited to, the existing site conditions, project schedule, phasing plan, proposed uses, hours of operation, number of employees, gross square footage, number of units and bedrooms, public subsidy requested, project team, etc.		
		** When submitting, you must collate the Letters of Intent with the Development Plans **		
	Development Plans	Twenty-Eight (28) <u>legible</u> & <u>scaled</u> 11" x 17" copies, collated and stapled.	28	
	Site Plan			
	Survey or site plan of existing conditions	** When submitting, you must collate the Letters of Intent with the Development Plans **		
	Grading Plan			
	Utility Plan	For a detailed list of the content requirements for each of these plan sheets,		
	Landscape Plan and Landscape Worksheet	please see Land Use Application Form LND-B (https://www.cityofmadison.com/ dpced/bi/documents/LUAChecklist.pdf)		
	Building Elevations	apeca/ bi/ abcuments/ Lone neckilst.par.		
	Roof and Floor Plans			
	Fire Access Plan and Fire Access Worksheet			
	Supplemental Requirements (Based on Application Type)	Additional materials are required for the following application types noted below. Please see Land Use Application Form LND-B (https://www.cityofmadison.com/dpced/bi/documents/LUAChecklist.pdf) for a detailed list of the submittal requirements for these application types.		
		The following Conditional Use Applications: □ Lakefront Developments □ Outdoor Eating Areas □ Development Adjacent to Public Parks □ Demolition Permits □ Modifications to Parking Requirements (i.e. Parking Reductions or Exceeding the Maximum) □ Development Within Downtown Core (DC) and Urban Mixed-Use (UMX) Zoning Districts □ Zoning Map Amendments (i.e. Rezonings) □ Planned Development General Development Plans (GDPs) / Planned Development Specific Implementation Plans (SIPs)		
	Digital Copies of all Submitted Materials	Digital copies of all items, submitted in hard copy are required. All development plan set sheets must be scalable to full- and half-size sheets. Individual PDF files of each item submitted should be compiled on a CD or flash drive, or in an email to pcapplications@cityofmadison.com . The email must include the project address, project name, and applicant name. Electronic submittals via file hosting services (such as Dropbox.com) are not allowed. Applicants who are unable to provide the materials electronically should contact the Planning Division at (608) 266-4635 for assistance.	1	4 OE 6

LAND USE APPLICATION - INSTRUCTIONS & FORM



APPLICATION FORM (CONTINUED)

5. Pro	oject Description	
Pro	ovide a brief description of the project and all proposed uses of the site	e:
Co	onstruction of a mixed-use development with two four story apartment	buildings with 188 units total.
Pro	pposed Dwelling Units by Type (if proposing more than 8 units):	
	Efficiency: 33 1-Bedroom: 102 2-Bedroom: 53 2-3	
	Density (dwelling units per acre): 561 S.F./D.U. Lot Size (in squa	re feet & acres): 105,375 S.F. / 2.419 acres
Pro	pposed On-Site Automobile Parking Stalls by Type (if applicable): 1 b	
	Surface Stalls: 38 Under-Building/Structured:	193
Pro	posed On-Site Bicycle Parking Stalls by Type (if applicable):	(40)
	Indoor: 168 Outdoor: 24 (visitors and commer	
Sch	neduled Start Date: Phase 1 is Spring of 2021 Planned Com	pletion Date: Spring of 2022
1,00	plicant Declarations	
	Pre-application meeting with staff . Prior to preparation of this applicatio the proposed development and review process with Zoning and Plannin	• • • • • • • • • • • • • • • • • • • •
	Planning staff Kevin Firchow	Date 3/24/2020
	Zoning staff Jenny Krichgatter	Date_3/24/2020
	Demolition Listserv (https://www.cityofmadison.com/developmentCenter/	demolitionNotification/notificationForm.cfm).
	Public subsidy is being requested (indicate in letter of intent)	
	Pre-application notification : The zoning code requires that the applineighborhood and business associations in writing no later than 30 of the pre-application notification or any correspondence granting neighborhood association(s), business association(s), AND the dates	Didays prior to FILING this request. Evidence gray a waiver is required. List the alderperson,
	District Alder District 15 Alder Grant Foster	Date_6/8/2020
	Neighborhood Association(s) Lake Edge and East Morland	Date 6/8/2020
	Business Association(s)	Date
The a	pplicant attests that this form is accurately completed and all require	ed materials are submitted:
Name	e of applicant <u>Joe Krupp</u> Relation	nship to property <u>Owner</u>
Autho	prizing signature of property owner	Date 7-7-20

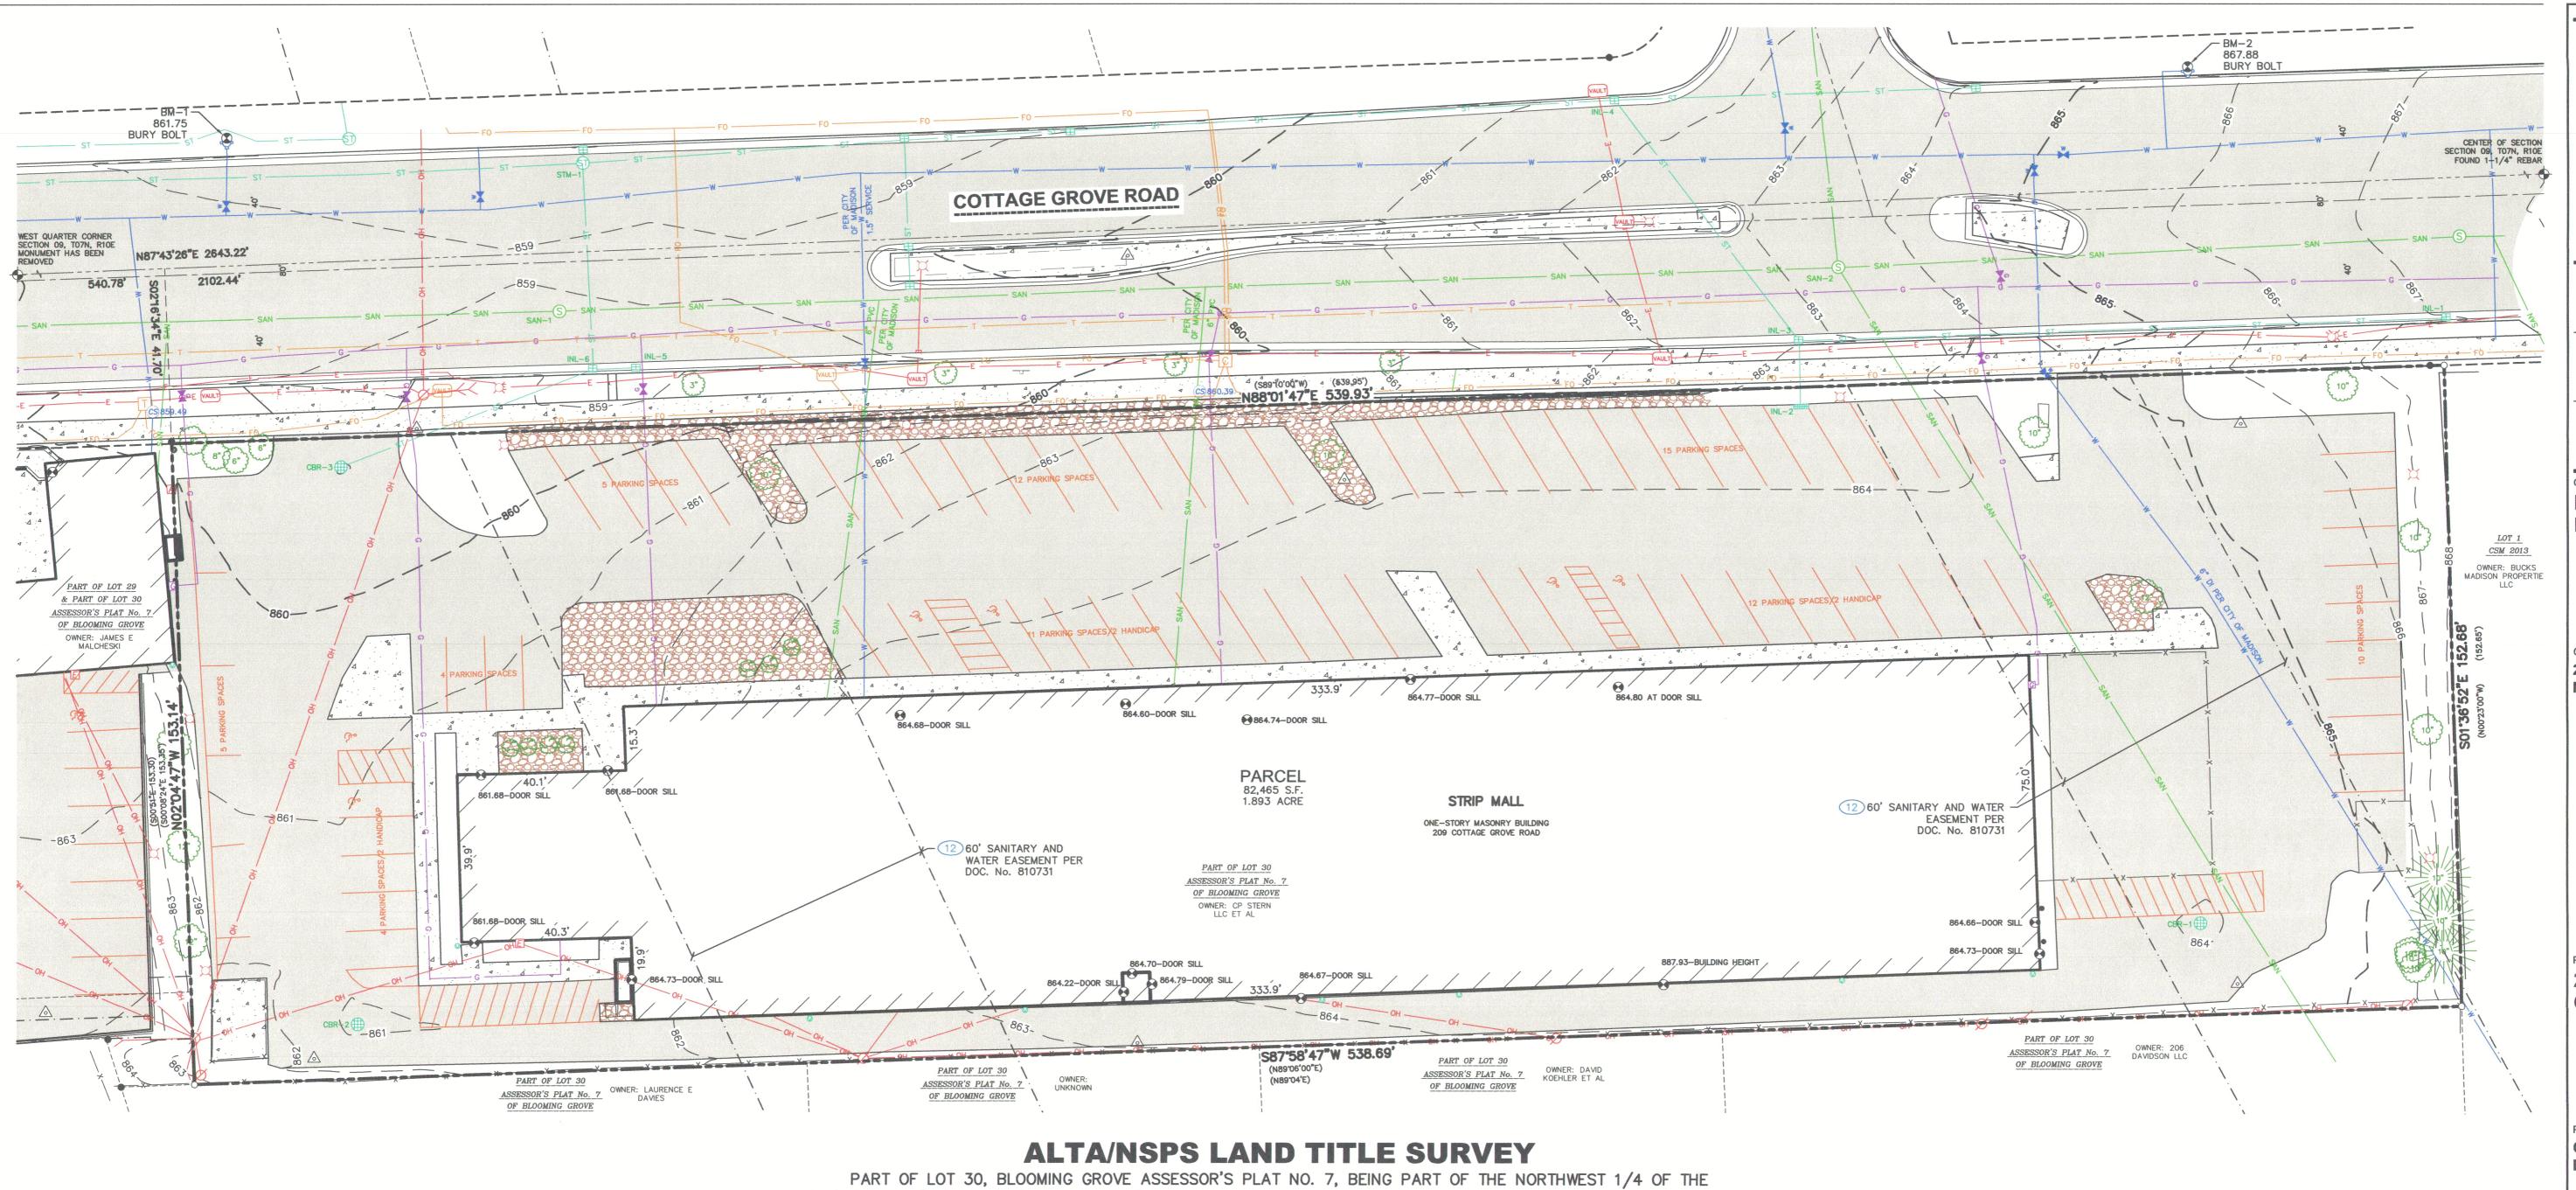

SOUTHWEST 1/4 OF SECTION 09, TOWNSHIP 07 NORTH, RANGE 10 EAST, CITY OF MADISON, DANE COUNTY, WISCONSIN,

E	Œ	ND)

BUSH

---- CENTERLINE

HANDICAP PARKING

0	3/4" x 24" REBAR SET (1.50 LBS/LF)	RIGHT-OF-WAY LINE	
*	GOVERNMENT CORNER	SECTION LINE	
	¾" REBAR FOUND	PARCEL BOUNDARY	
A	CONTROL POINT	PROPERTY LINE	
	BENCHMARK	EASEMENT LINE	
$oldsymbol{\Theta}$	FINISHED FLOOR SHOT LOCATION	LANDSCAPE LIMITS	
-0-	SIGN	-x-x- FENCE LINE	
S	SANITARY MANHOLE	EDGE OF PAVEMENT	
©	CLEAN OUT	CONCRETE CURB & GUTTER	
W G	WATERMAIN OR GASMAIN VALVE	EDGE OF GRAVEL	
0	HYDRANT		
(CS)	CURB STOP/SERVICE VALVE		
ST	STORM MANHOLE	ST STORM SEWER	

ROUND CASTED INLET -----G---- NATURAL GAS SQUARE CASTED INLET CURB INLET --- E --- UNDERGROUND ELECTRIC O DOWNSPOUT ----FO----- FIBER OPTIC G GAS REGULATOR/METER ----OT---- OVERHEAD TELEPHONE ELECTRIC METER --- I --- UNDERGROUND TELEPHONE AIR CONDITION UNIT /////// BUILDING LIGHT POLE ----- WALL LINE POWER POLE W/GUY ---875--- INDEX CONTOUR VAULT VAULT ---874--- INTERMEDIATE CONTOUR TELEPHONE PEDESTAL BITUMINOUS PAVEMENT CABLE PEDESTAL DECIDUOUS TREE CONCRETE PAVEMENT CONIFEROUS TREE GRAVEL

> ----- EDGE OF BITUMINOUS PAVEMENT STRIPING () DENOTES RECORD DATA DEPICTING THE SAME LINE ON THE GROUND AS RETRACED BY THIS SURVEY

	STORM	SEWER	MANHOLE	S	
STRUCT. ID	RIM ELEVATION	INVERT	ELEVATION	PIPE SIZE	PIPE TYPE
STM-1	858.30	W	853.82	18"	RCP
		E	853.82	18"	RCP
		S	854.07	15"	RCP

SANITARY SEWER MANHOLES					
STRUCT. ID	RIM ELEVATION	INVERT	ELEVATION	PIPE SIZE	PIPE TYPE
SAN-1	858.84	W	850.30	10"	PVC
		E	850.20	10"	PVC
SAN-2	863.34	N	845.63	15"	PVC
		W	847.82	10"	PVC
		S	846.02	10"	CIPP
		E	845.63	15"	PVC

	STORI	M SEWER	RINLETS		
INLET ID	RIM ELEVATION	INVERT	ELEVATION	PIPE SIZE	PIPE TYP
CBR-1	863.88	*	_	-	_
CBR-2	860.73	*	_	_	
INL-1	866.79	W	862.50	12"	RCP
INL-2	863.42	N	862.32	8"	PVC
INL-3	862.52	S	860.12	8"	PVC
		Е	860.27	12"	RCP
		NW	859.55	18"	RCP
INL-4	861.30	SE	856.75	18"	RCP
		E	857.45	12"	RCP
		W	856.75	18"	RCP
CBR-3	858.95	NE*	_	12"	VCP
INL-5	858.25	W	855.14	12"	RCP
INL-6	858.25	N	855.63	15"	RCP
		E	855.67	12"	RCP
		SW	855.57	12"	VCP

- 1. BEARINGS FOR THIS SURVEY AND MAP ARE REFERENCED TO THE WISCONSIN COUNTY COORDINATE SYSTEM, DANE COUNTY ZONE; THE NORTH LINE OF THE SOUTHWEST QUARTER OF SECTION 09 BEARS N87°44'31"E.
- 2. ELEVATIONS ARE BASED ON THE NORTH AMERICAN VERTICAL DATUM OF 1988 (NAVD88). BENCHMARK IS A BRASS MONUMENT MARKING THE NORTHWEST CORNER OF SECTION 09, T07N, R10E, ELEVATION = 854.08'
- 3. CONTOUR INTERVAL IS ONE FOOT.
- 4. SUBSURFACE UTILITIES AND FEATURES SHOWN ON THIS MAP HAVE BEEN APPROXIMATED BY LOCATING SURFICIAL FEATURES AND APPURTENANCES, LOCATING DIGGERS HOTLINE FIELD MARKINGS AND BY REFERENCE TO UTILITY RECORDS AND MAPS. DIGGER'S HOTLINE LOCATE TICKET NO. 20201712762 AND 20201712822, WITH A CLEAR DATE OF APRIL 24, 2020, AND DIGGER'S HOTLINE PRINTS TICKET NO. 20201712842, WITH A CLEAR DATE OF MAY 01, 2020.
- 5. UTILITY COMPANIES CONTACTED THRU DIGGERS HOTLINE: CITY OF MONONA AT&T DISTROBUTION

CITY OF MADISON ENGINEERING TDS METROCOM MADISON METRO SEWERAGE DIST CHARTER COMMUNICATIONS MADISON GAS & ELECTRIC

- 6. BEFORE EXCAVATION, APPROPRIATE UTILITY COMPANIES SHOULD BE CONTACTED. FOR EXACT LOCATION OF UNDERGROUND UTILITIES, CONTACT DIGGERS HOTLINE, AT 1.800.242.8511. 7. ROADWAY UTILITY RECORD DRAWINGS WERE REQUESTED FROM THE CITY OF MADISON. THE UTILITIES SHOWN REPRESENT FIELD LOCATED UTILITES
- FOR INFORMATIONAL PURPOSES ONLY: IN COMBINATION WITH THE SUPPLIED CITY RECORDS.

NOTES CORRESPONDING TO TABLE A REQUIREMENTS:

- ITEM 9 THERE ARE 78 PARKING SPACES AND 6 HANDICAP SPACES FOR A TOTAL OF 84 PARKING SPACES.
- ITEM 11 SOURCE INFORMATION FROM PLANS AND MARKING WILL BE COMBINED WITH OBSERVED EVIDENCE OF UTILITIES PURSUANT TO SECTION 5.E.iv. TO DEVELOP A VIEW OF THE UNDERGROUND UTILITIES. HOWEVER, LACKING EXCAVATION, THE EXACT LOCATION OF UNDERGROUND FEATURES CANNOT BE ACCURATELY, COMPLETELY, AND RELIABLY DEPICTED. IN ADDITION, IN SOME JURISDICTIONS, 811 OR OTHER SIMILAR UTILITY LOCATE REQUESTS FROM SURVEYORS MAY BE IGNORED OR RESULT IN AN INCOMPLETE RESPONSE, IN WHICH CASE THE SURVEYOR SHALL NOTE ON THE PLAT OR MAP HOW THIS AFFECTED THE SURVEYOR'S ASSESSMENT OF THE LOCATION OF THE UTILITIES. WHERE ADDITIONAL OR MORE DETAILED INFORMATION IS REQUIRED, THE CLIENT IS ADVISED THAT EXCAVATION AND/OR A PRIVATE UTILITY LOCATE REQUEST MAY BE NECESSARY.
- ITEM 16 THERE IS NO OBSERVED EVIDENCE OF CURRENT EARTH MOVING WORK, BUILDING CONSTRUCTION OR BUILDING ADDITIONS AT THE TIME OF
- ITEM 18 NO DELINEATION MARKERS OBSERVED AT THE TIME OF THIS SURVEY.

NOTES CORRESPONDING TO SCHEDULE B-SECTION TWO EXCEPTIONS (FIRST AMERICAN TITLE INSURANCE COMPANY, FILE No.: NCS-1010356-MAD, EFFECTIVE DATE: APRIL 13, 2020 AT 8:00 A.M.)

11) GRANT OF EASEMENT TO WISCONSIN TELEPHONE COMPANY RECORDED: NOVEMBER 30, 1921, AS DOCUMENT No. 406519a.

THIS ITEM DOES AFFECT THE SUBJECT PROPERTY BUT IS NOT GRAPHIC IN NATURE, THEREFOR IT IS NOT PLOTTED HEREON.

(12) GRANT OF EASEMENT TO THE TOWN OF BLOOMING GROVE FOR SANITARY SEWER LINE AND WATER MAIN RECORDED: JANUARY 03, 1951 VOLUME 236 OF MISCELLANEOUS, PAGE 15, AS DOCUMENT No. 810731.

THIS ITEM DOES AFFECT THE SUBJECT PROPERTY AND IS PLOTTED HEREON.

LEGAL DESCRIPTION (AS FURNISHED)

(FIRST AMERICAN TITLE INSURANCE COMPANY, FILE No.: NCS-1010356-MAD, EFFECTIVE DATE: APRIL 13, 2020 AT 8:00 A.M.)

PART OF LOT THIRTY (30), BLOOMING GROVE ASSESSOR'S PLAT No. 7, IN THE CITY OF MADISON, DANE COUNTY, WISCONSIN, DESCRIBED AS FOLLOWS: BEGINNING AT THE SOUTHEAST CORNER OF OUTLOT 29 OF SAID ASSESSOR'S PLAT; THENCE 00°51' EAST; THENCE NORTH 89°06' EAST, 538.69 FEET; THENCE NORTH 00°23' WEST, 152.65 FEET TO THE SOUTH LINE OF THE NEWLY WIDENED COTTAGE GROVE ROAD; THENCE SOUTH 89°10' WEST, ALOND SAID SOUTH LINE OF NEWLY WIDENED ROAD, 539.95 FEET TO ITS POINT OF INTERSECTION WITH THE EAST LINE OF ABOVE MENTIONED OUTLOT 29; THENCE SOUTH 00°51' EAST ALONG SAID EAST LINE OF OUTLOT, 134.0 FEET TO THE POINT OF BEGINNING.

ADDRESS: 209 COTTAGE GROVE ROAD, MADISON, WI

TAX KEY NUMBER: 251/0710-093-0312-5

SURVEYOR'S CERTIFICATE

i) FIRST AMERICAN TITLE INSURANCE COMPANY,

ii) KRUPP-GROVE FAMILY LIMITED PARTNERSHIP, A WISCONSIN LIMITED PARTNERSHIP, iii) CP STERN, LLC, A WISCONSIN LIMITED LIABILITY COMPANY, AS TO AN UNDIVIDED 55% TENANT COMMON INTEREST, iv) STAR INVESTMENTS, LLC, A WISCONSIN LIMITED LIABILITY COMPANY, A/K/A STAR INVESTMENTS, LLC, AS TO AN UNDIVIDED 45% TENANT IN COMMON INTEREST,

THIS IS TO CERTIFY THAT THIS MAP OR PLAT AND THE SURVEY ON WHICH IT IS BASED WERE MADE IN ACCORDANCE WITH THE 2016 MINIMUM STANDARD DETAIL REQUIREMENTS FOR ALTA/NSPS LAND TITLE SURVEYS, JOINTLY ESTABLISHED AND ADOPTED BY ALTA AND NSPS AND INCLUDES ITEMS 1, 4, 5, 7(a), 8, 9, 11, 13, 16, AND 18 OF TABLE A THEREOF. THE FIELD WORK WAS COMPLETED ON MAY 05, 2020.

Hodel J. Buh TODD J. BUHR, S-2614 PROFESSIONAL LAND SURVEYOR Email: todd.buhr@jsdinc.com

Website: www.jsdinc.com



CREATE THE VISION TELL THE STORY

MADISON MILWAUKEE KENOSHA APPLETON WAUSAU

MADISON REGIONAL OFFICE 161 HORIZON DRIVE, SUITE 101 VERONA, WISCONSIN 53593 P. 608.848.5060


CLIENT: **PRIME URBAN** PROPERTIES, LLC

2010 EASTWOOD DRIVE, SUITE 201 MADISON, WI 53704-5387

209 COTTAGE **GROVE ROAD**

PROJECT LOCATION: CITY OF MADISON, WI DANE COUNTY



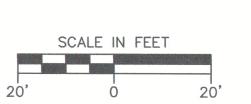

		A STANSON OF THE
Design/Drawn:	CJO	05/06/20
Approved:	TJB	05/07/20

SHEET TITLE: **ALTA/NSPS**

LAND TITLE **SURVEY**

SHEET NUMBER:


TODD J. BUHR

S - 2614

DEFOREST,

JSD PROJECT NO:

20-9688\$

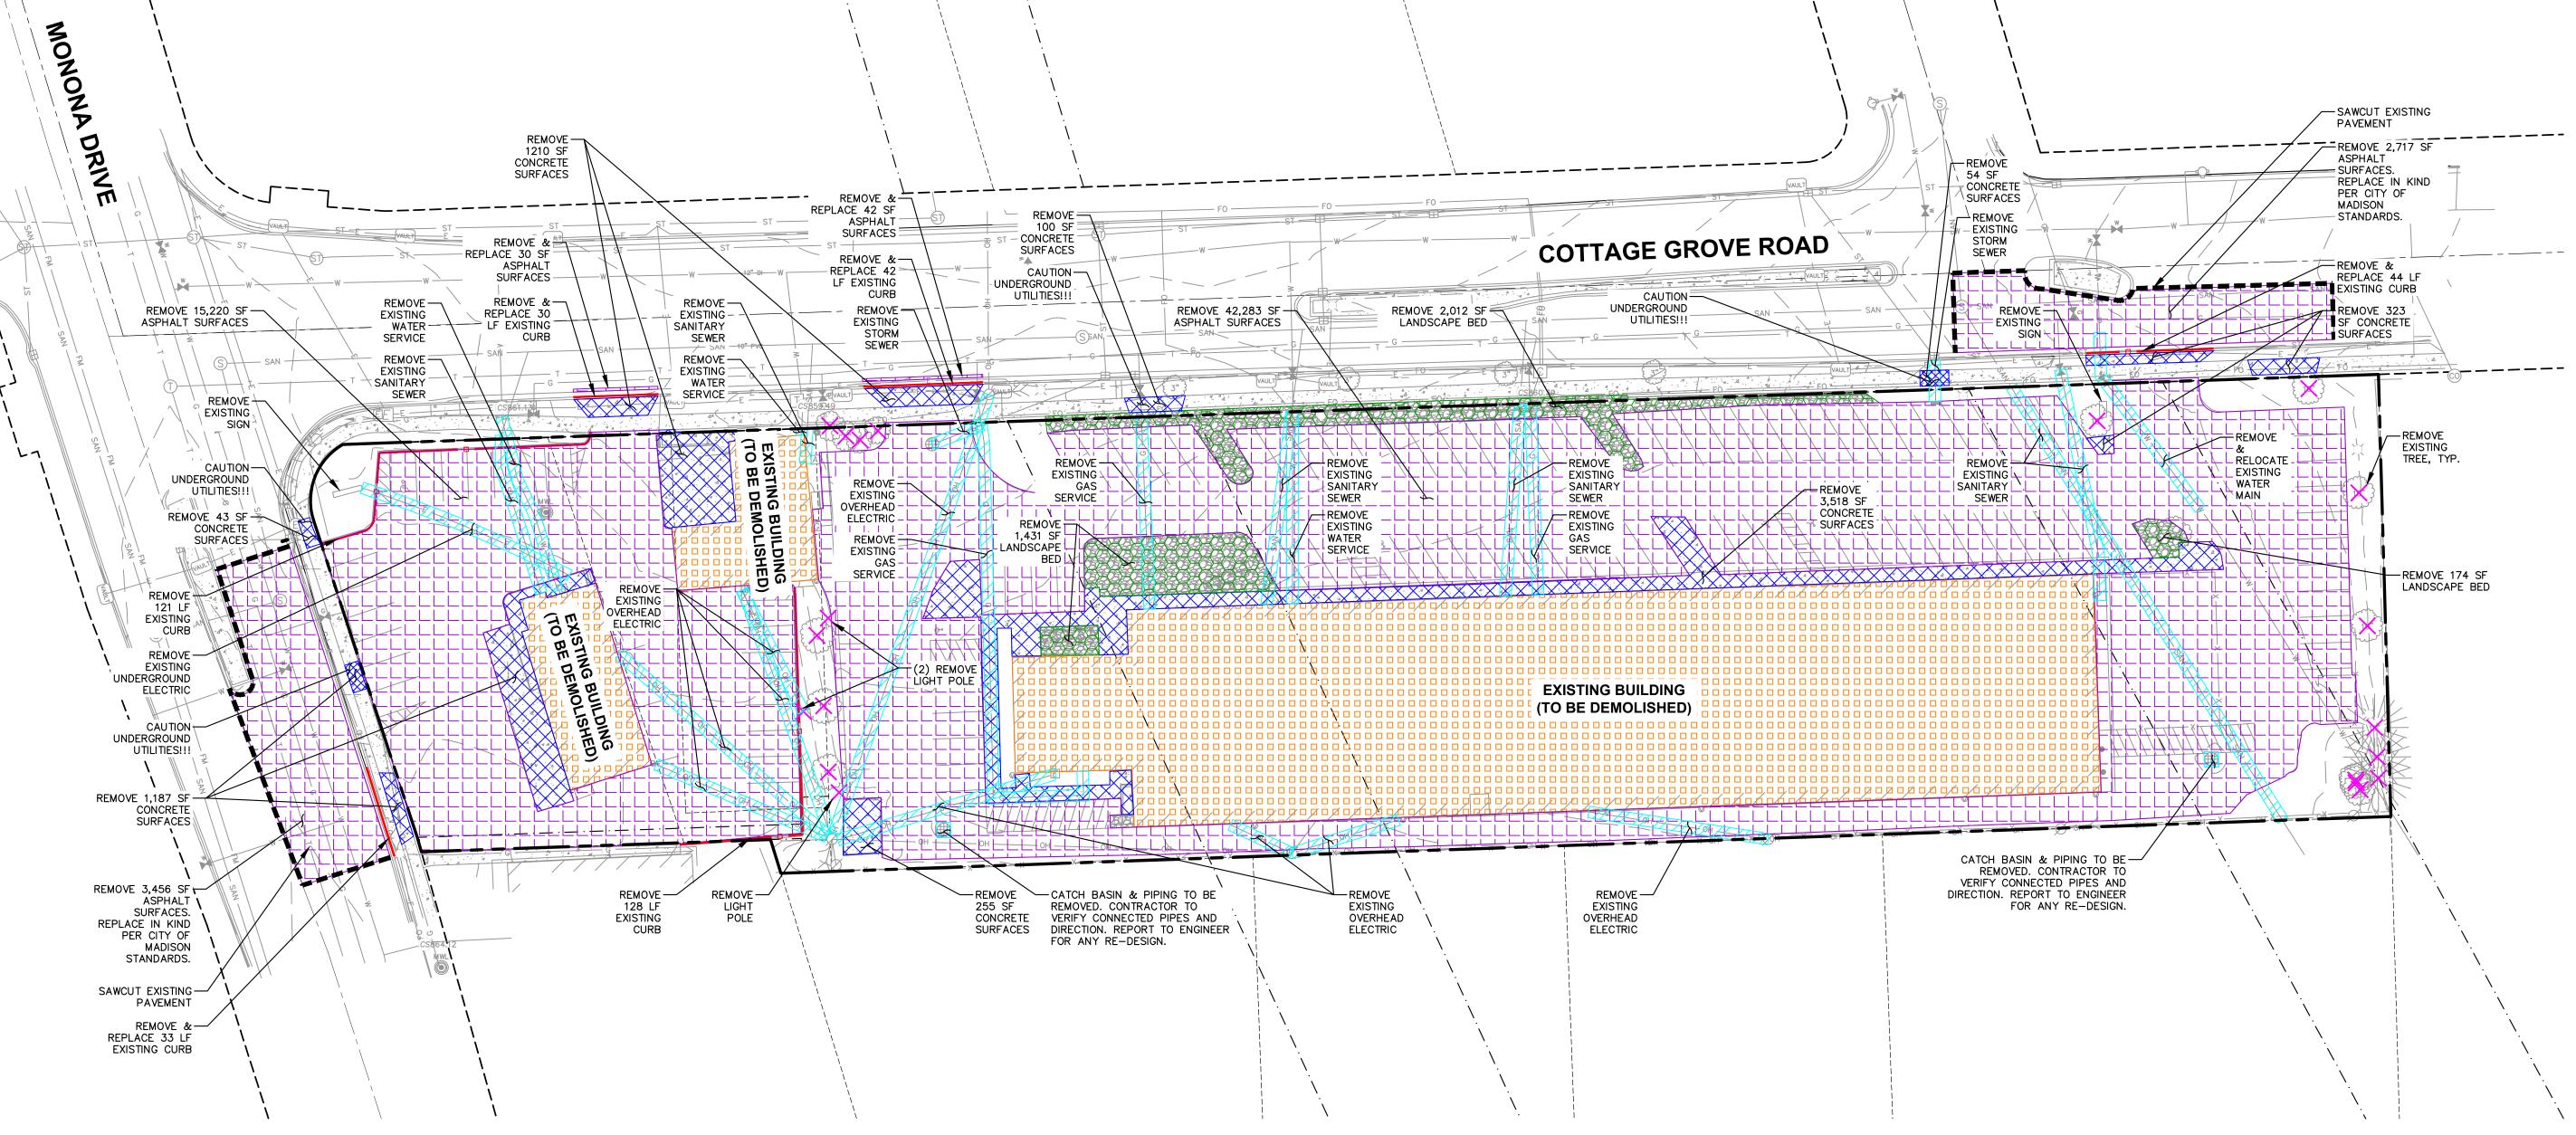

DEMOLITION NOTES

- THIS PLAN INDICATES ITEMS ON THE PROPERTY INTENDED FOR DEMOLITION BASED ON THE CURRENT SITE DESIGN THAT HAVE BEEN IDENTIFIED BY A REASONABLE OBSERVATION OF THE EXISTING CONDITIONS THROUGH FIELD SURVEY RECONNAISSANCE, "DIGGER'S HOTLINE" LOCATION, AND GENERAL "STANDARD OF CARE". THERE MAY BE ADDITIONAL ITEMS THAT CAN NOT BE IDENTIFIED BY A REASONABLE ABOVE GROUND OBSERVATION, OF WHICH THE ENGINEER WOULD HAVE NO KNOWLEDGE OR MAY BE A PART OF ANOTHER DESIGN DISCIPLINE. IT IS THE CONTRACTOR'S/BIDDER'S RESPONSIBILITY TO REVIEW THE PLANS, INSPECT THE SITE AND PROVIDE THEIR OWN DUE DILIGENCE TO INCLUDE IN THEIR BID WHAT ADDITIONAL ITEMS, IN THEIR OPINION, MAY BE NECESSARY FOR DEMOLITION. ANY ADDITIONAL ITEMS IDENTIFIED BY THE CONTRACTOR/BIDDER SHALL BE IDENTIFIED IN THE BID AND REPORTED TO THE ENGINEER OF RECORD. JSD TAKES NO RESPONSIBILITY FOR ITEMS ON THE PROPERTY THAT COULD NOT BE LOCATED BY A REASONABLE OBSERVATION OF THE PROPERTY OR OF WHICH THEY WOULD HAVE NO
- CONTRACTOR SHALL KEEP ALL STREETS AND PRIVATE DRIVES FREE AND CLEAR OF ALL CONSTRUCTION RELATED DIRT, DUST AND DEBRIS.
- ALL TREES WITHIN THE CONSTRUCTION LIMITS SHALL BE REMOVED UNLESS SPECIFICALLY CALLED OUT FOR PROTECTION. ALL TREES TO BE REMOVED SHALL BE REMOVED IN THEIR ENTIRETY AND STUMPS SHALL BE GROUND TO PROPOSED SUBGRADE.
- 4. ALL LIGHT POLES TO BE REMOVED SHALL BE REMOVED IN THEIR ENTIRETY, INCLUDING BASE AND ALL APPURTENANCES. SALVAGE FOR RELOCATION. COORDINATE RELOCATION AND/OR ABANDONMENT OF ALL ELECTRIC LINES WITH ELECTRICAL ENGINEER AND OWNER PRIOR TO DEMOLITION.
- ABANDONED/REMOVED ITEMS SHALL BE DISPOSED OF OFF SITE UNLESS OTHERWISE NOTED.
- CONTRACTOR TO REPLACE ALL SIDEWALK AND CURB AND GUTTER ABUTTING THE PROPERTIES, WHICH IS DAMAGED BY THE CONSTRUCTION, OR ANY SIDEWALK AND CURB AND GUTTER THAT THE CITY ENGINEER DETERMINES NEEDS TO BE REPLACED BECAUSE IT IS NOT AT A DESIRABLE GRADE REGARDLESS OF WHETHER THE CONDITION EXISTED PRIOR TO BEGINNING CONSTRUCTION.
- PRIOR TO CONSTRUCTION, THE CONTRACTOR IS RESPONSIBLE FOR: 7.1. EXAMINE ALL SITE CONDITIONS RELATIVE TO THE CONDITIONS INDICATED ON THE ENGINEERING DRAWINGS. ANY DISCREPANCIES ARE TO BE REPORTED IMMEDIATELY TO THE ENGINEER AND RESOLVED PRIOR TO THE START OF CONSTRUCTION.
- 7.2. VERIFYING UTILITY ELEVATIONS AND NOTIFYING ENGINEER OF ANY DISCREPANCIES. NO WORK SHALL BE PERFORMED UNTIL THE DISCREPANCIES ARE RESOLVED.
- 7.3. NOTIFYING ALL UTILITIES PRIOR TO THE REMOVAL OF ANY UNDERGROUND UTILITIES.
- NOTIFYING THE DESIGN ENGINEER AND LOCAL CONTROLLING MUNICIPALITY 48 HOURS PRIOR TO
- THE START OF CONSTRUCTION TO ARRANGE FOR APPROPRIATE CONSTRUCTION INSPECTION. 8. ANY SANITARY SEWER, SANITARY SEWER SERVICES, WATER MAIN, WATER SERVICES, STORM SEWER,

OR OTHER UTILITIES, WHICH ARE DAMAGED BY THE CONTRACTORS, SHALL BE REPAIRED TO THE

- OWNER'S SATISFACTION AT THE CONTRACTOR'S EXPENSE. CONTRACTOR IS RESPONSIBLE FOR SITE SAFETY DURING THE CONSTRUCTION OF THESE
- IMPROVEMENTS.
- RELOCATION WITH RESPECTIVE UTILITY COMPANY. COORDINATION REQUIRED PRIOR TO CONSTRUCTION. 11. ALL DEMOLITION SHALL BE IN ACCORDANCE WITH THE APPROVED MUNICIPALITY RECYCLING PLAN.
- 12. ANY CONTAMINATED SOILS SHALL BE REMOVED IN ACCORDANCE WITH FEDERAL AND STATE REGULATIONS TO AN APPROVED LANDFILL.

10. CONTRACTOR TO COORDINATE PRIVATE UTILITY REMOVAL / ABANDONMENT AND NECESSARY

- 13. ALL EXISTING UTILITIES TO BE FIELD LOCATED AND FLAGGED BY CONTRACTOR.
- 14. EXISTING FIBER OPTIC LINE TO BE CLEARLY MARKED PRIOR TO ANY EXCAVATION. CONTRACTOR TO NOTIFY ENGINEER IMMEDIATELY IF ANY DISCREPANCIES OCCUR IN THE LOCATION SHOWN OR PROPOSED IMPROVEMENTS IMPACTING EXISTING FIBER OPTIC LINE LOCATION.
- 15. SEWER ABANDONMENT SHALL BE IN ACCORDANCE WITH SECTION 3.2.24, OF THE STANDARD SPECIFICATIONS FOR WATER AND SEWER CONSTRUCTION IN WISCONSIN, LATEST ADDITION, AND CITY
- 16. WATER ABANDONMENT SHALL BE IN ACCORDANCE WITH SECTION 4.14.0 OF THE STANDARD SPECIFICATIONS FOR WATER AND SEWER CONSTRUCTION IN WISCONSIN, LATEST ADDITION, AND CITY
- 17. ALL PERIMETER EROSION CONTROL DEVICES SHALL BE INSTALLED PRIOR TO THE START OF DEMOLITION ACTIVITIES. CONTRACTOR SHALL KEEP ALL STREETS AND PAVEMENT FREE AND CLEAR OF ALL CONSTRUCTION RELATED DIRT, DUST AND DEBRIS.
- 18. BUILDING REMOVALS SHALL BE BY A QUALIFIED CONTRACTOR. CONTRACTOR TO FOLLOW ALL DEMOLITION REGULATIONS, DISCONNECT ALL UTILITIES, OBTAIN ALL APPLICABLE PERMITS AND DISPOSE OF ALL BUILDING MATERIALS IN APPROPRIATE LANDFILLS. DEMOLISHED MATERIALS SHALL NOT BE BURIED ON SITE. IF ENCOUNTERED, ANY CONTAMINATED SOILS SHALL BE REMOVED TO A LANDFILL IN ACCORDANCE WITH APPROPRIATE STATE AND FEDERAL REGULATIONS.
- 19. CONTRACTOR TO REMOVE EXISTING UTILITY PIPE OR PROVIDE PIPE BACK-FILLING AFTER REMOVAL OF EXISTING UTILITIES WITHIN BUILDING FOOTPRINT USING "LOW DENSITY CONCRETE/FLOWABLE FILL".
- 20. RESTORATION OF THE EXISTING ROADWAY RIGHT-OF-WAYS ARE CONSIDERED INCIDENTAL AND SHOULD BE PART OF THE COST OF THE UNDERGROUND IMPROVEMENTS, DEMOLITION AND REMOVAL. THIS INCLUDES CURB & GUTTER, SIDEWALK, TOPSOIL, SEEDING AND MULCHING.

LEGEND

PROPERTY LINE ----- EASEMENT LINE DEMOLITION - REMOVAL OF ONSITE CURB SURFACES AND BASE COURSE DEMOLITION - PAVEMENT MILL AND OVERLAY DEMOLITION - REMOVAL OF RETAINING WALL DEMOLITION - REMOVAL OF ASPHALT SURFACES DEMOLITION - REMOVAL OF CONCRETE SURFACES DEMOLITION - REMOVAL OF BUILDINGS/STRUCTURES DEMOLITION - REMOVAL OF UTILITIES DEMOLITION - REMOVAL OF LANDSCAPE BEDDING TREE REMOVAL

SAWCUT EXISTING PAVEMENT



MADISON MILWAUKEE WAUSAU APPLETON KENOSHA CHICAGO COEUR D'ALENE

MADISON REGIONAL OFFICE 161 HORIZON DRIVE, SUITE 101 VERONA, WISCONSIN 53593 P. 608.848.5060

PRIME URBAN PROPERTIES, LLC

CLIENT ADDRESS: 1952 ATWOOD AVENUE MADISON, WI 53704

209 COTTAGE GROVE ROAD APARTMENTS

PROJECT LOCATION: MADISON, WI DANE COUNTY


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07.08.2020 LAND USE SUBMITTAL

DEMOLITION PLAN


Toll Free (800) 242-8511 JSD PROJECT NO:


	north	•
	SCALE IN FEE	T
30'	0	30
DIGGE	RS J H	OTLI

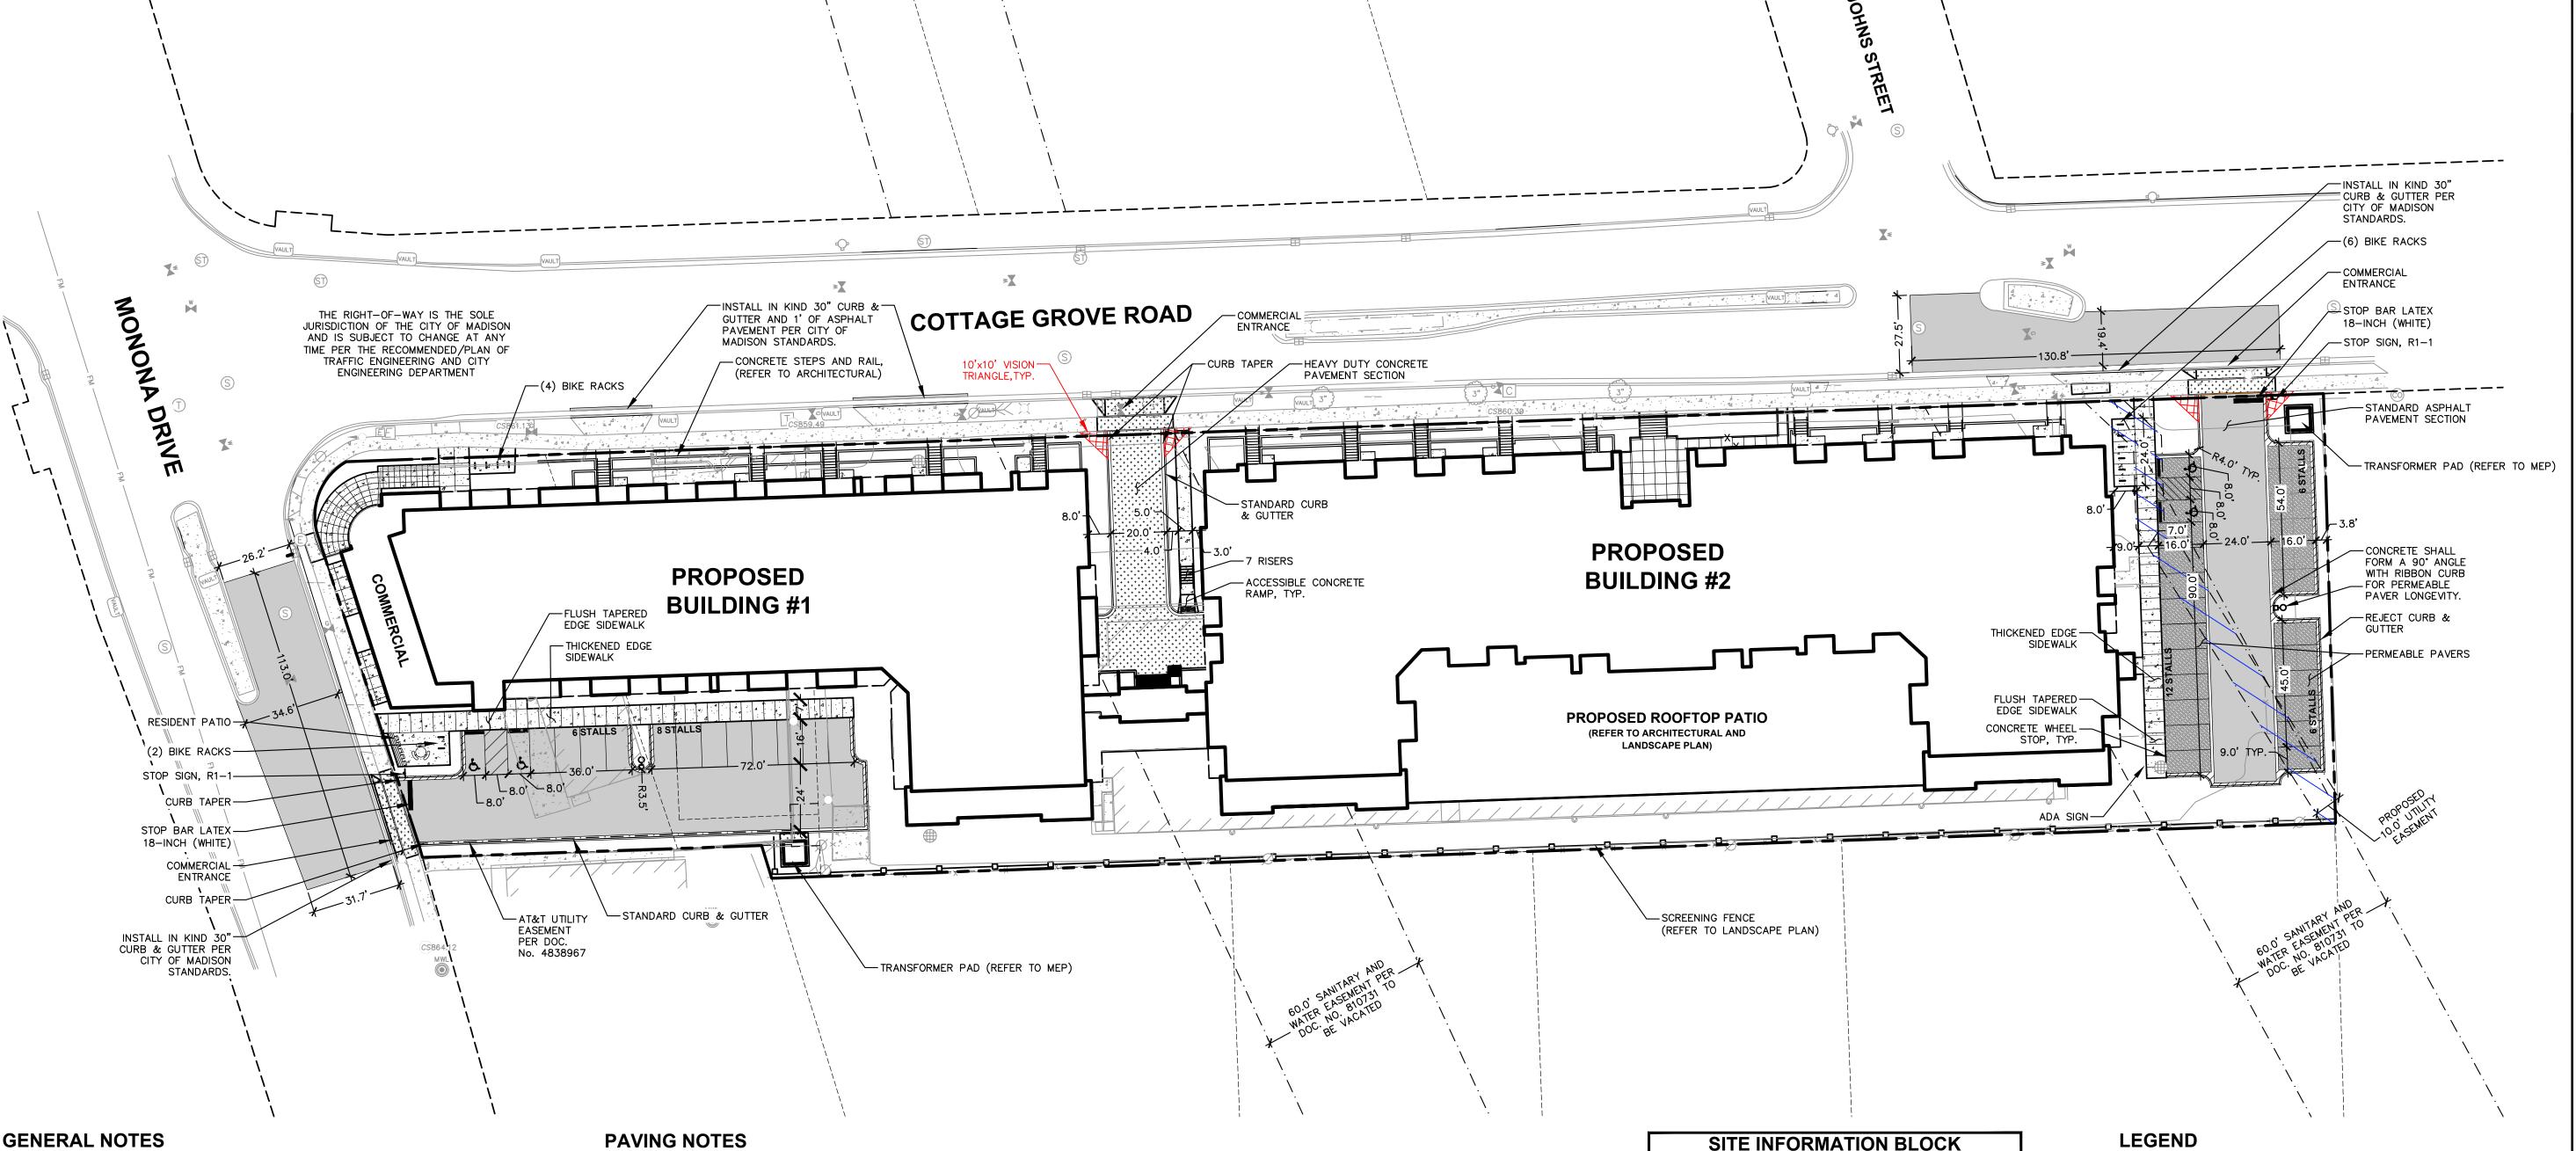


GENERAL NOTES

- 1. REFER TO THE EXISTING CONDITIONS SURVEY FOR EXISTING CONDITIONS NOTES AND LEGENDS.
- ALL WORK IN THE ROW AND/OR PUBLIC EASEMENTS SHALL BE IN ACCORDANCE WITH THE STANDARD SPECIFICATIONS FOR SEWER & WATER CONSTRUCTION IN WISCONSIN AND MUNICIPAL REQUIREMENTS.
- 3. EXISTING GRADE SPOT ELEVATIONS SHOWN FOR INFORMATIONAL PURPOSES. DURING CONSTRUCTION MATCH EXISTING GRADES AT CONSTRUCTION LIMITS.
- 4. NO SITE GRADING OUTSIDE OR DOWNSLOPE OF PROPOSED SILT FENCE LOCATION. NO LAND DISTURBANCE BEYOND PROPERTY LINES.
- 5. JSD SHALL BE HELD HARMLESS AND DOES NOT WARRANT ANY DEVIATIONS BY THE OWNER/CONTRACTOR FROM THE APPROVED CONSTRUCTION PLANS THAT MAY RESULT IN DISCIPLINARY ACTIONS BY ANY OR ALL REGULATORY AGENCIES.
- GENERAL
- 1.1. ALL PAVING SHALL CONFORM TO "STATE OF WISCONSIN STANDARD SPECIFICATIONS FOR HIGHWAY & STRUCTURE CONSTRUCTION, LATEST EDITION, APPLICABLE CITY OF MADISON ORDINANCES AND THE GEOTECHNICAL REPORT PREPARED BY (TBD)
- 1.2. ALL PAVING DIMENSIONS ARE TO FACE OF CURB UNLESS SPECIFIED OTHERWISE.
- 1.3. SURFACE PREPARATION NOTIFY ENGINEER/OWNER OF UNSATISFACTORY CONDITIONS. DO NOT BEGIN PAVING WORK UNTIL DEFICIENT SUBBASE AREAS HAVE BEEN CORRECTED AND ARE READY TO RECEIVE PAVING.
- 1.4. ANY REQUIRED REPLACEMENT OF PUBLIC CURB AND GUTTER SHALL MATCH EXISTING AND MEET MUNICIPALITY REQUIREMENTS.
- 2. ASPHALTIC CONCRETE PAVING SPECIFICATIONS
- 2.1. CODES AND STANDARDS THE PLACING, CONSTRUCTION AND COMPOSITION OF THE ASPHALTIC BASE COURSE AND ASPHALTIC CONCRETE SURFACE COURSE SHALL BE IN ACCORDANCE WITH THE REQUIREMENTS OF SECTIONS 450, 455, 460 AND 465 OF THE STATE OF WISCONSIN STANDARD SPECIFICATIONS FOR HIGHWAY AND STRUCTURE CONSTRUCTION, CURRENT EDITION. HEREAFTER, THIS PUBLICATION WILL BE REFERRED TO AS STATE HIGHWAY SPECIFICATIONS.
- 2.2. WEATHER LIMITATIONS APPLY TACK COATS WHEN AMBIENT TEMPERATURE IS ABOVE 50° F (10° C) AND WHEN TEMPERATURE HAS NOT BEEN BELOW 35° F (1° C) FOR 12 HOURS IMMEDIATELY PRIOR TO APPLICATION. DO NOT APPLY WHEN BASE IS WET OR CONTAINS EXCESS OF MOISTURE. CONSTRUCT ASPHALTIC CONCRETE SURFACE COURSE WHEN ATMOSPHERIC TEMPERATURE IS ABOVE 40° F (4° C) AND WHEN BASE IS DRY AND WHEN WEATHER IS NOT RAINY. BASE COURSE MAY BE PLACED WHEN AIR TEMPERATURE IS ABOVE 30° F $(-1^{\circ}$ C).
- 2.3. GRADE CONTROL ESTABLISH AND MAINTAIN REQUIRED LINES AND ELEVATIONS FOR EACH COURSE DURING CONSTRUCTION.
- 2.4. CRUSHED AGGREGATE BASE COURSE THE TOP LAYER OF BASE COURSE SHALL CONFORM TO SECTIONS 301 AND 305, STATE HIGHWAY SPECIFICATIONS.
- 2.5. BINDER COURSE AGGREGATE THE AGGREGATE FOR THE BINDER COURSE SHALL CONFORM TO SECTIONS 460 AND 315, STATE HIGHWAY SPECIFICATIONS.
- 2.6. SURFACE COURSE AGGREGATE THE AGGREGATE FOR THE SURFACE COURSE SHALL CONFORM TO SECTIONS 460 AND 465, STATE HIGHWAY SPECIFICATIONS.
- 2.7. ASPHALTIC MATERIALS THE ASPHALTIC MATERIALS SHALL CONFORM TO SECTION 455 AND 460, STATE HIGHWAY SPECIFICATIONS.
- 3. CONCRETE PAVING SPECIFICATIONS
- 3.1. CONCRETE PAVING SHALL BE IN ACCORDANCE WITH THE REQUIREMENTS OF SECTIONS 415 AND 416 OF THE STATE HIGHWAY SPECIFICATIONS.
- 3.2. CONCRETE PAVEMENT SHALL BE REINFORCED WITH NOVOMESH 950 (OR EQUAL) FIBER REINFORCEMENT AT A RATE OF 5 LBS/CUBIC YARD.
- 3.3. CURING COMPOUNDS SHALL CONFORM TO SECTION 415 OF THE STATE HIGHWAY SPECIFICATIONS.
- 3.4. CONTRACTOR SHALL PROVIDE CONTROL JOINTS AND CONSTRUCTION JOINTS OF ONE-QUARTER CONCRETE THICKNESS AT AN EQUAL RATIO OF LENGTH TO WIDTH WHEREVER POSSIBLE WITH A MAXIMUM LENGTH BETWEEN JOINTS OF 8' ON CENTER.
- 3.5. CONTRACTOR SHALL PROVIDE EXPANSION JOINTS IN SIDEWALKS AT A MAXIMUM 24' ON CENTER.
- 3.6. EXTERIOR CONCRETE SURFACES SHALL BE BROOM FINISHED.
- 3.7. ALL CONCRETE SURFACES TO BE SEALED WITH TYPE TK-26UV CONCRETE SEALANT.
- 4. PAVEMENT MARKING SPECIFICATIONS
- 4.1. USE 4" WIDE, HIGH VISIBILITY YELLOW LATEX PAINT FOR STALL LINES.
- 4.2. MARK AND STRIPE ADA PARKING SPACES APPROPRIATELY.
- 4.3. ALL PAVEMENT MARKINGS INCLUDING: STOP BARS, CROSSWALKS, DIRECTIONAL ARROWS, PARKING STALL LINES, ADA STALL MARKINGS, NO PARKING ZONES, DROP-OFF/PICK-UP ZONES SHALL BE PAINTED WITH LATEX PAINT PER SPECIFICATIONS.
- 4.4. 2' x 4' TRUNCATED DOME WARNING DETECTION FIELD SHALL BE PLACED AT ALL ADA RAMPS.

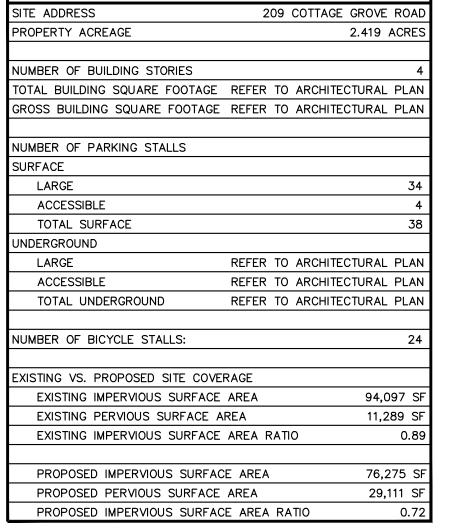

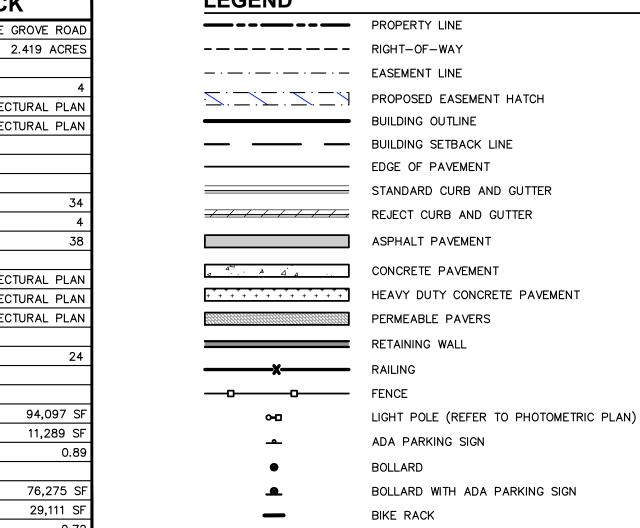

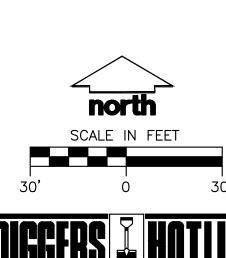

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PRIME URBAN PROPERTIES, LLC

CLIENT ADDRESS: 1952 ATWOOD AVENUE MADISON, WI 53704

209 COTTAGE GROVE ROAD APARTMENTS


PROJECT LOCATION: MADISON, WI DANE COUNTY

07.08.2020 LAND USE SUBMITTAL

SITE PLAN

Design/Drawn:

MSS/APM

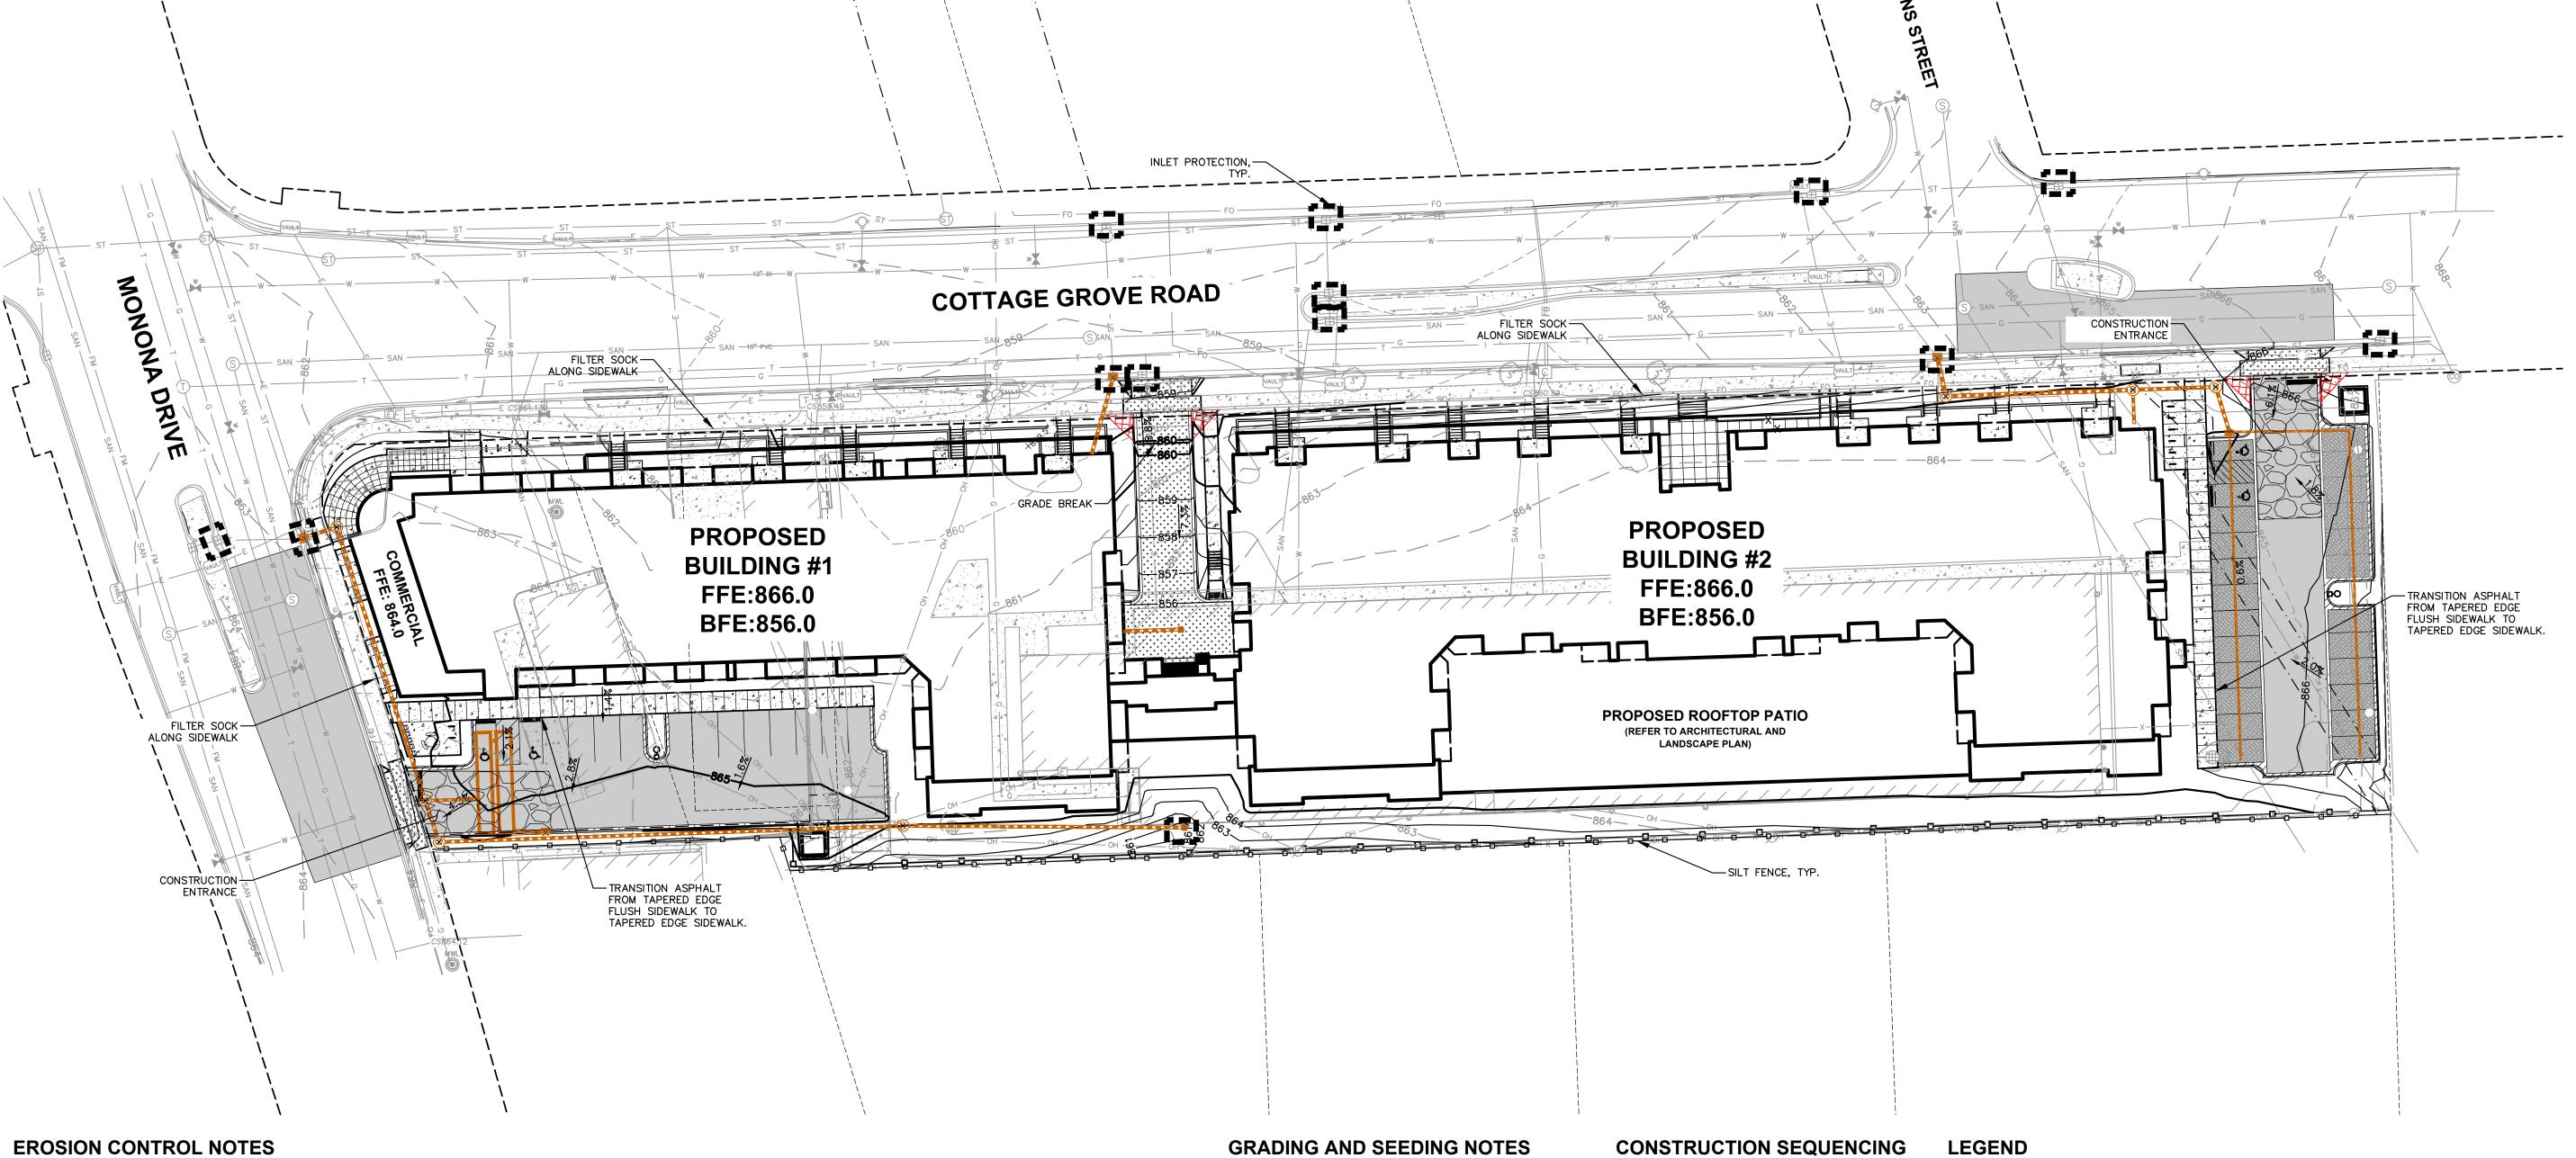

- CONTRACTOR IS RESPONSIBLE TO NOTIFY ENGINEER OF RECORD AND OFFICIALS OF ANY CHANGES TO THE EROSION CONTROL AND STORMWATER MANAGEMENT PLANS. ENGINEER OF RECORD AND APPROPRIATE CITY OF MADISON OFFICIALS MUST APPROVE ANY CHANGES PRIOR TO DEVIATION FROM THE APPROVED PLANS.
- ALL EROSION CONTROL MEASURES SHALL BE CONSTRUCTED AND MAINTAINED BY THE CONTRACTOR IN ACCORDANCE WITH THE WISCONSIN DEPARTMENT OF NATURAL RESOURCES (WDNR) TECHNICAL STANDARDS (REFERRED TO AS BMP'S) AND CITY OF MADISON ORDINANCE. IT IS THE CONTRACTOR'S RESPONSIBILITY TO OBTAIN A COPY OF THESE STANDARDS. CONTRACTOR SHALL BE RESPONSIBLE FOR ANY ADDITIONAL EROSION CONTROL MEASURES WHICH MAY BE NECESSARY TO MEET UNFORESEEN FIELD CONDITIONS.
- 3. INSTALL PERIMETER EROSION CONTROL MEASURES (SUCH AS CONSTRUCTION ENTRANCES, SILT FENCE AND EXISTING INLET PROTECTION) PRIOR TO ANY SITE WORK, INCLUDING GRADING OR DISTURBANCE OF EXISTING SURFACE COVER, AS SHOWN ON PLAN. MODIFICATIONS TO THE APPROVED EROSION CONTROL DESIGN IN ORDER TO MEET UNFORESEEN FIELD CONDITIONS IS ALLOWED IF MODIFICATIONS CONFORM TO BMP'S. ALL DESIGN MODIFICATIONS MUST BE APPROVED BY THE CITY OF MADISON PRIOR TO DEVIATION OF THE APPROVED PLAN.
- 4. ADDITIONAL EROSION CONTROL MEASURES, AS REQUESTED BY STATE INSPECTORS, LOCAL INSPECTORS, COUNTY INSPECTORS AND/OR ENGINEER OF RECORD SHALL BE INSTALLED WITHIN 24 HOURS OF
- INSPECTIONS AND MAINTENANCE OF ALL EROSION CONTROL MEASURES SHALL BE ROUTINE (ONCE PER WEEK MINIMUM) TO ENSURE PROPER FUNCTION OF EROSION CONTROLS AT ALL TIMES. EROSION CONTROL MEASURES ARE TO BE IN WORKING ORDER AT THE END OF EACH WORK DAY.
- 6. ALL EROSION AND SEDIMENT CONTROL ITEMS SHALL BE INSPECTED WITHIN 24 HOURS OF ALL RAIN EVENTS EXCEEDING 0.5 INCHES. ANY DAMAGED EROSION CONTROL MEASURES SHALL BE REPAIRED OR REPLACED IMMEDIATELY UPON INSPECTION.
- CONSTRUCTION ENTRANCES SHALL BE INSTALLED AT ALL LOCATIONS OF VEHICLE INGRESS/EGRESS POINTS. ADDITIONAL LOCATIONS OTHER THAN AS SHOWN ON THE PLANS MUST BE PRIOR APPROVED BY THE MUNICIPALITY. CONSTRUCTION ENTRANCES SHALL BE 50' LONG AND NO LESS THAN 12" THICK BY USE OF 3" CLEAR STONE. CONSTRUCTION ENTRANCES SHALL BE MAINTAINED BY THE CONTRACTOR IN A CONDITION WHICH WILL PREVENT THE TRACKING OF MUD OR DRY SEDIMENT ONTO ADJACENT PUBLIC STREETS AFTER EACH WORKING DAY OR MORE FREQUENTLY AS REQUIRED.
- 8. PAVED SURFACES ADJACENT TO CONSTRUCTION SITE VEHICLE ACCESS SHALL BE SWEPT AND/OR SCRAPED TO REMOVE ACCUMULATED SOIL, DIRT AND/OR DUST AFTER THE END OF EACH WORK DAY AND AS REQUESTED BY THE CITY OF MADISON.
- INLET PROTECTION SHALL BE IMMEDIATELY FITTED AT THE INLET OF ALL INSTALLED STORM SEWER AND SILT FENCE SHALL BE IMMEDIATELY FITTED AT ALL INSTALLED CULVERT INLETS TO PREVENT SEDIMENT DEPOSITION WITHIN STORM SEWER SYSTEMS.
- 10. DITCH CHECKS AND APPLICABLE EROSION NETTING/MATTING SHALL BE INSTALLED IMMEDIATELY AFTER
- COMPLETION OF GRADING EFFORTS WITHIN DITCHES/SWALES TO PREVENT SOIL TRANSPORTATION.

11. EROSION CONTROL FOR UTILITY CONSTRUCTION (STORM SEWER, SANITARY SEWER, WATER MAIN, ETC.):

A. PLACE EXCAVATED TRENCH MATERIAL ON THE HIGH SIDE OF THE TRENCH. B. BACKFILL, COMPACT, AND STABILIZE THE TRENCH IMMEDIATELY AFTER PIPE CONSTRUCTION. C. DISCHARGE TRENCH WATER INTO A SEDIMENTATION BASIN OR FILTERING TANK IN ACCORDANCE WITH THE DEWATERING TECHNICAL STANDARD NO. 1061 PRIOR TO RELEASE INTO THE STORM SEWER, RECEIVING STREAM, OR DRAINAGE DITCH.

- 12. ALL SLOPES 4:1 OR GREATER SHALL BE STABILIZED WITH CLASS I, TYPE B EROSION MATTING OR APPLICATION OF A WISCONSIN DEPARTMENT OF TRANSPORTATION (WisDOT) APPROVED POLYMER SOIL STABILIZATION TREATMENT OR A COMBINATION THEREOF, AS REQUIRED WITHIN 7 DAYS OF REACHING FINAL GRADE AND/OR AS SOON AS CONDITIONS ALLOW. DRAINAGE SWALES SHALL BE STABILIZED WITH CLASS II, TYPE B EROSION MATTING. EROSION MATTING AND/OR NETTING USED ONSITE SHALL BE INSTALLED IN ACCORDANCE WITH MANUFACTURER'S GUIDELINES AND WDNR TECHNICAL STANDARDS
- 13. CONTRACTOR SHALL TAKE ALL NECESSARY STEPS TO CONTROL DUST ARISING FROM CONSTRUCTION OPERATIONS. REFER TO WDNR TECHNICAL STANDARD 1068.
- 14. EROSION CONTROL MEASURES SHALL NOT BE REMOVED UNTIL ALL LAND DISTURBING CONSTRUCTION ACTIVITY AT THE SITE HAS BEEN COMPLETED AND THAT A UNIFORM PERENNIAL VEGETATIVE COVER HAS BEEN ESTABLISHED WITH A DENSITY OF AT LEAST 70% FOR UNPAVED AREAS AND AREAS NOT COVERED BY PERMANENT STRUCTURES OR THAT EMPLOY EQUIVALENT PERMANENT STABILIZATION
- 15. CONTRACTOR/OWNER SHALL FILE A NOTICE OF TERMINATION UPON COMPLETION OF THE PROJECT IN ACCORDANCE WITH WDNR REQUIREMENTS AND/OR PROPERTY SALE IN ACCORDANCE WITH WDNR

16. STABILIZATION PRACTICES:

- *STABILIZATION MEASURES SHALL BE INITIATED AS SOON AS PRACTICABLE IN PORTIONS OF THE SITE WHERE CONSTRUCTION ACTIVITIES HAVE TEMPORARILY OR PERMANENTLY CEASED. NO MORE THAN SEVEN (7) DAYS SHALL PASS AFTER THE CONSTRUCTION ACTIVITY IN THAT PORTION OF THE SITE HAS CEASED UNLESS: *THE INITIATION STABILIZATION MEASURES BY THE SEVENTH (7) DAY AFTER CONSTRUCTION
- ACTIVITY HAS CEASED IS PRECLUDED BY SNOW COVER. IN THAT EVENT, STABILIZATION SHALL BE INITIATED AS SOON AS PRACTICABLE. *CONSTRUCTION ACTIVITY WILL RESUME ON A PORTION OF THE SITE WITHIN FOURTEEN (14) DAYS FROM WHEN ACTIVITY CEASED, (I.E. THE TOTAL TIME PERIOD THAT THE CONSTRUCTION
- ACTIVITY IS TEMPORARILY CEASED IS LESS THAN FOURTEEN (14) DAYS. IN THAT EVENT, STABILIZATION MEASURES DO NOT HAVE TO BE INITIATED ON THAT PORTION OF THE SITE BY THE SEVENTH (7) DAY AFTER CONSTRUCTION ACTIVITY HAS TEMPORARILY CEASED. *STABILIZATION MEASURES SHALL BE DETERMINED BASED ON SITE CONDITIONS AT THE TIME
- OF CONSTRUCTION ACTIVITY HAS CEASED, INCLUDING BUT NOT LIMITED TO WEATHER CONDITIONS AND LENGTH OF TIME MEASURE MUST BE EFFECTIVE. THE FOLLOWING ARE ACCEPTABLE STABILIZATION MEASURES:
 - PERMANENT SEEDING; IN ACCORDANCE WITH APPROVED CONSTRUCTION SPECIFICATION * TEMPORARY SEEDING; MAY CONSIST OF SPRING OATS(100LBS/ACRE) AND/OR WHEAT OR CEREAL RYE (150LB/ACRE)
 - HYDRO-MÙLCHING WITH A TACKIFIER * GEOTEXTILE EROSION MATTING * SODDING

- 1. ALL PROPOSED GRADES SHOWN ARE FINISHED GRADES. CONTRACTOR SHALL VERIFY ALL GRADES, MAKE SURE ALL AREAS DRAIN PROPERLY AND SHALL REPORT ANY DISCREPANCIES TO THE ENGINEER PRIOR TO CONSTRUCTION.
- 2. CONTRACTOR SHALL ASSUME SOLE RESPONSIBILITY FOR COMPUTATIONS OF ALL GRADING QUANTITIES. WHILE JSD PROFESSIONAL SERVICES, INC. ATTEMPTS TO PROVIDE A COST EFFECTIVE APPROACH TO BALANCE EARTHWORK, GRADING DESIGN IS BASED ON MANY FACTORS, INCLUDING SAFETY, AESTHETICS, AND COMMON ENGINEERING STANDARDS OF CARE. THEREFORE, NO GUARANTEE CAN BE MADE FOR A BALANCED
- 3. PARKING LOT AND DRIVEWAY ELEVATIONS ARE PAVEMENT GRADES, NOT TOP OF CURB GRADES, UNLESS OTHERWISE
- 4. ANY WORK WITHIN RIGHT-OF-WAY SHALL BE PROPERLY PERMITTED AND COORDINATED WITH THE APPROPRIATE OFFICIALS PRIOR TO COMMENCEMENT OF ANY CONSTRUCTION ACTIVITIES. ALL GRADING WITHIN RIGHT-OF-WAY IS SUBJECT TO APPROVAL BY SAID OFFICIALS.
- ADVANCE OF ANY SOIL DISTURBING ACTIVITIES, IN ACCORDANCE WITH MUNICIPAL REQUIREMENTS.
- 6. ALL DISTURBED AREAS SHALL BE SODDED AND/OR SEEDED AND MULCHED IMMEDIATELY FOLLOWING GRADING ACTIVITIES. SOD/SEED MIX TO BE IN ACCORDANCE WITH LANDSCAPE PLAN.
- CONTRACTOR SHALL CHISEL-PLOW OR DEEP TILL WITH DOUBLE TINES ALL STORMWATER MANAGEMENT FACILITIES JUST PRIOR TO SODDING AND/OR SEEDING AND MULCHING TO PROMOTE INFILTRATION.
- 8. CONTRACTOR SHALL WATER ALL NEWLY SODDED/SEEDED AREAS DURING THE SUMMER MONTHS WHENEVER THERE IS A 7 DAY LAPSE WITH NO SIGNIFICANT RAINFALL.
- 9. CONTRACTOR TO DEEP TILL ALL COMPACTED PERVIOUS SURFACES PRIOR TO SODDING AND/OR SEEDING AND MULCHING.
- 10. ALL SLOPES 20% OR GREATER SHALL BE TEMPORARY SEEDED, MULCHED, OR OTHER MEANS OF COVER PLACED ON THEM WITHIN 2 WEEKS OF DISTURBANCE.
- 11. ALL EXPOSED SOIL AREAS THAT WILL NOT BE BROUGHT TO FINAL GRADE OR ON WHICH LAND DISTURBING ACTIVITIES WILL NOT BE PERFORMED FOR A PERIOD GREATER THAN 30 DAYS AND REQUIRE VEGETATIVE COVER FOR LESS THAN 1 YEAR. REQUIRE TEMPORARY SEEDING FOR EROSION CONTROL. SEEDING FOR EROSION CONTROL SHALL BE IN ACCORDANCE WITH WDNR TECHNICAL STANDARD 1059 AND CITY OF MADISON ORDINANCE.


- INSTALL PERIMETER SILT FENCE, INLET PROTECTION AND TEMPORARY CONSTRUCTION ENTRANCE.
- 2. STRIP AND STOCKPILE TOPSOIL, INSTALL SILT FENCE
- AROUND PERIMETER OF STOCKPILE. 3. ROUGH GRADE RETENTION POND AND INSTALL POND
- CONDUCT ROUGH GRADING EFFORTS AND INSTALL
- CHECK DAMS WITHIN DRAINAGE DITCHES AS
- 5. INSTALL UTILITY PIPING AND STRUCTURES, IMMEDIATELY INSTALL INLET PROTECTION.
- 6. COMPLETE FINAL GRADING, INSTALLATION OF GRAVEL BASE COURSES, PLACEMENT OF CURBS,
- PAVEMENTS, WALKS, ETC. 7. PLACE TOPSOIL AND IMMEDIATELY STABILIZE DISTURBED AREAS WITH EROSION CONTROL
- MEASURES AS INDICATED ON PLANS. 5. CONTRACTOR SHALL PROVIDE NOTICE TO THE MUNICIPALITY IN 8. RESTORE RETENTION POND (FINAL GRADE RETENTION
 - POND PER PLAN REQUIREMENTS)
 - EROSION CONTROLS SHALL NOT BE REMOVED UNTIL SITE IS FULLY STABILIZED OR 70% VEGETATIVE COVER IS ESTABLISHED.

CONTRACTOR MAY MODIFY SEQUENCING AFTER ITEM NO. 1 AS NEEDED TO COMPLETE CONSTRUCTION IF EROSION CONTROLS ARE MAINTAINED IN ACCORDANCE WITH THE CONSTRUCTION SITE EROSION CONTROL REQUIREMENTS.

	PROPERTY LINE
	RIGHT-OF-WAY
	EASEMENT LINE
	BUILDING OUTLINE
	EDGE OF PAVEMENT
	STANDARD CURB AND GUTTER
	REJECT CURB AND GUTTER
	ASPHALT PAVEMENT
	HEAVY DUTY ASPHALT PAVEMENT
	CONCRETE PAVEMENT
+ + + + + + + + + + + + + + + + + + + +	HEAVY DUTY CONCRETE PAVEMENT
	PERMEABLE PAVERS
959	PROPOSED 1 FOOT CONTOUR
960	PROPOSED 5 FOOT CONTOUR
— — ·959· — —	EXISTING 1 FOOT CONTOUR
960	EXISTING 5 FOOT CONTOUR
-	DRAINAGE DIRECTION
	GRADE BREAK
	RETAINING WALL
x	RAILING
	FENCE
	SILT FENCE
	CONSTRUCTION ENTRANCE

EROSION MATTING

INLET PROTECTION

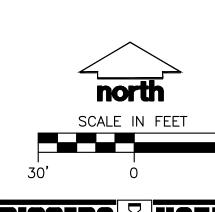

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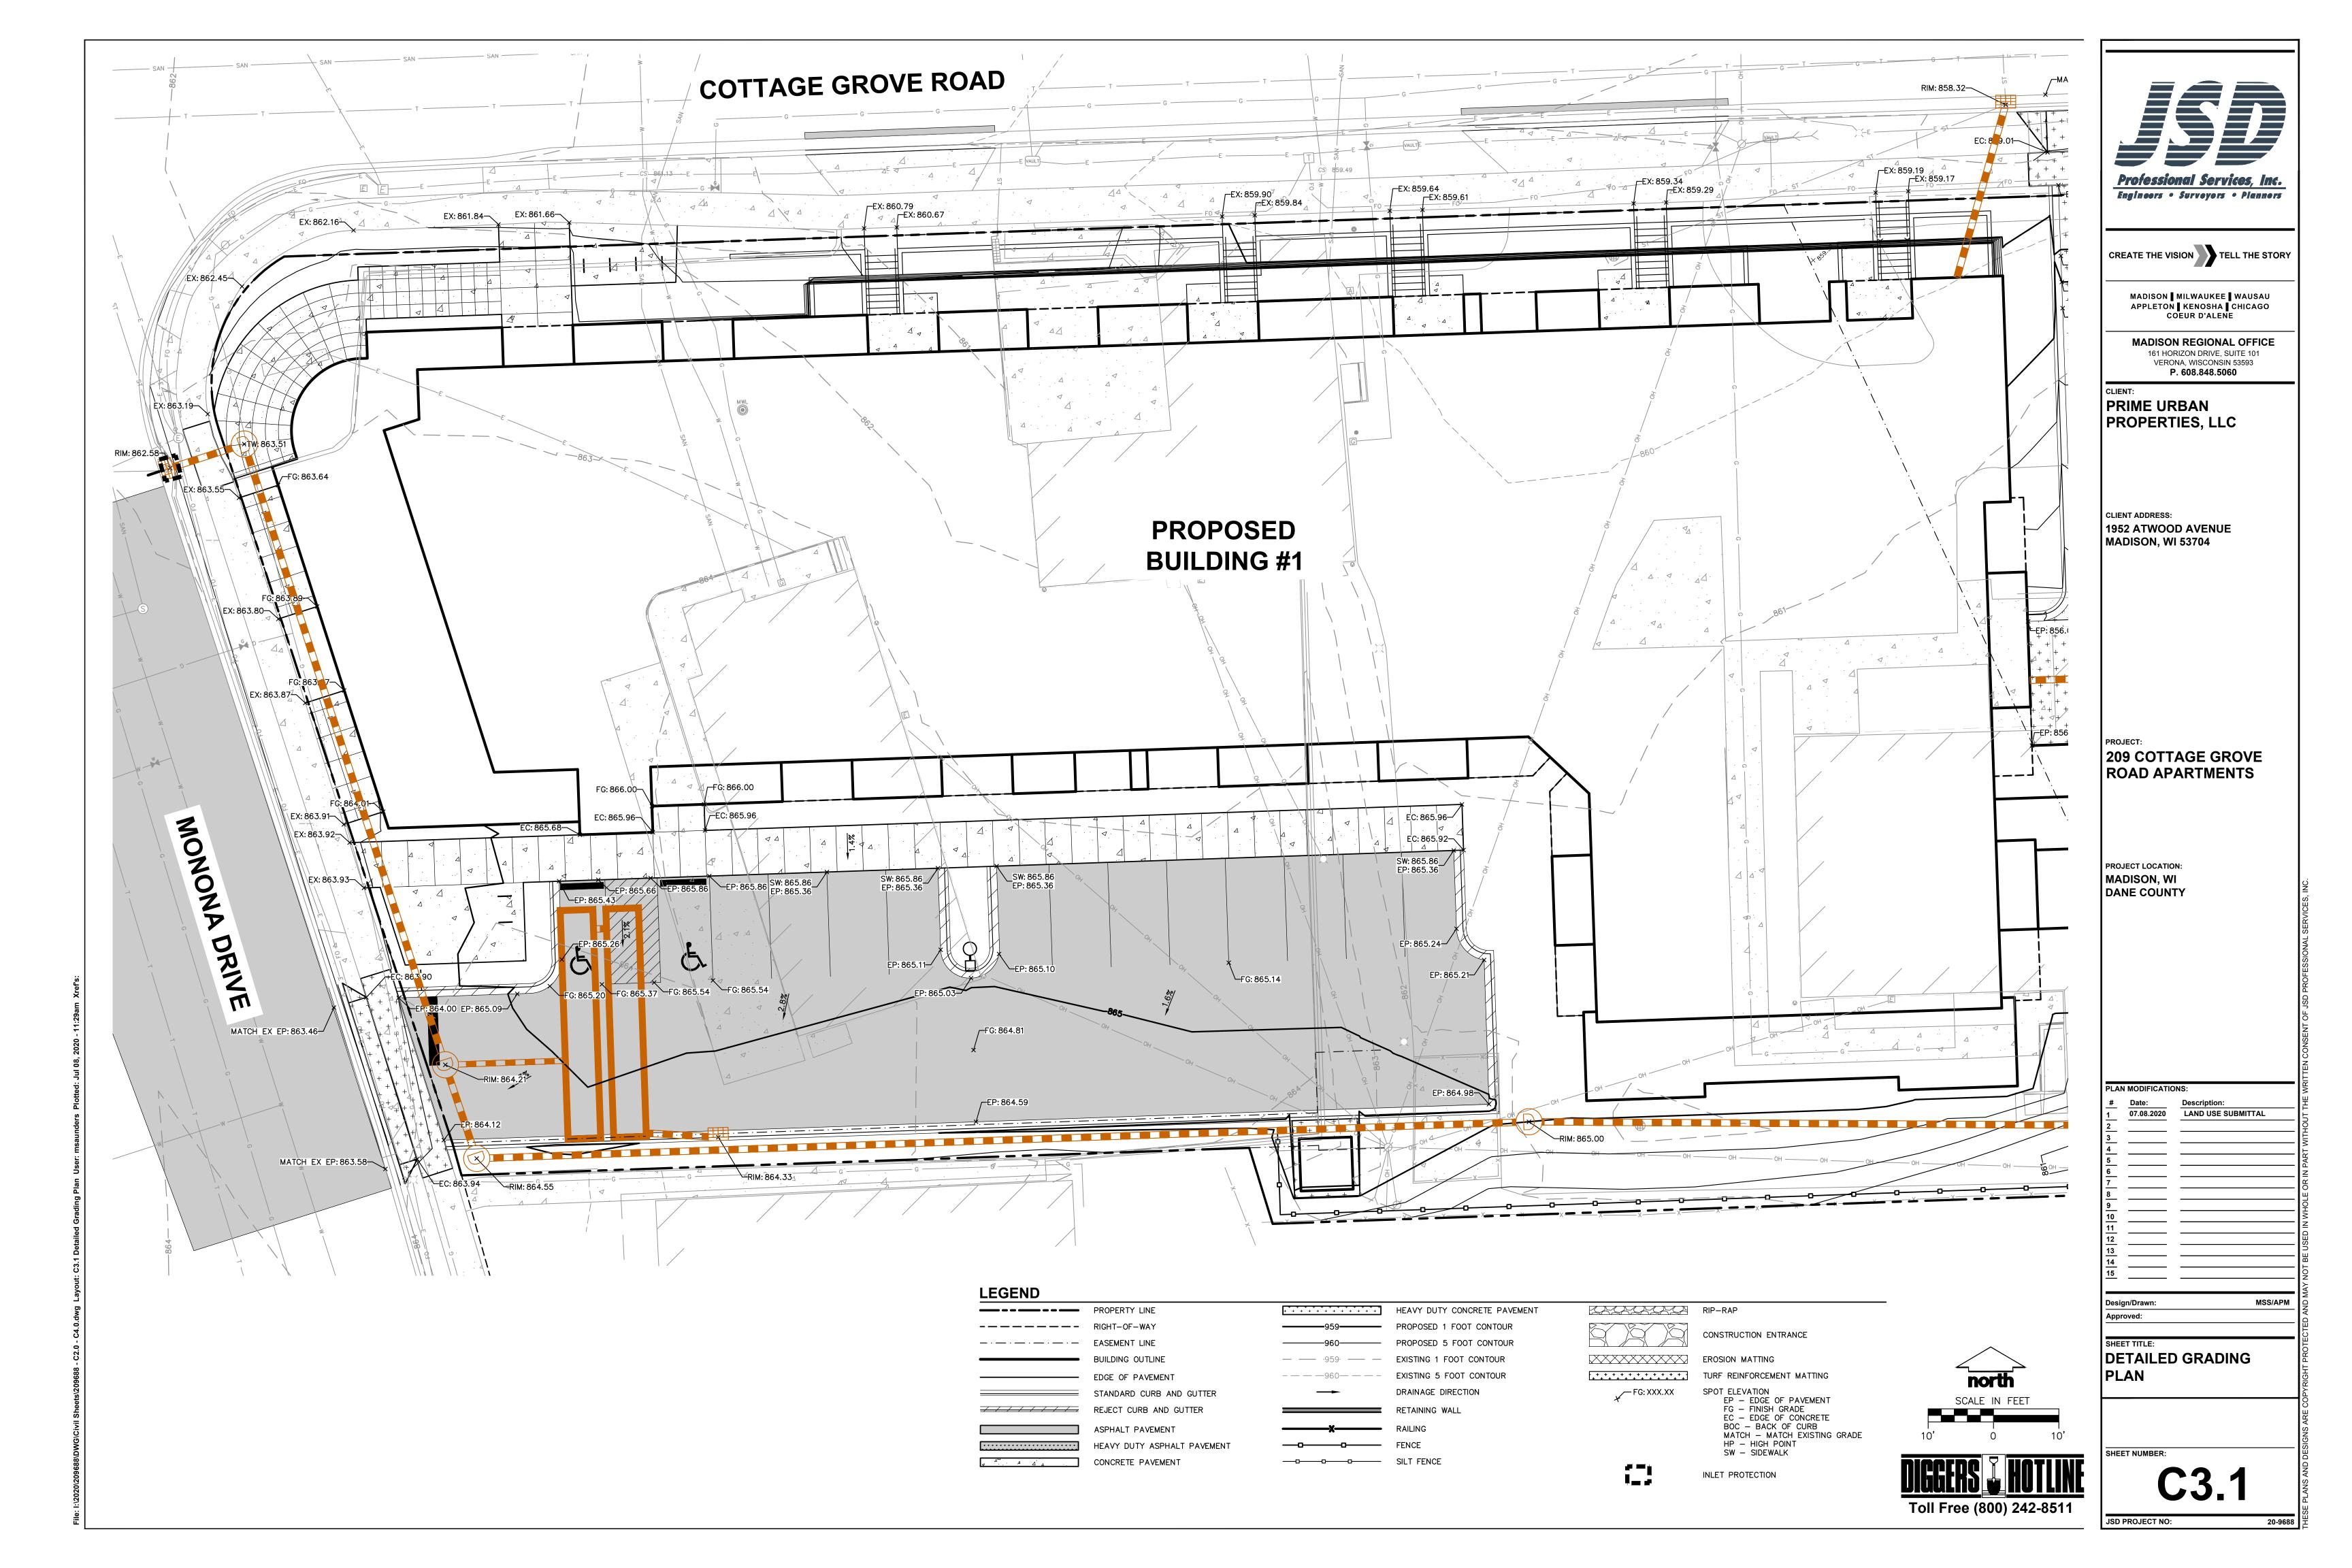
209 COTTAGE GROVE ROAD APARTMENTS


PROJECT LOCATION: MADISON, WI DANE COUNTY


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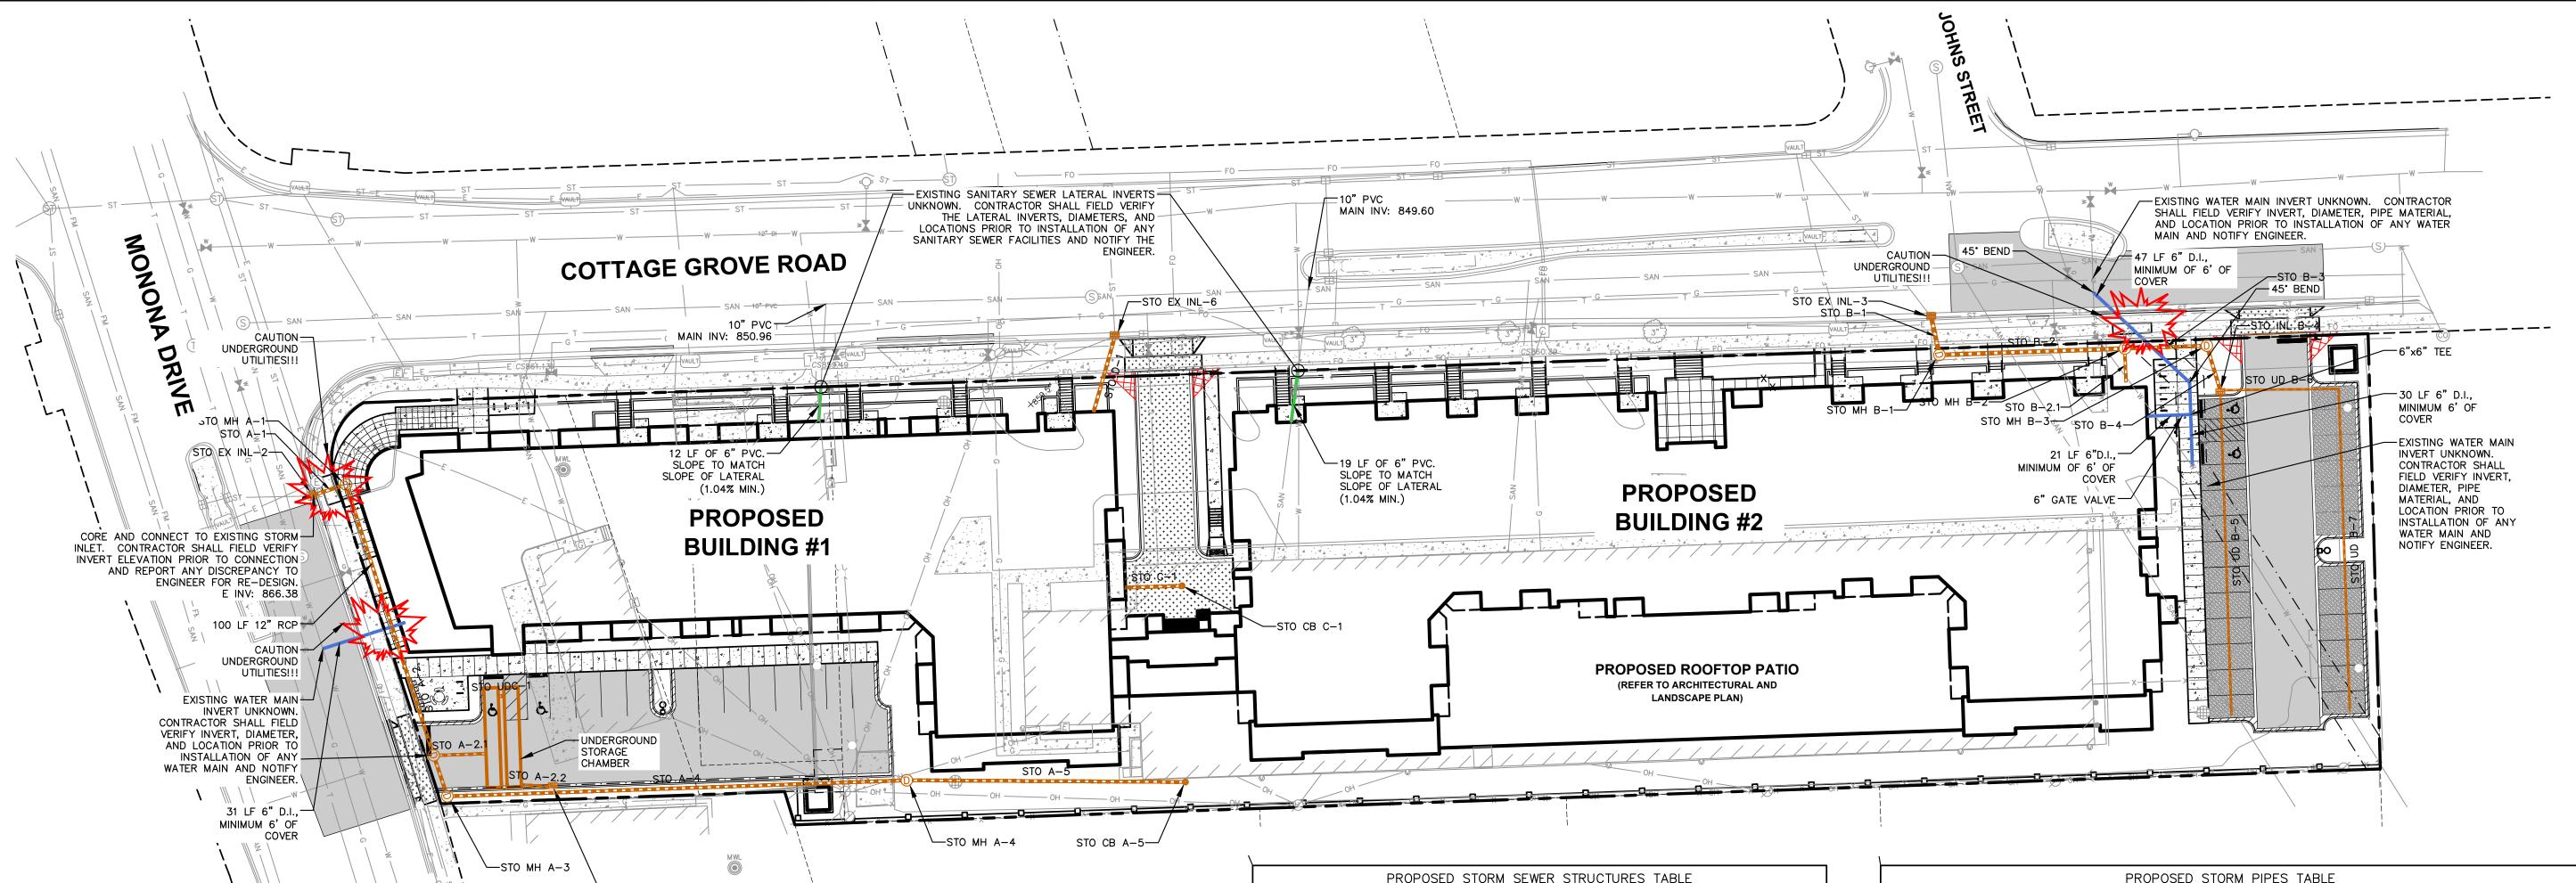
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GRADING & EROSION CONTROL PLAN







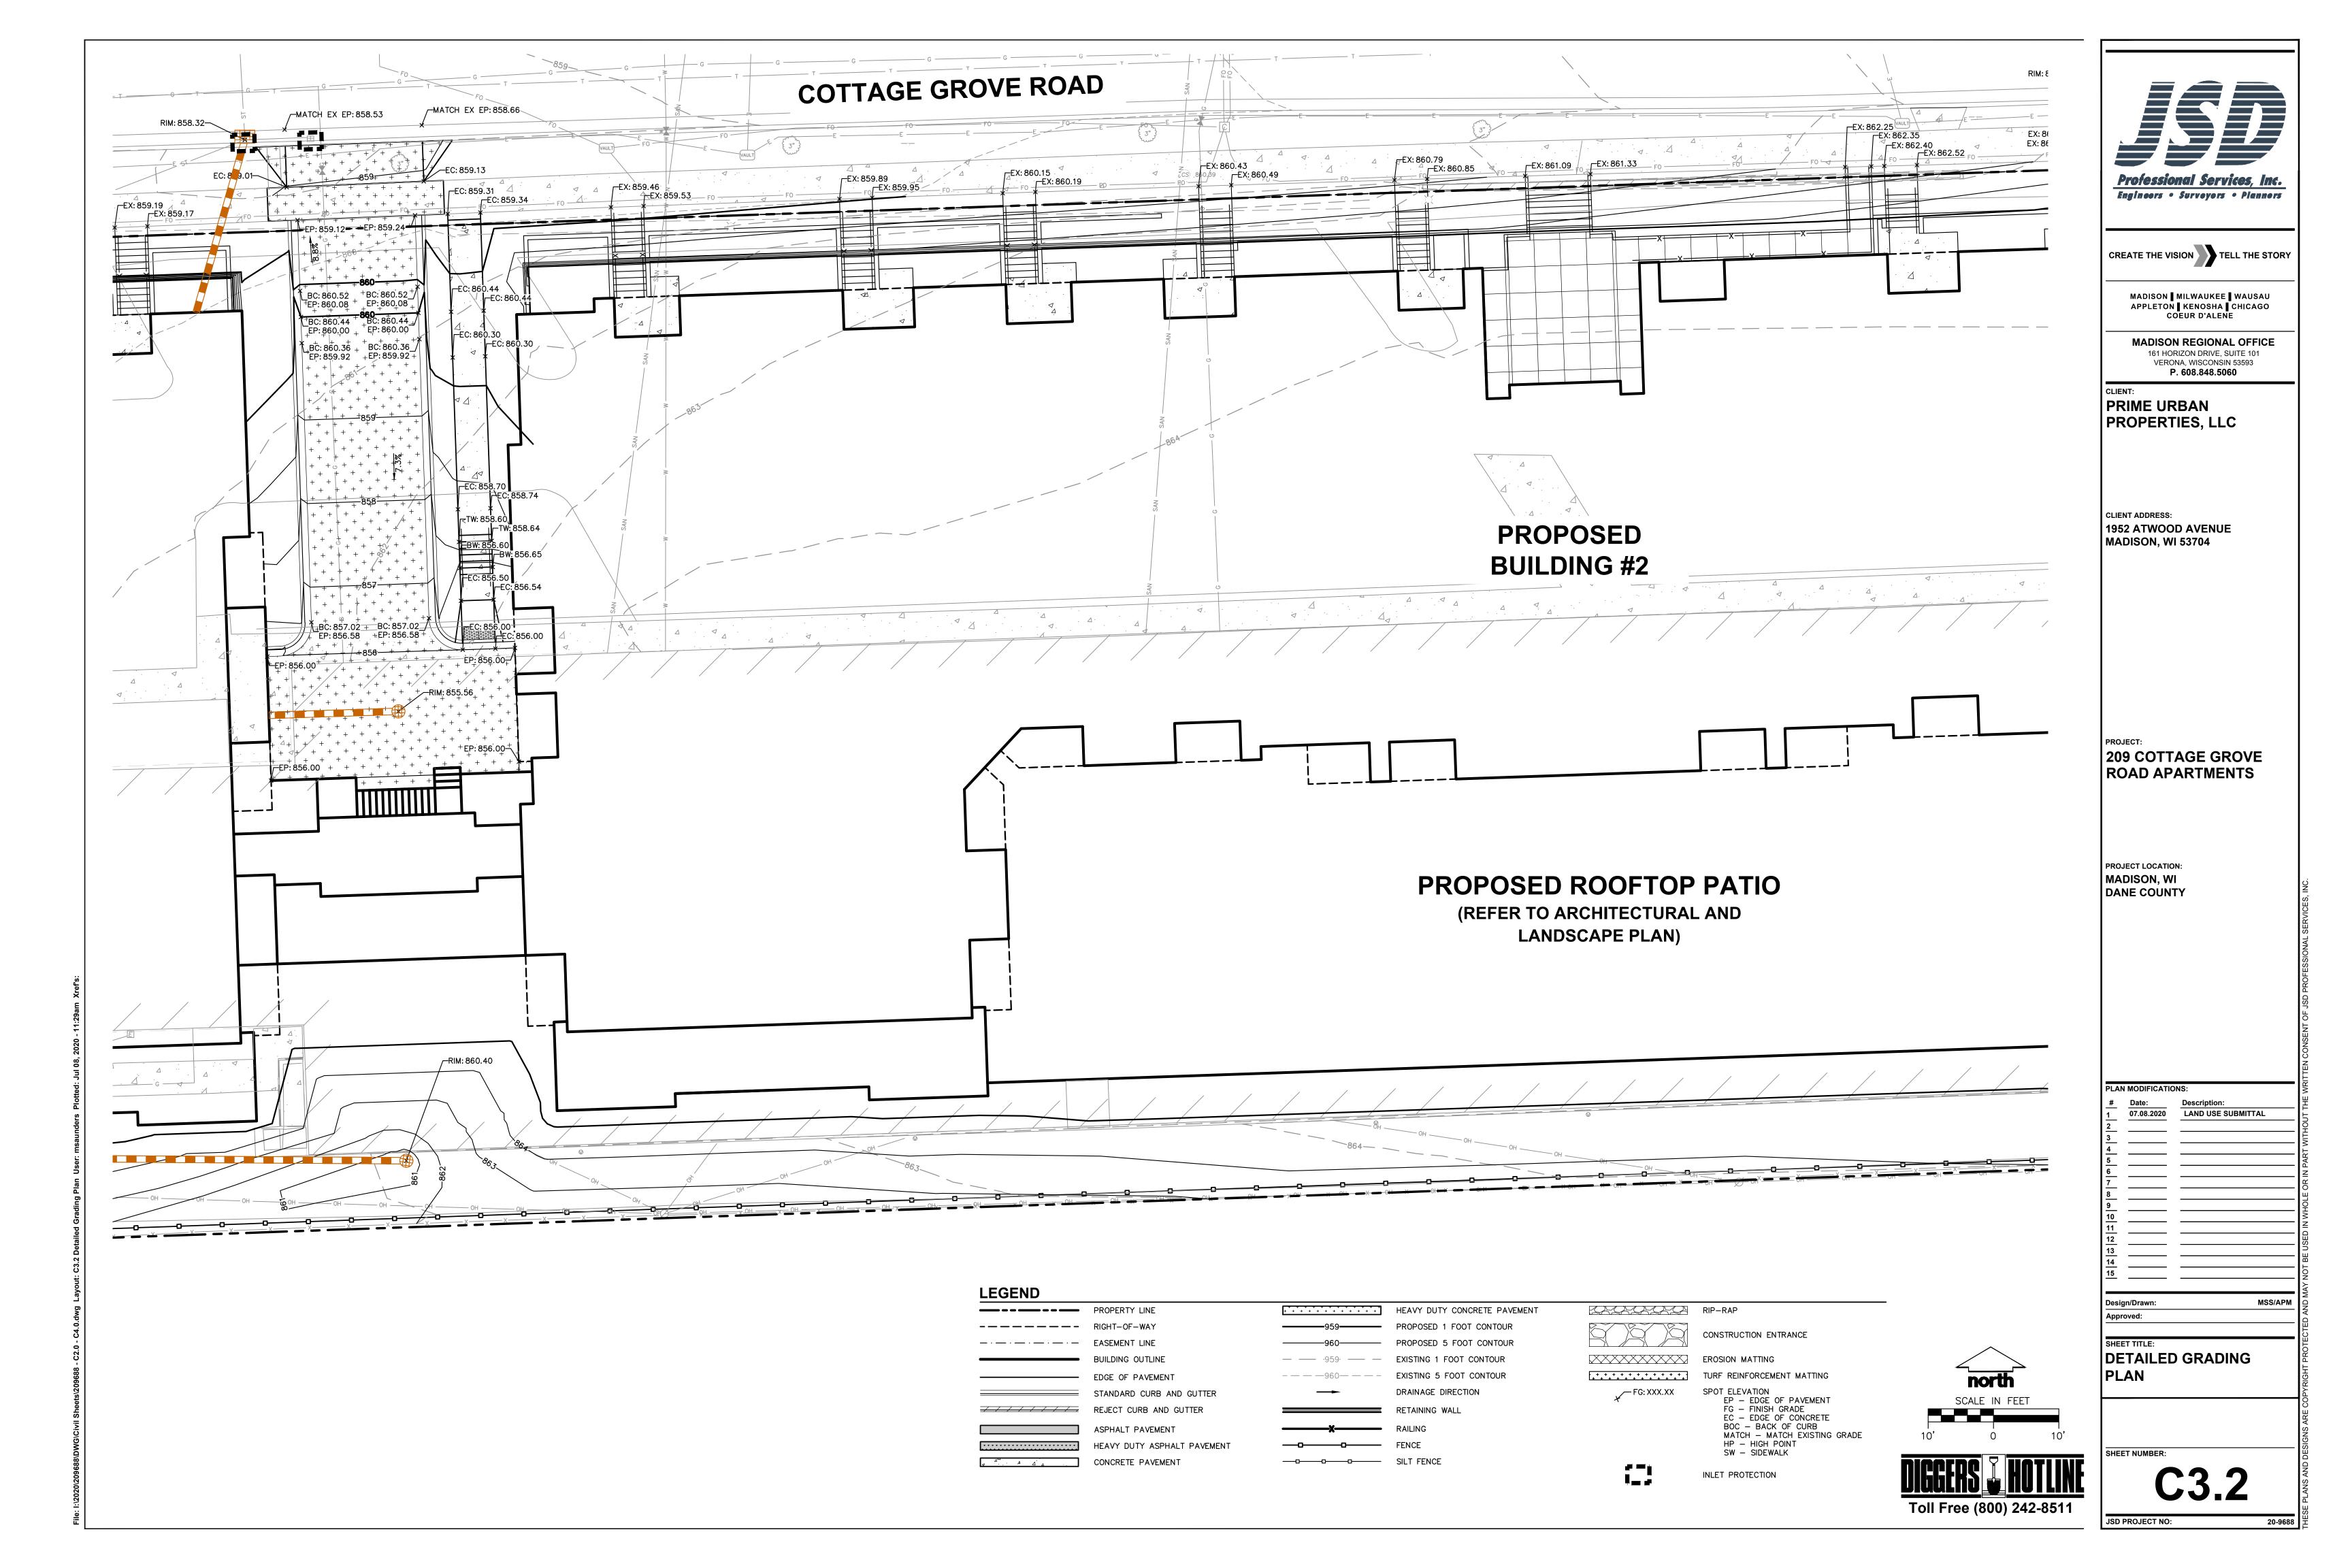

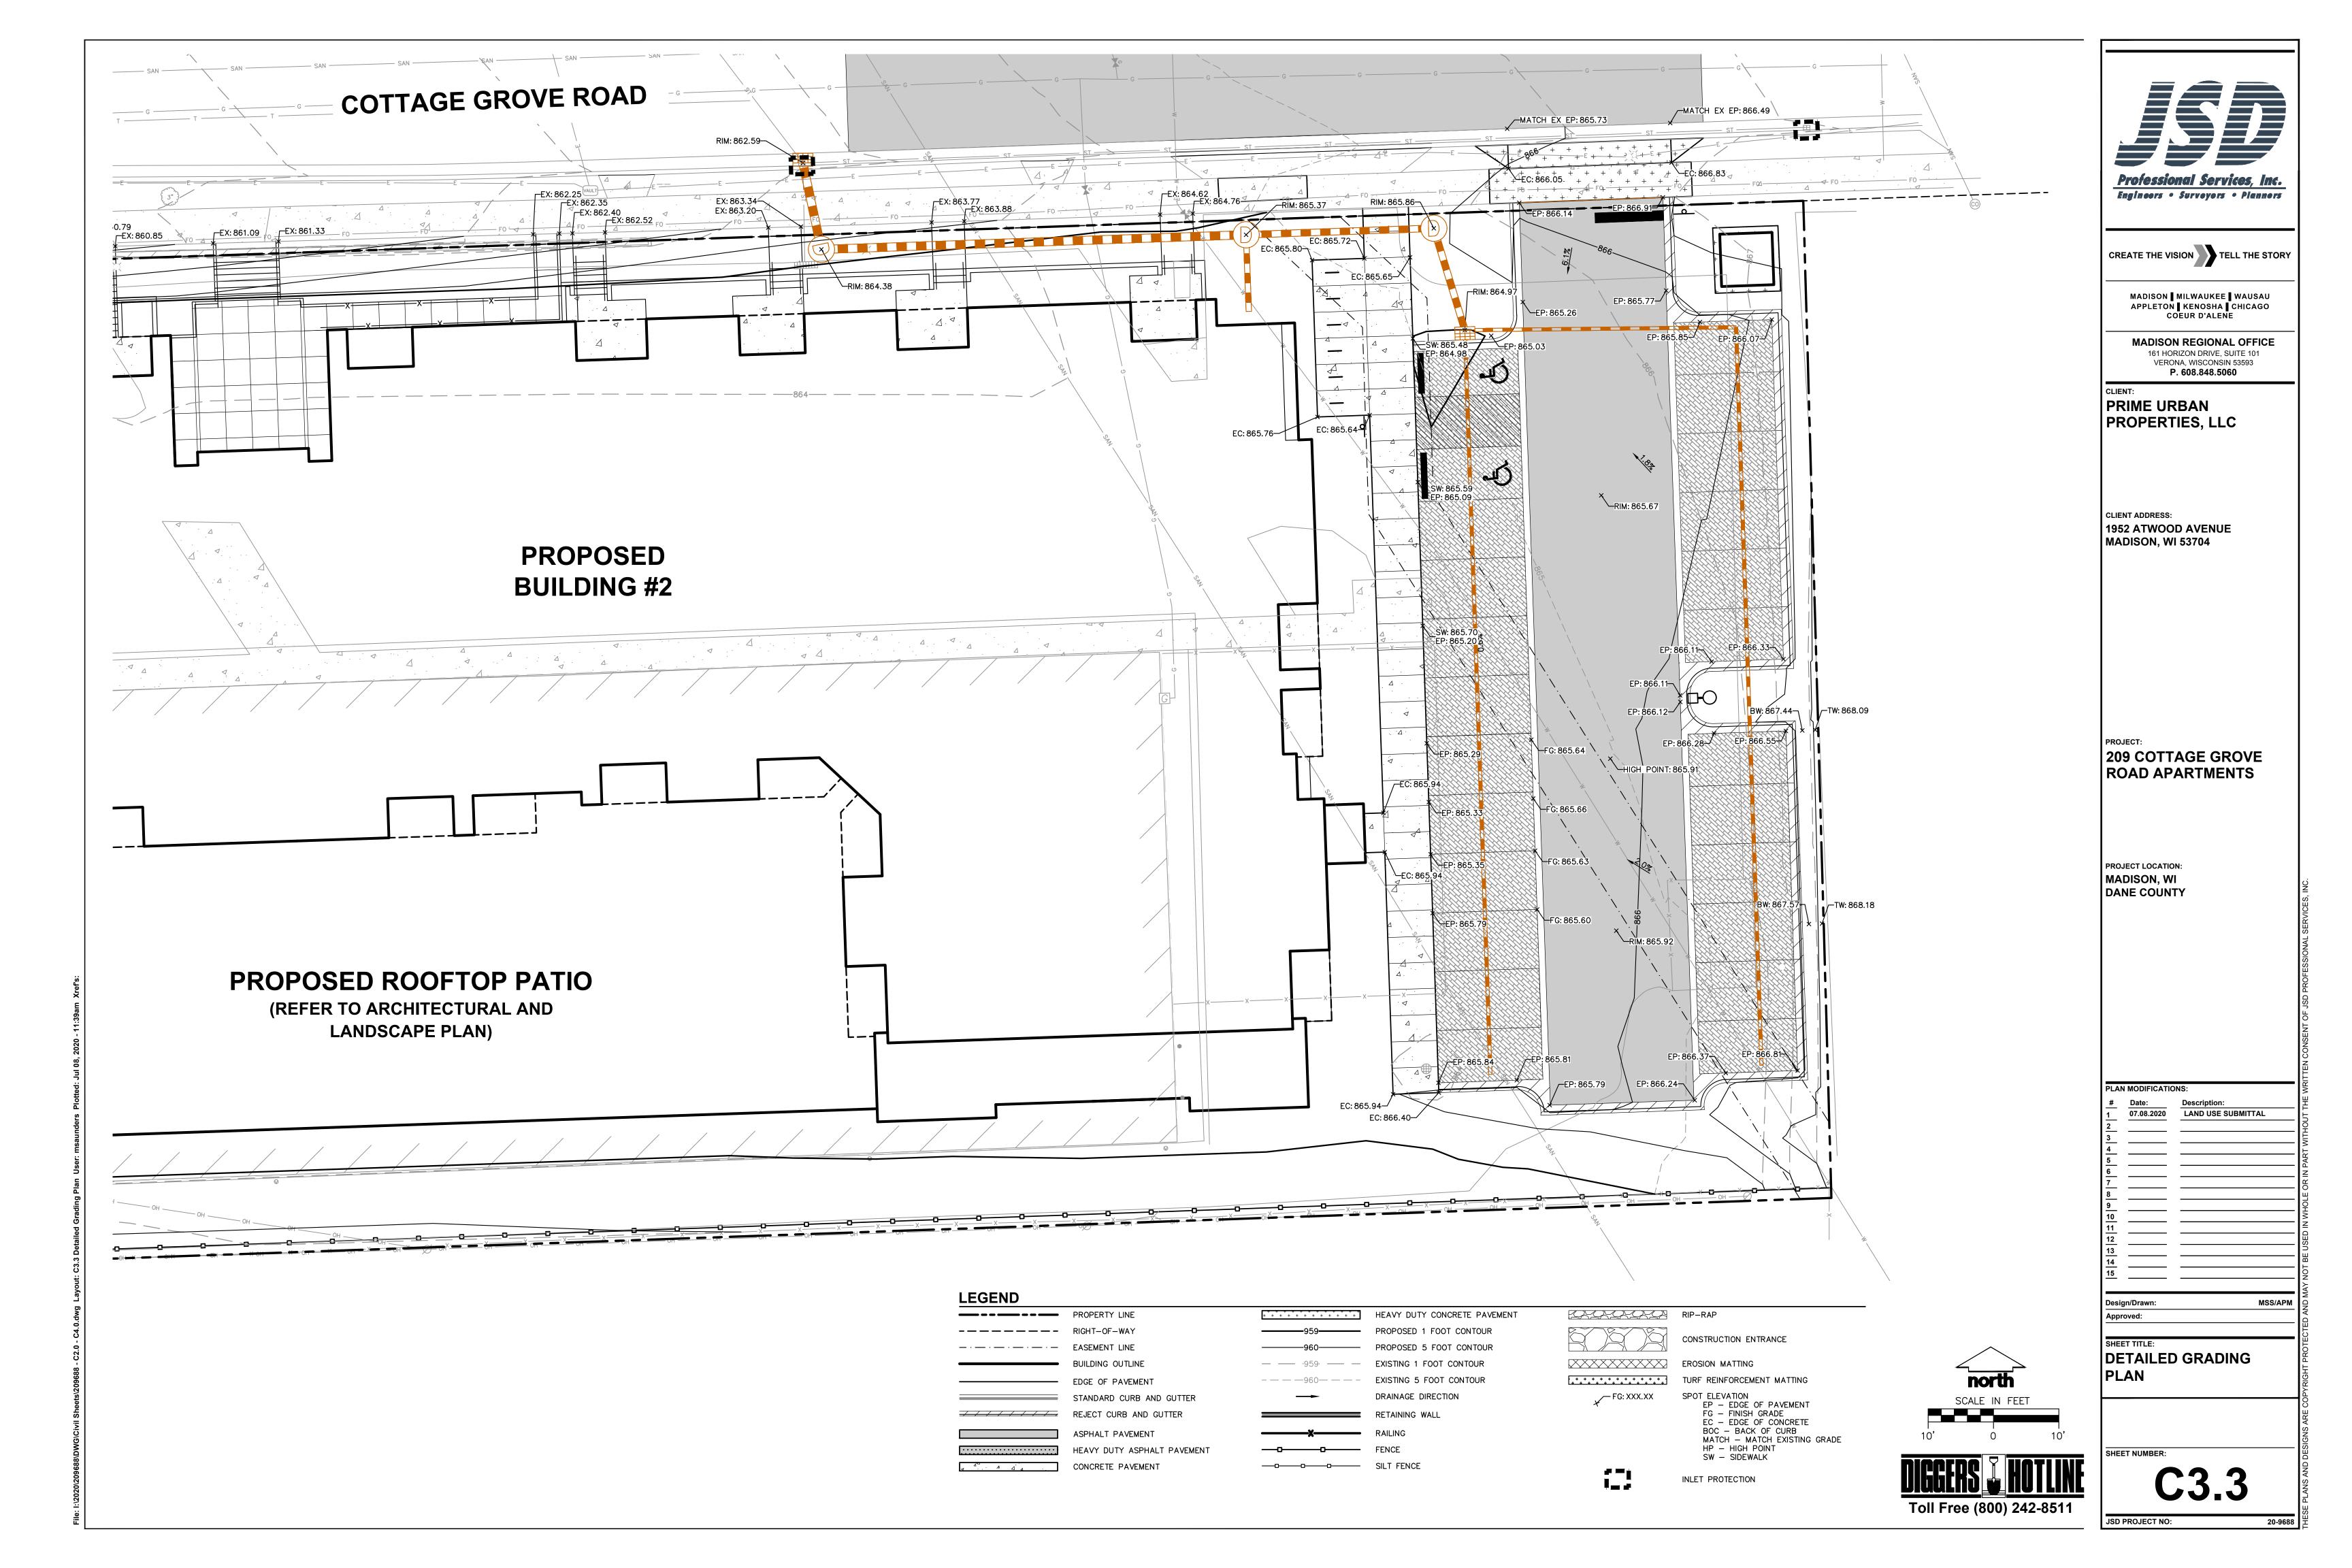UTILITY NOTES

ALL EXISTING UTILITIES ARE SHOWN FOR INFORMATIONAL PURPOSES ONLY AND ARE NOT GUARANTEED TO BE ACCURATE OR ALL INCLUSIVE. THE CONTRACTOR IS RESPONSIBLE FOR MAKING HIS OWN DETERMINATION AS TO THE TYPE AND LOCATIONS OF UNDERGROUND UTILITIES AS MAY BE NECESSARY TO AVOID DAMAGE THERETO. CONTRACTOR/OWNER SHALL CALL "DIGGER'S HOTLINE" PRIOR TO ANY CONSTRUCTION.

PRIOR TO CONSTRUCTION, THE PRIME CONTRACTOR IS RESPONSIBLE FOR: EXAMINING ALL SITE CONDITIONS RELATIVE TO THE CONDITIONS INDICATED ON THE ENGINEERING DRAWINGS. ANY DISCREPANCIES ARE TO BE REPORTED TO THE ENGINEER AND RESOLVED PRIOR TO THE START OF CONSTRUCTION. * OBTAINING ALL PERMITS INCLUDING PERMIT COSTS, TAP FEES, METER DEPOSITS,

BONDS, AND ALL OTHER FEES REQUIRED FOR PROPOSED WORK TO OBTAIN

- OCCUPANCY. * VERIFYING ALL ELEVATIONS, LOCATIONS AND SIZES OF SANITARY, WATER AND STORM LATERALS AND CHECK ALL UTILITY CROSSINGS FOR CONFLICTS. NOTIFY ENGINEER OF ANY DISCREPANCY. NO WORK SHALL BE PERFORMED UNTIL THE DISCREPANCY IS
- RESOLVED.
- * NOTIFYING ALL UTILITIES PRIOR TO INSTALLATION OF ANY UNDERGROUND IMPROVEMENTS.
- * NOTIFYING THE DESIGN ENGINEER AND MUNICIPALITY 48 HOURS PRIOR TO THE START OF CONSTRUCTION TO ARRANGE FOR APPROPRIATE CONSTRUCTION OBSERVATION. COORDINATING ALL CONSTRUCTION WITH OTHER CONTRACTORS INVOLVED WITH CONSTRUCTION OF THE PROPOSED DEVELOPMENT AND FOR REPORTING ANY ERRORS

OR DISCREPANCIES BETWEEN THESE PLANS AND PLANS PREPARED BY OTHERS.

- ALL UTILITY WORK SHALL BE DONE IN ACCORDANCE WITH THE STANDARD SPECIFICATIONS FOR SEWER AND WATER CONSTRUCTION IN WISCONSIN - AND ALL STATE AND LOCAL CODES AND SPECIFICATIONS. IT IS THE CONTRACTORS RESPONSIBILITY TO DETERMINE WHICH SPECIFICATIONS AND CODES APPLY, AND TO COORDINATE ALL CONSTRUCTION ACTIVITIES WITH THE APPROPRIATE LOCAL AND STATE AUTHORITIES.
- SPECIFICATIONS SHALL COMPLY WITH THE CITY OF MADISON SPECIAL PROVISIONS.
- LENGTHS OF ALL UTILITIES ARE TO CENTER OF STRUCTURES OR FITTINGS AND MAY VARY SLIGHTLY FROM PLAN. LENGTHS SHALL BE VERIFIED IN THE FIELD DURING CONSTRUCTION.
- CONTRACTOR IS RESPONSIBLE FOR SITE SAFETY DURING THE CONSTRUCTION OF IMPROVEMENTS.
- CONTRACTOR SHALL INSTALL A PEDESTRIAN FENCE AROUND ALL EXCAVATIONS TO BE LEFT OPEN OVER NIGHT AS REQUIRED IN CONSTRUCTION SITES WHERE THE POTENTIAL FOR PEDESTRIAN INJURY EXISTS.
- CONTRACTOR SHALL ADJUST AND/OR RECONSTRUCT ALL UTILITY COVERS (SUCH AS MANHOLE COVERS, VALVE BOX COVERS, ETC.) TO MATCH THE FINISHED GRADES OF THE AREAS EFFECTED BY THE CONSTRUCTION.
- THE PRIME CONTRACTOR IS RESPONSIBLE FOR COORDINATING ALL CONSTRUCTION WITH OTHER CONTRACTORS INVOLVED WITH CONSTRUCTION OF THE PROPOSED DEVELOPMENT AND FOR REPORTING ANY ERRORS OR DISCREPANCIES BETWEEN THESE PLANS AND PLANS PREPARED BY OTHERS.
- O. ANY SANITARY SEWER, SANITARY SEWER SERVICES, WATER MAIN, WATER SERVICES, STORM SEWER, OR OTHER UTILITIES, WHICH ARE DAMAGED BY THE CONTRACTORS, SHALL BE REPAIRED TO THE OWNER'S SATISFACTION AT THE CONTRACTOR'S EXPENSE.
- THE CONTRACTOR IS RESPONSIBLE FOR PROVIDING THE ENGINEER WITH AS-BUILT CONDITIONS OF THE DESIGNATED IMPROVEMENTS IN ORDER THAT THE APPROPRIATE DRAWINGS CAN BE PREPARED, IF REQUIRED. ANY CHANGES TO THE DRAWINGS OR ADDITIONAL ITEMS MUST BE REPORTED TO THE ENGINEER AS WORK PROGRESSES.

2. STORM SEWER SPECIFICATIONS -

PIPE - REINFORCED CONCRETE PIPE (RCP) SHALL MEET THE REQUIREMENTS OF ASTM CLASS III (MINIMUM) C-76 WITH RUBBER GASKET JOINTS CONFORMING TO ASTM C-443. HIGH DENSITY DUAL-WALL POLYETHYLENE CORRUGATED PIPE SHALL BE AS MANUFACTURED BY ADS OR EQUAL WITH WATER TIGHT JOINTS, AND SHALL MEET THE REQUIREMENTS OF AASHTO DESIGNATION M-294 TYPE "S".

INLETS - INLETS SHALL BE CONSTRUCTED IN ACCORDANCE WITH FILE. NO. 28 OF THE "STANDARD SPECIFICATIONS", OR APPROVED EQUAL WITH A 1'-8" X 2'-6" MAXIMUM OPENING. CURB FRAME & GRATE SHALL BE NEENAH R-3067 WITH TYPE R GRATE, OR

BACKFILL AND BEDDING - STORM SEWER SHALL BE CONSTRUCTED WITH GRAVEL BACKFILL AND CLASS "B" BEDDING IN ALL PAVED AREAS AND TO A POINT 5 FEET BEYOND THE EDGE OF PAVEMENT. TRENCHES RUNNING PARALLEL TO AND LESS THAN 5 FEET FROM THE EDGE OF PAVEMENT SHALL ALSO REQUIRE GRAVEL BACKFILL. LANDSCAPED AREAS MAY BE BACKFILLED WITH EXCAVATED MATERIAL IN CONFORMANCE WITH SECTION 8.43.5 OF THE "STANDARD SPECIFICATIONS".

FIELD TILE CONNECTION - ALL FIELD TILE ENCOUNTERED DURING CONSTRUCTION SHALL BE INCLUDED IN THE UNIT PRICE(S) FOR STORM SEWER. TILE LINES CROSSED BY THE TRENCH SHALL BE REPLACED WITH THE SAME MATERIAL AS THE STORM SEWER.

13. WATER MAIN SPECIFICATIONS -

-STO INL A-2.2

PIPE - DUCTILE IRON PIPE SHALL BE CLASS 52 CONFORMING TO AWWA C151 AND CHAPTER 8.18.0 OF THE "STANDARD SPECIFICATIONS". POLYVINYL CHLORIDE (PVC) PIPE SHALL MEET THE REQUIREMENTS OF AWWA STANDARD C-900, CLASS 150, DR-18, WITH CAST IRON O.D. AND INTEGRAL ELASTOMERIC BELL AND SPIGOT JOINTS. NON-METALLIC WATER MAINS SHALL BE INSTALLED WITH BLUE INSULATION TRACER WIRE AND CONFORM WITH SPS 382.30(11)(h).

VALVES AND VALVE BOXES - GATE VALVES SHALL BE AWWA GATE VALVES MEETING THE REQUIREMENTS OF AWWA C-500 AND CHAPTER 8.27.0 OF THE "STANDARD SPECIFICATIONS". GATE VALVES AND VALVE BOXES SHALL CONFORM TO LOCAL PLUMBING ORDINANCES.

HYDRANTS - HYDRANTS SHALL CONFORM TO THE SPECIFICATIONS OF THE CITY OF MADISON. THE DISTANCE FROM THE GROUND LINE TO THE CENTERLINE OF THE LOWEST NOZZLE AND THE LOWEST CONNECTION OF THE FIRE DEPARTMENT SHALL BE NO LESS THAN 18-INCHES AND NO ------GREATER THAN 23-INCHES (SEE DETAIL).

BEDDING AND COVER MATERIAL - PIPE BEDDING AND COVER MATERIAL SHALL BE SAND, CRUSHED STONE CHIPS OR CRUSHED STONE SCREENINGS CONFORMING TO CHAPTER

8.43.2 OF THE "STANDARD SPECIFICATIONS".

BACKFILL - BACKFILL MATERIAL AND INSTALLATION SHALL BE IN ACCORDANCE WITH CHAPTER 2.6.0 OF THE "STANDARD SPECIFICATIONS". GRAVEL BACKFILL IS REQUIRED IN ALL PAVED AREAS AND TO A POINT 5 FEET BEYOND THE EDGE OF PAVEMENT. TRENCHES RUNNING PARALLEL TO AND LESS THAN 5 FEET FROM THE EDGE OF PAVEMENT SHALL ALSO REQUIRE GRAVEL BACKFILL, LANDSCAPED AREAS MAY BE BACKFILLED WITH EXCAVATED MATERIAL IN CONFORMANCE WITH SECTION 8.43.5 OF THE "STANDARD SPECIFICATIONS".

14. SANITARY SEWER SPECIFICATIONS -

PIPE - SANITARY SEWER PIPE MATERIAL SHALL BE POLYVINYL CHLORIDE (PVC) MEETING REQUIREMENTS OF ASTM D 3034. SDR-35. WITH INTEGRAL BELL TYPE FLEXIBLE ELASTOMERIC JOINTS, MEETING THE REQUIREMENTS OF ASTM

BEDDING AND COVER MATERIAL - BEDDING AND COVER MATERIAL SHALL CONFORM TO THE APPROPRIATE SECTIONS OF THE "STANDARD SPECIFICATION" WITH THE FOLLOWING MODIFICATION: "COVER MATERIAL SHALL BE THE SAME AS USED FOR BEDDING AND SHALL CONFORM TO SECTION 8.43.2 (A). BEDDING AND COVER MATERIAL SHALL BE PLACED IN A MINIMUM OF THREE SEPARATE LIFTS, OR AS REQUIRED TO INSURE ADEQUATE COMPACTING OF THESE MATERIALS, WITH ONE LIFT OF BEDDING MATERIAL ENDING AT OR NEAR THE SPRINGLINE OF THE PIPE. THE CONTRACTOR SHALL TAKE CARE TO COMPLETELY WORK BEDDING MATERIAL UNDER THE HAUNCH OF THE PIPE TO PROVIDE ADEQUATE SIDE SUPPORT."

BACKFILL - BACKFILL MATERIAL AND INSTALLATION SHALL BE IN ACCORDANCE CHAPTER 2.6.0 OF THE "STANDARD SPECIFICATIONS." GRAVEL BACKFILL IS REQUIRED IN ALL PAVED AREAS AND TO A POINT 5 FEET BEYOND THE EDGE OF PAVEMENT. TRENCHES RUNNING PARALLEL TO AND LESS THAN 5 FEET FROM THE EDGE OF PAVEMENT SHALL ALSO REQUIRE GRAVEL BACKFILL. LANDSCAPED AREAS MAY BE BACKFILLED WITH EXCAVATED MATERIAL IN CONFORMANCE WITH SECTION 8.43.5 OF THE "STANDARD SPECIFICATIONS."

MANHOLES - MANHOLES SHALL BE CONSTRUCTED IN ACCORDANCE WITH FILE NOS. 12, 13 AND 15 OF THE "STANDARD SPECIFICATIONS" AND ALL SPECIAL PROVISIONS OF THE CITY OF MADISON.

15. WATERMAIN AND SANITARY SEWER SHALL BE INSULATED WHEREVER THE DEPTH OF COVER IS LESS THAN 6 FEET. INSULATION AND INSTALLATION OF INSULATION SHALL BE CONFORMING WITH CHAPTER 4.17.0 "INSULATION" OF THE STANDARD SPECIFICATIONS FOR SEWER AND WATER CONSTRUCTION IN WISCONSIN 6TH EDITION UPDATED WITH ITS LATEST ADDENDUM (TYP.).

		THOI GOLD STORM SEWER STREET							
		LABEL	RIM EL. (FT)	INVERT EL. (FT)	DEPTH (FT)	STRUCTURE DESC.	FRAME & GRAT		
LEGEND		STO CB A-5	860.40	W INV: 858.72 (12")	1.7	36 IN MH (FLAT)	R-2050 TYPE (
	PROPERTY LINE	STO CB C-1	855.56	W INV: 852.46 (12")	3.1	36 IN MH (FLAT)	R-2050 TYPE [
	RIGHT-OF-WAY	STO INL A-2.2	864.33	W INV: 859.36 (12")	5.0	2 x 3 INLET	R-3067 TYPE I		
	EASEMENT LINE BUILDING OUTLINE	STO INL B-4	864.97	N INV: 861.11 (12") S INV: 861.61 (6") E INV: 861.61 (6")	3.9	2 x 3 INLET	R-3067 TYPE I		
	EDGE OF PAVEMENT STANDARD CURB AND GUTTER	STO MH A-1	863.51	W INV: 856.44 (12") S INV: 856.54 (12")	7.1	48 IN MH (FLAT)	R-1550 SOLID L		
	REJECT CURB AND GUTTER ASPHALT PAVEMENT	STO MH A-2	864.21	N INV: 857.04 (12") S INV: 857.14 (12") E INV: 859.21 (10")	7.2	48 IN MH (FLAT)	R-1550 SOLID L		
4 + + + + + + + + + + + + + + + + + + +	CONCRETE PAVEMENT HEAVY DUTY CONCRETE PAVEMENT	STO MH A-3	864.55	N INV: 857.22 (12") E INV: 857.32 (12")	7.3	48 IN MH (FLAT)	R-1550 SOLID L		
×	RETAINING WALL RAILING	STO MH A-4	865.00	W INV: 858.13 (12") E INV: 858.23 (12")	6.9	48 IN MH (FLAT)	R-1550 SOLID L		
	FENCE SANITARY SEWER	STO MH B-1	864.38	N INV: 859.94 (15") E INV: 860.04 (15")	4.4	48 IN MH (FLAT)	R-1550 SOLID L		
	WATERMAIN	STO MH B-3	865.86	W INV: 860.93 (12") S INV: 861.03 (12")	4.9	48 IN MH (FLAT)	R-1550 SOLID L		
	STORM SEWER		-	•	•				

		PROPO:	SED STO	ORM PIPES TAE	BLE		
LABEL	FROM	то	LENGTH	INVERT EL. (FT)	DISCHARGE EL. (FT)	SLOPE	SIZE & MATERIAL
STO A-1	STO MH A-1	STO EX INL-2	12'	856.44	856.38	0.50%	12 IN RCP
STO A-2	STO MH A-2	STO MH A-1	100'	857.04	856.54	0.50%	12 IN RCP
STO A-2.1	STO UDC O	STO MH A-2	18'	859.30	859.21	0.50%	10 IN HDPE
STO A-2.2	STO INL A-2.2	STO UDC I	11'	859.36	859.30	0.50%	12 IN HDPE (HP)
STO A-3	STO MH A-3	STO MH A-2	15'	857.22	857.14	0.50%	12 IN RCP
STO A-4	STO MH A-4	STO MH A-3	161'	858.13	857.32	0.50%	12 IN HDPE (HP)
STO A-5	STO CB A-5	STO MH A-4	98'	858.72	858.23	0.50%	12 IN HDPE (HP)
STO B-1	STO MH B-1	STO EX INL-3	14'	859.94	859.80	1.00%	15 IN HDPE
STO B-2	STO MH B-2	STO MH B-1	65'	860.69	860.04	1.00%	15 IN HDPE
STO B-2.1	STO RD B-2.1	STO MH B-2	12'	861.34	861.11	2.00%	10 IN HDPE
STO B-3	STO MH B-3	STO MH B-2	29'	860.93	860.79	0.50%	12 IN HDPE
STO B-4	STO INL B-4	STO MH B-3	16'	861.11	861.03	0.50%	12 IN HDPE
STO C-1	STO CB C-1	STO INL C-BUILDING	20'	852.46	852.06	2.00%	12 IN HDPE
STO D-1	STO RD D-1	STO EX INL-6	27'	856.15	855.88	1.00%	12 IN HDPE
STO UD B-5	STO CO B-5	STO INL B-4	114'	862.18	861.61	0.50%	6 IN HDPE
STO UD B-6	STO CO B-6	STO INL B-4	42'	861.82	861.61	0.50%	6 IN HDPE
STO UD B-7	STO CO B-7	STO CO B-6	113'	862.38	861.82	0.50%	6 IN HDPE
STO UDC-1	UG CHAMBER	UG CHAMBER	2'	-0.50	-0.50	0.00%	12 IN HDPE



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MADISON REGIONAL OFFICE 161 HORIZON DRIVE, SUITE 101 VERONA, WISCONSIN 53593 P. 608.848.5060

PRIME URBAN PROPERTIES, LLC

CLIENT ADDRESS: 1952 ATWOOD AVENUE **MADISON, WI 53704**

209 COTTAGE GROVE ROAD APARTMENTS


PROJECT LOCATION: MADISON, WI DANE COUNTY

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UTILITY PLAN



Toll Free (800) 242-8511

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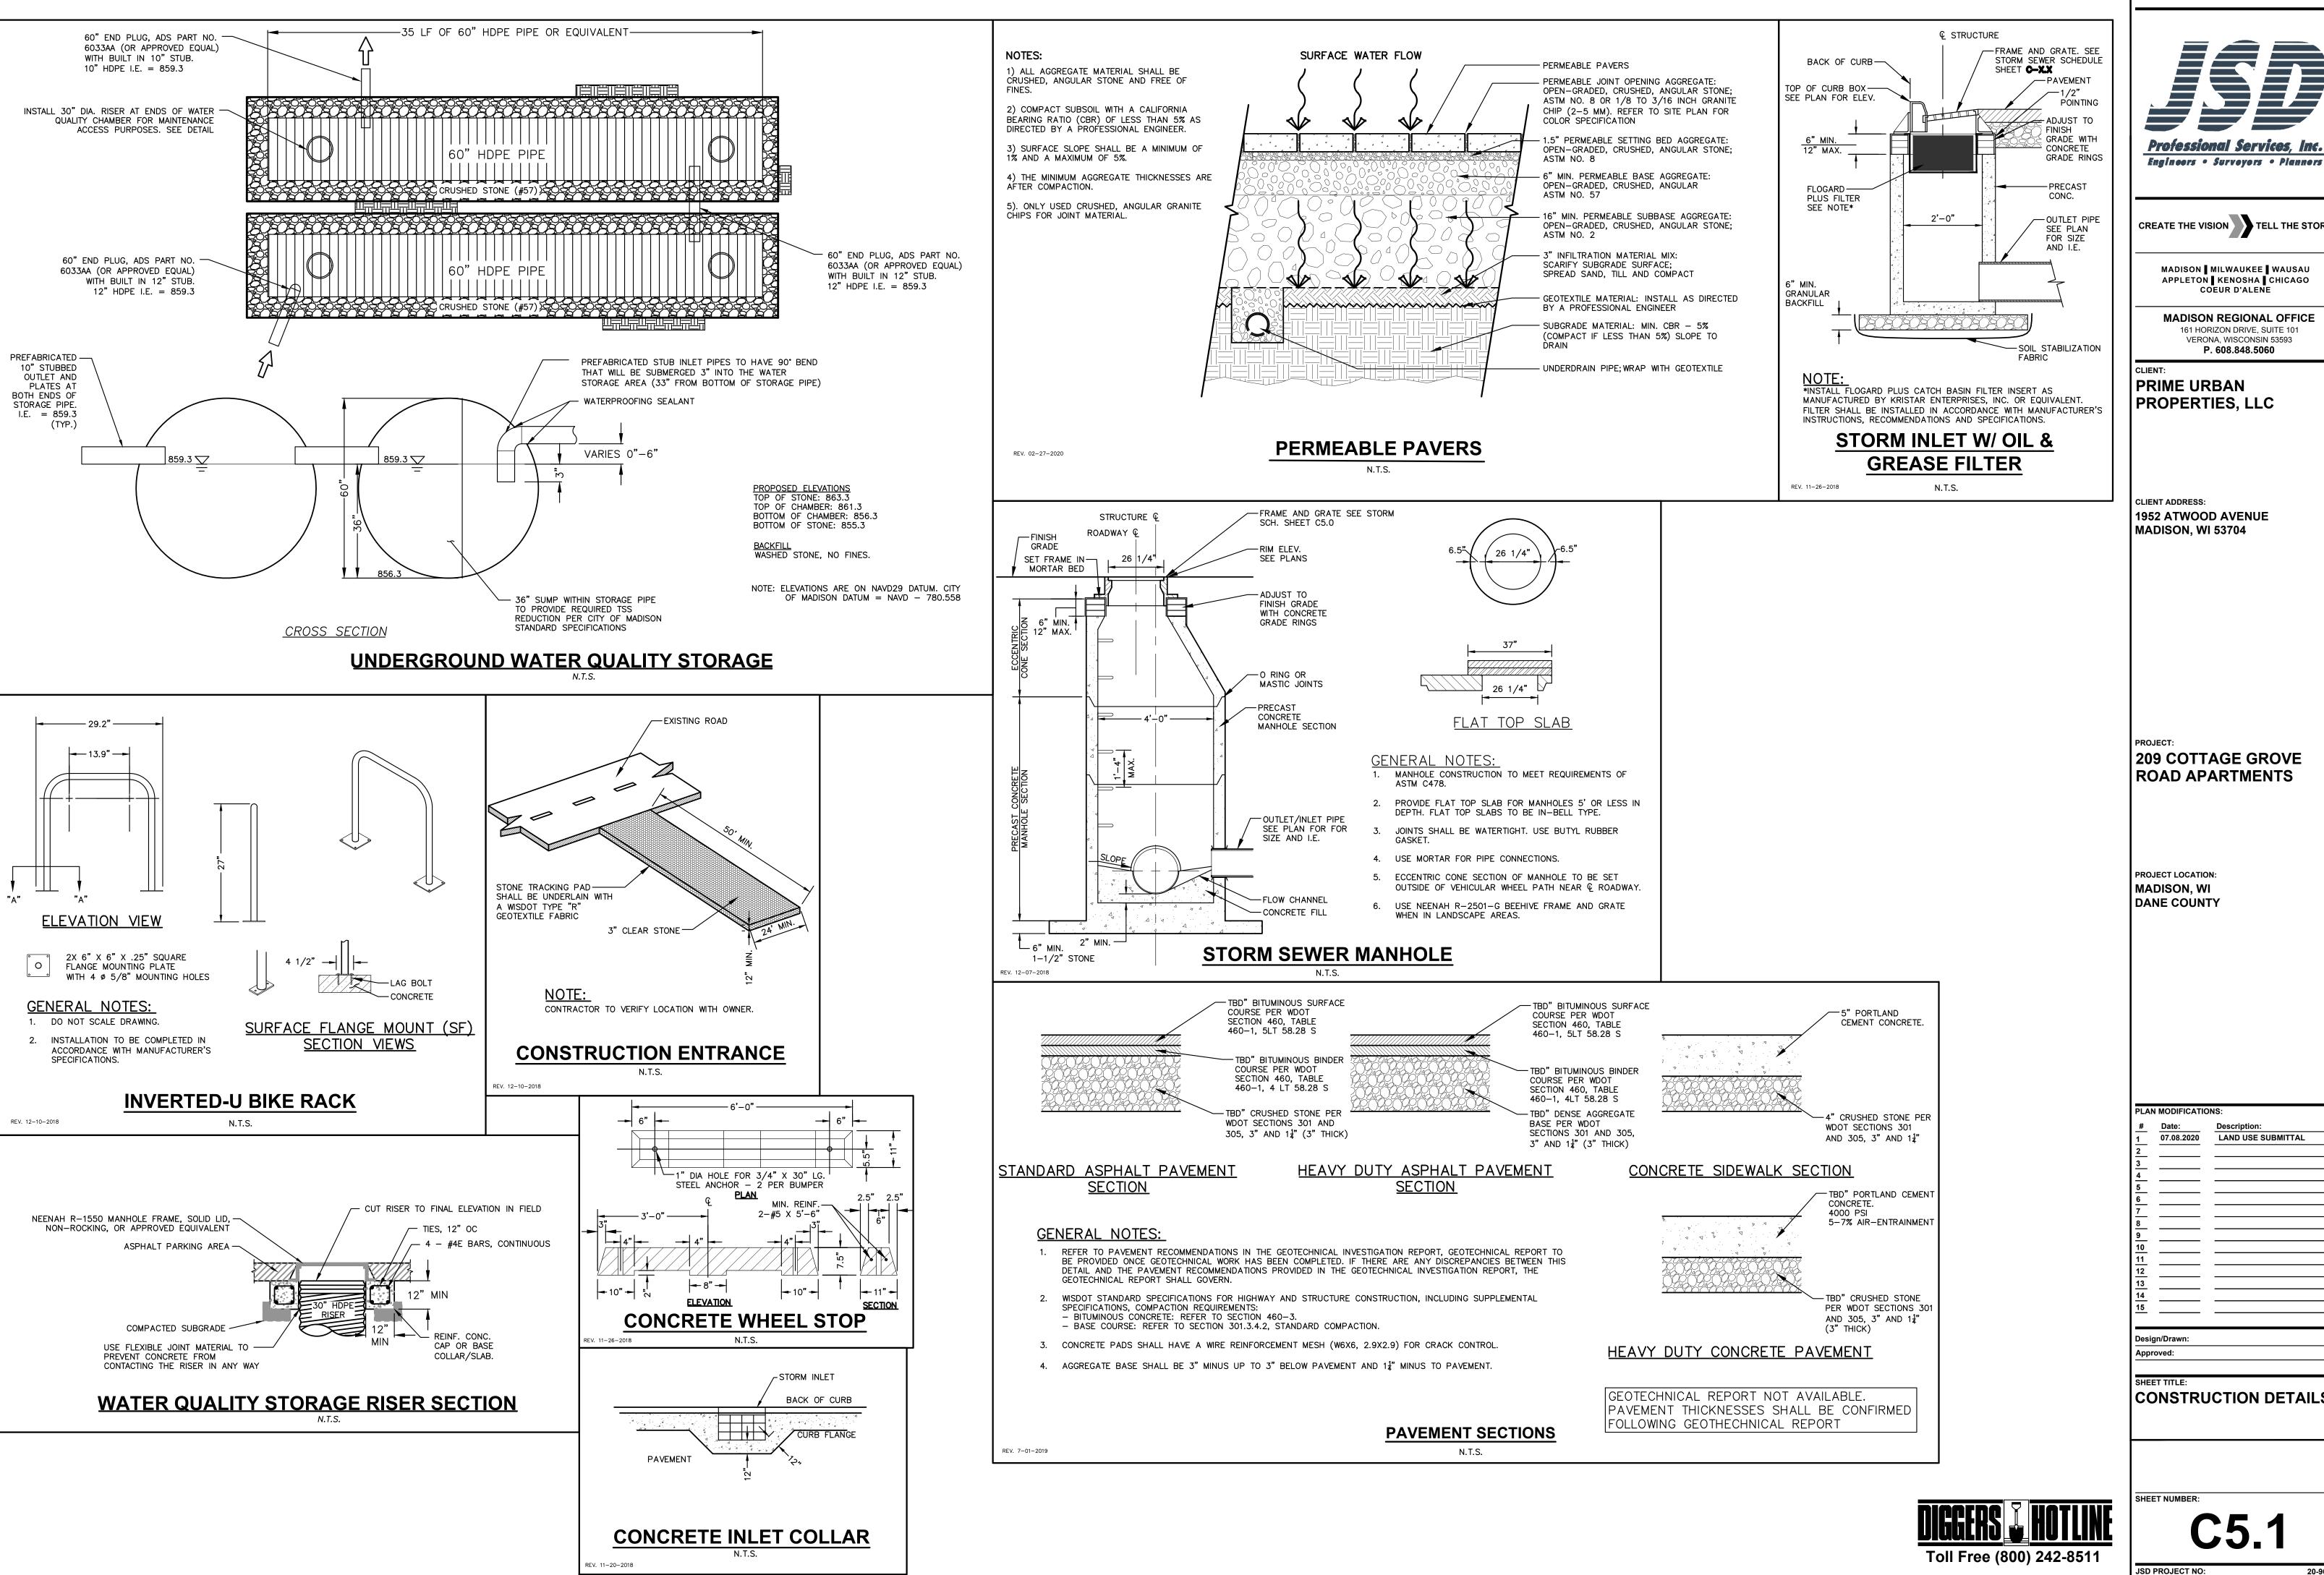
PROJECT LOCATION: MADISON, WI DANE COUNTY

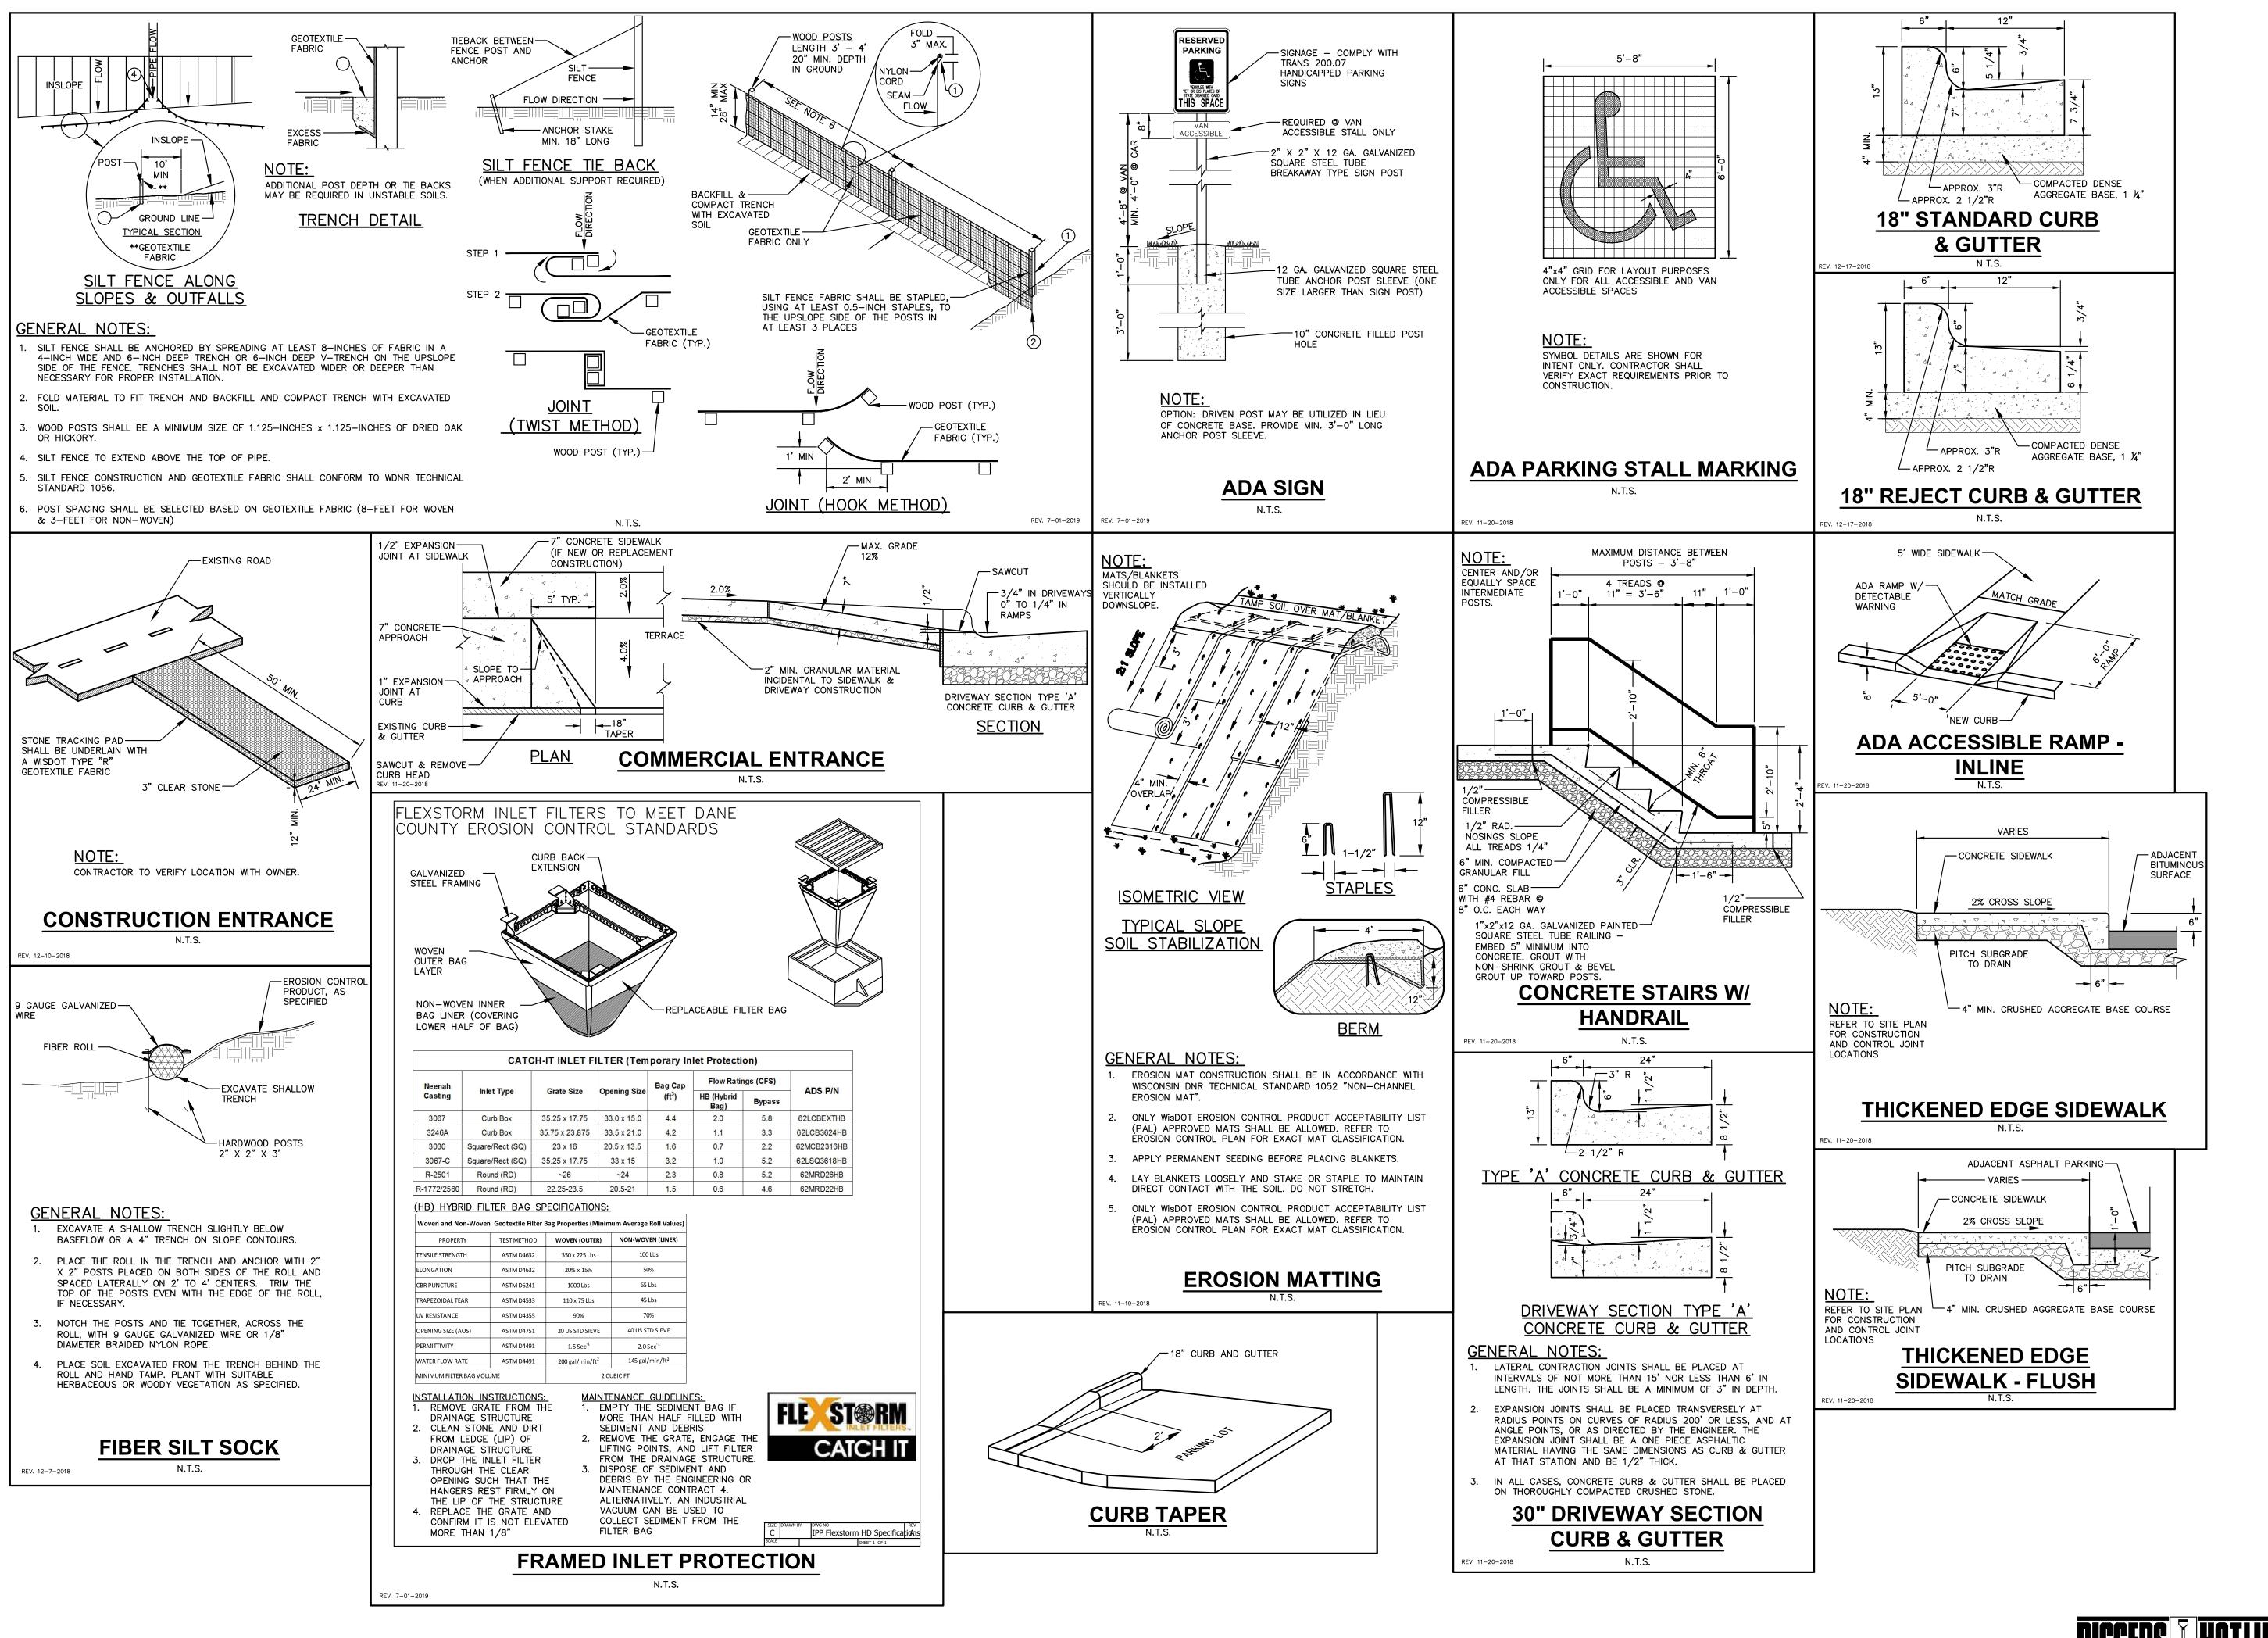PLAN MODIFICATIONS: 07.08.2020 LAND USE SUBMITTAL

Design/Drawn:

Approved:

CONSTRUCTION DETAILS



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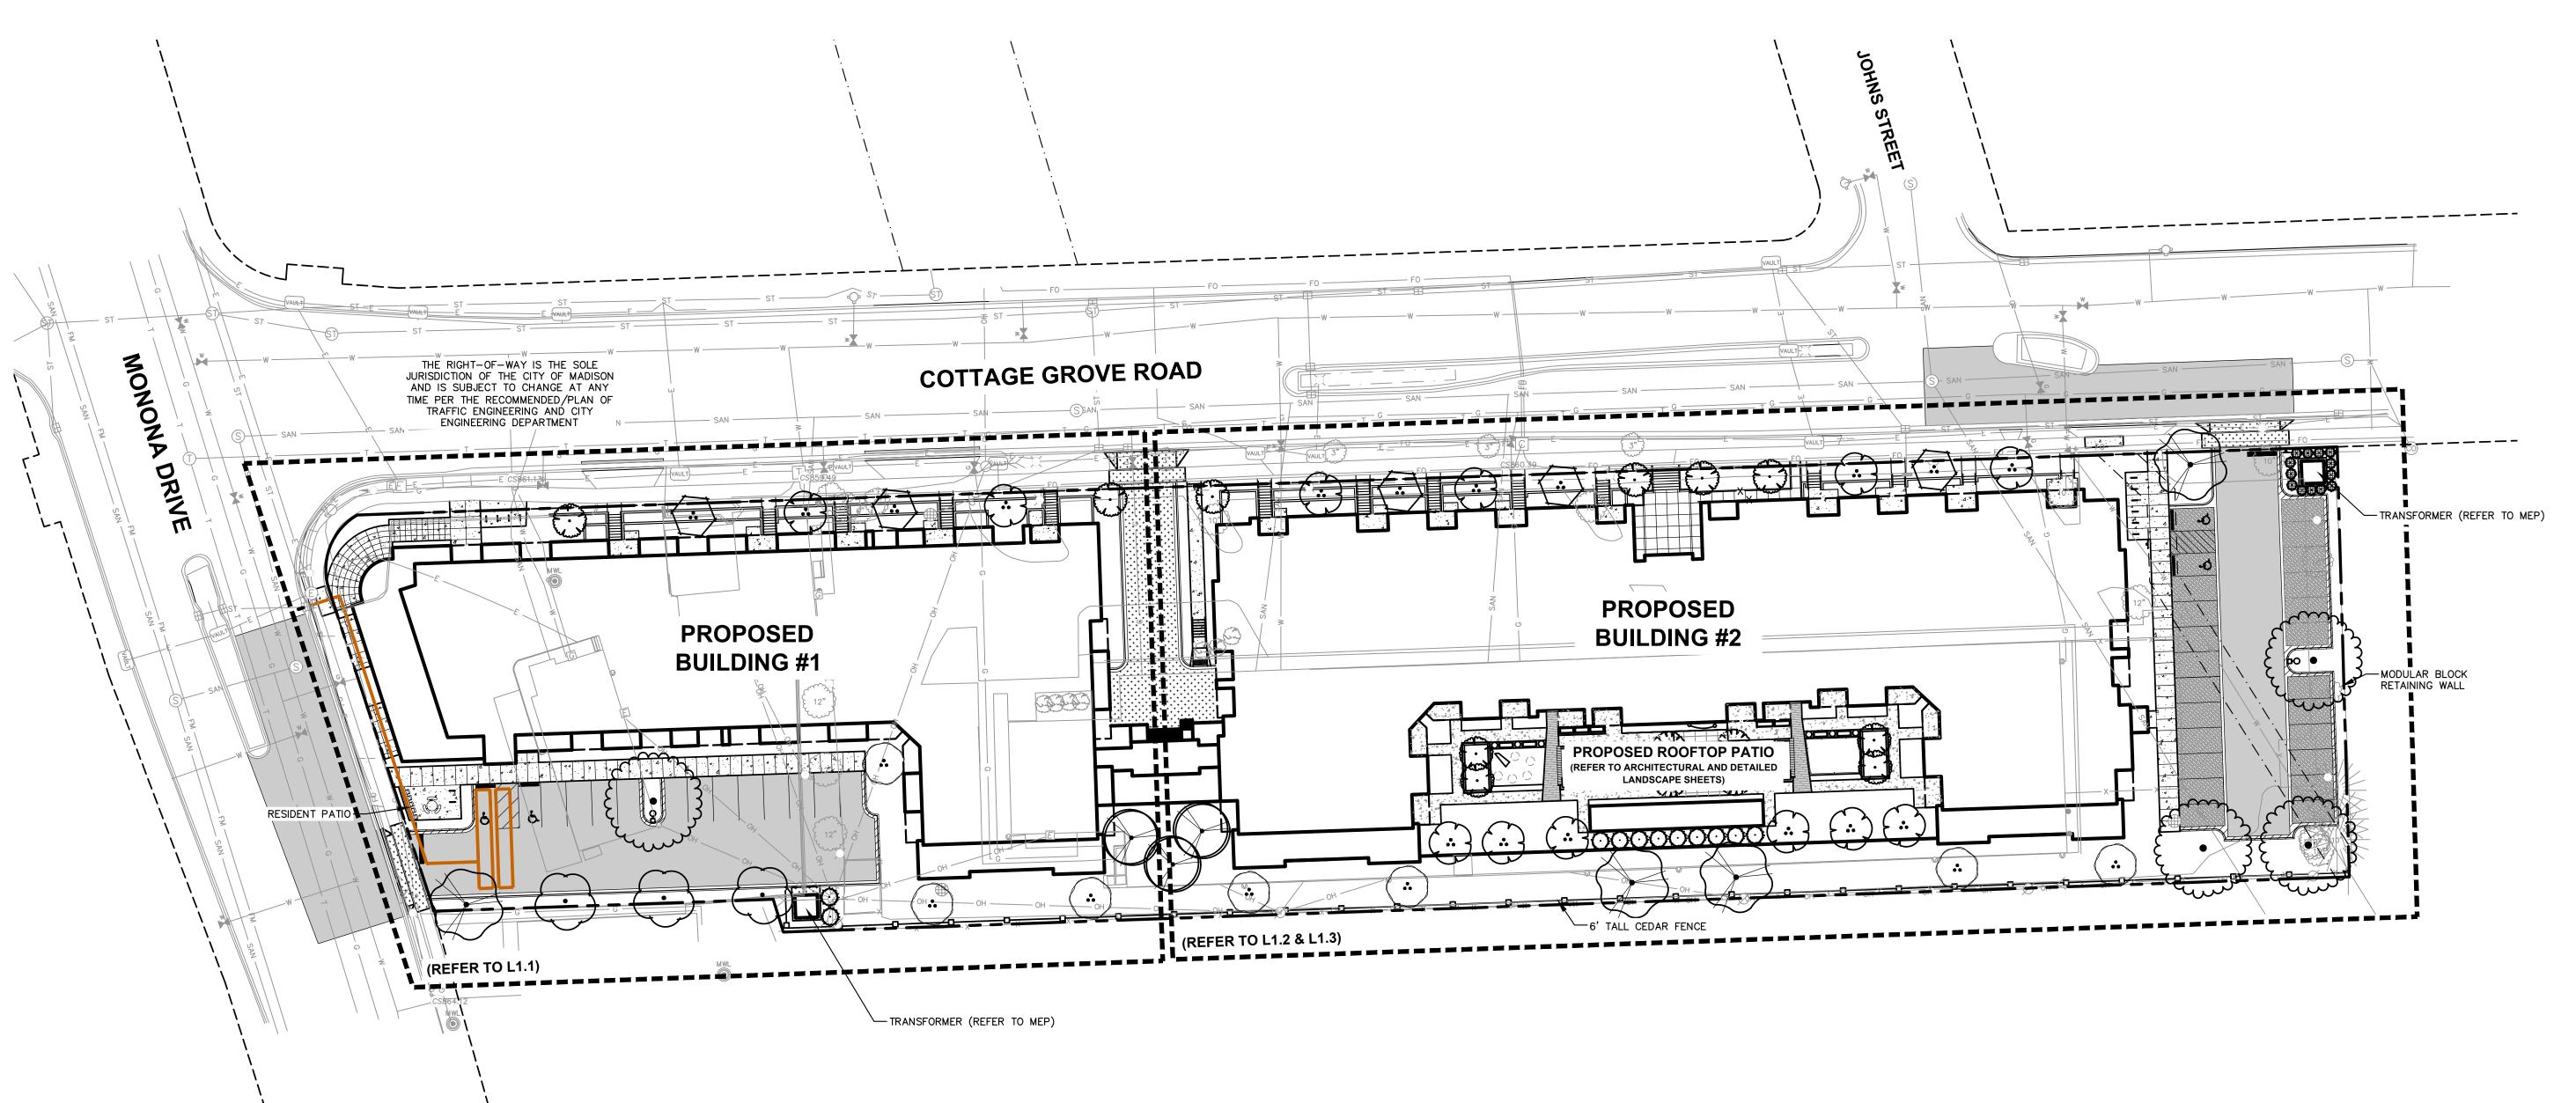
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1952 ATWOOD AVENUE

209 COTTAGE GROVE

07.08.2020 LAND USE SUBMITTAL

CONSTRUCTION DETAILS



GENERAL NOTES


- REFER TO THE EXISTING CONDITIONS SURVEY FOR EXISTING CONDITIONS NOTES AND LEGEND.
- 2. ALL WORK IN THE ROW SHALL BE IN ACCORDANCE WITH THE MUNICIPAL STANDARD SPECIFICATIONS FOR PUBLIC WORKS CONSTRUCTION
- 3. JSD SHALL BE HELD HARMLESS AND DOES NOT WARRANT ANY DEVIATIONS BY THE OWNER/CONTRACTOR FROM THE APPROVED CONSTRUCTION PLANS THAT MAY RESULT IN DISCIPLINARY ACTIONS BY ANY OR ALL REGULATORY AGENCIES.
- 4. DRAWING FOR REVIEW NOT FOR CONSTRUCTION UNLESS OTHERWISE NOTED IN THE TITLE BLOCK.
- 5. THE LANDSCAPE CONTRACTOR SHALL COORDINATE ALL FINE GRADING AND TOPSOILING WITH GENERAL CONTRACTOR
- 6. REFER TO "LANDSCAPE DETAILS AND NOTES" SHEET FOR ADDITIONAL DETAILS, NOTES AND SPECIFICATION INFORMATION INCLUDING MATERIALS, GUARANTEE AND EXECUTION RELATED TO LANDSCAPE
- 7. CONTRACTOR SHALL REVIEW SITE CONDITIONS FOR UTILITY CONFLICTS, DRAINAGE ISSUES, SUBSURFACE ROCK, AND PLANT PLACEMENT CONFLICTS PRIOR TO PLANT INSTALLATION. REPORT ANY CONDITIONS THAT MAY HAVE ADVERSE IMPACT ON PLANTING OPERATIONS TO LANDSCAPE ARCHITECT
- 8. DO NOT COMMENCE PLANTING OPERATIONS UNTIL ALL ADJACENT SITE IMPROVEMENTS, IRRIGATION INSTALLATION, AND FINISH GRADING ARE COMPLETE

ORNAMENTAL TREES	BOTANICAL / COMMON NAME	CONT	SIZE	LS POINTS	QTY
(∴)	Amelanchier x grandiflora `Autumn Brilliance` / Autumn Brilliance Serviceberry	B & B	1.5" Cal (Multi-Stem)	15	12
	Crataegus viridis `Winter King` / Winter King Hawthorn	B & B	1.5" Cal (Multi-Stem)	15	5
	Malus x `Royal Raindrops` / Royal Raindrops Crabapple	B & B	1.5"Cal	15	10
	Malus x `Spring Snow` / Spring Snow Crabapple	B & B	1.5"Cal	15	4
OVERSTORY DECIDUOUS TREES	BOTANICAL / COMMON NAME	CONT	SIZE	LS POINTS	QTY
	Acer x freemanii `Marmo` / Marmo Freeman Maple	B & B	2.5"Cal	35	4
<u>.</u>	Betula nigra `BNMTF` TM / Dura Heat River Birch	B & B	2.5" Cal (Multi-Stem)	35	7
\bigcirc	Betula populifolia `Whitespire` - Single / Whitespire Birch - Single	B & B	2.5"Cal	35	3
$\overline{\dot{\odot}}$	Celtis occidentalis `Prairie Pride` / Prairie Pride Hackberry	B & B	2.5"Cal	35	4
$\overline{\bigcirc}$	Ginkgo biloba `Autumn Gold` TM / Autumn Gold Maidenhair Tree	B & B	2.5"Cal	35	3
ALL EVERGREEN TREES	BOTANICAL / COMMON NAME	CONT	SIZE	LS POINTS	QTY
0	Juniperus chinensis `lowa` / lowa Juniper	B & B	Min. 5` tall	35	11
IPRIGHT EVERGREEN SHRUB	BOTANICAL / COMMON NAME	CONT	SIZE	LS POINTS	QTY
(Thuja occidentalis `Emerald` / Emerald Arborvitae	B & B	Min. 3` tall	10	15
ECIDUOUS SHRUBS	BOTANICAL / COMMON NAME	CONT	SIZE	LS POINTS	QTY
\odot	Aronia melanocarpa `UCONNAM165` TM / Low Scape Mound Chokeberry	#3	Min. 8"-18"	3	130
⊕	Clethra alnifolia `Ruby Spice` / Ruby Spice Clethra	#3	Min. 12"-24"	3	26
$\langle \cdot \rangle$	Comus baileyi / Bailey`s Red-twig Dogwood	#3	Min. 12"-24"	3	15
\otimes	Hydrangea arborescens `Incrediball` / Incrediball White Hydrangea	#3	Min. 12"-24"	3	26
\odot	Hydrangea paniculata `Little Lime` / Little Lime Hydrangea	#3	Min. 12"-24"	3	30

₩	Physocarpus opulifolius `Little Devil` TM / Dwarf Ninebark	#3	Min. 12"-24"	3	10
	Viburnum carlesii `SMVCB` TM / Spice Baby Koreanspice Viburnum	#3	Min. 12"-24"	3	38
\odot	Viburnum x juddii / Judd Viburnum	#3	Min. 12"-24"	3	14
EVERGREEN SHRUBS	BOTANICAL / COMMON NAME	CONT	SIZE	LS POINTS	QTY
\odot	Buxus x `Green Velvet` / Green Velvet Boxwood	3 gal	Min. 12"-24"	4	44
\otimes	Juniperus sabina `Mini-Arcadia` / Mini Arcadia Juniper	#3	Min. 12" Wide	4	20
*	Taxus x media `Everlow` / Everlow Yew	#3	Min. 12" Wide	4	30
PERENNIALS & GRASSES	BOTANICAL / COMMON NAME	CONT	SIZE	LS POINTS	QTY
\odot	Allium x `Summer Beauty` / Summer Beauty Allium	#1	Min. 8"-18"	2	108
*	Astilbe chinensis `Vision in Pink` / Vision in Pink Chinese Astilbe	#1	Min. 8"-18"	2	15
£‡3	Astilbe chinensis `Vision in White` / Vision in White Chinese Astilbe	#1	Min. 8"-18"	2	30
0	Calamintha nepeta `Montrose White` / Montrose White Catmint	#1	Min. 8"-18"	2	143
\odot	Echinacea x `CBG Cone 2` TM / Pixie Meadowbrite Purple Coneflower	#1	Min. 8"-18"	2	82
\bigoplus	Geranium x `Rozanne` / Rozanne Cranesbill	#1	Min. 8"-18"	2	48
\oplus	Geranium x cantabrigiense `Biokovo` / Biokovo Cranesbill	#1	Min. 8"-18"	2	15
€;3	Hemerocallis x `Chicago Apache` / Daylily	#1	Min. 8"-18"	2	109
*	Hosta x `Autumn Frost` / Autumn Frost Plantain Lily	#1	Min. 8"-18"	2	26
**	Hosta x `Halcyon` / Halcyon Plantain Lily	#1	Min. 8"-18"	2	47
Ç.	Liatris spicata `Kobold` / Kobold Spike Gayfeather	#1	Min. 8"-18"	2	56
Marie	Panicum virgatum `Shenandoah` / Shenandoah Switch Grass	#1	Min. 8"-18"	2	110
*	Sporobolus heterolepis `Tara` / Prairie Dropseed	#1	Min. 8"-18"	2	275

Hydrangea paniculata `Little Quick Fire` / Little Quick Fire Hydrangea

#3 Min. 12"-24"

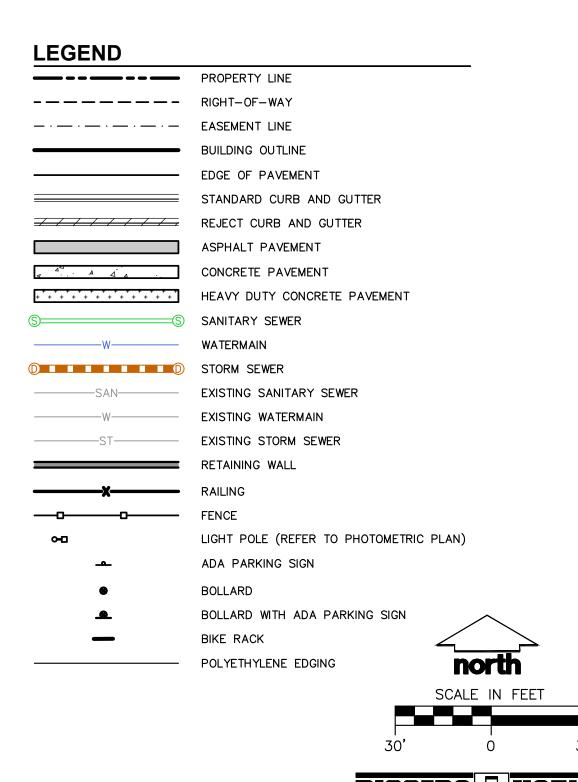



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VERONA, WISCONSIN 53593

P. 608.848.5060

PRIME URBAN PROPERTIES, LLC

CLIENT ADDRESS:
1952 ATWOOD AVENUE
MADISON, WI 53704

PROJECT:
209 COTTAGE GROVE
ROAD APARTMENTS

PROJECT LOCATION:
MADISON, WI
DANE COUNTY

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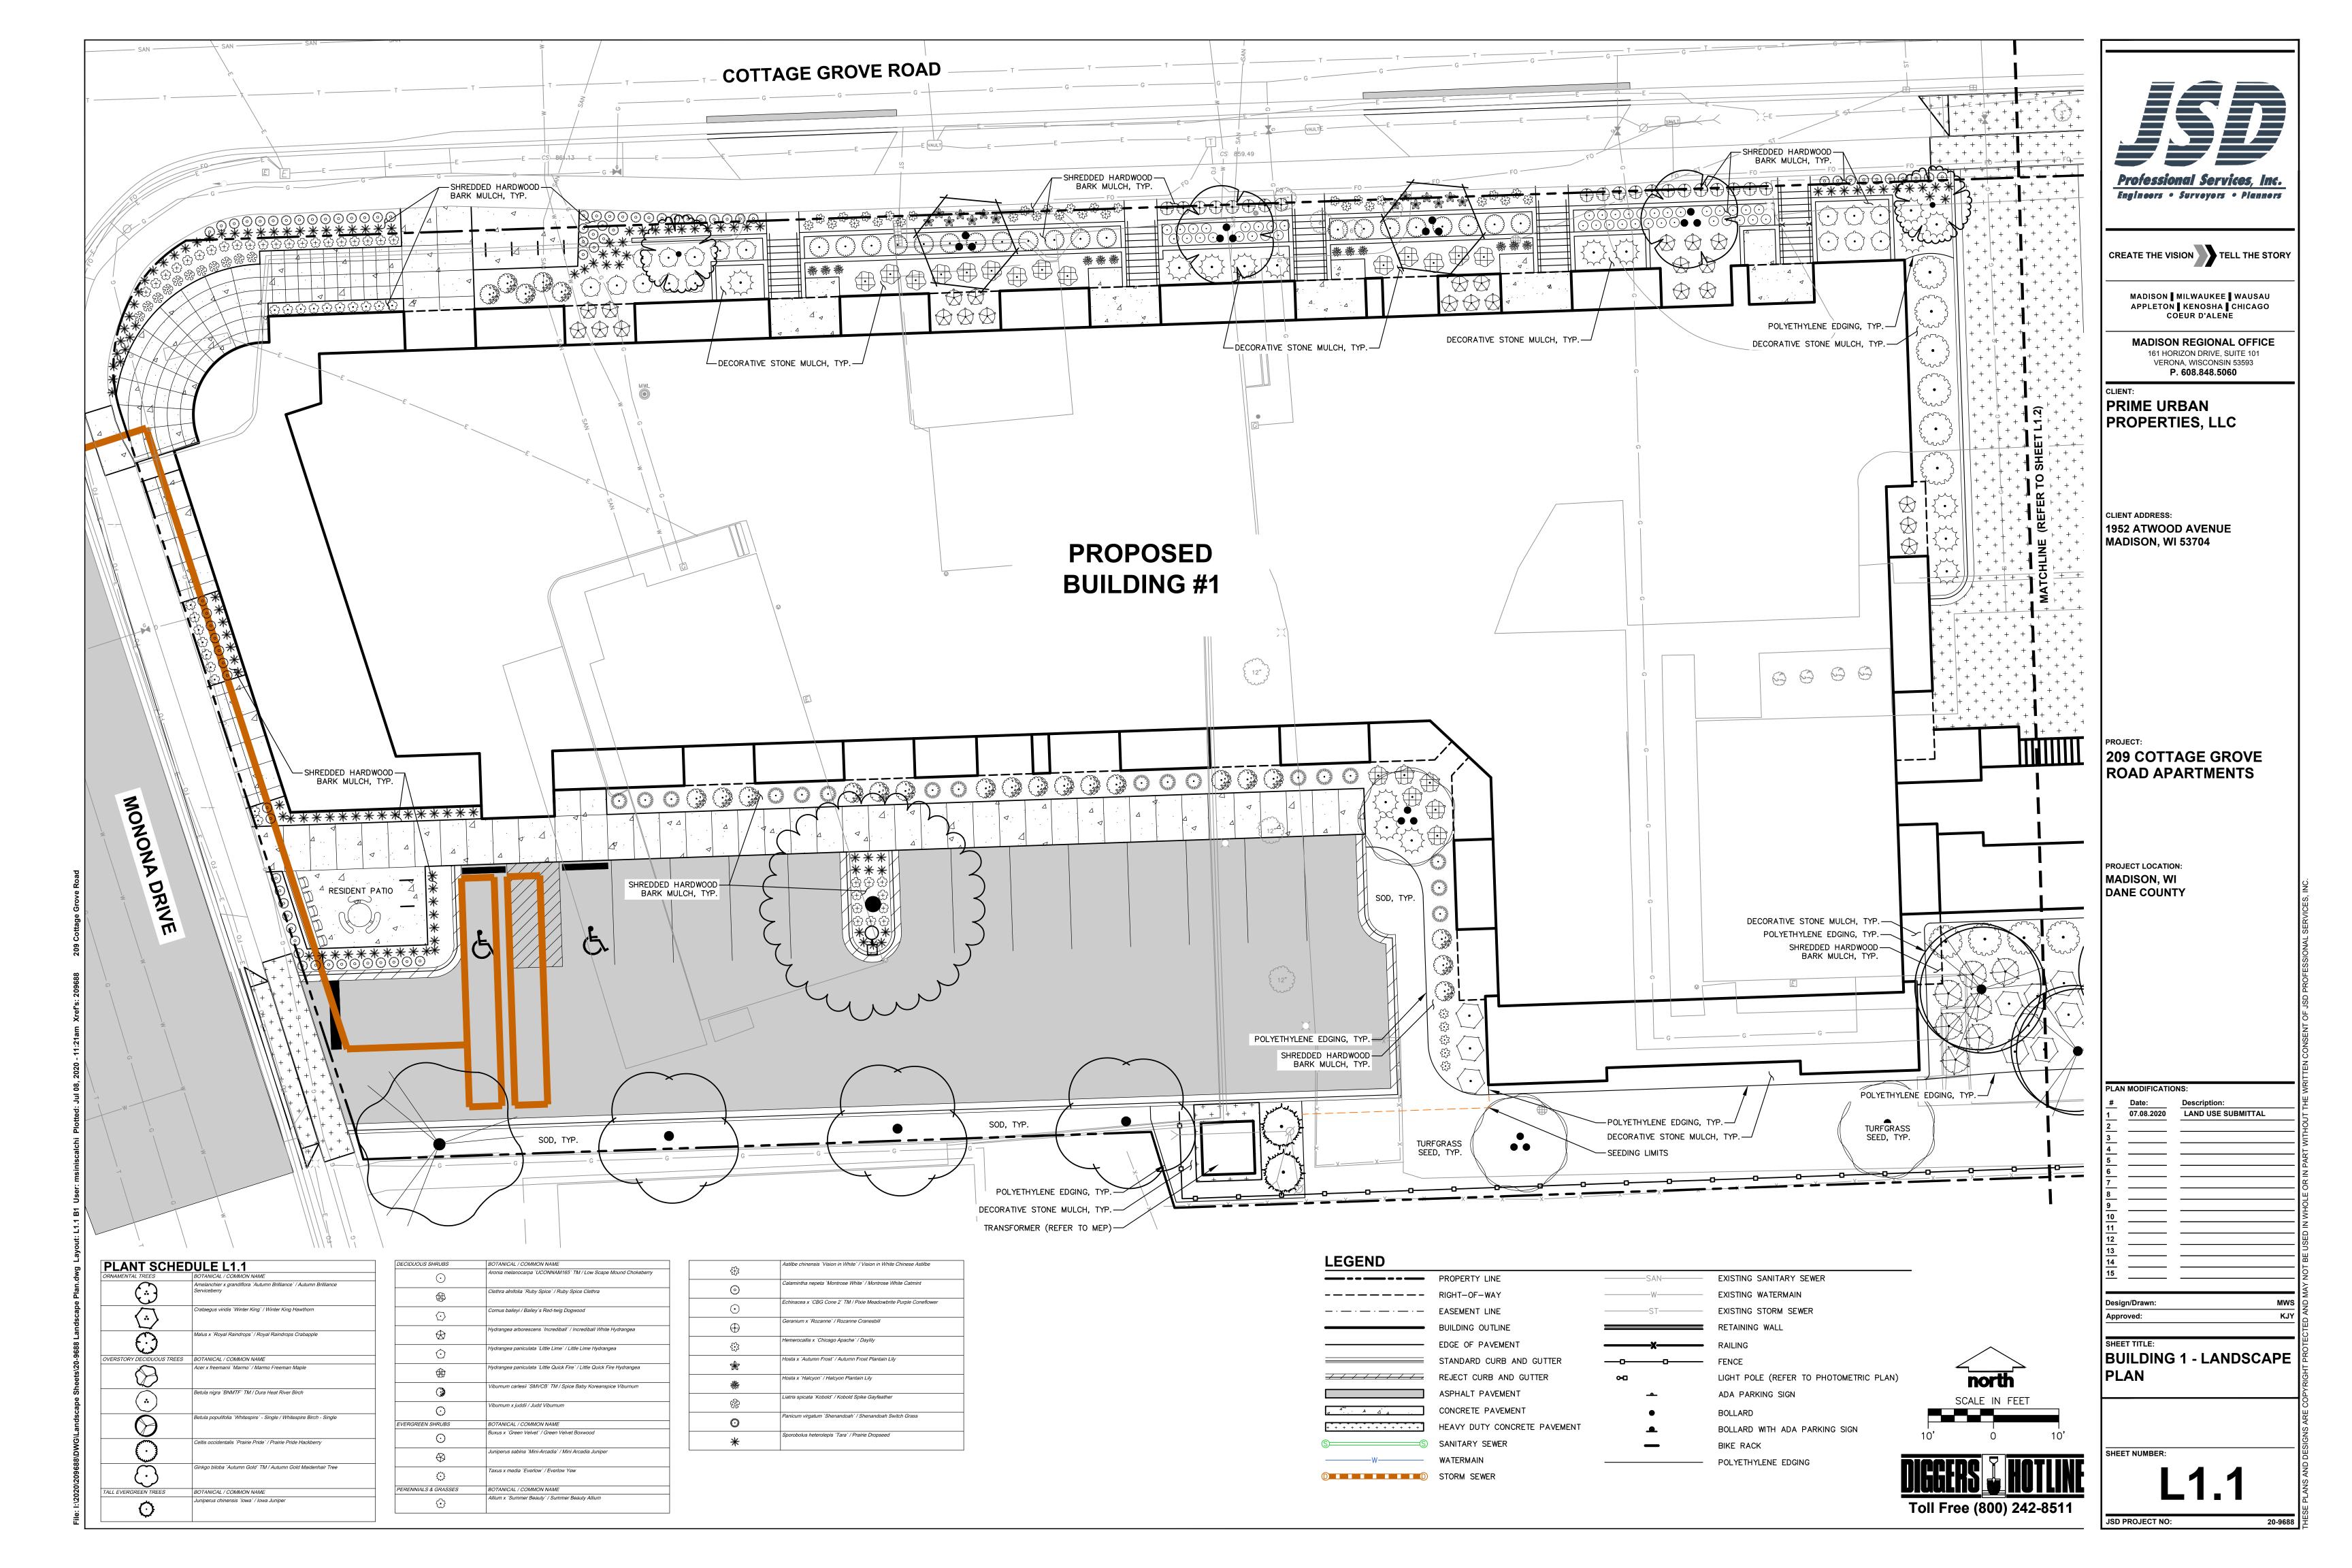
Design/Drawn: MWS
Approved: KJY


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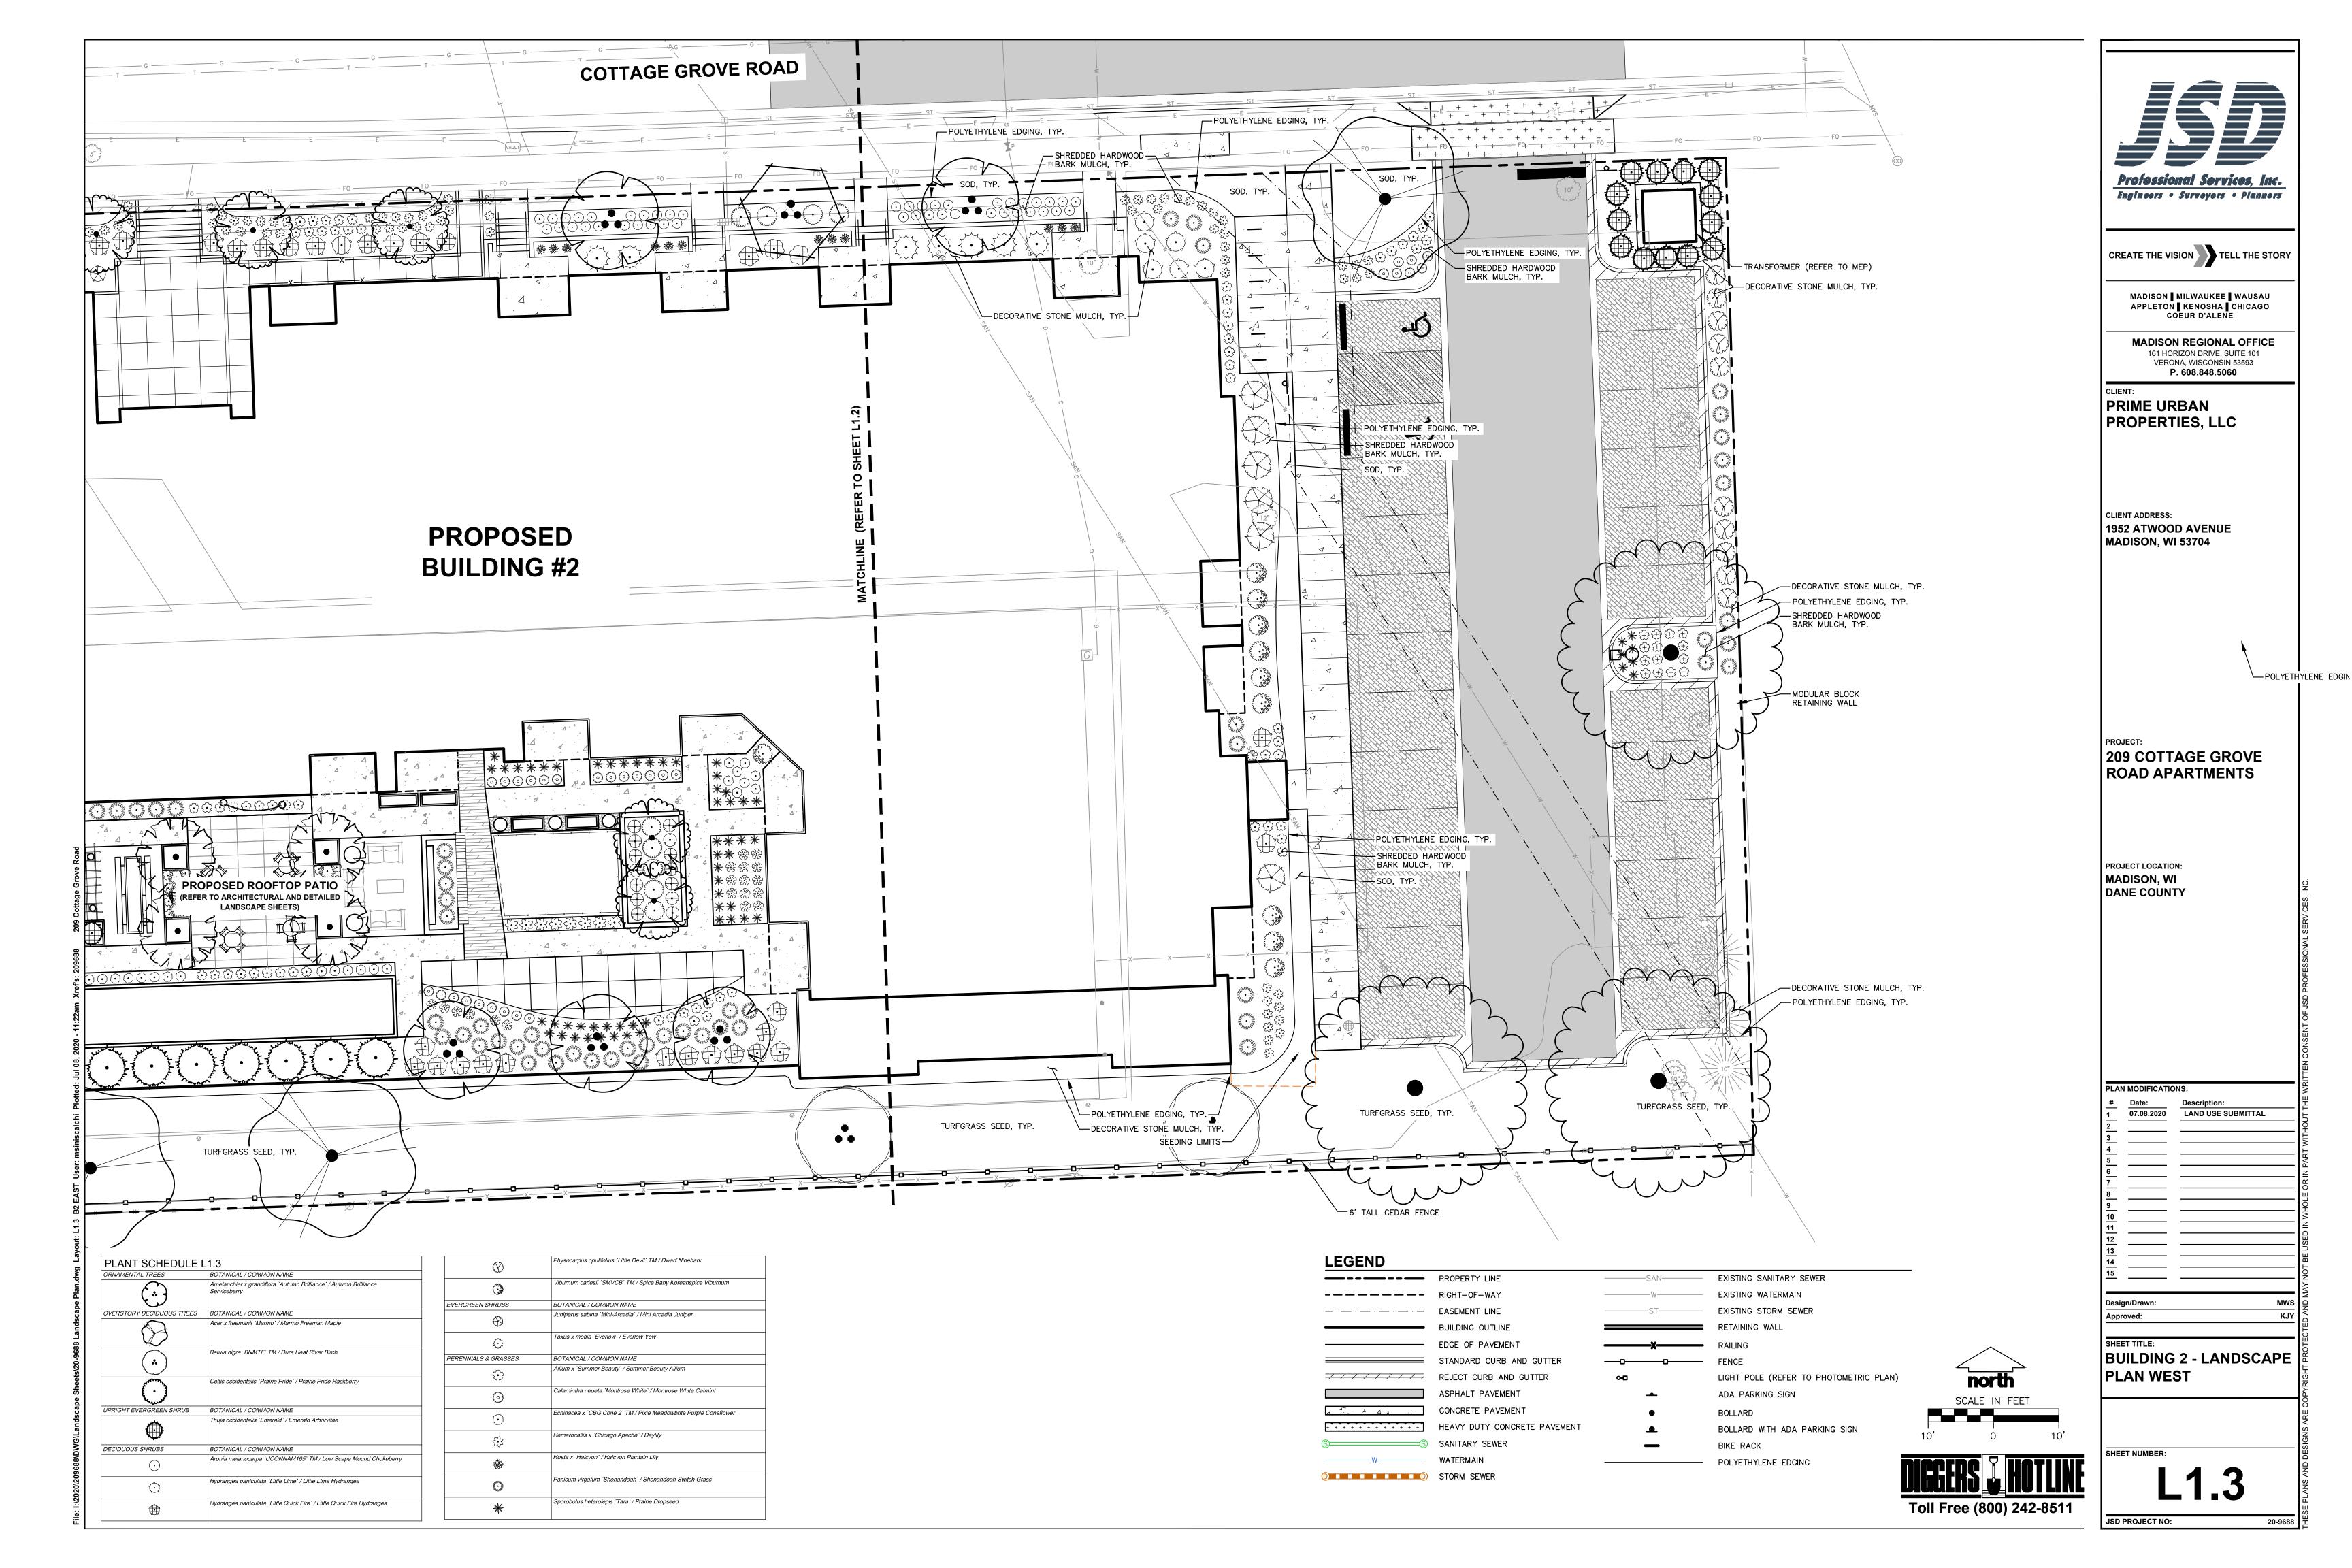
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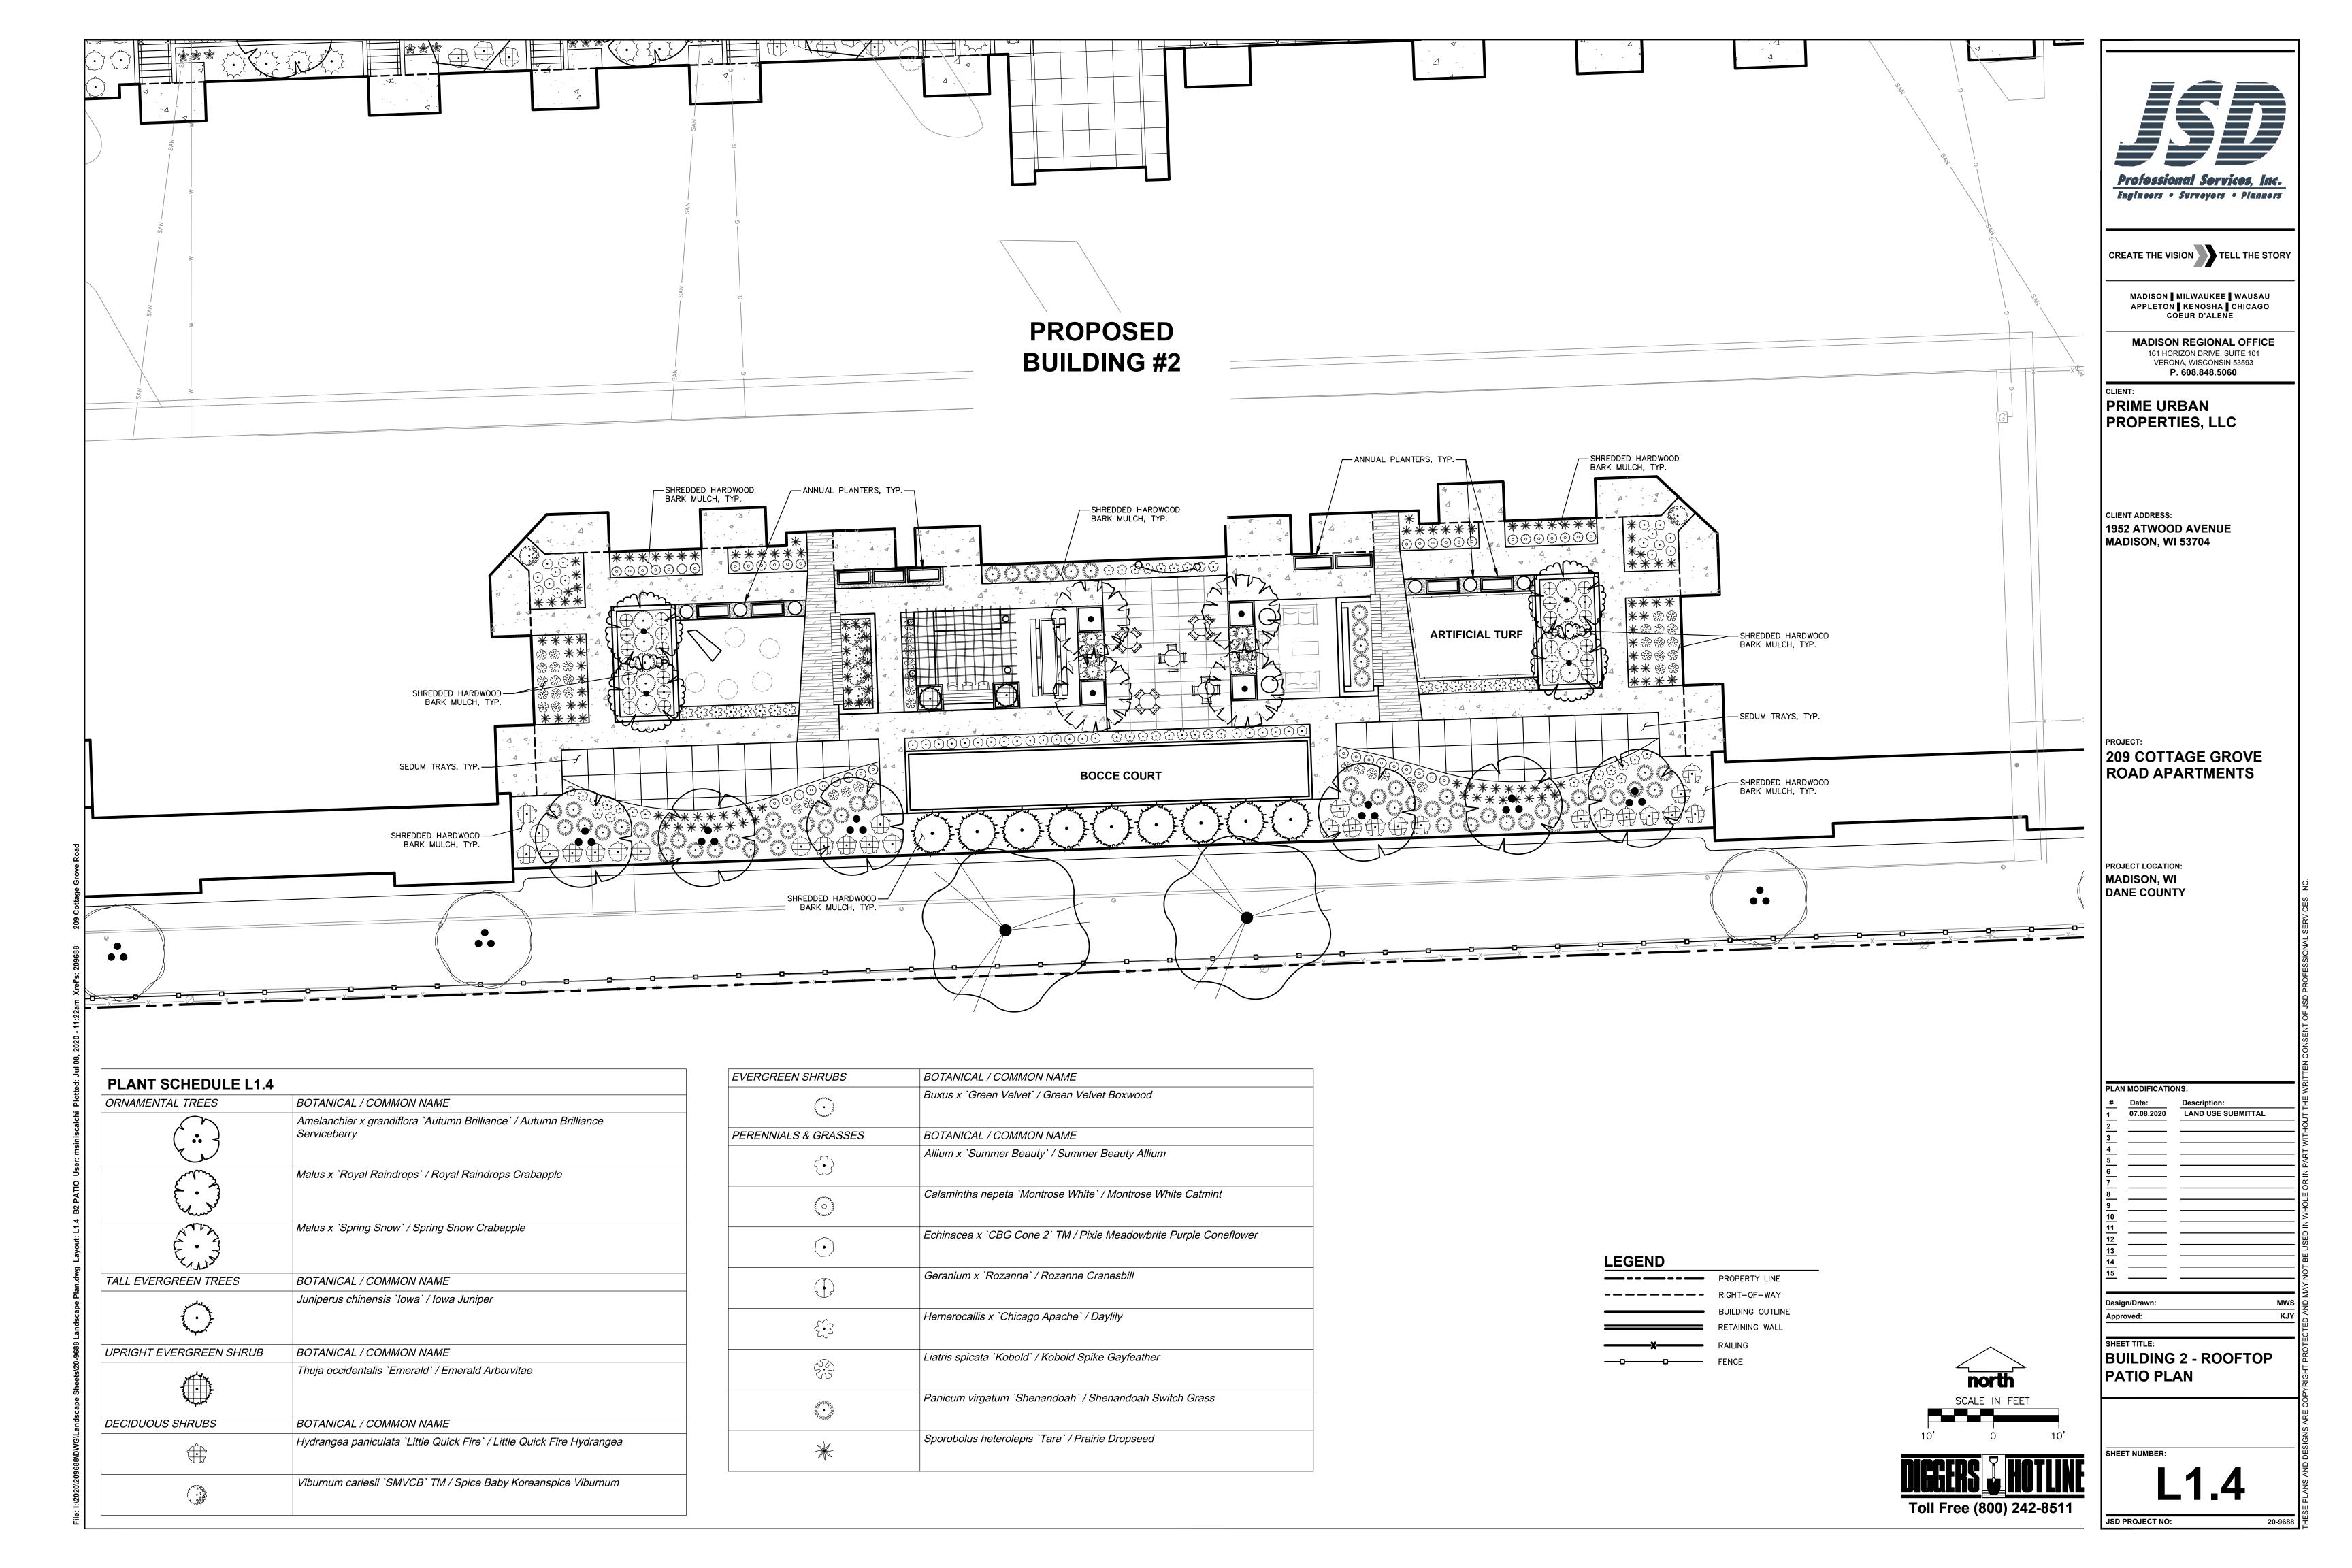
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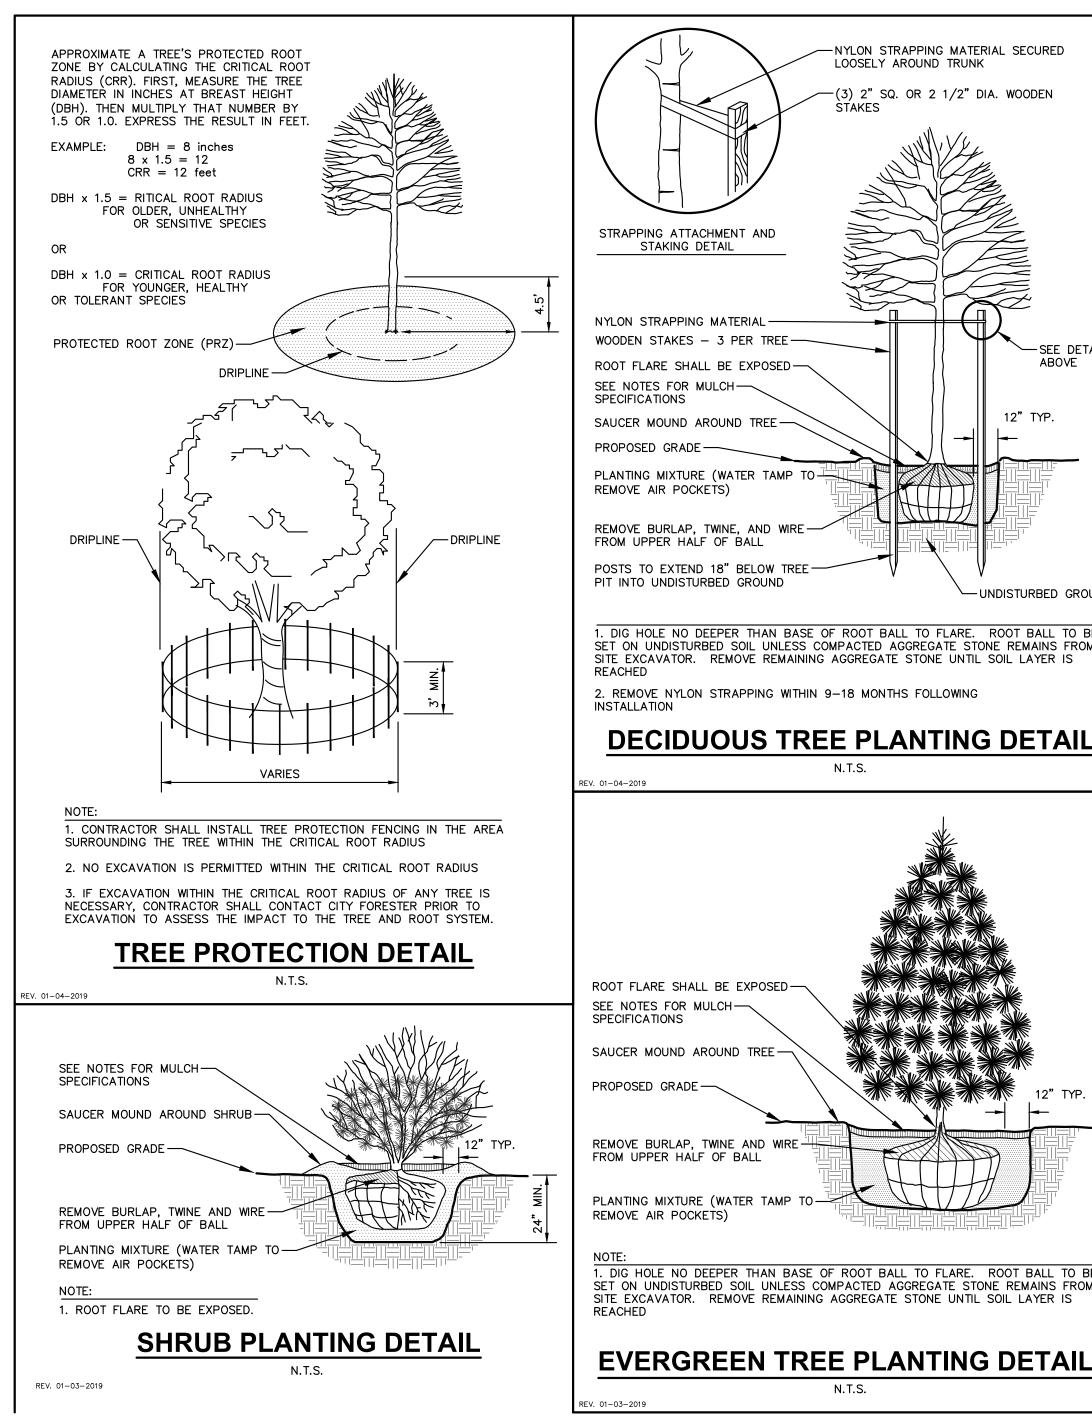
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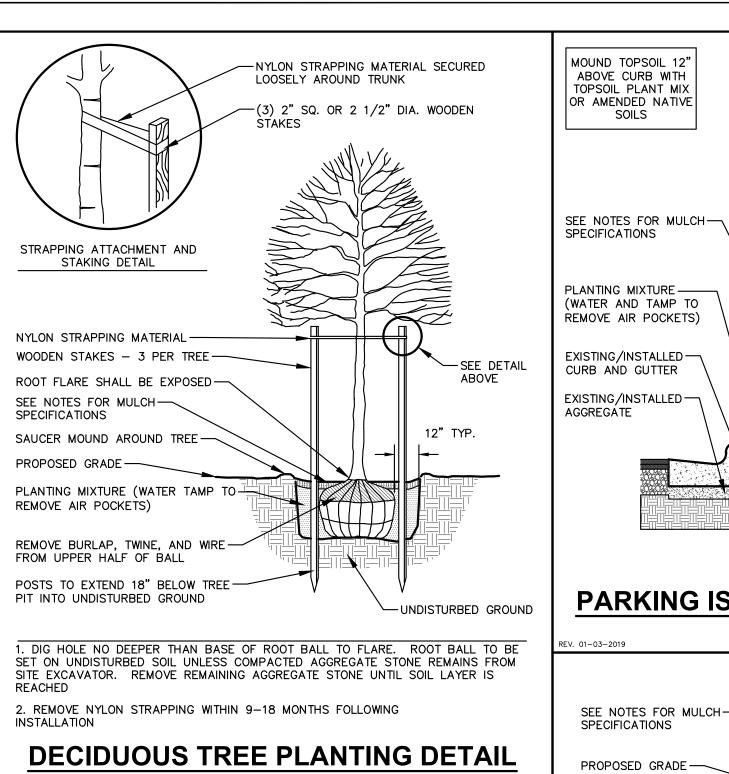











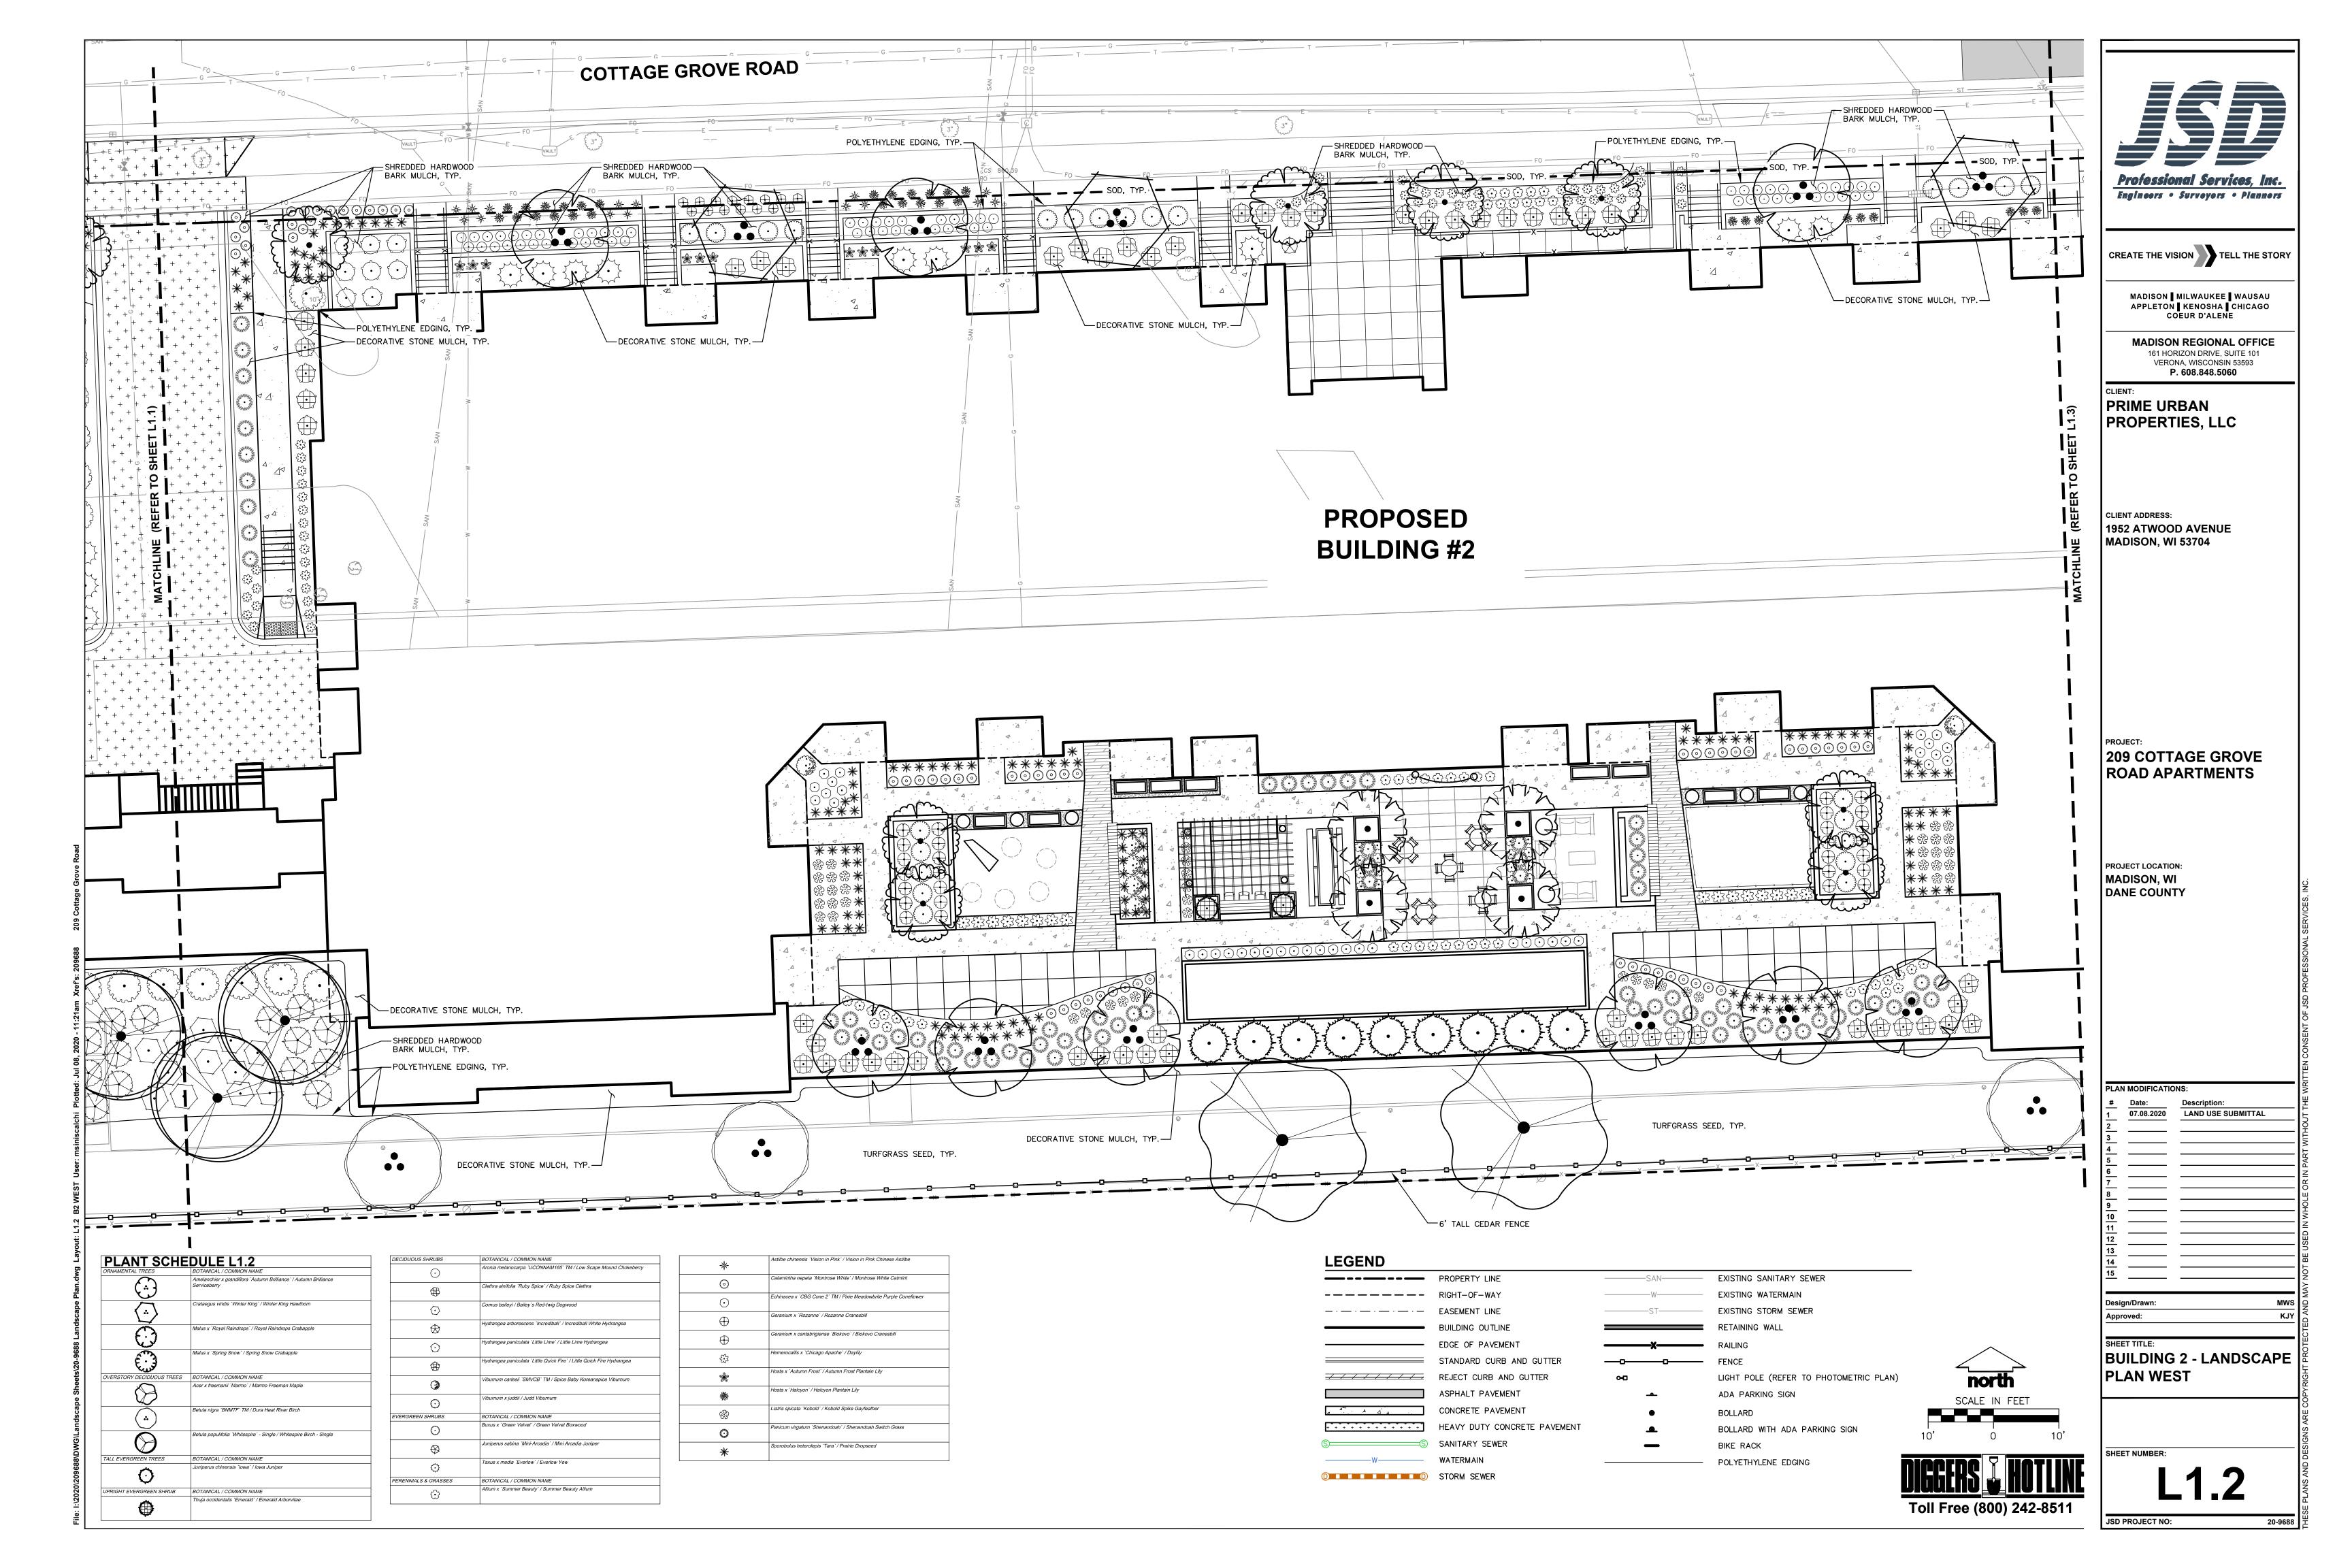

DIMENSION VARIES (SEE SITE PLAN) PARKING ISLAND LANDSCAPE DETAIL 5" POLYETHYLENE EDGING-3/8" GALVANIZED STEEL SPIKE 8" - 10" LONG

POLYETHYLENE LANDSCAPE EDGING **DETAIL**

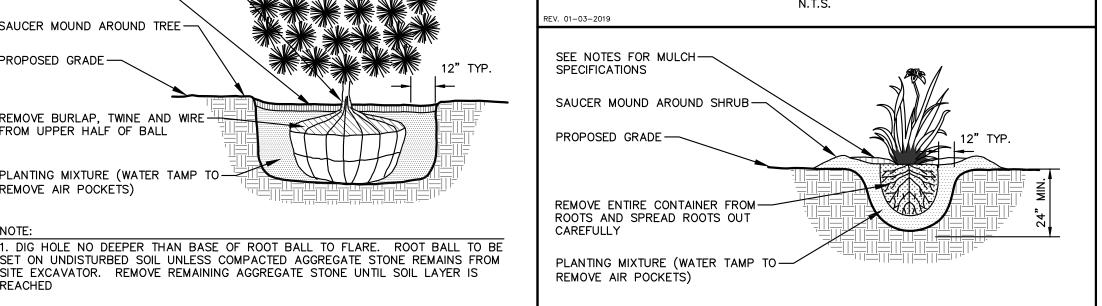

PERENNIAL/ORNAMENTAL GRASS **PLANTING DETAIL**

8'-0" 5/8" x 6" x 6' CEDAR-BOARD DOG-EAR FENCE PICKET, NATURAL WEATHERED (UNSTAINED) GALVANIZED STEEL -POST CAP, TYP. GALVANIZED STEEL PIPE ---2" DIA. (2 3/8" O.D.) x 6' $2" \times 4" \times 6'$ CEDAR RAIL,— GALVANIZED SIMPSON PGT-PIPE GRIP TIE (PGT2A) w/ (4) 1/4" LAG BOLTS 2" RADIUS TAPERED — BULLNOSE FINISH AT GRADE FINISHED GRADE -CONCRETE FOOTING — BOARD-ON-BOARD OPTION TO HAVE PICKETS ON BOTH SIDES OF FENCE WITH 3 1/2" GAP BETWEEN ALL PICKETS. **OPAQUE CEDAR PRIVACY FENCE**

REV. 06-21-2019

GENERAL NOTES

PARKING ISLAND TO

BE DUG FREE OF

AGGREGATE TO A

MINIMUM DEPTH OF

FOR PLANTINGS

AFTER INSTALLATION

OF CURB AND

GUTTER

24" AND PREPARED

- GENERAL: ALL WORK IN THE R-O-W AND PUBLIC EASEMENTS SHALL BE IN ACCORDANCE WITH LOCAL MUNICIPAL REQUIREMENTS. JSD SHALL BE HELD HARMLESS AND DOES NOT WARRANT ANY DEVIATIONS BY THE OWNER/CONTRACTOR FROM THE APPROVED CONSTRUCTION PLANS THAT MAY RESULT IN DISCIPLINARY ACTIONS BY ANY OR ALL REGULATORY AGENCIES. LOCATE ALL UTILITIES PRIOR TO CONSTRUCTION. THE CONTRACTOR IS RESPONSIBLE FOR REPAIRING ANY DAMAGE DONE TO UTILITIES. CONTRACTOR MUST CALL 1-800-242-8511 FOR UTILITY LOCATIONS AT LEAST THREE DAYS PRIOR TO DIGGING. HAND DIG AND INSTALL ALL PLANTS THAT ARE NEAR EXISTING UTILITIES. PROTECT PREVIOUSLY INSTALLED WORK OF OTHER TRADES. CONTRACTOR IS RESPONSIBLE FOR STAKING THE PLANT MATERIALS FOR REVIEW BY OWNER PRIOR TO DIGGING AND PLACEMENT AND SHALL COORDINATE ALL FINE GRADING AND RESTORATION WITH THE GRADING CONTRACTOR.
- DELIVERY AND HANDLING: DO NOT DELIVER MORE PLANT MATERIALS THAN CAN BE PLANTED IN ONE DAY, UNLESS ADEQUATE, APPROPRIATE AND SECURE STORAGE IS PROVIDED AND APPROVED BY OWNER'S REPRESENTATIVE. AT ALL TIMES, PROTECT ALL PLANT MATERIALS FROM WIND AND DIRECT SUN. DELIVER PLANTS WITH LEGIBLE IDENTIFICATION LABELS. PROTECT PLANTS DURING DELIVERY AND DO NOT PRUNE PRIOR TO DELIVERY. ALL TREES AND SHRUBS SHALL BE PLANTED ON THE DAY OF DELIVERY; IF THIS IS NOT POSSIBLE, PROTECT THE PLANT MATERIALS NOT PLANTED BY STORING THEM IN A SHADED, SECURE AREA, PROTECTING THE ROOT MASS WITH WET SOIL, MULCH, HAY OR OTHER SUITABLE MEDIUM. CONTRACTOR TO KEEP ALL PLANT MATERIALS ADEQUATELY WATERED TO PREVENT ROOT DESICCATION. DO NOT REMOVE CONTAINER GROWN STOCK FROM CONTAINERS BEFORE TIME OF PLANTING. DO NOT PICK UP CONTAINER OR BALLED PLANTS BY STEM OR ROOTS. ALL PLANTS SHALL BE LIFTED AND HANDLED FROM THE BOTTOM OF THE CONTAINER OR BALL. PERFORM ACTUAL PLANTING ONLY WHEN WEATHER AND SOIL CONDITIONS ARE SUITABLE IN ACCORDANCE WITH LOCALLY ACCEPTED BEST HORTICULTURAL PRACTICES.
- MATERIALS PLANTS: ALL PLANTS SHALL CONFORM TO THE LATEST VERSION OF THE AMERICAN STANDARD FOR NURSERY STOCK ANSI Z60.1. PLANTS SHALL BE TRUE TO SPECIES AND VARIETY SPECIFIED AND NURSERY GROWN IN ACCORDANCE WITH GOOD HORTICULTURAL PRACTICES UNDER CLIMATIC CONDITIONS SIMILAR TO THOSE IN THE LOCALITY OF THE PROJECT FOR AT LEAST 2 YEARS. PLANTS SHALL BE FRESHLY DUG (DURING THE MOST RECENT FAVORABLE HARVEST SEASON). PLANTS SHALL BE SO TRAINED IN DEVELOPMENT AND APPEARANCE AS TO BE UNQUESTIONABLY SUPERIOR IN FORM, COMPACTNESS, AND SYMMETRY. PLANTS SHALL BE SOUND, HEALTHY, VIGOROUS, WELL BRANCHED AND DENSELY FOLIATED WHEN IN LEAF, AND FREE OF DISEASE AND INSECTS (ADULT EGGS, PUPAE OR LARVAE). THEY SHALL HAVE HEALTHY, WELL-DEVELOPED ROOT SYSTEMS AND SHALL BE FREE FROM PHYSICAL DAMAGE OR OTHER CONDITIONS THAT WOULD PREVENT THRIVING GROWTH OR PREMATURE MORTALITY. PLANTS SHALL BE OF THE HIGHEST QUALITY, POSSESS TYPICAL GROWTH HABITS AND FORM FOR THEIR SPECIES AND BE FREE OF INJURY. PARKWAY TREES AND PARKING LOT TREES SHALL HAVE A MINIMUM BRANCHING HEIGHT OF SIX (6) FEET ABOVE THE GROUND TO ALLOW ADEQUATE VISUAL AND PHYSICAL CLEARANCE.
- PRUNING: THE CONTRACTOR SHALL PRUNE ALL TREES AND REPAIR ANY INJURIES THAT OCCURRED DURING THE PLANTING PROCESS, DOUBLE LEADERS, DEAD BRANCHES, AND LIMBS DAMAGED OR BROKEN DURING THE PLANTING PROCESS, SHALL BE PRUNED. THIS SHALL BE THE ONLY PRUNING ALLOWED AT PLANTING. PRUNING SHALL CONFORM TO THE LATEST VERSION OF THE AMERICAN STANDARD FOR TREE CARE OPERATIONS, ANSI A300. PRUNE TREES IN ACCORDANCE WITH NAA GUIDELINES. DO NOT TOP TREES. PRUNE SHRUBS ACCORDING TO STANDARD HORTICULTURAL PRACTICES. ON CUTS OVER 3/4" IN DIAMETER AND BRUISES OR SCARS ON BARK, TRACE THE INJURED CAMBIUM LAYER BACK TO LIVING TISSUE AND REMOVE. SMOOTH AND SHAPE WOUNDS SO AS NOT TO RETAIN WATER. TREAT THE AREA WITH AN APPROVED INCONSPICUOUS LATEX BASED ANTISEPTIC TREE PAINT, IF PRUNING OCCURS "IN SEASON". DO NOT PRUNE ANY OAK TREES DURING THE MONTHS FROM APRIL TO OCTOBER.
- CLEANUP: THE WORK AREA SHALL BE KEPT SAFE AND NEAT AT ALL TIMES. DISPOSED OF EXCESS SOIL. REMOVE ALL CUTTINGS AND WASTE MATERIALS. SOIL AND BRANCHES. BIND AND WRAP THESE MATERIALS. ANY REJECTED PLANTS. AND ANY OTHER DEBRIS RESULTING FROM ALL PLANTING TASKS AND PROMPTLY CLEAN UP AND REMOVE FROM THE PROJECT SITE. UNDER NO CIRCUMSTANCES SHALL THE ACCUMULATION OF SOIL, BRANCHES OR OTHER DEBRIS BE ALLOWED UPON A PUBLIC PROPERTY IN SUCH A MANNER AS TO RESULT IN A PUBLIC SAFETY HAZARD OR DAMAGE. LIKEWISE, UNDER NO CIRCUMSTANCES SHALL ANY DEBRIS OR INCIDENTAL MATERIALS BE ALLOWED UPON ADJACENT PRIVATE PROPERTY.
- ANY SUBSTITUTIONS IN PLANT TYPE, LOCATION, OR SIZE SHALL BE APPROVED BY LANDSCAPE ARCHITECT PRIOR TO INSTALLATION.
- CONTRACTOR TO VERIFY PLANT MATERIAL QUANTITIES AND SQUARE FOOTAGES. QUANTITIES SHOWN ON PLAN TAKE PRECEDENCE OVER THOSE ON SCHEDULE.

LANDSCAPE MATERIAL NOTES

- MATERIALS PLANTING MIXTURE: ALL HOLES EXCAVATED FOR TREES, SHRUBS, PERENNIALS AND ORNAMENTAL GRASSES SHALL BE BACKFILLED WITH TWO (2) PARTS TOPSOIL, ONE (1) PART SAND AND ONE (1) PART COMPOST. SOIL MIXTURE SHALL BE WELL BLENDED PRIOR TO INSTALLATION.
- MATERIALS TOPSOIL: TOPSOIL TO BE CLEAN, FRIABLE LOAM FROM A LOCAL SOURCE, FREE FROM STONES OR DEBRIS OVER 3/4" IN DIAMETER, AND FREE FROM TOXINS OR OTHER DELETERIOUS MATERIALS. TOPSOIL SHALL HAVE A pH VALUE BETWEEN 6 AND 7. TOPSOIL AND PLANTING SOIL SHALL BE TESTED TO ENSURE CONFORMANCE WITH THESE SPECIFICATIONS AND SHALL BE AMENDED TO MEET THESE SPECIFICATIONS. PROVIDE TEST RESULTS TO OWNER'S REPRESENTATIVE PRIOR TO PLACEMENT. DO NOT PLACE FROZEN OR MUDDY TOPSOIL. APPLY SOIL AMENDMENTS TO ALL LANDSCAPE AREAS PER SOIL TEST.
- MATERIALS SHREDDED HARDWOOD BARK MULCH: ALL PLANTING AREAS LABELED ON PLAN SHALI RECEIVE CERTIFIED WEED FREE SHREDDED HARDWOOD BARK MULCH INSTALLED TO A MINIMUM AND CONSISTENT DEPTH OF 3-INCHES. SHREDDED HARDWOOD BARK MULCH SIZE & COLOR TO BE APPROVED BY OWNER'S REPRESENTATIVE PRIOR TO INSTALLATION. FERTILIZER SHALL BE IN ACCORDANCE WITH APPLICABLE LOCAL, COUNTY AND STATE REQUIREMENTS. SHREDDED HARDWOOD BARK MULCH AREAS SHALL NOT RECEIVE WOVEN WEED BARRIER FABRIC
- MATERIALS DECORATIVE STONE MULCH: ALL PLANTING AREAS LABELED ON PLAN SHALL RECEIVE SPREAD TO A MINIMUM AND CONSISTENT DEPTH OF 3-INCHES. DECORATIVE STONE MULCH SHALL BE 2" "AMERICAN" STONE, SUPPLIED FROM MADISON BLOCK & STONE, WWW.MADISONBLOCKANDSTONE.COM, (608) 249-5633. SUBSTITUTIONS IN STONE, SIZE AND/OR COLOR MUST BE APPROVED BY OWNER'S REPRESENTATIVE PRIOR TO INSTALLATION. FERTILIZER SHALL BE IN ACCORDANCE WITH APPLICABLE LOCAL, COUNTY AND STATE REQUIREMENTS. STONE MULCH AREAS SHALL RECEIVE WOVEN WEED BARRIER FABRIC. NO PLASTIC/IMPERVIOUS BARRIERS WILL BE PERMITTED. EXAMPLE: BLACK VISQUEEN.
- MATERIALS TREE & SHRUB RINGS: ALL TREES AND/OR SHRUBS PLANTED IN SEEDED LAWN AREAS TO BE INSTALLED WITH A MINIMUM 4' DIAMETER SHREDDED HARDWOOD BARK MULCH TREE RING SPREAD TO A CONSISTENT DEPTH OF 3-INCHES. ALL TREE RINGS SHOULD BE INSTALLED WITH A 5" DEPTH SHOVEL CUT EDGE, ANGLED 45 DEGREES INTO SOIL AT A 5' DIAMETER ABOUT THE CENTER OF THE TREE PLANTING. A PRE-EMERGENT GRANULAR HERBICIDE WEED-PREVENTER SHOULD BE MIXED WITH MULCH USED TO INSTALL TREE RING AS WELL AS TOPICALLY APPLIED TO COMPLETED INSTALLATION OF TREE RING.
- MATERIALS POLYETHYLENE EDGING: EDGING SHALL BE 5" DEEP, POLYETHYLENE EDGING. OWNER'S REPRESENTATIVE SHALL APPROVE PRODUCT SPECIFICATION PROVIDED BY LANDSCAPE CONTRACTOR.
- 7. MATERIALS TREE PROTECTION: ALL TREES TO BE INSTALLED WITH LDPE TREE GUARDS AS MANUFACTURED BY A.M. LEONARD HORTICULTURAL TOOL & SUPPLY CO., OR APPROVED EQUAL.
- 8. MATERIALS (ALTERNATE 1): TREE WATERING BAGS: ALL TREES TO BE INSTALLED WITH ONE (1) WATER BAG. PRODUCT TO BE "TREE GATOR ORIGINAL SLOW RELEASE WATERING BAG," PRODUCT NO. 98183-R OR APPROVED EQUAL. INSTALL IN ACCORDANCE WITH MANUFACTURER'S RECOMMENDATIONS.

SEEDING & SODDING NOTES

- MATERIALS TURFGRASS SEED: DISTURBED LAWN AREAS LABELED ON PLAN AS SUCH, SHALL RECEIVE 6" OF TOPSOIL AND EARTH CARPET'S "MADISON PARKS" GRASS SEED, OR EQUIVALENT AS APPROVED BY THE OWNER'S REPRESENTATIVE, INSTALLED PER MANUFACTURER'S RECOMMENDATIONS. IN ADDITION TO TURFGRASS SEED, ANNUAL RYE SHALL BE APPLIED TO ALL DISTURBED AREAS AT A RATE OF 1 1/2 LBS PER 1000 SQUARE FEET. FERTILIZE AND MULCH PER MANUFACTURER'S RECOMMENDATIONS. MULCH SHALL BE CERTIFIED NOXIOUS WEED SEED-FREE
- MATERIALS SOD: DISTURBED LAWN AREAS LABELED ON PLAN AS SUCH, SHALL RECEIVE 6" OF TOPSOIL AND A PREMIUM GRADE TURFGRASS SOD. ONLY IMPROVED TYPES OF SOD (ELITE) ARE ACCEPTABLE. TURFGRASS SHALL BE MACHINE CUT AT A UNIFORM THICKNESS OF .60 INCH, PLUS OR MINUS .25 INCH, AT TIME OF CUTTING. MEASUREMENT FOR THICKNESS SHALL EXCLUDE TOP GROWTH AND THATCH. LARGE ROLI TURFGRASS SOD SHALL BE CUT TO THE SUPPLIER'S STANDARD WIDTH (36-48 INCHES) AND LENGTH. BROKEN PADS AND TORN OR UNEVEN ENDS WILL NOT BE ACCEPTABLE. STANDARD SIZE SECTIONS OF TURGRASS SOD SHALL BE STRONG ENOUGH SO THAT THEY CAN BE PICKED UP AND HANDLED WITHOUT DAMAGE. TURFGRASS SOD SHALL NOT BE HARVESTED OR TRANSPLANTED WHEN MOISTURE CONTENT IS EXCESSIVELY DRY OR WET. AS THIS MAY ADVERSELY AFFECT ITS SURVIVAL. POST-PLANT IRRIGATION WILL BE NECESSARY TO ENSURE SOD STAYS ALIVE AND ROOTS INTO SOIL. THE CONTRACTOR IS RESPONSIBLE FOR WATERING SOD UNTIL TIME OF ACCEPTANCE BY THE OWNER. TURFGRASS SOD SHALL BE HARVESTED, DELIVERED, AND INSTALLED/TRANSPLANTED WITHIN A PERIOD OF 24 HOURS. TURFGRASS SOD SHALL BE RELATIVELY FREE OF THATCH, UP TO 0.5 INCH ALLOWABLE (UNCOMPRESSED). TURFGRASS SOD SHALL BE REASONABLY FREE (10 WEEDS/100 SQ. FT.) OF DISEASES, NEMATODES AND SOIL-BORNE INSECTS. ALL TURFGRASS SOD SHALL BE FREE OF GRASSY AND BROAD LEAF WEEDS AND WEED SEED. THE SOD SUPPLIER SHALL MAKE RECOMMENDATIONS TO THE CONTRACTOR REGARDING WATERING SCHEDULE. THE WATERING SCHEDULE SHOULD BEGIN IMMEDIATELY AFTER SOD IS INSTALLED.



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PRIME URBAN PROPERTIES, LLC

CLIENT ADDRESS: 1952 ATWOOD AVENUE MADISON, WI 53704

209 COTTAGE GROVE ROAD APARTMENTS

PROJECT LOCATION: MADISON, WI DANE COUNTY

#	Date:	Description:
	07.08.2020	LAND USE SUBMITTAL
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LANDSCAPE DETAILS &

JSD PROJECT NO:

Toll Free (800) 242-8511


CONTRACTOR AND OWNER RESPONSIBILITY NOTES


- GUARANTEE: THE CONTRACTOR SHALL GUARANTEE ALL PLANTS THROUGH ONE (1) YEAR AFTER ACCEPTANCE BY THE OWNER'S REPRESENTATIVE. PLANTS SHALL BE ALIVE AND IN HEALTHY AND FLOURISHING CONDITION AT THE END OF THE GUARANTEE PERIOD. THE CONTRACTOR SHALL REPLACE (AT NO COST TO OWNER) ANY PLANTS THAT ARE DEAD OR NOT IN A VIGOROUS THRIVING CONDITION. REPLACEMENT PLANTS SHALL BE OF THE SAME KIND AND SIZE AS ORIGINALLY SPECIFIED UNLESS OTHERWISE DIRECTED BY OWNER'S REPRESENTATIVE. RESTORE BEDS AS NECESSARY FOLLOWING PLANT REPLACEMENT, INCLUDING BUT NOT LIMITED TO BEDDING, EDGING, MULCH, ETC. REPLACE PLANTS DAMAGED AT TIME OF PLANTING. REPAIR AREAS DISTURBED IN ANY WAY DURING PLANT REPLACEMENT AT NO COST TO OWNER. CONTRACTOR SHALL PROVIDE A ONE (1)—YEAR STRAIGHTENING GUARANTEE FOR ALL TREES.
- CONTRACTOR IS RESPONSIBLE FOR STAKING THE PLANT MATERIALS FOR REVIEW BY OWNER'S REPRESENTATIVE PRIOR TO DIGGING AND PLACEMENT AND SHALL COORDINATE ALL FINE GRADING AND RESTORATION WITH THE GRADING CONTRACTOR.
- MAINTENANCE: (CONTRACTOR) FOR ALL PLANTINGS, SEEDED AND/OR SODDED LAWN AREAS: THE CONTRACTOR SHALL MAINTAIN ALL PLANTINGS AND LAWN AREAS FOR A MINIMUM TIME PERIOD OF 60 DAYS, UNTIL FINAL ACCEPTANCE BY OWNER'S REPRESENTATIVE. THE CONTRACTOR IS RESPONSIBLE FOR ADEQUATELY WATERING PLANTS AND LAWN/TURFGRASS DURING THIS 60 DAY ESTABLISHMENT PERIOD. CONTRACTOR IS RESPONSIBLE FOR THE ESTABLISHMENT OF HEALTHY VIGOROUS PLANT MATERIALS AND LAWN/TURFGRASS GROWTH. CONTRACTOR IS ALSO RESPONSIBLE FOR ANY PRUNING OF PLANT MATERIALS, AND SHAPING AND/OR REPLACEMENT OR SUPPLEMENT OF DEFICIENT SHREDDED HARDWOOD BARK MULCH DURING THIS PERIOD. LONG TERM PLANT MATERIALS AND LAWN/TURFGRASS MAINTENANCE AND ANY PROGRAM FOR SUCH IS THE RESPONSIBILITY OF THE OWNER. ALL PLANTINGS AND LAWN/TURFGRASS AREAS SHALL BE MAINTAINED IN A MANICURED CONDITION UNTIL THE TIME WHEN THE OWNER'S ACCEPTANCE IS GIVEN.
- MAINTENANCE: (OWNER) THE OWNER IS RESPONSIBLE FOR THE CONTINUED MAINTENANCE, REPAIR AND REPLACEMENT OF ALL LANDSCAPING MATERIALS AND WEED BARRIER FABRIC AS NECESSARY FOLLOWING THE ONE (1) YEAR CONTRACTOR GUARANTEE PERIOD.


RRIGATION (SEE SPECS):

BASE BID - DRIP IRRIGATION PROVIDED IN ALL PLANT BED AREAS SURROUNDING

BUILDING AND ROOFTOP PATIO PLANTERS ALTERNATE BID - POP-UP IRRIGATION FOR ALL PERIMETER PLANTING BEDS AND TURFGRASS AREAS

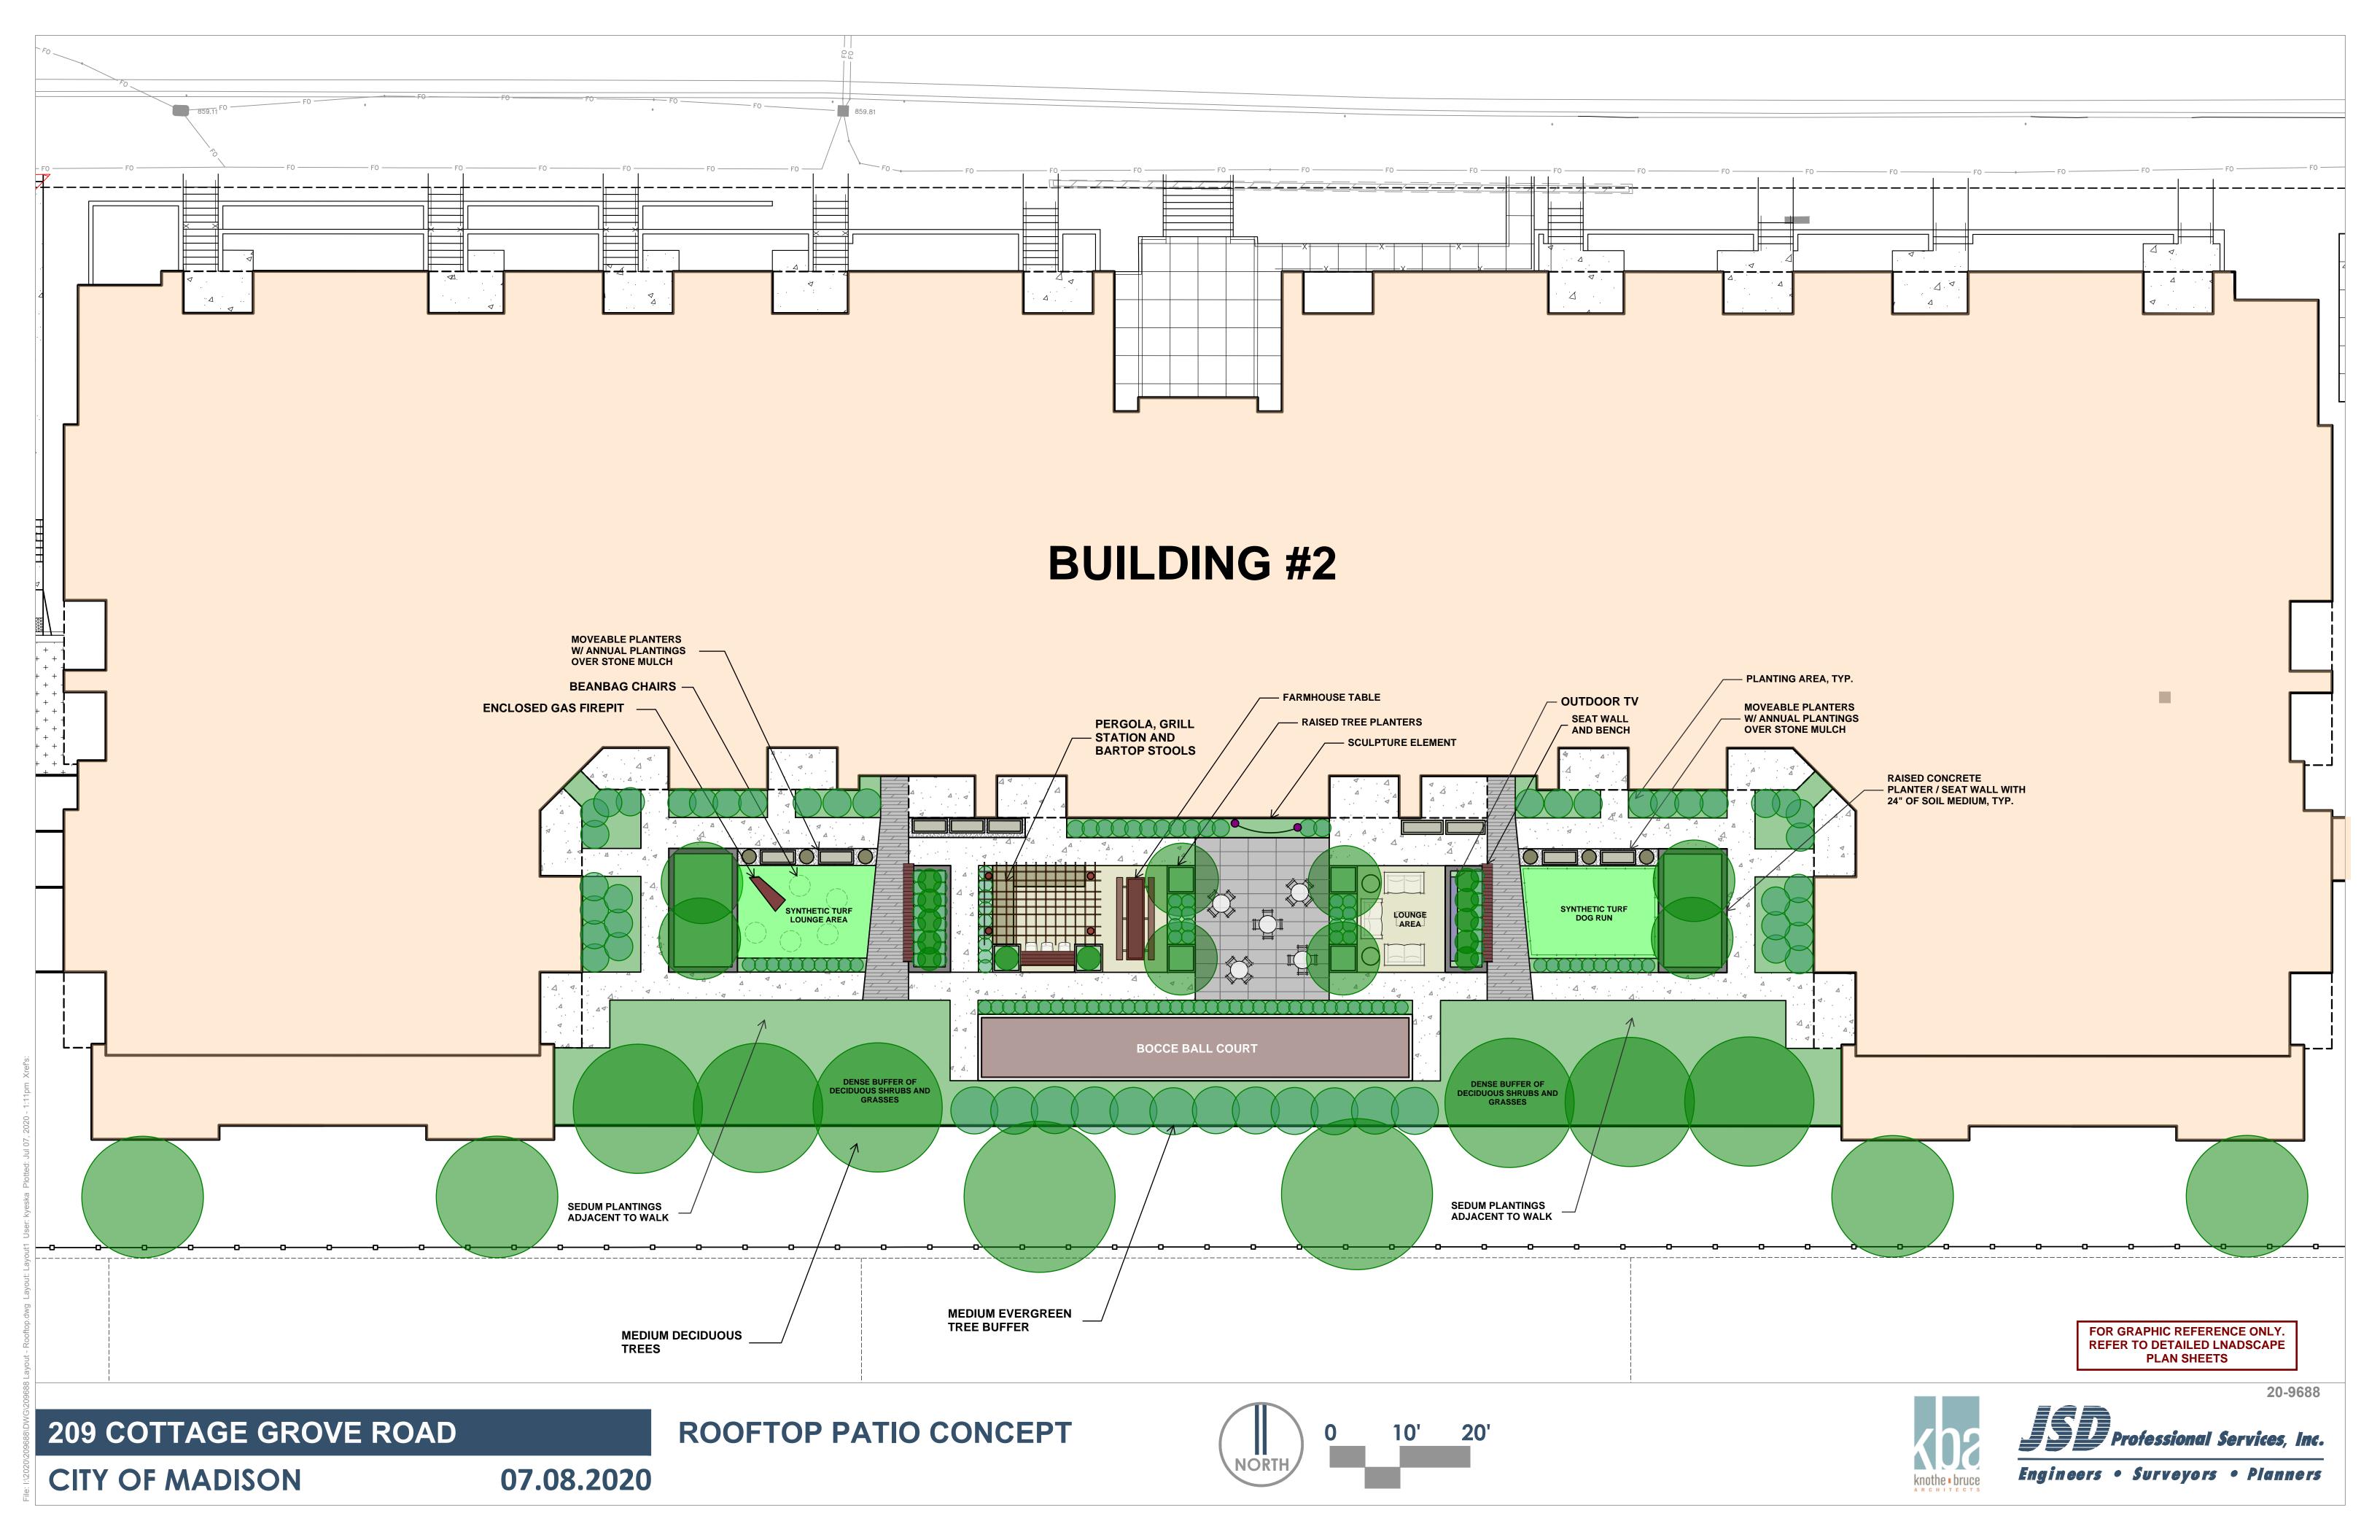

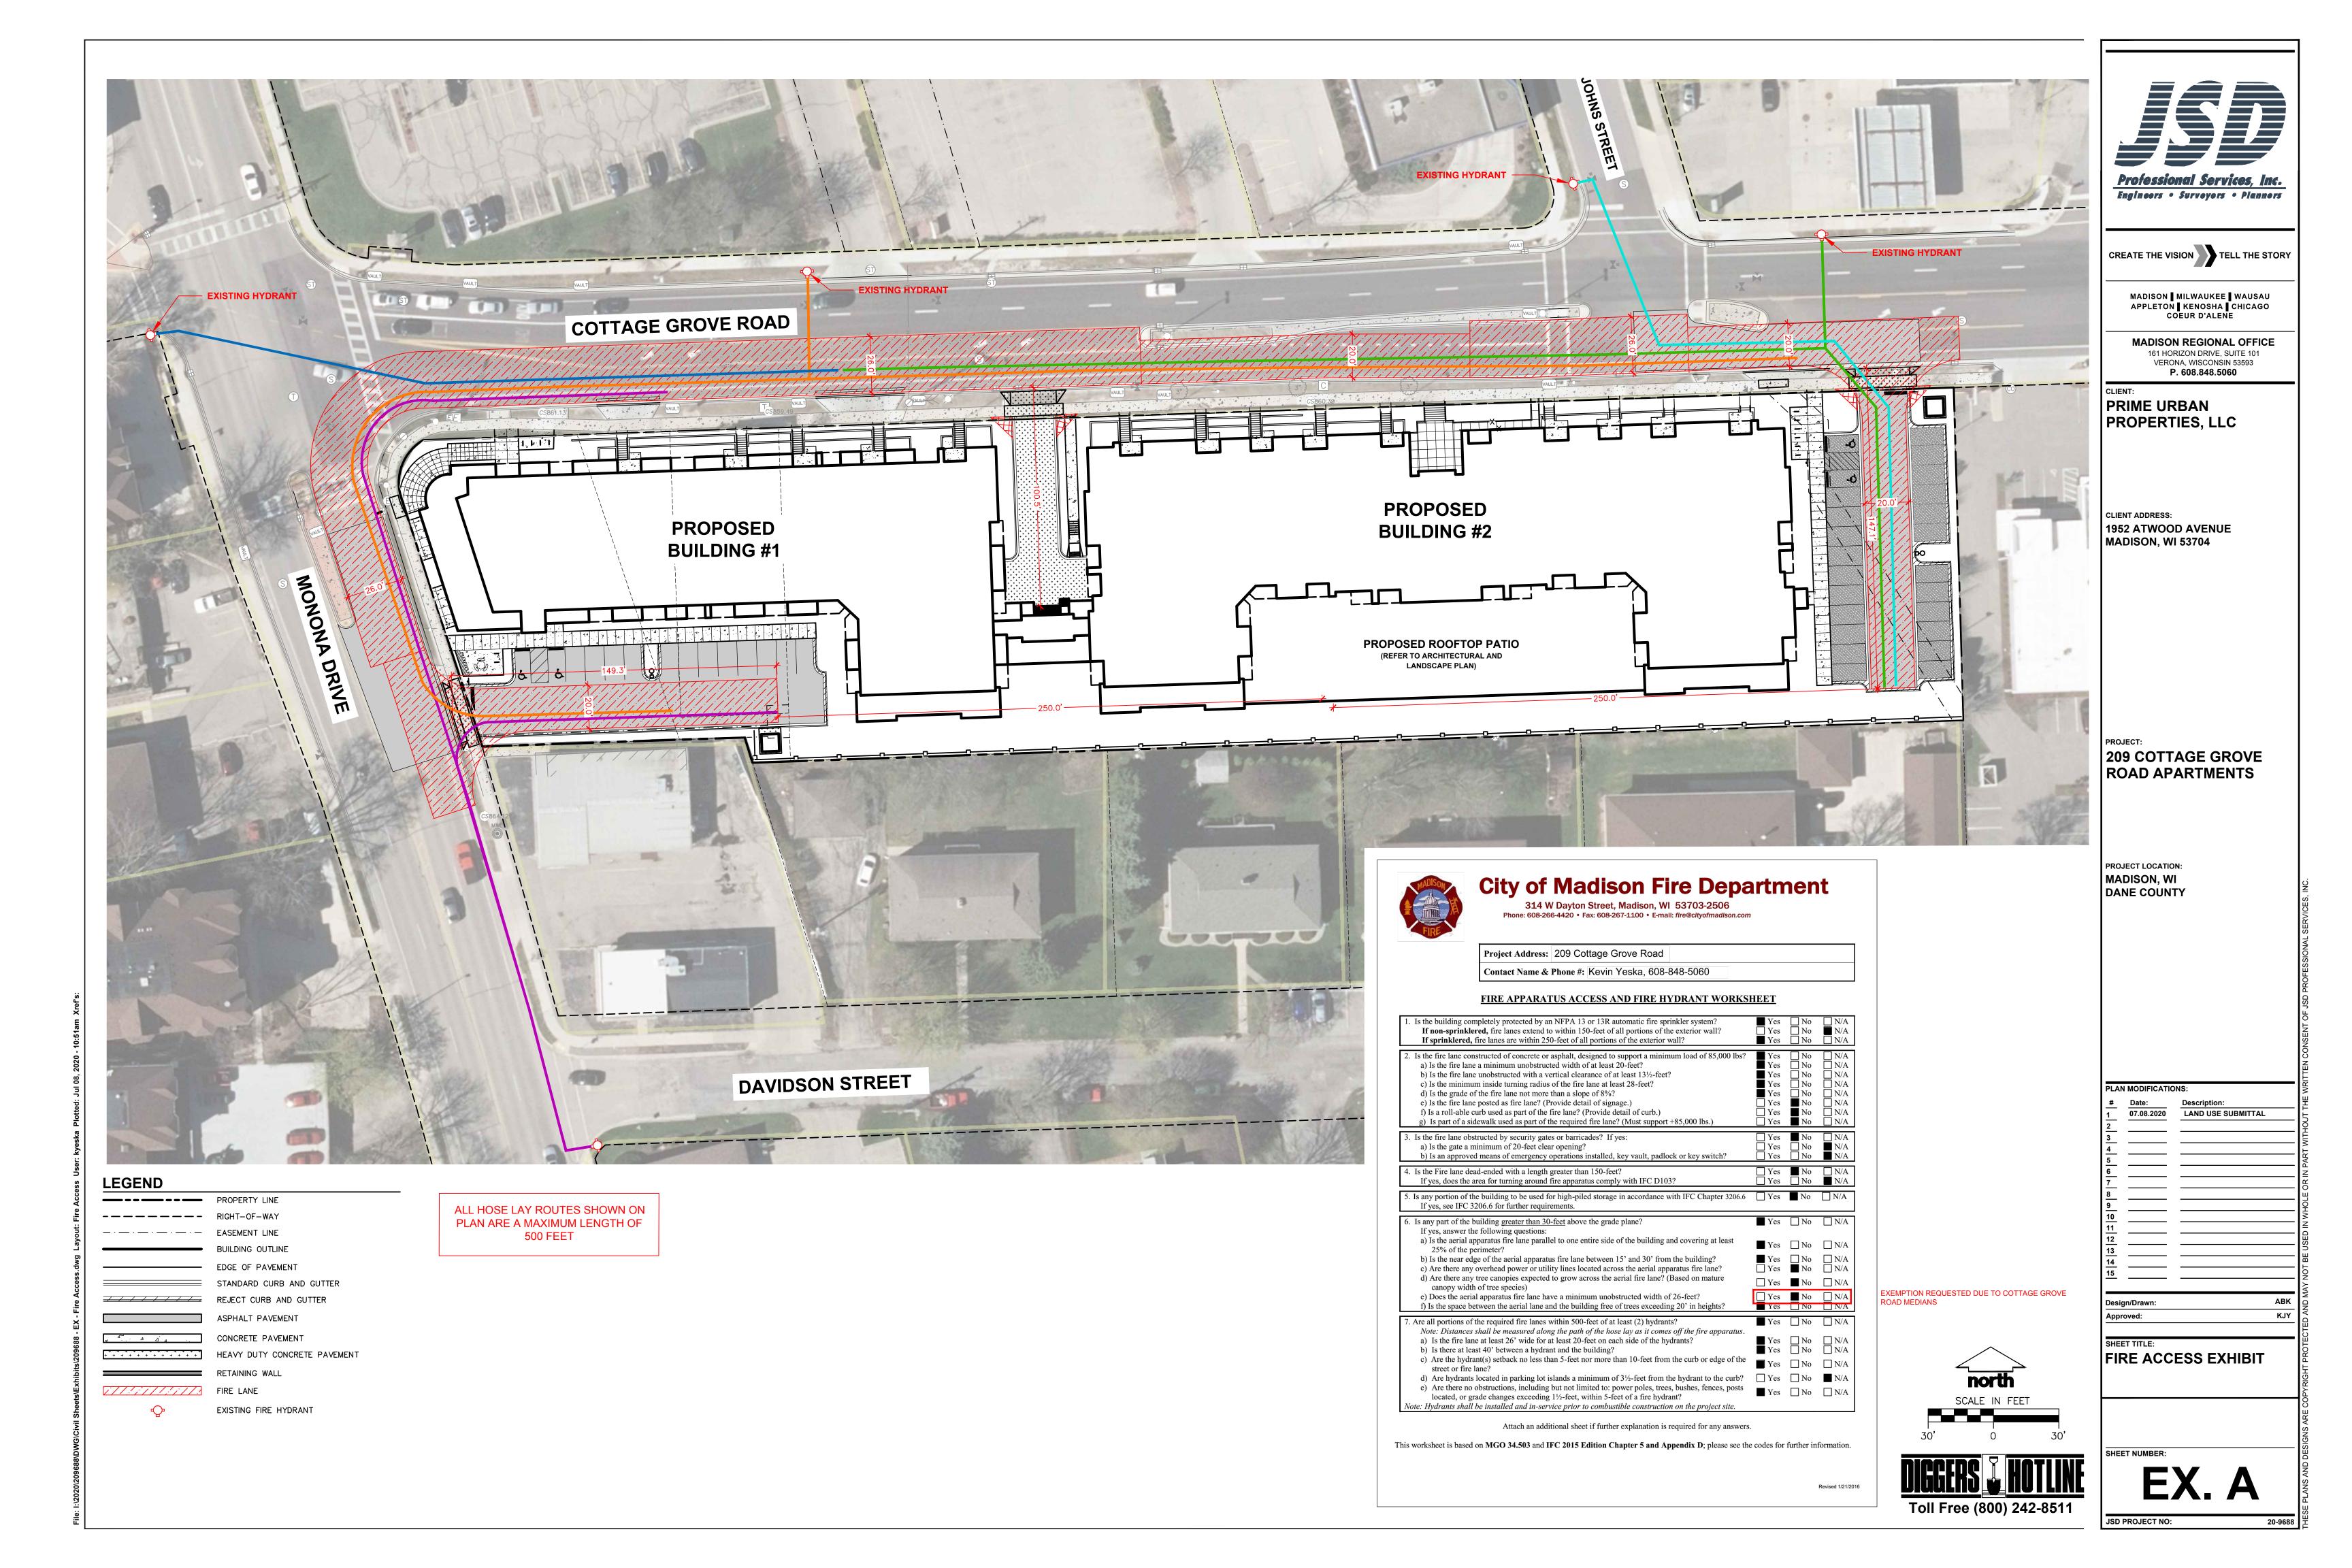

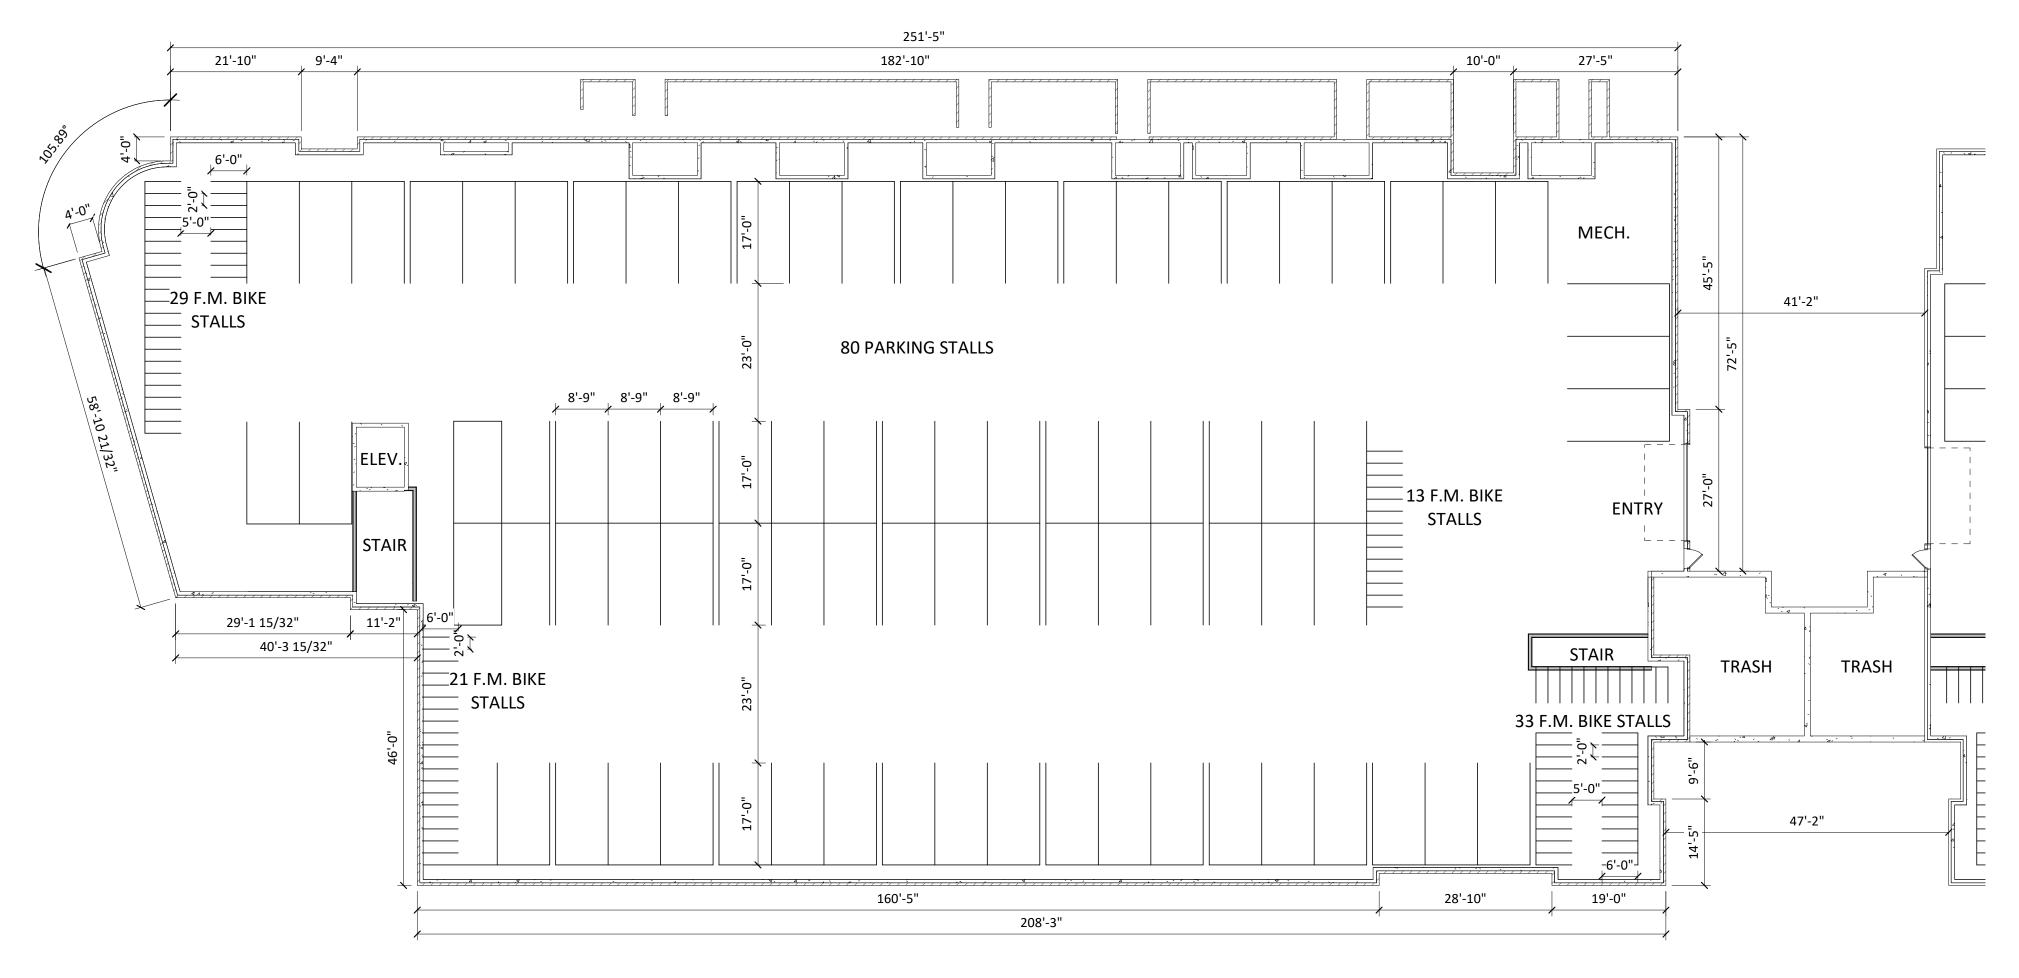

1 00 - BUILDING #1 - BASEMENT
A-1.0 1/16" = 1'-0"

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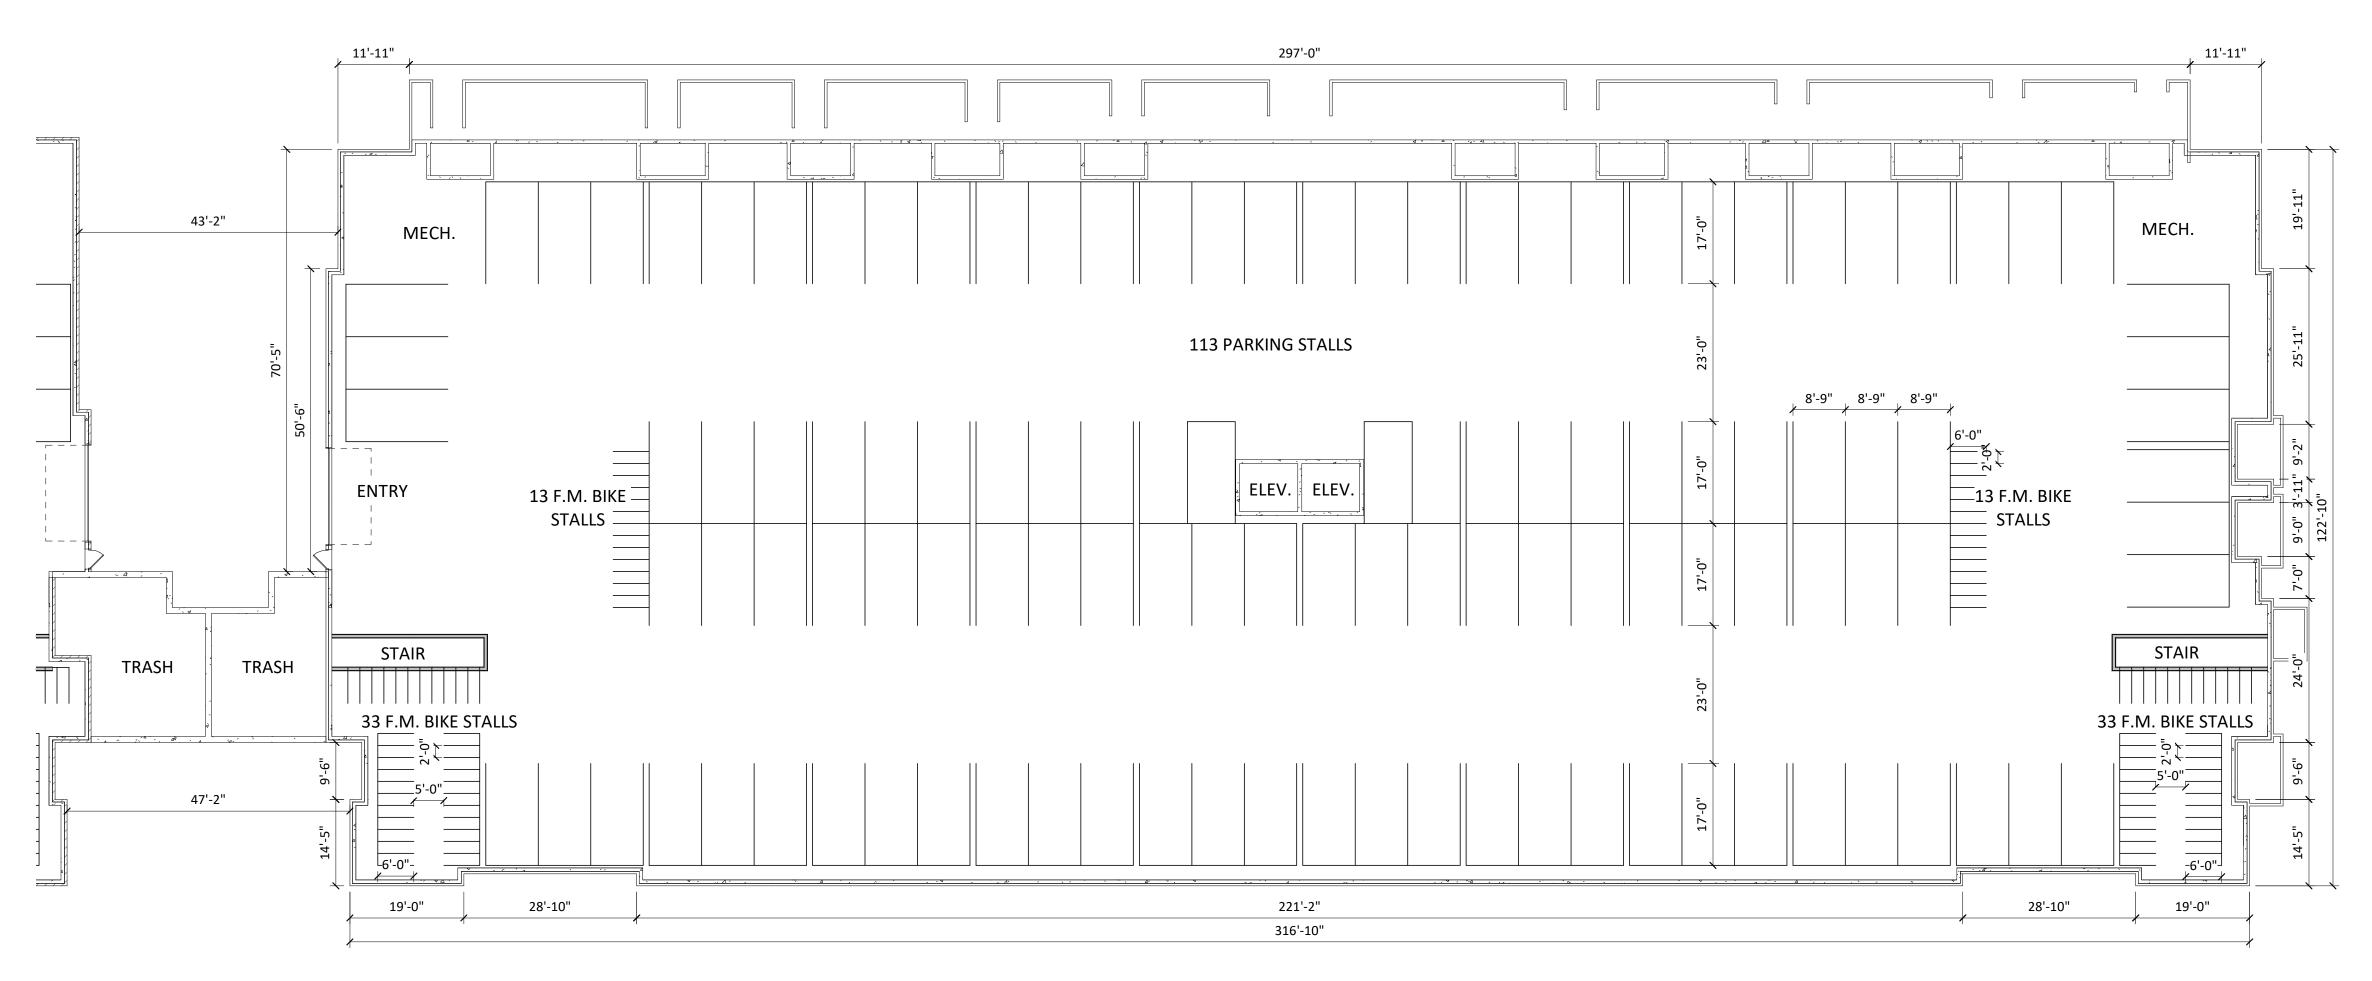
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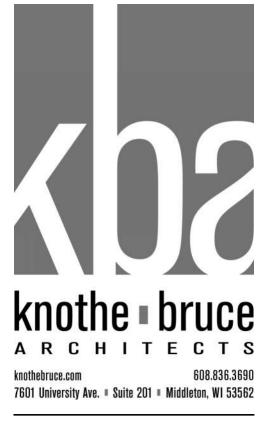
SHEET TITLE
BASEMENT
FLOOR PLAN

SHEET NUMBER

A-1.0



1 00 - BUILDING #2 - BASEMENT
A-1.1 1/16" = 1'-0"



KEY PLAN


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PROJECT TITLE
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SHEET TITLE
BASEMENT
FLOOR PLAN

SHEET NUMBER



1 01 - BUILDING #1 - FIRST FLOOR
A-1.2 1/16" = 1'-0"

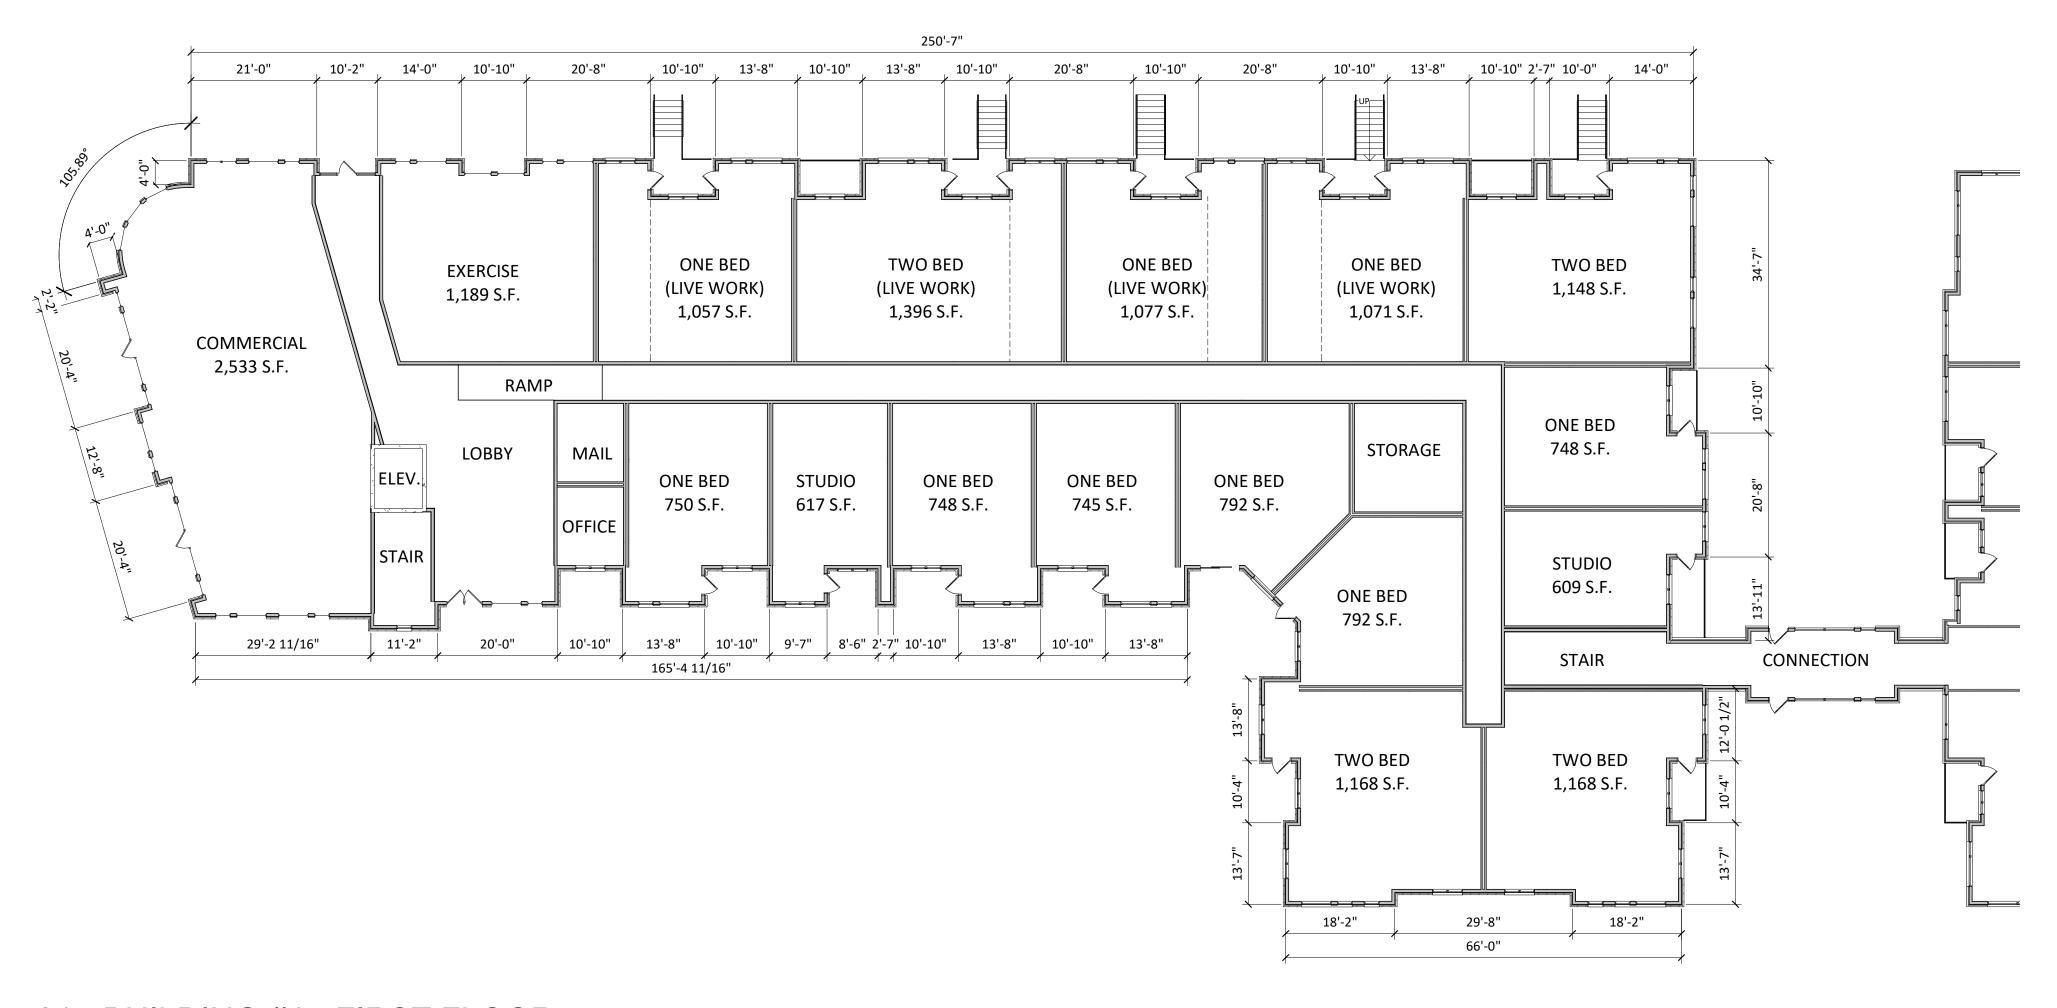

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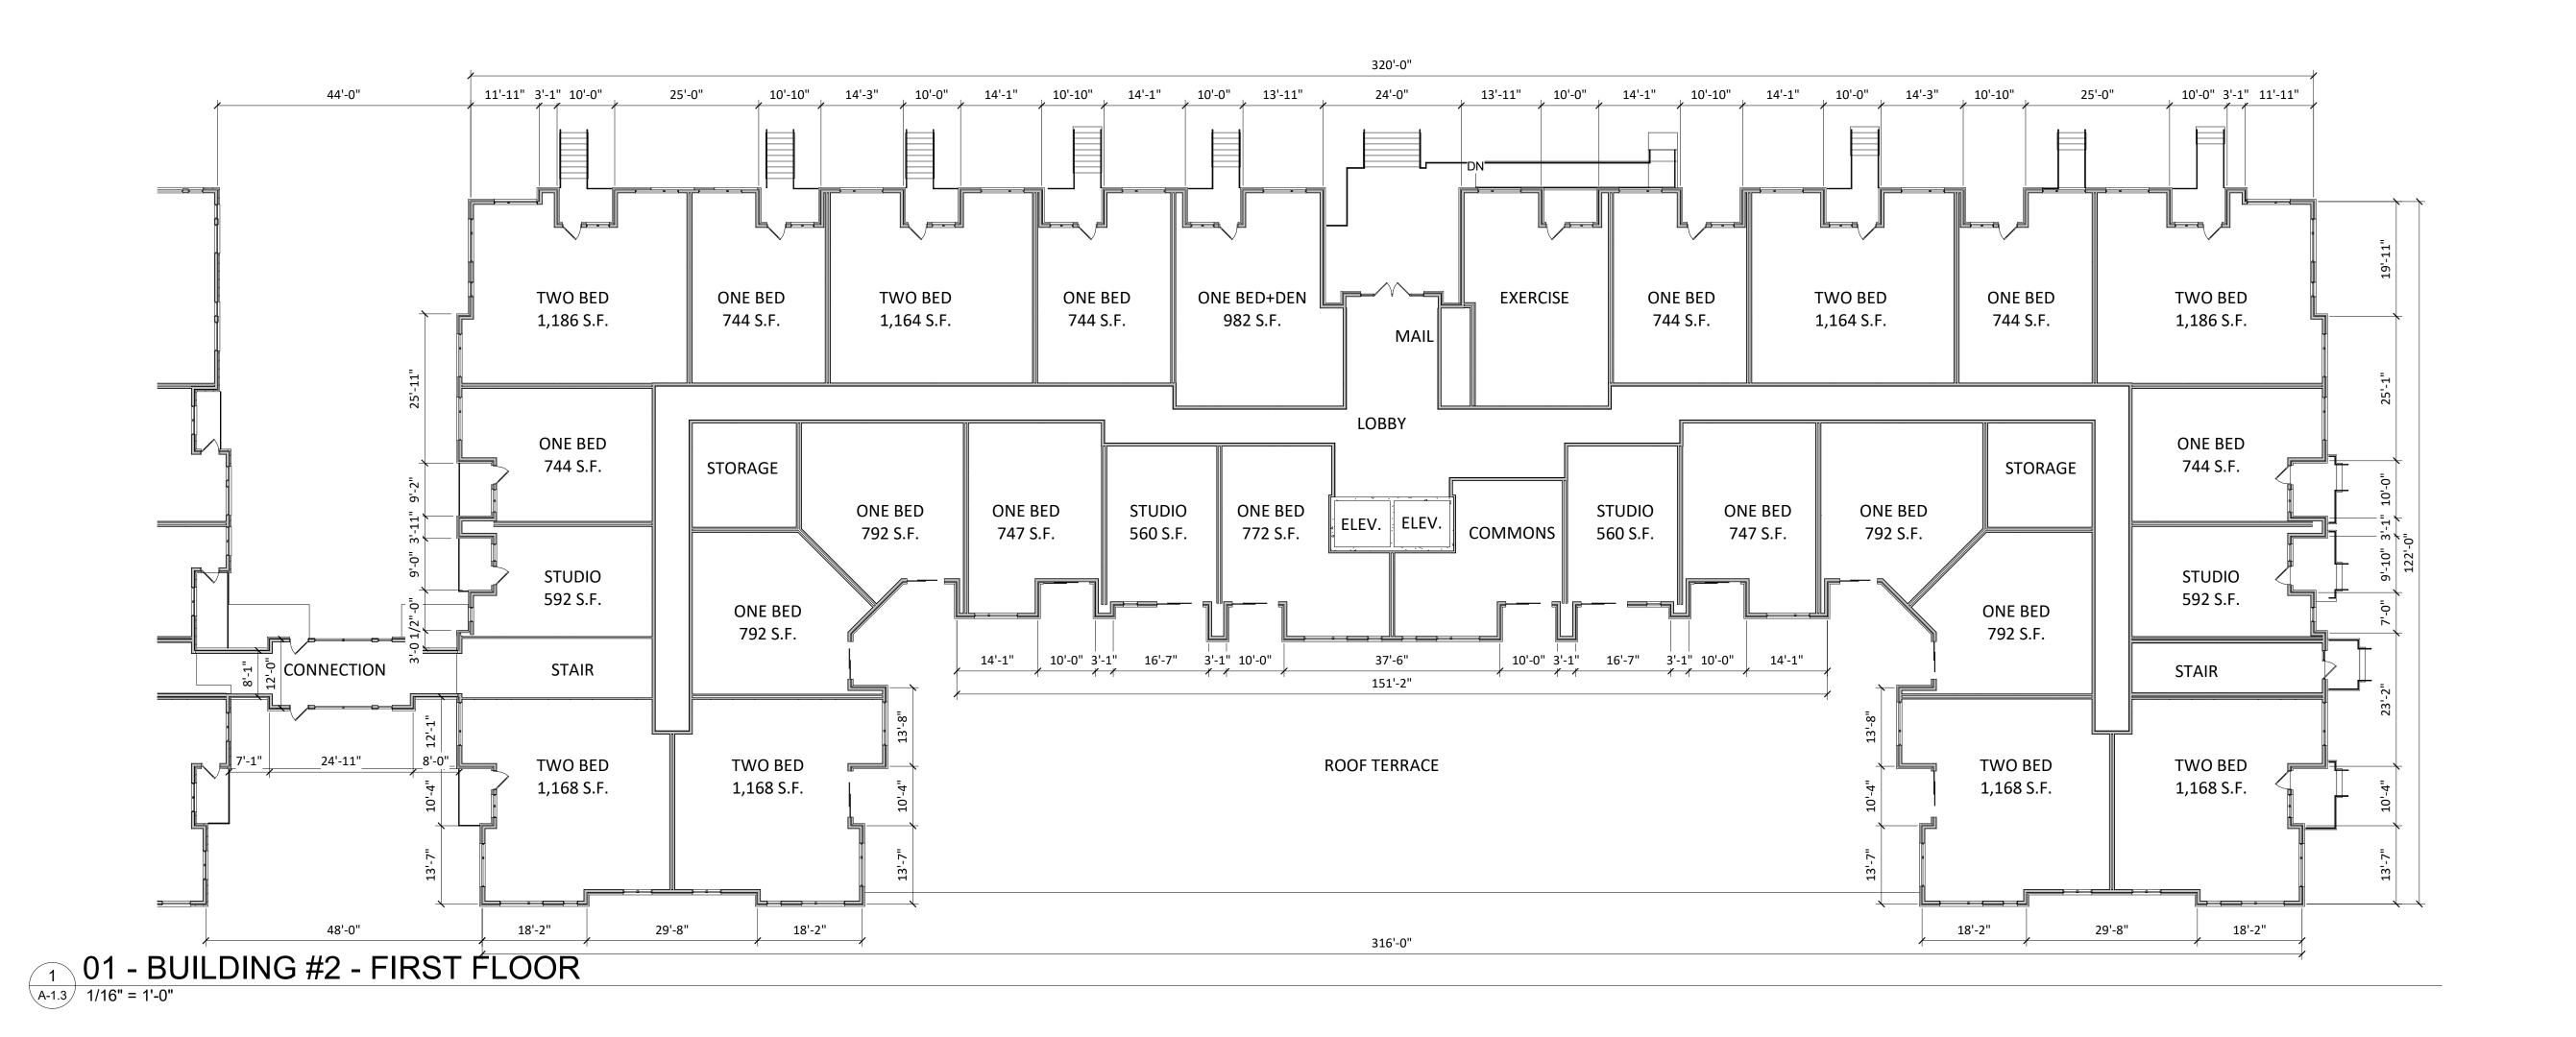
PROJECT TITLE

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SHEET TITLE FIRST FLOOR PLAN

SHEET NUMBER





KEY PLAN

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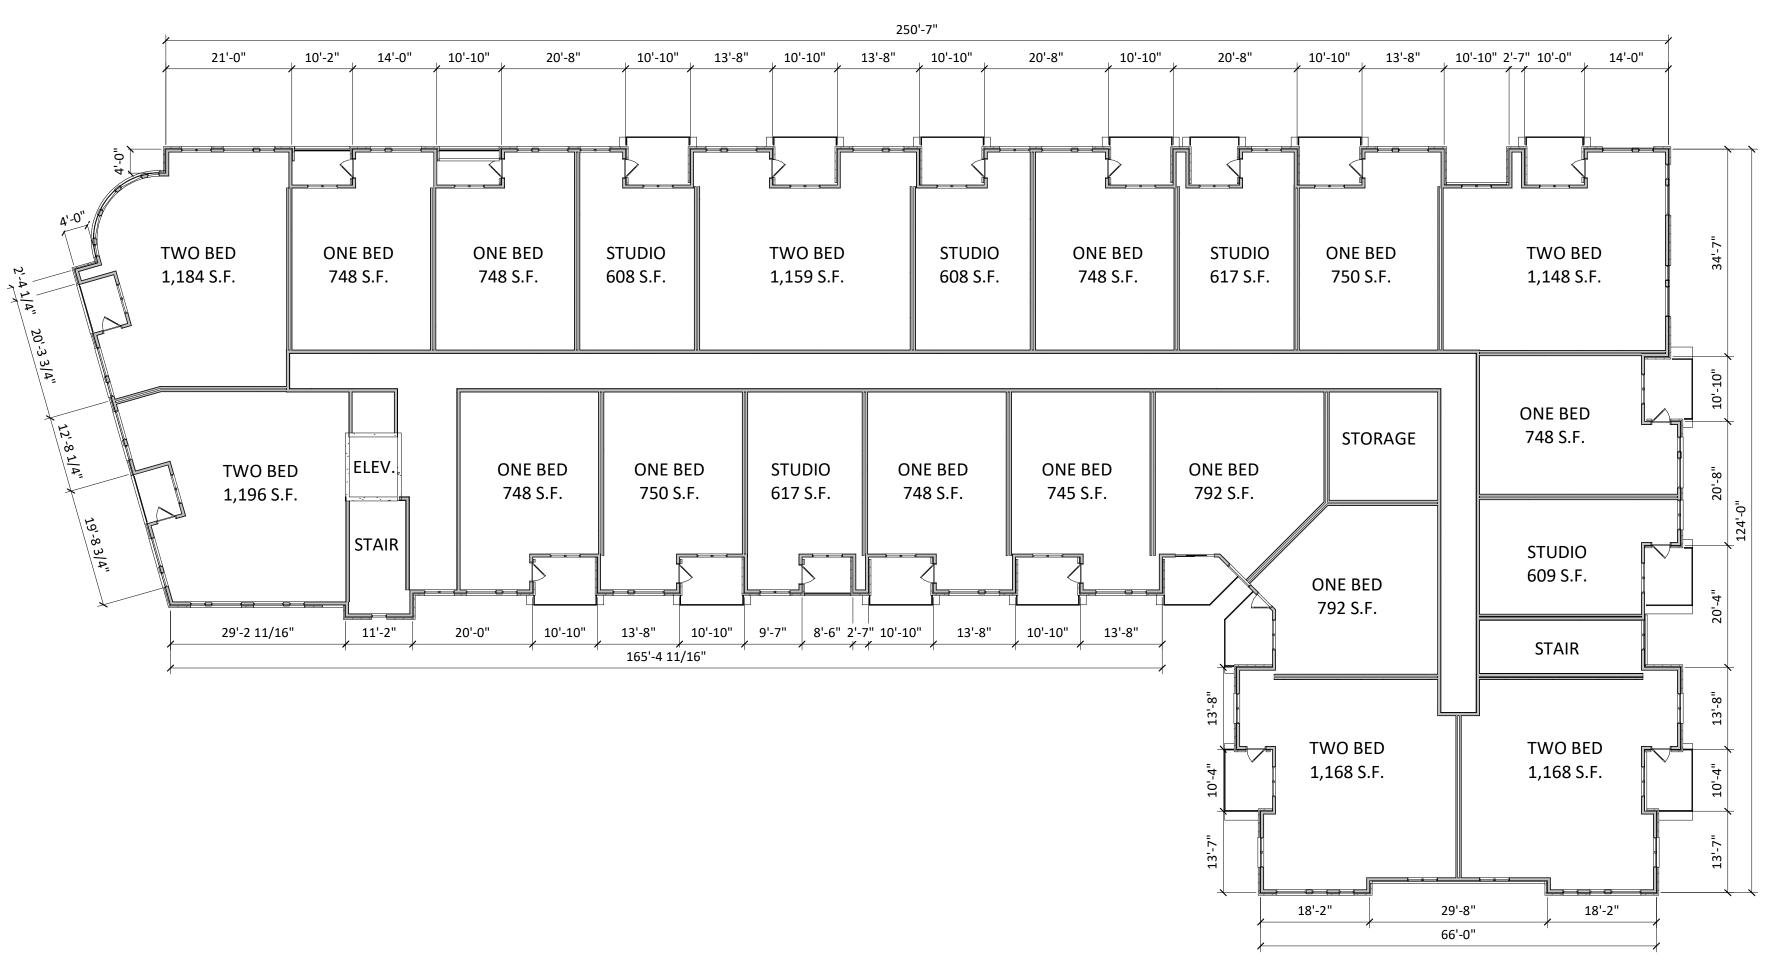
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FIRST FLOOR
PLAN

SHEET NUMBER


A-1.3

PROJECT NUMBER 201



02 - BUILDING #1 - SECOND FLOOR

A-1.4 1/16" = 1'-0"

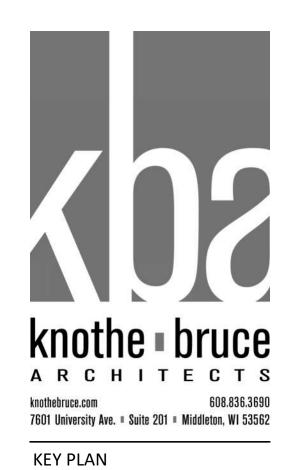

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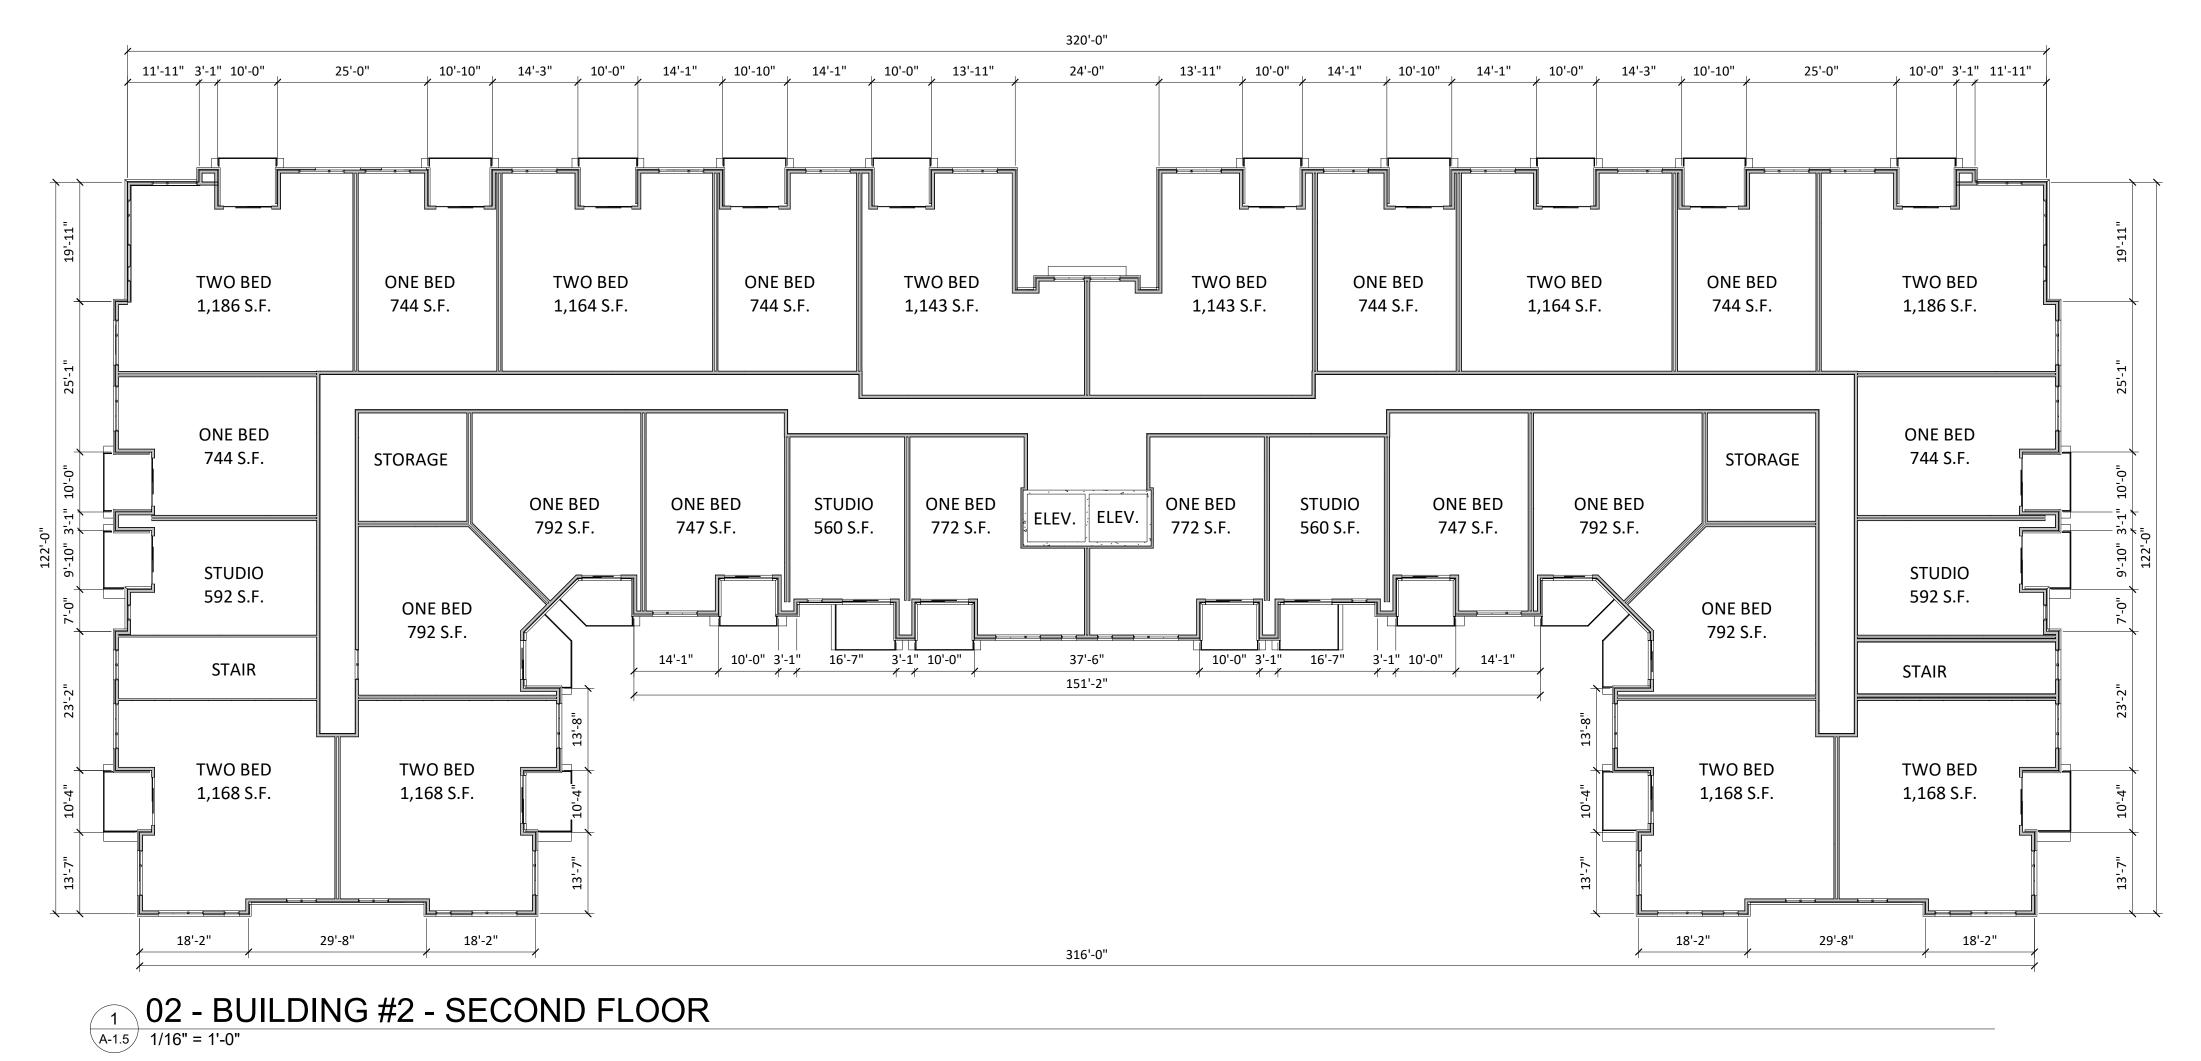
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SHEET TITLE SECOND FLOOR PLAN

SHEET NUMBER





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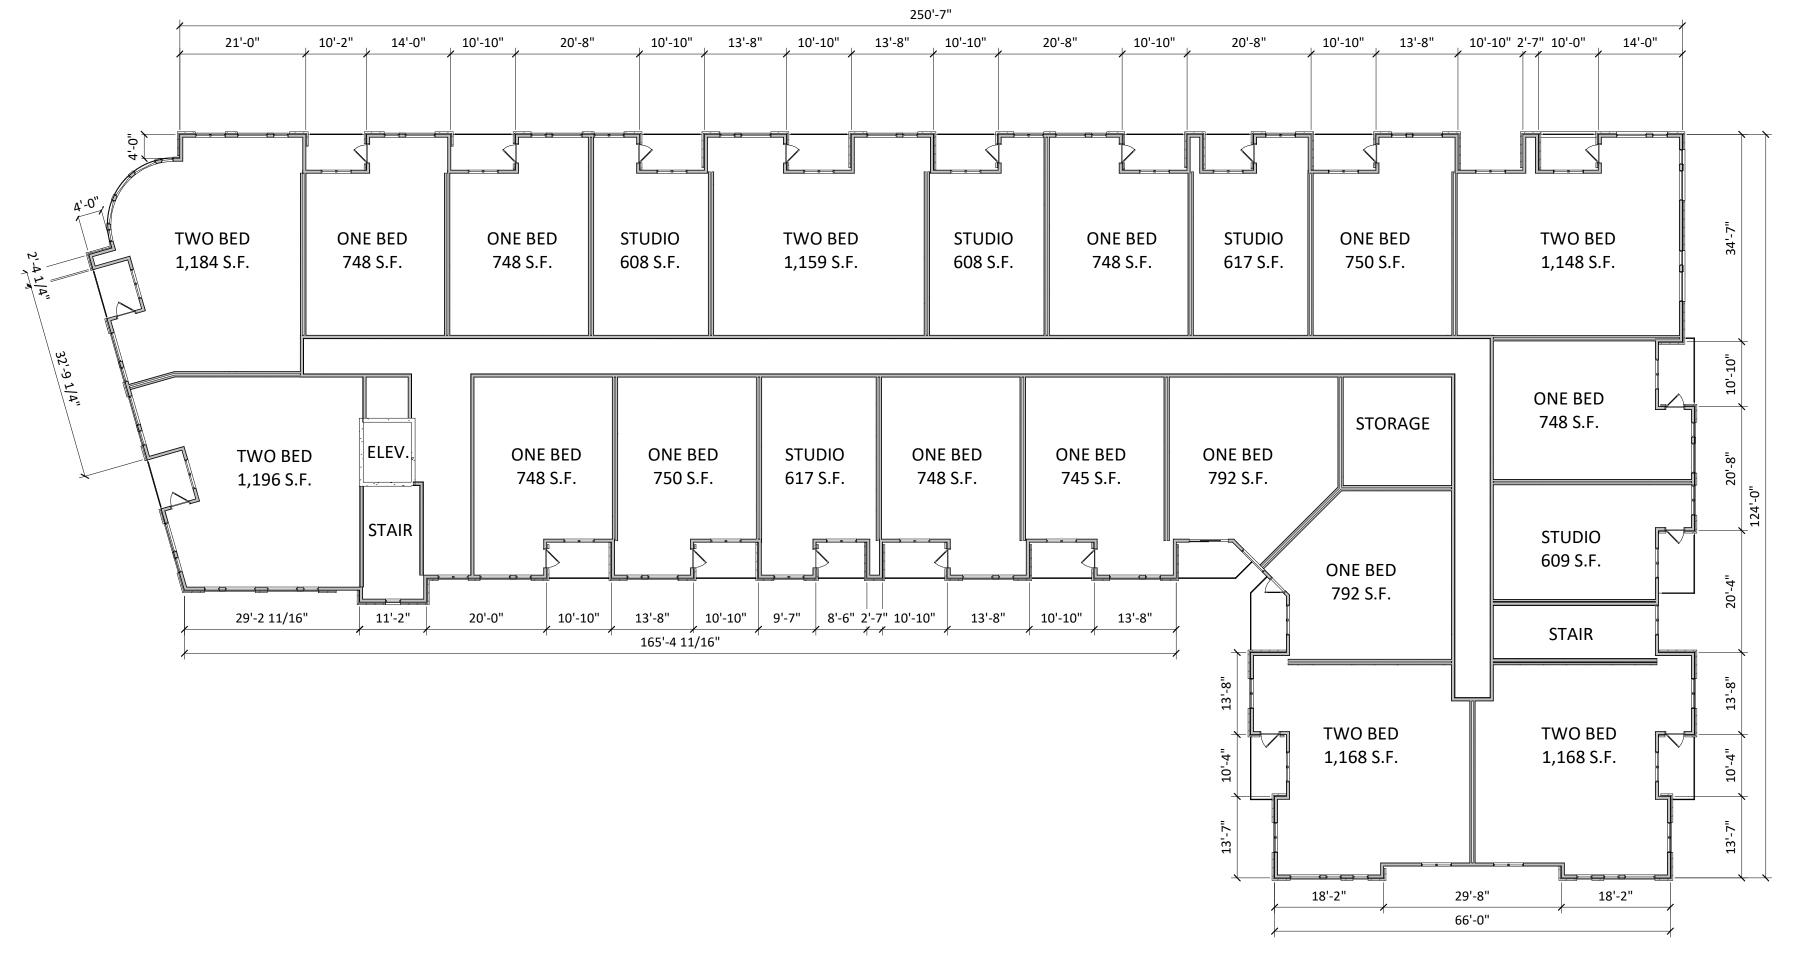
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SHEET TITLE SECOND FLOOR PLAN


SHEET NUMBER

A-1.5



03 - BUILDING #1 - THIRD FLOOR

1/16" = 1'-0"

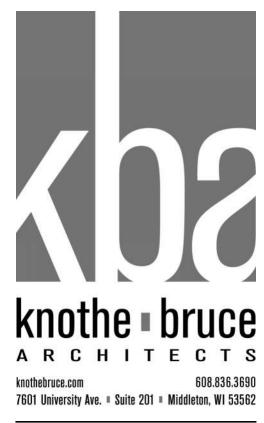

KEY PLAN

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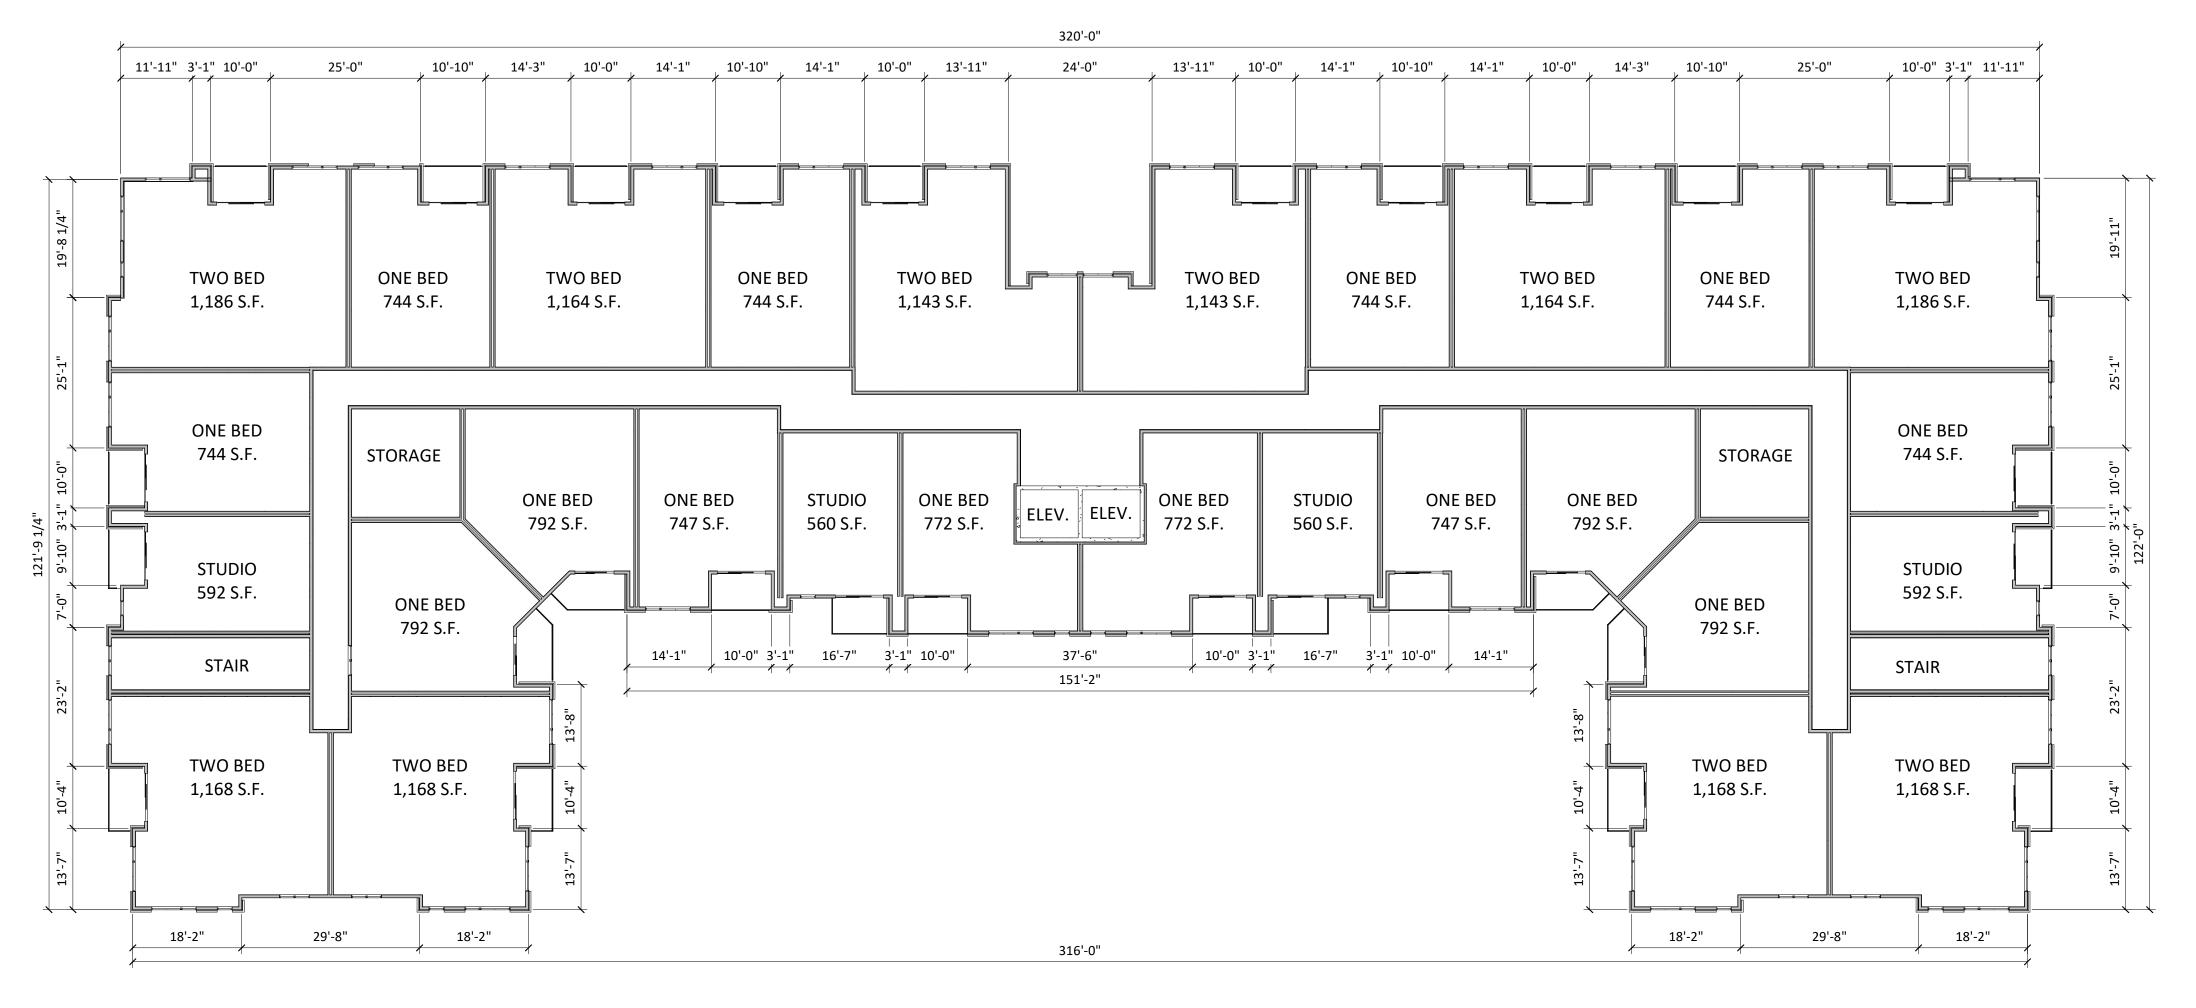
PROJECT TITLE
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Development

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THIRD FLOOR
PLAN

SHEET NUMBER

A-1.6



1 03 - BUILDING #2 - THIRD FLOOR
A-1.7 1/16" = 1'-0"




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PROJECT TITLE Prime Urban **Properties** Development

209 Cottage Grove Rd. Madison, Wisconsin SHEET TITLE

THIRD FLOOR PLAN

SHEET NUMBER

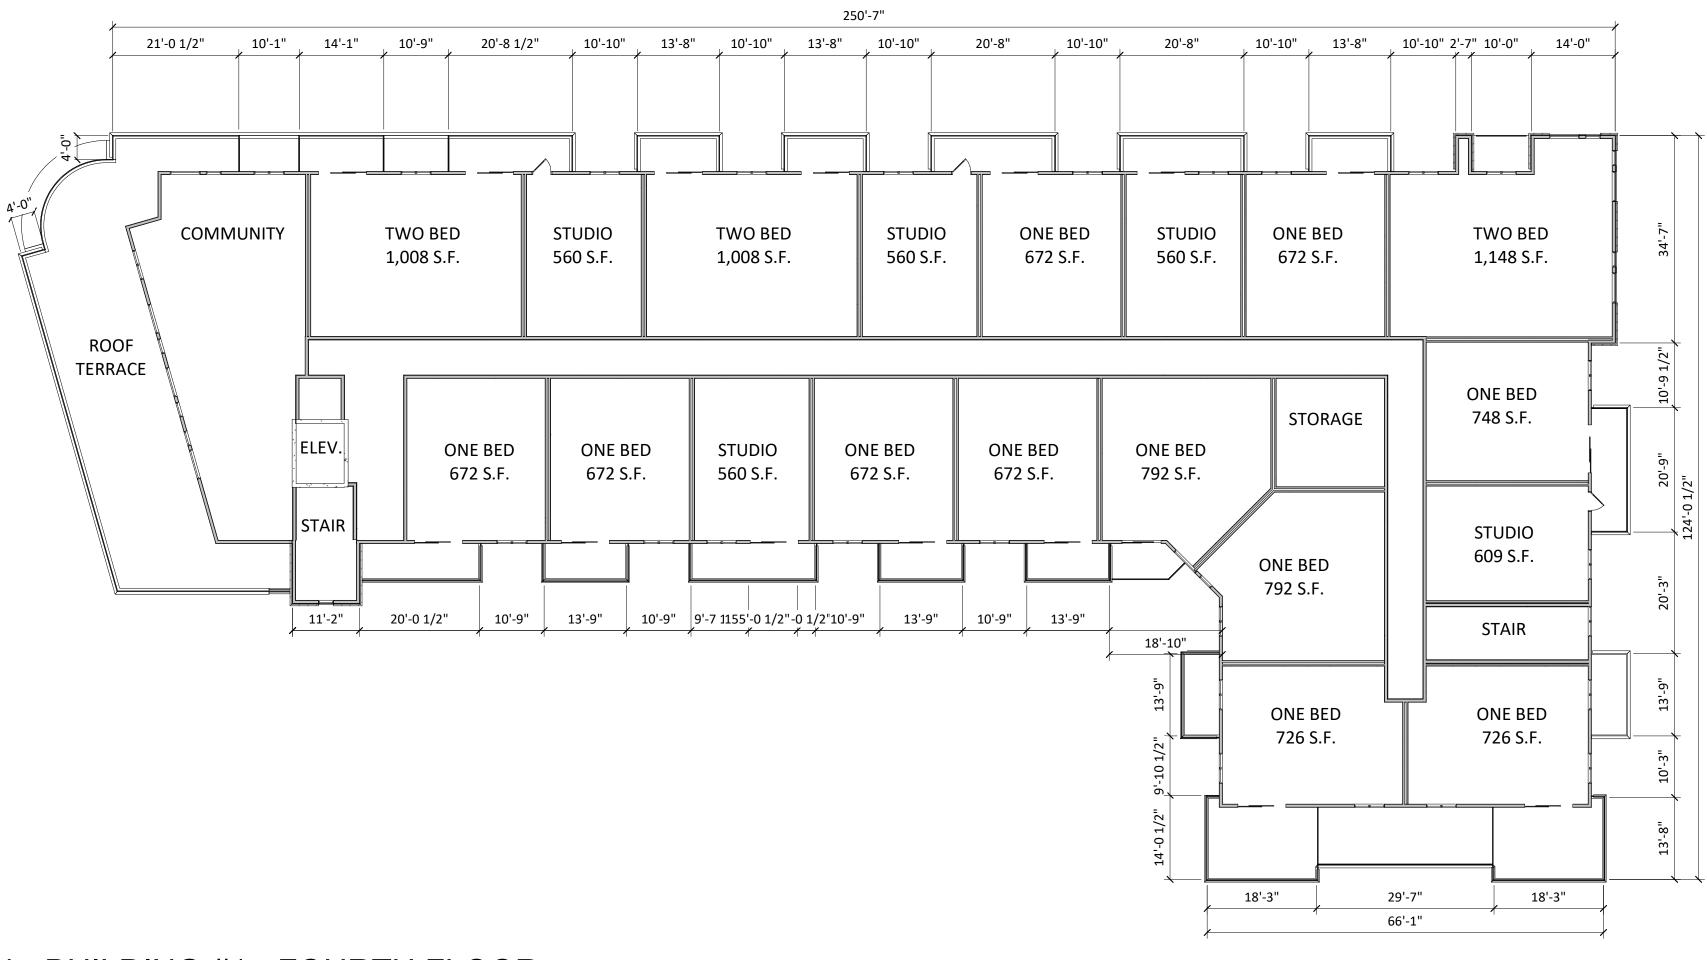

04 - BUILDING #1 - FOURTH FLOOR

1/16" = 1'-0"



KEY PLAN

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PROJECT TITLE Prime Urban


Properties Development

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SHEET TITLE FOURTH FLOOR PLAN

SHEET NUMBER

A-1.8

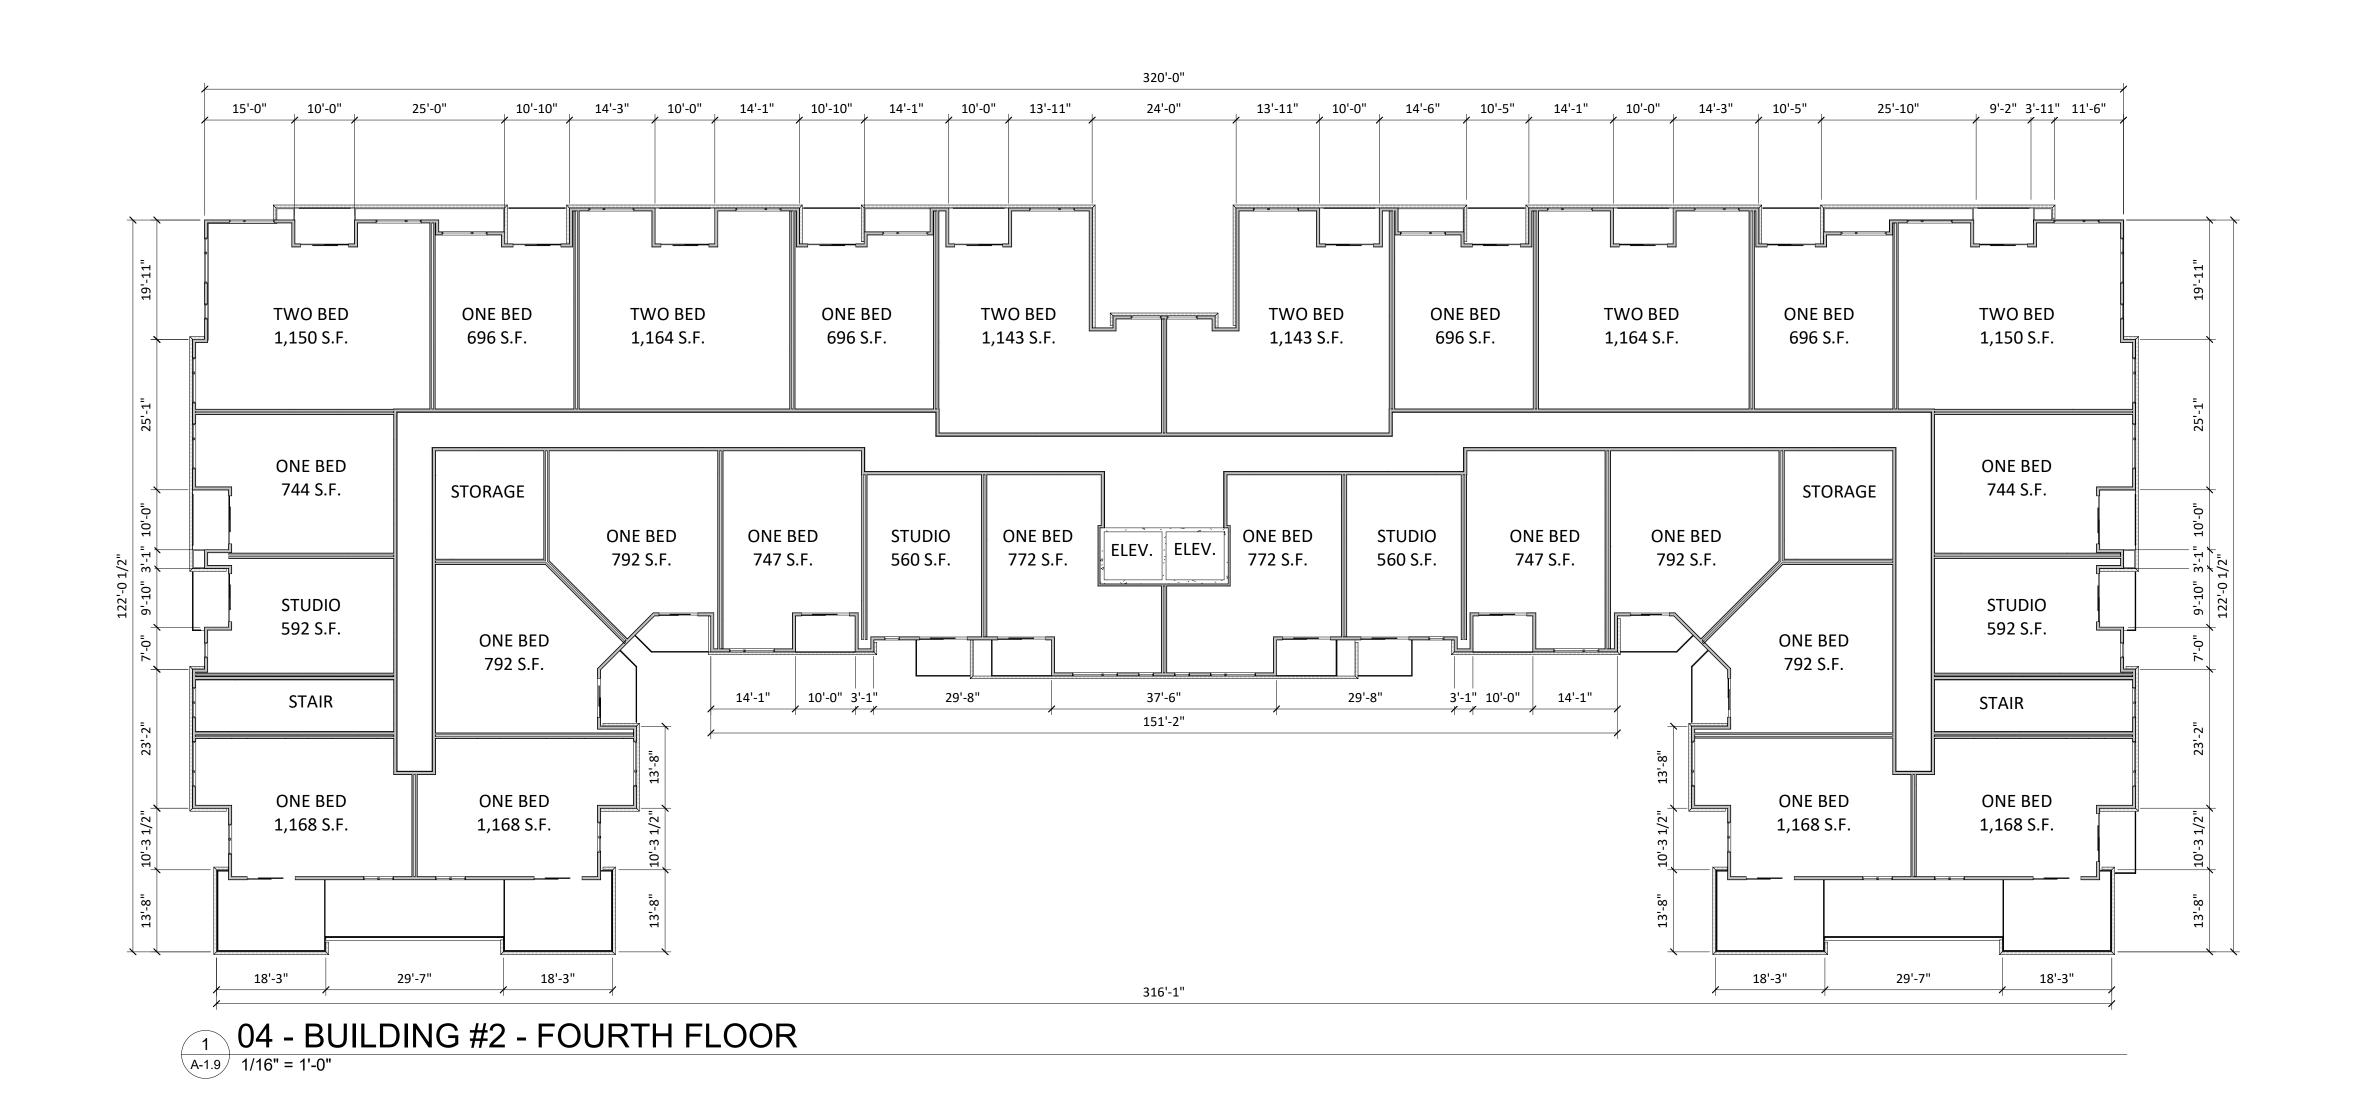

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FOURTH FLOOR
PLAN

SHEET NUMBER

A-1.9



BUILDING #1 - NORTH ELEVATION A-2.1 1/16" = 1'-0"



BUILDING #1 - SOUTH ELEVATION





BUILDING #1 - EAST ELEVATION A-2.1 1/16" = 1'-0"



4 BUILDING #1 - WEST ELEVATION
A-2.1 1/16" = 1'-0"



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ELEVATIONS

SHEET NUMBER

A-2.1

PROJECT NUMBER 2019

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5 BUILDING #1 - WEST ELEVATION INTERIOR
A-2.1 1/16" = 1'-0"



BUILDING #2 - NORTH ELEVATION 1/16" = 1'-0"



BUILDING #2 - SOUTH ELEVATION A-2.2 1/16" = 1'-0"



BUILDING #2 - EAST ELEVATION A-2.2 1/16" = 1'-0"



5 BUILDING #2 - WEST ELEVATION
A-2.2 1/16" = 1'-0"



BUILDING #2 - EAST ELEVATION INTERIOR A-2.2 1/16" = 1'-0"



BUILDING #2 - WEST ELEVATION INTERIOR

1/16" = 1'-0"



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ELEVATIONS

SHEET NUMBER

A-2.2



1 COLORED - BUILDING #1 - NORTH ELEVATION




COLORED - BUILDING #1 - SOUTH ELEVATION

A-2.3 1/16" = 1'-0"



3 COLORED - BUILDING #1 - EAST ELEVATION 1/16" = 1'-0"

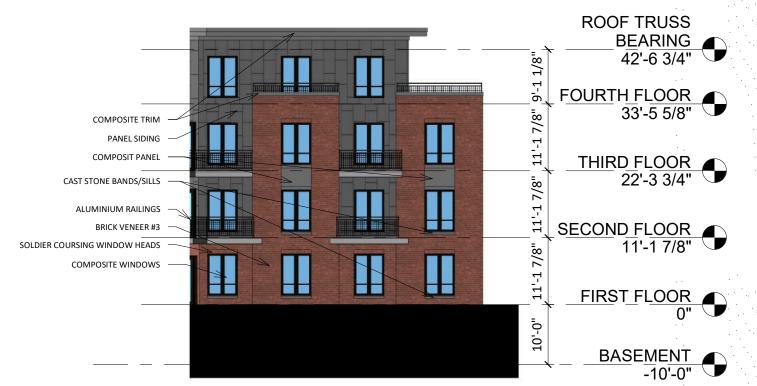

5 COLORED - BUILDING #1 - WEST ELEVATION INTERIOR



4 COLORED - BUILDING #1 - WEST ELEVATION
1/16" = 1'-0"



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EXTERIOR ELEVATIONS

SHEET NUMBER

A-2.3



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SHEET TITLE **EXTERIOR ELEVATIONS**

SHEET NUMBER

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COLORED - BUILDING #2 - NORTH ELEVATION

A-2.4 1/16" = 1'-0"



A-2.4 1/16" = 1'-0"

COLORED - BUILDING #2 - SOUTH ELEVATION

A-2.4 1/16" = 1'-0"

A-2.4 1/16" = 1'-0"



COLORED - BUILDING #2 - EAST ELEVATION A-2.4 1/16" = 1'-0"



COLORED - BUILDING #2 - EAST ELEVATION INTERIOR

A-2.4 1/16" = 1'-0"



