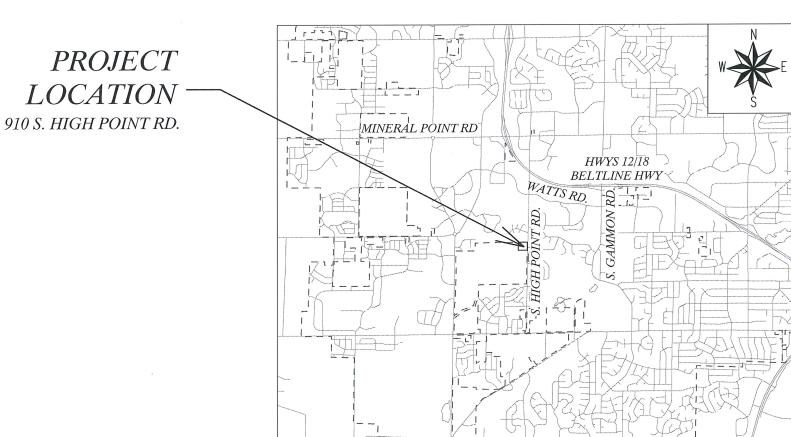


# MADISON WATER UTILITY UNIT WELL 26 BOOSTER PUMP #1 UPGRADE NOVEMBER 18, 2019

#### INDEX OF SHEETS


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SHEET NO.	W-4	EXISTING PIPING SECTION
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#### **GENERAL NOTES**

- (MWU) APPROVAL.
- W-5 FOR ADDITIONAL NOTES.
- CONTRACTOR.

- WORK.



1. UNLESS OTHERWISE SPECIFIED, ALL CONSTRUCTION SHALL CONFORM TO CITY OF MADISON STANDARD SPECIFICATIONS FOR PUBLIC WORKS CONSTRUCTION 2019 EDITION. SEE HTTPS://WWW.CITYOFMADISON.COM/BUSINESS/PW/SPECS.CFM 2. PIPE MATERIAL SHALL BE CLASS 52 DUCTILE IRON PIPE. 3. SEE SEQUENCE OF DEMOLITION AND CONSTRUCTION ON SHEET W-5. WELL 26 SHALL NOT BE OFFLINE (DOWN) FOR MORE THAN SIX HOURS WITHOUT MADISON WATER UTILITY

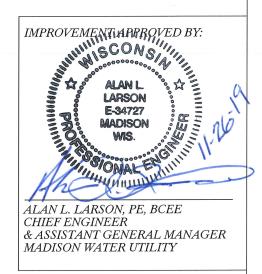4. REMOVAL OF THE OLD PUMP AND INSTALLATION OF A NEW PUMP IS PART OF THIS CONTRACT. THE PUMP AND ELECTRICAL WIRING IS PROVIDED BY MWU. SEE SUGGESTED SEQUENCE OF DEMOLITION AND CONSTRUCTION ON SHEET

5. ALL REQUIRED PERMITS ARE THE RESPONSIBILITY OF THE

6. CONTRACTOR IS REQUIRED TO MAINTAIN A SAFE WORKSPACE THROUGHOUT THE PROJECT. 7. WORK SHALL COMMENCE NO MORE THAN 30 DAYS AFTER EXECUTION OF THE STANDARD CITY OF MADISON PURCHASE ORDER AND NOTICE OF PUMP DELIVERY TO MWU. 8. PROJECT DURATION IS 30 CALENDAR DAYS FROM START OF

NUMBER	SIZE	TYPE	DISPOSITION	NORMAL POSITION	FUNCTION	NOTES
V-1	12"	BUTTERFLY	EXISTING	OPEN	DEEP WELL ISOLATION	
V-2	12"	BUTTERFLY	REPLACE	OPEN	RESERVOIR BYPASS	REPLACE WITH 12" FLANGED BUTTERFLY VALVE
V-3	12"	BUTTERFLY	EXISTING	OPEN	RESERVOIR ISOLATION	
V-4	24"	BUTTERFLY	EXISTING	OPEN	RESERVOIR ISOLATION	
V-5	24"	BUTTERFLY	EXISTING	OPEN	SYSTEM ISOLATION	
V-6	10"	GATE	REPLACE	OPEN	PUMP ISOLATION	REPLACE WITH 10" FLANGED GATE VALVE
V-7	8"	BUTTERFLY	REMOVE	OPEN	PUMP ISOLATION	
V-8	14"	GATE	EXISTING	OPEN	PUMP ISOLATION	
V-9	10"	BUTTERFLY	EXISTING	OPEN	PUMP ISOLATION	
V-10	12"	BUTTERFLY	NEW	OPEN	PUMP ISOLATION	
V-11	12"	BUTTERFLY	EXISTING	OPEN	SYSTEM ISOLATION	
V-12	12"	BUTTERFLY	NEW	OPEN	RESERVOIR ISOLATION/PUMP SUCTION	
CV-1	12"	CHECK VALVE	EXISTING	-	BACKFLOW AT DEEP WELL PUMP	
CV-2	8"	CHECK VALVE	REPLACE	-	PREVENT BACKFLOW AT BOOSTER PUMP #1	REPLACE WITH 6" CHECK VALVE
CV-3	10"	CHECK VALVE	EXISTING	-	PREVENT BACKFLOW AT BOOSTER PUMP #2	
M-1	12"	METER	EXISTING	-	METERS DEEP WELL PUMP DISCHARGE	
M-2	12"	METER	EXSITING	-	METERS FLOW TO ELEVATED RESERVOIR	

#### GENERAL NOTES

 CHECK VALVES SHALL BE A FLANGED SWING CHECK VALVE WITH OUTSIDE LEVER AND WEIGHT EQUIPPED WITH AN AIR-CUSHION CHAMBER TO CUSHION THE CLOSING OF THE VALVE DISC. THE VALVE SHALL BE MANUFACTURED IN ACCORDANCE WITH AWWA C508. CHECK VALVES SHALL BE MANUFACTURED BY GA INDUSTRIES OR APPROVED EQUIVALENT.

 BUTTERFLY VALVES SHALL BE AWWA C504, FLANGED SHORT BODY, CLASS 150B, EQUIPPED WITH STAINLESS STEEL SHAFT, TOP-MOUNTED HANDWHEEL OPERATORS AND CAST IRON VALVE DISK, BUTTERFLY VALVES SHALL BE MANUFACTURED BY BY KENNEDY OR MUELLER.

3. GATE VALVES SHALL BE RESILIENT WEDGE DESIGN PER AWWA C504, FLANGED AND EQUIPPED WITH HANDWHEEL OPERATOR. GATE VALVES SHALL BE MANUFACTURED BY KENNEDY, MUELLER OR CLOW.

#### MADISON WATER UTILITY UNIT WELL 26 BOOSTER PUMP #1 UPGRADE 12661

# APURTENANCE SCHEDULE

INSPECTOR: MWU	DRAWN BY: D.A.R.
CHECKED BY: A.L.L.	DATE: 11/26/2019

2'-10" UPPER TRENCH 4'-10"  $\Sigma$ 7'-4" 5'-I" 3'-8" 7'-2" — 2'-6" 4'-3" 3'-10" { 3 } LOWER TRENCH - 13'-10" 4'-3" 2 6'-0" ELECTRICAL 3'-2" 2'-11" 1'-9" CABINETS 1 1 (4) |'-8" 🗕 4'-0" 10'-1" 5 6'-2" 3'-2" 7'-0" -LOWER TRENCH 13'-6" M CHEMICAL ROOM TRENCH ===== ===1 ACCESS

FLOOR


PLAN 3/16"=1'

PLOT

ΓΥ

		SHEET NO. W-2/9
EXISTING F	N	
INSPECTOR: MWU DRAWN BY: D.A.		र.
CHECKED BY: A.L.L. DATE: 11/26/2019		

KEYED NOTES I. CONCRETE BASE FOR BOOSTER PUMP #I, 2'-5" HEIGHT ABOVE FLOOR 2. CONCRETE BASE FOR BOOSTER PUMP #2, 2'-2" HEIGHT ABOVE CONCRETE BASE FOR DEEP WELL PUMP, I'-0"± HEIGHT ABOVE FLOOR 4. ELECTRICAL CABINET 7'-8" HEIGHT ABOVE FLOOR 5. ELECTRICAL CABINET, 6'-2" HEIGHT ABOVE FLOOR

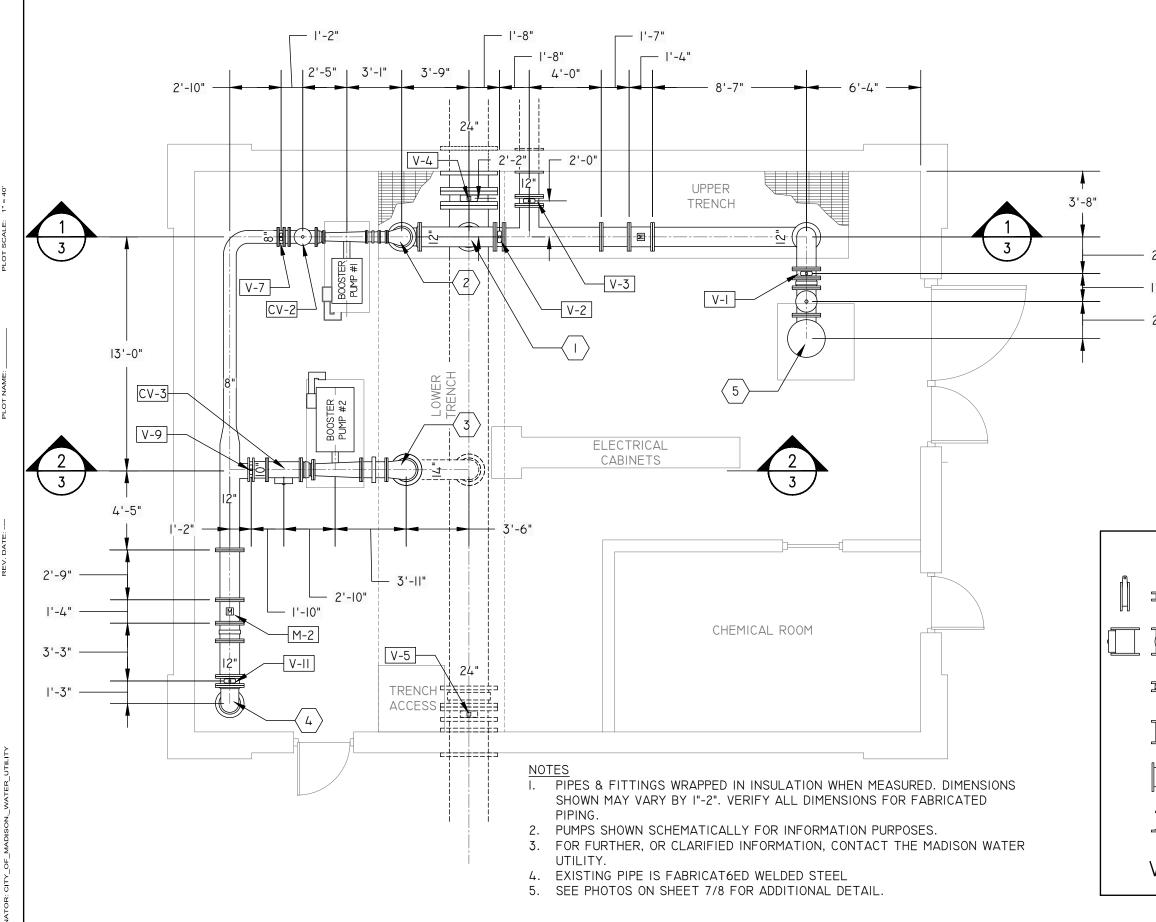


		MADISON WATER UNIT WELL 26 BOOSTER PUN 12661	•••••	SHEET NO. W-3/9
		EXISTING P	IPING PLA	N
		INSPECTOR: MWU	DRAWN BY: D.A.F	२.
		CHECKED BY: A.L.L.	DATE: 11/26/2019	1
KEY	ED NO	TES		
١.	12-IN >	K 12-IN VERTICAL TEE (BRA	NCH DOWN)	
2.	6-IN X DOWN	( 10-IN FLANGED 90° REDUC )	ING BEND (VERT	ICAL
3.	IO-IN ) DOWN	( 14-IN FLANGED 90° REDU( )	CING BEND (VER	TICAL


- 2'-0" 4. I2-IN X I2-IN VERTICAL BEND
- I'-7" 5. DEEP WELL PUMP
- 2'-1"



### LEGEND

- E BUTTERFLY VALVE
- · CHECK VALVE
- EXPANSION JOINT, FLEXIBLE COUPLING
- METER
- FLANGED PIPE SECTION, PIPE DIAMETER
- REDUCER
- V-4 VALVE NUMBER, REFER TO SEQUENCE OF DEMOLITION AND CONSTRUCTION, SHEET W-4

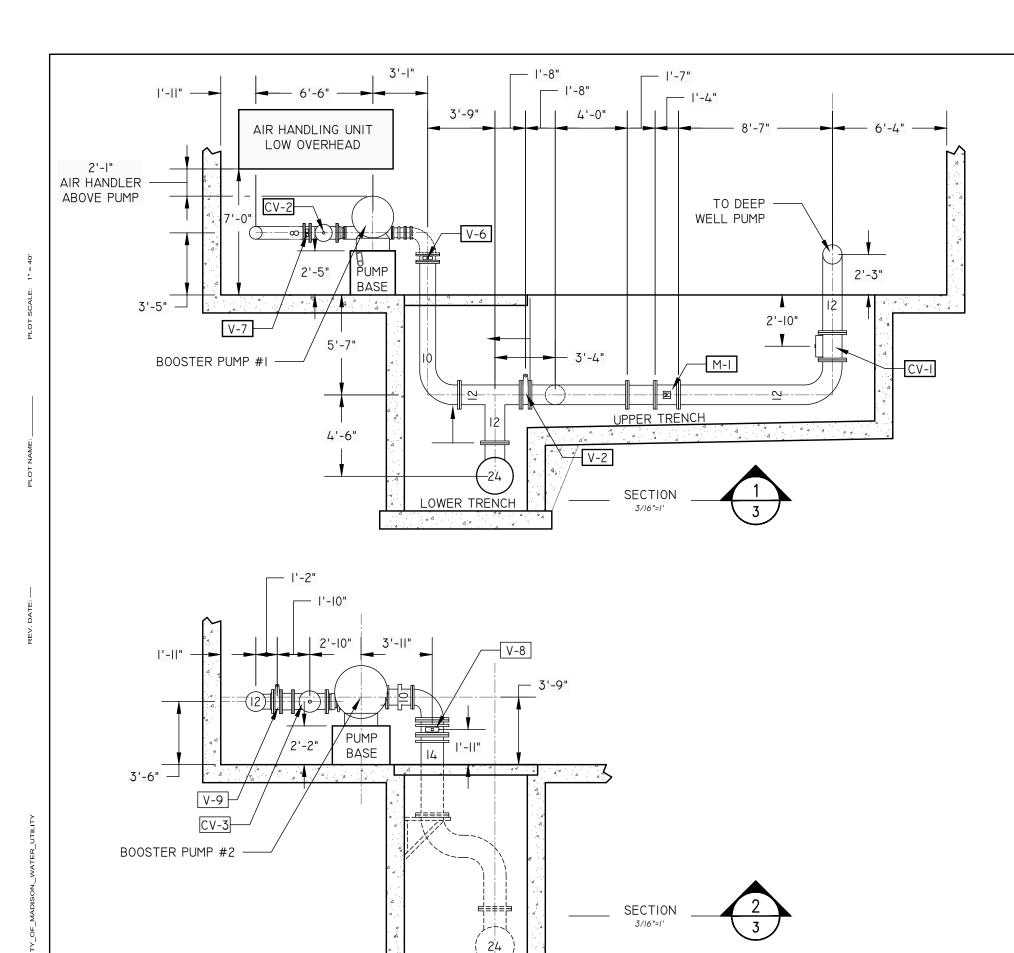

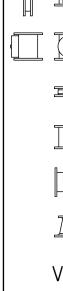

MADISON WATER UTILITY
UNIT WELL 26 BOOSTER PUMP #1 UPGRADE
12661

SHEET NO. W-4/9


# EXISTING PIPING SECTION

INSPECTOR: MWU	DRAWN BY: D.A.R.
CHECKED BY: A.L.L.	DATE: 11/26/2019



# LEGEND


- DEDIC BUTTERFLY VALVE
- CHECK VALVE
- EXPANSION JOINT, FLEXIBLE COUPLING
- METER
- FLANGED PIPE SECTION, PIPE DIAMETER
- REDUCER
- V-4 VALVE NUMBER, REFER TO SEQUENCE OF DEMOLITION AND CONSTRUCTION, SHEET W-4

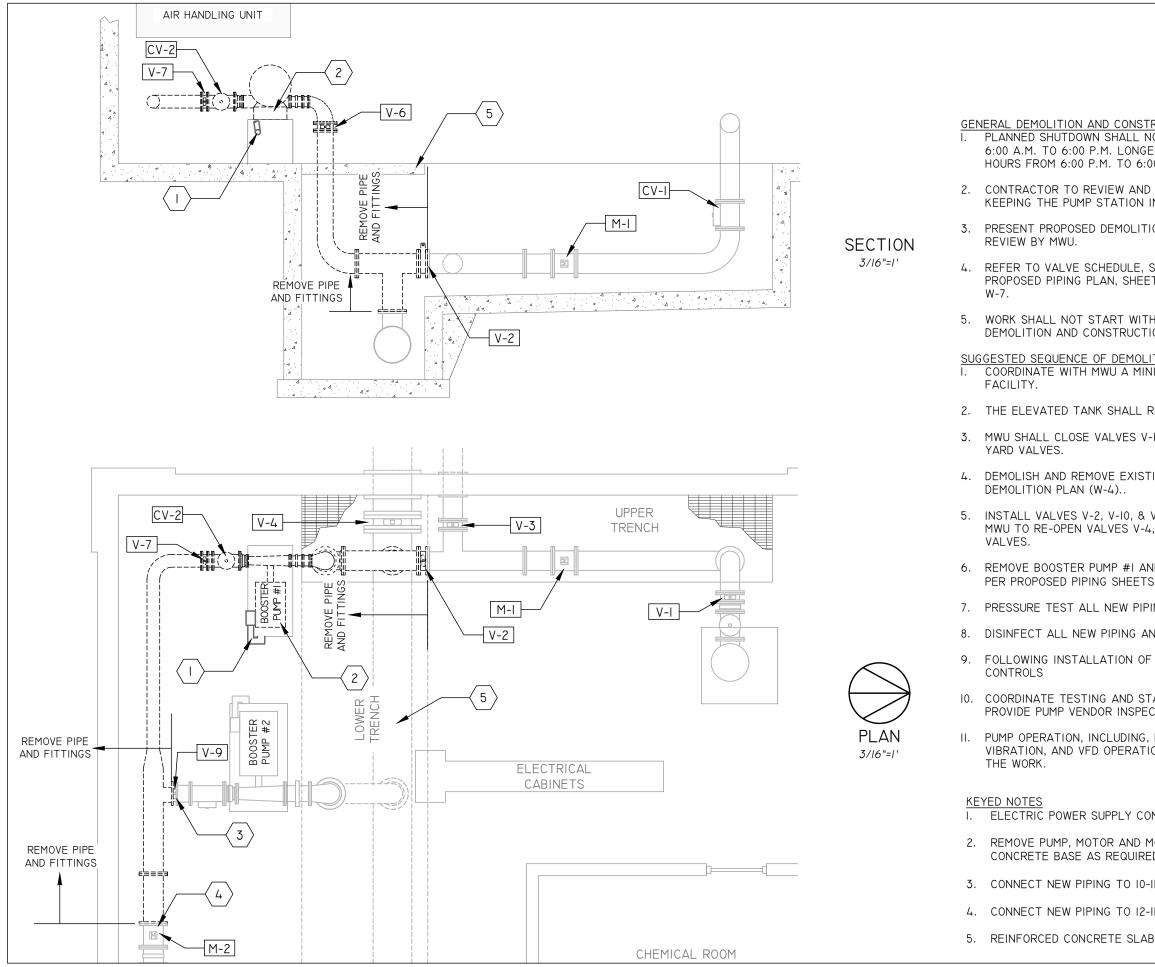

MADISON WATER UTILITY
UNIT WELL 26 BOOSTER PUMP #1 UPGRADE
12661

	DEMOLITION & SE	EQUENCING PLAN
	INSPECTOR: MWU	DRAWN BY: D.A.R.
	CHECKED BY: A.L.L.	DATE: 11/26/2019
	S DURING THE HOURS IAY BE POSSIBLE DURING NATE WITH MWU.	
PLAN WORK TO	ENSURE WORKER SAFET	′ WHILE
ION PLAN AND CC	NSTRUCTION SEQUENCE	FOR
	ING FLOOR PLAN, SHEET OSED PIPING SECTION, SH	
HOUT AN AGREED ION.	UPON SEQUENCE OF	
ITION AND CONST NIMUM OF 48 HOU	RUCTION RS PRIOR TO SHUT DOWN	I THE
REMAIN IN SERVIC	CE AT ALL TIMES.	
-I, V-3, V-4, V-5 8	V-II AND ANY APPROPRI	ATE
FING SUCTION ANI	D DISCHARGE PIPING PER	
	S TO REMAIN CLOSED. NO ANY APPROPRIATE YARD	)TIFY
ND INSTALL NEW S (W-6 & W-7).	PUMP AND REMAINING PI	PING
ING AND NEW PU	MP.	
ND PUMP.		
F THE PUMP, MWU	WILL INSTALL WIRING A	ND
	UMP WITH MWU. MWU WI STALLATION PRIOR TO S	
	D TO, PUMPING CAPACITY FED PRIOR TO ACCEPTAN	
NDUIT TO REMAII	Ν.	
	ETS. MODIFY AND/OR RE	CONSTRUCT
	PROVIDE SPACERS AS N	IECESSARY.
IN METER (M-2).		


5. REINFORCED CONCRETE SLAB OVER LOWER TRENCH, EXCEPT IN GRATE AREA.

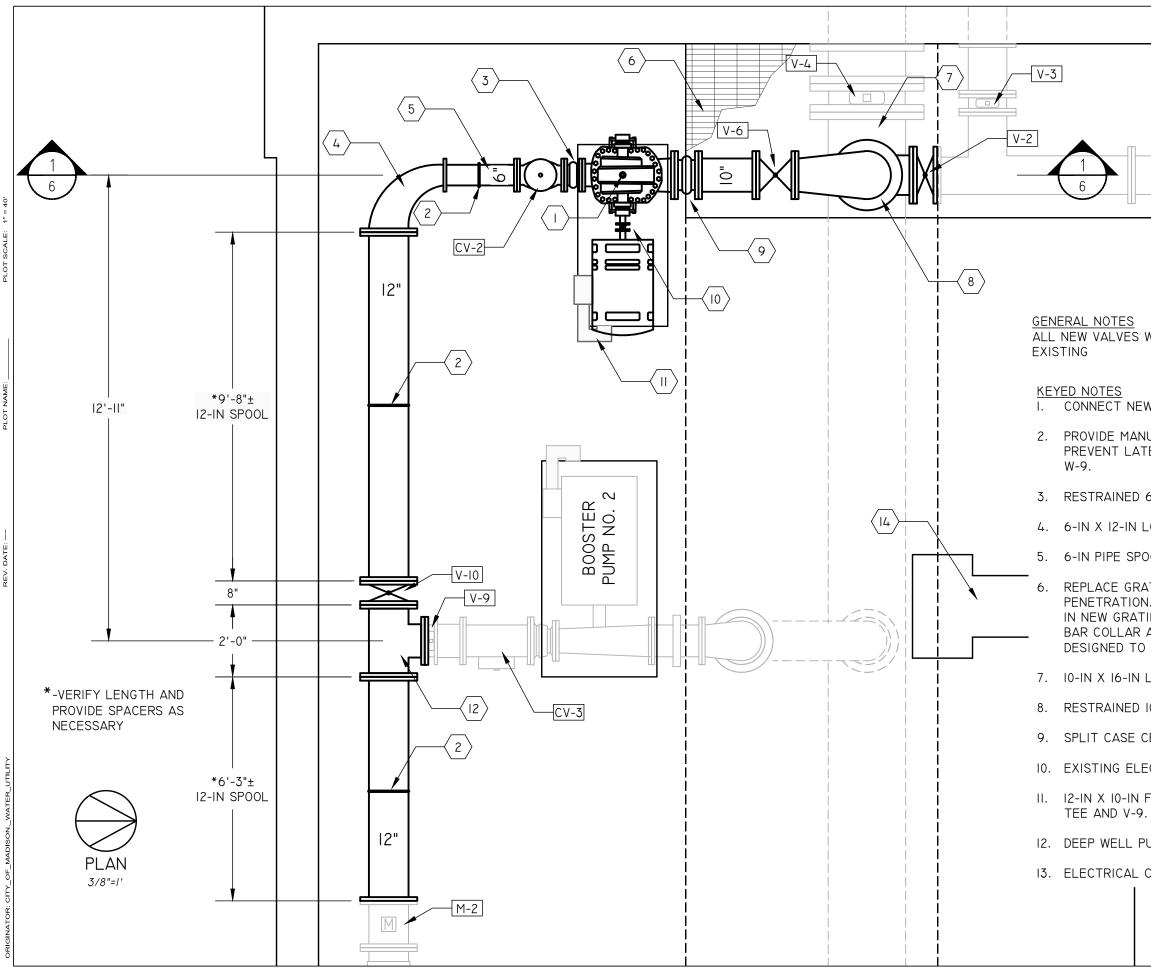


FILE NAME: F:\Wucommon\Civil3DProjects\Unit Well 26\CAD\Water\UW26 Floor Plan\_ArchUnits.dwg


DATE: 11/26/2019 9:59 AM

	MADISON WATER UTILITY UNIT WELL 26 BOOSTER PUMP #1 UPGRADE 12661	SHEET NO. W-6/9
	PROPOSED PIPING PL	AN
	INSPECTOR: MWU DRAWN BY: D.A	R.
	CHECKED BY: A.L.L. DATE: 11/26/201	9
	M-I	(
WILL HAVE WHEE	LED OPERATORS TO MATCH	
W PUMP TO EXIST	ING PUMP PRIMING SYSTEM.	
	SUPPORT SYSTEM AS REQUIRED TO CAL MOVEMENT. SEE DETAIL 9-1, S	
6-IN EXPANSION	JOINT	
LONG RADIUS FLA	NGED 90° REDUCING BEND	
DOL		
N. MATCH EXISTIN ING TO ACCOMMO AROUND OPENING	O ELIMINATE OLD SUCTION PIPE NG GRATING AND VERIFY SIZE. CUT DDATE NEW SUCTION PIPE. WELDED REQUIRED. GRATING SECTIONS SH SEE DETAIL 9-2, SHEET W-9.	STEEL
LONG RADIUS FLA	ANGED 90° REDUCING BEND	
IO-IN EXPANSION	JOINT	
CENTRIFUGAL PUN	1P & MOTOR, PROVIDED BY MWU	
ECTRICAL POWER	SUPPLY CONDUIT TO BE REUSED.	
FLANGED TEE. PF	ROVIDE SPACERS AS NECESSARY BE	ETWEEN
PUMP		
CABINET		

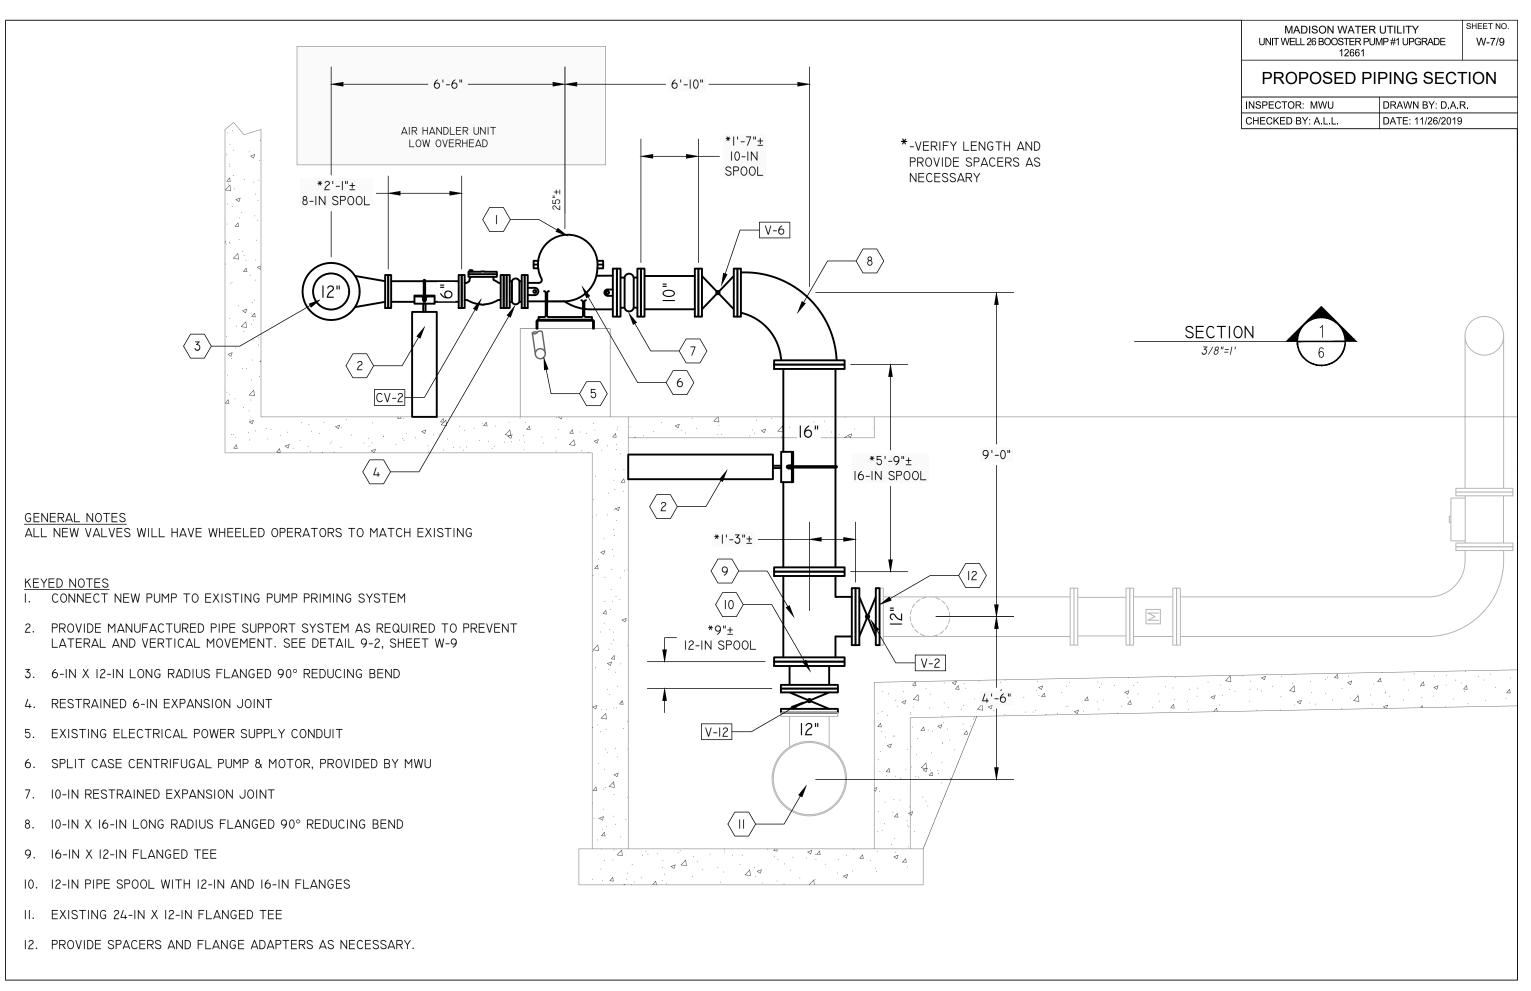

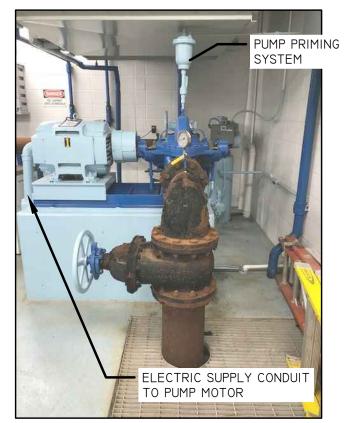

BOOSTER PUMP #I SIDE VIEW

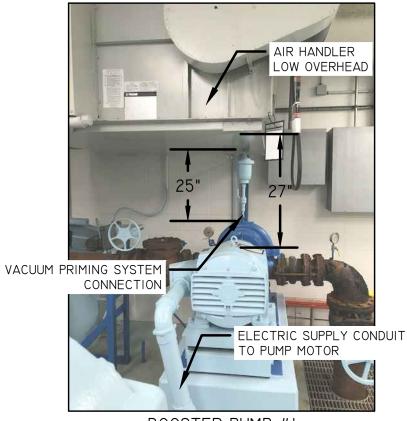


BOOSTER PUMP #I END VIEW OF MOTOR & PUMP



BOOSTER PUMP #I SUCTION PIPE



BOOSTER PUMP #I DISCHARGE PIPE

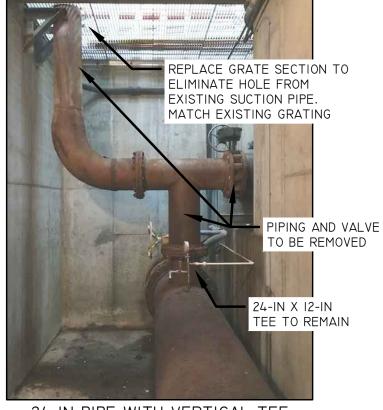

24-IN PIPE WITH VERTICAL TEE



PIPE OPENING THROUGH GRATING

#### MADISON WATER UTILITY UNIT WELL 26 BOOSTER PUMP #1 UPGRADE 12661

SHEET NO. W-8/9


#### PHOTOS


INSPECTOR: MWU CHECKED BY: A.L.L.

DRAWN BY: D.A.R. DATE: 11/26/2019



ELECTRIC SUPPLY CONDUIT

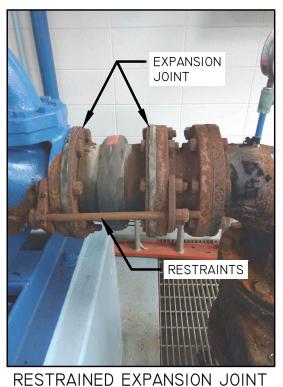

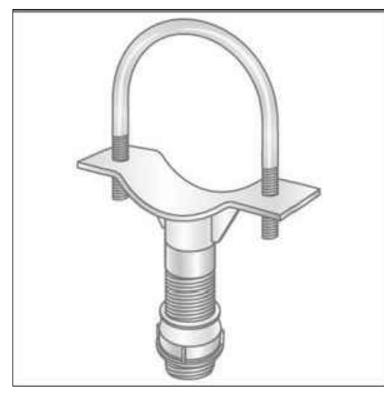

DETAIL 9-1: TYPICAL MANUFACTURED PIPE SUPPORT COMPONENT MANUFACTURED PIPE SUPPORT SYSTEM REQUIRED TO PREVENT LATERAL AND VERTICAL PIPE MOVEMENT (AS APPROPRIATE). SUBMIT SHOP DRAWINGS OF PIPE SUPPORT SYSTEMS TO MWU FOR REVIEW AND APPROVAL PRIOR TO INSTALLATION.



DETAIL 9-2: EXISTING STEEL GRATING I-I/2" X  $\frac{3}{16}$ " STEEL BEARING BAR @ I-I/4" SPACING WITH SWAGE LOCKED CROSS BARS @ 4" SPACING AND I-I/2 X <sup>3</sup>/<sub>16</sub>" STEEL BAR BANDING. PANEL SIZE 24" X 59". EQUIVALENT GRATING REQUIRED WHERE GRATING IS TO BE REPLACED. GRATING SHALL BE REMOVABLE. PIPE OPENINGS SHALL USE I-1/2" X 16" STEEL BAR FOR COLLAR OR BANDING. VERIFY ALL DIMENSIONS AND SPECIFICATIONS OF EXISTING GRATING.





ELECTRICAL CABINET TOWARD DEEP WELL (OBSCURED)



### ELECTRICAL CABINET FROM ACCESS DOOR.



MADISON WATER UTILITY UNIT WELL 26 BOOSTER PUMP #1 UPGRADE 12661 SHEET NO. W-9/9

### **PHOTOS & DETAILS**

INSPECTOR: MWU CHECKED BY: A.L.L. DRAWN BY: D.A.R. DATE: 11/26/2019

# ELEVATED RESERVOIR SUPPLY PIPE DOWNSTREAM OF BOOSTER PUMP #2 DISCHARGE PIPE



ELECTRICAL CABINET