URBAN DESIGN COMMISSION APPLICATION



City of Madison **Planning Division** Madison Municipal Building, Suite 017 215 Martin Luther King, Jr. Blvd. P.O. Box 2985



FOR OFFICE USE ONLY: Paid Receipt # Date received Received by _____ Aldermanic District Zoning District Urban Design District ____ Submittal reviewed by April 1, 2020 Legistar # ____

City/State/Zip _____

Madison, WI 53701-2985 (608) 266-4635 Complete all sections of this application, including the desired meeting date and the action requested. If you need an interpreter, translator, materials in alternate formats or other accommodations to access these forms, please call the phone number above immediately. 1. Project Information Address: _____ 2. Application Type (check all that apply) and Requested Date UDC meeting date requested _____ Alteration to an existing or previously-approved development New development Informational Final approval Initial approval 3. Project Type Project in an Urban Design District Signage Project in the Downtown Core District (DC), Urban Comprehensive Design Review (CDR) Mixed-Use District (UMX), or Mixed-Use Center District (MXC) Signage Variance (i.e. modification of signage height, Project in the Suburban Employment Center District (SEC), area, and setback) Campus Institutional District (CI), or Employment Campus Signage Exception District (EC) Planned Development (PD) Other General Development Plan (GDP) Please specify Specific Implementation Plan (SIP) Planned Multi-Use Site or Residential Building Complex 4. Applicant, Agent, and Property Owner Information Company _____ Applicant name City/State/Zip _____ Street address Telephone Project contact person _____ Company _____ Street address City/State/Zip _____ Telephone Property owner (if not applicant)

Email

Street address

Telephone

Each submittal must include

fourteen (14) 11" x 17" collated

paper copies. Landscape and

Lighting plans (if required)

must be full-sized and legible.

Please refrain from using

plastic covers or spiral binding.

5. Required Submittal Materials

Application Form

Letter of Intent

- If the project is within an Urban Design District, a summary of how the development proposal addresses the district criteria is required
- For signage applications, a summary of how the proposed signage is consistent with the applicable CDR or Signage Variance review criteria is required.

Development Plans (Refer to checklist on Page 4 for plan details)

Filing fee

Electronic Submittal*

Notification to the District Alder

Please provide an email to the District Alder notifying them that you are filing this UDC application. Please send this as early in the process as possible and provide a copy of that email with the submitted application.

Both the paper copies and electronic copies must be submitted prior to the application deadline before an application will be scheduled for a UDC meeting. Late materials will not be accepted. A completed application form is required for each UDC appearance.

For projects also requiring Plan Commission approval, applicants must also have submitted an accepted application for Plan Commission. consideration prior to obtaining any formal action (initial or final approval) from the UDC. All plans must be legible when reduced.

*Electronic copies of all items submitted in hard copy are required. Individual PDF files of each item submitted should be compiled on a CD or flash drive, or submitted via email to udcapplications@cityofmadison.com. The email must include the project address, project name, and applicant name. Electronic submittals via file hosting services (such as Dropbox.com) are not allowed. Applicants who are unable to provide the materials electronically should contact the Planning Division at (608) 266-4635 for assistance.

6. Ap	pplicant Declarations	
1.	Prior to submitting this application, the applicant is require Commission staff. This application was discussed with	
2.	The applicant attests that all required materials are included in thi is not provided by the application deadline, the application will consideration.	, ,
Name	e of applicant	Relationship to property
Autho	orizing signature of property owner	Date
7. Ap	oplication Filing Fees	

Fees are required to be paid with the first application for either initial or final approval of a project, unless the project is part of the combined application process involving the Urban Design Commission in conjunction with Plan Commission and/or Common Council consideration. Make checks payable to City Treasurer. Credit cards may be used for application fees of less than \$1,000.

Please consult the schedule below for the appropriate fee for your request:

Urban Design Districts: \$350 (per §35.24(6) MGO).

Minor Alteration in the Downtown Core District (DC) or Urban Mixed-Use District (UMX): \$150 (per §33.24(6)(b) MGO)

Comprehensive Design Review: \$500 (per §31.041(3)(d)(1)(a) MGO)

Minor Alteration to a Comprehensive Sign Plan: \$100 (per §31.041(3)(d)(1)(c) MGO)

All other sign requests to the Urban Design Commission, including, but not limited to: appeals from the decisions of the Zoning Administrator, requests for signage variances (i.e. modifications of signage height, area, and setback), and additional sign code approvals: \$300 (per §31.041(3)(d)(2) MGO)

A filing fee is not required for the following project applications if part of the combined application process involving both Urban Design Commission and Plan Commission:

- Project in the Downtown Core District (DC), Urban Mixed-Use District (UMX), or Mixed-Use Center District (MXC)
- Project in the Suburban Employment Center District (SEC), Campus Institutional District (CI), or **Employment Campus District (EC)**
- Planned Development (PD): General Development Plan (GDP) and/or Specific Implementation Plan (SIP)
- Planned Multi-Use Site or Residential Building Complex

URBAN DESIGN COMMISSION APPROVAL PROCESS



Introduction

The City of Madison's Urban Design Commission (UDC) has been created to:

- Encourage and promote high quality in the design of new buildings, developments, remodeling, and additions so as to maintain and improve the established standards of property values within the City.
- Foster civic pride in the beauty and nobler assets of the City, and in all other ways possible assure a functionally efficient and visually attractive City in the future.

Types of Approvals

There are three types of requests considered by the UDC:

- Informational Presentation. Applicants may, at their discretion, request to make an Informational Presentation to the
 UDC prior to seeking any approvals to obtain early feedback and direction before undertaking detailed design. Applicants
 should provide details on the context of the site, design concept, site and building plans, and other relevant information
 to help the UDC understand the proposal and provide feedback. (Does not apply to CDR's or Signage Variance requests)
- <u>Initial Approval</u>. Applicants may, at their discretion, request initial approval of a proposal by presenting preliminary design information. As part of their review, the Commission will provide feedback on the design information that should be addressed at Final Approval stage.
- <u>Final Approval</u>. Applicants may request Final Approval of a proposal by presenting all final project details. Recommendations or concerns expressed by the UDC in the initial approval must be addressed at this time.

Presentations to the Commission

Primarily, the UDC is interested in the appearance and design quality of projects. Emphasis should be given to the site plan, landscape plan, lighting plan, building elevations, exterior building materials, color scheme, and graphics.

When presenting projects to the UDC, applicants must fill out a registration slip provided in the meeting room and present it to the Secretary. Presentations should generally be limited to 5 minutes or as extended by motion by consent of the Commission. The Commission will withhold questions until the end of the presentation.

Applicants are encouraged to consider the use of various graphic presentation material including a locator map, photographs, renderings/model, scale drawings of the proposal in context with adjacent buildings/uses/signs, etc., as may be deemed appropriate to describe the project and its surroundings. Graphics should be mounted on rigid boards so that they may be easily displayed. Applicants/presenters are responsible for all presentation materials, AV equipment and easels.

URBAN DESIGN DEVELOPMENT PLANS CHECKLIST



The items listed below are minimal application requirements for the type of approval indicated. Please note that the UDC and/or staff may require additional information in order to have a complete understanding of the project.

1. Informa	tional Presentation						
	Locator Map)		Requirem	ents for All Plan Sheets		
	Letter of Intent (If the project is within			1. Title	block		
	an Urban Design District, a summary of			2. Shee	et number		
	<u>how</u> the development proposal addresses the district criteria is required)		Providing additional	3. Nort	:h arrow		
	Contextual site information, including		information beyond these	4. Scale	e, both written and graphic		
_	photographs and layout of adjacent		minimums may generate a greater level of feedback	5. Date			
	buildings/structures		from the Commission.		dimensioned plans, scaled		
	Site Plan				'= 40' or larger as must be legible, including		
	Two-dimensional (2D) images of			the full-siz	zed landscape and lighting		
	proposed buildings or structures.	J		plans (if re	quired)		
2. Initial A	pproval						
	Locator Map)			
	Letter of Intent (If the project is within a the development proposal addresses the			of <u>how</u>			
	Contextual site information, including ph structures	otog	raphs and layout of adjacent bu	uildings/	Providing additional information beyond these		
	Landscape Plan and Plant List (must be le	egible	e)		from the Commission.		
	Building Elevations in both black & whi material callouts)	te ar	nd color for all building sides	(include			
	PD text and Letter of Intent (if applicable	!)		J			
3. Final Ap	proval						
All the r	equirements of the Initial Approval (see al	oove), <u>plus</u> :				
	Grading Plan						
	Proposed Signage (if applicable)						
	Lighting Plan, including fixture cut sheet	s and	d photometrics plan (<i>must be le</i>	egible)			
	Utility/HVAC equipment location and scr	eeni	ng details (with a rooftop plan	if roof-mou	inted)		
	PD text and Letter of Intent (if applicable	;)					
	Samples of the exterior building materia	ls (pi	resented at the UDC meeting)				
4. Compre	hensive Design Review (CDR) and Varia	nce '	Requests (Sianage annlicatio	ons only)			
	Locator Map		negacoto (<u>orginage appinaan</u>	,,,,,,,,,,,,,,,,,,,,,,,,,,,,,,,,,,,,,,			
_	·	ooser	d signage is consistent with the CI	OR or Signage	e Variance criteria is required)		
_	Letter of Intent (a summary of <u>how</u> the proposed signage is consistent with the CDR or Signage Variance criteria is required Contextual site information, including photographs of existing signage both on site and within proximity to the						
_	project site		.g. ap. 10 2 2 2 2 2 2 2 2 2 2 2 2 2 2 2 2 2 2		р. с		
	Site Plan showing the location of existing driveways, and right-of-ways	ş sign	nage and proposed signage, din	nensioned s	signage setbacks, sidewalks,		
	Proposed signage graphics (fully dimens	ione	d, scaled drawings, including m	naterials and	d colors, and night view)		
	Perspective renderings (emphasis on pe	destr	rian/automobile scale viewshed	ds)			
	Illustration of the proposed signage that		•		g requested.		
	Graphic of the proposed signage as it relates to what the Ch. 31, MGO would permit						



May 18, 2020

Kevin Firchow Janine Glaeser Department of Planning & Development 215 Martin Luther King Jr Blvd Madison, WI 53703

Re: Letter of Intent

825 E. Washington Ave – Conditional Use

Dear Tim:

This is our Letter of Intent (Conditional Use) for the property located at 825 E. Washington Ave. The owner, MM East Washington, LLC is planning to develop a new eight-story, 151 guestroom hotel at this location. The development shall include the demolition of the existing structures located at 825 East Washington Avenue & 824 East Main Street.

The hotel is designed to integrate into the East Washington Capitol Gateway Corridor and address the four Urban Design District No. 8 core development principles:

- 1. To protect the iconic view of the Capitol.
 - a. The structure is set back from the street with heights and step backs well inside of density limits.
- 2. To respect and strengthen existing neighborhoods.
 - a. The hotel and restaurant will enhance the fabric of the neighborhood.
- 3. To establish a transit-oriented employment corridor
 - a. This project compliments and supports that vision.
- 4. To create a vibrant boulevard corridor to Madison's Downtown and is a critical street for the vitality of adjoining neighborhoods.
 - a. This mixed-use development will add character, energetic vibe and provide patrons to the neighborhood business.

Urban Design District No. 8 Design Criteria

(Site is located in 12a and 12b as shown in Map of District)

- 1. Building Height
 - a. 12a (E. Wash) 12 levels maximum. 8 levels proposed
 - b. 12b (E. Main) 8 levels maximum. 8 levels proposed
- 2. Building Setback
 - a. 12a (E. Wash) 15' maximum. 15' proposed to building footprint. (canopy encroaches 16")
 - b. 12b (E. Main) 15' maximum. 15' proposed to GTTS
- 3. Building Stepback
 - a. 12a (E. Wash) 15' maximum. 15' proposed (53'-5" aff)
 - b. 12b (E. Main) N/A
- 4. Parking and Service Areas
 - a. Pedestrian access Primary Entrance at E. Wash with secondary near drop off.
 - b. Vehicle access Primary Entrance off E. Wash with secondary from E. Main.
 - c. Vehicle Parking 0 stalls required 6 stalls provided on site (remainder off site)
 - d. Bicycle Parking 26 stalls required 26 stalls provided (2'x6' with 5' access aisle)
 - e. Deliveries Enter site from E. Wash and use 10'x35' loading zone.
 - f. Refuse Free standing structure with generator located above it. (See A4.03)

- 5. Landscaping
 - a. E. Wash setback area contains activated hardscape patio. Existing Terrace tree to remain.
 - b. E. Main setback areas contain dense planting with detailed design.
- 6. Site Lighting and Furnishings
 - a. Site Lighting All fixtures are located on building and providing intentional low level, dimmed illumination. Existing lighting from adjacent buildings and streetlighting will assist to make the site properly lit and secure.
 - b. Furnishings Designed to complement the character of the hotel.
- 7. Building Massing and Articulation
 - a. Custom Moxy Hotel project designed specifically for this site with no corporate design elements.
 - b. Massing is broken into three forms
 - i. Front Six story form with dark columns, large industrial divided light windows that speaks to the history of E. Wash.
 - ii. Field The long "middle" of the building has project vertical EIFS forms with variated width negative space.
 - iii. Top Recessed black form with significant transparency that provides a subtle beacon effect.
- 8. Material and Colors
 - a. Simple, timeless palate of black (metal panel and window frames), concrete, clear glazing and EIFS (Corten finish)
- 9. Windows and Entrances
 - a. Primary pedestrian entrance is easily identifiable below canopy and signage.
 - b. Twenty-foot tall transparent glazing wrap around the E. Wash entrance providing long sightlines into the two story bar and lounge.
 - c. E. Main entrances (hotel and restaurant/meeting) are convienantly located at the drop off with a simple walking pattern to the adjacent parking structure that is partially under cover.
- 10. Signage Will be submitted separately.
- 11. Restoration/Preservation Activities Will be looking to salvage a number items from the existing buildings to integrate into the interior of the hotel.
- 12. Upper Level Development Standards no bonus stories are being requested.

Hotel Design highlights:

- Fun new hotel Moxy by Marriott that provides lively public spaces and minimalist style and cozy guest rooms that will reflect the spirit of the Capitol East Neighborhood.
- Roof top restaurant and lounge that will allow every guest and Madison residents to experience the best views of the neighborhood, Madison lakes and Isthmus
- Urban Architecture that embraces the history of the neighborhood
- Roof top meeting and event space open to public use
- First floor bar, lounge, and restaurant

The total gross area of the new building is 80,977 sf. The lot area is 21,865 sf (or 0.5 acres).

Total Parking/Bicycle Stalls will be as follows:

Parcel 2 (Hotel)

Small Car Parking: 0 Large Car Parking: 5 Accessible Parking: 1 Bicycle Stall: 28

Total Vehicle Parking: 6

All maintenance, including trash and snow removal, will be provided by private contract.

The proposed hours of operation will be as follows:

- Hotel: 24 hours a day/365 days a year.
 - \circ This includes the exterior patio space, attached to two guest rooms, facing East Washington Avenue, located on the 6^{th} floor.
- Hotel Bar/Cafe and 8th Floor Restaurant: Sunday-Thursday (6:00 a.m. 12:00 a.m.) & Friday/Saturday (6:00 a.m. 2:00 a.m.)
 - o This includes the exterior front patio, facing East Washington Avenue, located on the 1st floor

The project is anticipated to create approximately 30 new jobs during development/construction and approximately an additional 50 positions, during operation.

The proposed construction schedule is for demolition of the existing structures to commence in the fourth quarter of 2020 with new construction to commence immediately thereafter, and construction completion to be early 2022. This application includes a request for a demolition permit to demolish the properties located at 825 E. Washington Ave. & 824 E. Main St.

The Development Team includes the following:

Developer/Owner: MM East Washington, LLC

c/o North Central Group

1600 Aspen Commons, Suite 200

Middleton, WI 53562 Phone: 608-836-6060 Fax: 608-836-6399

Principal Contact: Andy Inman

ainman@ncghotels.com

Architect: GBA

2248 Deming Way Middleton, WI 53562 Phone: 608-829-1750 Fax: 608-829-3056

Principal Contact: Josh Wilcox josh.wilcox@garybrink.com

Civil/Landscape: Pinnacle Engineering Group

20725 Watertown Road, Suite 100

Brookfield, WI 53186 Phone: 262-754-8888

Principal Contact: Aaron Koch aekoch@pinnacle-engr.com

Please refer to the attached plans for additional information.

Sincerely,

Josh Wilcox VP/Partner

PROPOSED



825 East Washington Avenue Madison, Wisconsin

UDC/Planning Commission Submittal May 18, 2020



SHEET INDEX:

TITLE SHEET ARCHITECTURAL DRAWINGS (CONTINUED) **EXISTING SITE CONTEXT PHOTOS** A2.06 6TH FLOOR PLAN 7TH FLOOR PLAN **CIVIL DRAWINGS** 8TH FLOOR PLAN **ROOF PLAN EXISTING CONDITIONS & SITE DEMO PLAN** SITE PLAN ENLARGED OUTDOOR SEATING PLAN GRADING & PAVING PLAN ENLARGED PATIO PLAN UTILITY PLAN A4.03 GTTS SITE DETAILS **BUILDING ELEVATIONS** SITE DETAILS **BUILDING ELEVATIONS**

BUILDING ELEVATIONS

BUILDING RENDERINGS

BUILDING SECTION

A7.02 BUILDING SECTION

CONCEPTUAL MURAL WALL

LANDSCAPE DRAWINGS LANDSCAPE PLAN

LANDSCAPE NOTES & DETAILS

FIRE ACCESS PLAN

ARCHITECTURAL DRAWINGS **ELECTRICAL PHOTOMETRIC DRAWINGS** A2.01 1ST FLOOR PLAN PHOTOMETRIC SITE PLAN 2ND FLOOR PLAN PHOTOMETRIC FLOOR PLANS 3RD-5TH FLOOR PLAN LIGHT FIXTURE CUT SHEETS LIGHT FIXTURE CUT SHEETS

Moxy Hotel - Madison Wisconsin									
	1st Floor	2nd Floor	3rd Floor	4th Floor	5th Floor	6th Floor	7th Floor	8th Floor	Totals
Square Flootage By Use (per Floor)									
Hotel	5,555 sf	9,633 sf	11,566 sf	11,566 sf	11,566 sf	10,897 sf	10,897 sf	7,481 sf	79,161 sf
Office			179			N=0		-	0 st
Parking		-	-	-	-	,	•	25 26	0 sf
Mech / Storage	a a	1,332 sf	8 = 8		:=	B L R	===	909 sf	2,241 sf
Totals	5,555 sf	10,965 sf	11,566 sf	11,566 sf	11,566 sf	10,897 sf	10,897 sf	8,390 sf	81,402 sf
				Parking Space	ces (per Floor)				
Standard	5 stalls	-	.=	-	8=	N=X	.	=	5 stalls
Compact	=	-	-	9	(e		-)	-	0 stalls
Accessible	1 stalls		-	ä	12	103	-	<u> </u>	1 stalls
Total	6 stalls	0 stalls	0 stalls	0 stalls	0 stalls	0 stalls	0 stalls	0 stalls	6 stalls
				Guestroom Ma	atrix (per Floor)				
Double Queen	ä	·	8 Guestrooms	8 Guestrooms	8 Guestrooms	5 Guestrooms	7 Guestrooms	2	36 Guestrooms
Acc. Double Queen	+	: -	1 Guestrooms	1 Guestrooms	1 Guestrooms	1 Guestrooms	1 Guestrooms	-	5 Guestrooms
King	Щ	-	22 Guestrooms	22 Guestrooms	22 Guestrooms	17 Guestrooms	17 Guestrooms	2	100 Guestrooms
Suite	•		180			3 Guestrooms	2 Guestrooms		5 Guestrooms
Acc. King	4		1 Guestrooms	1 Guestrooms	1 Guestrooms	1 Guestrooms	1 Guestrooms	-	5 Guestrooms
Total Per Floor	0 Guestrooms	0 Guestrooms	32 Guestrooms	32 Guestrooms	32 Guestrooms	27 Guestrooms	28 Guestrooms	0 Guestrooms	151 Guestrooms

PROJECT LOCATION MAP







DEVELOPER:

AANTAAT ANDVINIAAN

NORTH CENTRAL GROUP c/o MM EAST WASHINGTON, LLC

1600 ASPEN COMMONS, SUITE 200 MIDDLETON. WISCONSIN 53562 PHONE: (608) 662-3631

AINMAN@NCGHOTELS.COM

ARCHITECT:

GBA ARCHITECTURE & DESIGN

2248 DEMING WAY, SUITE 120 MIDDLETON. WISCONSIN 53562 PHONE: (608) 829-1750

EMAIL: JOSH.WILCOX@GARYBRINK.COM

CONTACT: JOSH WILCOX



CIVIL ENGINEER / LANDSCAPE ARCHITECT

PINNACLE ENGINEERING GROUP 20725 WATERTOWN ROAD, SUITE 100

BROOKFIELD, WISCONSIN 53186 PHONE: (414) 397-5065

AEKOCH@PINNACLE-ENG.COM CONTACT: AARON KOCH



AS NOTED SCALE: Ø4/Ø1/2Ø2Ø *0*5/18/2*0*20


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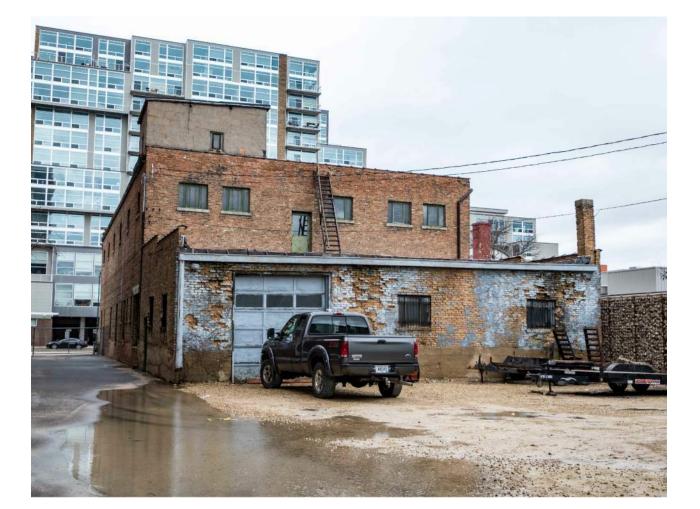
824 East Washington Avenue - Interior No. 1




824 East Washington Avenue - Exterior No. 1



825 East Washington Avenue - Interior No. 1

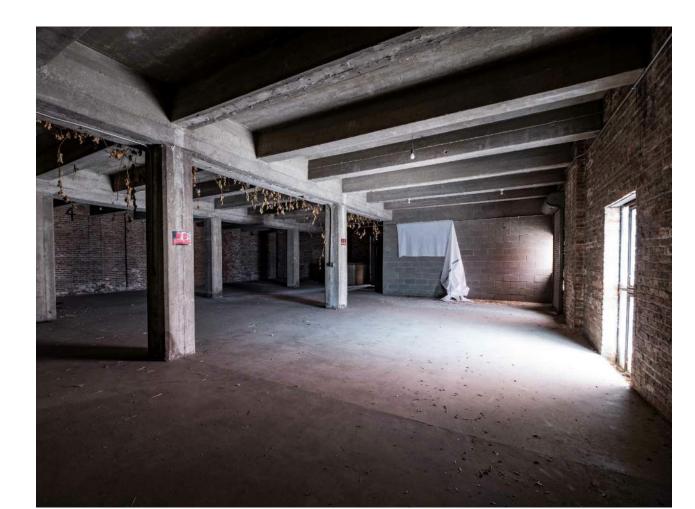

825 East Washington Avenue - Exterior No. 1

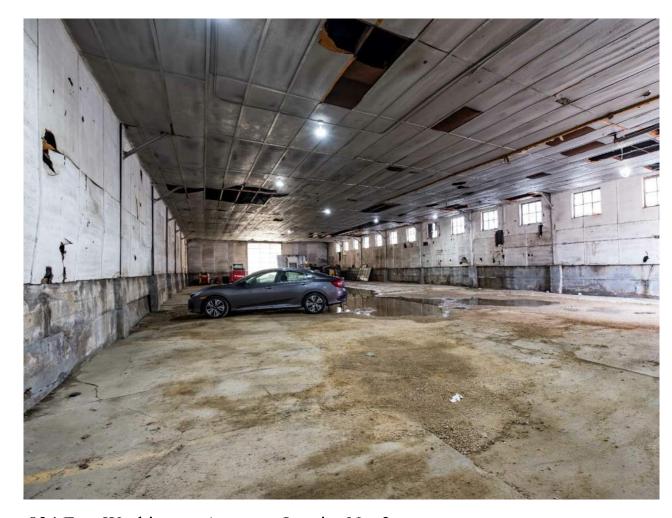


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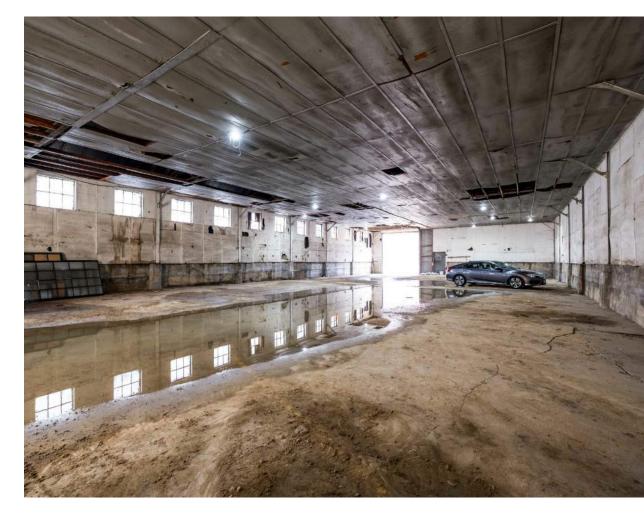
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825 East Washington Avenue - Interior No. 2




825 East Washington Avenue - Exterior No. 2



824 East Washington Avenue - Interior No. 3

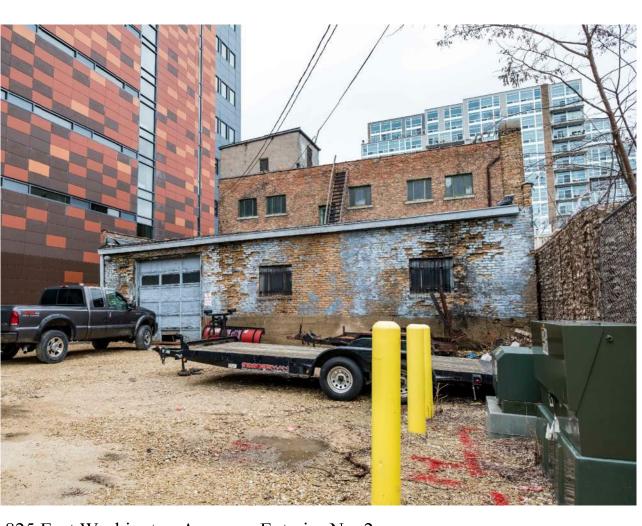

824 East Washington Avenue - Exterior No. 3

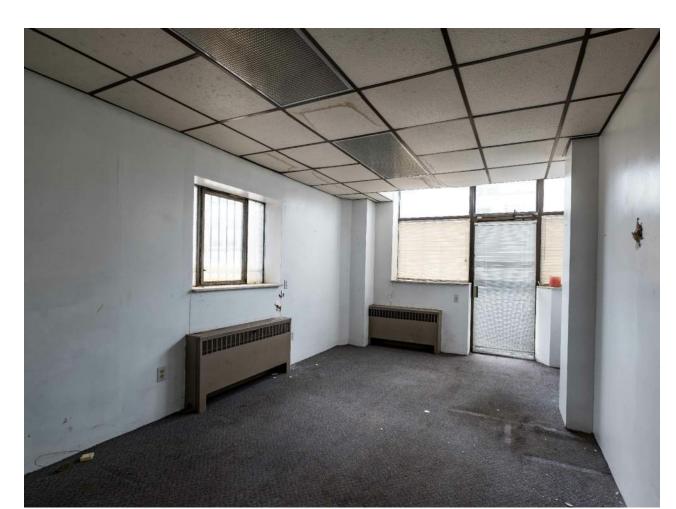

825 East Washington Avenue - Interior No. 3




825 East Washington Avenue - Exterior No. 3



824 East Washington Avenue - Interior No. 4



824 East Washington Avenue - Exterior No. 4

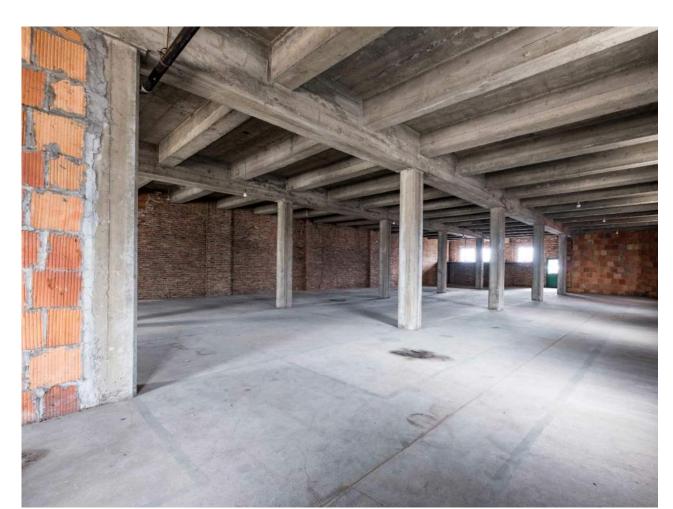

825 East Washington Avenue - Interior No. 4




825 East Washington Avenue - Exterior No. 4



824 East Washington Avenue - Interior No. 5



824 East Washington Avenue - Exterior No. 5

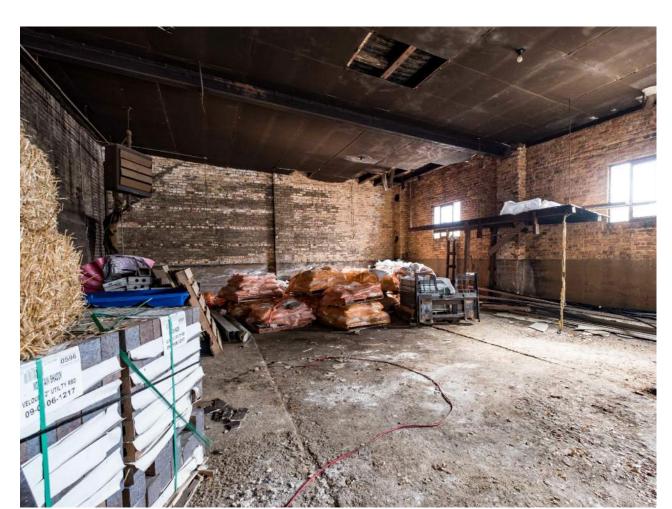

825 East Washington Avenue - Interior No. 5



825 East Washington Avenue - Exterior No. 5

PROJECT:

MOXY HOTEL
825 E. WASHINGTON AVENUE
MADISON, WI 53703
CLIENT:

NORTH CENTRAL GROUP
C/O MIM EAST WASHINGTON, LLC
1600 ASPEN COMMONS, SUITE 200
MIDDLETON, WI 53562

2020 GBA.
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PROJECT: 201926

DRAWN BY: DSD

DRAWN BY: DSD
DATE: 05/18/2020
SCALE: AS NOTED
PC & UDC 04/01/2020
PC & UDC 05/18/2020

SITE CONTEXT PHOTOS


PINNACLE ENGINEERING GROUP ENGINEERING I NATURAL RESOURCES I SURVEYING


WISCONSIN OFFICE:
20725 WATERTOWN ROAD, SUITE 100
BROOKFIELD, WI 53186
(262) 754-8888

(262) 754-8888

CHICAGO | MILWAUKEE : NATIONWIDE www.pinnacle-engr.com

PLAN | DESIGN | DELIVER

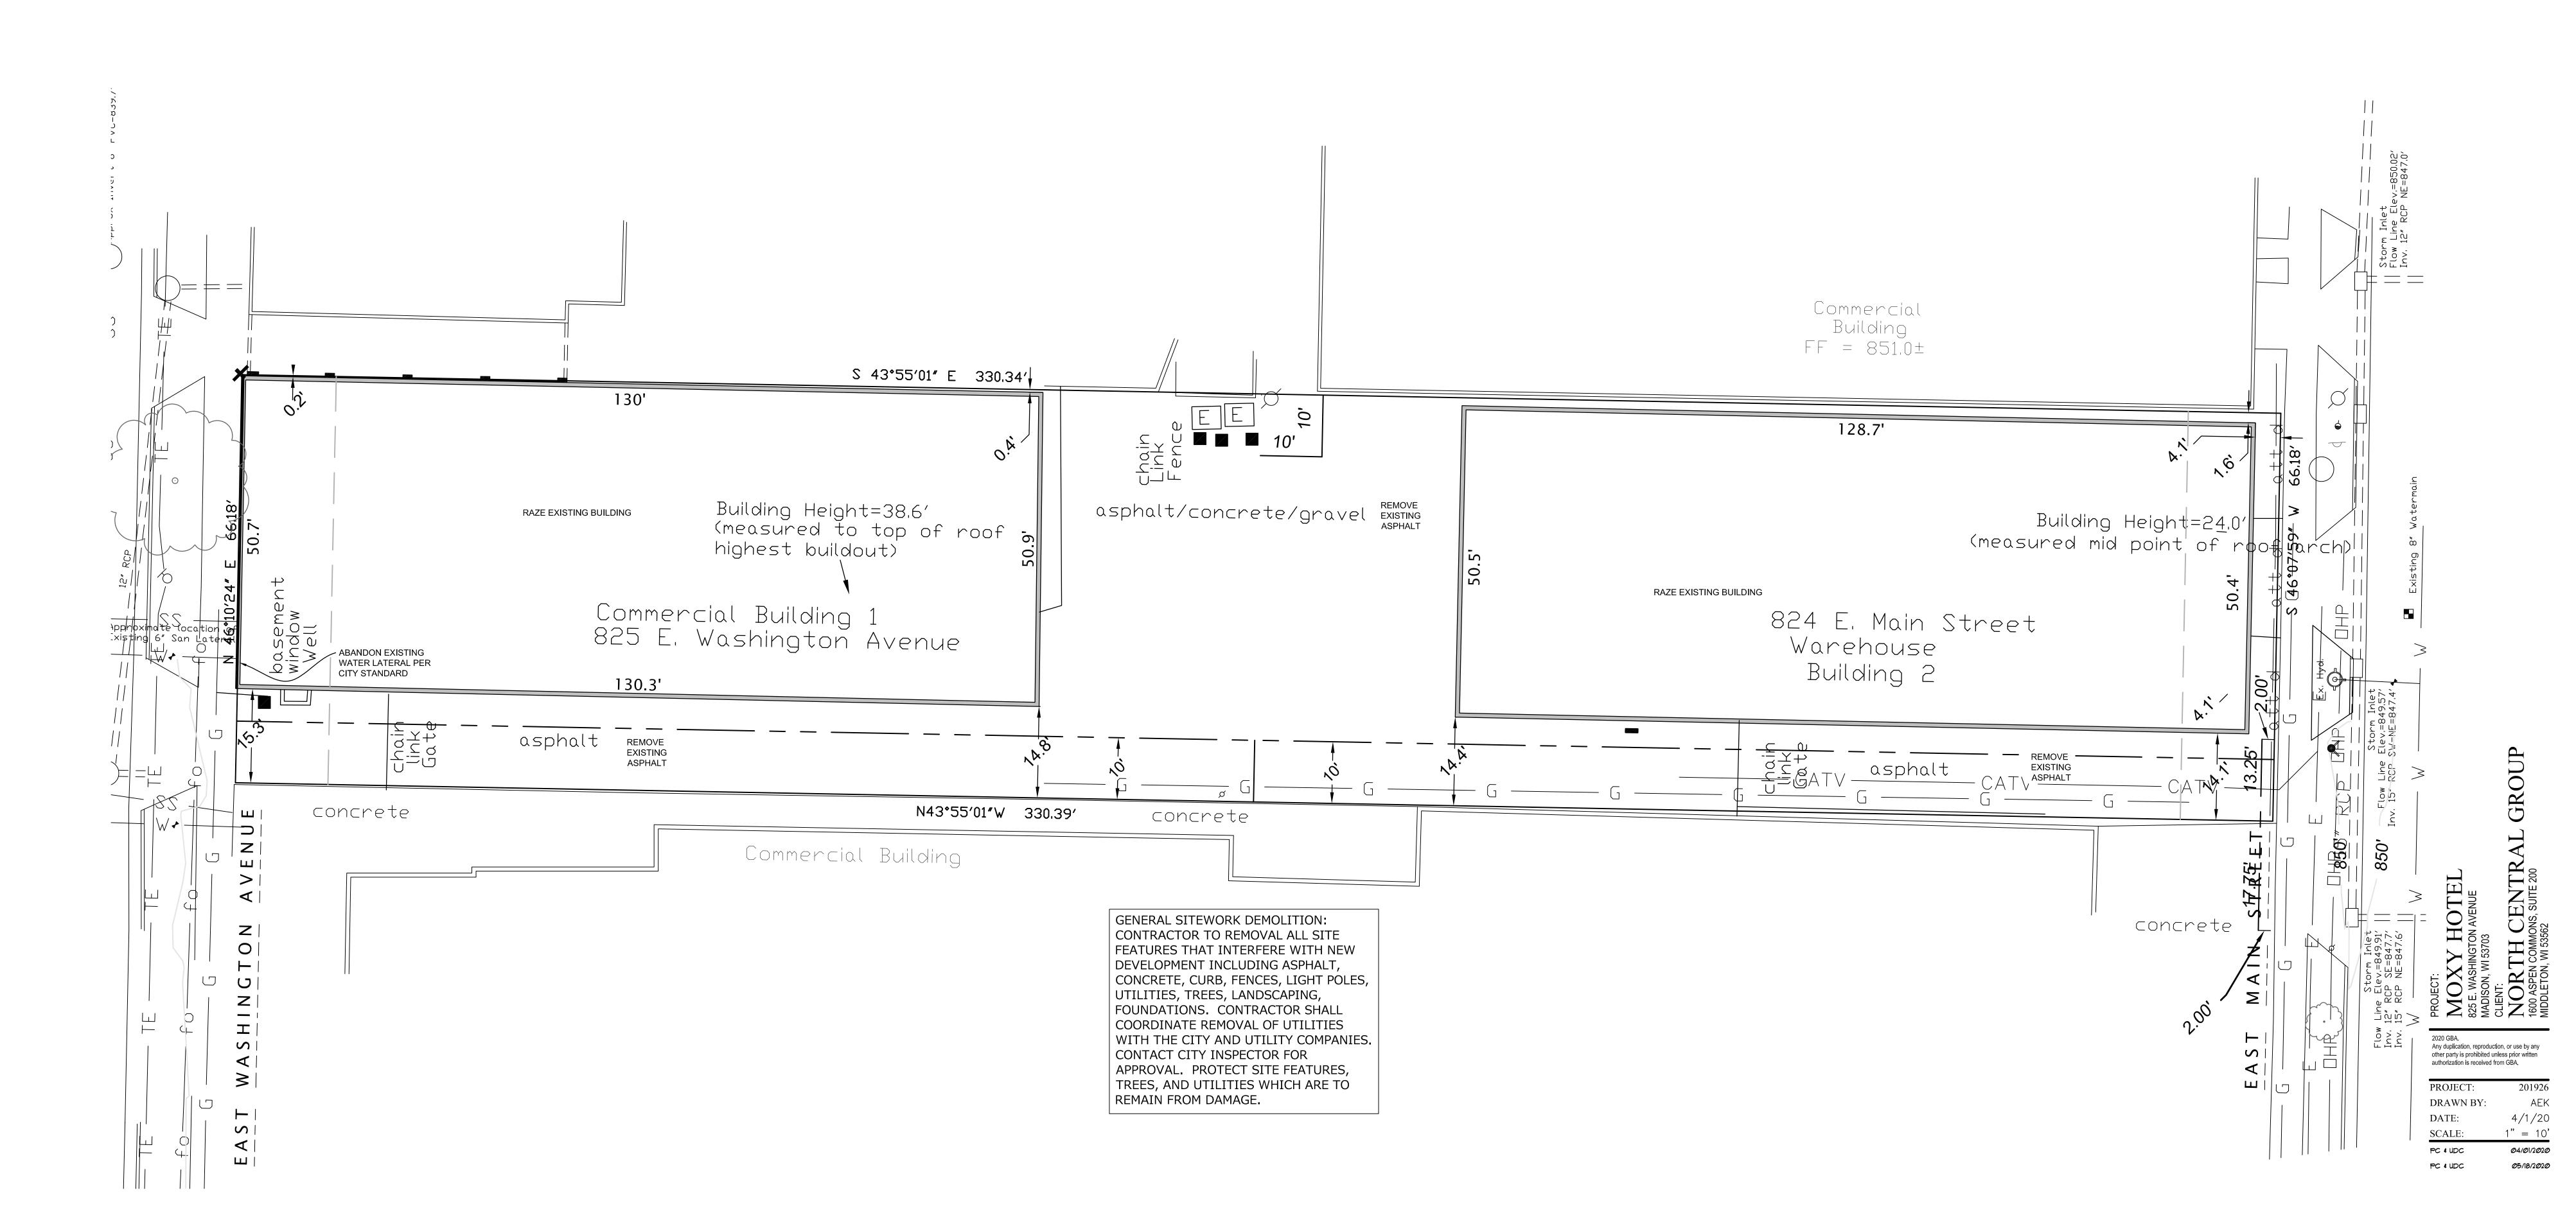

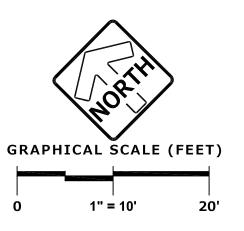

EXISTING
CONDITIONS &
SITE DEMO PLAN

C1.0

PINNACLE ENGINEERING GROUP ENGINEERING I NATURAL RESOURCES I SURVEYING

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CHICAGO I MILWAUKEE: NATIONWIDE
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PLAN I DESIGN I DELIVER


SITE DATA TABLE

TOTAL LOT AREA = 21,865 SF (0.502 AC)

BUILDING AREA = 5,768 SF (0.132 AC)
PAVEMENT AREA = 14,158 SF (0.325 AC)
GREENSPACE = 1,939 SF (0.0445 AC)

IMPERVIOUS AREA = 19,926 SF (91.1%) GREENSPACE AREA = 1,939 SF (8.9%)

PARKING COUNT = 6 TOTAL (1 ADA)

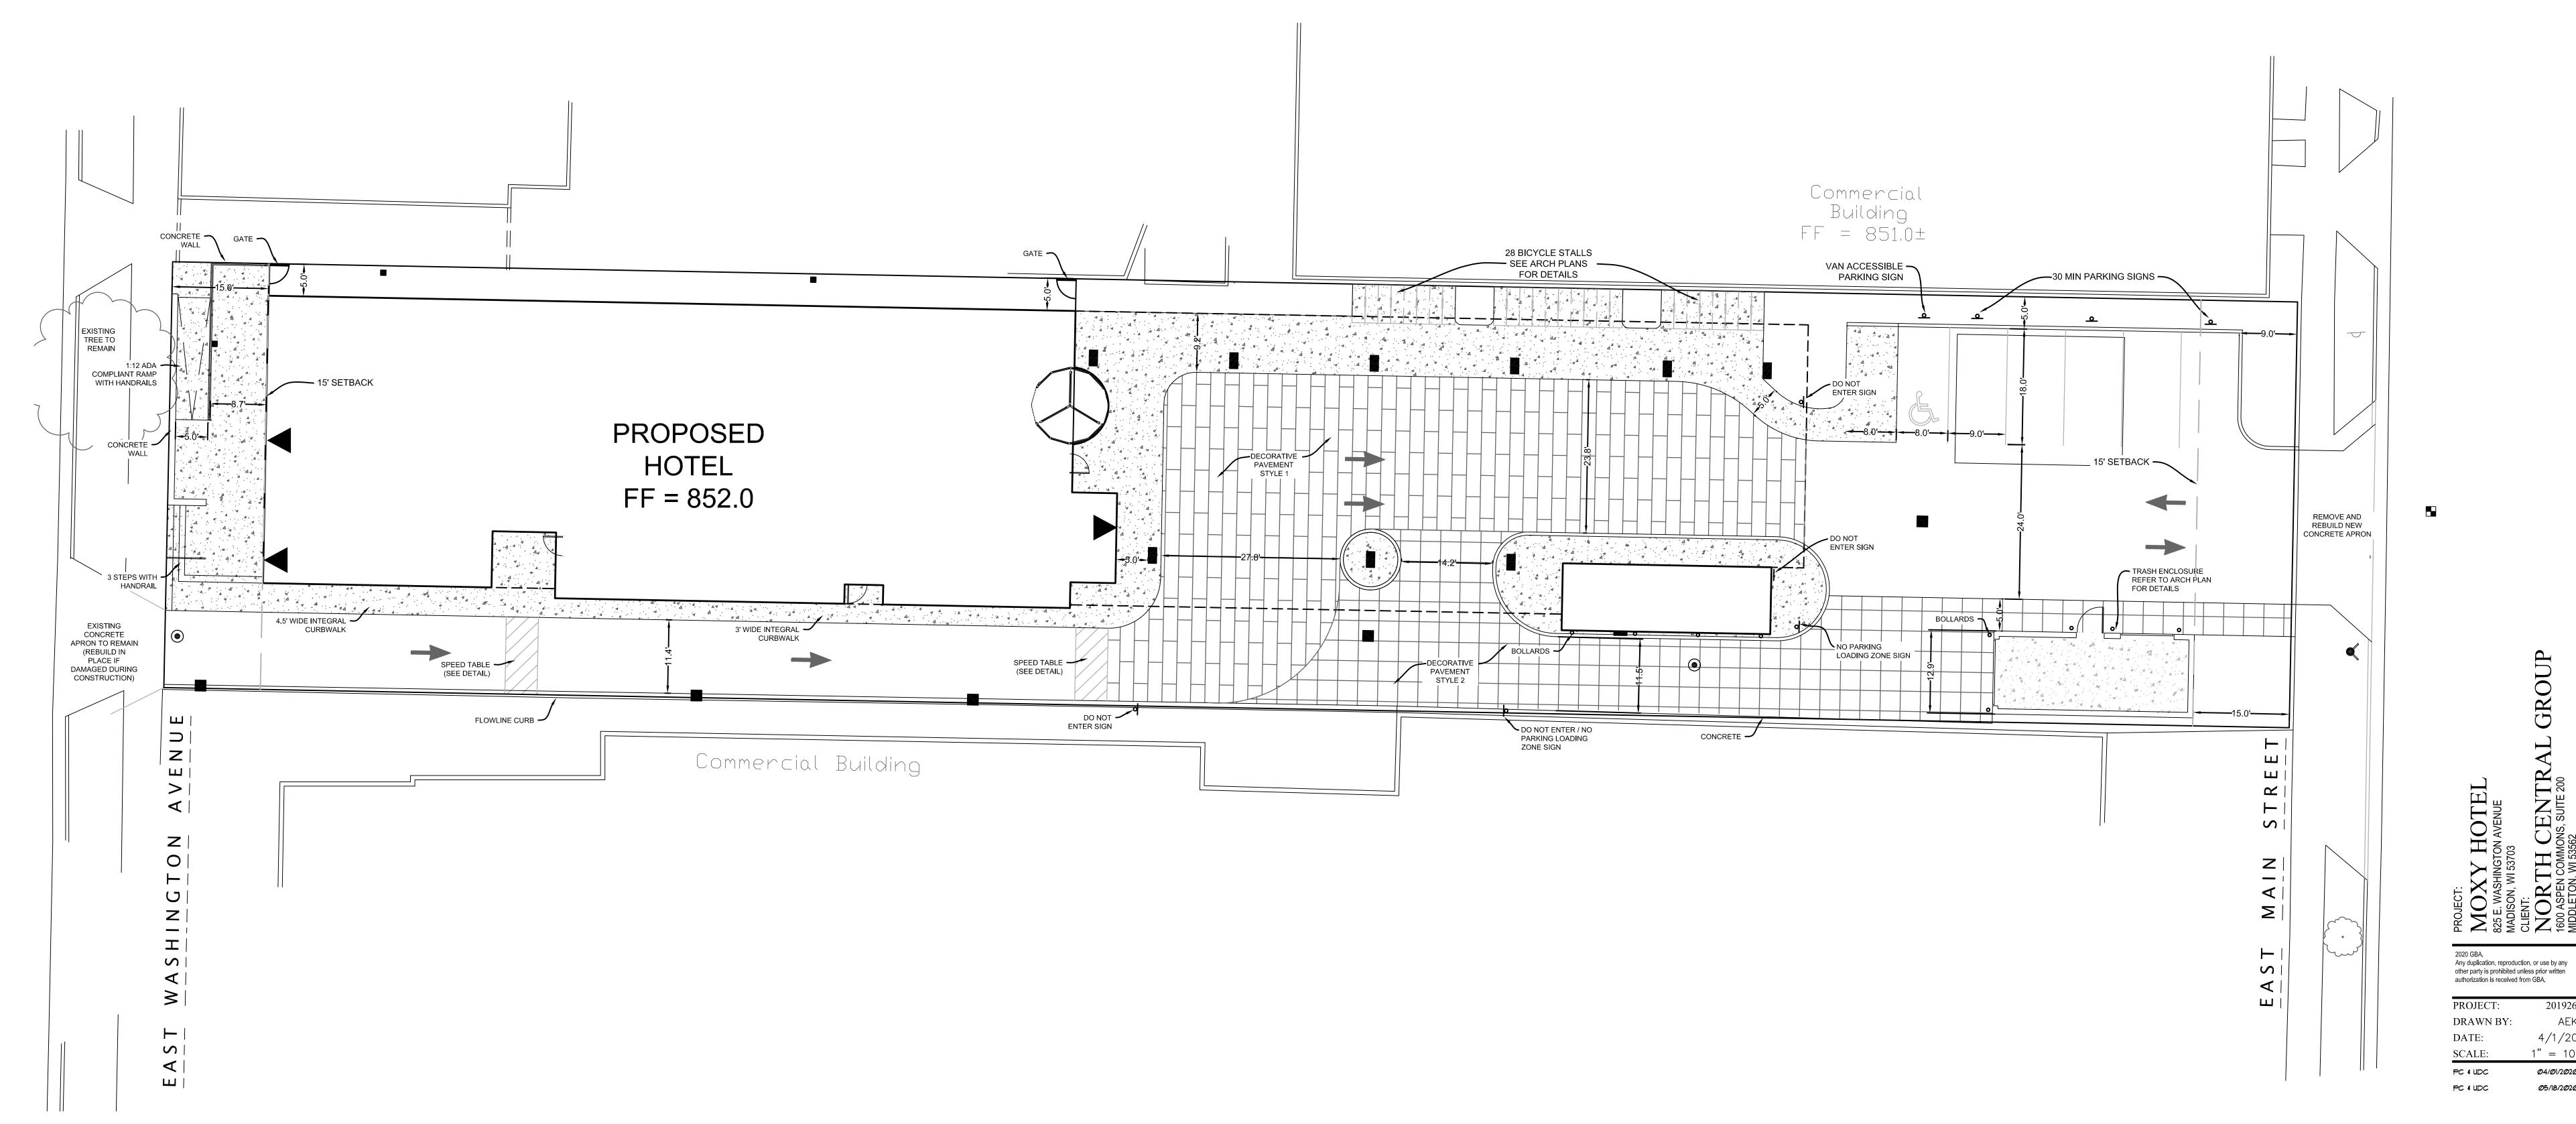

FRAPHICAL SCALE (FEET)




PINNACLE ENGINEERING GROUP
ENGINEERING I NATURAL RESOURCES I SURVEYING

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CHICAGO I MILWAUKEE: NATIONWIDE
www.pinnacle-engr.com

PLAN I DESIGN I DELIVER

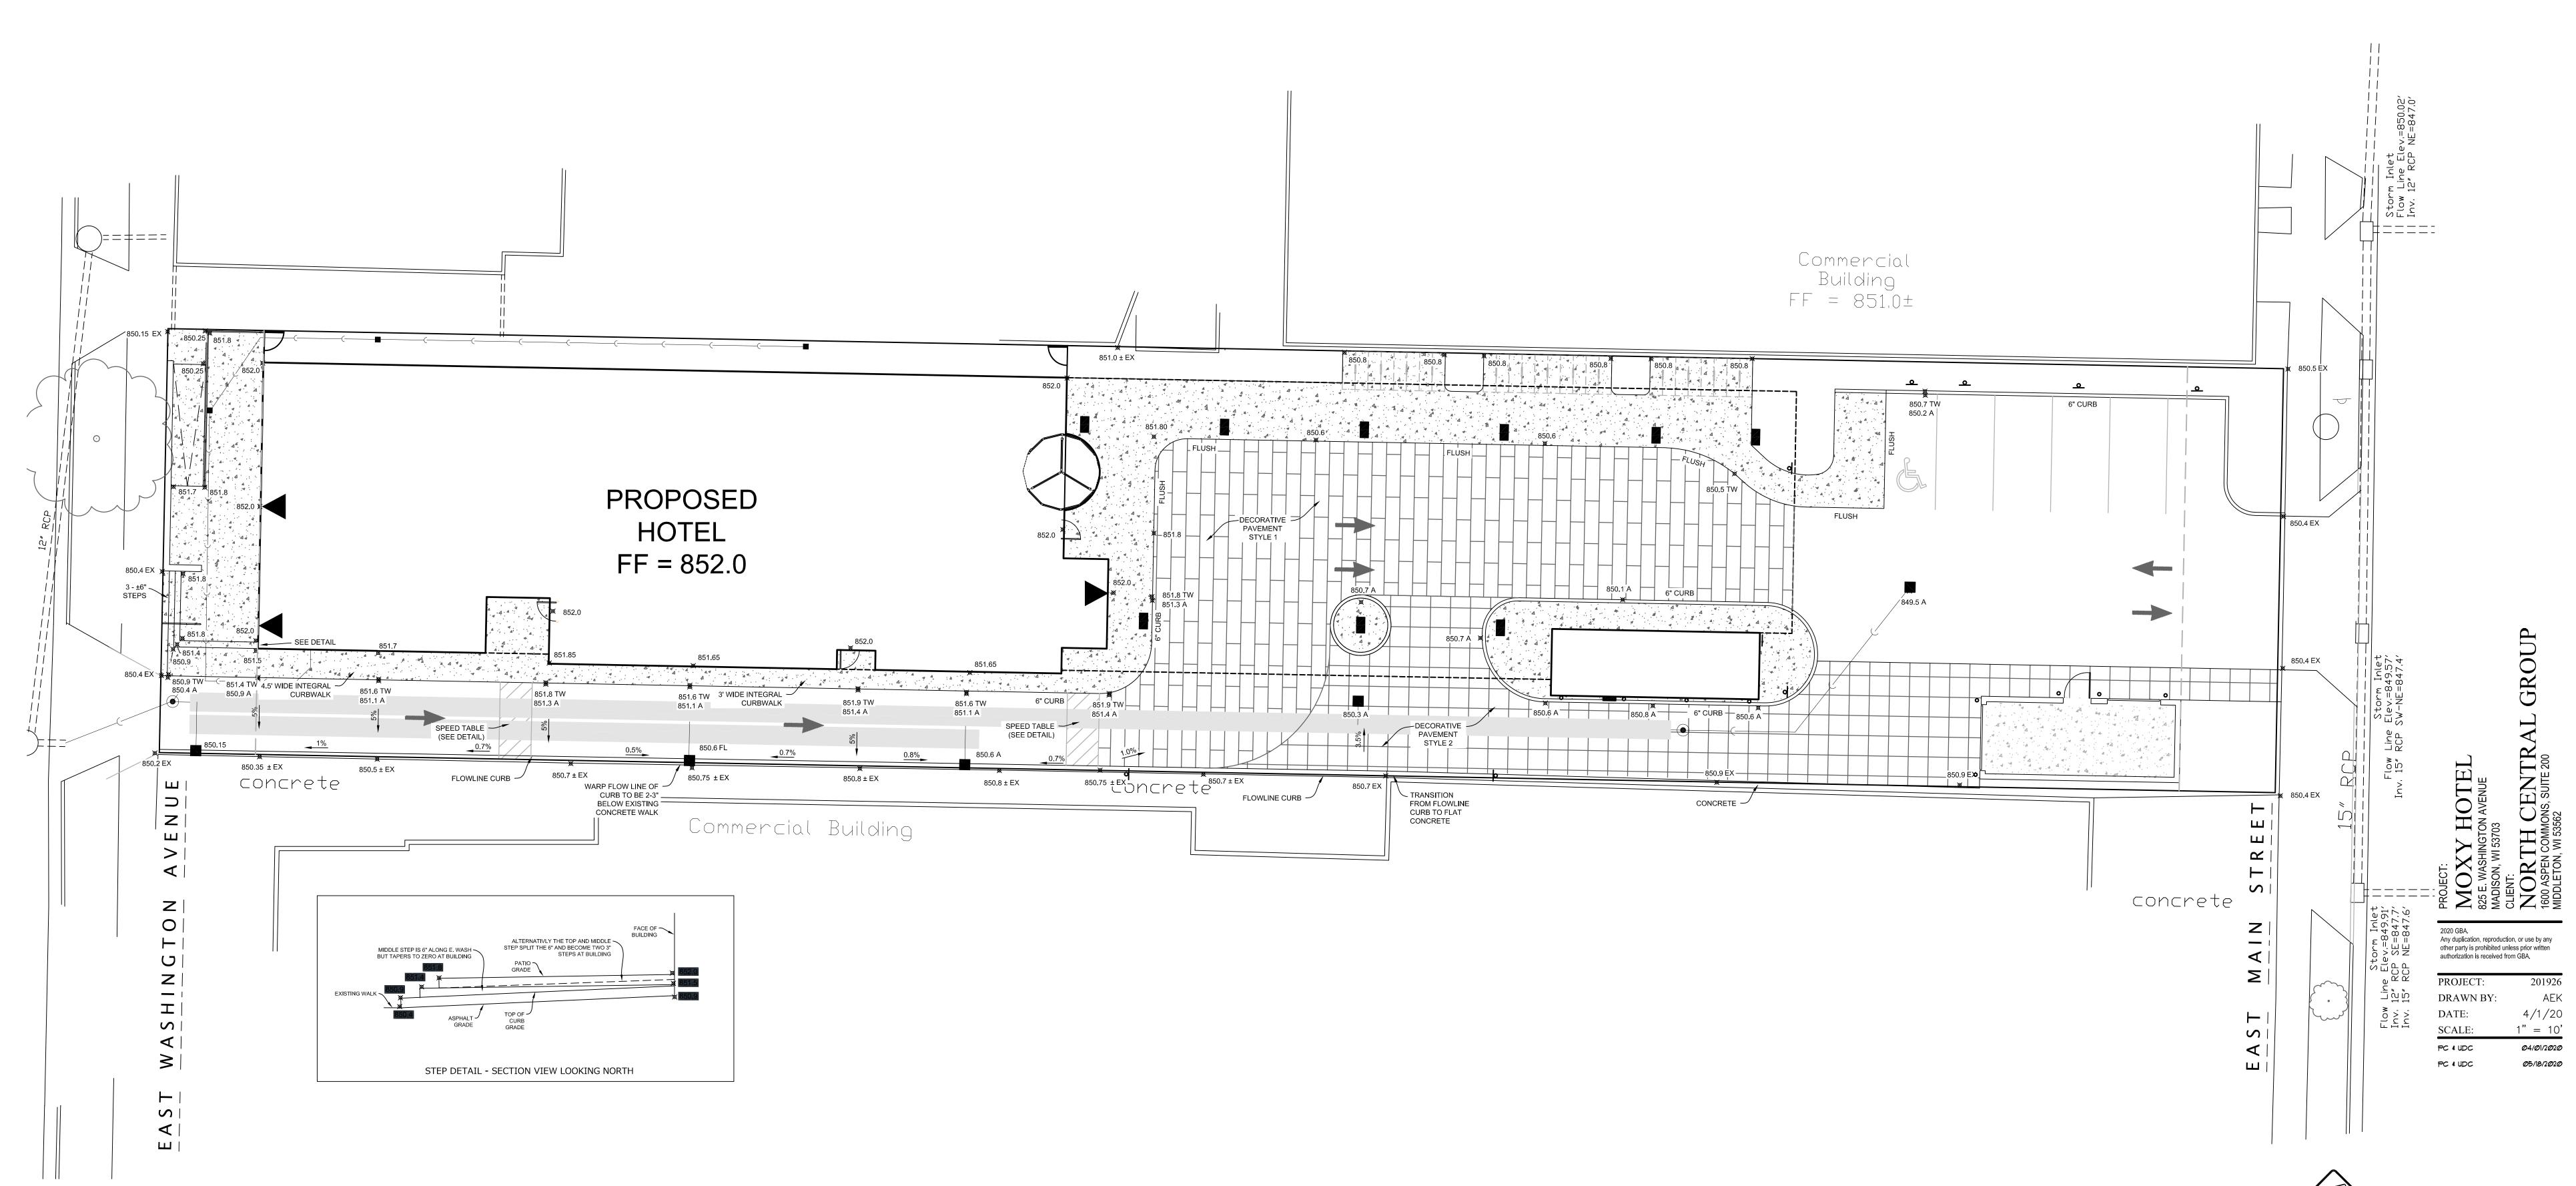


GRAPHICAL SCALE (FE


PAVING PLAN


C3.0




PINNACLE ENGINEERING GROUP ENGINEERING I NATURAL RESOURCES I SURVEYING WISCONSIN OFFICE: 20725 WATERTOWN ROAD, SUITE 100 BROOKFIELD, WI 53186 (262) 754-8888 CHICAGO | MILWAUKEE : NATIONWIDE www.pinnacle-engr.com PLAN I DESIGN I DELIVER

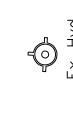

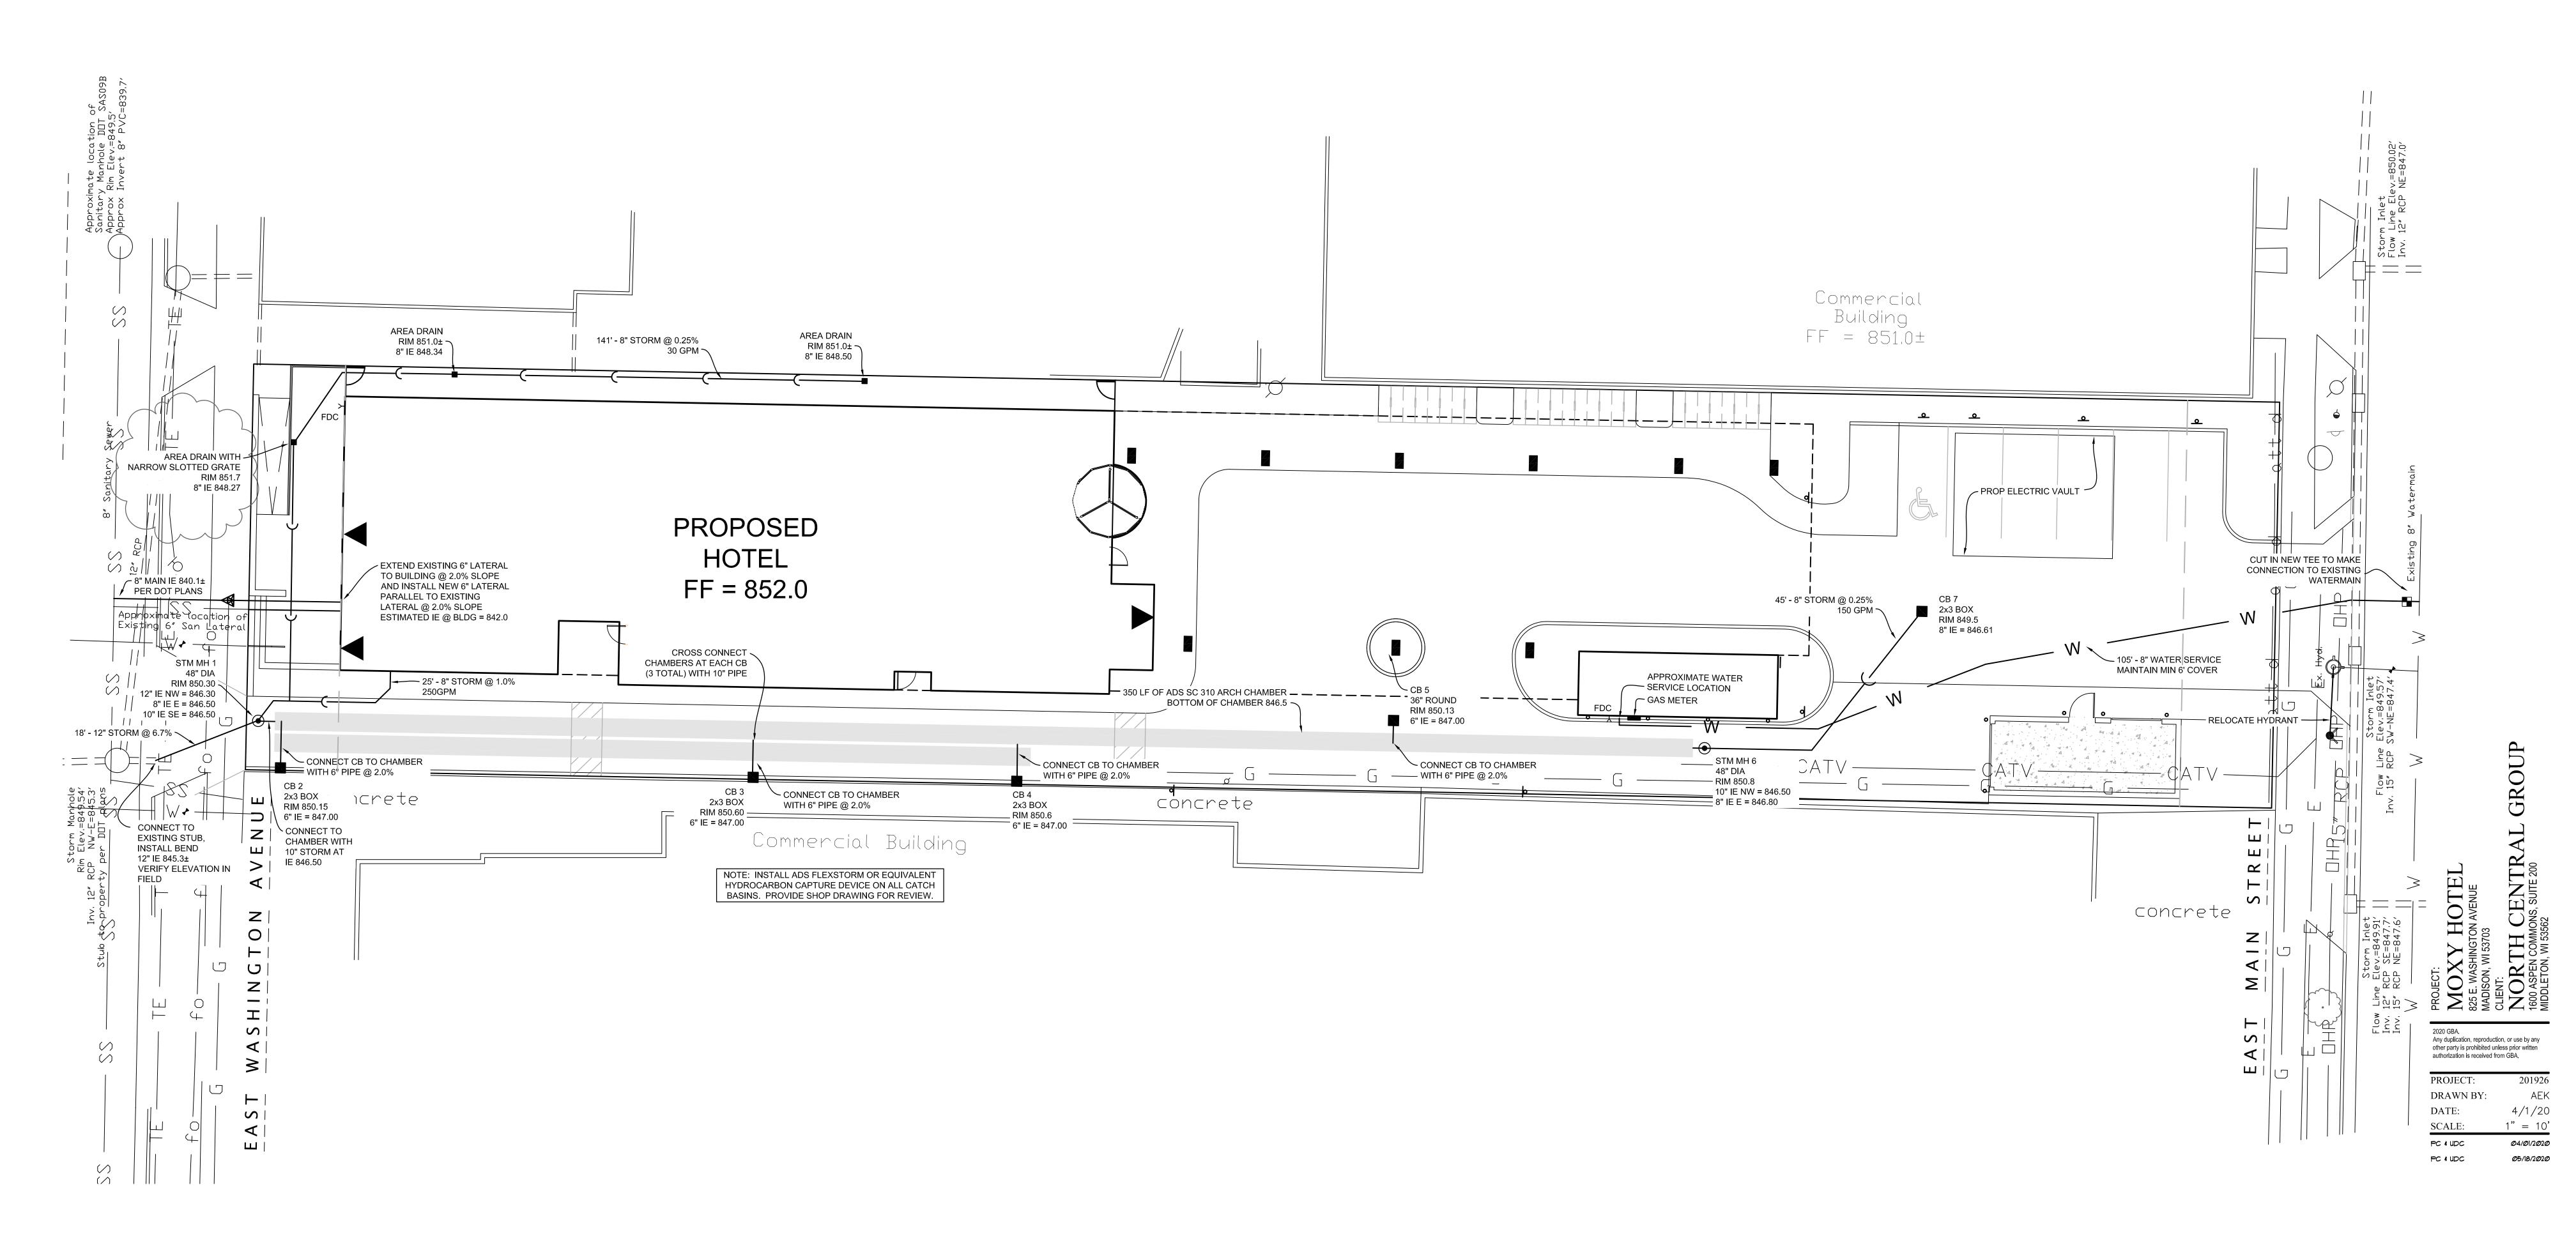

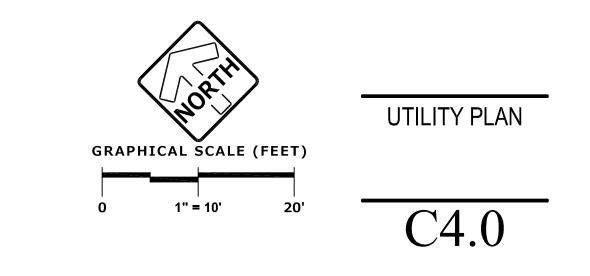

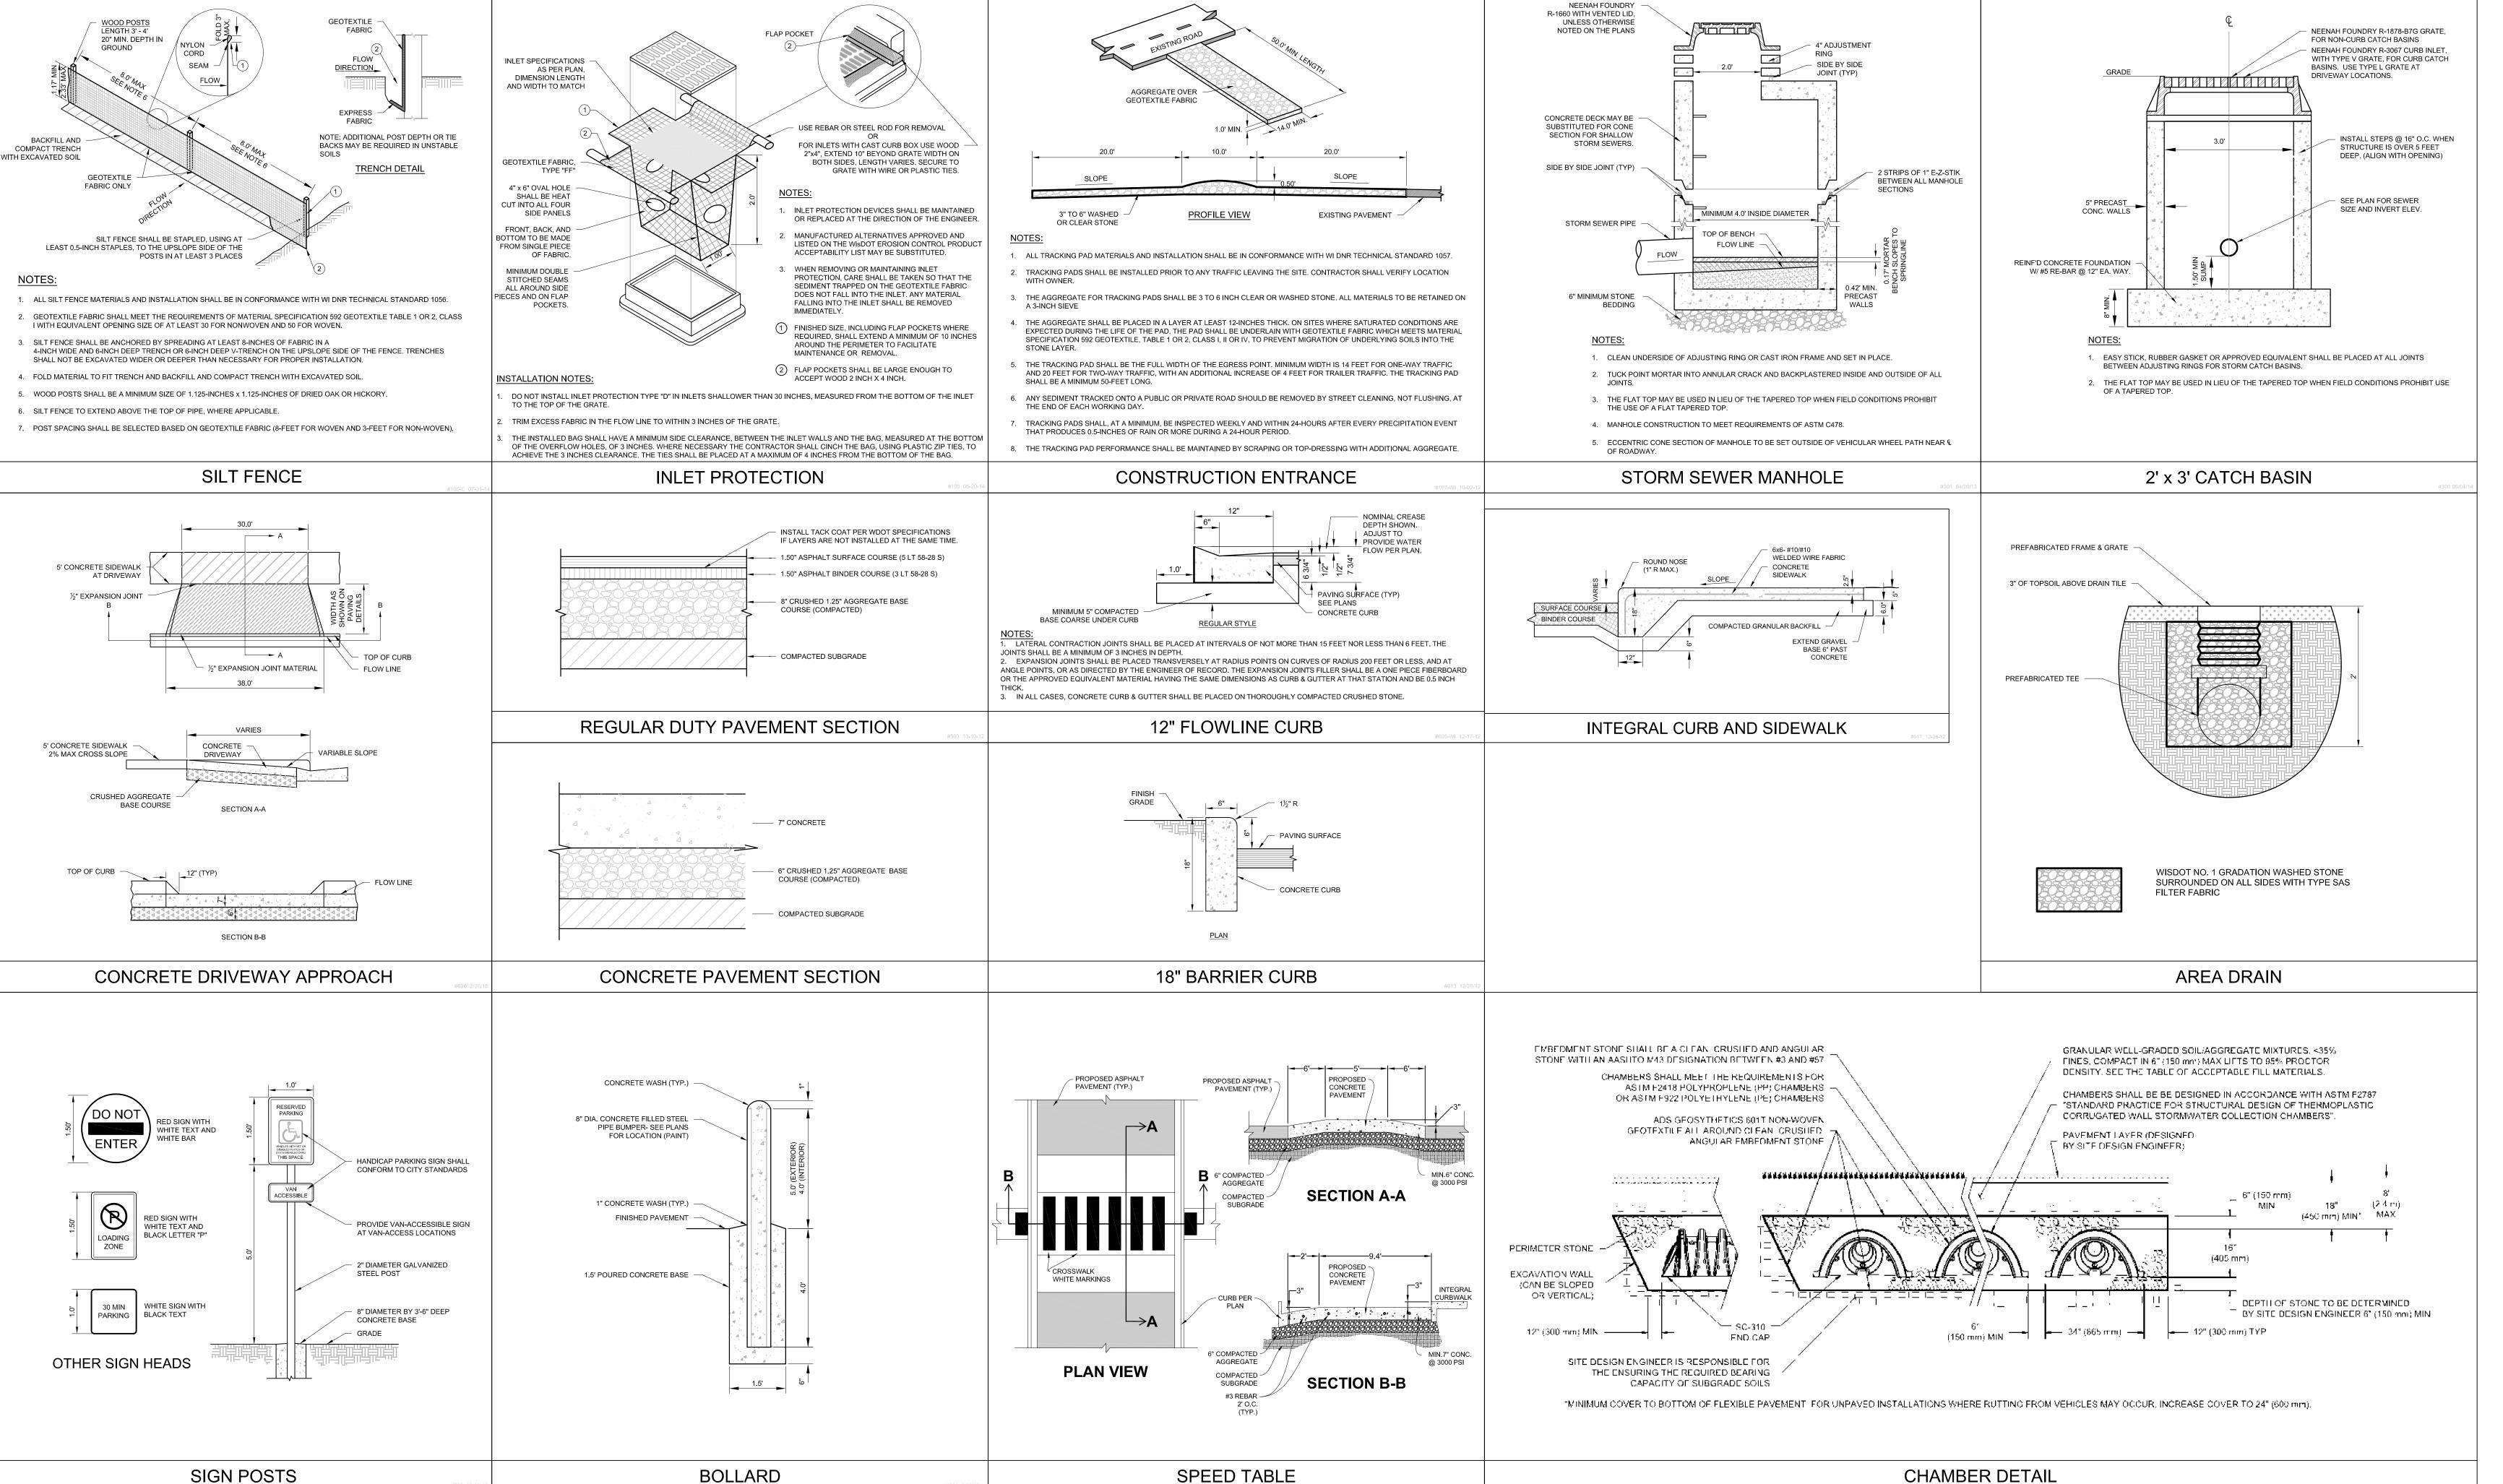



PROJECT:

MOXY HOTEL

825 E. WASHINGTON AVENUE

MADISON, WI 53703

CLIENT:

NORTH CENTRAL GROUP

1600 ASPEN COMMONS, SUITE 200

MIDDLETON, WI 53562


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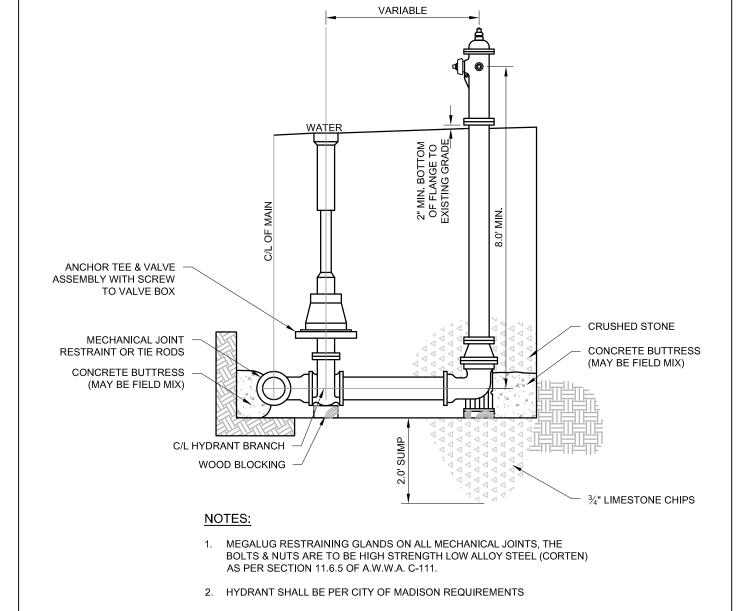
PROJECT: 201926
DRAWN BY: AEK
DATE: 4/1/20
SCALE: NONE

Ø5/18/2Ø2Ø

SITE DETAILS & SPECIFICATIONS

PINNACLE ENGINEERING GROUP ENGINEERING I NATURAL RESOURCES I SURVEYING WISCONSIN OFFICE:



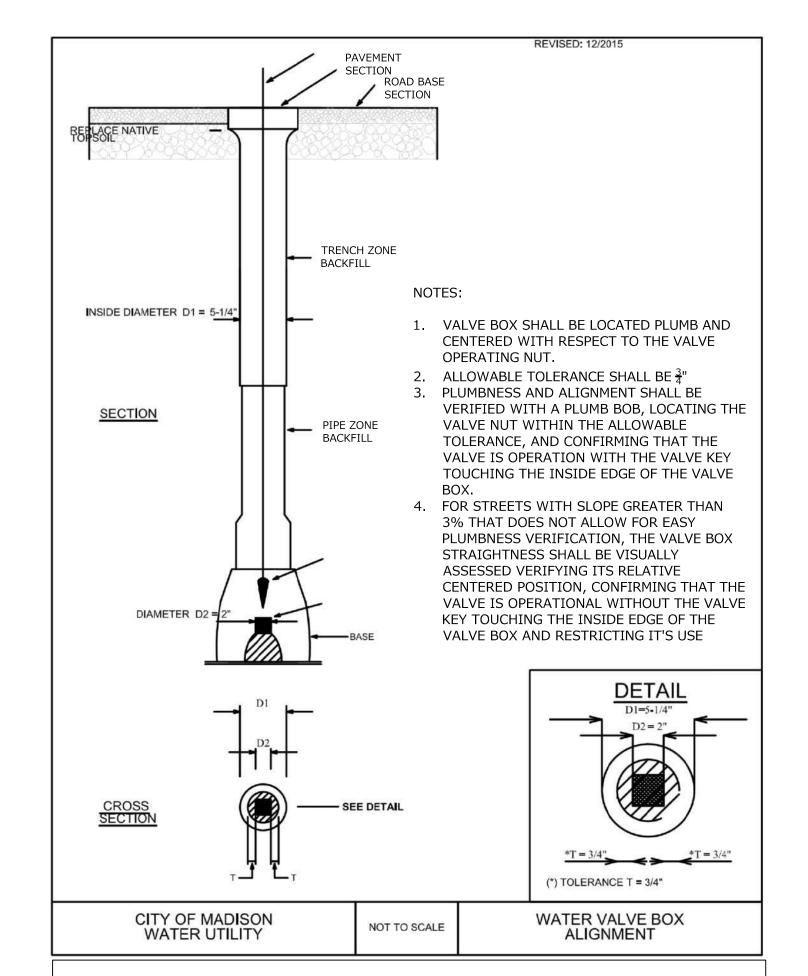

FIRE HYDRANT

GENERAL SPECIFICATIONS FOR CONSTRUCTION ACTIVITIES

1. THE PROPOSED IMPROVEMENTS SHALL BE CONSTRUCTED ACCORDING TO THE WISCONSIN D.O.T. STANDARD SPECIFICATIONS FOR HIGHWAY AND STRUCTURE CONSTRUCTION, LATEST EDITION, THE STANDARD SPECIFICATIONS FOR SEWER & WATER IN WISCONSIN, AND WISCONSIN ADMINISTRATIVE CODE, SPS 360, 382-383, AND THE LOCAL ORDINANCES AND SPECIFICATIONS.

- 2. THE CONTRACTOR SHALL OBTAIN ALL PERMITS REQUIRED FOR EXECUTION OF THE WORK. THE CONTRACTOR SHALL CONDUCT HIS WORK ACCORDING TO THE REQUIREMENTS OF THE PERMITS.
- 3. THE CONTRACTOR SHALL NOTIFY THE OWNER AND THE MUNICIPALITY FORTY- EIGHT (48) HOURS PRIOR TO THE START OF CONSTRUCTION.
- 4. THE MUNICIPALITY SHALL HAVE THE RIGHT TO INSPECT, APPROVE, AND REJECT THE CONSTRUCTION OF THE PUBLIC PORTIONS OF THE WORK. THE OWNER SHALL HAVE THE RIGHT TO INSPECT, APPROVE, AND REJECT THE CONSTRUCTION OF ALL PRIVATE PORTIONS OF THE WORK.
 5. THE CONTRACTOR SHALL INDEMNIFY THE OWNER, THE ENGINEER, AND THE MUNICIPALITY, THEIR AGENTS, ETC, FROM ALL LIABILITY INVOLVED WITH THE
- CONSTRUCTION, INSTALLATION, AND TESTING OF THE WORK ON THIS PROJECT.

 6. SITE SAFETY SHALL BE THE SOLE RESPONSIBILITY OF THE CONTRACTOR.
- 7. THE CONTRACTOR IS RESPONSIBLE FOR FIELD VERIFYING ALL UTILITY INFORMATION SHOWN ON THE PLANS PRIOR TO THE START OF CONSTRUCTION. THE CONTRACTOR SHALL CALL DIGGER'S HOTLINE AT 1-800-242-8511 TO NOTIFY THE UTILITIES OF HIS INTENTIONS, AND TO REQUEST FIELD STAKING OF EXISTING UTILITIES.
- 8. SILT FENCE AND OTHER EROSION CONTROL FACILITIES MUST BE INSTALLED PRIOR TO CONSTRUCTION OR ANY OTHER LAND DISTURBING ACTIVITY. FOLLOW THE SEQUENCE OF CONSTRUCTION ON THE EROSION CONTROL PLAN FOR MORE DETAILS. INSPECTIONS SHALL BE MADE WEEKLY OR AFTER EVERY RAINFALL OF 0.5" OR MORE. REPAIRS SHALL BE MADE IMMEDIATELY. THE CONTRACTOR SHALL BE RESPONSIBLE FOR REMOVING ALL EROSION CONTROL FACILITIES ONCE THE THREAT OF EROSION HAS PASSED WITH THE APPROVAL OF THE GOVERNING AGENCY.

9. ANY ADJACENT PROPERTIES OR ROAD RIGHT-OF-WAYS WHICH ARE DAMAGED DURING CONSTRUCTION MUST BE RESTORED BY THE CONTRACTOR.

10. TRASH AND DEBRIS SHALL BE NOT BE ALLOWED TO ACCUMULATE ON THIS SITE AND THE SITE SHALL BE CLEAN UPON COMPLETION OF WORK.

11. THE OWNER SHALL HAVE THE RIGHT TO HAVE ALL MATERIALS USED IN CONSTRUCTION TESTED FOR COMPLIANCE WITH THESE SPECIFICATIONS.

SPECIFICATIONS FOR GRADING & EROSION CONTROL

1. THE CONTRACTOR SHALL ASSUME SOLE RESPONSIBILITY FOR THE COMPUTATIONS OF ALL GRADING AND FOR ACTUAL LAND BALANCE, INCLUDING UTILITY TRENCH SPOIL. THE CONTRACTOR SHALL IMPORT OR EXPORT MATERIAL AS NECESSARY TO COMPLETE THE PROJECT. CONTRACTOR SHALL NOTIFY OWNER OF THE NEED TO IMPORT OR HAUL OFF SOIL. ON-SITE LOCATIONS SUITABLE FOR BORROW OR FILL MAY BE PRESENT. COORDINATE WITH OWNER.

2. THE CONTRACTOR IS RESPONSIBLE FOR VERIFYING SOIL CONDITIONS PRIOR TO COMMENCEMENT OF CONSTRUCTION. A GEOTECHNICAL REPORT MAY BE

- 3. SITE SHALL BE CLEARED TO THE LIMITS SHOWN ON THE PLANS. REMOVE VEGETATION FROM THE SITE. BURNING IS NOT PERMITTED. PROTECT TREES AND OTHER FEATURES FROM DAMAGE WITH FENCING. STOCKPILES SHALL NOT BE LOCATED CLOSER THAN 25' TO A DRAINAGE STRUCTURE OR FEATURE AND SHALL
- BE SURROUNDED WITH SILT FENCE.

 4. THE GEOTECHNICAL ENGINEER IS RESPONSIBLE FOR VERIFYING COMPACTION AND FILL PLACEMENT IN THE FIELD. THE GEOTECHNICAL ENGINEER MAY SUPERCEDE THESE SPECIFICATIONS IF THERE IS GOOD CAUSE TO DO SO. AN EXPLANATION MUST BE SUBMITTED TO THE ENGINEER IN WITTING BEFORE ANY
- DEVIATIONS ARE MADE. 5. IF NO GEOTECHNICAL RECOMMENDATION IS AVAILABLE, THEN THE FOLLOWING SPECIFICATIONS SHALL APPLY. ALL FILL SHALL BE CONSIDERED STRUCTURAL FILL AND SHALL BE PLACED IN ACCORDANCE WITH THE FOLLOWING: THE COMPACTED FILL SUBGRADE SHALL CONSIST OF AND SHALL BE UNDERLAIN BY SUITABLE BEARING MATERIALS, FREE OF ALL ORGANIC, FROZEN OR OTHER DELETERIOUS MATERIAL AND INSPECTED AND APPROVED BY THE RESIDENT GEOTECHNICAL ENGINEER. PREPARATION OF THE SUBGRADE, AFTER STRIPPING, SHALL CONSIST OF PROOF-ROLLING TO DETECT UNSTABLE AREAS THAT MIGHT BE UNDERCUT, AND COMPACTING THE SCARIFIED SURFACE TO THE SAME MINIMUM DENSITY INDICATED BELOW. THE COMPACTED FILL MATERIALS SHALL BE FREE OF ANY DELETERIOUS, ORGANIC OR FROZEN MATTER AND SHALL HAVE A MAXIMUM LIQUID LIMIT (ASTM-D-423) AND PLASTICITY INDEX (ASTM D-424) IF 30 AND 10 RESPECTFULLY, UNLESS SPECIFICALLY TESTED AND FOUND TO HAVE LOW EXPANSIVE PROPERTIES AND APPROVED BY AN EXPERIENCED SOILS ENGINEER. THE TOP TWELVE (12") INCHES OF COMPACTED FILL SHOULD HAVE A MAXIMUM THREE (3") INCH PARTICLE DIAMETER AND ALL UNDERLYING COMPACTED FILL A MAXIMUM SIX (6") INCH PARTICLE DIAMETER UNLESS SPECIFICALLY APPROVED BY AN EXPERIENCED SOILS ENGINEER. ALL FILL MATERIAL MUST BE TESTED AND APPROVED UNDER THE DIRECTION AND SUPERVISION OF AN EXPERIENCED SOILS ENGINEER PRIOR TO PLACEMENT, IF THE FILL IS TO PROVIDE NON-FROST SUSCEPTIBLE CHARACTERISTICS, IT MUST BE CLASSIFIED AS A CLEAN GW, GP, SW, OR SP PER UNITED SOIL CLASSIFICATION SYSTEM (ASTM D-2487). FOR STRUCTURAL FILL THE DENSITY OF THE STRUCTURAL COMPACTED FILL AND SCARIFIED SUBGRADE AND GRADES SHALL NOT BE LESS THAN 95 PERCENT OF THE MAXIMUM DRY DENSITY AS DETERMINED BY THE STANDARD PROCTOR (ASTM D-698) WITH THE EXCEPTION TO THE TOP 12 INCHES OF PAVEMENT SUBGRADE WHICH SHALL A MINIMUM IN-SITU DENSITY OF 100 PERCENT OF THE MAXIMUM DRY DENSITY, OR 5 PERCENT HIGHER THAN UNDERLYING FILL MATERIALS. THE MOISTURE CONTENT OF COHESIVE SOIL SHALL NOT VARY BY MORE THAN -1 TO +3 PERCENT AND GRANULAR SOIL ±3 PERCENT OF OPTIMUM WHEN PLACED AND COMPACTED OR RECOMPACTED, UNLESS SPECIFICALLY APPROVED BY THE SOILS ENGINEER TAKING INTO CONSIDERATION THE TYPE OF MATERIALS AND COMPACTION EQUIPMENT BEING USED. THE COMPACTION EQUIPMENT SHOULD CONSIST OF SUITABLE MECHANICAL EQUIPMENT SPECIFICALLY DESIGNED FOR SOIL COMPACTION. BULLDOZERS OR SIMILAR TRACKED VEHICLES ARE TYPICALLY NOT SUITABLE FOR COMPACTION. MATERIAL THAT IS TOO WET TO PERMIT PROPER COMPACTION MAY BE SPREAD ON THE FILL AND PERMITTED TO DRY. DISCING, HARROWING OR PULVERIZING MAY BE NECESSARY TO REDUCE THE MOISTURE CONTENT TO A SATISFACTORY VALUE, AFTER WHICH IT SHALL BE COMPACTED. THE FINISHED SUBGRADE AREAS OF THE SITE SHALL BE COMPACTED TO 100 PERCENT OF THE STANDARD PROCTOR (ASTM D-398) MAXIMUM DENSITY.
- 6. NO FILL SHALL BE PLACED ON A WET OR SOFT SUBGRADE. THE SUBGRADE SHALL BE PROOF-ROLLED AND INSPECTED BY THE GEOTECHNICAL ENGINEER
- BEFORE ANY MATERIAL IS PLACED.

 7. SUBGRADE TOLERANCES ARE +/-1" FOR LANDSCAPE AREAS AND +/-½" FOR ALL PAVEMENT AND BUILDING AREAS.
- 8. TOPSOIL SHALL BE FREE OF DELETERIOUS MATERIALS, ROOTS, OLD VEGETATION, ROCKS OVER 2" DIAMETER AND SHALL NOT BE EXCESSIVELY CLAYEY IN NATURE. NO CLUMPS LARGER THAN 4" ARE ACCEPTABLE. TOPSOIL MAY BE AMENDED AS NEEDED WITH SAND OR COMPOST TO BE LOOSE WHEN SPREAD.
- 9. THE CONTRACTOR SHALL MAINTAIN SITE DRAINAGE THROUGHOUT CONSTRUCTION. THIS MAY INCLUDE THE EXCAVATION OF TEMPORARY DITCHES OR PUMPING TO ALLEVIATE WATER PONDING. ANY DEWATERING SHALL NOT GO DIRECTLY TO STREAMS, CREEKS, WETLANDS OR OTHER ENVIRONMENTALLY SENSITIVE AREAS WITHOUT BEING TREATED FIRST. A DIRT BAG OR OTHER DEWATERING TREATMENT DEVICE MAY BE USED TO CAPTURE SEDIMENT FROM THE PUMPED WATER

10. CONTRACTOR IS ADVISED THAT ALL MUD AND DEBRIS MUST NOT BE DEPOSITED ONTO THE ADJACENT ROADWAYS PER THE REQUIREMENT OF THE MUNICIPALITY OR OTHER APPROPRIATE GOVERNMENT AGENCIES. IN THE EVENT THIS OCCURS, THE ROADWAYS SHALL BE POWER SWEPT IMMEDIATELY AND ALL SEDIMENT REMOVED FROM DOWNSTREAM FACILITIES.

SPECIFICATIONS FOR PRIVATE UTILITIES

ENGINEER IMMEDIATELY FOR POSSIBLE REDESIGN.

AVAILABLE FROM THE OWNER.

1. BEFORE PROCEEDING WITH ANY UTILITY CONSTRUCTION, THE CONTRACTOR SHALL EXCAVATE EACH EXISTING LATERAL OR POINT OF CONNECTION AND VERIFY THE LOCATION AND ELEVATION OF ALL UTILITIES. IF ANY EXISTING UTILITIES ARE NOT AS SHOWN ON THE DRAWINGS, THE CONTRACTOR SHALL NOTIFY THE

- 2. ALL CONNECTIONS TO EXISTING PIPES AND MANHOLES SHALL BE CORED CONNECTIONS. CONNECTIONS TO WATERMAIN SHALL BE WET TAPED WITH A STAINLESS STEEP TAPPING SLEEVE.
- 3. PROPOSED SANITARY SEWER AND INTERNALLY CONNECTED STORM SEWER SHOWN ON THIS PLAN SHALL TERMINATE AT A POINT FIVE (5) FEET FROM THE EXTERIOR BUILDING WALL. THE EXACT LOCATION OF ALL DOWN SPOUTS CONNECTIONS SHALL BE PER THE ARCHITECTURAL PLANS.
- 4. CONTRACTOR SHALL NOT SHUT OFF WATER OR PLUG SANITARY SEWER IN MUNICIPAL LINES WITHOUT PRIOR APPROVAL.
- 5. MATERIALS FOR STORM SEWER SHALL BE AS FOLLOWS: STORM SEWER PIPE 48" OR LESS SHALL BE HIGH DENSITY POLYETHYLENE (HDPE) CORRUGATED PIPE WITH AN INTEGRALLY FORMED SMOOTH WATERWAY SUCH AS ADS N-12. FOR PIPE 10" OR LESS IN DIAMETER, PVC, ASTM D-3034, SDR-26, MAY ALSO BE USED. WHERE SPECIFICALLY REQUIRED, REINFORCED CONCRETE PIPE (RCP), ASTM C-76, CLASS III OR HIGHER, MAY BE USED. TRENCH SECTION SHALL BE CLASS "B" FOR PVC AND HDPE AND CLASS "C" FOR CONCRETE (PER STANDARD SPECIFICATIONS). MANHOLES, INLETS AND CATCH BASINS SHALL BE PRE CAST REINFORCED CONCRETE, ASTM C-478. CASTINGS SHALL BE HEAVY DUTY CAST IRON. AREA DRAINS SHALL BE PER THE DETAIL ON THE PLANS. CONNECTIONS TO EXISTING PIPES SHALL BE MADE WITH INSERTA WYE OR EQUIVALENT. LAST (3) THREE JOINTS SHALL BE RESTRAINED WITH RODS.
- MATERIALS FOR SANITARY SEWER SHALL BE AS FOLLOWS: SANITARY SEWER SHALL BE PVC, ASTM D-3034, SDR-35 WITH RUBBER GASKETED JOINTS, CONFORMING TO ASTM D-3212. TRENCH SECTIONS SHALL BE CLASS "B" BEDDING (PER STANDARD SPECIFICATIONS). CRUSHED STONE CHIPS SHALL BE USED FOR BEDDING MATERIAL. CONNECTIONS SHALL BE MAD WITH A INSERTA WYE OR EQUIVALENT. A MINIMUM OF 6' OF COVER IS REQUIRED FOR ALL SANITARY SEWER.
 MATERIALS FOR WATER SERVICES AND PRIVATE HYDRANTS SHALL BE AS FOLLOWS: WATER SERVICES SHALL BE PVC, HDPE, OR DI AS ALLOWED BY MUNICIPAL CODE, PVC SHALL BE AWWA C-900. DI SHALL BE AWWA C151, CLASS 52 (OR AS REQUIRED BY LOCAL CODE). TRENCH SECTIONS SHALL BE CLASS "B" BEDDING (PER STANDARD SPECIFICATIONS). CRUSHED STONE CHIPS SHALL BE USED FOR BEDDING MATERIAL. CONNECTION SHALL BE MADE WITH A WET TAP, CORPORATE STOP AND VALVE BOX PER MUNICIPAL STANDARDS. A MINIMUM OF 6' COVER IS REQUIRED FOR ALL WATERMAIN. VALVES SHALL BE NONRISING STEM, RESILIENT SEATED GATE VALVES COMPLYING WITH AWWA C509 WITH A THREE PIECE CAST IRON VALVE BOX. INSTALL THRUST BLOCKS AT ALL BENDS AND TEES. DISINFECT
- 8. EXTREME CAUTION MUST BE FOLLOWED REGARDING THE COMPACTION OF ALL UTILITY TRENCHES. MECHANICALLY COMPACTED GRANULAR BACKFILL IS REQUIRED UNDER & WITHIN 5 FEET OF ALL PAVEMENT INCLUDING SIDEWALKS. FLOODING OF BACKFILL MATERIAL IS NOT ALLOWED.
- 9. TRACER WIRE (NO. 8 SINGLE STRAND COPPER) AND WARNING TAPE SHALL BE INSTALLED ON ALL UTILITIES IN ACCORDANCE WITH THE LOCAL AND STATE CODES. TRACER WIRE SHALL TERMINATE IN A VALVECO TERMINAL BOX AT EACH END.
- MANDREL TESTING ON SANITARY LINES AND PRESSURE TESTING ON WATERMAIN MAY BE REQUIRED BY THE OWNER OR MUNICIPALITY.
 UPON COMPLETION OF FINAL PAVING OPERATIONS, THE UTILITY CONTRACTOR SHALL ADJUST ALL MANHOLE AND INLET RIMS AND VALVE BOXES TO FINISHED GRADE

SPECIFICATIONS FOR PAVING

ALL NEW LINES AND OBTAIN SAFE WATER SAMPLE PRIOR TO USE.

- 1. AGGREGATES USED IN THE CRUSHED STONE BASE SHALL CONFORM TO THE GRADATION REQUIREMENTS SECTIONS 301.2 AND 305.2.2 OF THE STANDARD SPECIFICATIONS. THICKNESS SHALL BE PER THE DETAIL ON THE PLANS. BASE SHALL BE 1 ⅓" INCH DIAMETER LIMESTONE TRAFFIC BOND AGGREGATE BASE COURSE UNLESS NOTED OTHERWISE. SUBSTITUTION AND/OR RECYCLED MATERIALS MAY BE ALLOWED WITH APPROVAL FROM THE OWNER.
- SUBGRADE SHALL BE PROOFROLLED AND APPROVED BY A GEOTECHNICAL ENGINEER PRIOR TO PLACEMENT OF STONE BASE. EXCAVATE UNSUITABLE AREAS AND REPLACE WITH BREAKER RUN STONE AND RECOMPACT. REFER TO THE GEOTECHNICAL REPORT FOR ADDITIONAL SPECIFICATIONS.
 EXISTING PAVEMENT SHALL BE SAWCUT IN NEAT STRAIGHT LINES TO FULL DEPTH AT ANY POINT WHERE EXISTING PAVEMENT IS REMOVED. CURB AND WALK SHALL BE REMOVED TO THE NEAREST JOINT. REMOVED PAVEMENT SHALL BE REPLACED WITH THE SAME SECTION AS EXISTING. MUNICIPAL STANDARDS MAY REQUIRE ADDITIONAL WORK.
- 4. ASPHALT FOR PARKING AREAS AND THE PRIVATE ROAD SHALL BE PER THE DETAILS MATERIALS AND PLACEMENT SHALL CONFORM TO THE DOT STANDARD SPECIFICATIONS, SECTION 450 AND 460 LT 58-28 S IS REQUIRED UNLESS NOTED OTHERWISE. A COMMERCIAL GRADE MIX MAY BE SUBSTITUTED ONLY WITH APPROVAL FROM THE OWNER.
- 5. CONCRETE FOR CURB, DRIVEWAY, WALKS AND NON-FLOOR SLABS SHALL CONFORM TO SECTION 415 OF THE STANDARD SPECIFICATIONS, GRADE A, ASTM C-94, 6 BAG MIX, WITH A MINIMUM 28 DAY COMPRESSIVE STRENGTH OF 3,500 PSI. JOINTING SHALL BE PER SECTION 415.3.7 OF THE STANDARD SPECIFICATIONS WITH CONSTRUCTION JOINTS HAVING A MAXIMUM SPACING OF 10'. EXPANSION JOINTS SHALL BE PROVIDED EVERY 50'. CONCRETE SHALL BE FINISHED PER SECTION 415.3.8 WITH A MEDIUM BROOM TEXTURE. A CURING MEMBRANE IN CONFORMANCE WITH SECTION 415.3.12 IS REQUIRED.

MOXY HOTEL
825 E. WASHINGTON AVENUE
MADISON, WI 53703
CLIENT:
NORTH CENTRAL GROUP
1600 ASPEN COMMONS, SUITE 200

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PROJECT: 201926

DRAWN BY: AEK

DATE: 4/1/20

SCALE: NONE

PC & UDC 05/18/2020

PC & UDC 05/18/2020

SITE DETAILS & SPECIFICATIONS

City of Madison Fire Department

Phone: 608-266-4420 • Fax: 608-267-1100 • E-mail: fire@cityofmadison.com

Project Address: 825 E Washington Ave

 Is the building completely protected by an NFPA 13 or 13R automatic fire sprinkler system? If non-sprinklered, fire lanes extend to within 150-feet of all portions of the exterior wall?


Contact Name & Phone #: Andy Inman - North Central Group

FIRE APPARATUS ACCESS AND FIRE HYDRANT WORKSHEET

If non-sprinklered, fire lanes extend to within 150-feet of all portions of the exterior wall	Yes	No	×	
 2. Is the fire lane constructed of concrete or asphalt, designed to support a minimum a) Is the fire lane a minimum unobstructed width of at least 20-feet? b) Is the fire lane unobstructed with a vertical clearance of at least 13½-feet? c) Is the minimum inside turning radius of the fire lane at least 28-feet? d) Is the grade of the fire lane not more than a slope of 8%? e) Is the fire lane posted as fire lane? (Provide detail of signage.) f) Is a roll-able curb used as part of the fire lane? (Provide detail of curb.) g) Is part of a sidewalk used as part of the required fire lane? (Must support +85 	No fire lanes proposed on site. Access via public roadways.	Yes Yes Yes Yes Yes Yes Yes Yes Yes	No	
Is the fire lane obstructed by security gates or barricades? If yes: a) Is the gate a minimum of 20-feet clear opening? b) Is an approved means of emergency operations installed, key vault, padlock of the control of th	or key switch?	Yes Yes Yes	No No	
Is the Fire lane dead-ended with a length greater than 150-feet? If yes, does the area for turning around fire apparatus comply with IFC D103?		☐ Yes	□ No □ No	X
Is any portion of the building to be used for high-piled storage in accordance with If yes, see IFC 3206.6 for further requirements.	IFC Chapter 3206.6	☐ Yes	☐ No	X
 6. Is any part of the building greater than 30-feet above the grade plane? If yes, answer the following questions: a) Is the aerial apparatus fire lane parallel to one entire side of the building and 25% of the perimeter? b) Is the near edge of the aerial apparatus fire lane between 15° and 30° from the c) Are there any overhead power or utility lines located across the aerial apparatus d) Are there any tree canopies expected to grow across the aerial fire lane? (Bas canopy width of tree species) Existing Street Tree c) Does the aerial apparatus fire lane have a minimum unobstructed width of 26 f) Is the space between the aerial lane and the building free of trees exceeding 2 	e building? tus fire lane? ed on mature -feet?	X Yes Yes X Yes Yes X Yes X Yes X Yes Yes	No No No No No No No No No	
 7. Are all portions of the required fire lanes within 500-feet of at least (2) hydrants? Note: Distances shall be measured along the path of the hose lay as it comes off a) Is the fire lane at least 26' wide for at least 20-feet on each side of the hydrantb) Is there at least 40' between a hydrant and the building? c) Are the hydrant(s) setback no less than 5-feet nor more than 10-feet from the street or fire lane? d) Are hydrants located in parking lot islands a minimum of 3½-feet from the he) Are there no obstructions, including but not limited to: power poles, trees, by located, or grade changes exceeding 1½-feet, within 5-feet of a fire hydrant? 	nts? curb or edge of the cydrant to the curb? ushes, fences, posts	X Yes X Yes X Yes X Yes Yes Yes	No No No No No	
Note: Hadronic shall be installed and in coming prior to combinatible construction of				

Attach an additional sheet if further explanation is required for any answers.

This worksheet is based on MGO 34.503 and IFC 2012 Edition Chapter 5 and Appendix D; please see the codes for further information.

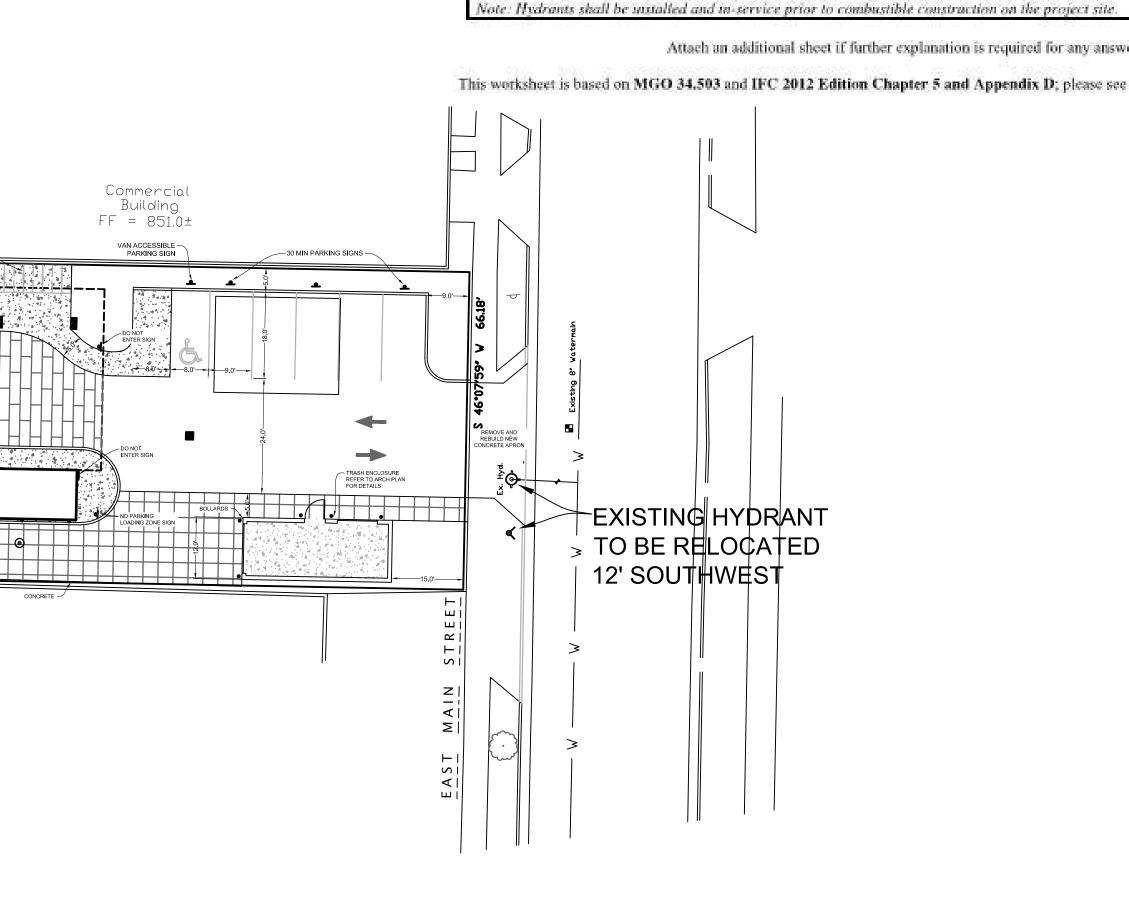

EXISTING HYDRANT

S 43°55′01″ E 330.34′

PROPOSED HOTEL FF = 852.0

Commercial Building

FLOWLINE CURB

EXISTING CITY

TREE TO REMAIN

2248 DEMING WAY, SUITE 120 MIDDLETON, WI 53562 608-829-1750 608-829-3056 (FAX)

PINNACLE ENGINEERING GROUP ENGINEERING I NATURAL RESOURCES I SURVEYING

WISCONSIN OFFICE: 20725 WATERTOWN ROAD, SUITE 100 BROOKFIELD, WI 53186


(262) 754-8888

CHICAGO | MILWAUKEE : NATIONWIDE www.pinnacle-engr.com PLAN | DESIGN | DELIVER

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DRAWN BY:



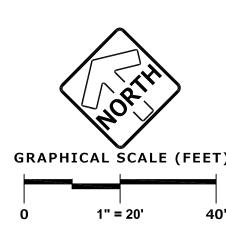

CITY OF MADISON LANDSCAPE WORKSHEET

Section 28.142 Madison General Ordinance

Project Location	Address 825 E. Washington Ave	탁
Name of Project	Moxy Hotel	
Owner / Contact	Andy Inman	<u> </u>

** Landscape plans for zoning lots greater than ten thousand (10,000) square feet in size MUST be prepared by a registered landscape architect. **

Contact Email ainman@ncghotels.com

The following standards apply to all extenor construction and development activity, including the expansion of existing buildings, structures and parking lots, except the construction of detached single-family and two-family dwellings and their accessory structures. The entire development site must be brought up to compliance with this section unless all of the following conditions apply, in which case only the affected areas need to be brought up to compliance

- (a) The area of site disturbance is less than ten percent (10%) of the entire development site during any ten-(10) year period.
- (b) Gross floor area is only increased by ten percent (10%) during any ten-(10) year period.
- (c) No demolition of a principal building is involved.
- (d) Any displaced landscaping elements must be replaced in the site and shown on a revised landscaping plan.

Required landscaped areas shall be calculated based upon the total developed area of the property. Developed area is defined as that area within a single contiguous boundary which is mode up of structures, parking, driveways and decking leading facilities, but excluding the area of any building footprint at grade, land designated for open space uses such as athletic fields, and undeveloped land area on the same zoning lot. There are three methods for calculating landscape points depending on the size of the lot and Zoning District.

(a) For all lots except those described in (b) and (c) below, five (5) landscape points shall be provided for each three hundred (300) square feet of developed area.

Total square footage of developed area. 20,124 sd Total landscape points required 335

(b) For lots larger than five (5) acres, points shall be provided at five (5) points per three hundred (300) square feet for the first five (5) developed acres, and one (1) point per one hundred (100) square feet for all additional

Total square footage of developed area

Five (5) acres = 217,800 square feet

First five (5) developed acres = 3,630 points

Remainder of developed area

Total landscape points required

(c) For the Industrial - Limited (IL) and Industrial - General (IG) districts, one (1) point shall be provided per one hundred (100) square feet of developed area.

Total square footage of developed area

Total landscape points required ____

Tabulation of Points and Credits

Use the table to indicate the quantity and points for all existing and proposed landscape elements.

Use the table to indicate the quantity and points for all existing and proposed landscape elements.									
76 . 77 . 771	Minimum Size at Installation	Points	Credits/ Lands	Existing caping	New/ Proposed Landscaping				
Plant Type/ Element			Quantity	Points Achieved	Quantity	Points Achieved			
Overstory deciduous tree	2½ inch caliper measured diameter at breast height (dbh)	35			1	35			
Tall evergreen tree (i.e. pine, spruce)	5-6 feet tall	3.5							
Omamental tree	1 1/2 inch caliper	15							
Upright evergreen shrub (i.e. arborvitae)	3-4 feet tall	10			19	190			
Shrub, deciduous	#3 gallon container size, Min. 12"-24"	3			20	60			
Shrub, evergreen	#3 gallon container size, Min. 12"-24"	4			5	20			
Omamental grasses/ perennials	#1 gallon container size, Min. 8"-18"	2			36	72			
Omamental/ decorative fencing or wall	n/a	4 per 10 lineal ft.							
Existing significant specimen tree	Minimum size: 2 ½ inch caliper dbh, *Trees must be within developed area and cannot comprise more than 30% of total required points.	14 per caliper inch dbh. Maximum points per tree: 200							
Landscape furniture for public seating and/or transit connections	* Furniture must be within developed area, publically accessible, and cannot comprise more than 5% of total required points.	5 points per "seat"							
Sub Totals						377			

Total Number of Points Provided 377

* As determined by ANSI, ANLA- American standards for nursery stock. For each size, minimum plant sizes shall conform to the specifications as stated in the current American Standard for Nursery Stock.

PLANT SCHEDULE OVERSTORY TREE (35 POINTS EACH) **BOTANICAL NAME COMMON NAME** SIZE QTY 2.5" Cal. Celtis occidentalis `Chicagoland` Chicagoland Hackberry UPRIGHT EVERGREEN SHRUB (10 POINTS EACH) BOTANICAL NAME COMMON NAME QTY Taxus x media `Hicksii` **Hicks Yew** Tsuga canadensis `Gentsh White` Gentsh White Hemlock DECIDUOUS SHRUBS
(3 POINTS EACH) COMMON NAME BOTANICAL NAME Diervilla sessilifolia `Cool Splash` Cool Splash False Honeysuckle Hydrangea paniculata `Bobo` Bobo Hydrangea **BOTANICAL NAME** COMMON NAME (4 POINTS EACH) Juniperus sabina `Buffalo` Buffalo Juniper Taxus x media `Everlow` 3 gal. ORNAMENTAL GRASSES BOTANICAL NAME COMMON NAME (2 POINTS EACH) Switch Grass Panicum virgatum `Northwind` Sporobolus heterolepis Prairie Dropseed PERENNIALS (2 POINTS EACH) **BOTANICAL NAME** COMMON NAME SPACING QTY Hybrid Cranesbill 24" o.c. 14 Geranium x `Rozanne` TM STONE MULCH 641 sf



LANDSCAPING POINTS REQUIREMENTS DEVELOPED AREA ON SITE: 20,124 SF REQUIRED POINTS: (20,124 / 300) X 5 = 335 POINTS PROVIDED POINTS WITH PLANTS: 377 POINTS




PINNACLE ENGINEERING GROUP ENGINEERING I NATURAL RESOURCES I SURVEYING WISCONSIN OFFICE: 20725 WATERTOWN ROAD, SUITE 100 **BROOKFIELD, WI 53186** (262) 754-8888 CHICAGO I MILWAUKEE : NATIONWIDE www.pinnacle-engr.com

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4/1/20 1" = 10' 04/01/2020

*0*5/18/2*0*20

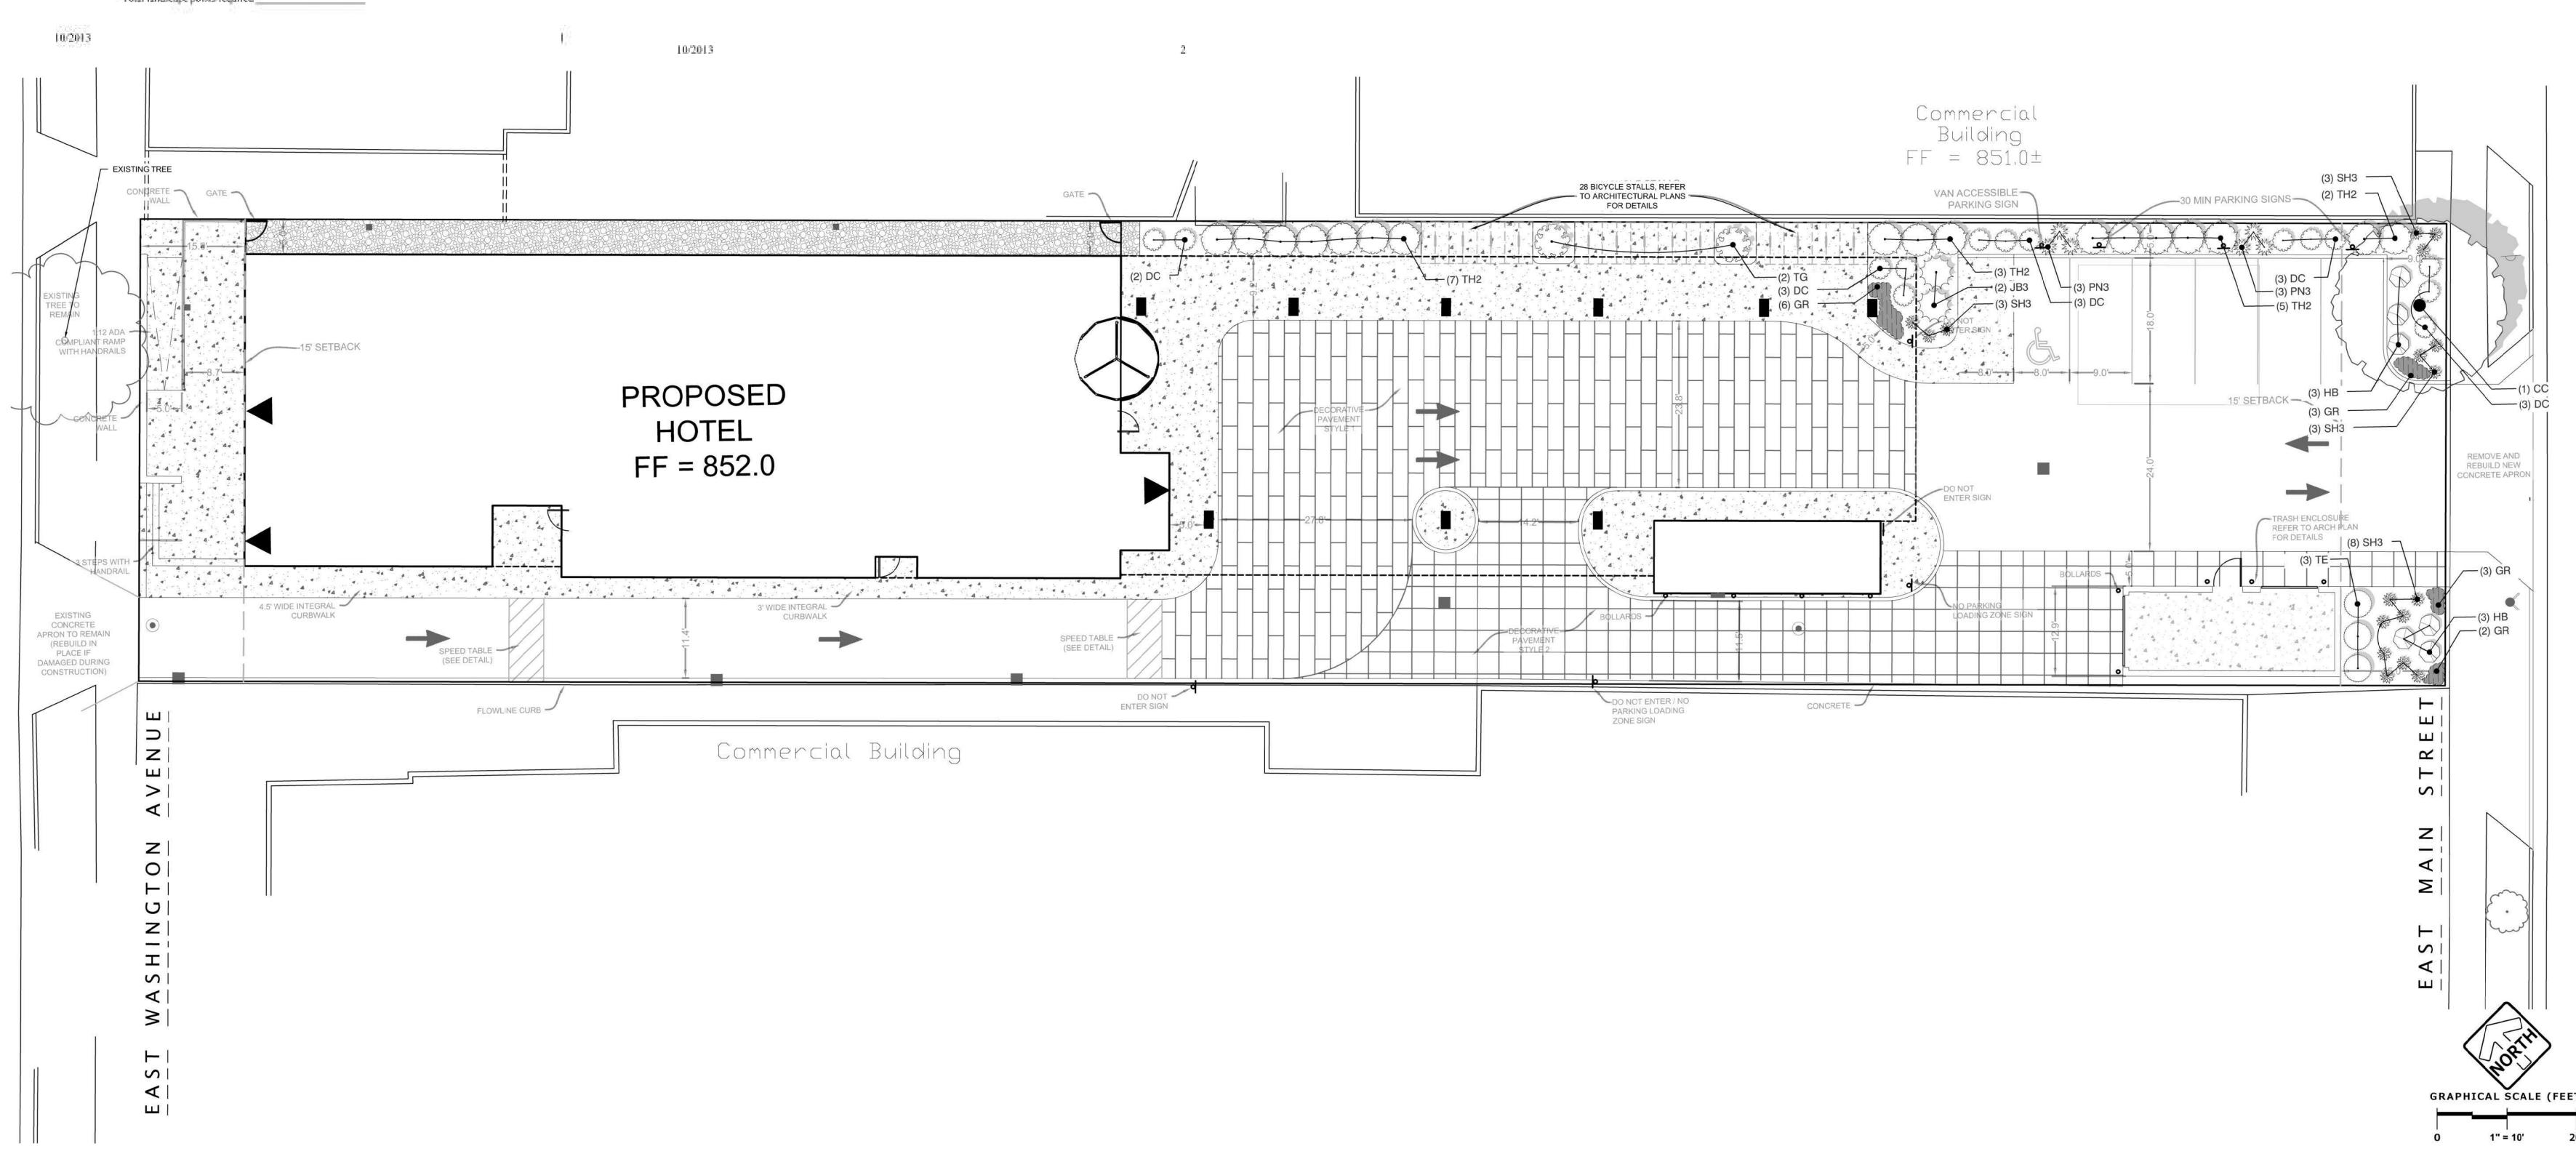

GENERAL PLANTING NOTES


- 1. THE LAYOUT OF ALL PLANTING BEDS AND INDIVIDUAL TREES AND SHRUBS SHALL BE STAKED BY THE CONTRACTOR IN ADVANCE OF INSTALLATION. FLAGGING, STAKES, OR PAINT MAY BE USED TO DELINEATE LOCATIONS AS SCALED FROM THE PLANS. AN APPROVED REPRESENTATIVE WILL REVIEW THESE LOCATIONS WITH THE CONTRACTOR AND MAKE MINOR ADJUSTMENTS AS NECESSARY. BED LAYOUT SHALL ALSO INCLUDE PERENNIAL GROUPINGS BY SPECIES.
- 2. THE CONTRACTOR IS RESPONSIBLE FOR INDEPENDENTLY DETERMINING THE PLANT MATERIAL QUANTITIES REQUIRED BY THE LANDSCAPE PLANS. REPORT ANY DISCREPANCIES TO THE LANDSCAPE ARCHITECT.
- 3. NO PLANT MATERIAL OR PLANT SIZE SUBSTITUTIONS WILL BE ACCEPTED UNLESS APPROVAL BY THE LANDSCAPE ARCHITECT. ANY CHANGES SHALL BE SUBMITTED TO THE LANDSCAPE ARCHITECT IN WRITING PRIOR TO INSTALLATION.
- 4. ALL BNB STOCK SHALL BE NURSERY GROWN IN A CLAY LOAM SOIL FOR A MINIMUM OF THREE GROWING SEASONS WITHIN 200 MILES OF PROJECT LOCATION, IN A ZONE COMPATIBLE WITH USDA HARDINESS ZONE 5A. SEED SHALL BE PROVIDED FROM A NURSERY (WITHIN 200 MILES) WITH A SIMILAR PLANT HARDINESS ZONE AS PROJECT LOCATION. EXISTING SOIL SHALL BE AMENDED PER SOIL ANALYSIS REPORT TO ENSURE A PROPER GROWING MEDIUM IS ACHIEVED.
- 5. ALL PLANT MATERIAL SHALL COMPLY WITH STANDARDS DESCRIBED IN AMERICAN STANDARD OF NURSERY STOCK Z60.1 ANSI. LANDSCAPE ARCHITECT OR OWNERS AUTHORIZED REPRESENTATIVE RESERVES THE RIGHT TO INSPECT AND POTENTIALLY REJECT ANY PLANT MATERIAL DEEMED TO NOT MEET THE REQUIRED STANDARDS.
- 6. ALL STOCK SHALL BE FREE OF DISEASES AND HARMFUL INSECTS, DAMAGE, DISORDERS AND DEFORMITIES.
- 7. TREES SHALL HAVE SINGLE, STRAIGHT TRUNKS AND WELL BALANCED BRANCH SYSTEMS. HEIGHT-TO-CALIPER RATIOS SHALL BE CONSISTENT WITH THE LATEST EDITION OF ANSI Z60.1.
- 8. ROOT SYSTEMS SHALL BE LARGE ENOUGH TO ALLOW FOR FULL RECOVERY OF THE TREE, AND SHALL CONFORM TO STANDARDS AS THEY APPEAR IN THE MOST CURRENT REVISION OF THE AMERICAN ASSOCIATION OF NURSERYMEN'S AMERICAN STANDARD OF NURSERY STOCK ANSI Z60.1.
- 9. BNB TREES SHALL BE DUG WITH A BALL OF SOIL, NOT SOFT BALLED OR POTTED AND SHALL BE FIRM IN THEIR ROOTBALL. ROOT BALL SHALL BE WRAPPED (WITH BIODEGRADABLE MATERIAL). THE TREE ROOT FLARE, OR COLLAR, SHALL BE AT OR WITHIN THE TOP THREE INCHES OF GRADE.
- 10. ALL SPRING TREES MUST BE FRESHLY DUG IN THE SPRING OF 2020.
- 11. ALL AUTUMN TREES MUST BE FRESHLY DUG IN THE AUTUMN OF 2020 IF AVAILABLE AT TIME OF PLANTING.
- 12. TREES SHALL BE ALIVE, HEALTHY AND APPROPRIATELY MOIST, AT TIME OF DELIVERY.
- 13. ALL PLANT MATERIAL SHALL BE INSTALLED IN ACCORDANCE WITH PLANTING DETAILS.
- 14. ALL PLANTING BEDS SHALL HAVE A MINIMUM 10" DEPTH OF PREPARED SOIL. WITH APPROVAL, EXISTING SOIL MAY BE UTILIZED PROVIDED THE PROPER SOIL AMENDMENTS ARE TILLED THOROUGHLY INTO THE TOP 10" OF SOIL. REFER TO SOIL PLACEMENT NOTES.
- 15. WHILE PLANTING TREES AND SHRUBS, BACKFILL \(\frac{2}{3} \) OF PLANTING HOLE AND WATER TREE THOROUGHLY BEFORE INSTALLING THE REMAINDER OF SOIL MIXTURE. AFTER ALL SOIL HAS BEEN PLACED INTO THE PLANTING HOLE WATER THOROUGHLY AGAIN.
- 16. THE CONTRACTOR MUST LABEL ALL TREES WITH THE COMMON AND BOTANICAL NAMES PRIOR TO FINAL INSPECTION.
- 17. ALL PLANTING BEDS SHALL BE MULCHED WITH 3" DEEP SHREDDED HARDWOOD MULCH.
- 18. ALL FINISH GRADING TO BE INSTALLED BY LANDSCAPE CONTRACTOR.
- 19. ALL DISTURBED AREAS WITHIN THE PROJECT SHALL BE RESTORED TO ORIGINAL OR BETTER CONDITION.
- 20. ALL DISTURBED AREAS OUTSIDE THE LIMITS OF WORK SHALL BE RESTORED TO ORIGINAL OR BETTER CONDITION AT NO ADDITIONAL COST TO THE OWNER.
- 21. THE CONTRACTOR SHALL VERIFY ALL EXISTING UTILITIES, INCLUDING ANY IRRIGATION LINES, PRIOR TO DIGGING. CONSULT DIGGERS HOTLINE.
- 22. THE CONTRACTOR SHALL ENSURE THAT SOIL CONDITIONS AND COMPACTION ARE ADEQUATE TO ALLOW FOR PROPER DRAINAGE AROUND THE CONSTRUCTION SITE. UNDESIRABLE CONDITIONS SHALL BE BROUGHT TO THE ATTENTION OF THE LANDSCAPE ARCHITECT PRIOR TO BEGINNING OF WORK. IT SHALL BE THE CONTRACTOR'S RESPONSIBILITY TO ENSURE PROPER SURFACE AND SUBSURFACE DRAINAGE IN ALL AREAS
- 23. THE CONTRACTOR IS RESPONSIBLE FOR ALL PERMITS, FEES, AND LICENSES NECESSARY FOR THE INSTALLATION OF THIS PLAN.
- 24. THE CONTRACTOR IS TO REVIEW ALL SITE ENGINEERING DOCUMENTS PRIOR TO INSTALLATION. ANY CONFLICTS MUST BE REPORTED TO THE LANDSCAPE ARCHITECT. THESE LANDSCAPE DRAWINGS ARE FOR THE INSTALLATION OF PLANT MATERIALS ONLY UNLESS OTHERWISE STATED.
- 25. THE CONTRACTOR SHALL PROVIDE WATERING AND MAINTENANCE SERVICES FOR A PERIOD OF 60 DAYS TO ENSURE VEGETATIVE ESTABLISHMENT. UPON COMPLETION OF THE PROJECT, CONTRACTOR SHALL SUPPLY THE OWNER IN WRITING WITH ONGOING WATERING AND MAINTENANCE INSTRUCTIONS.
- 26. PLANT MATERIALS SHALL BE GUARANTEED FOR A PERIOD OF ONE (1) YEAR FROM TIME OF OWNER ACCEPTANCE. ONLY ONE REPLACEMENT PER PLANT WILL BE
- REQUIRED DURING THE WARRANTY PERIOD EXCEPT IN THE EVENT OF FAILURE TO COMPLY WITH THE SPECIFIED REQUIREMENTS.


 27. THE CONTRACTOR IS RESPONSIBLE TO CONDUCT A FINAL WALK THROUGH WITH THE LANDSCAPE ARCHITECT AND OR OWNERS REPRESENTATIVE TO ANSWER QUESTIONS, PROVIDE INSTRUCTIONS, AND ENSURE THAT PROJECT REQUIREMENTS HAVE BEEN MET.

SOIL PLACEMENT NOTES

1. LOOSEN SUBGRADE TO A MINIMUM DEPTH INDICATED IN PLANTING NOTES USING A CULTI-MULCHER OR SIMILAR EQUIPMENT, AND REMOVE STONES MEASURING OVER 1-1/2 INCHES IN ANY DIMENSION, STICKS, RUBBISH AND OTHER EXTRANEOUS MATTER.

- 2. THOROUGHLY BLEND PLANTING SOIL MIX FOR PLANTING BED AREAS. (1 PART EXISTING SOIL, 1 PART TOPSOIL, 1 PART ORGANIC SOIL AMENDMENT, 2.9 POUNDS PER CUBIC YARD OF 4-4-4 ANALYSIS SLOW-RELEASE FERTILIZER)
- 3. TREE AND SHRUB HOLES SHALL BE FILLED WITH A PREPARED PLANTING MIXTURE OF 1 PART TOPSOIL, 2 PARTS PLANTING SOIL MIX.
- 4. SPREAD SOIL AND SOIL AMENDMENTS TO DEPTH INDICATED ON DRAWINGS, BUT NOT LESS THAN REQUIRED TO MEET FINISH GRADES AFTER NATURAL SETTLEMENT. (FINISH GRADE OF PLANTING BEDS SHALL BE 3" BELOW ALL ADJACENT SURFACES.
- 5. PLACE APPROXIMATELY 1/2 OF TOTAL AMOUNT OF SOIL REQUIRED. WORK INTO TOP OF LOOSENED SUBGRADE TO CREATE A TRANSITION LAYER, THEN PLACE REMAINDER OF THE SOIL. SOIL TRANSITION LAYER SHALL BE TILLED TO A MINIMUM DEPTH OF 6" BELOW THE DEPTH OF NEWLY PLACED SOIL.
- 6. DO NOT SPREAD IF PLANTING SOIL OR SUBGRADE IS FROZEN, MUDDY, OR EXCESSIVELY WET.
- 7. FINISH GRADING: GRADE SOIL TO A SMOOTH, UNIFORM SURFACE PLANE WITH A LOOSE, UNIFORMLY FINE TEXTURE.
- 8. ROLL AND RAKE, REMOVE RIDGES, AND FILL DEPRESSIONS TO MEET FINISH GRADES.
- 9. RESTORE PLANTING BEDS IF ERODED OR OTHERWISE DISTURBED AFTER FINISH GRADING AND BEFORE PLANTING.

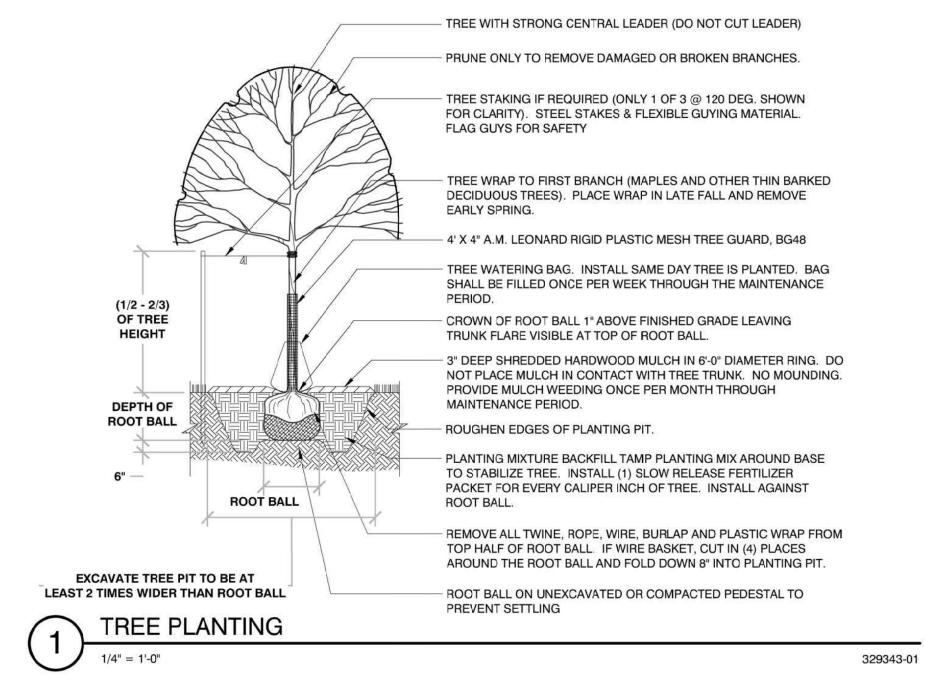

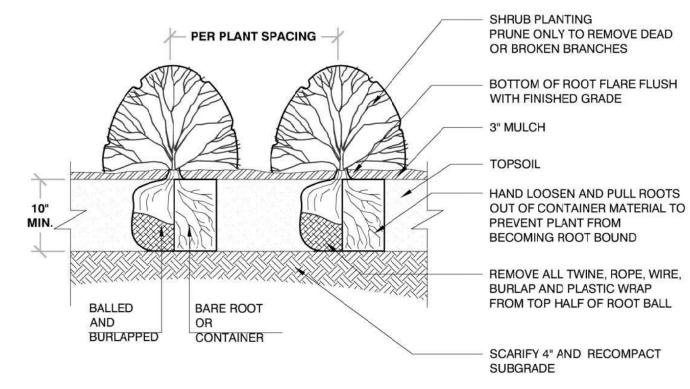

2248 DEMING WAY, SUITE 120
MIDDLETON, WI 53562
608-829-1750
608-829-3056 (FAX)

PINNACLE ENGINEERING GROUP
ENGINEERING I NATURAL RESOURCES I SURVEYING
WISCONSIN OFFICE:
20725 WATERTOWN ROAD, SUITE 100

BROOKFIELD, WI 53186

(262) 754-8888

PLAN | DESIGN | DELIVER


CHICAGO I MILWAUKEE : NATIONWID www.pinnacle-engr.com

REROOT PLANTING NOTES:


SOAK ROOTS IN WATER FOR AT LEAST ONE HOUR BUT NOT MORE THAN 24 HOURS PRIOR TO PLANTING.
SCARIFY SIDES AND BOTTOMS OF HOLE.


PROCEED WITH CORRECTIVE PRUNING OF THE TOP AND BOTTOM ROOTS.
TRANSFER PLANT DIRECTLY FROM WATER TO HOLE. SET PLANT SO THE ROOT FLARE IS
APPROXIMATELY AT THE FINISHED SOIL ELEVATION. SPREAD ROOTS OUT EVENLY. PLUMB AND
IMMEDIATELY BACKFILL WITH PLANTING SOIL MIX.

BACKFILL VOIDS AND WATER SECOND TIME.
 PLACE MULCH WITHIN 48 HOURS OF THE SECOND WATERING UNLESS SOIL MOISTURE IS EXCESSIVE.

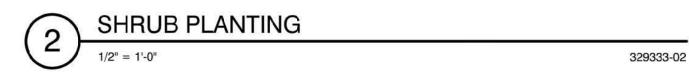

WATER THOROUGHLY WITHIN 2 HOURS TO SETTLE PLANTS AND FILL VOIDS.

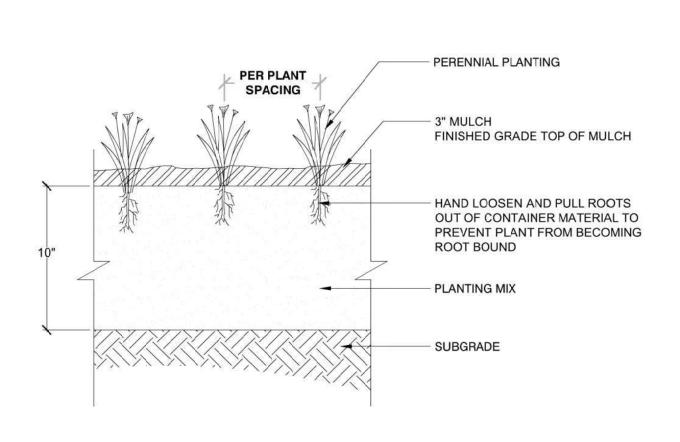


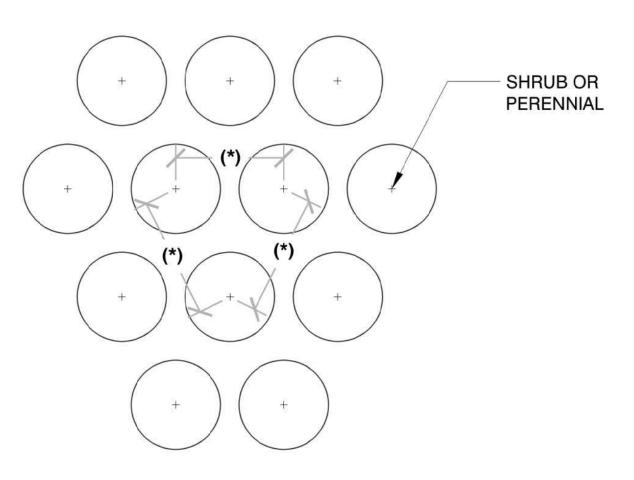


(*) = SPECIFIED PLANT SPACING PER PLANTING LIST



329413-02

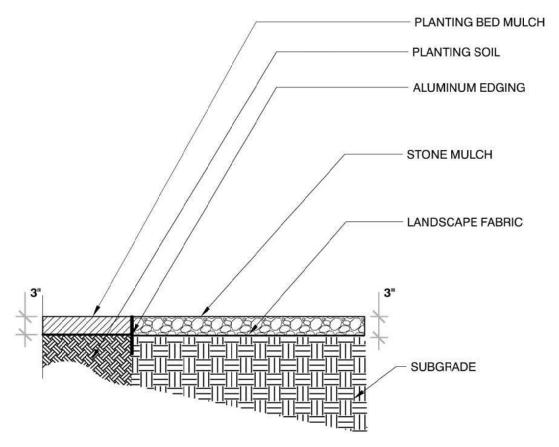

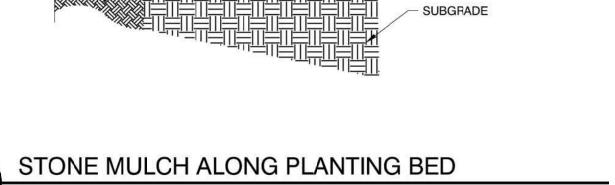

MOXY HOTEL

825 E. WASHINGTON AVENUE

MADISON, WI 53703

CLIENT:

NORTH CENTRAL GROU

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 PROJECT:
 201926

 DRAWN BY:
 DJB

 DATE:
 4/1/20


 SCALE:
 NTS

 PC & UDC
 04/01/2020

 PC & UDC
 05/18/2020

LANDSCAPE NOTES & DETAILS

2.0

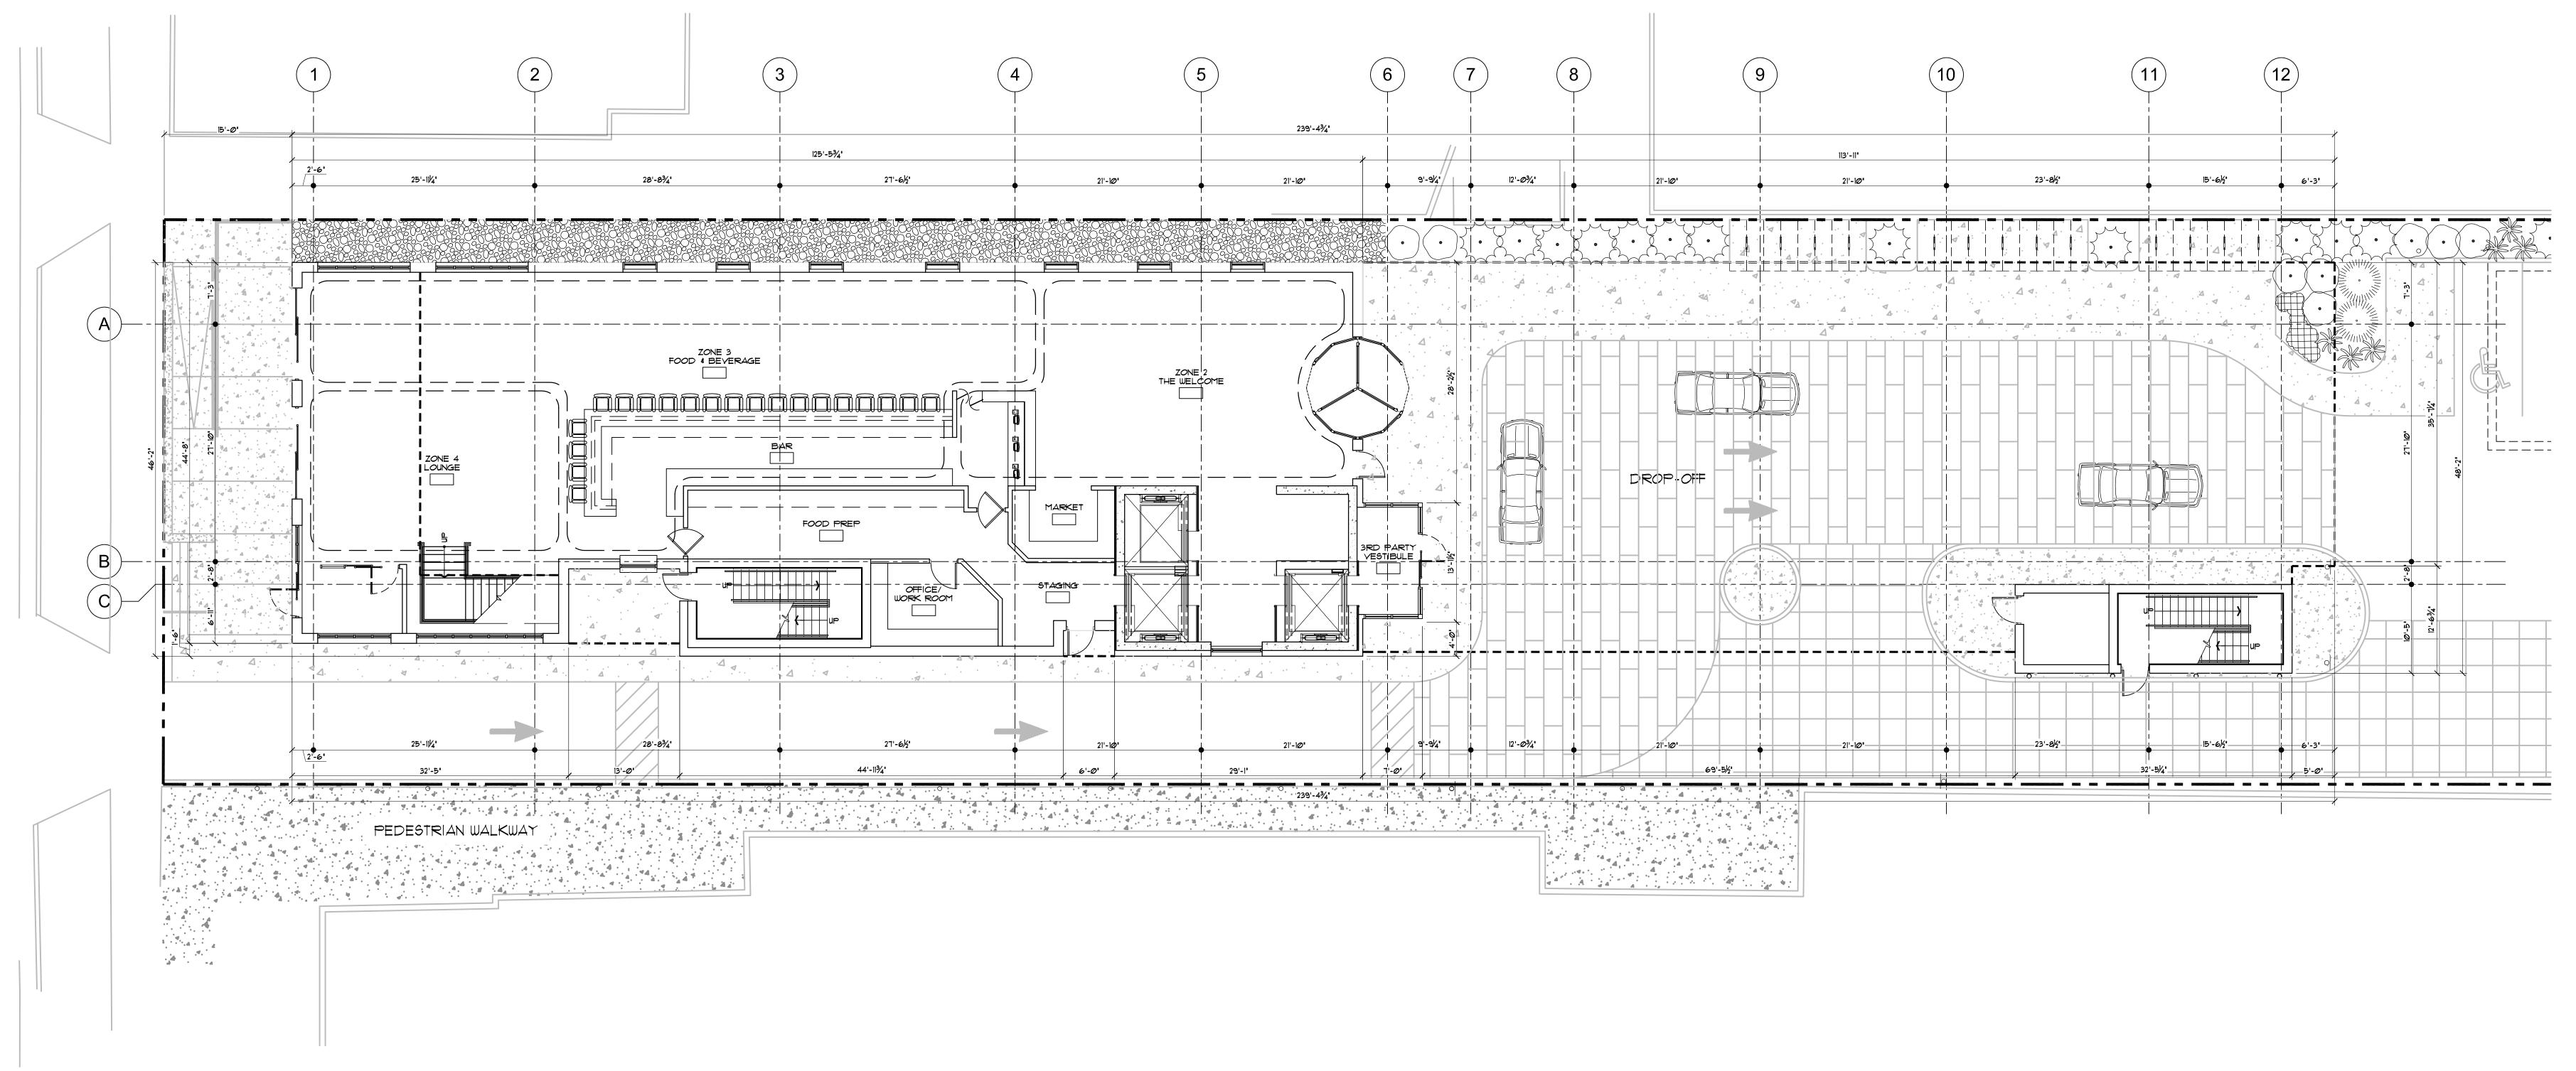

PROJECT:

MOXY HOTEL
825 E. WASHINGTON AVENUE
MADISON, WI 53703
CLIENT:
NORTH CENTRAL GROUP
C/O MM EAST WASHINGTON, LLC
1600 ASPEN COMMONS, SUITE 200
MIDDLETON, WI 53562

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PROJECT: 201926

DRAWN BY: DSD

DATE: Ø5/18/2Ø2Ø


SCALE: AS NOTED

 SCALE:
 AS NOTED

 PC & UDC
 04/01/2020

 PC & UDC
 05/18/2020

FIRST FLOOR PLAN

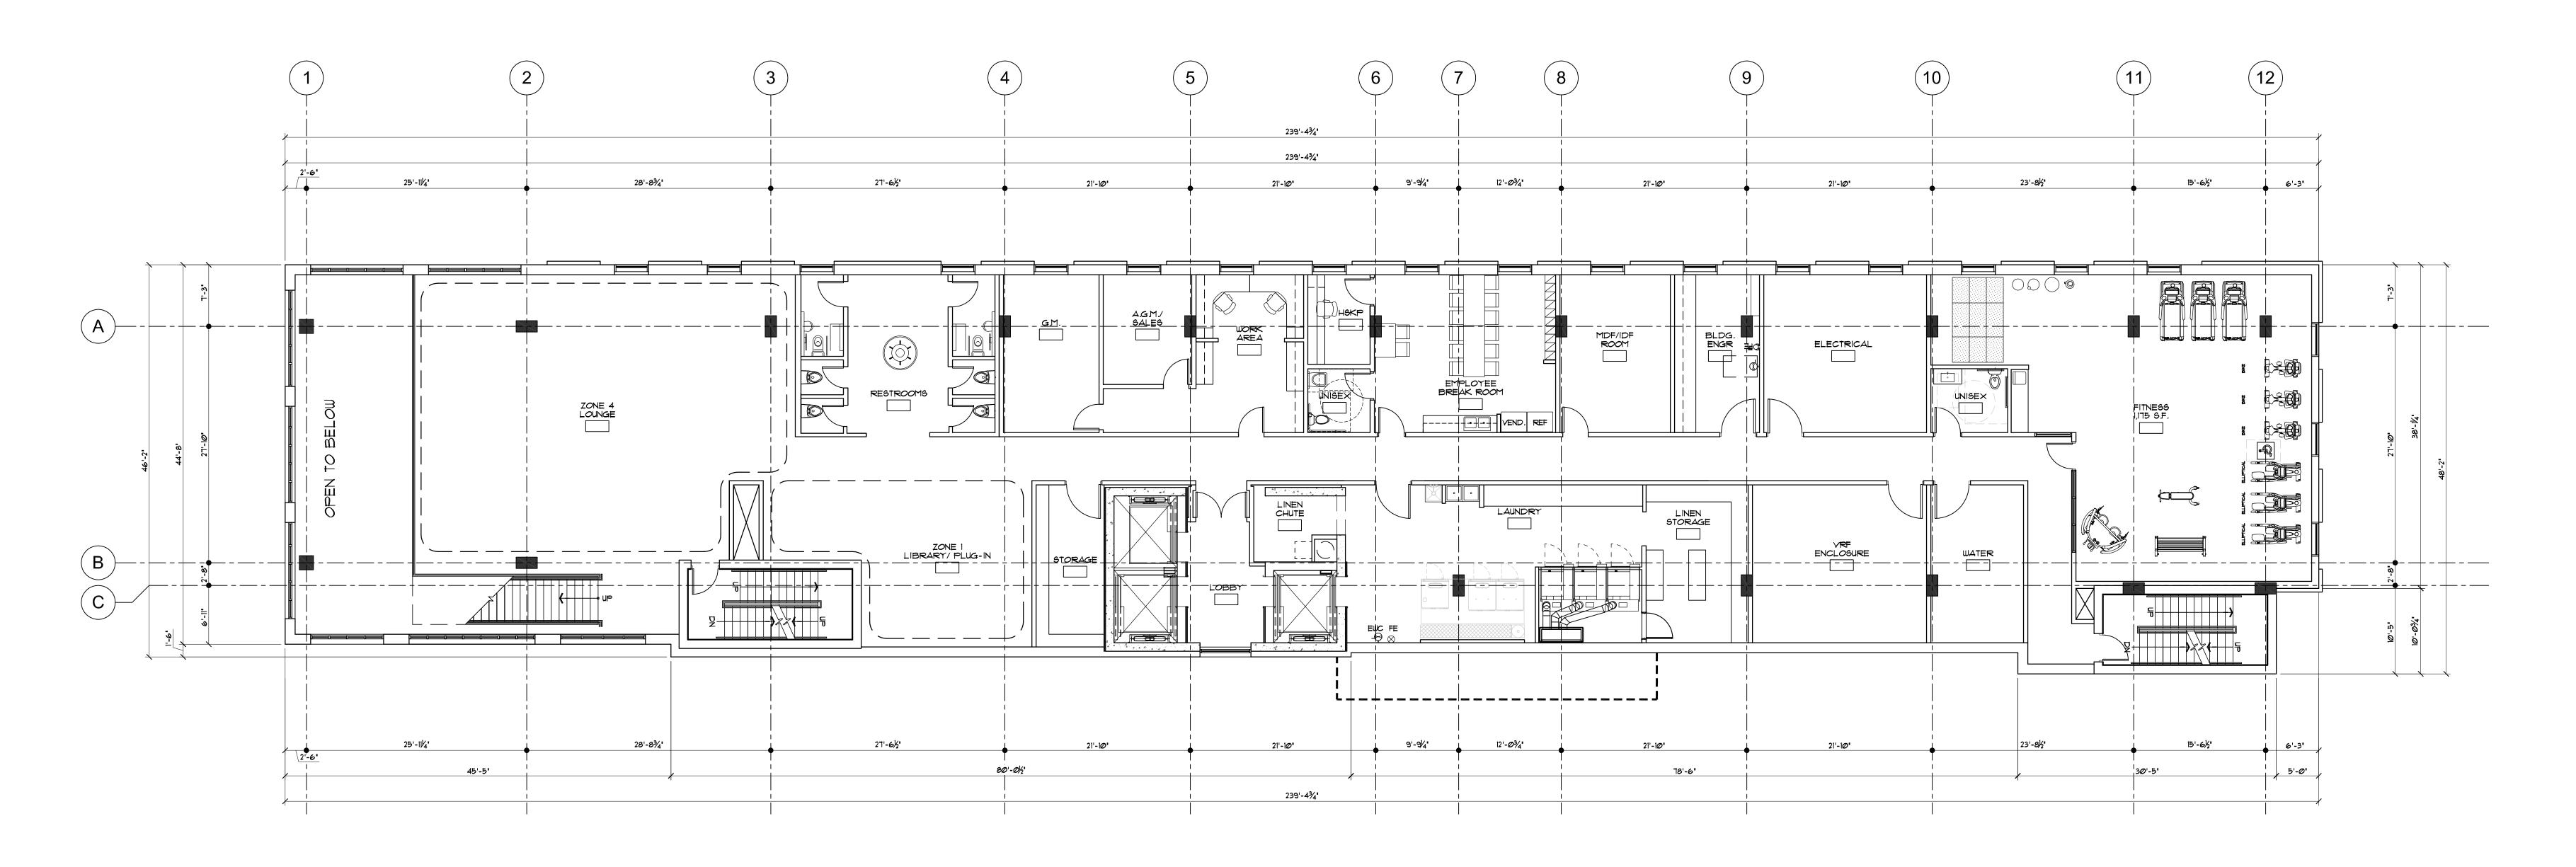

PROJECT:

MOXY HOTEL
825 E. WASHINGTON AVENUE
MADISON, WI 53703
CLIENT:

NORTH CENTRAL GROUP
C/O MM EAST WASHINGTON, LLC
1600 ASPEN COMMONS, SUITE 200
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PROJECT: 201926

DRAWN BY: DSD

DRAWN BY: DSD

DATE: 05/18/2020

SCALE: AS NOTED


PC & UDC 04/01/2020

PC & UDC 05/18/2020

2ND FLOOR PLAN 0' 4' 8' 16' 24'

SCALE: 1/8' = 1'-0'

SECOND FLOOR PLAN

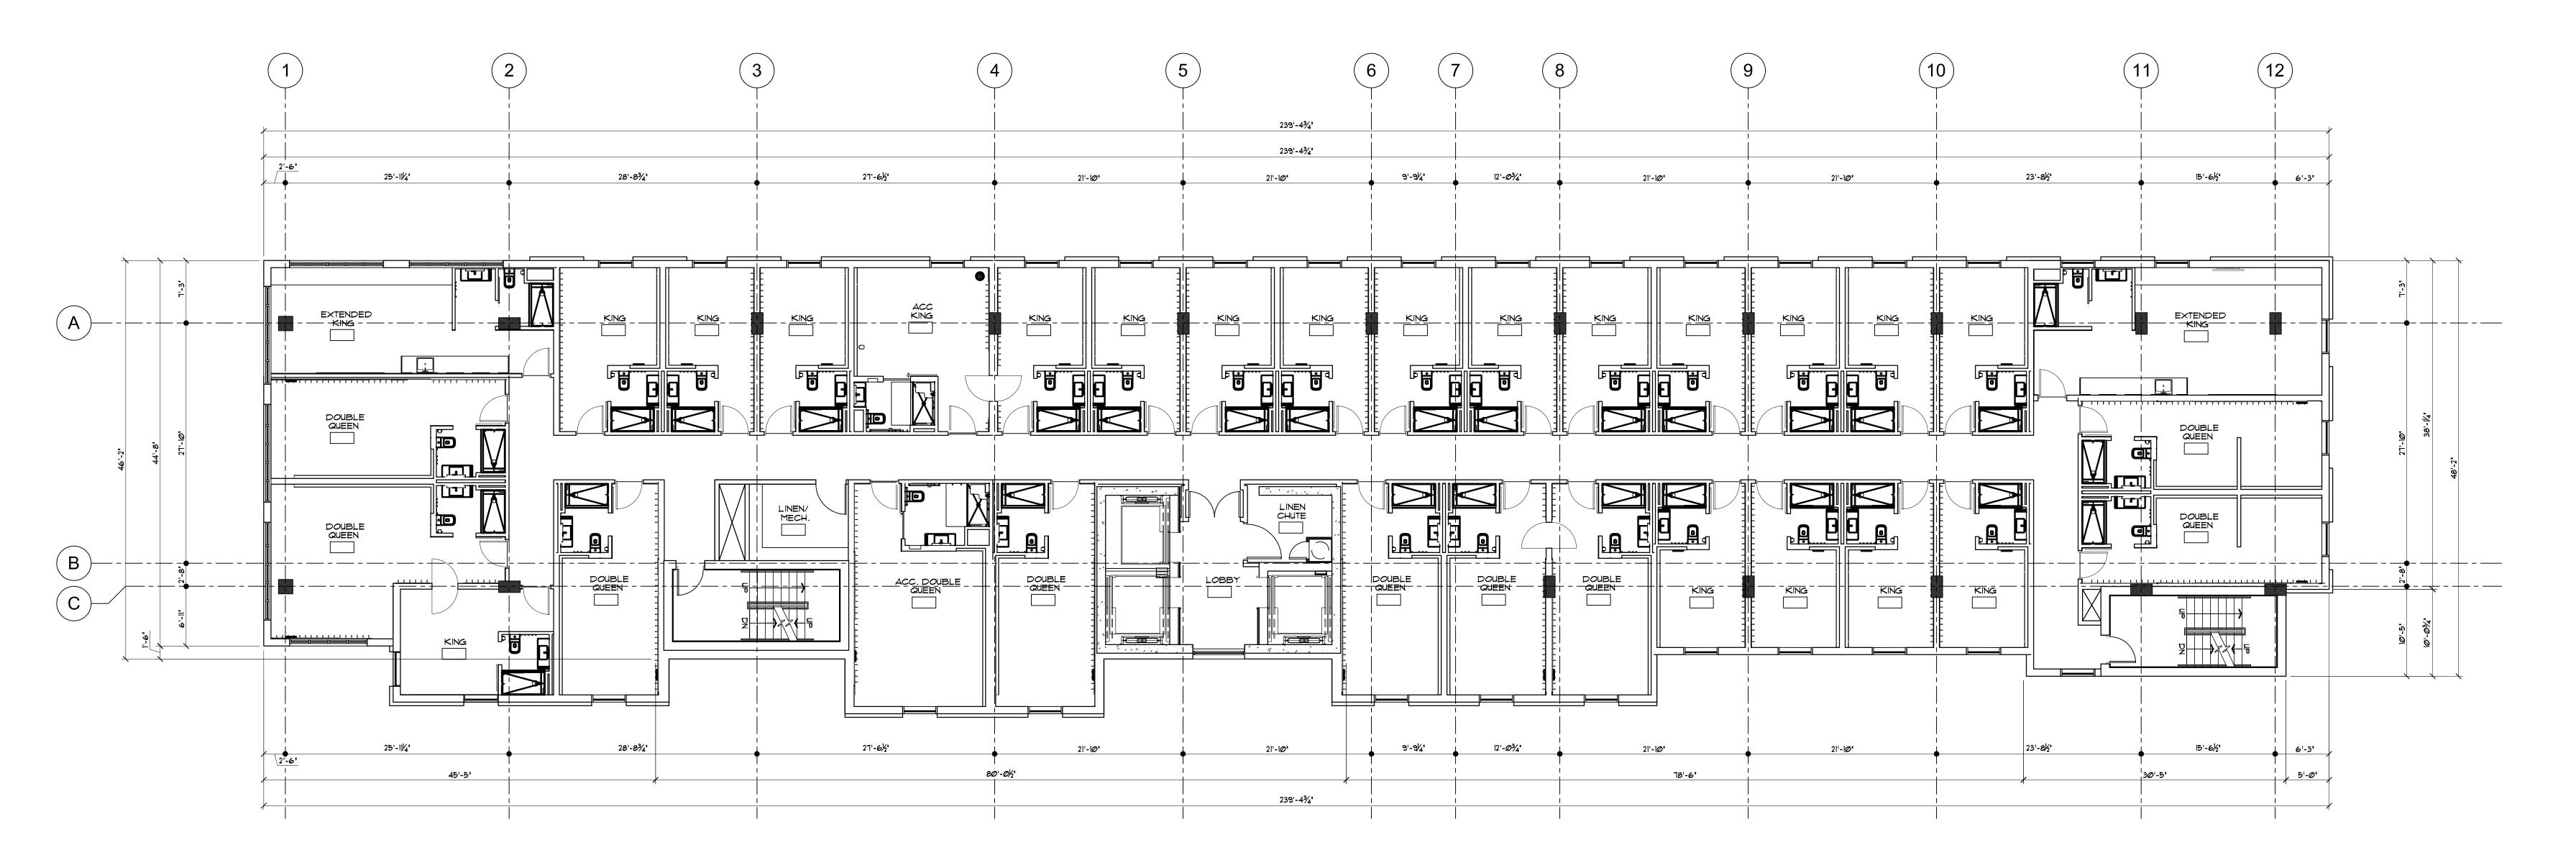

3RD - 5TH
FLOOR PLAN

GCALE: 1/8' = 1'-@'

MOXY HOTEL
825 E. WASHINGTON AVENUE
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PROJECT: 201926

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 DSD


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 SCALE:
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 PC & UDC
 Ø4/Ø1/2@2@

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3RD - 5TH FLOOR PLAN



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 SCALE:
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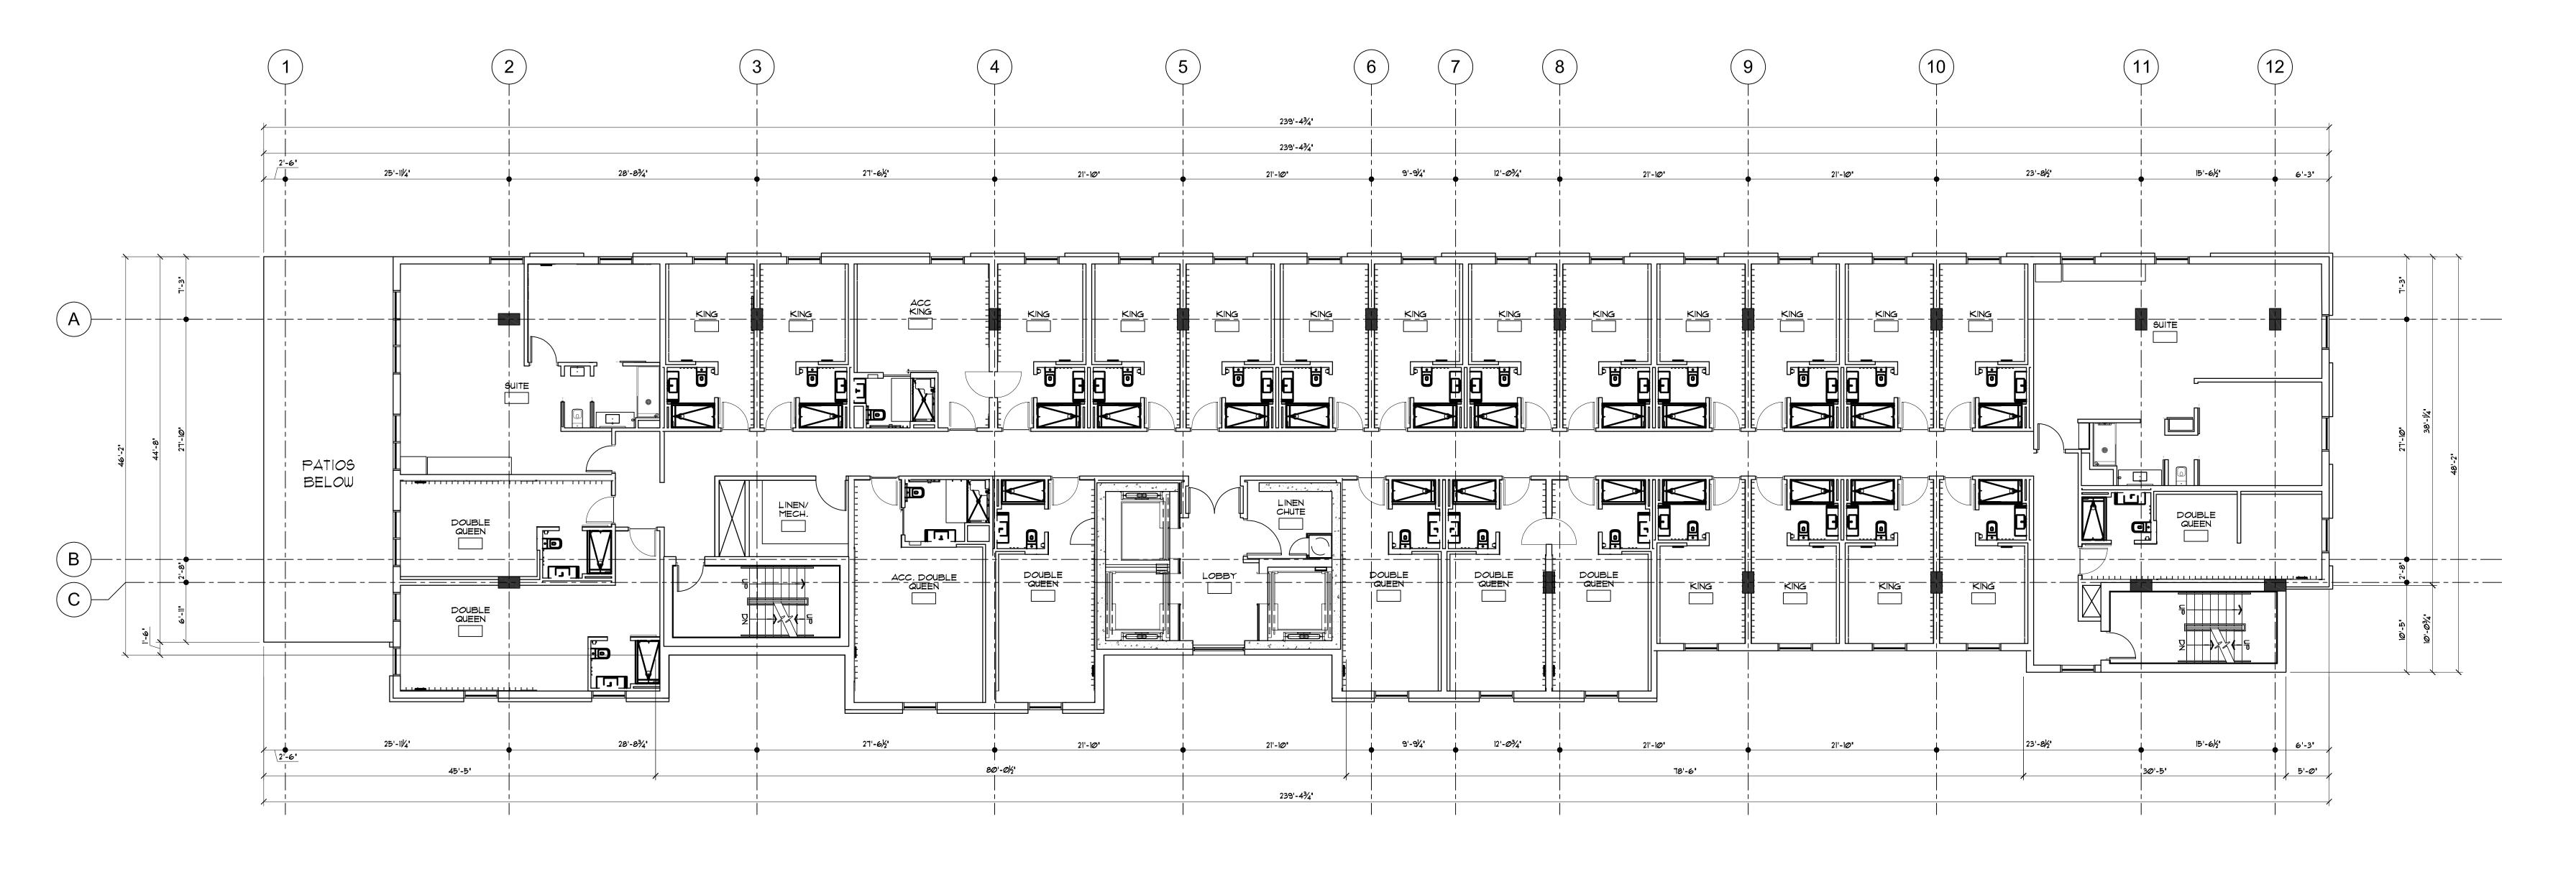
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 05/18/2020

6TH FLOOR PLAN 0 4 8 1 6 24 5 5 CALE: 1/8' = 1'-0'

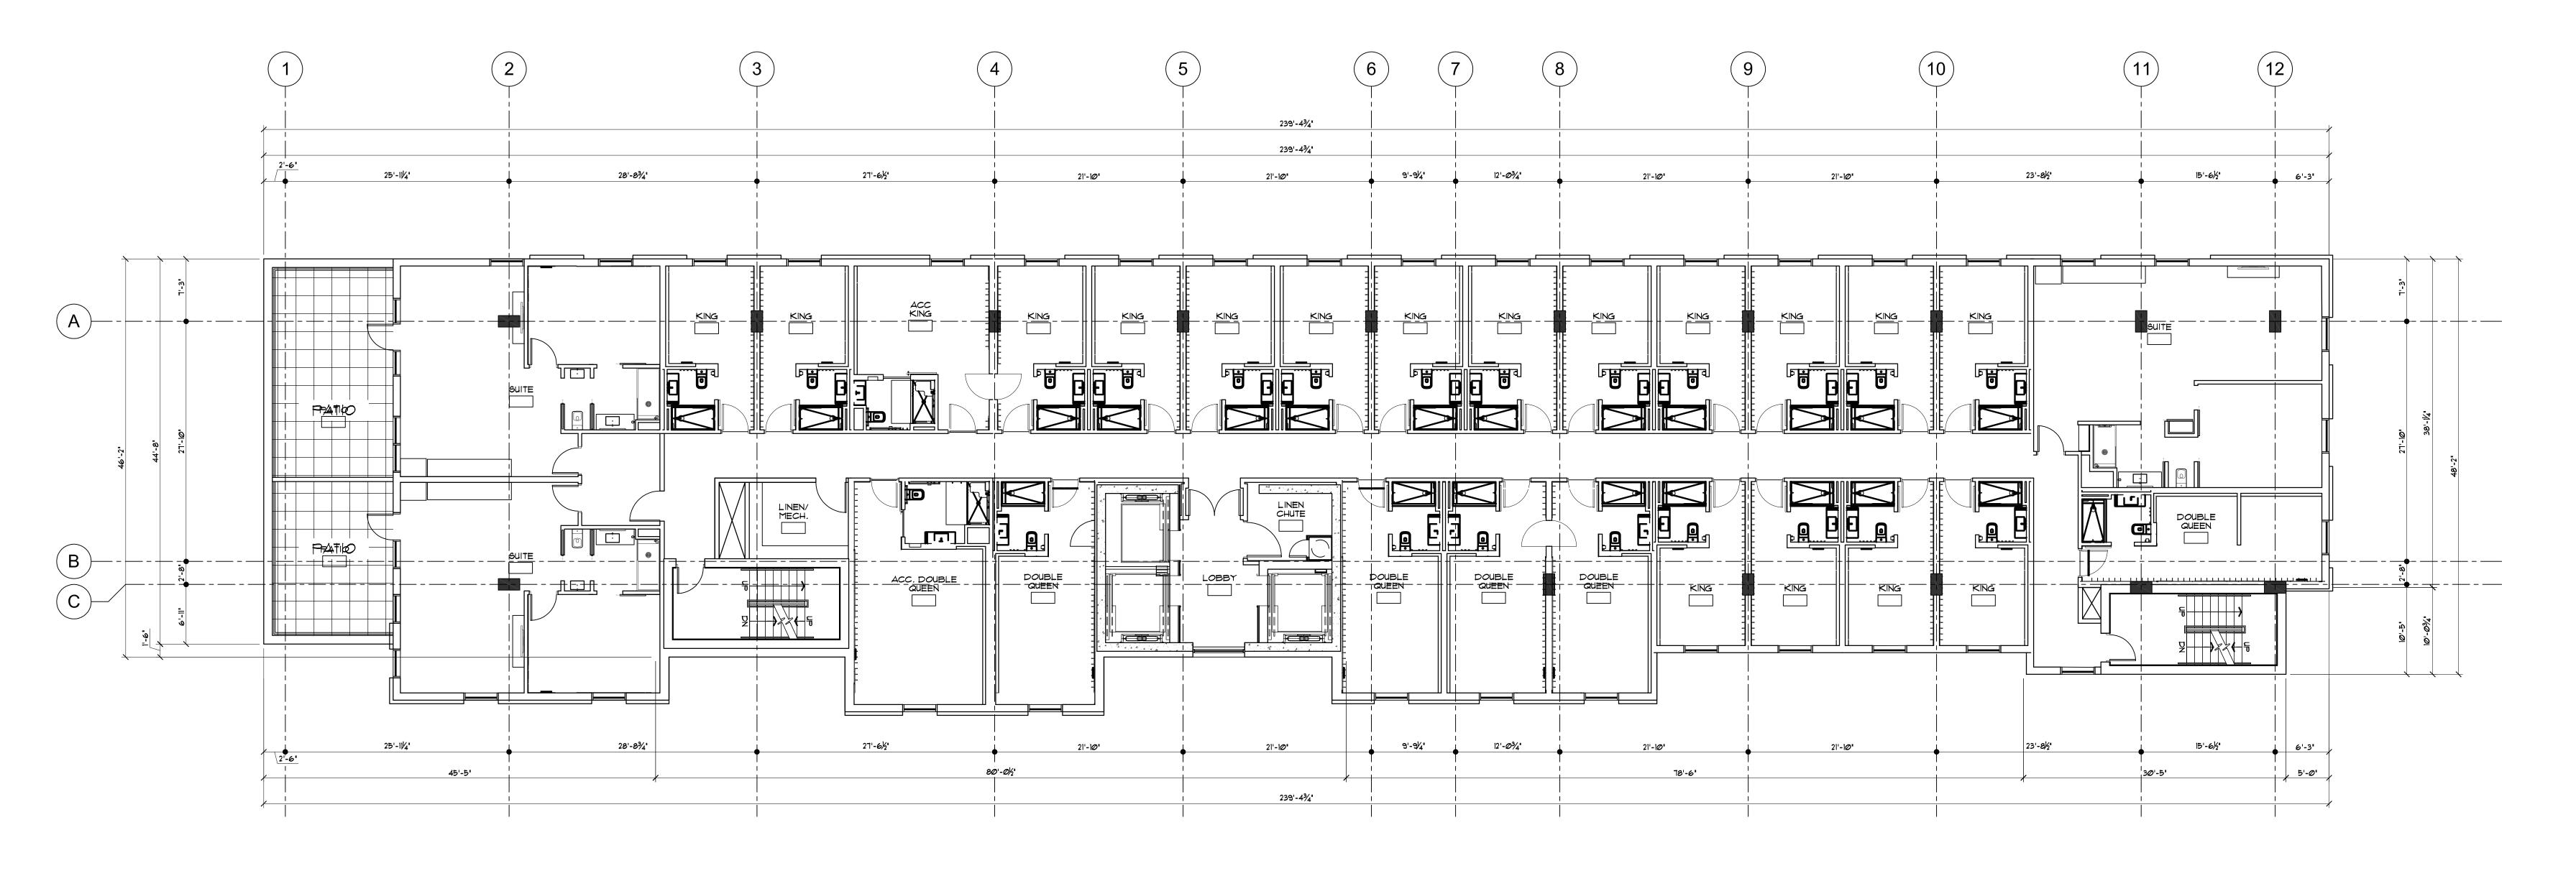6TH FLOOR PLAN



MOXY HOTEL

825 E. WASHINGTON AVENUE
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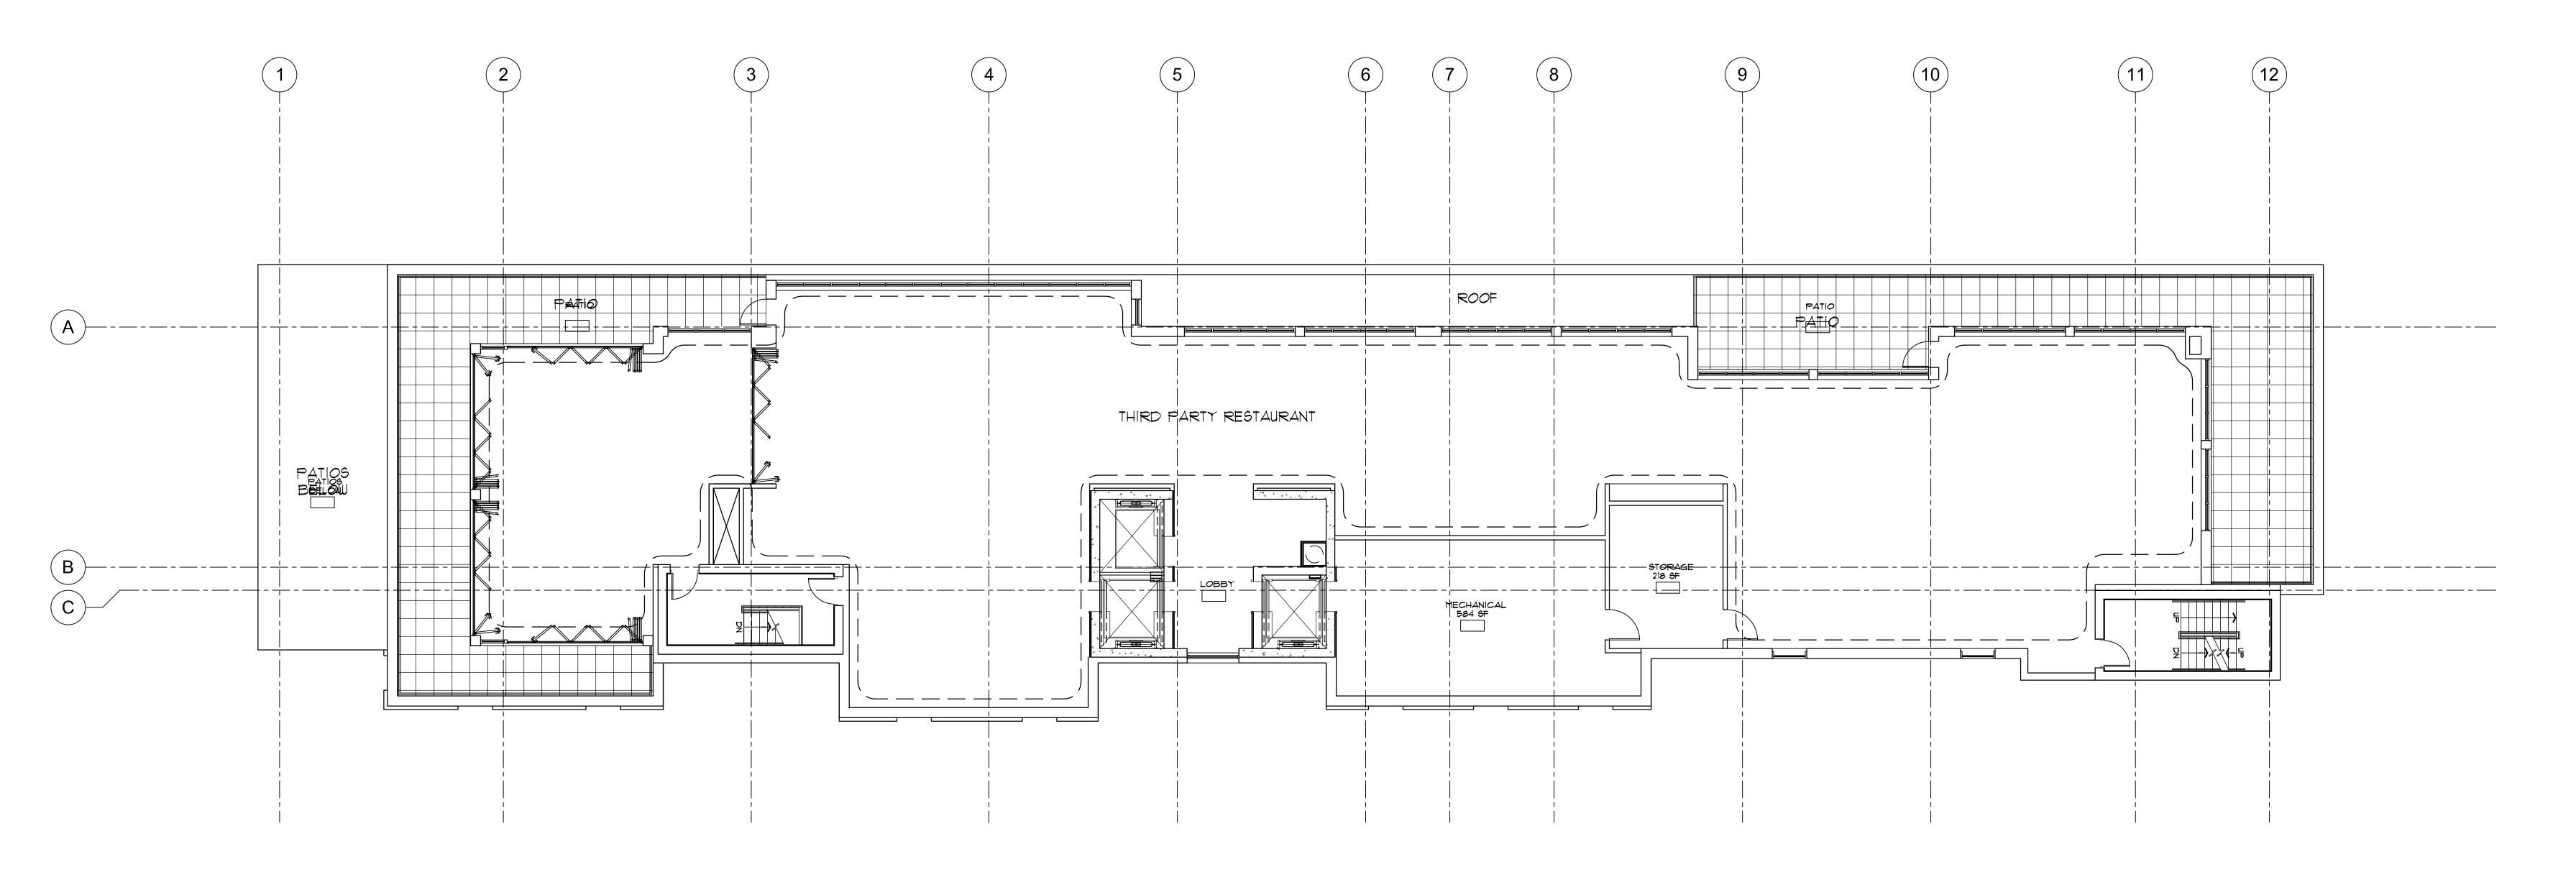
 SCALE:
 AS NOTED

PC & UDC 04/01/2020
PC & UDC 05/18/2020

7TH FLOOR PLAN 0' 4' 8' 16' 24'

SCALE: 1/8' = 1'-0'

7TH FLOOR PLAN



PROJECT:

MOXY HOTEL

825 E. WASHINGTON AVENUE
MADISON, WI 53703
CLIENT:

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 PROJECT:
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 DRAWN BY:
 DSD

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 SCALE:
 AS NOTED


 PC & UDC
 Ø4/Ø1/2@2@

Ø5/18/2Ø2Ø

8TH FLOOR PLAN 0' 4' 8' 16' 24'

8TH FLOOR PLAN



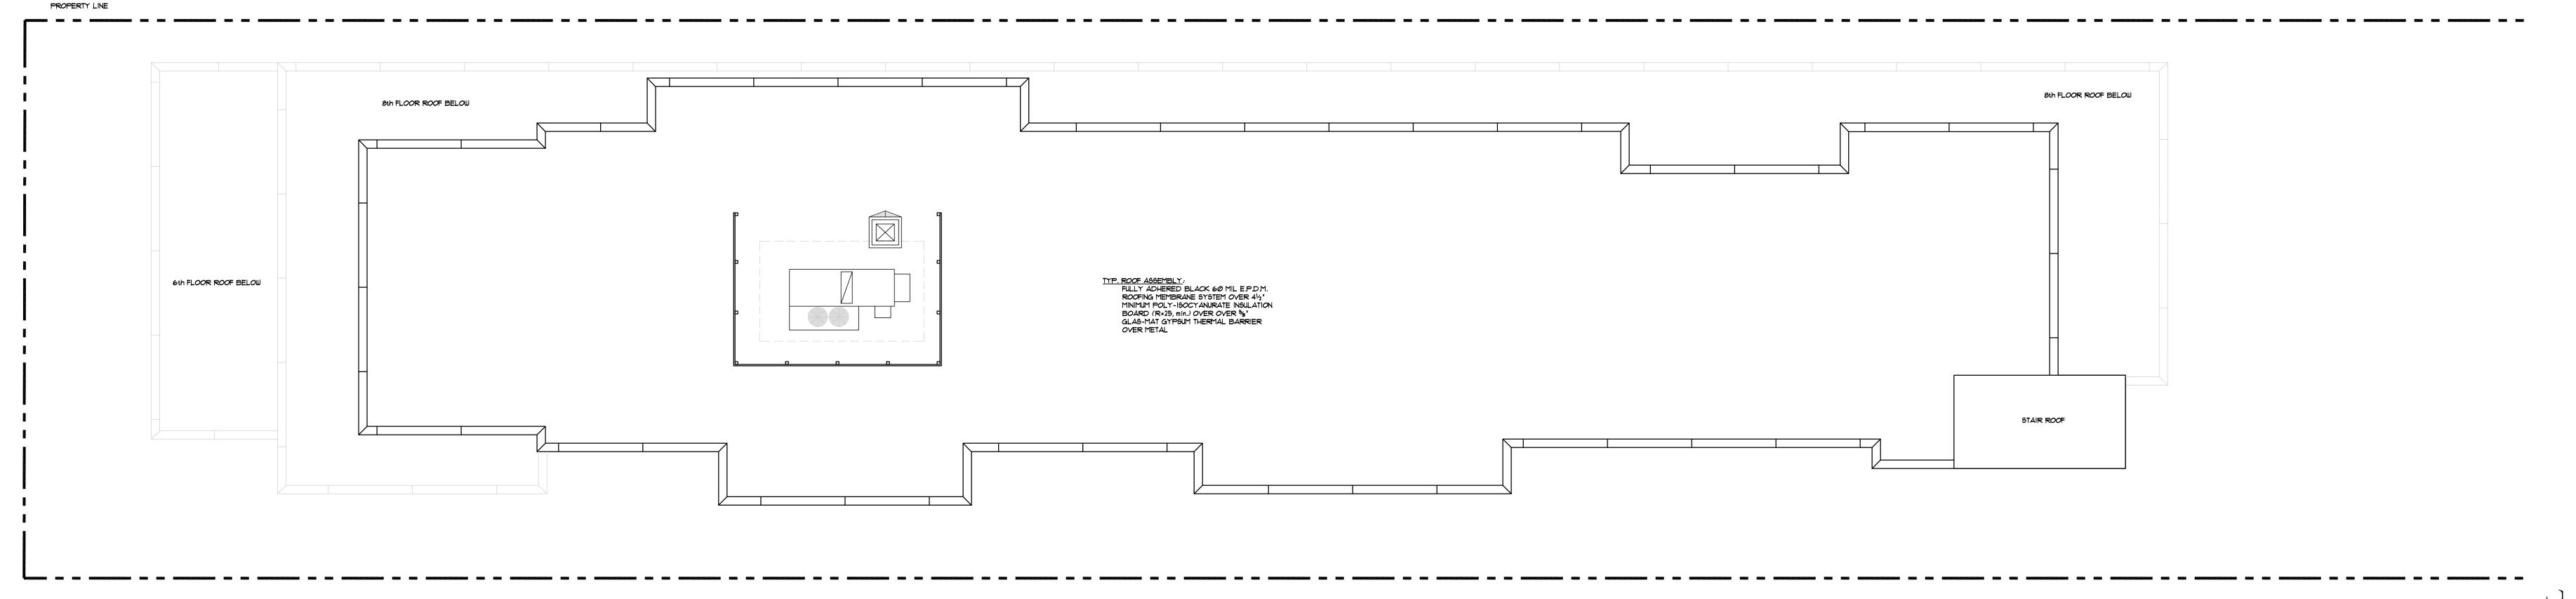

PROJECT:

MOXY HOTEL
825 E. WASHINGTON AVENUE
MADISON, WI 53703
CLIENT:

NORTH CENTRAL GROUP
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PROJECT: DRAWN BY: DSD
 DATE:
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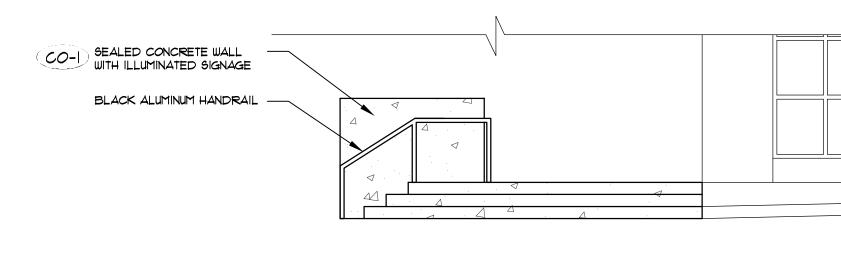
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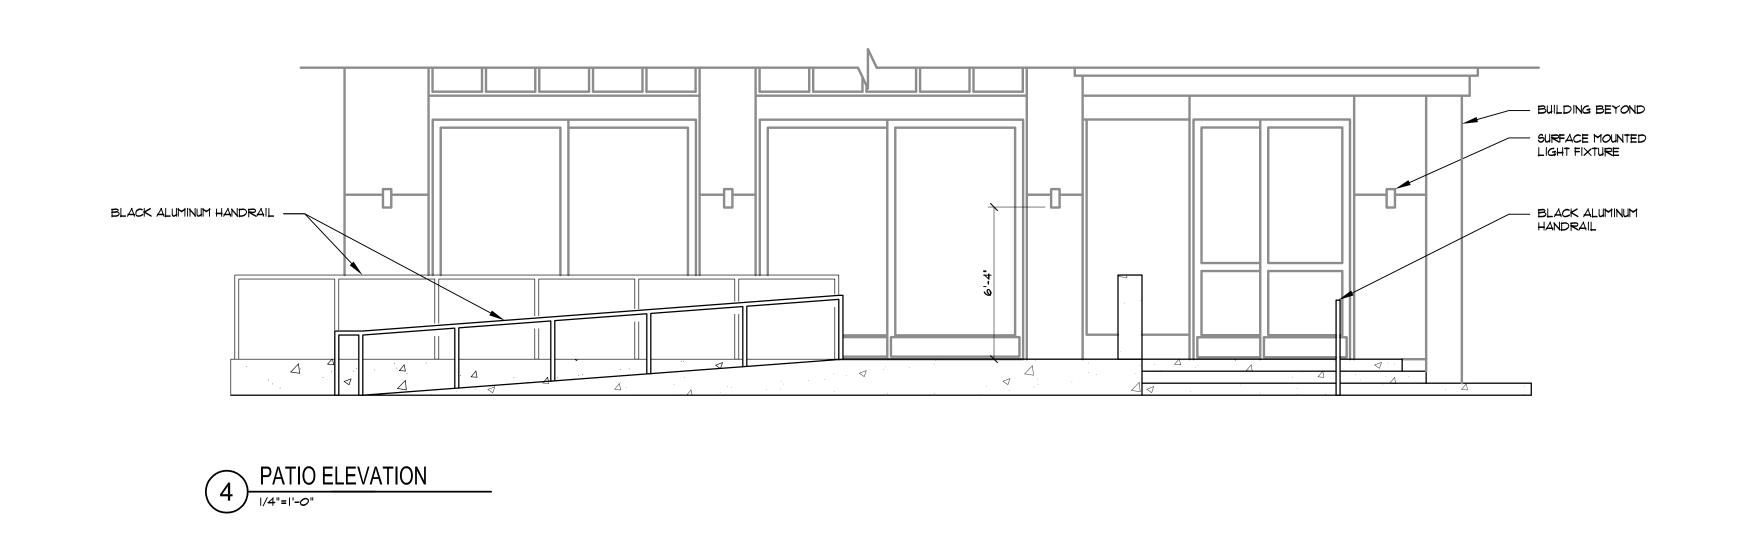
ROOF PLAN


SCALE: 1/8' = 1'-0'

ROOF PLAN




PATIO ELEVATION 1/4"=1'-0"



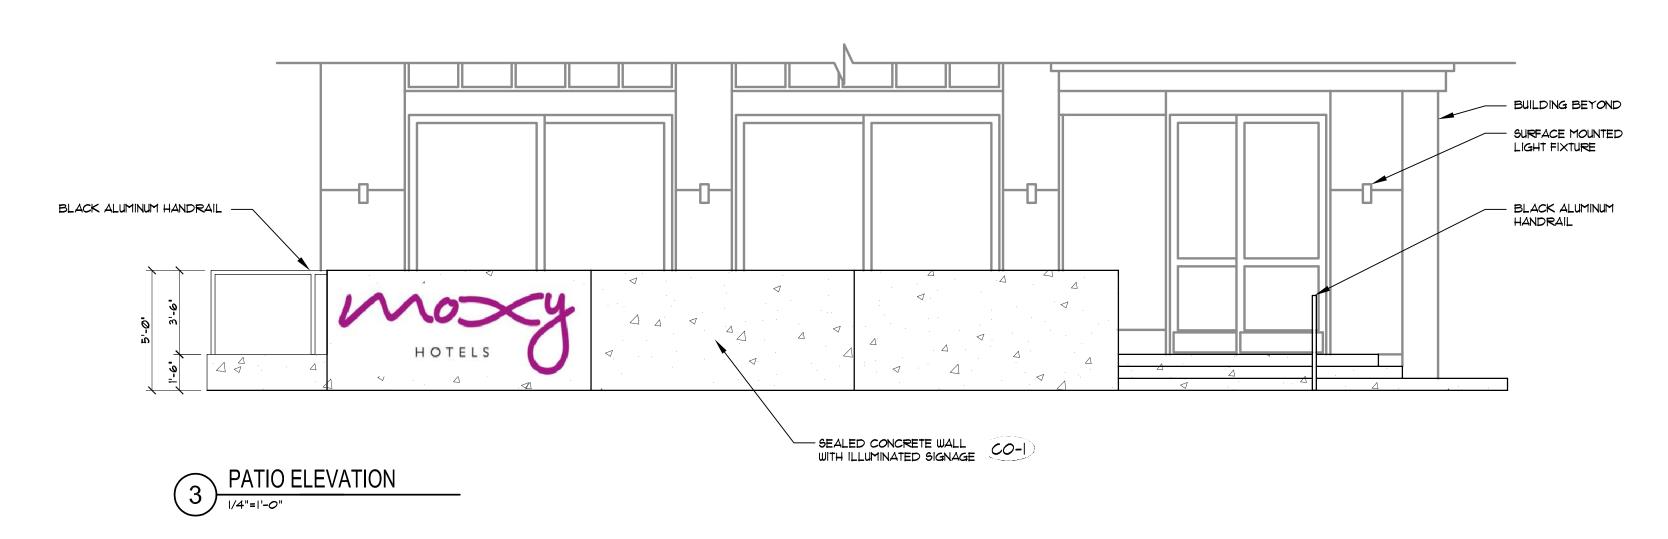



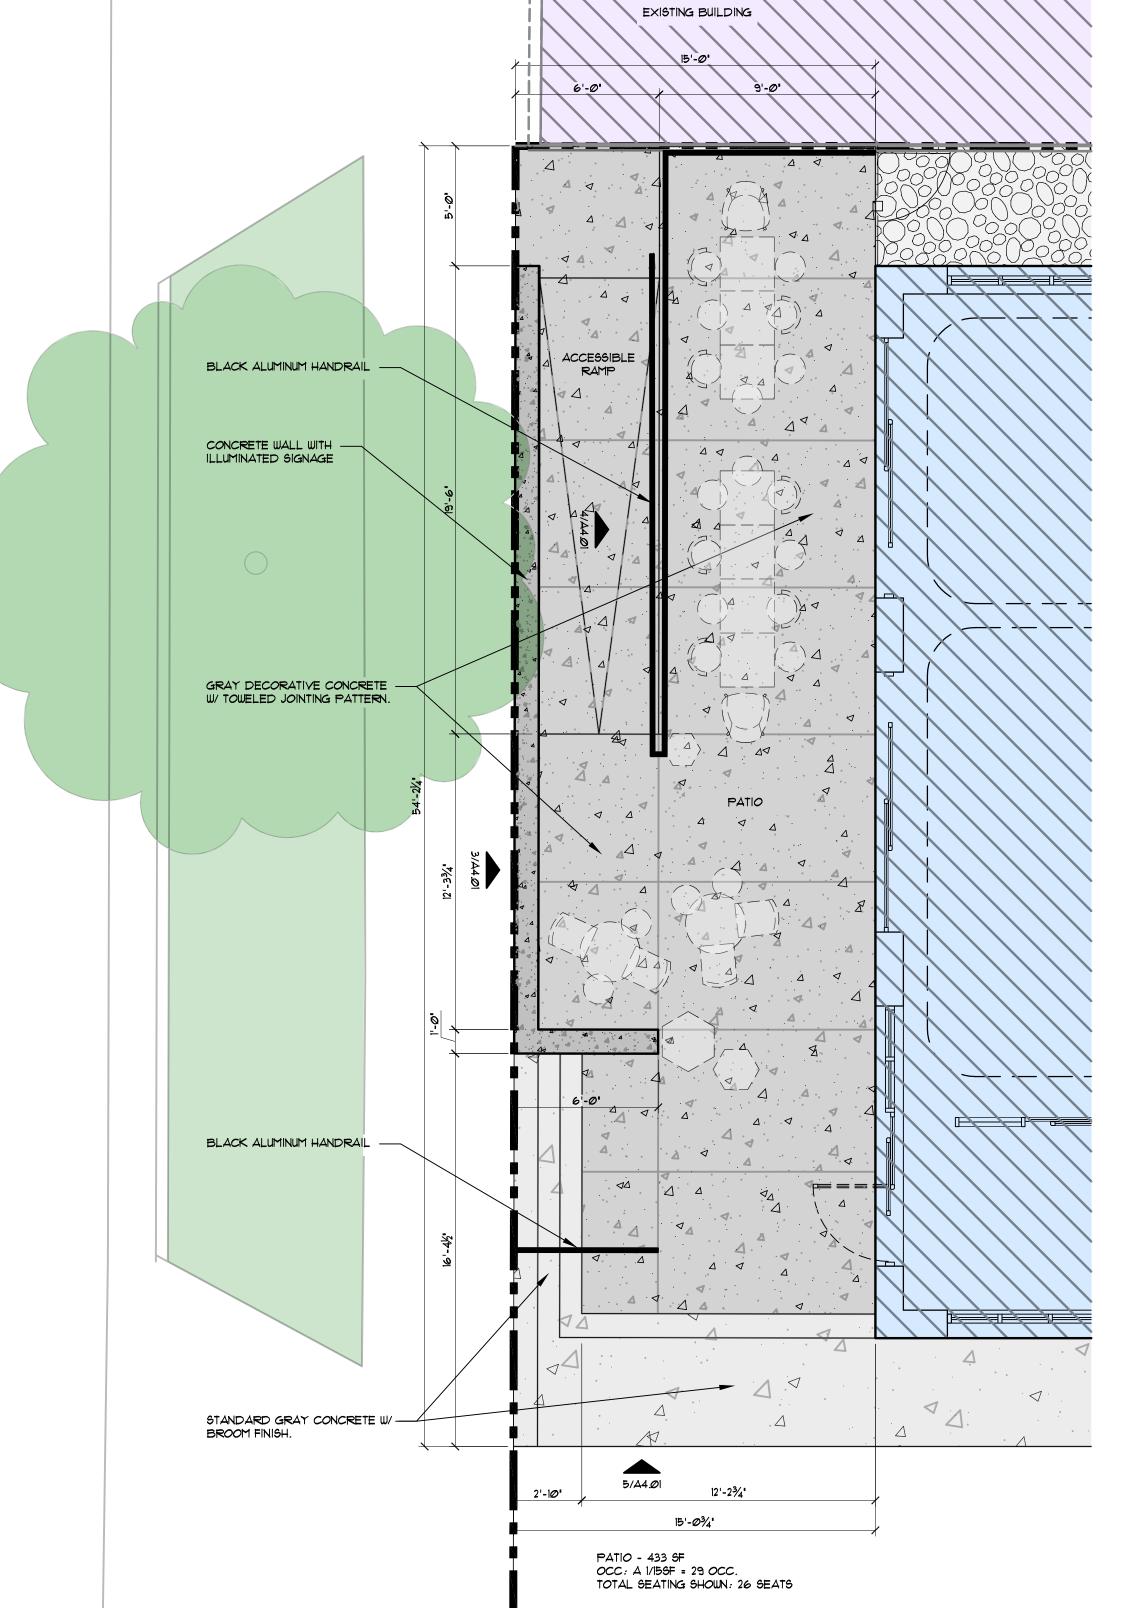

PROJECT:

MOXY HOTEL

825 E. WASHINGTON AVENUE

MADISON, WI 53703

CLIENT:

NORTH CENTRAL GROUP

C/O MIM EAST WASHINGTON, MI 53562

1600 ASPEN COMMONS, SUITE 200

MIDDLETON, WI 53562

PROJECT: 201926

DRAWN BY: DSD


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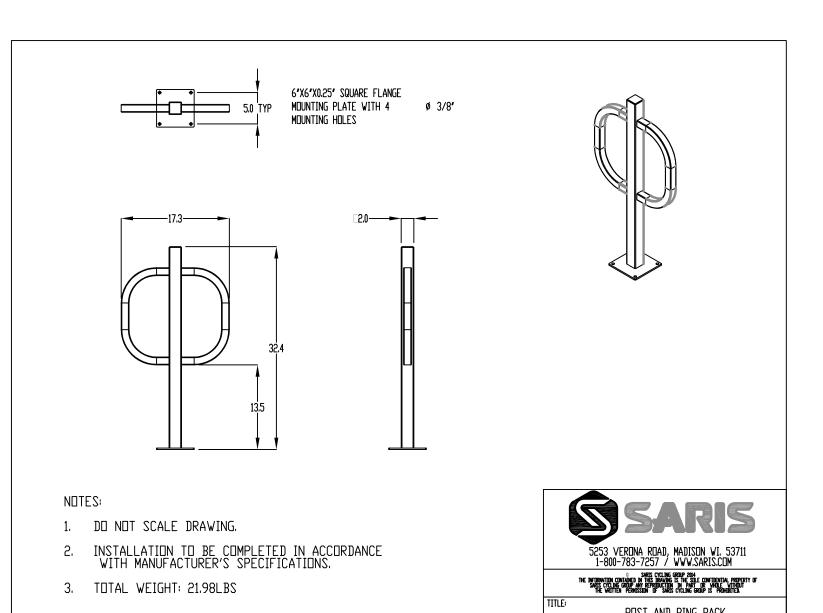
SCALE: AS NOTED

PC & UDC Ø4/01/2020

PC & UDC Ø5/18/2020

PATIO FLOOR PLANS




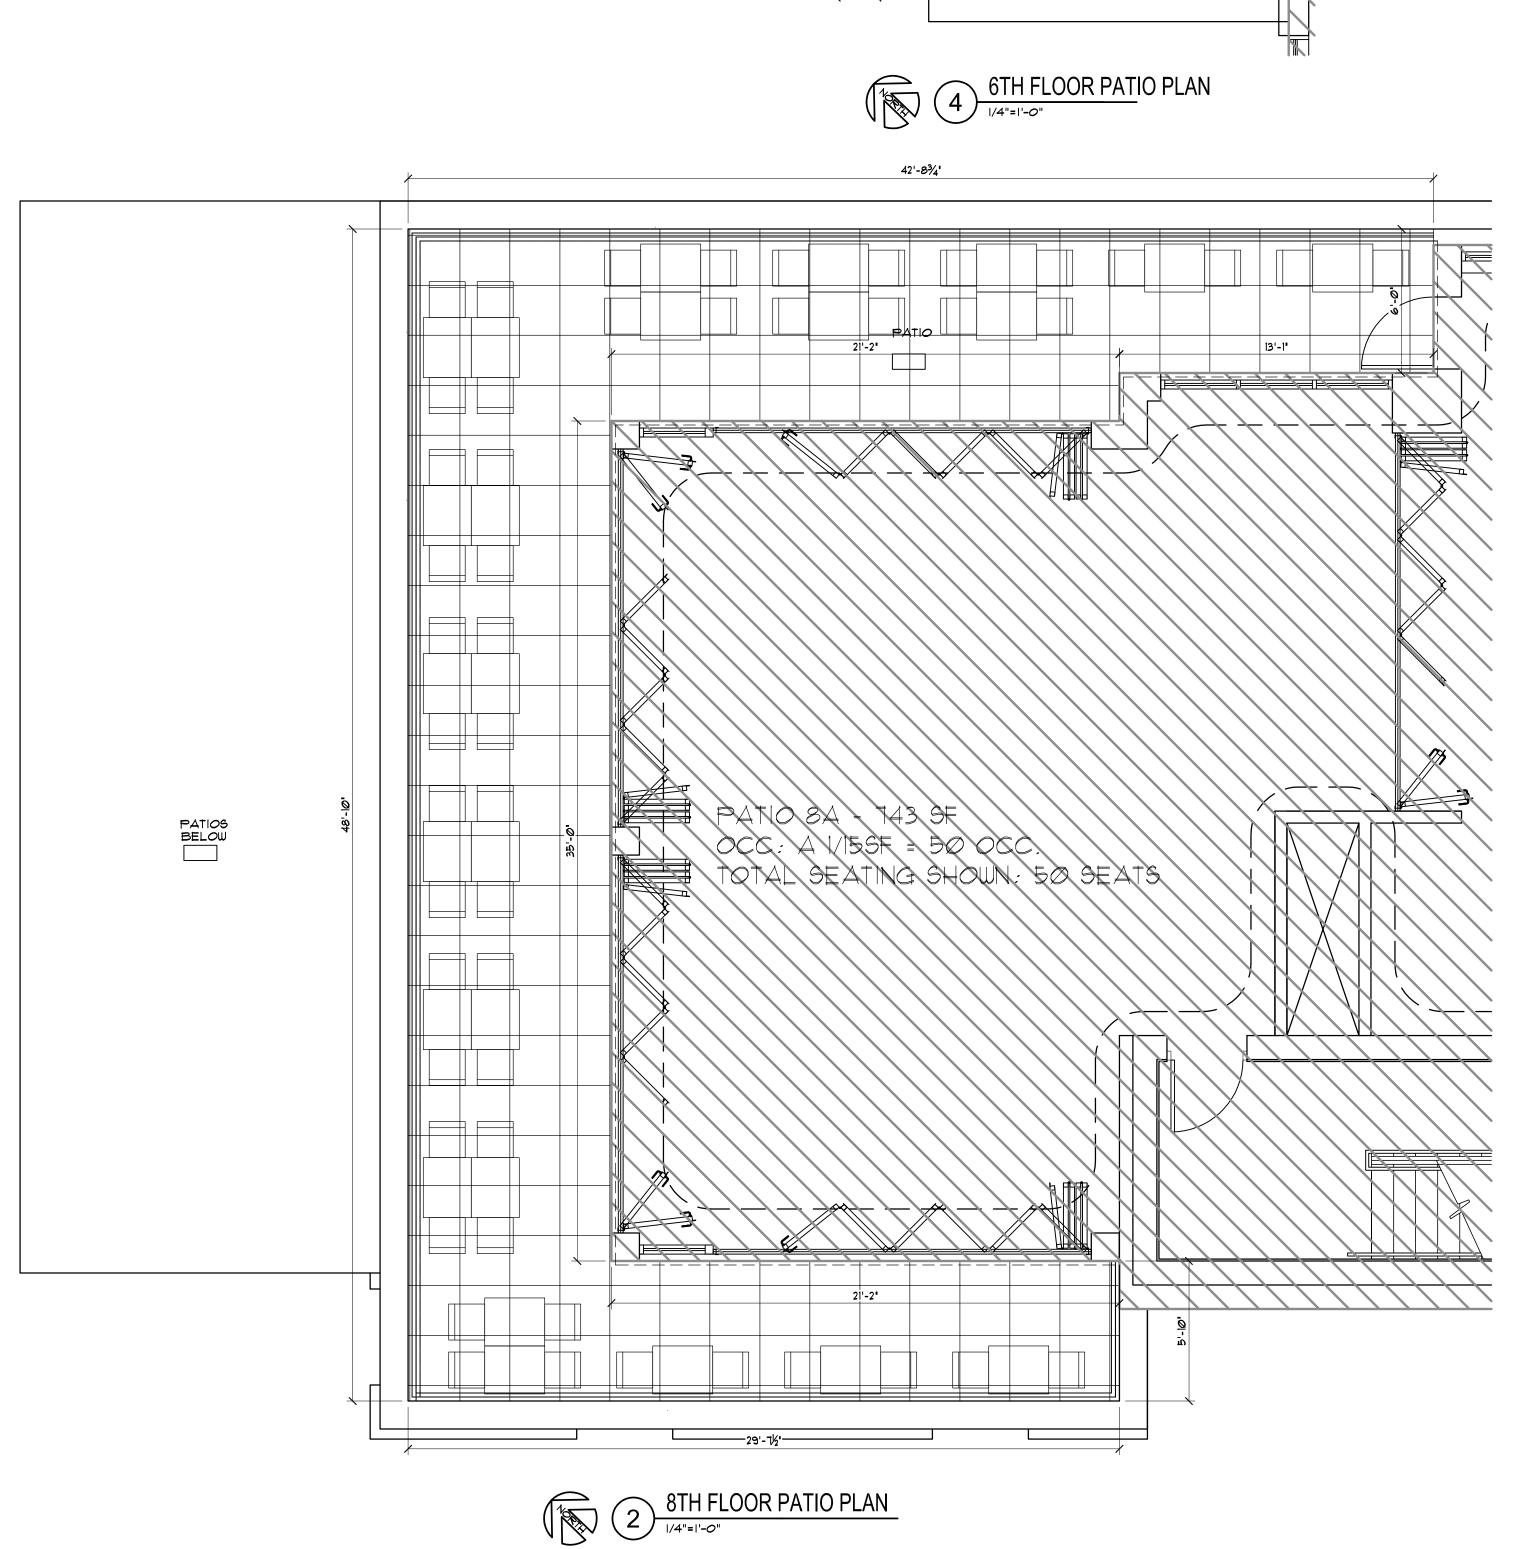


GLAZING AND VERTICAL
STANCHION AS DESIGNED BY RAIL
ENGINEER. DRINK RAIL - ---DESIGNED BY RAIL ENGINEER — ST. STL U-CHANNEL BOTTOM RAIL AS DESIGNED BY RAILING ENGINEER - PEDESTAL PAVERS POST AND RING RACK 6 BIKE RACK - SARIS POST & RING

6TH AND 8TH FLOOR RAILING SECTION

— ST. STL U-CHANNEL TOP RAIL AS DESIGNED BY RAILING ENGINEER

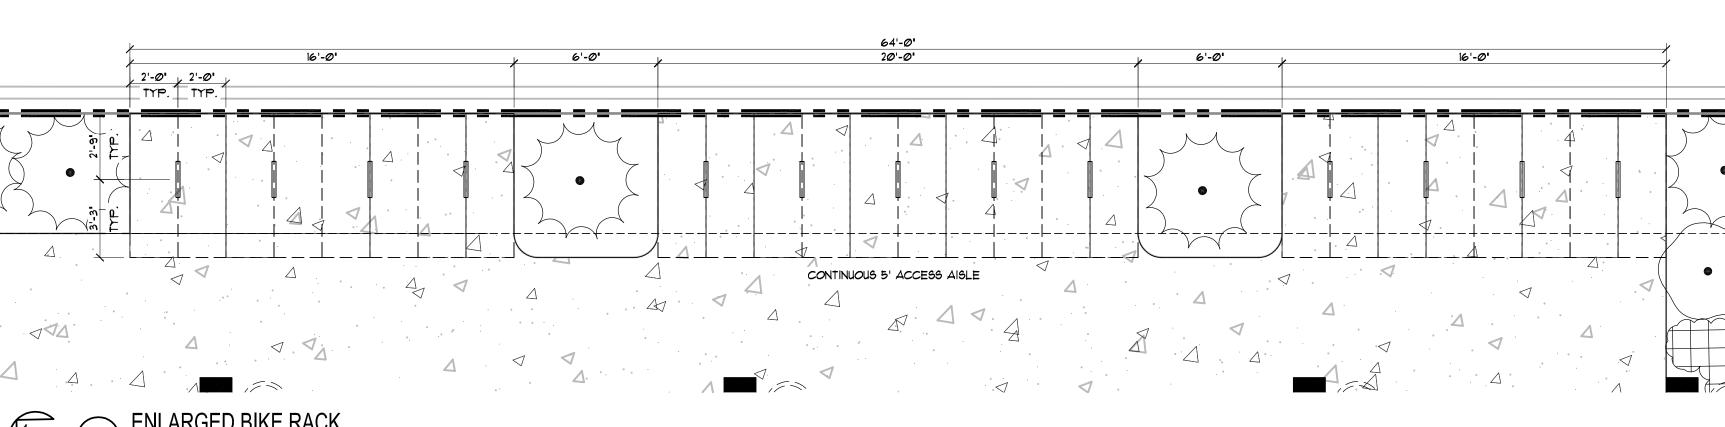

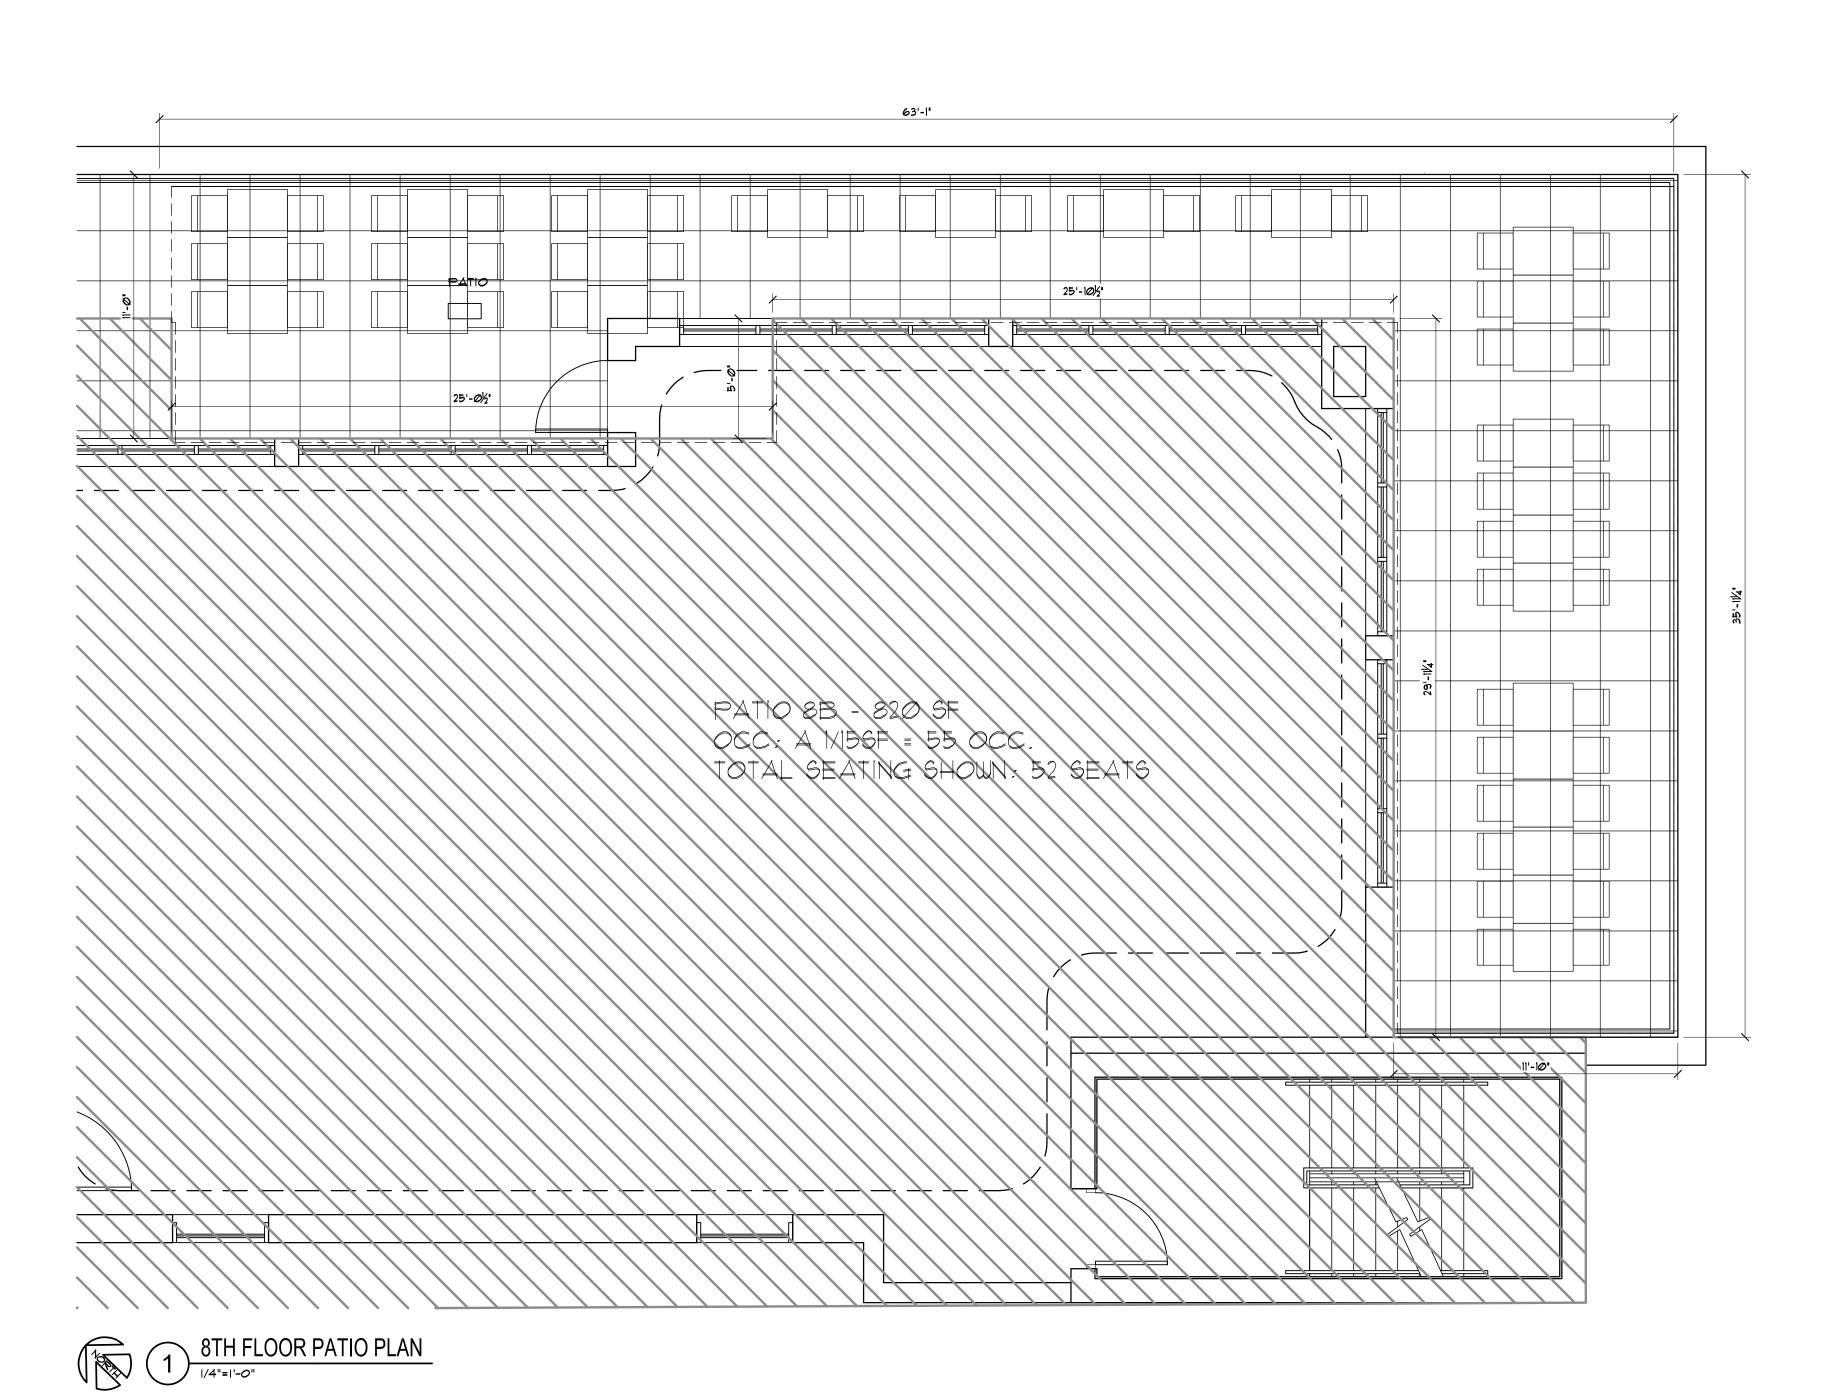

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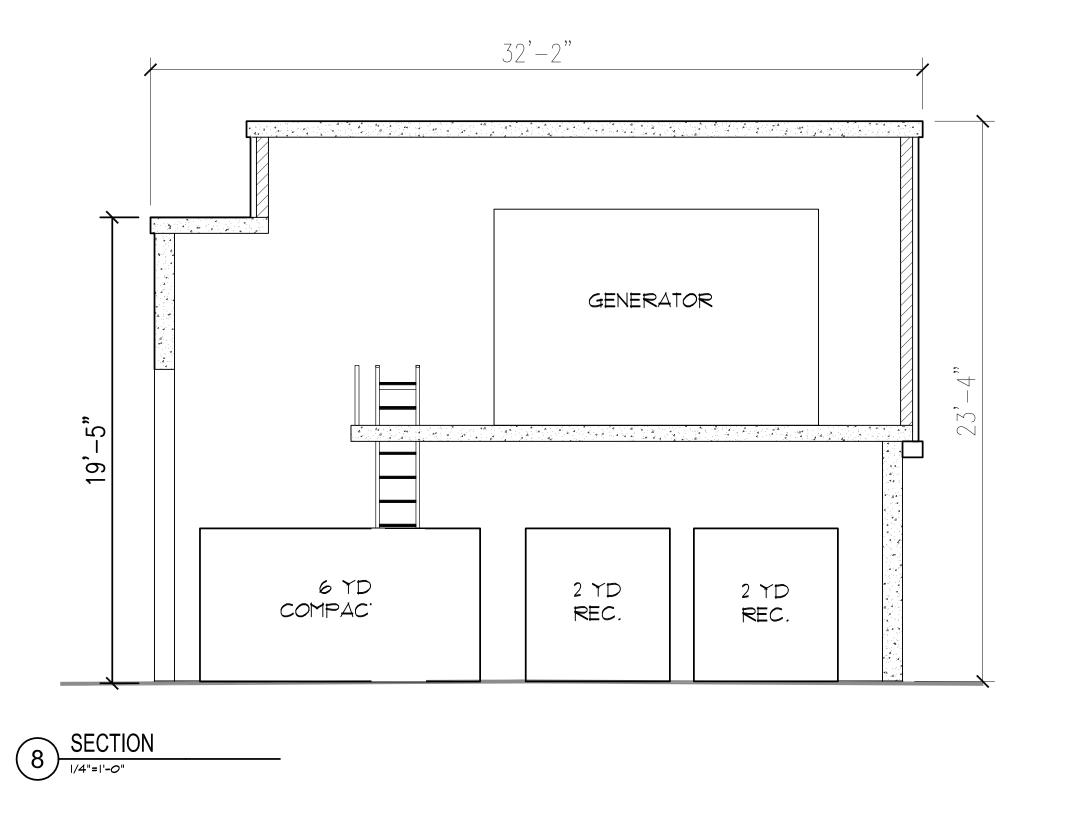
PATIO FLOOR


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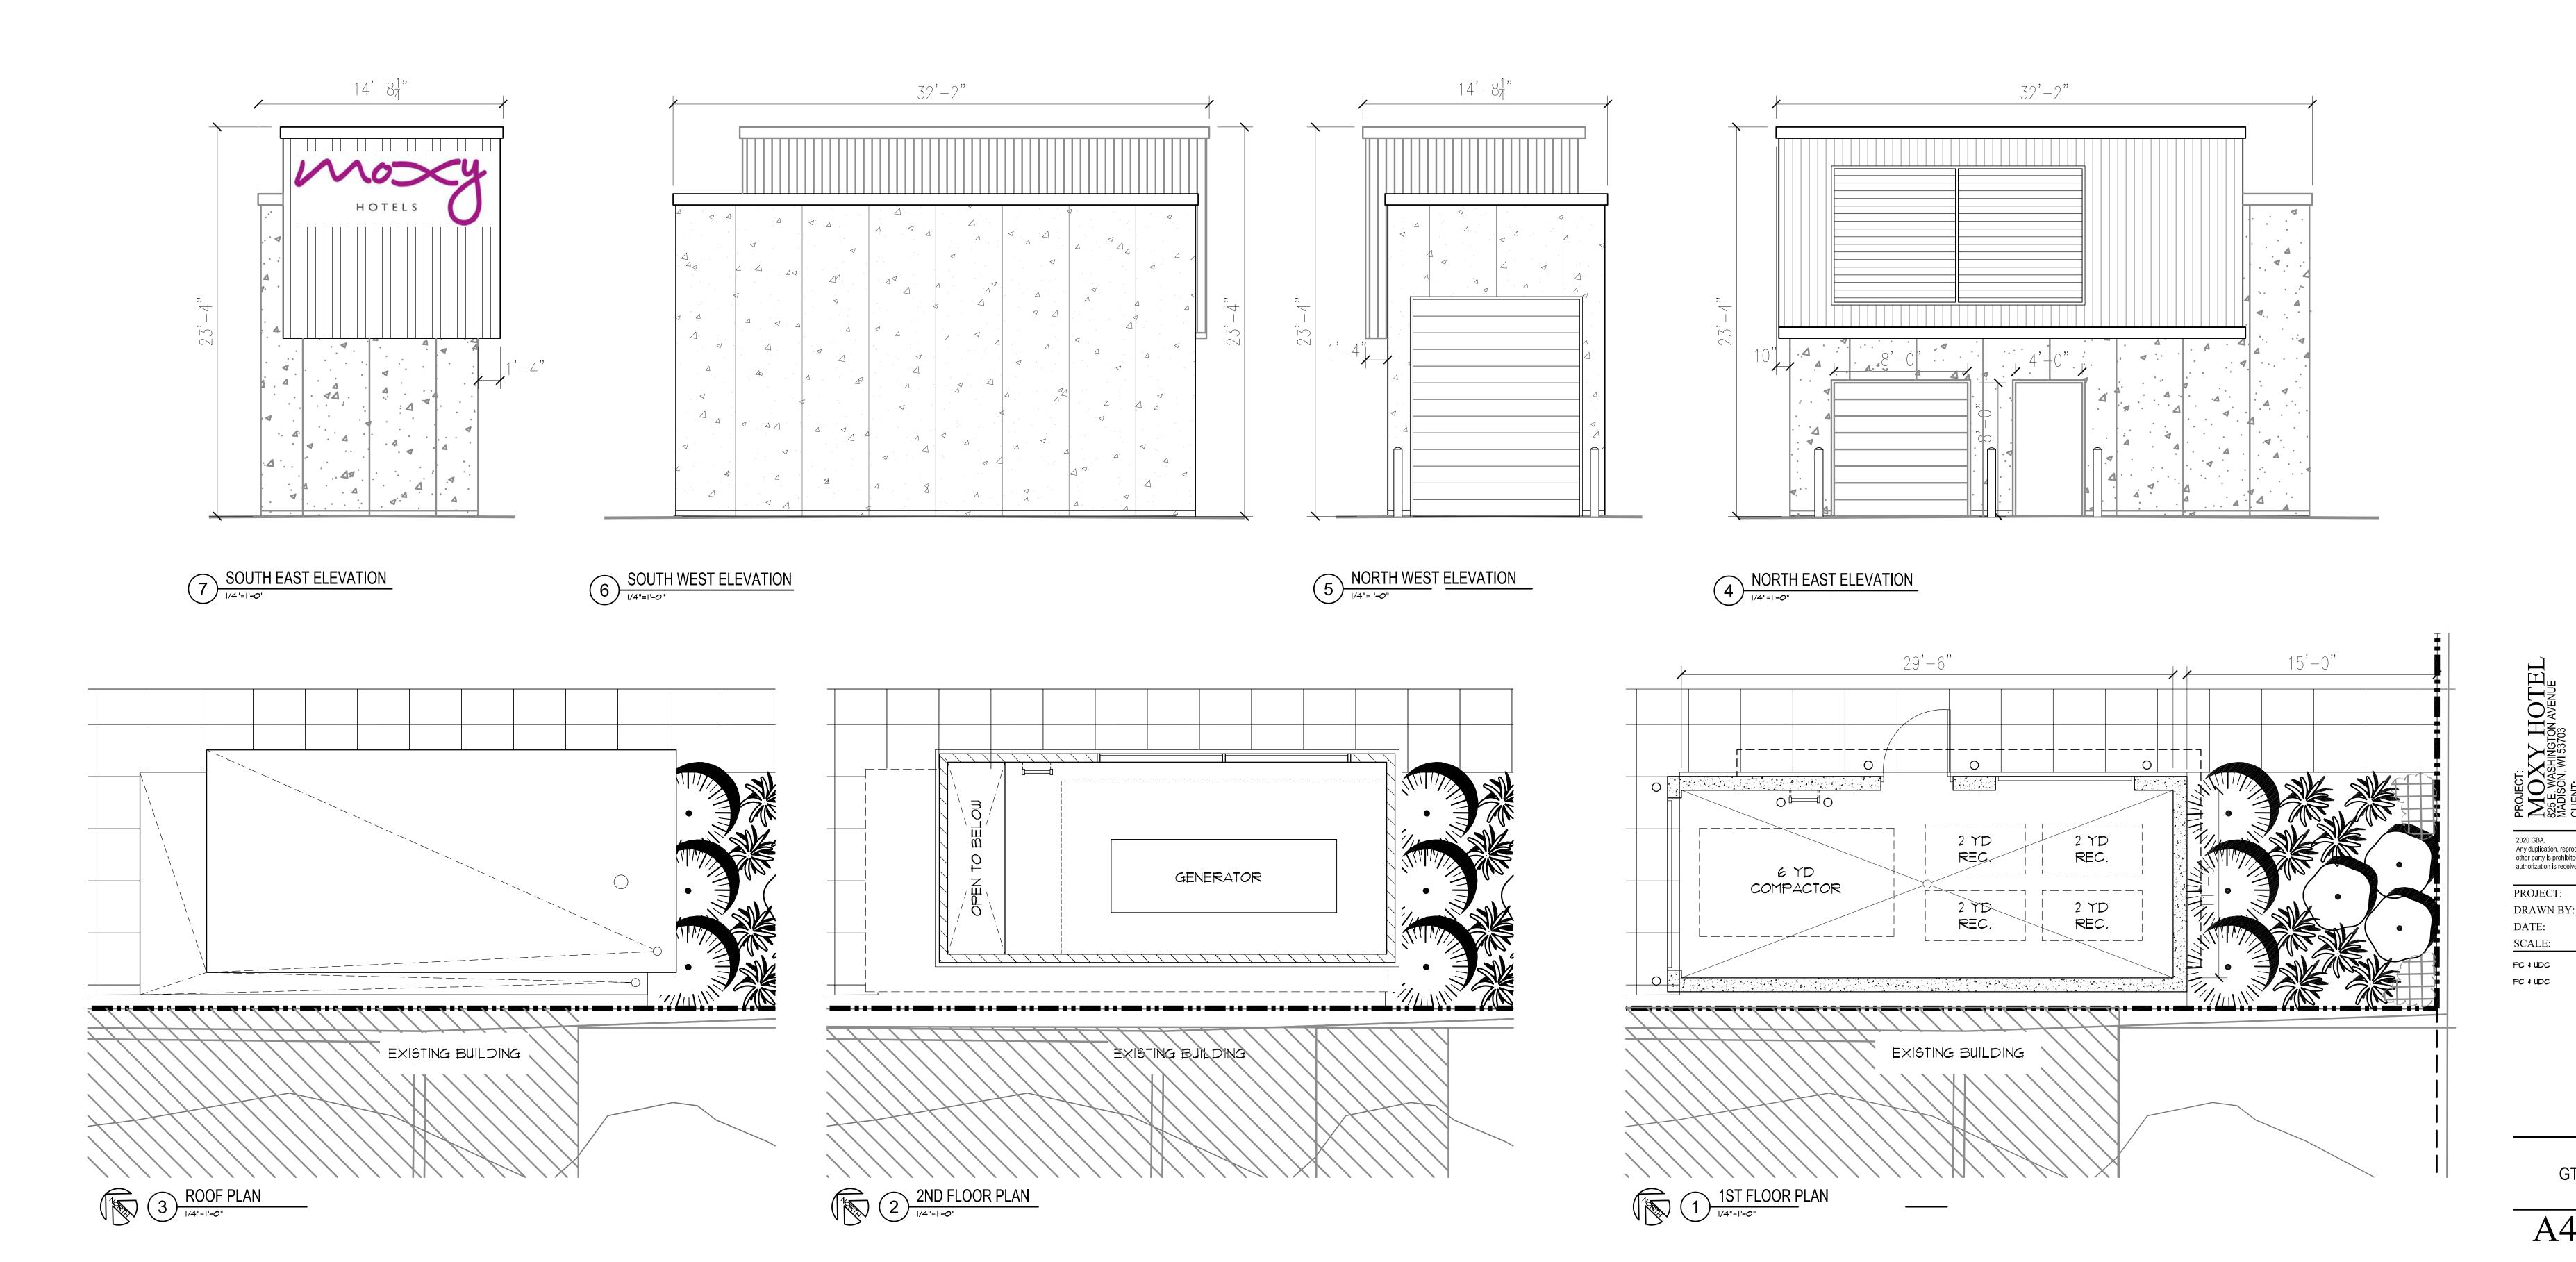
AS NOTED

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A4.02





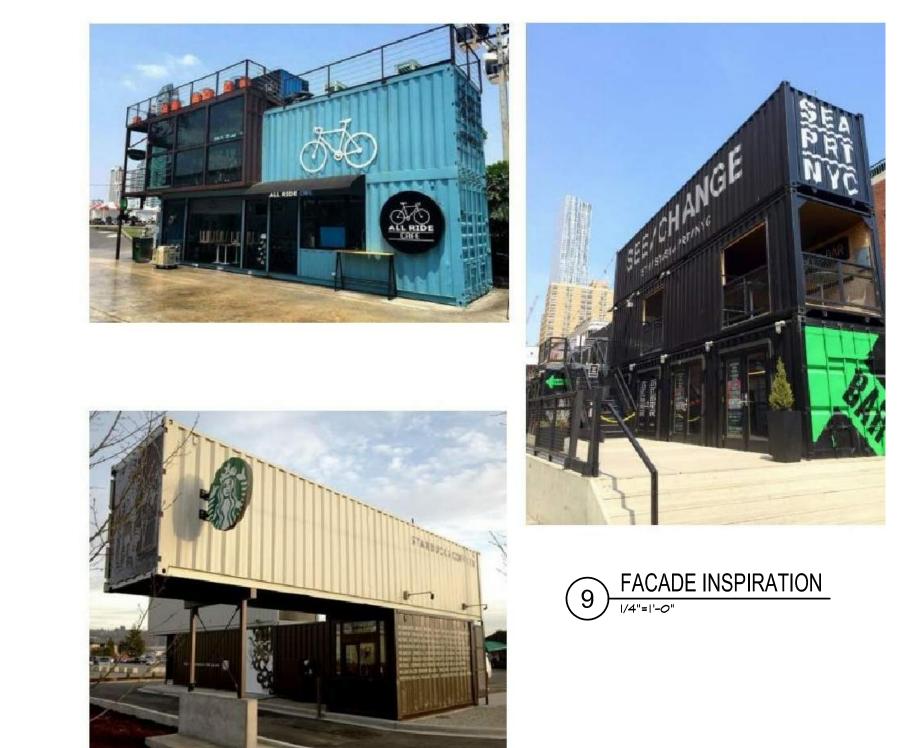

PROJECT:

MOXY HOTEL
825 E. WASHINGTON AVENUE
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CLIENT:

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C/O MM EAST WASHINGTON, L
1600 ASPEN COMMONS, SUITE 200
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AS NOTED

Ø4/Ø1/2Ø2Ø Ø5/18/2*0*2Ø

A4.03



CLIENT:

NORTH CENTRAL GROUP

C/O MM EAST WASHINGTON,
1600 ASPEN COMMONS, SUITE 200
MIDDLETON, WI 53562 PROJECT:

MOXY HOTEL
825 E. WASHINGTON AVENUE
MADISON, WI 53703

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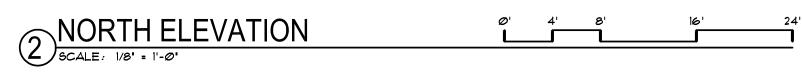
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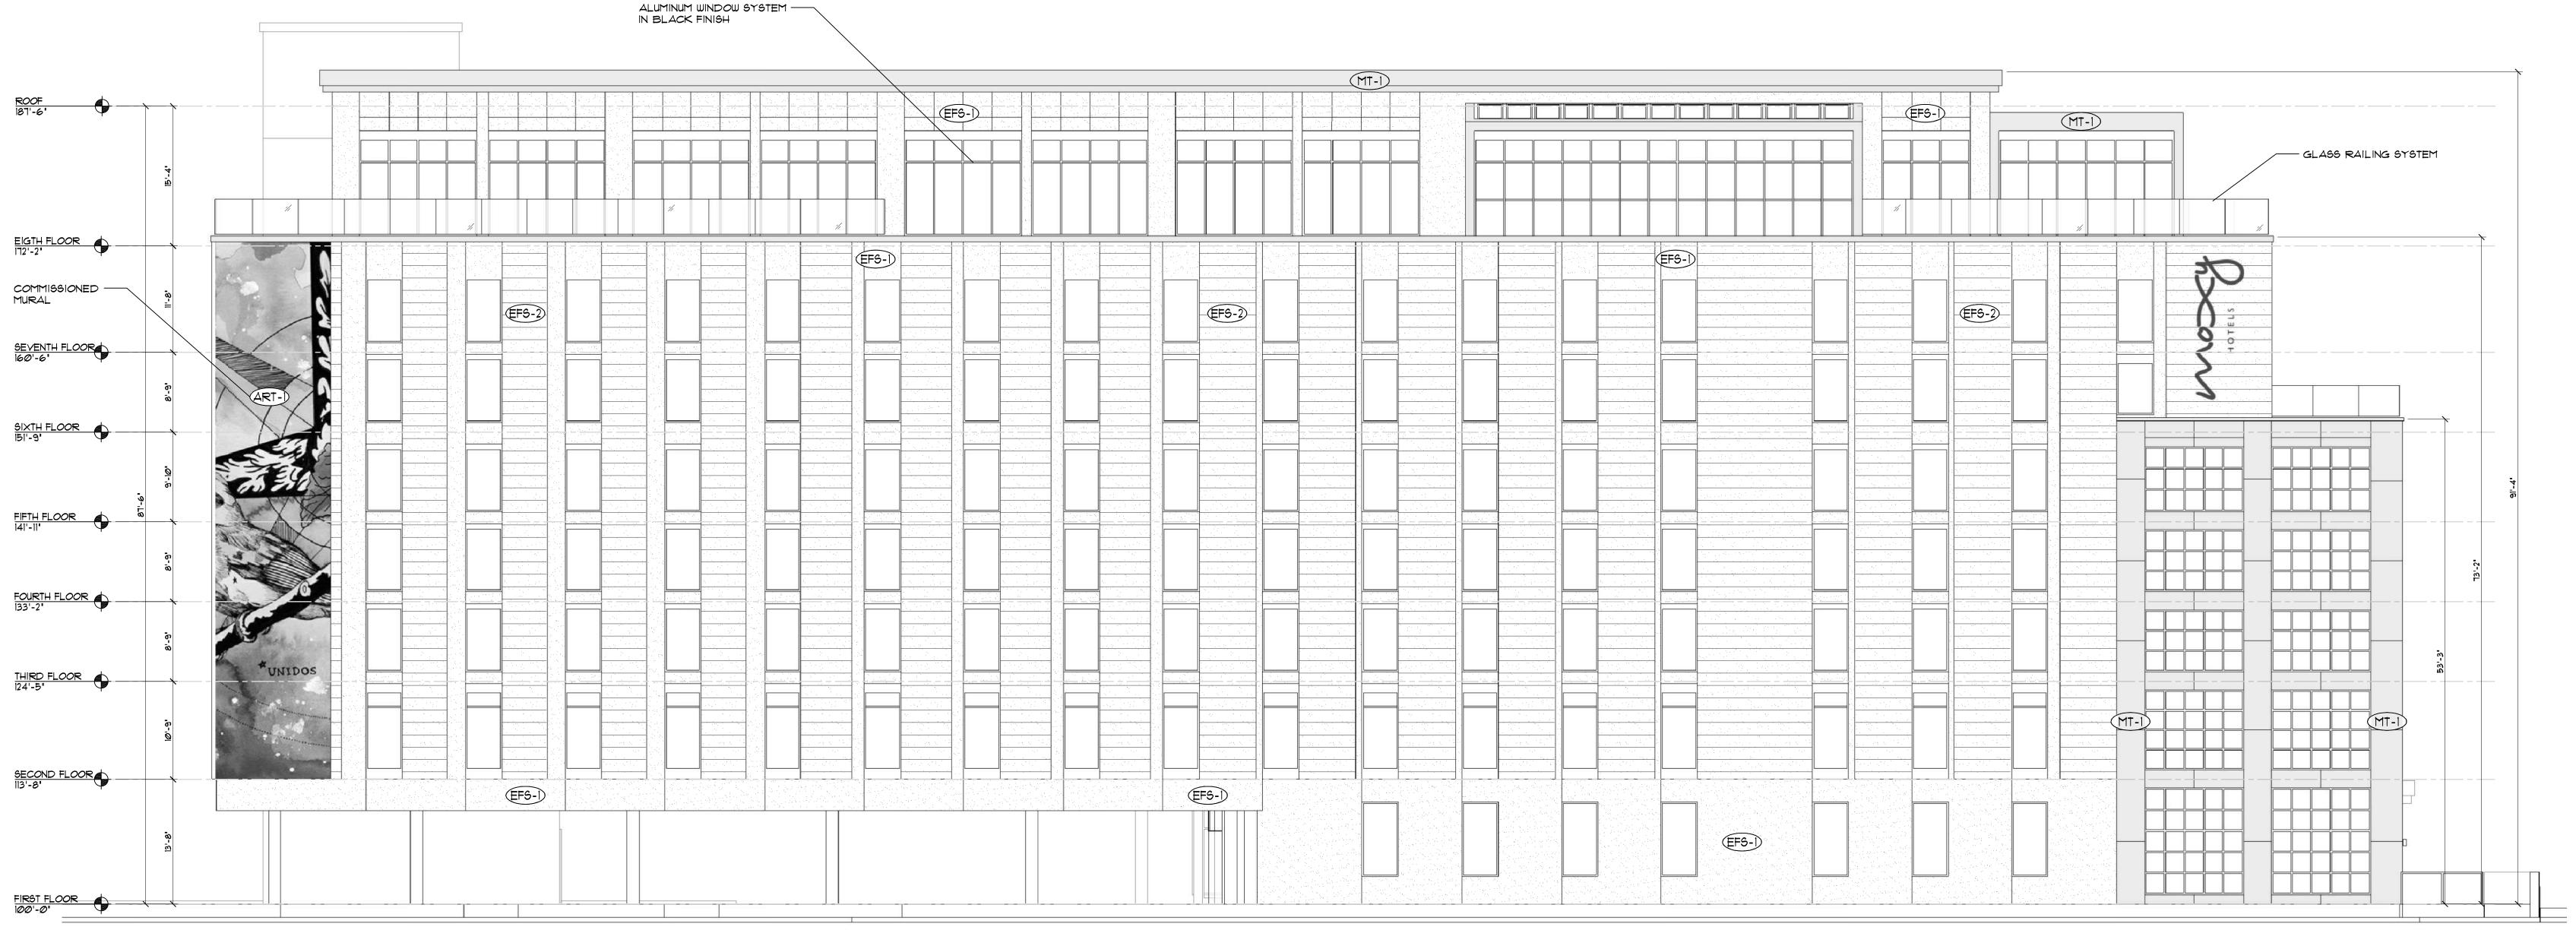
EAST & WEST BUILDING **ELEVATIONS**

A6.01









NORTH ELEVATION

SCALE: 1/8' = 1'-Ø' Ø' 4' 8' 16' 24' PROJECT:

MOXY HOTEL
825 E. WASHINGTON AVENUE
MADISON, WI 53703
CLIENT:

NORTH CENTRAL GROUP
C/O MM EAST WASHINGTON, LLC
1600 ASPEN COMMONS, SUITE 200
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SCALE: AS NOTED Ø5/18/2Ø2Ø PC & UDC

NORTH
BUILDING
ELEVATIONS

A6.02





SOUTH
BUILDING
ELEVATION

A6.03

PROJECT:

MOXY HOTEL
825 E. WASHINGTON AVENUE
MADISON, WI 53703
CLIENT:
NORTH CENTRAL GROUP
C/O MIM EAST WASHINGTON, L.
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AS NOTED

04/01/2020 05/18/2020

DRAWN BY:

SCALE:

PC & UDC



Moxy Hotel Mural Narrative

Mural Approach and Narrative

This mural will be a landmark that amplifies the identity of the Cap East neighborhood. The health and vibrancy of a community can often be diagnosed by the presence of arts & culture. Healthy communities have thriving artists, vibrant art scenes, and strong cultural identity. Collapsing communities have none.

Visual landmarks are especially impactful—as human beings, we receive 70% of our sensory information through visuals. So what we see in our built environment day-to-day is integral to public health and wellbeing. A mural at this location, by a local artist and entrepreneur, will serve as a signal for whom our public spaces are for. Art that faces the public sends the message that our neighborhood is a place where the community can gather and socialize. This is a place that acts as a steward of its community, by adding beauty and cultural richness to our environment. This is a place that values and cultivates the local ecosystem, and encourages us to pay attention to our surroundings and engage in creative exploration.

Substrate and Mural Materials:

The primary materials for the mural will be:

- Polytab mural fabric: a nonwoven, weather durable substrate
- o Gloss gel medium: a strong adhesive that permanently bonds the mural to wall surfaces
- o UV protective coating: to protect the mural from mildew, sun fading, and harsh weather conditions


These materials are tested and proven to last minimum 30 years with proper maintenance. For maintenance, murals should be recoated for UV and weather protection every 3-4 years to preserve longevity.

Example Concept Image



La Navigante (The Navigator). This artwork features golden-winged warblers, which are native to Wisconsin and migrate as far as Venezuela, an 8,000-mile round-trip every year. La Navigante is a part of a series that features migratory Wisconsin birds that play both a local and global role in their ecosystems.



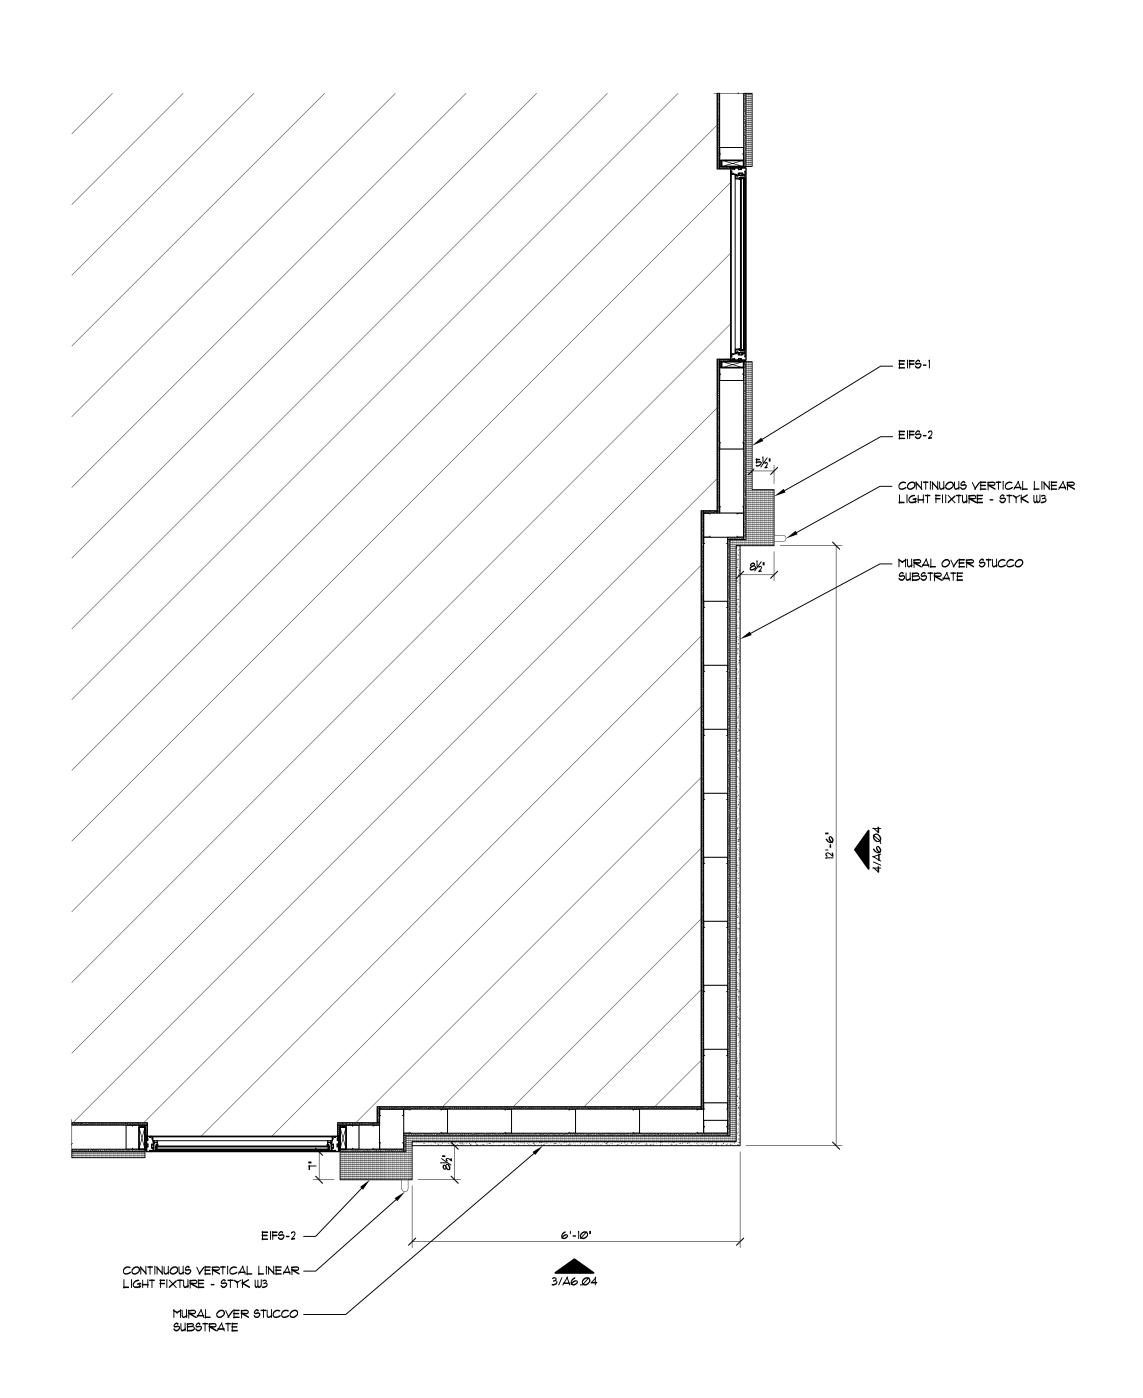

MURAL WALL - PLAN VIEW

SCALE: 1/2' = 1'-0'



12'-6' 4/A6_04 NORTH ELEVATION

6'-10**'** 3/A6.04 EAST ELEVATION

MURAL WALL - UNFOLDED ELEVATION

SCALE: 3/8' = 1'-Ø'

PROJECT:

MOXY HOTEL

825 E. WASHINGTON AVENUE
MADISON, WI 53703
CLIENT:
NORTH CENTRAL GROUP
C/O MIM EAST WASHINGTON,
1600 ASPEN COMMONS, SUITE 200
MIDDLETON, WI 53562

CONCEPTUAL MURAL WALL

DRAWN BY:

AS NOTED

*0*5/18/2*0*20



FROM EAST WASHINGTON LOOKING SOUTH





FROM EAST MAIN LOOKING WEST




FROM EAST WASHINGTON LOOKING EAST

Ø5/18/2*0*2Ø

RENDERINGS



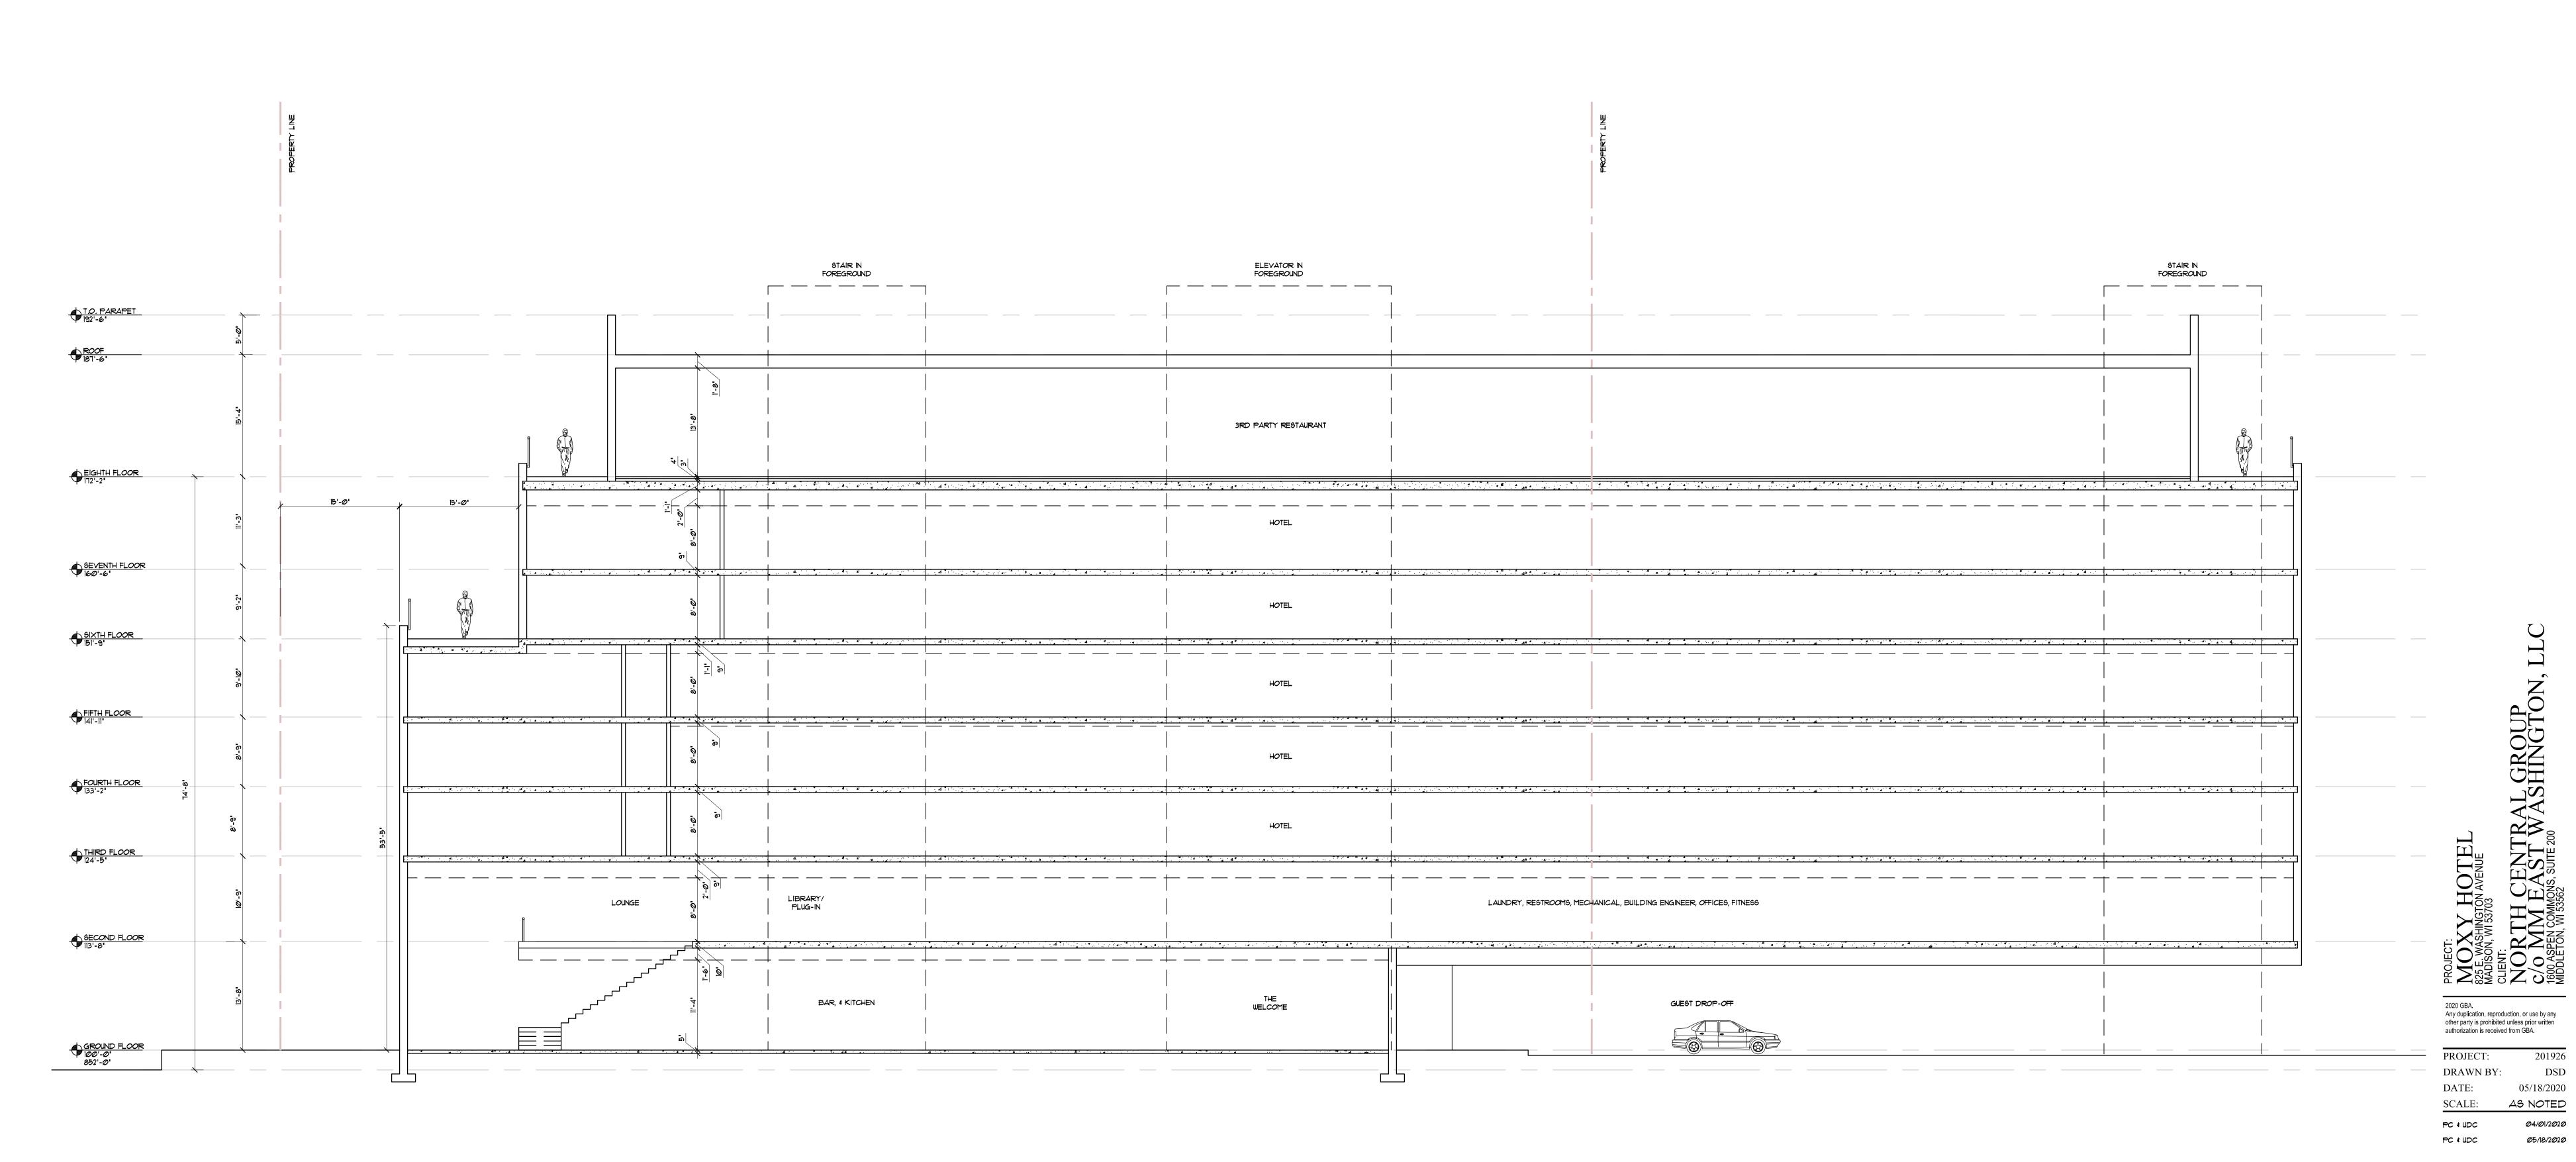


BUILDING SECTION O' 4' 5' 16' 24'

BUILDING SECTION A7.01

04/01/2020 Ø5/18/2*0*2Ø



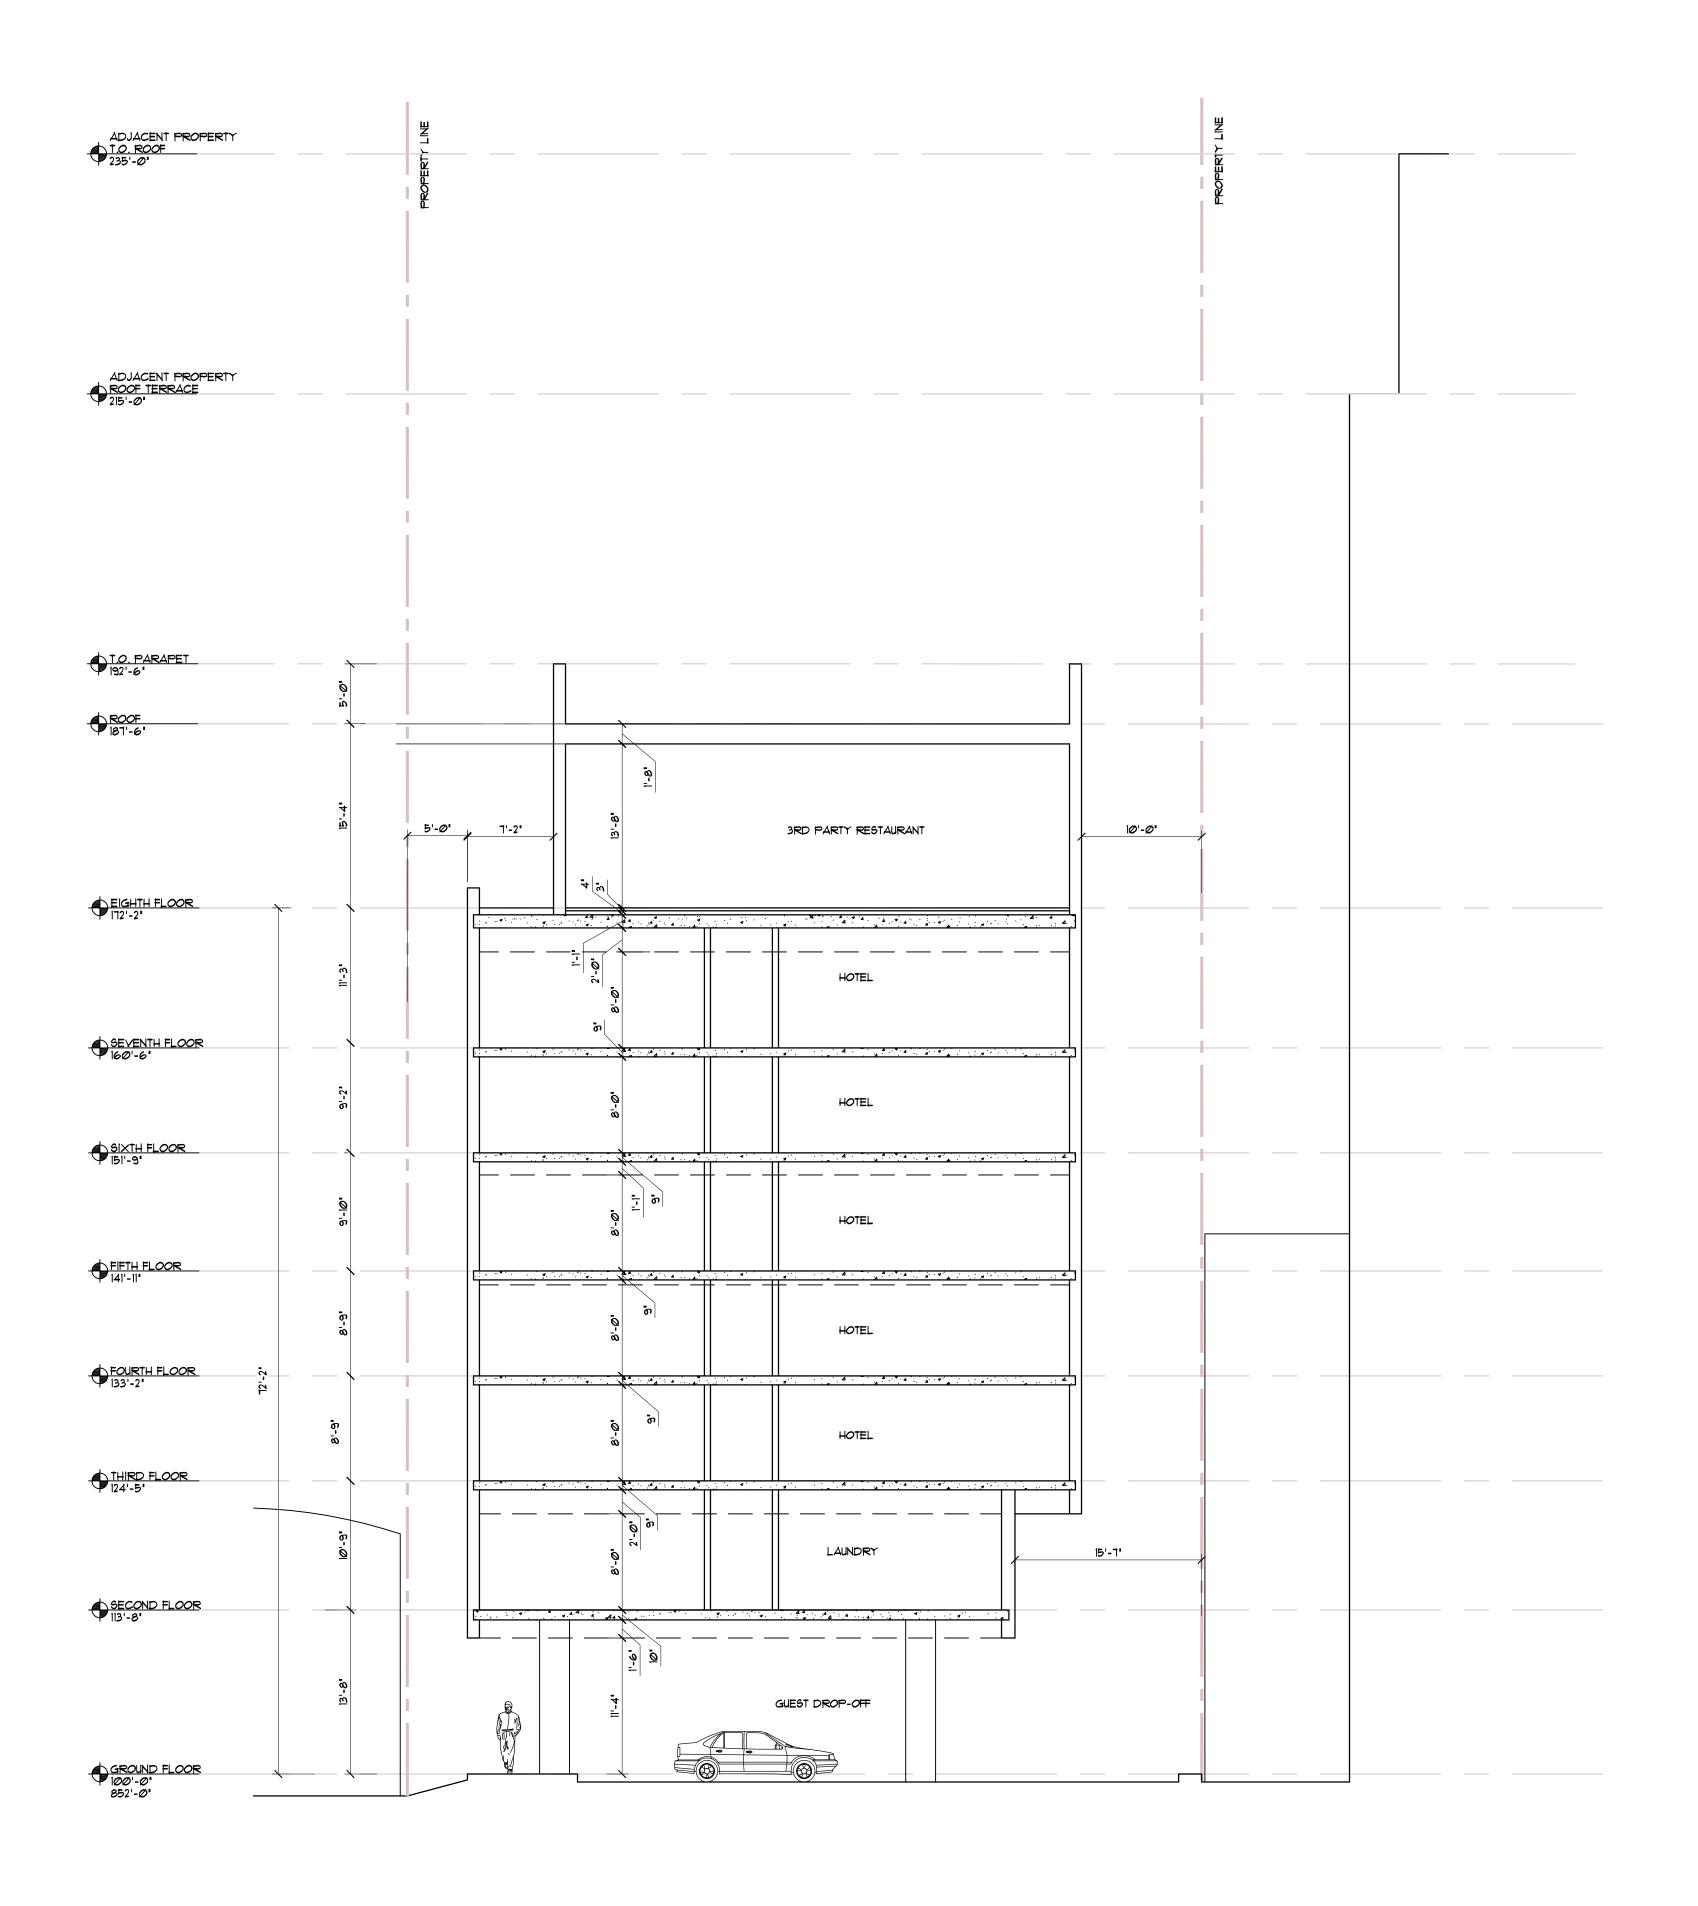

BUILDING SECTION 6' 4' 8' 16' 24'

PROJECT:

MOXY HOTEL
825 E. WASHINGTON AVENUE
MADISON, WI 53703
CLIENT:
NORTH CENTRAL GROUP
C/O MM EAST WASHINGTON, L
1600 ASPEN COMMONS, SUITE 200
MIDDLETON, WI 53562

2020 GBA.
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PROJECT: 201926
DRAWN BY: DSD
DATE: 05/18/2020
SCALE: AS NOTED


 DATE:
 05/18/2020

 SCALE:
 AS NOTED

 PC & UDC
 04/01/2020

 PC & UDC
 05/18/2020

BUILDING SECTION A7.02

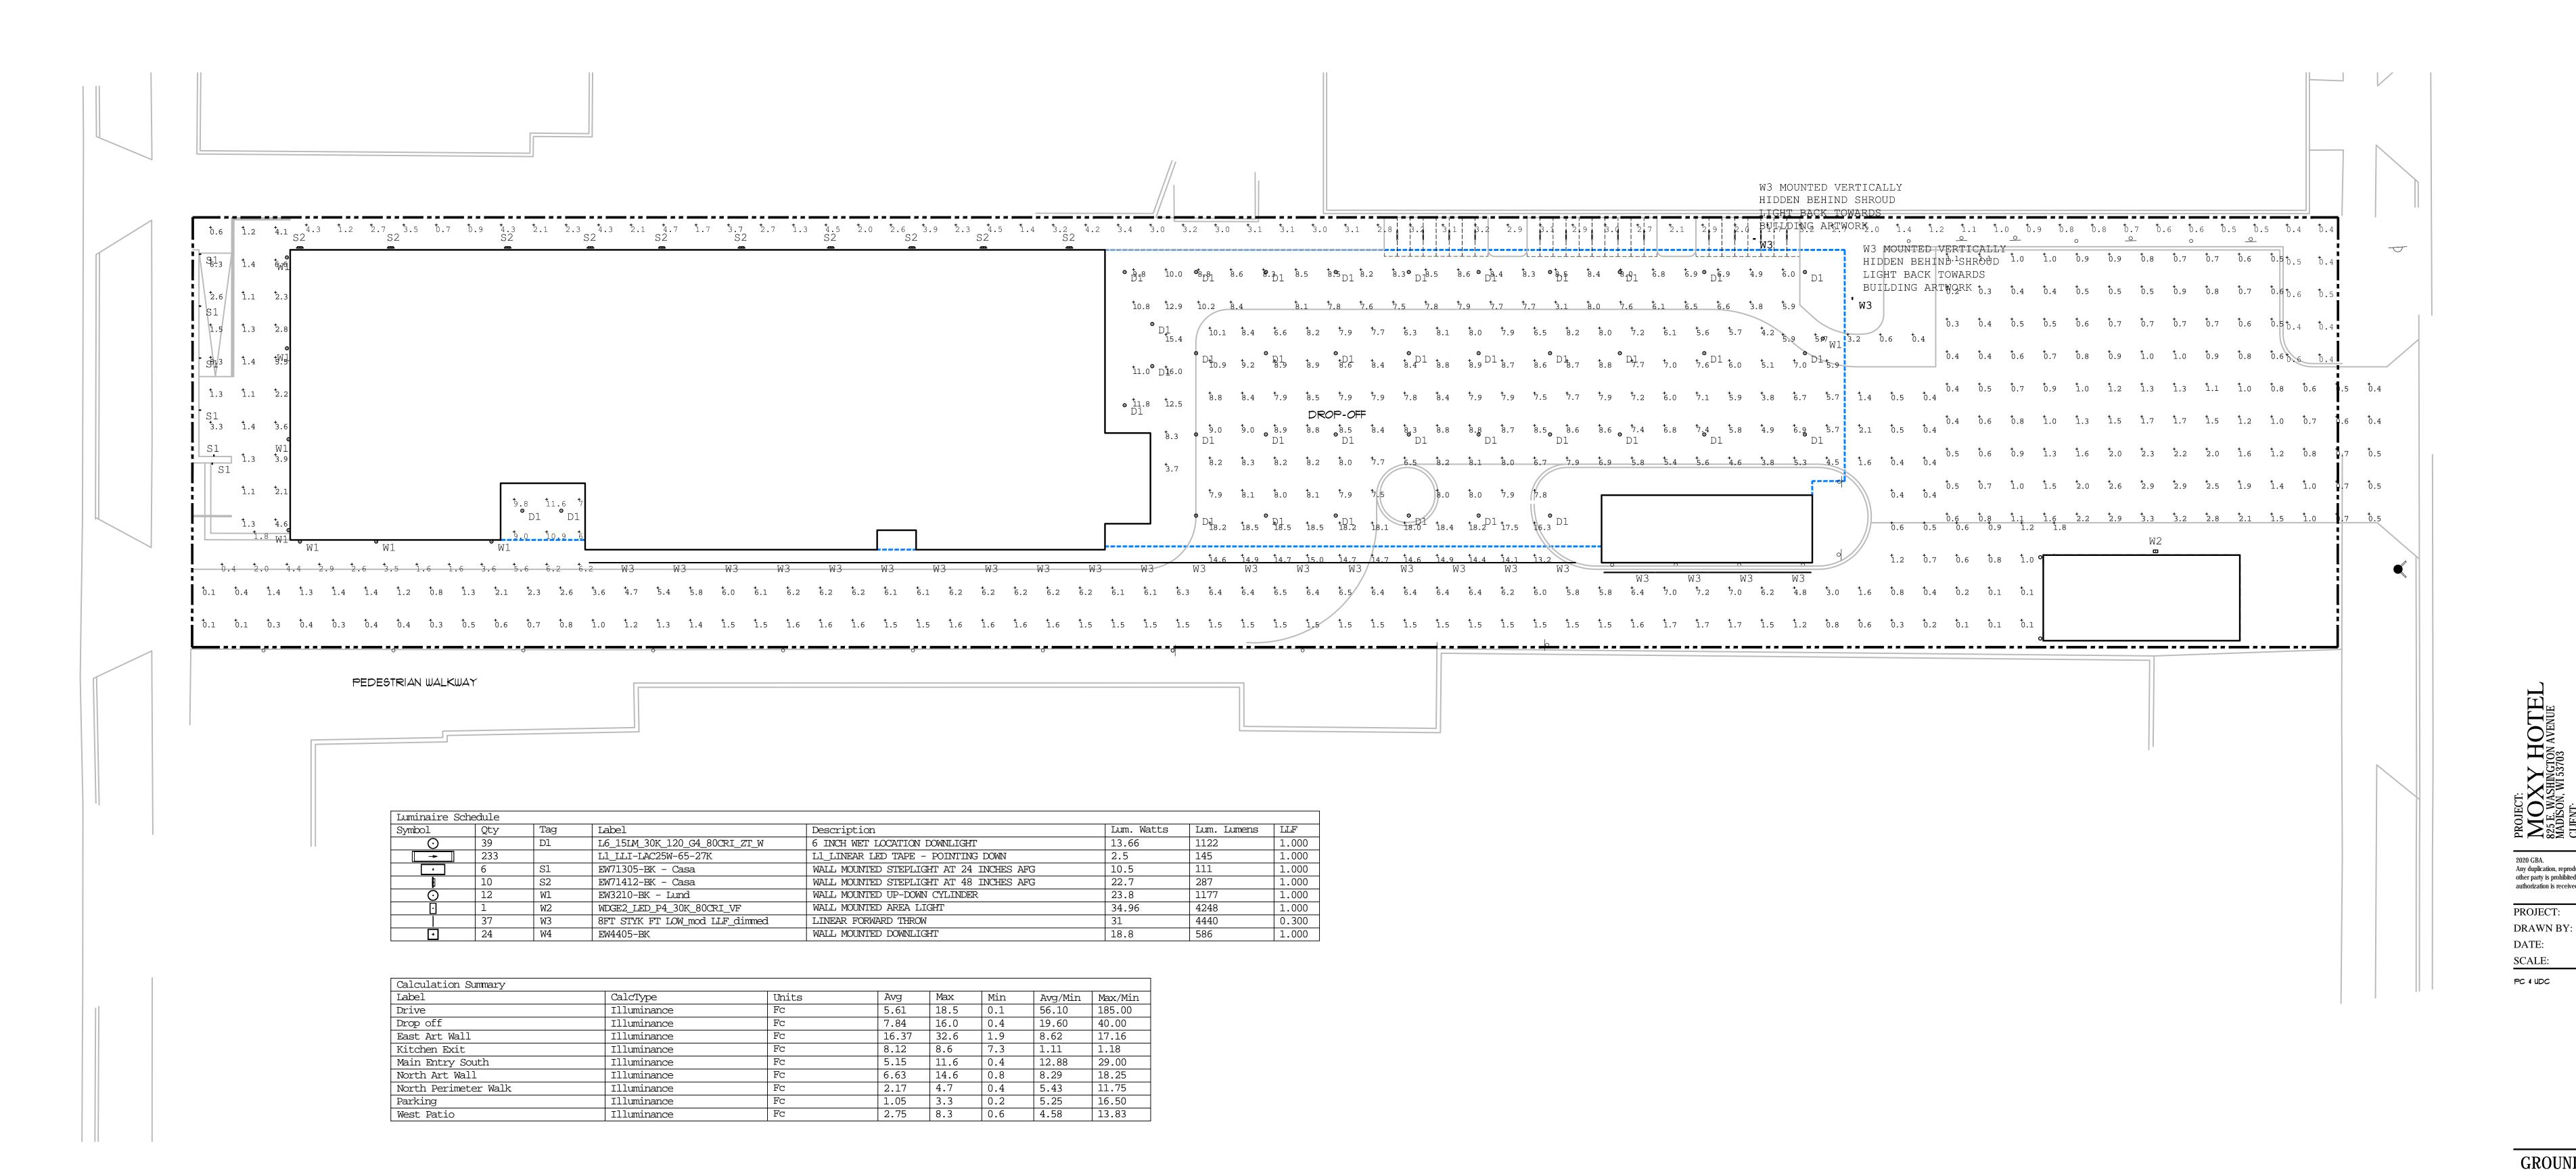


GROUND FLOOR PHOTOMETRICS

ORTH CENTRAL GROUP O MM EAST WASHINGTO MOXY HOTEL
25 E. WASHINGTON AVENUE
ADDISON, WI 53703 Any duplication, reproduction, or use by any other party is prohibited unless prior written authorization is received from GBA.

GROUND FLOOR PHOTOMETRICS

E1.01

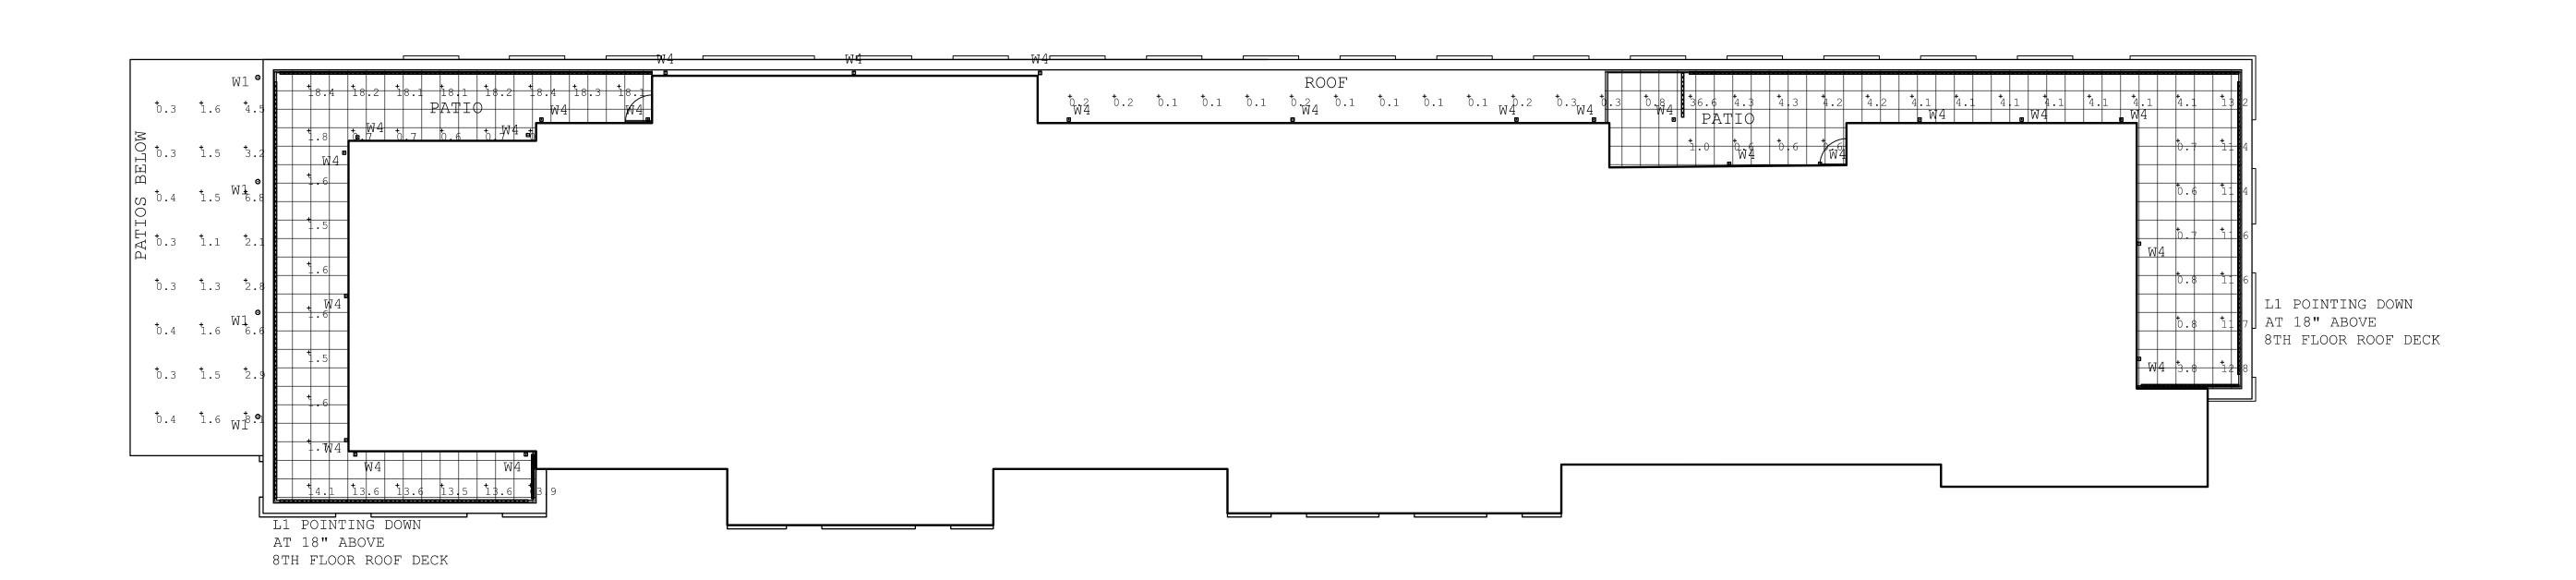



Luminaire S	Schedule						
Symbol	Qty	Tag	Label	Description	Lum. Watts	Lum. Lumens	LLF
0	39	D1	L6_15LM_30K_120_G4_80CRI_ZT_W	6 INCH WET LOCATION DOWNLIGHT	13.66	1122	1.000
	233		L1_LLI-LAC25W-65-27K	L1_LINEAR LED TAPE - POINTING DOWN	2.5	145	1.000
,	6	S1	EW71305-BK - Casa	WALL MOUNTED STEPLIGHT AT 24 INCHES AFG	10.5	111	1.000
1	10	S2	EW71412-BK - Casa	WALL MOUNTED STEPLIGHT AT 48 INCHES AFG	22.7	287	1.000
0	12	W1	EW3210-BK - Lund	WALL MOUNTED UP-DOWN CYLINDER	23.8	1177	1.000
	1	W2	WDGE2_LED_P4_30K_80CRI_VF	WALL MOUNTED AREA LIGHT	34.96	4248	1.000
	37	W3	8FT STYK FT LOW mod LLF dimmed	LINEAR FORWARD THROW	31	4440	0.300
•	24	W4	EW4405-BK	WALL MOUNTED DOWNLIGHT	18.8	586	1.000


Calculation Summary									
Label	CalcType	Units	Avg	Max	Min	Avg/Min	Max/Min		
6th floor Patio	Illuminance	Fc	2.14	8.1	0.3	7.13	27.00		
8th Floor Patio West	Illuminance	FC	10.90	63.9	0.6	18.17	106.50		
8th Floor Patio West_1	Illuminance	Fc	4.08	36.6	0.1	40.80	366.00		

SIXTH & EIGHTH FLOOR PHOTOMETRICS




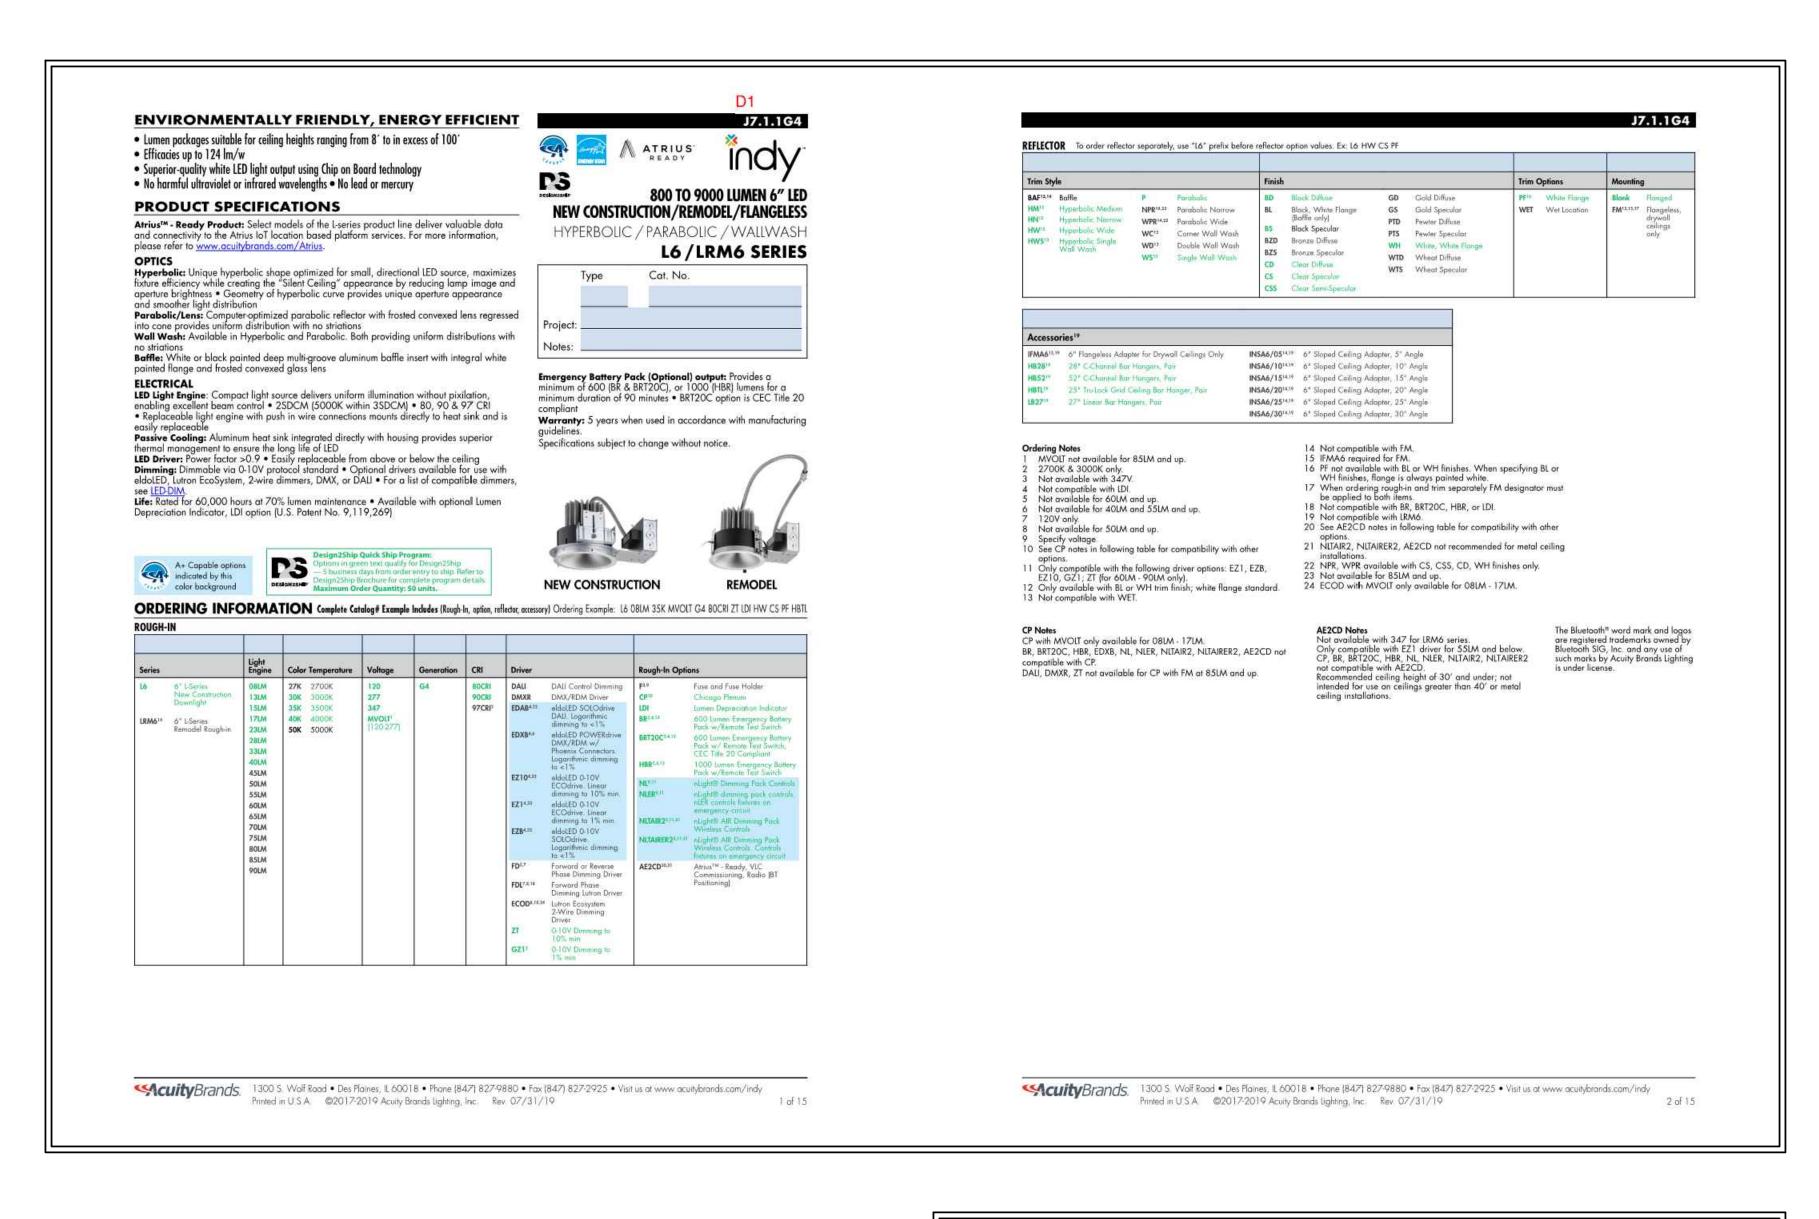

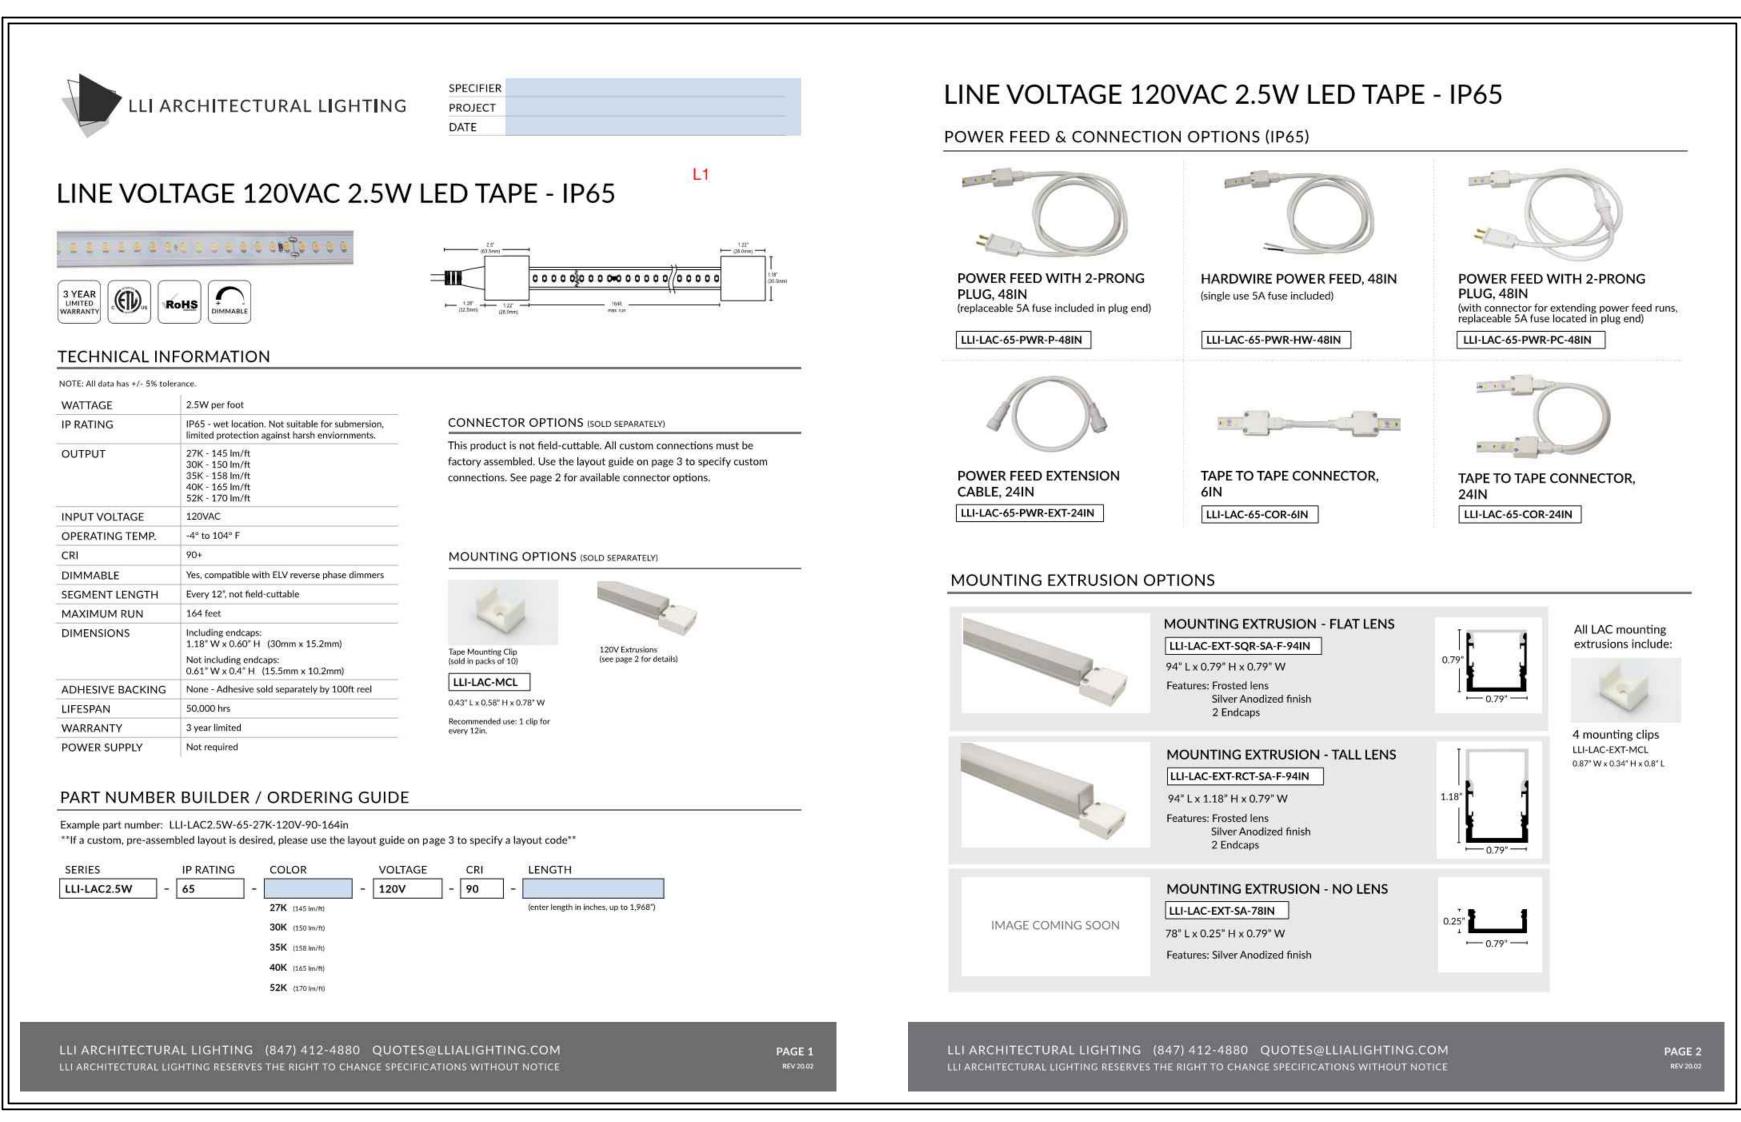

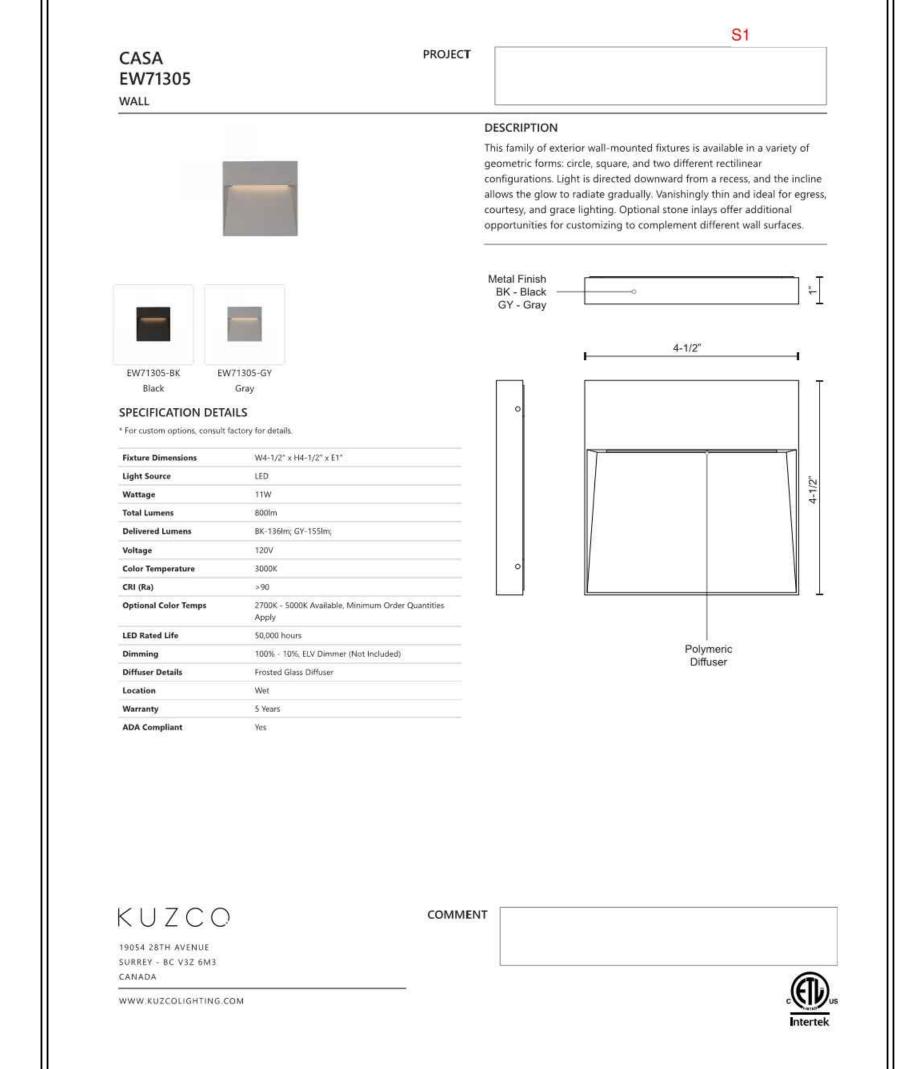



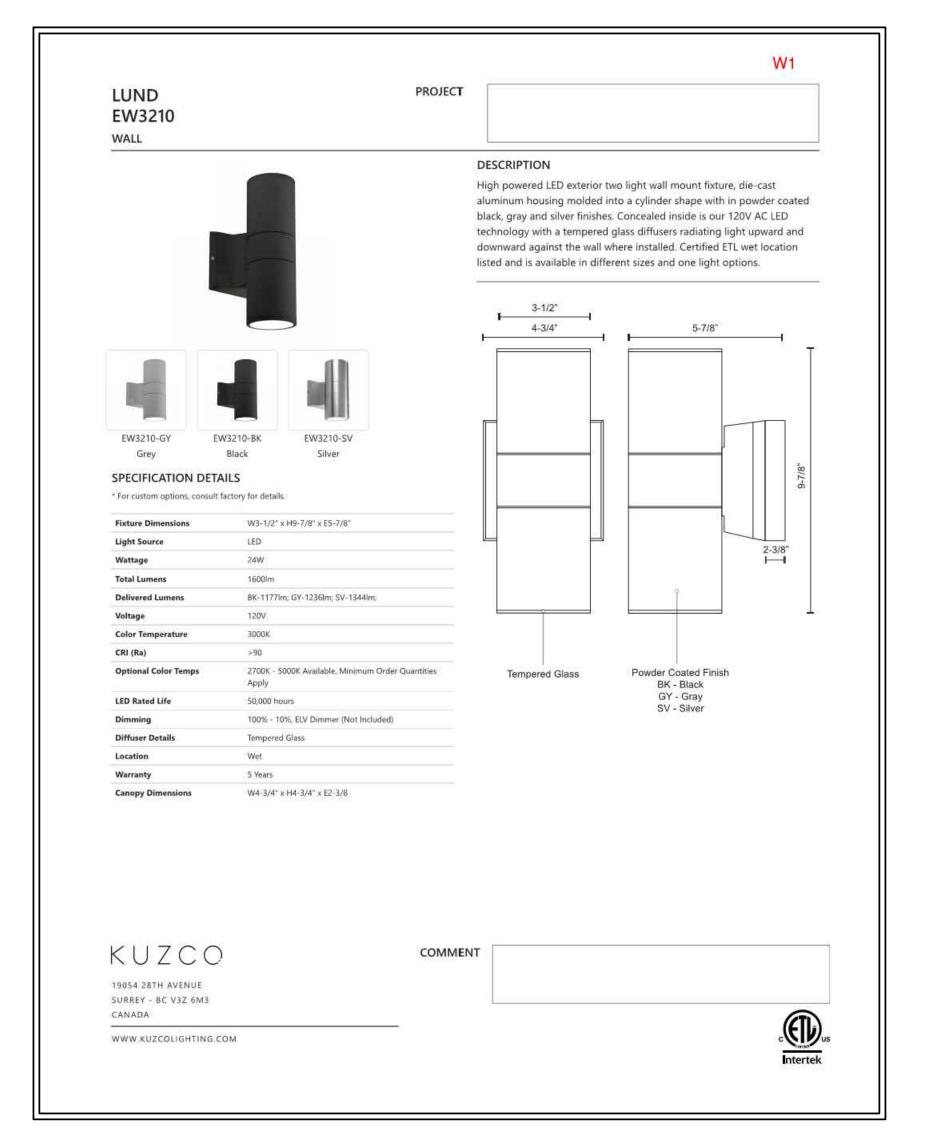



PROJECT: DRAWN BY:

SCALE:


EXTERIOR LIGHTING CUTSHEETS


E3.01


AS NOTED

4/1/2020



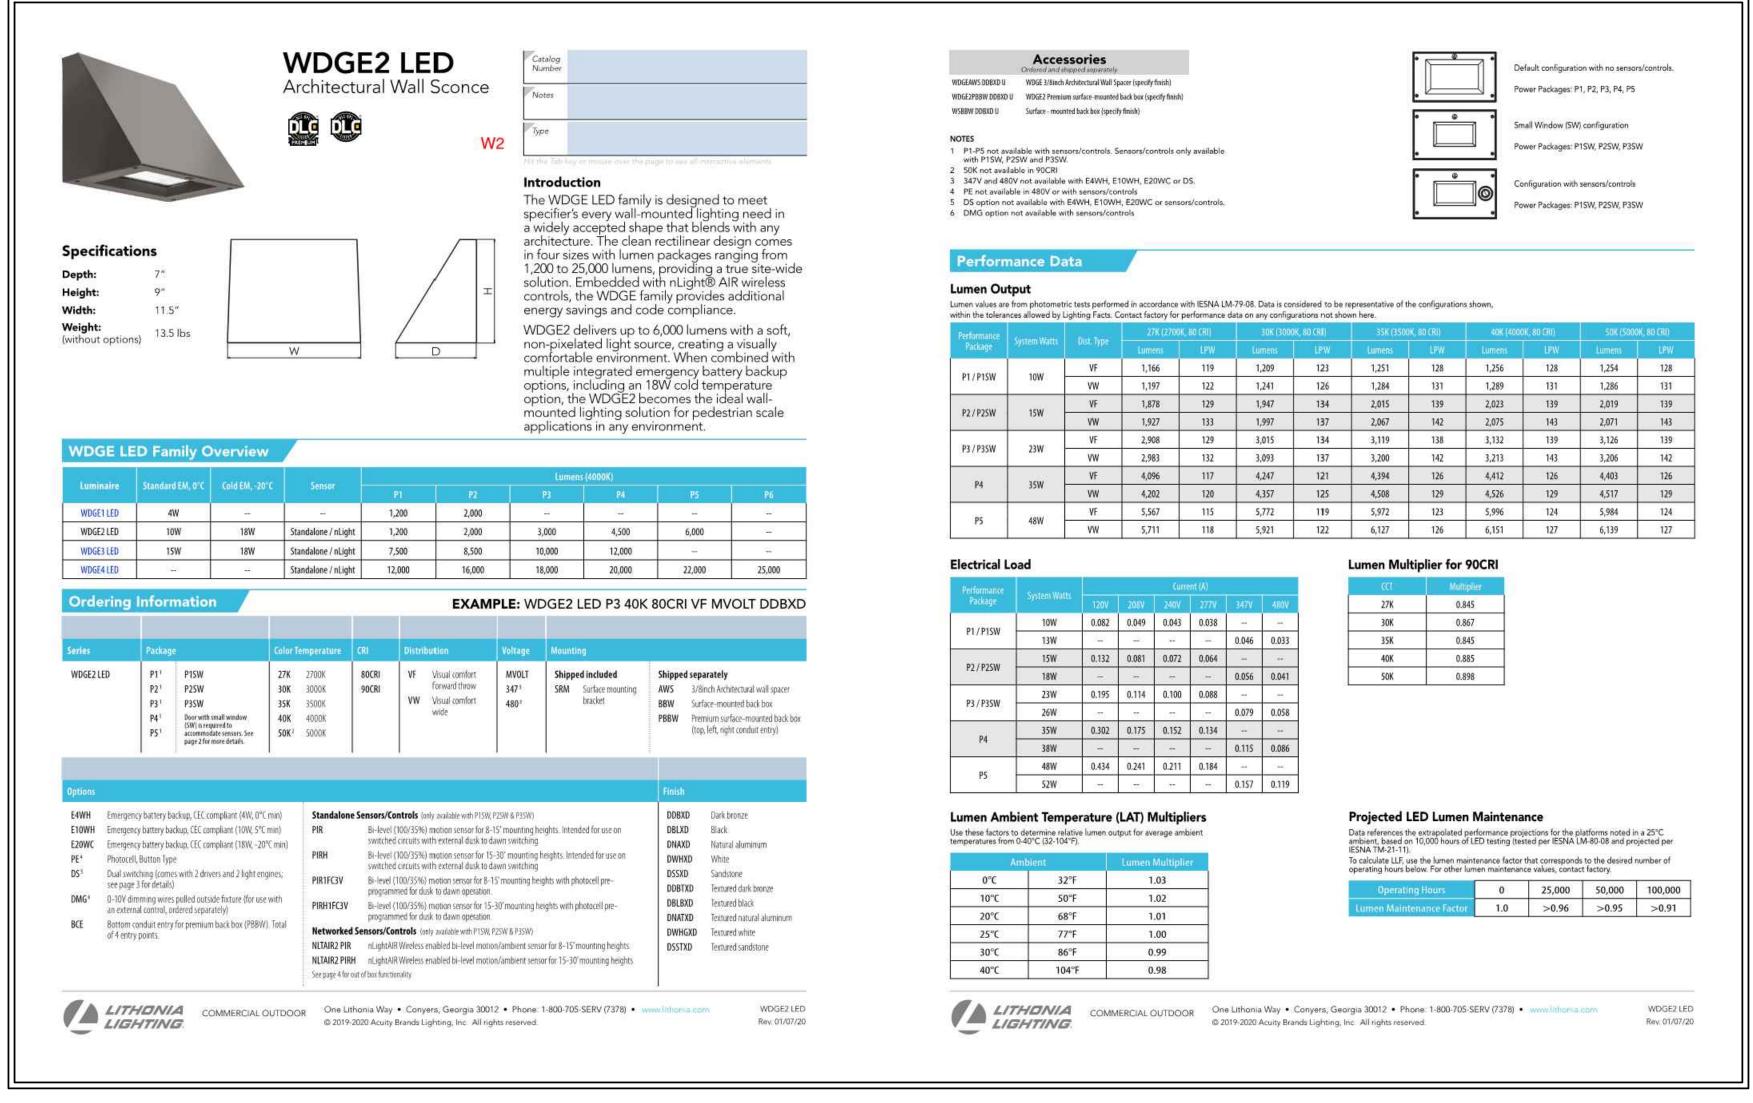

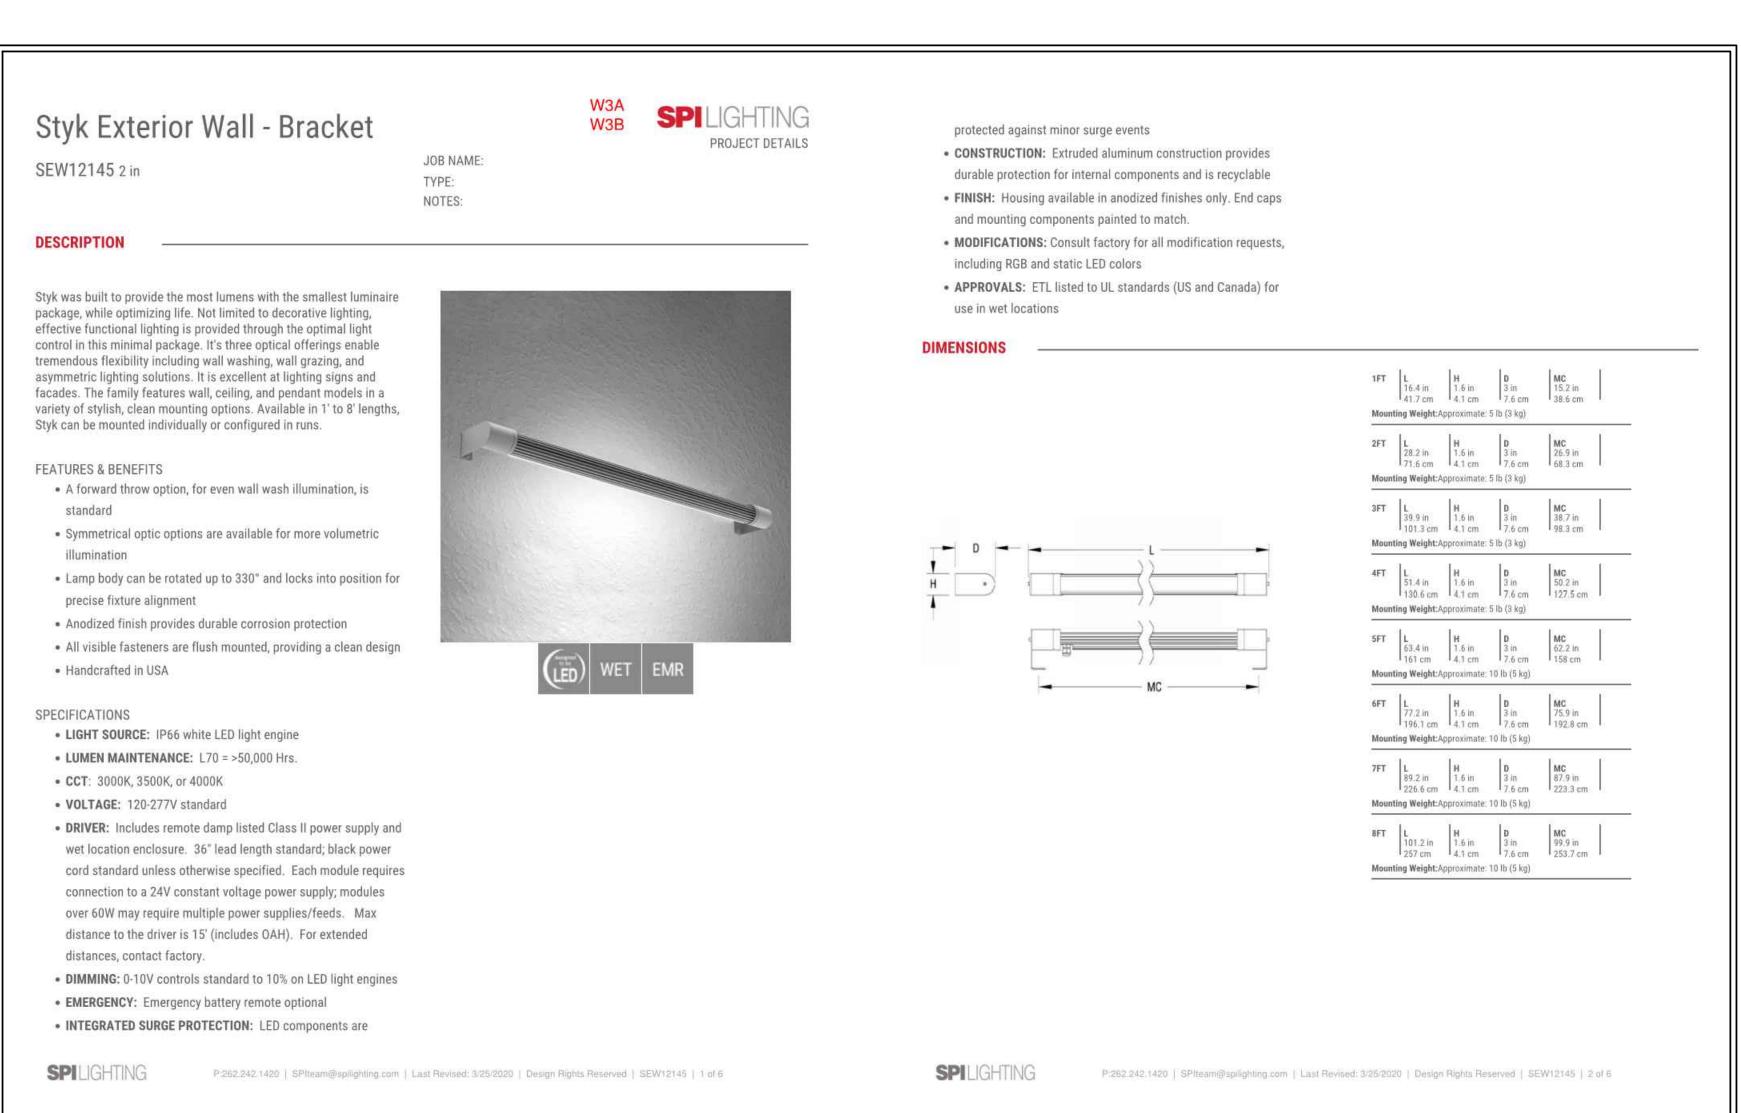

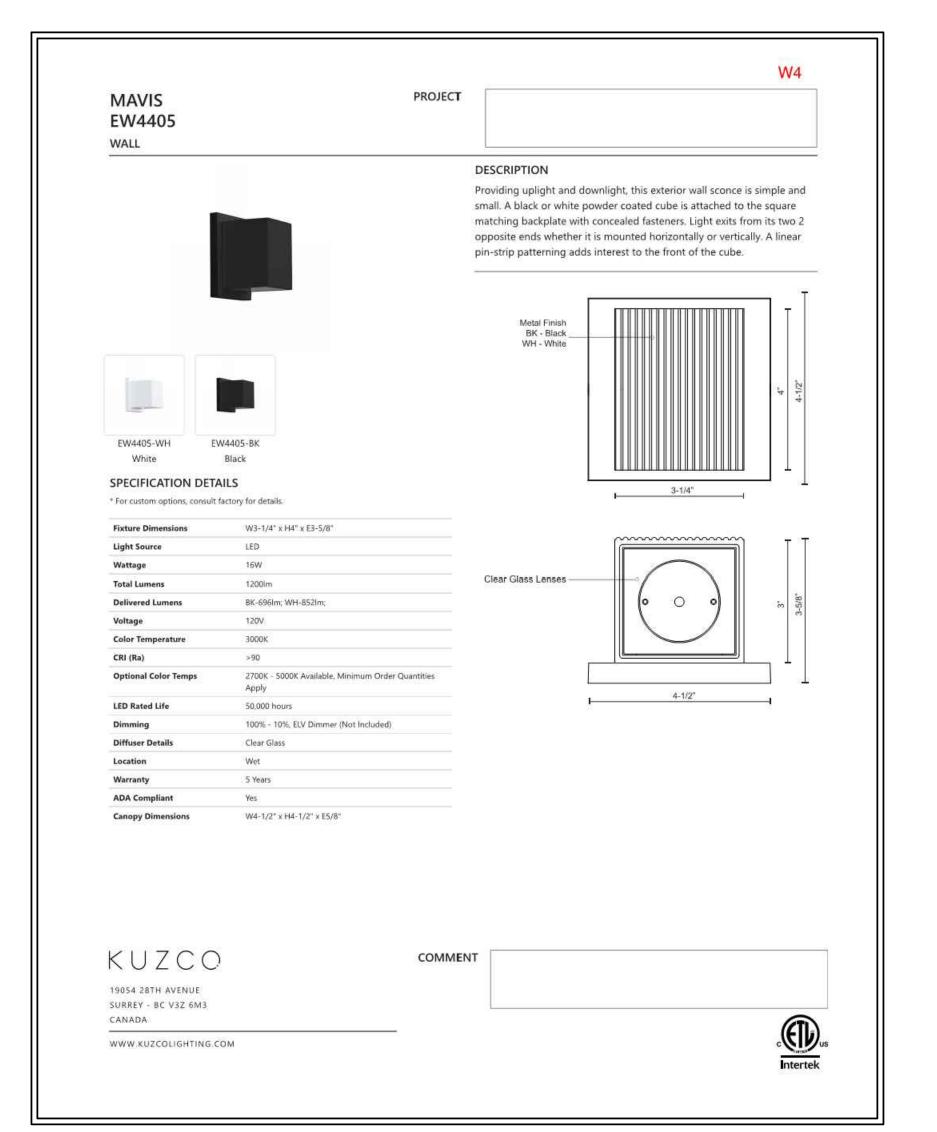



PROJECT:

SCALE:

DRAWN BY:

AS NOTED

4/1/2020