




L 1.1

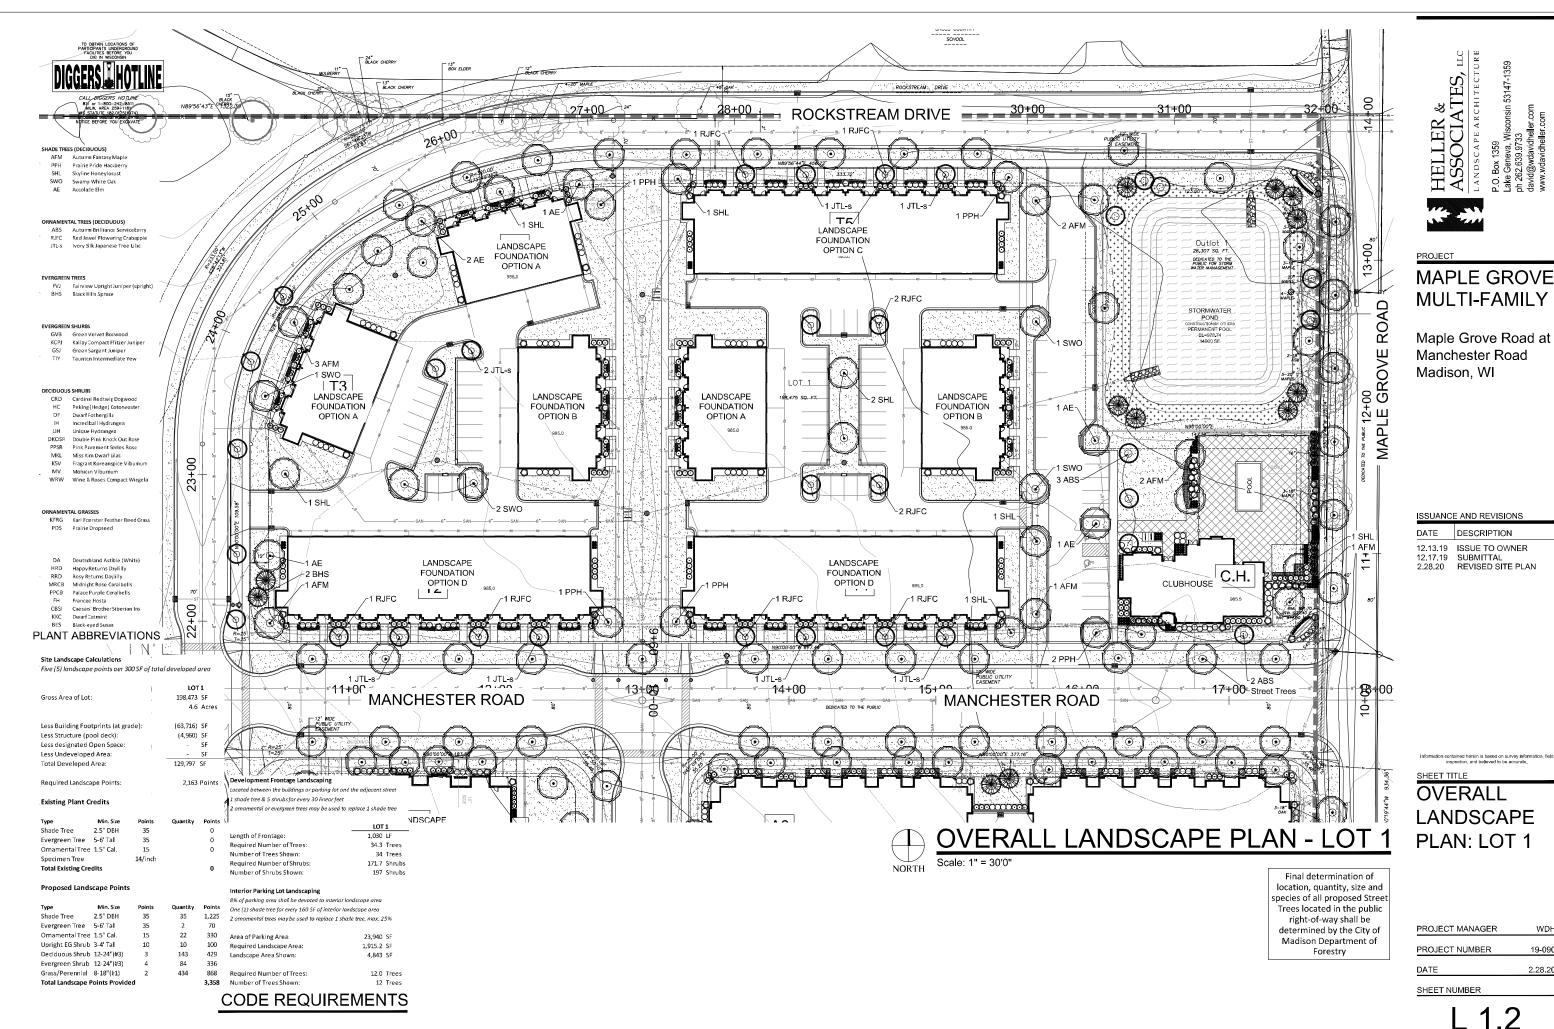

L 1.2

2.28.20

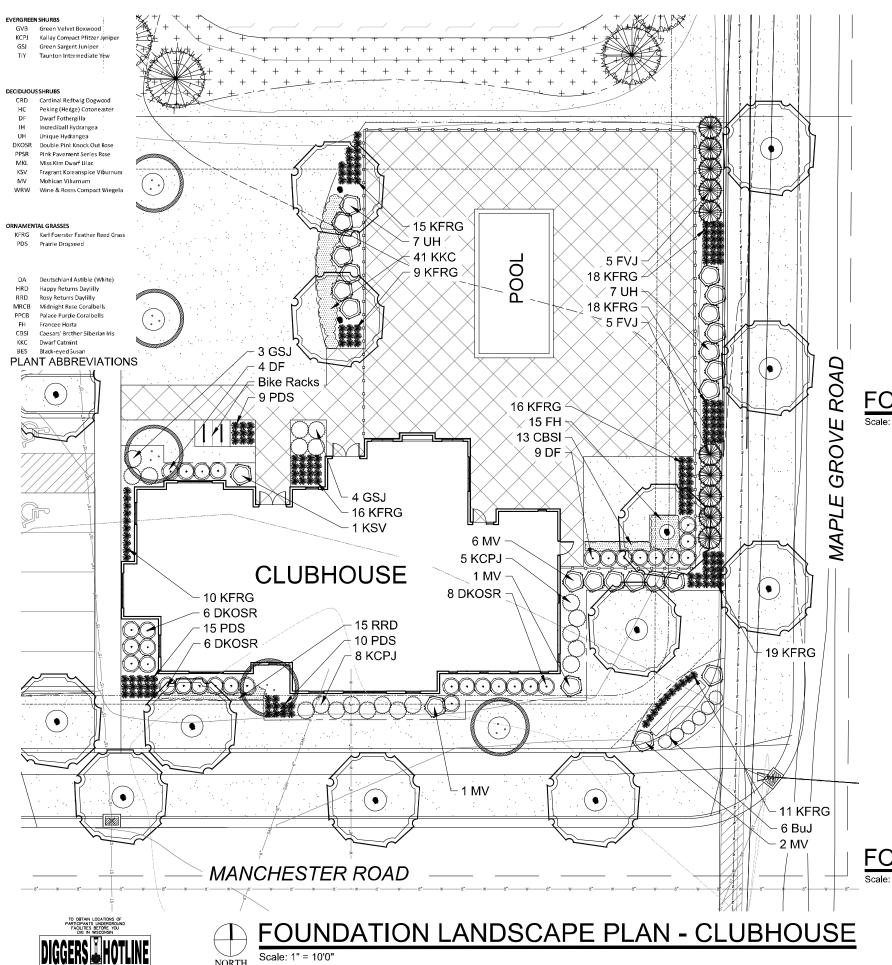

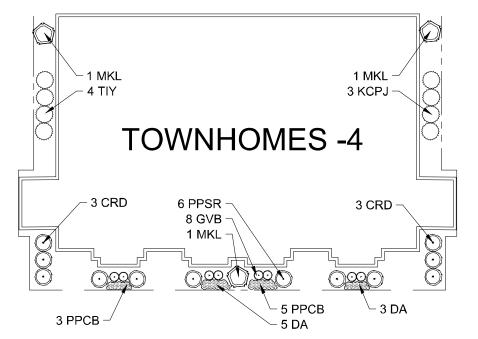


HELLER & ASSOCIATES, LLC LANDSCAPE ARCHITECTURE P.O. Box 1359 Lake Geneva, Wisconsin 53147-1359 ph 262.639.373 david@wdavidheller.com www.wdavidheller.com

PROJECT

MAPLE GROVE MULTI-FAMILY

Maple Grove Road at Manchester Road Madison, WI

FOUNDATION LANDSCAPE PLAN - OPTION "A"

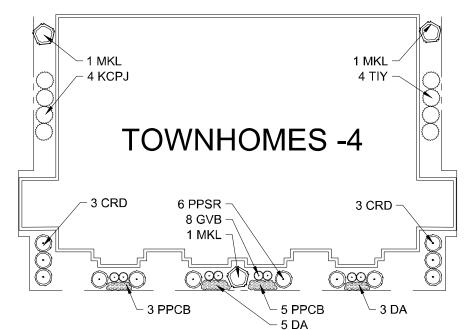

FOUNDATION LANDSCAPE PLAN - OPTION "B" Scale: 1" = 10'0"

DATE DESCRIPTION

12.13.19 ISSUE TO OWNER 12.17.19 SUBMITTAL 2.28.20 REVISED SITE PLAN


Information contained herein is based on survey information, fi inspection, and believed to be accurate.

FOUNDATION
LANDSCAPE
PLANS:
CLUBHOUSE &
TOWNHOUSE


PROJECT MANAGER	WDH
PROJECT NUMBER	19-090
DATE	2.28.20
SHEET NUMBER	

L 1.3



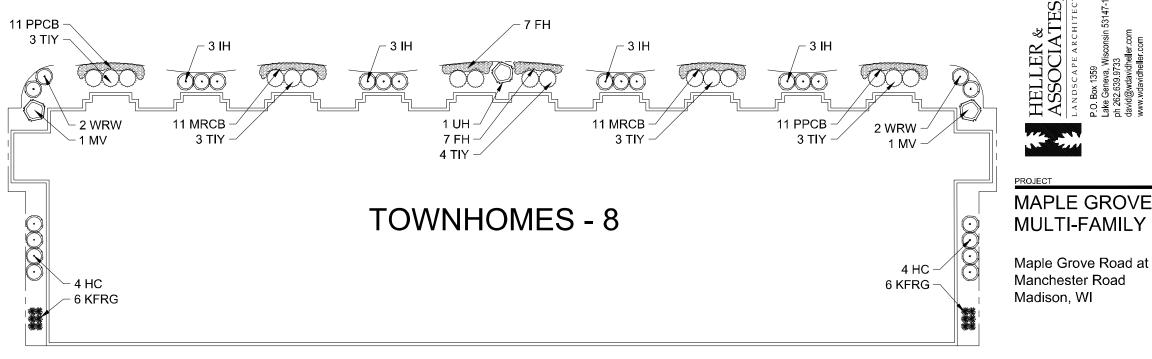



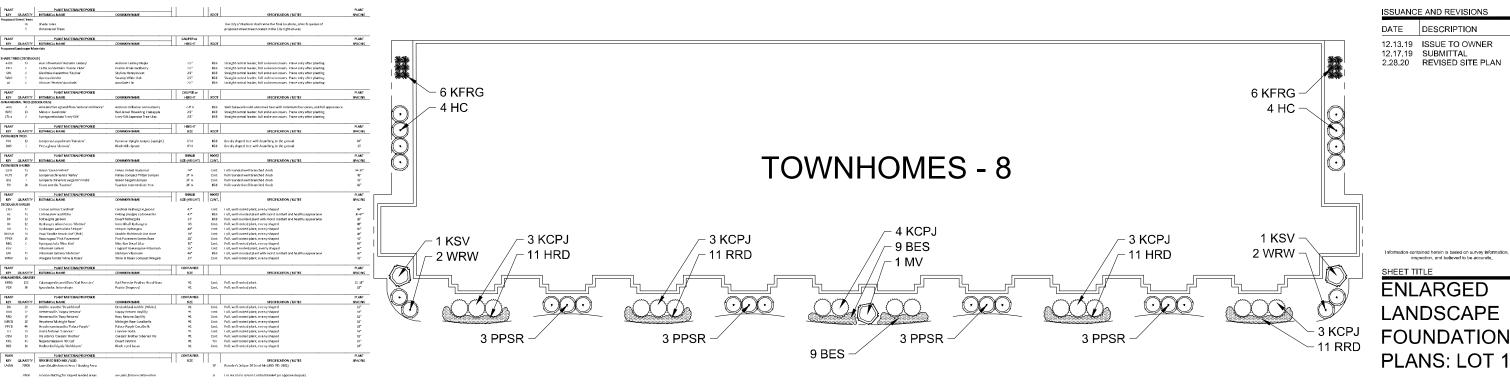

FOUNDATION LANDSCAPE PLAN -OPTION "D"


PROJECT NUMBER

SHEET NUMBER


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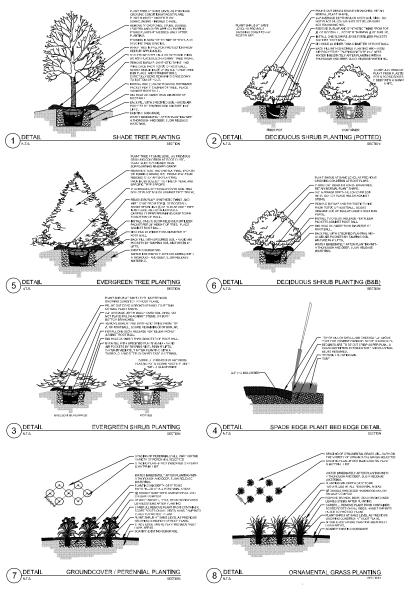
L 1.4

PLANT & MATERIAL SCHEDULE: LOT 1




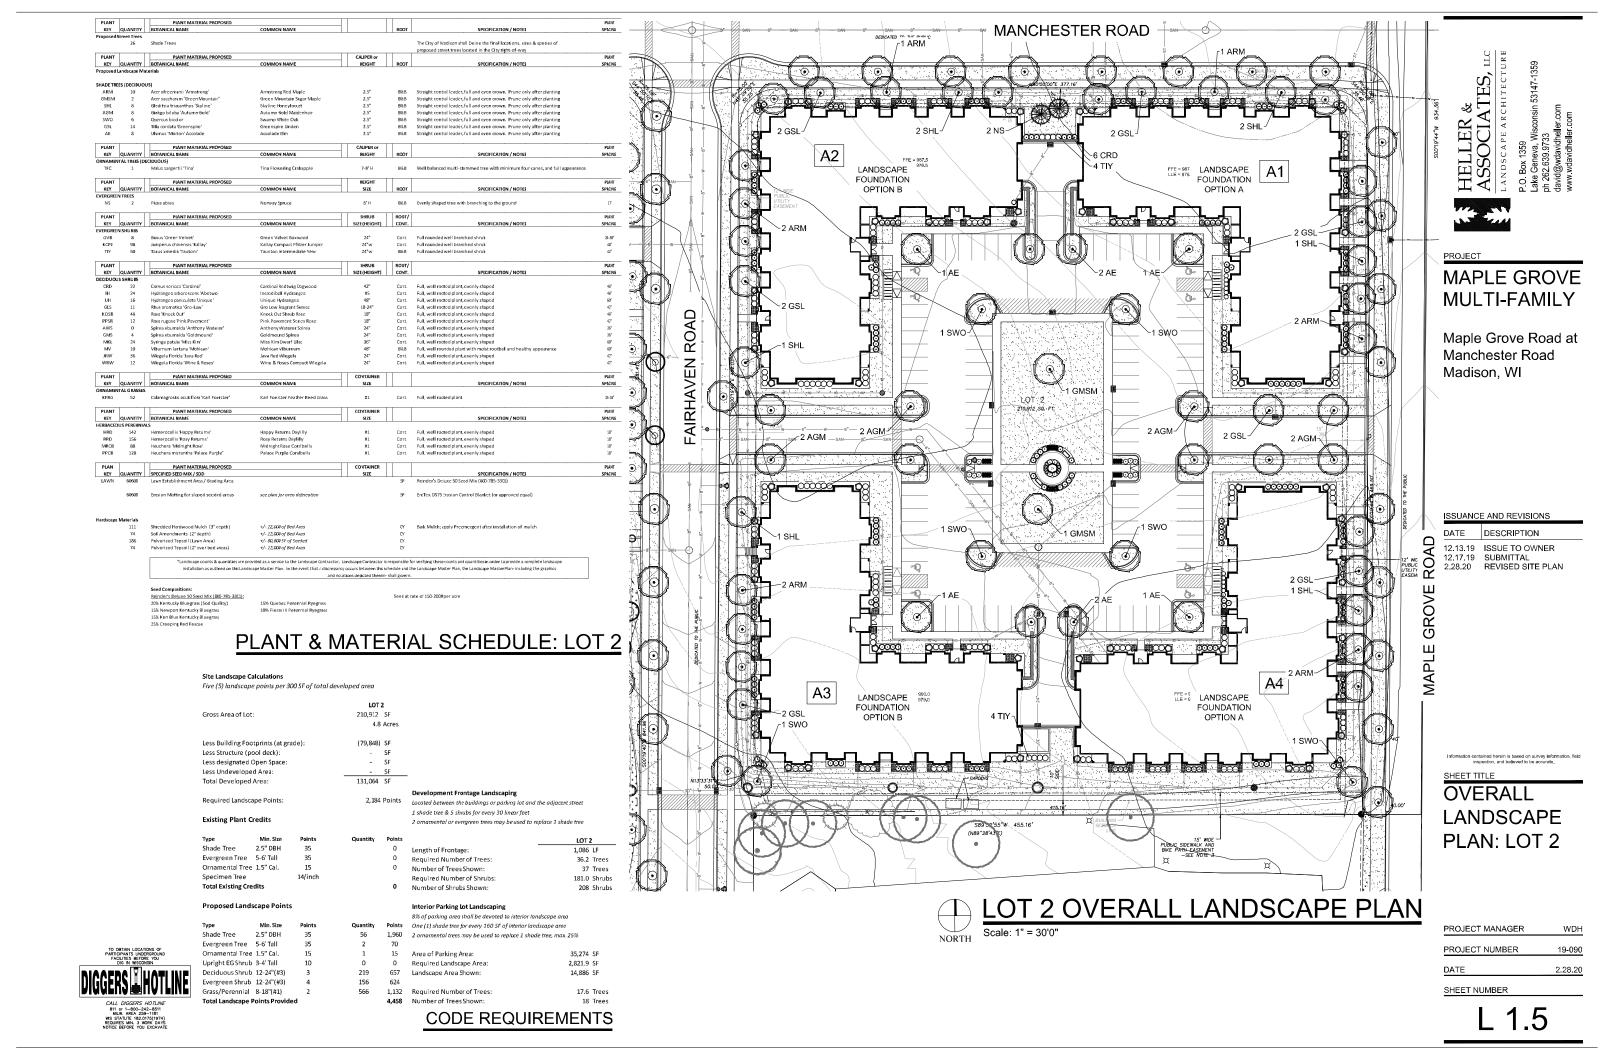



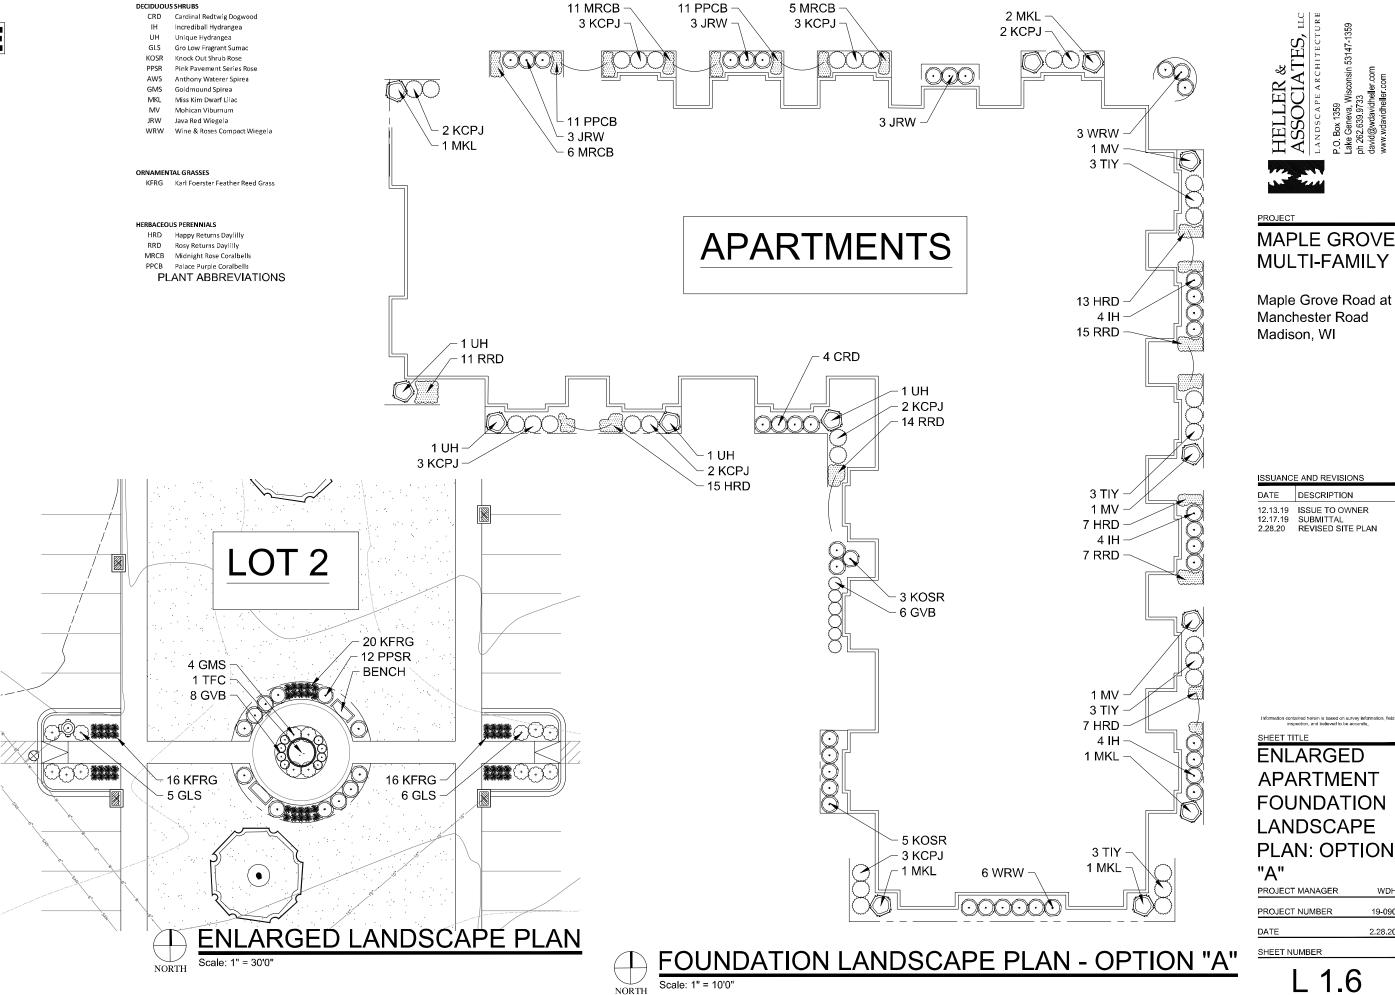


PLANTING & HARDSCAPE DETAILS

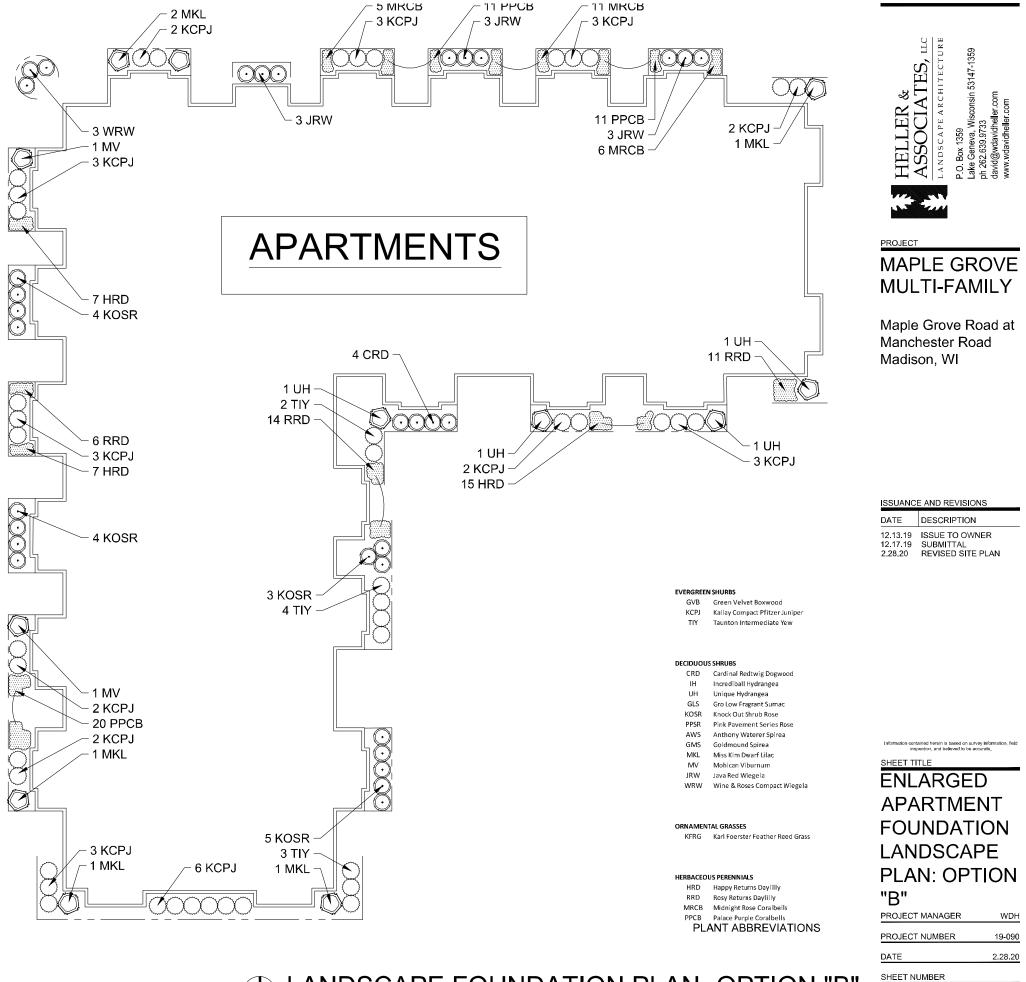

LAI
Scale: 1

LANDSCAPE FOUNDATION PLAN -OPTION "B"

L 1.7

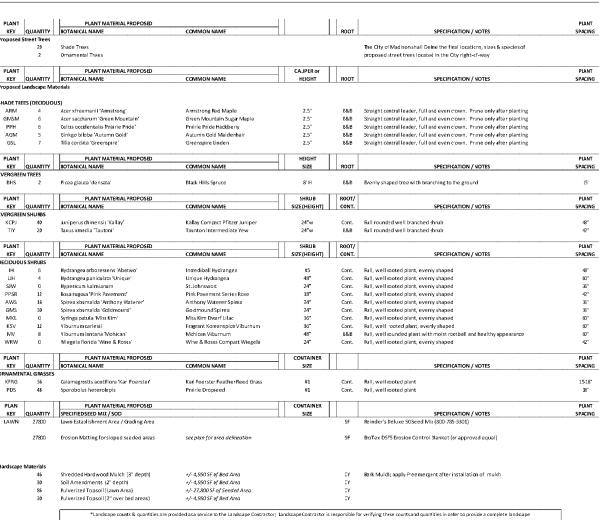

installation as outlined on this Landscape Master Plan. In the event that a discrepancy occurs between this schedule and the Landscape Master Plan, the Landscape Master Plan including the graphic and notations depoted therein-shall govern

15% Creeping Red Fescue

Reinder's Deluxe 50 Seed Mix (800-785-3301): 20% Kentucky Bluegrass (Sod Quality) 15% Newport Kentucky Bluegrass 15% Ken Blue Kentucky Bluegrass

15% Quebec Perennial Ryegrass 10% Fiesta III Perennial Ryegrass Seed at rate of 150-200# per acie

PLANT & MATERIAL SCHEDULE: LOT 3

Site Landscape Calculations

Five (5) landscape points per 300 SF of total developed area

	LOT 3	;	
Gross Area of Lot:	71,092	SF	
	1.6	Acres	
Less Building Footprints (at grade):	(22,692)	SF	
Less Structure (pool deck):	-	SF	
Less designated Open Space:	-	ŞF	
Less Undeveloped Area:	-	SF	
Total Developed Area:	48,400	SF	
			Development Frontage Landscaping
Required Landscape Points:	807	Points	Located between the buildings or parking lo

Located between the buildings or parking lot and the adjacent street 1 shade tree & 5 shrubs for every 30 linear feet

Existing Plant Credits


Туре	Min. Size	Points	Quantity	Points		LOTS	3
Shade Tree	2.5" DBH	35		0	Length of Frontage:	785	LF
Evergreen Tree	5-6' Tall	35		0	Required Number of Trees:	26.2	Trees
Ornamental Tree	1.5" Cal.	15		0	Number of Trees Shown:	26	Trees
Specimen Tree		14/inch			Required Number of Shrubs:	130.9	Shrubs
Total Existing Cre	edits			0	Number of Shrubs Shown:	126	Shrubs

Proposed Landscape Points

8% of parking area shall be devoted to interior landscape area One (1) shade tree for every 160 SF of interior landscape area

Shade Tree	2.5" DBH	35	28	980	2 ornamental trees may be used to replace 1 shade tree, max. 25%		
Evergreen Tree	5-6' Tall	35	2	70			
Ornamental Tree	1.5" Cal.	15	0	0	Area of Parking Area:	5,055	SF
Upright EG Shrub	3-4' Tall	10	0	0	Required Landscape Area:	404.4	SF
Deciduous Shrub	12-24"(#3)	3	88	264	Landscape Area Shown:	408	SF
Evergreen Shrub	12-24"(#3)	4	60	240			
Grass/Perennial	8-18"(#1)	2	84	168	Required Number of Trees:	2.5	Trees
				4 700	N 1 67 01	~	-

Interior Parking Lot Landscaping

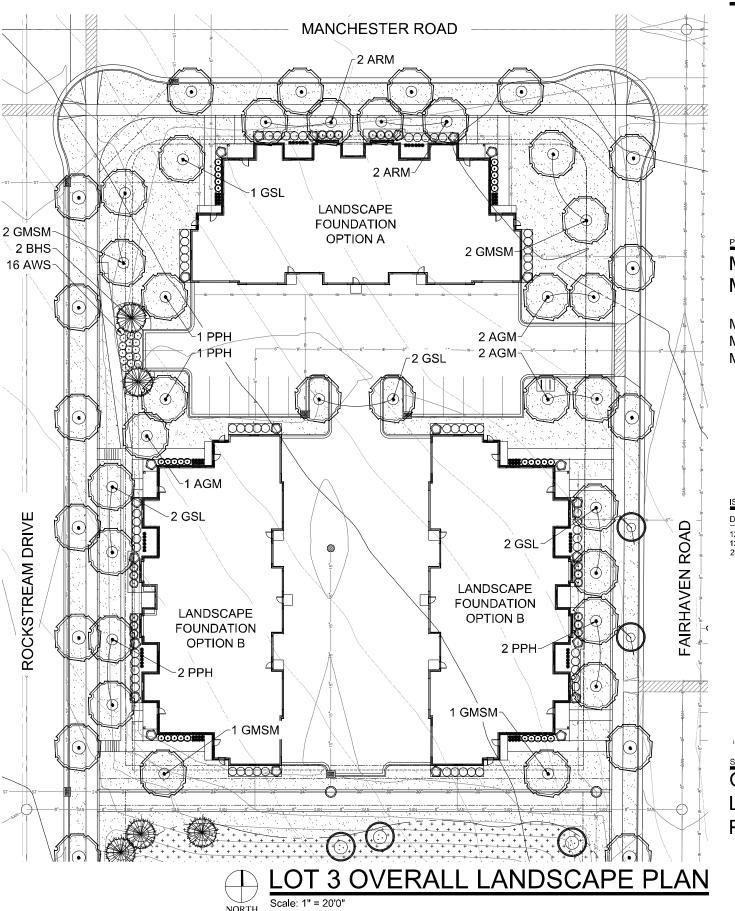

HELLER & ASSOCIATES, 1

MAPLE GROVE **MULTI-FAMILY**

Maple Grove Road at Manchester Road Madison, WI

ISSUANCE AND REVISIONS

DESCRIPTION 12.13.19 ISSUE TO OWNER 12.17.19 SUBMITTAL REVISED SITE PLAN

SHEET TITLE

OVERALL LANDSCAPE PLAN: LOT 3

PROJECT MANAGER	WDH
PROJECT NUMBER	19-090
DATE	2.28.20
SHEET NUMBER	

L 1.8

CODE REQUIREMENTS

ntal or evergreen trees may be used to replace 1 shade tree



EVERGREEN SHURBS

KCPJ Kallay Compact Pfitzer Juniper Taunton Intermediate Yew

DECIDUOUS SHRUBS

Incrediball Hydrangea UH Unique Hydrangea PPSR Pink Pavement Series Rose AWS Anthony Waterer Spirea MKL Miss Kim Dwarf Lilad **KSV** Fragrant Koreanspice Viburnum

Wine & Roses Compact Wiegela

ORNAMENTAL GRASSES

WRW

KFRG Karl Foerster Feather Reed Grass PDS Prairie Dropseed

PLANT ABBREVIATIONS

- 1. Contractor responsible for contacting Diggers Hotline (811 or 800-242-8511) to have site marked prior to excavation or planting
- 2. Contractor to verify all plant quantities shown on Plant & Material List and landscape planting symbols and report any discrepancies to Landscape Architect of General Contractor.
- 3. All plantings shall comply with standards as described in American Standard of Nursery Stock Z60.1 ANSI (latest version). Landscape Architect reserves the right to inspect, and potentially reject any plants that are inferior, compromised, undersized, diseased, improperly transported, installed incorrectly or damaged. No sub-standard "3 Gorde" or "Park Grade" plant hallerial shall be accepted. Plant material shall portinate any originate from nursery(fies) with a similar dimate as a final plant material shall port material shall provide the property of the property of the provided provided that the provided provided the provided provide
- 5. Topspol in Parking Lot Islands (if applicable): All parking lot islands to be backfilled with topsoil to a minimum depth of 18" to insure long-term plant health. Topsoil should be placed within 3" of finish grade by General Contractor / Excavation Contractor during rough grading operations/activity. The landscape contractor shall be responsible for the fine grading of all disturbed areas, planting bed areas, and lawn areas. Crown all parking lot islands a minimum of 6" to provide proper drainage, unless otherwise specified.
- 6. Tree Planting: Plant all trees slightly higher than finished grade at the root flare. Remove excess soil from the top of the root ball, if needed. Remove and discard non-biodegradable ball wrapping and support wire. Removed biodegradable burlap and wire cage (if present) from the top \(\frac{1}{3}\) of the rootball and carefully bend remaining wire down to the bottom of the hole. Once the tree has been placed into the hole and will no longer be moved, score the remaining $\frac{2}{3}$ of the burlap and remove the twine. Provide three slow release fertilizer for each tree planted.
- 7. Tree Planting: Backfill tree planting holes 80% existing soils removed from excavation and 20% plant starter mix. Avoid air pockets and do not tamp soil down. Discard any gravel, rocks, heavy clay, or concrete pieces. When hole is § full, trees shall be watered thoroughly, and water left to soak in before proceeding to fill the remainder of the hole. Water again to full soak in the new planting. Each tree shall receive a 3" deep, 4-5" diameter (see planting details or planting plan) shredded hardwood bark mulch ring around all trees planted in Jawan areas. Do not build up any mulch onto the trunk of any tree. Trees that are installed incorrectly will be replaced at the time and expense of the Landscape Contractor.
- 8. Shrub Planting: All shrubs to be planted in groupings as indicated on the Landscape Plan. Install with the planting of shrubs a ¹⁰/₅₀ mix of plant starter with topsoil. Install lopsoil into all plant beds as needed to achieve proper grade and displace undesirable soil (see planting detail). Remove all excessive graved, day and stones from plant beds prior to planting. When hole(s) are ½ full, shrubs shall be watered thoroughly, and water left to soak in before proceeding. Provide slow-release fertilizer packets at the rater of 1 per 24* height/diamter of shrub at planting.
- 9. Mulching. All free and shrub planting beds to receive a 3" deep layer of high qualify shredded hardwood bark mulch (not pigment dyed or enviro-mulch). All perennial planting areas (groupings) shall receive a 2" layer of shredded hardwood bark mulch, and groundcover areas a 1-2" layer of the same mulch. Do not mulch annual flower bods (if applicable). Do not allow mulch to contact plant stems and tree trunks.
- 10. Edging: All planting beds shall be edged with a 4" deep spade edge using a flat landscape spade or a mechanical edger. Bedlines are to be cut crisp, smooth as per plan. A clean definition between landscape beds and lawn is required. Pack mulch against lawn edge to hald in place.
- 11. Plant bed preparation/Soil Amendment composition: All perennial, groundcover and annual areas (if applicable) are required to receive a blend of organic soil (Soil Amendments) amendments prior to installation. Roto-till the following materials at the following ratio, into existing soil beds or installed topsoil beds to a depth of approximately 8"-10". Containerized and balled & burlapped plant material should be back-filled with amended soil:

Per 100 SF of bed area (Soil Amendment composition): ¾ CY Peat Moss or Mushroom Compost

¾ CY blended/pulverized Topsoil
¼ CY composted manure

In roto-tilled beds only, also include in above mixture: 2 lbs Starter Fertilizer

- 12. Lawn Installation for all sodded turfgrass areas: Contractor to furnish and prepare blended topsoli (2" minimum) and sod bed, removing all debris and stones ½" and larger. Apply a 10-10-10 starter lawn fertilizer uniformly throughout areas prior to laying sod. Use only premium sod blend according to TPI (revised 1995) and ASPA Standards. Install sod uniformly with staggered joints, laid tightly end to end and side to side. Roll sod with a walk behind roller and water immediately upon installation to a 3" depth. Stake any sod installed on slopes steeper than 13, and in late applications. Contractor is responsible to provide a smooth, uniform, healthy turf, and is responsible for the first two mowings of the newly installed turf, and is also responsible for watering during this
- 13. Installation preparation for all seeded areas: remove/kill off any existing unwanted vegetation prior to seeding. Prepare the topsoil (if adequate or provide as in item #6 above) and seed bed by removing all surface stones 1* or larger. Apply a starter fertilizer and specified seed uniformly at the specified rate, and provide much covering suitable to germinate and establish turf. Provide seed and fertilizer specifications to Landscape Architect and Owner prior to installation. Erosion control measures are to be used in swales and on shopes in excess of 1:3 and where applicable (see Civil Engineering Drawings). Methods of installation may var are the discretion of the Landscape Contractor on his/her responsibility to establish and guarantee a smooth, uniform, quality turf. A minimum of 2* days are the discretion of the Landscape Contractor on his/her responsibility to establish and guarantee a smooth, uniform, quality turf. A minimum of 2* of blended, prepared and non-compacted toposi is required for all lavar areas. If straw mulch used as a mulch covering, a tacklifier may be necessary to avoid wind dispersal of mulch covering. Marsh hay containing reed canary grass is NOT acceptable as a mulch covering.

An acceptable quality seed installation is defined as having:


No bare spots larger than one (1) square foot

No more than 10% of the total area with bare areas larger than one (1) square foot

- 14. No-Mow seed areas: "No-Mow" fine fescue seed mix with annual rye nurse crop (available at Cedar Creek Seed Farm 888-313-6807; or Prairie Nursery 608-286-3879) or approved equivalent mix from a reputable seed mix provider. Apply at 220 lbs per acre or at rate recommended by supplier. Prepare seed bed and soil as specified in time #13 above.
- 15. Native Prairie Seed Mix / Stormwater Seed Mix: Native seed mixes as listed on the Plant and Material List or other seeding schedules outlined on the landscape plan set. Seed mixes available from Prairie Nursery 808-296-3379 or JF New 808-348-1783 or approved equivalent mix from a reputable seed mix provider. Apply at rates specified herein, or per supplier recommendation. Prepare soil and seed bed as in lam #13 above.
- 16. Warranty and Replacements: All plantings are to be watered thoroughly at the time of planting, through construction and upon completion of project as required. Trees, Evergreens, and Shrubs (deciduous and evergreen) shall be guaranteed (100% replacement) for a minimum of one (1) year from the date of project completion. Perennials, groundovers, and ornamental grasses shall be guaranteed for a minimum of one (1) growing season. Perennials, groundovers, and ornamental grasses planted after September 15th shall be guaranteed through May 31st the following year. Only one replacement per plant will be required during the warranty period, except for bases or replacements due to fallure to comply with grain strength on the project.

 Watering and general ongoing maintenance instructions are to be supplied by the Landscape Contractor to the Owner upon completion of the project.
- 17. The Landscape Contractor is responsible for the watering and maintenance of all landscape areas for a period of 45 days after the substantial completion of the landscape installation. This shall include all trees, shrubs, evergreens, perennials, omamental grasses, turf grass, no-mow grass, and native prairie seed mix / stormwater seed mix. Work also includes weeding, edging, mulching (only if required), fertilizing, trimming, sweeping up grass dippings, pruning and dependentions.
- 18. Project Completion: Landscape Contractor is responsible to conduct a final review of the project, upon completion, with the Landscape Architect, Client o Owner / Clent Representative, and the General Contractor to answer questions, provide written care instructions for new plantings and turf, and insure that all specifications have been mel.

LANDSCAPE GENERAL NOTES

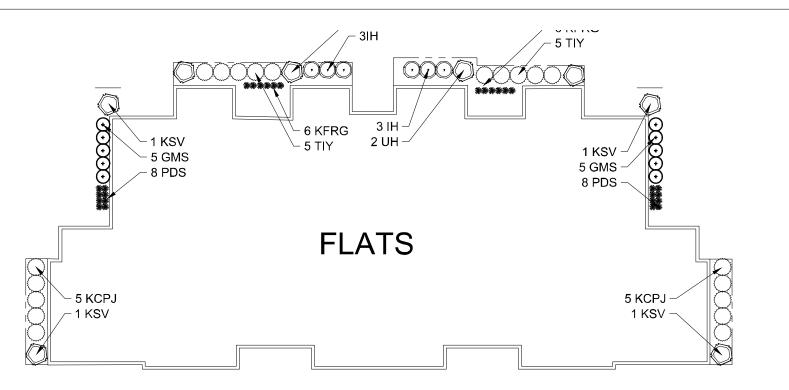




MAPLE GROVE MULTI-FAMILY

Maple Grove Road at Manchester Road Madison, WI



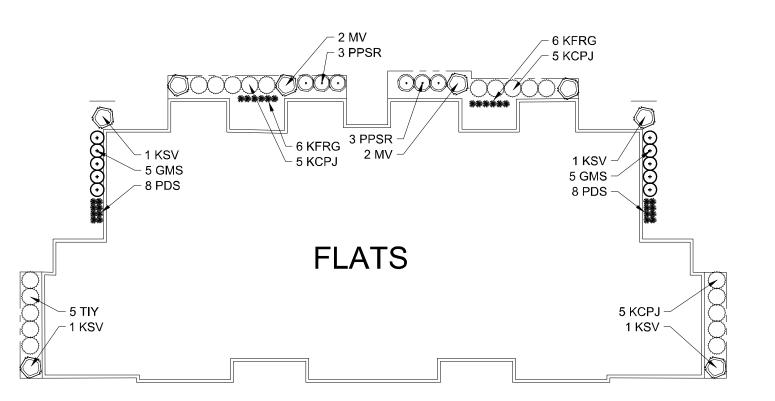

ISSUANCE AND REVISIONS

DESCRIPTION DATE 12.13.19 ISSUE TO OWNER 12.17.19 SUBMITTAL 2.28.20 REVISED SITE PLAN


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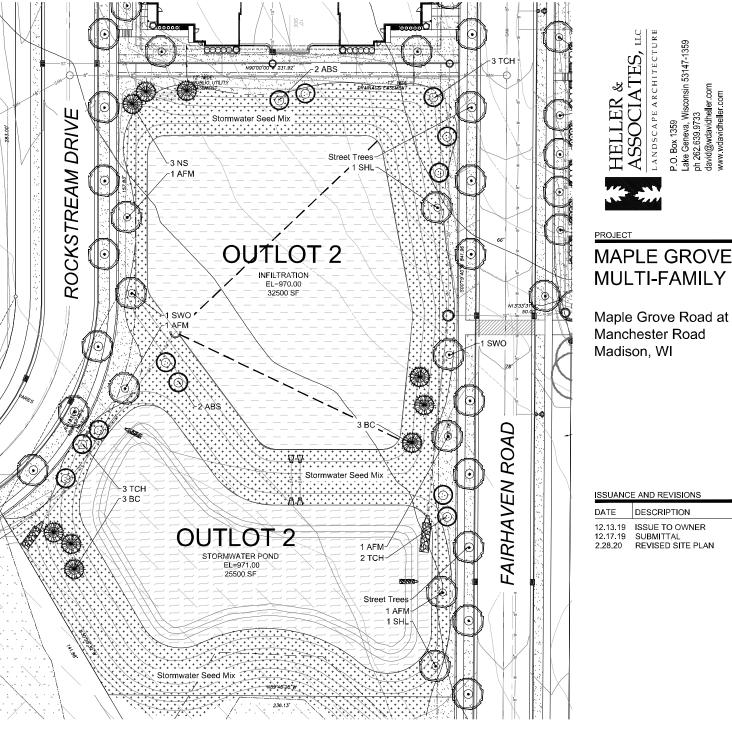
OVERALL LANDSCAPE PLAN: LOT 3

PROJECT MANAGER	WDI
PROJECT NUMBER	19-09
DATE	2.28.2
SHEET NUMBER	

LANDSCAPE FOUNDTION - OPTION "B"

L 1.9



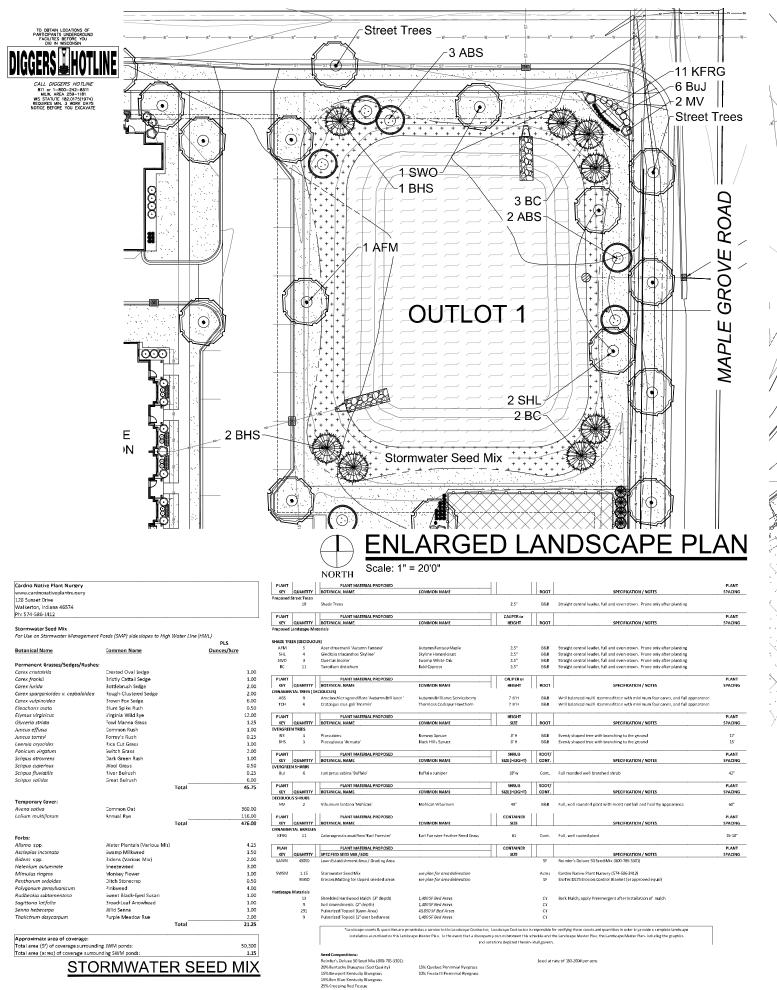

ENLARGED LANDSCAPE PLAN


OVERALL LANDSCAPE PLAN: OUTLOTS 1 & 2


DESCRIPTION

PROJECT NUMBER

L 1.10

PLANT & MATERIAL SCHEDULE: OUTLOTS 1 & 2

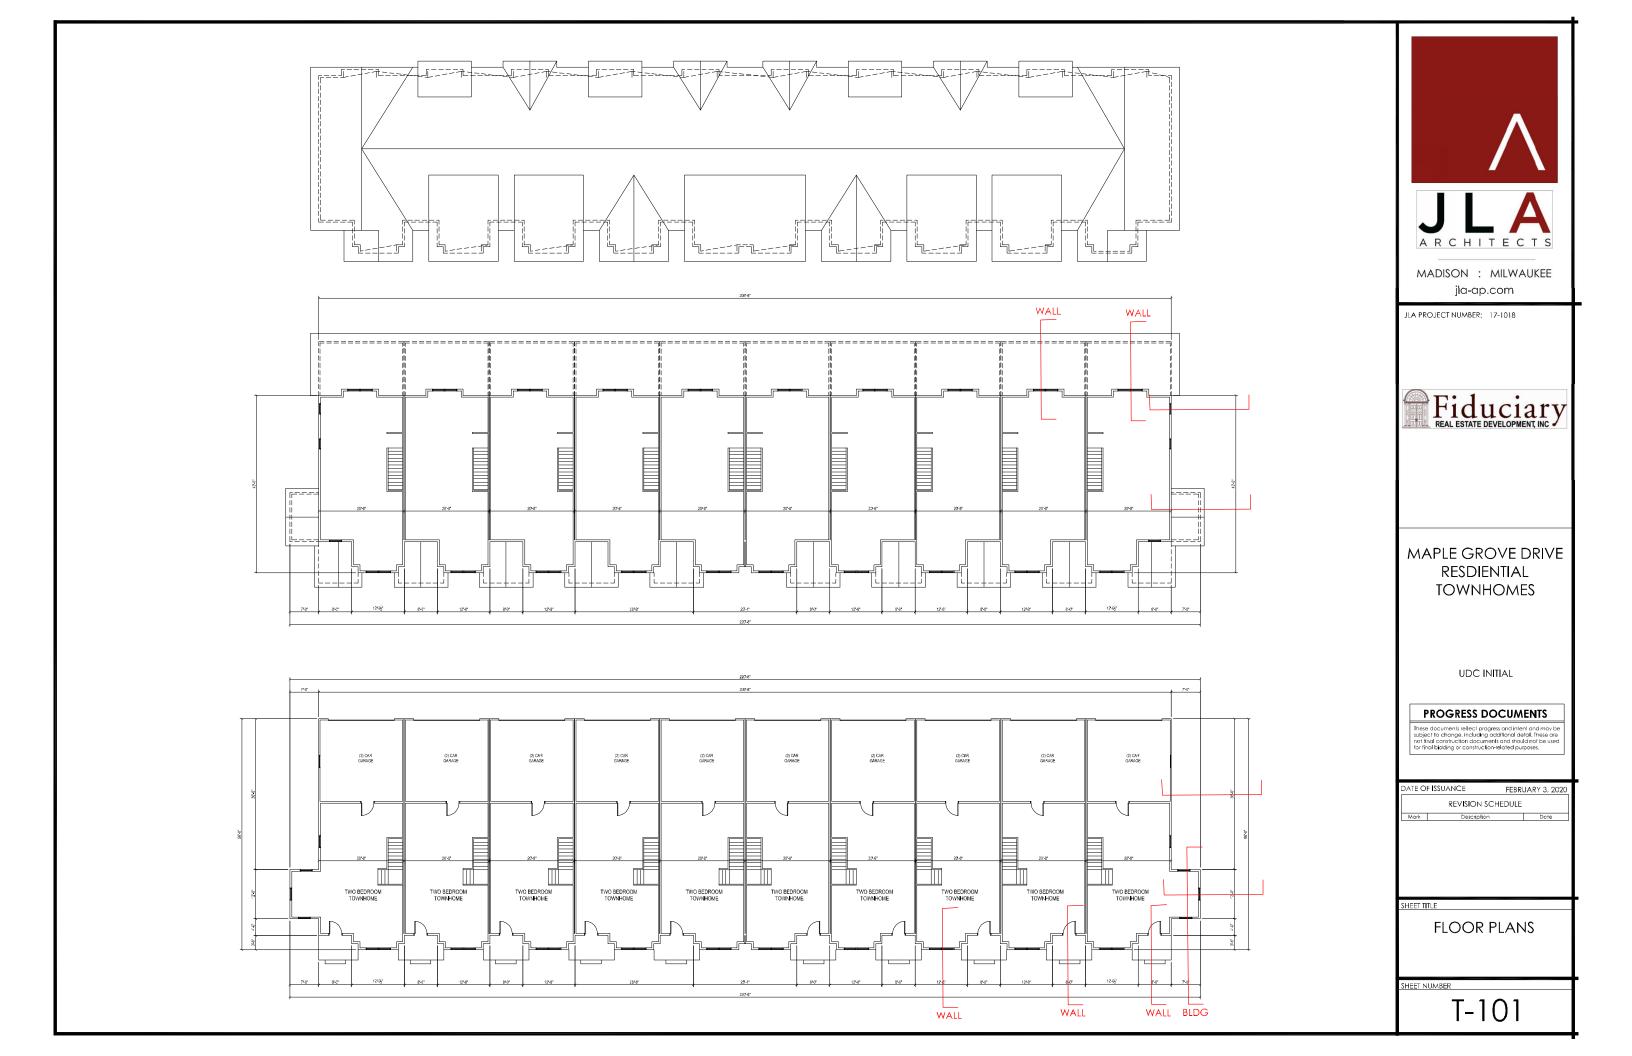

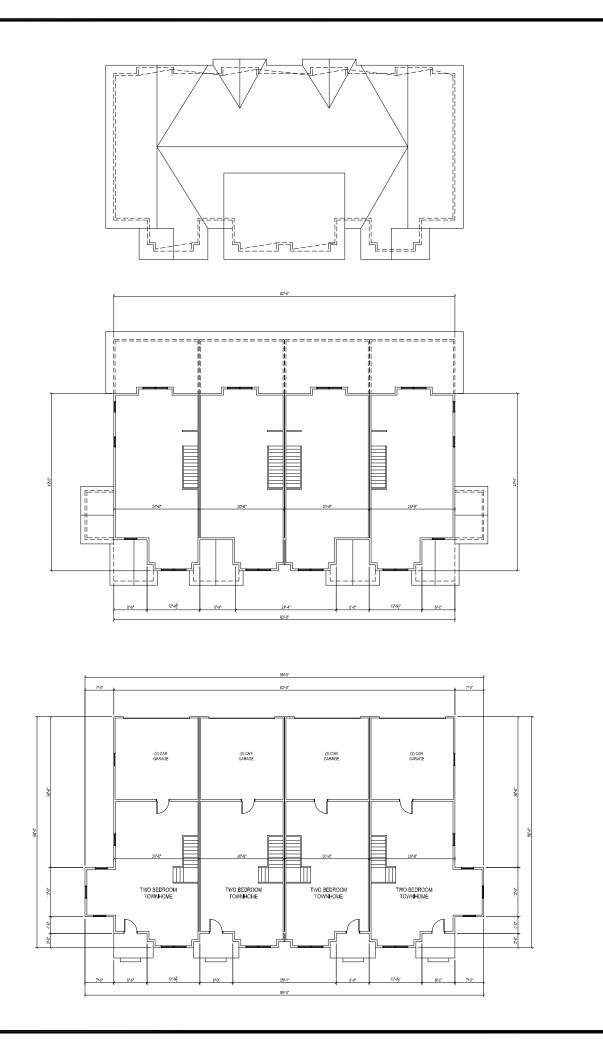



JLA PROJECT NUMBER: 17-1018



MAPLE GROVE DRIVE RESDIENTIAL TOWNHOMES

UDC INITIAL

PROGRESS DOCUMENTS

These documents reflect progress and intent and may be subject to change, including additional detail. These are not final construction documents and should not be used for final bidding or construction-related purposes.

DATE OF	ISSUANCE	FEBRUARY 3, 2020
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SHEET TITLE

FLOOR PLANS

SHEET NIIMBE

T-102







JLA PROJECT NUMBER: XX-XXXX-XX

MAPLE GROVE DRIVE RESDIENTIAL TOWNHOMES

UDC INITIAL

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DATE O	f Issuance	FEBRUARY 3, 2020
	revis ion s	CHEDULE
Mark	Description	Date

SHEET TIT

SKETCHUP ELEVATIONS

SHEET NUMBER

T-A200



VINYL LAP SIDING (COLOR #2) ---

16 10 Unit South Elevation

6 Side Elevation 2









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JLA PROJECT NUMBER: XX-XXXX-XX

MAPLE GROVE DRIVE RESDIENTIAL TOWNHOMES

UDC INITIAL

PROGRESS DOCUMENTS

DATE OF ISSUANCE FEBRUARY 3, 2020 REVISION SCHEDULE

SHEET TITLE

SKETCHUP **ELEVATIONS**

T-A201



16 10 Unit North Elevation

6 Side Elevation 1



6 PERSPECTIVE





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MAPLE GROVE DRIVE RESDIENTIAL TOWNHOMES

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REVISION SO	CHEDULE	
Mark Description Date		

SHEET TITL

SKETCHUP PERSPECTIVES

SHEET NUMBE

T-A202



6 PERSPECTIVE





MADISON : MILWAUKEE jla-ap.com

JLA PROJECT NUMBER: XX-XXXX-XX

MAPLE GROVE DRIVE RESDIENTIAL TOWNHOMES

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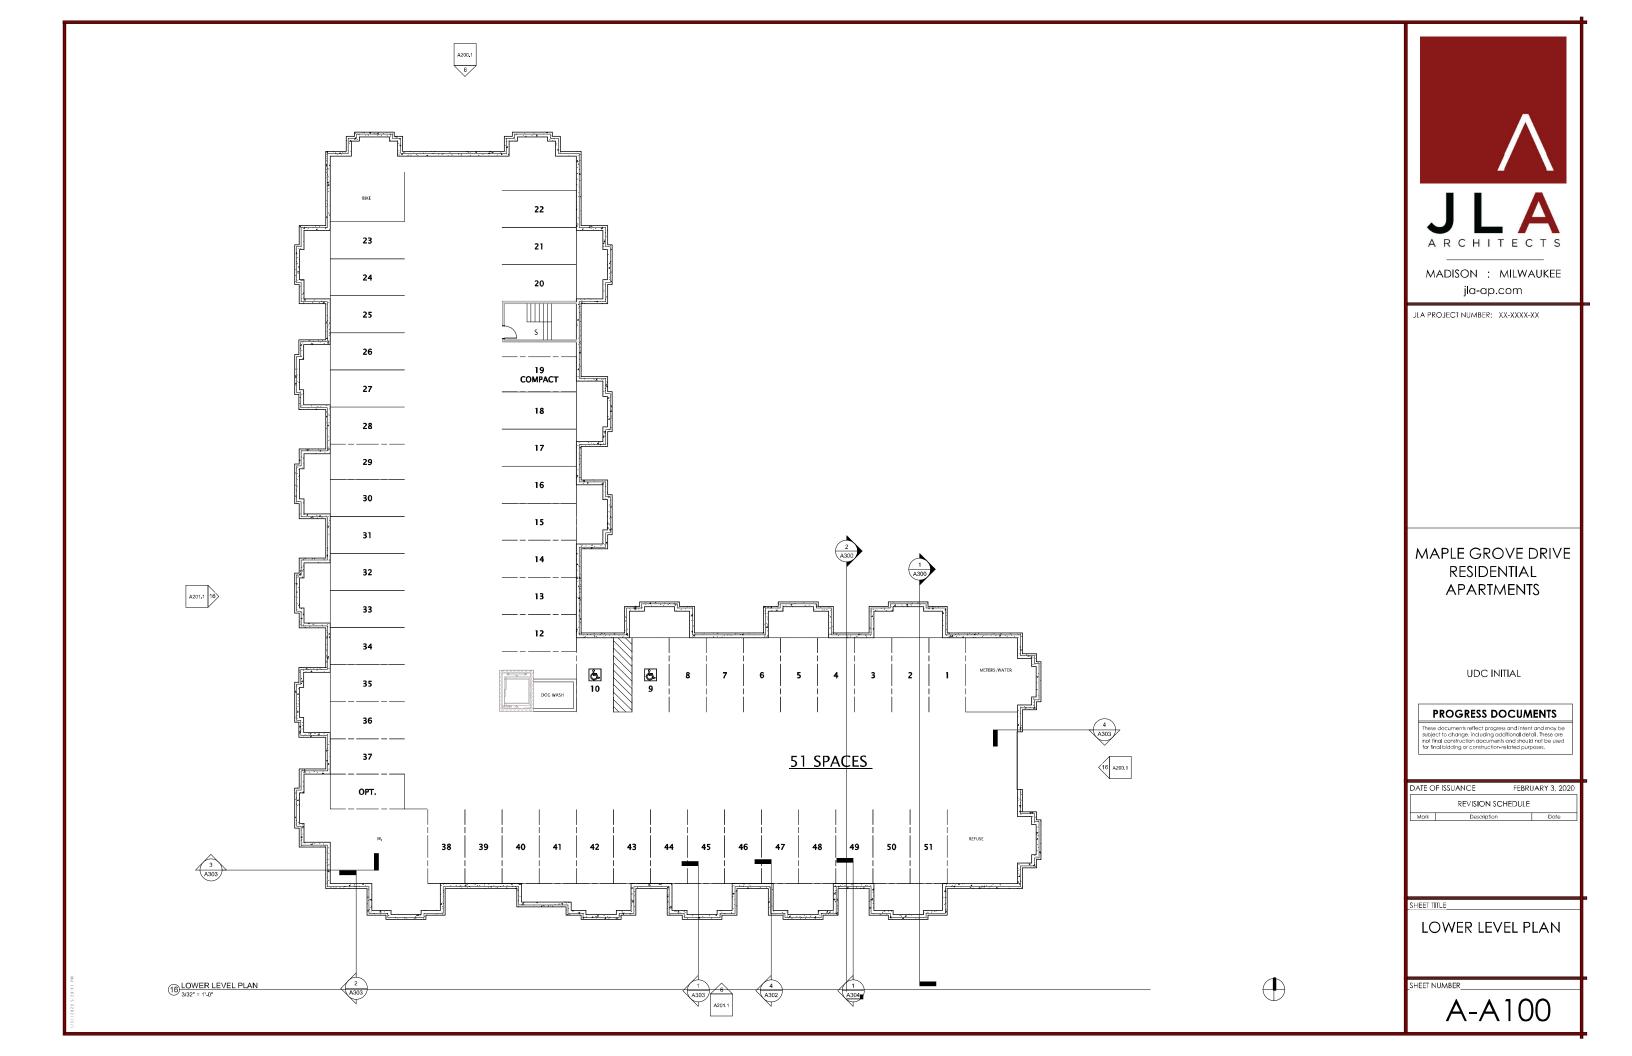
DATE OF ISSUANCE FEBRUARY 3, 2020			
REVISION SCHEDULE			
Mark	Description	n Date	


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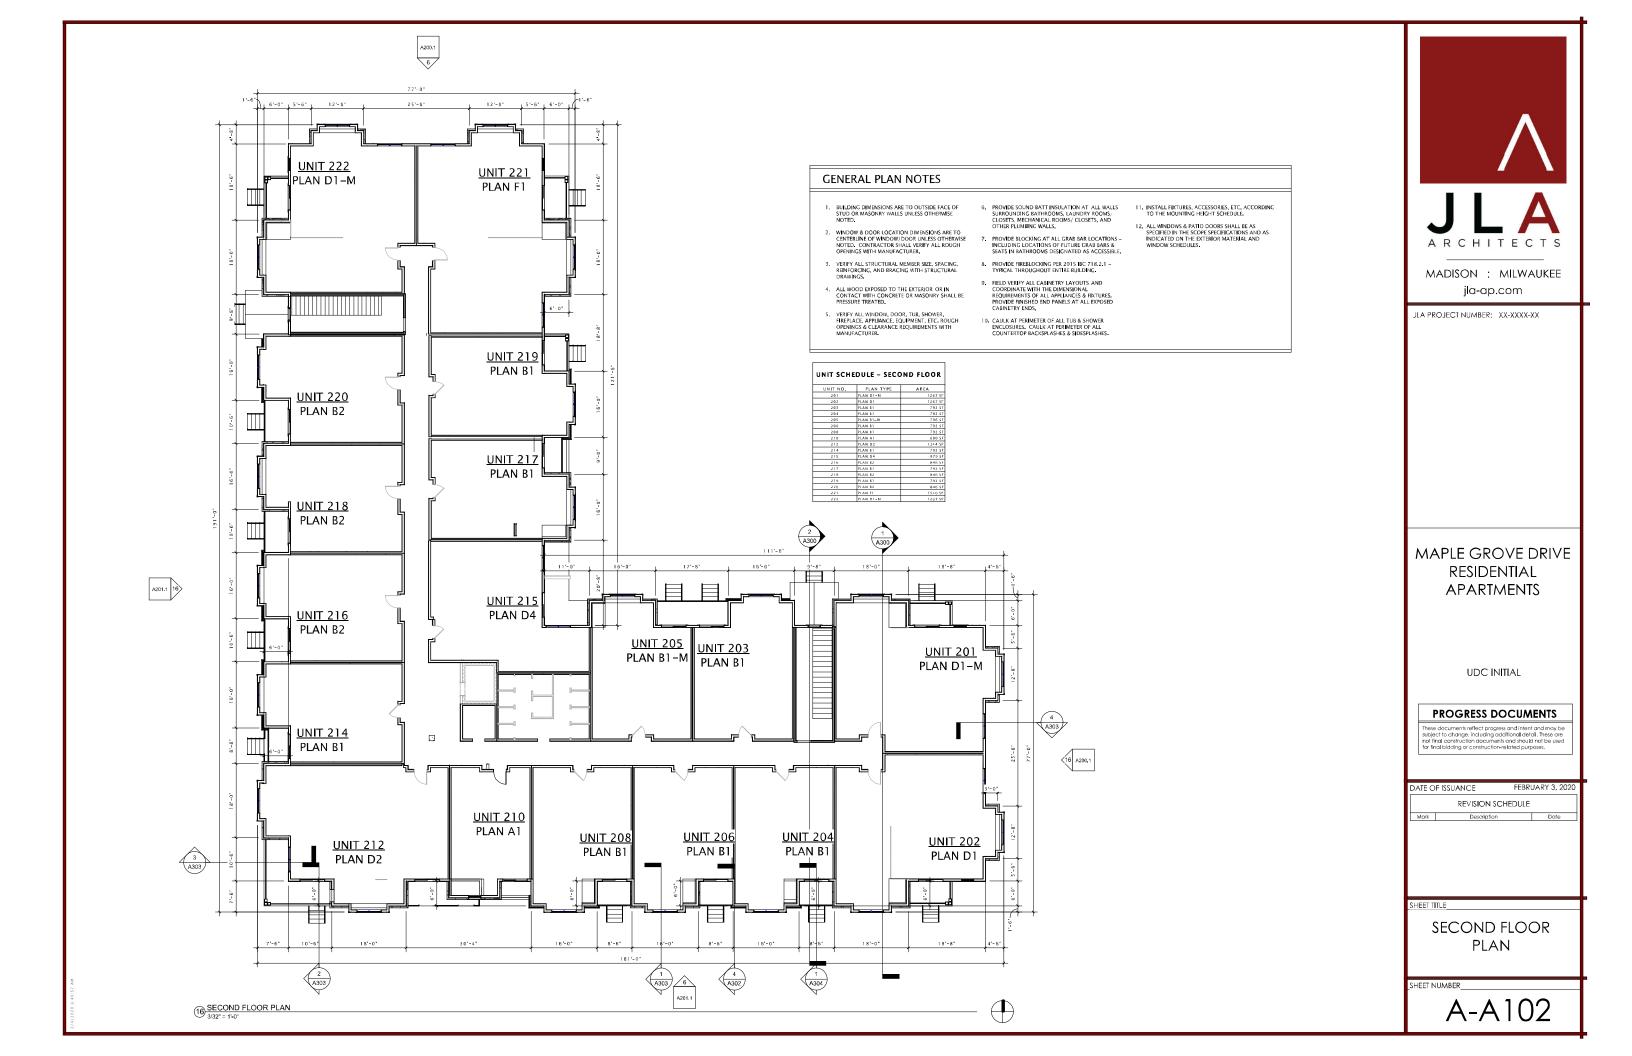
SKETCHUP PERSPECTIVES


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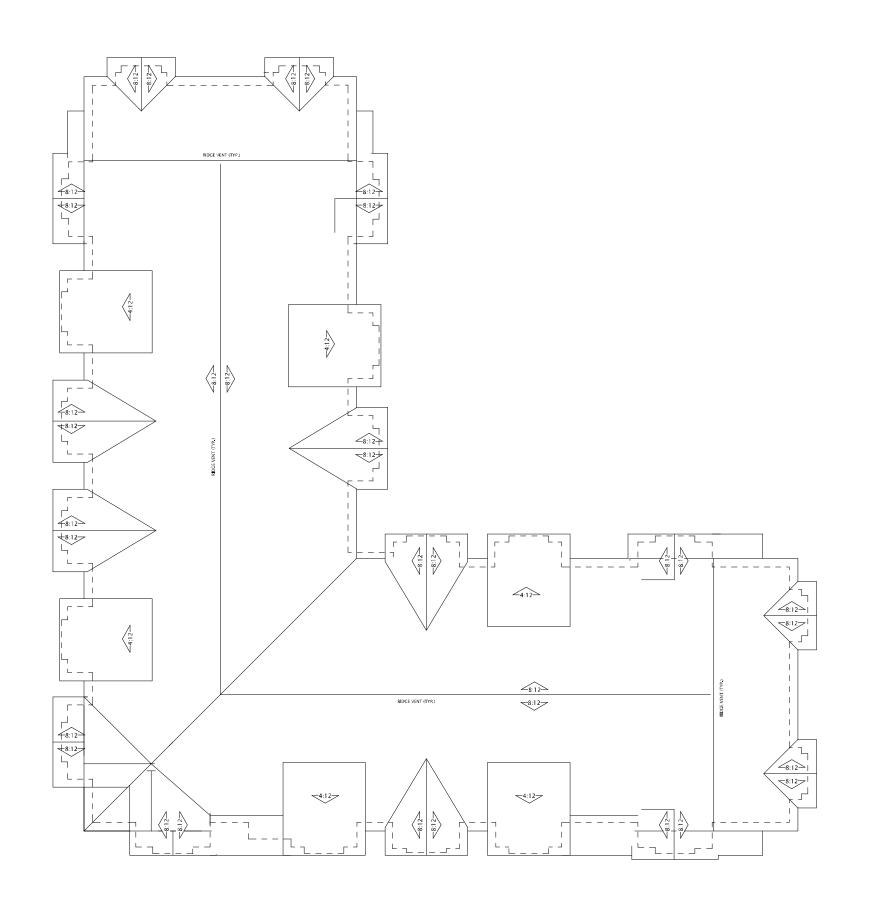
T-A202







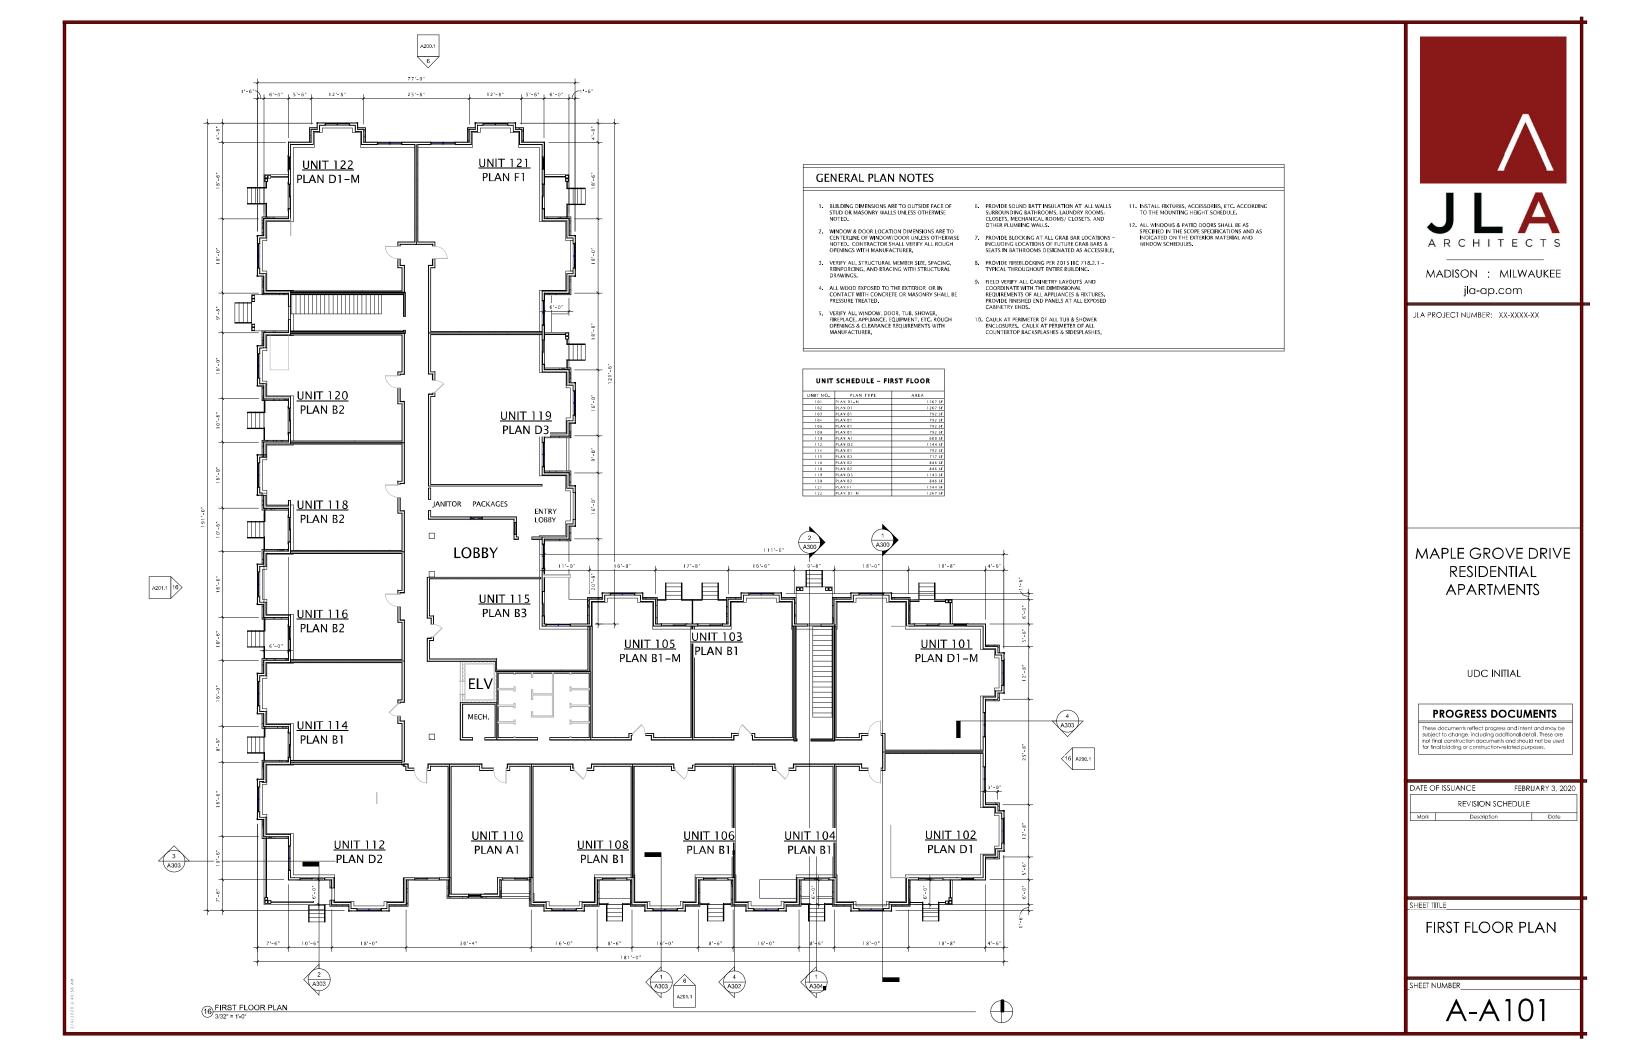

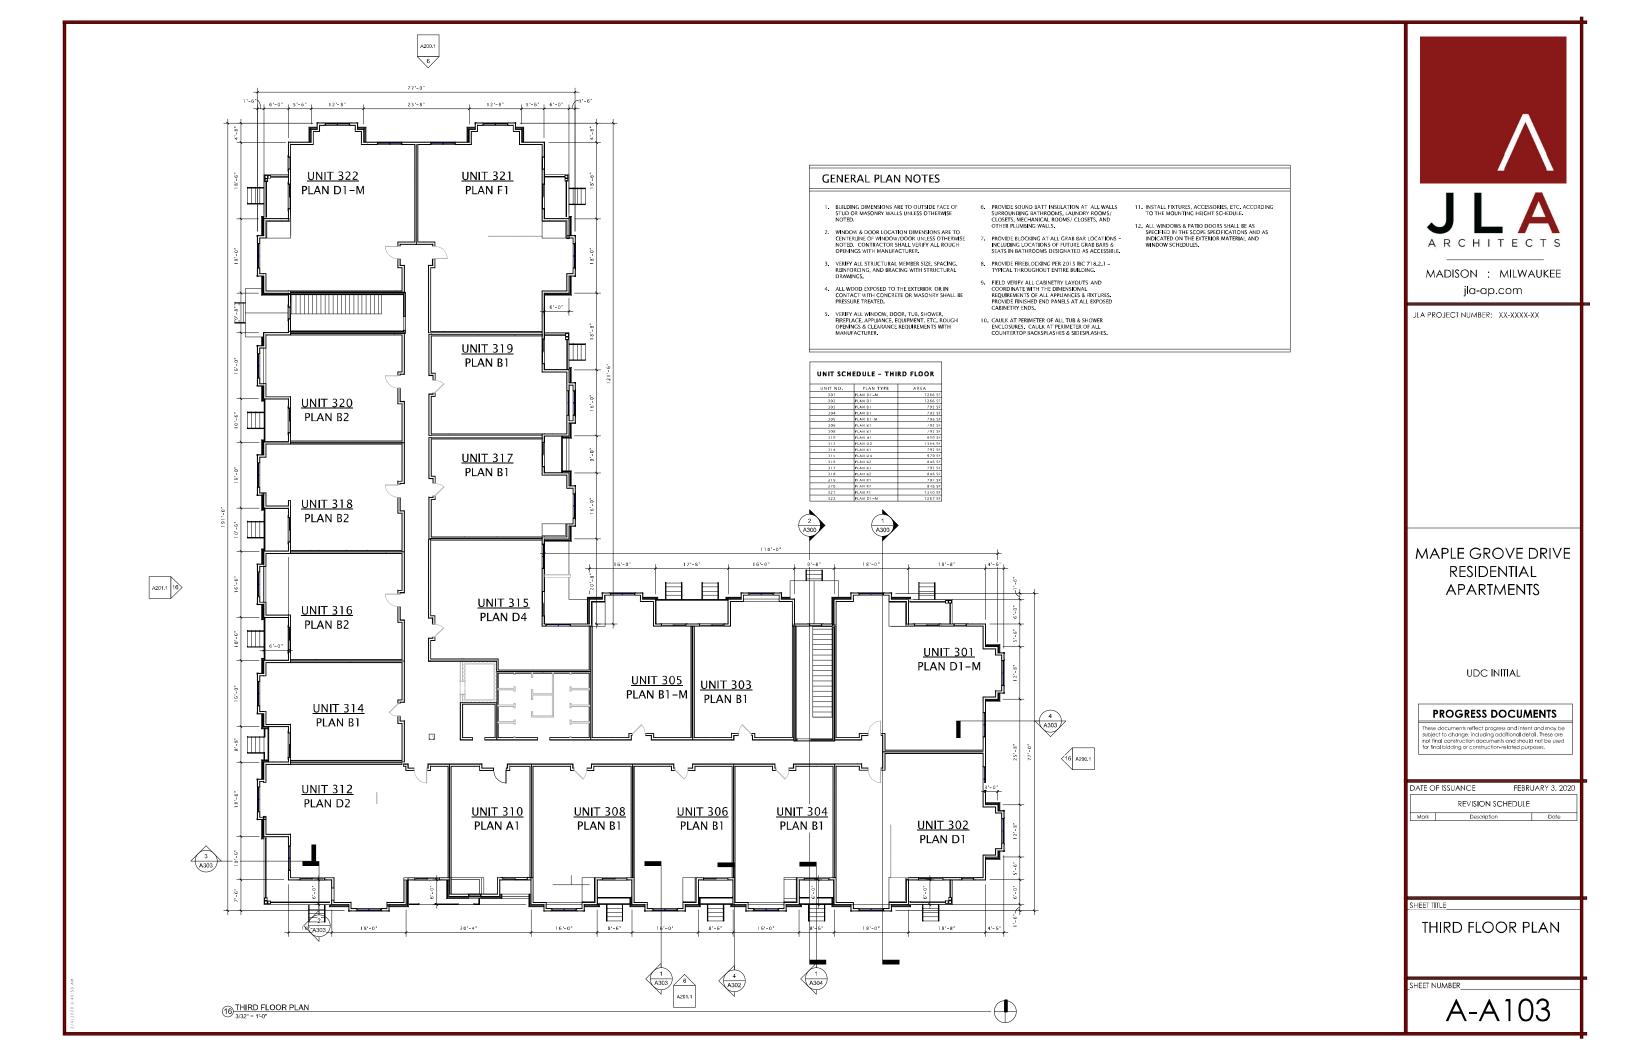



JLA PROJECT NUMBER: XX-XXXX-XX

MAPLE GROVE DRIVE RESIDENTIAL APARTMENTS

UDC INITIAL

PROGRESS DOCUMENTS

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DATE O	f ISSUANCE	FEBRUARY 3, 2020	
	revision schedule		
Mark	Description Date		

SHEET TI

ROOF PLAN

SHEET NUMBER

A-A104

1) ROOF PLAN Copy 1





16 A - Elevation West



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JLA PROJECT NUMBER: XX-XXXX-XX

MAPLE GROVE DRIVE RESIDENTIAL APARTMENTS

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 DATE OF ISSUANCE
 FEBRUARY 3, 2020

 REVISION SCHEDULE
 Mark

 Description
 Date

SHEET TITL

SKETCHUP ELEVATIONS

SHEET NUMBER

A-A200



6 A - Elevation North



16 A - Elevation East



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MAPLE GROVE DRIVE RESIDENTIAL APARTMENTS

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Mark Description Date		

SHEET TITL

SKETCHUP ELEVATIONS

SHEET NUMBER

A-A201



6 PERSPECTIVE 1/8" = 1'-0"





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MAPLE GROVE DRIVE RESIDENTIAL APARTMENTS

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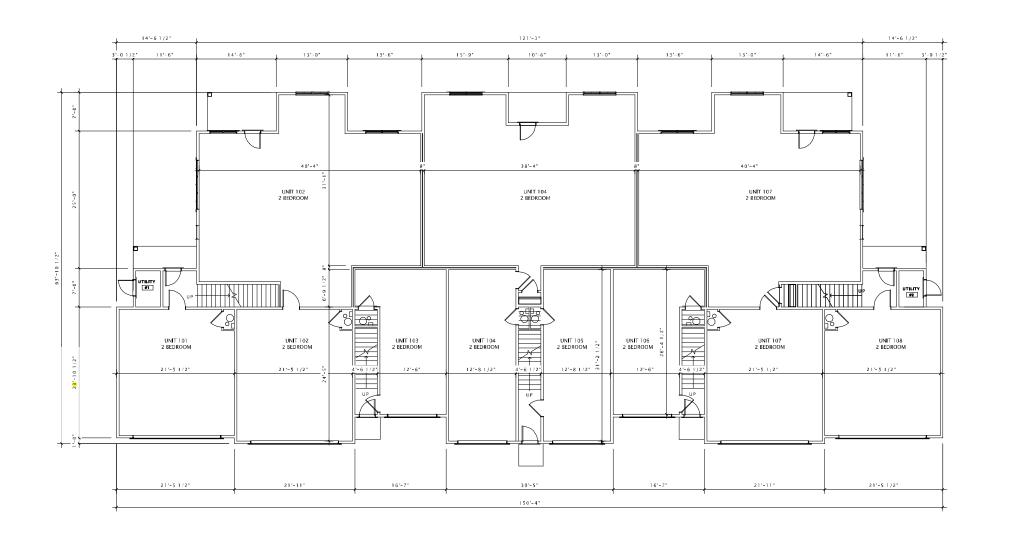
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SHEET TITL

SKETCHUP PERSPECTIVES

SHEET NUMBER

A-A202





JLA PROJECT NUMBER: XX-XXXX-XX

MAPLE GROVE ROAD STACKED FLATS

UDC INITIAL

PROGRESS DOCUMENTS

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	revision schedule		CHEDULE
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SHEET TITLE


FIRST FLOOR PLAN

HEET NUMBER

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S-A101

1/8" = 1'-0"



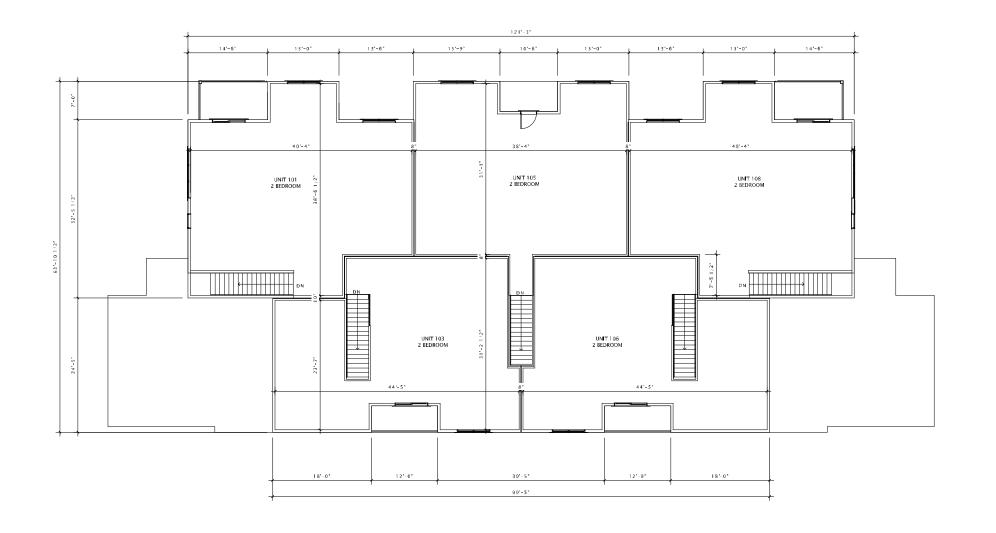

JLA PROJECT NUMBER: XX-XXXX-XX

MAPLE GROVE ROAD STACKED FLATS

UDC INITIAL

PROGRESS DOCUMENTS

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DATE OF ISSUANCE FEBRUARY 3, 2020

REVISION SCHEDULE

Mark Description Date

SHEET TITLE

SECOND FLOOR PLAN

HEET NUMBER


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S-A102

SECOND FLOOR PLAN

1/8" = 1'-0"

Z019 10:55:29 P



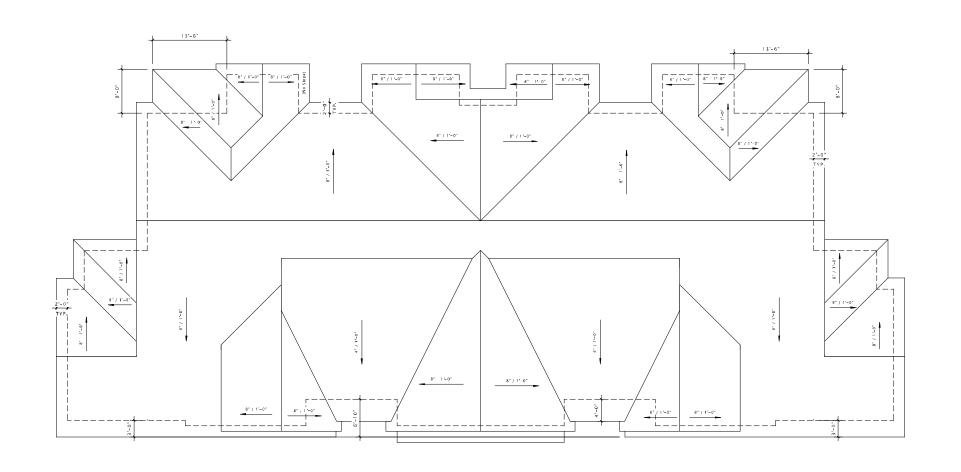

JLA PROJECT NUMBER: XX-XXXX-XX

MAPLE GROVE ROAD STACKED FLATS

UDC INITIAL

PROGRESS DOCUMENTS

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- 1				
	DATE O	F ISSUANCE	FEBRUARY 3, 2020	C
		revision	SCHEDULE	
	Mark	Description	on Date	_

SHEET TITL

ROOF PLAN

SHEET NUMBER

S-A103

1) ROOF PLAN 1/8" = 1'-0"

2019 10:55:30 |





JLA PROJECT NUMBER: 17-1018

MAPLE GROVE ROAD STACKED FLATS

UDC INITIAL

PROGRESS DOCUMENTS

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1	DATE O	F ISSUANCE	FEBRUARY 3, 2020
	revision schedule		
	Mark Description Date		
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SHEET TITLE

SKETCHUP ELEVATIONS

SHEET NUMBER

S-A200



(16) West Elevation

Z0 1.25.26 PM



JLA PROJECT NUMBER: 17-1018

MADISON : MILWAUKEE jla-ap.com

MAPLE GROVE ROAD STACKED FLATS

UDC INITIAL

PROGRESS DOCUMENTS

DATE OF ISSUANCE FEBRUARY 3,			
	revision schedule		
Mark	Mark Description Date		

SKETCHUP **ELEVATIONS**

S-A201

6 South Elevation
3/16" = 1'-0"



16 East Elevation
3/16" = 1'-0"



6 PERSPECTIVE 1/8" = 1'-0"





MADISON : MILWAUKEE jla-ap.com

JLA PROJECT NUMBER: XX-XXXX-XX

MAPLE GROVE DRIVE RESIDENTIAL STACKED FLATS

UDC INITIAL

PROGRESS DOCUMENTS

These documents reflect progress and intent and may be subject to change, including additional detail. These are not final construction documents and should not be used for final bidding or construction-related purposes.


DATE OF ISSUANCE		FEBRUARY 3, 2020	
revision sci		EDULE	
Mark	Description	Date	

SHEET TITL

SKETCHUP PERSPECTIVE

SHEET NUMBE

SF-A202

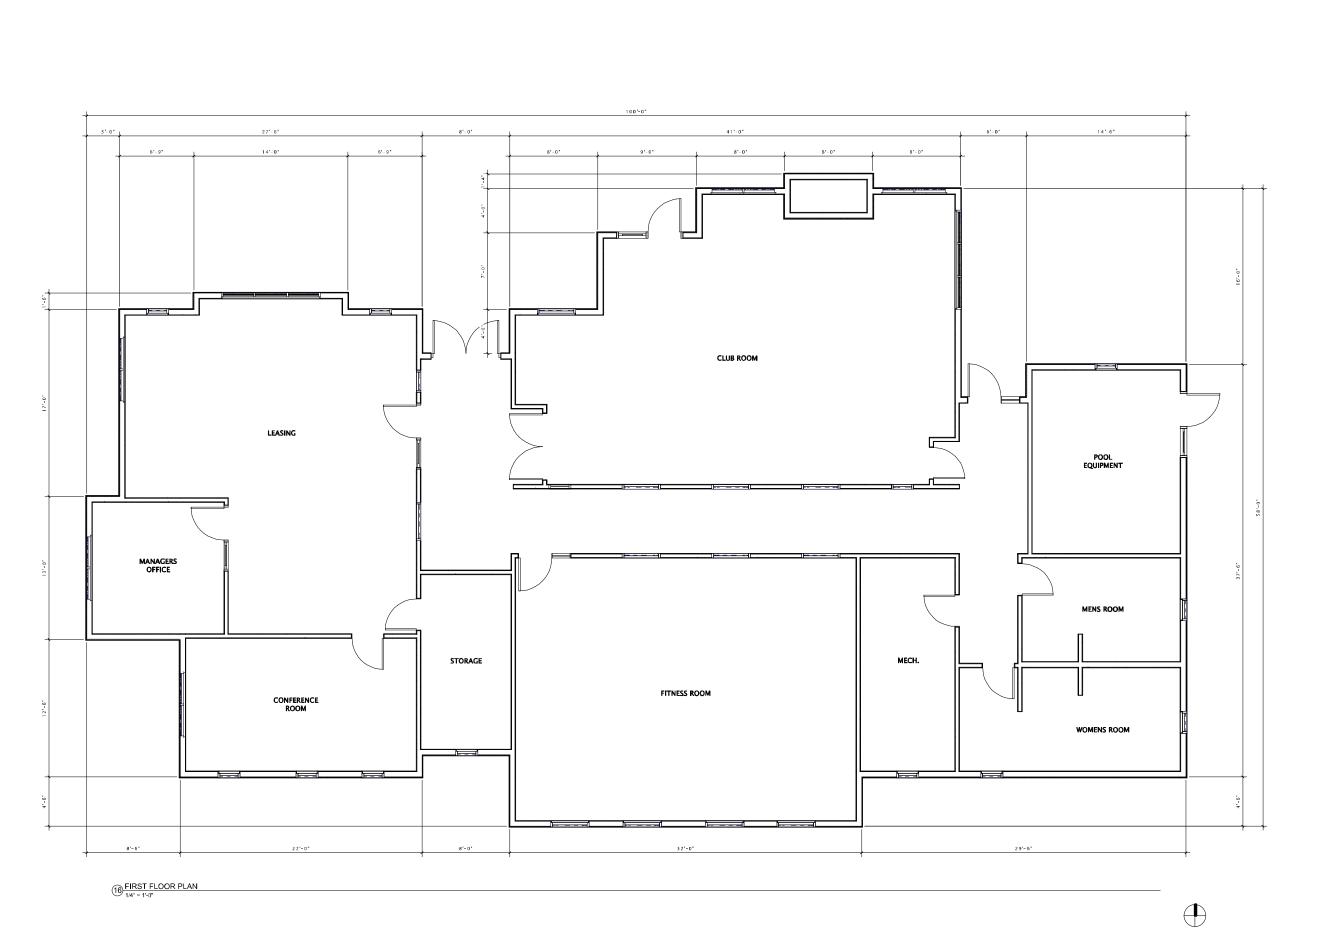



JLA PROJECT NUMBER: XX-XXXX-XX

MAPLE GROVE DRIVE CLUBHOUSE

UDC INITIAL

PROGRESS DOCUMENTS


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DATE OF ISSUANCE FEBRUARY 3, 202 REVISION SCHEDULE		
Mark	Description	Date
		'

SHEET TITL

FIRST FLOOR PLAN

SHEET NUMBE

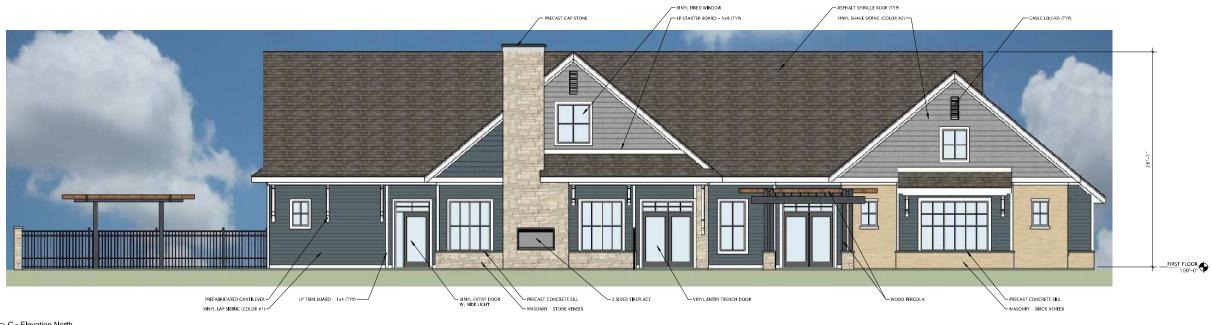

6 C - Elevation North
3/16" = 1'-0"



16 C - Elevation West



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MAPLE GROVE DRIVE CLUBHOUSE

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PROGRESS DOCUMENTS

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DATE OF ISSUANCE		FEBRU	JARY 3, 2020
REVISION SCHI		CHEDULE	
Mark	Mark Description		

SHEET TITLE

SKETCHUP ELEVATIONS

SHEET NUMBER



6 C - Elevation South
3/16" = 1'-0"



16 C - Elevation East 3/16" = 1'-0"



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MAPLE GROVE DRIVE CLUBHOUSE

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PROGRESS DOCUMENTS

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DATE OF ISSUANCE FEBRU			JARY 3, 2020
REVISION SCHEDULE			
Mark Description Date			Date

SHEET TITL

SKETCHUP ELEVATIONS

SHEET NUMBER



6 PERSPECTIVE Club House





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MAPLE GROVE DRIVE CLUBHOUSE

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PROGRESS DOCUMENTS

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DATE OF ISSUANCE FEBRUARY 3, 20			
	revision schedule		
Mark	Mark Description Date		

SHEET TITLE

SKETCHUP PERSPECTIVES

SHEET NUMBER