

GENERAL NOTES:

I. THE APPLICANT SHALL REPLACE ALL SIDEWALK AND CURB AND GUTTER THAT ABUTS THE PROPERTY THAT IS DAMAGED BY THE CONSTRUCTION, OR ANY SIDEWALK AND CURB AND GUTTER WHICH THE CITY ENGINEER DETERMINES NEEDS TO BE REPLACED BECAUSE IT IS NOT AT A DESIRABLE GRADE, REGARDLESS OF WHETHER THE CONDITION EXISTED PRIOR TO BEGINNING CONSTRUCTION.

2. ALL WORK IN THE PUBLIC RIGHT OF WAY SHALL BE PERFORMED BY A CITY-LICENSED CONTRACTOR.


3. ALL DAMAGE TO THE PAVEMENT ON CITY STREETS, AND ADJACENT TO THIS DEVELOPMENT SHALL BE RESTORED IN ACCORDANCE WITH THE CITY OF MADISON'S PAVEMENT PATCHING CRITERIA.

4. EXISTING STREET TREES SHALL BE PROTECTED. CONTRACTOR SHALL INSTALL TREE PROTECTION FENCING IN THE AREA BETWEEN THE CURB AND SIDEWALK AND EXTEND IT AT LEAST 5 FEET FROM BOTH SIDES OF THE TREE ALONG THE LENGTH OF THE TERRACE. NO EXCAVATION IS PERMITTED WITHIN 5 FEET OF THE OUTSIDE EDGE OF THE TREE TRUNK. IF EXCAVATION WITHIN 5 FEET OF ANY TREE IS NECESSARY, CONTRACTOR SHALL CONTACT CITY FORESTRY (266-4816) PRIOR TO EXCAVATION TO ASSESS THE IMPACT TO THE TREE AND ROOT SYSTEM. TREE PRUNING SHALL BE COORDINATED WITH CITY FORESTRY. TREE PROTECTION SPECIFICATIONS CAN BE FOUND IN SECTION 107.13 OF CITY OF MADISON STANDARD SPECIFICATIONS FOR PUBLIC WORKS CONSTRUCTION.


5. APPROVAL OF PLANS FOR THIS PROJECT DOES NOT INCLUDE ANY APPROVAL TO PRUNE, REMOVE, OR PLANT TREES IN THE PUBLIC RIGHT-OF-WAY. PERMISSION FOR SUCH ACTIVITIES MUST BE OBTAINED FROM THE CITY FORESTER (266-4816).

6. THE PUBLIC RIGHT-OF-WAY IS THE SOLE JURISDICTION OF THE CITY OF MADISON AND IS SUBJECT TO CHANGE AT ANY TIME. NO ITEMS SHOWN ON THIS SITE PLAN IN THE RIGHT-OF-WAY ARE PERMANENT AND MAY NEED TO BE REMOVED AT THE APPLICANTS EXPENSE UPON NOTIFICATION BY THE CITY.


BIKE RACKS:

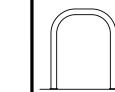

INTERIOR & EXTERIOR FLOOR MOUNTED: "INVERTED U" TYPE. MADRAX UX OR SARIS BIKE DOCK

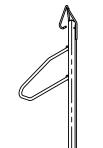

INTERIOR WALL MOUNTED: MADRAX VERTICAL RACK OR SARIS BIKE TRACK

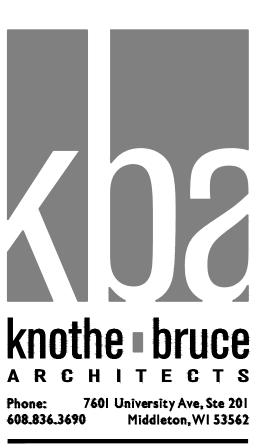

ISSUED
Issued for Land Use & UDC Submittal: 11/20/2019

PROJECT TITLE

FLAD - SEGOE


Site Address:
4510 Regent St & 4513
Vernon Blvd.
SHEET TITLE
Site Plan


SHEET NUMBER



PROJECT NO.


© Knothe & Bruce Architects, LLC

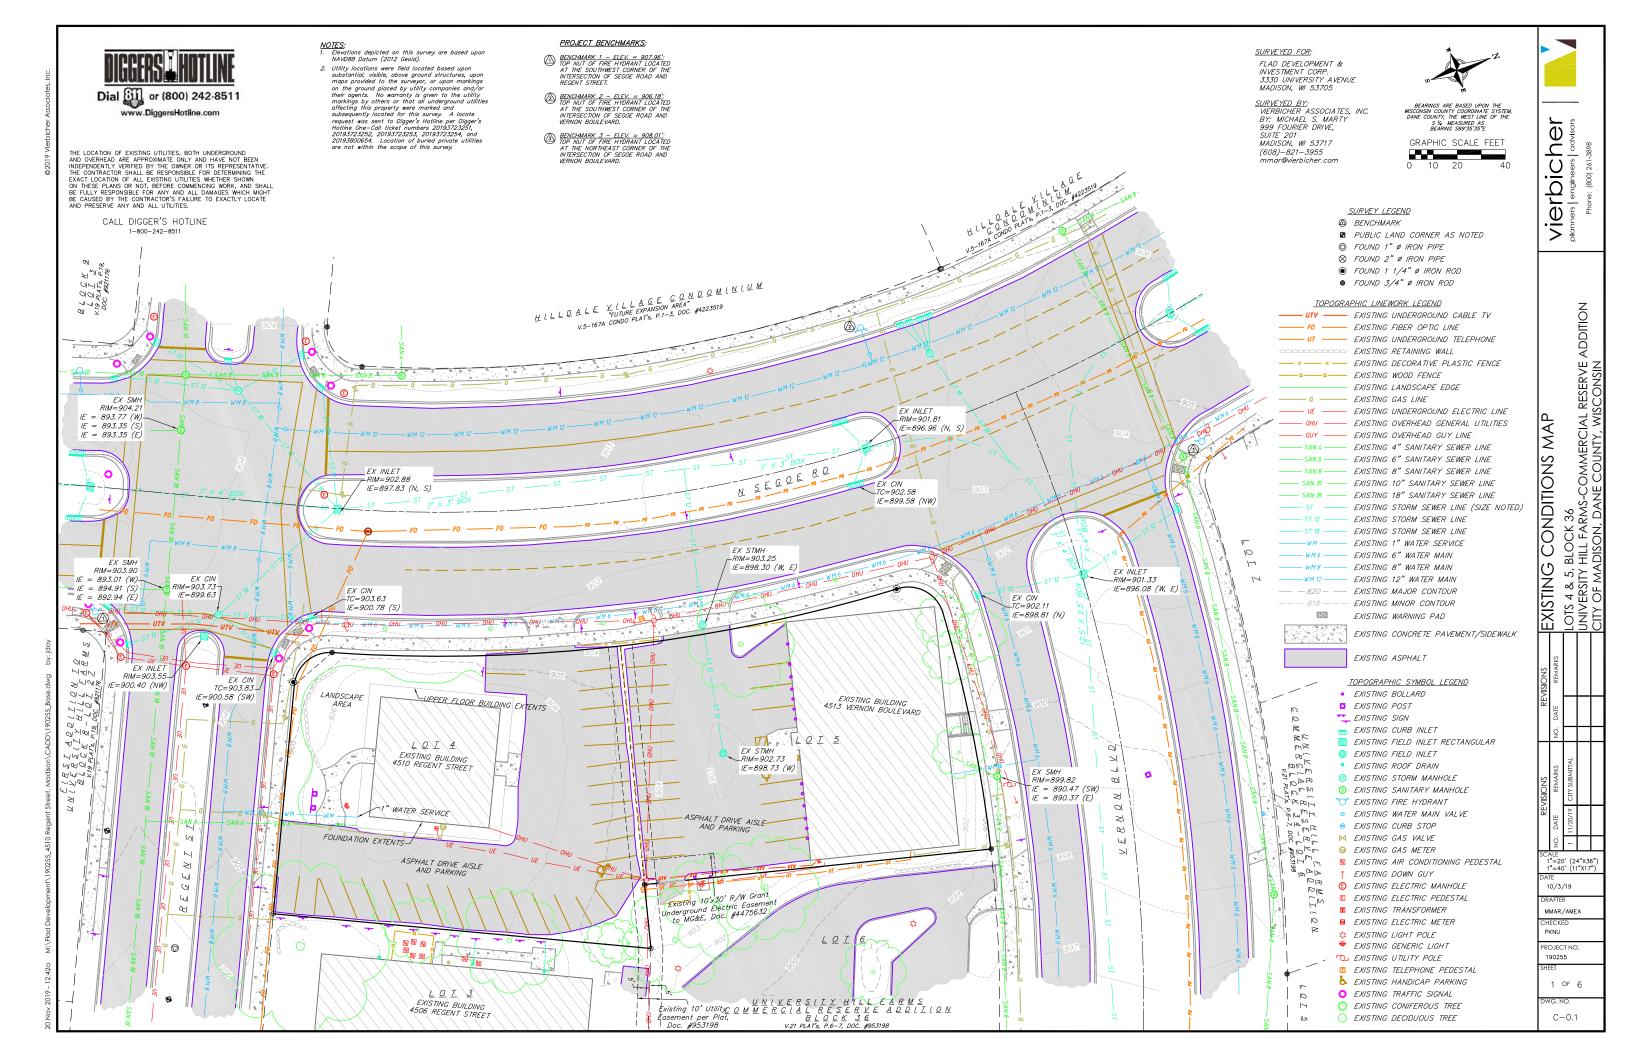

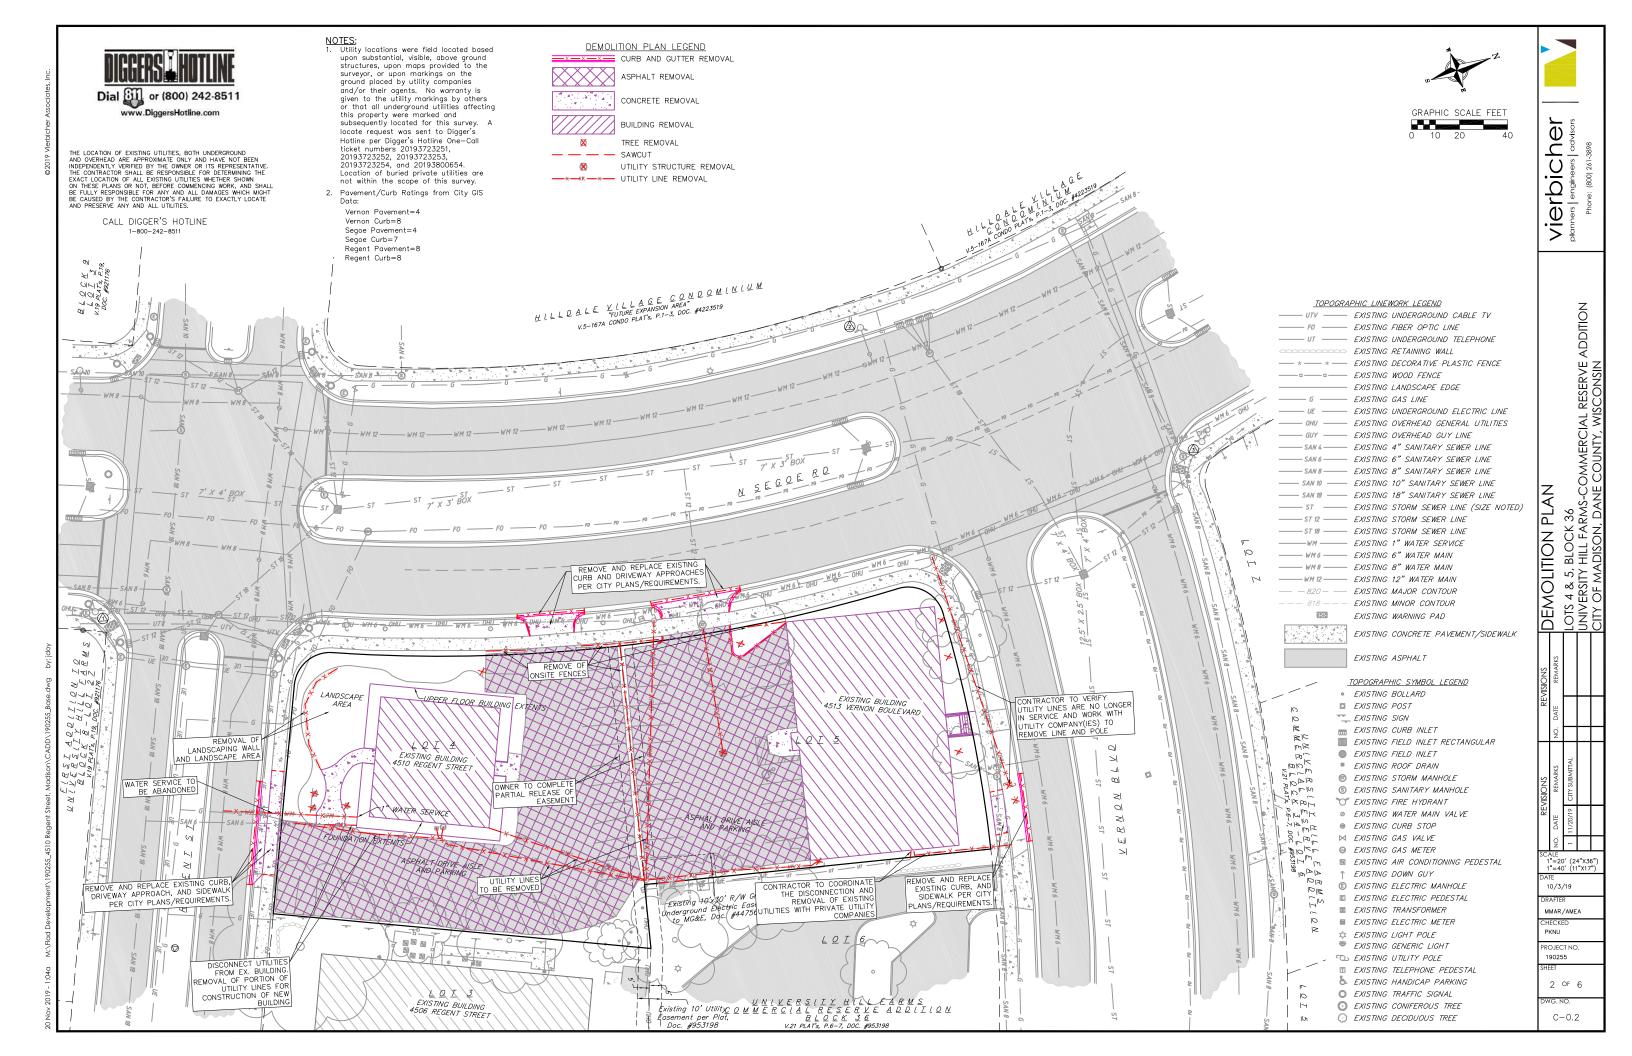


STATISTICS						
DESCRIPTION	SYMBOL	AVG.	MAX.	MIN.	MAX. / MIN.	AVG. / MIN.
Uncovered Parking Area	+	2.0 fc	15.7 fc	0.2 fc	78.5:I	10.0:1
Parking Entrance Lighting	+	2.1 fc	10.0 fc	0.2 fc	50.0:I	10.5:1

LUMINA	AIRE SO	CHEDULE					
SYMBOL LA	ABEL QTY	. MANUF.	CATALOG	DESCRIPTIC	N	FILE	MOUNTING
	A 2	LITHONIA LIGHTING	CNY LED PI 40K MVOLT	CONTRACTOR CNY LED CANO PI=4,500lm		CNY_LED_PI_40K_MVOLT.ies	8'-0" ABOVE PARKING SURFACE
			EXAMPLE LIC	GHT FIXTUE	ISOLUX (CONTOUR = 0.25 FC CONTOUR = 0.5 FC CONTOUR = 1.0 FC	

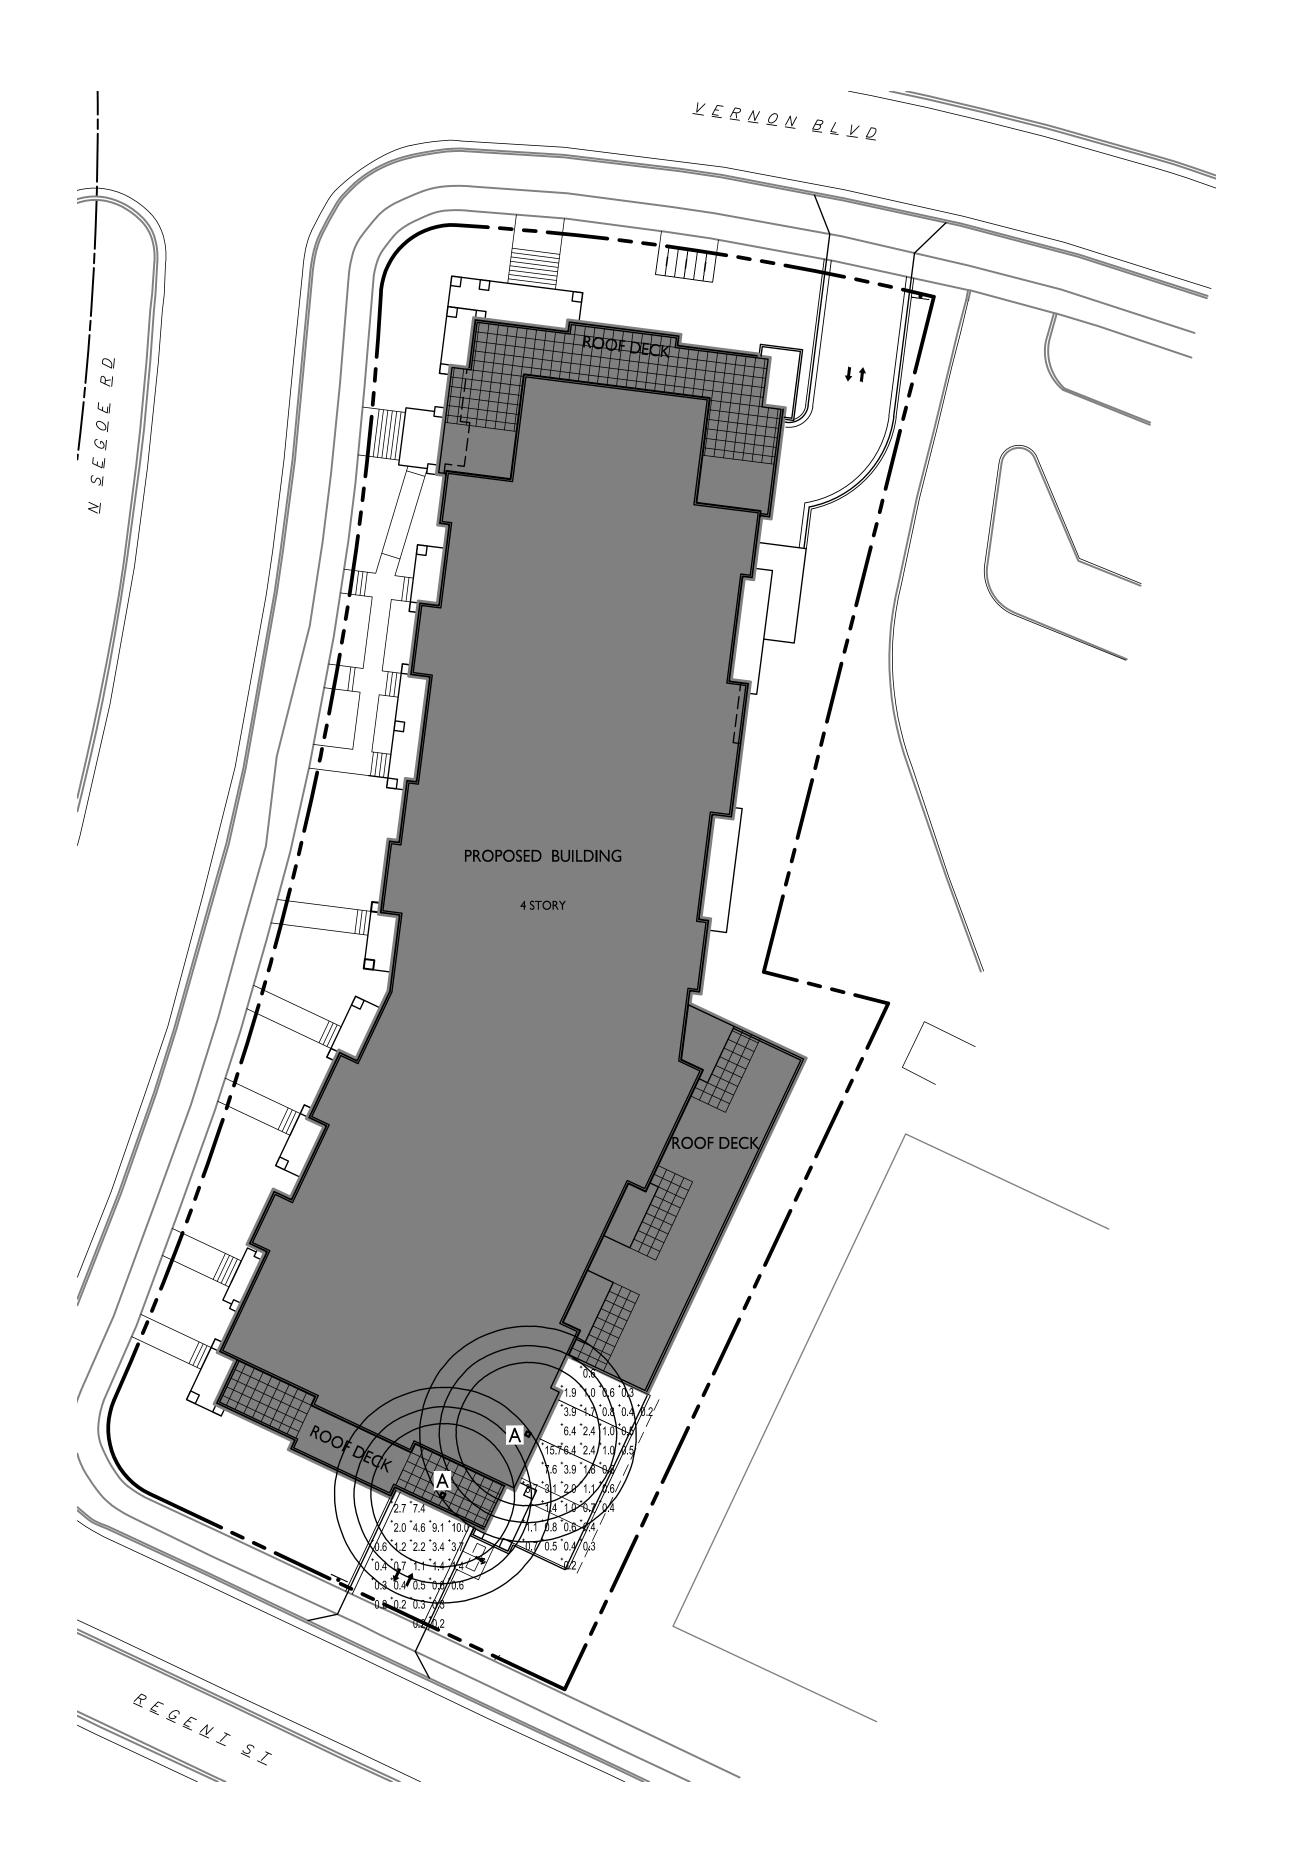



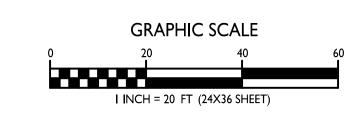



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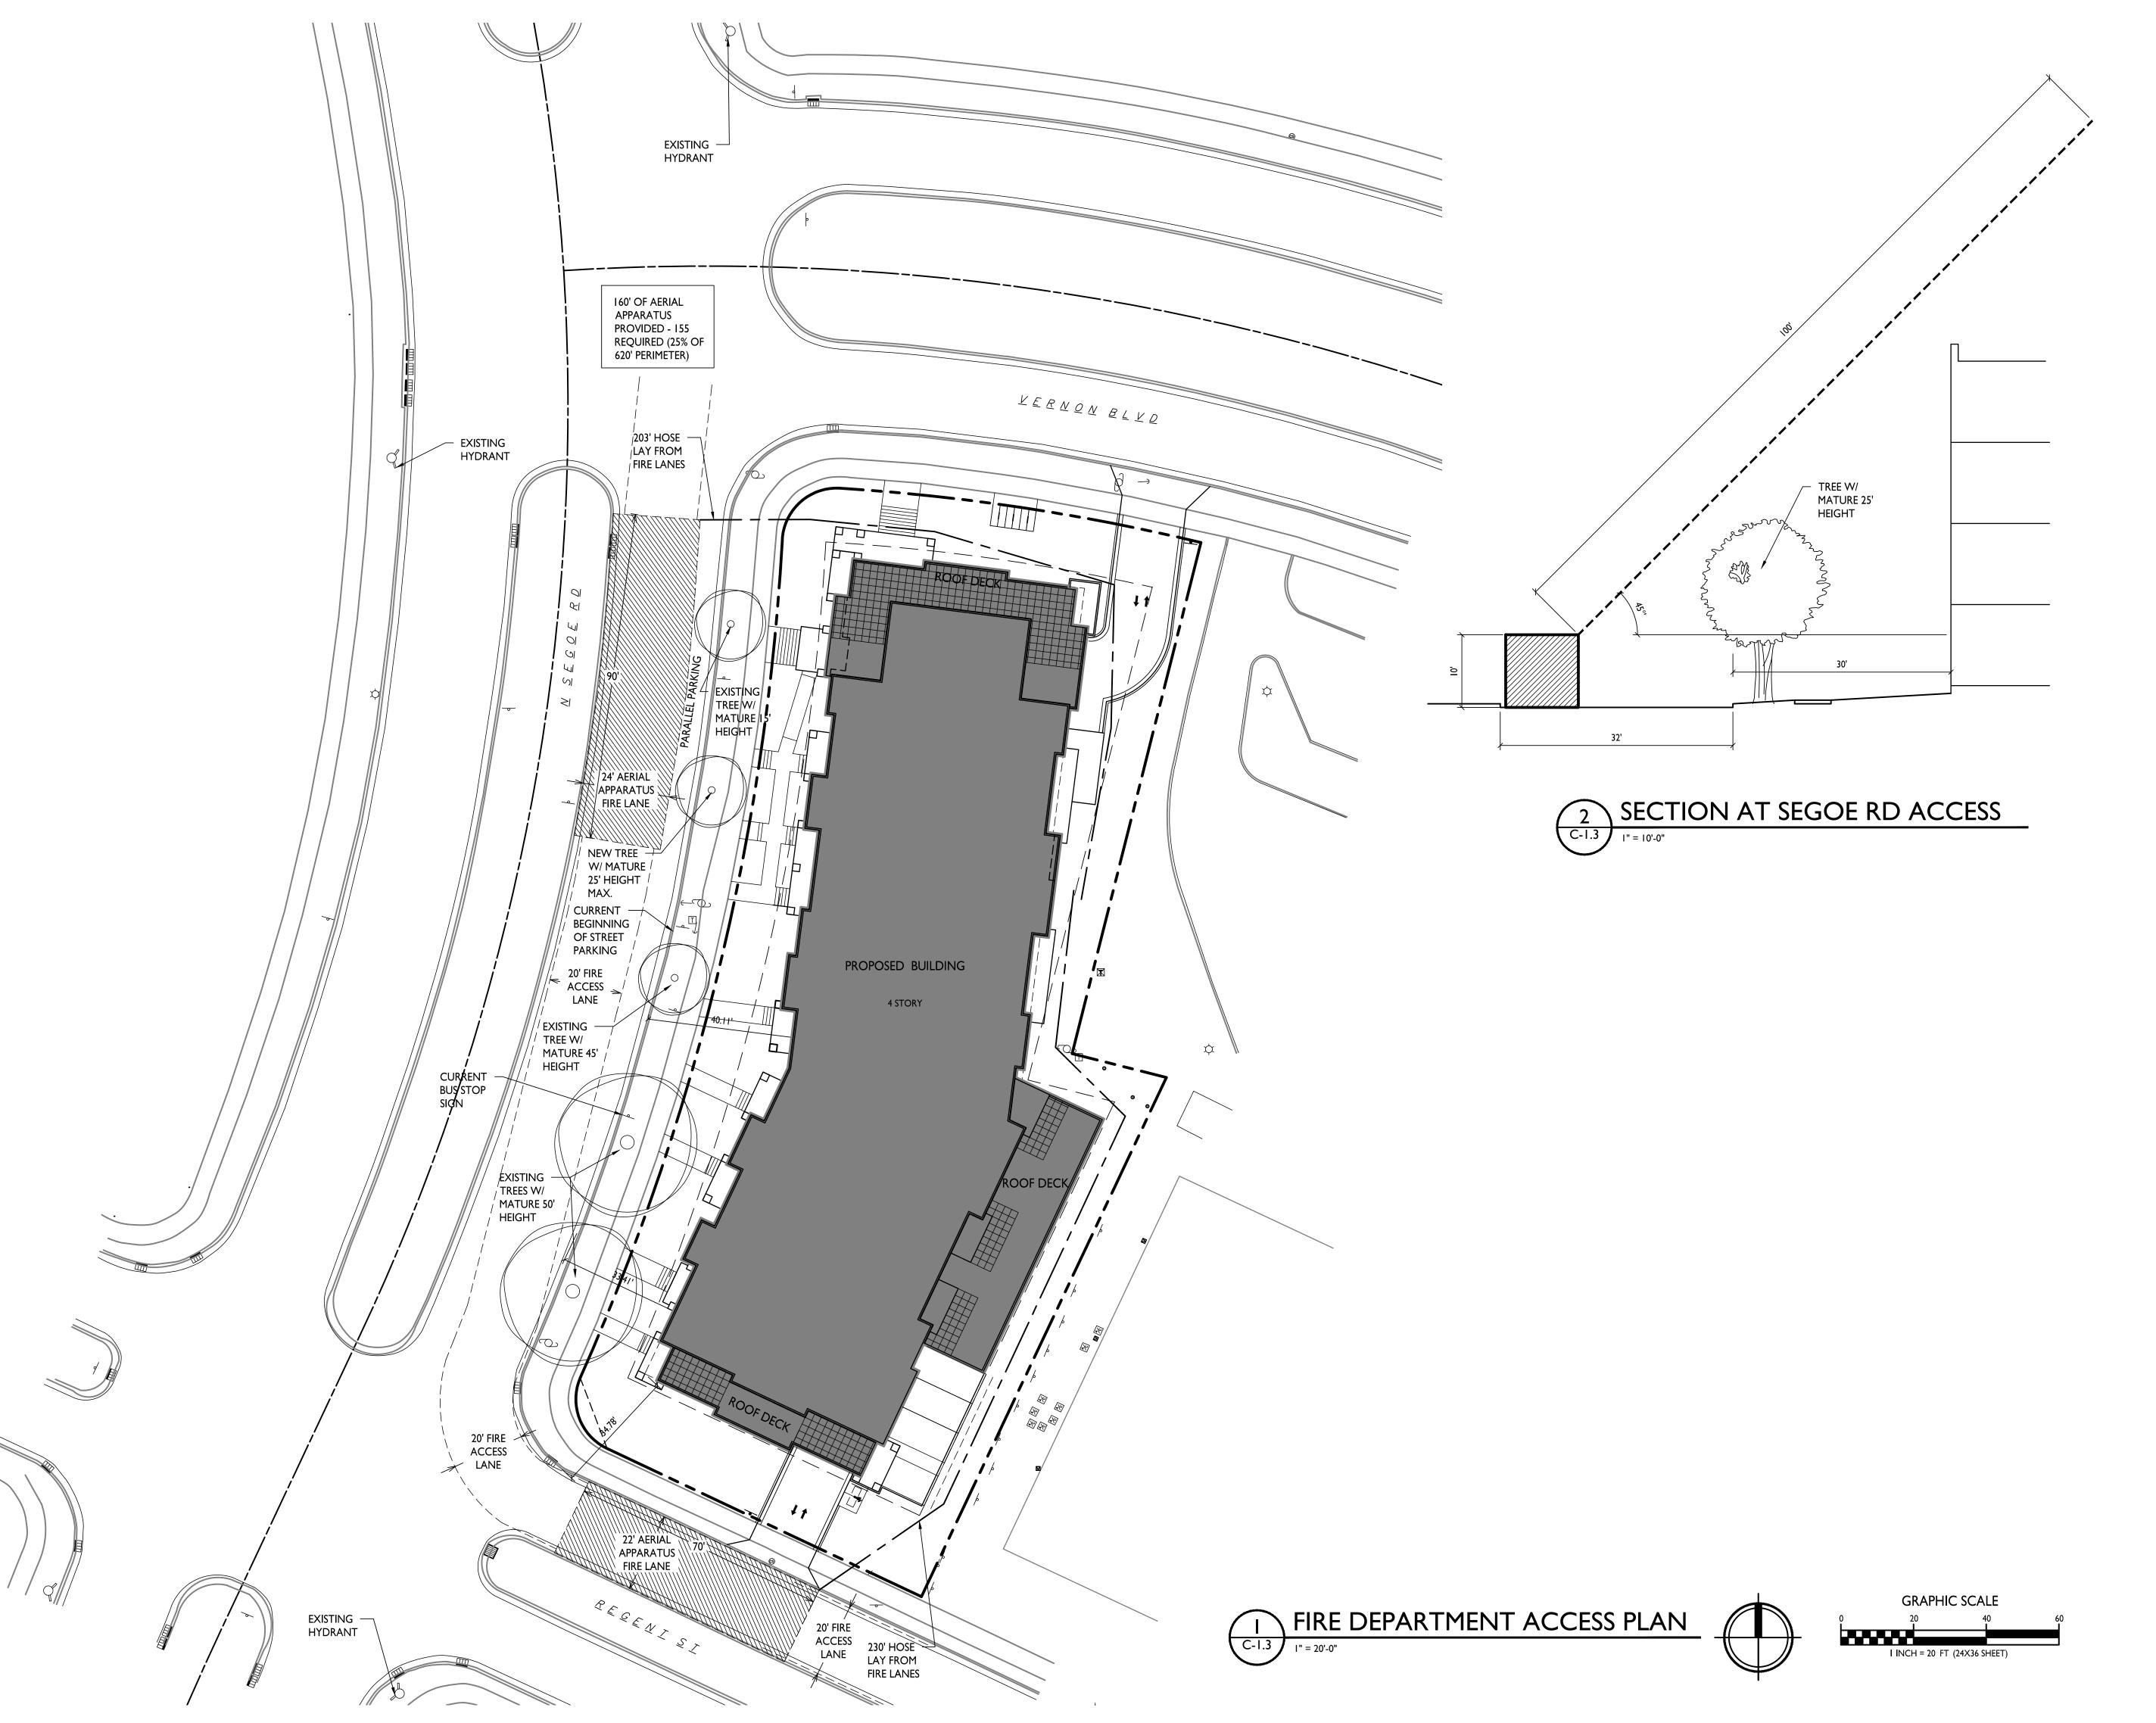
PROJECT TITLE


FLAD - SEGOE

Site Address:
4510 Regent St & 4513
Vernon Blvd.
SHEET TITLE
Site Lighting Plan

SHEET NUMBER

C-1.2



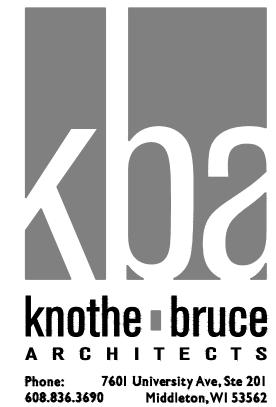

ISSUED
Issued for Land Use & UDC Submittal: 11/20/2019

PROJECT TITLE
FLAD - SEGOE


Site Address:
4510 Regent St & 4513
Vernon Blvd.

SHEET TITLE
Fire Department
Access Plan

SHEET NUMBER

C-1.3

PROJECT NO. 92

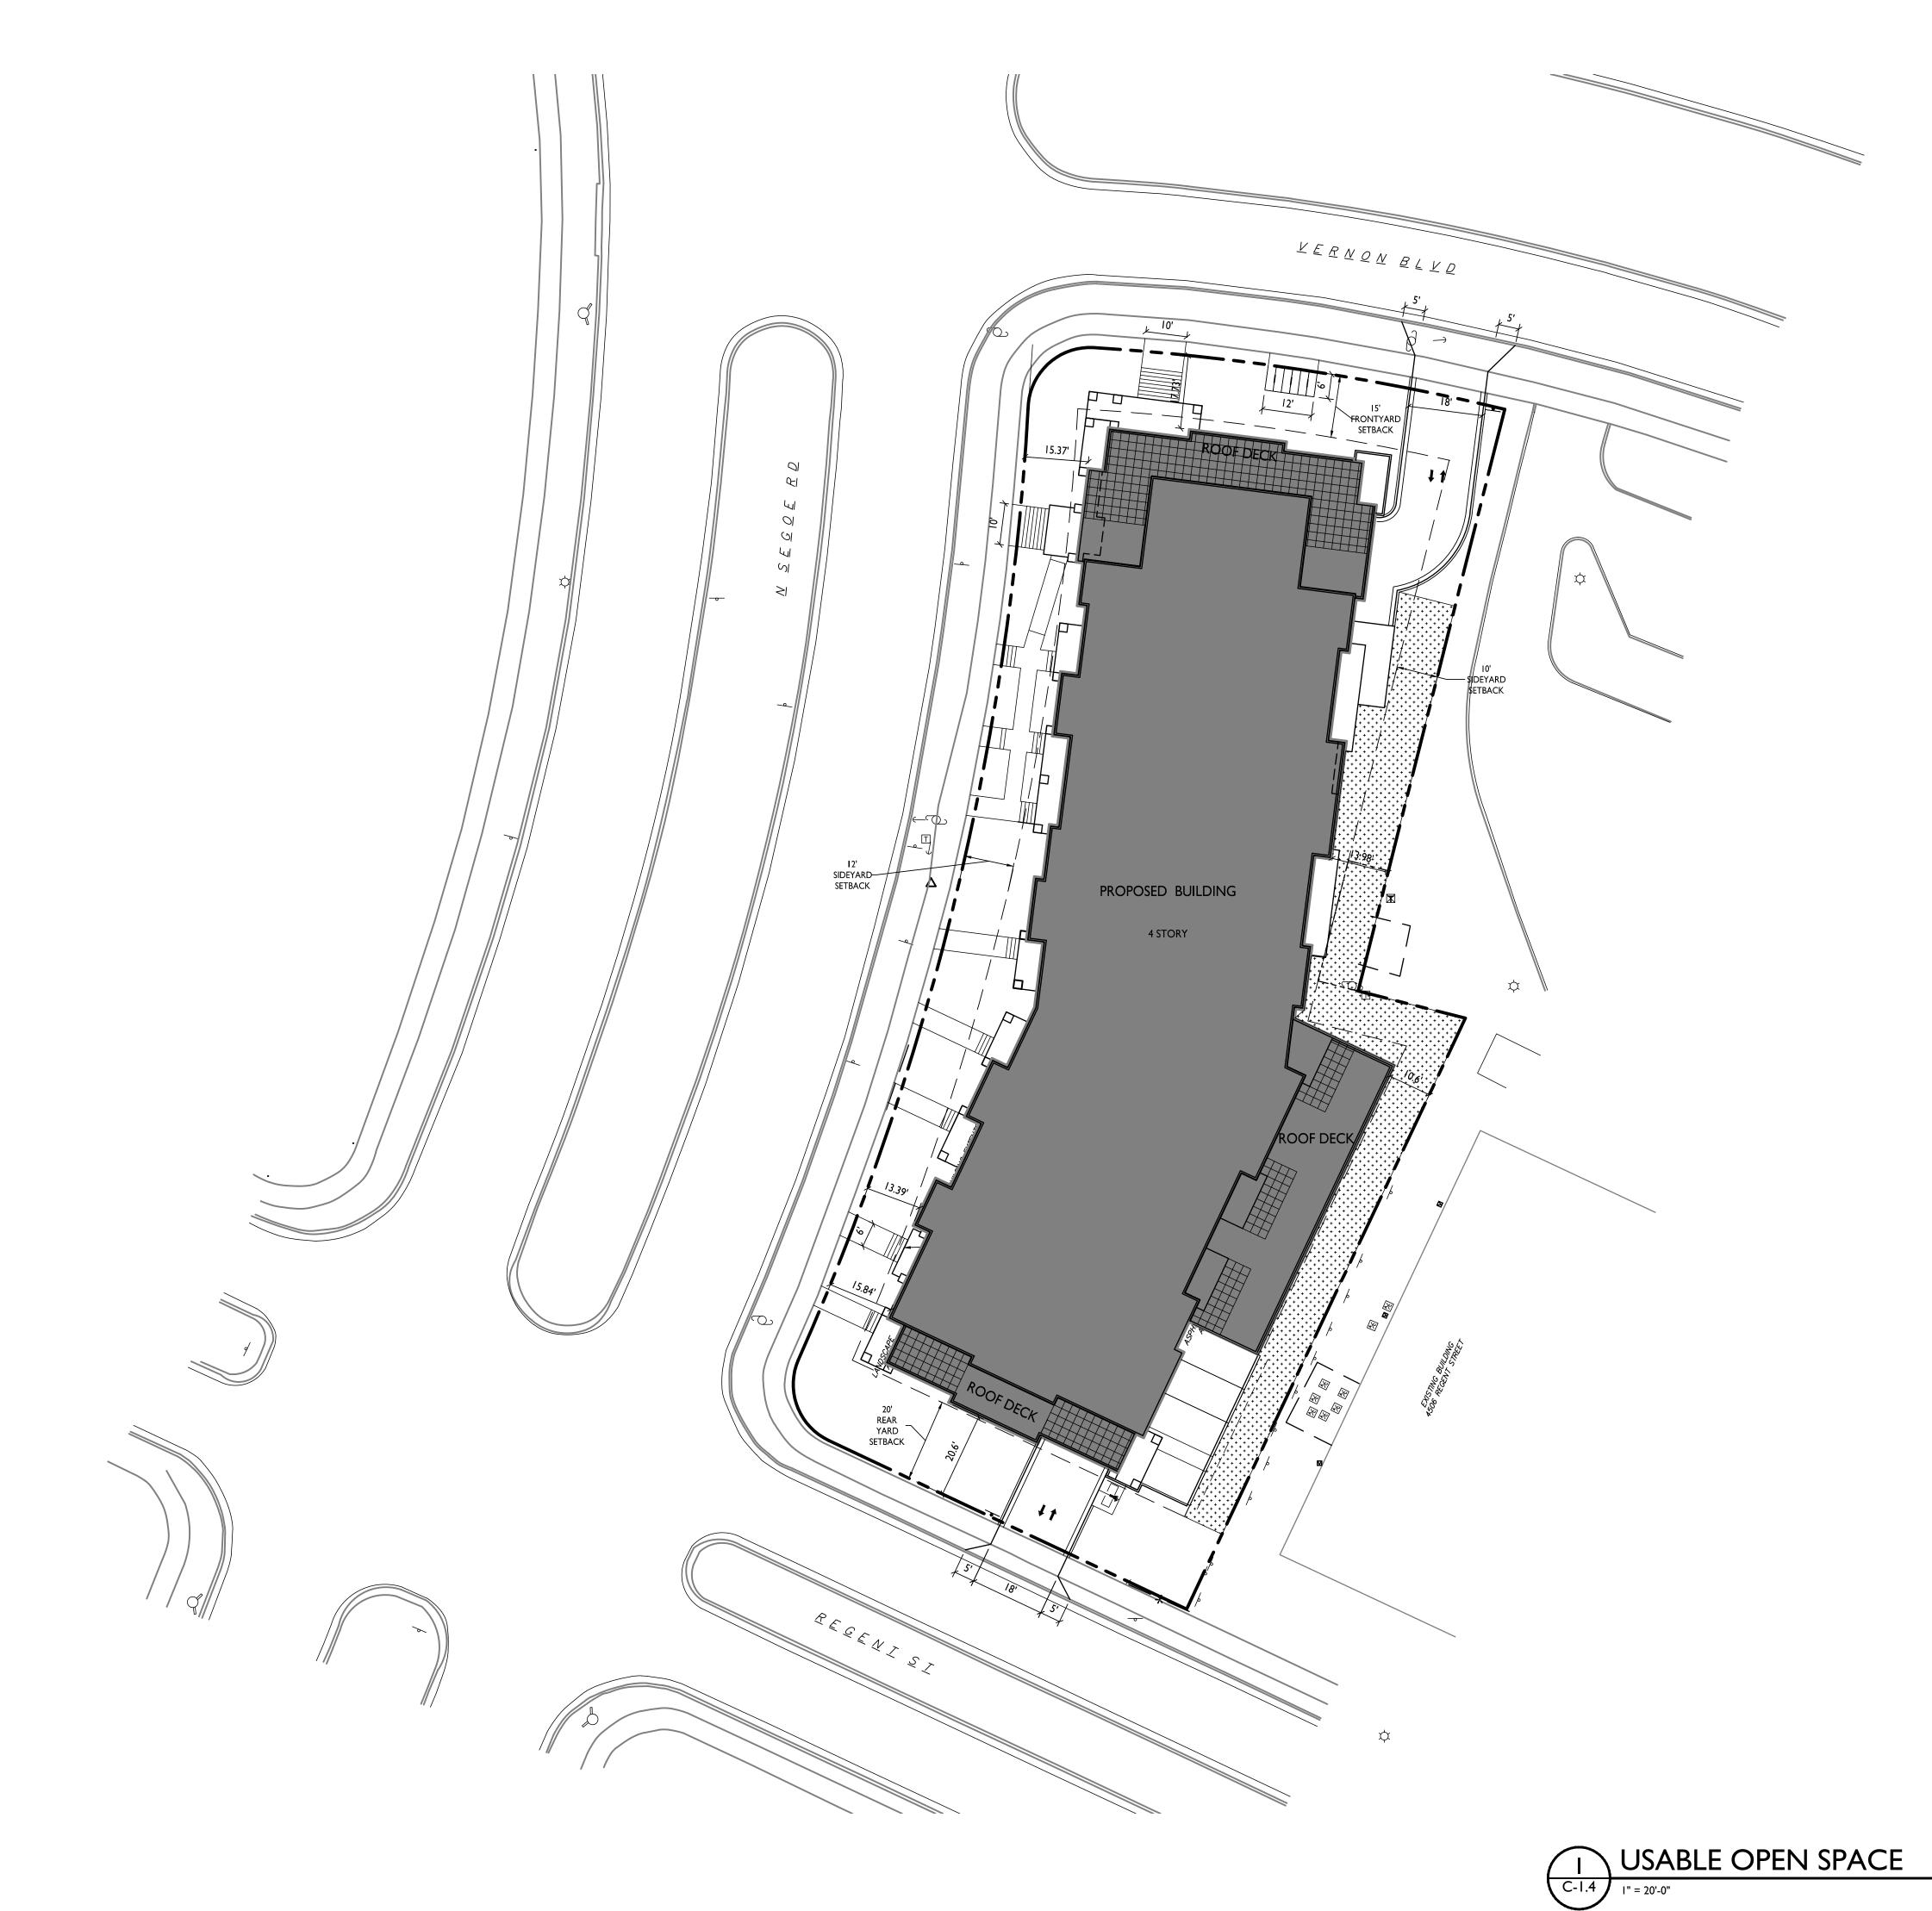




USABLE OPEN SPACE ZONING: TR-U2 REQUIRED OPEN SPACE: OPEN SPACE/ UNIT: 140 S.F. / UNIT 59 D.U. **DWELLING UNITS:** 8,260 S.F. REQUIRED TOTAL OPEN SPACE PROVIDED: BALCONIES & ROOF DECK 6,048 S.F. AT GRADE 3,049 S.F. 9,097 S.F. PROVIDED TOTAL


ISSUED
Issued for Land Use & UDC Submittal: 11/20/2019

PROJECT TITLE
FLAD - SEGOE

Site Address:
4510 Regent St & 4513
Vernon Blvd.
SHEET TITLE
Usable Open
Space

SHEET NUMBER

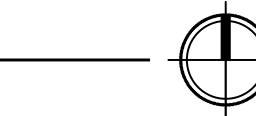

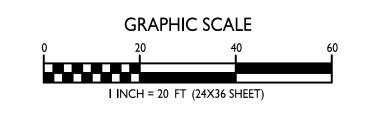






LOT COVERAGE

ZONING: TR-U2 LOT AREA

31,659 S.F. MAX. ALLOWED 25,327 S.F.(80%) PROPOSED LOT COVERAGE 21,924 S.F. (69%)

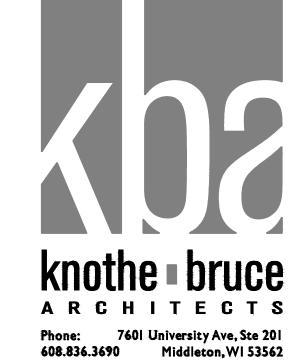

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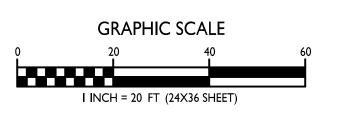
PROJECT TITLE


FLAD - SEGOE


Site Address:
4510 Regent St & 4513
Vernon Blvd.
SHEET TITLE
Lot Coverage

SHEET NUMBER





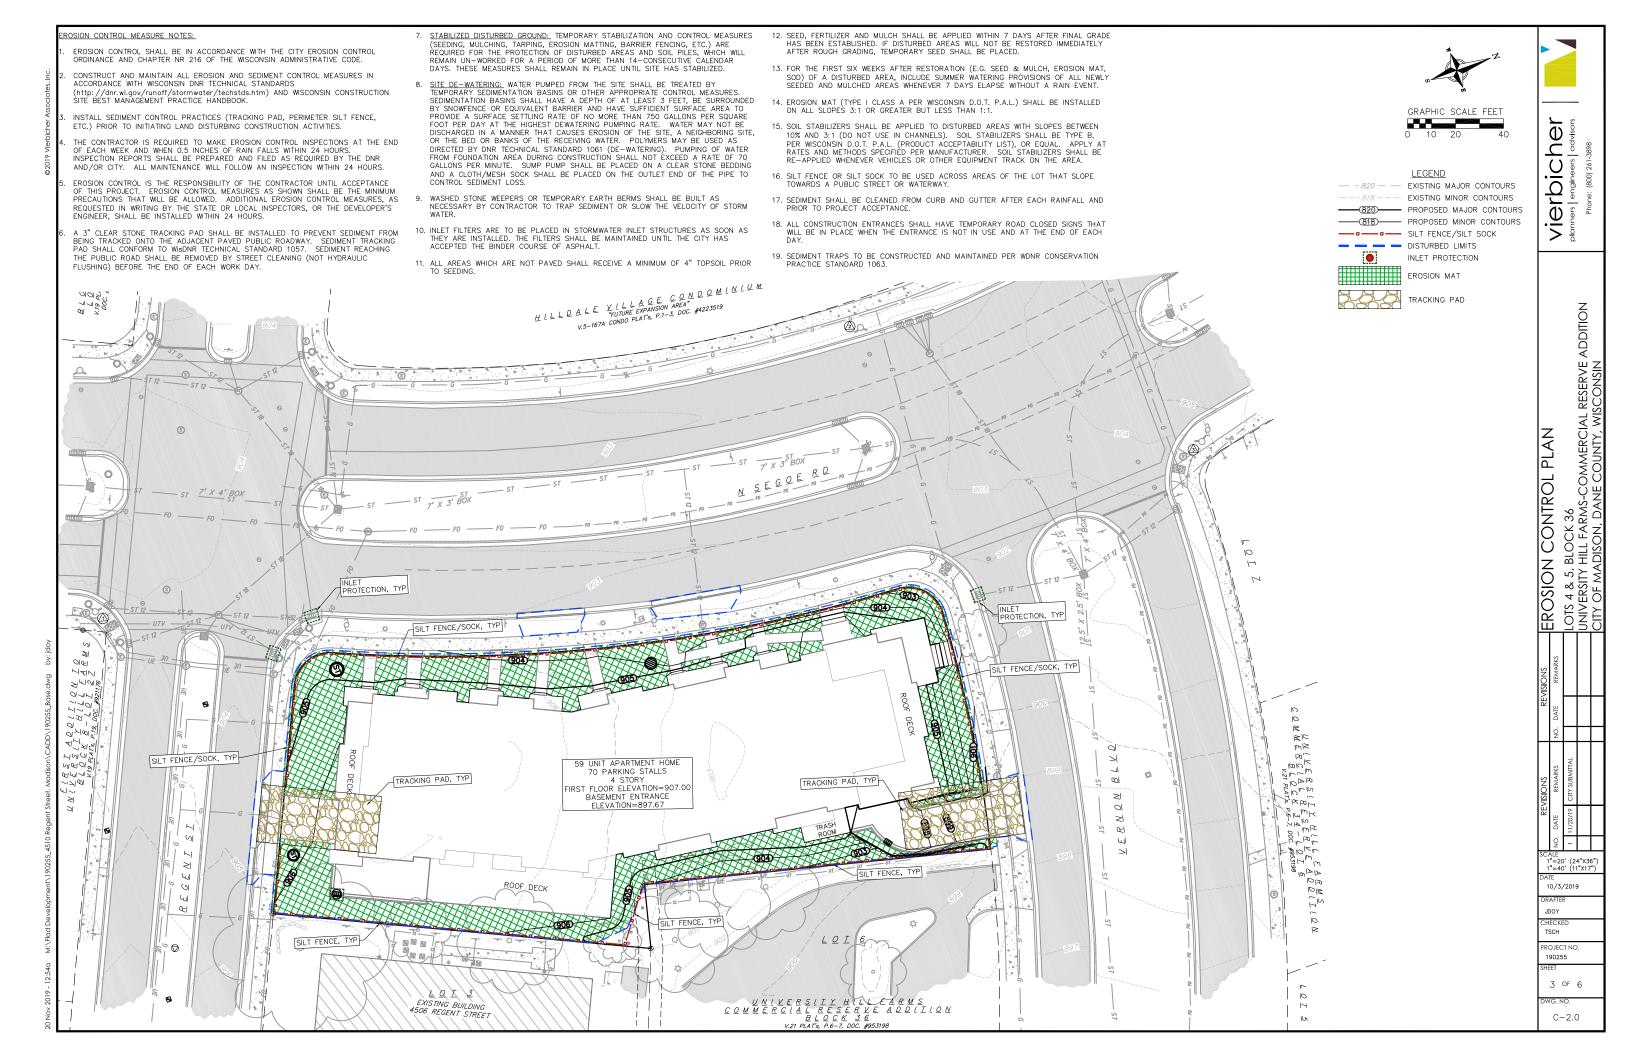

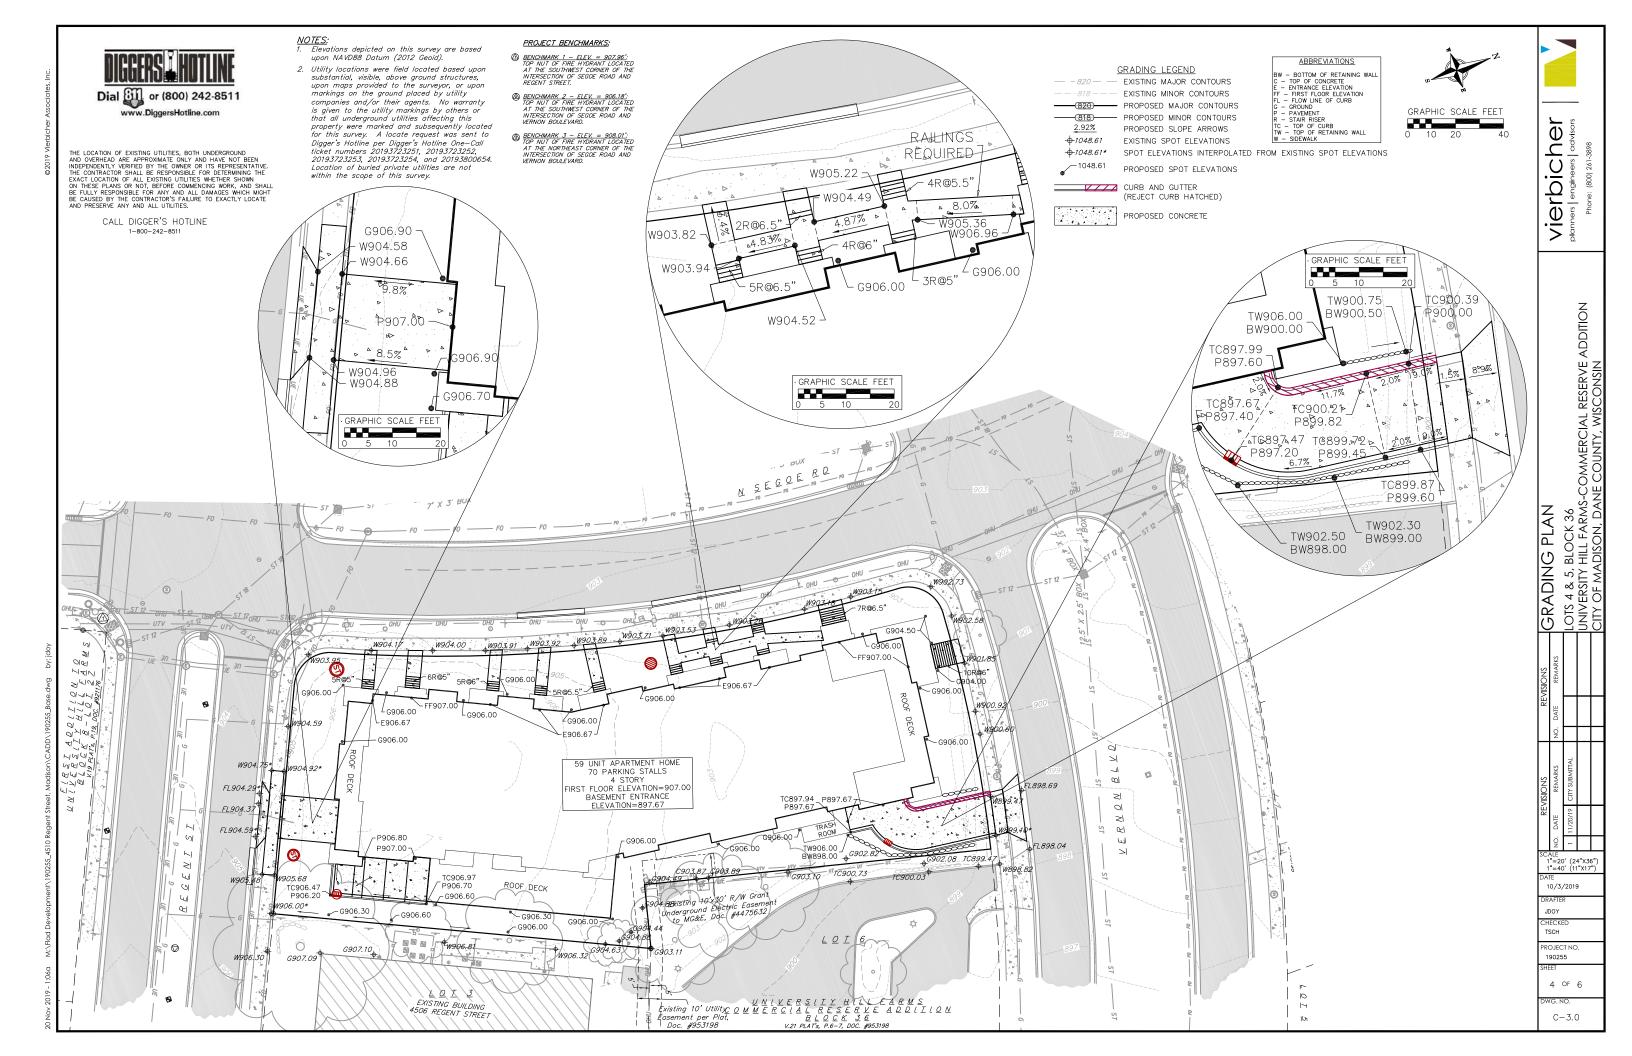

<u>NOTES:</u> 1. Elevations depicted on this survey are based

markings on the ground placed by utility companies and/or their agents. No warranty is

given to the utility markings by others or that all underground utilities affecting this property were marked and subsequently located for this

survey. A locate request was sent to Digger's Hotline per Digger's Hotline One—Call ticket numbers 20193723251, 20193723252,

20193723253, 20193723254, and 20193800654. Location of buried private utilities are not within

the scope of this survey.

- BENCHMARK 1 ELEV. = 907.96'; TOP NUT OF FIRE HYDRANT LOCATED AT THE SOUTHWEST CORNER OF THE INTERSECTION OF SEGOE ROAD AND REGENT STREET. upon NAVD88 Datum (2012 Geoid). Utility locations were field located based upon substantial, visible, above ground structures, upon maps provided to the surveyor, or upon
 - (B) BENCHMARK 2 ELEV. = 906.18'; TOP NUT OF FIRE HYDRANT LOCATED AT THE SOUTHWEST CORNER OF THE INTERSECTION OF SEGOE ROAD AND VERNON BOULEVARD.

PROJECT BENCHMARKS:

BENCHMARK 3 - ELEV. = 908.01':
TOP NUT OF FIRE HYDRANT LOCATED
AT THE NORTHEAST CORNER OF THE
INTERSECTION OF SEGOE ROAD AND
VERNON BOULEVARD.

UTILITY NOTES:

- PRIVATE WATER MAIN AND SERVICES SHALL BE DUCTILE IRON (AWWA C-151, CLASS 52) OR APPROVED EQUAL MATERIAL THAT CONFORMS TO SPS 384.30(4).
- 2. PRIVATE SANITARY SEWER AND LATERALS SHALL BE POLYVINYL CHLORIDE (PVC) ASTM D3034 - SDR 35 OR APPROVED EQUAL MATERIAL THAT CONFORMS TO SPS 384.30(2).
- A MEANS TO LOCATE BURIED UNDERGROUND EXTERIOR NON METALLIC SEWERS/MAINS AND WATER SERVICES/MAINS MUST BE PROVIDED WITH TRACER WIRE OR OTHER METHODS IN ORDER TO BE LOCATED PER SPS 382.30(11)(h) AND SPS 382.40(8)(k).
- 4. EXTERIOR WATER SUPPLY PIPING SETBACKS AND CROSSINGS SHALL BE IN ACCORDANCE WITH SPS 382.40(8)(b).
- NO PERSON MAY ENGAGE IN WORK AT PLUMBING IN THE STATE UNLESS LICENSED TO DO SO BY THE DEPARTMENT OF COMMERCE PER S.145.06.
- SITE CONTRACTOR SHALL LEAVE SANITARY AND WATER LATERALS FIVE (5) FEET SHORT (HORIZONTALLY) FROM THE BUILDING. BUILDING PLUMBER SHALL VERIFY SIZE AND EXACT LOCATION OF PROPOSED SANITARY AND WATER LATERALS.
- CONTRACTOR SHALL FIELD VERIFY THE SIZE, TYPE, LOCATION, AND ELEVATION OF EXISTING UTILITIES PRIOR TO INSTALLING ANY ON—SITE UTILITIES OR STRUCTURES. CONTACT ENGINEER PRIOR TO INSTALLATION IF DISCREPANCY EXISTS WITHIN THESE PLANS.

8. PROPOSED UTILITY SERVICE LINES AS SHOWN ARE APPROXIMATE. COORDINATE THE EXACT LOCATIONS WITH THE PLUMBING DRAWNGS. COORDINATE THE LOCATIONS WITH THE PLUMBING CONTRACTOR AND/OR OWNER'S CONSTRUCTION REPRESENTATIVE PRIOR TO INSTALLATION OF ANY NEW UTILITIES.

CONTRACTOR SHALL BE RESPONSIBLE FOR COORDINATING THE RELOCATION OF ANY UTILITIES ENCOUNTERED AND REPLACEMENT OF ANY UTILITIES DAMAGED WITHIN INFLUENCE ZONE OF NEW CONSTRUCTION. CONTRACT ENGINEER IF THE EXISTING UTILITIES VARY APPRECIABLY FROM THE PLANS.



- 11. CLEAN OUT ALL EXISTING AND PROPOSED STORM INLETS AND CATCH BASINS AT THE COMPLETION OF CONSTRUCTION.
- 12. CONTRACTOR IS TO COMPLETE TEST HOLES TO OBTAIN CROSSING ELEVATIONS AT ALL UTILITY CROSSING LOCATIONS TO VERIFY ELEVATIONS ARE NOT IN CONFLICT.
- 13. SURVEYOR SHALL CHECK ANY LOCATIONS WHERE PROPOSED SANITARY AND STORM SEWER IS CONNECTING INTO EXISTING SANITARY AND STORM SEWER TO VERIFY EXISTING INVERT ELEVATIONS. CONTACT ENGINEER WITH ANY PLAN DISCREPANCIES.

GRAPHIC SCALE FEET

──

STORM SEWER PIPE

STORM SEWER MANHOLE STORM SEWER CURB INLET

STORM SEWER CURB INLET W/MANHOLE STORM SEWER FIELD INLET

ABBREVIATIONS

STMH - STORM MANHOLI CI - CURB INLET CB - CATCH BASIN

PROPOSED UTILITY LEGEND

ADDITION RESERVE , BLOCK 36 HILL FARMS-COMMERCIAL ADISON, DANE COUNTY, WIS PLAN 4 & 5, | ERSITY | OF MA ALITILA LOTS 1"=20' (24"X36" 1"=40' (11"X17") 10/3/2019 JDOY TSCH

ROJECT NO.

5 OF 6

C - 4.0

190255

vierbiche

6 HILLDALE VILLAGE CONDOMINULUM

V.5-167A CONDO PLATS, P.1-3, DOC. #4223519 2 6 0 C 6 6 0 Z 19 PLATS, DOC. #9211 0 SAN A STAN FX SMH RIM=904.21 IE = 893.77 (W)-EX INLET -RIM=901.81 = 893.35 (S) IE=896.96 (N. IF = 893.35 (F)EX INLET -RIM=902.88 0 FX CIN IE=897.83 (N. S) -TC = 902.58IE=899.58 (NW) EX STMH RIM = 90.3.25FX SMH IE=898.30 (W, E) RIM=903.90 EX INLET $IF = 89.3 \, \Omega 1 \, (W)$ R/M = 901.3326'-8" HDPE STORM SEWER @ 1.04% 894.91 (S) 6' CB RIM=904.60 IE=896.08 (W, E, EX CIN -TC=903.63 = 892.94 (E. EX CIN TC=902.11 24" INV=898.90 IF=900 78 (S 36" INV=898.90 IE=898.81 (N) -36" HDPE STORM INSTALL CAP WITH 5" ORIFICE AT INVERT OF 12" PIPE TO RESTRICT FLOW TO 12" PIPE


POTENTIAL LOCATION OF ROOF DISCHARGE PIPE. ALL ROOFWATER TO BE CONVEYED TO STORM STRUCTURES ST-1, ST-2, OR ST-3. COORDINATE FINAL LOCATIONS WITH ENGINEER SEWER @ 0.25% 0161 FX INI FT MAN RIM=903.55-EX CIN TC=903.83-≥141018 | IE=900.40 (NW) IE=900.58 (SW) 5' CB W/INLET POTENTIAL LOCATION OF ROOF BOLT DOWN LID RIM=903.90 DISCHARGE PIPE. ALL ROOFWATER TO
BE CONVEYED TO STORM STRUCTURES
ST-1, ST-2, OR ST-3. COORDINATE PLUMBER TO MAXIMIZE THE CAPACITY OF THE EXISTING 6" SANITARY LATERAL ON RECENT ST. THE REMAINING FLOWS 12" INV (5" ORIFICE)=898.57 36" INV=898.57 IMIS ISIC FINAL LOCATIONS WITH ENGINEER ARE TO DISCHARGE TO THE EXISTING 8" 79'-24" HDPE STORM SEWER @ 0.25% SANITARY LATERAL ON VERNON BLVD 59 UNIT APARTMENT HOME PLUMBER TO MAXIMIZE THE CAPACITY OF PLUMBER TO CONNECT TO 70 PARKING STALLS THE EXISTING 6" SANITARY LATERAL ON REGENT ST. THE REMAINING FLOWS ARE EX SMH EXISTING 6" WATER SERVICE 4 STORY RIM=899.82 ω STORM SEWER DISCHARGE TO PUMP INSIDE FIRST FLOOR ELEVATION=907.00 BASEMENT ENTRANCE = 890.47 (SW) TO DISCHARGE TO THE EXISTING 8"
SANITARY LATERAL ON VERNON BLVD >1 BUILDING. PLUMBER TO DESIGN PUMP(S IE = 890.37 (E)FOR 100-YEAR STORM EVENT (MIN. 01 POTENTIAL LOCATION OF ROOF POTENTIAL LOCATION OF ROOF DISCHARGE PIPE. ALL ROOFWATER TO BE CONVEYED TO STORM STRUCTURES ST-1, ST-2, OR ST-3, COORDINATE FINAL LOCATIONS WITH ENGINEER \geq - SAN 6 - α \geq INV=900.10 24" INV=899.10 5' CB W/INLET ROOF DECK 3' SUMP TC=906.45 22'-12" HDPE STORM SEWER @ 15.22% R/W Gran SUMP INVERT=900.45 Existing HUX3U K/W Graff Inderground Electric Easemer to MG&E, Doc. #4475632 TC = 897.47 α 12" INVERT=903.45 12" INV=894.20 LOI 图图 图 0 0 LQIJ Existing 10' Utility O M M E R C L A L R E S E R V E

B L O C K 3 6

Doc. #953198 EXISTING BUILDING 17 4506 REGENT STREET




FLEXSTORM CATCH-IT FILTERS 11 GA -GALVANIZED STEFI SUSPENSION -LIFT HANDLES SYSTEM STANDARD 2"
OVERFLOW AREA CLAMPING BAND REPLACEABLE SEDIMENT BAGS WITH GEOTEXTILE FILTER FABRIC TYPICAL RECTANGULAR TYPICAL ROUND INLET FILTER INLET FILTER

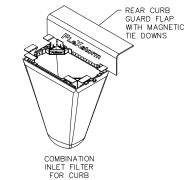

HOODS

NOTES:

- 1. ALL FRAMING IS CONSTRUCTED OF CORROSION RESISTANT STEEL (ZINC PLATED OR GALVANIZED) FOR 7 YEAR MINIMUM SERVICE LIFE.
- 2. UPON ORDERING CONFIRMATION OF THE DOT CALLOUT, PRECAST OR CASTING
 MAKE AND MODEL, OR DETAILED DIMENSIONAL FORMS MUST BE PROVIDED TO CONFIGURE AND ASSEMBLE YOUR CUSTOMIZED FLEXSTORM INLET FILTER. PART NUMBER ALONE IS NOT SUFFICIENT
- 3 FOR WRITTEN SPECIFICATIONS AND MAINTENANCE GUIDELINES VISIT WWW.INLETFILTERS.COM

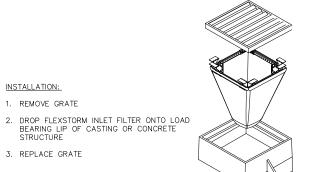


INSTALLATION:

1. REMOVE GRATE

3. REPLACE GRATE

FRAMED INLET PROTECTION

NOT TO SCALE

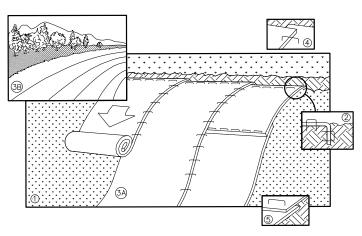


NOTE: REFER TO GENERAL STAPLE PATTERN GUIDE FOR CORRECT STAPLE PATTERN RECOMMENDATIONS FOR SLOPE INSTALLATIONS.

- PREPARE SOIL BEFORE INSTALLING BLANKETS, INCLUDING APPLICATION OF
- FERTILIZER AND SEED.


 NOTE: WHEN USING CELL—O—SEED, DO NOT SEED PREPARED AREA.

 CELL—O—SEED MUST BE INSTALLED WITH PAPER SIDE DOWN.

 2. BEGIN AT THE TOP OF THE SLOPE BY ANCHORING THE BLANKET IN 6" DEEP
- BY 6" WIDE TRENCH. BACKFILL AND COMPACT THE TRENCH AFTER STAPLING. ROLL THE BLANKETS <A.> DOWN, OR <B.> HORIZONTALLY ACROSS THE SLOPE THE EDGES OF PARALLEL BLANKETS MUST BE STAPLED WITH APPROXIMATELY 2" OVERLAP
- WHEN BLANKETS MUST BE SPLICED DOWN THE SLOPE, PLACE BLANKETS END OVER END (SHINGLE STYLE) WITH APPROXIMATELY 4" OVERLAP. STAPLE
- THROUGH OVERLAPPED AREA, APPROXIMATELY 12" APART.
 6. ALL BLANKETS MUST BE SECURELY FASTENED TO THE SLOPE BY PLACING STAPLES/STAKES IN APPROPRIATE LOCATIONS AS RECOMMENDED BY THE MANUFACTURER.
- TYPE A, URBAN E-MAT SHALL BE USED WITHIN THE PUBLIC ROAD RIGHT OF WAY ON WEST END CIRCLE AND WALL STREET FOR RESTORATION. MULCH SHALL NOT BE USED WITHIN THE PUBLIC ROAD RIGHT OF WAY.

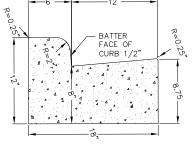





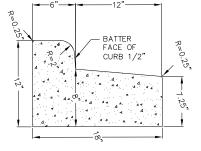

CURB AND GUTTER REJECT CROSS SECTION



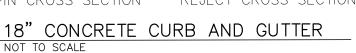


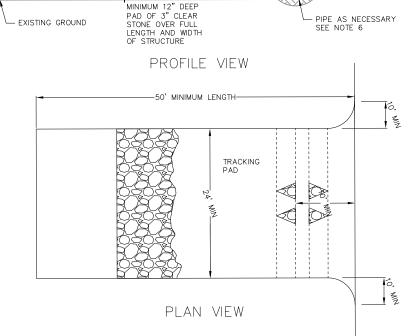

-50' MINIMUM LENGTH

- 1. FOLLOW WISCONSIN DNR TECHNICAL STANDARD 1057 FOR FURTHER DETAILS AND INSTALLATION.
- 2. LENGTH MINIMUM OF 50'.
- 3. WDTH 24' MINIMUM, SHOULD BE FLARED AT THE EXISTING ROAD TO PROVIDE A TURNING RADIUS.
- 4. ON SITES WITH A HIGH GROUNDWATER TABLE OR WHERE SATURATED CONDITIONS EXIST, GEOTEXTILE FABRIC SHALL BE PLACED OVER EXISTING GROUND PRIOR TO PLACING STONE. FABRIC SHALL BE WISDOT TYPE—HR GEOTEXTILE FABRIC
- 5. STONE CRUSHED 3" CLEAR STONE SHALL BE PLACED AT LEAST 12" DEEP OVER THE ENTIRE LENGTH AND WIDTH OF ENTRANCE.
- 6. SURFACE WATER ALL SURFACE WATER FLOWING TO OR DIVERTED TOWARDS CONSTRUCTION ENTRANCES SHALL BE PIPED THROUGH THE ENTRANCE. MAINTAINING POSITIVE DRAINAGE. PIPE INSTALLED THROUGH THE STABILIZED CONSTRUCTION ENTRANCE SHALL BE PROTECTED WITH A MOUNTABLE BERM WITH 5:1 SLOPES AND MINIMUM OF 6" STONE OVER THE PIPE. PIPE SHALL BE SIZED ACCORDING TO THE DRAINAGE REQUIREMENTS. WHEN THE ENTRANCE IS LOCATED AT A HIGH SPOT AND HAS NO DRAINAGE TO CONVEY A PIPE SHALL NOT BE NECESSARY. THE MINIMUM PIPE DIAMETER SHALL BE 6". CONTRACTOR SHALL BE RESPONSIBLE FOR THE MAINTENANCE OF SAID PIPE
- 7. LOCATION A STABILIZED CONSTRUCTION ENTRANCE SHALL BE LOCATED WHERE CONSTRUCTION TRAFFIC ENTERS AND/OR LEAVES THE CONSTRUCTION SITE. VEHICLES LEAVING THE SITE MUST TRAVEL OVER THE ENTIRE




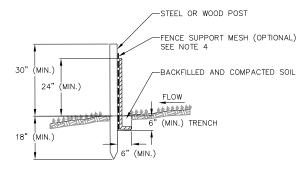

- 10 FT. (MAX.)

MESH = 6 FT. (MAX.)



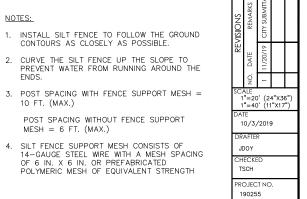

MOUNTABLE BERM

PAVEMENT

vierbiche

ADDITION

RESERVE ,

.4 & 5, BLOCK 36 FERSITY HILL FARMS-COMMERCIAL OF MADISON, DANE COUNTY, WIS

LOTS

6 OF 6

C - 5.0

PLAN

ONSTRUCTION DETAILS


- EARTH FILL

6" MIN. HEIGHT

C-5.0

EROSION MAT

NOT TO SCALE

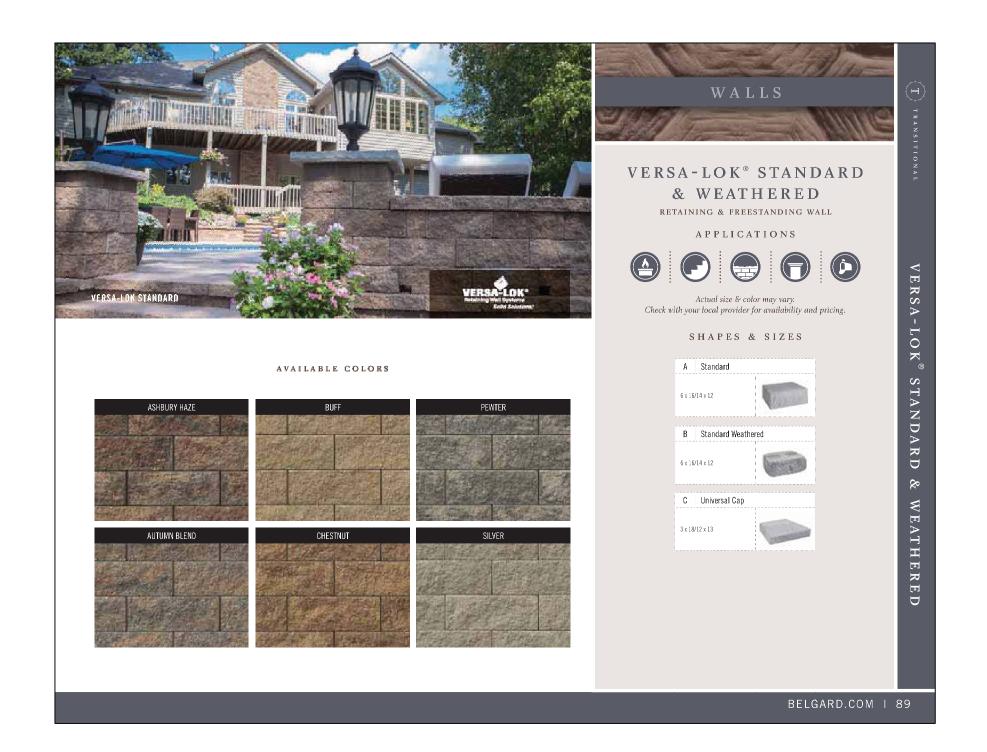

GENERAL NOTES

A) Areas labeled "Brown Colored Wood Mulch" to receive a mixture of recycled wood mulch, colored brown, spread to a 3" depth over pre-emergent herbicide.

B) Individual trees (and shrub groupings) found along perimeter of property as well as those found within lawn areas to receive wood mulch rings (and wood mulch beds) consisting of a mixture of recycled wood mulch, colored brown, spread to a minimum 3" depth (3' wide beds for shrub groupings).

C) "Vinyl Edging" to be Valley View Black Diamond Vinyl Edging or equivalent.

D) Areas labeled "Eau Claire washed stone" to receive I-I/2" Eau Claire washed stone spread to a 3" depth over fabric weed barrier.

E) "Seed" areas shall be finish-graded and seeded at a rate of 4 lbs. per 1,000 sq. ft.

F) Seed shall consist of the following mixture:
10% Palmer IV Perennial Ryegrass
20% Dragon Kentucky Bluegrass
20% Diva Kentucky Bluegrass
20% Foxy II Creeping Red Fescue
15% Vail II Perennial Ryegrass

15% Ginney Kentucky Bluegrass

G) Areas labeled "Seed/Straw Mat" shall be seeded with the above-noted premium lawn seed mixture and overlaid with DS75 straw erosion control netting that is then pegged into the soil with metal staples.

H) Areas labeled "Sod" shall receive only No. I grade nursery-grown bluegrass sod.

I) Existing street trees shall be protected. Contractor shall install tree protection fencing in the area between the curb and sidewalk and extend it at least 5 feet from both sides of the tree along the length of the terrace. No excavation is permitted within 5 feet of the outside edge of the tree trunk. If Excavation within 5 feet of any tree is necessary, contractor shall contact City Forestry (608)266-4816 prior to excavation to assess the impact to the tree and root system. Tree pruning shall be coordinated with City Forestry. Tree protection specifications can be found in section 107.13 of City of Madison Standard specifications for Public Works Construction-http://www.cityofmadison.com/business/pw/documents/StdSpecs/2019/Part1.pdf.

J) Contractor shall contact City Forestry (608)266-4816 at least one week prior to installing street trees to schedule inspecting the nursery stock and reviewing landscaping specifications with the landscaper.

Plant Material List

Broadleaf De	ciduous			
Quantity	Code Name	Common Name	Scientific Name	Planting Siz
4	ARM	Armstrong Maple	Acer X Freemanii 'armstrong'	2 I/2" B&B
4	ABS	Autumn Brill Serviceberry	Amelanchier X Grand 'autumn Brill'	7' B&B
3	GGCT	Golden Glory Corn Cherry (tf)	Cornus Mas 'golden Glory' (tf)	2" B&B
I	EKC	Espresso Kentucky Coffeetree	Gymnocladus Dioicus 'espresso-Jfs'	2" B&B
5	RJC	Red Jewel Crabapple	Malus 'jewelcole'	2" B&B
6	RPO	Regal Prince English Oak	Quercus Robur 'long'	2 I/2" B&B
Conifer Everg	reen			
Quantity	Code Name	Common Name	Scientific Name	Planting Siz
17	MMP	Mops Mugo Pine	Pinus Mugo 'mops'	#3 CONT.
3	HA	Holmstrup Arborvitae	Thuja Occidentalis 'holmstrup'	5' B&B
16	EA	Emerald Arborvitae	Thuja Occidentalis 'smaragd'	6' B&B
12	WGA	Woodward Globe Arborvitae	Thuja Occidentalis 'woodwardii'	#5 CONT.
Perennial				
Quantity	Code Name	Common Name	Scientific Name	Planting Siz
54	KFG	Karl Foerster's Feather Reed G	Calamagrostis Acutiflora 'karl Foerster'	#I CONT.
17	PMG	Purple Maiden Grass	Miscanthus Sinensis Var Purpurescens	#I CONT.
66	PRD	Prairie Dropseed	Sporobolus Heterolepis	#I CONT.
Shrub				
Quantity	Code Name	Common Name	Scientific Name	Planting Siz
3	GFS	Goldflame Spirea	Spiraea Japonica 'goldflame'	#3 CONT.
7	CLV	Chicago Lustre Arwd Viburnum	Viburnum Dentatum 'synnestvedt'	4' B&B


MADISON LANDSCAPE WORKSHEET


Zoning	district	is ⁻	TRI	J-2	
T - 4-1	£-	_ 4-			٠. لـ

NUMBER OF LANDSCAPE POINT REQUIRED


28 Landscape Units x 5 landscape points for first 5 acres	140	points
0 Landscpe Units x I landscape point for additional 0 acres	0	points
TOTAL LANDSCAPE POINTS REQURED	140	points

	Point	NI	EW	EXIS	TING	
PLANT TYPE or ELEMENT	Value	Qty.	Points Achieved	Qty.	Points Achieved	
Overstory Deciduous Tree : 2-1/2" (dbh)	35	10	350			
Tall Evergreen Tree : 5-6 feet tall	35	0	0			
Ornamental Tree : I-I/2" Caliper (dbh)	15	П	165			
Upright Evergreen Shrub : 3-4 feet tall	10	19	190			
Shrub, deciduous : 3 gallon / 12"-24"	3	10	30			
Shrub, evergreen : 3 gallon / 12"-24"	4	29	116			
Ornamental grass/perennial :Igallon / 8"-18"	2	137	274			
Ornamental / Decorative fencing or wall	4 per 10 l.f.					
Existing significant specimen tree	I4 per Cal. In.					TOTAL
Landscape furniture for public seating and /or transit connections	5 per 'seat'					POINTS PROVIDE
	Sub	Totals	1,125	+	NA	= 1,125

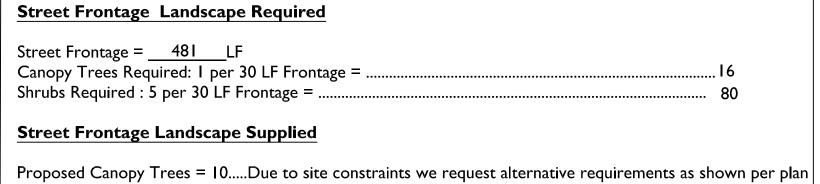

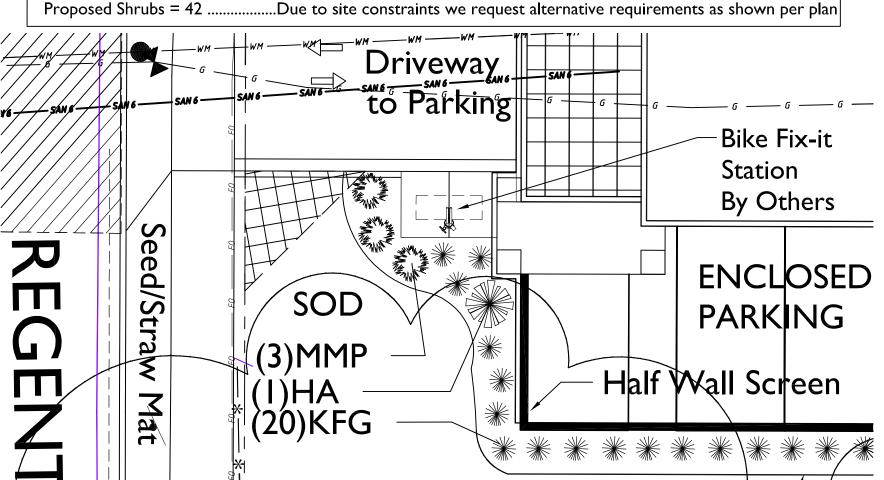

Bike Fix-it Station Enlarged to 1/8"=1'-0"

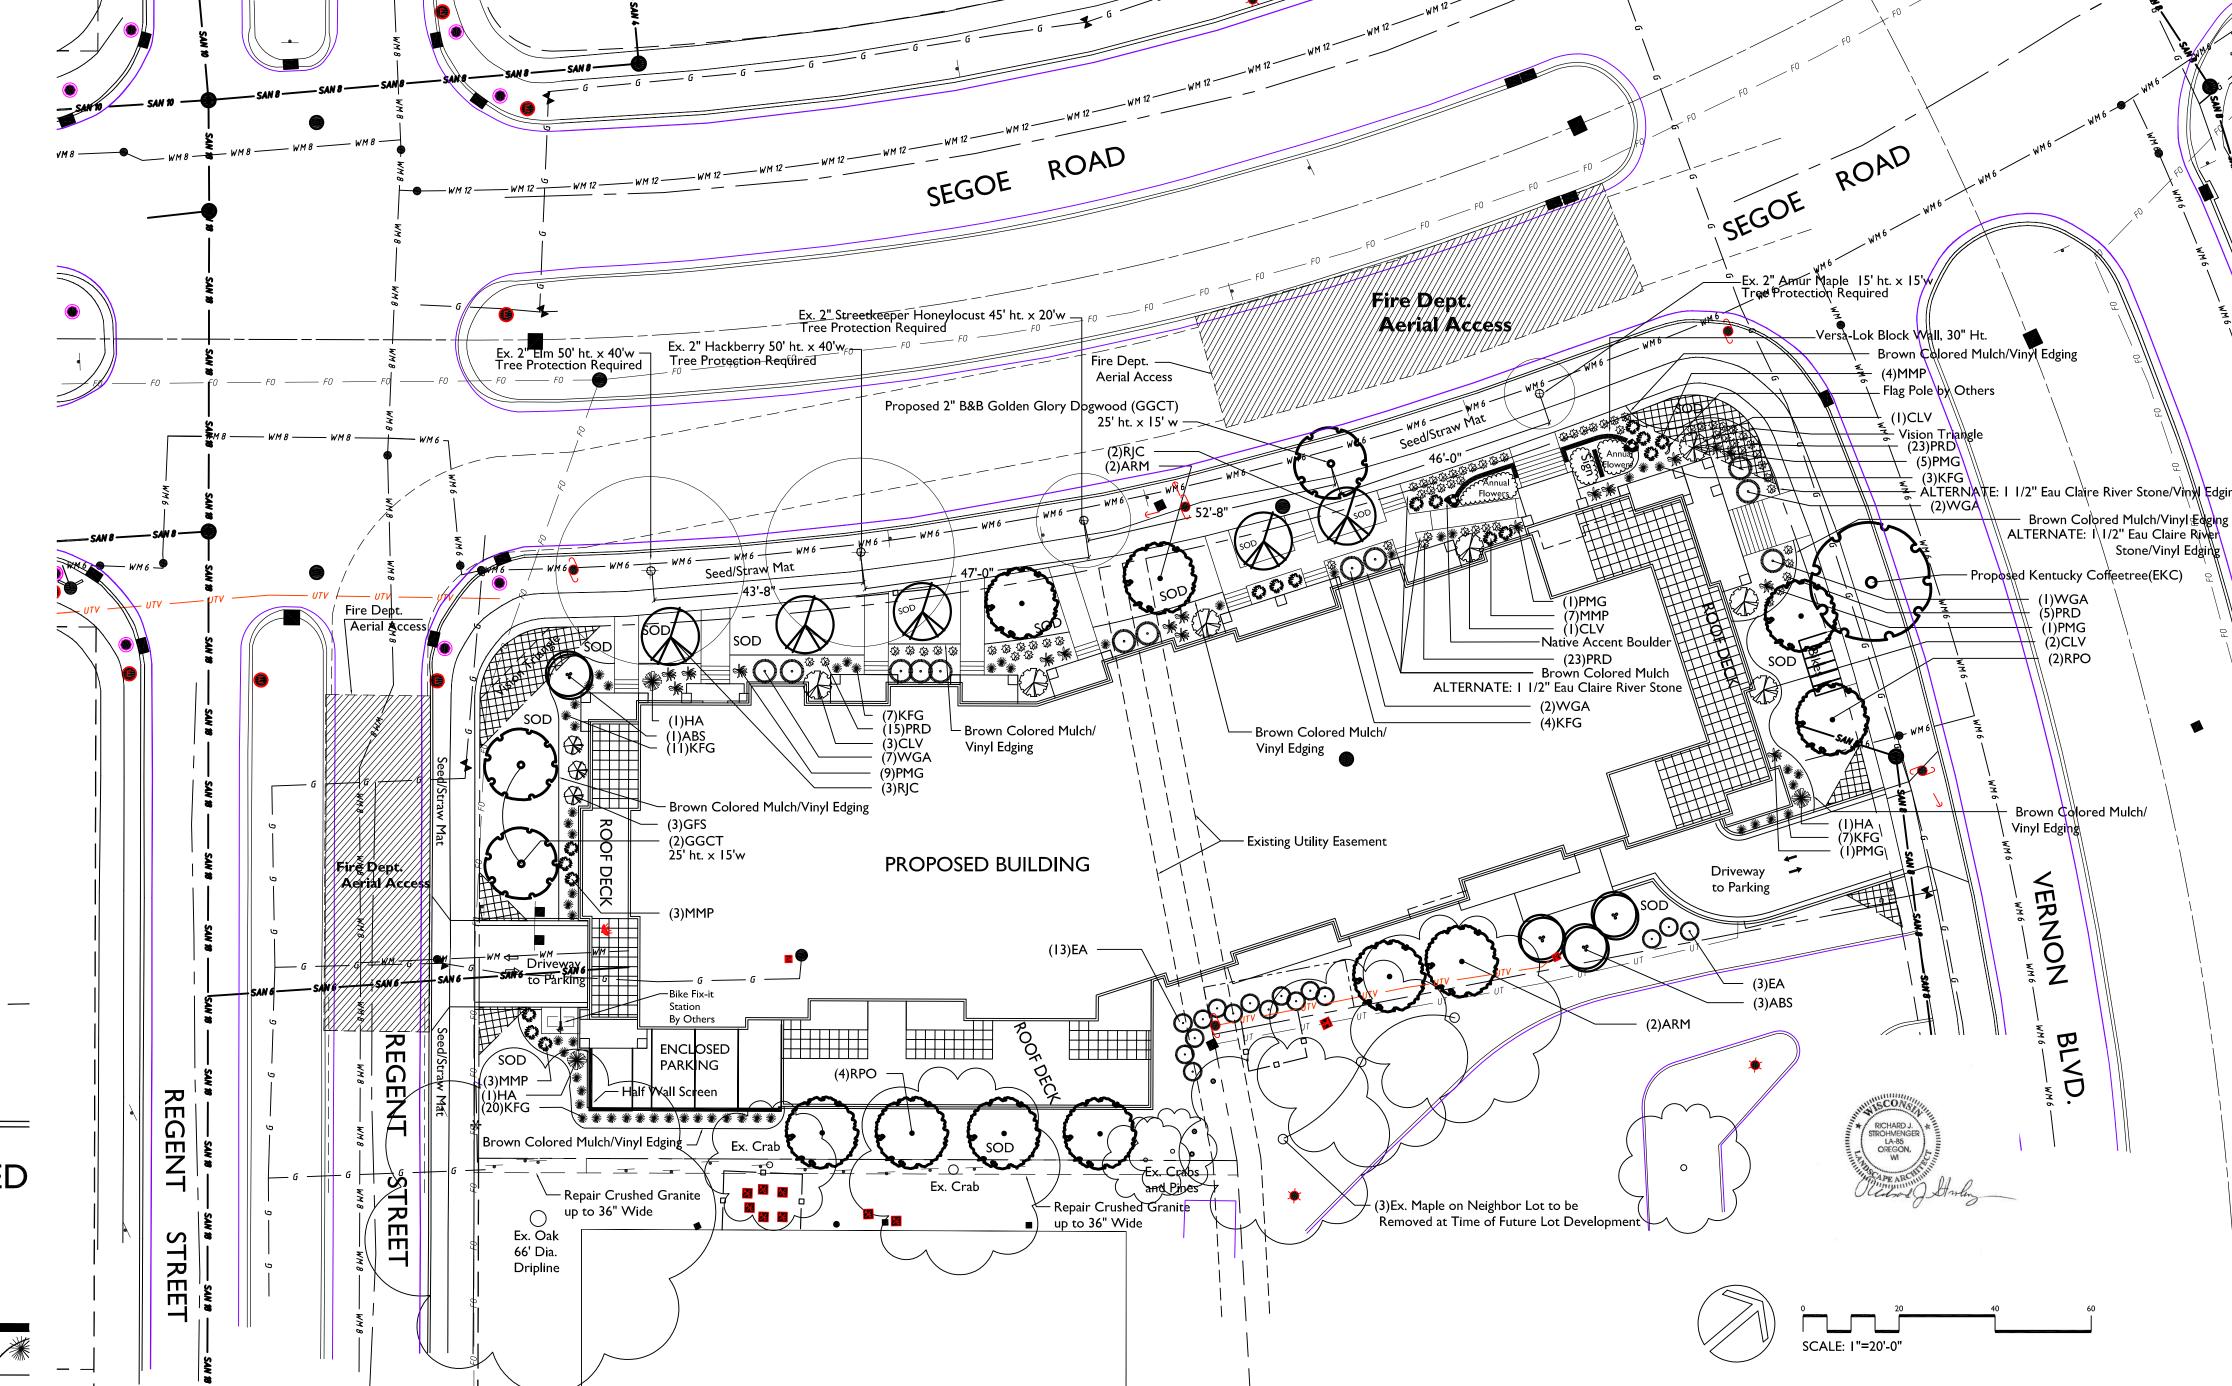

the bruce company

OF WISCONSIN INC.

LANDSCAPE ARCHITECTS

LANDSCAPE CONTRACTORS

2830 PARMENTER STREET

P.O. BOX 620330

MIDDLETON, WI 53562-0330

TEL (608) 836-7041

FAX (608) 831-6266


THE HAMPTONS APARTMENTS
NORTH SEGOE ROAD AND REGENT STREET


Checked By: SS Drawn By: 11/14/19 RS

Revised: I/I4/20 RS
Revised:

L1

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Issued for Land Use & UDC Submittal; 11/20/2019

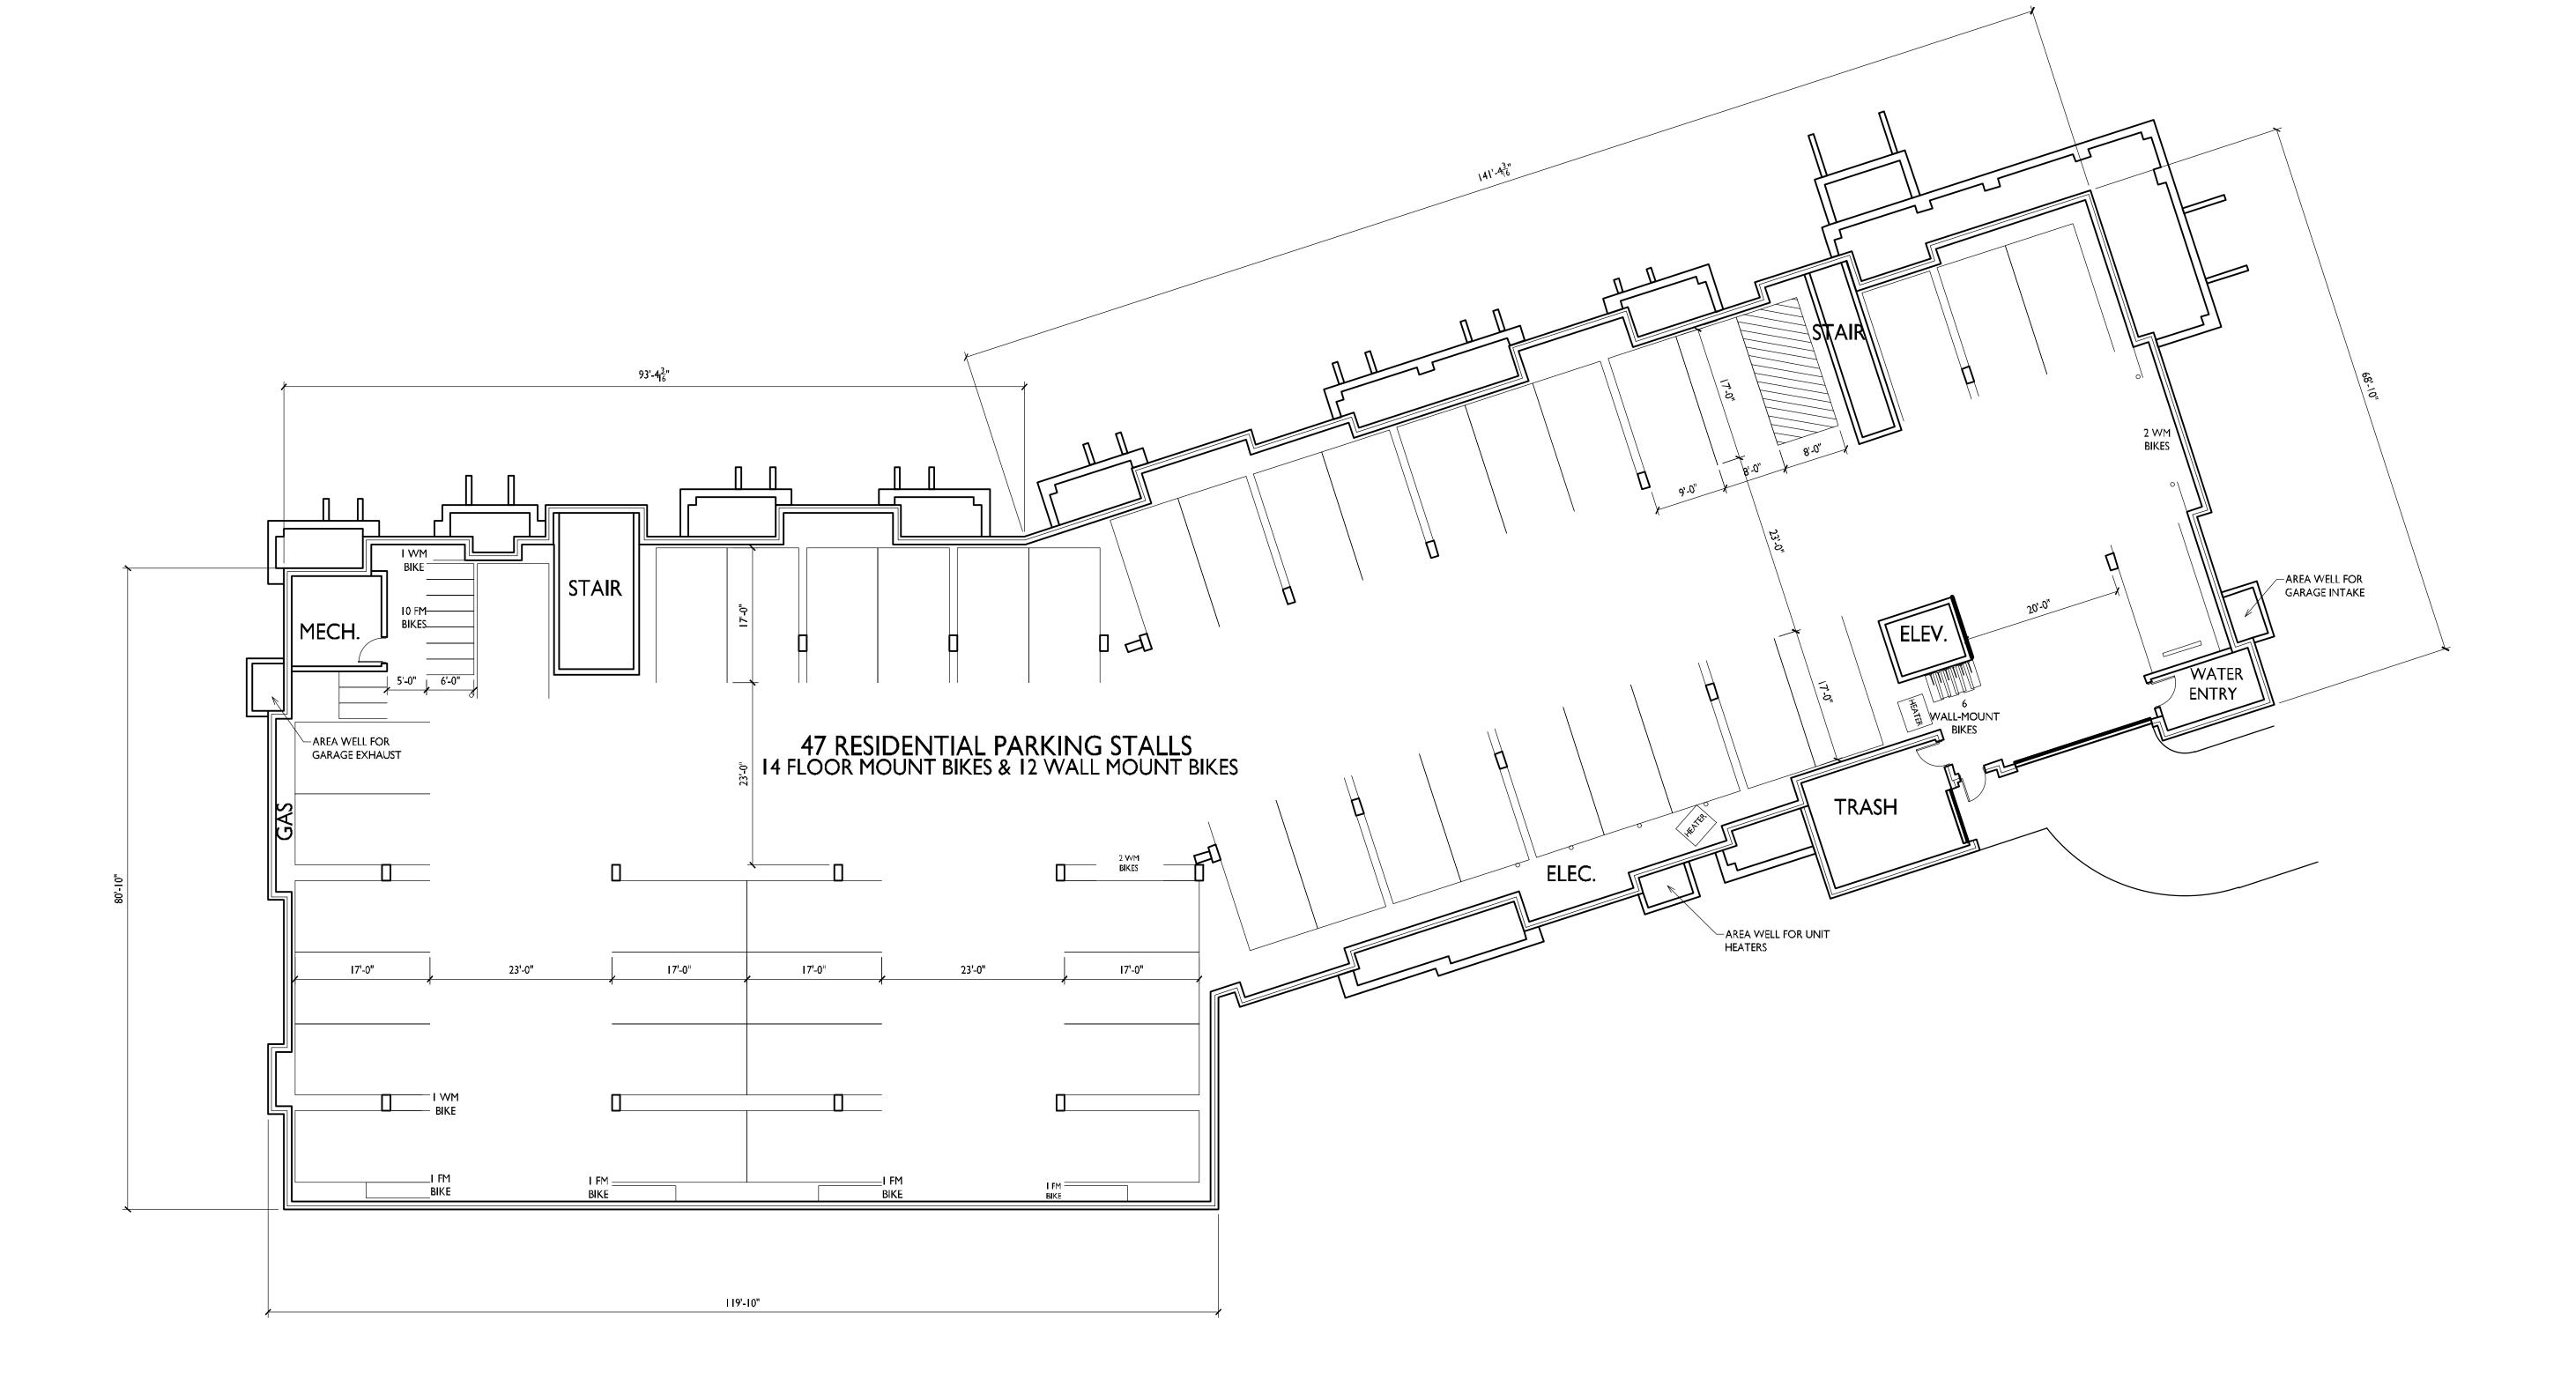PROJECT TITLE
FLAD - SEGOE

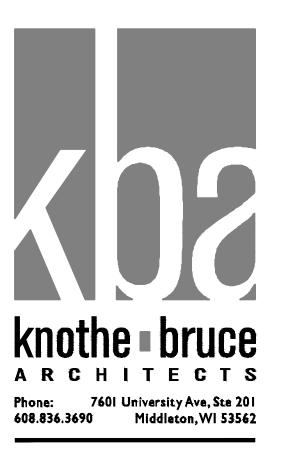Site Address:
4510 Regent St & 4513
Vernon Blvd.
SHEET TITLE Basement Floor Plan

SHEET NUMBER

A-1.0

© Knothe & Bruce Architects, LLC

1945

PROJECT NO.


BASEMENT FLOOR PLAN

3/32" = 1'-0"





KEY PLAN

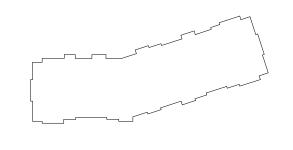

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PROJECT TITLE

FLAD - SEGOE

4510 REGENT ST. & 4513 VERNON BLVD. MADISON, WI

SHEET TITLE
First Floor
Plan

SHEET NUMBER



SECOND FLOOR PLAN

A-1.2 3/32" = 1'-0"

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ARCHITECTS

knothebruce.com
608.836.3690
7601 University Ave. • Suite 201 • Middleton, WI 53562

KEY PLAN

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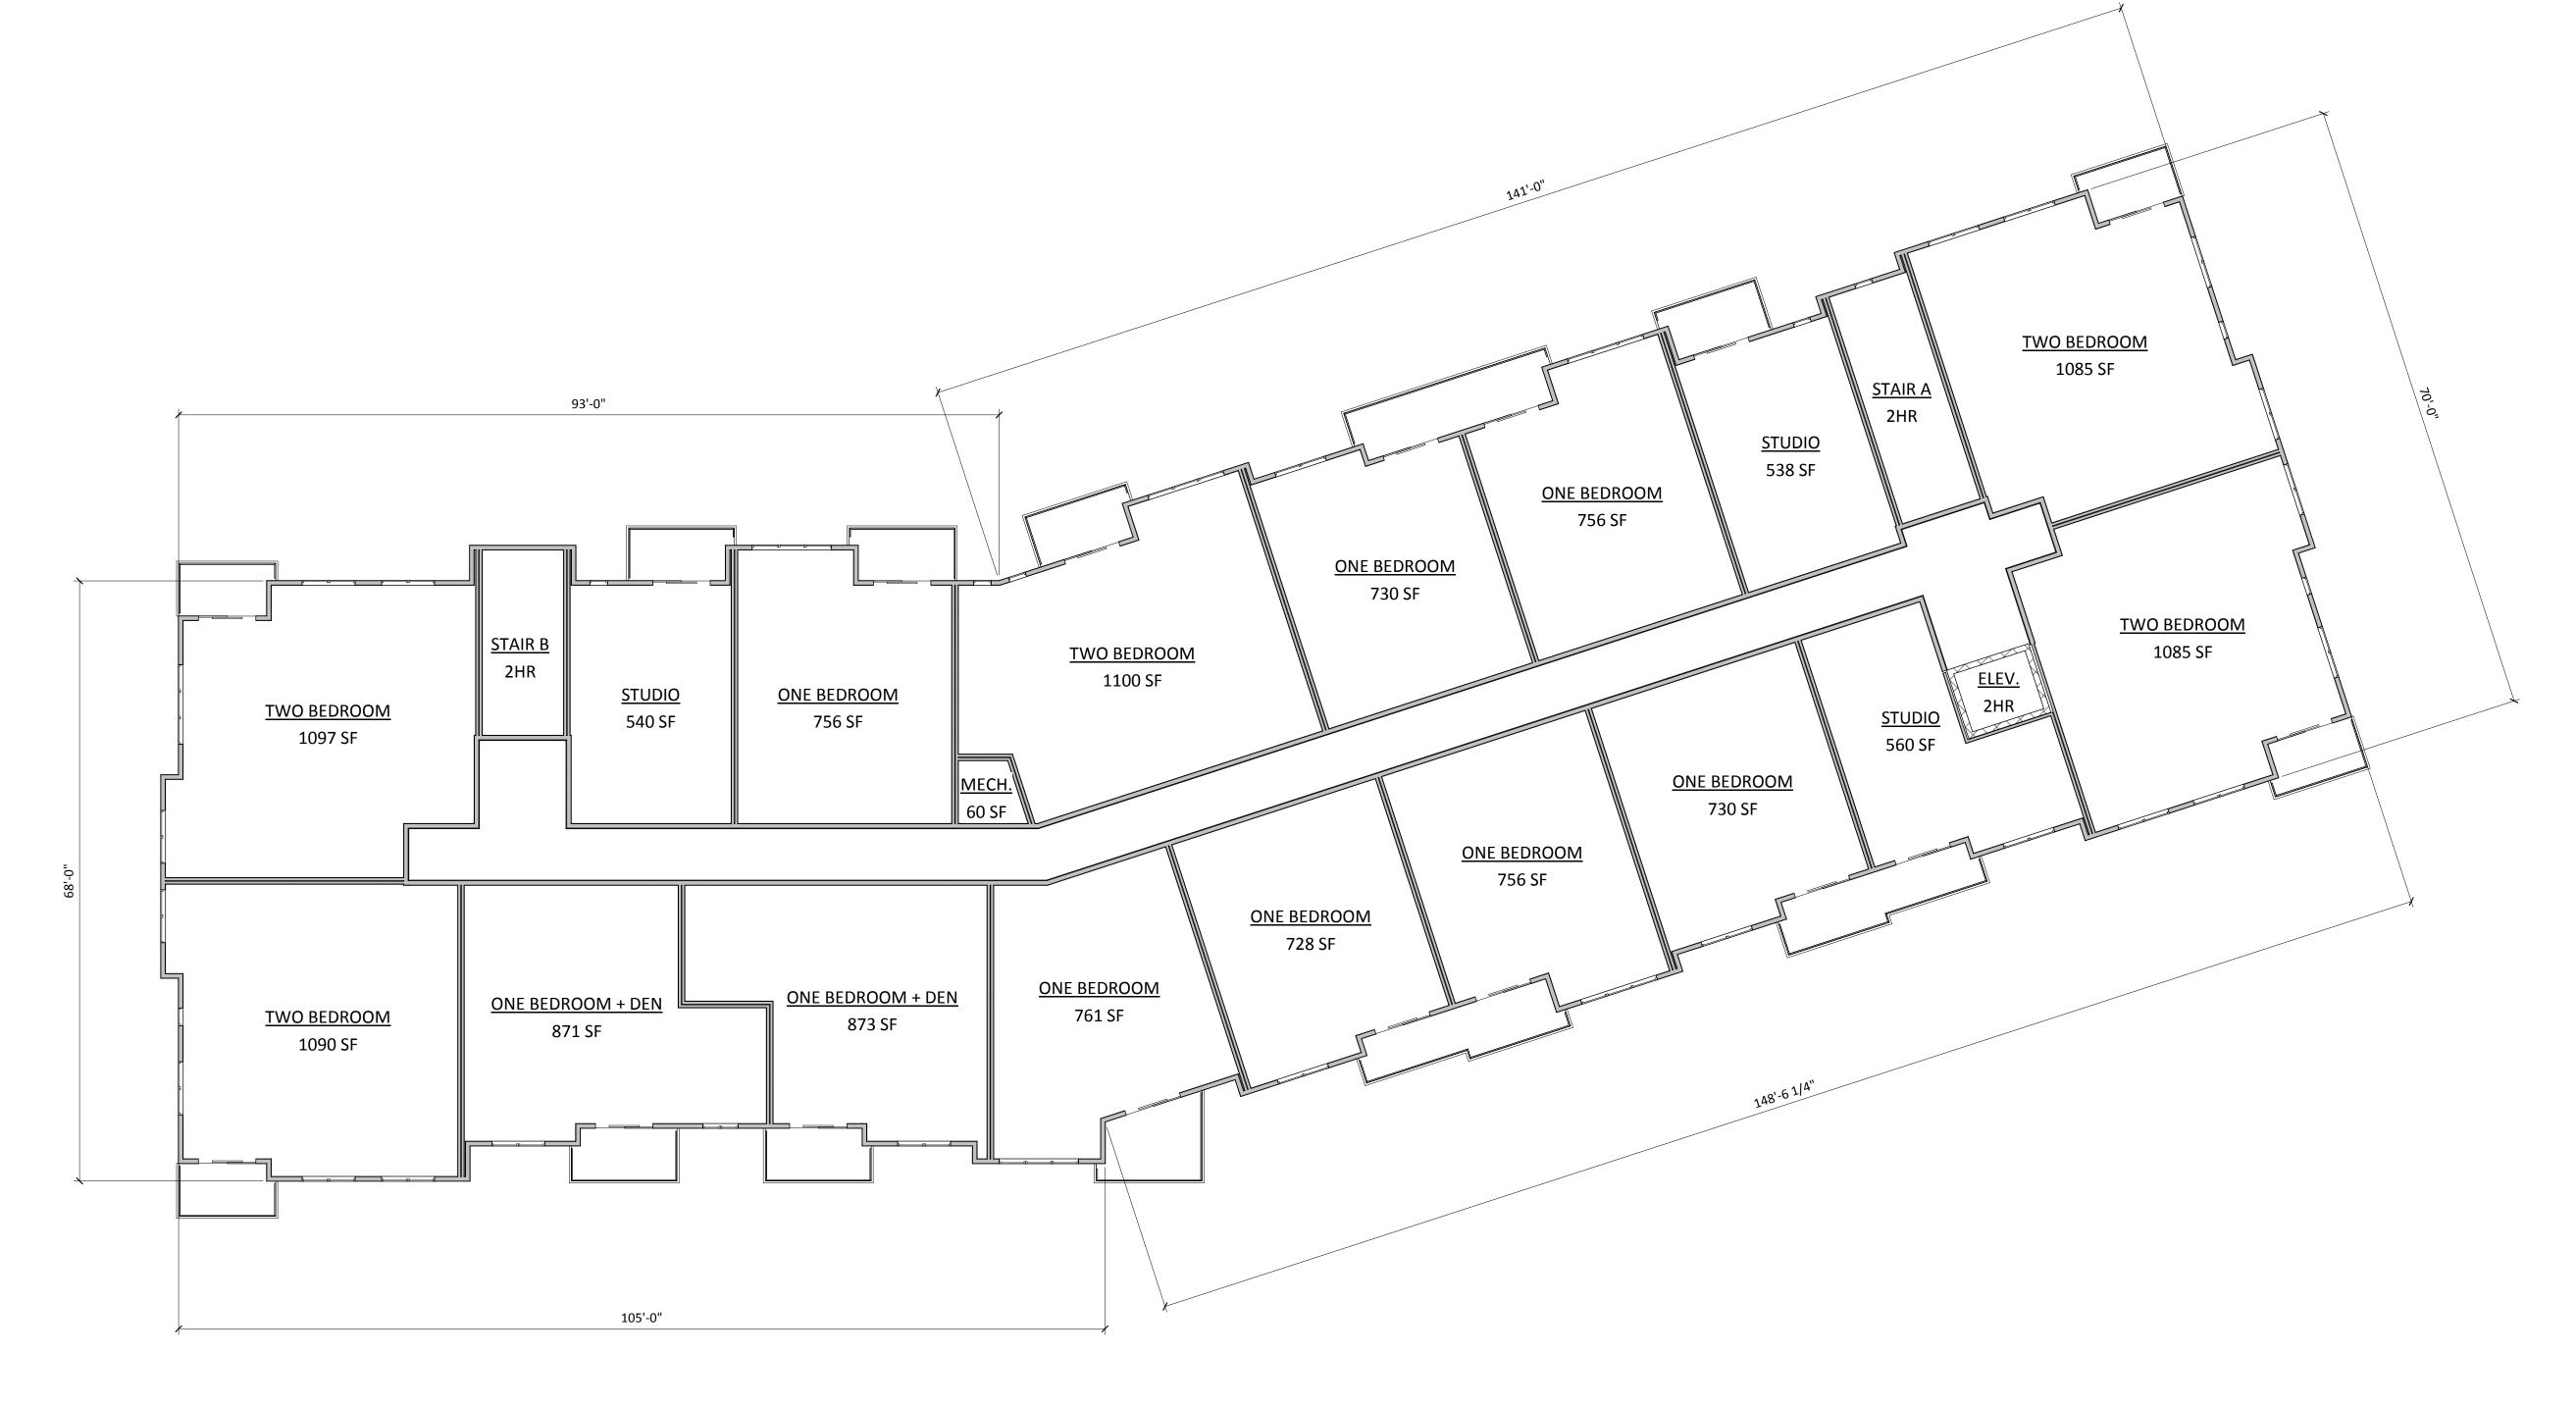
PROJECT TITLE

FLAD - SEGOE

4510 REGENT ST. & 4513 VERNON BLVD. MADISON, WI

SHEET TITLE
Second
Floor Plan


SHEET NUMBER



1 THIRD FLOOR PLAN
A-1.3 3/32" = 1'-0"



KEY PLAN

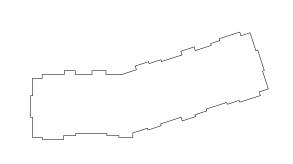

ISSUED
Issued for Land Use - November 20, 2019

PROJECT TITLE

FLAD - SEGOE

4510 REGENT ST. & 4513 VERNON BLVD. MADISON, WI

SHEET TITLE
Third Floor
Plan

SHEET NUMBER

A-1.3



FOURTH FLOOR PLAN


3/32" = 1'-0"

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PROJECT TITLE

FLAD - SEGOE


4510 REGENT ST. & 4513 VERNON BLVD. MADISON, WI

SHEET TITLE
Fourth Floor
Plan

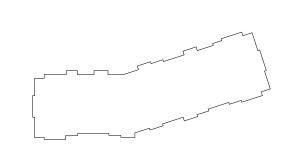
SHEET NUMBER

A-1.4PROJECT NUMBER 1945


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KEY PLAN

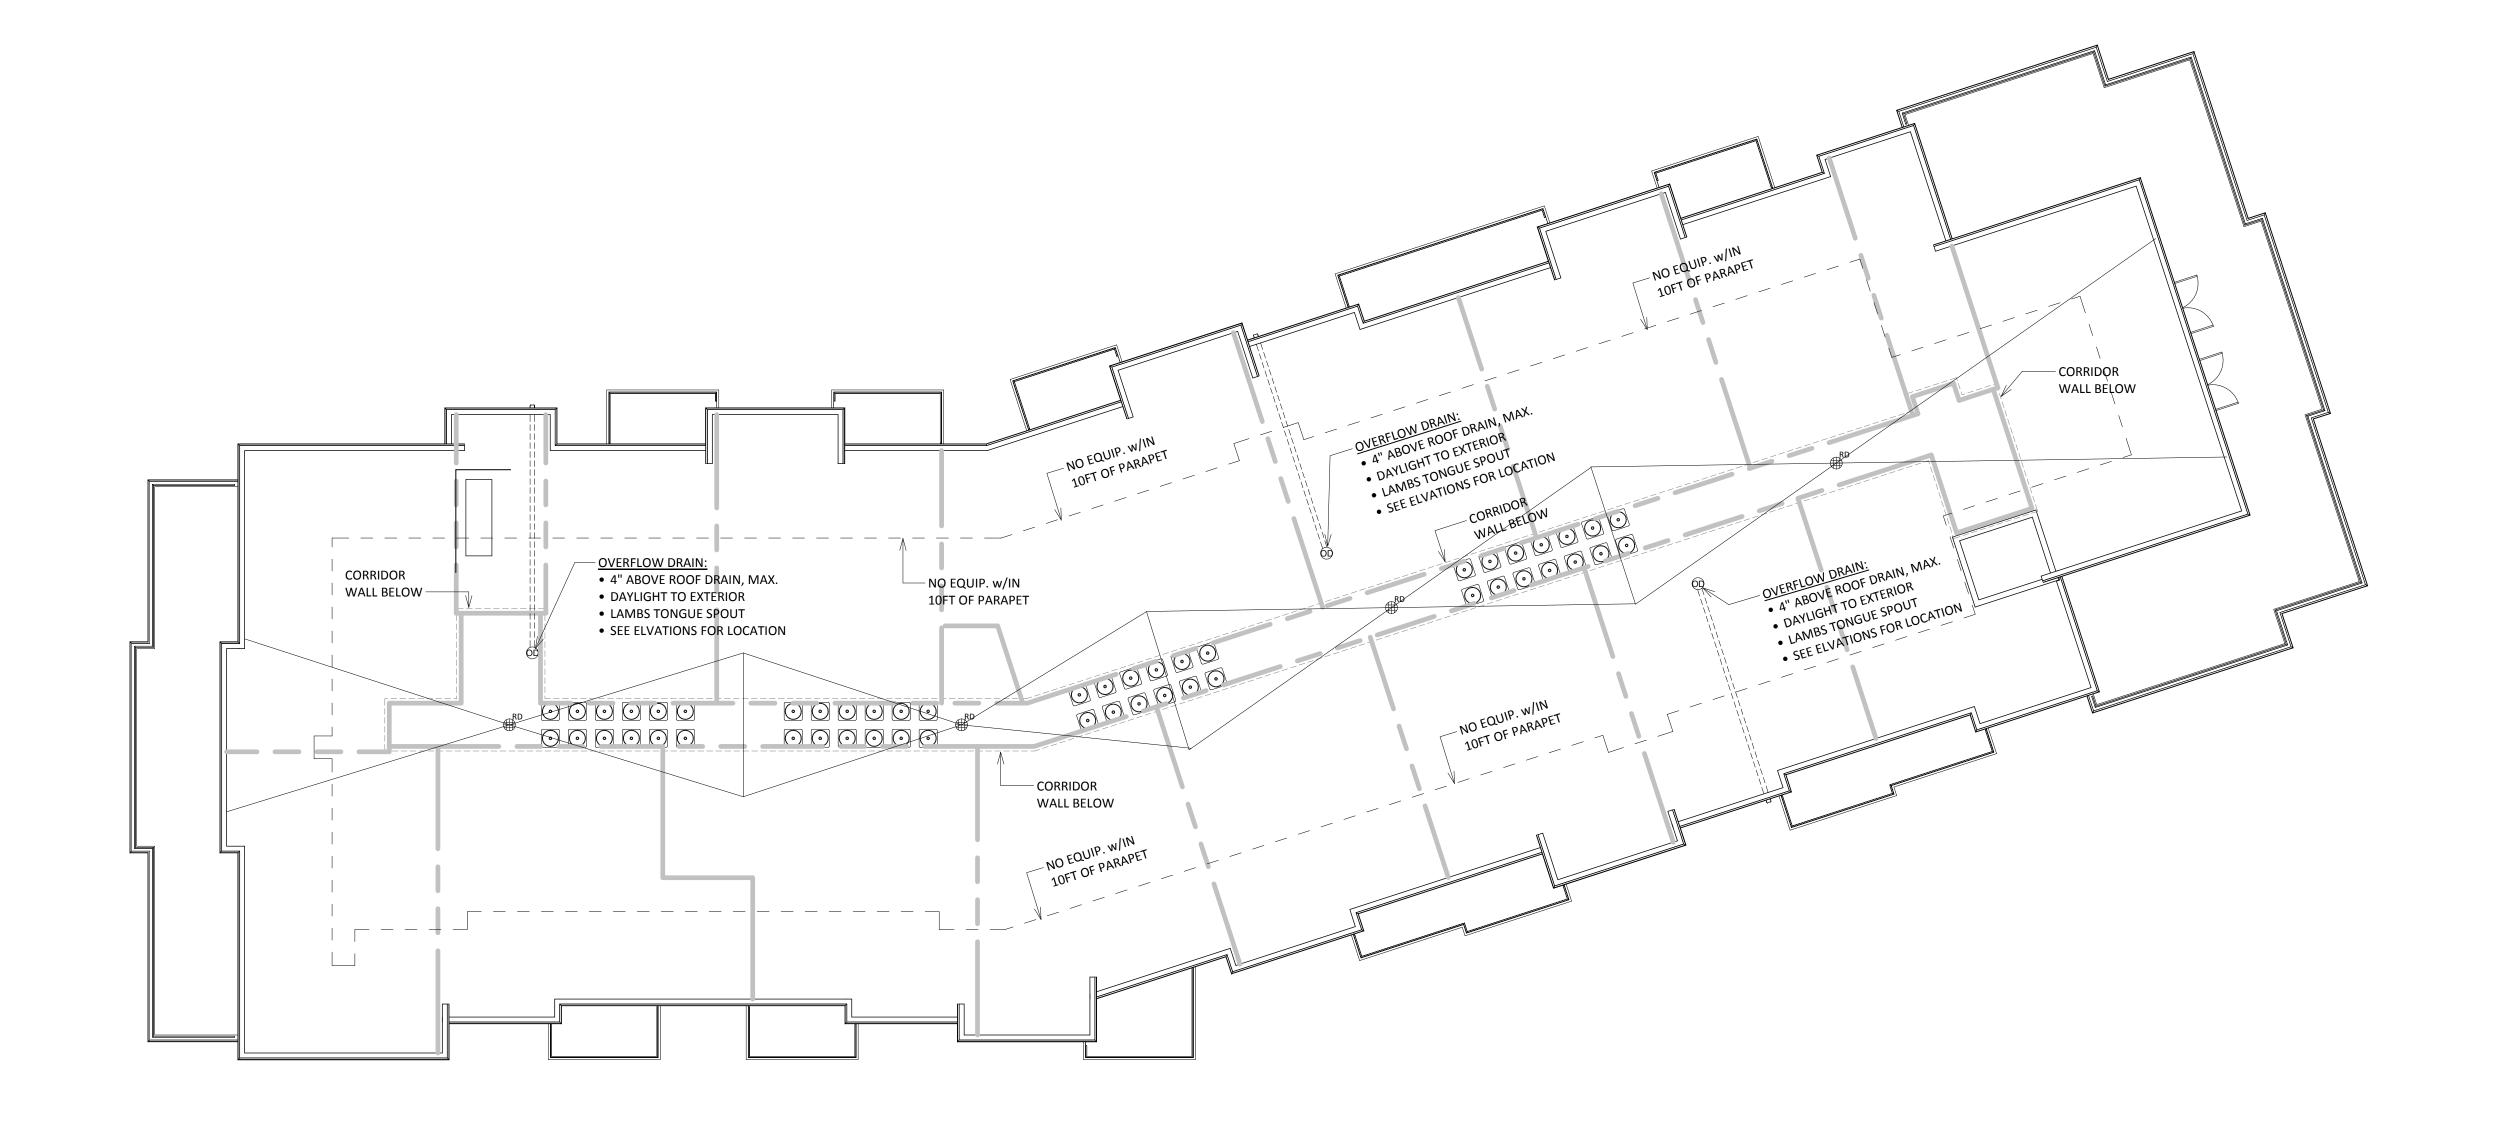

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PROJECT TITLE

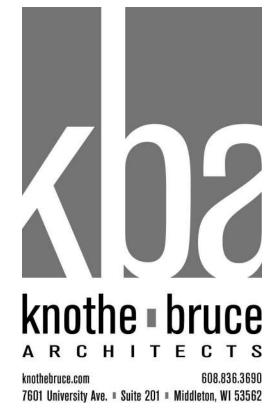FLAD - SEGOE

4510 REGENT ST. & 4513 VERNON BLVD. MADISON, WI

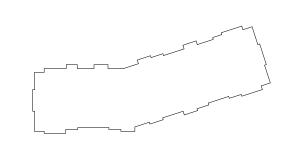SHEET TITLE

Roof Plan

SHEET NUMBER

A-1.5







7601 University Ave. Suite 201 Middleton, WI 53562

KEY PLAN

4510 REGENT ST. &
4513 VERNON BLVD.
MADISON, WI

SHEET TITLE
Exterior

SHEET NUMBER

Elevations

PROJECT NUMBER 1945
© Knothe & Bruce Architects, LLC

PARTIAL WEST ELEVATION

1/8" = 1'-0"



PARTIAL WEST ELEVATION

1/8" = 1'-0"

EXTERIOR MATERIAL SCHEDULE							
BUILDING ELEMENT MANUFACTURER COLOR							
6" COMPOSITE LAP SIDING (#1)	JAMES HARDIE	NIGHT GRAY					
6" COMPOSITE LAP SIDING (#2)	JAMES HARDIE	ARCTIC WHITE					
COMPOSITE PANEL	JAMES HARDIE	NIGHT GRAY					
COMPOSITE TRIM	JAMES HARDIE	ARCTIC WHITE					
STONE VENEER	NATURAL STONE VENEERS	SUTTON					
VINYL WINDOWS	ANDERSON SILVERLINE	WHITE					
ALUM. STOREFRONT	N/A	BLACK ANODIZED					
METAL DOORS/FRAMES	N/A	MATCH WINDOWS					
STONE SILLS & BANDS	EDWARDS	TBD					
SOFFITS & FASCIA	N/A	MATCH COMPOSITE TRIM					

BLACK

N/A

RAILINGS



NORTH ELEVATION

A-2.2 1/8" = 1'-0"



SOUTH ELEVATION
A-2.2 1/8" = 1'-0"

EXTERIOR MATERIAL SCHEDULE							
BUILDING ELEMENT	MANUFACTURER	COLOR					
" COMPOSITE LAP SIDING (#1)	JAMES HARDIE	NIGHT GRAY					
" COMPOSITE LAP SIDING (#2)	JAMES HARDIE	ARCTIC WHITE					
OMPOSITE PANEL	JAMES HARDIE	NIGHT GRAY					
OMPOSITE TRIM	JAMES HARDIE	ARCTIC WHITE					
TONE VENEER	NATURAL STONE VENEERS	SUTTON					
INYL WINDOWS	ANDERSON SILVERLINE	WHITE					
LUM. STOREFRONT	N/A	BLACK ANODIZED					
IETAL DOORS/FRAMES	N/A	MATCH WINDOWS					
TONE SILLS & BANDS	EDWARDS	TBD					
OFFITS & FASCIA	N/A	MATCH COMPOSITE TRIM					
AILINGS	N/A	BLACK					

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KEY PLAN

ISSUED
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PROJECT TITLE

FLAD - SEGOE

4510 REGENT ST. & 4513 VERNON BLVD. MADISON, WI

Exterior Elevations

SHEET NUMBER

A-2.2



KEY PLAN

7601 University Ave. Suite 201 Middleton, WI 53562

ISSUED Issued for Land Use - November 20, 2019

PROJECT TITLE FLAD - SEGOE

4510 REGENT ST. & 4513 VERNON BLVD. MADISON, WI SHEET TITLE

Exterior Elevations

SHEET NUMBER

EXTERIOR MATERIAL SCHEDULE

COLOR

NIGHT GRAY

NIGHT GRAY

SUTTON

WHITE

BLACK

ARCTIC WHITE

BLACK ANODIZED

MATCH WINDOWS

MATCH COMPOSITE TRIM

ARCTIC WHITE

MANUFACTURER

NATURAL STONE VENEERS

ANDERSON SILVERLINE

JAMES HARDIE

JAMES HARDIE

JAMES HARDIE

JAMES HARDIE

N/A

N/A

N/A

N/A

EDWARDS

BUILDING ELEMENT

6" COMPOSITE LAP SIDING (#1)

6" COMPOSITE LAP SIDING (#2)

COMPOSITE PANEL

COMPOSITE TRIM

STONE VENEER

VINYL WINDOWS

ALUM. STOREFRONT

METAL DOORS/FRAMES

STONE SILLS & BANDS

SOFFITS & FASCIA

RAILINGS

A-2.3

PROJECT NUMBER 1945 © Knothe & Bruce Architects, LLC

PARTIAL EAST ELEVATION

1/8" = 1'-0"



PARTIAL EAST ELEVATION

1/8" = 1'-0"














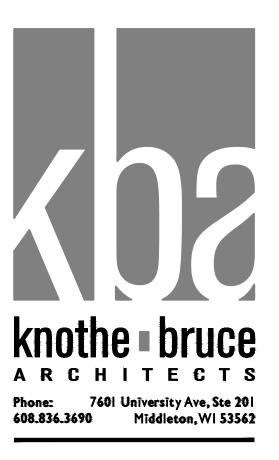


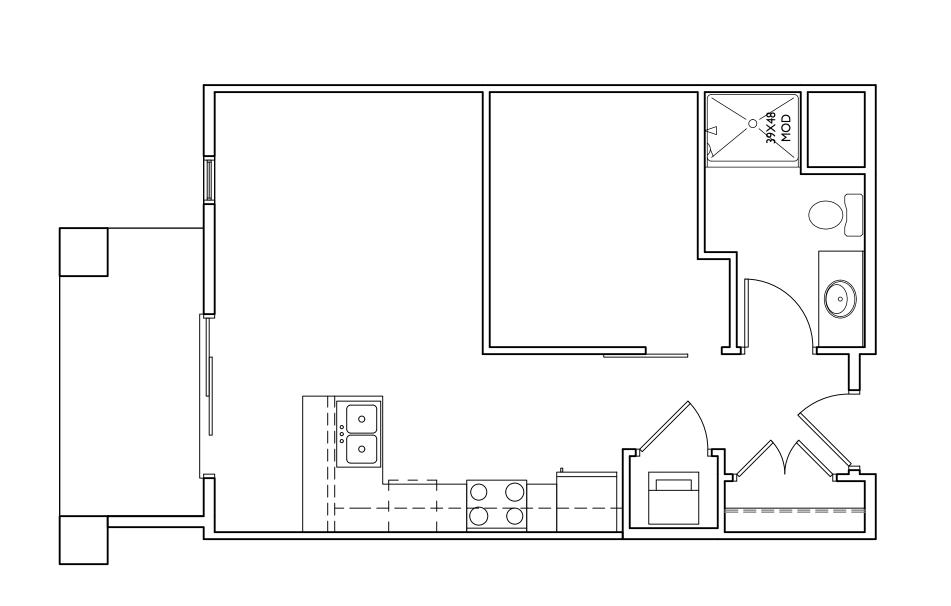

STUDIO

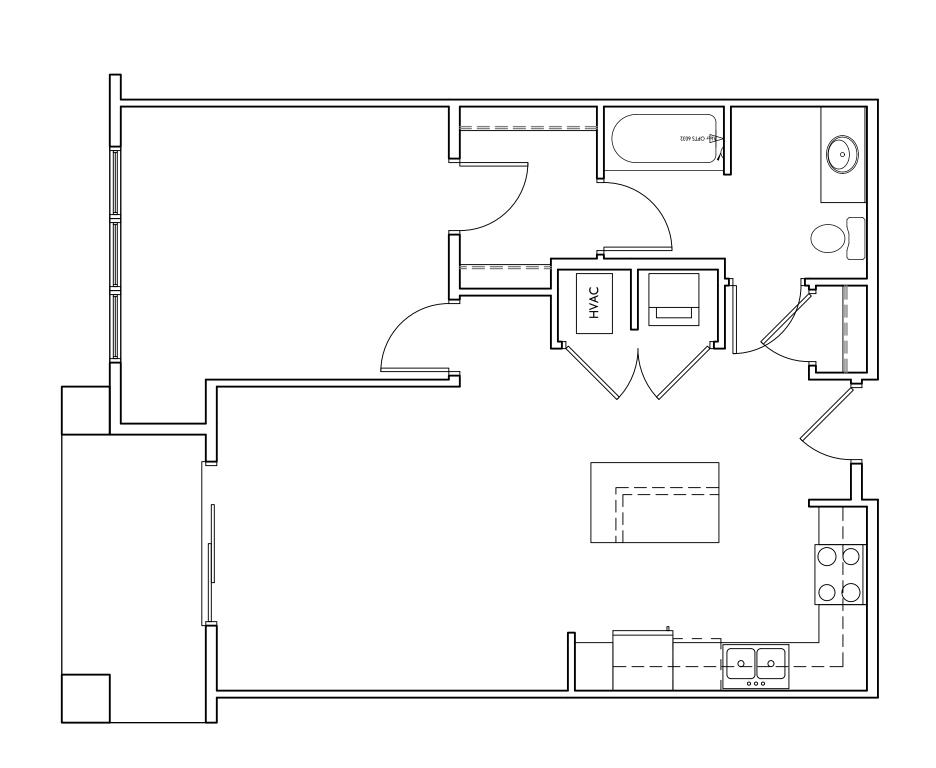

ONE BEDROOM

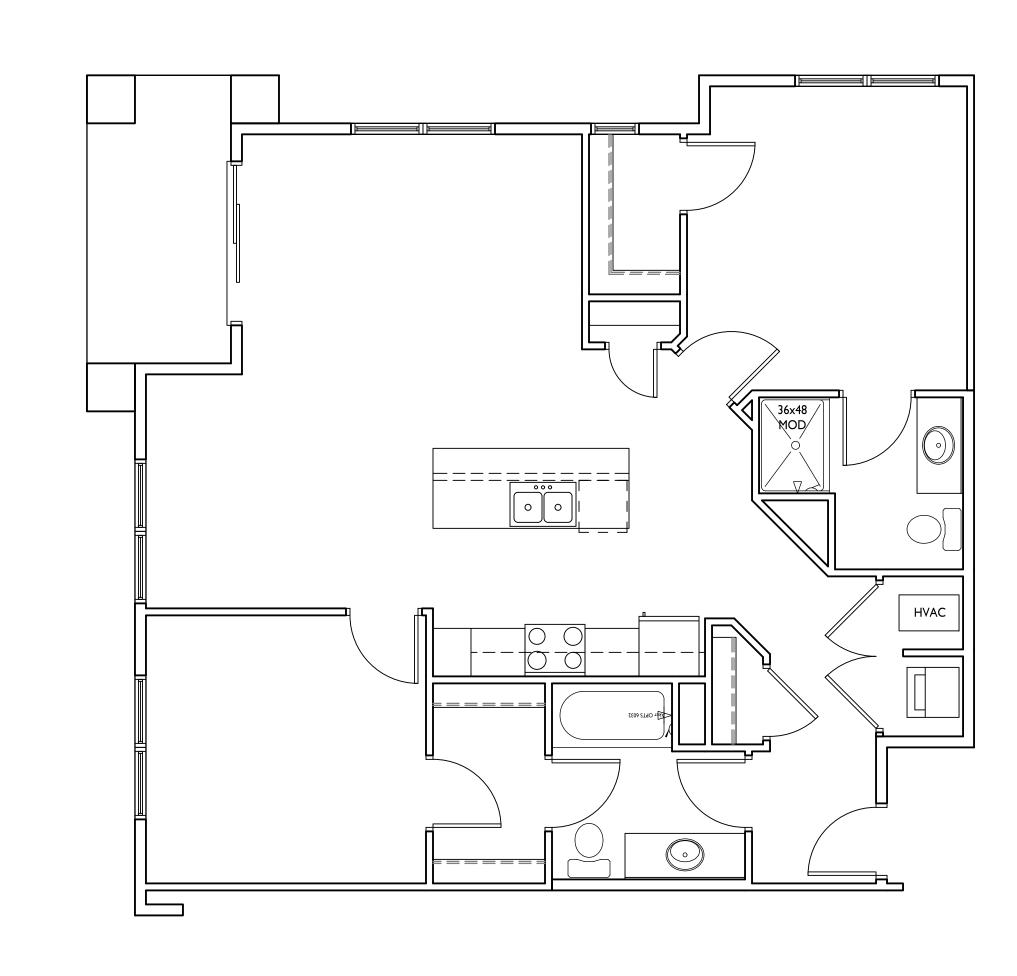

ISSUED
Issued for Land Use & UDC Submittal: 11/20/2019

PROJECT TITLE
FLAD - SEGOE

TWO BEDROOM

Site Address:
4510 Regent St & 4513
Vernon Blvd.
SHEET TITLE
Typical Unit Plans

SHEET NUMBER

A-5.1

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PROJECT NO.

TYPICAL UNIT PLANS

1/4" = 1'-0"