URBAN DESIGN COMMISSION APPLICATION





P	ity of Madison lanning Division Madison Municipal Building, Suite 017	FOR OFFICE USE ONLY:		
2	15 Martin Luther King, Jr. Blvd. O. Box 2985	Paid Receipt # Date received		
١	Madison, WI 53701-2985			
(508) 266-4635	Received by		
		Aldermanic District		
	omplete all sections of this application, including	Zoning District		
	ne desired meeting date and the action requested.	Urban Design District		
	you need an interpreter, translator, materials in alternate	Submittal reviewed by		
	rmats or other accommodations to access these forms, ease call the phone number above immediately.	Legistar #		
	roject Information ddress: 3840 Maple Grove Drive			
T	tle: FRED - Maple Grove Residential			
	pplication Type (check all that apply) and Requested DC meeting date requested			
✓	New development	ing or previously-approved development		
✓	Informational 🔲 Initial approval	☐ Final approval		
3. Pı	oject Type			
	Project in an Urhan Design District	Signago		

3. Project Type

Telephone

	Project in an Urban Design District	Sigi	nage
	Project in the Downtown Core District (DC), Urban		Comprehensive Design Review (CDR)
	Mixed-Use District (UMX), or Mixed-Use Center District (MXC)		Signage Variance (i.e. modification of signage height,
	Project in the Suburban Employment Center District (SEC), Campus Institutional District (CI), or Employment Campus District (EC)		area, and setback)
			ner
	Planned Development (PD)		Please specify
	☐ General Development Plan (GDP)		
	Specific Implementation Plan (SIP)		

4. Applicant, Agent, and Property Owner Information

☐ Planned Multi-Use Site or Residential Building Complex

Applicant, Agent, a	nd Property Owner Information	
Applicant name	Paul Schmitter	Company Fiduciary Real Estate Development
Street address	789 N. Water Street	City/State/Zip Milwaukee, Wi 53202
Telephone	414-442-3867	Email pschmitter@fred-inc.com
Project contact pers	on Marc Ott	Company JLA aRCHITECTS
Street address	800 W. Broadway, Suite 200	City/State/Zip Monona, Wi 53713
Telephone	608-442-3687	Email mott@jla-ap.com
Property owner (if n	not applicant) Schmitt Family Trust et. al. c	o Thomas Schmitt
Street address	113 S. Main Street	City/State/Zip Verona, Wi 53593

Email

608-845-7489

5. F	Required Submittal Materials	
✓	☑ Application Form	
✓	☑ Letter of Intent	Each submittal must include
	 If the project is within an Urban Design District development proposal addresses the district crit 	eria is required paper copies. Landscape and
	 For signage applications, a summary of how the tent with the applicable CDR or Signage Variance 	review criteria is required. must be <u>full-sized and legible</u> .
✓	Development plans (Refer to checklist on Page 4 fo	r plan details) Please refrain from using plastic covers or spiral binding.
✓	☑ Filing fee	J plastic covers of spiral billuling.
✓	☑ Electronic Submittal*	
B	Both the paper copies and electronic copies <u>must</u> be subricheduled for a UDC meeting. Late materials will not be accep	mitted prior to the application deadline before an application will be ted. A completed application form is required for each UDC appearance
Fo	or projects also requiring Plan Commission approval, applicar consideration prior to obtaining any formal action (initial or fi	its must also have submitted an accepted application for Plan Commission nal approval) from the UDC. All plans must be legible when reduced.
co pi no	compiled on a CD or flash drive, or submitted via email t project address, project name, and applicant name. Elect	re required. Individual PDF files of each item submitted should be o udcapplications@cityofmadison.com. The email must include the ronic submittals via file hosting services (such as Dropbox.com) are aterials electronically should contact the Planning Division at (608)
6. A	Applicant Declarations	
1.	Prior to submitting this application, the applicant Commission staff. This application was discussed November 14, 2019	is required to discuss the proposed project with Urban Design with Janine Glaeser or
2.	. The applicant attests that all required materials are inclining is not provided by the application deadline, the application.	uded in this submittal and understands that if any required information cation will not be placed on an Urban Design Commission agenda for
Nam	ne of applicant Pauli Schmitter	Relationship to property Contract Buyer
		Actionship to property
Auth	norizing signature of property owner <u>Faul</u>) Date 12-18-2019
7. Ap	pplication Filing Fees	
Of Co	f the combined application process involving the Urban	either initial or final approval of a project, unless the project is part Design Commission in conjunction with Plan Commission and/or City Treasurer. Credit cards may be used for application fees of less
Ple	lease consult the schedule below for the appropriate fee	e for your request:
	Urban Design Districts: \$350 (per §35.24(6) MGO).	A CI: C - :
		A filing fee is not required for the following project applications if part of the combined application process involving both Urban Design Commission and Plan Commission:
	Comprehensive Design Review: \$500 (per §31.041(3)(d)(1)(a) MGO)	 Project in the Downtown Core District (DC), Urban Mixed-Use District (UMX), or Mixed-Use Center District (MXC)
	Minor Alteration to a Comprehensive Sign Plan: \$100 (per §31.041(3)(d)(1)(c) MGO)	
	All other sign requests to the Urban Desig Commission, including, but not limited to: appeal	n Employment Campus District (EC)

from the decisions of the Zoning Administrator,

requests for signage variances (i.e. modifications of

signage height, area, and setback), and additional sign

code approvals: \$300 (per §31.041(3)(d)(2) MGO)

Planned Development (PD): General Development

Plan (GDP) and/or Specific Implementation Plan (SIP)

Planned Multi-Use Site or Residential Building

Complex

URBAN DESIGN COMMISSION APPROVAL PROCESS



Introduction

The City of Madison's Urban Design Commission (UDC) has been created to:

- Encourage and promote high quality in the design of new buildings, developments, remodeling, and additions so as to maintain and improve the established standards of property values within the City.
- Foster civic pride in the beauty and nobler assets of the City, and in all other ways possible assure a functionally efficient and visually attractive City in the future.

Types of Approvals

There are three types of requests considered by the UDC:

- <u>Informational Presentation</u>. Applicants may, at their discretion, request to make an Informational Presentation to the UDC prior to seeking any approvals to obtain early feedback and direction before undertaking detailed design. Applicants should provide details on the context of the site, design concept, site and building plans, and other relevant information to help the UDC understand the proposal and provide feedback. (Does not apply to CDR's or Signage Variance requests)
- <u>Initial Approval</u>. Applicants may, at their discretion, request initial approval of a proposal by presenting preliminary design information. As part of their review, the Commission will provide feedback on the design information that should be addressed at Final Approval stage.
- <u>Final Approval</u>. Applicants may request Final Approval of a proposal by presenting all final project details. Recommendations or concerns expressed by the UDC in the initial approval must be addressed at this time.

Presentations to the Commission

Primarily, the UDC is interested in the appearance and design quality of projects. Emphasis should be given to the site plan, landscape plan, lighting plan, building elevations, exterior building materials, color scheme, and graphics.

When presenting projects to the UDC, applicants must fill out a registration slip provided in the meeting room and present it to the Secretary. Presentations should generally be limited to 5 minutes or as extended by motion by consent of the Commission. The Commission will withhold questions until the end of the presentation.

Applicants are encouraged to consider the use of various graphic presentation material including a locator map, photographs, renderings/model, scale drawings of the proposal in context with adjacent buildings/uses/signs, etc., as may be deemed appropriate to describe the project and its surroundings. Graphics should be mounted on rigid boards so that they may be easily displayed. Applicants/presenters are responsible for all presentation materials, AV equipment and easels.

URBAN DESIGN DEVELOPMENT PLANS CHECKLIST



The items listed below are minimal application requirements for the type of approval indicated. Please note that the UDC and/or staff may require additional information in order to have a complete understanding of the project.

1. Inform	ational Presentation		
	Locator Map		Requirements for All Plan Sheets
Ø	Letter of Intent (If the project is within an Urban Design District, a summary of how the development proposal addresses the district criteria is required)	Providing additional	 Title block Sheet number North arrow
	Contextual site information, including photographs and layout of adjacent buildings/structures	information beyond these minimums may generate a greater level of feedback from the Commission.	4. Scale, both written and graphic5. Date6. Fully dimensioned plans, scaled
V	Site Plan		at 1"= 40' or larger
✓	Two-dimensional (2D) images of proposed buildings or structures.		** All plans must be legible, including the full-sized landscape and lighting plans (if required)
2. Initial A	pproval		
	Locator Map)
	Letter of Intent (If the project is within a Uthe development proposal addresses the d		ry of <u>how</u>
	Contextual site information, including photo structures	ographs and layout of adjacent b	Providing additional
	Site Plan showing location of existing and lanes, bike parking, and existing trees over	ves, bike information beyond these minimums may generate a greater level of feedback	
	Landscape Plan and Plant List (must be legi	ble)	from the Commission.
	Building Elevations in both black & white material callouts)	and color for all building sides	(include
	PD text and Letter of Intent (if applicable)		
3. Final Ap	proval		
All the r	equirements of the Initial Approval (see abov	ve), plus :	
	Grading Plan		
	Proposed Signage (if applicable)		
	Lighting Plan, including fixture cut sheets a	nd photometrics plan (<i>must be l</i>	legible)
	Utility/HVAC equipment location and scree	ning details (with a rooftop plan	if roof-mounted)
	PD text and Letter of Intent (if applicable)		
	Samples of the exterior building materials (presented at the UDC meeting)	
4. Comprel	nensive Design Review (CDR) and Variance	e Requests (<u>Signage applicatio</u>	ons only)
	Locator Map		
	Letter of Intent (a summary of how the propose	ed signage is consistent with the C	DR or Signage Variance criteria is required)
	Contextual site information, including pho project site		
	Site Plan showing the location of existing sig	gnage and proposed signage, dir	mensioned signage setbacks, sidewalks,

☐ Proposed signage graphics (fully dimensioned, scaled drawings, including materials and colors, and night view)

☐ Illustration of the proposed signage that meets Ch. 31, MGO compared to what is being requested.

☐ Perspective renderings (emphasis on pedestrian/automobile scale viewsheds)


☐ Graphic of the proposed signage as it relates to what the Ch. 31, MGO would permit

driveways, and right-of-ways

MAPLE GROVE DRIVE RESIDENTIAL



MADISON, WISCONSIN

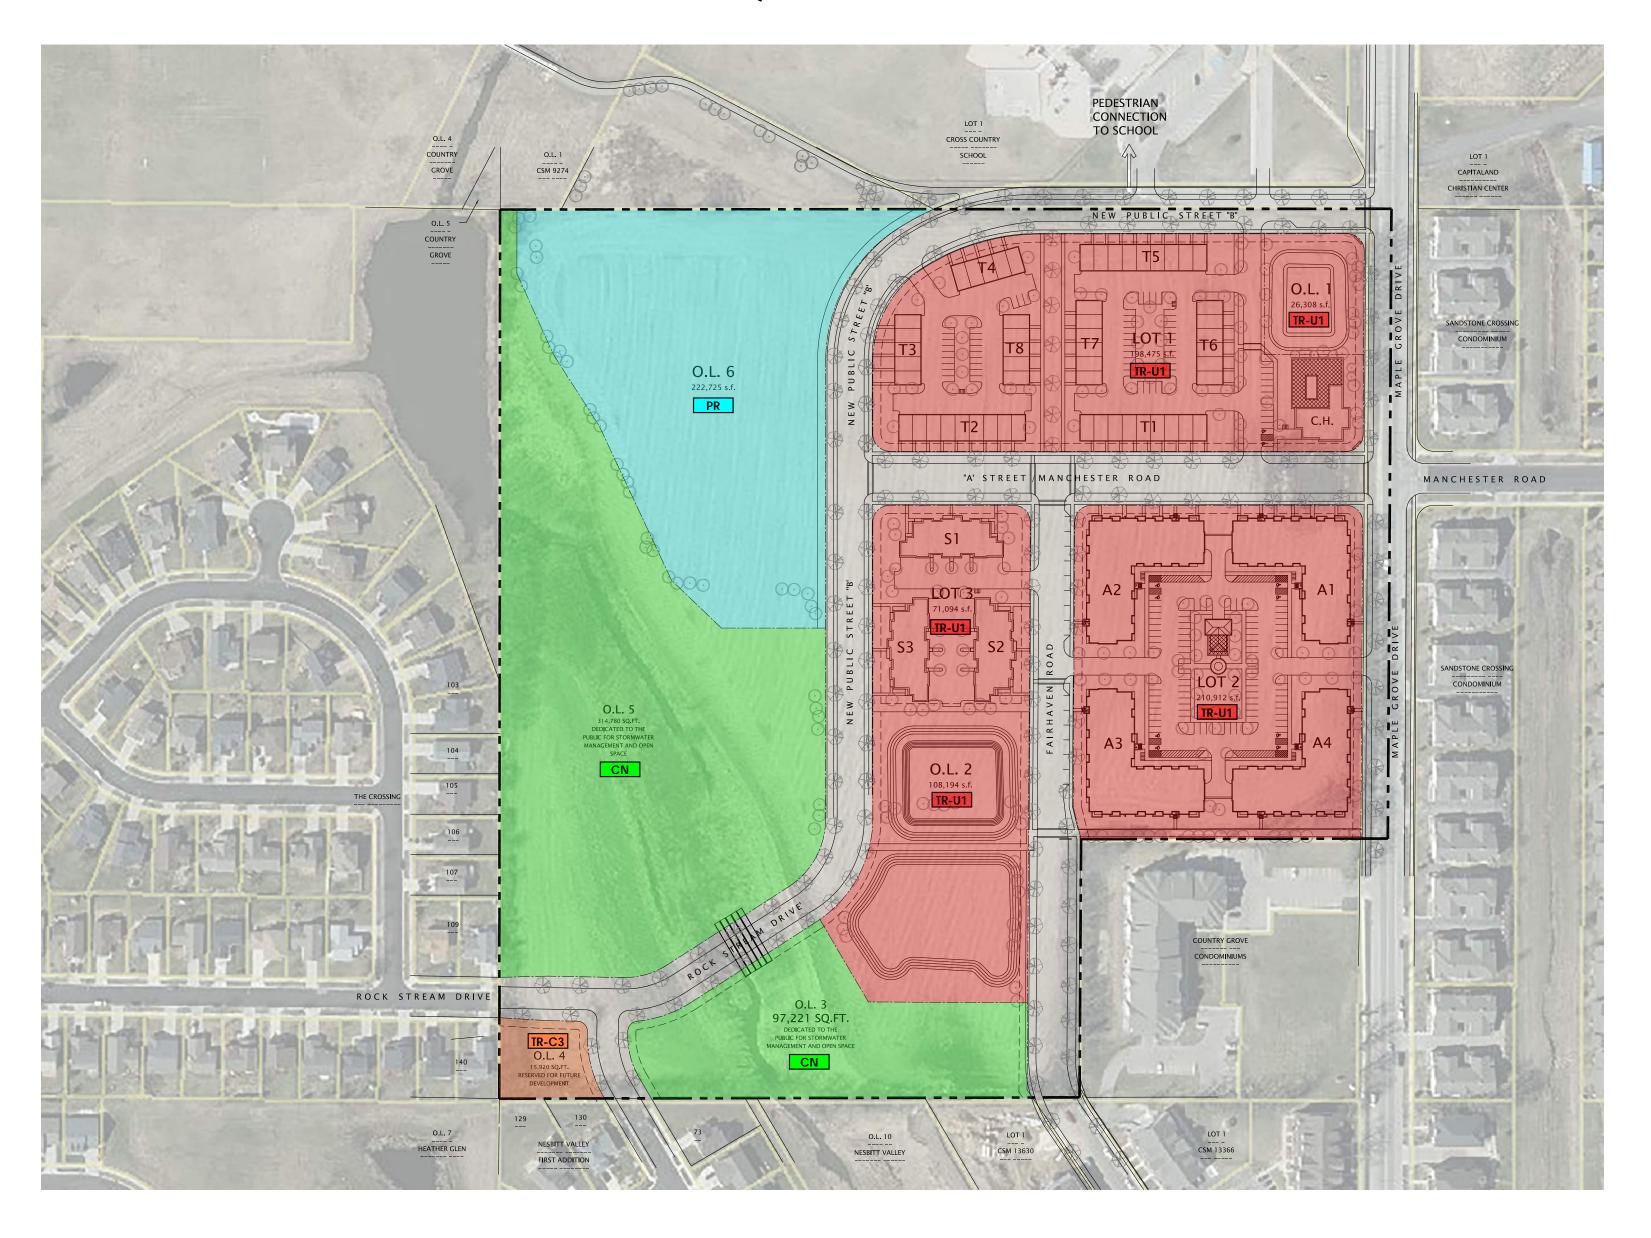


LAND USE APPLICATION SUBMITTAL






ABBREVIATIONS

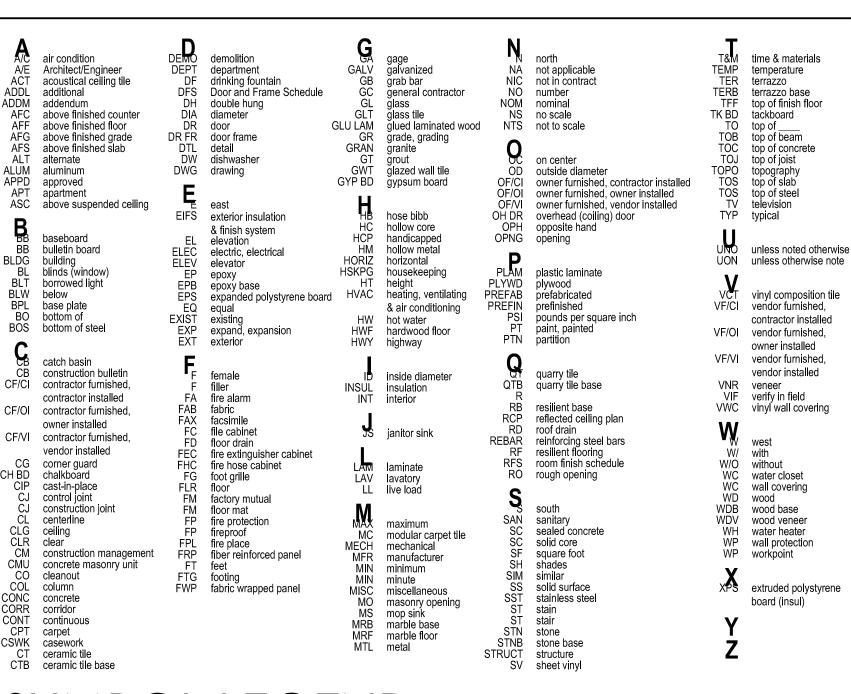

SYMBOL LEGEND

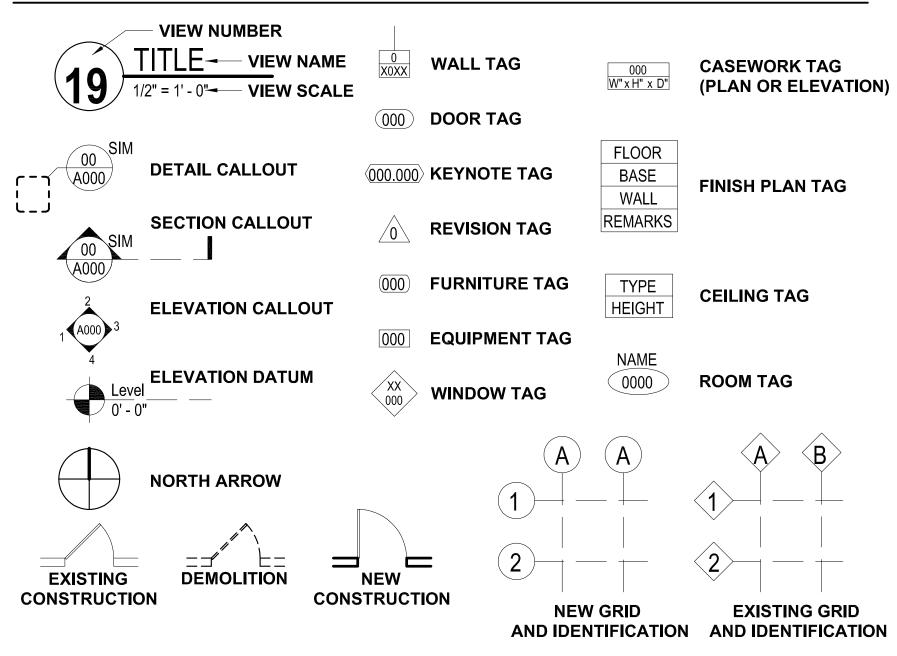

PROJECT ADDRESS

MAPLE GROVE DRIVE RESIDENTIAL MADISON, WISCONSIN


OWNER INFORMATION

FIDUCIARY REAL ESTATE DEVELOPMENT, INC.

789 NORTH WATER STREET - SUITE 200 MILWAUKEE, WISCONSIN 53202 CONTACT: MR. CRAIG RADDATZ CRADDATZ@FRED-INC.COMP 414.226.4535

PROJECT TEAM

ARCHITECTURAL

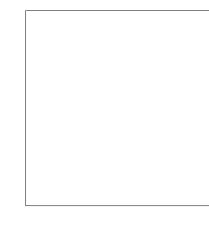

JLA ARCHITECTS & PLANNERS

2418 CROSSROADS DRIVE - SUITE 2300 MADISON, WISCONSIN 53718 CONTACT: MR. MARC OTT MOTT@JLA-AP.COM OFFICE: 608.241.9500 DIRECT: 608.442.3867

CIVIL ENGINEERING



7530 WESTWARD WAY
MADISON, WISCONSIN 53717
CONTACT: MR. BRUCE HOLLAR
BHOLLAR@DONOFRIO.CC
608.833.7530

VICINITY MAP



EXTENTS OF DEVELOPMENT

CH-A202 EXTERIOR PERSPECTIVES

SHEET INDEX

G000 G001	COVER INDEX
C-001 C-100 C-101 C-102 C-201 C-202 C-301 C-302 C-500	EXISTING CONDITIONS SITE PLAN SITE PLAN SITE PLAN GRADING PLAN GRADING PLAN UTILITY PLAN UTILITY PLAN FIRE ACCESS PLAN
P-1.0	SITE LIGHTING PHOTOMETRIC
L-1.0 L-1.1 L-1.2 L-1.3 L-1.4 L-1.5 L-1.6 L-1.7 L-1.8 L-1.9 L-1.10	OVERALL LANDSCAPE PLAN OVERALL EXISTING TREE INVENTORY OVERALL LANDSCAPE PLAN: LOT 1 FOUNDATION LANDSCAPE PLAN: CLUBHOUSE & TOWNHOMES ENLARGED LANDSCAPE FOUNDATION PLANS: LOT 1 OVERALL LANDSCAPE PLAN: LOT 2 ENLARGED APARTMENT FOUNDATION LANDSCAPE PLAN: OPTION A ENLARGED APARTMENT FOUNDATION LANDSCAPE PLAN: OPTION B OVERALL LANDSCAPE PLAN: LOT 3 ENLARGED LANDSCAPE FOUNDATION PLANS: OPTION A & B OVERALL LANDSCAPE PLAN: OUTLOT 1 & 2
T-A101 T-A102 T-A200 T-A201 T-A202	FLOOR PLANS FLOOR PLANS EXTERIOR ELEVATIONS EXTERIOR ELEVATIONS EXTERIOR PERSPECTIVES
A-A100 A-A101 A-A102 A-A103 A-A104 A-A200 A-A201 A-A202	FIRST FLOOR PLAN SECOND FLOOR PLAN THIRD FLOOR PLAN ROOF PLAN EXTERIOR ELEVATIONS EXTERIOR ELEVATIONS
S-A101 S-A102 S-A103 S-A200 S-A201 S-A202	FIRST FLOOR PLAN SECOND FLOOR PLAN ROOF PLAN EXTERIOR ELEVATIONS EXTERIOR ELEVATIONS EXTERIOR PERSPECTIVES
CH-A200 CH-A201	FIRST FLOOR PLANS EXTERIOR ELEVATIONS EXTERIOR PERSPECTIVES



ARCHITECTS

MADISON: MILWAUKEE jla-ap.com

JLA PROJECT NUMBER:17-1018



MAPLE GROVE DRIVE RESIDENTIAL

LAND USE SUBMITTAL

PROGRESS DOCUMENTS

These documents reflect progress and intent and may be subject to change, including additional detail. These are not final construction documents and should not be used for final bidding or construction-related purposes.

DATE OF ISSUANCE DECEMBER 18, 2019

REVISION SCHEDULE


RK DESCRIPTION

SHEET TITLE

INDEX SHEET

SHEET NUMBER

G001

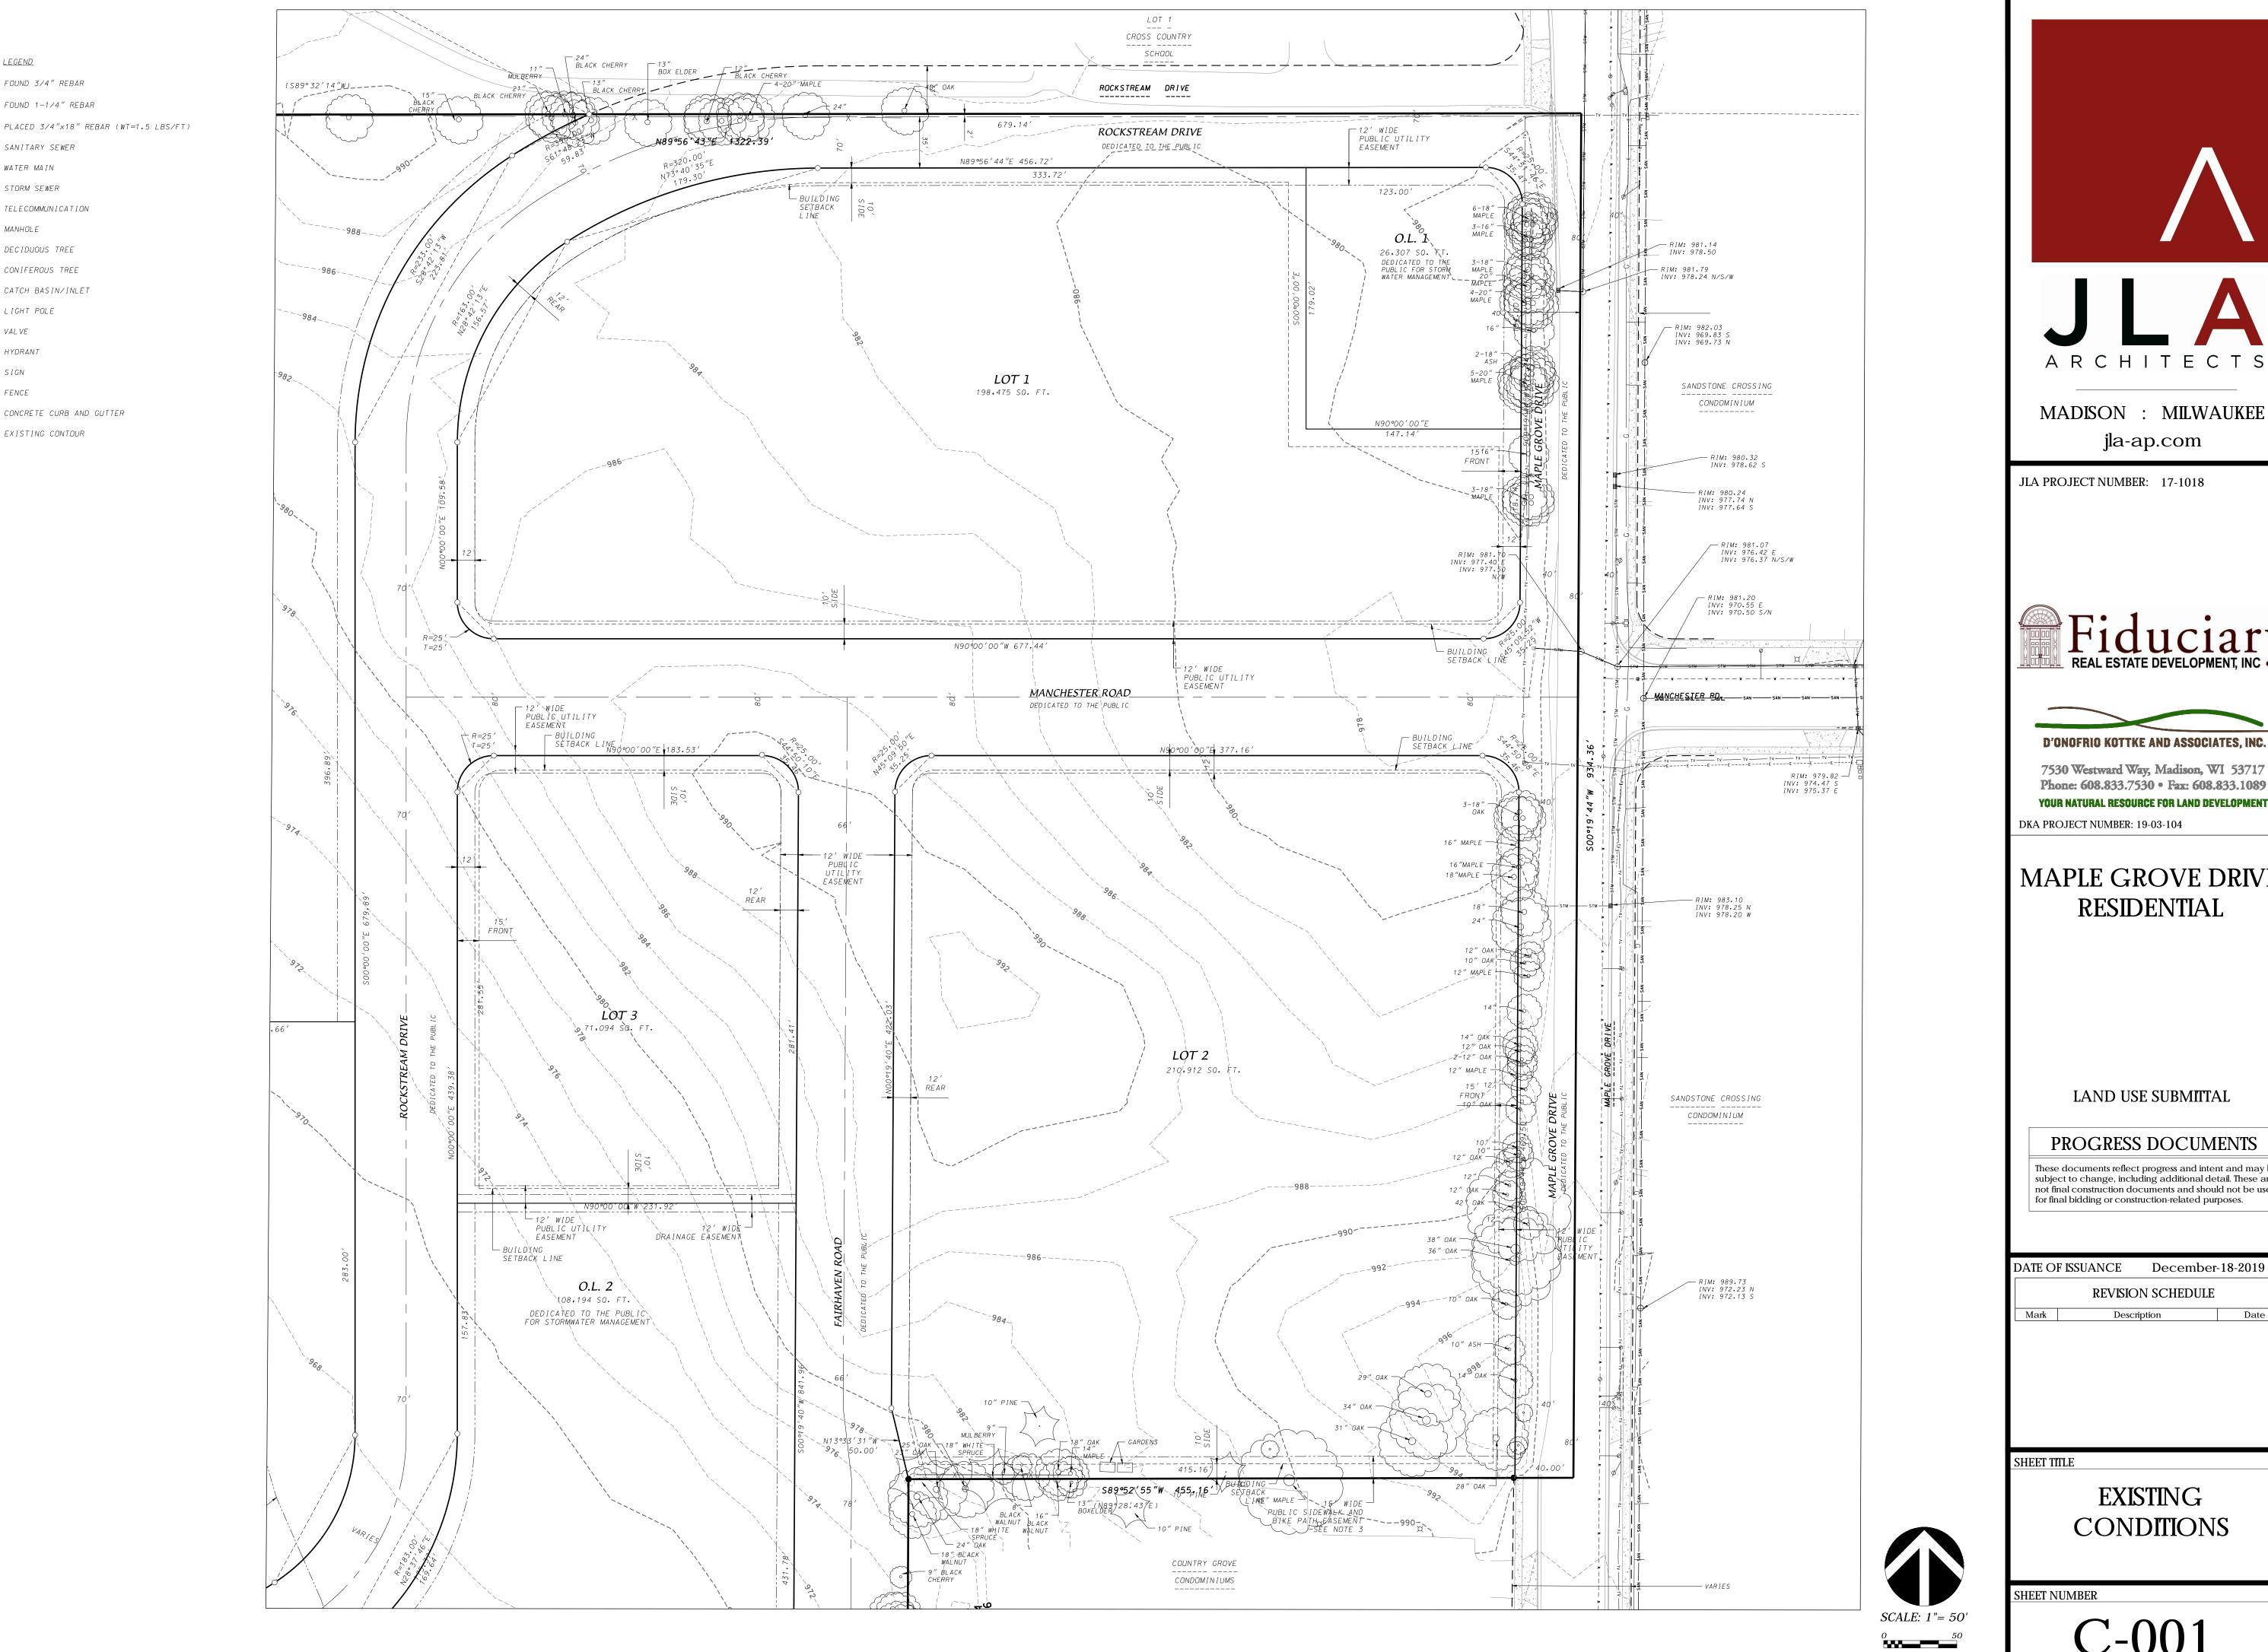

<u>LEGEND</u>

MANHOLE

DECIDUOUS TREE

CONIFEROUS TREE

CATCH BASIN/INLET

CONCRETE CURB AND GUTTER

EXISTING CONTOUR

LIGHT POLE

_____ _ _ W ____ WATER MAIN

TV TELECOMMUNICATION

FOUND 3/4" REBAR

FOUND 1-1/4" REBAR



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DKA PROJECT NUMBER: 19-03-104

MAPLE GROVE DRIVE RESIDENTIAL


LAND USE SUBMITTAL

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DATE OF ISSUANCE December-18-2019 REVISION SCHEDULE					
Mark Description Date					

EXISTING CONDITIONS




SITE PLAN INFORMATION BLOCK LOT 1 Existing Lot Area 198,475 sf Building Area 66,381 sf Total Covered Parking Stalls 100 Total Surface Parking Stalls 64 Total Parking Stalls 164 Total Covered Bike Parking Stalls 100 Total Surface Bike Parking Stalls 12 Total Bike Parking Stalls 112

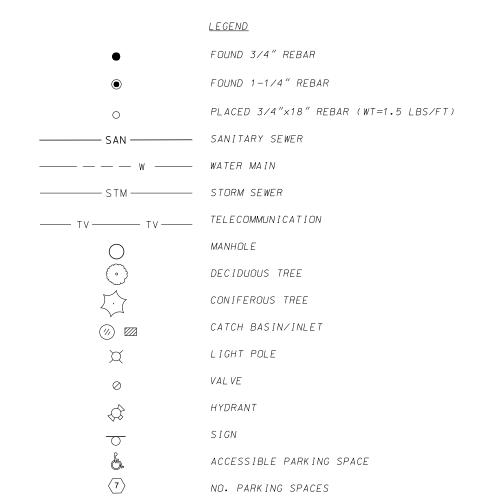FENCE

CONCRETE CURB AND GUTTER

SITE PLAN INFORMATION LOT 2	ON BLOCK
Existing Lot Area	210,912 sf
Building Area	87,280 st
Total Covered Parking Stalls	204
Total Surface Parking Stalls	92
Total Parking Stalls	296
Total Covered Bike Parking Stalls	176
Total Surface Bike Parking Stalls	40
Total Bike Parking Stalls	210

SITE PLAN INFORMATION BL LOT 3	OCK
Existing Lot Area	71,094 sf
Building Area	24,903 sf
Total Covered Parking Stalls	36
Total Surface Parking Stalls	36
Total Guest Parking Stalls	14
Total Parking Stalls	86
Total Covered Bike Parking Stalls	48
Total Surface Bike Parking Stalls	4
Total Bike Parking Stalls	52

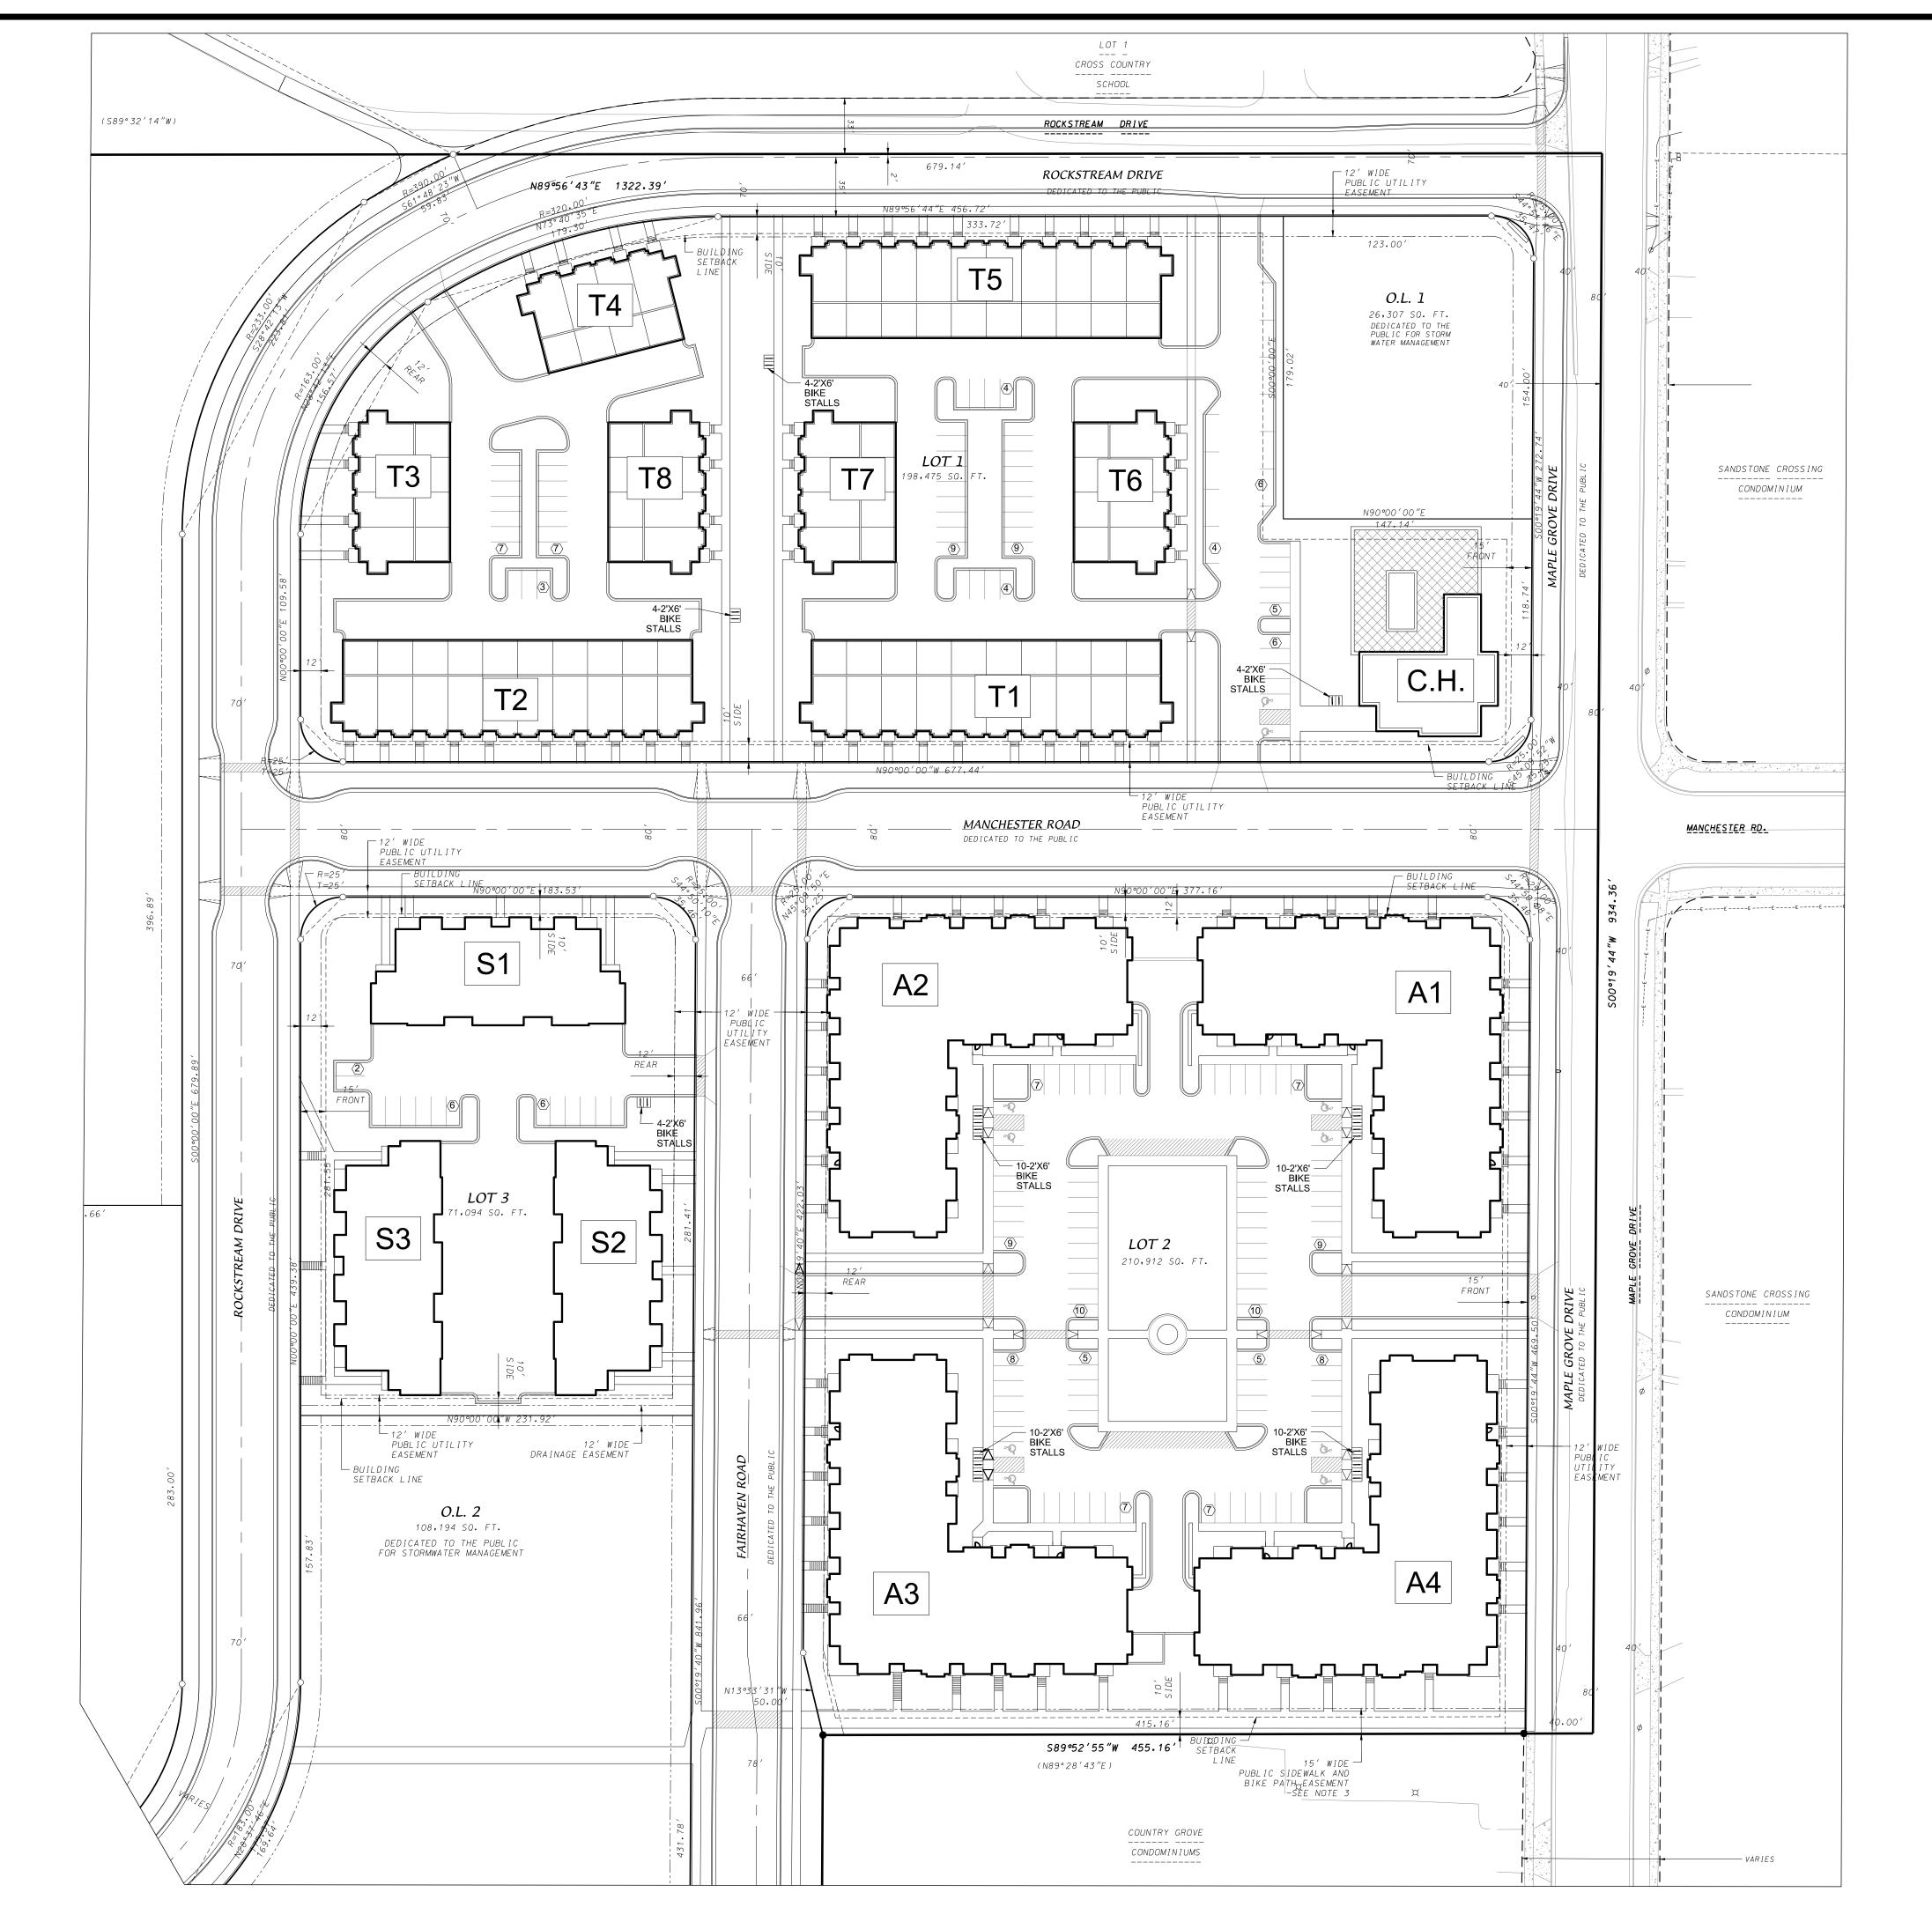



JLA PROJECT NUMBER: 17-1018

MADISON: MILWAUKEE

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D'ONOFRIO KOTTKE AND ASSOCIATES, INC.

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DKA PROJECT NUMBER: 19-03-104

MAPLE GROVE DRIVE RESIDENTIAL

LAND USE SUBMITTAL

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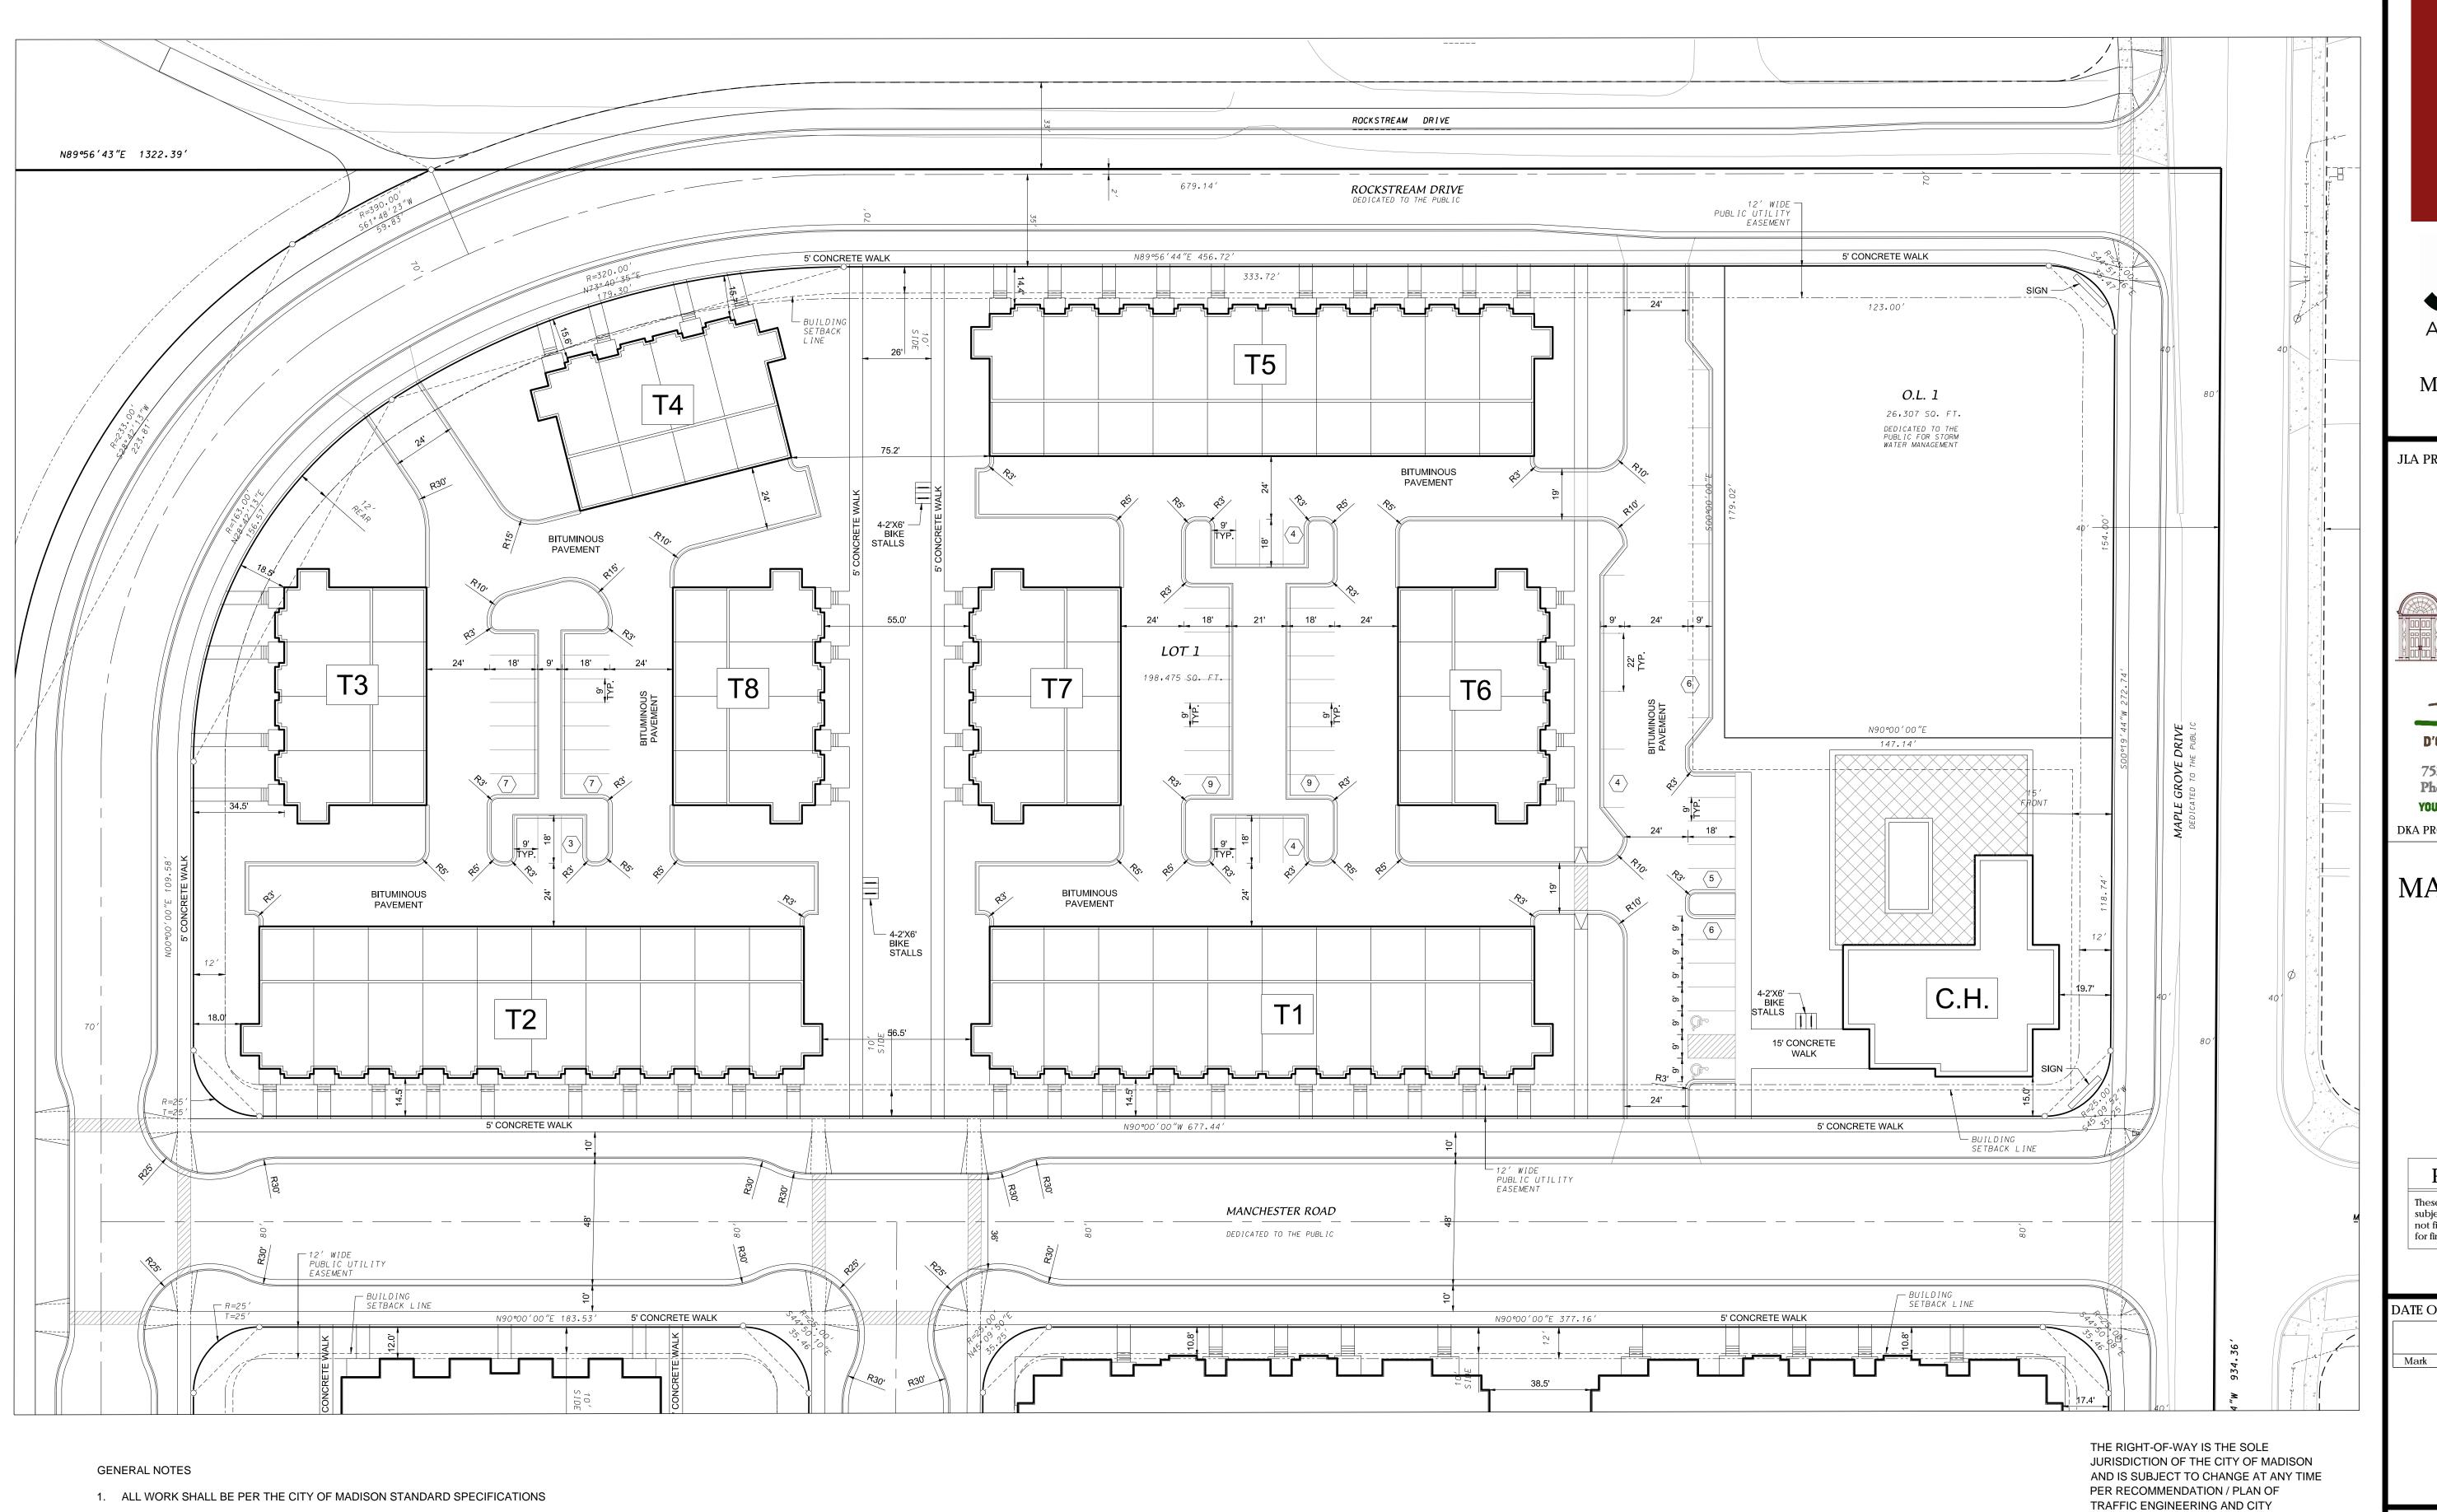
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SHEET TITLE

SITE PLAN


SHEET NUMBER





- 2. CONTRACTOR IS RESPONSIBLE TO OBTAIN ANY AND ALL PERMITS REQUIRED.
- 3. BUILDING CORNERS ARE APPROXIMATE AND FOR GENERAL BUILDING FOOTPRINT ONLY
- 4. IF ANY ERRORS, DISCREPANCIES, OR DIMENSIONS WITH PLAN BECOME APPARENT. IT SHALL BE BROUGHT TO THE ATTENTION OF THE ENGINEER PRIOR TO CONSTRUCTION
- 5. CONTRACTOR SHALL ENSURE THAT ALL STORMWATER DRAINS AWAY FROM BUILDING FOUNDATIONS DURING FINAL RESTORATION
- 6. CURB RADII DIMENSIONS TO FACE OF CURB UNLESS OTHERWISE NOTED
- 7. CONTRACTOR SHALL REPLACE ALL SIDEWALK AND CURB AND GUTTER WHICH ABUTS THE PROPERTY AND IS DAMAGED BY CONSTRUCTION OR ANY SIDEWALK AND CURB AND GUTTER WHICH THE CITY ENGINEER DETERMINES NEEDS TO BE REPLACED BECAUSE IT IS NOT AT A DESIRABLE GRADE.

ENGINEERING DEPARTMENTS.

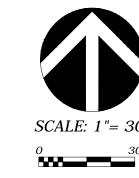



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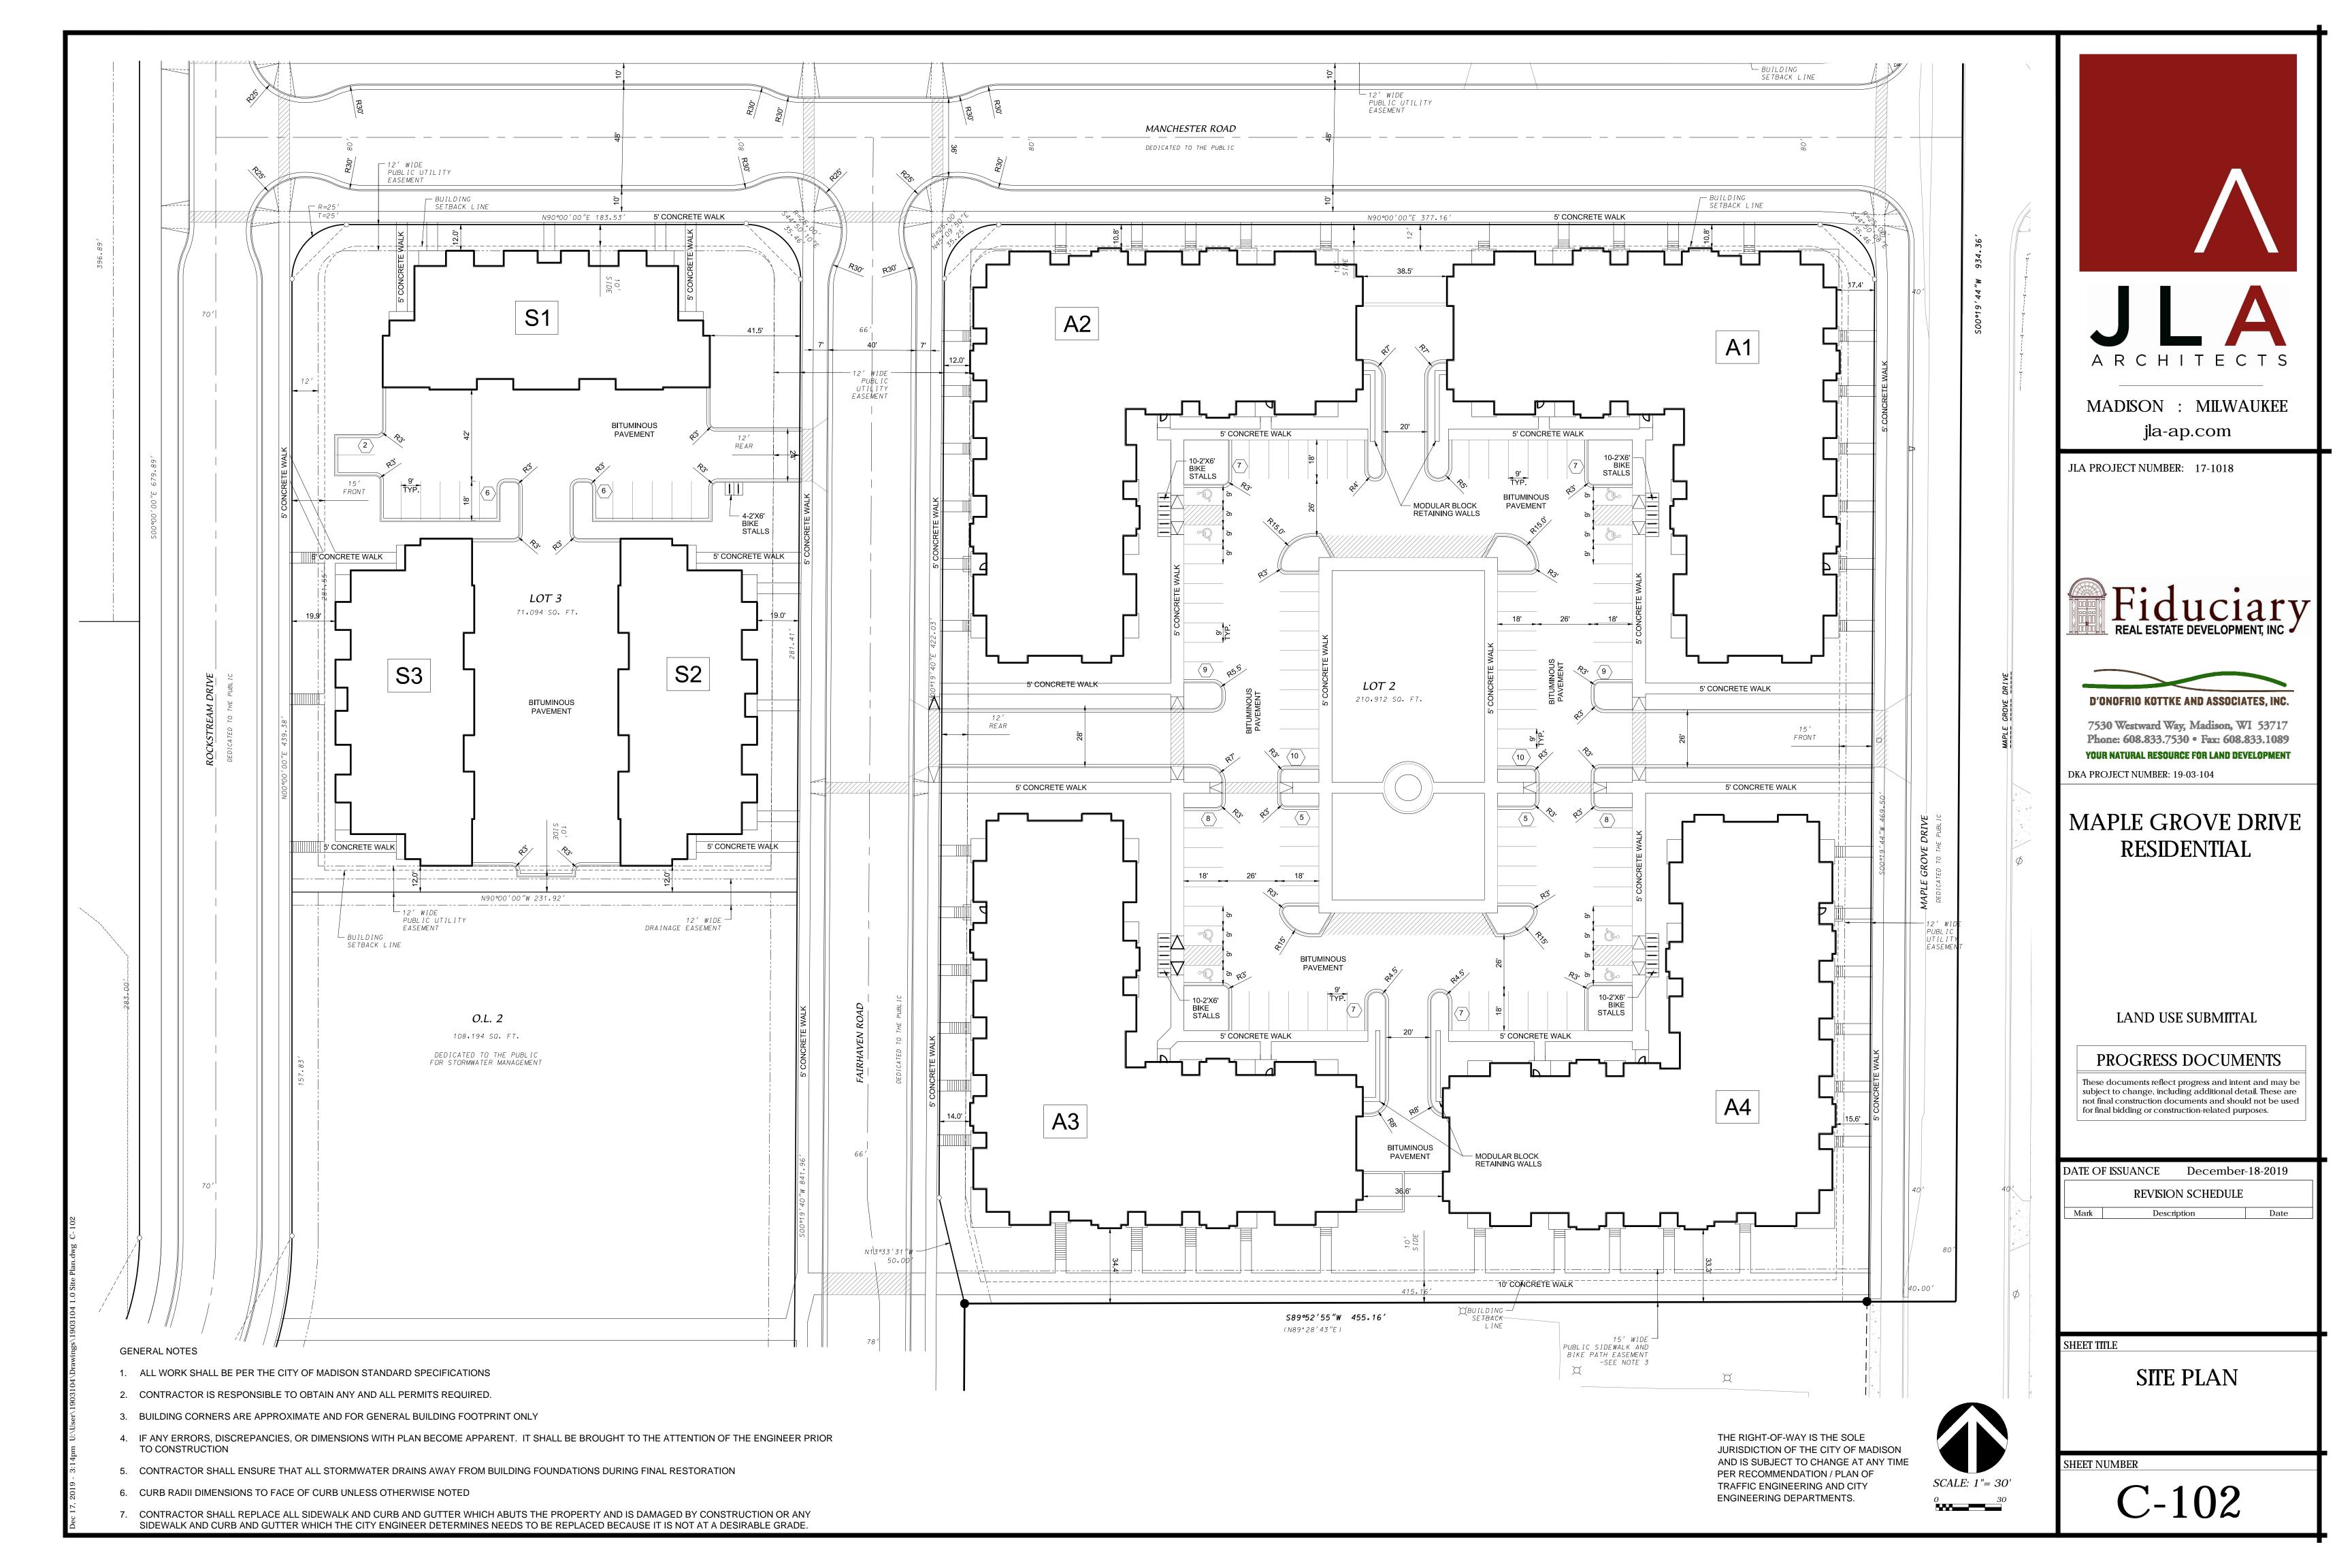
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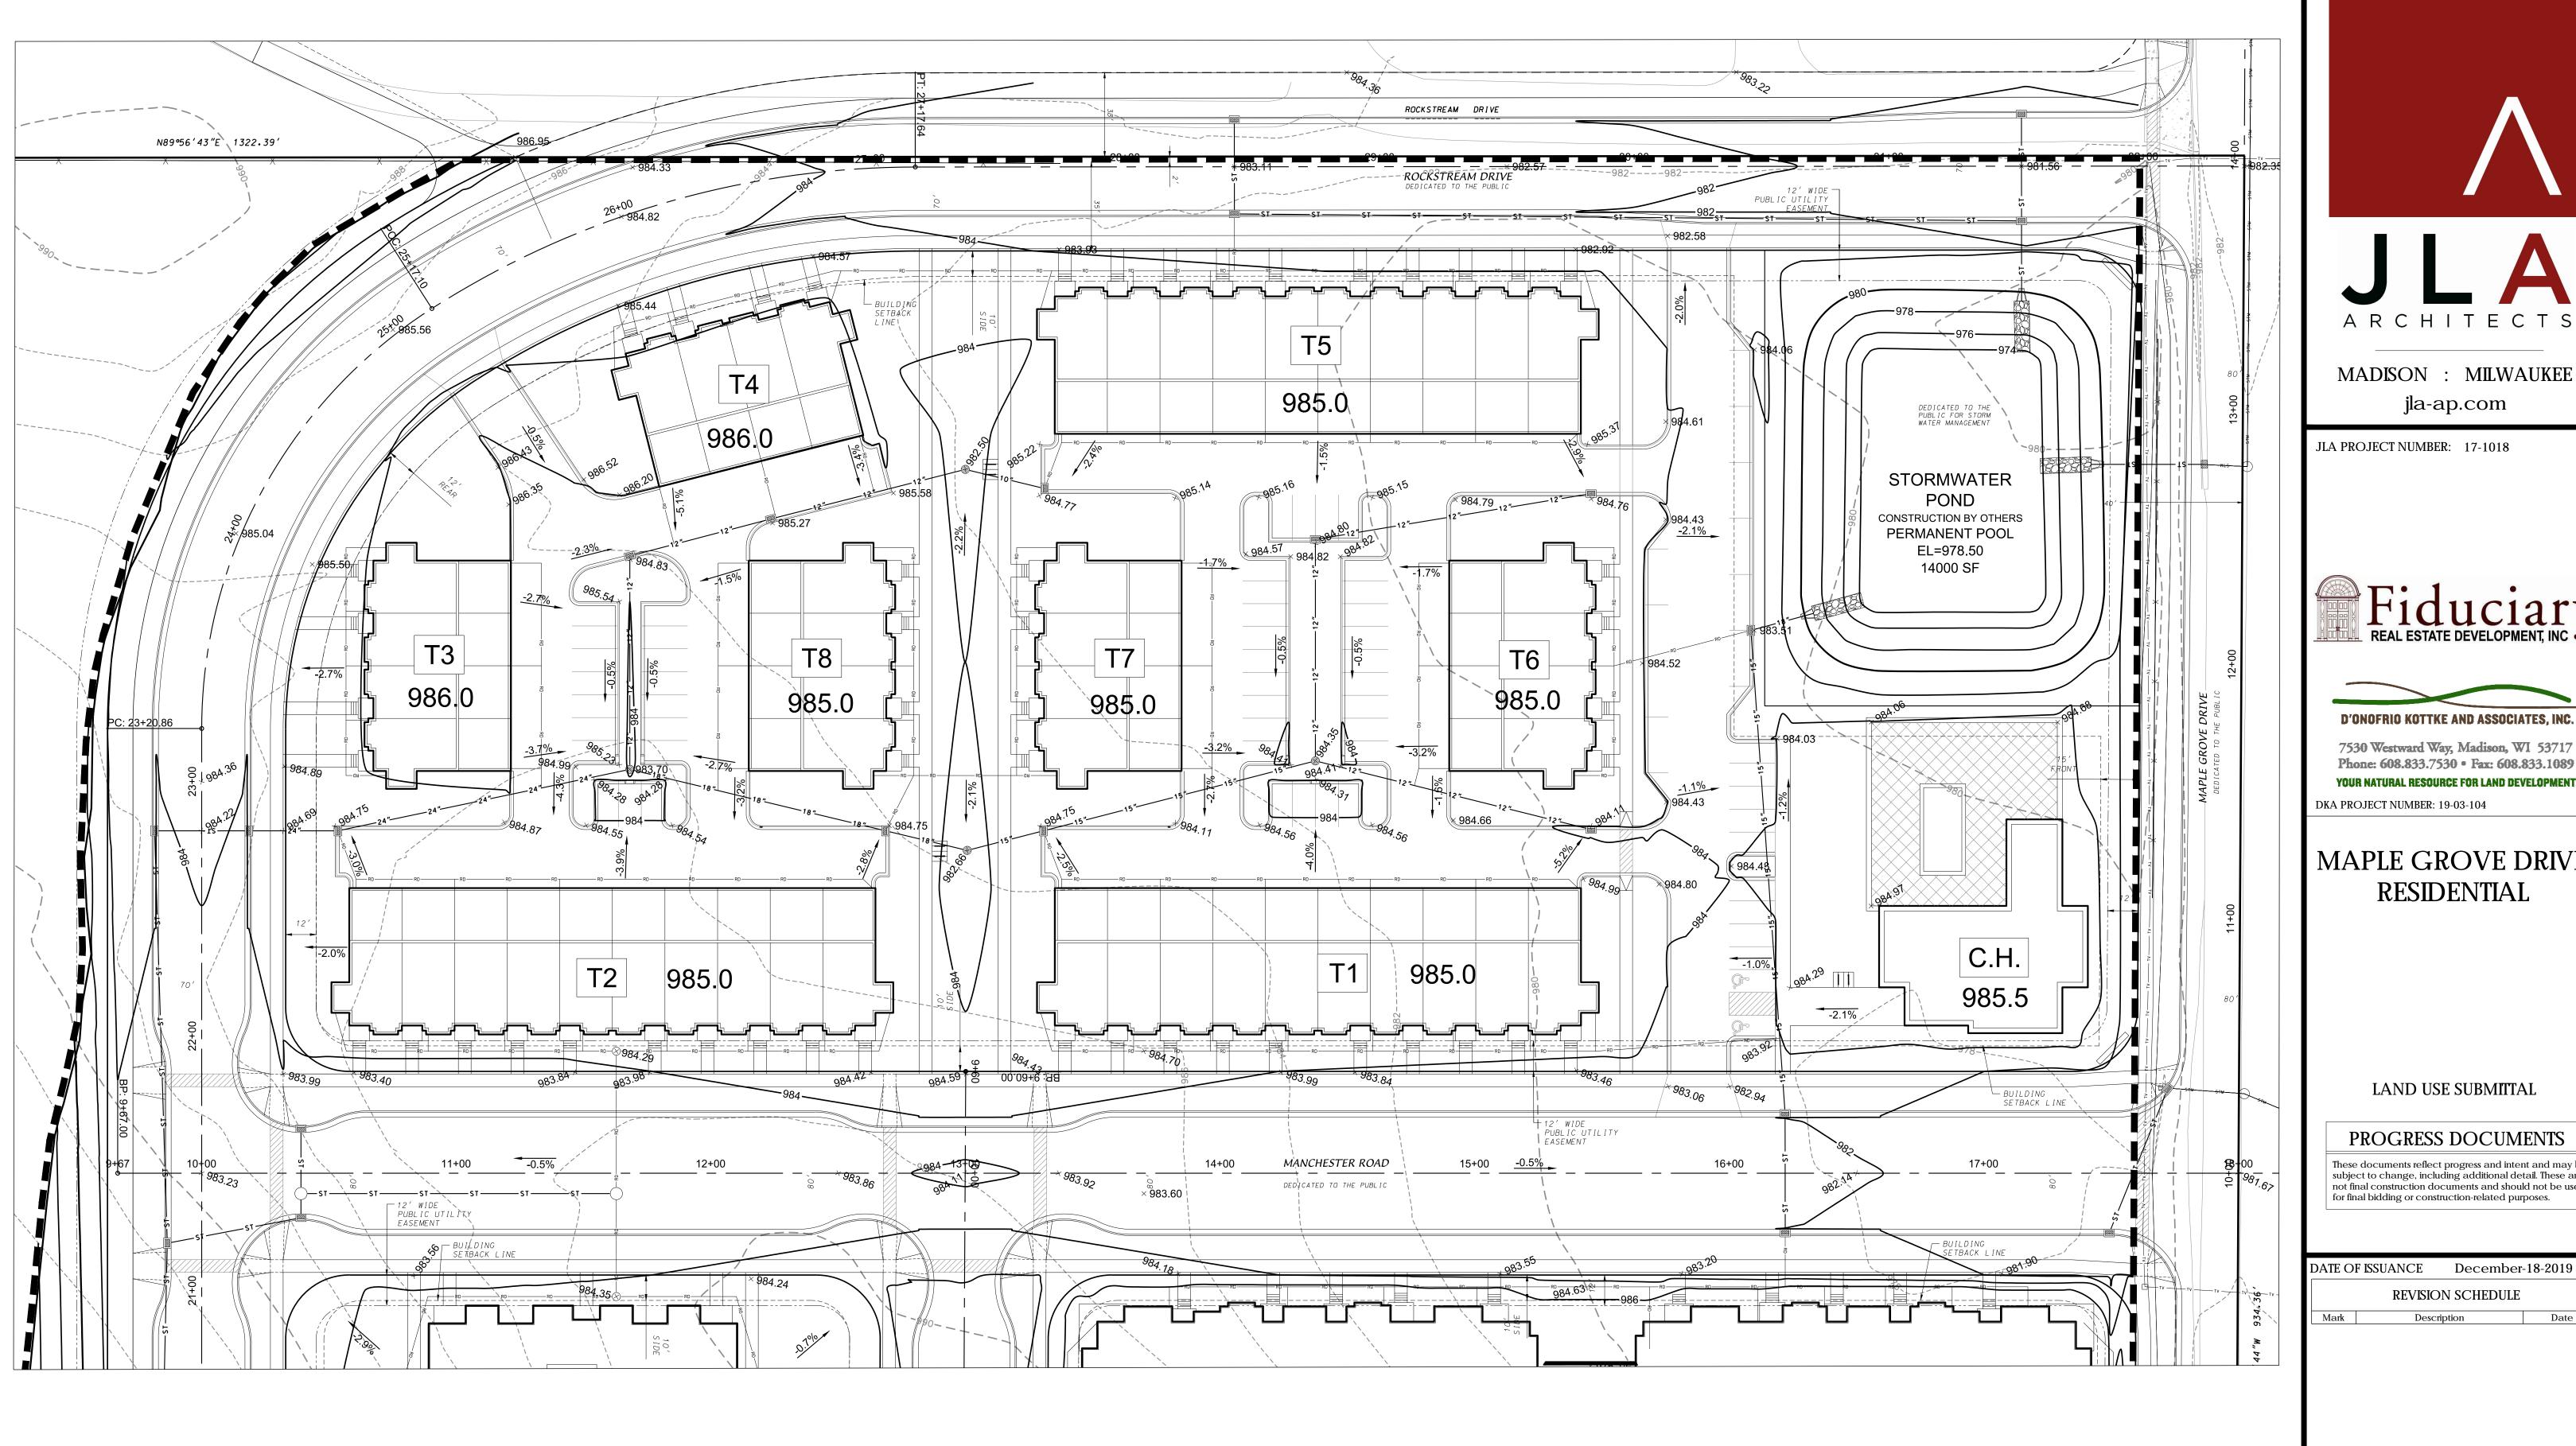
Description

SHEET TITLE

SITE PLAN

SHEET NUMBER





LEGEND



PROPOSED CONTOUR

EXISTING CONTOUR


GRADING LIMITS

GENERAL NOTES

- 1. ALL WORK SHALL BE PER THE CITY OF MADISON STANDARD SPECIFICATIONS
- 2. CONTRACTOR IS RESPONSIBLE TO OBTAIN ANY AND ALL PERMITS REQUIRED.
- 3. IF ANY ERRORS, DISCREPANCIES, OR DIMENSIONS WITH PLAN BECOME APPARENT IT SHALL BE BROUGHT TO THE ATTENTION OF THE ENGINEER PRIOR TO CONSTRUCTION
- 4. CONTRACTOR SHALL ENSURE THAT ALL STORMWATER DRAINS AWAY FROM BUILDING FOUNDATIONS DURING FINAL RESTORATION

GRADING AND EROSION CONTROL NOTES

- 1. NO SITE GRADING OUTSIDE OF THE LIMITS OF DISTURBANCE
- 2. CUT AND FILL SLOPES SHALL BE NO GREATER THAN 3:1
- 3. DEWATERING, IF APPLICABLE, SHALL BE CONDUCTED PER WDNR STORM WATER MANAGEMENT TECHNICAL STANDARD 1061.

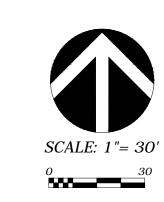



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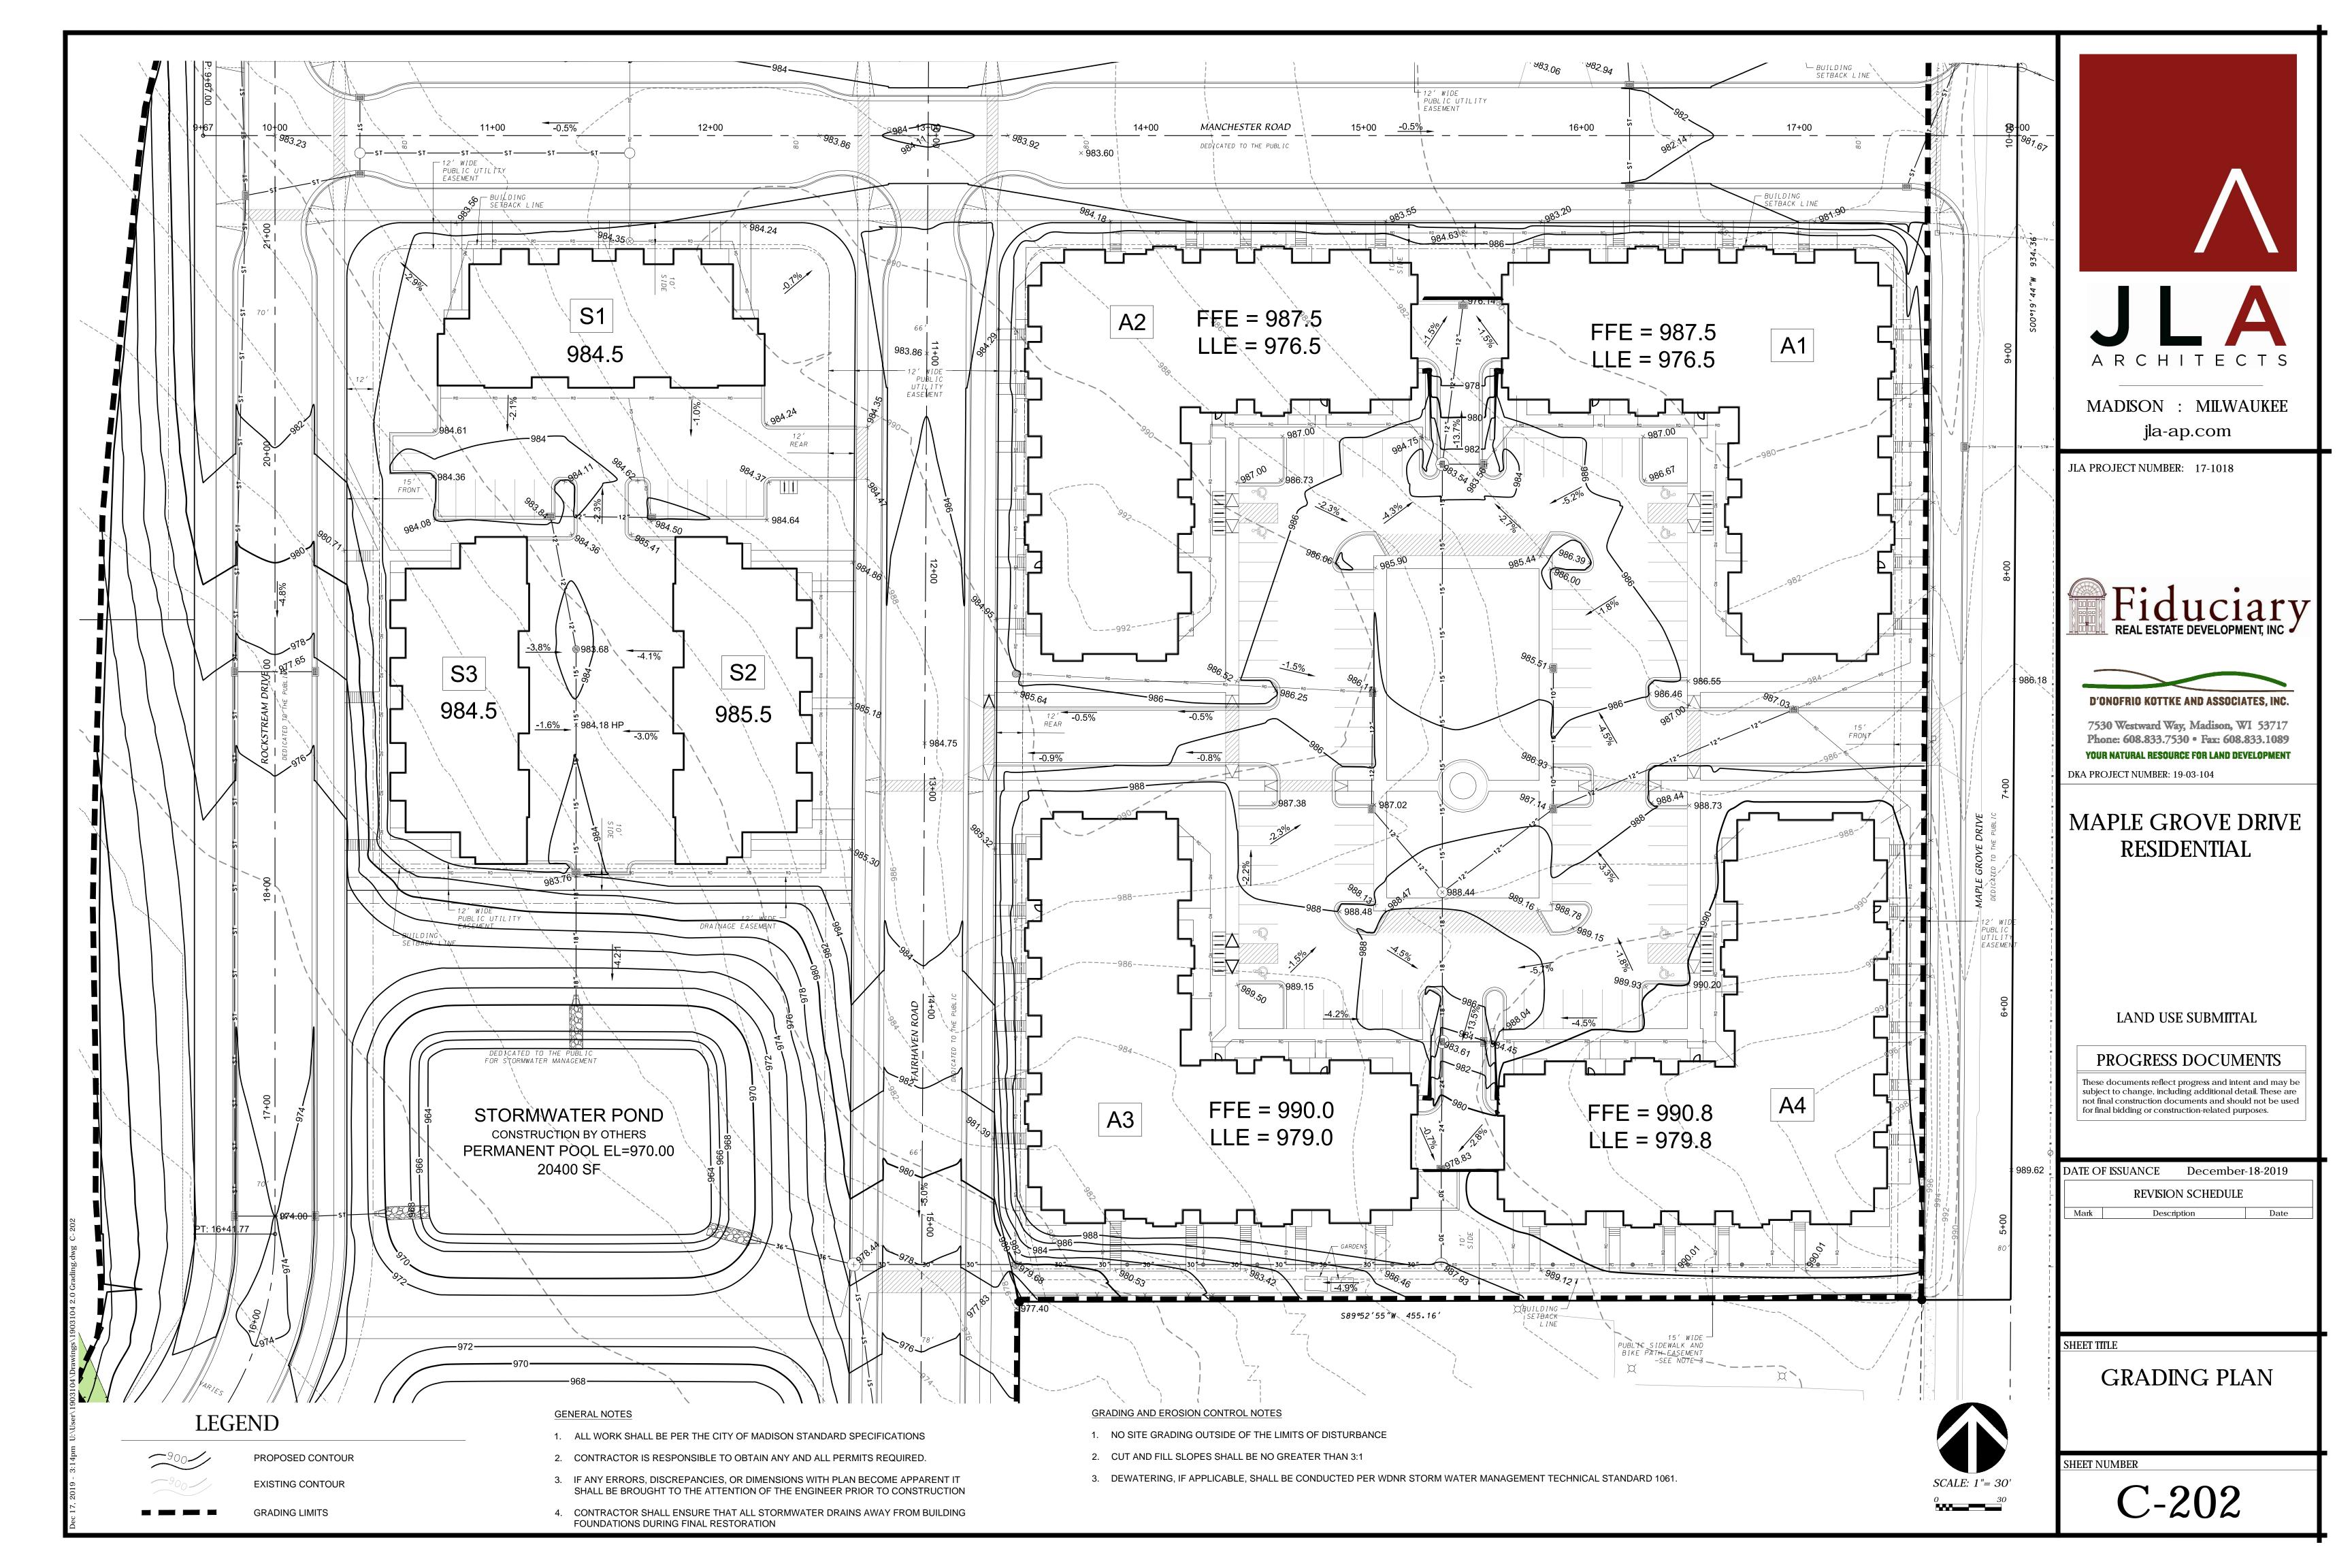
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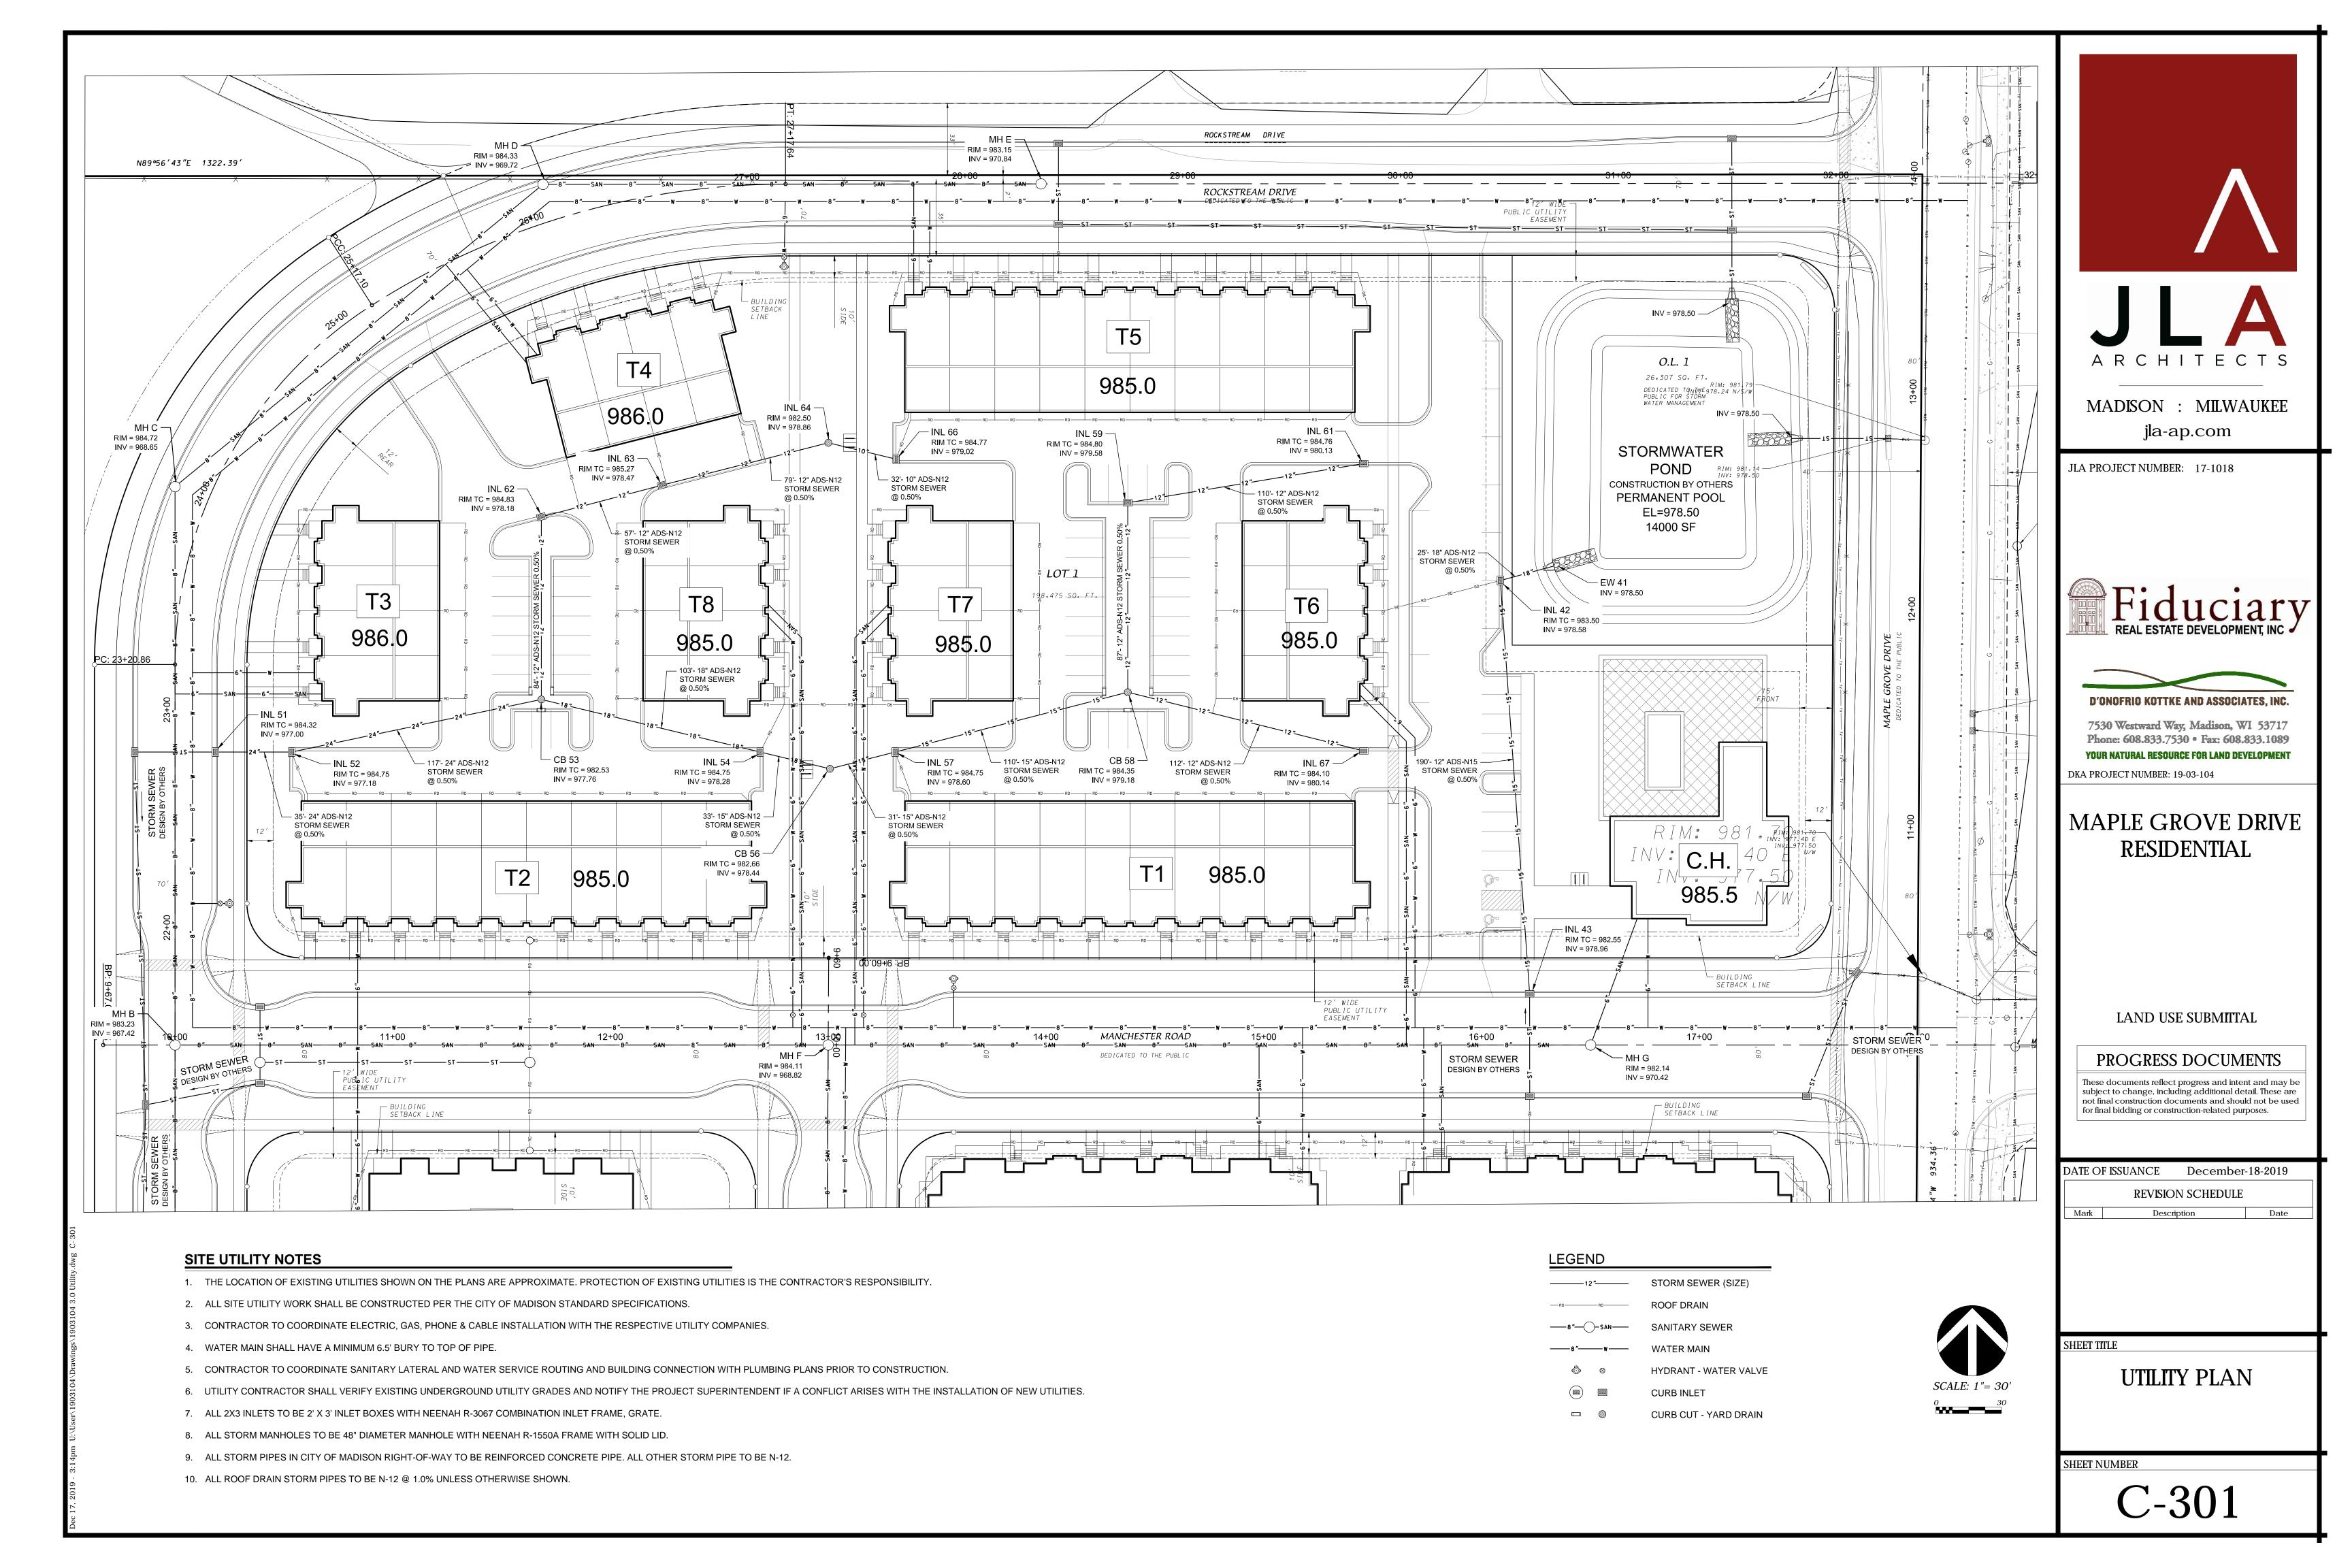
Date Description


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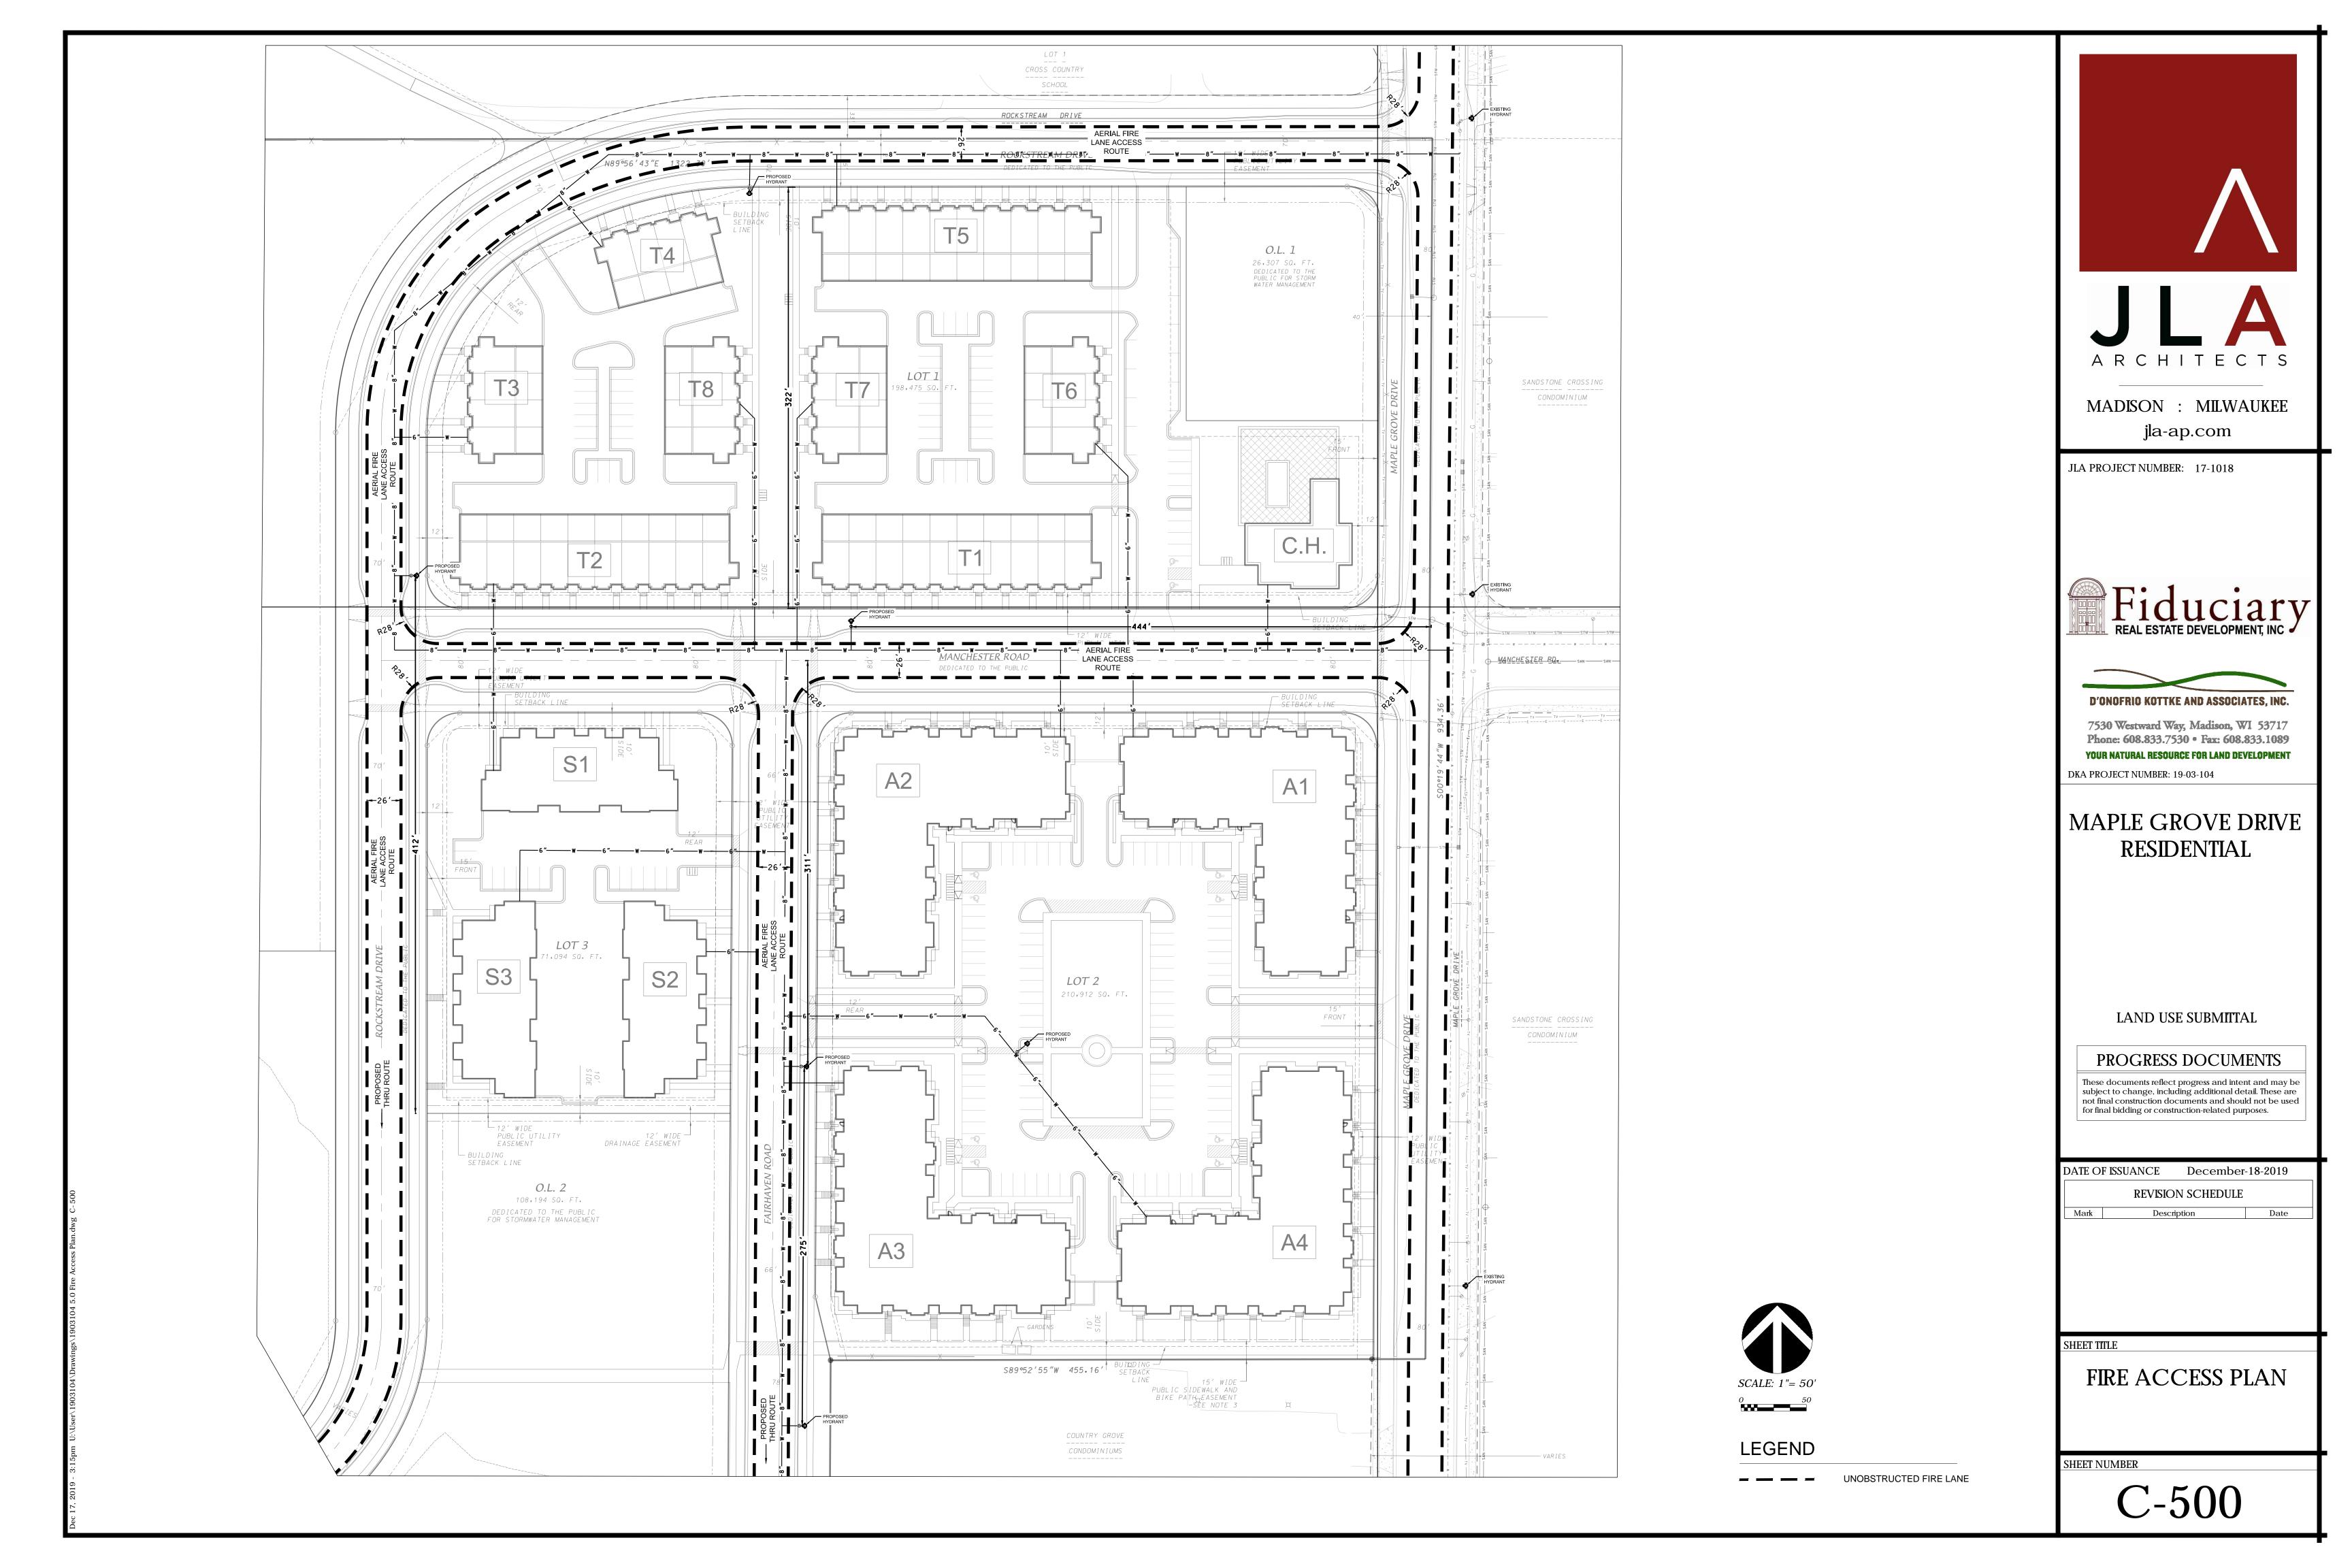
GRADING PLAN

SHEET NUMBER








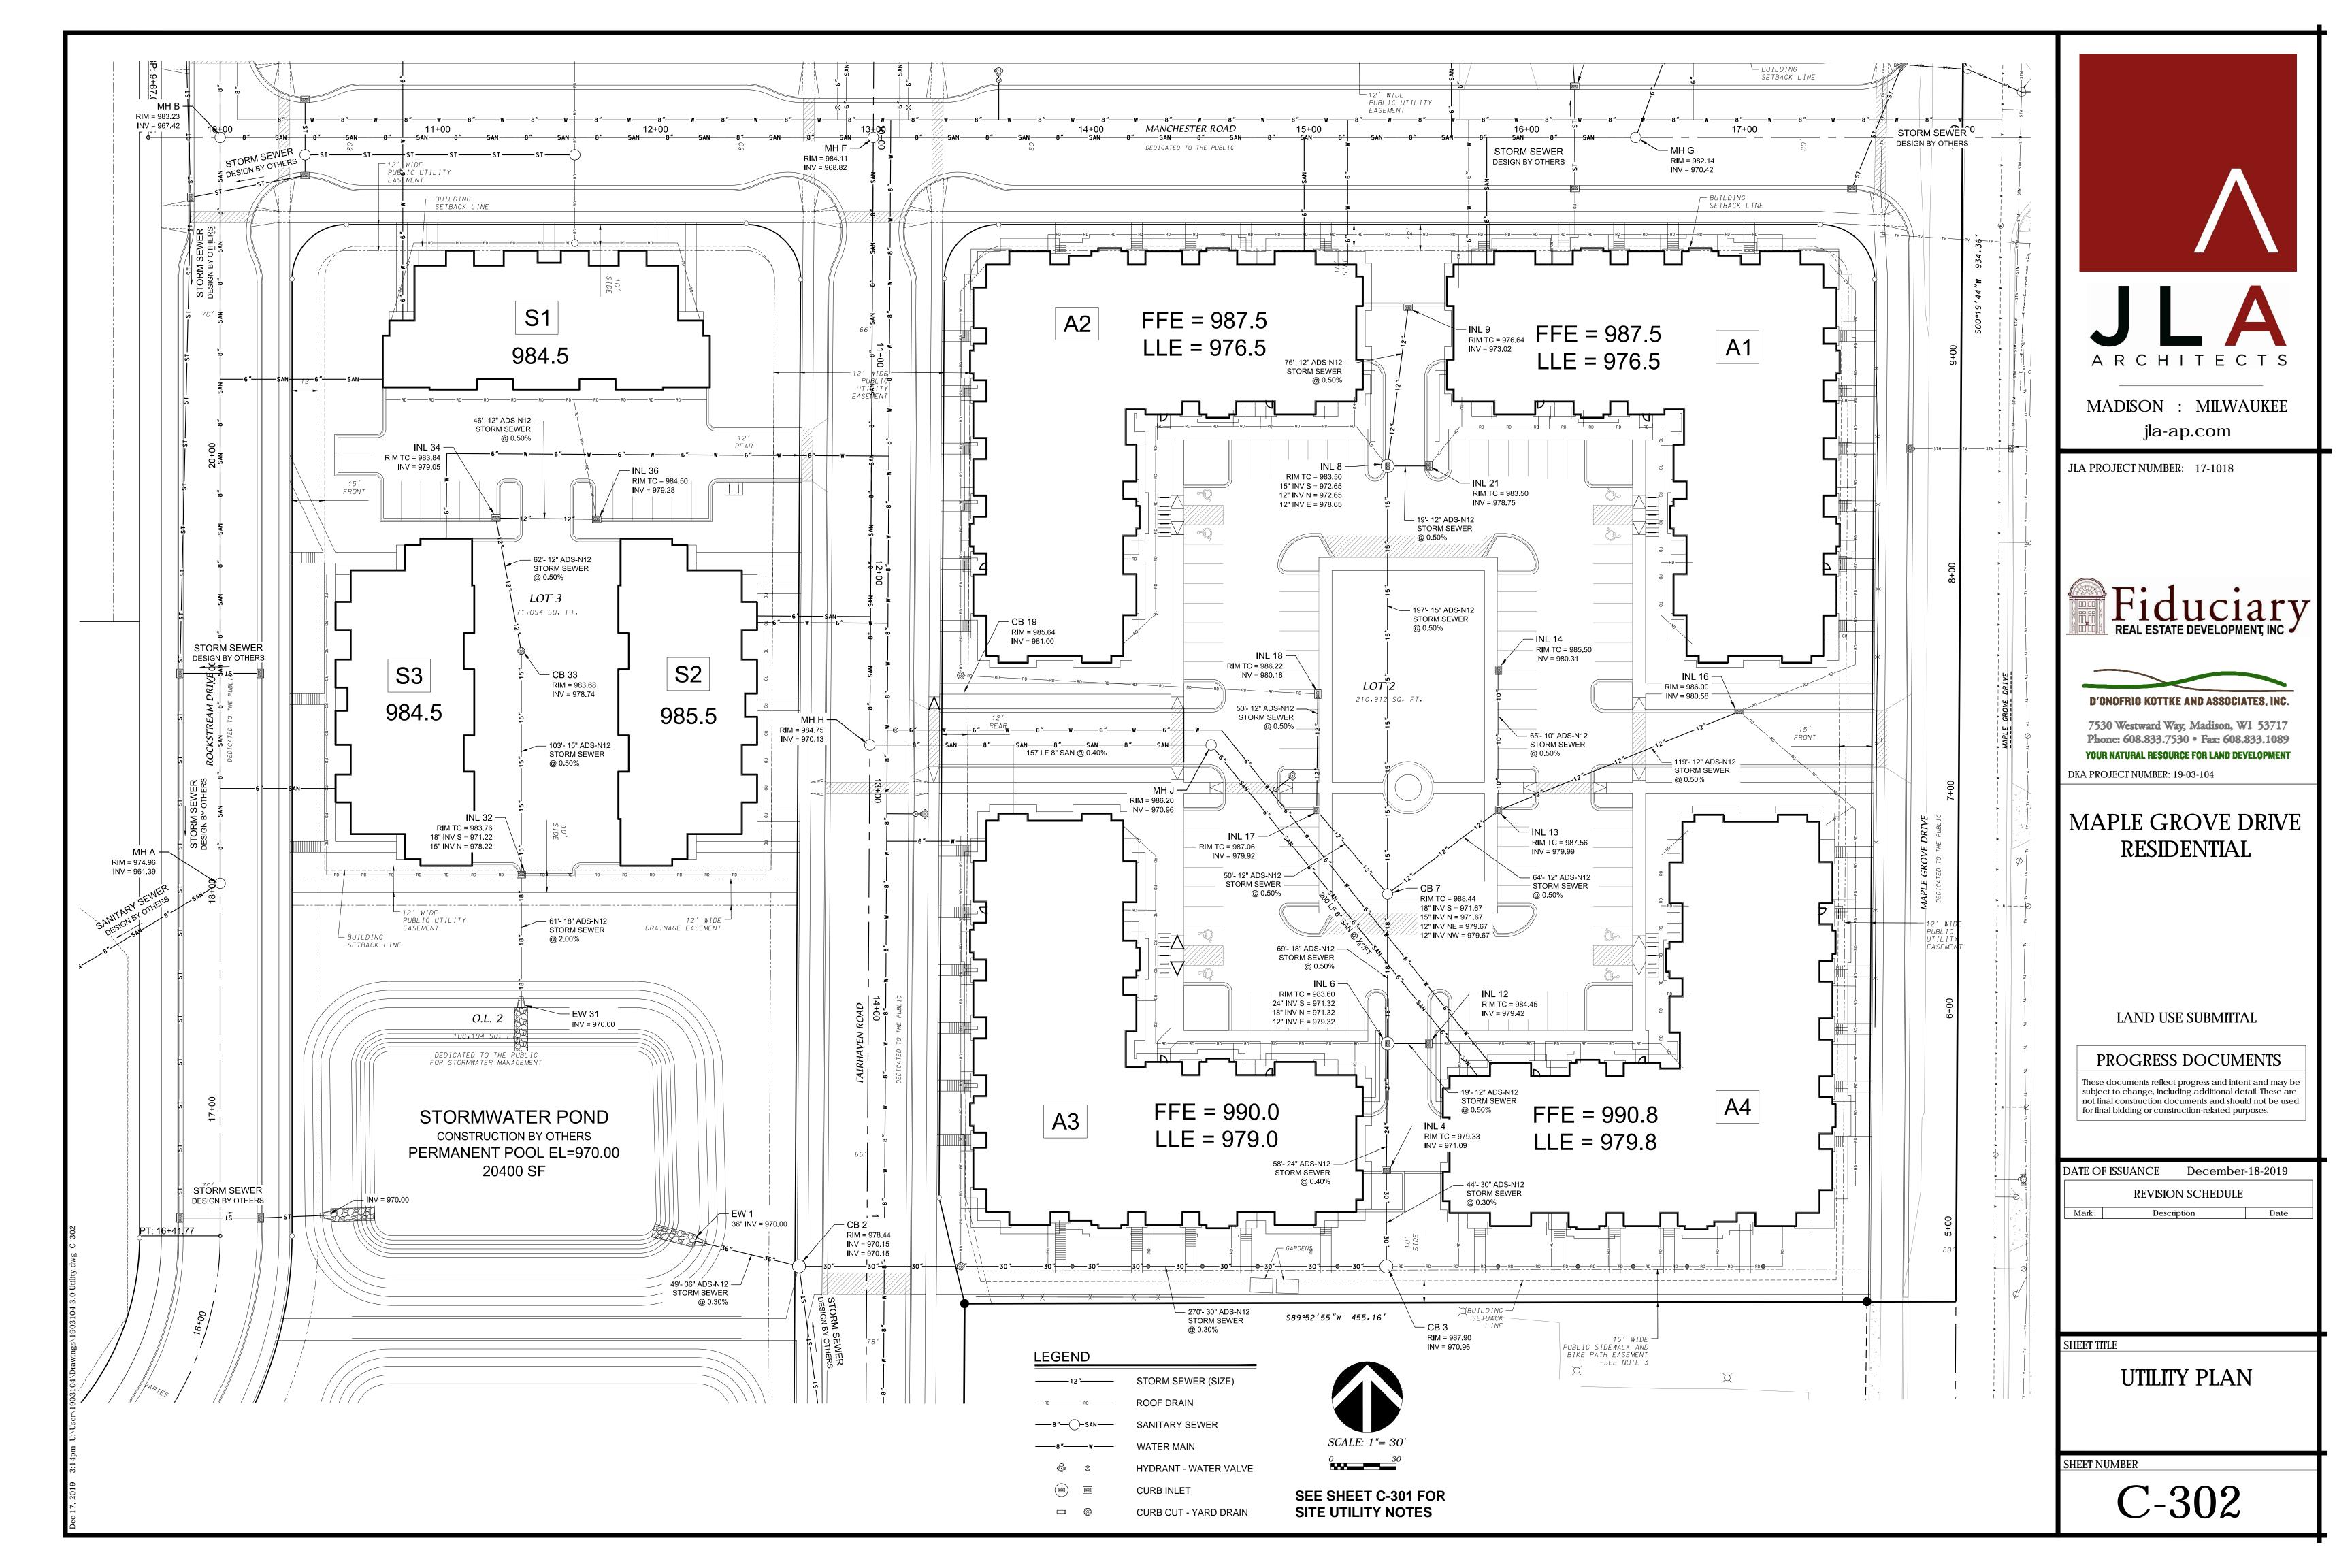


IAPLE GROVE SITE PLAN

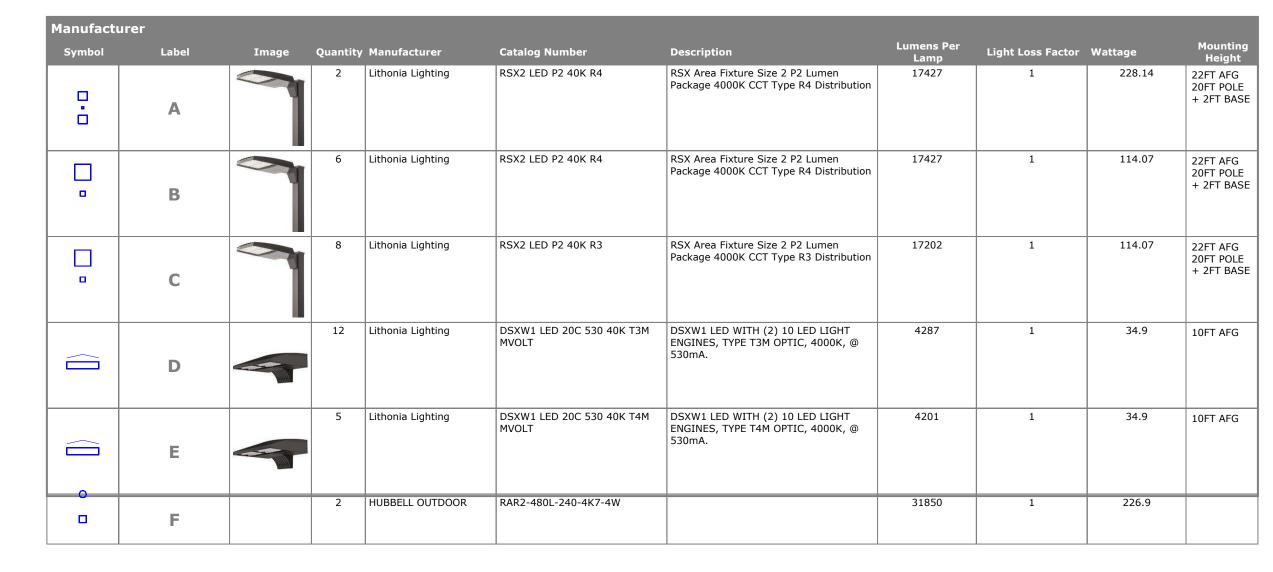

Note		
FC Meas	ured at 0' AFG	
	onsin Administrative Coo 16 (3) (d) pool will have ter light.	

Statistics						
Description	Symbol	Avg	Max	Min	Max/Min	Avg/Mi
BETWEEN T6 & C.H.	+	2.1 fc	6.3 fc	0.6 fc	10.5:1	3.5:1
LOT 1	+	2.2 fc	9.8 fc	0.5 fc	19.6:1	4.4:1
LOT 2		1.8 fc	7.4 fc	0.3 fc	24.7:1	5.9:1
LOT 3	+	1.8 fc	6.3 fc	0.3 fc	21.0:1	6.0:1
POOL	+	7.4 fc	11.6 fc	3.5 fc	3.3:1	2.1:1
T2/T3/T4/T8	+	2.5 fc	10.0 fc	0.5 fc	20.0:1	5.0:1

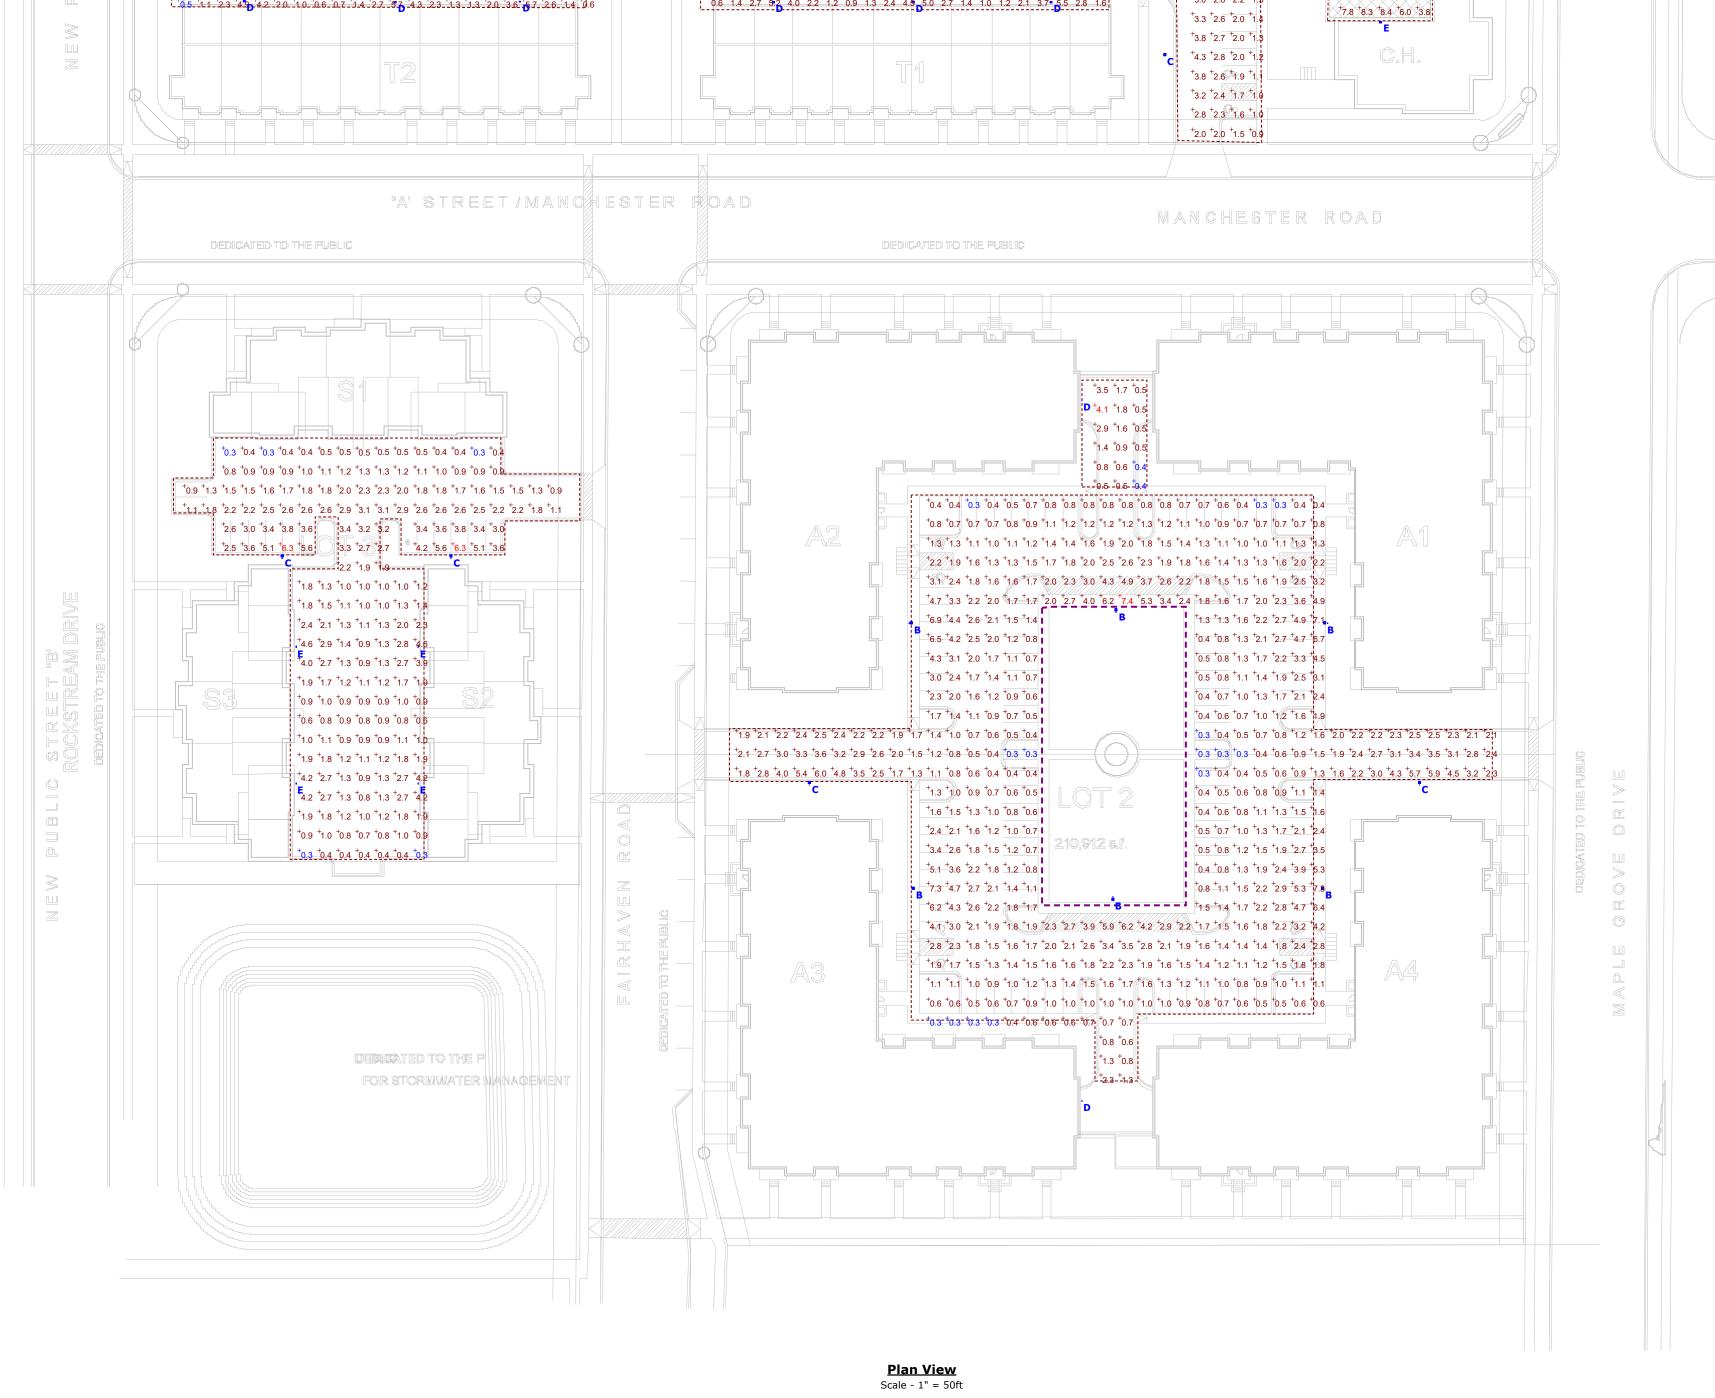

u bnama p

NEW PUBLIC STREET "B"

0.7 +1.3 +2.5 +4.1 +4.0 +2.0 +1.2 +0.9 +1.3 +2.2 +3.9 +4.1 +2.5 +1.4 +1.0 +1.2 +2.0 +3.9 +4.3 +2.8 +1.6 +1.0

[†]0.9 [†]0.9 [†]1.0 [†]1.3 [†]1.4 [†]1.4 [†]1.2 [†]1.0 [†]0.9 [†]0.9

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[†]0.8 [†]1.1 [†]1.3 [†]1.5 [†]2.0 [†]1.9 [†]1.4 [†]1.3 [†]1.0 [†]0.8

⁺1.1 ⁺1.4 ⁺1.9 ⁺2.3 ⁺3.3 ⁺3.0 ⁺2.2 ⁺1.8 ⁺1.4 ⁺1

⁺1.4 ⁺1.6 ⁺2.3 ⁺3 2 ⁺5.0 ⁺4.5 ⁺3.0 ⁺2.1 ⁺1.6 ⁺1.3

⁺1.6 ⁺2.1 ⁺3.1 ⁺4.7 ⁺7.4 ⁺6.8 ⁺4.4 ⁺2.8 ⁺2.1 ⁺1

⁺1.7 ⁺2.6 ⁺4.2 ⁺7.2 ⁺9.8 ⁺9.4 ⁺6.6 ⁺3.7 ⁺2.4 ⁺1.4

⁺1.7 ⁺2.5 ⁺4.1 ⁺6.8 ⁺9.5 ⁺9.1 ⁺6.3 ⁺3.6 ⁺2.4 ⁺1

⁺1.6 ⁺2.0 ⁺2.9 ⁺4.4 ⁺6.9 ⁺6.3 ⁺4.1 ⁺2.7 ⁺2.0 ⁺2.0

⁺1.3 ⁺1.6 ⁺2.2 ⁺3.0 ⁺4.7 ⁺4.3 ⁺2.9 ⁺2.1 ⁺1.5 ⁺1.3

⁺1.1 ⁺1.4 ⁺1.8 ⁺2.2 ⁺3.0 ⁺2.8 ⁺2.1 ⁺1.7 ⁺1.3 ⁺1.

[†]0.8 [†]1.0 [†]1.2 [†]1.4 [†]1.9 [†]1.8 [†]1.3 [†]1.2 [†]1.0 [†]0.8

[†]0.8 [†]0.9 [†]1.0 [†]1.0 [†]1.3 [†]1.2 [†]0.9 [†]1.0 [†]0.9 [†]0.8

0.6 1.4 2.7 5.2 4.0 2.2 1.2 0.9 1.3 2.4 4.5 5.0 2.7 1.4 1.0 1.2 2.1 3.7 5.5 2.8 1.6

+0.7 +1.0 +1.9 +2.3 +2.3 +1.5 +1.2 +1.2 +1.2 +1.8 +2.5 +2.5 +2.5 +1.9 +1.3 +1.2 +1.2 +1.5 +2.3 +2.4 +2.0 +1.2 +0.9 +0.7

5.1 ⁺3.9 ⁺2.7

+5.3 +3.5 +2.6 +2.1 +1.7 +1.2 +0.9 +1.3 +1.8 +2.5 +2.1 +1.6 +0.9 +0.5

⁺3.4 ⁺3.5 ⁺3.0 ⁺2.7 ⁺2.2 ⁺1.6 ⁺1.3 ⁺1.2 ⁺1.3 ⁺7.2 ⁺0.9

⁺2.1 ⁺2.7 ⁺2.8 ⁺2.6 ⁺2.5 ⁺2.0 ⁺1.5 ⁺1.3 ⁺1.1

+1.5 +2.2 +2.5 +2.7 +3.1 +2.6 +1.9 +1.6 +1.2

⁺1.5 ⁺1.9 ⁺2.8 ⁺3.9 ⁺6.0 ⁺4.9 ⁺3.3 ⁺2.2 ⁺1.7

⁺1.8 ⁺2.4 ⁺3.7 ⁺5.6 ⁺8.5 ⁺7.2 ⁺4.8 ⁺3.0 ⁺2.2

⁺1.8 ⁺2.7 ⁺4.6 ⁺7.5 ⁺10 0 ⁺8.5 ⁺6.6 ⁺3.5 ⁺2.4

+1.8 +2.5 +4.0 +6.4 +9.2 +8.1 +5.5 +3.2 +2.3 +1.4

+1.6 +2.0 +2.8 +4.1 +6.6 +5.4 +3.6 +2.4 +1.8 +1.4

⁺1.1 ⁺1.4 ⁺1.7 ⁺2.0 ⁺2.8 ⁺2.4 ⁺1.9 ⁺1.6 ⁺1.2 [†]1.0

⁺1.0 ⁺1.2 ⁺1.4 ⁺1.4 ⁺1.8 ⁺1.7 ⁺1.4 ⁺1.4 ⁺1.2 [†]1.0

+0.7 +1.2 +2.0 +3.0 +3.0 +1.9 +1.2 +1.0 +1.1 +1.4 +2.4 +3.3 +3.2 +2.0 +1.7 +1.6 +1.8 +2.9 +3.0 +2.3 +1.3 +0.8

⁺1.3 ⁺1.6 ⁺2.2 ⁺2.8 ⁺4.4 ⁺3.7 ⁺2.6 ⁺1.9 ⁺1.4

⁺1.4 ⁺2.0 ⁺2.6 ⁺3.1 ⁺4.2 ⁺3.5 ⁺2.5 ⁺1.9 ⁺1.4 ⁺1.1

STREET

0.6 +0.8 +0.8

+1.0 +1.3 +1.4 +1.0

⁺1.8 ⁺2.2 ⁺2.0 ⁺1.5 +2.8 +2.8 +2.2 +1.5 +4.2 +3.2 +2.3 116

⁺5.8 ⁺3.6 ⁺2.5 ⁺1

C+6.3 +3.9 +2.6 +1.8 ⁺4.9 ⁺3.4 ⁺2.5 ⁺1

+3.5 +3.0 +2.3 +1

⁺2.5 ⁺2.7 ⁺2.4 ⁺1

⁺1.7 ⁺2.0 ⁺2.0 ⁺1.

⁺1.5 ⁺1.8 ⁺1.6 ⁺1.2

+1.7 +1.8 +1.5 +1

⁺2.4 ⁺2.3 ⁺1.8 ⁺1.

⁺2.9 ⁺2.4 ⁺1.7 ⁺1

⁺3.2 ⁺2.4 ⁺1.7 ⁺1

⁺3.7 ⁺2.6 ⁺1.8 ⁺1.0

⁺3.5 ⁺2.6 ⁺1.8 ⁺1.2,

⁺3.2 ⁺2.5 ⁺1.8 ⁺1.3 ⁺0.9

⁺2.9 ⁺2.6 ⁺2.0 ⁺1.4 ⁺1.

2.1 +2.2 +1.9 +1.5 +1.2

⁺1.8 ⁺1.7 ⁺1.4 ⁺1.8

⁺1.8 ⁺1.8 ⁺1.6 ⁺1.8

⁺2.2 ⁺2.2 ⁺1.9 ⁺1.6

⁺3.0 ⁺2.6 ⁺2.2 ⁺1.5

⁺3.3 ⁺2.6 ⁺2.0 ⁺1.4

C +4.0 +2.7 +1.9 +1.1

DEDICATED TO

MANAGEMENT

FOR STORMWATER

⁺11.1⁺11.2⁺10.6⁺9.4 ⁺8.3 ⁺7.1 ⁺6.2

⁺11.6⁺11.0⁺10.0⁺8.9 ⁺7.4 ⁺6.4 ⁺5.8

+10.6+10.0+8.2 +7.0 +5.8 +5.2 +4.7


⁺9.3 ⁺9.0 ⁺7.1 ⁺6.0 ⁺4.8 ⁺2.0 ⁺3.5 ¹

*8.4 *8.2 *6.4 *5.3 *4.1


*8.0 *8.2 *7.0 *5.6 *3.7

Date 12/5/2019 Scale Not to Scale Drawing No. Summary

P-1.0

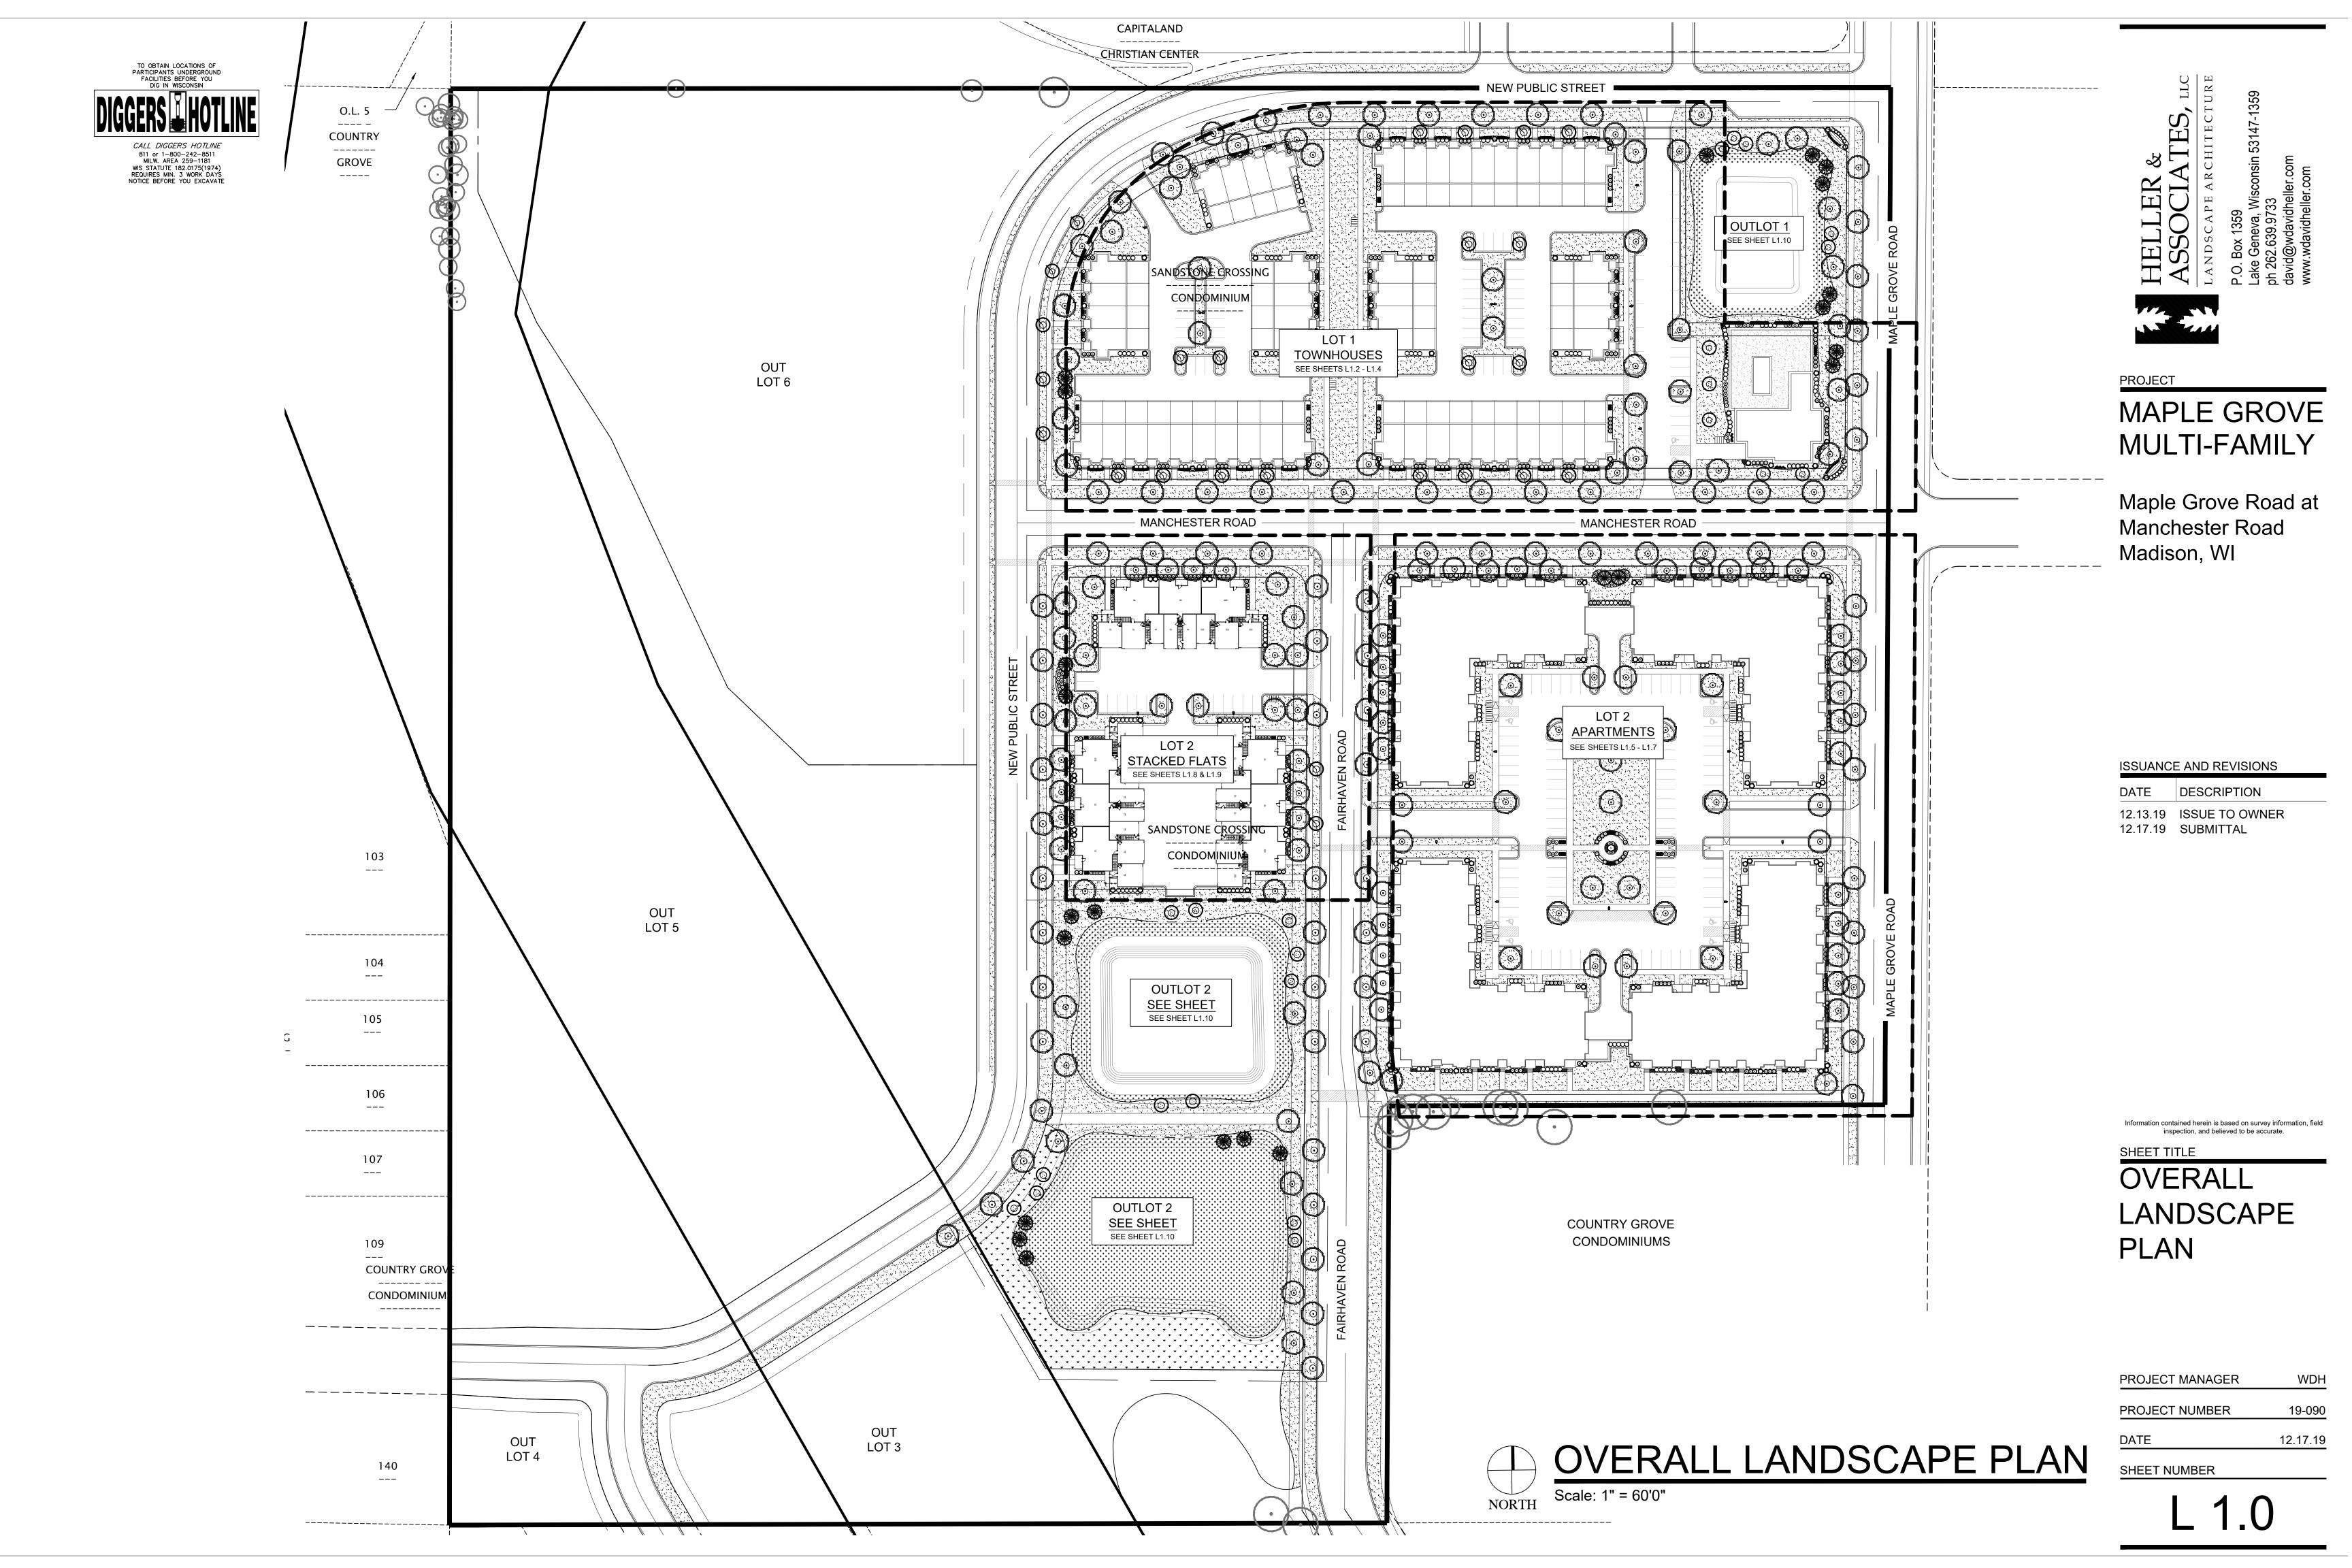



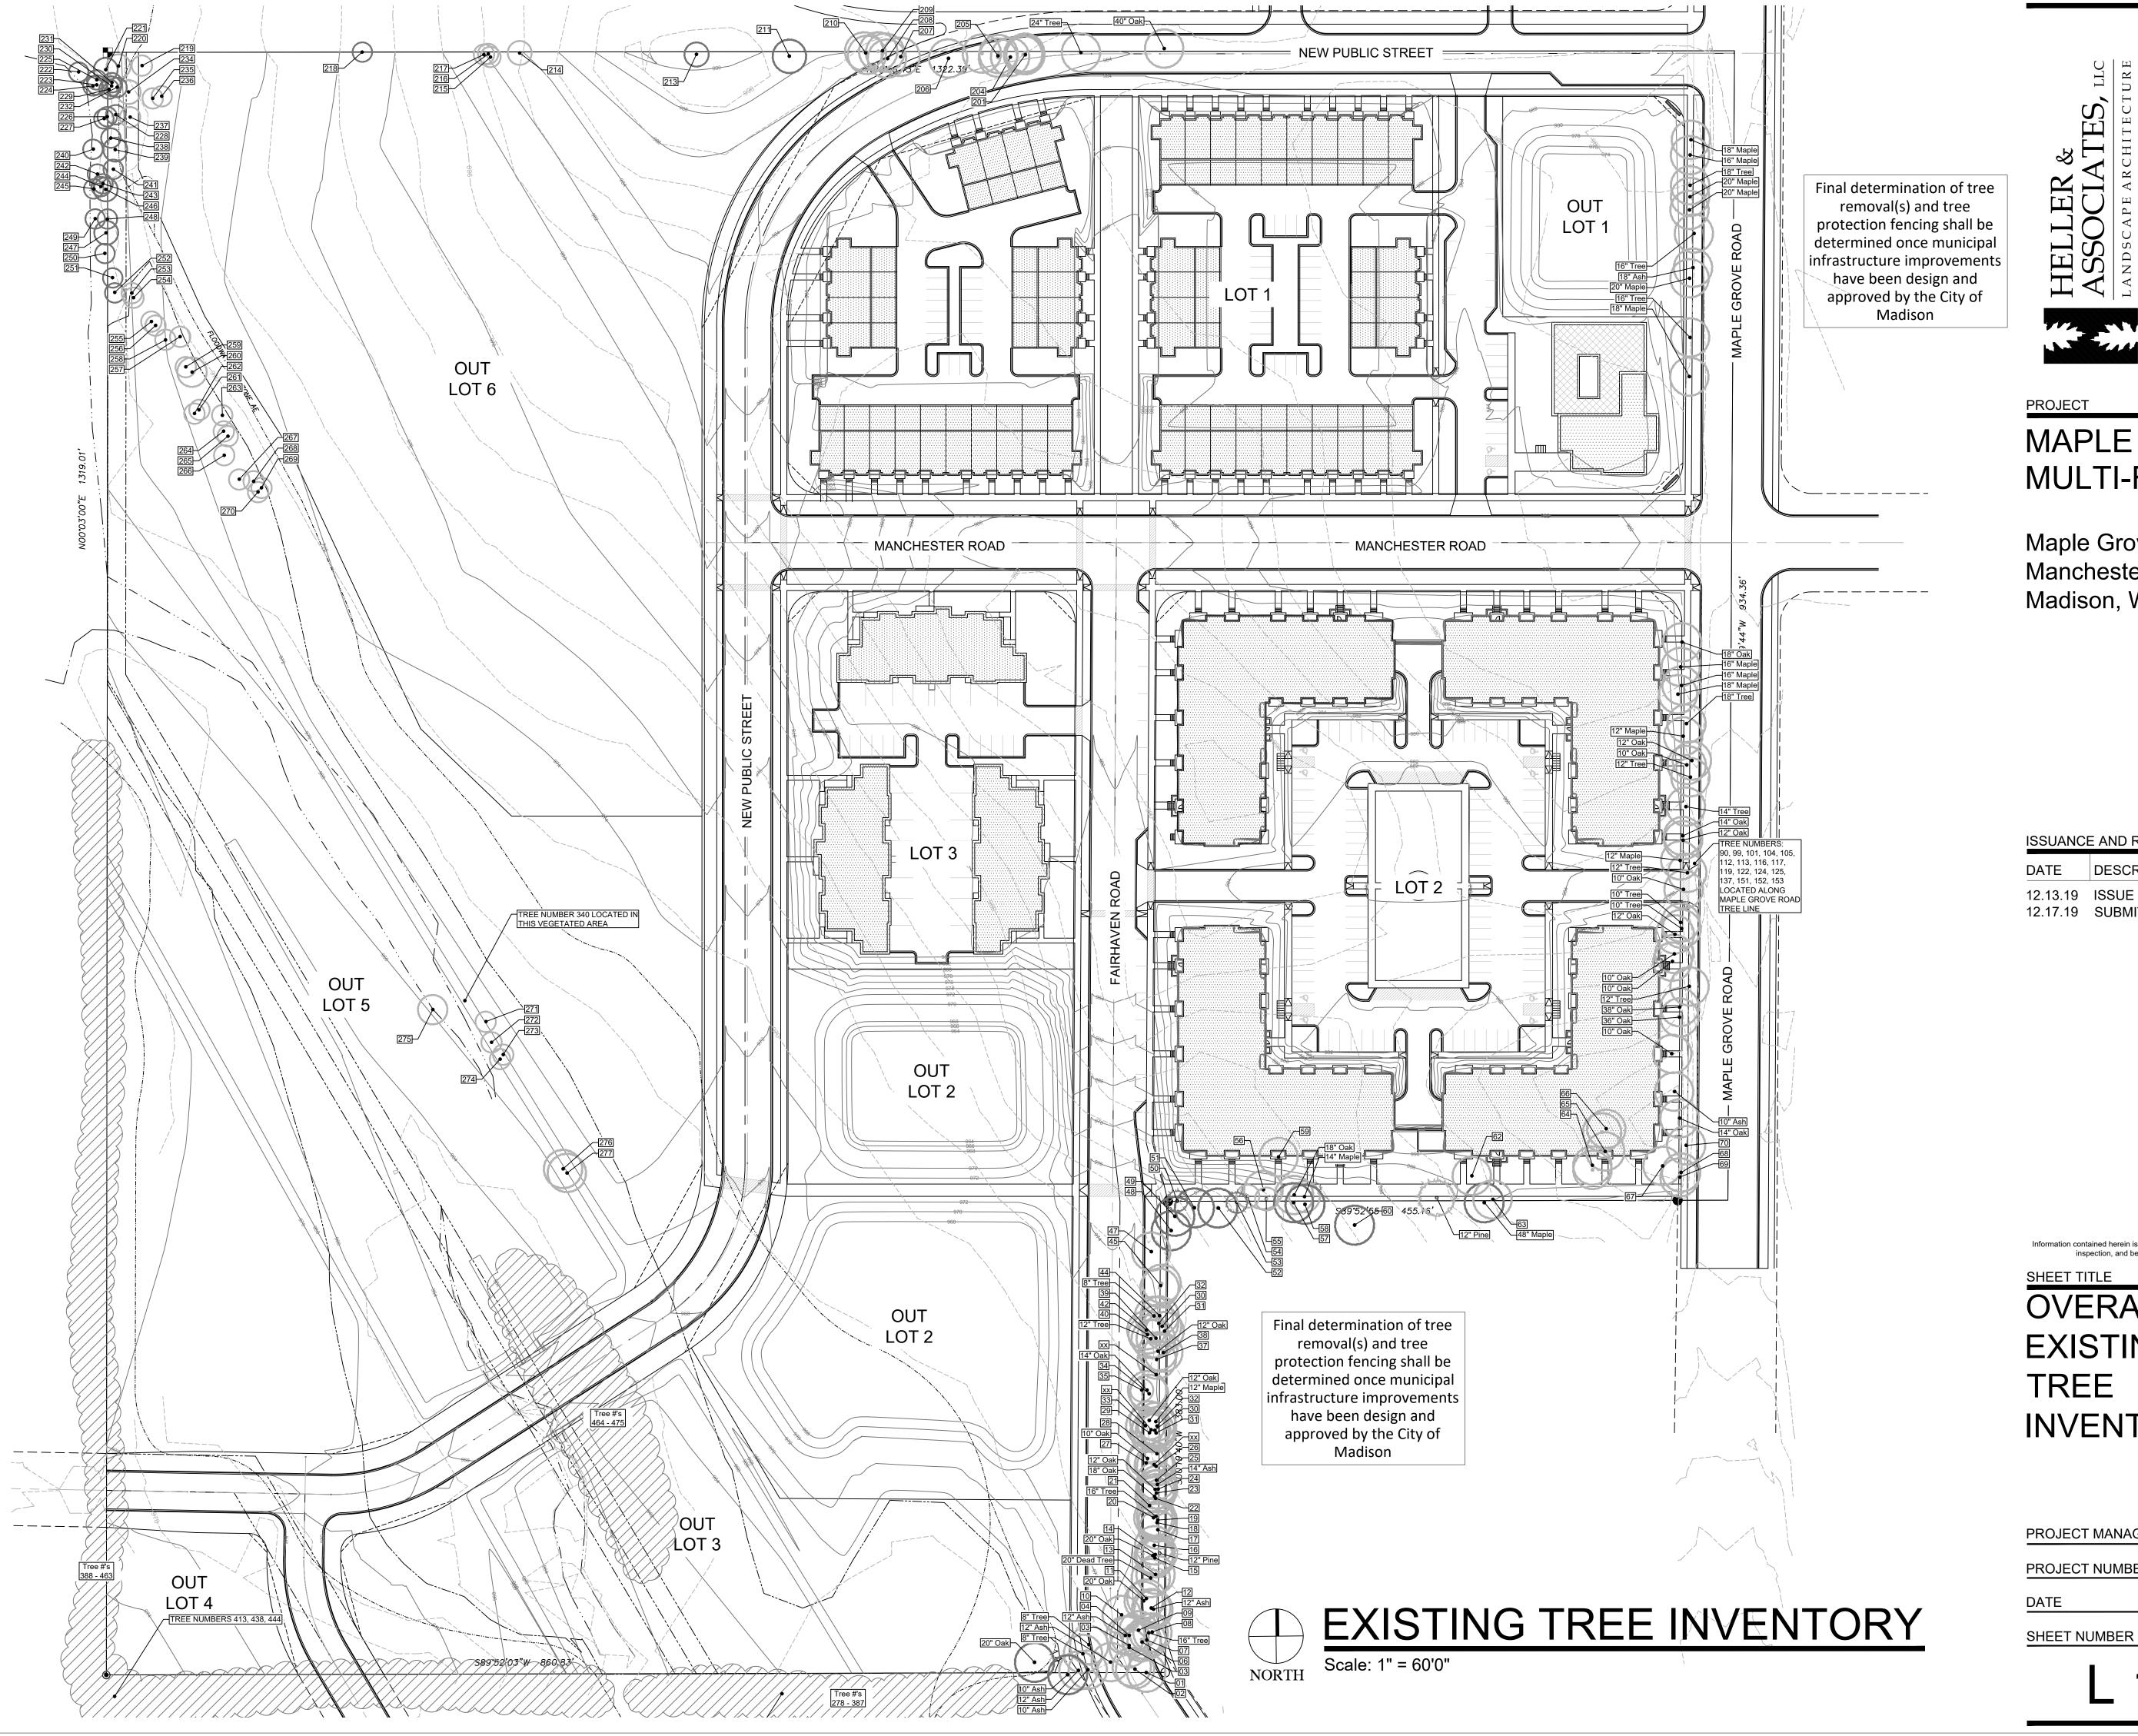



PROJECT

MAPLE GROVE **MULTI-FAMILY**

Maple Grove Road at Manchester Road Madison, WI

ISSUANCE AND REVISIONS


12.13.19 ISSUE TO OWNER 12.17.19 SUBMITTAL	DATE	DESCRIPTION

Information contained herein is based on survey information, field

SHEET TITLE

OVERALL EXISTING TREE INVENTORY

	PROJECT MANAGER	WD
!	PROJECT NUMBER	19-09
!	DATE	12.17.1

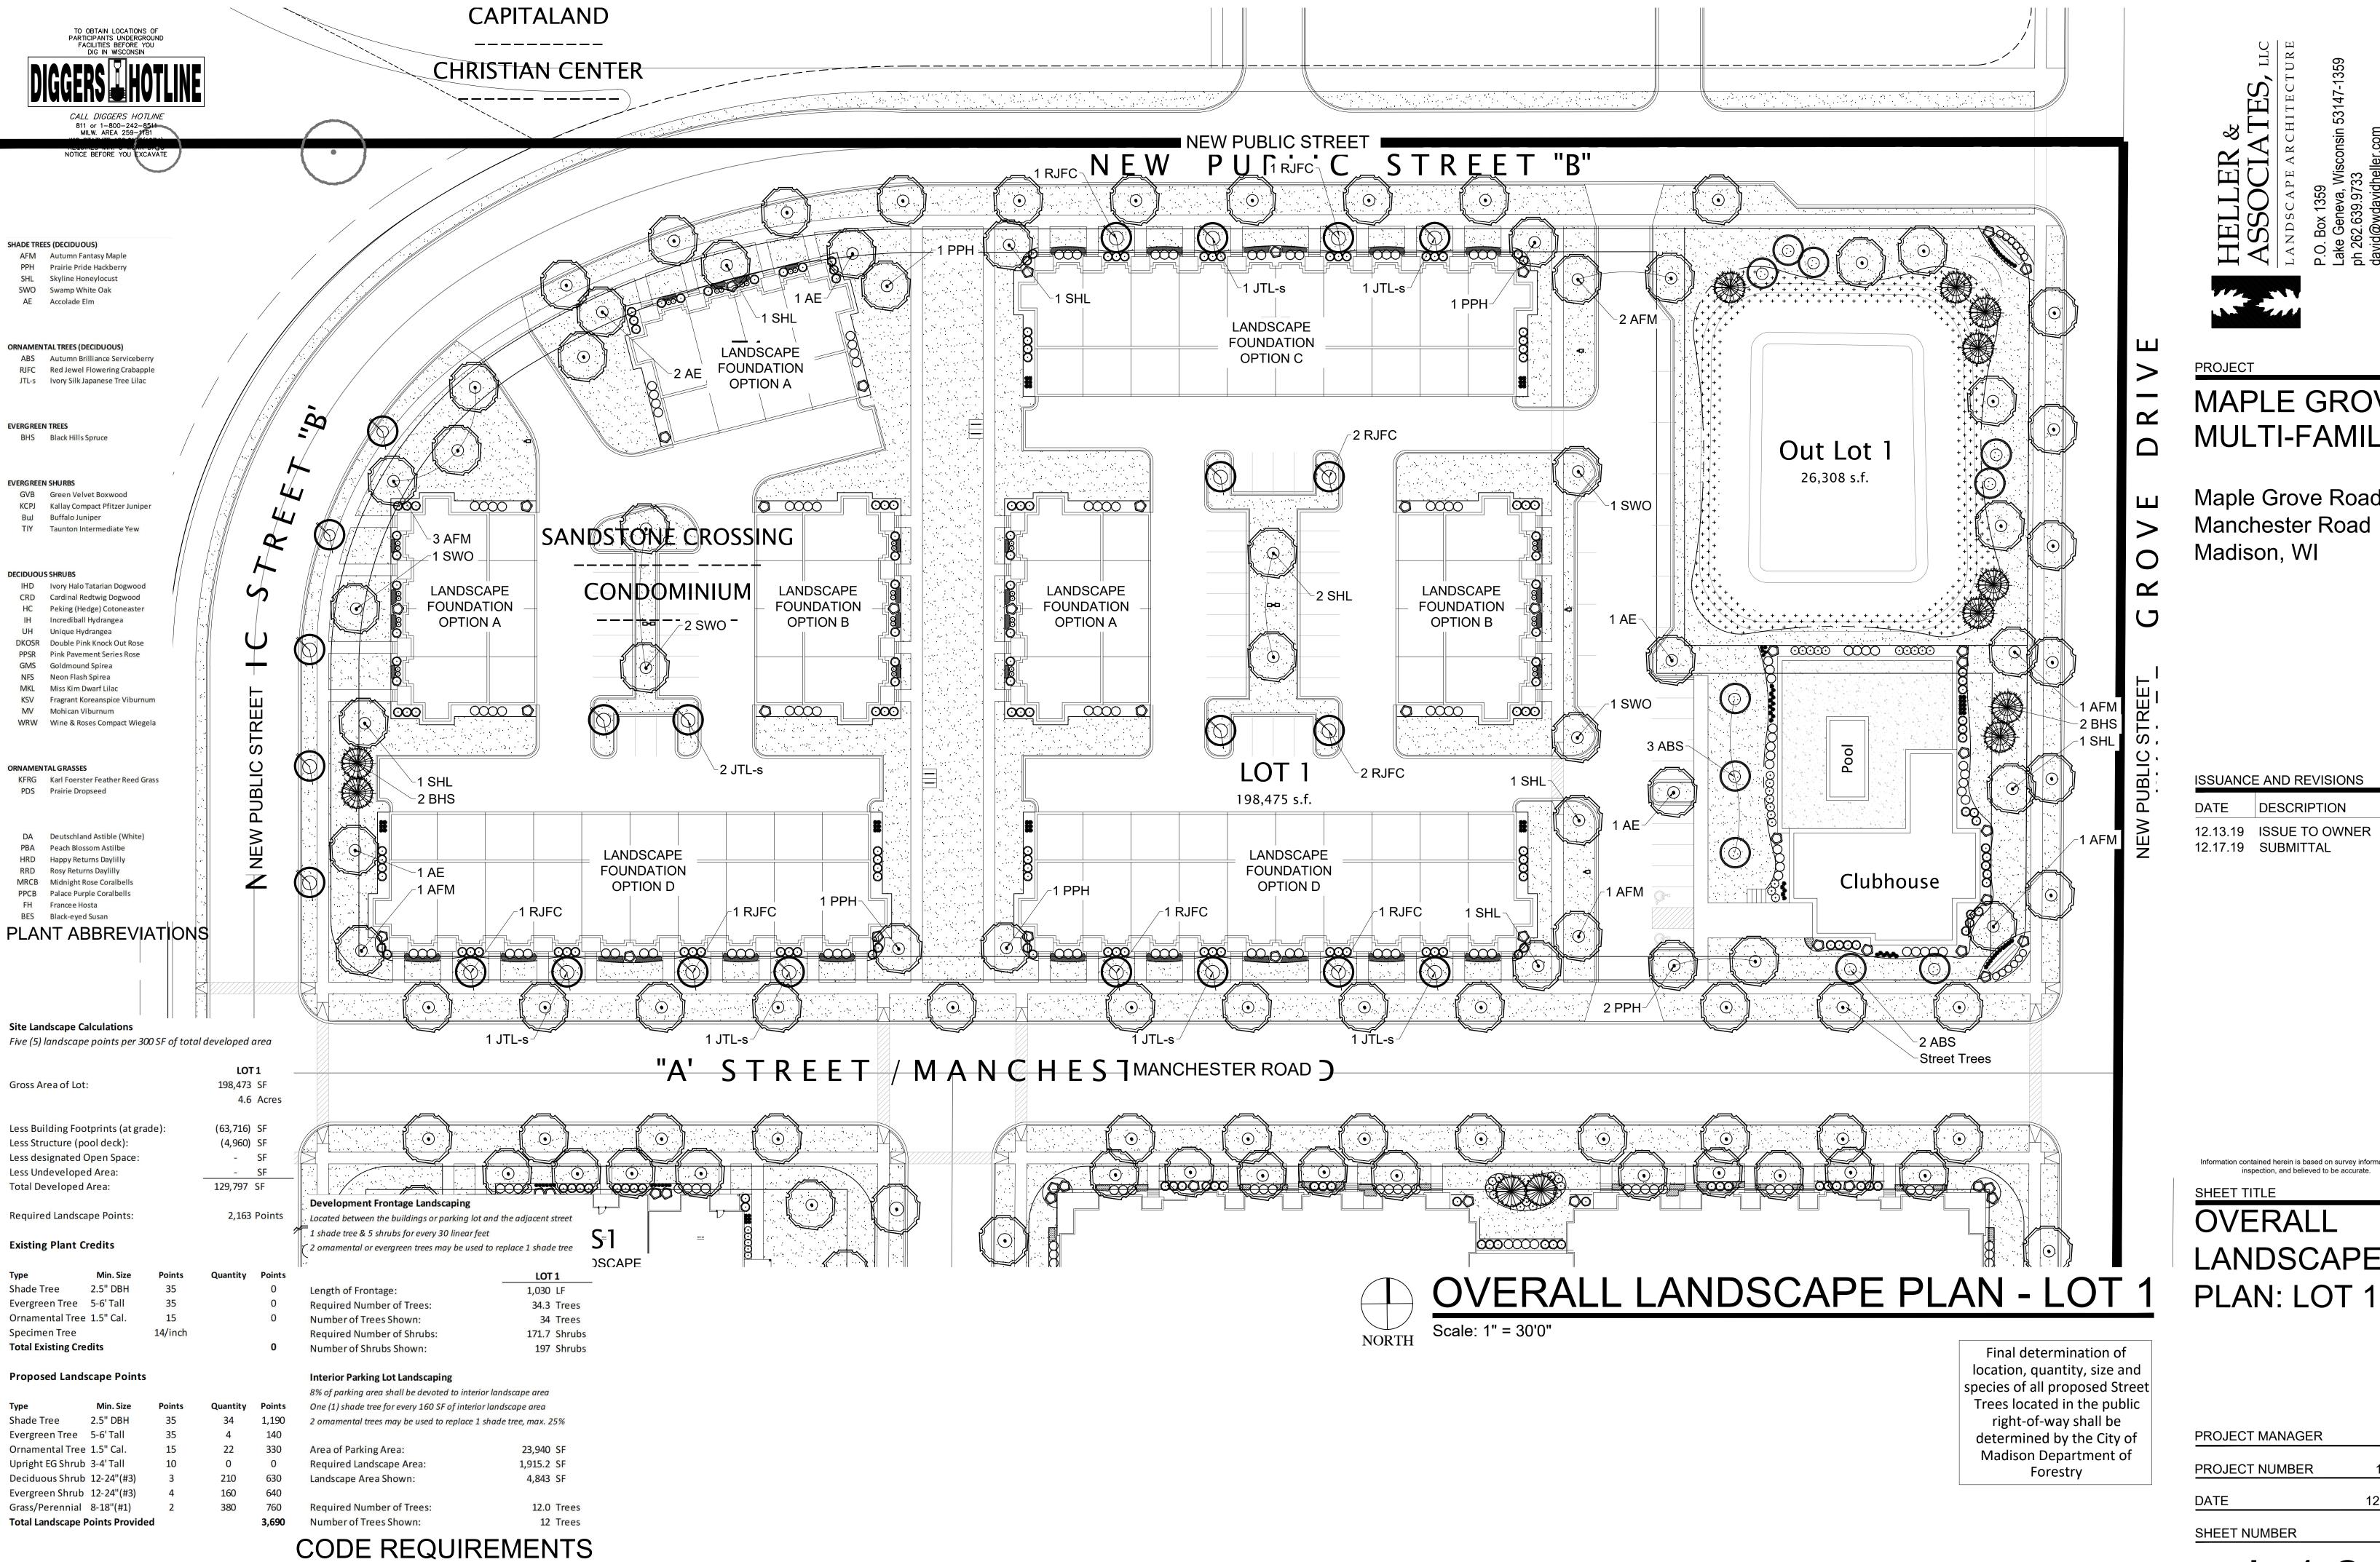

MAPLE GROVE **MULTI-FAMILY**

Maple Grove Road at Manchester Road Madison, WI

ISSUANCE AND REVISIONS

12.13.19 ISSUE TO OWNER 12.17.19 SUBMITTAL


Information contained herein is based on survey information, field inspection, and believed to be accurate


SHEET TITLE **OVERALL** LANDSCAPE

PROJECT MANAGER WDH PROJECT NUMBER 19-090


12.17.19

SHEET NUMBER

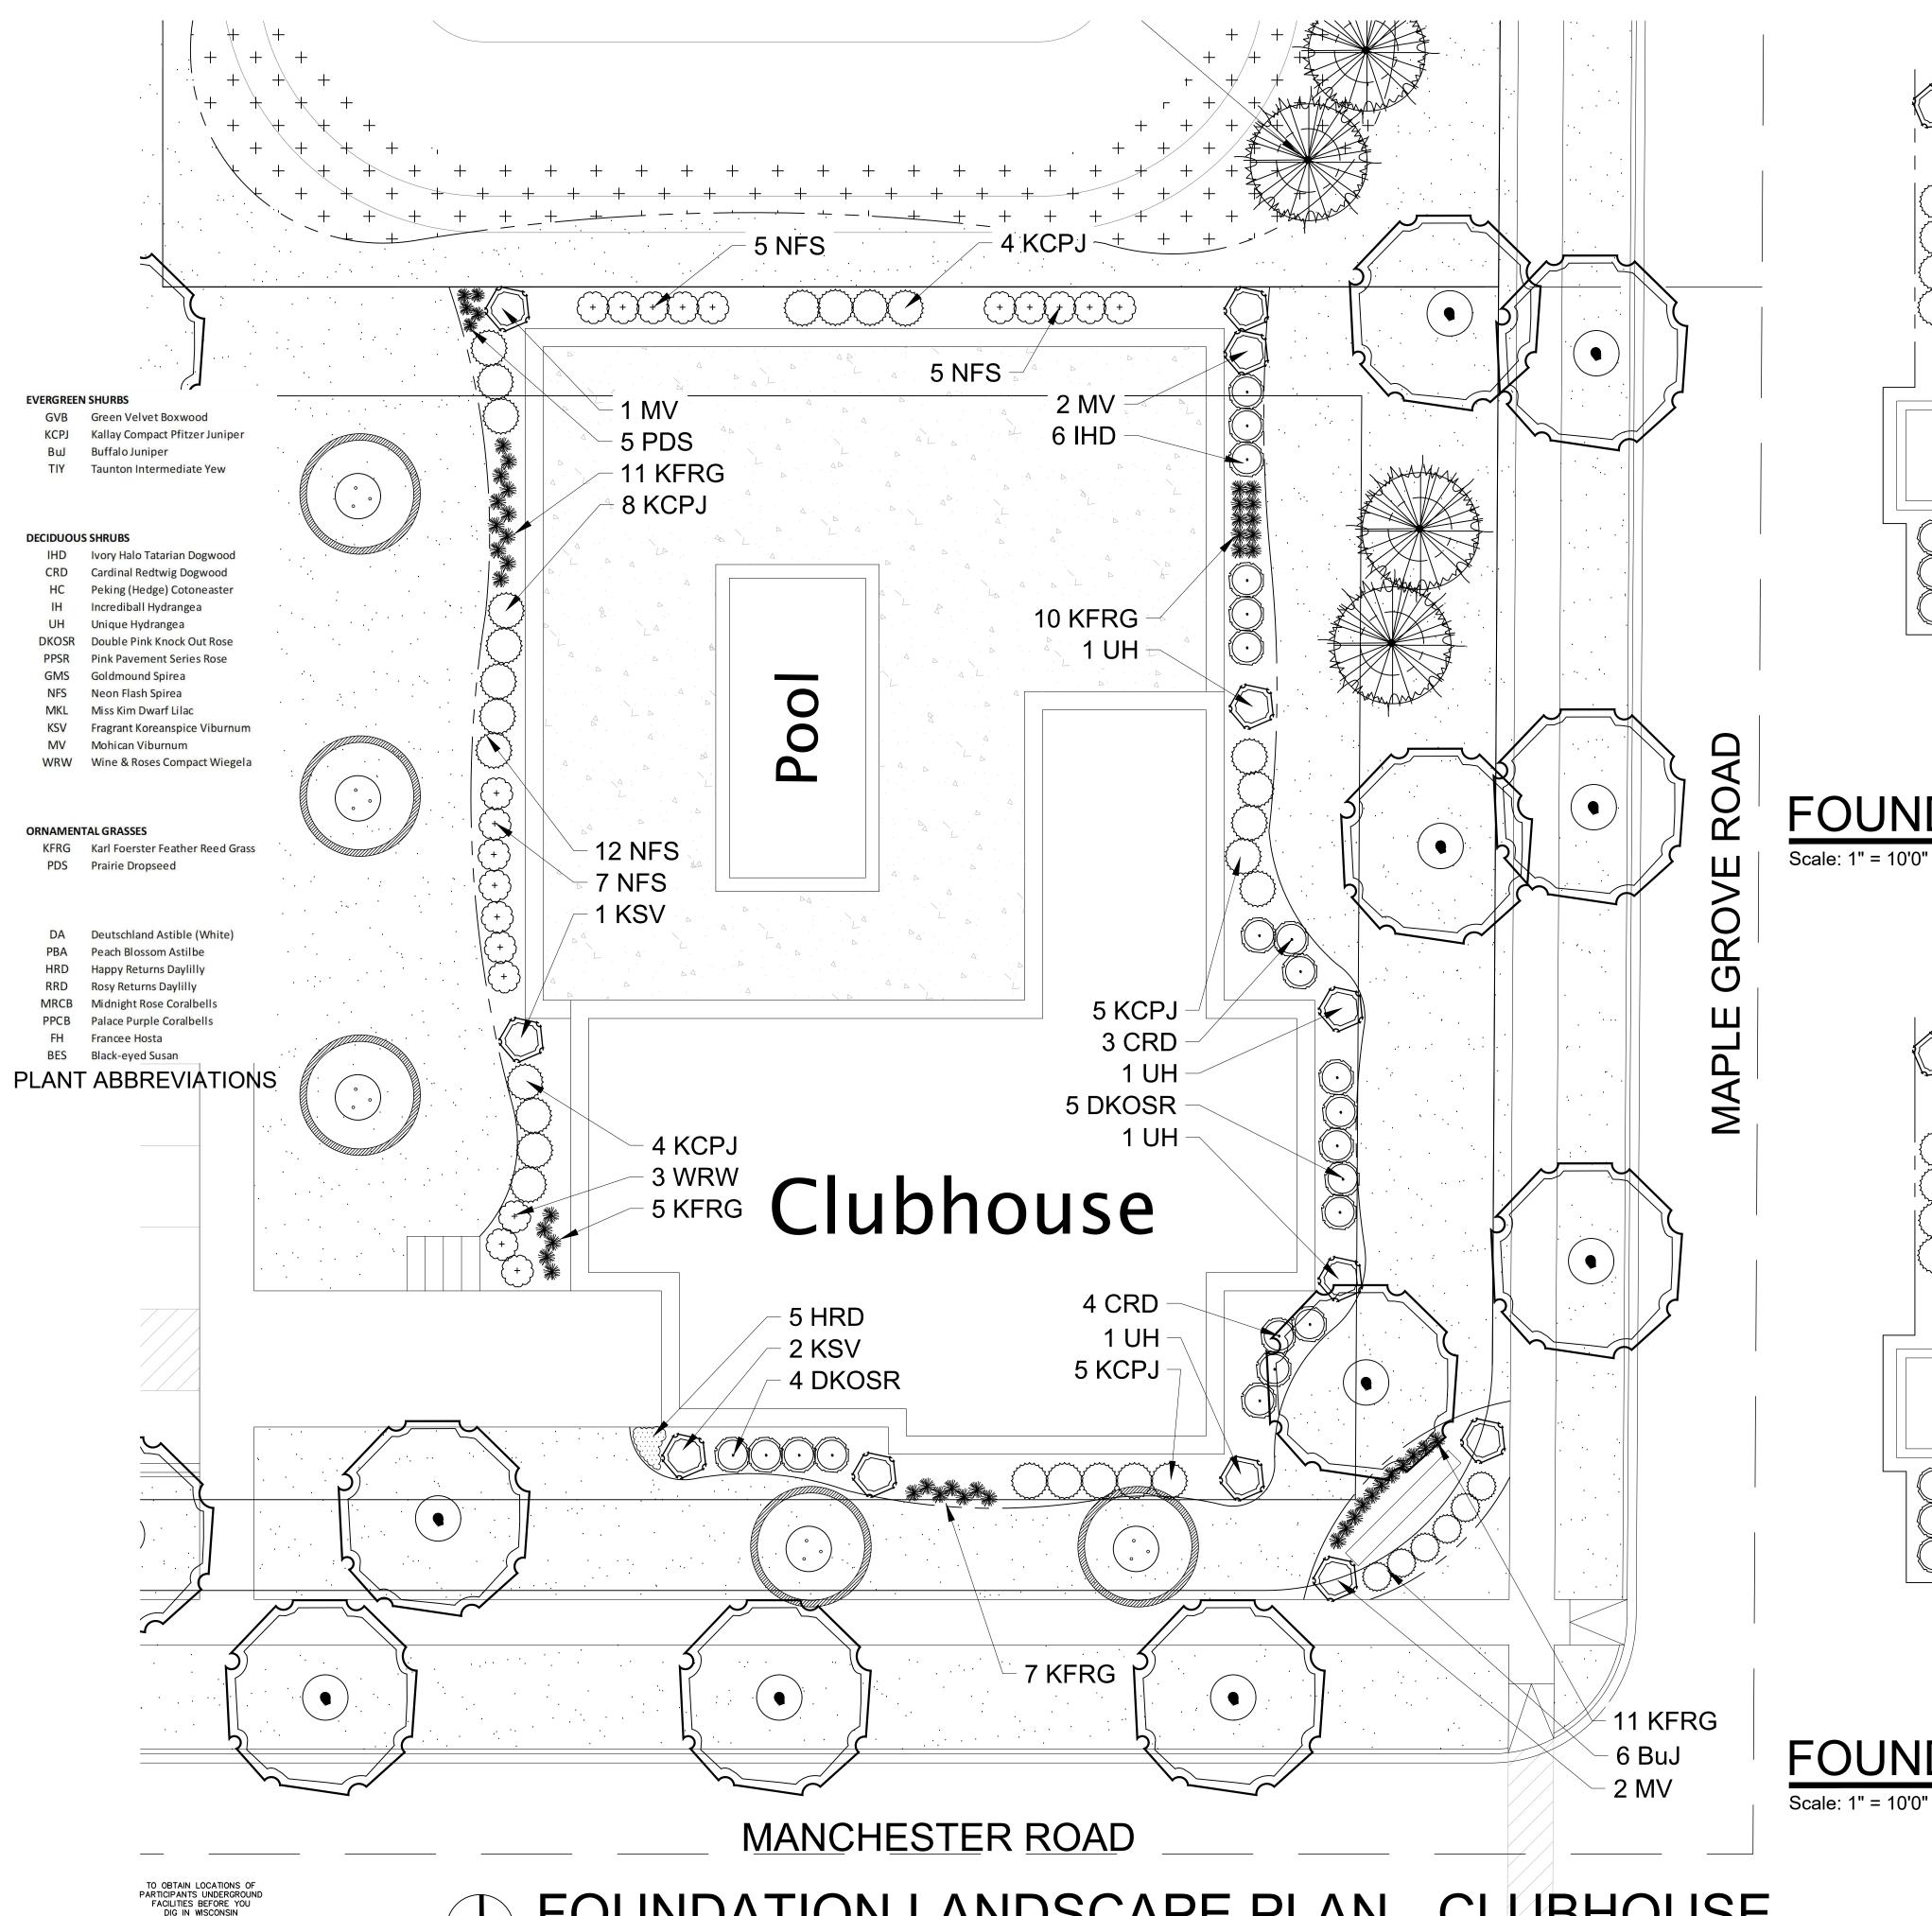

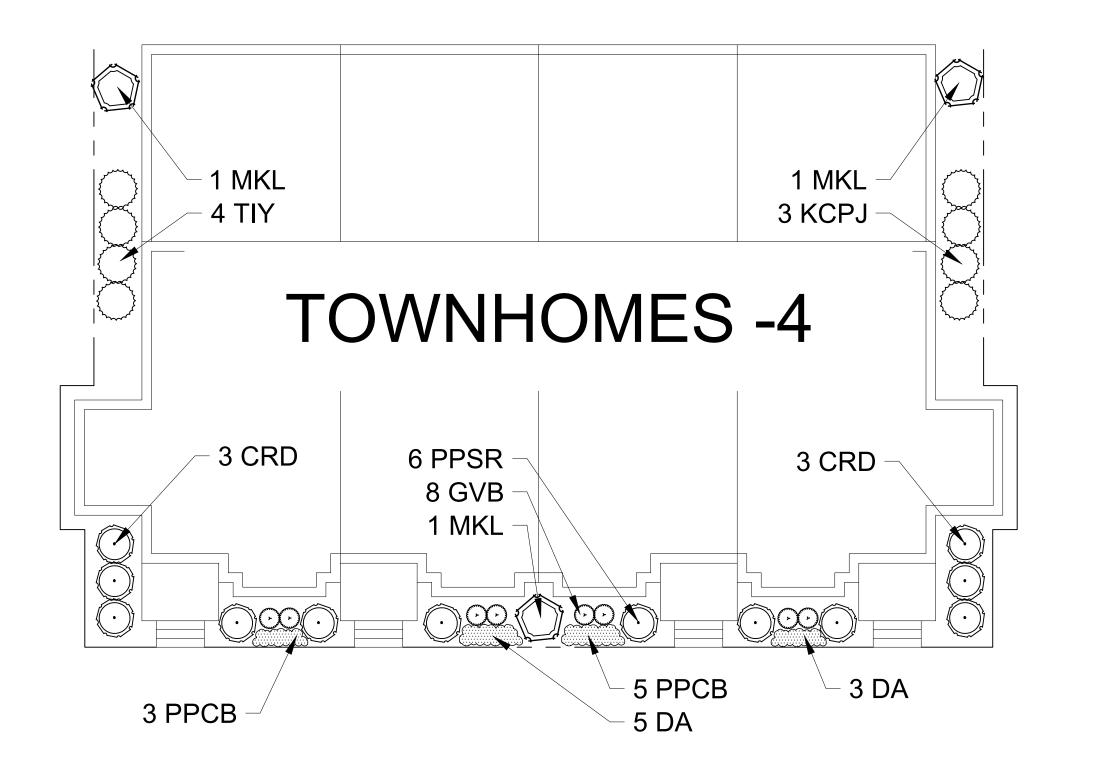

FOUNDATION LANDSCAPE PLAN - OPTION "A"

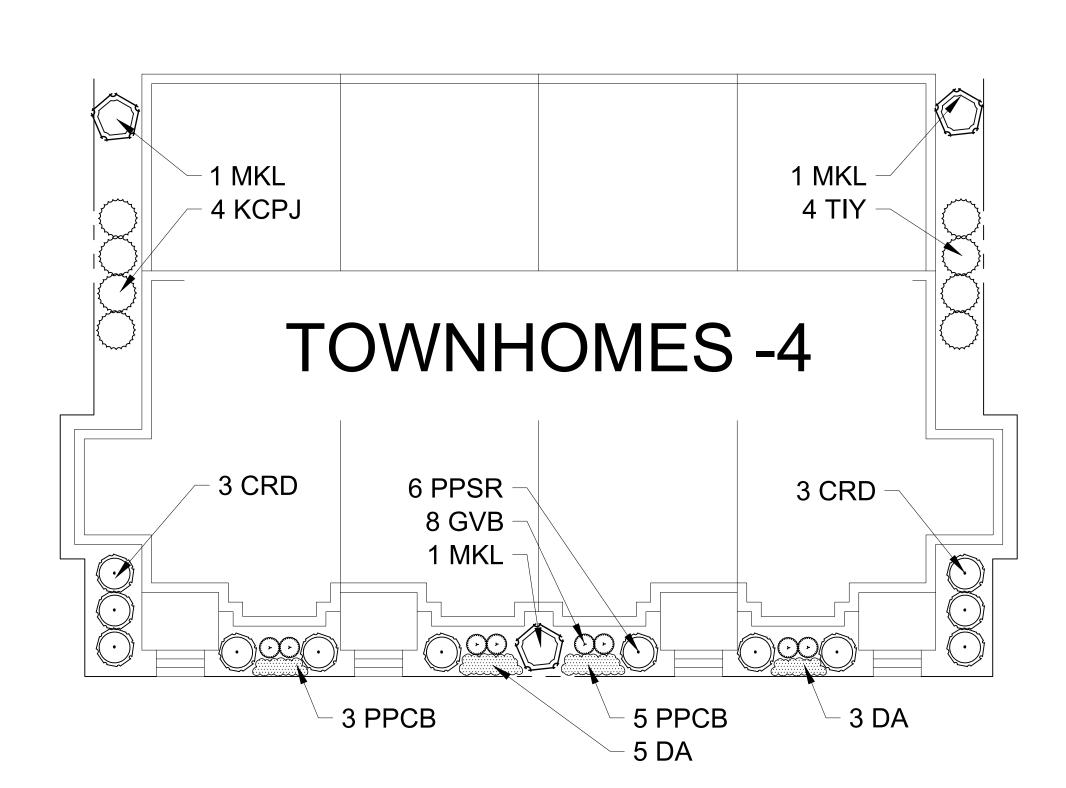

FOUNDATION LANDSCAPE PLAN - OPTION "B" Scale: 1" = 10'0"



MAPLE GROVE **MULTI-FAMILY**

Maple Grove Road at Manchester Road Madison, WI

ISSUANCE AND REVISIONS

DATE DESCRIPTION 12.13.19 ISSUE TO OWNER 12.17.19 SUBMITTAL

Information contained herein is based on survey information, field

FOUNDATION LANDSCAPE PLANS: CLUBHOUSE & TOWNHOUSE

PROJECT MANAGER	WDH
PROJECT NUMBER	19-090
DATE	12.17.17
SHEET NUMBER	



FOUNDATION LANDSCAPE PLAN - CLUBHOUSE Scale: 1" = 10'0"



Shade Trees


Reinder's Deluxe 50 Seed Mix (800-785-3301):

20% Kentucky Bluegrass (Sod Quality)

15% Newport Kentucky Bluegrass

15% Ken Blue Kentucky Bluegrass

5 Ornamental Trees

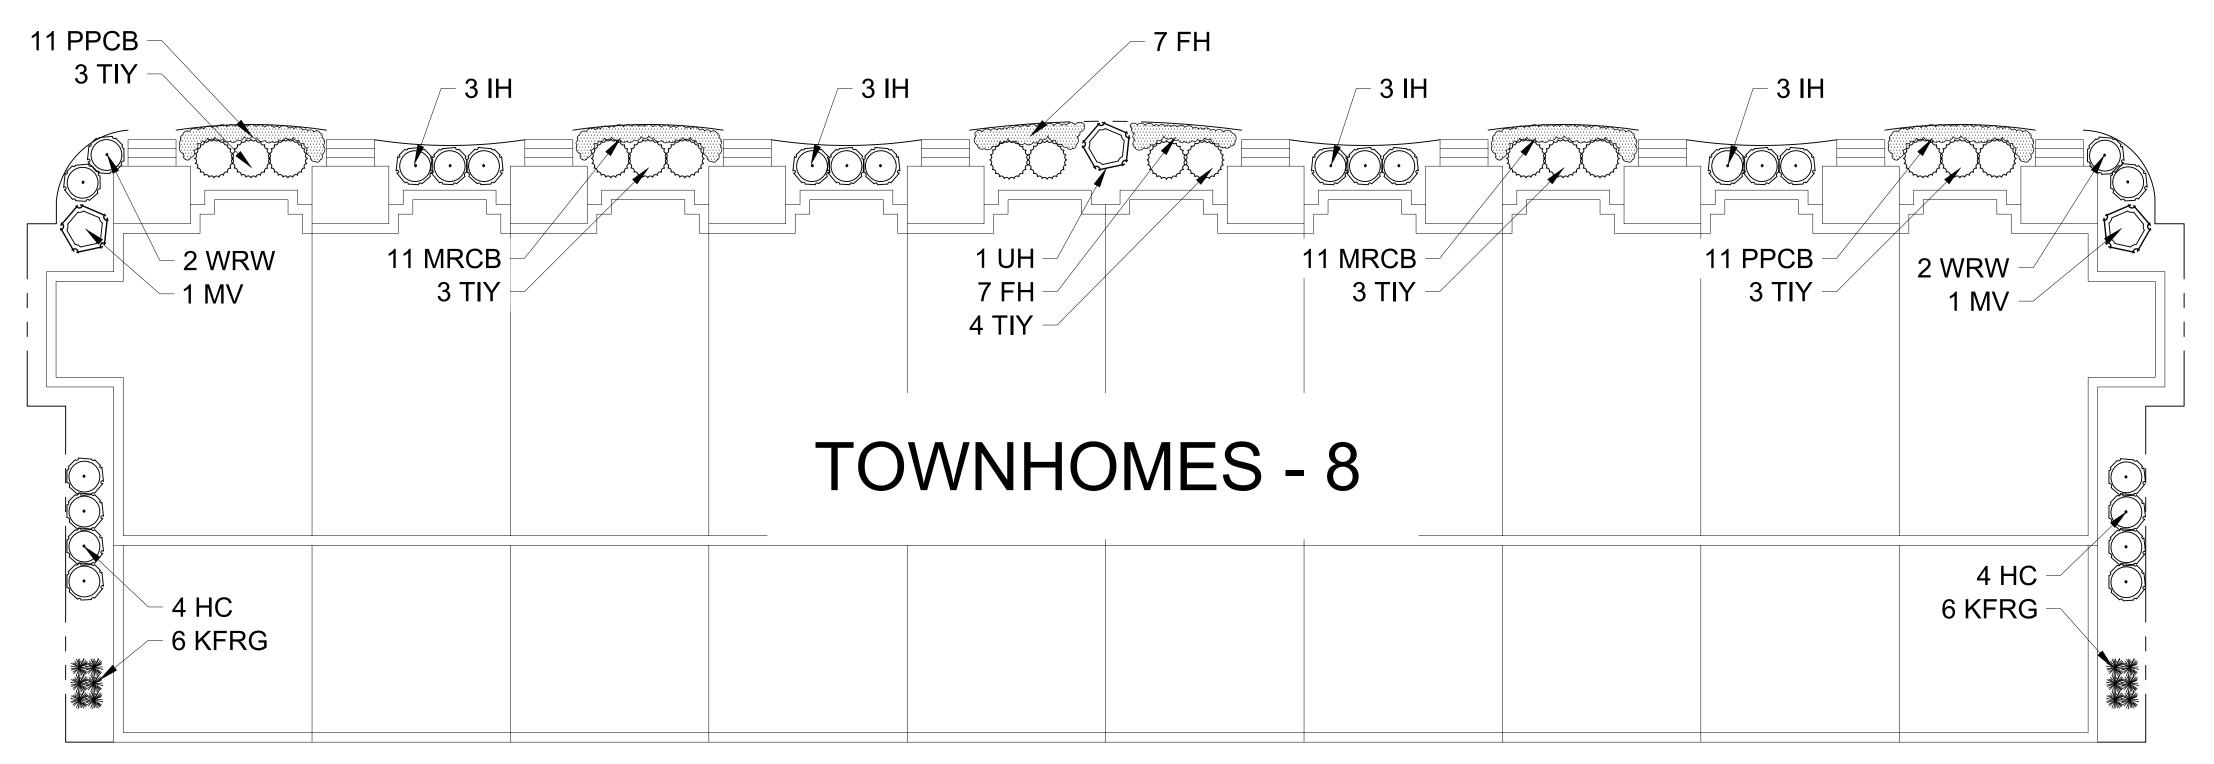



MAPLE GROVE MULTI-FAMILY

Maple Grove Road at Manchester Road Madison, WI

ISSUANCE AND REVISIONS

12.13.19 ISSUE TO OWNER

DATE DESCRIPTION

6 KFRG


4 HC

1 KSV

11 RRD

2 WRW

FOUNDATION LANDSCAPE PLAN - OPTION "C" Scale: 1" = 10'0"

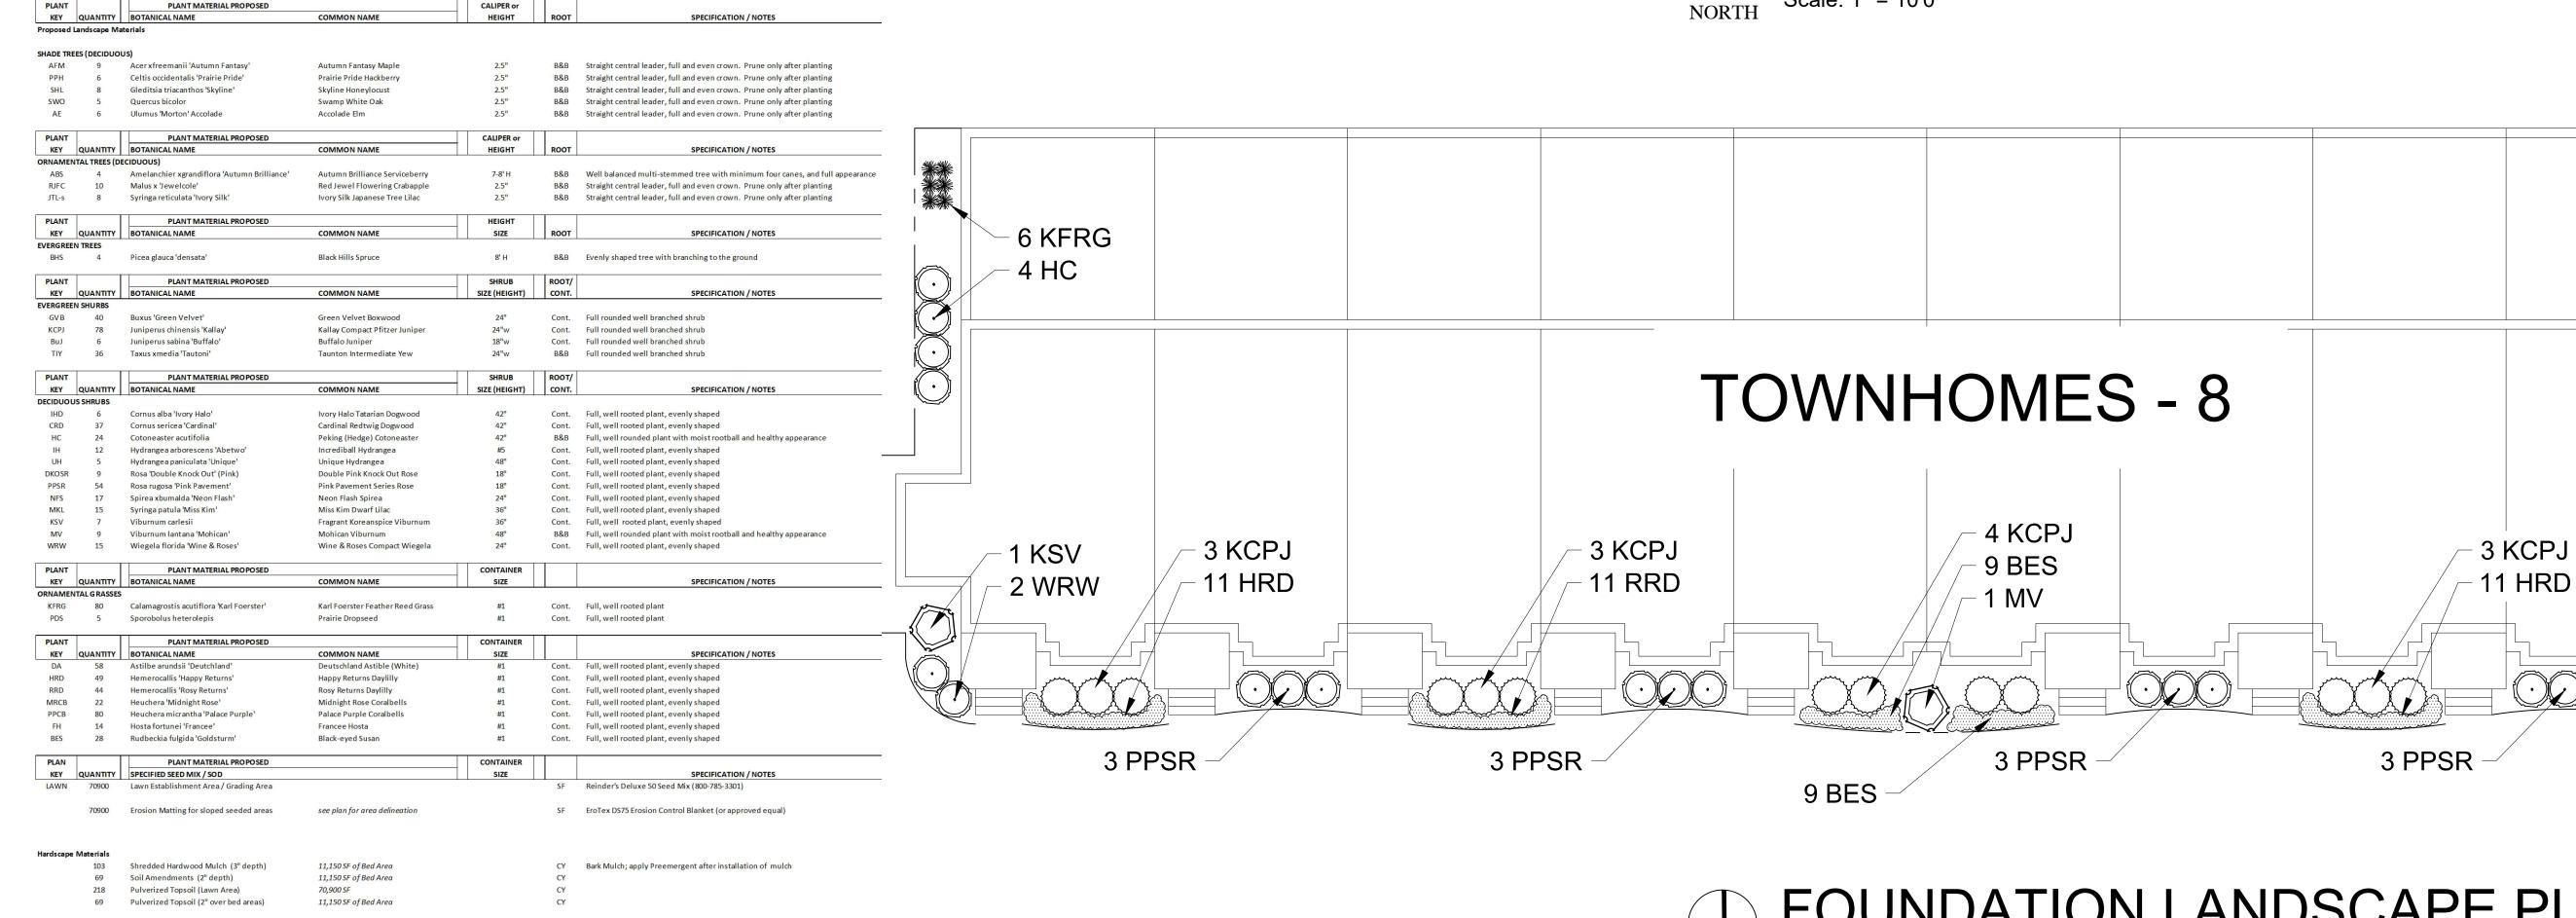

Information contained herein is based on survey information, field inspection, and believed to be accurate.

SHEET TITLE

ENLARGED

LANDSCAPE

FOUNDATION

PLANS: LOT 1

FOUNDATION LANDSCAPE PLAN -OPTION "D"

Scale: 1" = 10'0"

PROJECT MANAGER	WDH
PROJECT NUMBER	19-090
DATE	12.17.17
SHEET NUMBER	

L 1.4

PLANT & MATERIAL SCHEDULE: LOT 1

15% Quebec Perennial Ryegrass

10% Fiesta III Perennial Ryegrass

*Landscape counts & quantities are provided as a service to the Landscape Contractor; Landscape Contractor is responsible for verifying these counts and quantities in order to provide a complete landscape installation as outlined on this Landscape Master Plan. In the event that a discrepancy occurs between this schedule and the Landscape Master Plan, the Landscape Master Plan including the graphics

Seed at rate of 150-200# per acre

SPECIFICATION / NOTES

The City of Madison shall Deine the final locations, sizes & species of

proposed street trees located in the City right-of-way

PLANT KEY	QUANTITY	PLANT MATERIAL PROPOSED BOTANICAL NAME	COMMON NAME	-		ROO	т	SPECIFICATION / NOTES
	treet Trees			1 1		,,,,,		
	26	Shade Trees						The City of Madison shall Deine the final locations, sizes & species of proposed street trees located in the City right-of-way
PLANT		PLANT MATERIAL PROPOSED		-	ALIPER or	200	_	
	QUANTITY andscape Mat	BOTANICAL NAME terials	COMMON NAME		HEIGHT	ROO	Т	SPECIFICATION / NOTES
IADE TDE	ES (DECIDUOU	is)						
ARM	10	Acer xfreemanii 'Armstrong'	Armstrong Red Maple		2.5"	B&B	3 S	Straight central leader, full and even crown. Prune only after planting
GMSM	2	Acer saccharum 'Green Mountain'	Green Mountain Sugar Maple		2.5"	B&B	3 S	Straight central leader, full and even crown. Prune only after planting
SHL	8	Gleditsia triacanthos 'Skyline'	Skyline Honeylocust		2.5"	B&B		Straight central leader, full and even crown. Prune only after planting
AGM SWO	8	Ginkgo biloba 'Autumn Gold' Quercus bicolor	Autumn Gold Maidenhair		2.5" 2.5"	B&B B&B		Straight central leader, full and even crown. Prune only after planting
GSL	6 12	Tilia cordata 'Greenspire'	Swamp White Oak Greenspire Linden		2.5"	B&B		Straight central leader, full and even crown. Prune only after planting Straight central leader, full and even crown. Prune only after planting
AE	8	Ulumus 'Morton' Accolade	Accolade Elm		2.5"	B&B		Straight central leader, full and even crown. Prune only after planting
PLANT		PLANT MATERIAL PROPOSED		C	ALIPER or			
- NAC - C	QUANTITY	BOTANICAL NAME	COMMON NAME		HEIGHT	ROO	т	SPECIFICATION / NOTES
TFC	TAL TREES (DE 1	Malus sargentii 'Tina'	Tina Flowering Crabapple		7-8' H	B&B	3 V	Well balanced multi-stemmed tree with minimum four canes, and full appearance
PLANT		PLANT MATERIAL PROPOSED			HEIGHT			
KEY	QUANTITY	BOTANICAL NAME	COMMON NAME		SIZE	ROO	т	SPECIFICATION / NOTES
ERGREEN		Diago aleigo	Name of Company		OLL	D 0 D		Second to the second decrease of the boson of the second s
NS	2	Picea abies	Norway Spruce		8' H	B&B	3 E	Evenly shaped tree with branching to the ground
PLANT KEY	QUANTITY	PLANT MATERIAL PROPOSED BOTANICAL NAME	COMMON NAME	=	SHRUB E (HEIGHT)	ROOT	-	SPECIFICATION / NOTES
	N SHURBS	DOTANICALINAVIL	COMMON NAME	312	L (HLIOHI)	CON		SPECIFICATION / NOTES
GVB	8	Buxus 'Green Velvet'	Green Velvet Boxwood		24"	Cont	. F	Full rounded well branched shrub
KCPJ	110	Juniperus chinensis 'Kallay'	Kallay Compact Pfitzer Juniper		24"w	Cont		Full rounded well branched shrub
TIY	33	Taxus xmedia 'Tautoni'	Taunton Intermediate Yew		24"w	B&B	3 F	Full rounded well branched shrub
PLANT	CHANTITY	PLANT MATERIAL PROPOSED	COMMON NAME	-	SHRUB	ROOT		CONCURSATION (NOTES
	QUANTITY S SHRUBS	BOTANICALNAME	COMMON NAME	512	E (HEIGHT)	CON	1.	SPECIFICATION / NOTES
CRD	36	Cornus sericea 'Cardinal'	Cardinal Redtwig Dogwood		42"	Cont	t. F	Full, well rooted plant, evenly shaped
IH	40	Hydrangea arborescens 'Abetwo'	Incrediball Hydrangea		#5	Cont		Full, well rooted plant, evenly shaped
UH	6	Hydrangea paniculata 'Unique'	Unique Hydrangea		48"	Cont		Full, well rooted plant, evenly shaped
GLS	12	Rhus aromatica 'Gro-Low'	Gro Low Fragrant Sumac		18-24"	Cont		Full, well rooted plant, evenly shaped
PPSR AWS	56 11	Rosa rugosa 'Pink Pavement' Spirea xbumalda 'Anthony Waterer'	Pink Pavement Series Rose Anthony Waterer Spirea		18" 24"	Cont		Full, well rooted plant, evenly shaped Full, well rooted plant, evenly shaped
GMS	4	Spirea xbumalda 'Goldmound'	Goldmound Spirea		24"	Cont		Full, well rooted plant, evenly shaped
MKL	16	Syringa patula 'Miss Kim'	Miss Kim Dwarf Lilac		36"	Cont		Full, well rooted plant, evenly shaped
MV	18	Viburnum lantana 'Mohican'	Mohican Viburnum		48"	B&B	3 F	Full, well rounded plant with moist rootball and healthy appearance
WRW	24	Wiegela florida 'Wine & Roses'	Wine & Roses Compact Wiegela		24"	Cont	t. F	Full, well rooted plant, evenly shaped
PLANT		PLANT MATERIAL PROPOSED		СС	ONTAINER			
	QUANTITY TAL GRASSES	BOTANICALNAME	COMMON NAME		SIZE			SPECIFICATION / NOTES
KFRG	52	Calamagrostis acutiflora 'Karl Foerster'	Karl Foerster Feather Reed Grass		#1	Cont	t. F	Full, well rooted plant
PLANT		PLANT MATERIAL PROPOSED		СС	ONTAINER			
	QUANTITY	BOTANICAL NAME	COMMON NAME		SIZE			SPECIFICATION / NOTES
HRD	US PERENNIAI 132	حے Hemerocallis 'Happy Returns'	Happy Returns Daylilly		#1	Cont	F	Full, well rooted plant, evenly shaped
RRD	126	Hemerocallis 'Rosy Returns'	Rosy Returns Daylilly		#1	Cont		Full, well rooted plant, evenly shaped
PPCB	48	Heuchera micrantha 'Palace Purple'	Palace Purple Coralbells		#1	Cont	t. F	Full, well rooted plant, evenly shaped
FH	30	Hosta fortunei 'Francee'	Francee Hosta		#1	Cont	t. F	Full, well rooted plant, evenly shaped
PLAN	CHANTITY	PLANT MATERIAL PROPOSED		cc	ONTAINER			CDECIFICATION / NOTES
LAWN	QUANTITY 60600	SPECIFIED SEED MIX / SOD Lawn Establishment Area / Grading Area			SIZE	SF	R	SPECIFICATION / NOTES Reinder's Deluxe 50 Seed Mix (800-785-3301)
	60600	Erosion Matting for sloped seeded areas	see plan for area delineation			SF	F	EroTex DS75 Erosion Control Blanket (or approved equal)
	00000	closion matching for sloped seeded dreas	see parryor area defined torr			31	_	Liotex 2070 Elosion control Blanker (or approved equal)
ardscape	Materials							
•	104	Shredded Hardwood Mulch (3" depth)	11,190 SF of Bed Area			CY	В	Bark Mulch; apply Preemergent after installation of mulch
	69	Soil Amendments (2" depth)	11, 190 SF of Bed Area			CY		
	186 69	Pulverized Topsoil (Lawn Area) Pulverized Topsoil (2" over bed areas)	60, 600 SF 11, 190 SF of Bed Area			CY CY		
	0.5			Landscan	e Contractor is		le for ve	verifying these counts and quantities in order to provide a complete landscape
			pe Master Plan. In the event that a discrepand	cy occurs b		hedule an	d the L	andscape Master Plan, the Landscape Master Plan- including the graphics
		Seed Compositions:						
		Reinder's Deluxe 50 Seed Mix (800-785-3301): 20% Kentucky Bluegrass (Sod Quality) 15% Newport Kentucky Bluegrass	15% Quebec Perennial Ryegrass 10% Fiesta III Perennial Ryegrass			Seeda	at rate	e of 150-200# per acre

15% Ken Blue Kentucky Bluegrass 25% Creeping Red Fescue

PLANT & MATERIAL SCHEDULE: LOT 2

Site Landscape Calculations

Five (5) landscape points per 300 SF of total developed area

	LOT 2
Gross Area of Lot:	210,912 SF
	4.8 Acres
Less Building Footprints (at grade):	(79,848) SF
Less Structure (pool deck):	- SF
Less designated Open Space:	- SF
Less Undeveloped Area:	- SF
Total Developed Area:	131,064 SF
Required Landscape Points:	2,184 Points

Located between the buildings or parking lot and the adjacent street 1 shade tree & 5 shrubs for every 30 linear feet 2 ornamental or evergreen trees may be used to replace 1 shade tree

Existing Plant Credits

LOT 2 1,086 LF Length of Frontage: Required Number of Trees: 36.2 Trees Evergreen Tree 5-6' Tall Number of Trees Shown: 37 Trees Ornamental Tree 1.5" Cal. Required Number of Shrubs: 181.0 Shrubs 14/inch Specimen Tree Number of Shrubs Shown: 181 Shrubs **Total Existing Credits**

Proposed Landscape Points

Grass/Perennial 8-18"(#1)

Total Landscape Points Provided

Туре	Min. Size	Points	Quantity	Points
Shade Tree	2.5" DBH	35	54	1,890
Evergreen Tree	5-6' Tall	35	2	70
Ornamental Tree	1.5" Cal.	15	0	0
Upright EG Shrub	3-4' Tall	10	0	0
Deciduous Shrub	12-24"(#3)	3	226	678
Evergreen Shrub	12-24"(#3)	4	147	588

Area of Parking Area: Required Landscape Area: Landscape Area Shown:

Number of Trees Shown:

8% of parking area shall be devoted to interior landscape area One (1) shade tree for every 160 SF of interior landscape area 2 ornamental trees may be used to replace 1 shade tree, max. 25%


35,274 SF 2,821.9 SF 14,886 SF Required Number of Trees: 17.6 Trees

Development Frontage Landscaping

Interior Parking Lot Landscaping

CODE REQUIREMENTS

18 Trees

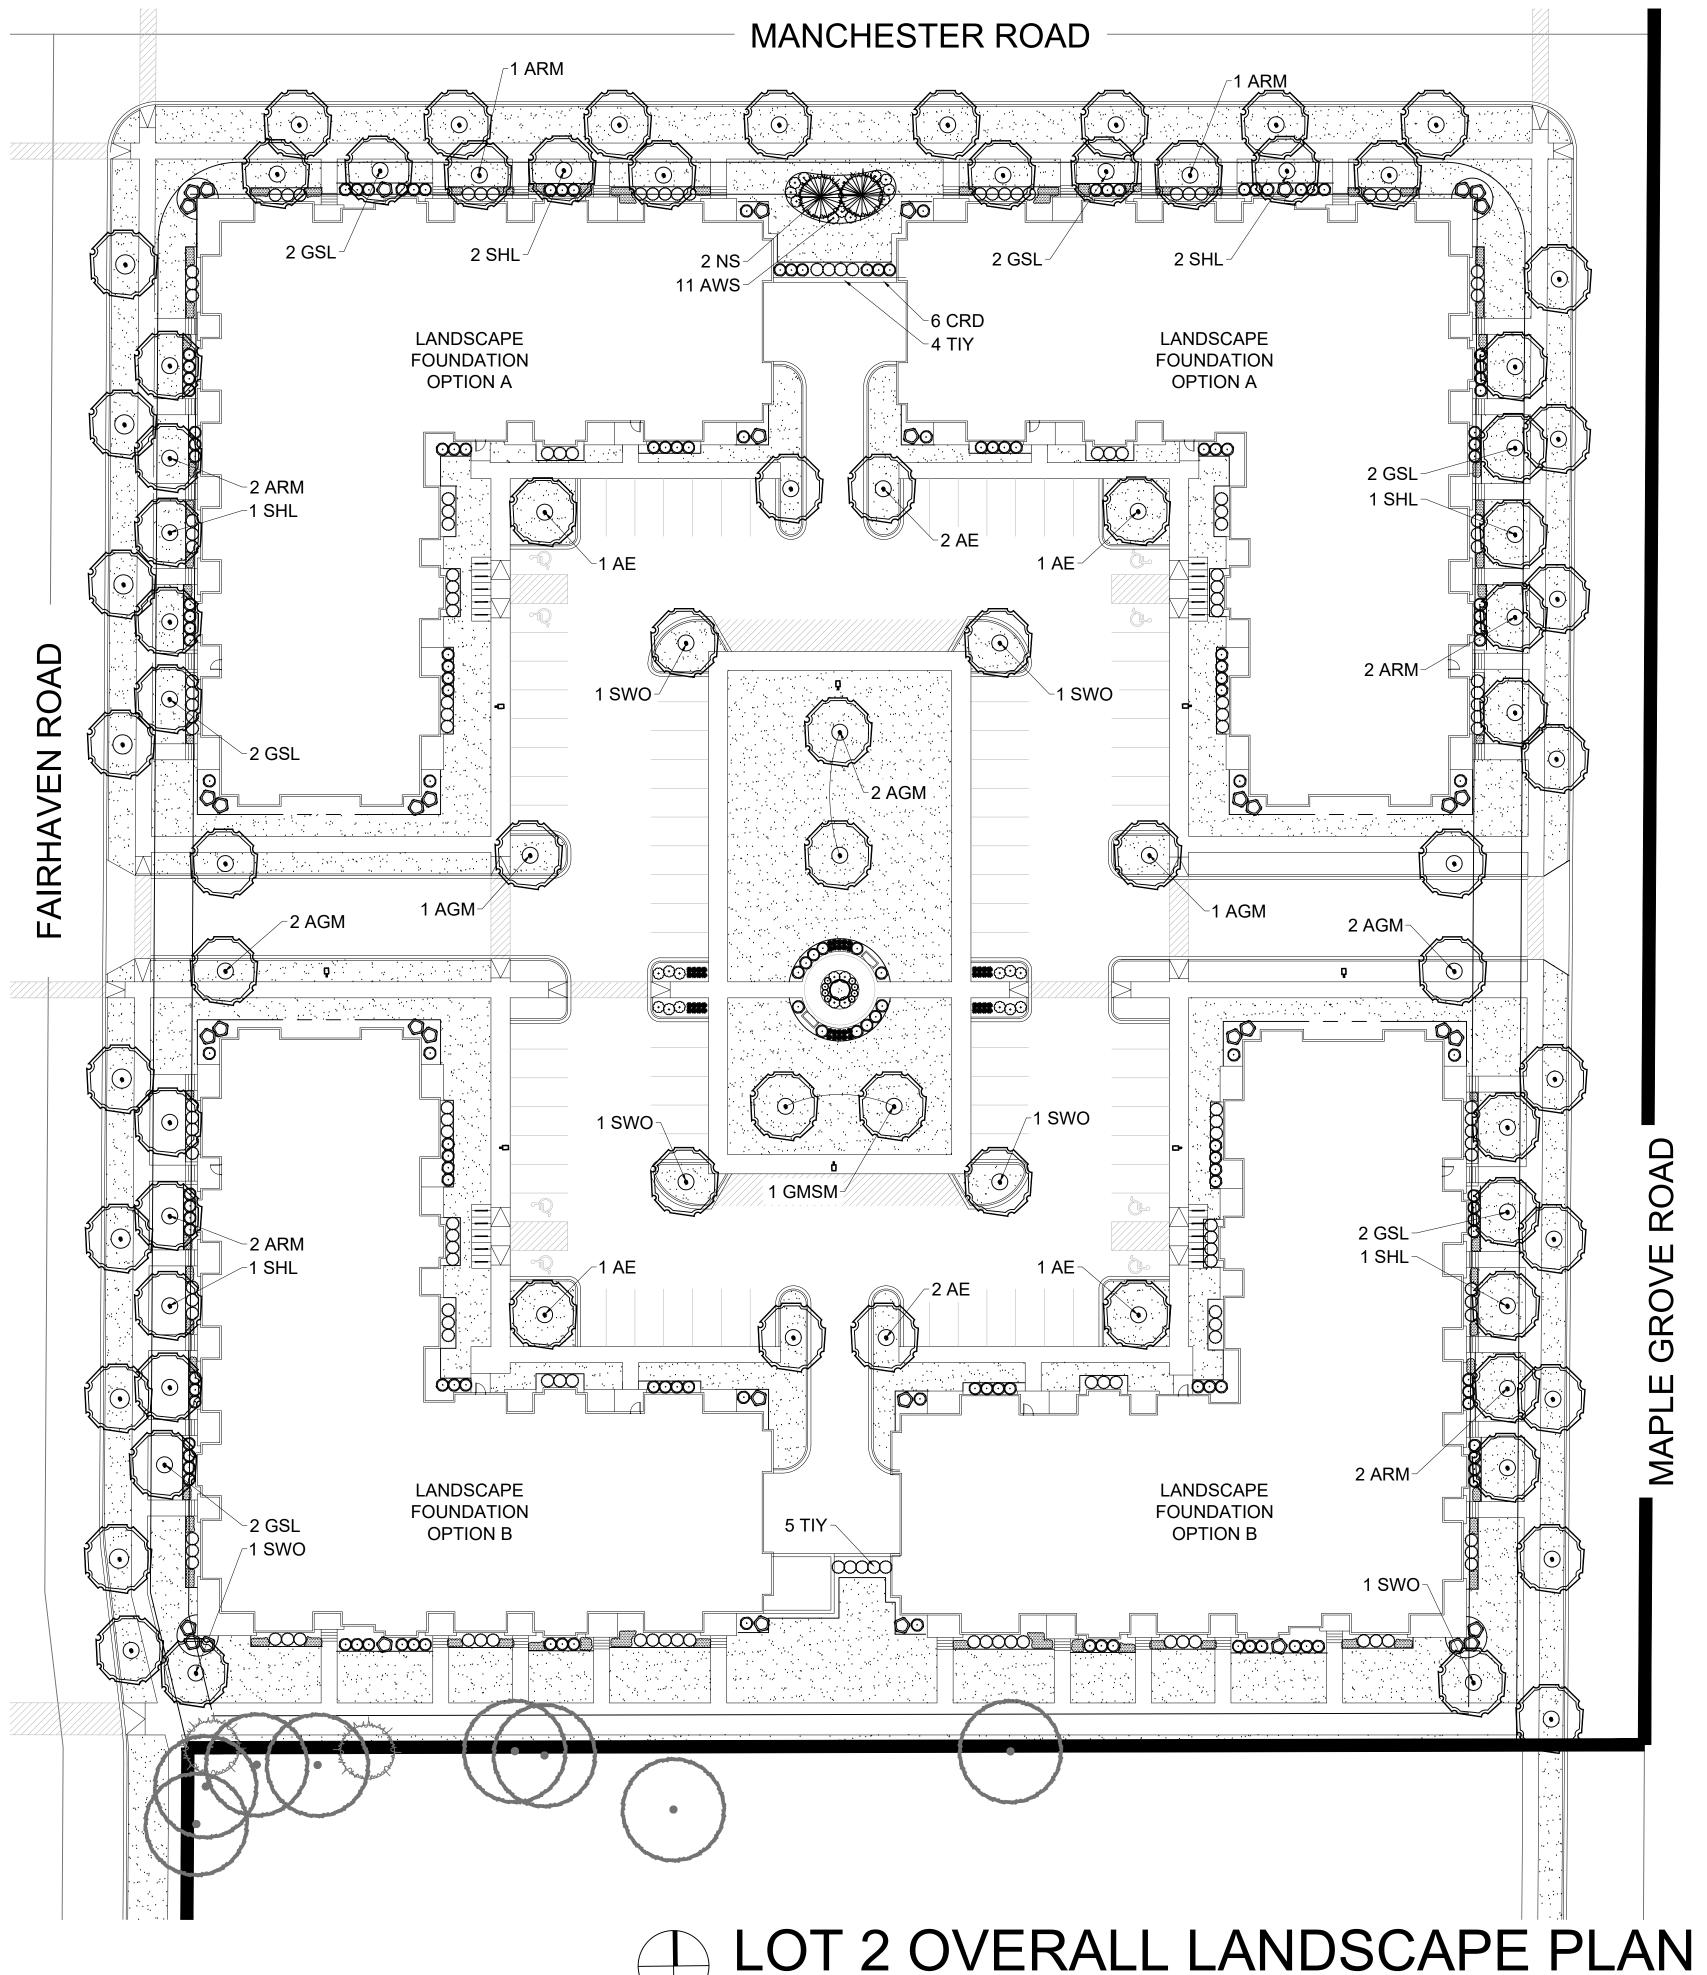

Scale: 1" = 30'0"

OVERALL LANDSCAPE

SHEET TITLE

PLAN: LOT 2

Information contained herein is based on survey information, field

inspection, and believed to be accurate.

MAPLE GROVE

MULTI-FAMILY

Maple Grove Road at

Manchester Road

ISSUANCE AND REVISIONS

12.13.19 ISSUE TO OWNER

DATE DESCRIPTION

12.17.19 SUBMITTAL

Madison, WI

PROJECT MANAGER WDH 19-090 PROJECT NUMBER DATE 12.17.19

SHEET NUMBER


Final determination of location, quantity, size and species of all proposed Street Trees located in the public right-of-way shall be determined by the City of

Madison Department of

Forestry

811 or 1-800-242-8511
MILW. AREA 259-1181
WIS STATUTE 182.0175(1974)
REQUIRES MIN. 3 WORK DAYS
NOTICE BEFORE YOU EXCAVATE



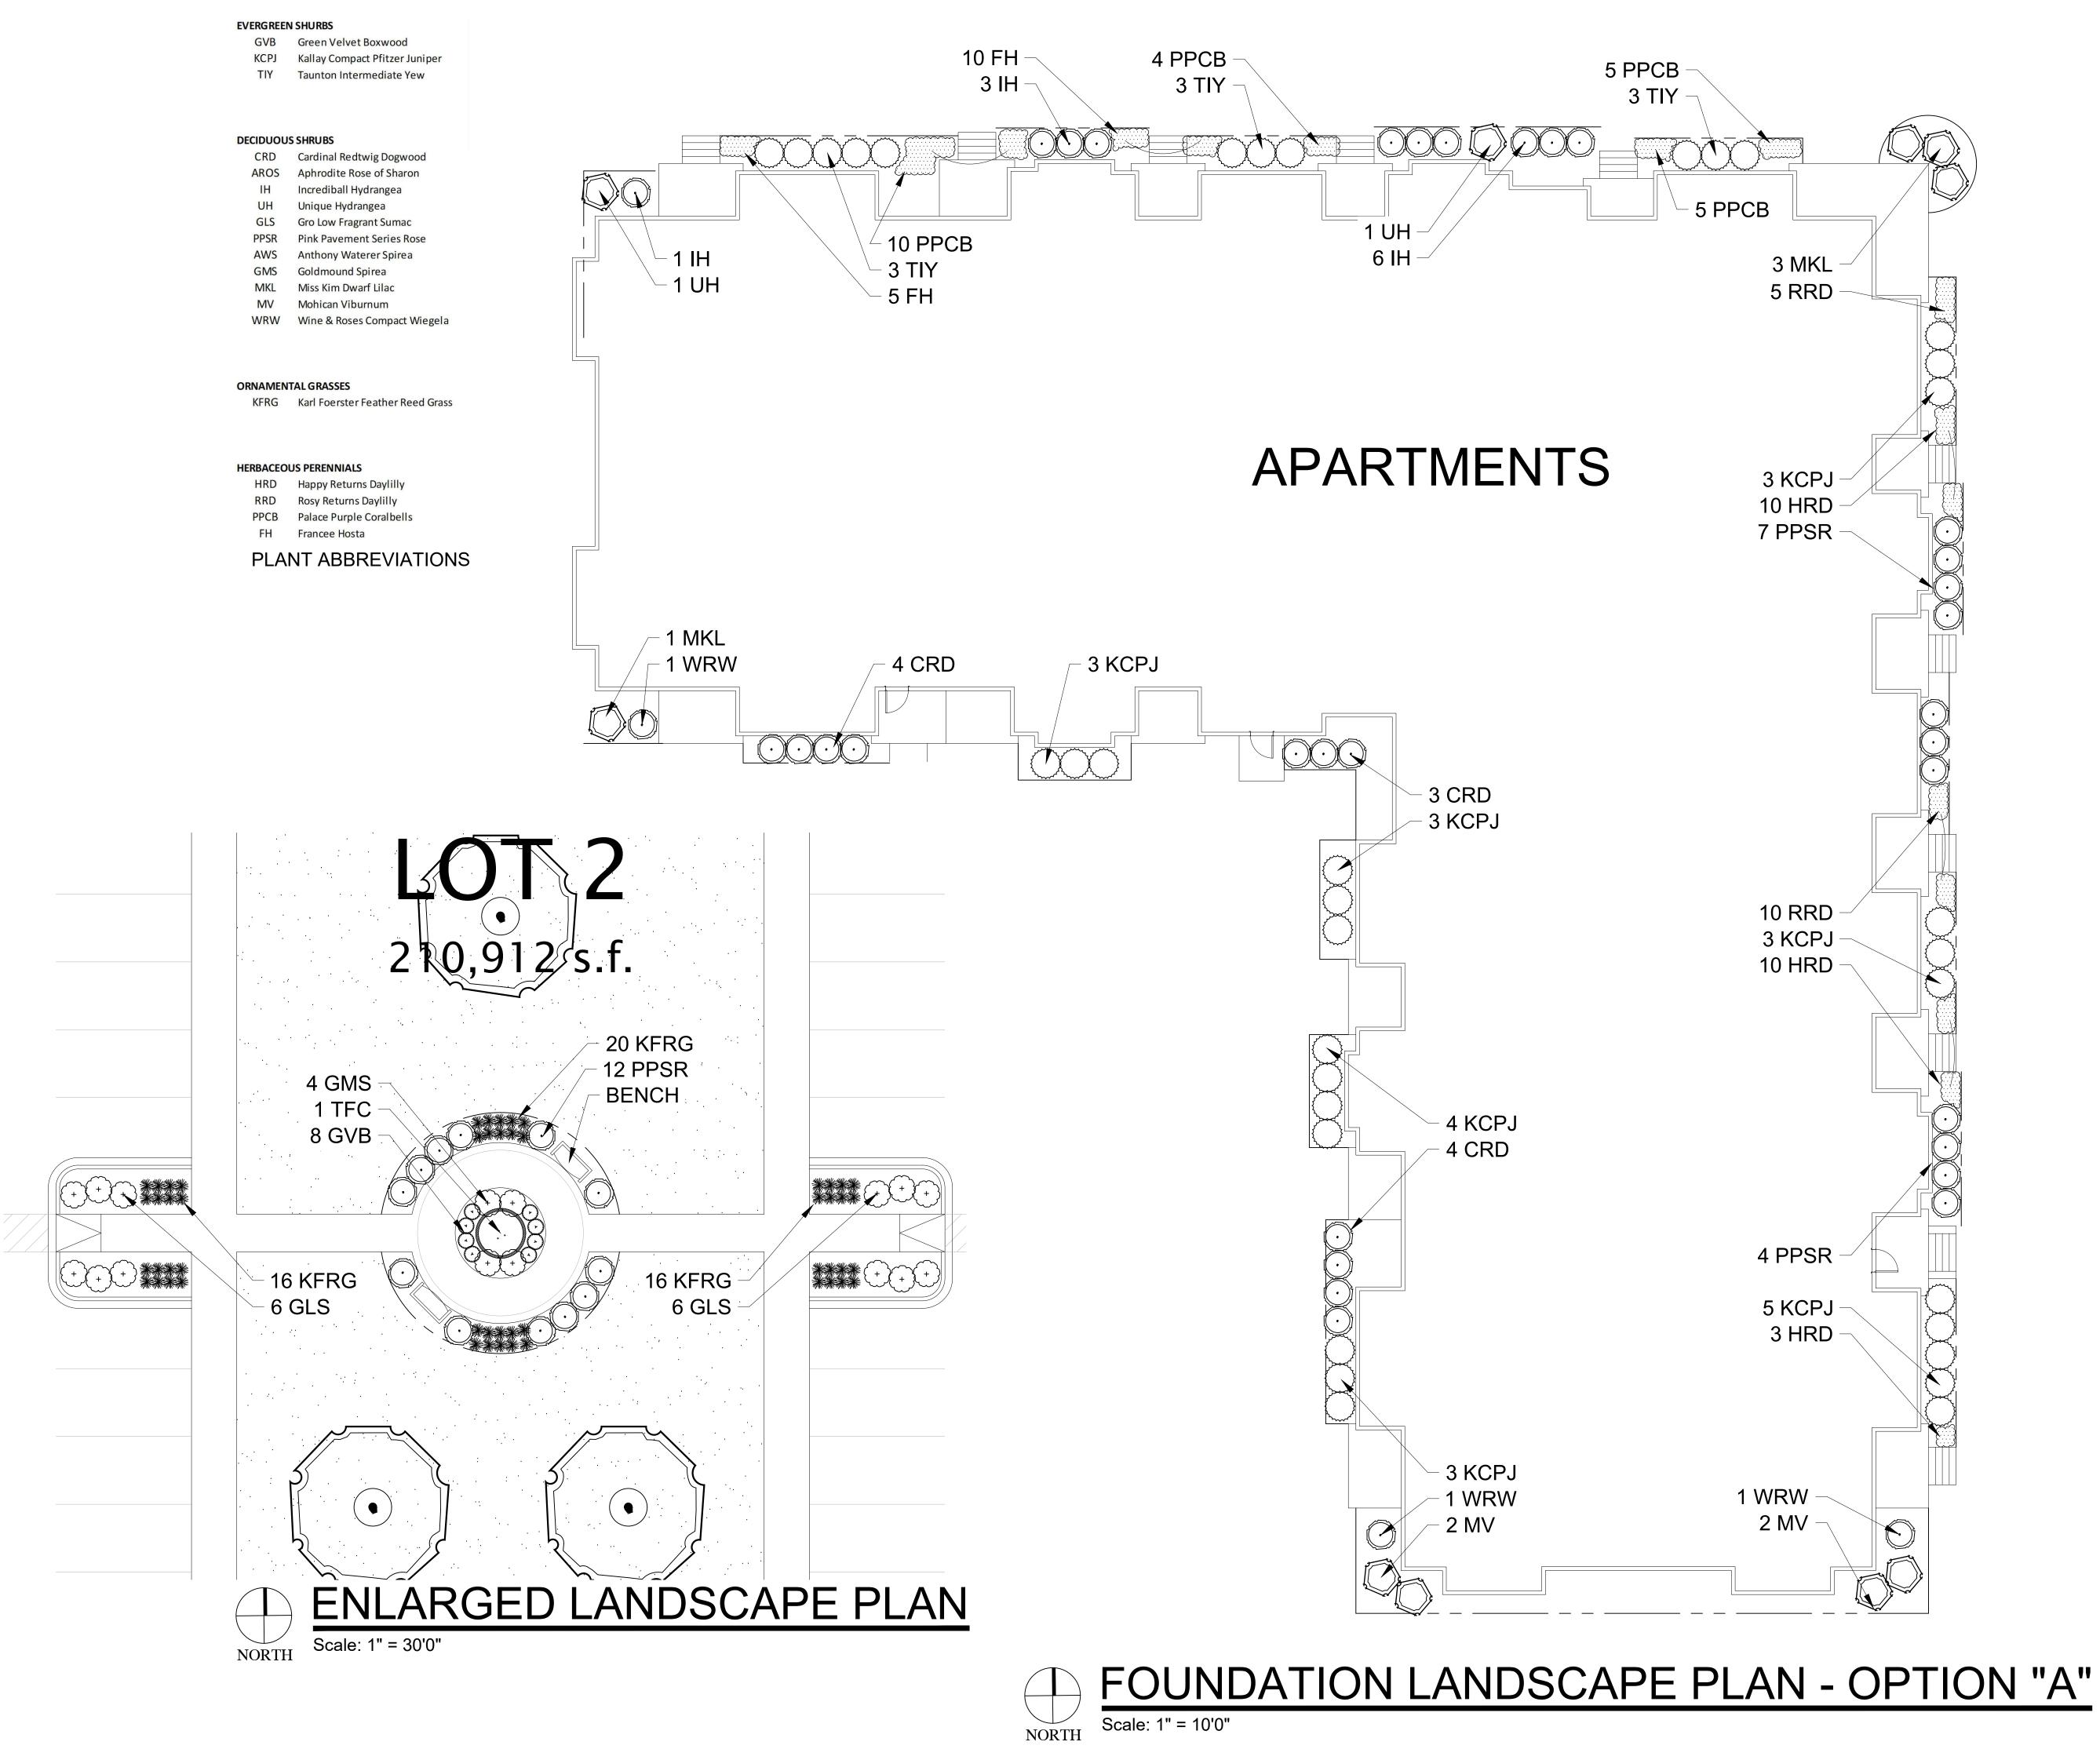

HELLER & ASSOCIATES, LILANDSCAPE ARCHITECTUR
P.O. Box 1359
Lake Geneva, Wisconsin 53147-1359



PROJECT

MAPLE GROVE MULTI-FAMILY

Maple Grove Road at Manchester Road Madison, WI

ISSUANCE AND REVISIONS

DATE	DESCRIPTION
	ISSUE TO OWNER SUBMITTAL

Information contained herein is based on survey information, field inspection, and believed to be accurate.

ENLARGED
APARTMENT
FOUNDATION
LANDSCAPE
PLAN: OPTION


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PROJECT NUMBER	19

DATE

SHEET NUMBER

L 1.6

12.17.19

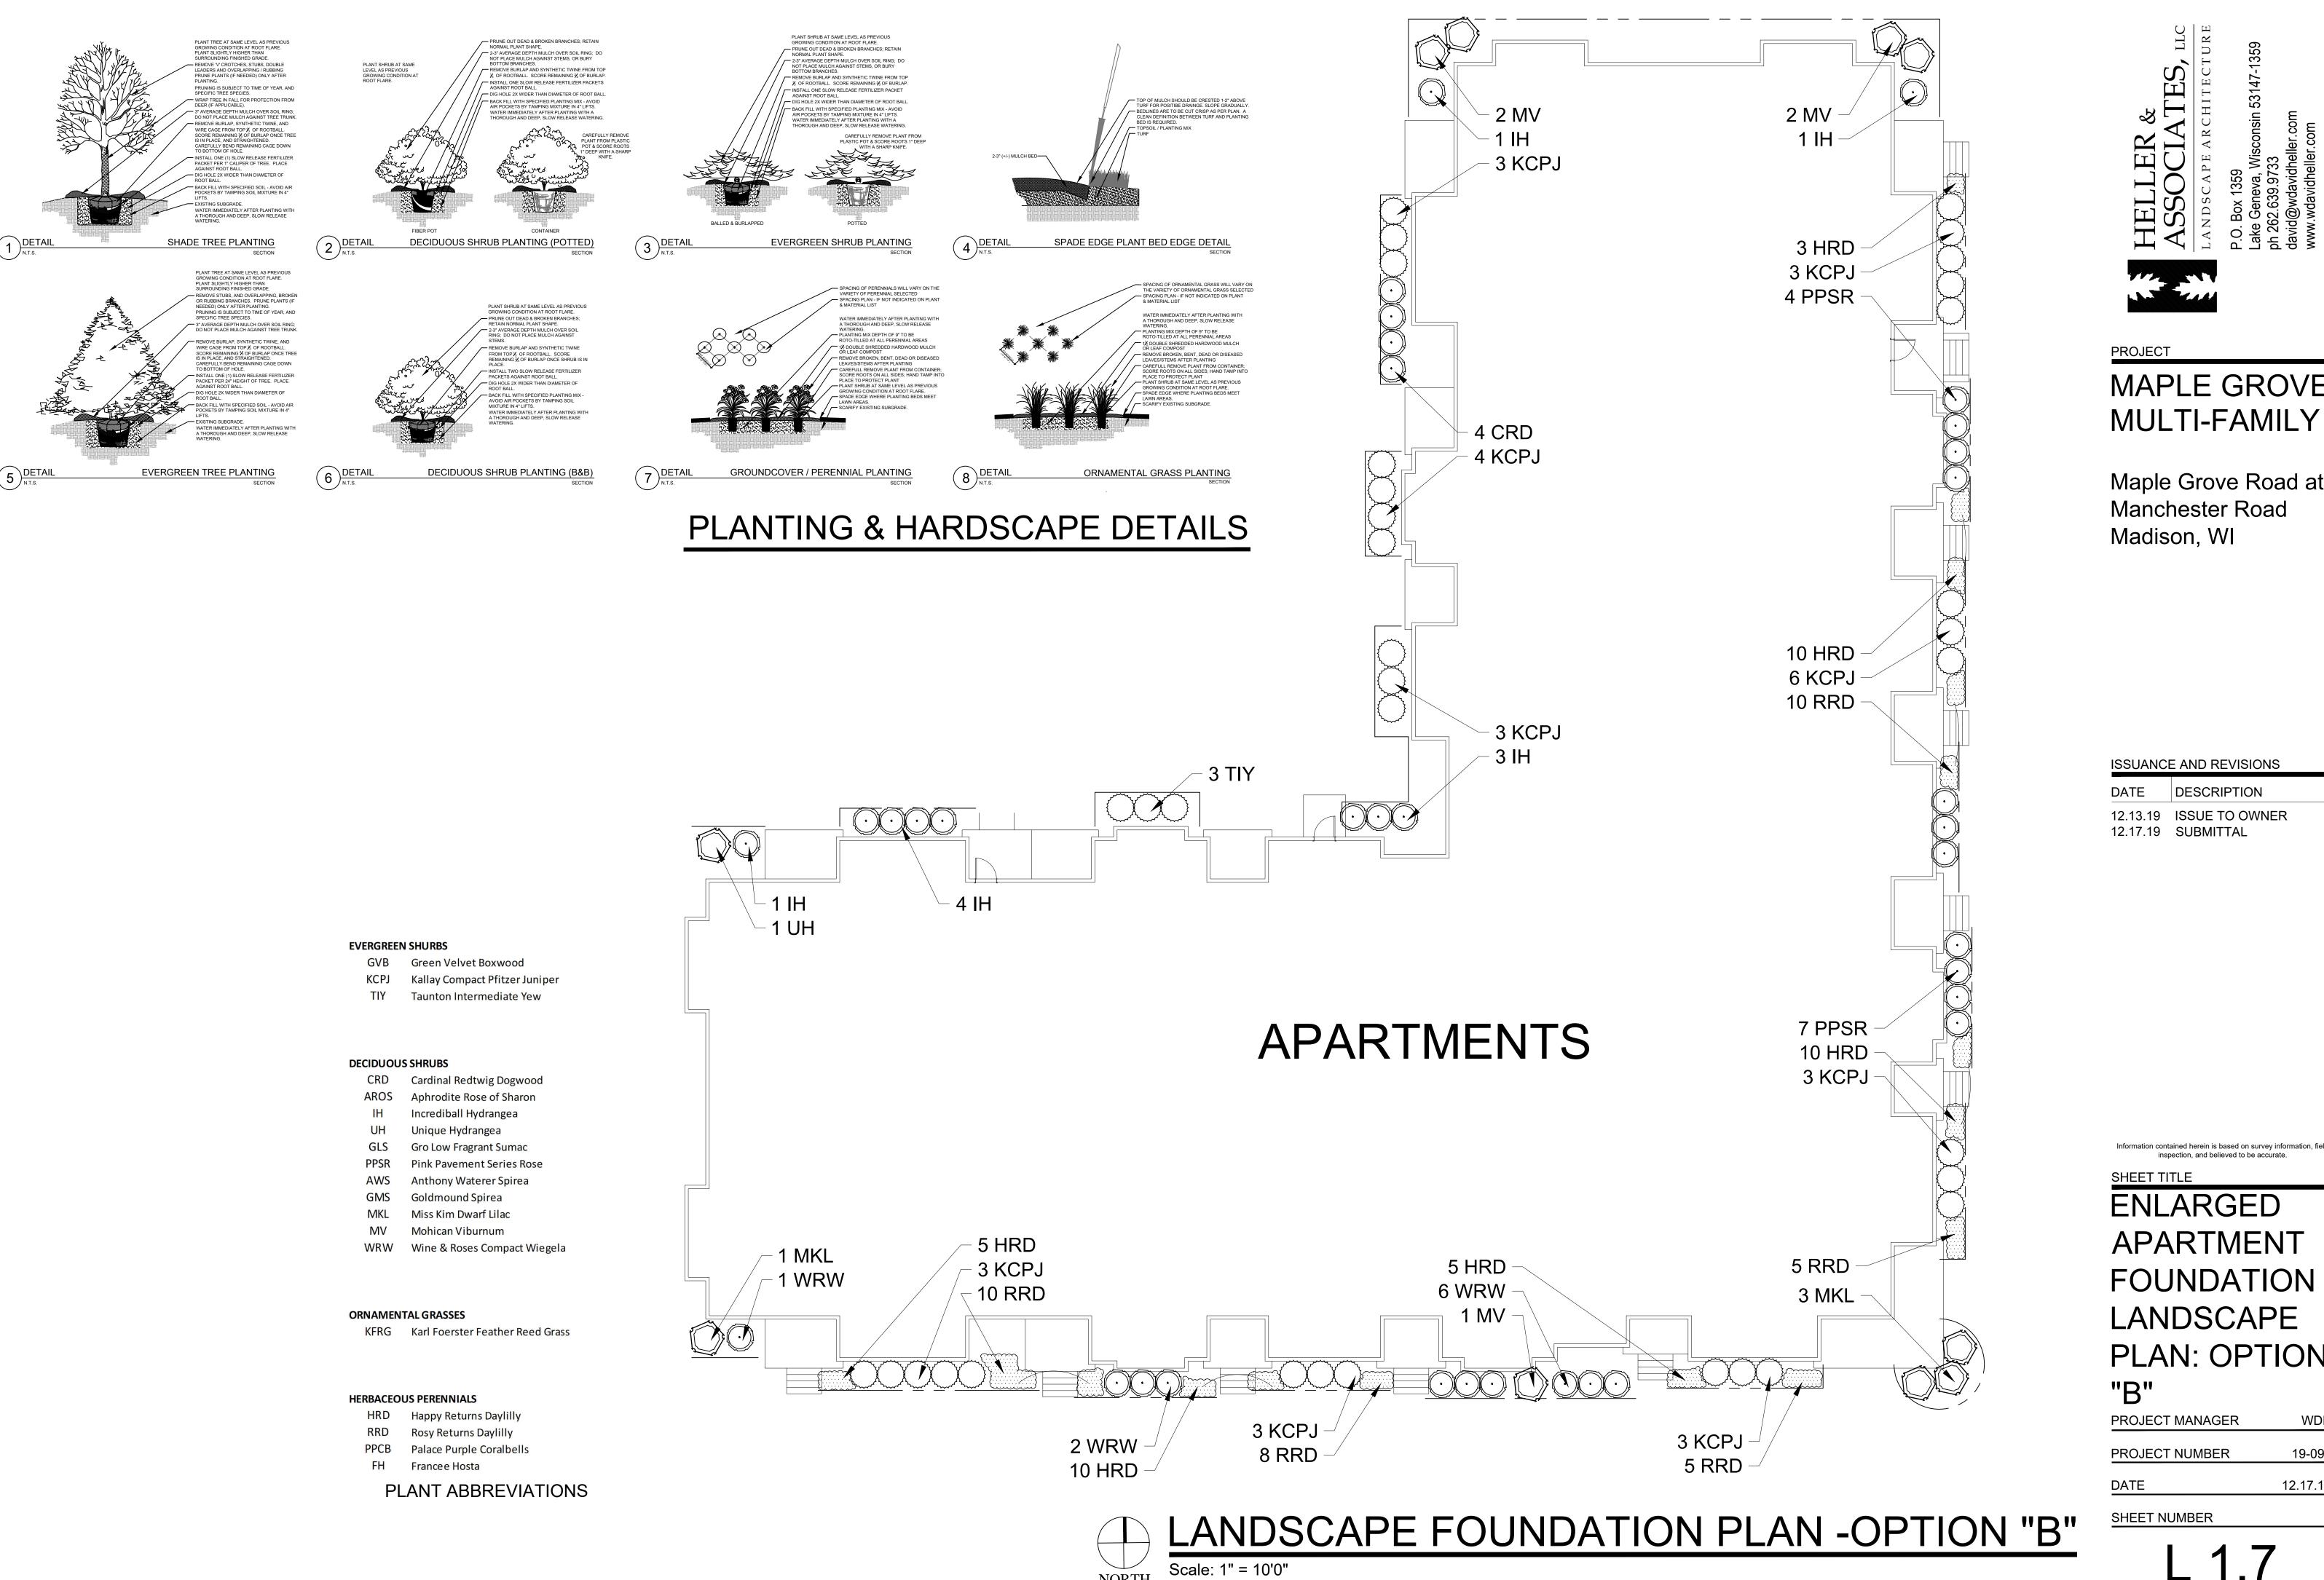

NORTH

MAPLE GROVE

Maple Grove Road at Manchester Road Madison, WI

ISSUANCE AND REVISIONS

DATE DESCRIPTION 12.13.19 ISSUE TO OWNER 12.17.19 SUBMITTAL

Information contained herein is based on survey information, field inspection, and believed to be accurate.

SHEET TITLE

ENLARGED APARTMENT FOUNDATION LANDSCAPE PLAN: OPTION "B"

PROJECT MANAGER PROJECT NUMBER

DATE

SHEET NUMBER

WDH

19-090

12.17.19

PLANT		PLANT MATERIAL PROPOSED				
KEY	QUANTITY	BOTANICAL NAME	COMMON NAME	7	ROOT	SPECIFICATION / NOTES
roposed :	Street Trees					
	29	Shade Trees				The City of Madison shall Deine the final locations, sizes & species of
	2	Ornamental Trees				proposed street trees located in the City right-of-way
DIANT		DI ANITAMATERIAL PROPOSER		CALIBER		
PLANT KEY	QUANTITY	PLANT MATERIAL PROPOSED BOTANICAL NAME	COMMON NAME	CALIPER or HEIGHT	ROOT	SPECIFICATION / NOTES
	Landscape Mat	1	COMMON NAME	ПЕІОПІ	ROUT	SPECIFICATION / NOTES
Торозси	Lanascape ivia					
HADE TRE	ES (DECIDUOU	S)				
GMSM	6	Acer saccharum 'Green Mountain'	Green Mountain Sugar Maple	2.5"	B&B	Straight central leader, full and even crown. Prune only after planting
PPH	8	Celtis occidentalis 'Prairie Pride'	Prairie Pride Hackberry	2.5"	B&B	Straight central leader, full and even crown. Prune only after planting
AGM	7	Ginkgo biloba 'Autumn Gold'	Autumn Gold Maidenhair	2.5"	B&B	Straight central leader, full and even crown. Prune only after planting
GSL	7	Tilia cordata 'Greenspire'	Greenspire Linden	2.5"	B&B	Straight central leader, full and even crown. Prune only after planting
	1			T	1 1 1	
PLANT	OLIANITITY	PLANT MATERIAL PROPOSED	COMMON NAME	HEIGHT	POOT	SDECIEICATION / NOTES
KEY VERGREE	QUANTITY N TREES	BOTANICAL NAME	COMMON NAME	SIZE	ROOT	SPECIFICATION / NOTES
BHS	2	Picea glauca 'densata'	Black Hills Spruce	8' H	B&B	Evenly shaped tree with branching to the ground
		-	,			
PLANT		PLANT MATERIAL PROPOSED		SHRUB	ROOT/	
KEY	QUANTITY	BOTANICAL NAME	COMMON NAME	SIZE (HEIGHT)	CONT.	SPECIFICATION / NOTES
	N SHURBS	luninomus ohi namaia Wallaul	Kallay Carrena et Bitter au luci	O #11	C	Full rounded well browship dishard
KCPJ	36	Juniperus chinensis 'Kallay'	Kallay Compact Pfitzer Juniper	24"w	Cont.	Full rounded well branched shrub
TIY	18	Taxus xmedia 'Tautoni'	Taunton Intermediate Yew	24"w	B&B	Full rounded well branched shrub
PLANT		PLANT MATERIAL PROPOSED		SHRUB	ROOT/	
KEY	QUANTITY	BOTANICAL NAME	COMMON NAME	SIZE (HEIGHT)	CONT.	SPECIFICATION / NOTES
ECIDUOL	JS SHRUBS					
IH	12	Hydrangea arborescens 'Abetwo'	Incrediball Hydrangea	#5	Cont.	Full, well rooted plant, evenly shaped
UH	8	Hydrangea paniculata 'Unique'	Unique Hydrangea	48"	Cont.	Full, well rooted plant, evenly shaped
SJW	30	Hypericum kalmianum	St. Johnswort	24"	Cont.	Full, well rooted plant, evenly shaped
PPSR	20	Rosa rugosa 'Pink Pavement'	Pink Pavement Series Rose	18"	Cont.	Full, well rooted plant, evenly shaped
AWS	16	Spirea xbumalda 'Anthony Waterer'	Anthony Waterer Spirea	24"	Cont.	Full, well rooted plant, evenly shaped
MKL	8	Syringa patula 'Miss Kim'	Miss Kim Dwarf Lilac	36"	Cont.	Full, well rooted plant, evenly shaped
KSV	8	Viburnum carlesii	Fragrant Koreanspice Viburnum	36"	Cont.	Full, well rooted plant, evenly shaped
WRW	4	Wiegela florida 'Wine & Roses'	Wine & Roses Compact Wiegela	24"	Cont.	Full, well rooted plant, evenly shaped
DIANT	1	DI ANTAMATERIAL PROPOSER		CONTAINED		
PLANT KEY	QUANTITY	PLANT MATERIAL PROPOSED BOTANICAL NAME	COMMON NAME	CONTAINER SIZE		SPECIFICATION / NOTES
	ITAL GRASSES	POTUNICALIMITE	COMMON NAME	JILL	1 1	Si Edification / NOTES
PDS	72	Sporobolus heterolepis	Prairie Dropseed	#1	Cont.	Full, well rooted plant
	 			T	 	
PLAN	OHANTER	PLANT MATERIAL PROPOSED		CONTAINER		CRECIFICATION (NOTES
KEY LAWN	QUANTITY 27800	SPECIFIED SEED MIX / SOD Lawn Establishment Area / Grading Area		SIZE	SF	SPECIFICATION / NOTES Reinder's Deluxe 50 Seed Mix (800-785-3301)
LAVVIN	2/000	Lawii Establisiillelit Aled / Glauffig Afed			35	Venirael 3 Delaye 30 Seed IAIIX (000-103-330T)
	27800	Erosion Matting for sloped seeded areas	see plan for area delineation		SF	EroTex DS75 Erosion Control Blanket (or approved equal)
		_	, -			
lardscape	Materials					
	46	Shredded Hardwood Mulch (3" depth)	5,150SF of Bed Area		CY	Bark Mulch; apply Preemergent after installation of mulch
	30	Soil Amendments (2" depth)	5,150SF of Bed Area		CY	
	86	Pulverized Topsoil (Lawn Area)	27,800 SF		CY	
	30	Pulverized Topsoil (2" over bed areas)	5,150SF of Bed Area		CY	

installation as outlined on this Landscape Master Plan. In the event that a discrepancy occurs between this schedule and the Landscape Master Plan, the Landscape Master Plan- including the graphics and notations depicted therein-shall govern.

Seed Compositions:

25% Creeping Red Fescue

Reinder's Deluxe 50 Seed Mix (800-785-3301): 20% Kentucky Bluegrass (Sod Quality) 15% Newport Kentucky Bluegrass 15% Ken Blue Kentucky Bluegrass

15% Quebec Perennial Ryegrass

10% Fiesta III Perennial Ryegrass

PLANT & MATERIAL SCHEDULE: LOT 3

Seed at rate of 150-200# per acre

Site Landscape Calculations

Five (5) landscape points per 300 SF of total developed area

	LOT 3
Gross Area of Lot:	71,092 SF
	1.6 Acres
Less Building Footprints (at grade):	(22,692) SF
Less Structure (pool deck):	- SF
Less designated Open Space:	- SF
Less Undeveloped Area:	- SF
Total Developed Area:	48,400 SF
Required Landscape Points:	807 Points

Existing Plant Credits

Туре	Min. Size	Points	Quantity	Points
Shade Tree	2.5" DBH	35		0
Evergreen Tree	5-6' Tall	35		0
Ornamental Tree	1.5" Cal.	15		0
Specimen Tree		14/inch		
Total Existing Cre	dits			0

Proposed Landscape Points

Туре	Min. Size	Points	Quantity	Points
Shade Tree	2.5" DBH	35	28	980
Evergreen Tree	5-6' Tall	35	2	70
Ornamental Tree	1.5" Cal.	15	0	0
Upright EG Shrub	3-4' Tall	10	0	0
Deciduous Shrub	12-24"(#3)	3	91	273
Evergreen Shrub	12-24"(#3)	4	60	240
Grass/Perennial	8-18"(#1)	2	60	120
Total Landscape P	oints Provid	led		1,683

Development Frontage Landscaping

Located between the buildings or parking lot and the adjacent street 1 shade tree & 5 shrubs for every 30 linear feet 2 ornamental or evergreen trees may be used to replace 1 shade tree


	LOT 3
Length of Frontage:	785 LF
Required Number of Trees:	26.2 Trees
Number of Trees Shown:	26 Trees
Required Number of Shrubs:	130.9 Shrubs
Number of Shrubs Shown:	131 Shrubs

Interior Parking Lot Landscaping

8% of parking area shall be devoted to interior landscape area One (1) shade tree for every 160 SF of interior landscape area 2 ornamental trees may be used to replace 1 shade tree, max. 25%

Area of Parking Area:	5,055	SF
Required Landscape Area:	404.4	SF
Landscape Area Shown:	408	SF
Required Number of Trees:	2.5	Trees
Number of Trees Shown:	3	Trees

CODE REQUIREMENTS

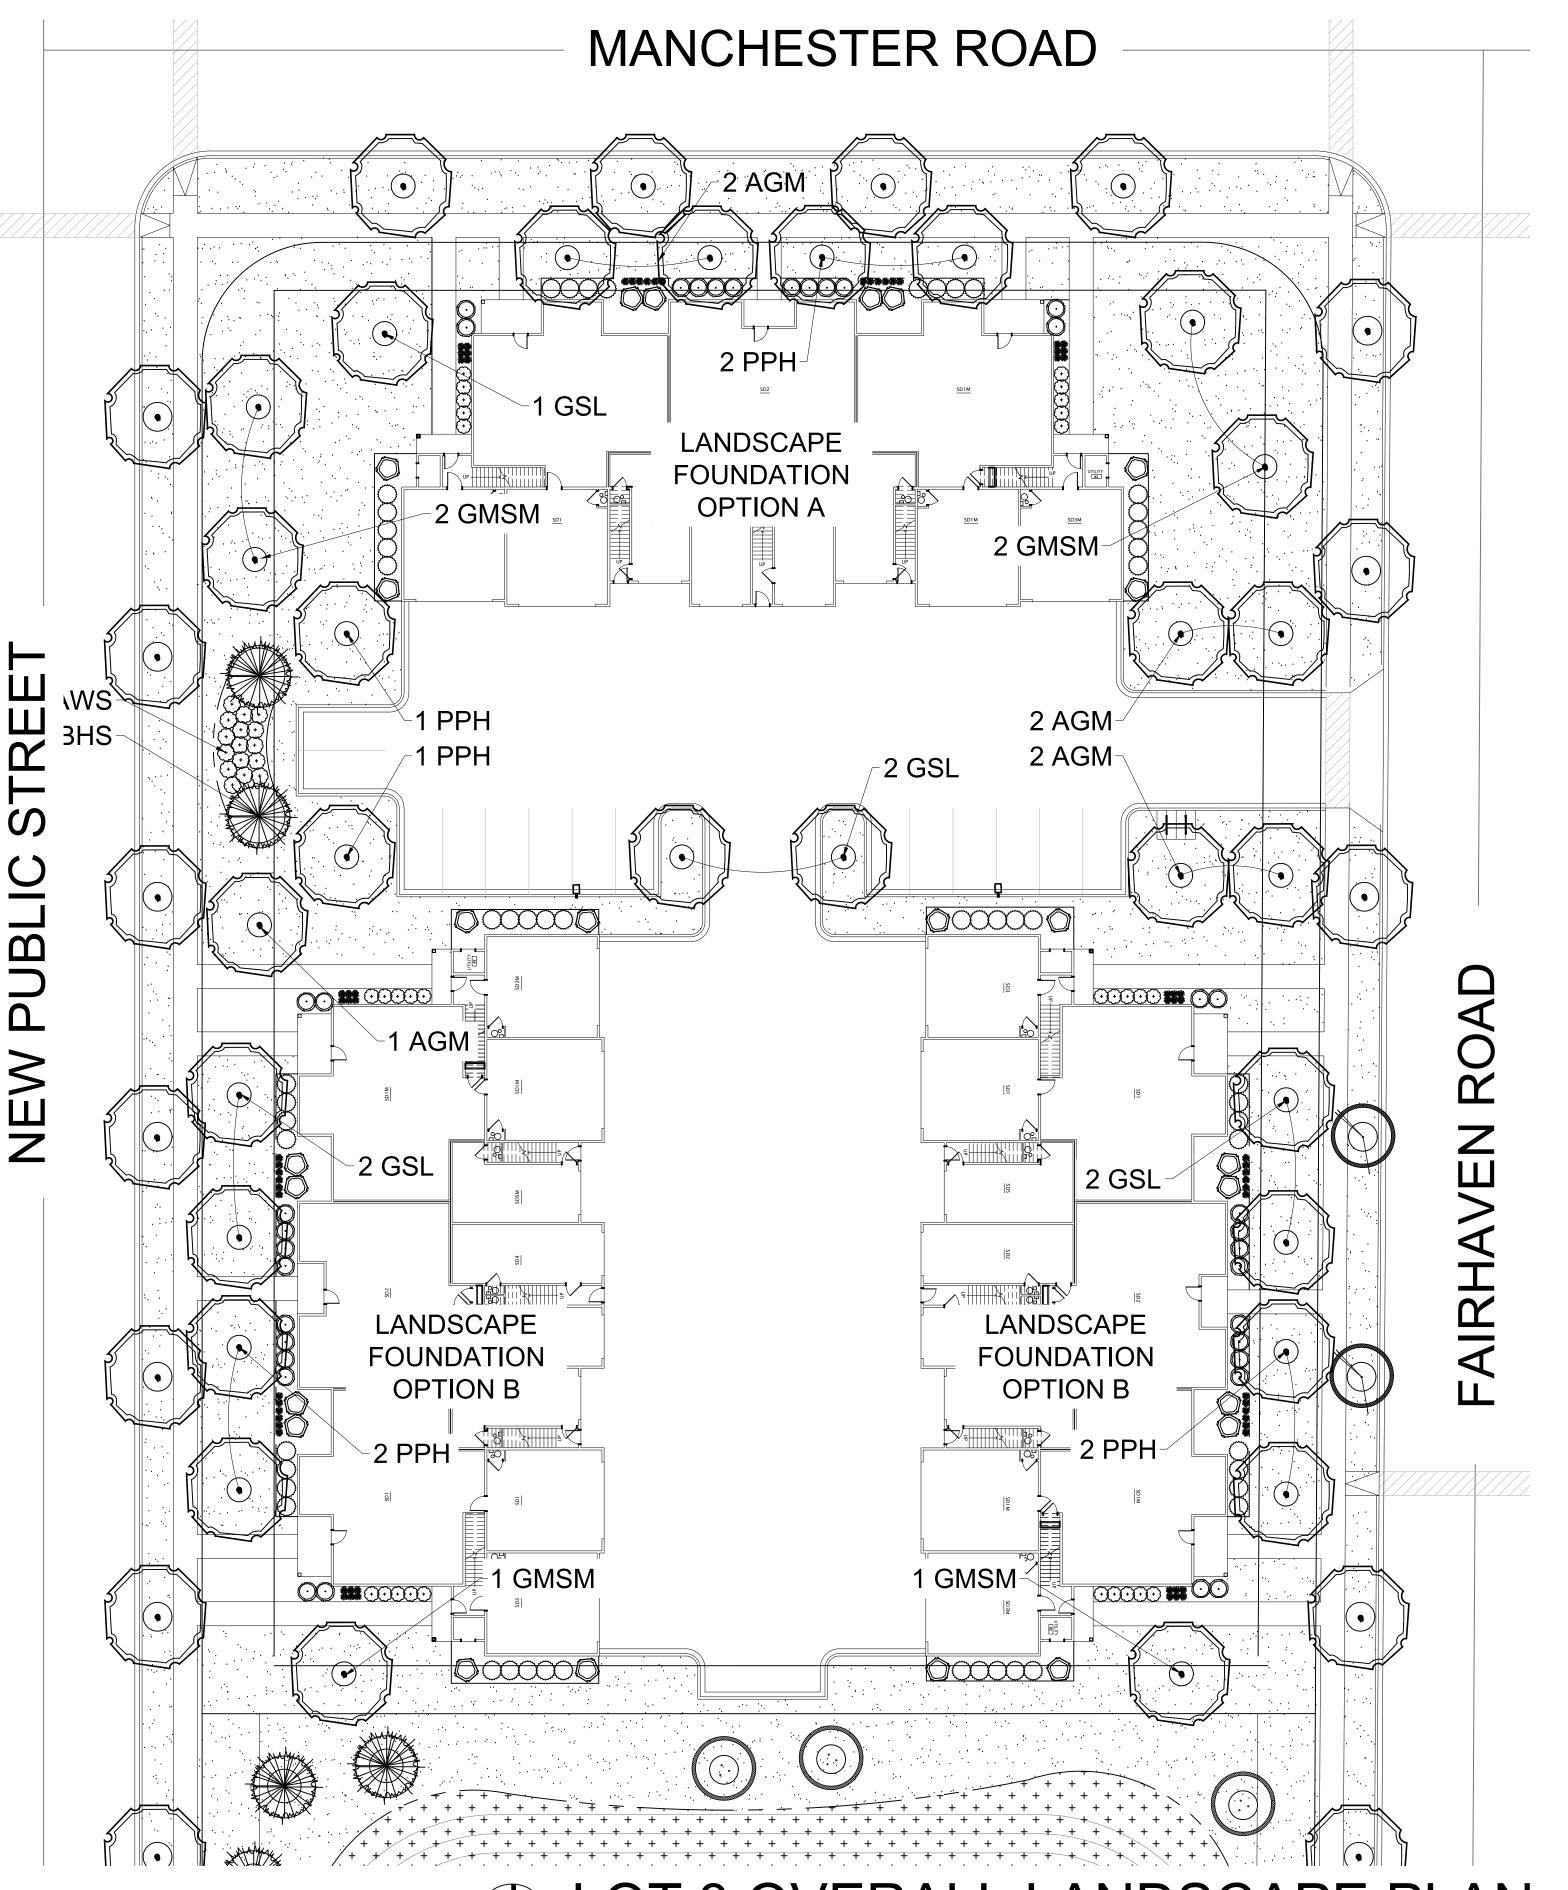

LOT 3 OVERALL LANDSCAPE PLAN

Scale: 1" = 20'0"

Final determination of location, quantity, size and species of all proposed Street Trees located in the public right-of-way shall be determined by the City of Madison Department of Forestry



MAPLE GROVE **MULTI-FAMILY**

Maple Grove Road at Manchester Road Madison, WI

ISSUANCE AND REVISIONS

DATE DESCRIPTION 12.13.19 ISSUE TO OWNER 12.17.19 SUBMITTAL

> Information contained herein is based on survey information, field inspection, and believed to be accurate.

SHEET TITLE

OVERALL LANDSCAPE PLAN: LOT 3

PROJECT MANAGER WDH PROJECT NUMBER 19-090 12.17.19 DATE

SHEET NUMBER





EVERGREEN SHURBS

Kallay Compact Pfitzer Juniper Taunton Intermediate Yew

DECIDUOUS SHRUBS

Unique Hydrangea Pink Pavement Series Rose Anthony Waterer Spirea

Incrediball Hydrangea

Miss Kim Dwarf Lilac Fragrant Koreanspice Viburnum

Wine & Roses Compact Wiegela

ORNAMENTAL GRASSES

KFRG Karl Foerster Feather Reed Grass

Prairie Dropseed

PLANT ABBREVIATIONS

- 1. Contractor responsible for contacting Diggers Hotline (811 or 800-242-8511) to have site marked prior to excavation or planting.
- 2. Contractor to verify all plant quantities shown on Plant & Material List and landscape planting symbols and report any discrepancies to Landscape Architect or
- 3. All plantings shall comply with standards as described in American Standard of Nursery Stock Z60.1 ANSI (latest version). Landscape Architect reserves the right to inspect, and potentially reject any plants that are inferior, compromised, undersized, diseased, improperly transported, installed incorrectly or damaged. No sub-standard "B Grade" or "Park Grade" plant material shall be accepted. Plant material shall originate from nursery(ies) with a similar climate as the planting site.
- 4. Any potential plant substitutions must be approved by Landscape Architect or Owner. All plants must be installed as per sizes indicated on Plant & Material Schedule, unless approved by Landscape Architect. Any changes to sizes shown on plan must be submitted in writing to the Landscape Architect prior to installation.
- 5. Topspoil in Parking Lot Islands (if applicable): All parking lot islands to be backfilled with topsoil to a minimum depth of 18" to insure long-term plant health. Topsoil should be placed within 3" of finish grade by General Contractor / Excavation Contractor during rough grading operations/activity. The landscape contractor shall be responsible for the fine grading of all disturbed areas, planting bed areas, and lawn areas. Crown all parking lot islands a minimum of 6" to provide proper drainage, unless otherwise specified.
- 6. Tree Planting: Plant all trees slightly higher than finished grade at the root flare. Remove excess soil from the top of the root ball, if needed. Remove and discard non-biodegradable ball wrapping and support wire. Removed biodegradable burlap and wire cage (if present) from the top $\frac{1}{3}$ of the rootball and carefully bend remaining wire down to the bottom of the hole. Once the tree has been placed into the hole and will no longer be moved, score the remaining $\frac{2}{3}$ of the burlap and remove the twine. Provide three slow release fertilizer for each tree planted.
- 7. Tree Planting: Backfill tree planting holes 80% existing soils removed from excavation and 20% plant starter mix. Avoid air pockets and do not tamp soil down. Discard any gravel, rocks, heavy clay, or concrete pieces. When hole is $\frac{2}{3}$ full, trees shall be watered thoroughly, and water left to soak in before proceeding to fill the remainder of the hole. Water again to full soak in the new planting. Each tree shall receive a 3" deep, 4-5' diameter (see planting details or planting plan) shredded hardwood bark mulch ring around all trees planted in lawn areas. Do not build up any mulch onto the trunk of any tree. Trees that are installed incorrectly will be replaced at the time and expense of the Landscape Contractor.
- 8. Shrub Planting: All shrubs to be planted in groupings as indicated on the Landscape Plan. Install with the planting of shrubs a 50/50 mix of plant starter with topsoil. Install topsoil into all plant beds as needed to achieve proper grade and displace undesirable soil (see planting detail). Remove all excessive gravel, clay and stones from plant beds prior to planting. When hole(s) are $\frac{2}{3}$ full, shrubs shall be watered thoroughly, and water left to soak in before proceeding. Provide slow-release fertilizer packets at the rater of 1 per 24" height/diamter of shrub at planting.
- 9. Mulching: All tree and shrub planting beds to receive a 3" deep layer of high quality shredded hardwood bark mulch (not pigment dyed or enviro-mulch). All perennial planting areas (groupings) shall receive a 2" layer of shredded hardwood bark mulch, and groundcover areas a 1-2" layer of the same mulch. Do not mulch annual flower beds (if applicable). Do not allow mulch to contact plant stems and tree trunks.
- 10. Edging: All planting beds shall be edged with a 4" deep spade edge using a flat landscape spade or a mechanical edger. Bedlines are to be cut crisp, smooth as per plan. A clean definition between landscape beds and lawn is required. Pack mulch against lawn edge to hold in place.
- 11. Plant bed preparation/Soil Amendment composition: All perennial, groundcover and annual areas (if applicable) are required to receive a blend of organic soil (Soil Amendments) amendments prior to installation. Roto-till the following materials at the following ratio, into existing soil beds or installed topsoil beds to a depth of approximately 8"-10". Containerized and balled & burlapped plant material should be back-filled with amended soil:


Per 100 SF of bed area (Soil Amendment composition):

- 3/4 CY Peat Moss or Mushroom Compost
- 3/4 CY blended/pulverized Topsoil ½ CY composted manure
- In roto-tilled beds only, also include in above mixture:
- 12. Lawn Installation for all sodded turfgrass areas: Contractor to furnish and prepare blended topsoil (2" minimum) and sod bed, removing all debris and stones ½" and larger. Apply a 10-10-10 starter lawn fertilizer uniformly throughout areas prior to laying sod. Use only premium sod blend according to TPI (revised 1995) and ASPA Standards. Install sod uniformly with staggered joints, laid tightly end to end and side to side. Roll sod with a walk behind roller and water immediately upon installation to a 3" depth. Stake any sod installed on slopes steeper than 1:3, and in all swale applications. Contractor is responsible to provide a smooth, uniform, healthy turf, and is responsible for the first two mowings of the newly installed turf, and is also responsible for watering during this
- 13. Installation preparation for all seeded areas: remove/kill off any existing unwanted vegetation prior to seeding. Prepare the topsoil (if adequate or provide as in item #6 above) and seed bed by removing all surface stones 1" or larger. Apply a starter fertilizer and specified seed uniformly at the specified rate, and provide mulch covering suitable to germinate and establish turf. Provide seed and fertilizer specifications to Landscape Architect and Owner prior to installation. Erosion control measures are to be used in swales and on slopes in excess of 1:3 and where applicable (see Civil Engineering Drawings). Methods of installation may vary are the discretion of the Landscape Contractor on his/her responsibility to establish and guarantee a smooth, uniform, quality turf. A minimum of 2" of blended, prepared and non-compacted topsoil is required for all lawn areas. If straw mulch is used as a mulch covering, a tackifier may be necessary to avoid wind dispersal of mulch covering. Marsh hay containing reed canary grass is NOT acceptable as a mulch covering.


An acceptable quality seed installation is defined as having:

- No bare spots larger than one (1) square foot No more than 10% of the total area with bare areas larger than one (1) square foot
- A uniform coverage through all turf areas
- 14. No-Mow seed areas: "No-Mow" fine fescue seed mix with annual rye nurse crop (available at Cedar Creek Seed Farm 888-313-6807; or Prairie Nursery 608-296-3679) or approved equivalent mix from a reputable seed mix provider. Apply at 220 lbs per acre or at rate recommended by supplier. Prepare seed bed and soil as specified in item #13 above.
- 15. Native Prairie Seed Mix / Stormwater Seed Mix: Native seed mixes as listed on the Plant and Material List or other seeding schedules outlined on the landscape plan set. Seed mixes available from Prairie Nursery 608-296-3679 or JF New 608-848-1789 or approved equivalent mix from a reputable seed mix provider. Apply at rates specified herein, or per supplier recommendation. Prepare soil and seed bed as in item #13 above.
- 16. Warranty and Replacements: All plantings are to be watered thoroughly at the time of planting, through construction and upon completion of project as required. Trees, Evergreens, and Shrubs (deciduous and evergreen) shall be guaranteed (100% replacement) for a minimum of one (1) year from the date of project completion. Perennials, groundcovers, and ornamental grasses shall be guaranteed for a minimum of one (1) growing season. Perennials, groundcovers, and ornamental grasses planted after September 15th shall be guaranteed through May 31st of the following year. Only one replacement per plant will be required during the warranty period, except for losses or replacements due to failure to comply with specified requirements. Watering and general ongoing maintenance instructions are to be supplied by the Landscape Contractor to the Owner upon completion of the project.
- 17. The Landscape Contractor is responsible for the watering and maintenance of all landscape areas for a period of 45 days after the substantial completion of the landscape installation. This shall include all trees, shrubs, evergreens, perennials, ornamental grasses, turf grass, no-mow grass, and native prairie seed mix / stormwater seed mix. Work also includes weeding, edging, mulching (only if required), fertilizing, trimming, sweeping up grass clippings, pruning and deadheading.
- 18. Project Completion: Landscape Contractor is responsible to conduct a final review of the project, upon completion, with the Landscape Architect, Client or Owner / Client Representative, and the General Contractor to answer questions, provide written care instructions for new plantings and turf, and insure that all specifications have been met.

LANDSCAPE GENERAL NOTES

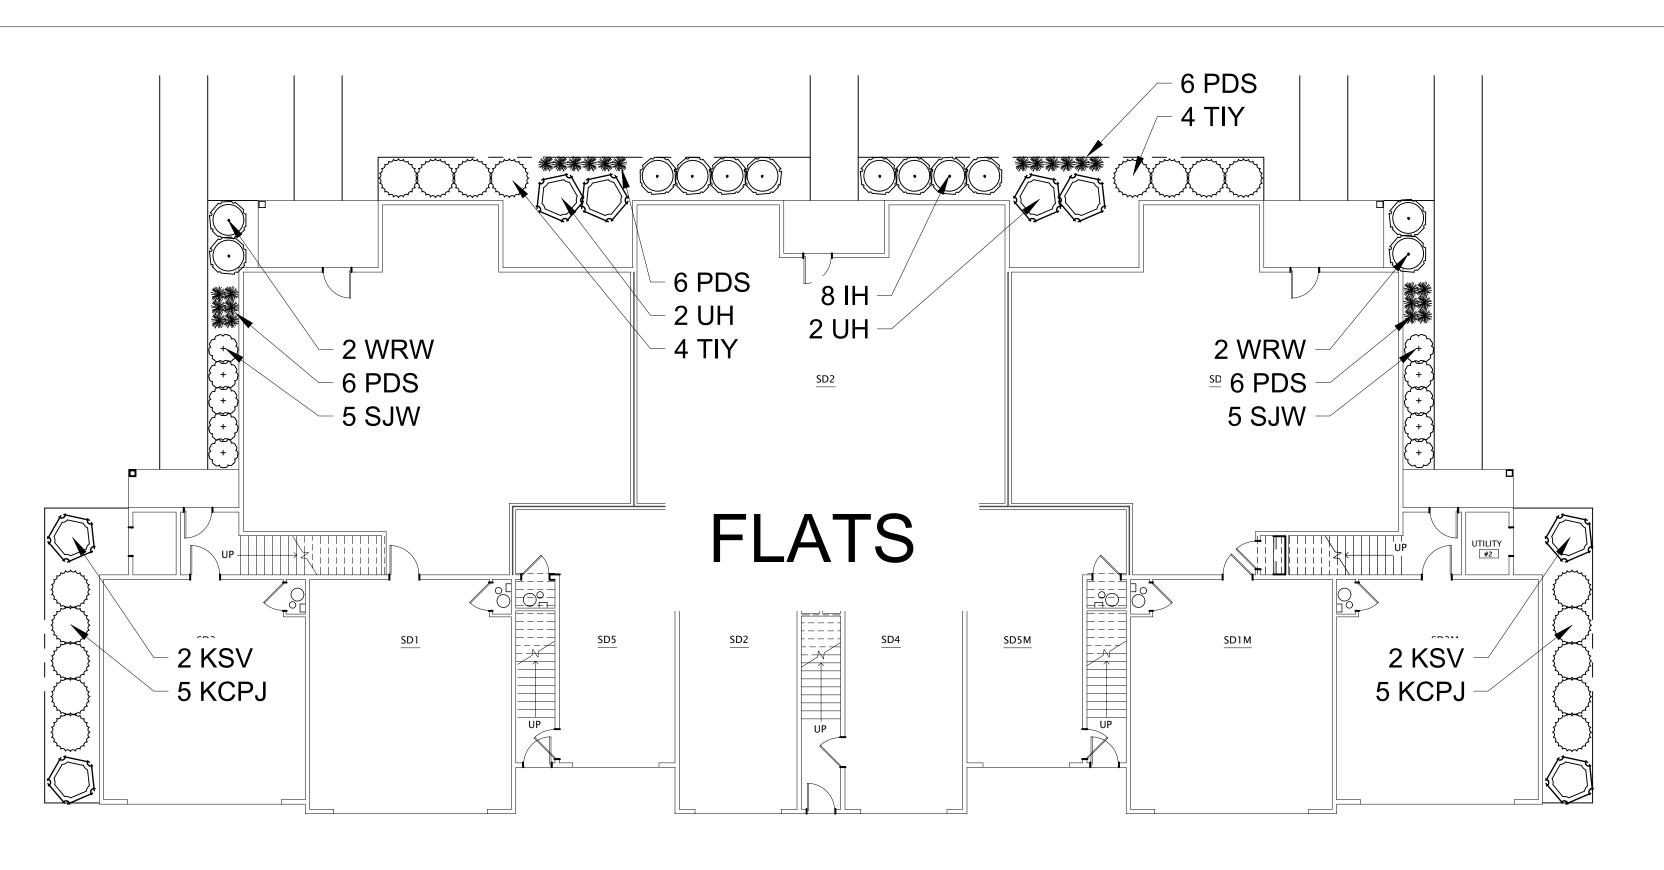



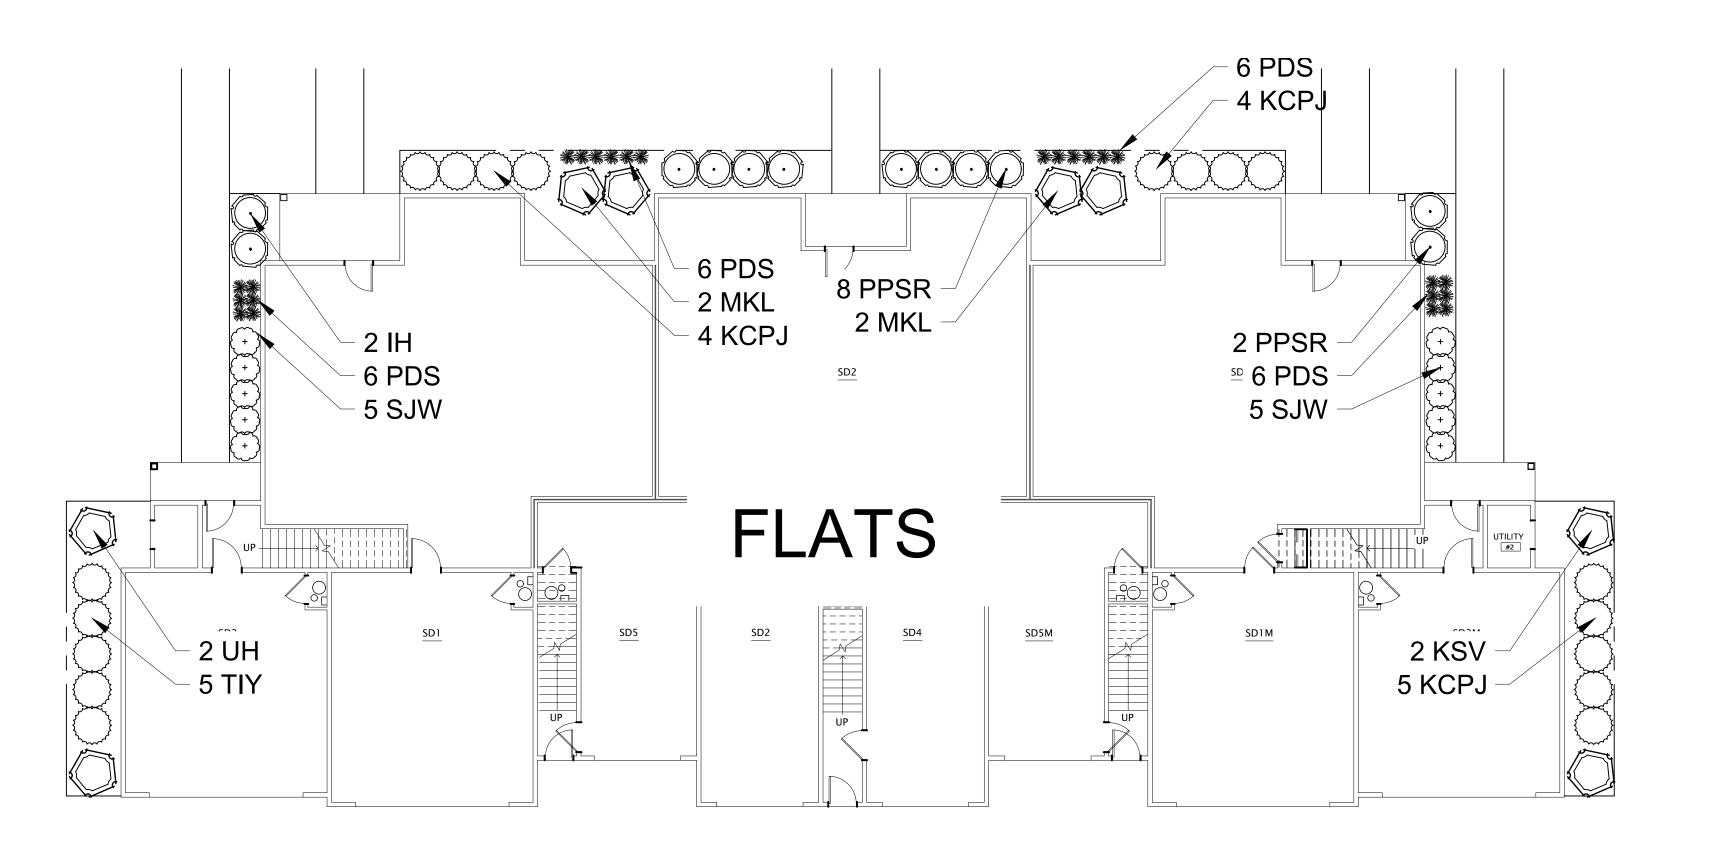



MULTI-FAMILY

MAPLE GROVE

PROJECT

Maple Grove Road at Manchester Road Madison, WI

ISSUANCE AND REVISIONS


DATE DESCRIPTION 12.13.19 ISSUE TO OWNER 12.17.19 SUBMITTAL


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SHEET TITLE **OVERALL** LANDSCAPE PLAN: LOT 3

PROJECT MANAGER PROJECT NUMBER 19-090 DATE 12.17.19

SHEET NUMBER



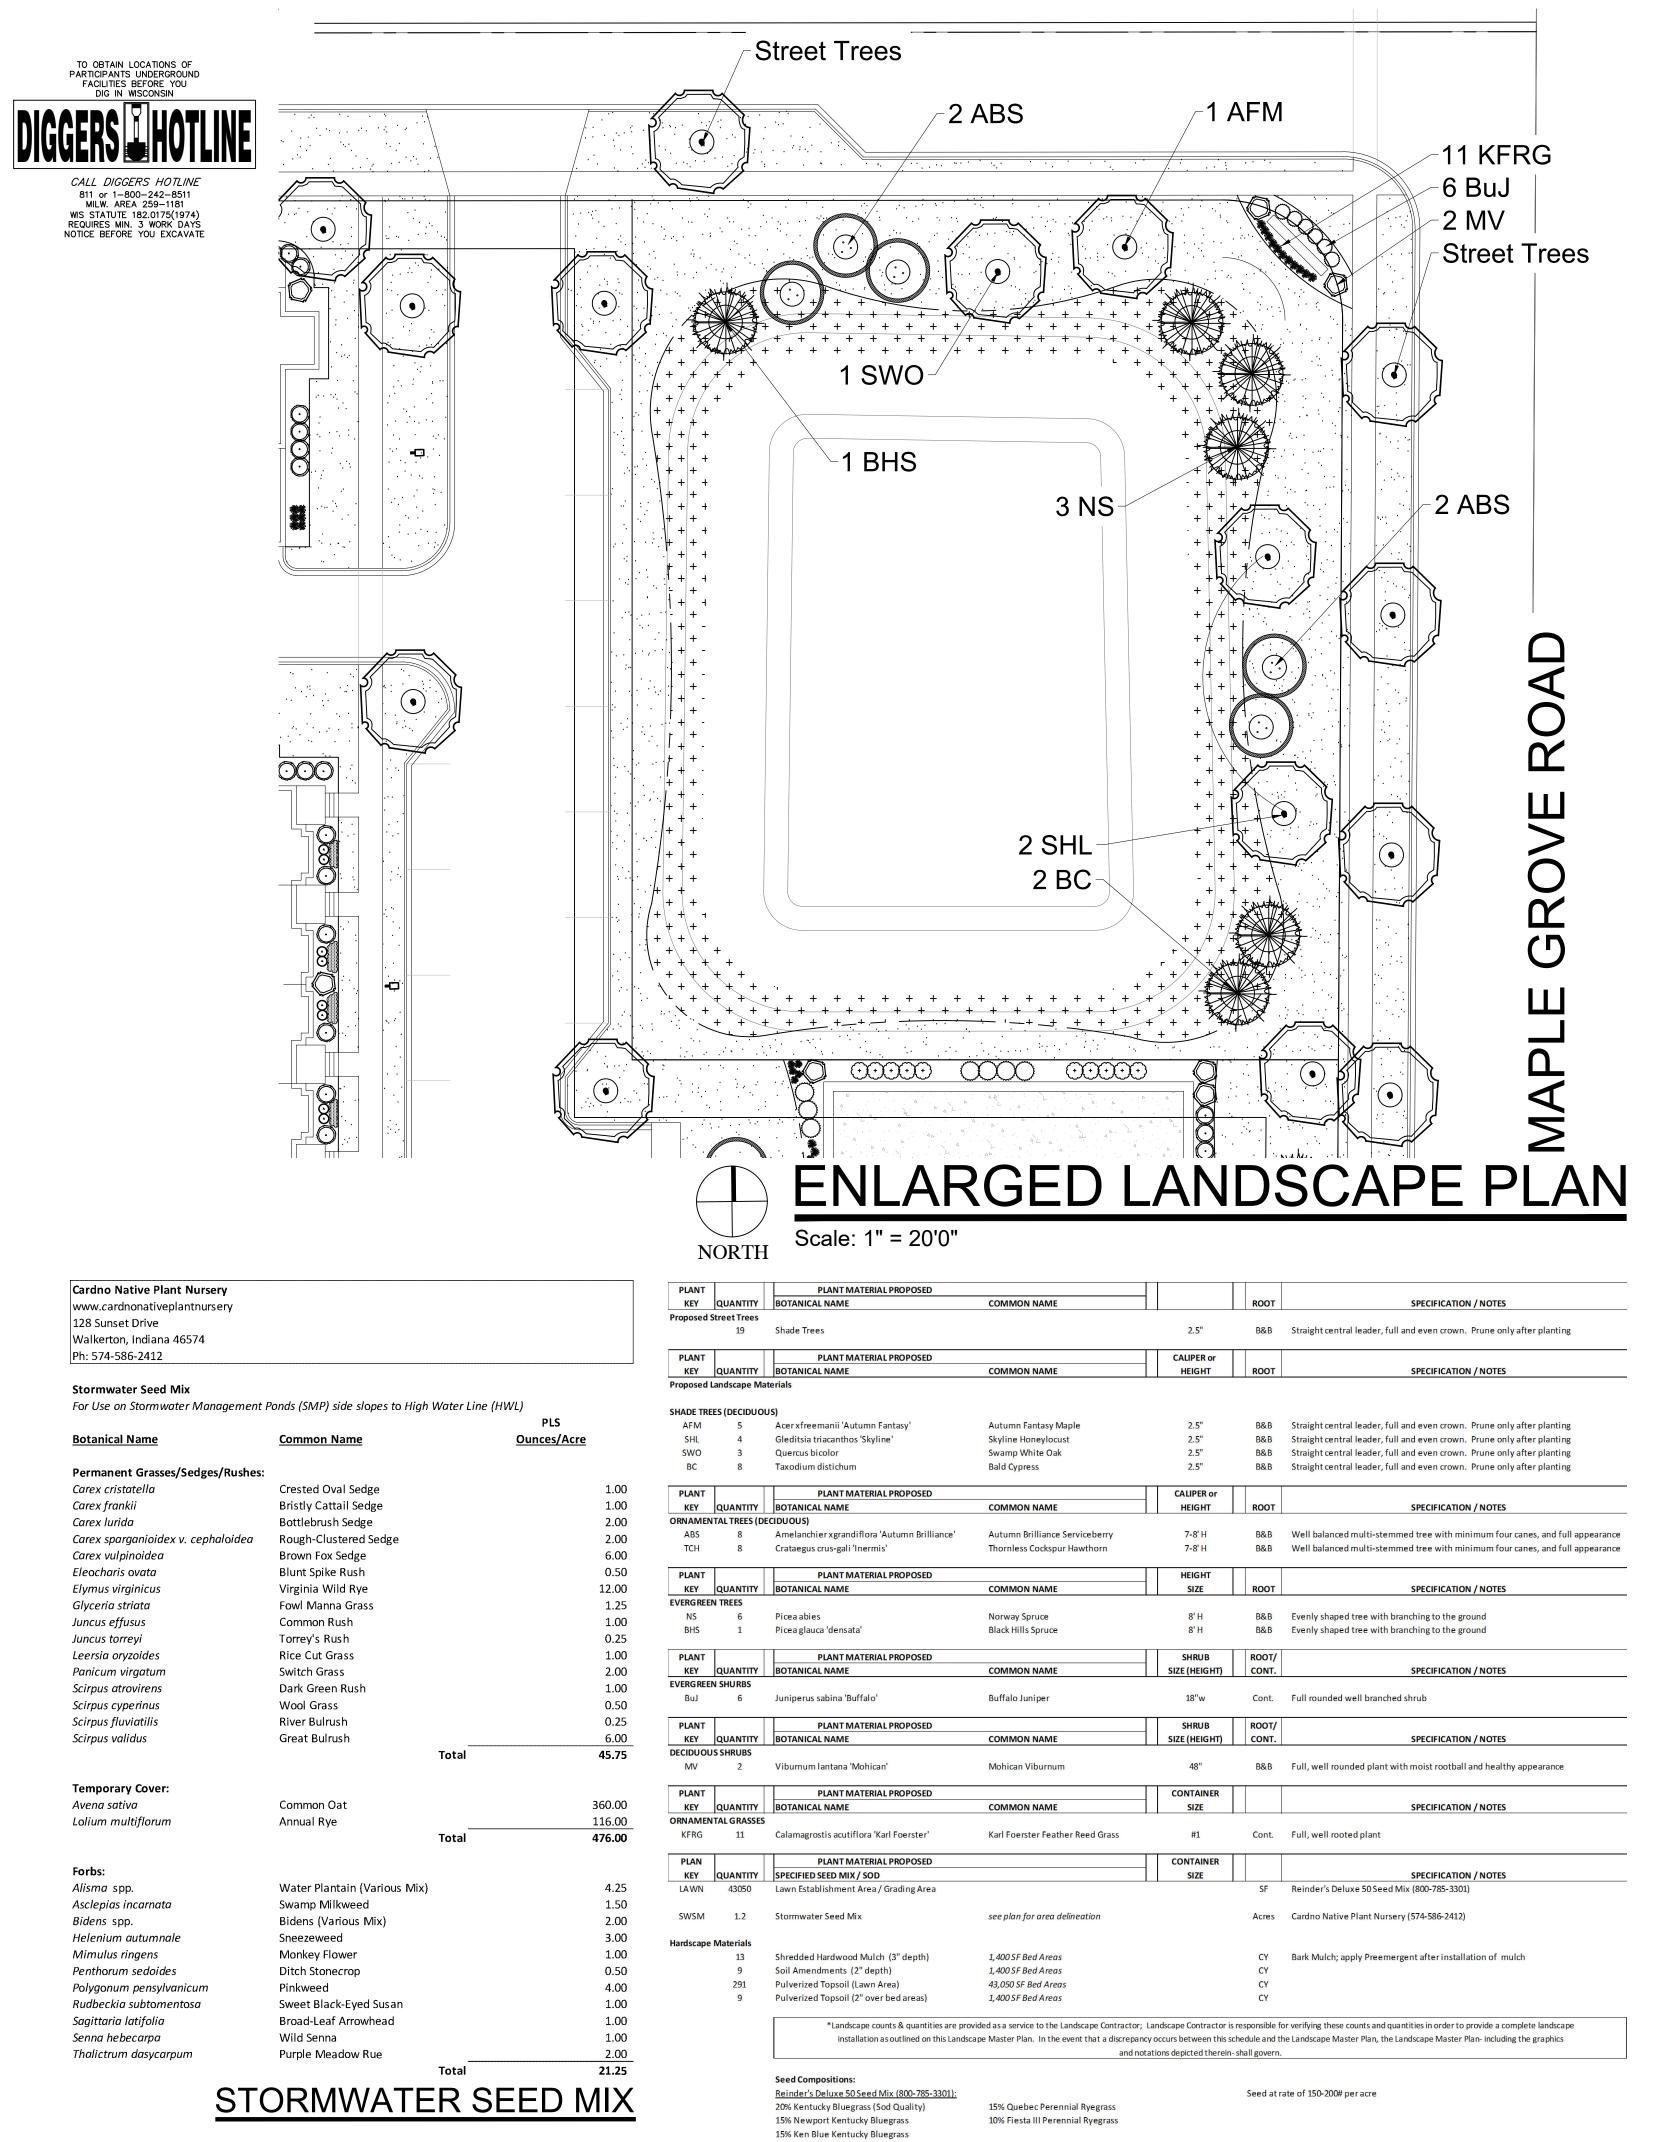

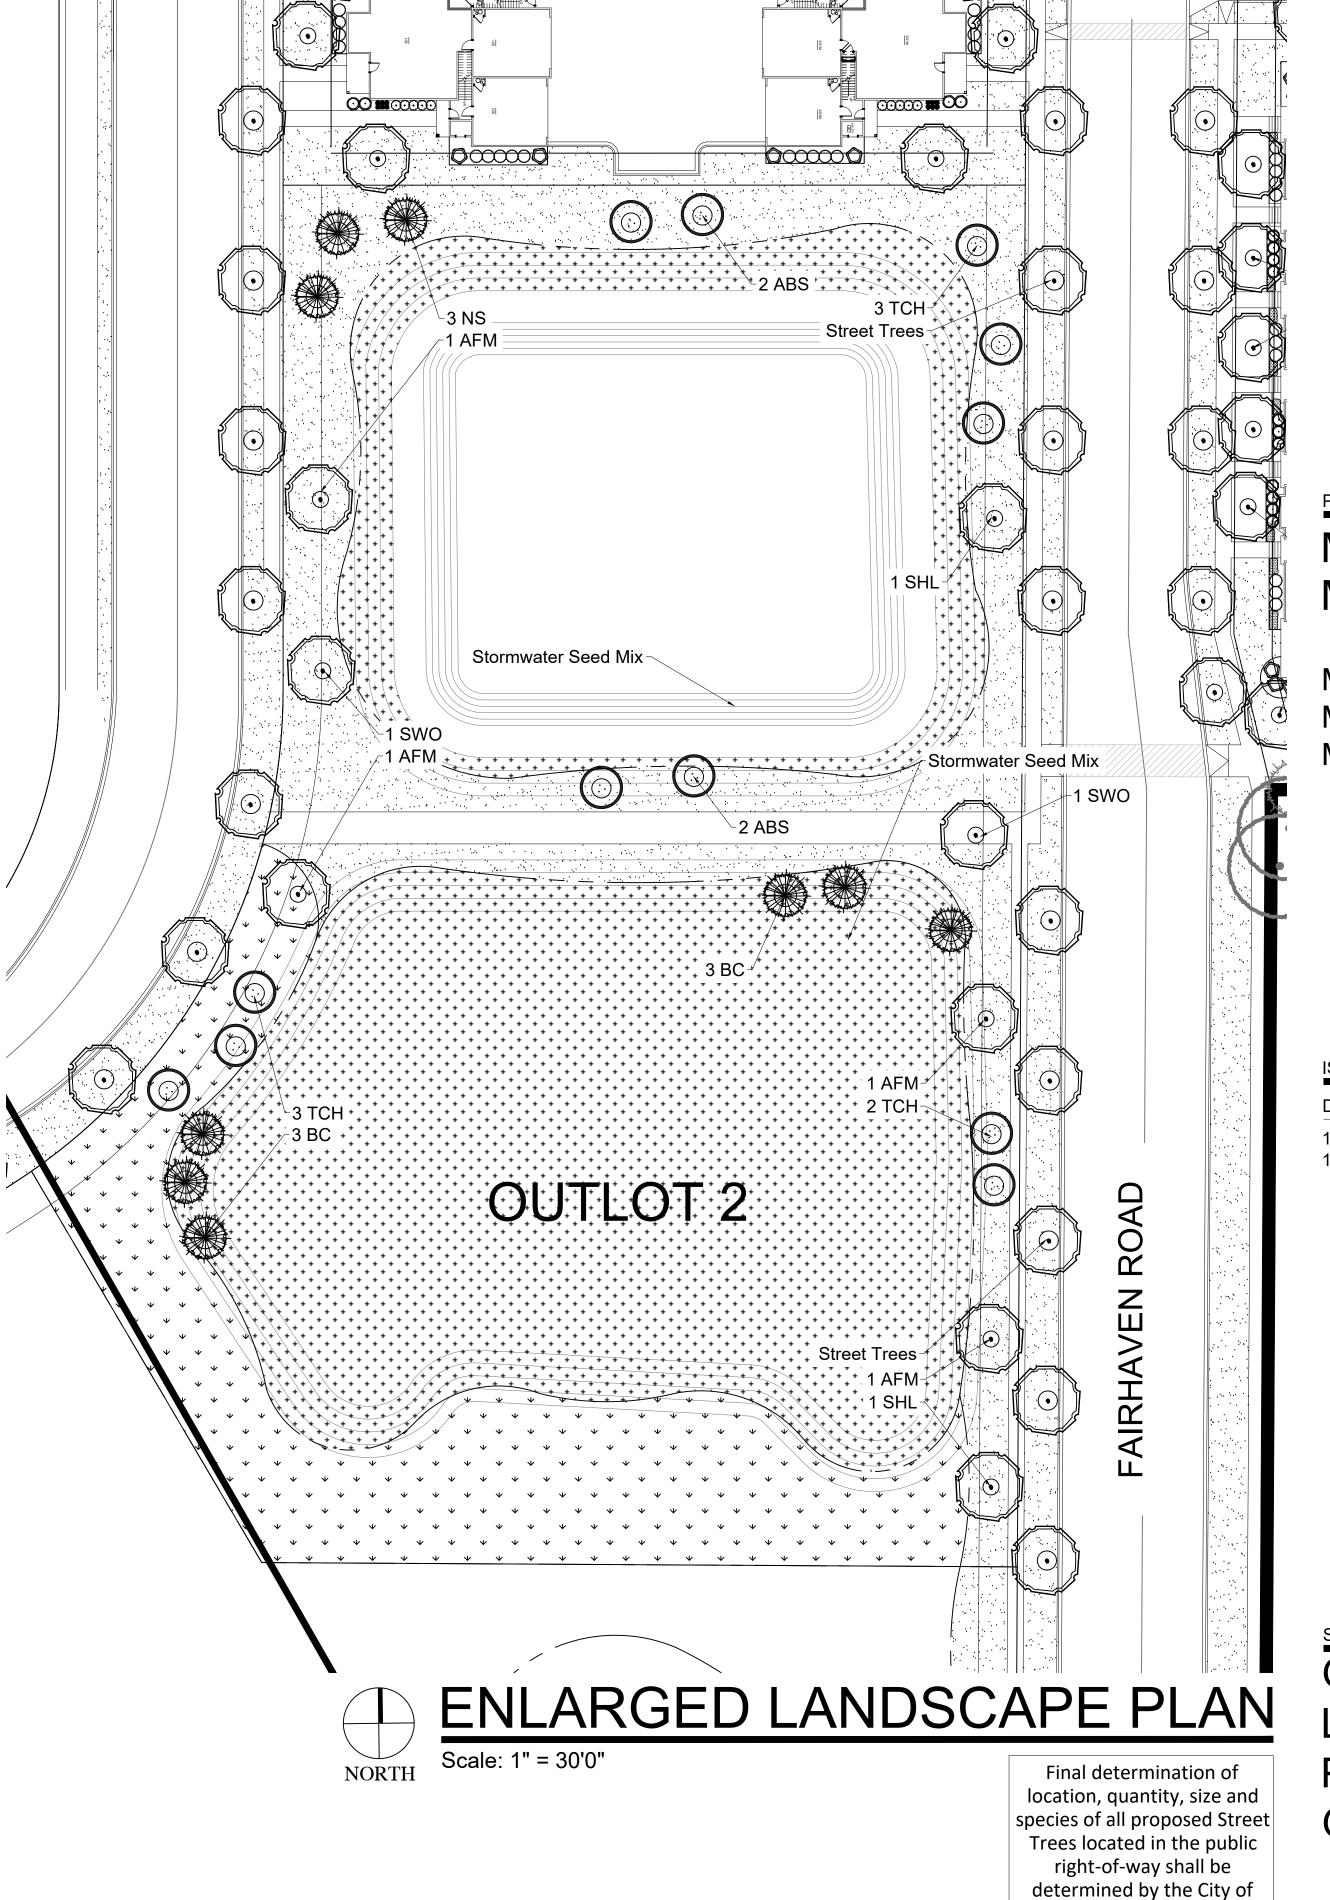HELLER & ASSOCIATES, LLC LANDSCAPE ARCHITECTURE P.O. Box 1359
Lake Geneva, Wisconsin 53147-1359
ph 262.639.9733
david@wdavidheller.com

ROJECT

MAPLE GROVE MULTI-FAMILY

Maple Grove Road at Manchester Road Madison, WI

ISSUANCE AND REVISIONS

DATE DESCRIPTION

12.13.19 ISSUE TO OWNER 12.17.19 SUBMITTAL

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SHEET TITLE

OVERALL
LANDSCAPE
PLAN:
OUTLOTS 1 & 2

PROJECT MANAGER WDH
PROJECT NUMBER 19-090

12.17.17

SHEET NUMBER


DATE

Madison Department of

Forestry

1 1 10

PLANT & MATERIAL SCHEDULE: OUTLOTS 1 & 2

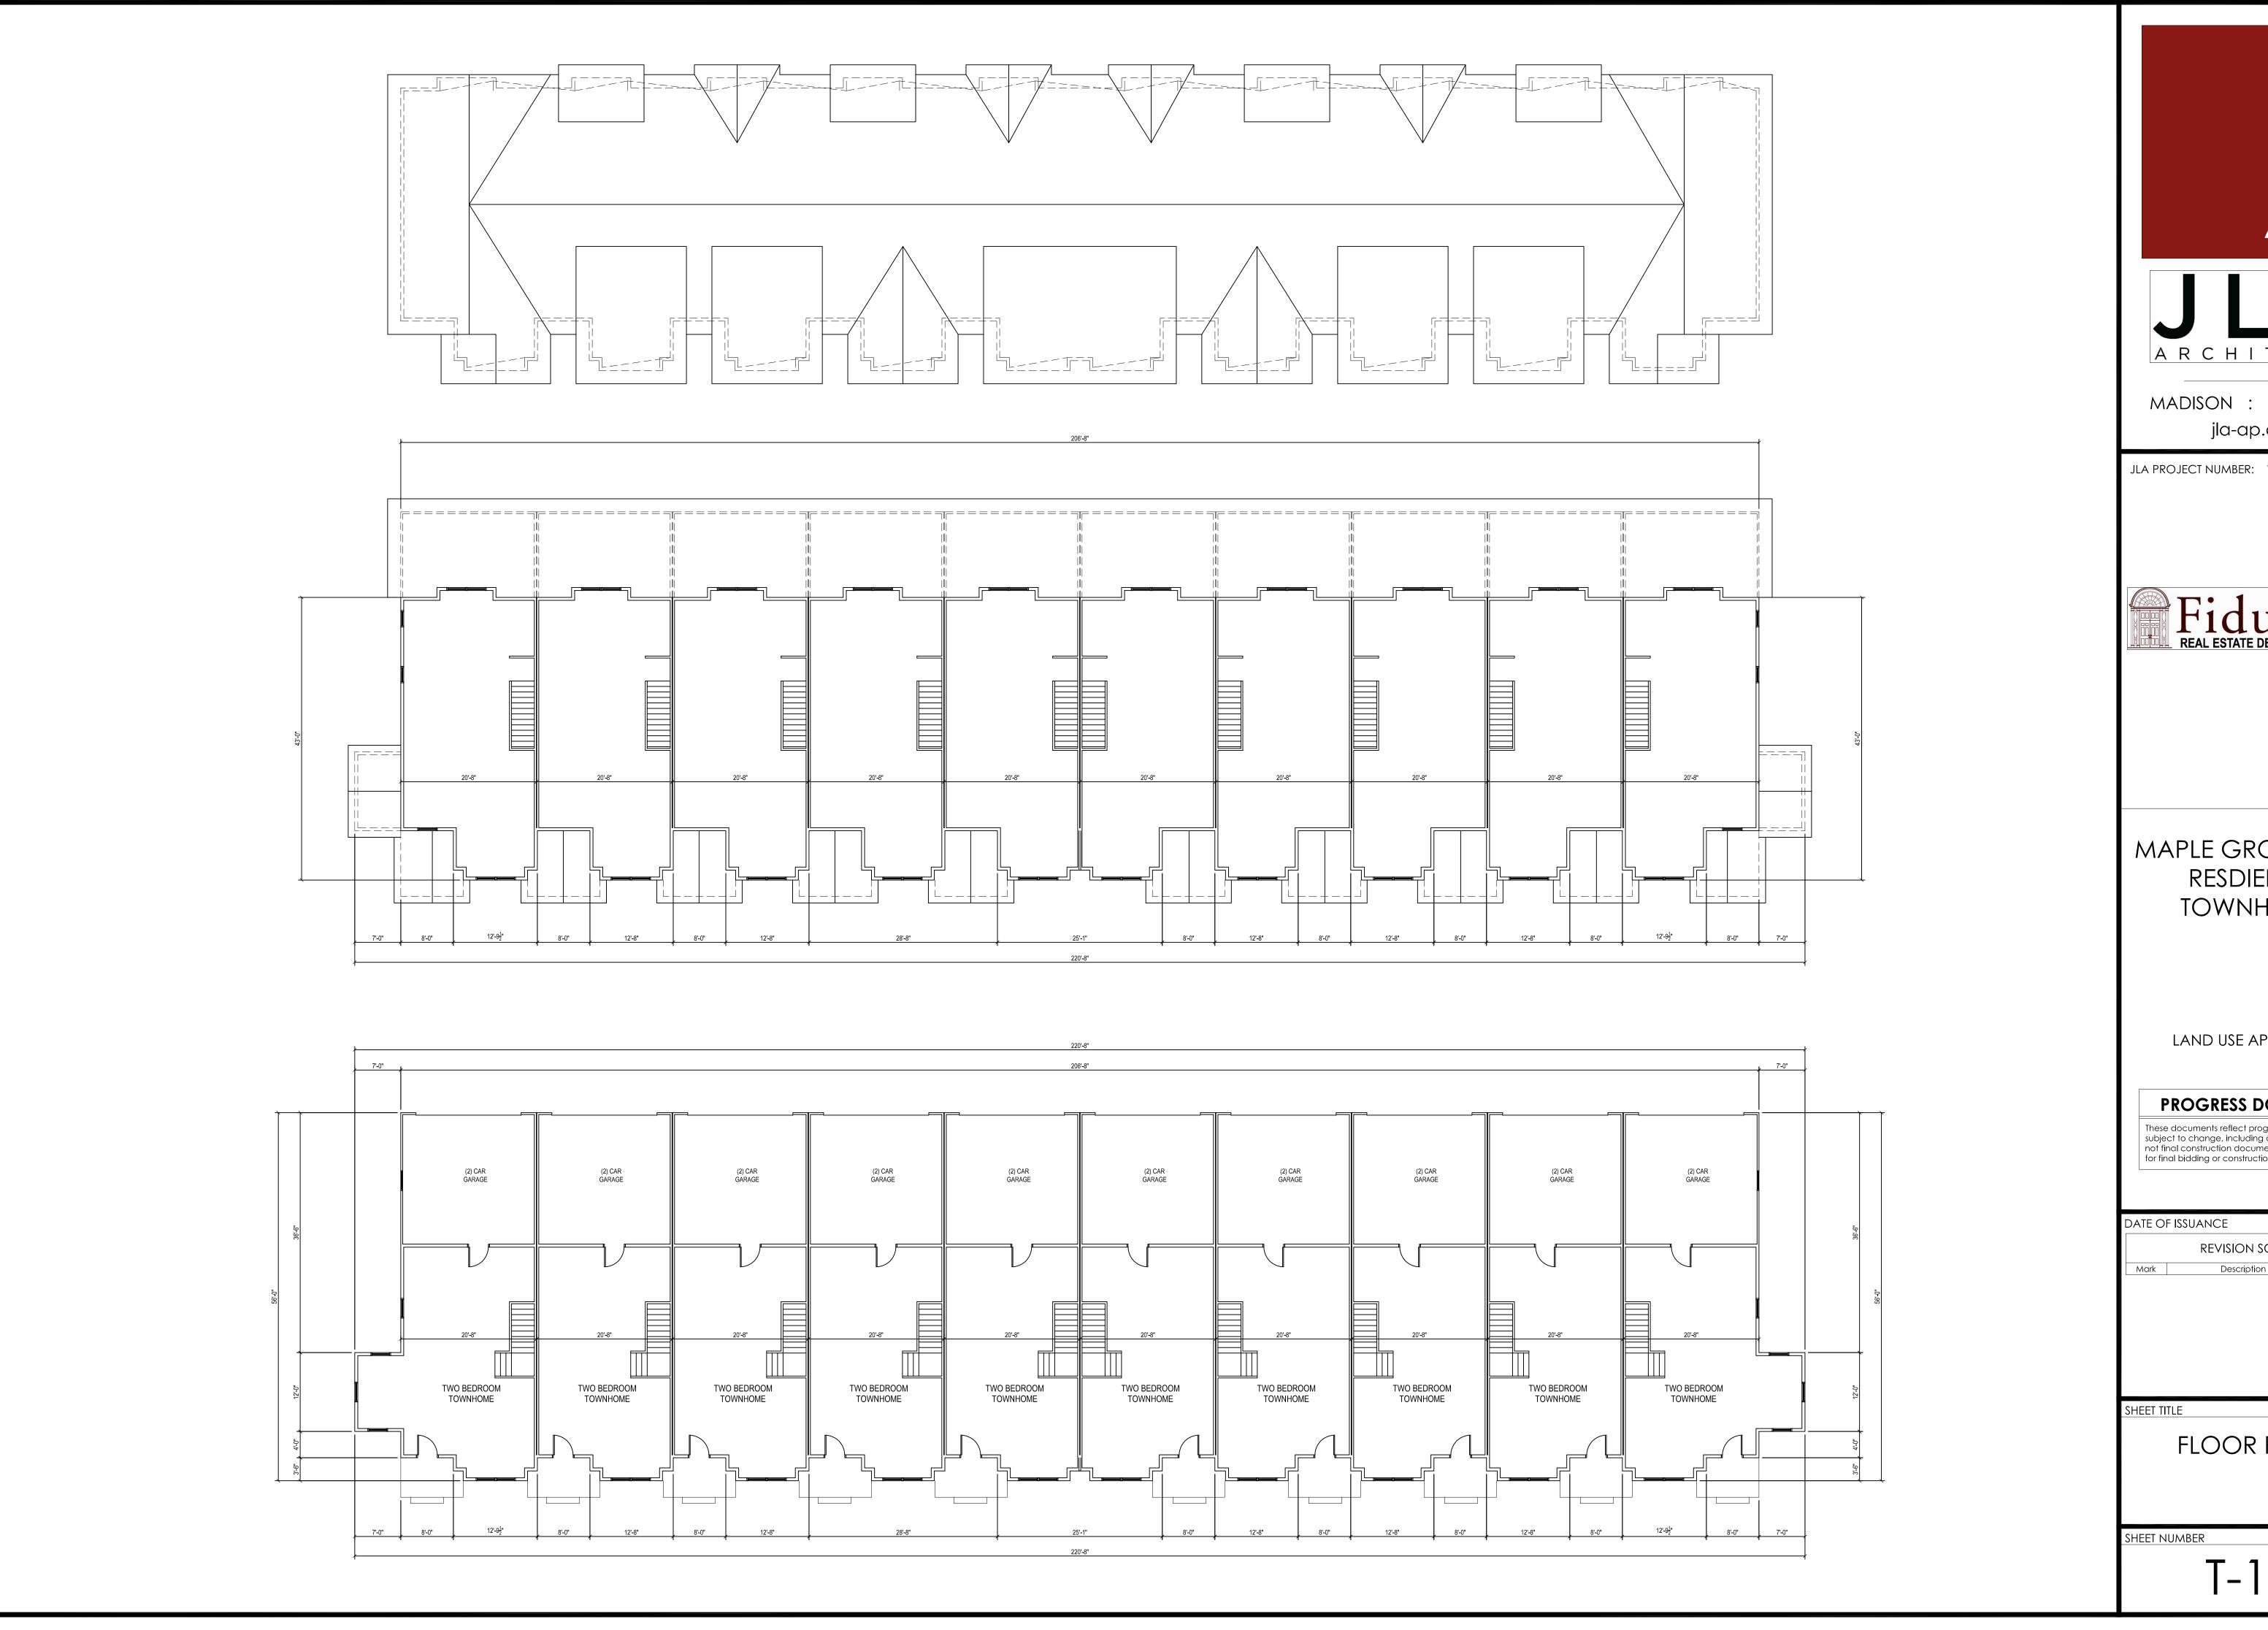



MADISON : MILWAUKEE jla-ap.com

JLA PROJECT NUMBER: 17-1018



MAPLE GROVE DRIVE RESDIENTIAL TOWNHOMES

LAND USE APPLICATION


PROGRESS DOCUMENTS


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DATE OF I	DATE OF ISSUANCE		DECEMBER 18, 2019	
REVISION SCHEDULE				
Mark	Descript	ion	Date	

FLOOR PLANS

T-101



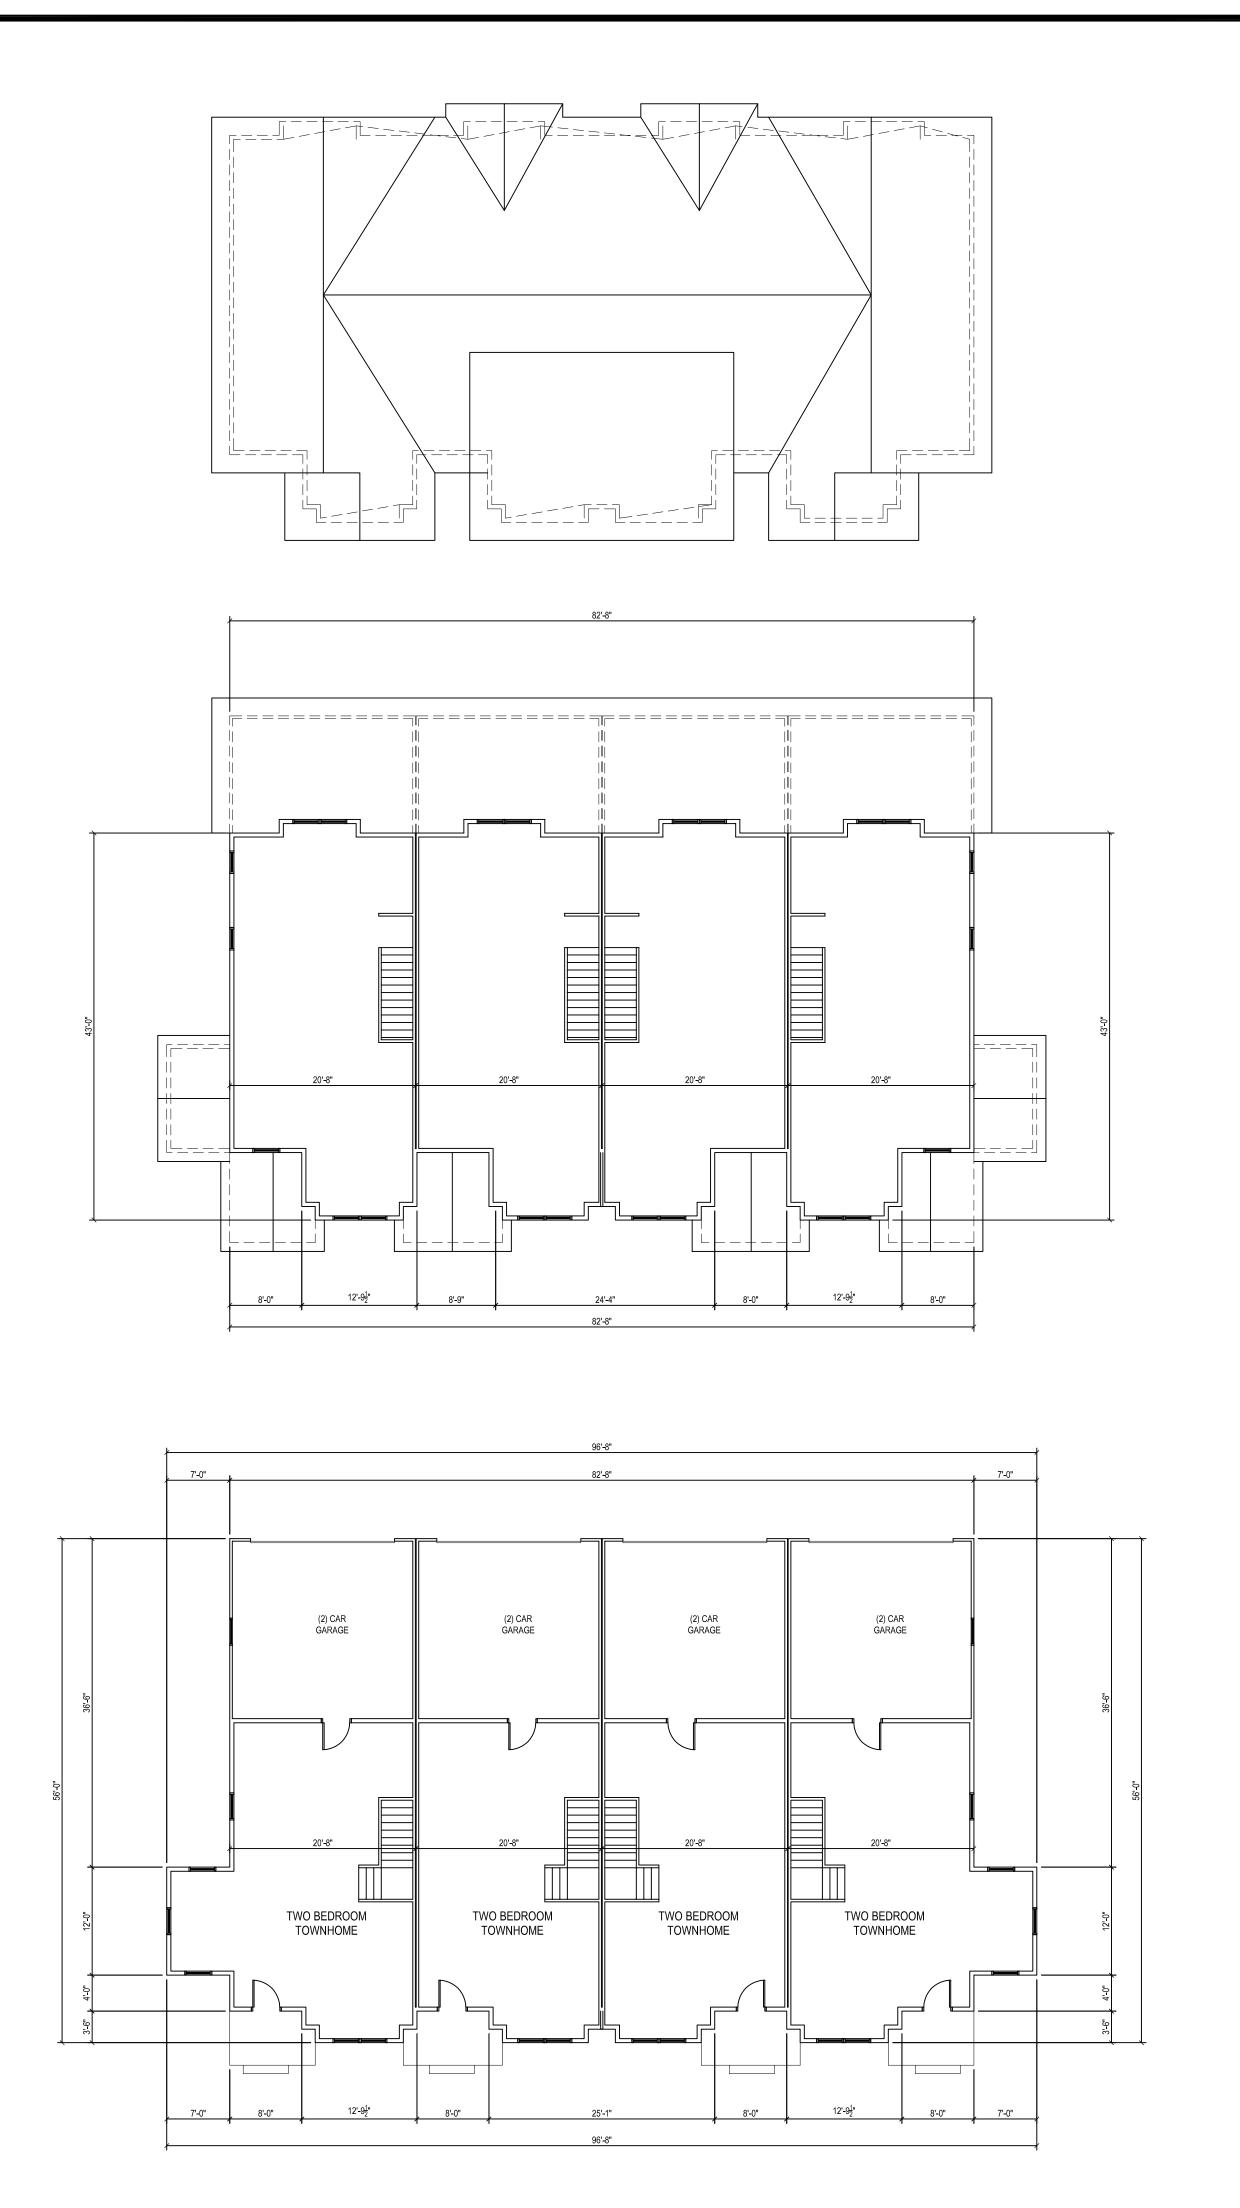

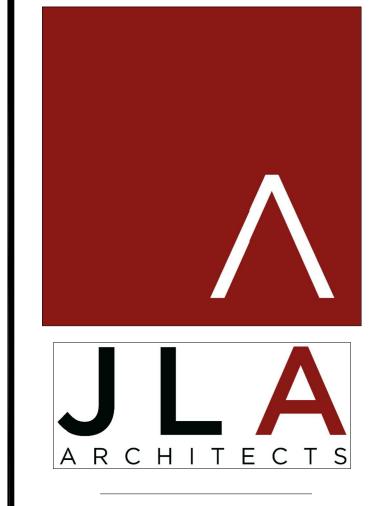MADISON : MILWAUKEE jla-ap.com

JLA PROJECT NUMBER: 17-1018



MAPLE GROVE DRIVE RESDIENTIAL TOWNHOMES

LAND USE APPLICATION

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	REVISION		

SHEET TITLE

FLOOR PLANS

SHEET NUMBER

T-102







MADISON: MILWAUKEE jla-ap.com

JLA PROJECT NUMBER: XX-XXXX-XX

XXX

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DATE OF ISSUANCE MONTH DATE, YEAR

REVISION SCHEDULE

Mark Description Date

SHEET TITLE_

SKETCHUP ELEVATIONS

SHEET NUMBER

T-A200



16 10 UNIT SOUTH ELEVATION 1/8" = 1'-0"

2019 1:35:21 AM






8 4 UNIT NORTH ELEVATION 1/8" = 1'-0"



16 10 UNIT NORTH ELEVATION
1/8" = 1'-0"

6 EAST ELEVATION

1/8" = 1'-0"

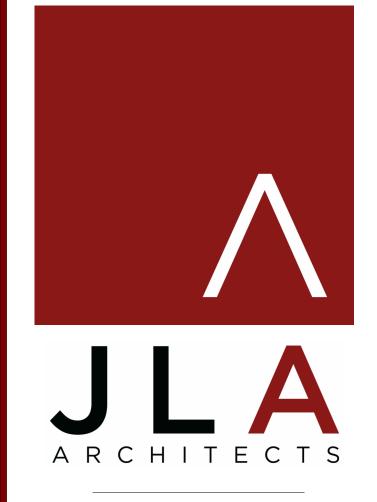

MADISON: MILWAUKEE jla-ap.com

JLA PROJECT NUMBER: XX-XXXX-XX

MAPLE GROVE DRIVE RESDIENTIAL TOWNHOMES

LAND USE APPLICATION

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REVISION SCHEDULE

Mark Description Date

SHEET TITLE

SKETCHUP ELEVATIONS

SHEET NUMBER_

T-A201



6 PERSPECTIVE NE



J. A. R. C. H. I. T. E. C. T. S.

MADISON: MILWAUKEE jla-ap.com

JLA PROJECT NUMBER: XX-XXXX-XX

MAPLE GROVE DRIVE RESDIENTIAL TOWNHOMES

LAND USE APPLICATION

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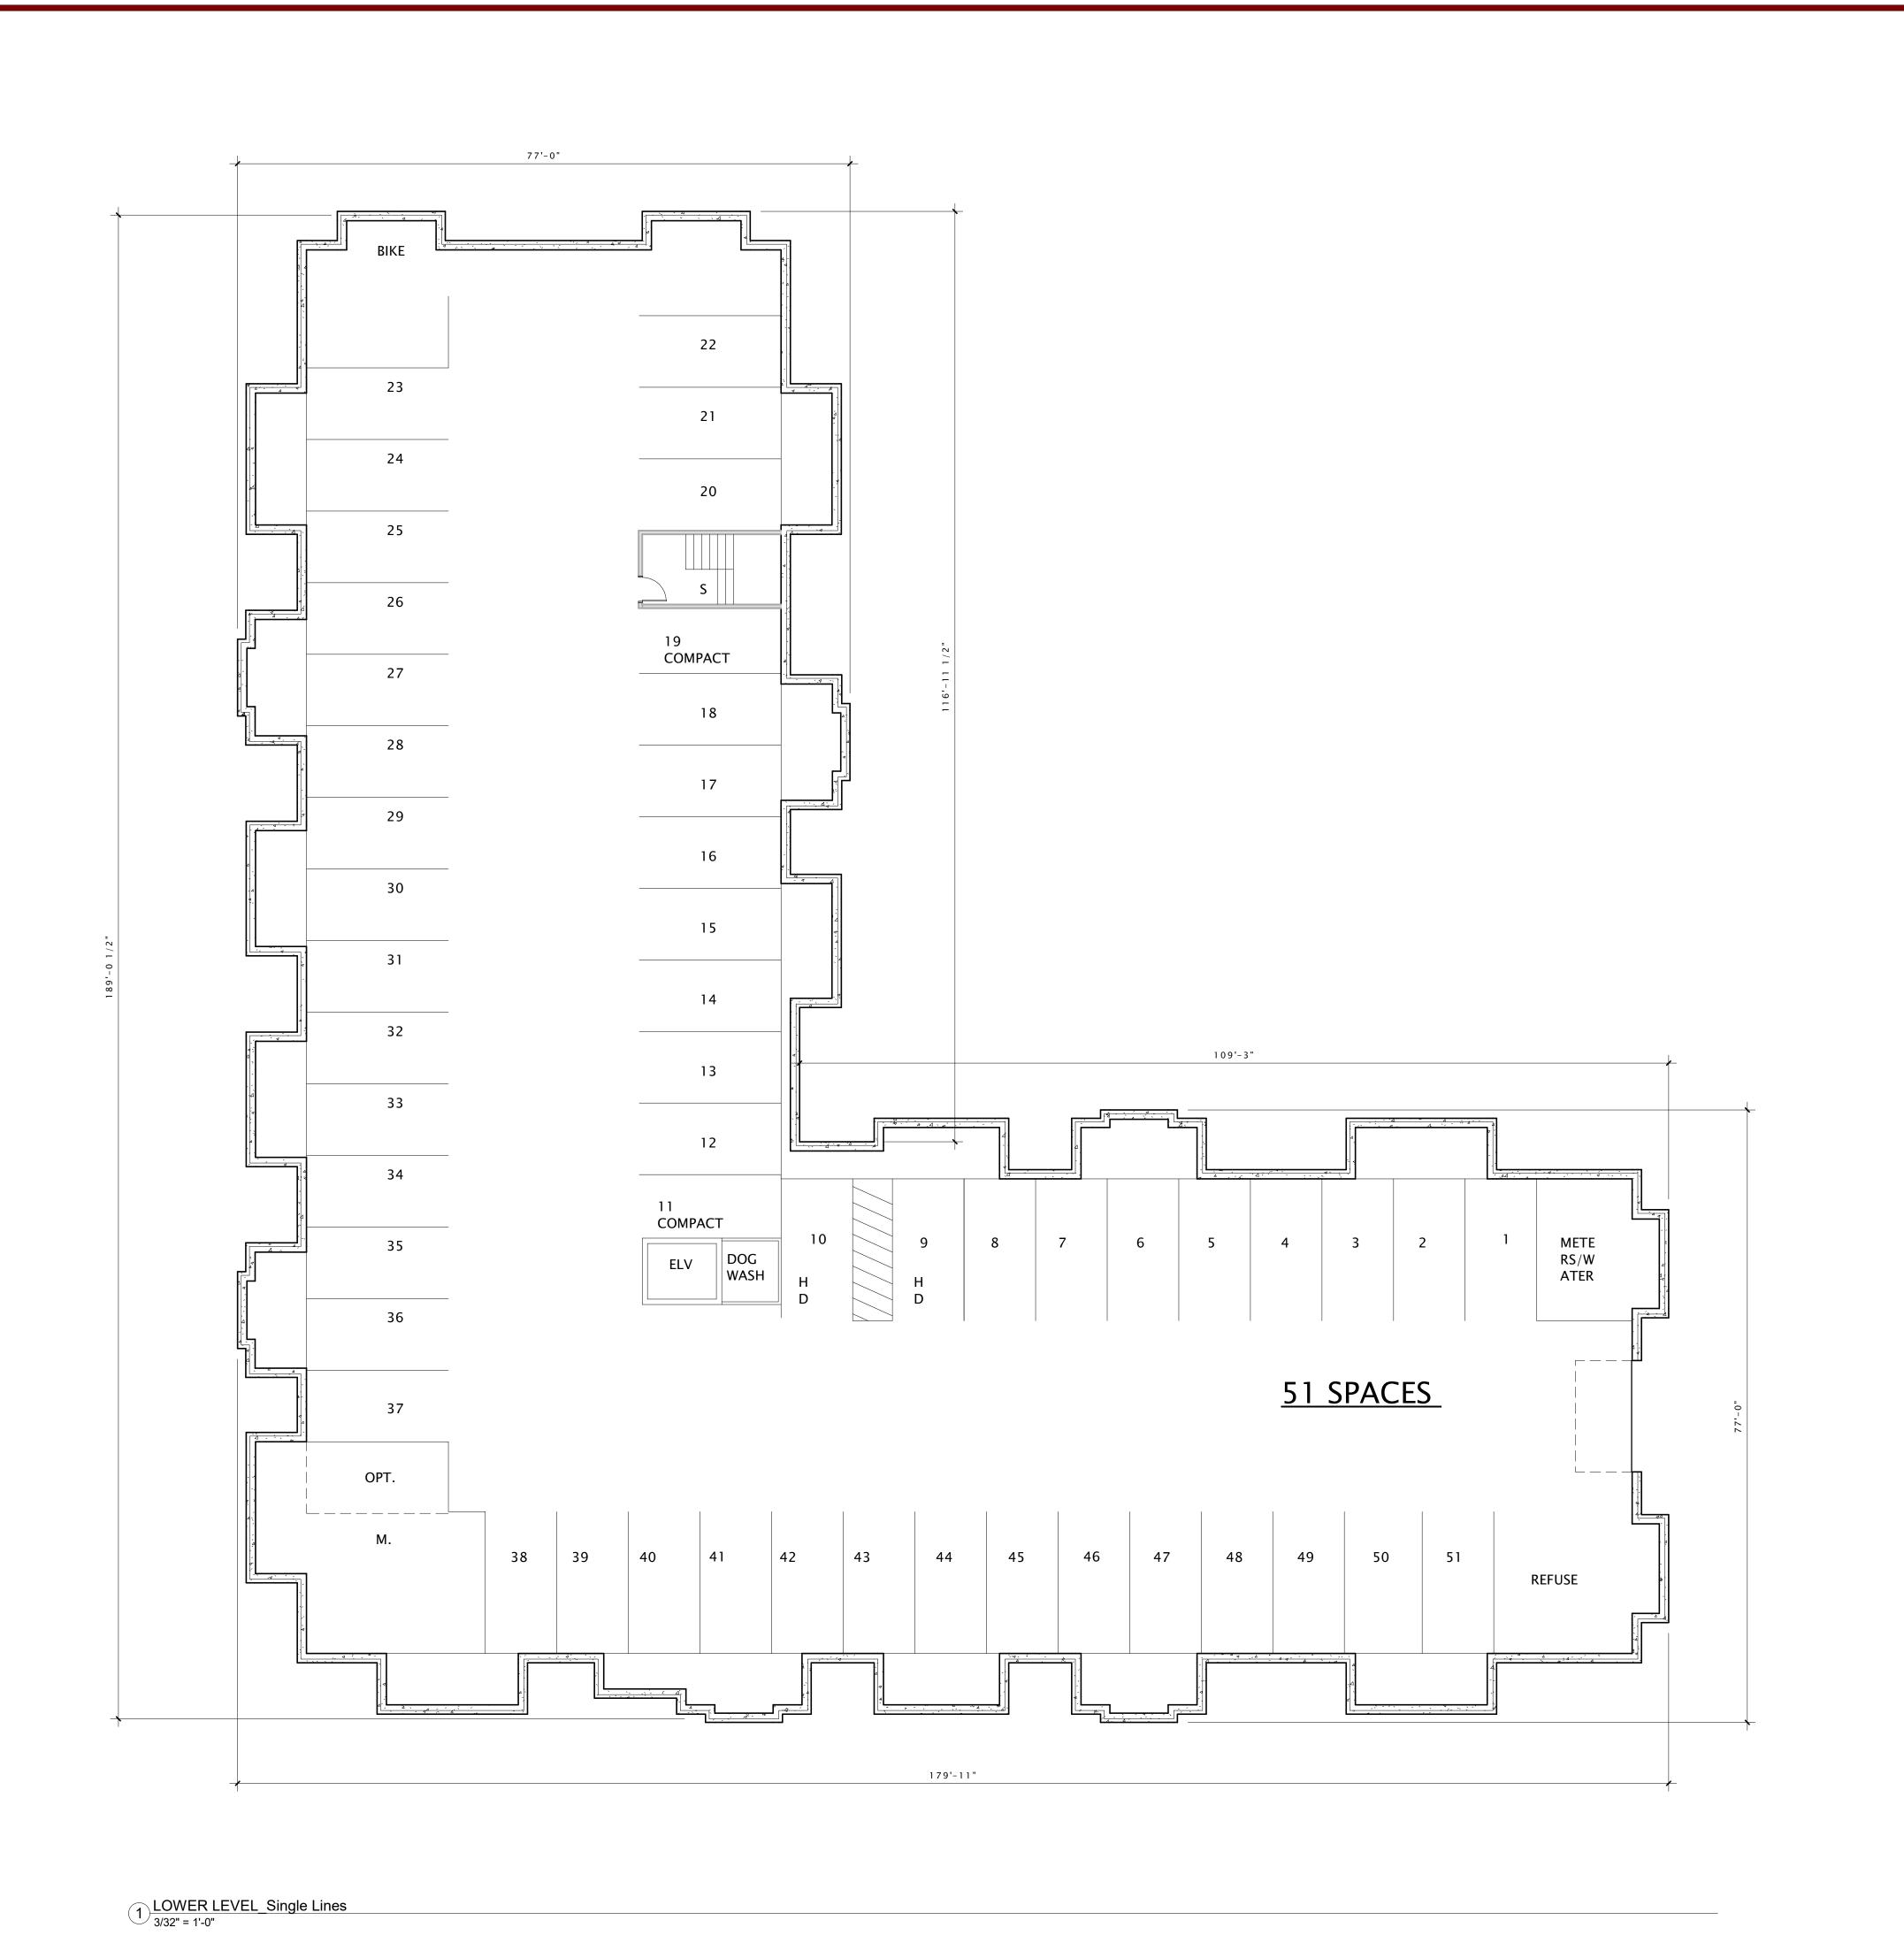
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SHEET TITLE_

SKETCHUP PERSPECTIVES

SHEET NUMBER_

T-A201





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JLA PROJECT NUMBER: XX-XXXX-XX

MAPLE GROVE DRIVE RESIDENTIAL APARTMENTS

LAND USE APPLICATION

PROGRESS DOCUMENTS

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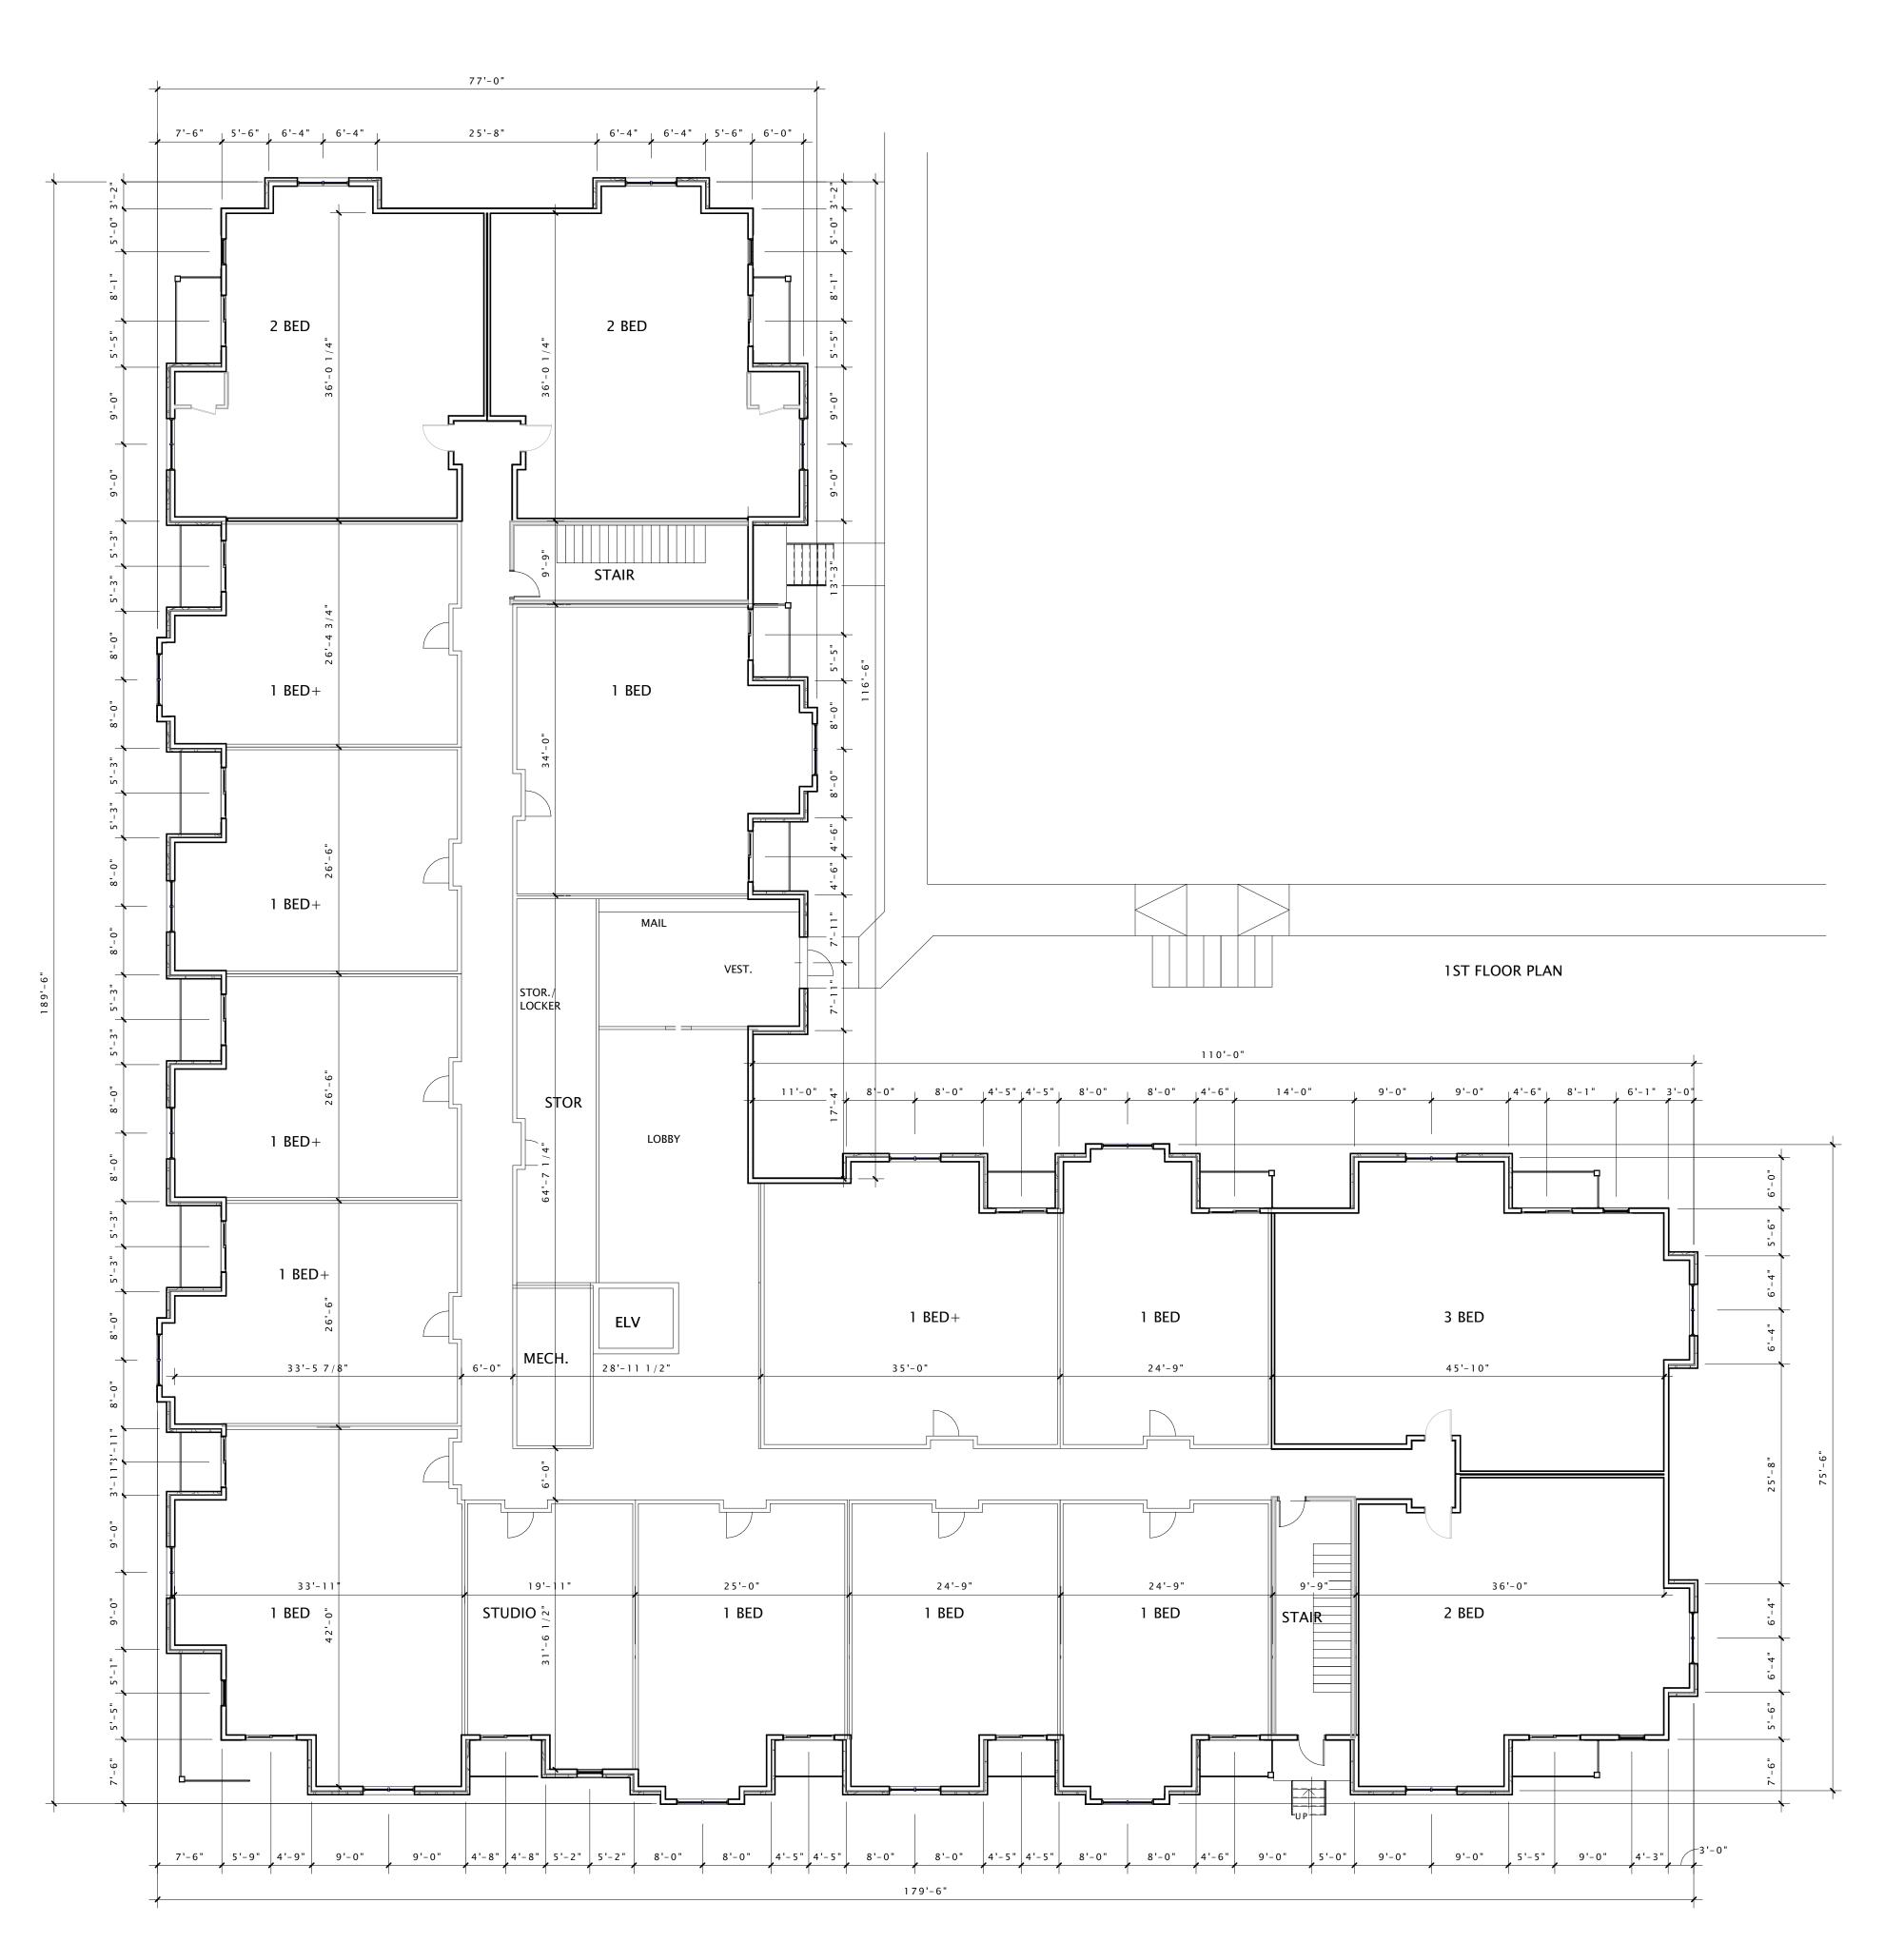
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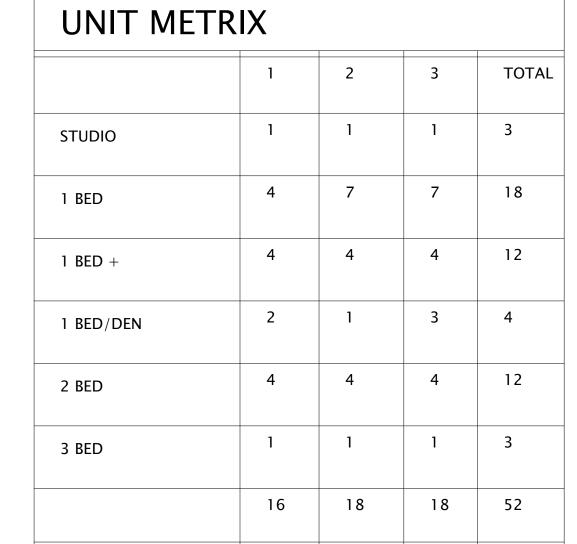
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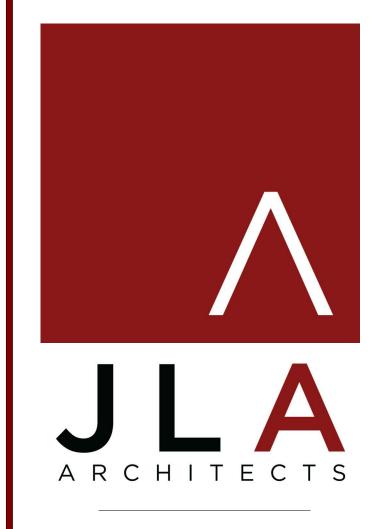
LOWER LEVEL PLAN

SHEET NUMBER



1 FIRST FLOOR Single Lines 3/32" = 1'-0"





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JLA PROJECT NUMBER: XX-XXXX-XX

MAPLE GROVE DRIVE RESIDENTIAL APARTMENTS

LAND USE APPLICATION

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	REVISION	SCHEDULE		

Description


Date

SHEET TITLE

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FIRST FLOOR PLAN

SHEET NUMBER



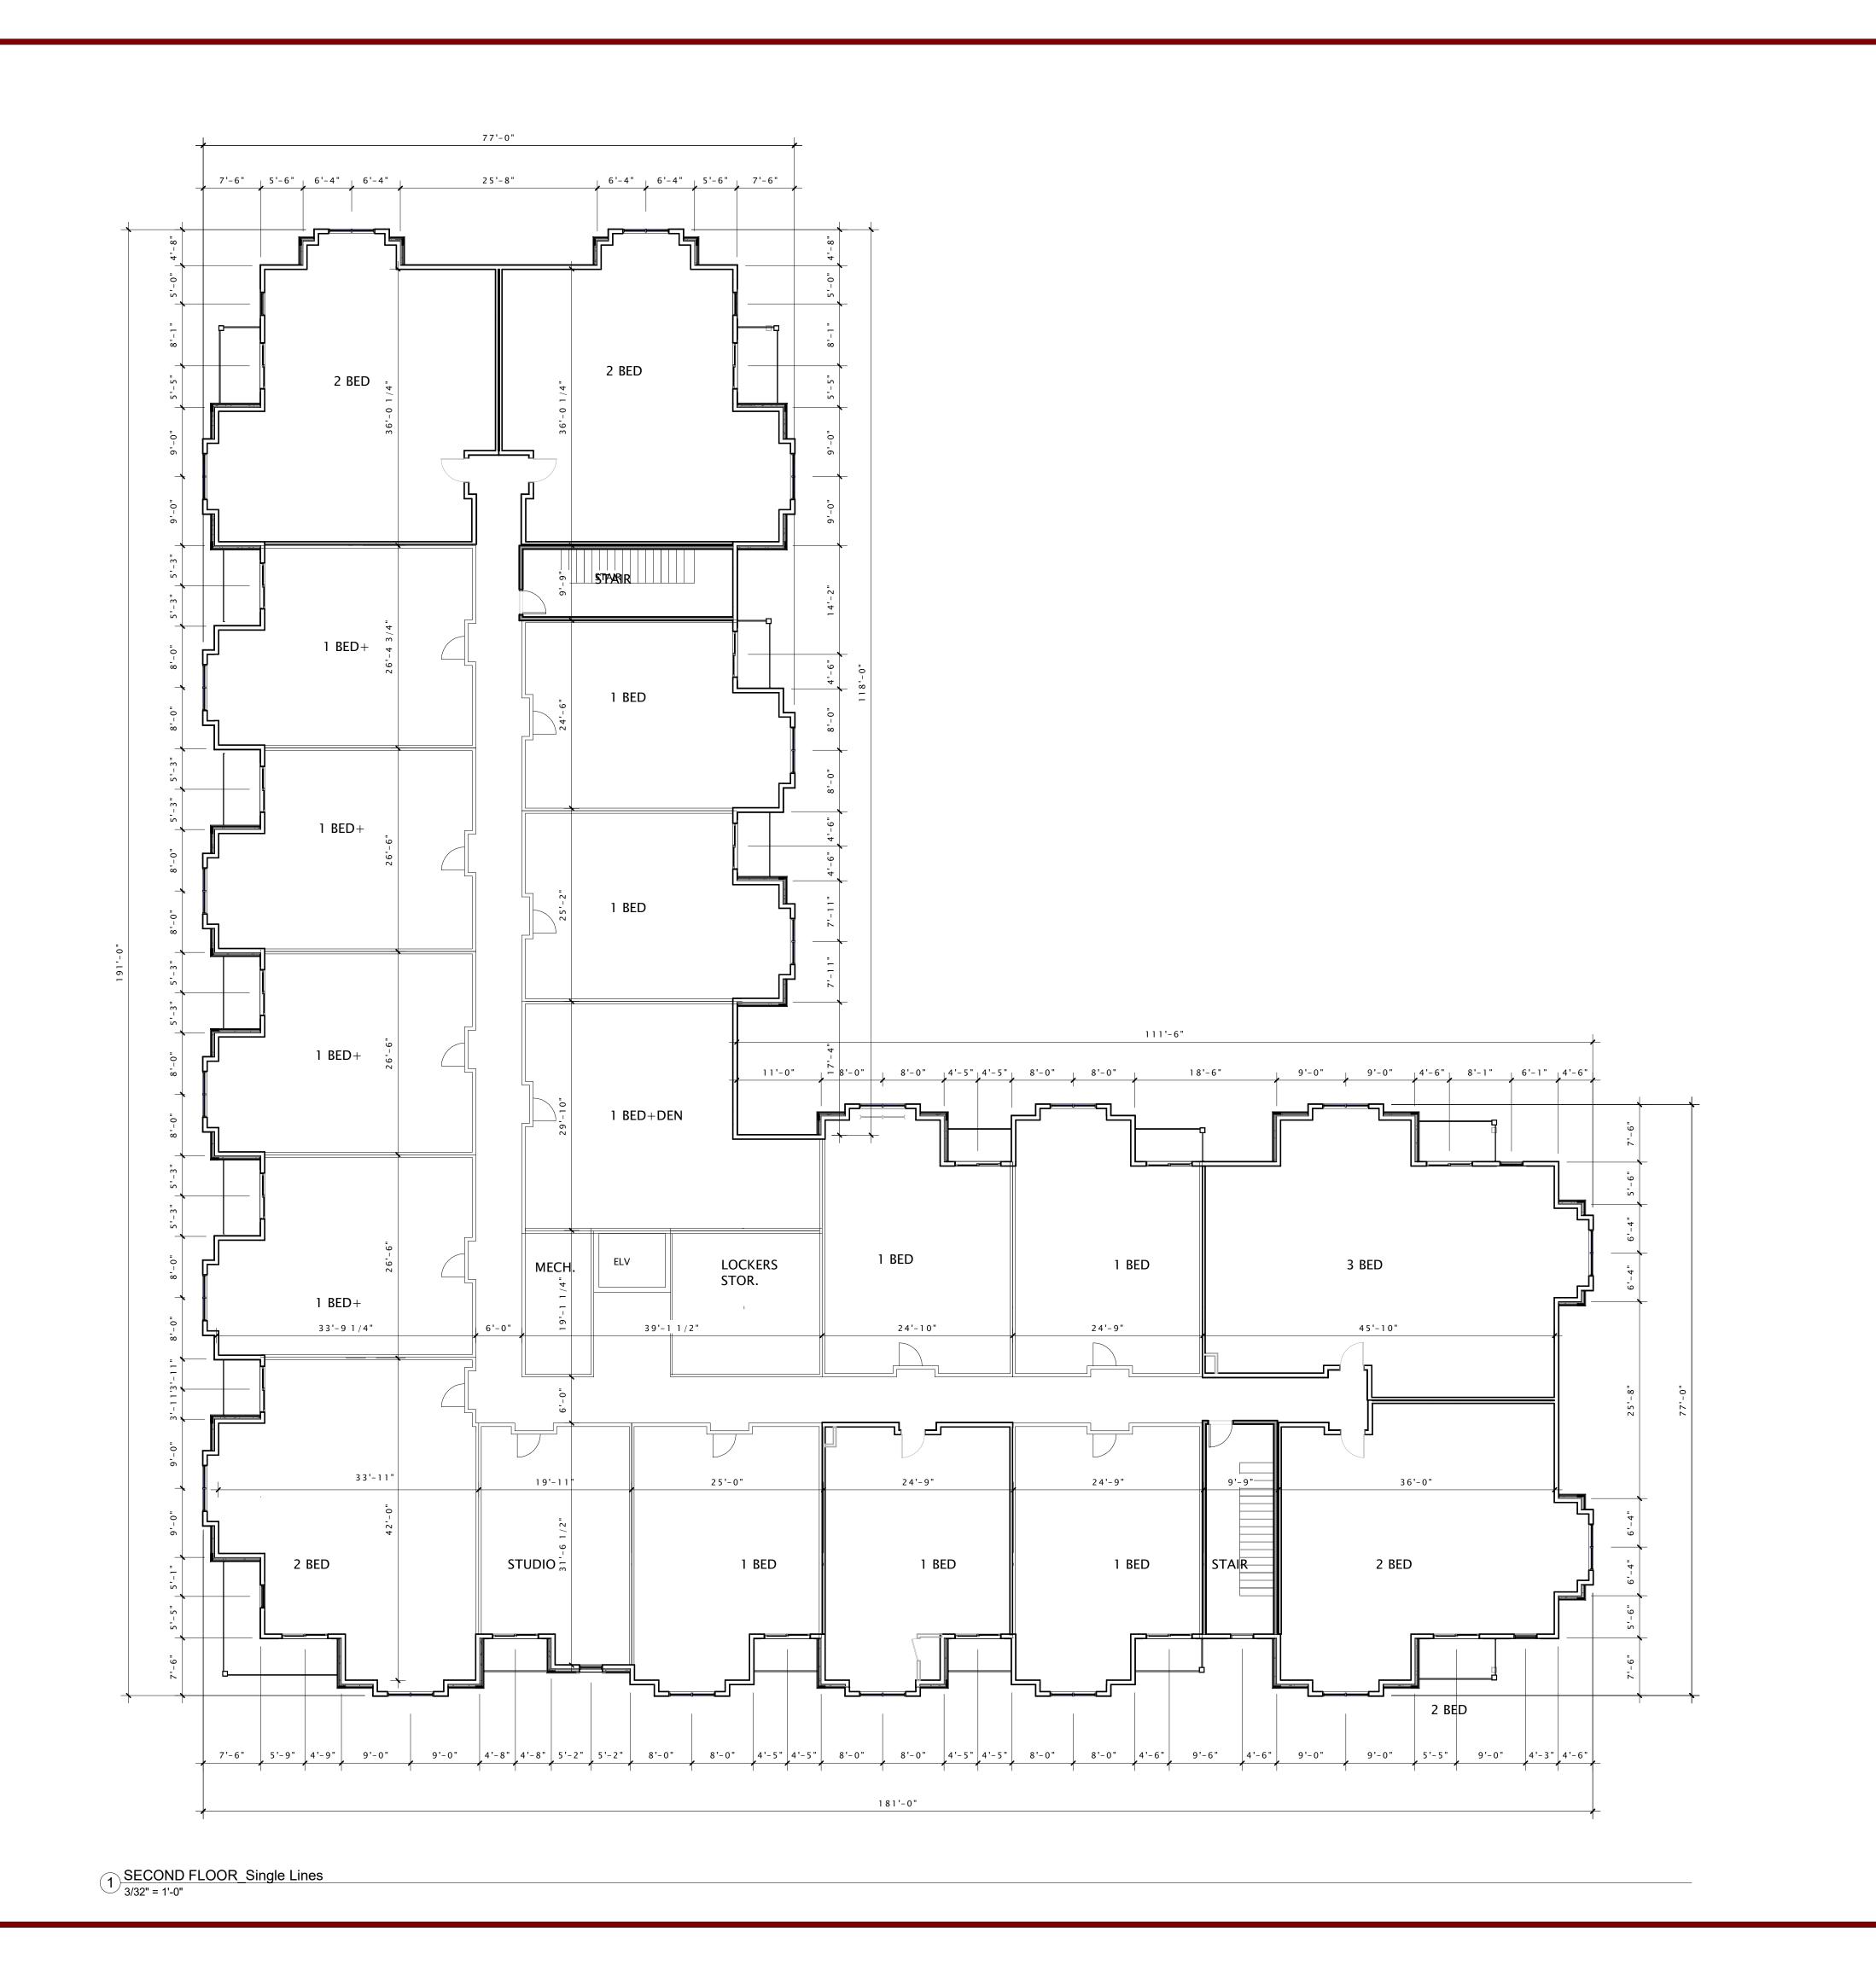

MADISON: MILWAUKEE jla-ap.com

JLA PROJECT NUMBER: XX-XXXX-XX

MAPLE GROVE DRIVE RESIDENTIAL APARTMENTS

LAND USE APPLICATION

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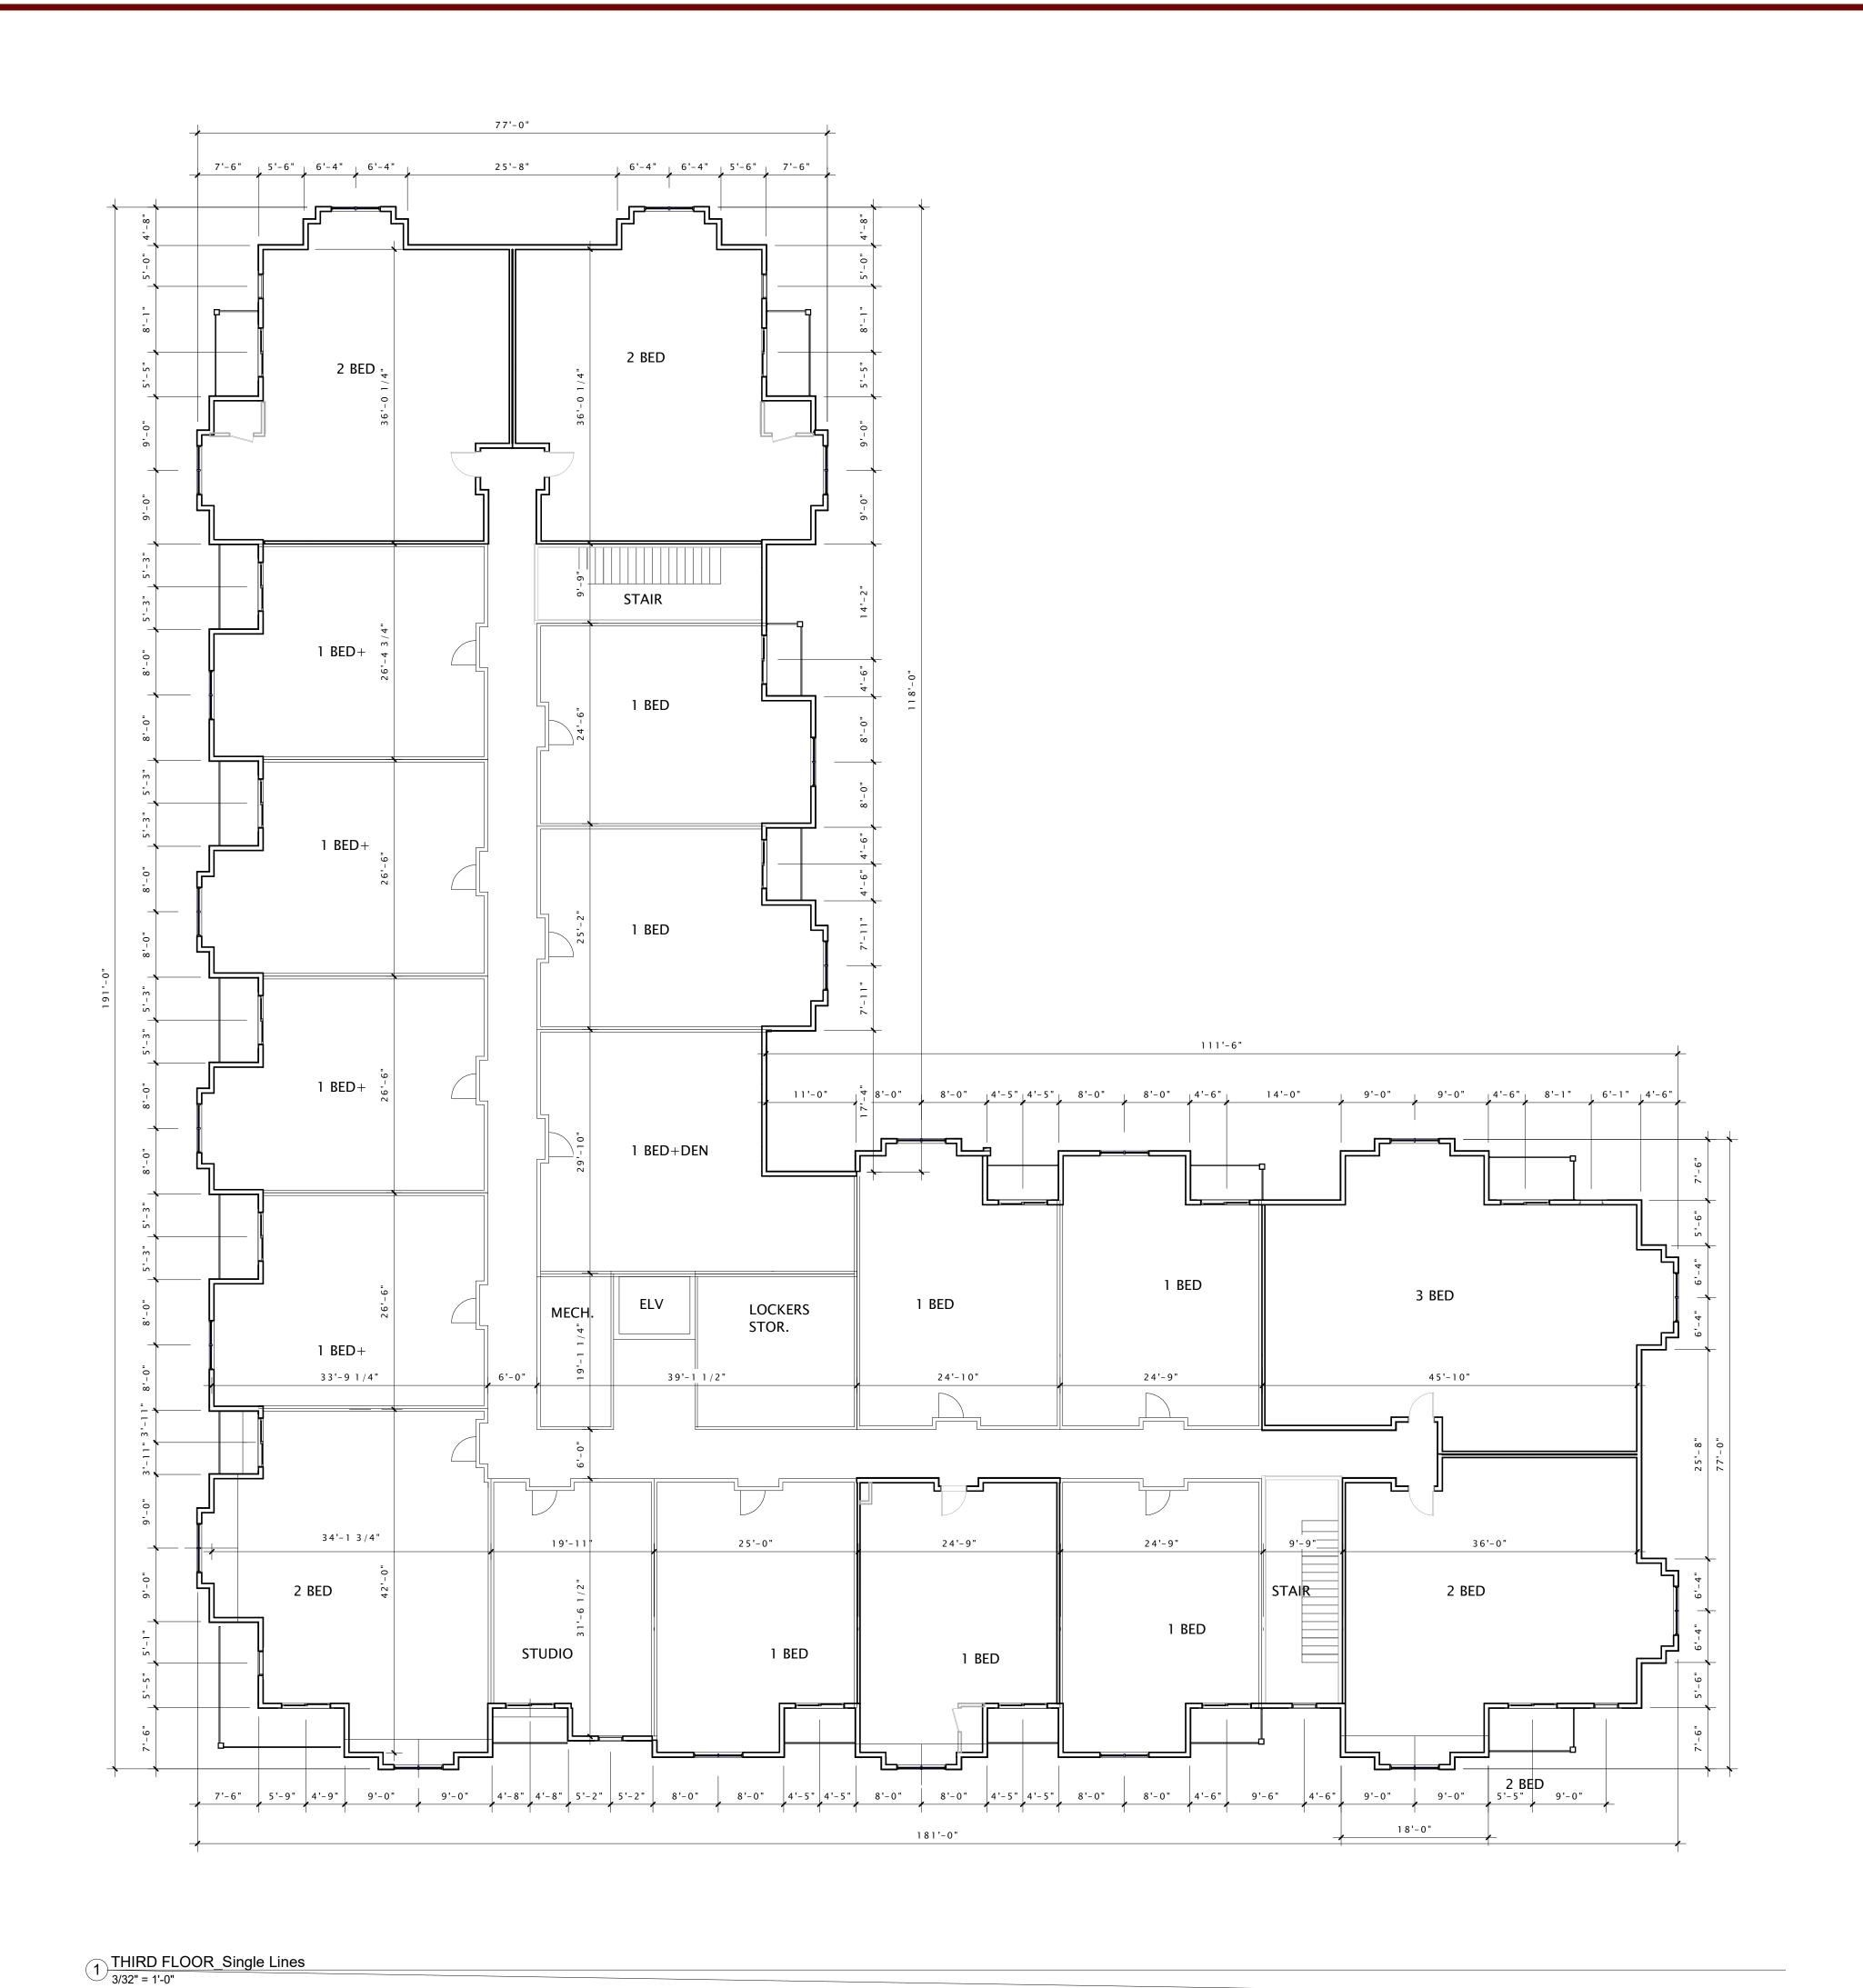
REVISION SCHEDULE

Mark Description Date

SHEET TITLE

SECOND FLOOR PLAN

SHEET NUMBER_





MADISON: MILWAUKEE jla-ap.com

JLA PROJECT NUMBER: XX-XXXX-XX

MAPLE GROVE DRIVE RESIDENTIAL APARTMENTS

LAND USE APPLICATION

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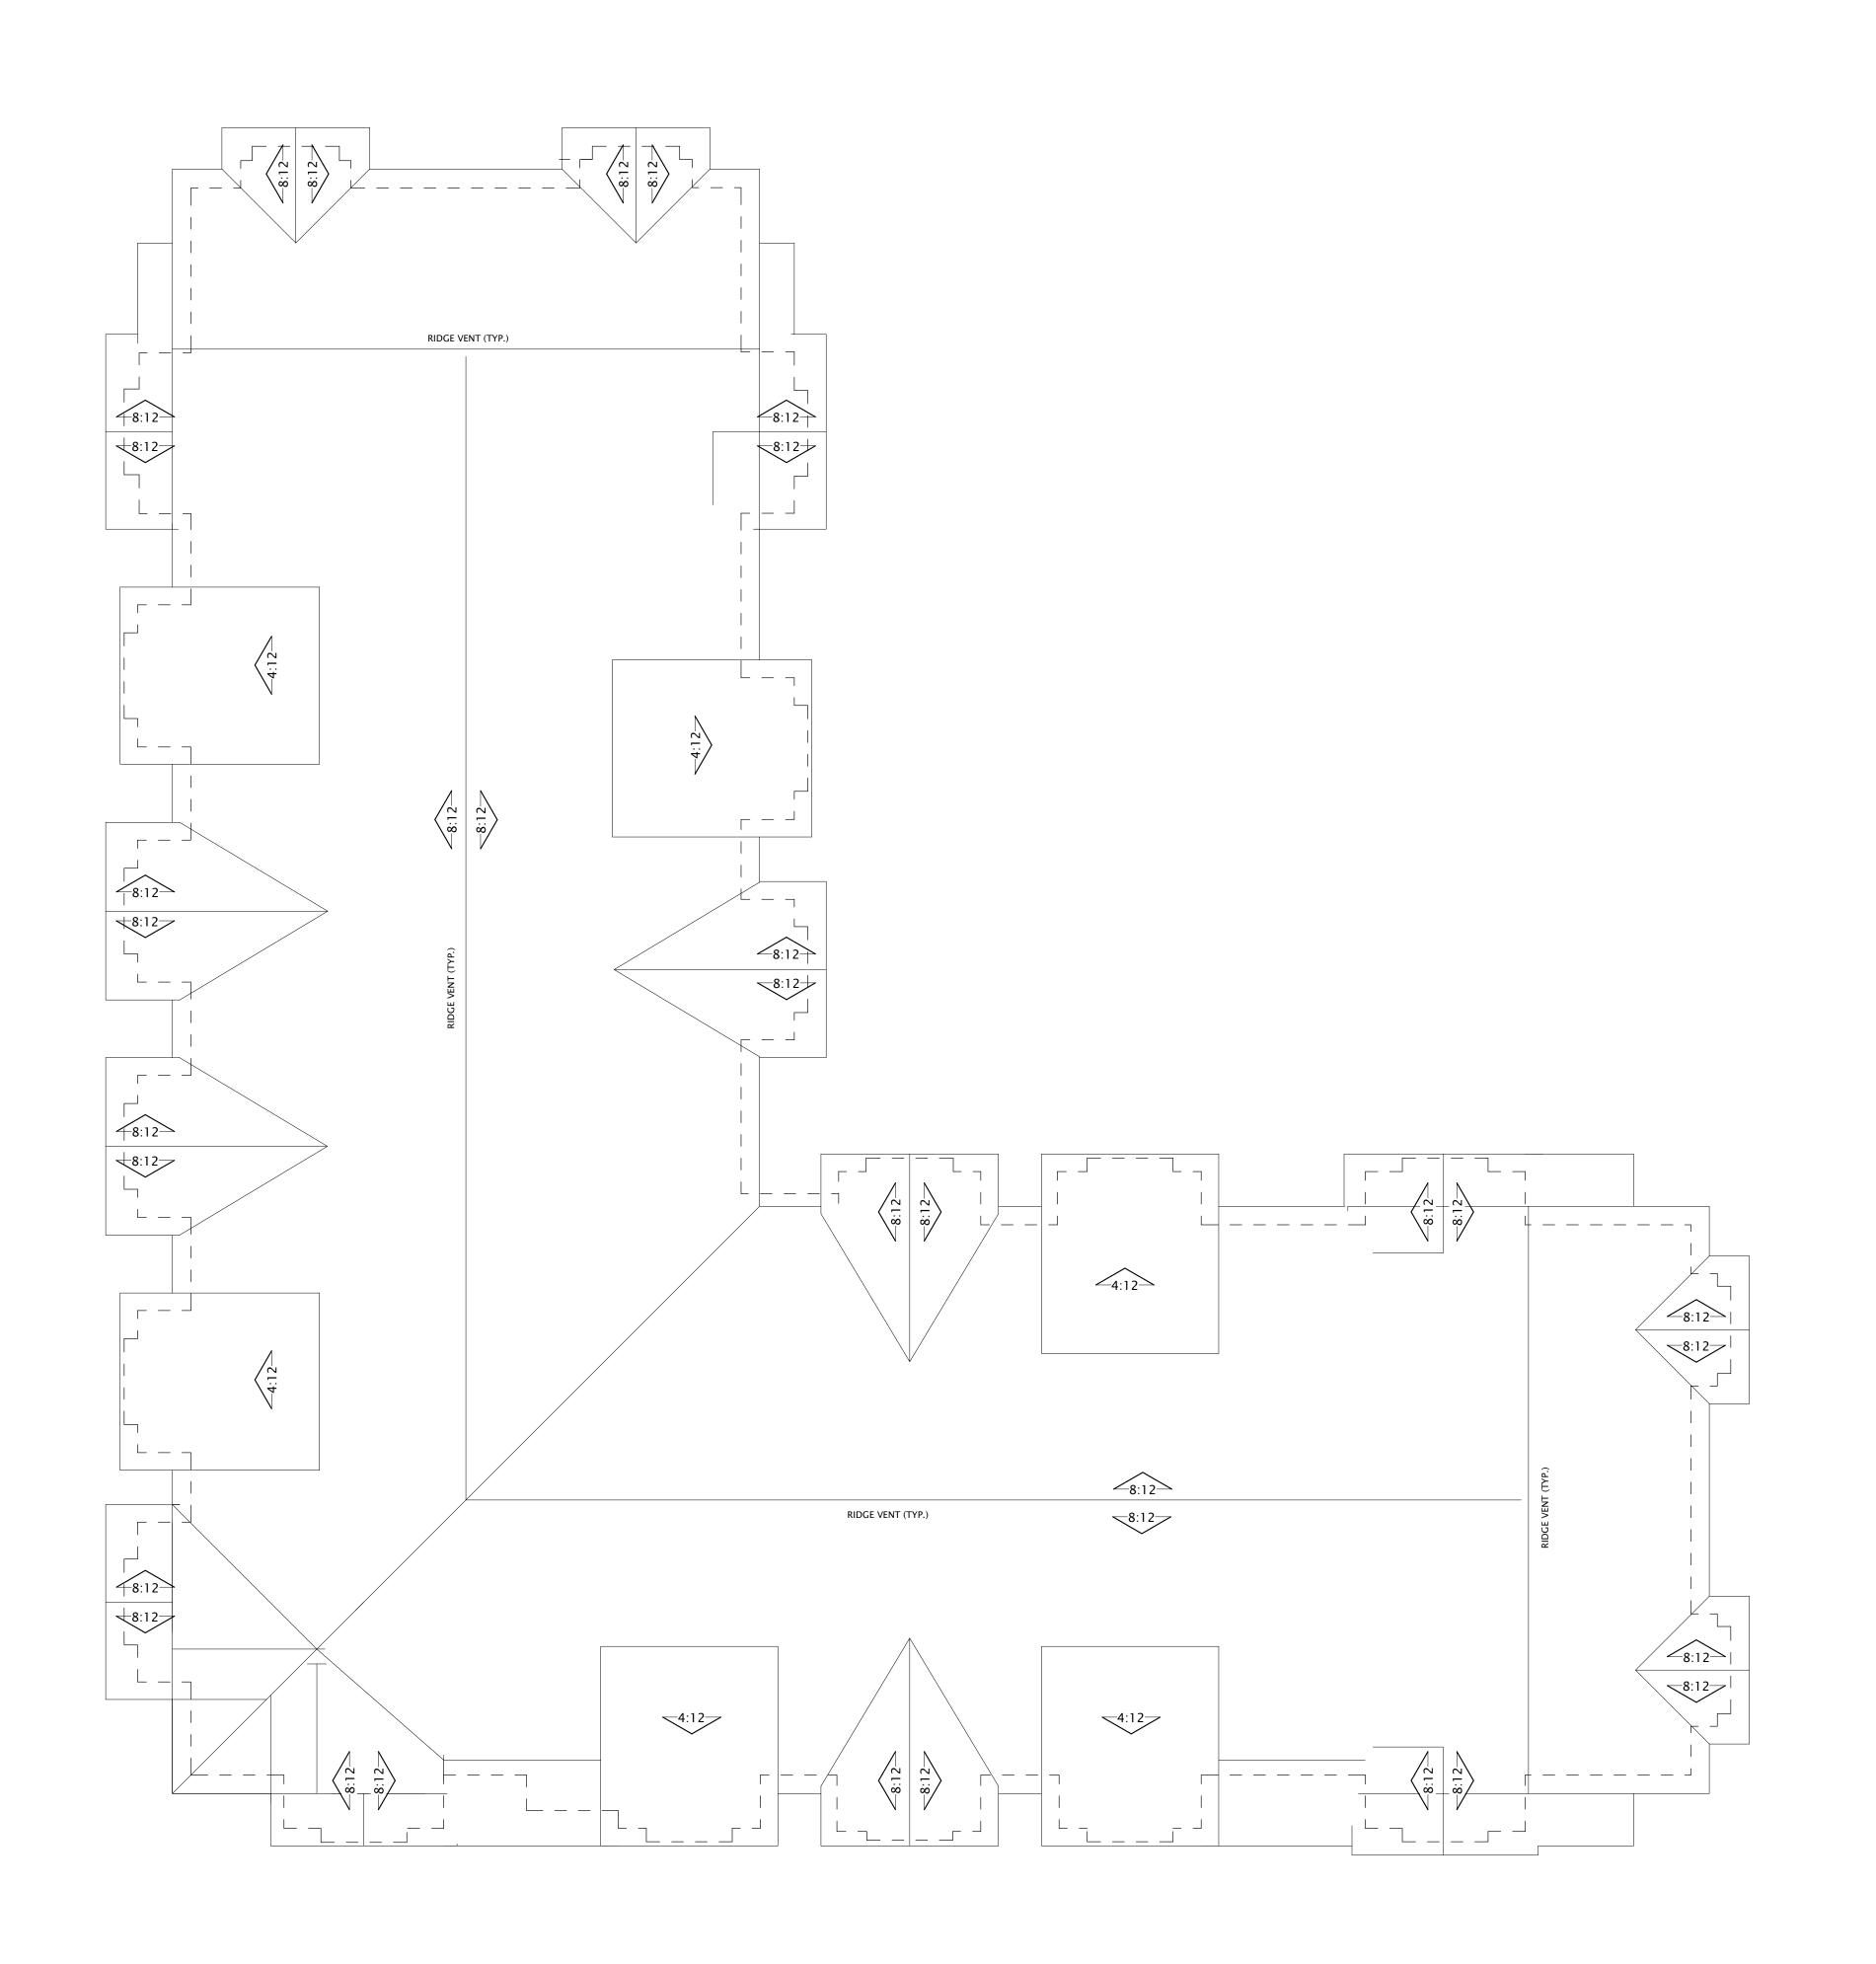
REVISION SCHEDULE

Mark Description Date

SHEET TITLE

THIRD FLOOR PLAN

SHEET NUMBER_





JLA PROJECT NUMBER: XX-XXXX-XX

MAPLE GROVE DRIVE RESIDENTIAL APARTMENTS

LAND USE APPLICATION

PROGRESS DOCUMENTS

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DATE OF ISSUANCE	DECEMBER 18, 2019
REVISION	SCHEDULE

REVISION SCHEDULE

Mark Description Date

SHEET TITLE_

ROOF PLAN

SHEET NUMBER


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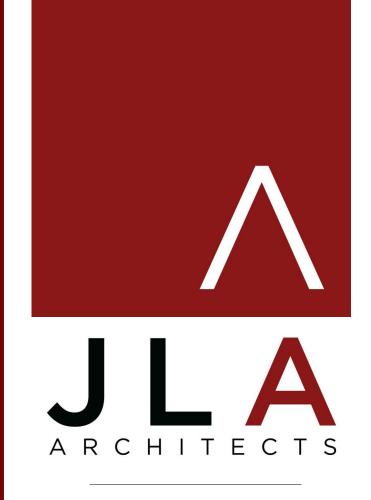
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1) ROOF PLAN Copy 1
3/32" = 1'-0"







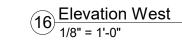

JLA PROJECT NUMBER: XX-XXXX-XX

MAPLE GROVE DRIVE RESIDENTIAL APARTMENTS

PROGRESS OF PROJECT

PROGRESS DOCUMENTS

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DATE OF ISSUANCE MONTH DATE, YEAR

REVISION SCHEDULE

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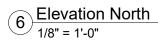
SHEET TITLE

SKETCHUP ELEVATIONS

SHEET NUMBER_

A-A200







16 Elevation East 1/8" = 1'-0"



MADISON: MILWAUKEE jla-ap.com

JLA PROJECT NUMBER: XX-XXXX-XX

MAPLE GROVE DRIVE RESIDENTIAL APARTMENTS

LAND USE APPLICATION

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SHEET TITLE

SKETCHUP ELEVATIONS


SHEET NUMBER

A-A201



6 PERSPECTIVE NE 1/-0"



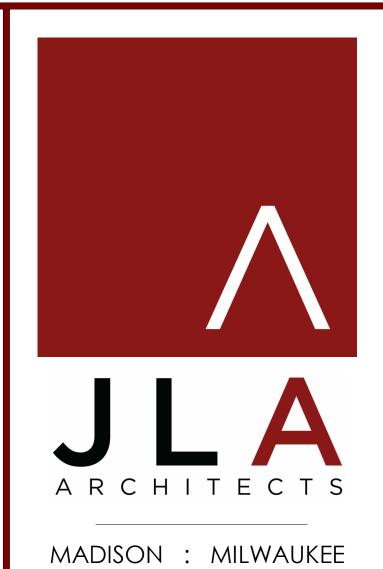

jla-ap.com

JLA PROJECT NUMBER: XX-XXXX-XX

MAPLE GROVE DRIVE RESIDENTIAL APARTMENTS

LAND USE APPLICATION

PROGRESS DOCUMENTS

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Description


SKETCHUP PERSPECTIVES

SHEET NUMBER_

SHEET TITLE

Mark

A-A202

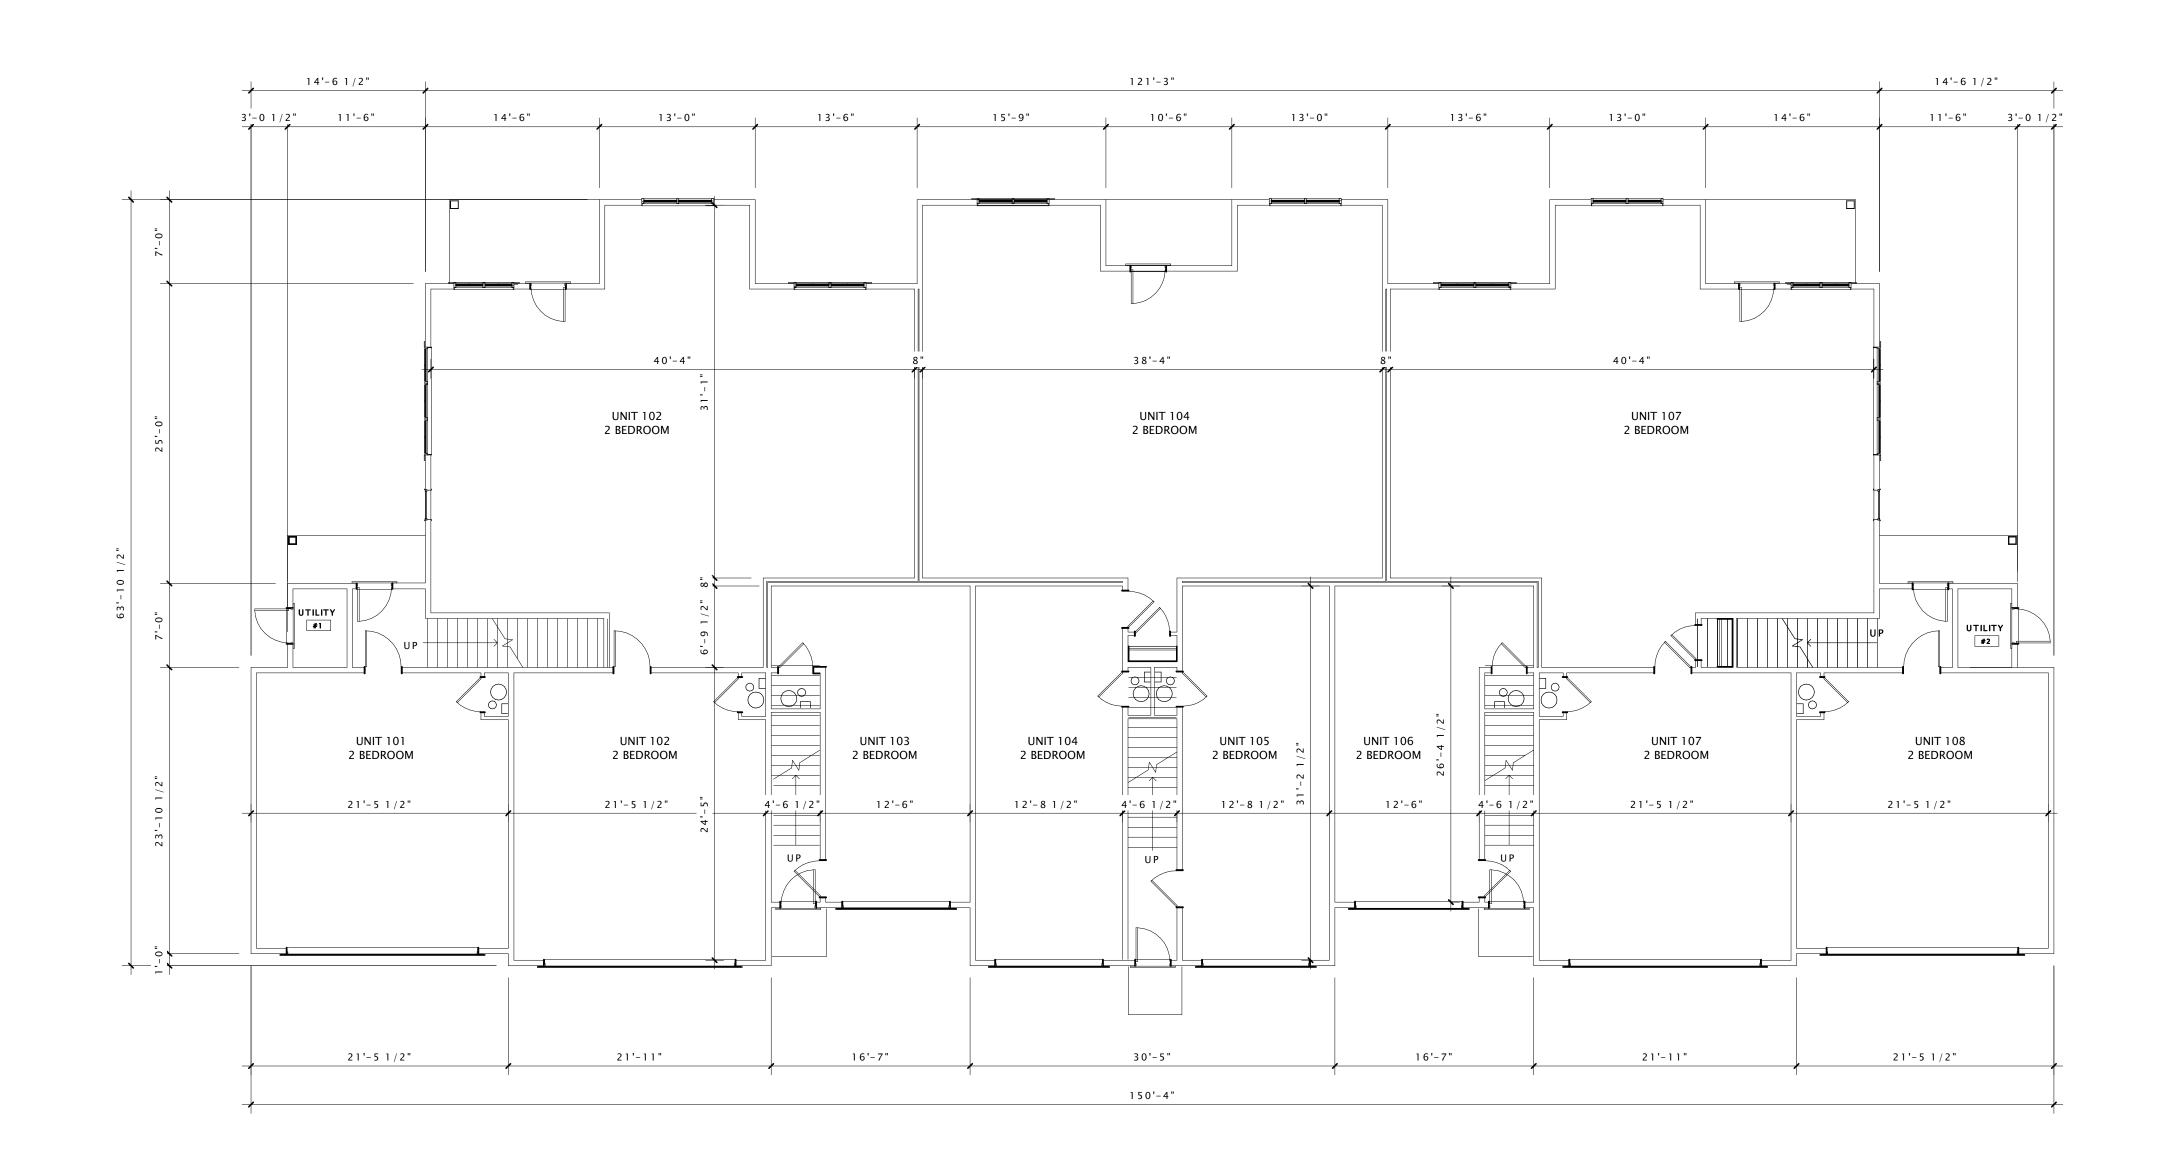



JLA PROJECT NUMBER: XX-XXXX-XX

MAPLE GROVE ROAD STACKED FLATS

LAND USE APPLICATION

PROGRESS DOCUMENTS

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DATE OF ISSUANCE DECEMBER 18, 2019 REVISION SCHEDULE

Description

Date


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SHEET TITLE

FIRST FLOOR PLAN

SHEET NUMBER_

S-A101



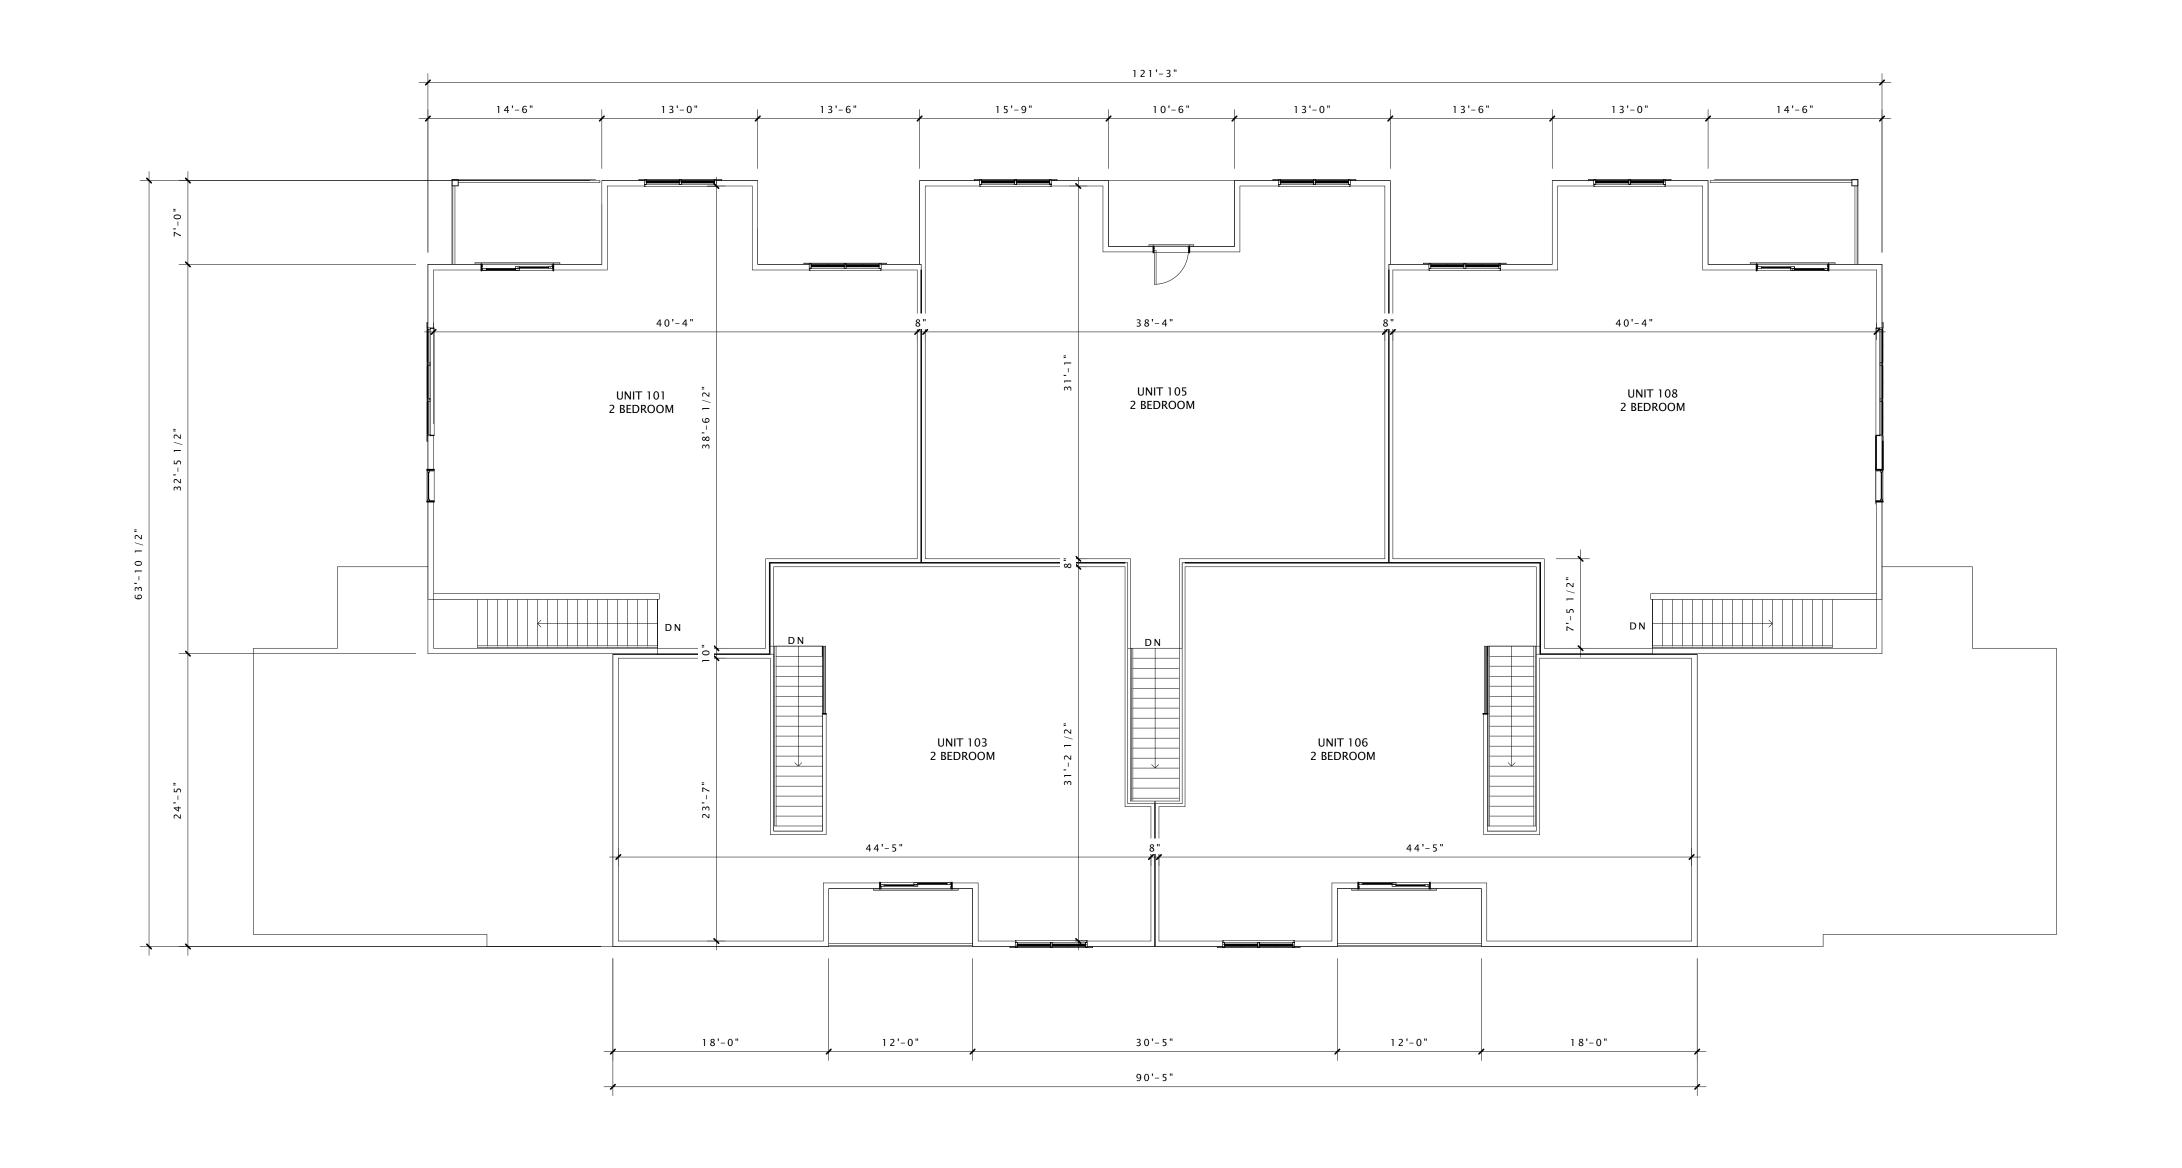

JLA PROJECT NUMBER: XX-XXXX-XX

MAPLE GROVE ROAD STACKED FLATS

LAND USE APPLICATION

PROGRESS DOCUMENTS

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REVISION SCHEDULE

REVISION SCHEDULE

Mark Description Date

SHEET TITLE


SECOND FLOOR PLAN

SHEET NUMBER_

S-A102

1) SECOND FLOOR PLAN
1/8" = 1'-0"

0:55:29 PM

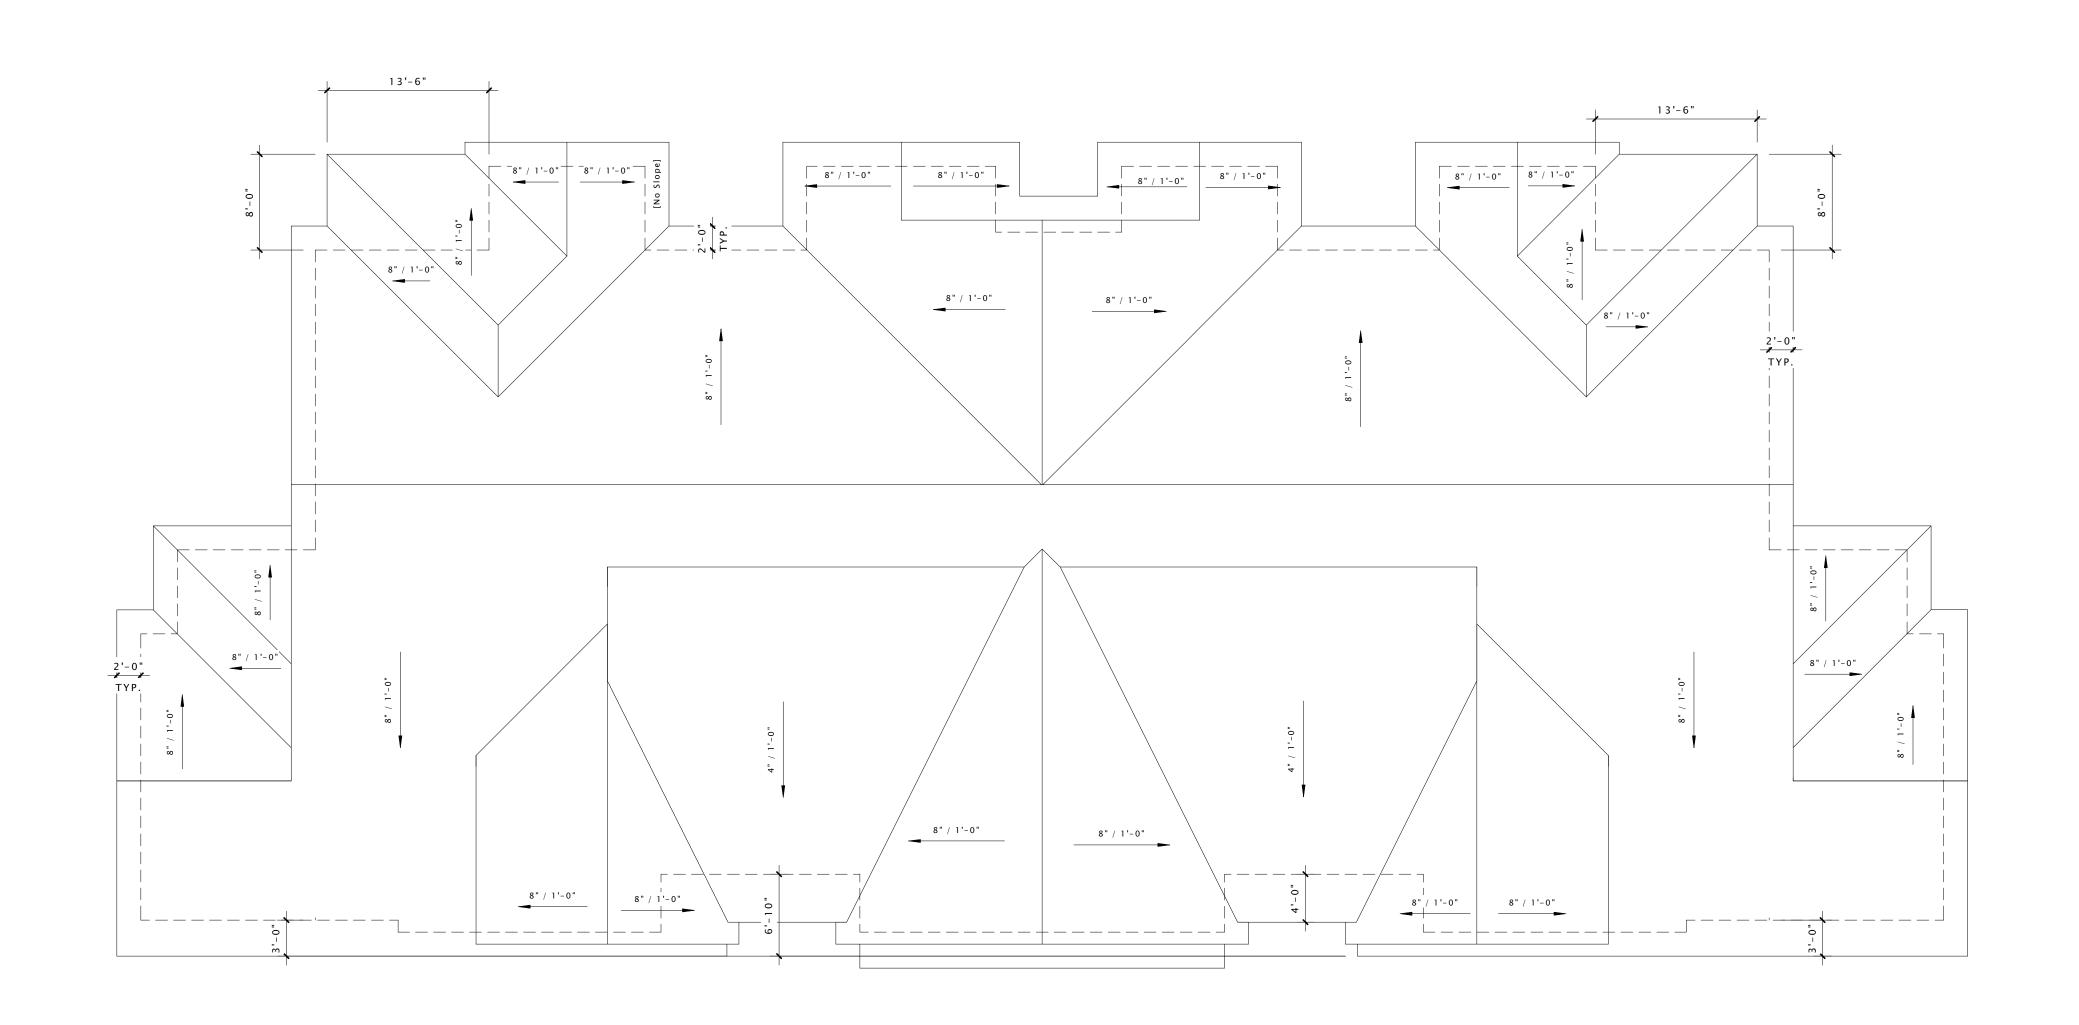



JLA PROJECT NUMBER: XX-XXXX-XX

MAPLE GROVE ROAD
STACKED FLATS

LAND USE APPLICATION

PROGRESS DOCUMENTS

These documents reflect progress and intent and may be subject to change, including additional detail. These are not final construction documents and should not be used for final bidding or construction-related purposes.

DATE OF ISSUANCE DECEMBER 18, 2019

REVISION SCHEDULE

Date

Mark Description

SHEET TITLE_

ROOF PLAN

SHEET NUMBER_

S-A103

1) ROOF PLAN 1/8" = 1'-0"



MADISON : MILWAUKEE

jla-ap.com

JLA PROJECT NUMBER: XX-XXXX-XX

XXX

PROGRESS OF PROJECT

PROGRESS DOCUMENTS

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DATE OF ISSUANCE		MONIH DAIE, YEAR			
REVISION SCHEDULE					
Mark	Description	า	Date		

SHEET TITLE

SKETCHUP **ELEVATIONS**

SHEET NUMBER

CABLE LOUVER


16) WEST ELEVATION
3/16" = 1'-0"



6 NORTH ELEVATION
3/16" = 1'-0"



16 EAST ELEVATION
3/16" = 1'-0"

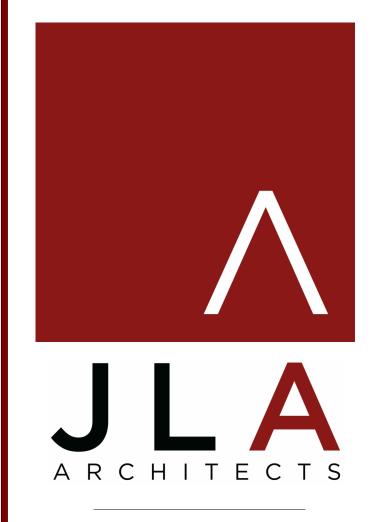

MADISON: MILWAUKEE jla-ap.com

JLA PROJECT NUMBER: XX-XXXX-XX

MAPLE GROVE DRIVE RESIDENTIAL STACKED FLATS

LAND USE APPLICATION

PROGRESS DOCUMENTS

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DATE OF ISSUANCE DECEMBER 18, 2019

REVISION SCHEDULE

Mark Description Date

SHEET TITLE

SKETCHUP ELEVATIONS

SHEET NUMBER_

SF-A201



6 PERSPECTIVE NE 1/8" = 1'-0"



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JLA PROJECT NUMBER: XX-XXXX-XX

MAPLE GROVE DRIVE RESIDENTIAL STACKED FLATS

LAND USE APPLICATION

PROGRESS DOCUMENTS

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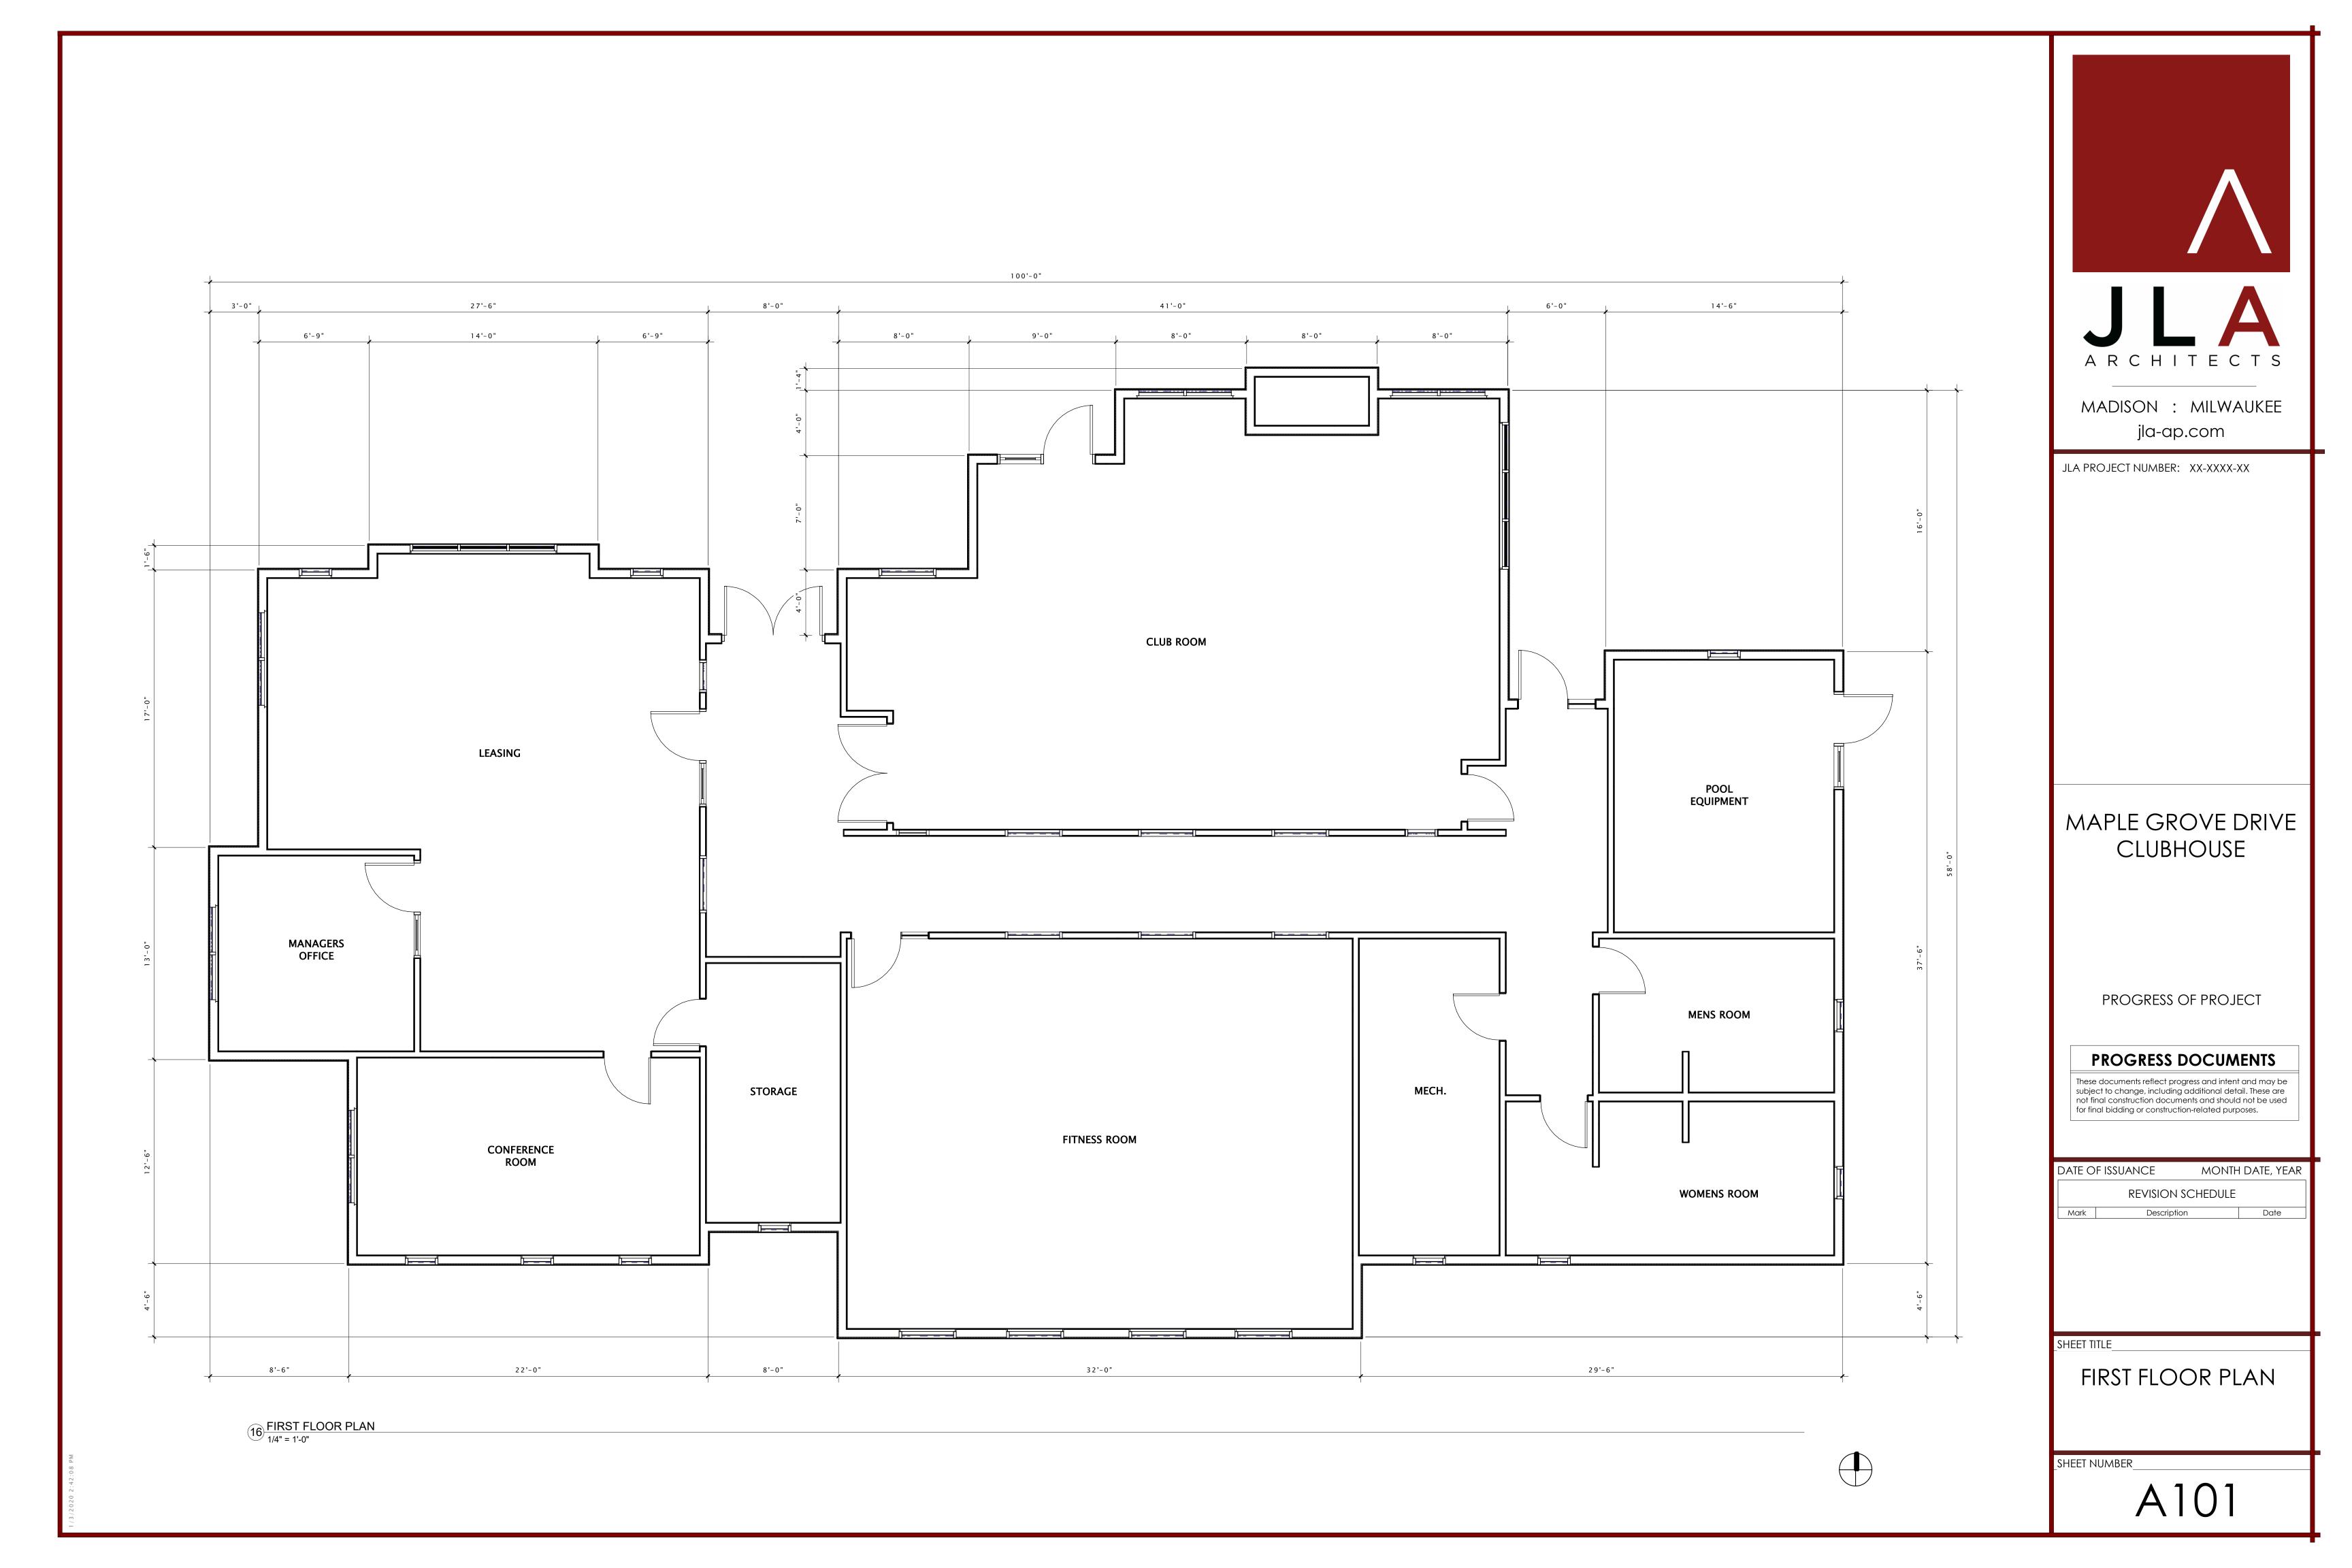
DECEMBER 18, 2019 DATE OF ISSUANCE REVISION SCHEDULE Date Mark Description


SHEET TITLE

SKETCHUP PERSPECTIVE

SHEET NUMBER

SF-A202



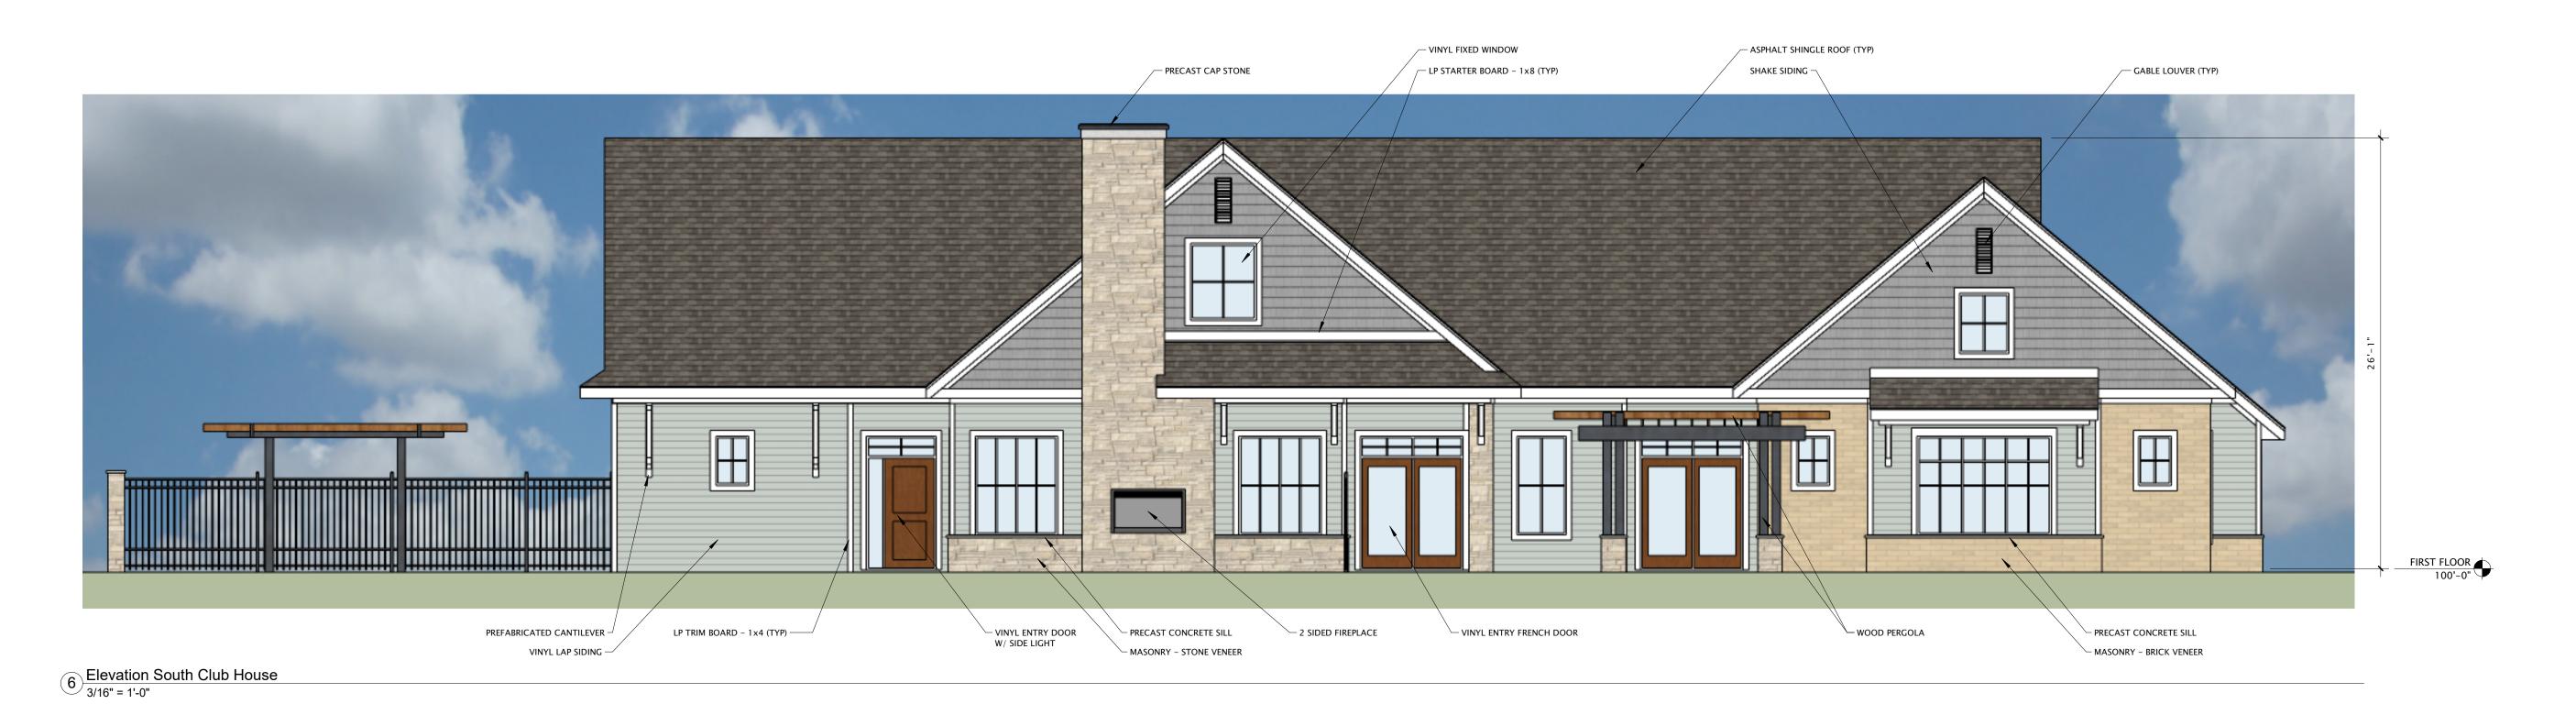



16 Elevation West Club House
3/16" = 1'-0"

J L A
ARCHITECTS

MADISON: MILWAUKEE jla-ap.com

JLA PROJECT NUMBER: XX-XXXX-XX

MAPLE GROVE DRIVE CLUBHOUSE

LAND USE APPLICATION

PROGRESS DOCUMENTS

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REVISION SCHEDULE

Mark Description Date

SHEET TITLE_

SKETCHUP ELEVATIONS

SHEET NUMBER_

CH-A200



6 Elevation North Club House 3/16" = 1'-0"



16 Elevation East Club House
3/16" = 1'-0"

J L A
ARCHITECTS

MADISON: MILWAUKEE jla-ap.com

JLA PROJECT NUMBER: XX-XXXX-XX

MAPLE GROVE DRIVE CLUBHOUSE

LAND USE APPLICATION

PROGRESS DOCUMENTS

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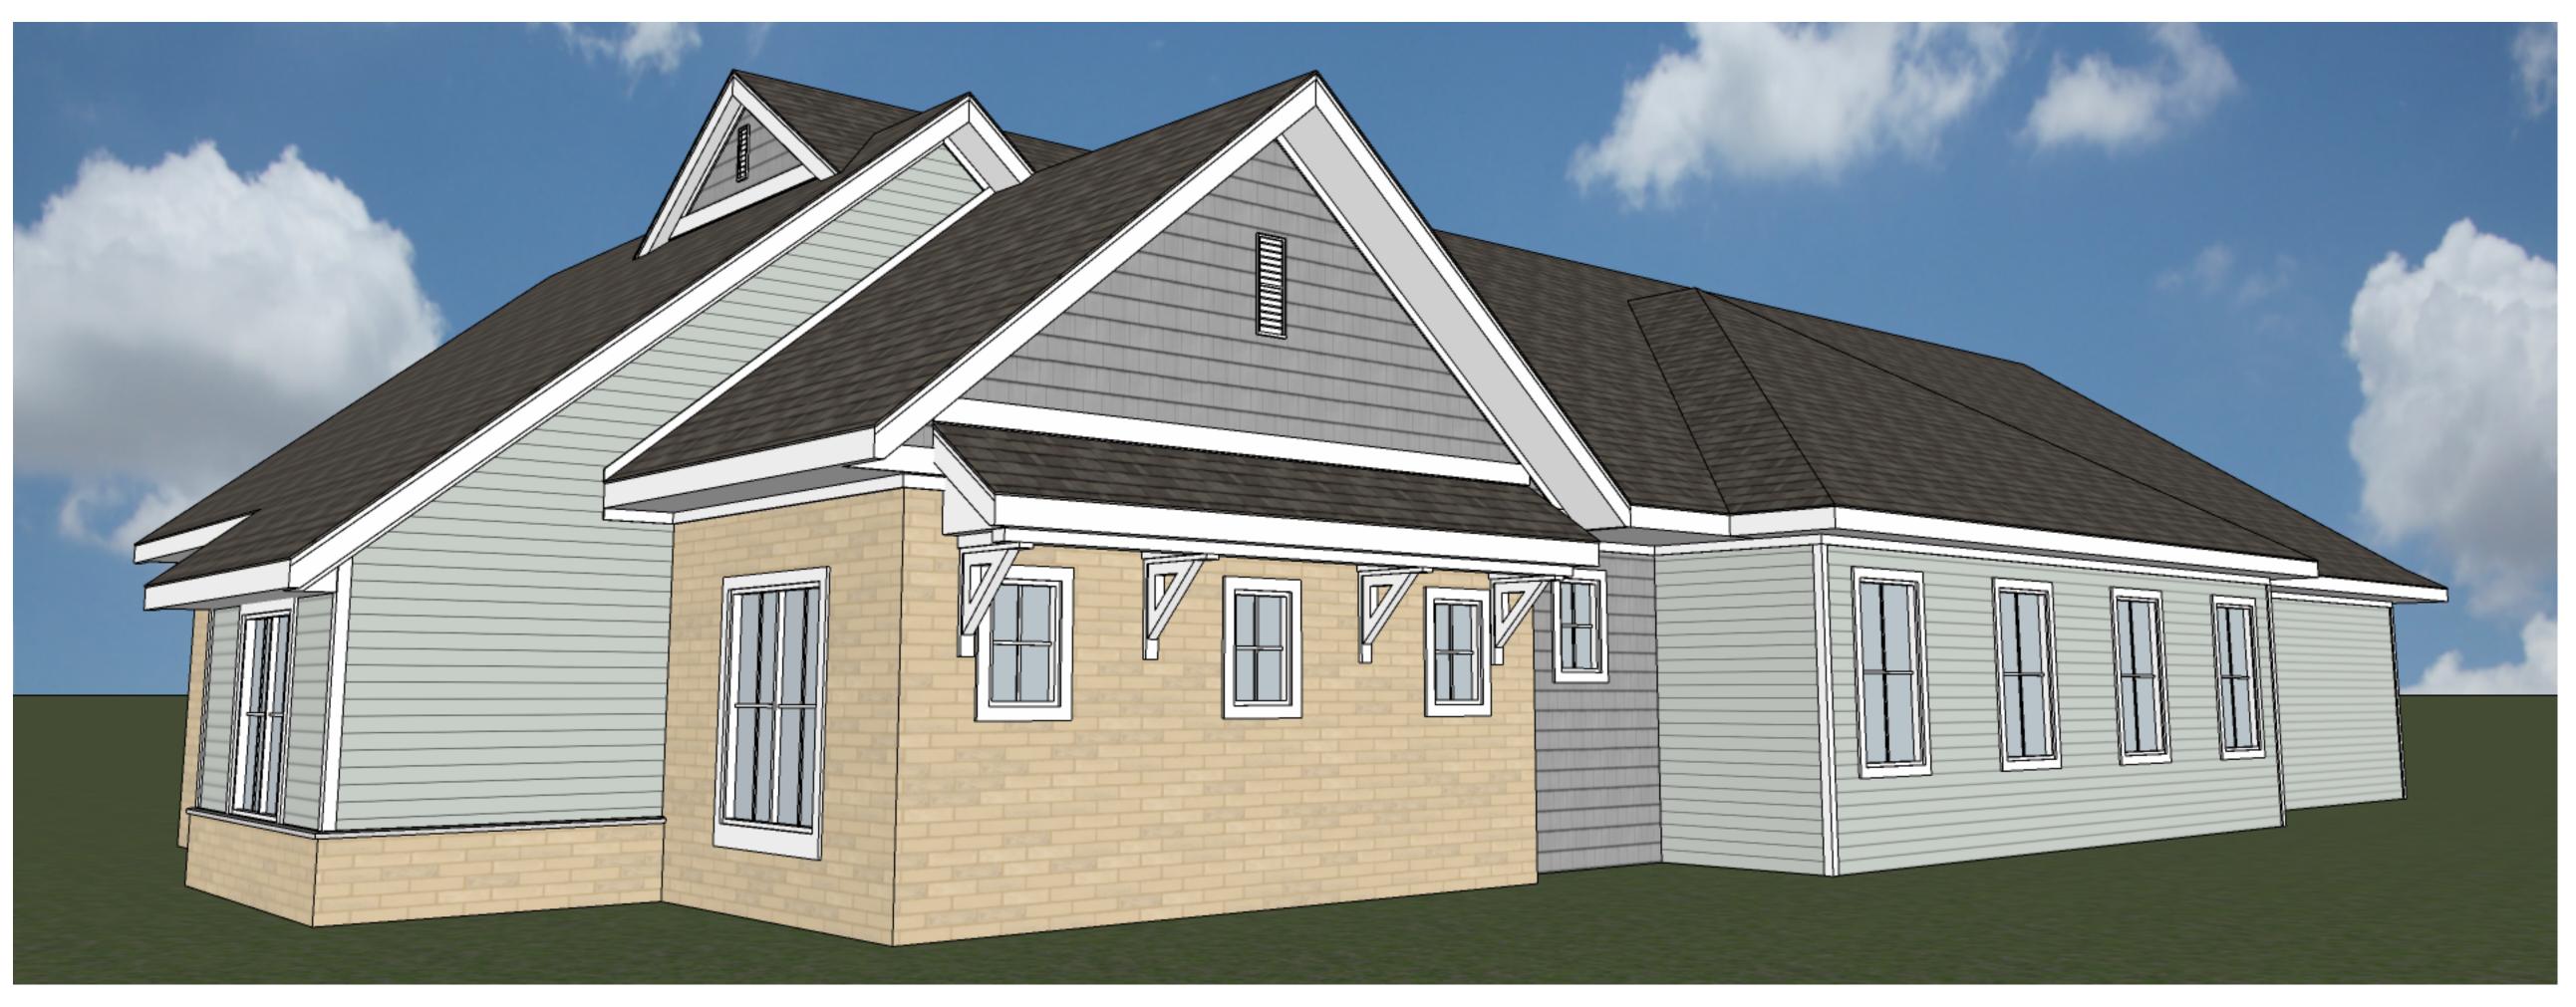
SHEET TITLE

Mark

SKETCHUP ELEVATIONS


SHEET NUMBER_

CH-A201



6 PERSPECTIVE Club House NE 1/8" = 1'-0"



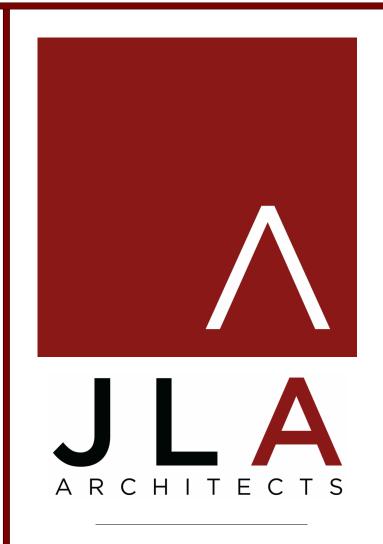

MADISON: MILWAUKEE jla-ap.com

JLA PROJECT NUMBER: XX-XXXX-XX

MAPLE GROVE DRIVE CLUBHOUSE

LAND USE APPLICATION

PROGRESS DOCUMENTS

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Date

Description

SKETCHUP PERSPECTIVES

SHEET NUMBER

SHEET TITLE

Mark

CH-A202