

GENERAL NOTES:

ALL WORK IN THE PUBLIC RIGHT OF WAY SHALL BE PERFORMED BY A

CITY-LICENSED CONTRACTOR.

I. THE APPLICANT SHALL REPLACE ALL SIDEWALK AND CURB AND GUTTER THAT ABUTS THE PROPERTY THAT IS DAMAGED BY THE CONSTRUCTION OR THAT THE CITY ENGINEER DETERMINES IS NOT AT A DESIRABLE GRADE.

2. ALL DAMAGE TO THE PAVEMENT ON CITY STREETS RESULTING FROM CONSTRUCTION OF THIS DEVELOPMENT SHALL BE RESTORED IN ACCORDANCE WITH THE CITY OF MADISON'S PAVEMENT PATCHING

3. THE ACCESSIBLE ROUTE SHALL HAVE A MAXIMUM 1:20 RUNNING SLOPE AND A MAXIMUM 1:48 CROSS SLOPE. CURB RAMPS SHALL BE NO STEEPER THAN 1:12 AND SHALL HAVE NO MORE THAN A 6 INCH RISE.

4. ACCESSIBLE PARKING STALLS SHALL HAVE A MAXIMUM SLOPE OF 1:48 IN ALL DIRECTIONS.

5. PROVIDE ACCESSIBLE PARKING SIGN AT THE HEAD OF EACH ACCESSIBLE STALL. BOTTOM OF SIGN SHALL BE MOUNTED AT 60 INCHES ABOVE GRADE.

6. PROVIDE CONCRETE WHEEL STOP AT HEAD OF EACH ACCESSIBLE STALL WHERE PARKING STALL SURFACE IS FLUSH WITH WALK.

Phone: 7601 University Ave, Ste 201 608.836.3690 Middleton, WI 53562

SITE DEVELOPMENT STATISTICS: 5130 HIGH CROSSING BLVD.

LOT 2 CSM 14019 ZONING DISTRICT: CC

LOT AREA: 89,965 S.F. (2.06 ACRES) **PAVING & WALKS:** 43,500 S.F. BUILDING FOOTPRINT: \ 10,900 S.F. TOTAL IMPERVIOUS: 54,400 S.F. 56,200 / 63% LOT COVERAGE:

**BUILDING AREAS:** 

FIRST FLOOR: 10,900 SECOND FLOOR: 10,238 THIRD FLOOR: 10,238 FOURTH FLOOR: 10,238 41,614 S.F.

HOTEL GUEST ROOMS: 95 PARKING STALLS: 106 (INCLUDING 5 ADA) PARKING RATIO: 1.1:1 PARKING RATIO LOT I & 2 COMBINED : I.06:I

BICYCLE PARKING: 10 (1 PER 10 GUEST ROOMS)

ISSUED Land Use Submittal - August 28, 2019 Revised Building Location - October 16, 2019



"INVERTED U" TYPE. MADRAX UX OR SARIS BIKE DOCK. PROVIDE ONE RACK BETWEEN EVERY TWO STALLS.

SHEET INDEX:

T-I.I OVERALL SITE PLAN & NOTES

C-I.I ARCHITECTURAL SITE PLAN

C-1.2 SITE LIGHTING PLAN C-I.3 FIRE DEPARTMENT ACCESS PLAN

C-I.4 LOT COVERAGE

C-I.0 EXISTING CONDITIONS

C-2.0 OVERALL GRADING PLAN C-2.1 NORTHWEST GRADING PLAN

C-2.2 SOUTHWEST GRADING PLAN

C-3.0 EROSION CONTROL PLAN

C-4.0 UTILITY PLAN

L-I.0 LANDSCAPE PLAN

A-I.I FIRST FLOOR PLAN

A-1.2 SECOND FLOOR PLAN

A-I.3 THIRD FLOOR PLAN

A-I.4 FOURTH FLOOR PLAN

A-I.5 ROOF PLAN

A-2.1 EXTERIOR ELEVATIONS A-2.2 EXTERIOR ELEVATIONS

A-5.I ENLARGED FLOOR PLANS

RENDERED PERSPECTIVE

PROJECT TITLE **AVID HOTEL** 

5130 High Crossing Blvd. Madison, WI


SHEET TITLE


Title Sheet


SHEET NUMBER


PROJECT NO.


1808 © Knothe & Bruce Architects, LLC

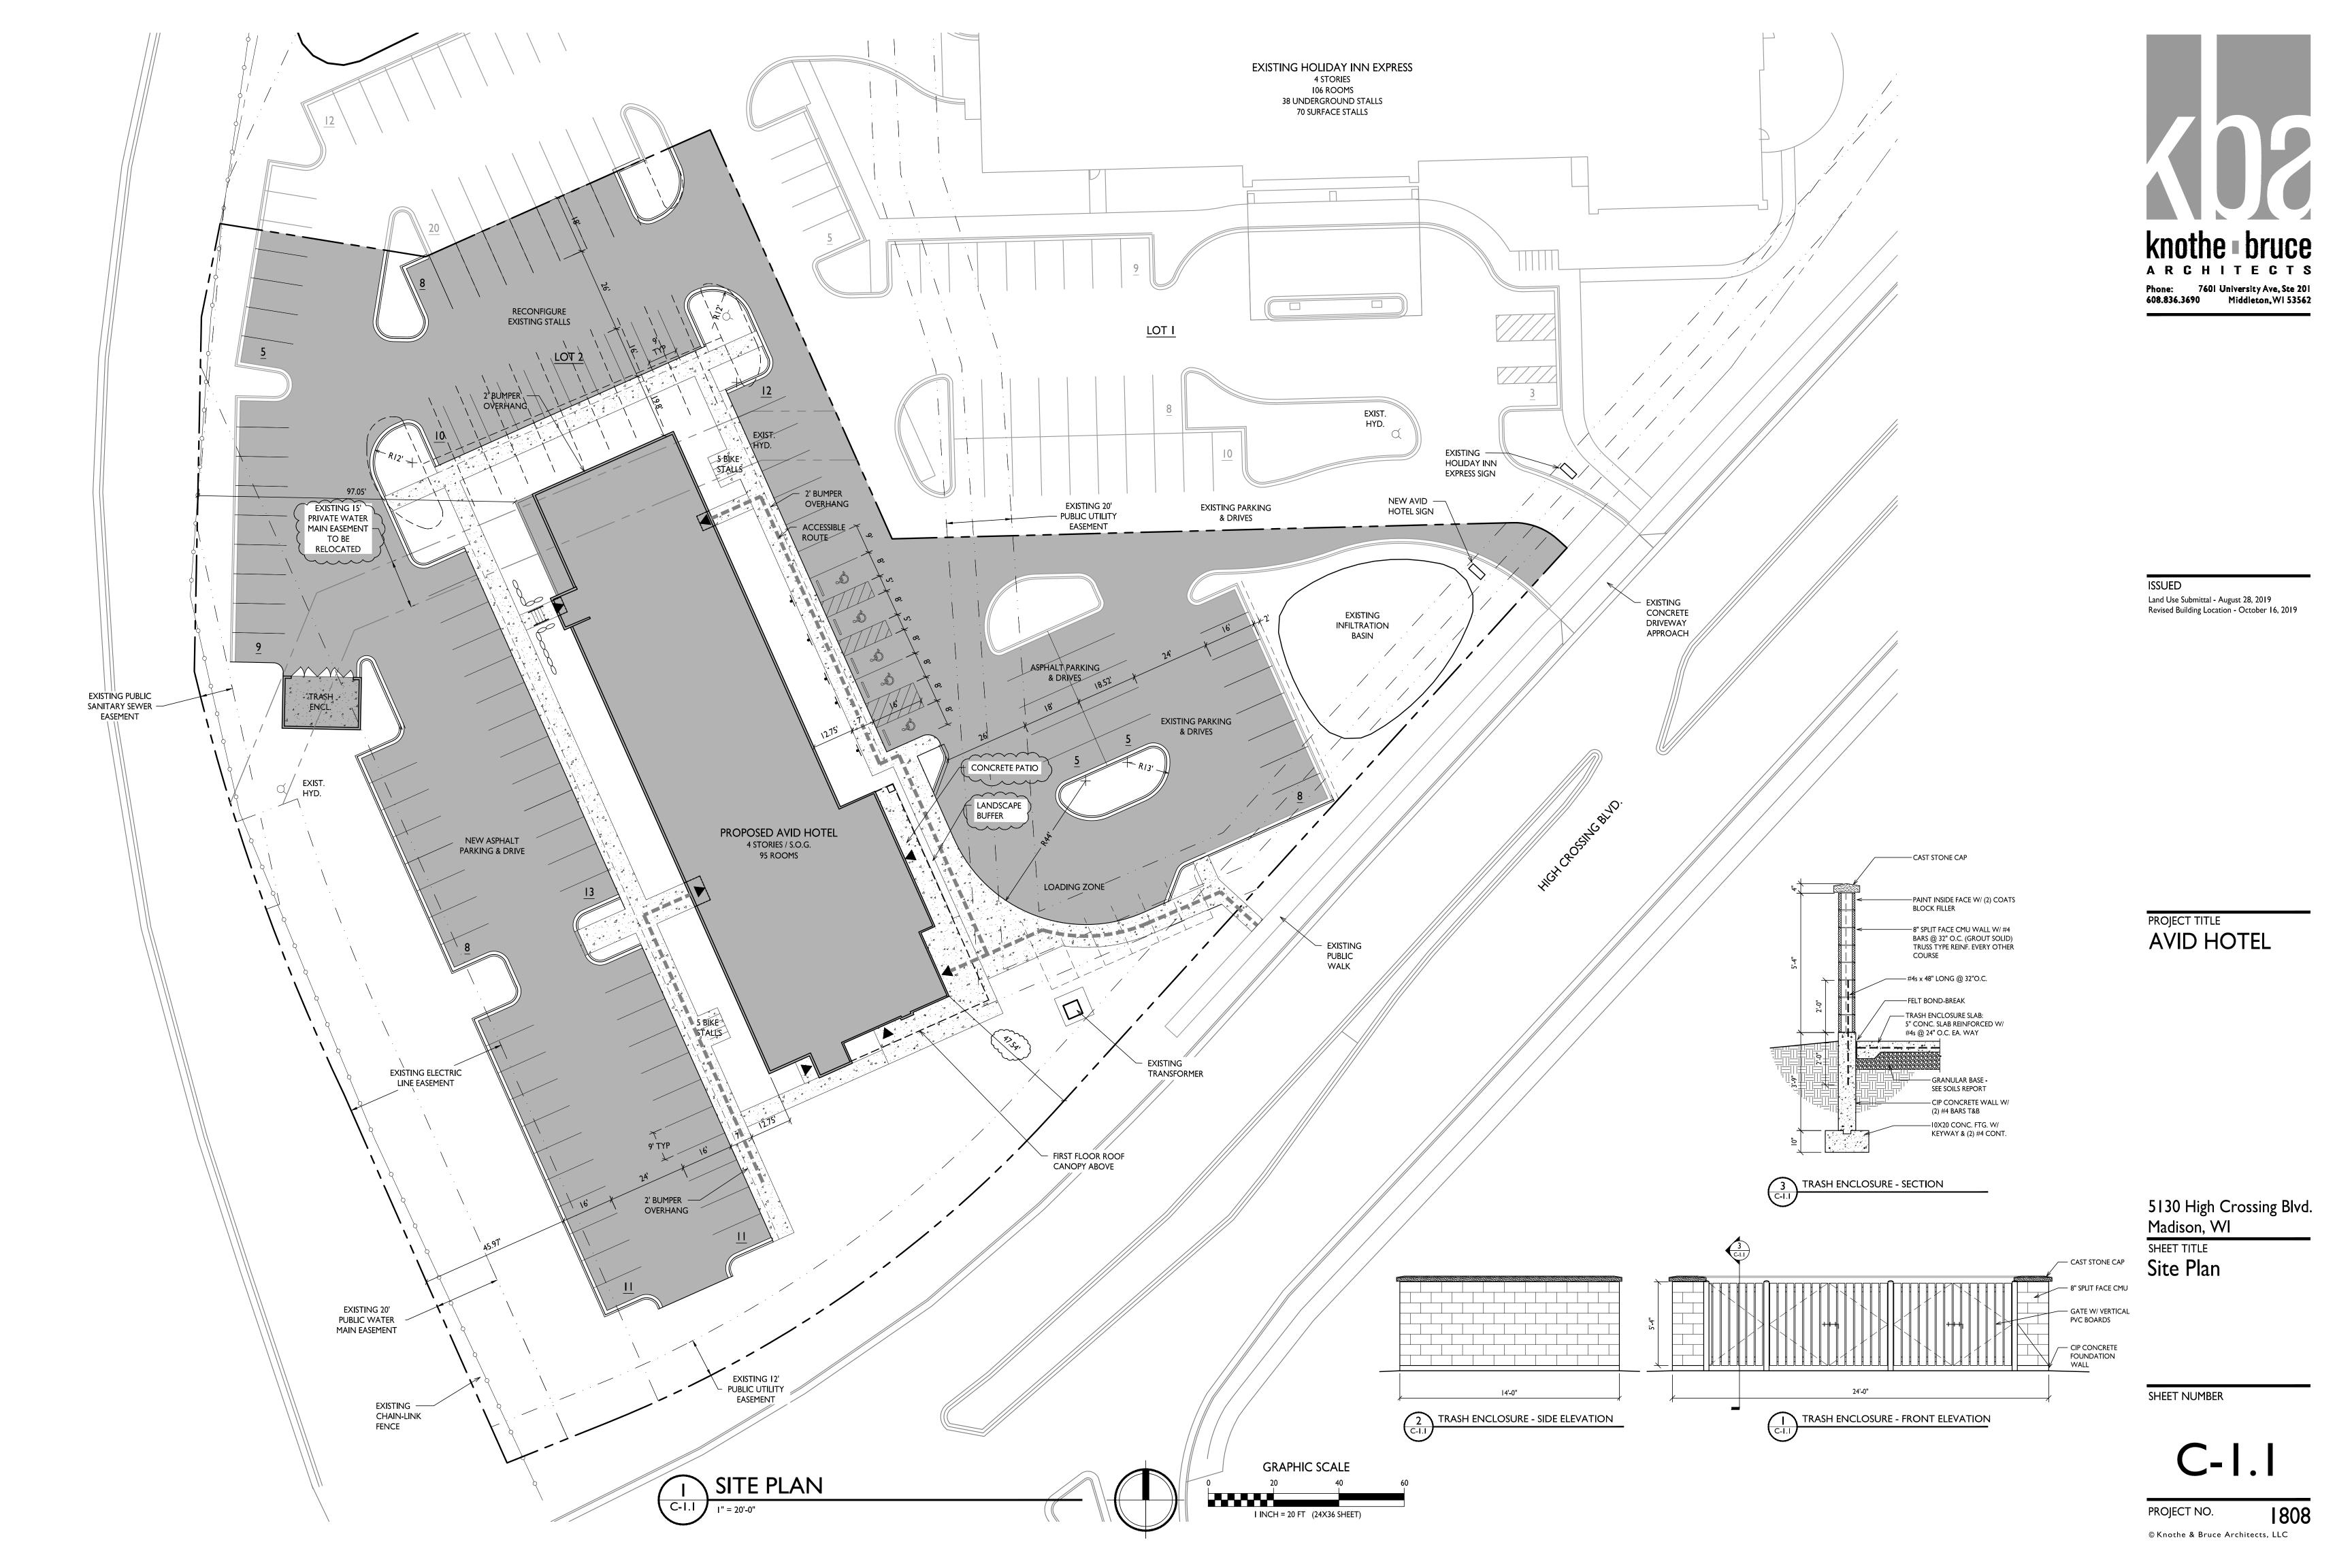

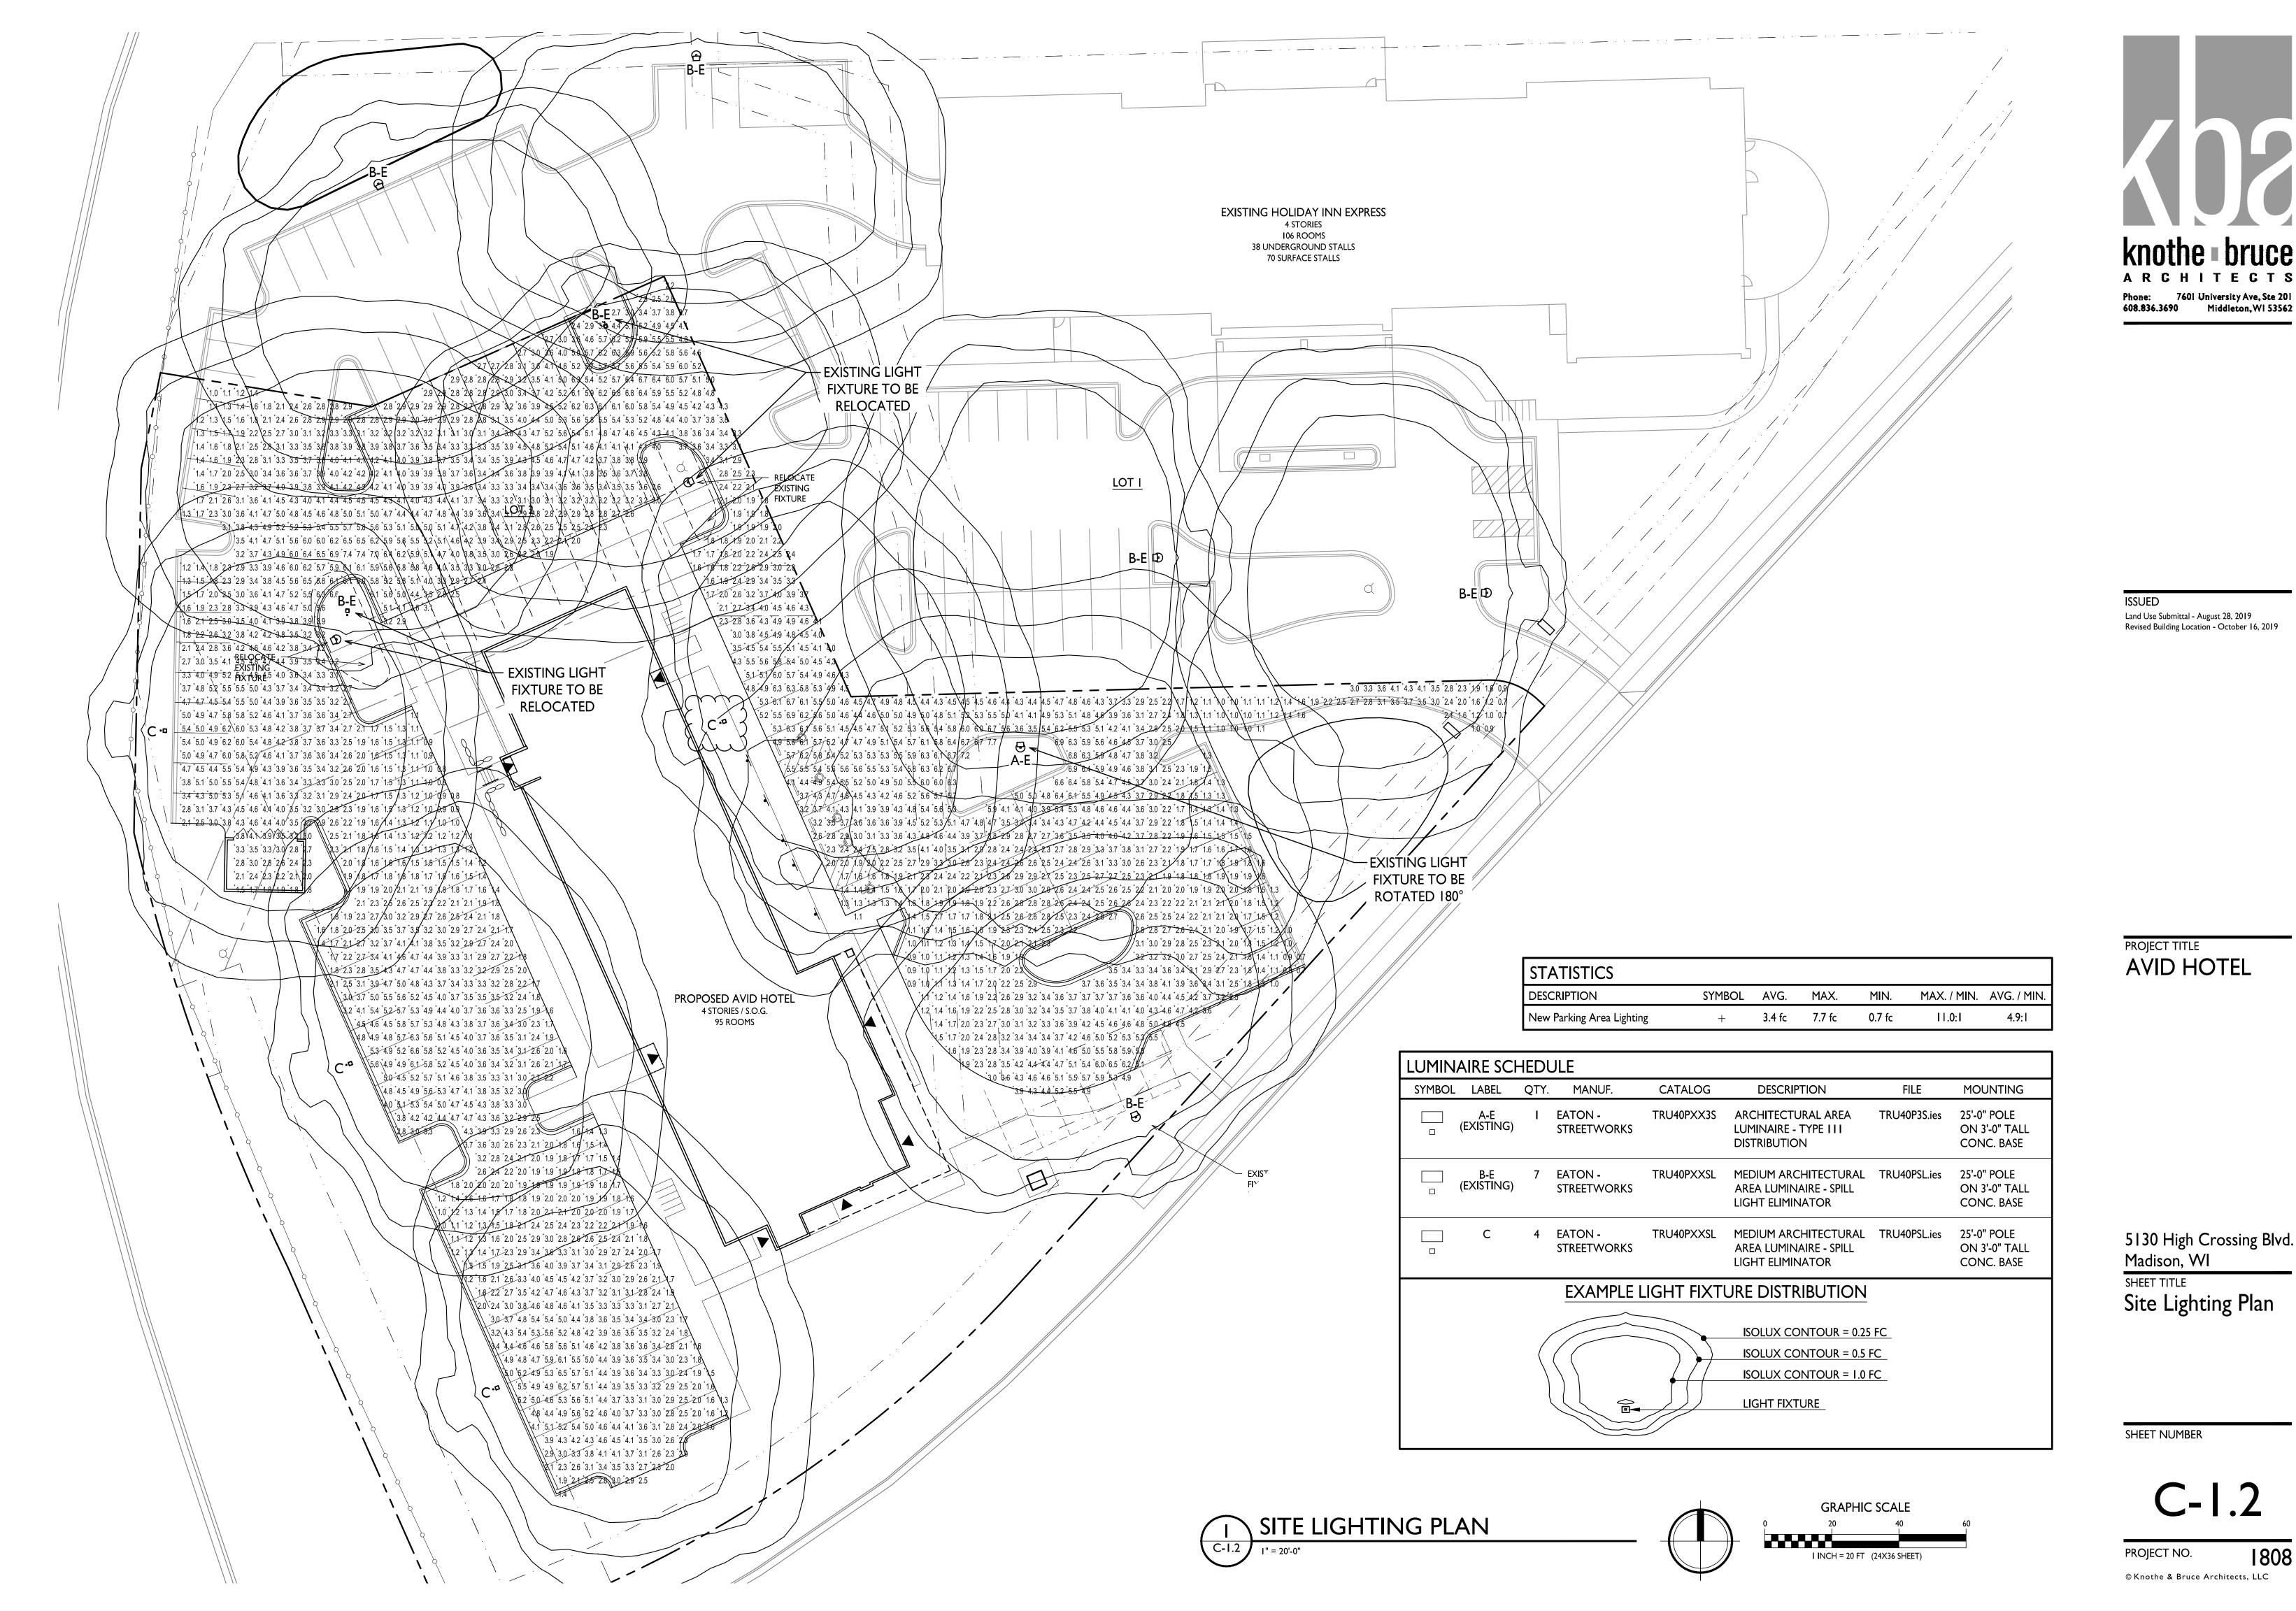

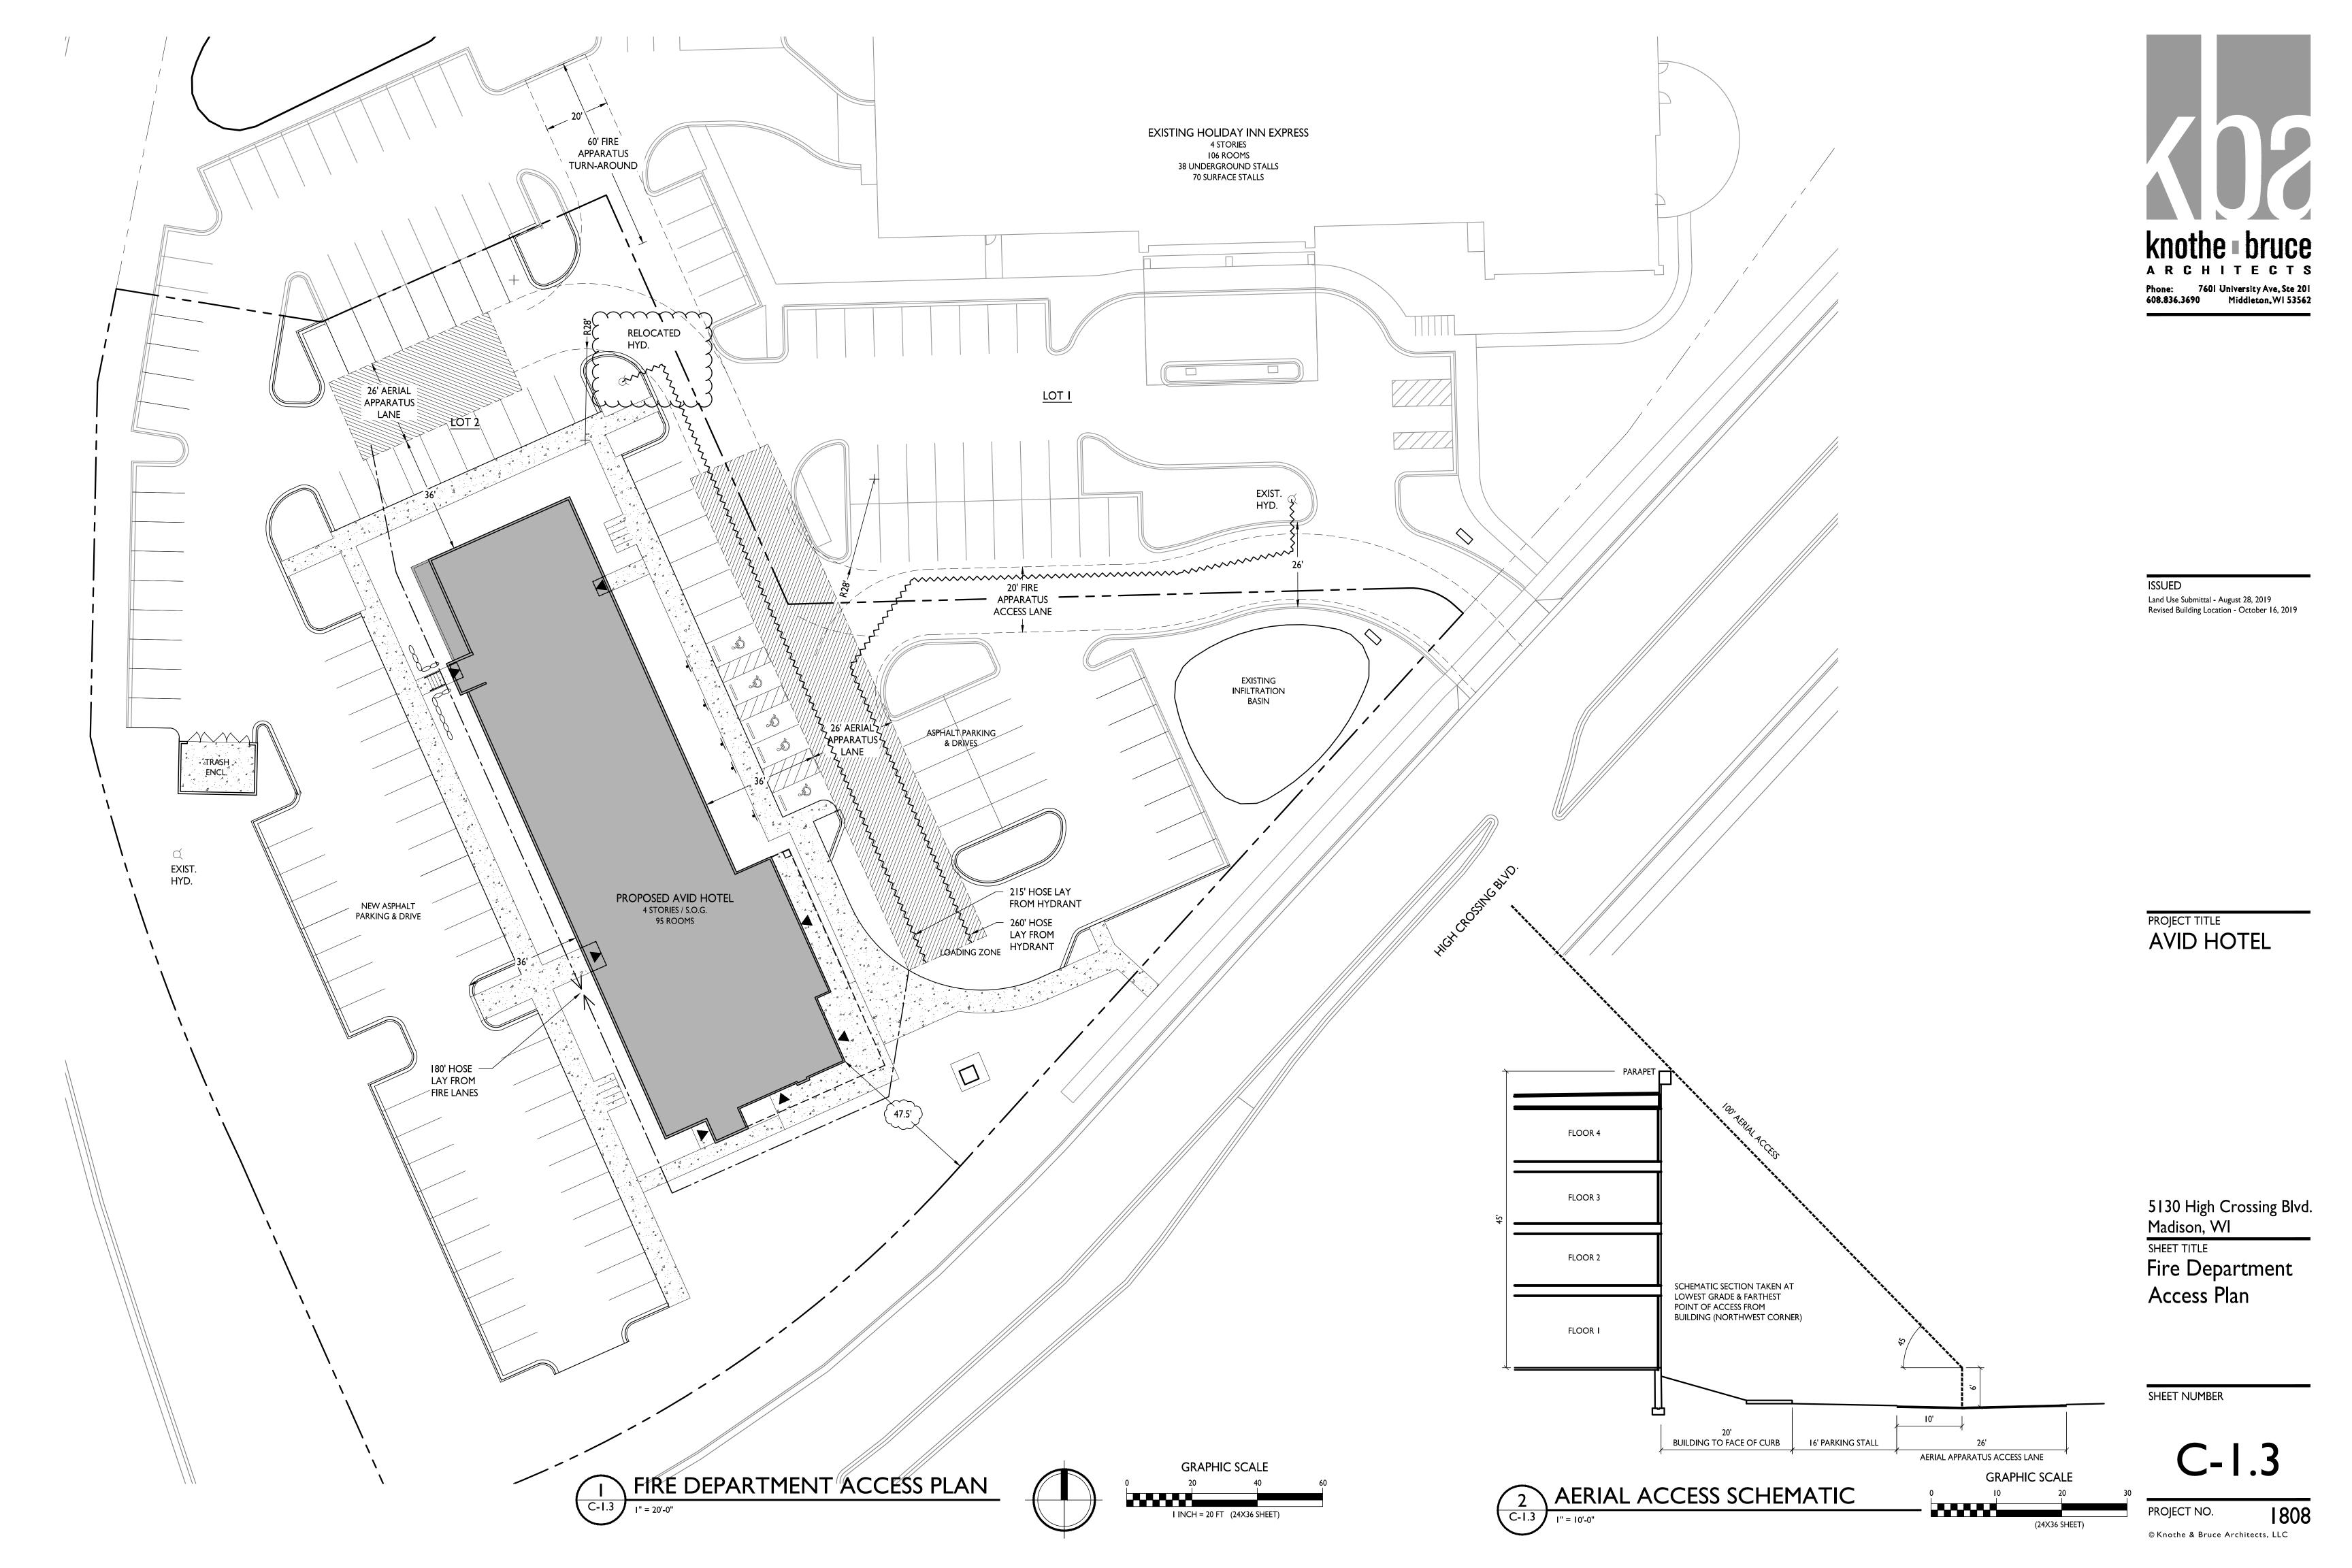

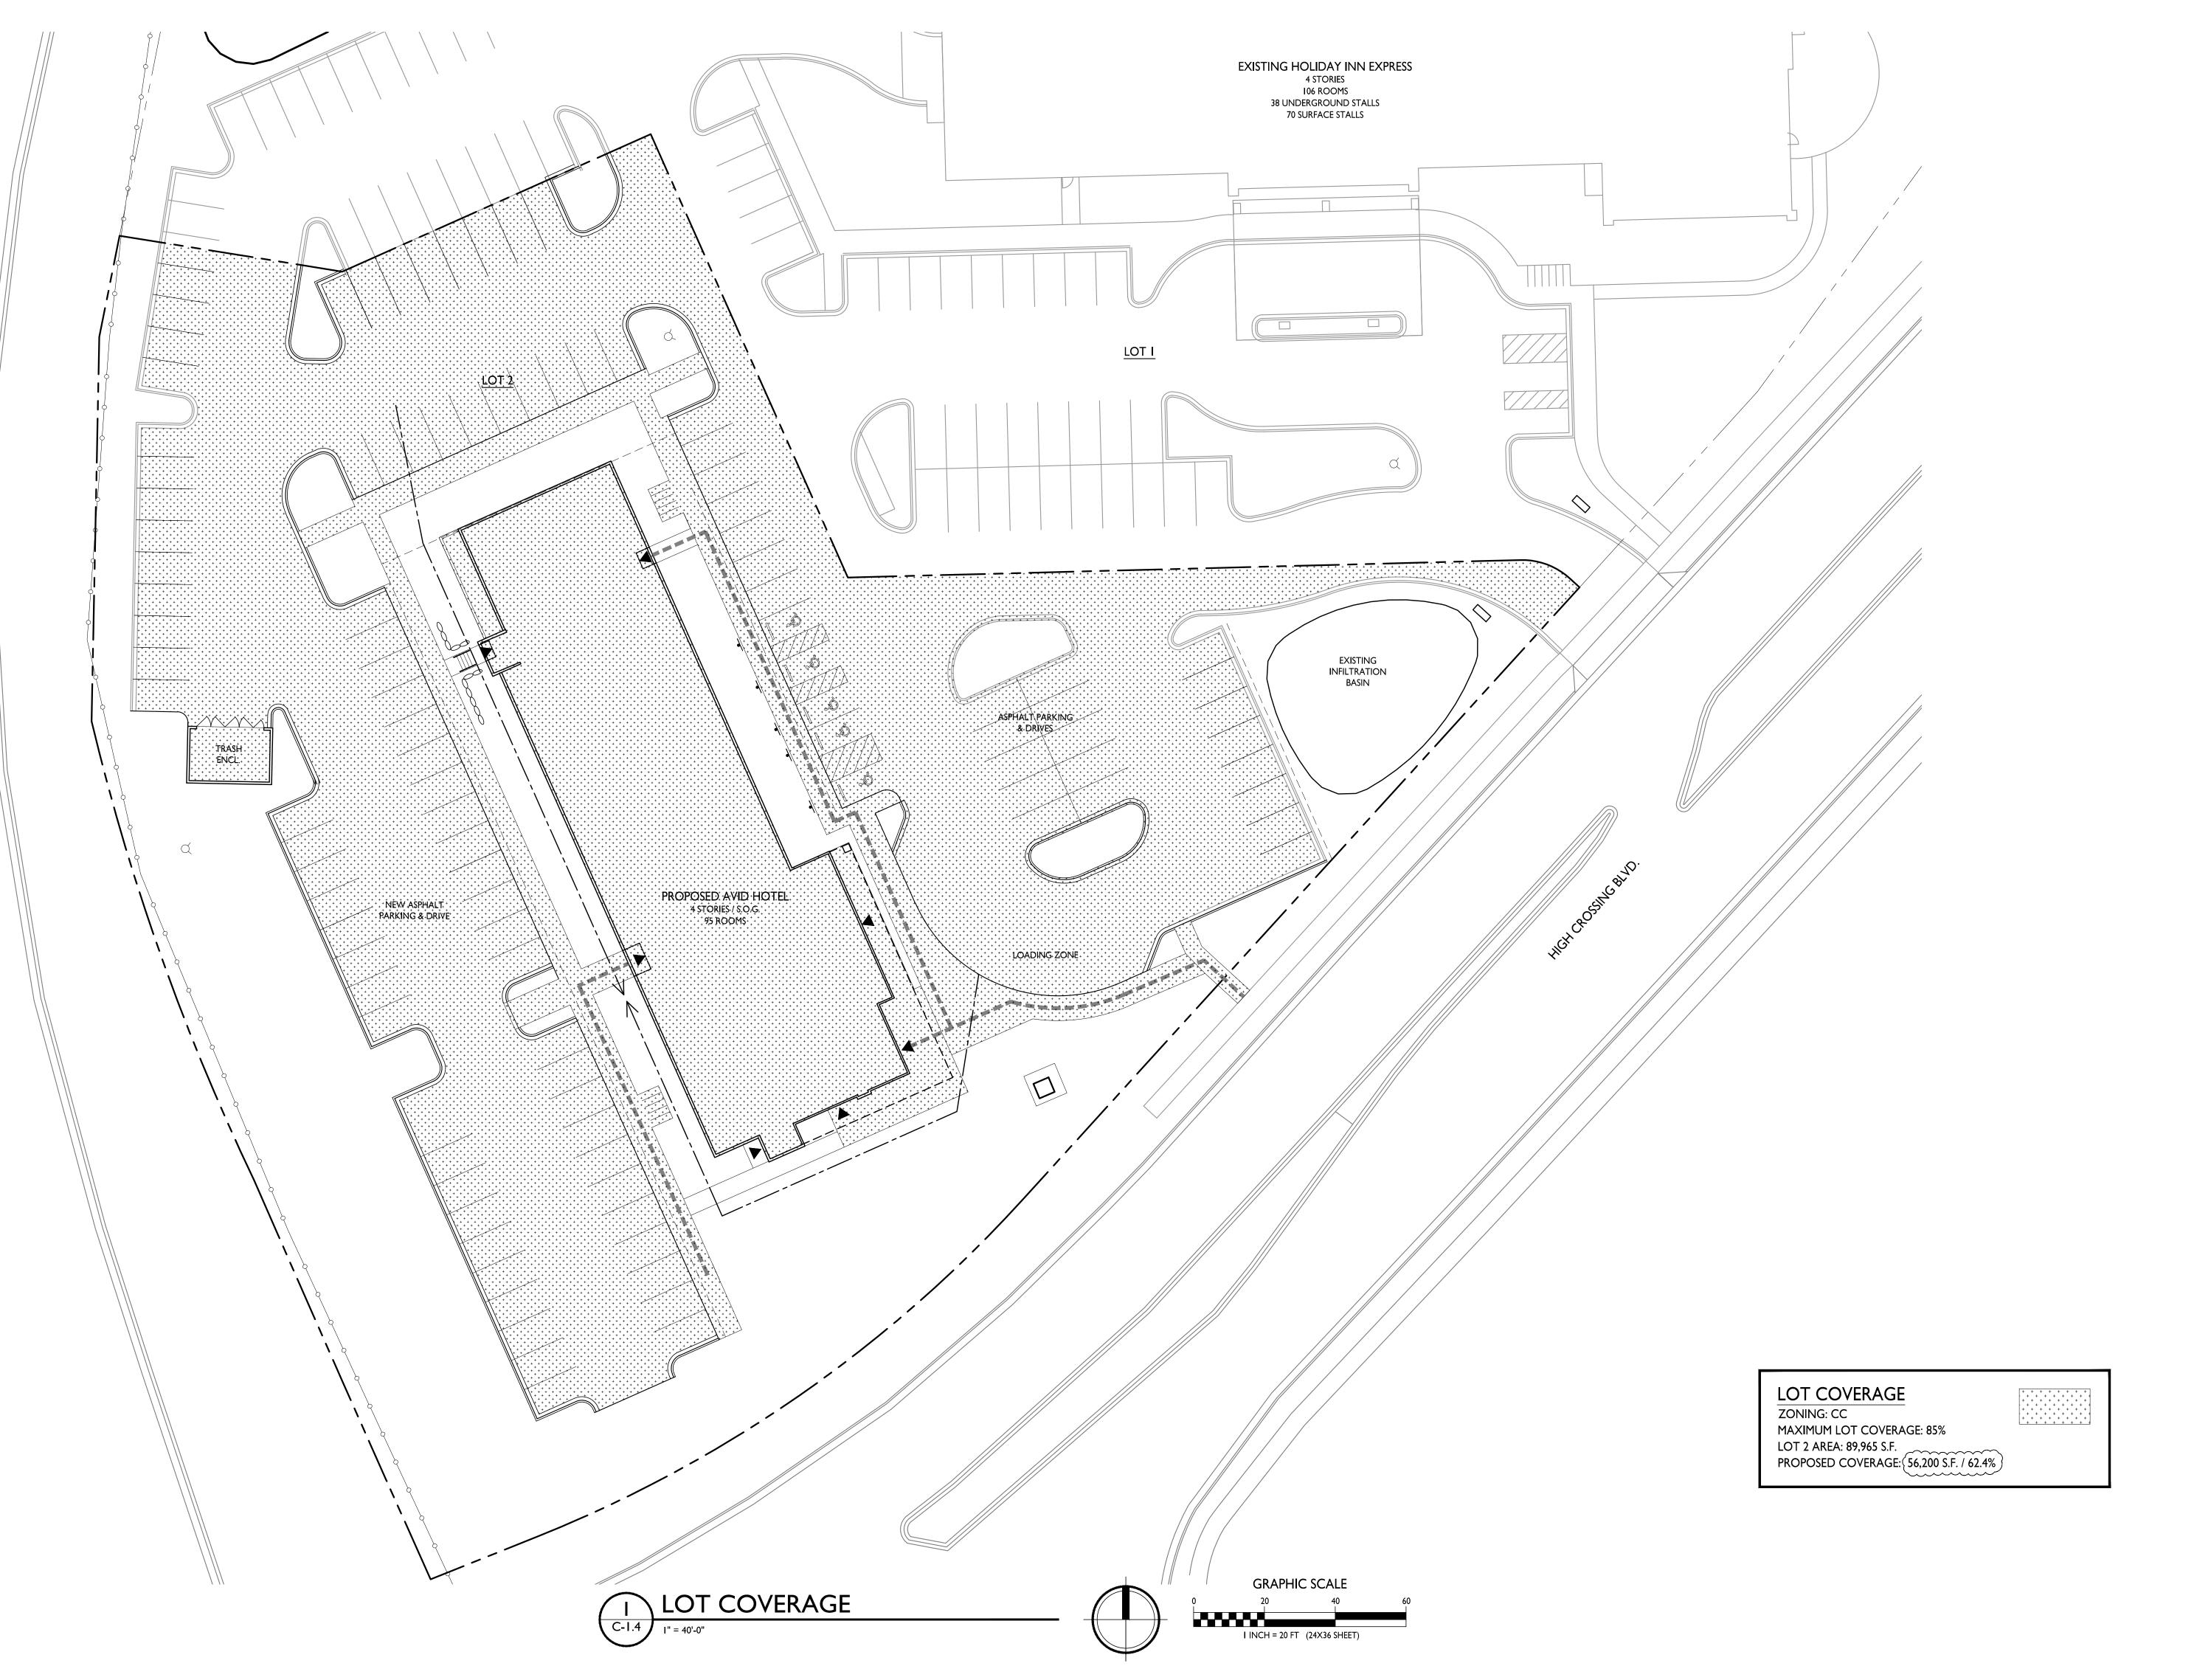

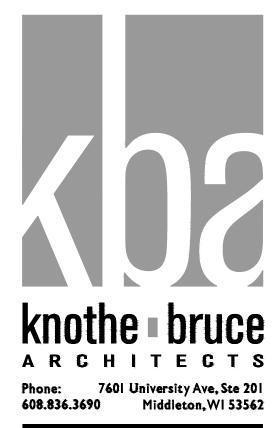

ISSUED

Issued for Land Use Submittal - July 17, 2019 Revised Building Location - October 16, 2019

PROJECT TITLE

AVID HOTEL

5130 High Crossing Blvd.

Madison, WI

SHEET TITLE

Lot Coverage


SHEET NUMBER

C-1.4

PROJECT NO.

NO. **1808** 

© Knothe & Bruce Architects, LLC

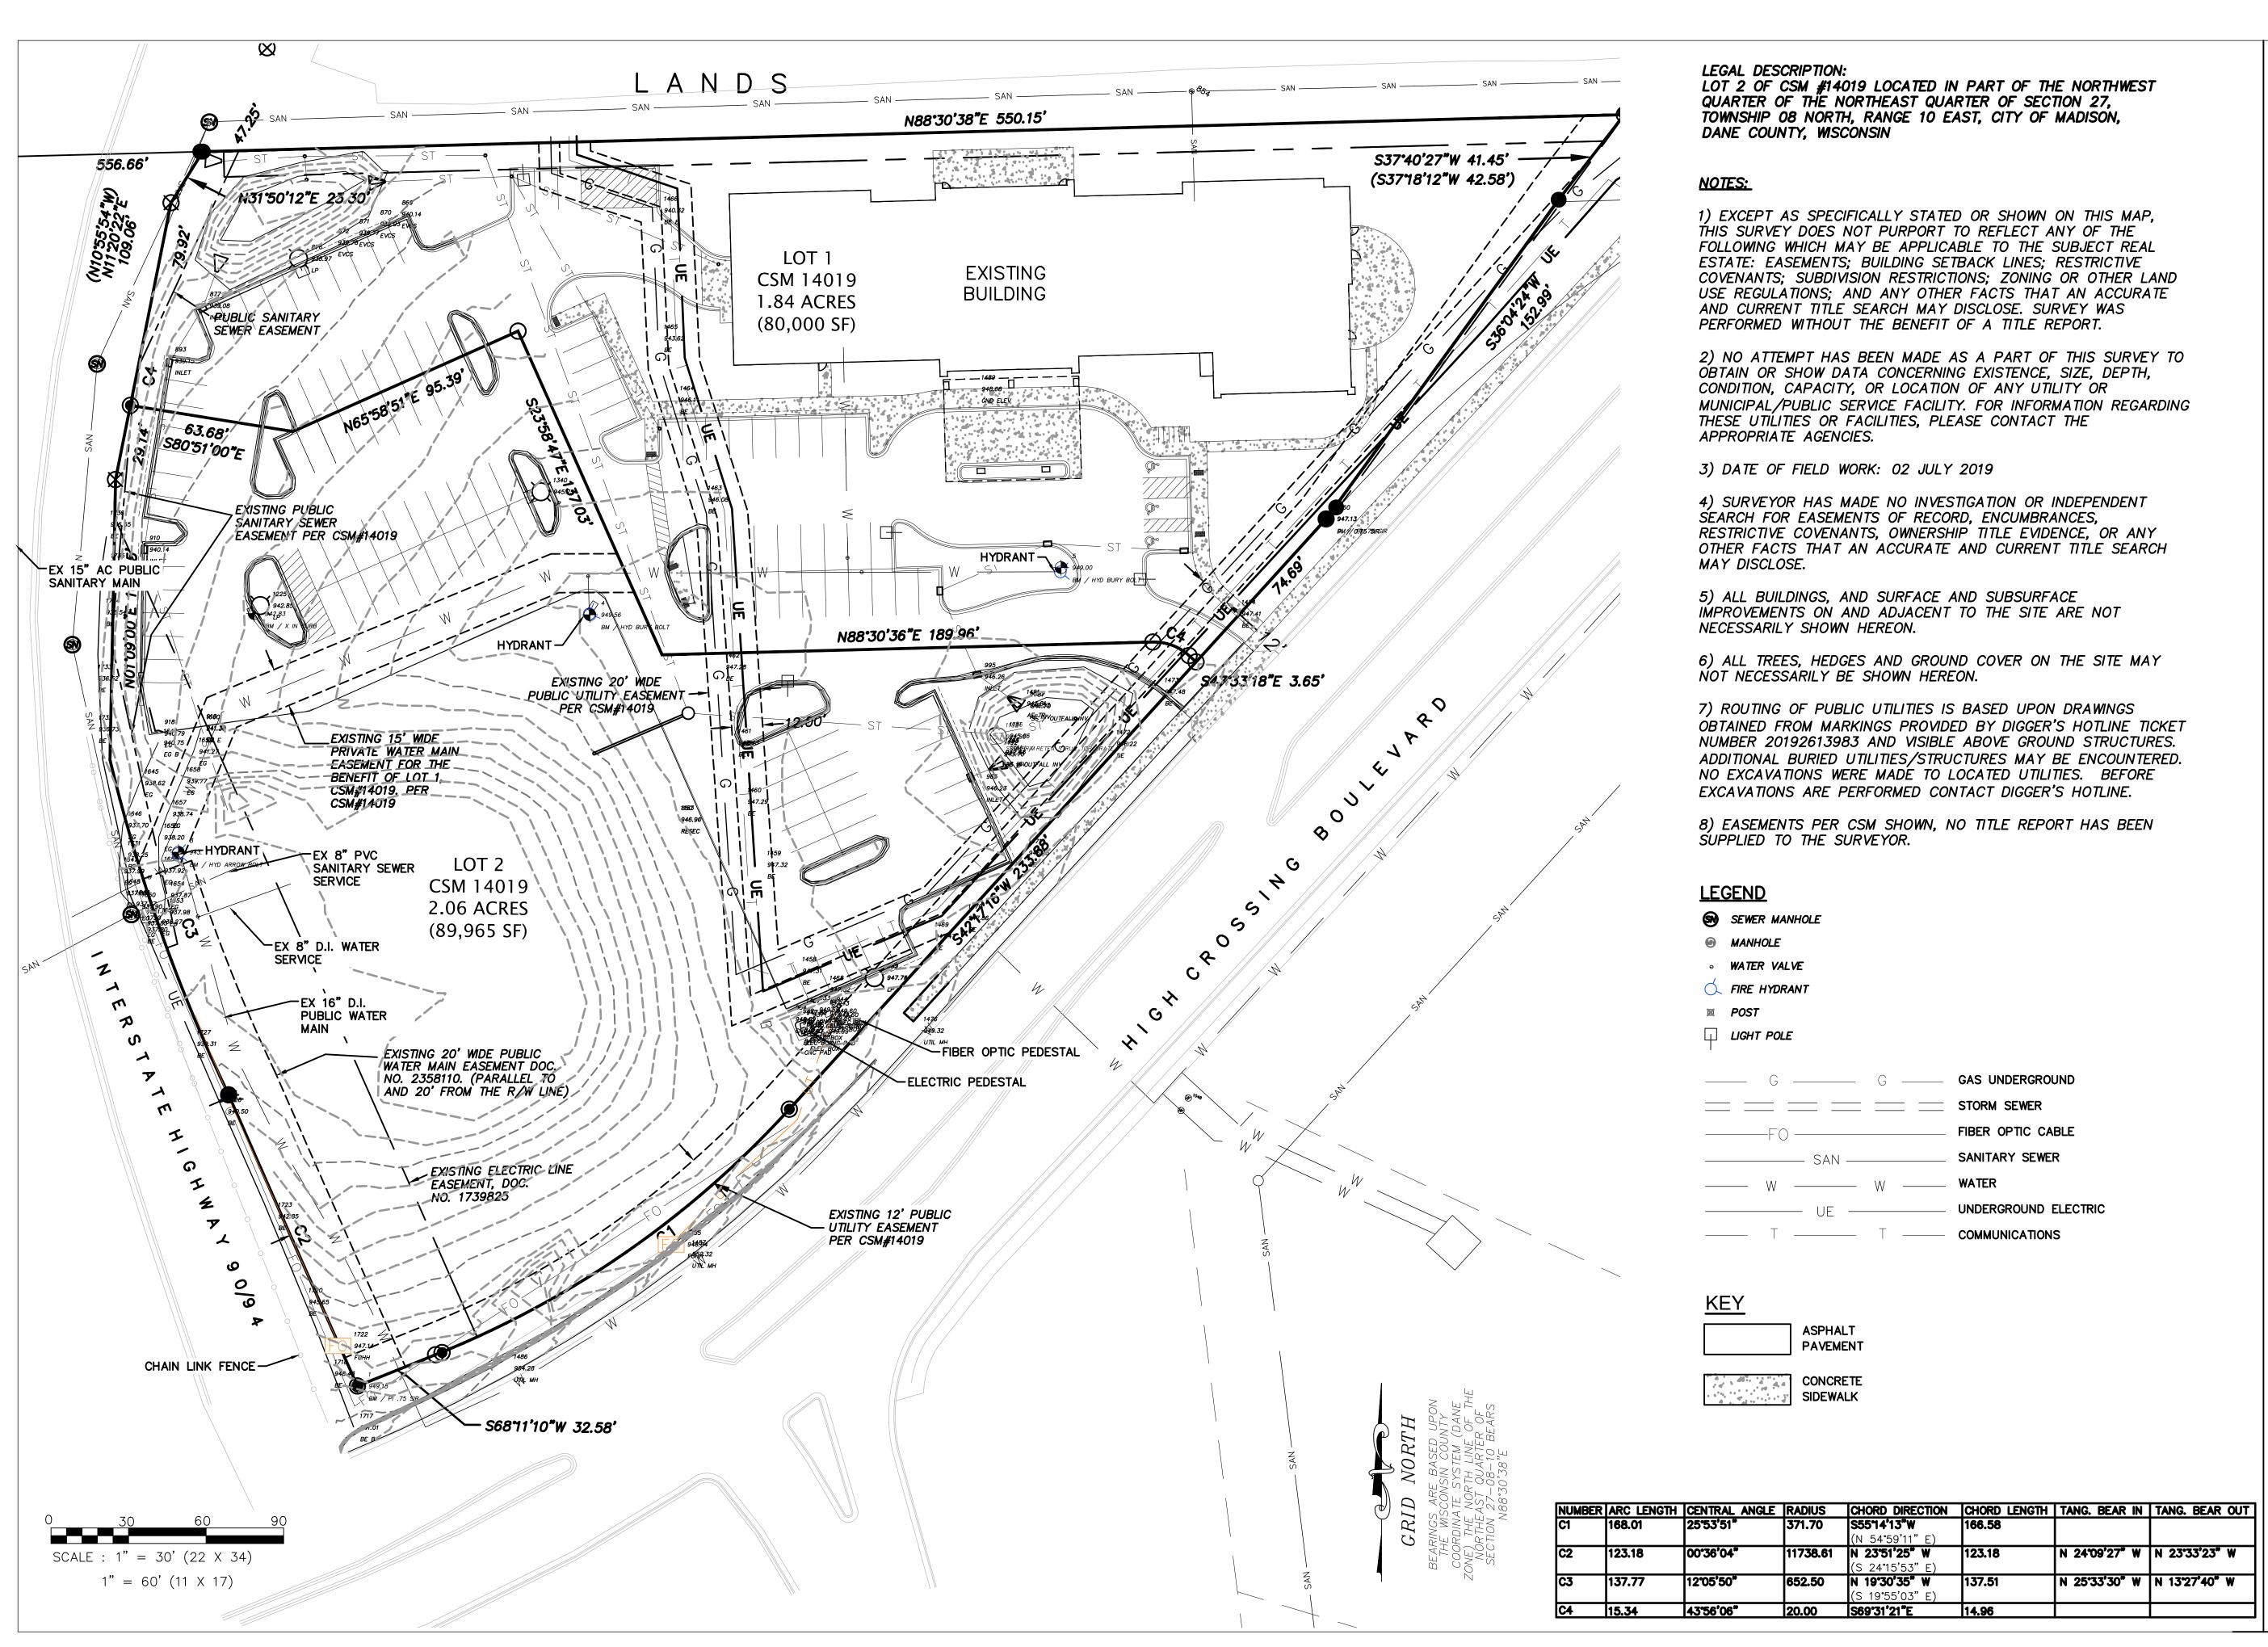



knothe bruce ARCHITECTS Phone: 7601 University Ave, Ste 201

608.836.3690 Middleton, WI 53562



818 N Meadowbrook Ln Waunakee, WI 53597 **phone** (608) 849-9378

ISSUED 10-15-19

PROJECT TITLE **AVID HOTEL** 

High Crossing Blvd. Madison, Wisconsin

SHEET TITLE


Existing Conditions


SHEET NUMBER


C-1.0


PROJECT NO.


© 2013 Knothe & Bruce Architects,

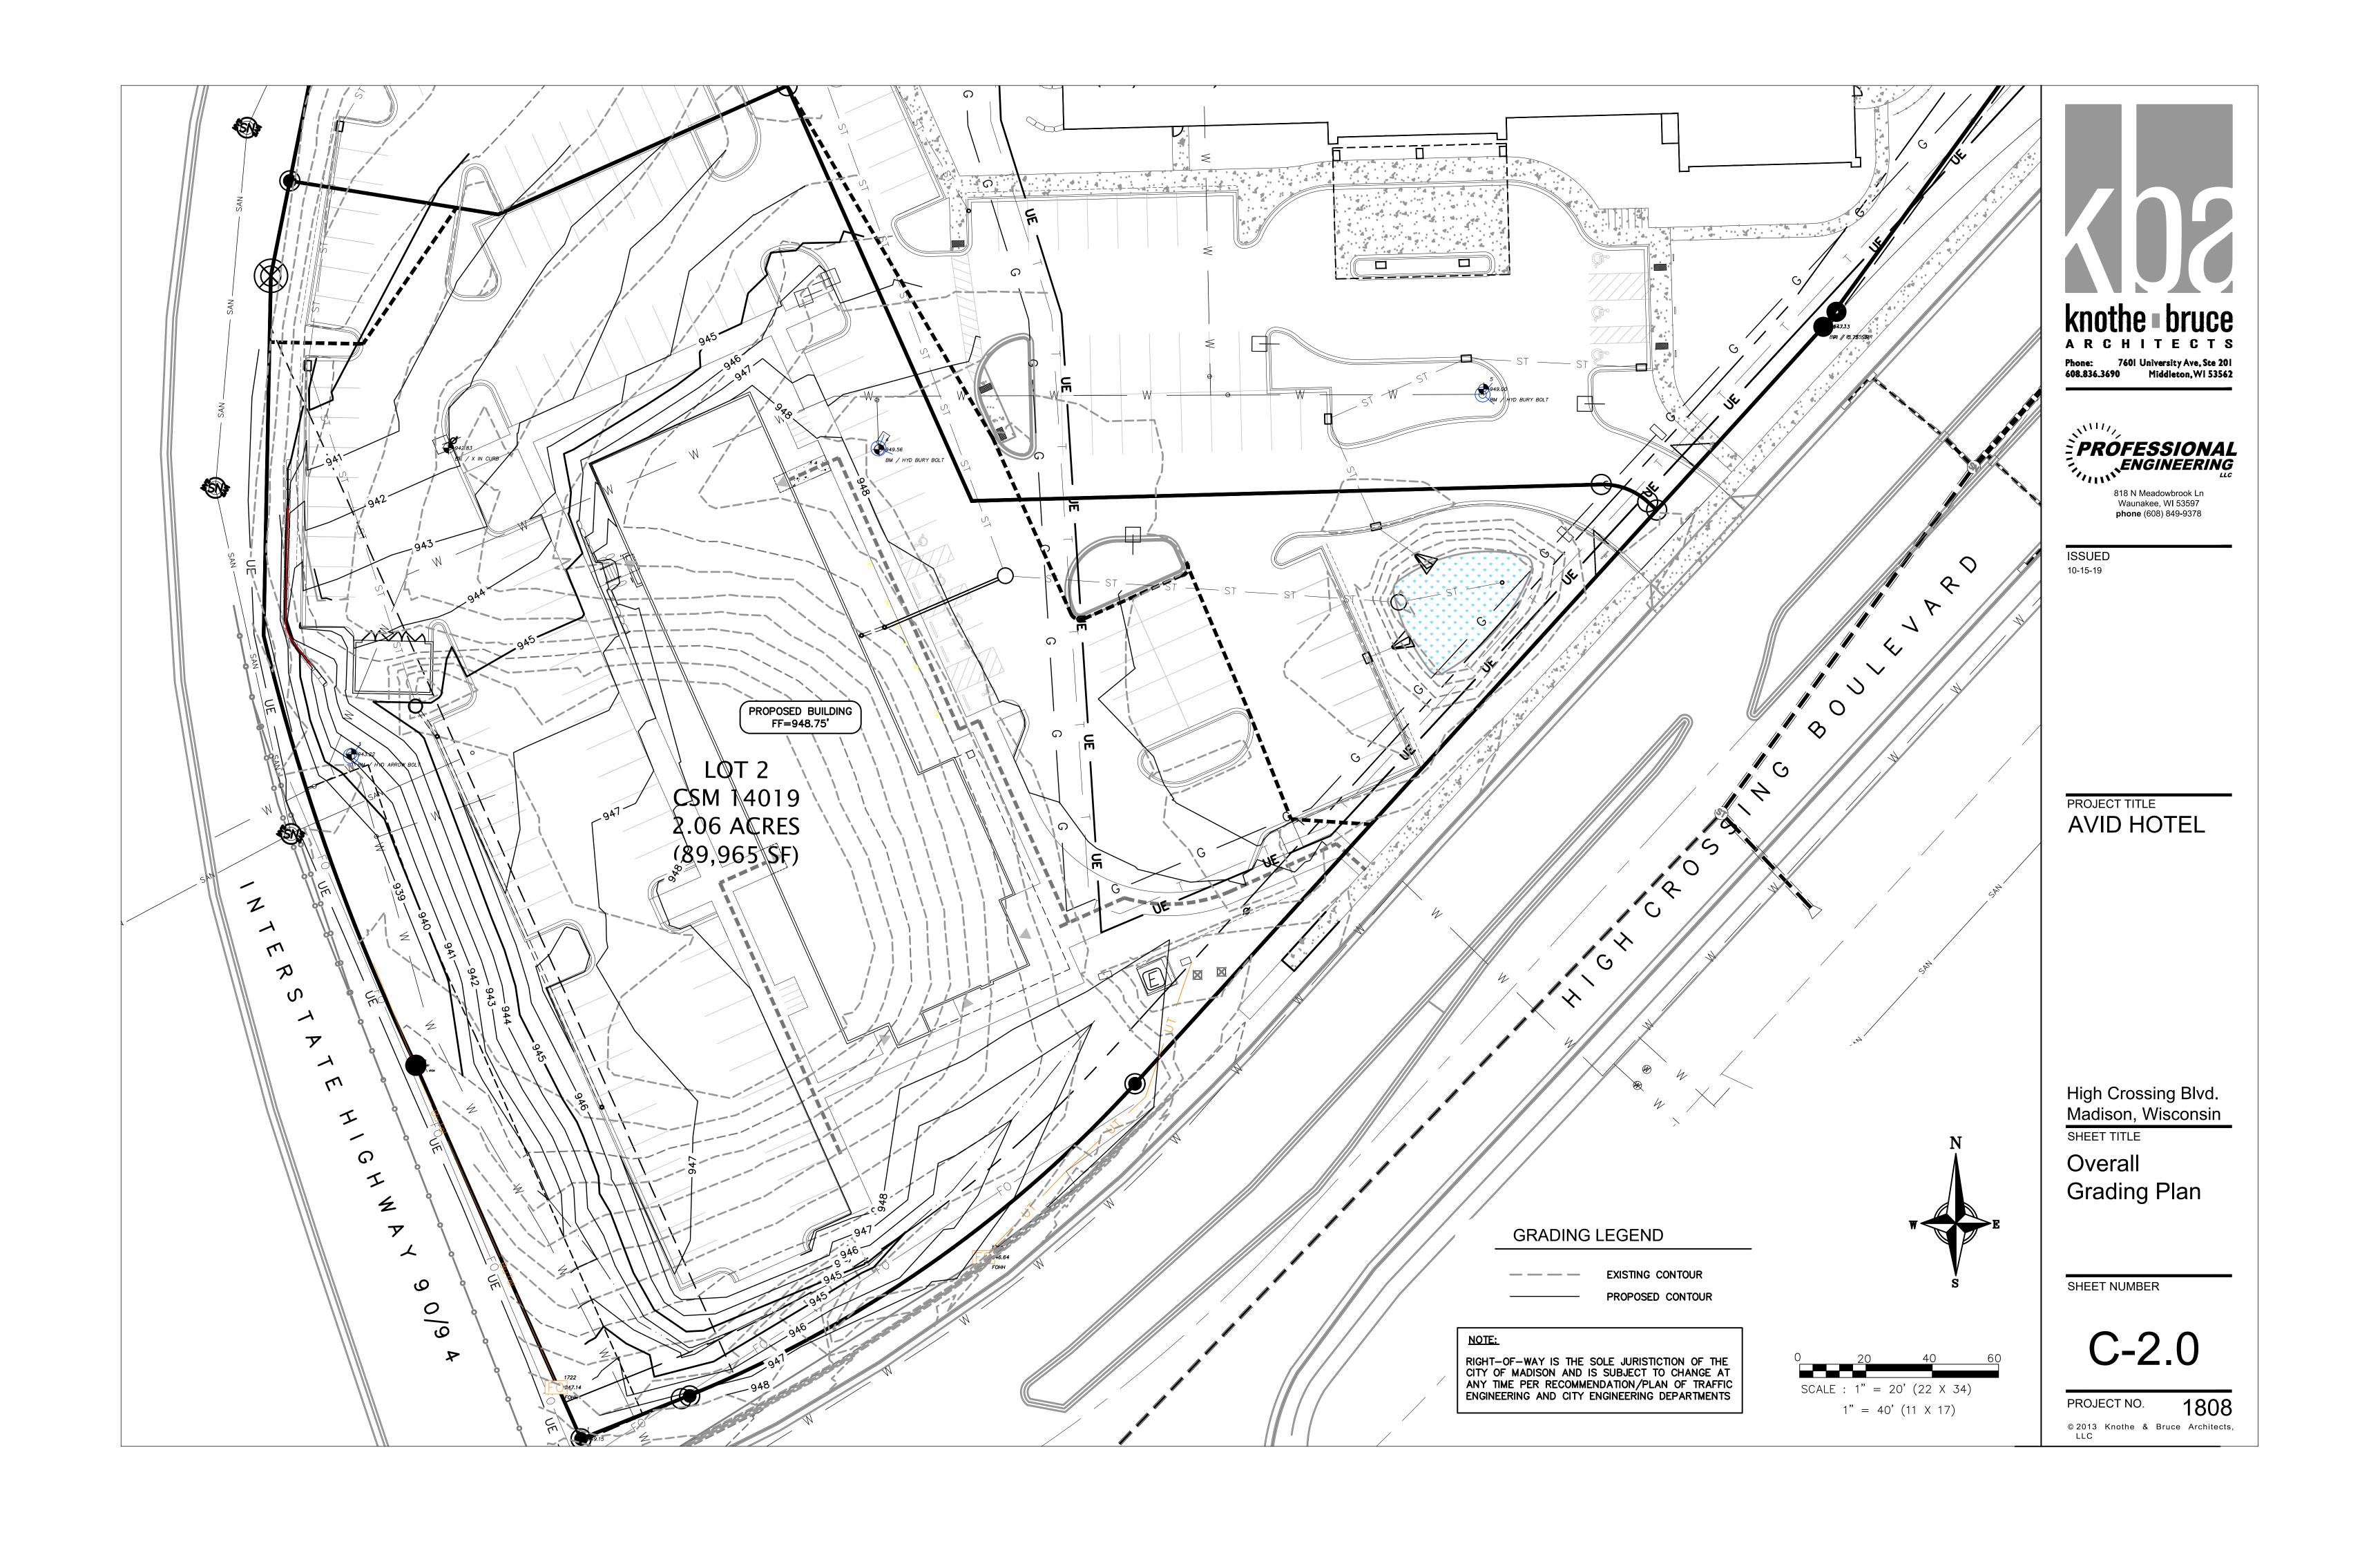

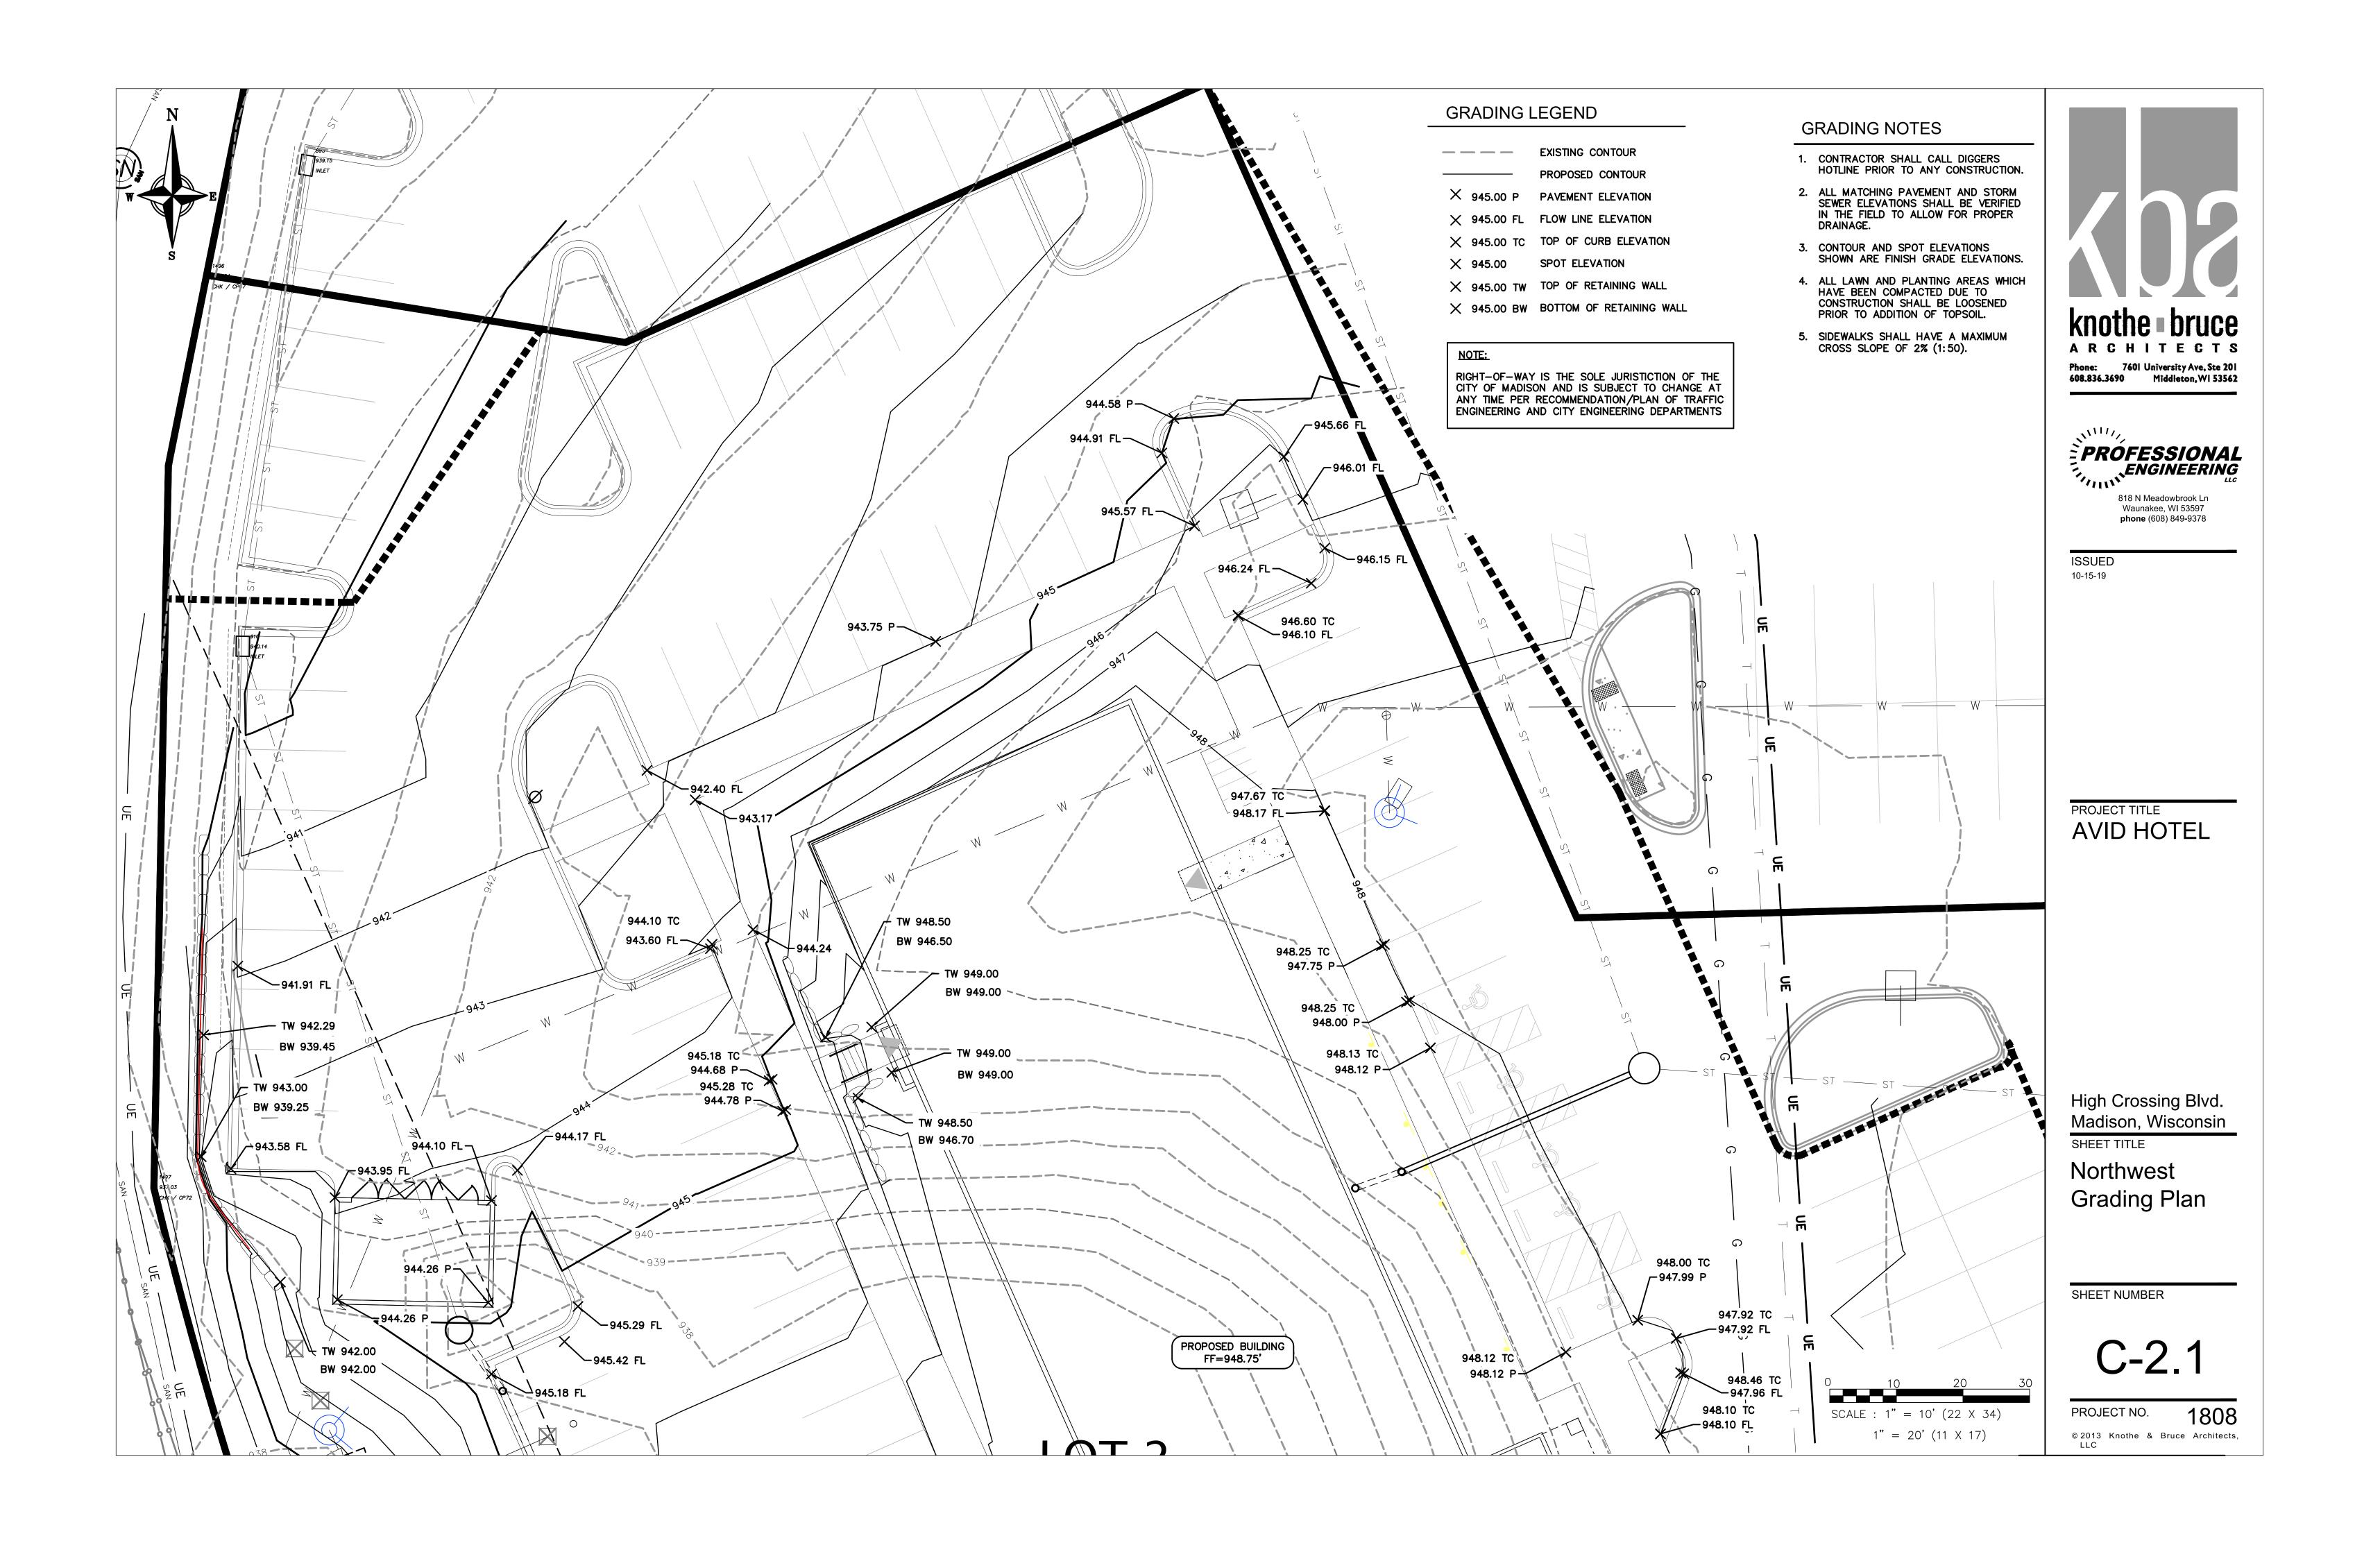

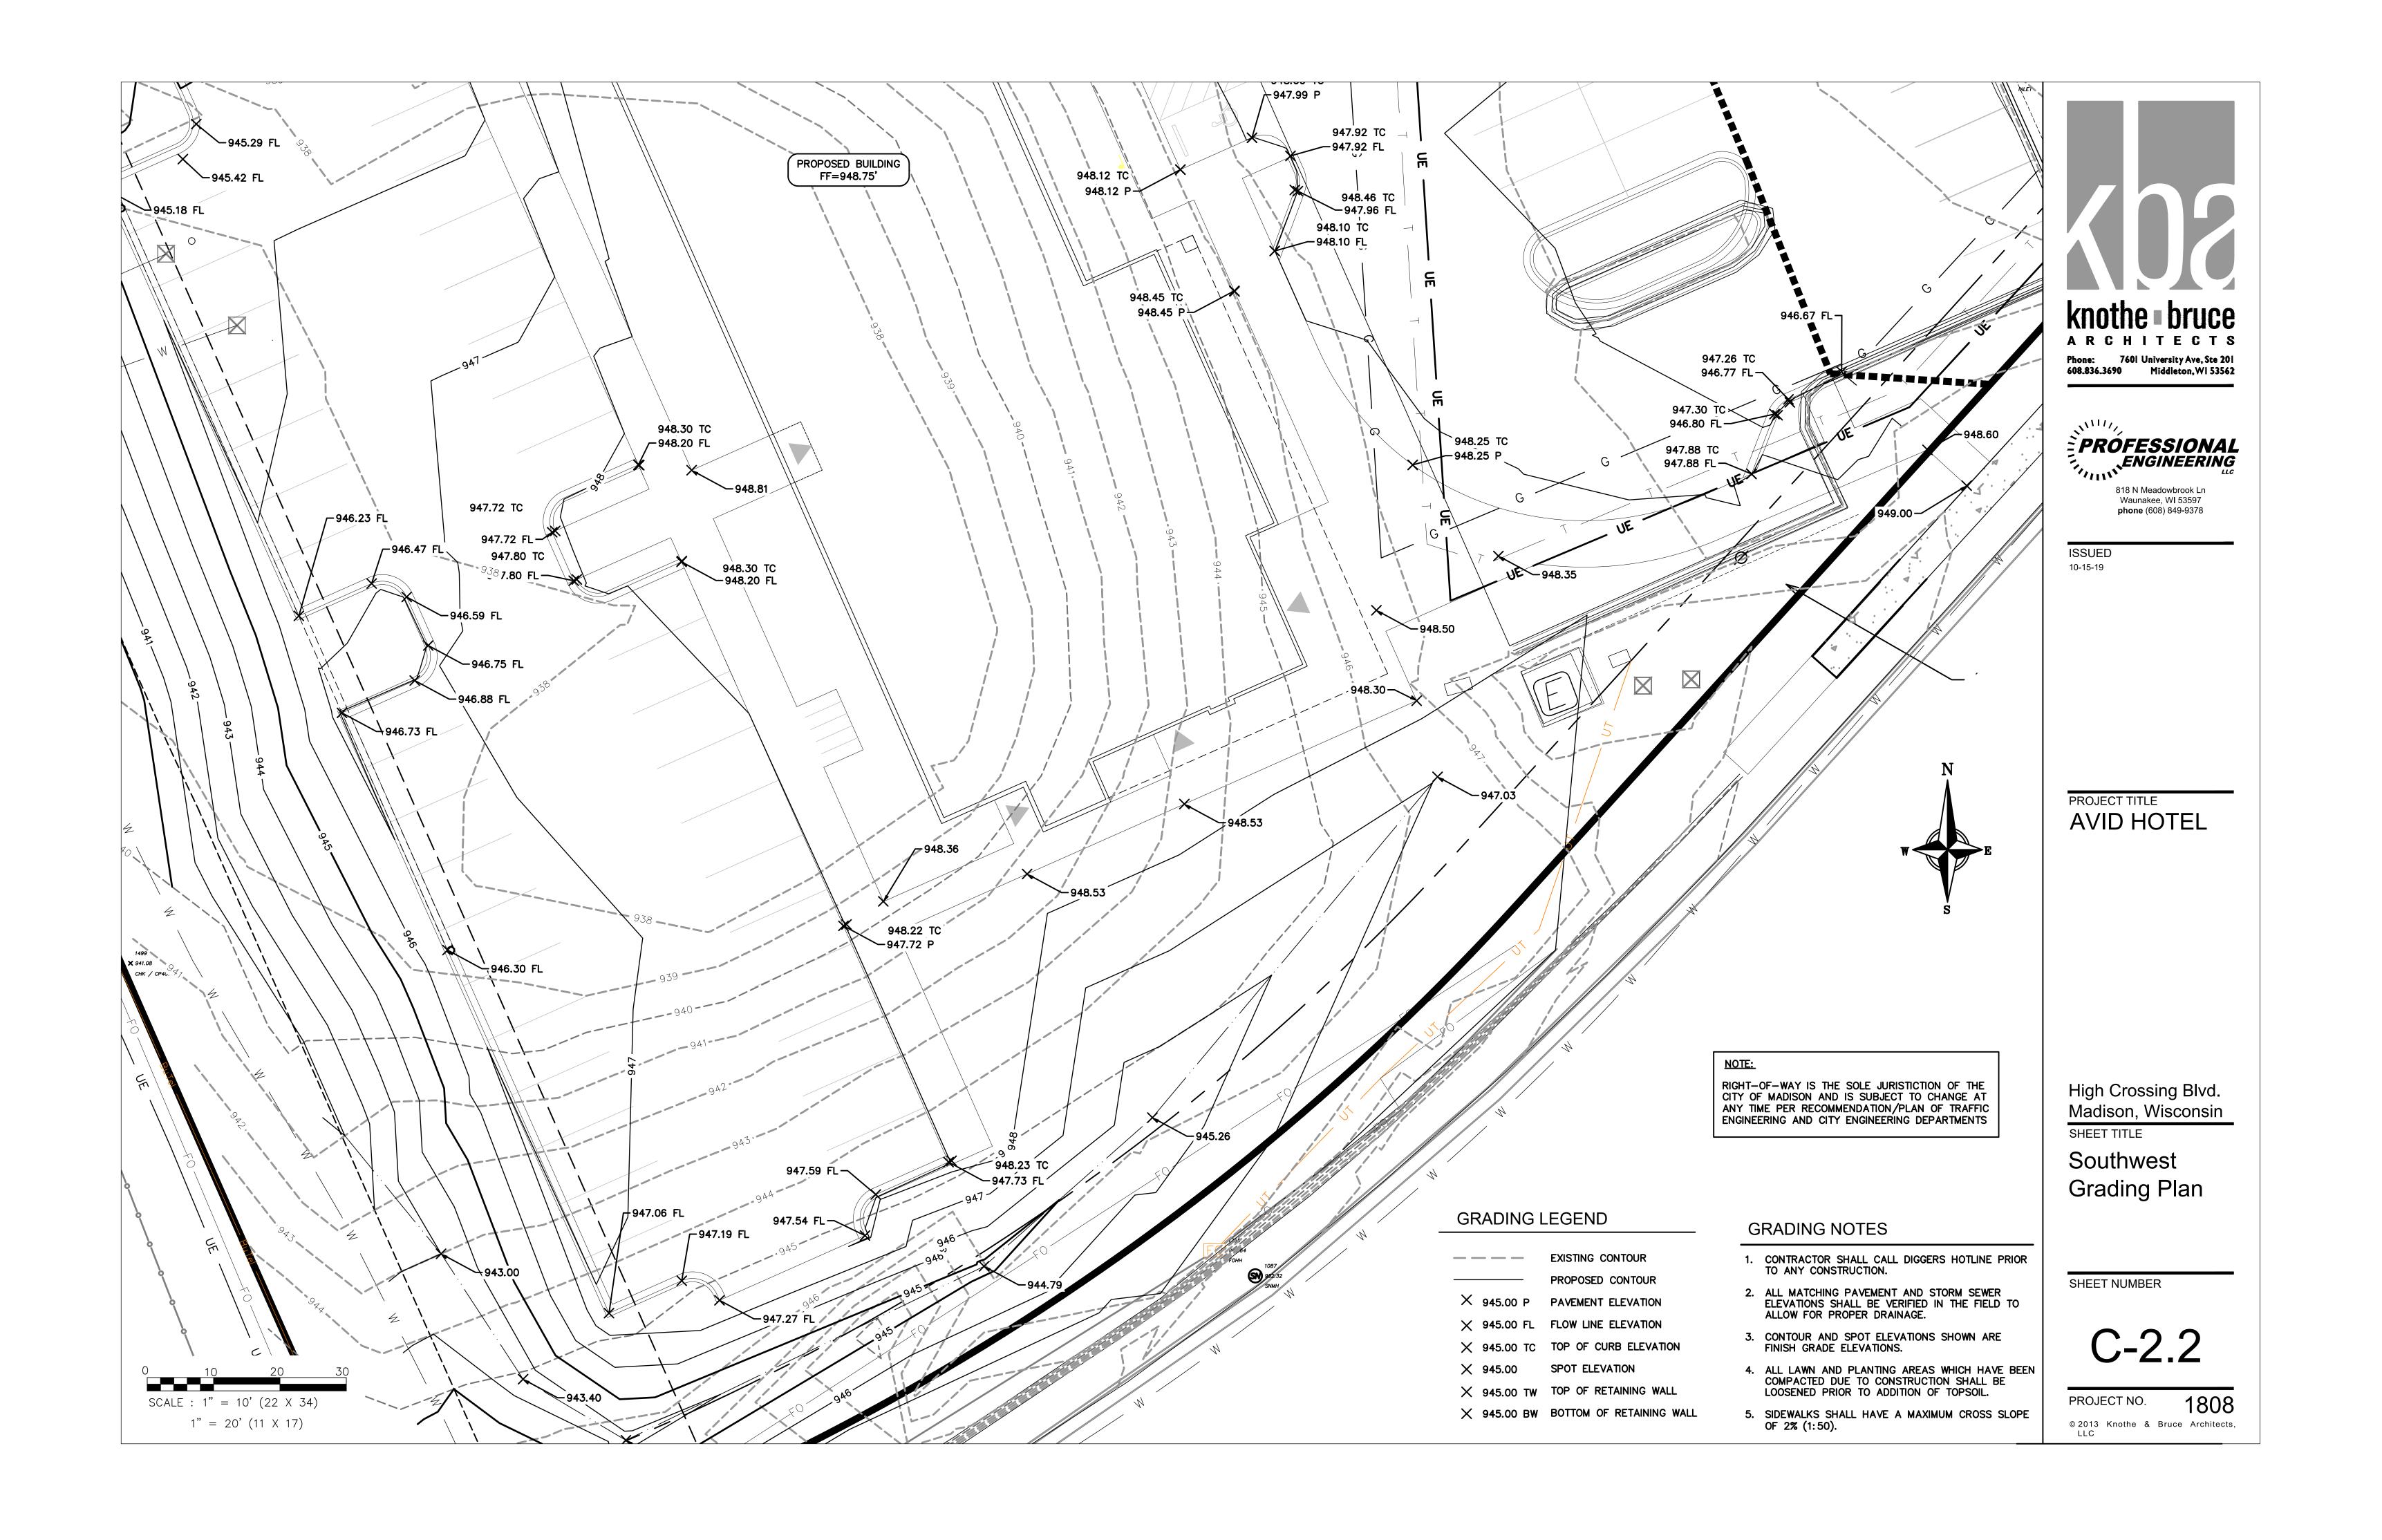

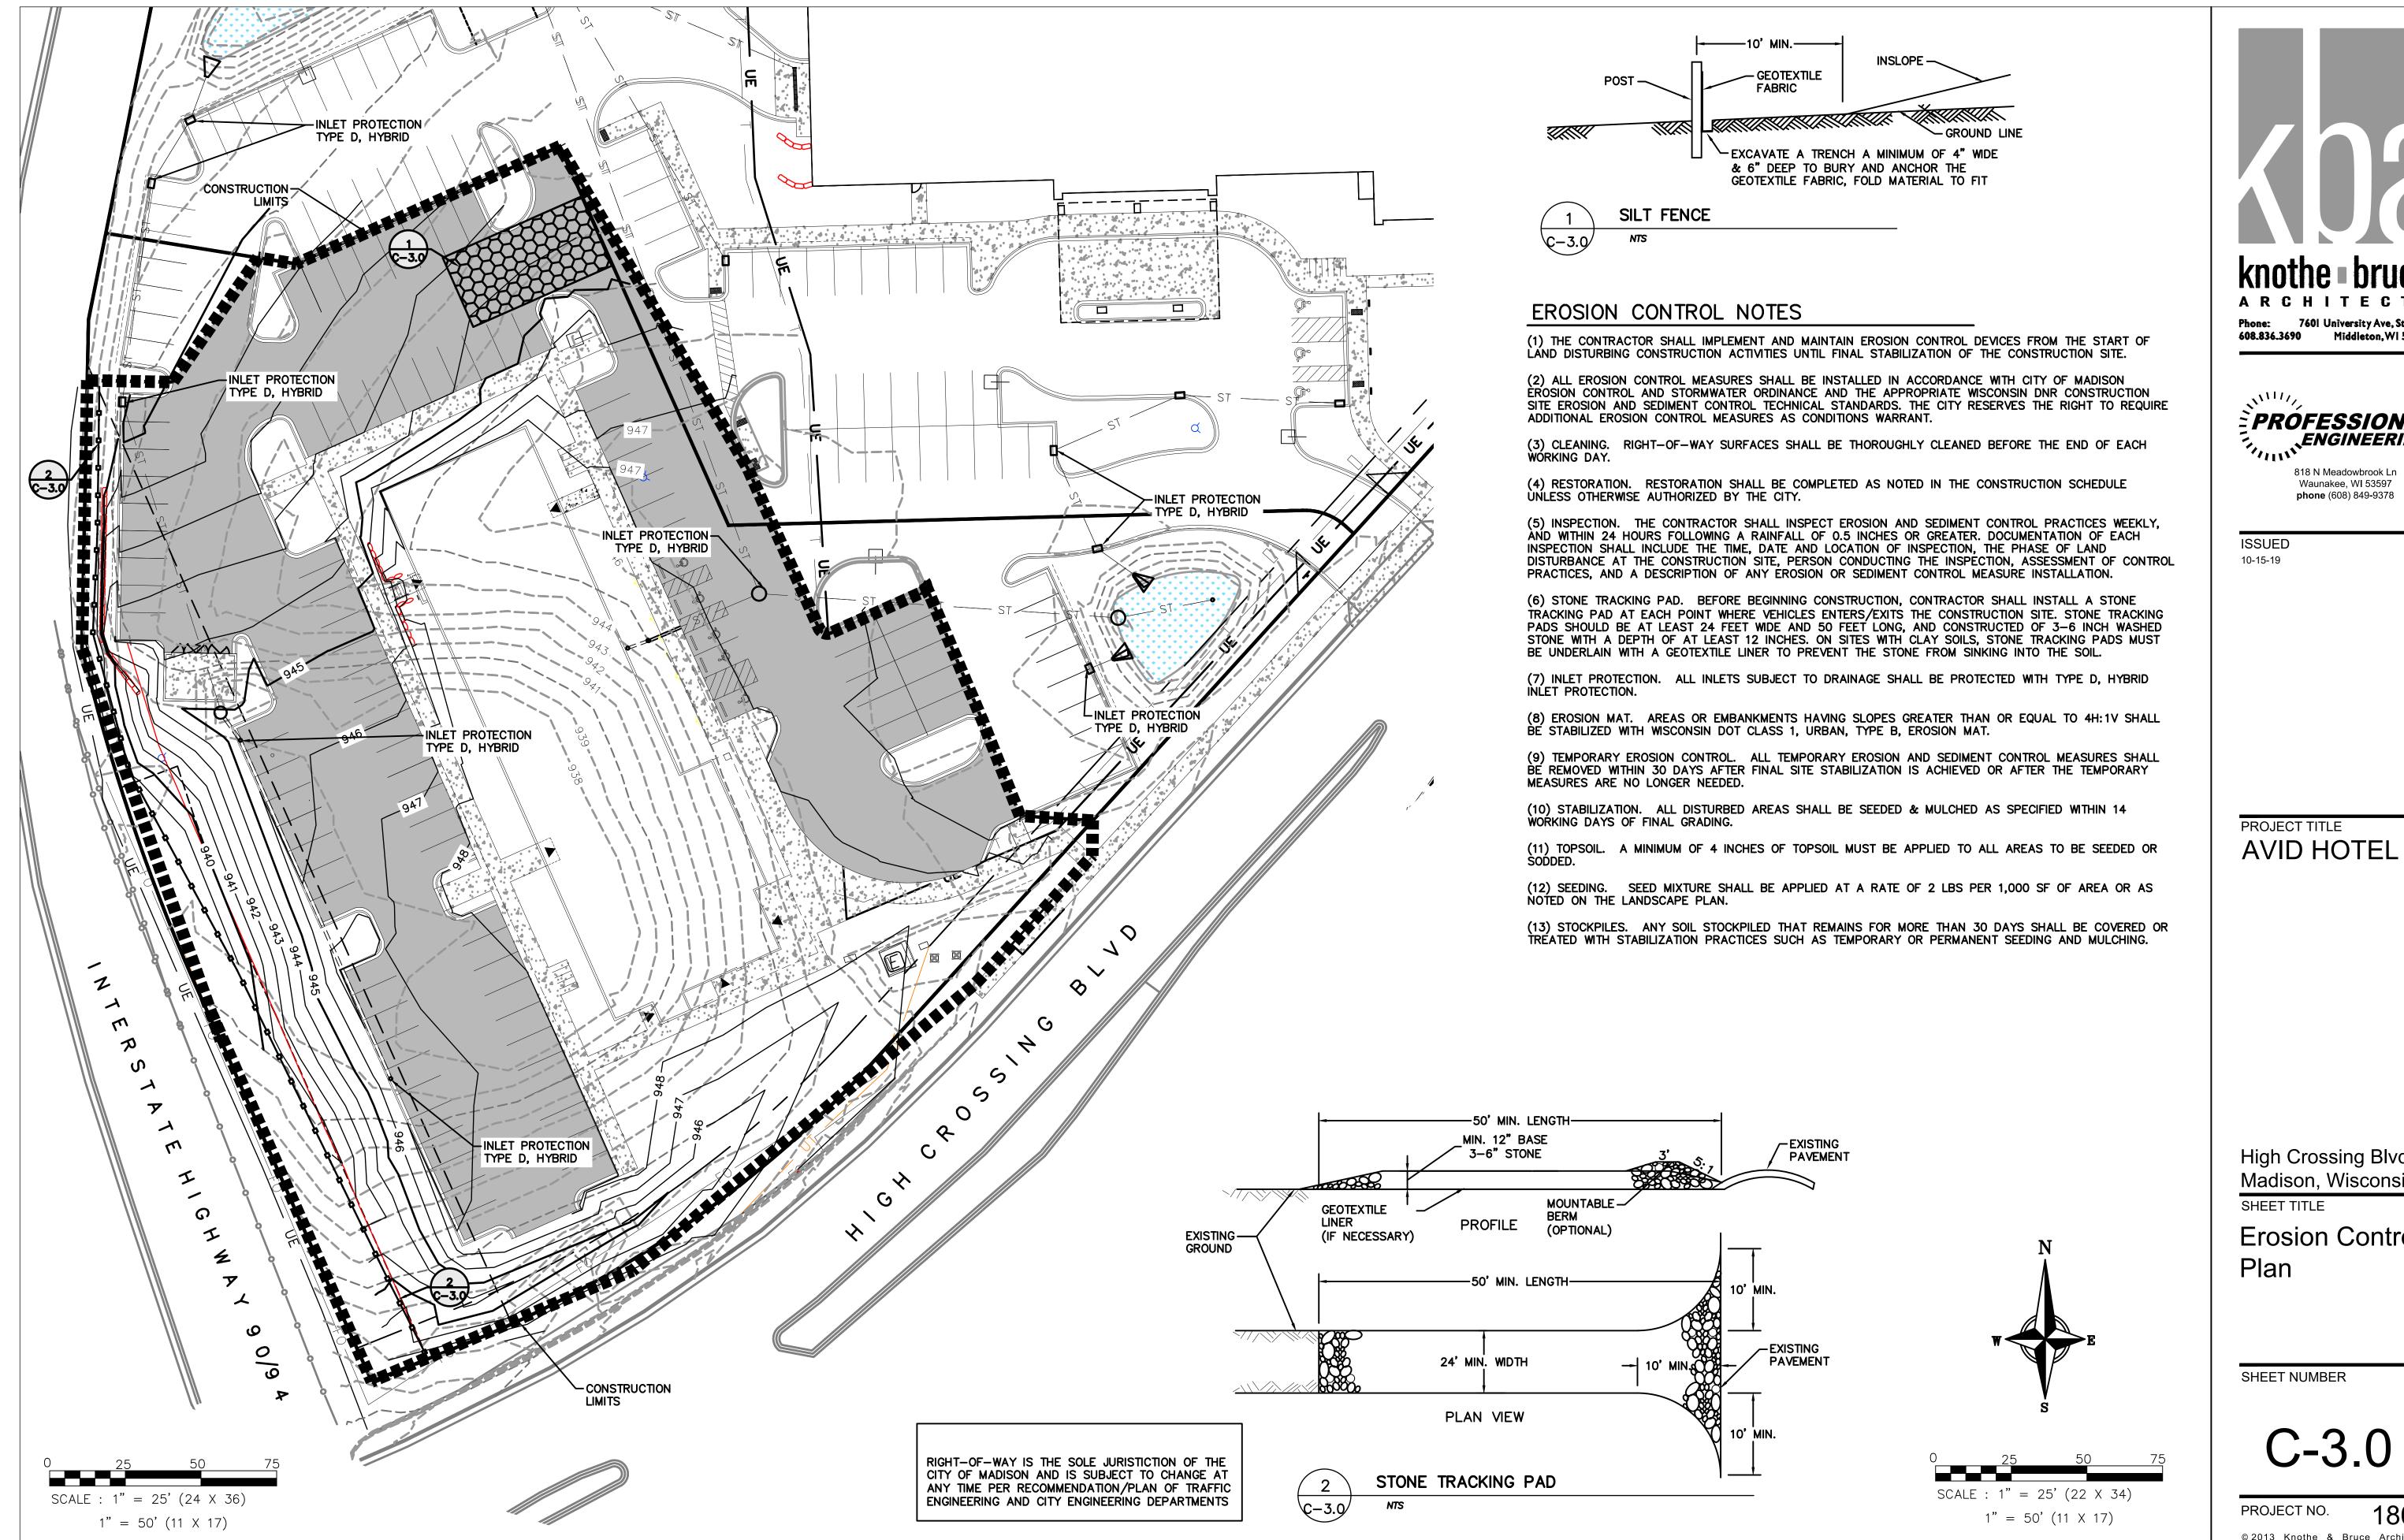

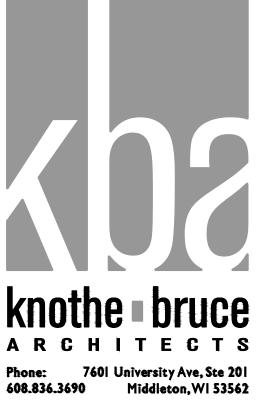

PROFESSIONAL ENGINEERING

> Waunakee, WI 53597 phone (608) 849-9378

PROJECT TITLE **AVID HOTEL** 

High Crossing Blvd. Madison, Wisconsin


SHEET TITLE

**Erosion Control** 

SHEET NUMBER

C - 3.0

PROJECT NO. © 2013 Knothe & Bruce Architects,

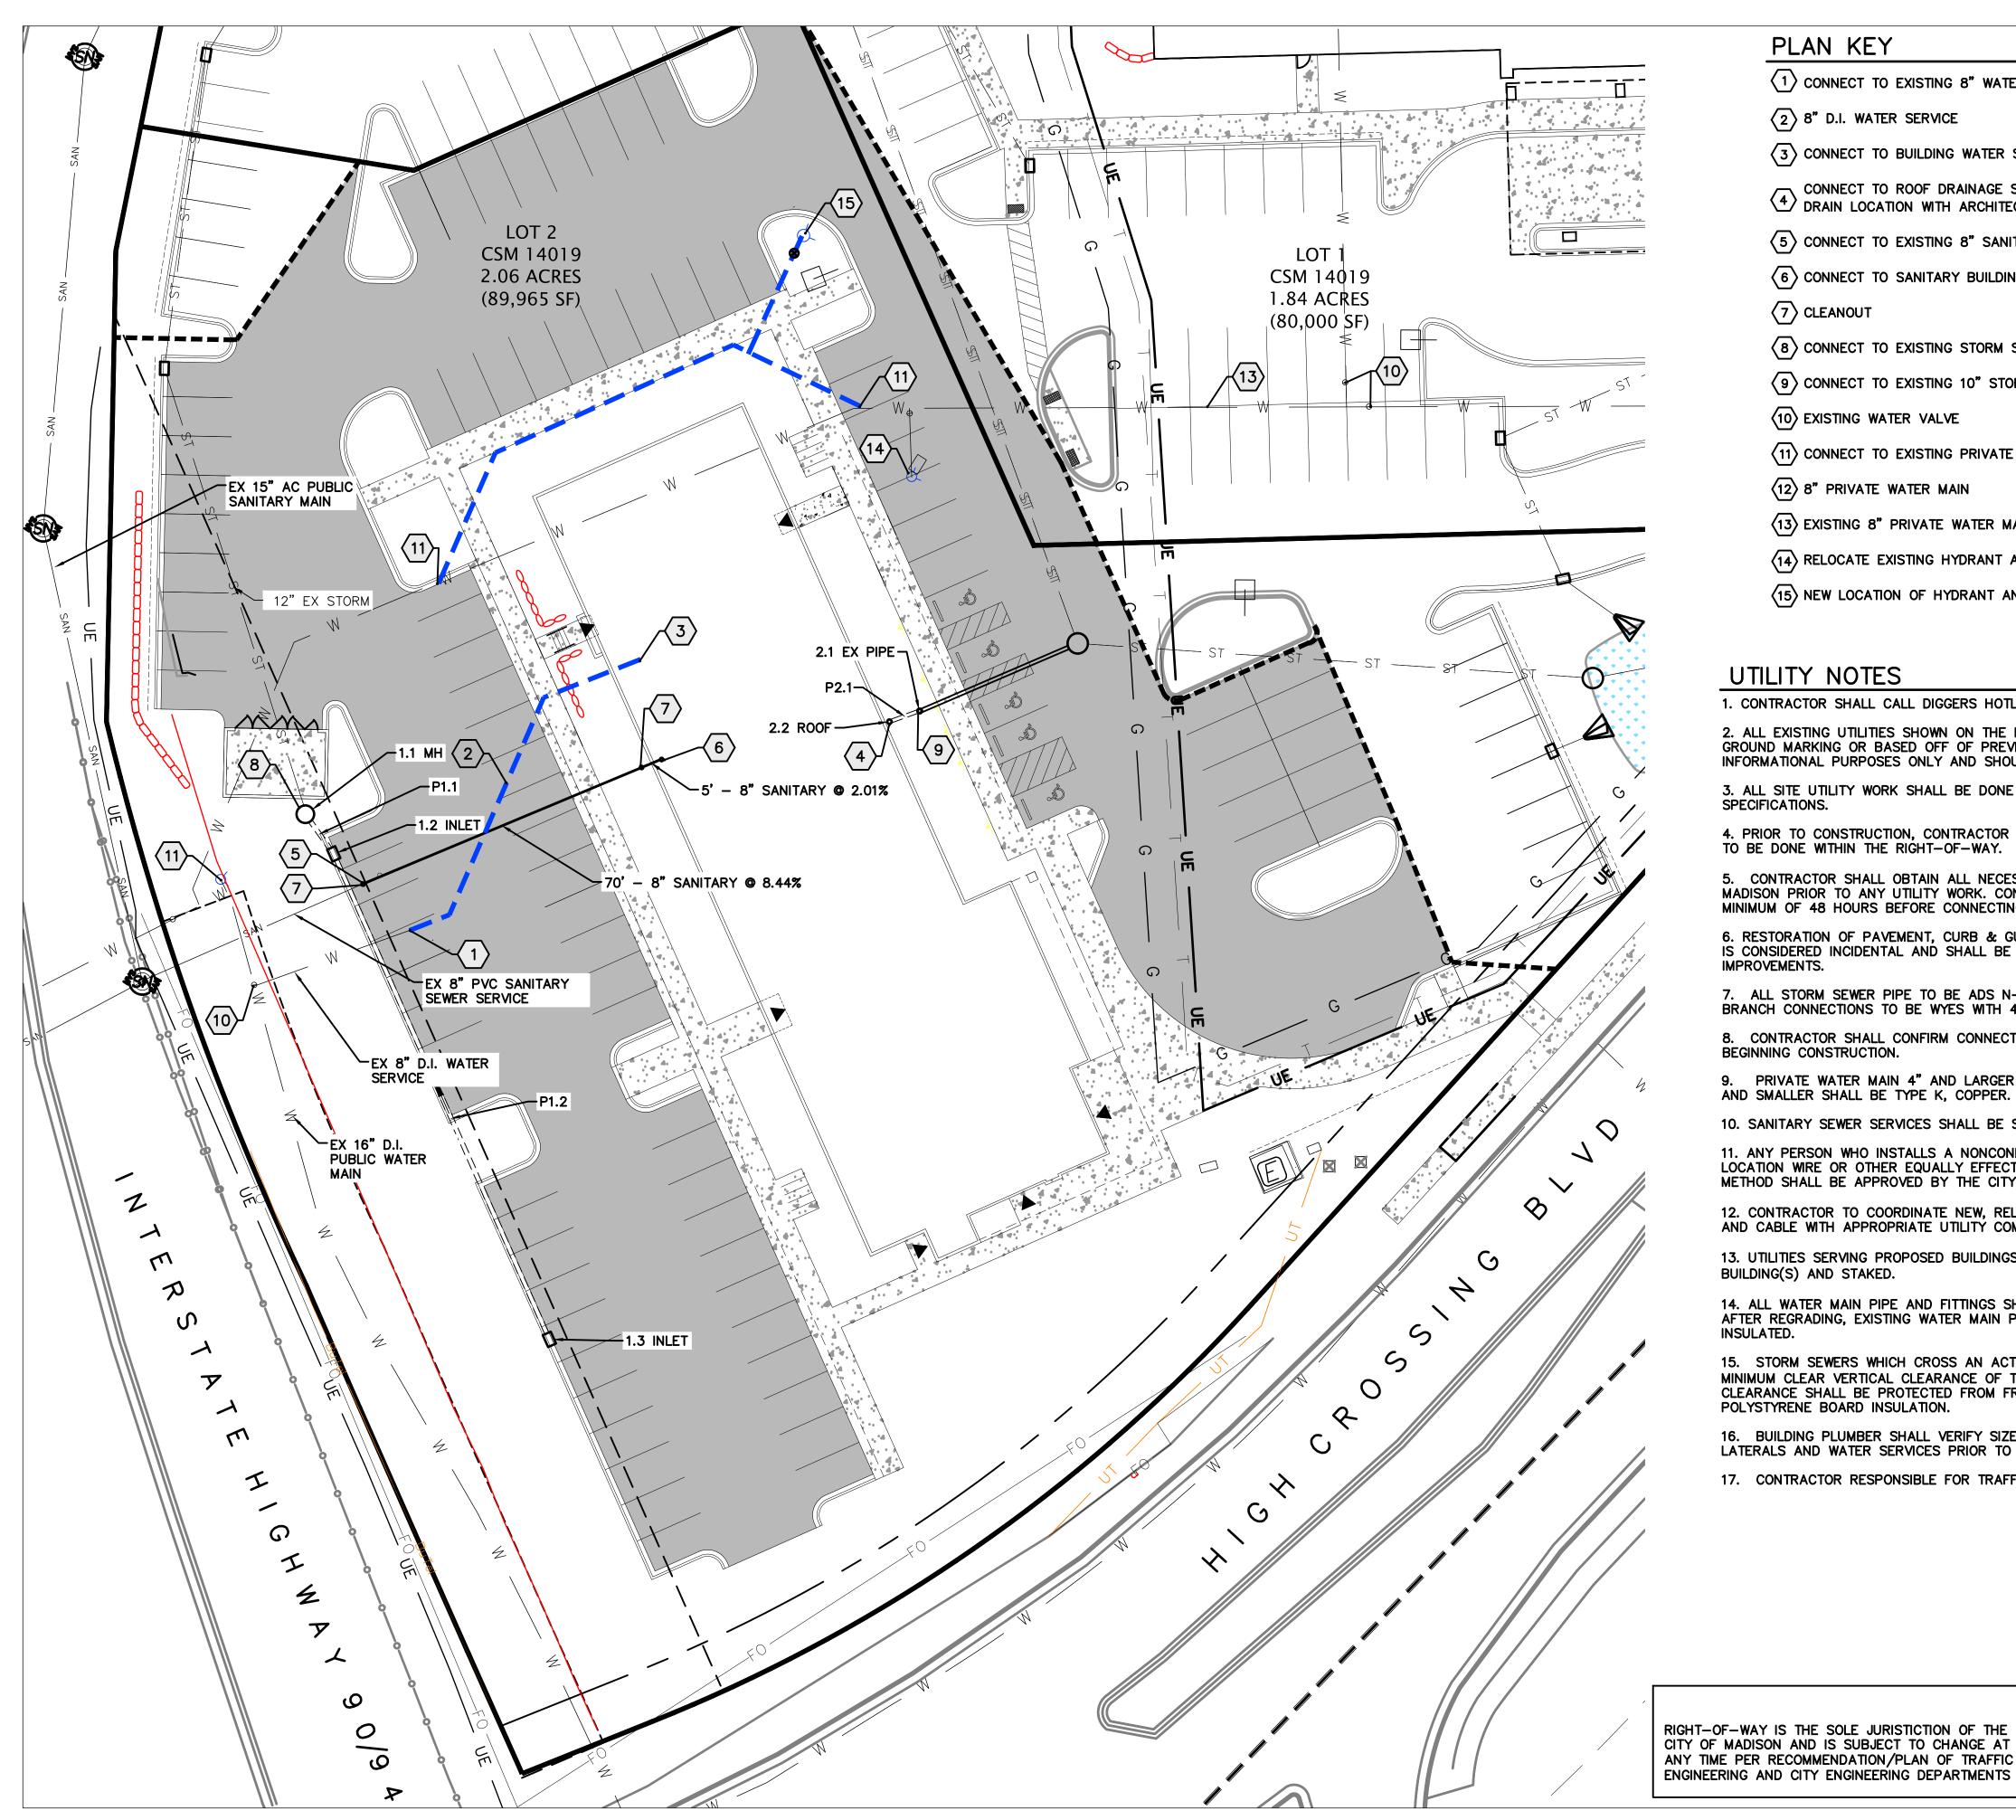

# PLAN KEY


- 1 CONNECT TO EXISTING 8" WATER LATERAL
- 2 8" D.I. WATER SERVICE
- (3) CONNECT TO BUILDING WATER SERVICE
- CONNECT TO ROOF DRAINAGE SYSTEM. CONTRACTOR TO VERIFY WITH FINAL DRAIN LOCATION WITH ARCHITECT.
- (5) CONNECT TO EXISTING 8" SANITARY LATERAL
- 6 CONNECT TO SANITARY BUILDING SEWER', SEE PLUMBING PLANS
- 7 CLEANOUT
- (8) CONNECT TO EXISTING STORM SEWER PIPE WITH MANHOLE STRUCTURE
- 9 CONNECT TO EXISTING 10" STORM SEWER
- (10) EXISTING WATER VALVE
- (11) CONNECT TO EXISTING PRIVATE WATER MAIN
- 12 8" PRIVATE WATER MAIN
- (13) EXISTING 8" PRIVATE WATER MAIN
- (14) RELOCATE EXISTING HYDRANT AND VALVE
- (15) NEW LOCATION OF HYDRANT AND VALVE


# UTILITY NOTES

BUILDING(S) AND STAKED.

- 1. CONTRACTOR SHALL CALL DIGGERS HOTLINE PRIOR TO ANY CONSTRUCTION.
- 2. ALL EXISTING UTILITIES SHOWN ON THE PLAN ARE APPROXIMATE AND WERE FIELD LOCATED FROM GROUND MARKING OR BASED OFF OF PREVIOUS PLANS. THE LOCATIONS ARE SHOWN FOR INFORMATIONAL PURPOSES ONLY AND SHOULD BE FIELD VERIFIED PRIOR TO CONSTRUCTION.
- 3. ALL SITE UTILITY WORK SHALL BE DONE IN ACCORDANCE WITH THE CITY OF MADISON STANDARD SPECIFICATIONS.
- 4. PRIOR TO CONSTRUCTION, CONTRACTOR SHALL OBTAIN A STREET OPENING PERMIT FOR ANY WORK TO BE DONE WITHIN THE RIGHT-OF-WAY.
- 5. CONTRACTOR SHALL OBTAIN ALL NECESSARY PLUGGING/CONNECTION PERMITS FROM THE CITY OF MADISON PRIOR TO ANY UTILITY WORK. CONTRACTOR TO NÓTIFY THE PUBLIC WORKS DEPARTMENT A MINIMUM OF 48 HOURS BEFORE CONNECTING TO PUBLIC UTILITIES.
- 6. RESTORATION OF PAVEMENT, CURB & GUTTER, AND SIDEWALK WITHIN THE STREET RIGHT OF WAY IS CONSIDERED INCIDENTAL AND SHALL BE INCLUDED IN THE COST OF THE UNDERGROUND
- 7. ALL STORM SEWER PIPE TO BE ADS N-12 AS NOTED ON THE STORM SEWER SCHEDULE. ALL BRANCH CONNECTIONS TO BE WYES WITH 45 DEGREE BENDS.
- 8. CONTRACTOR SHALL CONFIRM CONNECTION ELEVATION GRADES OF ALL PIPES PRIOR TO BEGINNING CONSTRUCTION.
- 9. PRIVATE WATER MAIN 4" AND LARGER SHALL BE DUCTILE IRON OR C900 PVC. WATER SERVICES 2" AND SMALLER SHALL BE TYPE K, COPPER.
- 10. SANITARY SEWER SERVICES SHALL BE SDR-35 PVC.
- 11. ANY PERSON WHO INSTALLS A NONCONDUCTIVE WATER OR SEWER LATERAL MUST ALSO INSTALL A LOCATION WIRE OR OTHER EQUALLY EFFECTIVE MEANS FOR MARKING THE LOCATION OF THE LATERAL. METHOD SHALL BE APPROVED BY THE CITY.
- 12. CONTRACTOR TO COORDINATE NEW, RELOCATED AND/OR ABANDONED GAS, ELECTRIC, TELEPHONE, AND CABLE WITH APPROPRIATE UTILITY COMPANIES.
- 13. UTILITIES SERVING PROPOSED BUILDINGS SHALL BE STUBBED WITHIN 5' OF THE PROPOSED
- 14. ALL WATER MAIN PIPE AND FITTINGS SHALL BE INSTALLED TO A MIN. DEPTH OF COVER OF 6.5'. AFTER REGRADING, EXISTING WATER MAIN PIPE WHICH DOES NOT MEET THIS REQUIREMENT SHALL BE
- 15. STORM SEWERS WHICH CROSS AN ACTIVE SEWER OR WATER MAIN OR LATERAL SHALL HAVE A MINIMUM CLEAR VERTICAL CLEARANCE OF THREE (3) FEET. CROSSINGS WITH LESSER VERTICAL CLEARANCE SHALL BE PROTECTED FROM FROST DAMAGE BY PLACEMENT OF 2-INCH THICK POLYSTYRENE BOARD INSULATION.
- 16. BUILDING PLUMBER SHALL VERIFY SIZE, SLOPE, AND EXACT LOCATION OF PROPOSED SANITARY LATERALS AND WATER SERVICES PRIOR TO INSTALLATION.
- 17. CONTRACTOR RESPONSIBLE FOR TRAFFIC CONTROL FOR WORK IN THE RIGHT-OF-WAY



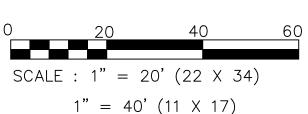

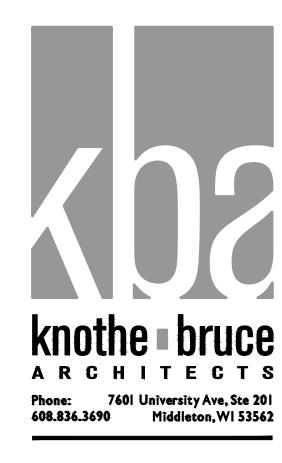



**phone** (608) 849-9378

ISSUED 10-15-19

PROJECT TITLE **AVID HOTEL** 

High Crossing Blvd. Madison, Wisconsin SHEET TITLE

**Utility Plan** 

SHEET NUMBER

C-4.0

PROJECT NO. © 2013 Knothe & Bruce Architects,

RIGHT-OF-WAY IS THE SOLE JURISTICTION OF THE CITY OF MADISON AND IS SUBJECT TO CHANGE AT ANY TIME PER RECOMMENDATION/PLAN OF TRAFFIC

# City of Madison, WI Landscape Worksheet

DEVELOPED LOTS	SQUARE FEET		LANDSCAPE POINTS REQ.
Total Developed Area			
42,491 (lot) - 30,224 (building footprint)	77887		1298
PLANT TYPE / ELEMENT	POINT VALUE	QUANTITY	TOTAL POINTS
Overstory Deciduous	35	13	455
Tall Evergreen Tree	35	4	140
Ornamental Tree	15	21	315
Upright Evergreen Shrub (i.e. arborvitae)	10		0
Shrub, deciduous	3	119	357
Shrub, evergreen	4	20	80
Ornamental Grasses/Perennials	2	87	174
Ornamental/Decorative Fencing or Wall			
(4pts / 10LF)	4		0
Existing Significant Specimen Tree	14		0
Landscape Furniture for public seating			
and/or transit connections	5		0
	POINT	S PROVIDED	1521

## PLANT LIST

KEY	SCIENTIFIC NAME	COMMON NAME	QTY	SIZE	ROOT	STEM
	DECIDUOUS TREES					
AF	Acer x freemanii 'Jefersred'	Autumn Blaze Maple	4	2"	B&B	
GT	Gleditsia triacanthos var. inermis 'Skyline'	Skyline Honeylocust	2	2"	B&B	
QB	Quercus bicolor	Swamp White Oak	3	2"	B&B	
UN	Ulmus 'New Horizon'	New Horizon Elm	3	2"	B&B	
TA	Tilia americana 'American Sentry'	American Sentry Linden	1	2"	B&B	
	ORNAMENTAL TREES	1	T	<u> </u>		
۸.	Amelanchier x grandiflora 'Autumn Brilliance'	Autumn Brilliance Serviceberry	4	2"	B&B	tree form
AG CC	Cercus canadensis	Eastern Redbud	3	2"	B&B	tree form
MJ	Malus 'Jewelcole'	Red Jewel Crabapple	4	2"	B&B	li ee ioiii
MR	Malus 'JFS-KW5'	Royal Raindrops Crabapple	7	2"	B&B	
SR	Syringa reticulata 'Ivory Silk'	Ivory Silk Japanese Tree Lilac	3	6'	B&B	1
_ SK	Syringa reticulata Tvory Silk	Ivory Silk Sapanese Tree Lilac	<u> </u>	0	I D&D	
	EVERGREEN TREES		T			
PG	Picea glauca var. densata	Black Hills Spruce	1	6'	B&B	
TO	Thuja occidentalis 'Techny'	Techny Arborvitae	2	6'	B&B	
TS	Thuja occidentalis 'Smarago'	Emerald Arborvitae	1	6'	B&B	
	EVEDODEEN CHDUDO	1	T	Ι	1	<u> </u>
Js	EVERGREEN SHRUBS  Juniper sabina 'Blue Forest'	Blue Forest Juniper	9	#5	Cont	
Pa	Picea abies 'Nidiformis'	Bird's Nest Spruce	+	+	Cont.	
Tm		· ·	9	#5	Cont.	
im	Taxus x media 'Tauntonii'	Tauntoni Yew	J 9	#5	Cont.	
	DECIDUOUS SHRUBS		T			
Cs	Cornus sericea 'Isanti'	Isanti Red Twig Dogwood	4	#5	Cont.	
Сс	Cotinus coggygria 'Golden Spirit'	Golden Spirit Smokebush	3	#5	Cont.	
Cw	Cotinus coggygria 'NCC01'	Winecraft Black Smokebush	9	#5	Cont.	
Dk	Diervilla 'G2X885411'	Kodiak Red Bush Honeysuckle	10	#3	Cont.	
Eb	Euonymu fortunei 'Interbolwji'	Blondy Euonymus	2	#3	Cont.	
Hq	Hydrangea paniculata 'SMHPLQF'	Little Quick Fire Hydrangea	8	#3	Cont.	
Нр	Hydrangea paniculata 'DVPPinky'	Pinky Winky Hydrangea	3	#5	Cont.	
Po	Physocarpus opulifolius 'Jefam'	Amber Jubilee Ninebark	32	#5	Cont.	
Pt	Physocarpus opulifolius 'SMPOTW'	Tiny Wine Ninebark	11	#5	Cont.	
Rp	Rhododendron 'PJM'	PJM Rhododendron	4	#5	Cont.	
Rk	Rosa 'BAlmir'	Easy Elegance Kashmir Rose	7	#3	Cont.	
Sb	Spiraea betulifolia 'Tor Gold'	Glow Girl Spirea	12	#3	Cont.	
Sp	Syringa 'SMSJBP7'	Dark Purple Bloomerang Lilac	5	#3	Cont.	
Vd	Viburnum dentatum 'Christom'	Blue Muffin Arrowwood Viburnum	9	#5	Cont.	
	LODMANISMENTAL ODAGOGO & DEDENIMALO	1			_	
	ORNAMENTAL GRASSES & PERENNIALS	Kon Francisco Francisco Prant C	- 04	11.4	0	1
ca	Calamagrostis x acutiflora 'Karl Foerster'	Karl Foerster Feather Reed Grass	31	#1	Cont.	-
he	Hemerocallis 'EveryDaylily Cream'	Everyday Daylily Cream Daylily	24	#1	Cont.	-
pa	Perovskia atriplicifolia	Russian Sage	3	#1	Cont.	-
sn	Salvia nemorosa 'Caradonna'	Caradonna Salvia	6	#1	Cont.	-
SS	Schizachyrium scoparium 'Carousel'	Carousel Little Bluestem Grass	15	#1	Cont.	1

WM Brown Dyed Wood Mulch / Vinyl edge


WS Brown Dyed Wood Mulch / Shovel cut edge

SOD Premium Kentucky Bluegrass sod

SEED Premium sunny seed blend with straw mat. (Class 1 Type B single net)

# LANDSCAPE NOTES:

- Please refer to Grading & Erosion Control Plan for final contour information.
- Individual tree and shrub groupings in lawn areas to receive wood mulch rings with shovel cut edge.
- Add street trees per the direction of the City Forester.
- Vinyl edge is Dimex EdgePro polyvinyl edging or equivalent

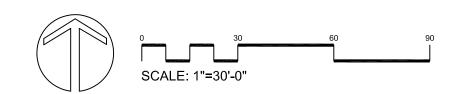



OLSON A TOON
LANDSCAPING 2

3570 Pioneer Road Verona, WI 53593 PH: (608) 827-9401 FAX: (608) 827-9402 WEB: www.olsontoon.com

# THE AVID HOTEL


Date: Scale: Designer: KMS Job #

Seal:
To protect against legal liability, the plans presented herein are "schematic," and should not be outsourced as "biddable" or "construction documents" unless approved by the Landscape Designer. This is not an original document unless stamped in red, as ORIGINAL.


Revisions:

\_\_1.0

Reference Name:

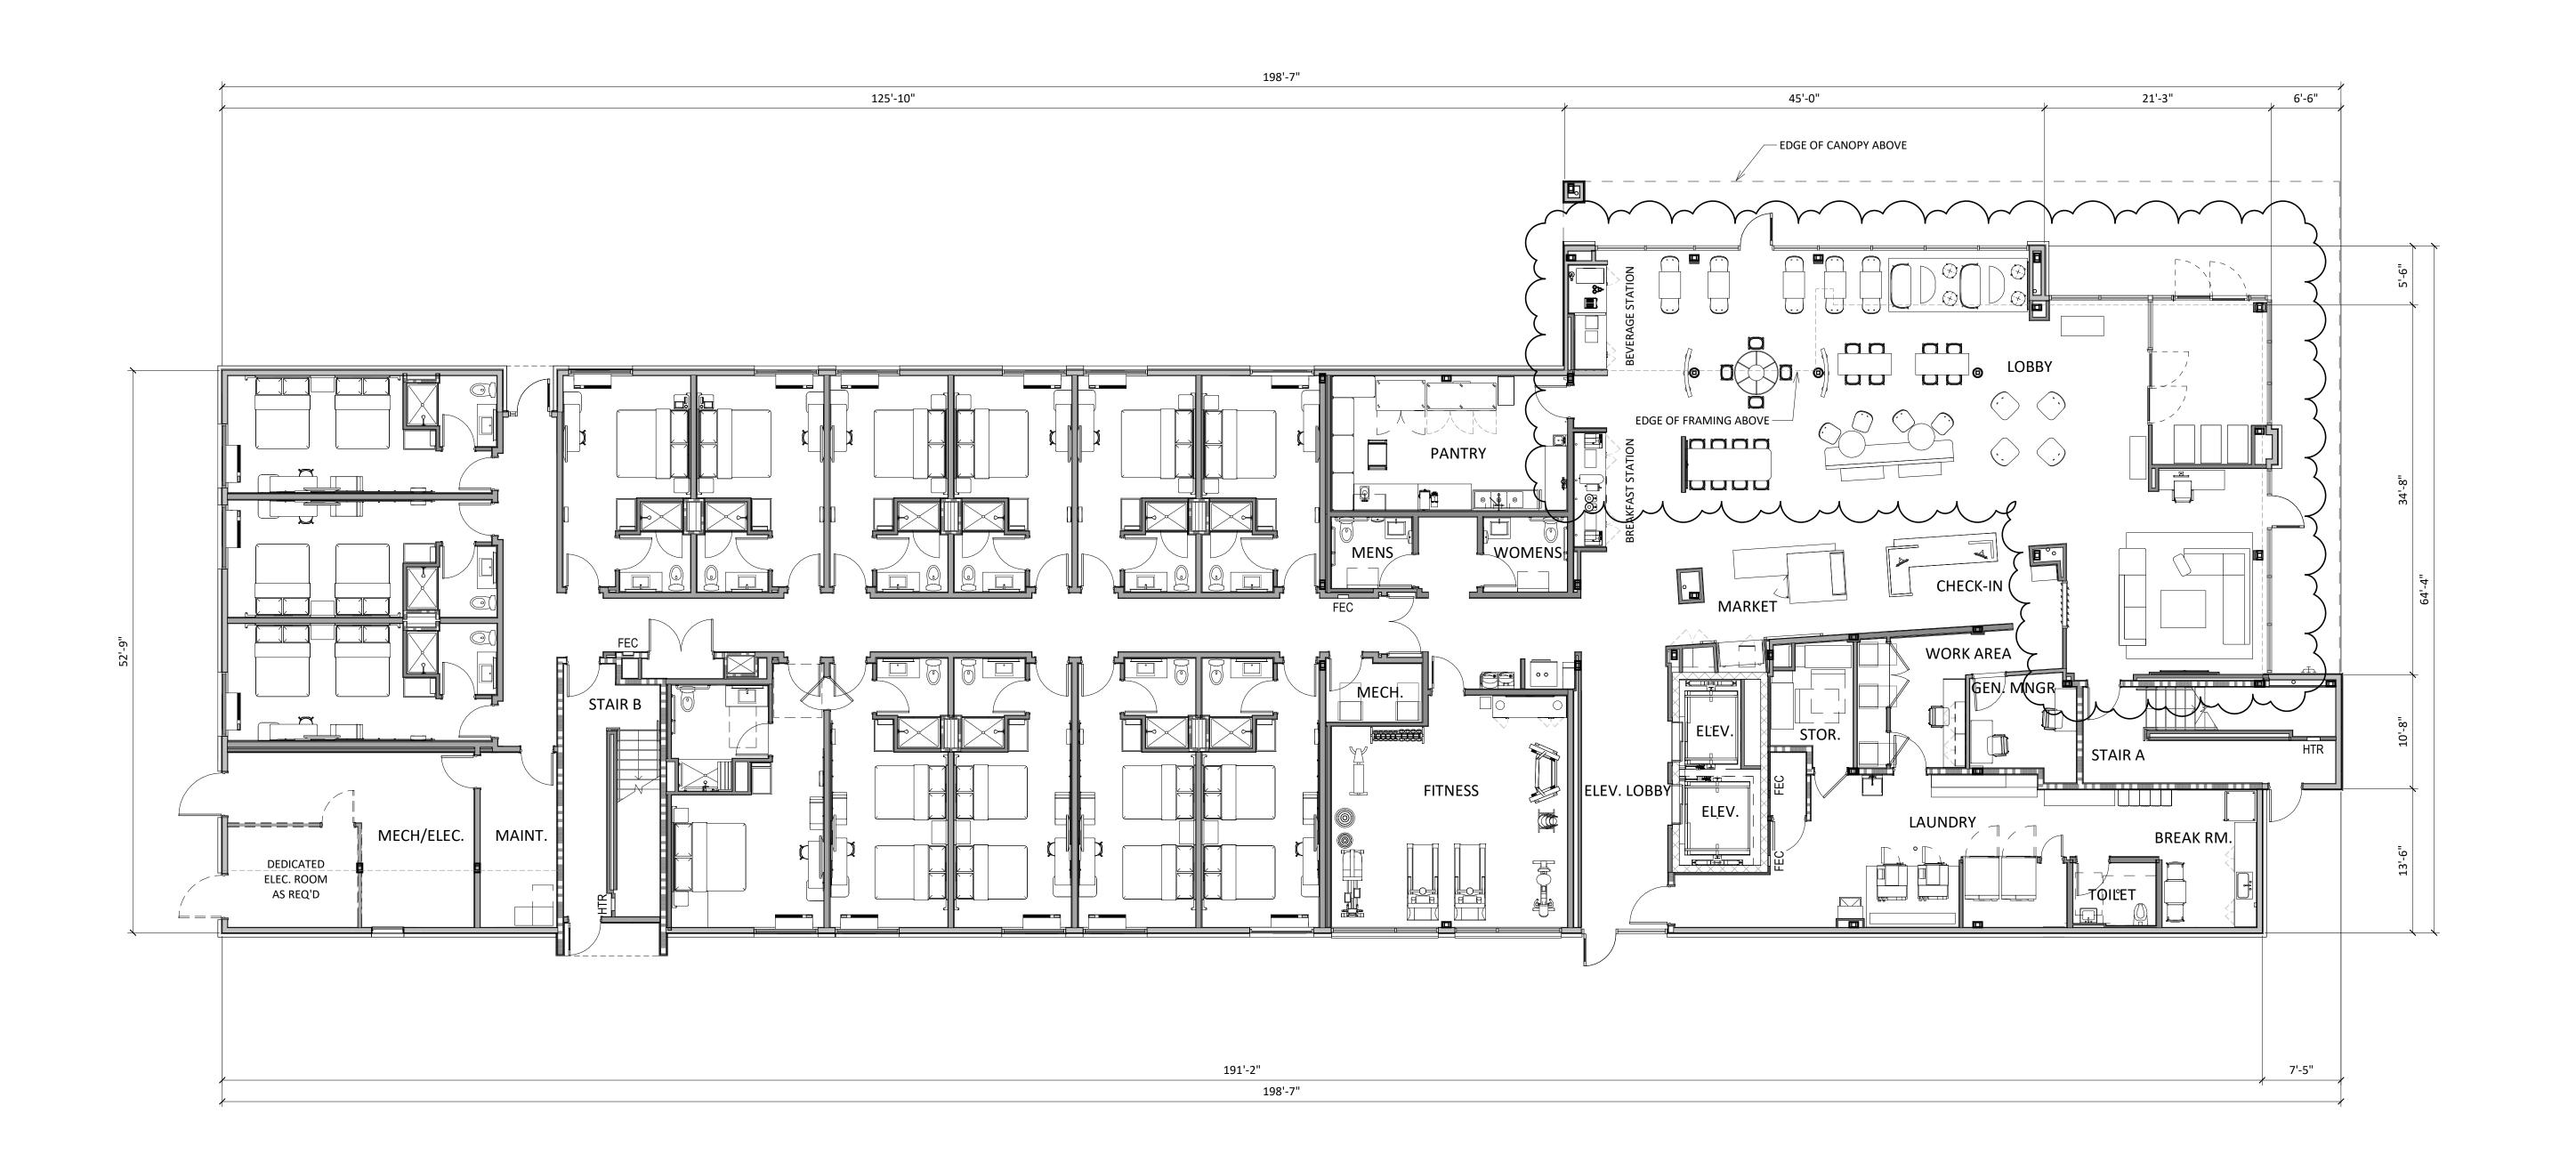



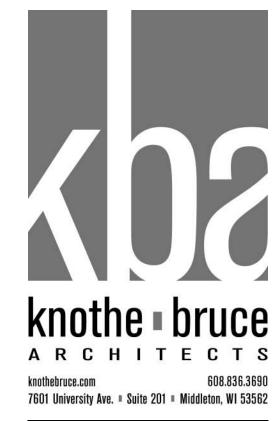

ISSUED
Revised Building Location - October 16, 2019


1 Revision 1 10/16/19
PROJECT TITLE

**AVID HOTEL** 

5110 HIGH CROSSING BLVD MADISON, WI

SHEET TITLE
First Floor
Plan

SHEET NUMBER

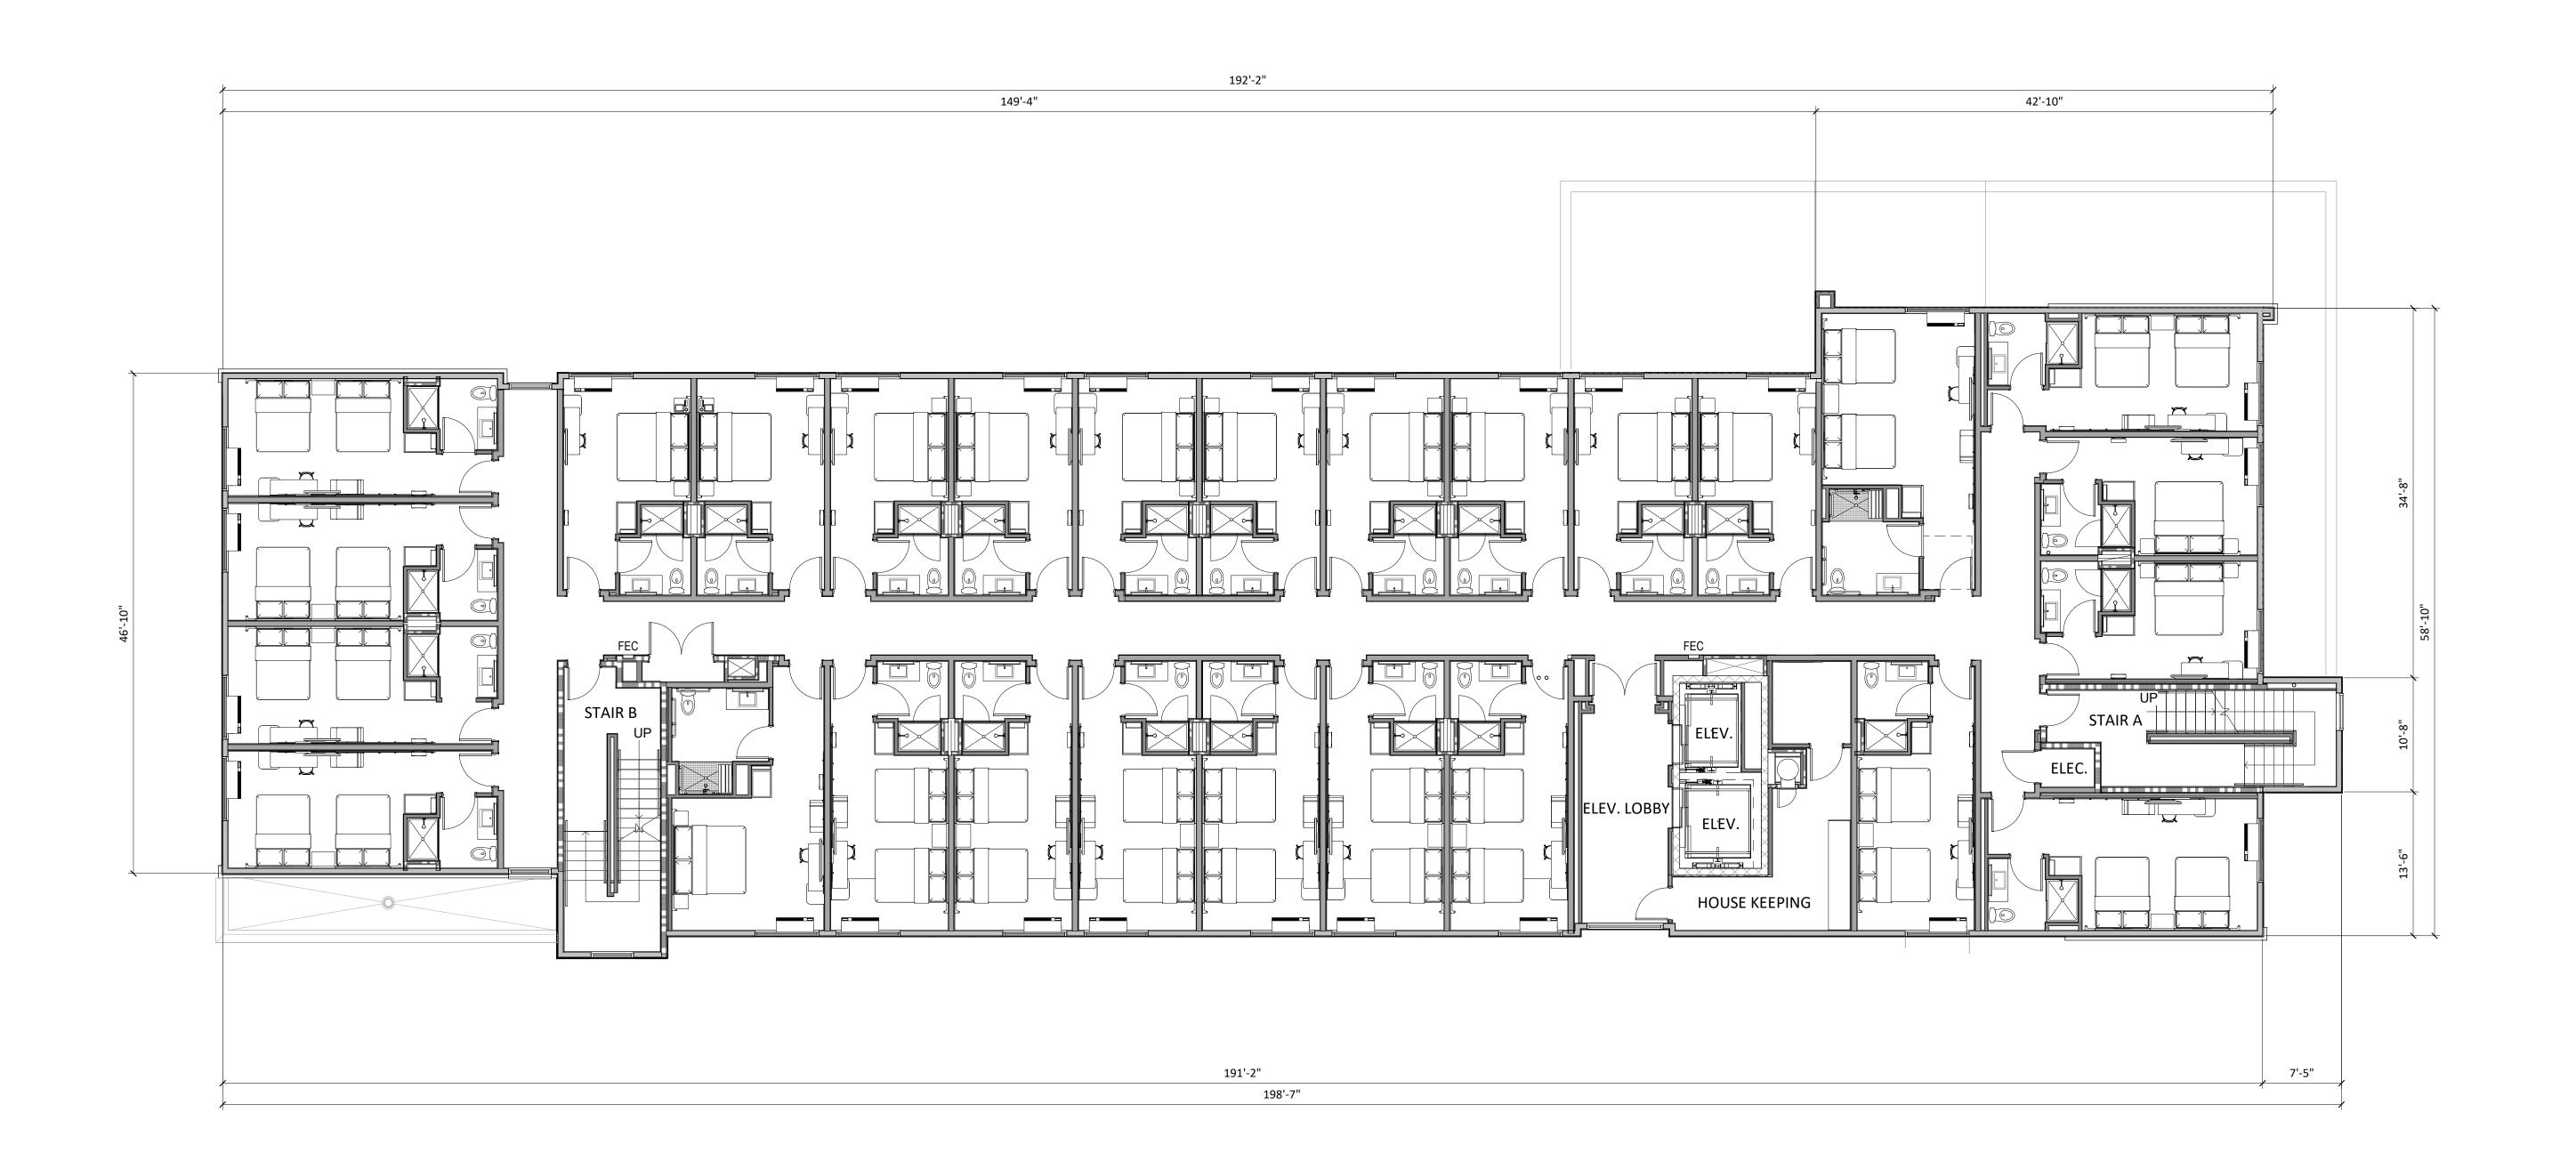





ISSUED
Revised Building Location - October 16, 2019


PROJECT TITLE

AVID HOTEL


5110 HIGH CROSSING BLVD MADISON, WI

SHEET TITLE
Second
Floor Plan

SHEET NUMBER

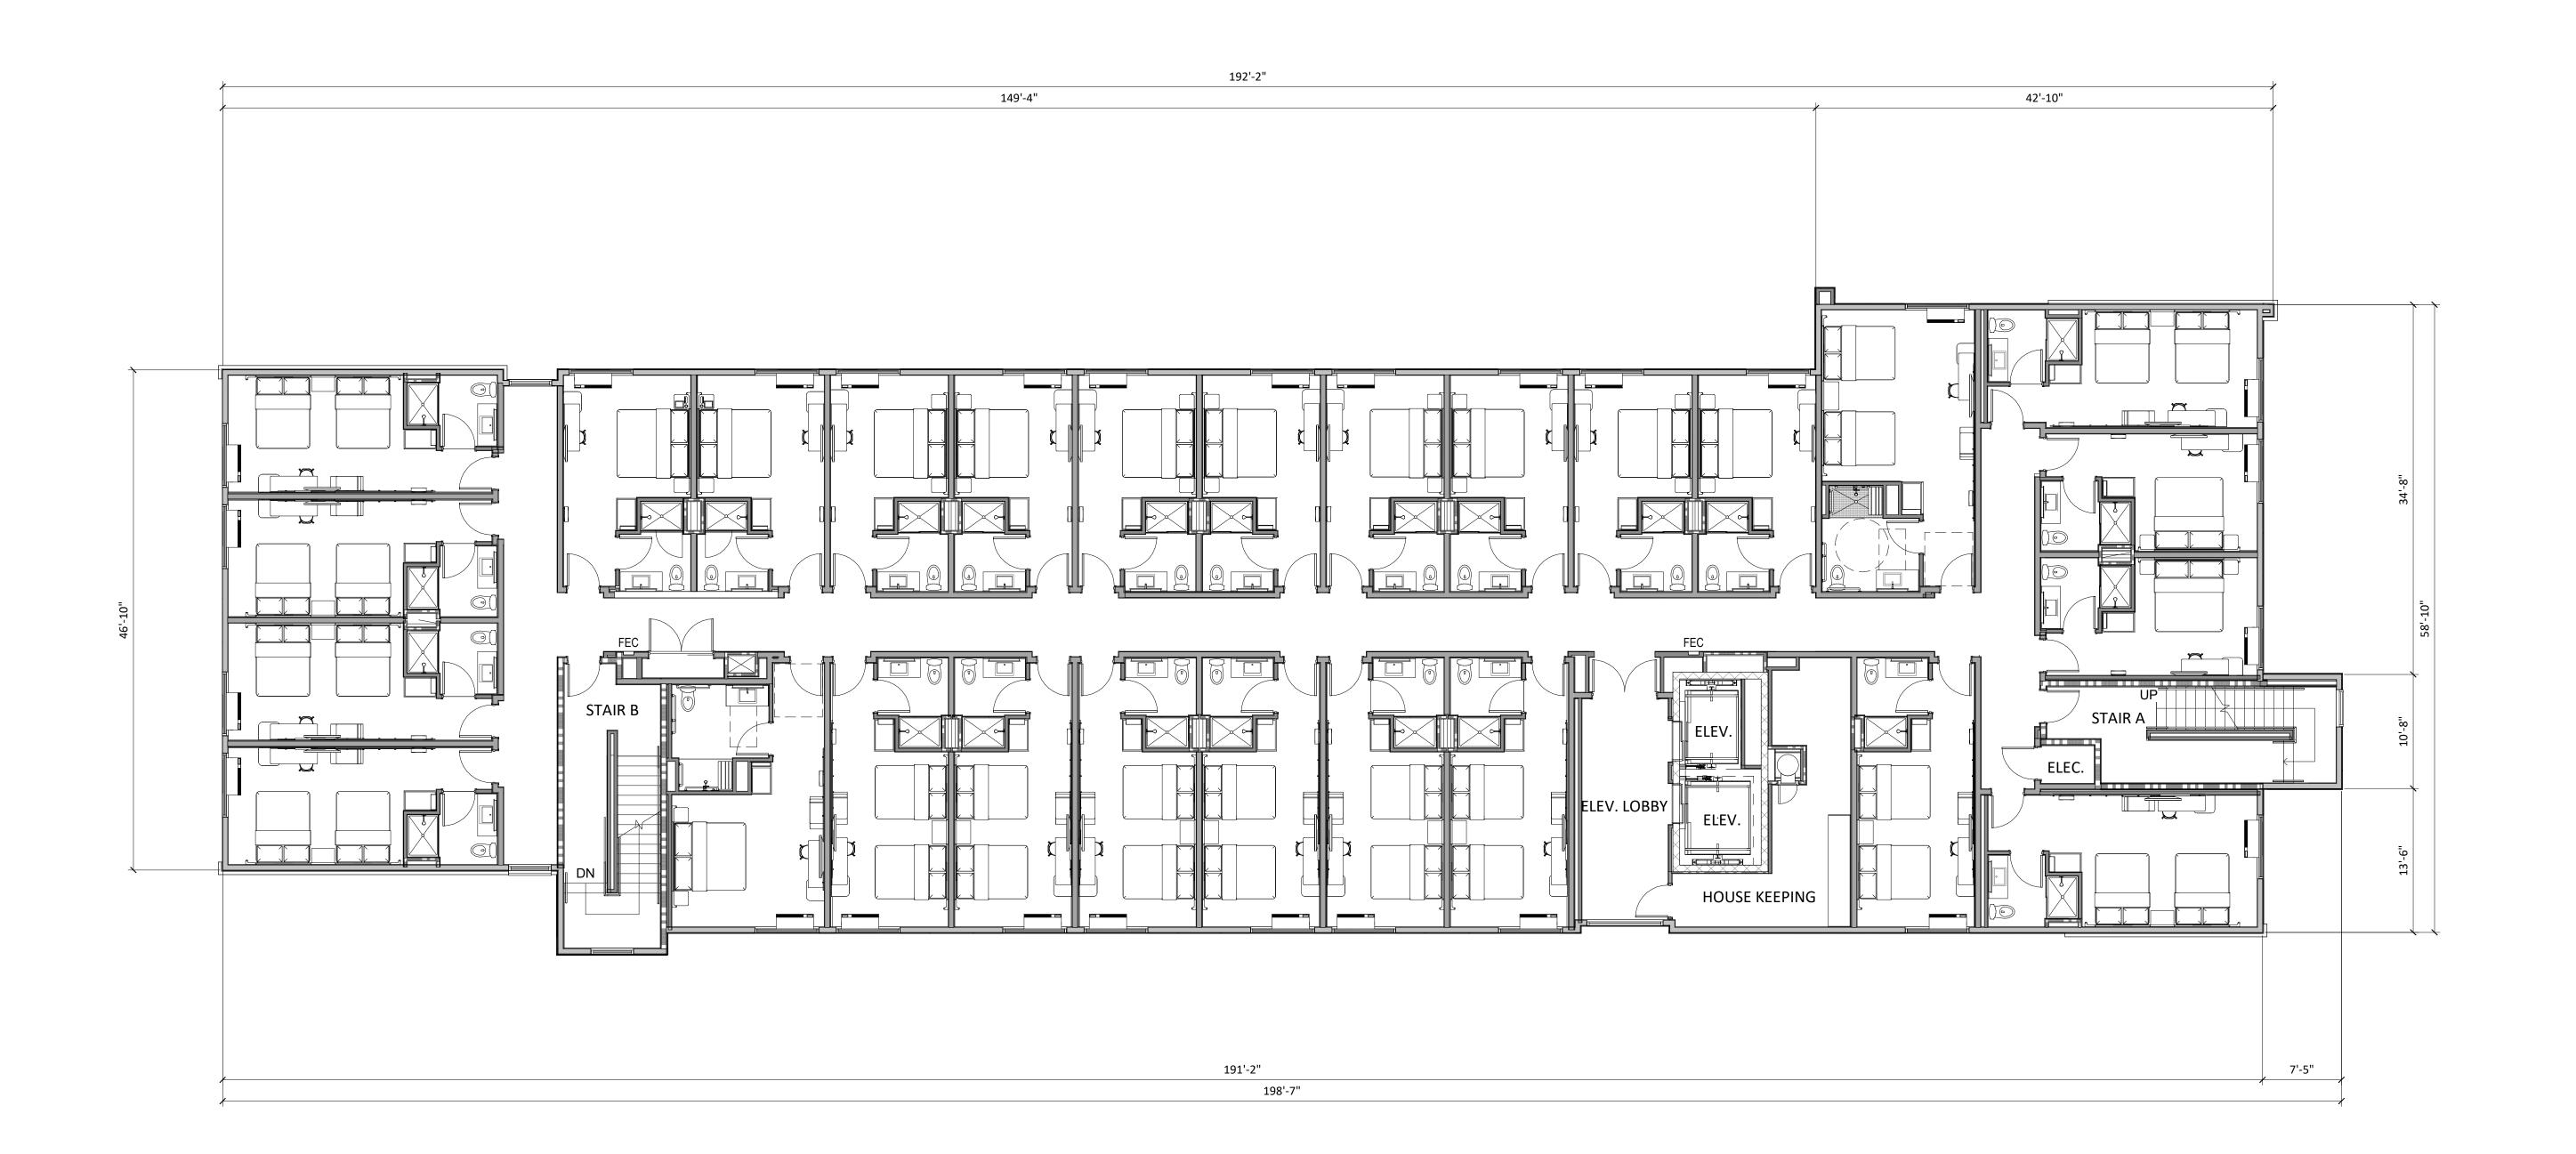



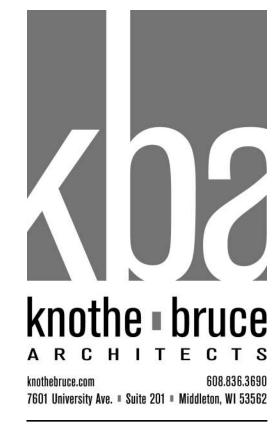

ISSUED
Revised Building Location - October 16, 2019

PROJECT TITLE

AVID HOTEL

5110 HIGH CROSSING BLVD MADISON, WI


SHEET TITLE
Third Floor
Plan

SHEET NUMBER


A-1.3

PROJECT NUMBER 1808

© 2015 Knothe & Bruce Architects, LLC

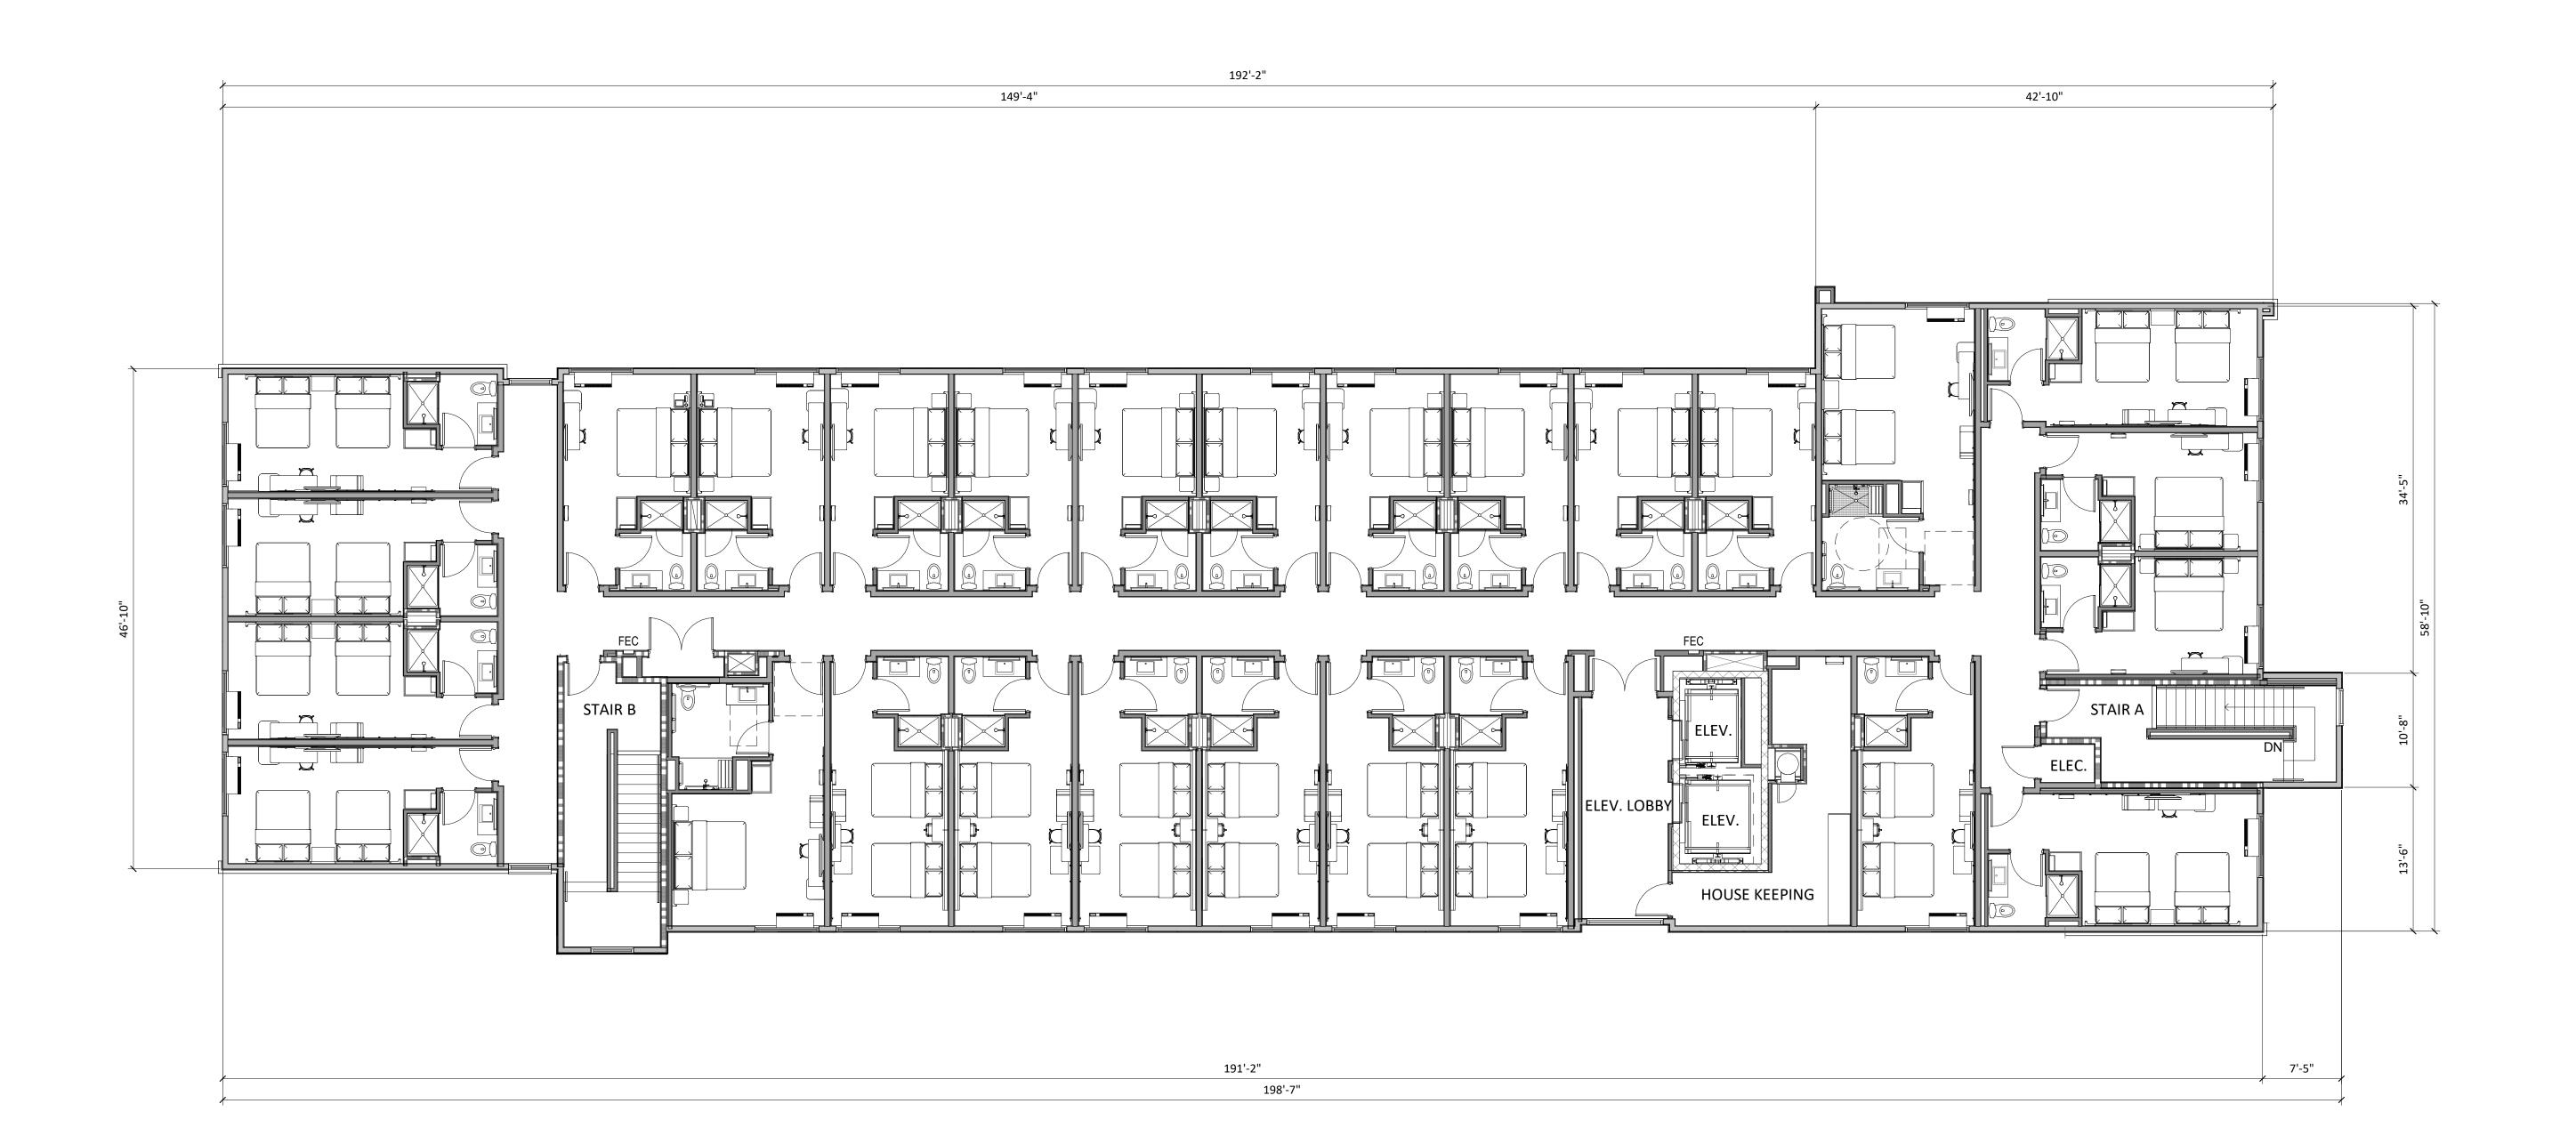



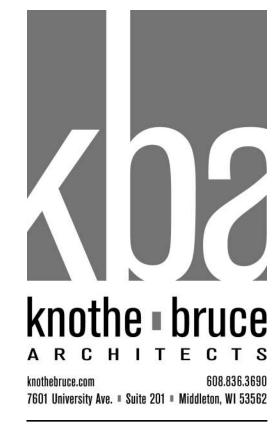

ISSUED
Revised Building Location - October 16, 2019


PROJECT TITLE

AVID HOTEL

5110 HIGH CROSSING BLVD MADISON, WI

Fourth Floor

SHEET NUMBER

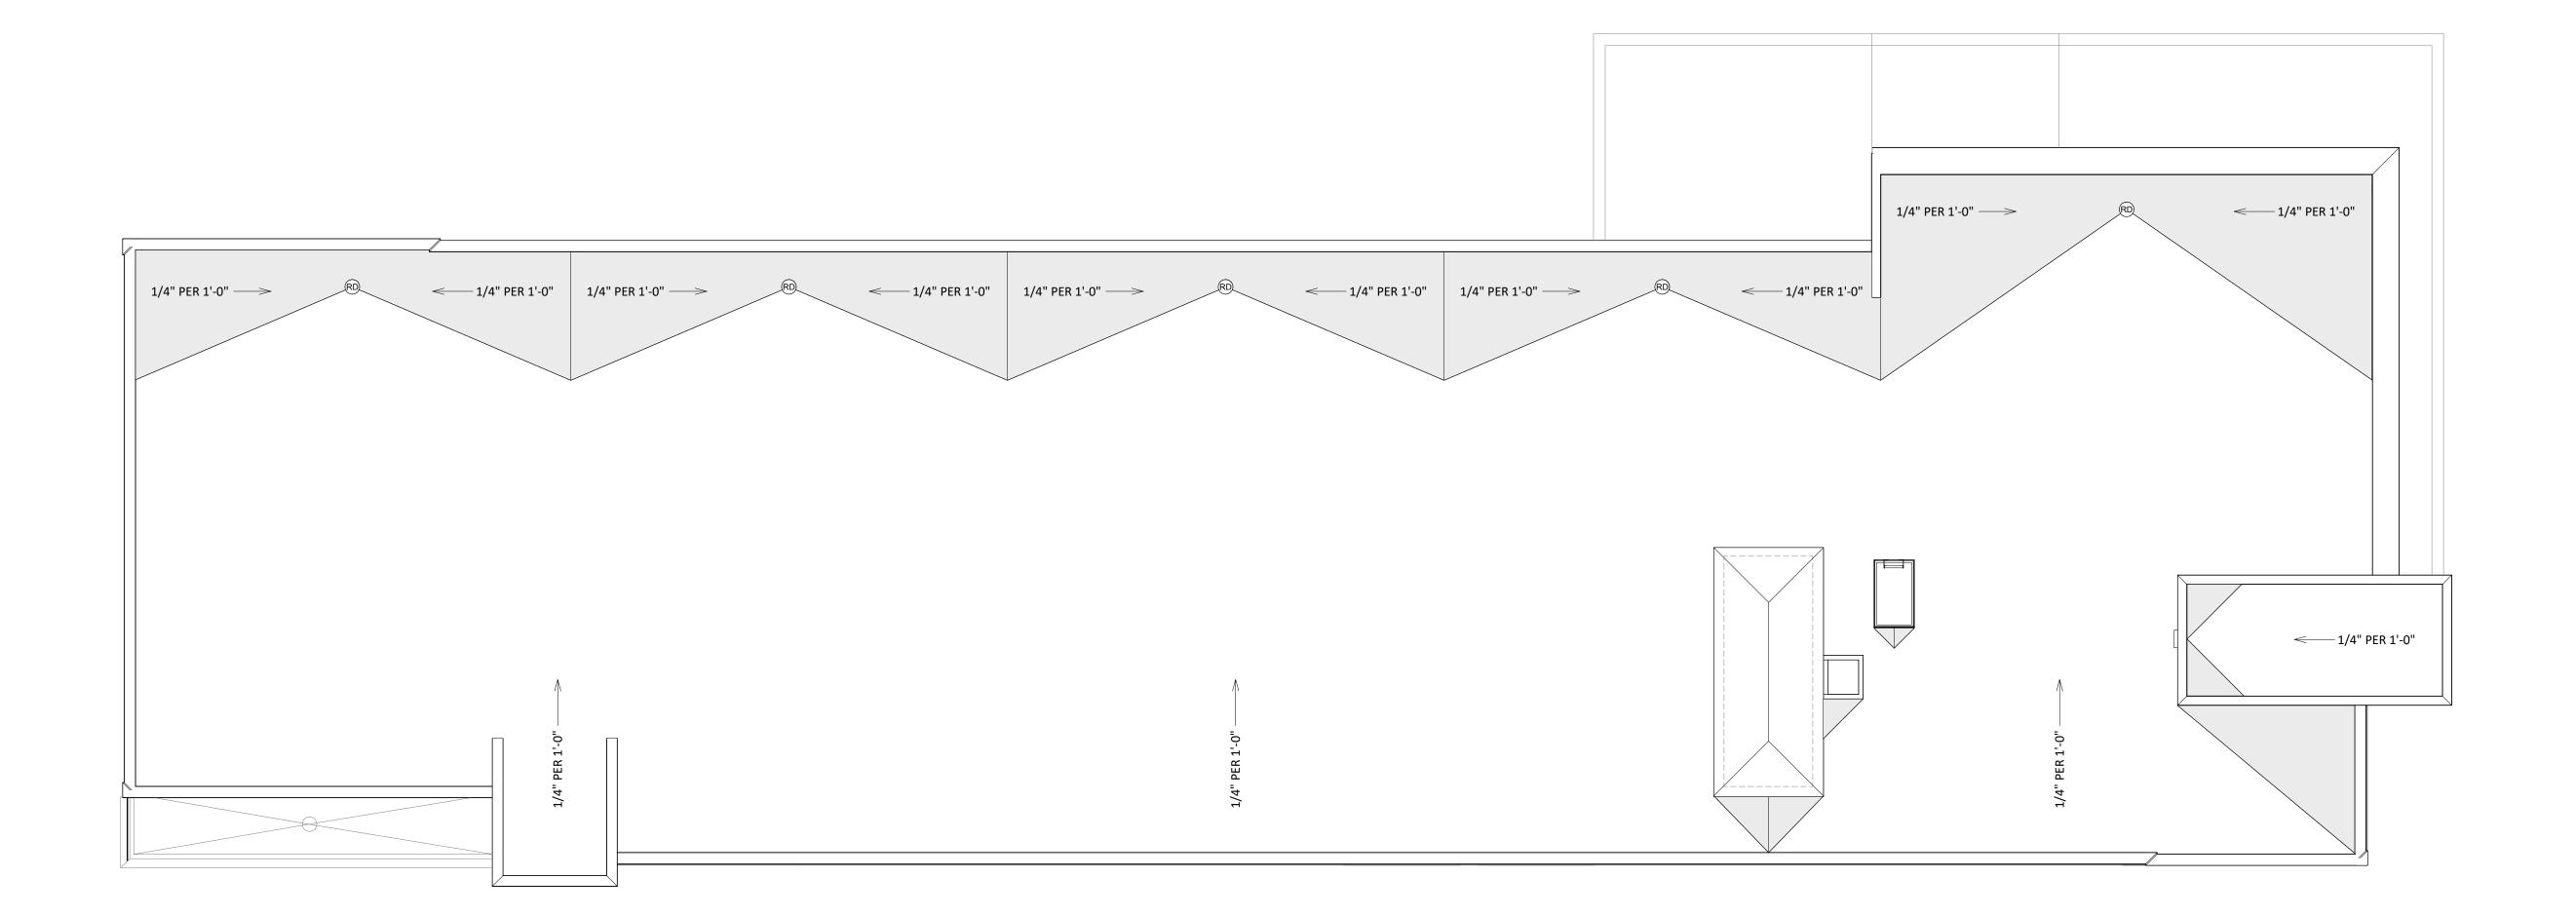



ISSUED
Revised Building Location - October 16, 2019

PROJECT TITLE


AVID HOTEL


5110 HIGH CROSSING BLVD MADISON, WI

SHEET TITLE
Roof Plan

SHEET NUMBER

EXTERIOR MATERIAL SCHEDULE					
BUILDING ELEMENT	COLOR				
1 FIBER CEMENT PANELS	MINDFUL GRAY - SW7016				
2 FIBER CEMENT PANELS	GAUNTLET GRAY - SW7019				
3 FIBER CEMENT PANELS	CHERRY TOMATO - SW6864				
4 CANOPY SOFFIT	BORABORA SHORE - SW9045				
S BRICK VENEER	ACME BRICK - SLATE GRAY				
CAST STONE BASE & BAND	PRAIRIE STONE - GRIS				
ALUMINUM EXTERIOR / INTERIOR STOREFRONT	CLEAR ANODIZED				
ALUMINUM WINDOWS W/ INTEGRAL LOUVER	DARK BRONZE ANODIZED				
ALUMINUM WINDOWS @ BRICK VENEER (5)	DARK BRONZE ANODIZED				
ALUMINUM WINDOWS @ RED WALLS ③	CLEAR ANODIZED				
INSULATED METAL DOORS/FRAMES	MATCH ADJACENT FIBER CEMENT PANELS OR BRICK VENEER				
METAL COPINGS & FLASHING	MATCH ADJACENT FIBER CEMENT PANELS OR BRICK VENEER				
STEEL ENTRY CANOPY	GAUNTLET GRAY - SW7019 - MATCH				
ALUMINUM LOUVERS @ BRICK VENEER	GAUNTLET GRAY - SW7019 - MATCH				

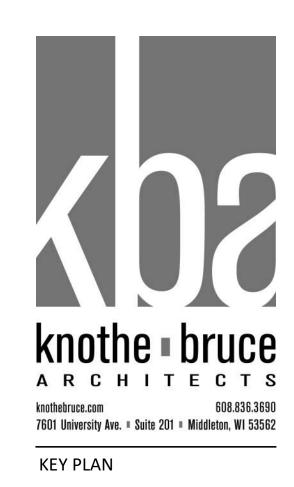


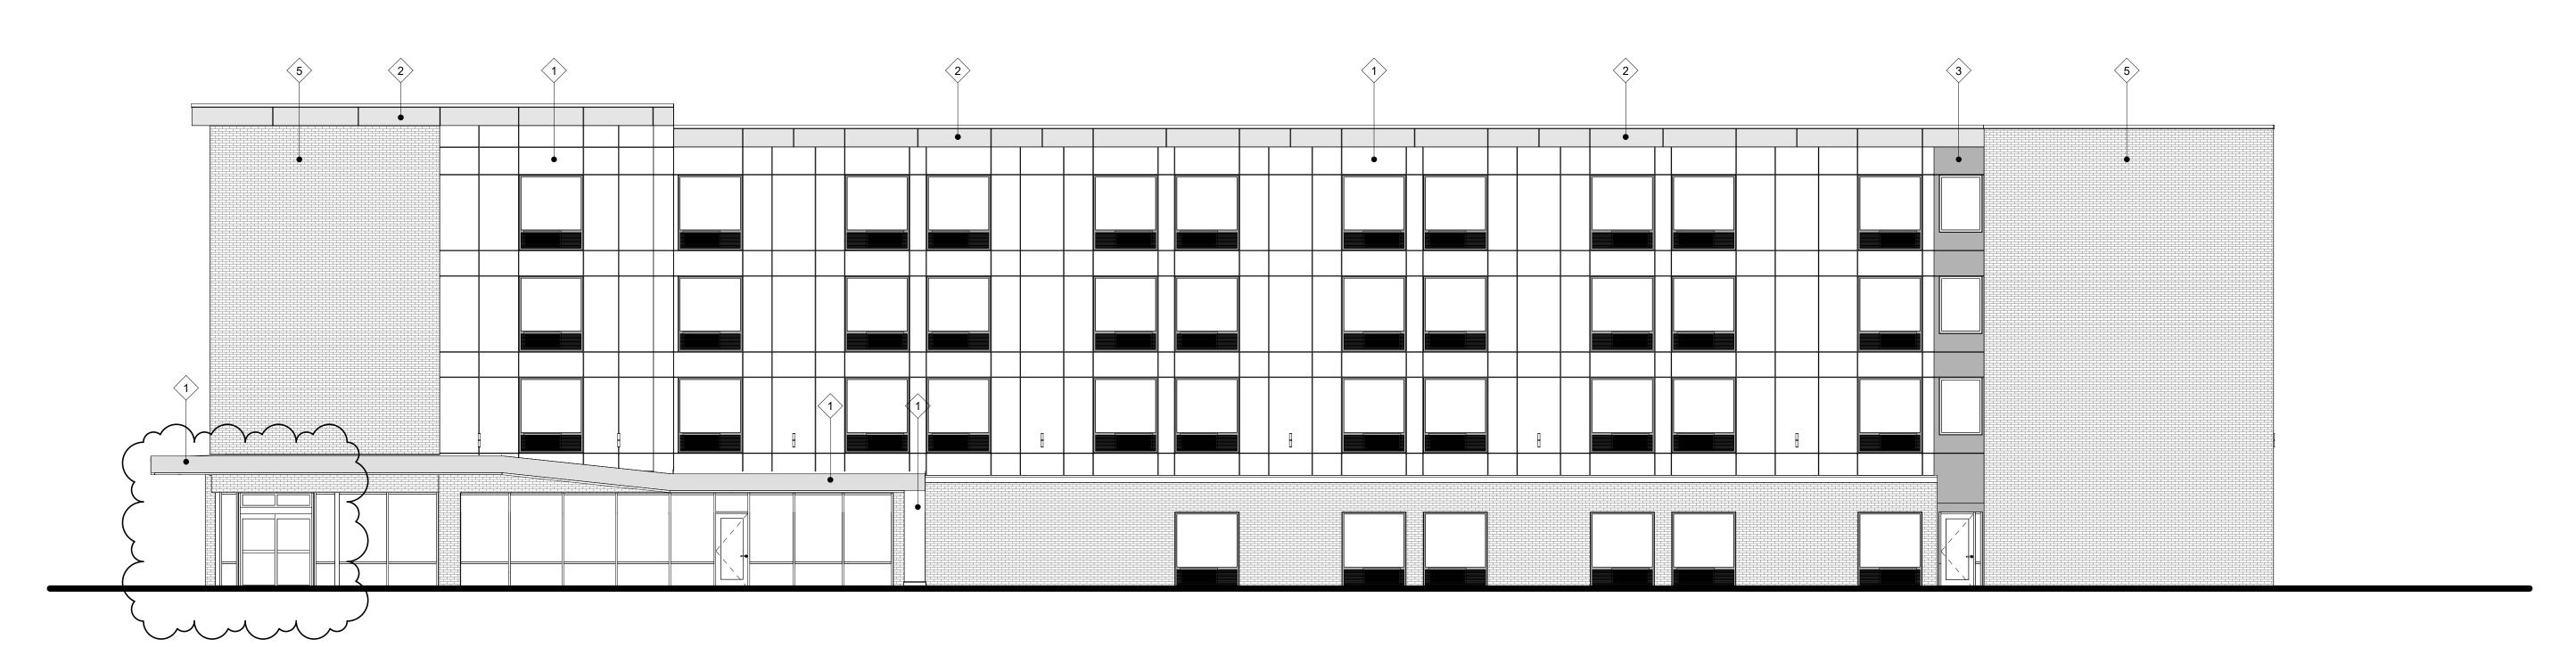

ISSUED
Revised Building Location - October 16, 2019

1 EAST ELEVATION 1/8" = 1'-0"

1 Revision 1 10/16/19
PROJECT TITLE
AVID HOTEL

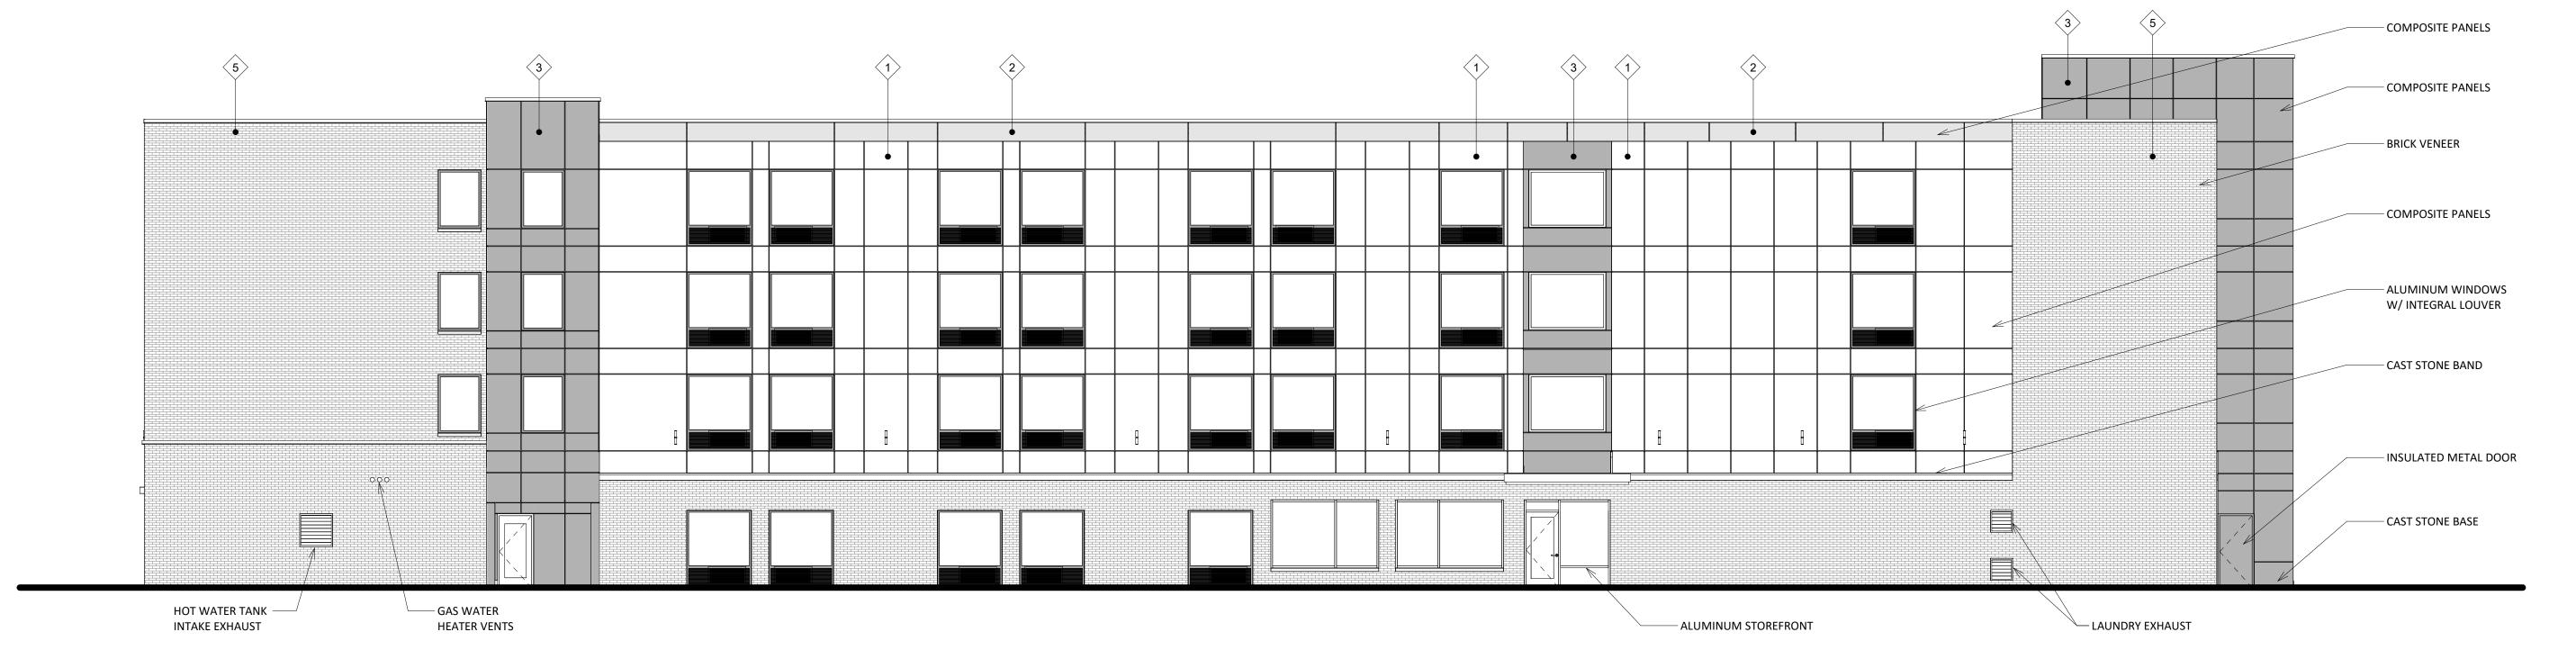

5110 HIGH
CROSSING BLVD
MADISON, WI

SHEET TITLE
Exterior
Elevations

SHEET NUMBER


A-2.1

PROJECT NUMBER 1808

© 2015 Knothe & Bruce Architects, LLC

2 WEST ELEVATION 1/8" = 1'-0"



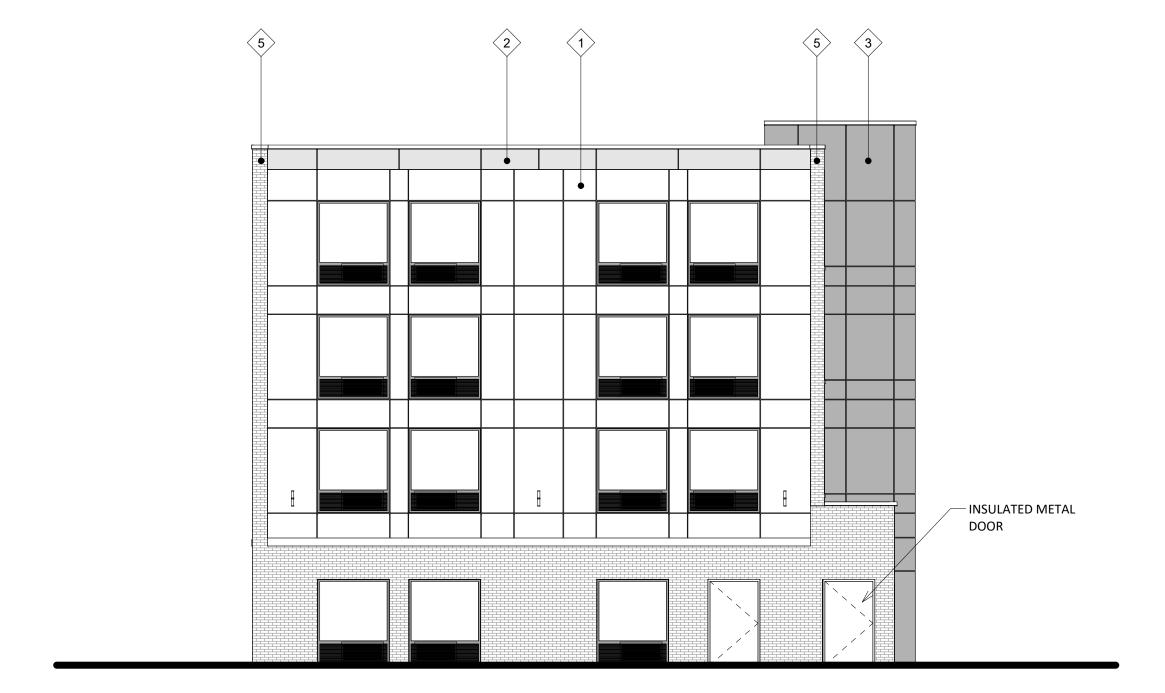

STEEL ENTRY
CANOPY

COMPOSITE PANELS (INDERNINSIDE OF ENTRY CANOPY)

ISSUED
Revised Building Location - October 16, 2019

1 Revision 1 10/16/19
PROJECT TITLE

AVID HOTEL

SOUTH ELEVATION

A-2.2 1/8" = 1'-0"

NORTH ELEVATION

1/8" = 1'-0"

5110 HIGH CROSSING BLVD MADISON, WI

Exterior Elevations

SHEET NUMBER

A-2.2


PROJECT NUMBER 1808

© 2015 Knothe & Bruce Architects, LLC

EXTERIOR	MAT	ERIAL SCHE	DULE
BUILDING ELEMENT		COLOR	
1 FIBER CEMENT PANELS		MINDFUL GRAY - SW7016	
2 FIBER CEMENT PANELS		GAUNTLET GRAY - SW7019	
3 FIBER CEMENT PANELS	·	CHERRY TOMATO - SW6864	
4 CANOPY SOFFIT		BORABORA SHORE - SW9045	
5 BRICK VENEER		ACME BRICK - SLATE GRAY	
CAST STONE BASE & BAND		PRAIRIE STONE - GRIS	
ALUMINUM EXTERIOR / INTERIOR STOREFRONT		CLEAR ANODIZED	
ALUMINUM WINDOWS W/ INTEGRAL LOUVER		DARK BRONZE ANODIZED	
ALUMINUM WINDOWS @ BRICK VENEER 5		DARK BRONZE ANODIZED	
ALUMINUM WINDOWS @ RED WALLS ③		CLEAR ANODIZED	
INSULATED METAL DOORS/FRAMES		MATCH ADJACENT FIBER CEM	ENT PANELS OR BRICK VENEER
METAL COPINGS & FLASHING		MATCH ADJACENT FIBER CEM	ENT PANELS OR BRICK VENEER
STEEL ENTRY CANOPY		GAUNTLET GRAY - SW7019 - N	латсн <u> </u>
ALUMINUM LOUVERS @ BRICK VENEER		GAUNTLET GRAY - SW7019 - N	



1 EAST ELEVATION 1/8" = 1'-0"

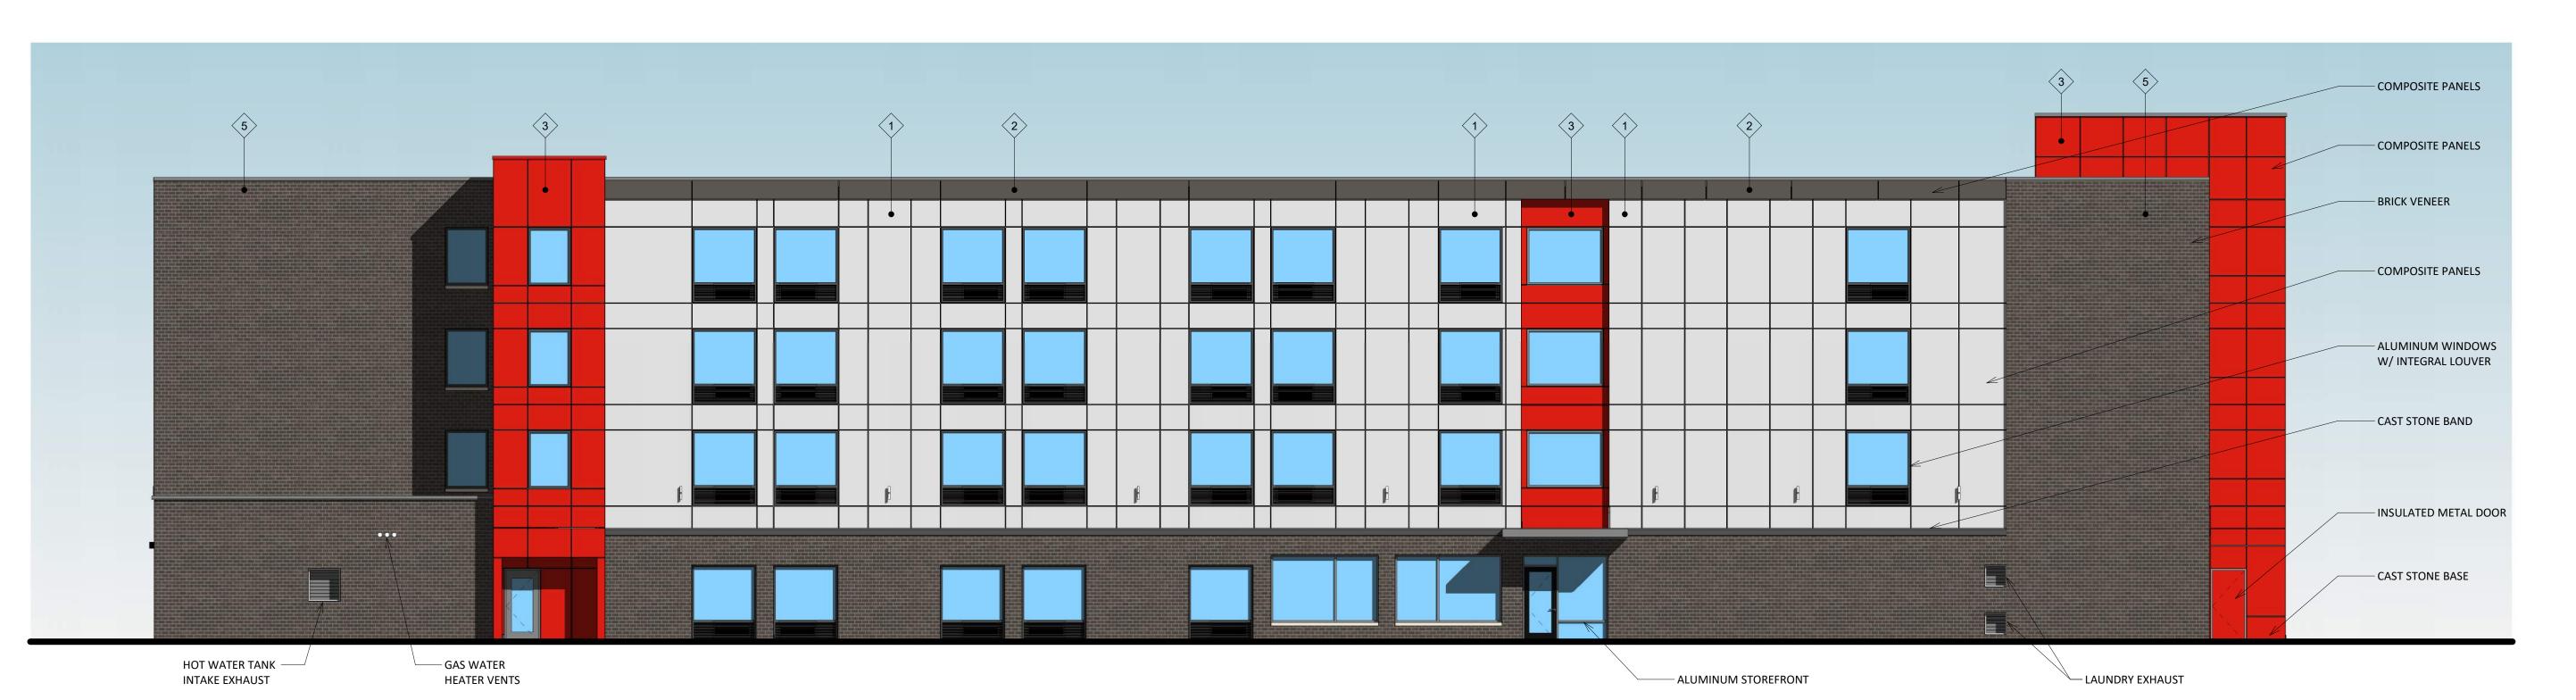

2 WEST ELEVATION
A-2.1 1/8" = 1'-0"

knothe bruce

A R C H I T E C T S

knothebruce.com
608.836.3690
7601 University Ave. Suite 201 Middleton, WI 53562

KEY PLAN

Revised Building Location - October 16, 2019

1 Revision 1 10/16/19
PROJECT TITLE

**AVID HOTEL** 

5110 HIGH CROSSING BLVD MADISON, WI

Exterior Elevations


SHEET NUMBER

A-2.1



NORTH ELEVATION

A-2.2 1/8" = 1'-0"

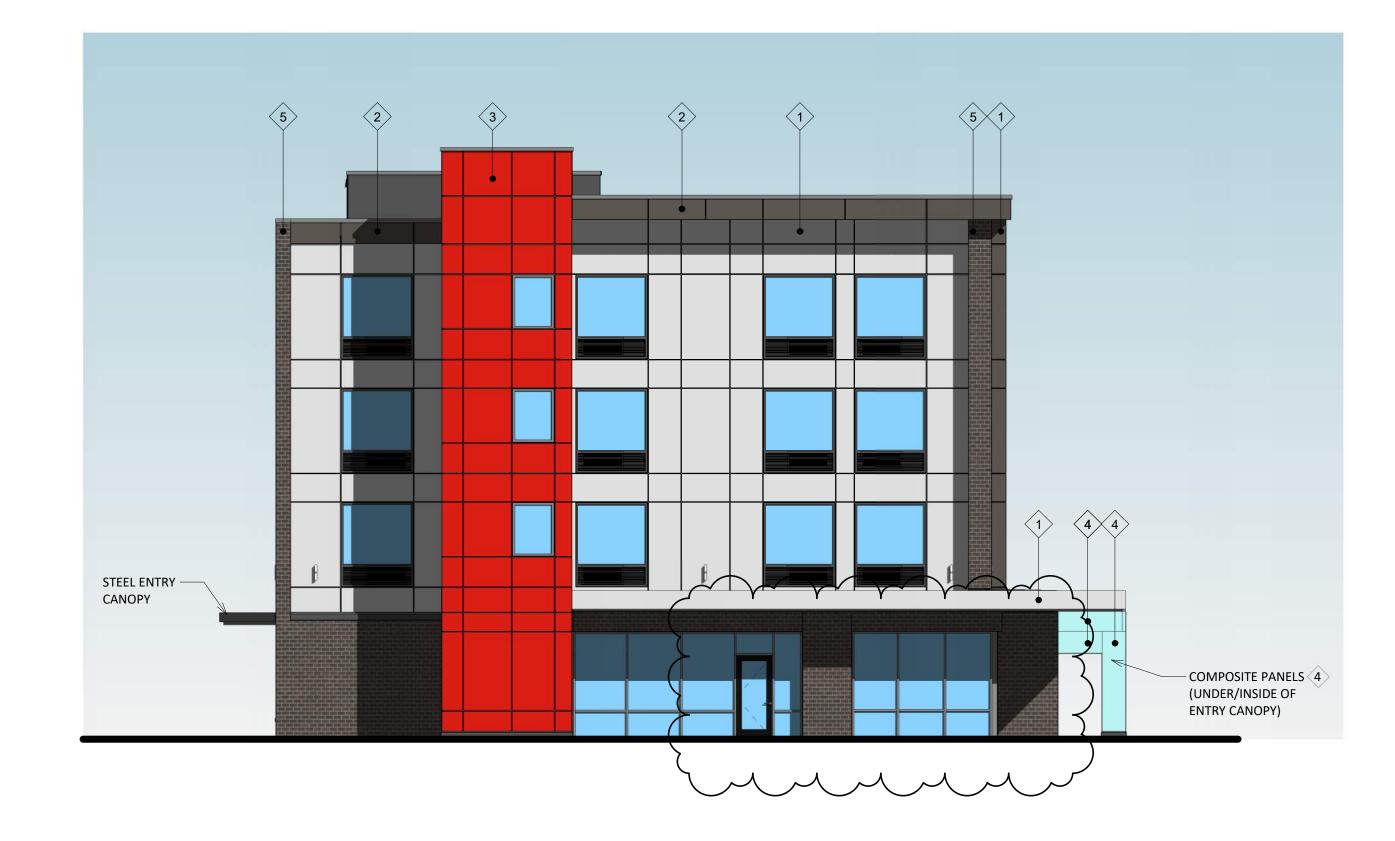

SOUTH ELEVATION

Revised Building Location - October 16, 2019

7601 University Ave. Suite 201 Middleton, WI 53562

**KEY PLAN** 

1 Revision 1 10/16/19
PROJECT TITLE

AVID HOTEL

5110 HIGH CROSSING BLVD MADISON, WI

Exterior Elevations

SHEET NUMBER





### **DESCRIPTION**

The Tribute is the most versatile, functionally designed, universally adaptable outdoor luminaire available. The Tribute brings outstanding performance to walkways, parking lots, roadways, loading docks, building areas, and any security lighting application. U.L. listed and CSA certified for wet locations. IP55 Rating.

Catalog #	Туре
Project	
Comments	Date
Prepared by	

### **SPECIFICATION FEATURES**

### Construction

Rugged one-piece die-cast aluminum housing and door frame. One-piece silicone gasket protects the optical chamber from performance degrading contaminants. One (1) stainless spring latch and two (2) stainless hinges allow toolless opening and removal of door frame.

### **Electrical**

Ballast and related electrical componentry are hard mounted to die-cast housing for optimal heat transfer and operating efficiency. Optional swing-down galvanized steel power tray with integral handle and quick disconnects allows tray to be completely removed from housing providing ample room for fixture installation and maintenance.

### Reflector

Choice of nine (9) high efficiency optical distributions, including five (5) segmented optical systems

constructed of premium 95% reflective anodized aluminum sheet. Optical segments are rigidly mounted inside a thick gauge aluminum housing for superior protection. All segment faces are clean of rivet heads, tabs or other means of attachment which may cause streaking in the light distribution. Optical modules are field rotatable in 90° increments and offered standard with mogul-base lampholders for High Pressure Sodium and 250-400W Pulse Start Metal Halide assemblies.

### Mounting

Extruded 8" aluminum arm features internal bolt guides for easy positioning of fixture during installation to pole or wall surface. Standard single carton packaging of housing, square pole arm and round pole adapter allow for consolidated product arrival to site. Optional internal mast arm mount accepts a 1 1/4" to 2 3/8"

O.D. horizontal tenon, while 4-bolt clamping mechanism secures fixture. Cast-in leveling guides provide +/-5° vertical leveling adjustment.

### **Finish**

Housing and arm finished in a 5 stage premium TGIC bronze polyester powder coat paint. Optional colors include black, grey, white, dark platinum and graphite metallic. RAL and custom color matches available.

**Efficiency Standards Notice** Select luminaires are manufactured to USA and California efficiency regulations.




Streetworks

### **TRU TRIBUTE**

100 - 400W **Pulse Start Metal Halide High Pressure Sodium** 

AREA LUMINAIRE


### **DIMENSIONS**

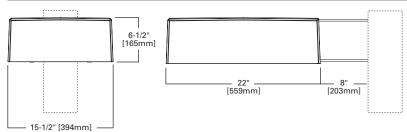


### ARM DRILLING

### TYPE "M" 2-5/16 [59mm] 3/4" [19mm] Dia. Hole 2-7/16" [62mm] 4-7/8" [124mm] (2) 5/8" [16mm] Dia. Holes

### WALL DRILLING

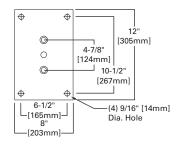

### TRUNNION DRILLING

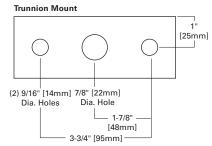

### CERTIFICATIONS

IP55 Rated UL Listed for Wet Locations CSA Certified for Wet Locations EISA Compliant ®

### **EPA** Effective Projected Area: Without Arm 1.19 With Arm 1.63


SHIPPING DATA Approximate Net Weight: 39 lbs. (18 kgs.)







### MOUNTING CONFIGURATIONS

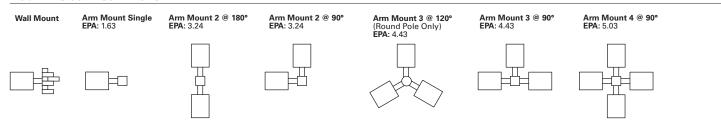

### ORDERING INFORMATON

Sample Number: TRU40PWWSLAP

Product Family 1,2	Lamp Wattag	9	Lamp Type <sup>4</sup>	Ballast Type <sup>4</sup>	Voltage <sup>4</sup>	Distribution	Color
TRU=Tribute (Arm Included)	Pulse Start M 25=250W 32=320W 35=350W 40=400W <sup>4</sup> High Pressure 10=100W 15=150W 20=200W 25=250W 40=400W 24=250/400W, 42=400/250W,	Sodium wired 250W	P=Pulse Start Metal Halide S=High Pressure Sodium	H=Reac. /HPF K=10KV CWA N=Hi.Reac. /NPF P=Hi.Reac. /HPF R=Reac. /NPF W=CWA <sup>5</sup>	2=120V 0=208V 4=240V 7=277V 8=480V 9=347V W=Multi-Tap, wired 120V N=Multi-Tap, wired 277V	2F=Type II Formed 2S=Type II Segmented 3F=Type III Formed 3S=Type III Segmented 4F=Type IV Formed 4S=Type IV Segmented 5F=Type V Formed 5S=Type V Segmented SL=Spill Light Eliminator	AP=Grey BZ=Bronze BK=Black DP=Dark Platinum GM=Graphite Metallic WH=White
Options (Add as Suffix)  1=Single Fuse (120, 277 or 34 2=Double Fuse (208, 240 or 44 4=NEMA Twistlock Photocontrol H=Plug-In Starter Receptacle T=Terminal Block U=U.L. Listed O=Quartz Restrike (Hot Restri EM=Quartz Restrike with Dela at Cold Start) 7  TM=Trunnion Mount PT=Electrical Power Tray S=1-1/4" - 2-3/8" Internal Mass LA=Less Arm (Order Mountin K=Level Indicator B=House Side Shield 8	80V) <sup>6</sup> trol Receptacle ke Only) <sup>7</sup> ty (Also Strikes	MA1201-XX=I MA1218-XX=I MA1219-XX=I QA1090=Adju TR/VS=Field I MA1221-XX=I MA1222-XX=I MA1223-XX=I MA1225-XX=I MA1010-XX=S MA1011-XX=S MA1011-XX=S	Order Seperately) <sup>9</sup> Direct Wall Mount Kit <sup>2</sup> Direct Mount for Pole <sup>2</sup> Wall Mounting Plate stable Slipfitter Arm for Tenoi nstalled Vandal Shield <sup>10</sup> External House Side Shield Kit nternal House Side Shield Kit strenal House Side Shield Kit Single Tenon Adapter for 3-1/2 2 @ 180° Tenon Adapter for 3-1 3 @ 120° Tenon Adapter for 3-1 4 @ 90° Tenon Adapter for 3-1	t [EPA 0.38] for 2S/3S for 4S for 2F/3F for 4F !" O.D. Tenon 1/2" O.D. Tenon	MA1015-XX=2 @ 120° Ten MA1016-XX=3 @ 90° Tenc MA1017-XX=Single Tenon MA1018-XX=2 @ 180° Ten MA1019-XX=3 @ 120° Ten MA1045-XX=4 @ 90° Tenc MA1048-XX=2 @ 90° Tenc MA1049-XX=3 @ 90° Tenc OA/RA1016=NEMA Type F OA/RA1027=NEMA Type F	n Adapter for 3-1/2" O.D. Te Adapter for 2-3/8" O.D. Ten on Adapter for 2-3/8" O.D. To on Adapter for 2-3/8" O.D. To on Adapter for 2-3/8" O.D. Te on Adapter for 2-3/8" O.D. Te	non on enon enon non non

### NOTES:

- 1. Customer is responsible for engineering analysis to confirm pole and fixture compatibility for all applications. Refer to our white paper WP513001EN for additional support information.

  2. 8 Inch Arm and pole adapter included with fixture. Specify Less Arm "LA" option when mounting accessory is ordered separately.

- Requires reduced envelope lamp.
   Consult an Eaton representative for lamp/ballast type/voltage compatibility.
   Pulse start metal halide EISA compliant constant wattage autotransformer (CWA) ballasts are available in 250, 320 and 400 watts.
- 6. Must specify voltage.
- Quartz options not available with SL optics.
   House side shield not available on 5S, 5F, or SL optics.

- 9. Replace XX with color specification.
  10. Not available with SL Optic or House Side Shield.



# **City of Madison Fire Department**

314 W Dayton Street, Madison, WI 53703-2506

Phone: 608-266-4420 • Fax: 608-267-1100 • E-mail: fire@cityofmadison.com

<b>Project Address:</b>	5110 High Crossing Blvd.
Contact Name &	Phone #: Greg Held 608-836-3690

### FIRE APPARATUS ACCESS AND FIRE HYDRANT WORKSHEET

<ol> <li>Is the building completely protected by an NFPA 13 or 13R automatic fire sprinkler system?         If non-sprinklered, fire lanes extend to within 150-feet of all portions of the exterior wall?         If sprinklered, fire lanes are within 250-feet of all portions of the exterior wall?     </li> </ol>	X Yes Yes X Yes	☐ No ☐ No ☐ No	<ul><li>N/A</li><li>N/A</li><li>N/A</li></ul>
<ul> <li>2. Is the fire lane constructed of concrete or asphalt, designed to support a minimum load of 85,000 lbs? <ul> <li>a) Is the fire lane a minimum unobstructed width of at least 20-feet?</li> <li>b) Is the fire lane unobstructed with a vertical clearance of at least 13½-feet?</li> <li>c) Is the minimum inside turning radius of the fire lane at least 28-feet?</li> <li>d) Is the grade of the fire lane not more than a slope of 8%?</li> <li>e) Is the fire lane posted as fire lane? (Provide detail of signage.)</li> <li>f) Is a roll-able curb used as part of the fire lane? (Provide detail of curb.)</li> <li>g) Is part of a sidewalk used as part of the required fire lane? (Must support +85,000 lbs.)</li> </ul> </li> </ul>		No   No   No   No   No   No   No   No	N/A   N/A   N/A   N/A   N/A   N/A   N/A   N/A
<ul><li>3. Is the fire lane obstructed by security gates or barricades? If yes:</li><li>a) Is the gate a minimum of 20-feet clear opening?</li><li>b) Is an approved means of emergency operations installed, key vault, padlock or key switch?</li></ul>	Yes Yes Yes	X No No No	<ul><li>N/A</li><li>N/A</li><li>N/A</li><li>N/A</li></ul>
4. Is the Fire lane dead-ended with a length greater than 150-feet?  If yes, does the area for turning around fire apparatus comply with IFC D103?	X Yes X Yes	☐ No ☐ No	<ul><li>□ N/A</li><li>□ N/A</li></ul>
5. Is any portion of the building to be used for high-piled storage in accordance with IFC Chapter 3206.6 If yes, see IFC 3206.6 for further requirements.	Yes	X No	□ N/A
6. Is any part of the building greater than 30-feet above the grade plane?	X Yes	☐ No	N/A
<ul> <li>6. Is any part of the building greater than 30-feet above the grade plane?</li> <li>If yes, answer the following questions:</li> <li>a) Is the aerial apparatus fire lane parallel to one entire side of the building and covering at least 25% of the perimeter?</li> <li>b) Is the near edge of the aerial apparatus fire lane between 15' and 30' from the building?</li> <li>c) Are there any overhead power or utility lines located across the aerial apparatus fire lane?</li> <li>d) Are there any tree canopies expected to grow across the aerial fire lane? (Based on mature canopy width of tree species)</li> </ul>	X Yes	□ No	<ul> <li>N/A</li> <li>N/A</li> <li>N/A</li> <li>N/A</li> <li>N/A</li> </ul>
If yes, answer the following questions:  a) Is the aerial apparatus fire lane parallel to one entire side of the building and covering at least 25% of the perimeter?  b) Is the near edge of the aerial apparatus fire lane between 15' and 30' from the building?  c) Are there any overhead power or utility lines located across the aerial apparatus fire lane?  d) Are there any tree canopies expected to grow across the aerial fire lane? (Based on mature	X Yes Yes Yes	□ No ⊠ No ⊠ No	□ N/A □ N/A □ N/A
If yes, answer the following questions:  a) Is the aerial apparatus fire lane parallel to one entire side of the building and covering at least 25% of the perimeter?  b) Is the near edge of the aerial apparatus fire lane between 15' and 30' from the building?  c) Are there any overhead power or utility lines located across the aerial apparatus fire lane?  d) Are there any tree canopies expected to grow across the aerial fire lane? (Based on mature canopy width of tree species)  e) Does the aerial apparatus fire lane have a minimum unobstructed width of 26-feet?  f) Is the space between the aerial lane and the building free of trees exceeding 20' in heights?		☐ No ☑ No ☑ No ☑ No ☑ No ☑ No ☐ No ☐ No	<ul> <li>N/A</li> <li>N/A</li> <li>N/A</li> <li>N/A</li> <li>N/A</li> <li>N/A</li> <li>N/A</li> </ul>
If yes, answer the following questions:  a) Is the aerial apparatus fire lane parallel to one entire side of the building and covering at least 25% of the perimeter?  b) Is the near edge of the aerial apparatus fire lane between 15' and 30' from the building?  c) Are there any overhead power or utility lines located across the aerial apparatus fire lane?  d) Are there any tree canopies expected to grow across the aerial fire lane? (Based on mature canopy width of tree species)  e) Does the aerial apparatus fire lane have a minimum unobstructed width of 26-feet?		□ No ☑ No ☑ No ☑ No ☑ No	<ul> <li>N/A</li> <li>N/A</li> <li>N/A</li> <li>N/A</li> <li>N/A</li> </ul>

Attach an additional sheet if further explanation is required for any answers.

This worksheet is based on MGO 34.503 and IFC 2015 Edition Chapter 5 and Appendix D; please see the codes for further information.