# CocoVaa CHOCOLATIER

# 1813 E WASHINGTON AVE MADISON, WISCONSIN


CONTACTS

PROJECT INFO

GRAPHIC SYMBOLS

**ABBREVIATIONS** 

@       AT       LLH       LONG LEG HORIZONTAL         A.B.       ANCHOR BOLT       LLV       LONG LEG VERTICAL         A/C       AIR CONDITIONER       LS##       LAZY SUSAN         ACCESS.       ACCESSIBLE       LVP       LUXURY VINYL PLANK         ACT       ACOUSTICAL CEILING TILE       LVT       LUXURY VINYL TILE         ADJ.       ADJACENT       MATL.       MATERIAL         ADJ.       ADJUSTABLE ROD AND SHELF       MAX.       MAXIMUM         A.F.F.       ABOVE FINISH FLOOR       MC       MEDICINE CABINET         AL       ALUMINUM       MECH.       MECHANICAL         ALT.       ALTERNATE       MFR.       MANUFACTURER('S)         ALUM.       ALUMINUM       MH.       MANHOLE         APPROX.       APPROXIMATE       MIN.       MINIMUM         B##       BASE CABINET       M.O.       MASONRY OPENING         BD.       BOARD       MOD.       MODULE         BIT.       BITUMINOUS       M.R.       MODULE         BIT.       BITUMINOUS       M.T.       METAL         BRG.       BEARING       N.I.C.       NOT IN CONTRACT         CAB.       CABINET       N.T.S.       NOT TO SCALE <th>NORTH ARROW  X  A-X.X  X  INTERIOR ELEVATIONS  DETAIL CALLOUT  SECTION CUT</th> <th>PROJECT: #1832 ADDRESS: 1813 E WASHINGTON AVE., MADISON, WI WORK DESCRIPTION: TENANT SPACE BUILDOUT  APPLICABLE CODES AND STANDARDS: SPS 361-366 WISCONSIN COMMERCIAL BUILDING CODE INTERNATIONAL BUILDING CODE (IBC) 2015 ICC/ANSI A117.1-2009  BUILDING TYPE IA TENANT BUILDOUT AREA - 1,365 SQ.FT.</th> <th>ARCHITECT: Knothe &amp; Bruce Architects, LLC 7601 University Avenue, Suite 201 Middleton, WI 53562 Contact: Kevin Burow Phone: (608) 836-3690 E-mail: kburow@knothebruce.com</th> <th>ARCHITECTURAL T-I.I TITLE SHEET  A-I.I FIRST FLOOR PLAN A-4.I WALL TYPES, GENERAL NOTES, DOOR SCHEDULE A-6.I INTERIOR ELEVATIONS, ACCESSIBILITY REQUIREMENTS  A-8.I DEVICE PLACEMENT PLAN</th>	NORTH ARROW  X  A-X.X  X  INTERIOR ELEVATIONS  DETAIL CALLOUT  SECTION CUT	PROJECT: #1832 ADDRESS: 1813 E WASHINGTON AVE., MADISON, WI WORK DESCRIPTION: TENANT SPACE BUILDOUT  APPLICABLE CODES AND STANDARDS: SPS 361-366 WISCONSIN COMMERCIAL BUILDING CODE INTERNATIONAL BUILDING CODE (IBC) 2015 ICC/ANSI A117.1-2009  BUILDING TYPE IA TENANT BUILDOUT AREA - 1,365 SQ.FT.	ARCHITECT: Knothe & Bruce Architects, LLC 7601 University Avenue, Suite 201 Middleton, WI 53562 Contact: Kevin Burow Phone: (608) 836-3690 E-mail: kburow@knothebruce.com	ARCHITECTURAL T-I.I TITLE SHEET  A-I.I FIRST FLOOR PLAN A-4.I WALL TYPES, GENERAL NOTES, DOOR SCHEDULE A-6.I INTERIOR ELEVATIONS, ACCESSIBILITY REQUIREMENTS  A-8.I DEVICE PLACEMENT PLAN
COMN. COMMUNICATION P.C. PRECAST CONCRETE CONT. CONTINUOUS P.D.F. POWER DRIVEN FASTENER CORR. CORRIDOR PLBG. PLUMBING CPT CARPET P.T. PRESSURE TREATED CT CERAMIC TILE PLWD. PLYWOOD D DRYER PSF POUNDS PER SQUARE FOOT DB## DRAWER BASE CABINET PSI POUNDS PER SQUARE INCH D.F. DRINKING FOUNTAIN Q.T. QUARRY TILE DIA. DIAMETER ##R NUMBER OF STAIR RISERS DIM. DIMENSION R.D. ROOF DRAIN DN DOWN REINF. REINFORCING OR REINFORCED D.S. DOWN SPOUT REM. REMOVABLE D.T. DRAIN TILE REQ'D. REQUIRED DW DISHWASER R.O. ROUGH OPENING EA. EACH	EXTERIOR ELEVATION  COLUMN REFERENCE GRID		TENANT SPACE	
ELEC. ELECTRIC ELEV. ELEVATION OR ELEVATOR EJ EXPANSION JOINT EQ. EQUAL E.W.C. ELECTRIC WATER COOLER EXIST. EXISTING EXPANSION EXT. EXPANSION EXT. EXPANSION EXT. EXTERIOR F.E. FIRE EXTINGUISHER FEC FIRE EXTINGUISHER CABINET F.D. FLOOR DRAIN  SOUND SOLID CORE WOOD SOLID	WALL TYPE  (0000) DOOR TAG			
FIN. FINISHED  FLR. FLOOR  FNDN. FOUNDATION  F.O.C. FACE OF CONCRETE  F.O.M. FACE OF MASONRY  F.O.S. FACE OF STUD  F.R.P. FIBERGLASS REINFORCED PANEL  F.T. FOOT OR FEET  F.G. FOOTING  GA. GAUGE  G.C. GENERAL CONTRACTOR  F.C. S. FINISHED  S.V. SHEET VINYL FLOORING  ##T NUMBER OF STAIR TREADS  TOP AND BOTTOM  TASE  TOP AND BOTTOM  TASE  TOP OF BEAM  TRAFFIC BEARING MEMBRANE  T.O.A. TOP OF COLUMN  TOP OF CMU  TOP OF FOOTING  T.O.F. TOP OF FOOTING  GA. GAUGE  G.C. GENERAL CONTRACTOR  T.O.P. TOP OF PIER  T.O.W. TOP OF WALL	X WINDOW TAG  ALX WDX ALUM. / WOOD WINDOW TAG			
G.W.B. GYPSUM WALL BOARD GYP. GYPSUM H.B. HOSE BIB HCW HOLLOW CORE WOOD HGT. HEIGHT HOM. HOLLOW METAL HORZ. HORIZONTAL HCW HOUR HRAT. HOUR HRAT. HEATING HYP. TYPICAL UNEXC. UNEXCAVATED U.N.O. UNLESS NOTED OTHERWISE WANITY BASE CABINET VCT VINYL COMPOSITION TILE WERT. VERTICAL HTG. HEATING HVAC HEATING/VENTILATION/AIR CONDITIONING WWC VINYL WALL COVERING HVAC INTERNATIONAL BUILDING CODE W## WALL CABINET WCC## WALL CORNER CABINET	REVISION CLOUD & TAG	TOTAL STATE OF THE PROPERTY OF		
INC INTERNATIONAL MECHANICAL CODE  INC INTERNATIONAL MECHANICAL CODE  INSUL. INSULATION  INT. INTERIOR  INV. INVERT  JT. JOINT  LAV. LAVATORY  WP WATERPROOF  WT WEIGHT  W.W.F. WIRE WELDED FABRIC	EXTERIAL FINISH MATERIAL TAG			

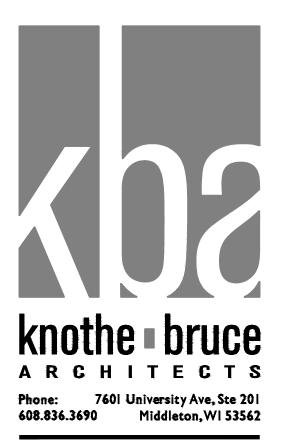

ISSUED

SHEET INDEX

Issued for Permitting - July 6, 2018

PROJECT TITLE

CocoVaa

at The Marling

East Washington Ave. Madison, Wisconsin

SHEET TITLE
TITLE SHEET

SHEET NUMBER

T-1.1

PROJECT NO.

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- **GENERAL NOTES:** . SALES AND RETAIL AREA TO HAVE PRESSED TIN CEILING TILES IN SUSPENDED ALUMINUM GRID AT 17' A.F.F.
- KITCHEN AREA TO HAVE VINYL-FACED GYPSUM TILES IN SUSPENDED ALUMINUM GRID AT 14' A.F.F.
- TOILET ROOM, JANITOR'S CLOSET, DISH ROOM AND COLD STORAGE TO HAVE GYPSUM BOARD CEILING AT 9'-0" A.F.F. 4. ALL FLOORS TO BE POLISHED CONCRETE
- FINISH EXCEPT TOILET ROOM TO HAVE CERAMIC TILE FLOORING KITCHEN, COLD STORAGE, DISH ROOM &
- JANITOR CLOSET WALLS TO BE EPOXY PAINTED 6. AIR BRUSH ROOM TO HAVE 6'-0" HIGH
- STAINLESS STEEL WALL PANELS ON THE 3 INTERIOR WALLS (NOT AT THE DOORWAY)
- 7. INSTALL VINYL BASE IN ALL AREAS EXCEPT THE RETAIL AND SALES AREA

8. INSTALL WOOD BASE IN RETAIL AND SALES

- **ELECTRICAL NOTES:**
- PROVIDE NEW ELECTRICAL SERVICE AND LOCATE PANEL IN KITCHEN PER PLAN LIGHTING IN KITCHEN TO BE RECESSED CAN LIGHTS AND PENDANTS SELECTED BY
- LIGHTING IN RETAIL AND SALES TO BE PENDANTS SELECTED BY OWNER LIGHTING IN COLD STORAGE, JANITOR'S CLOSET AND DISH ROOM TO BE LED
- SURFACE MOUNT DISC LIGHTS PROVIDE (3) RETRACTABLE DROP DOWN POWER CONNECTIONS ABOVE KITCHEN ISLANDS PER PLAN
- PROVIDE POWER FEED TO SIGNAGE ON FACE OF BUILDING/CANOPY -
- COORDINATE LOCATION WITH LANDLORD SEE A-8.1 FOR DEVICE PLACEMENT LAYOUT
- PROVIDE WATER FEED FOR ICE MAKER

PLUMBING NOTES:

REQUIRED

**HVAC NOTES:** COOLING EQUIPMENT FOR COLD STORAGE ROOM IS SUPPLIED BY OWNER

PROVIDE HOT AND COLD WATER AND A

OWNER TO SUPPLY HAND WASH SINK IN KITCHEN AND SINK IN DISH ROOM - ALL

COORDINATE WITH HVAC CONTRACTOR

ON ANY WATER OR DRAIN CONNECTIONS


DRAIN LINE TO ALL SINK LOCATIONS

OTHER FIXTURES BY CONTRACTOR

PROVIDE OPEN SITE DRAIN LINE AT


LOCATIONS INDICATED ON PLAN

- LOCATE NEW HVAC EQUIPMENT ABOVE THE TOILET ROOM AND JANITOR'S CLOSET AREA ON CEILING DECK AREA COORDINATE CONDENSER UNIT
- LOCATIONS WITH LANDLORD PROVIDE CONDENSATE HOOD OVER
- DISHWASHER IN DISH ROOM INSTALL EXHAUST HOOD (SUPPLIED BY OWNER) IN AIR BRUSH ROOM

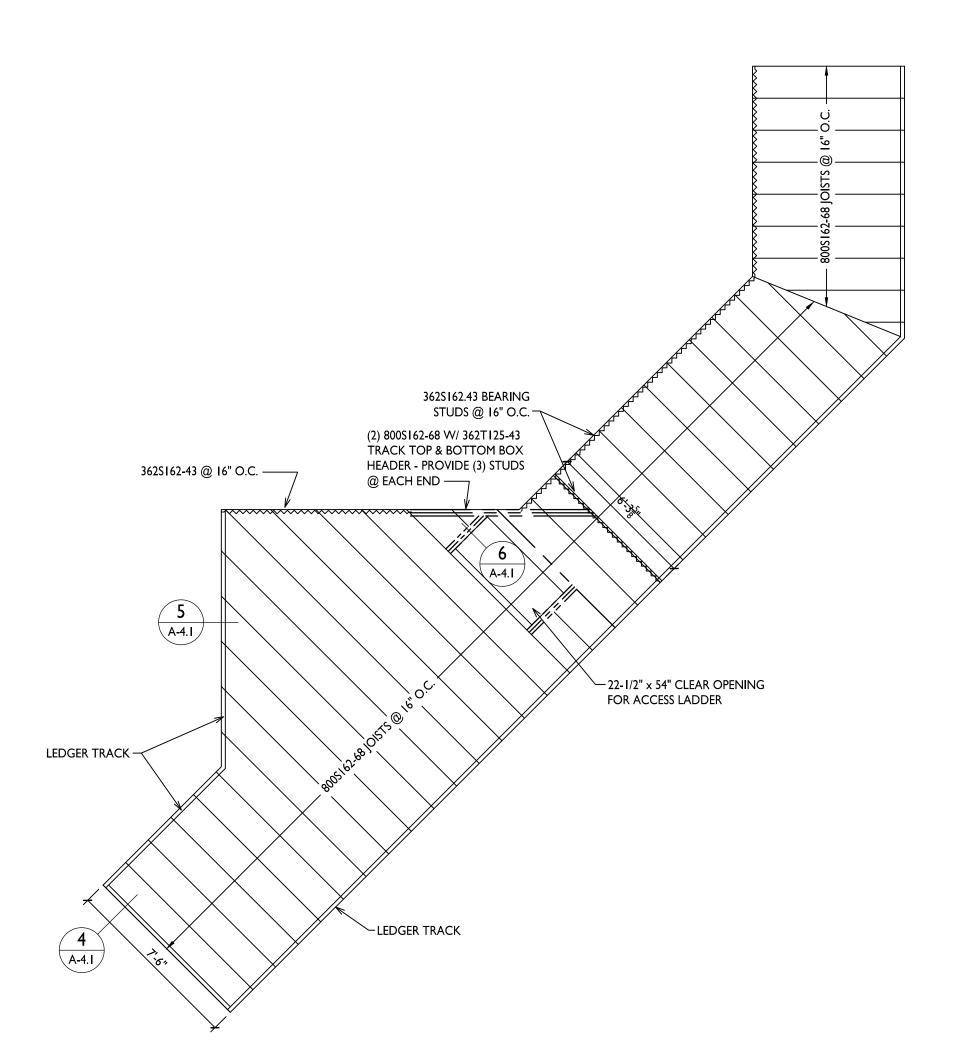






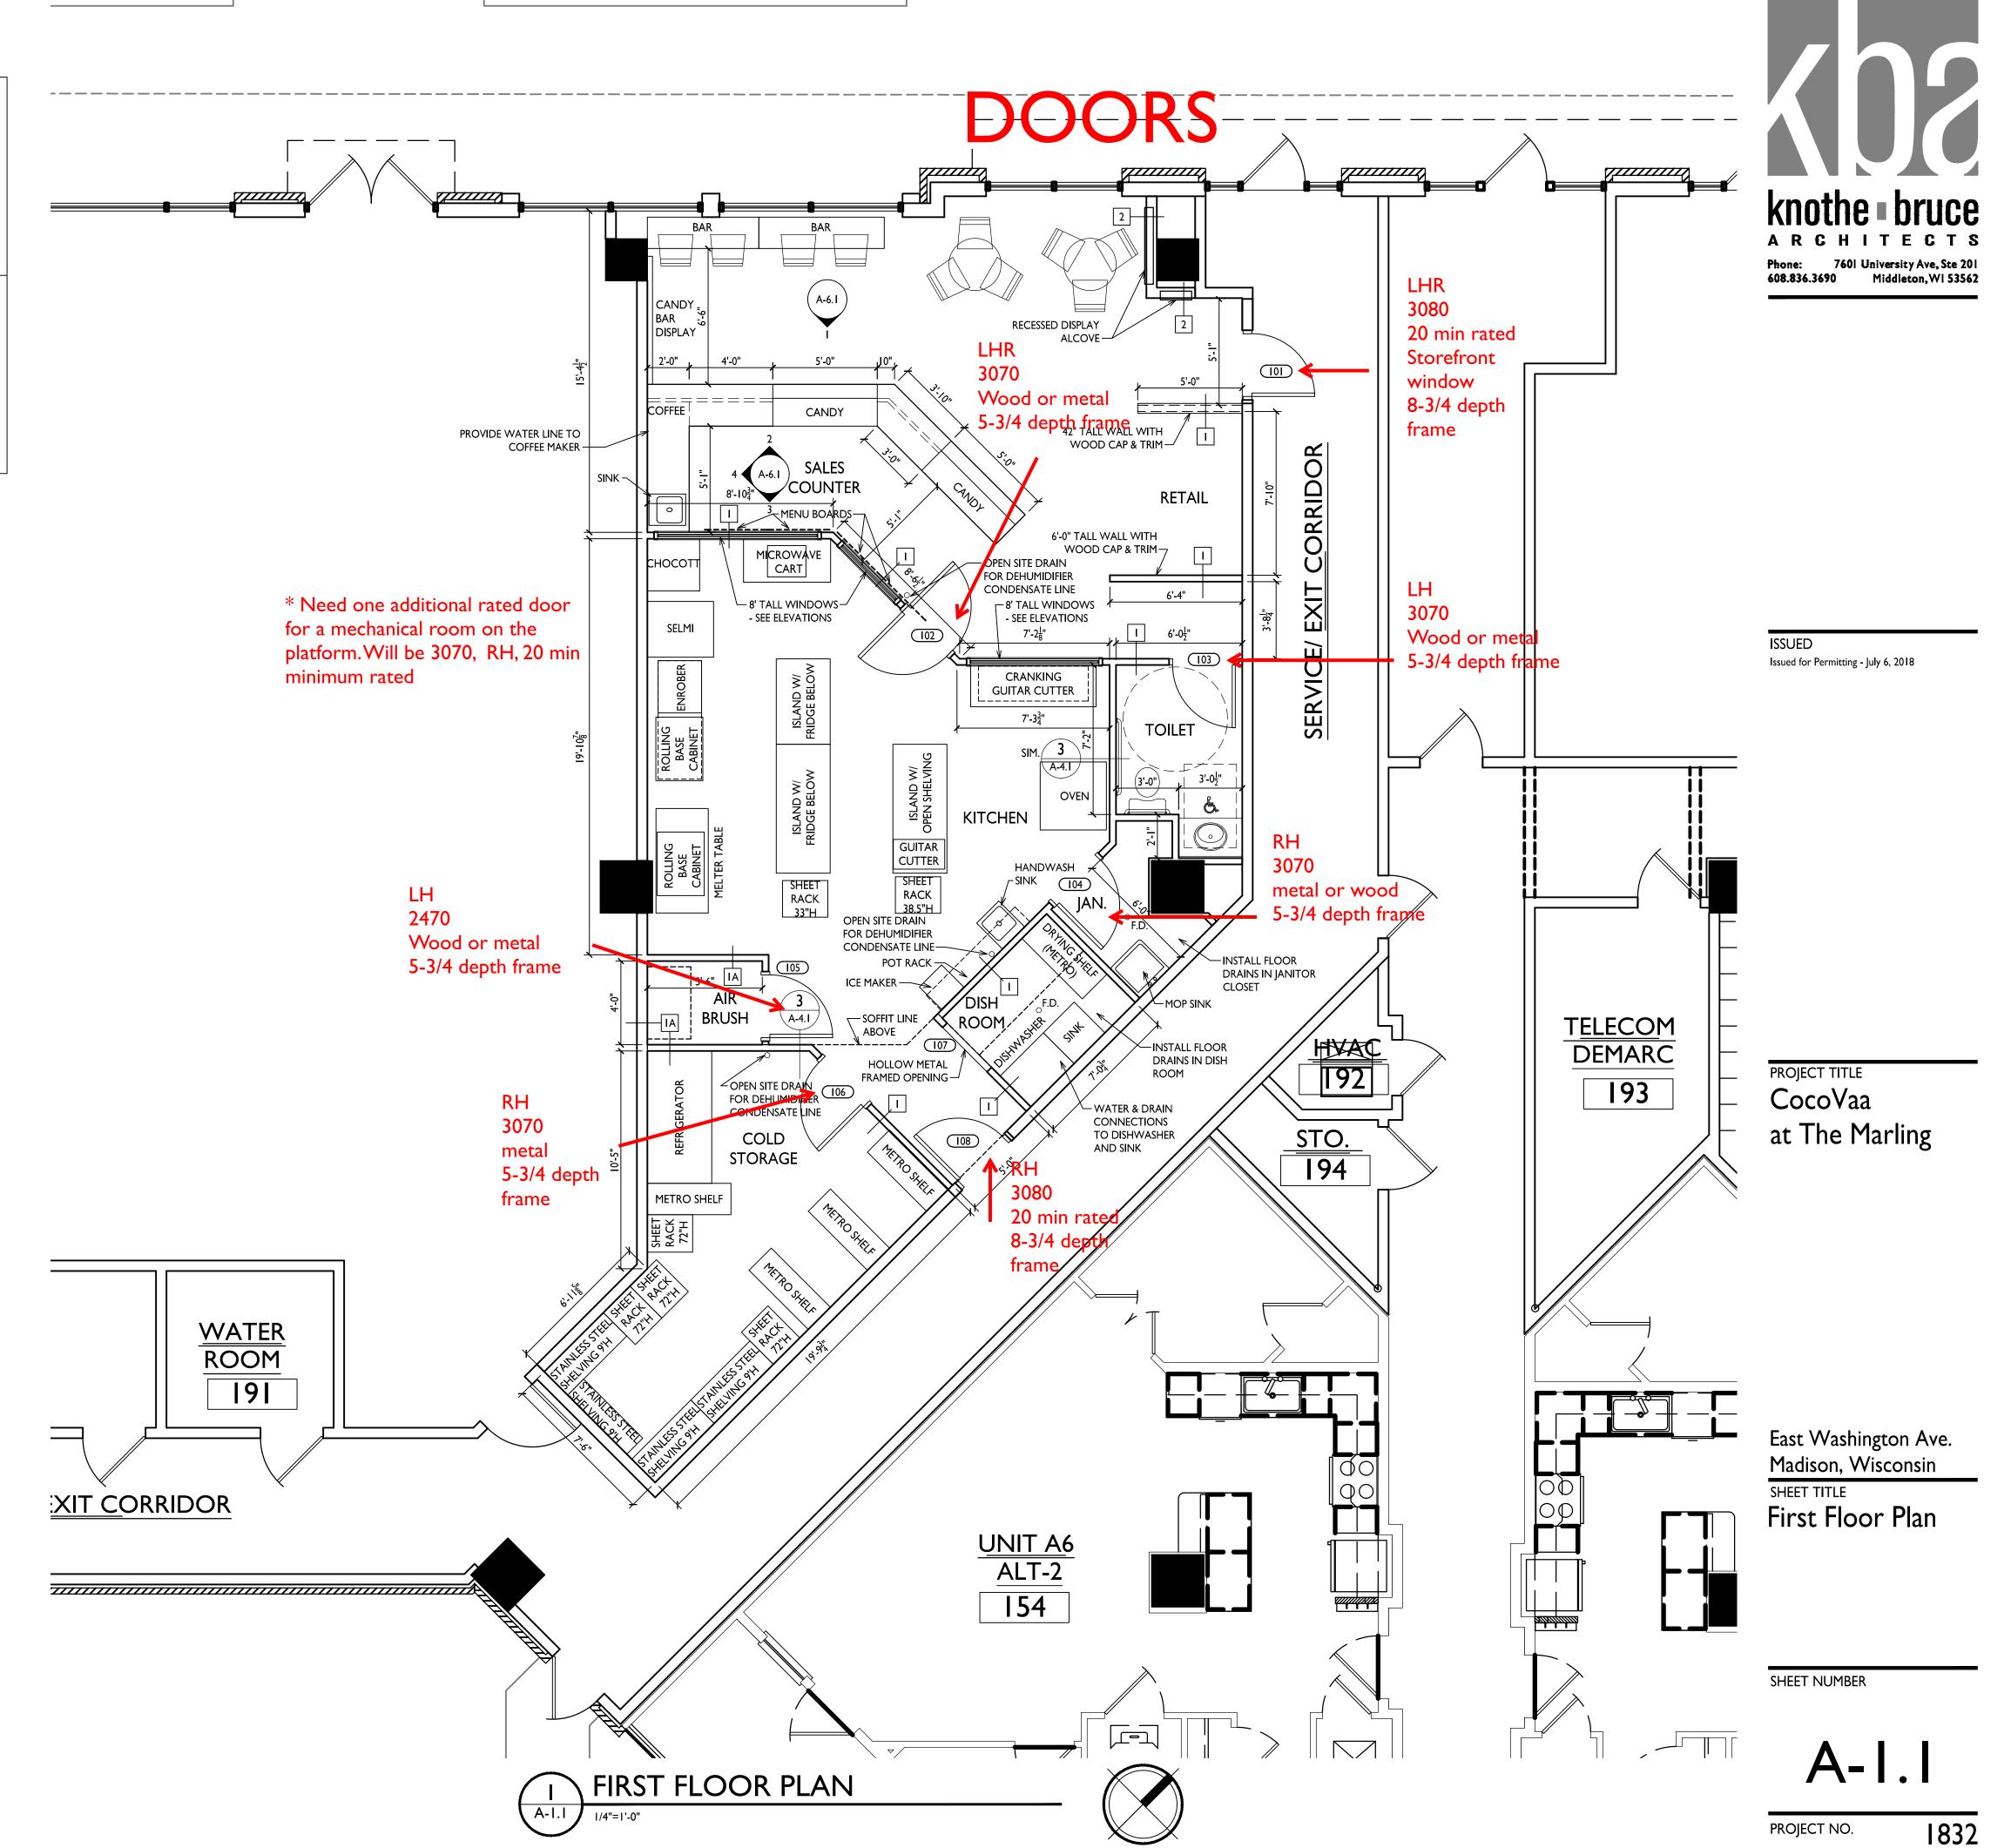

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 $\Diamond$ 

	DOOR SCHEDULE											
		DOOR			FRA	ME						
MARK X		SI	ŽE		D005		FRAME	RATING				
U.N.O.	LOCATION	WIDTH	HEIGHT	MATERIAL	DOOR ELEVATION	MATERIAL	ELEVATION ("A" U.N.O.)		NOTES			
101	ENTRY	3'-0"	7'-0"	AL	B	AL						
102	KITCHEN	3'-0"	7'-0"	AL	В	ÀL	В		DUAL-SWING DOOR			
103	TOILET ROOM	3'-0"	7'-0"	SCW	Α	HM						
104	JANITOR	3-0"	7'-0"	SCW	Α	HM						
105	AIR BRUSH	3'-0"	7'-0"	HM	Α	HM						
106	COLD STORAGE	3'-0"	7'-0"	IM	Α	HM						
107	DISHES	3'-0"	7'-0"	NONE		HM			FLUSH HOLLOW METAL FRAME ONLY			
108	SERVICE	3'-0"	7'-0"	HM	Α	HM						

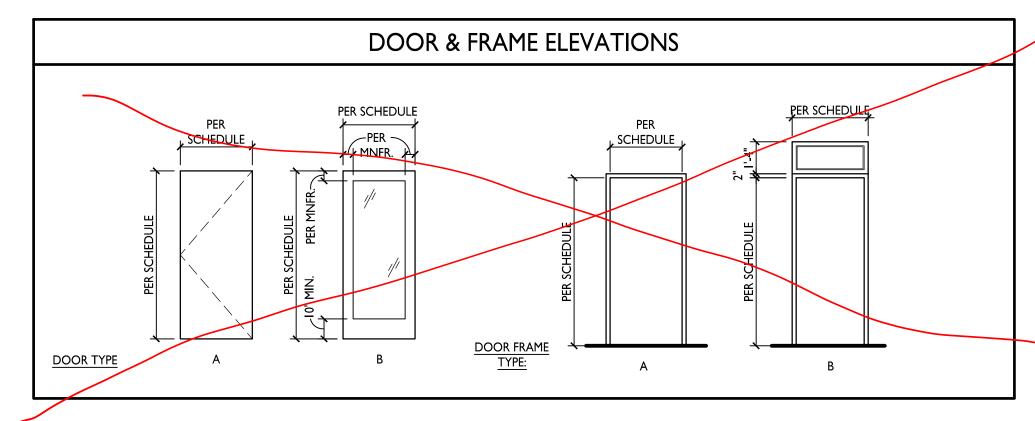

## DOOR SCHEDULE GENERAL NOTES

- ALL RATED DOORS TO BE PART OF A LISTED SYSTEM, INCLUDING: DOOR, FRAME, GLAZING, CLOSER & HARDWARE.
- S LABELED DOORS TO MEET REQUIREMENTS FOR A SMOKE AND DRAFT CONTROL DOOR PER UL 1784 WITH AN ARTIFICIAL BOTTOM SEAL INSTALLED ACROSS THE FULL WIDTH OF THE DOOR ASSEMBLY (IBC SECTION 715.4.3.1)
- ARTIFICIAL BOTTOM SEAL INSTALLED ACROSS THE FULL WIDTH OF THE DOOR ASSEMBLY (IBC SECTION 715.4

   INTERIOR SWINGING DOORS SHALL HAVE 3/4" MAX. UNDERCUT, OR LESS IF REQUIRED BY NFPA 80.
- PROVIDE TEMPERED SAFETY GLAZING AT ALL WINDOWS/DOOR GLAZING WITHIN 24" OF FLOOR AND ANY WINDOW/ SIDELIGHT ADJACENT TO DOORS.

DOOR SCHEDULE ABBREVIATIONS: AL - ALUMINUM

HM - HOLLOW METAL
IM - INSULATED METAL
KD - KNOCK DOWN FRAME
SCW - SOLID CORE WOOD
HCW - HOLLOW CORE WOOD
ACW - ALUMINUM CLAD WOOD
WD - WOOD
FG - FIBERGLASS

### GENERAL SECTION / DETAIL NOTES:

- I. PLAN DIMENSIONS ARE TO FACE OF FRAMING/CMU/CONCRETE, CENTERLINE OF STRUCTURAL COLUMNS, AND CENTERLINE OF WINDOW/DOOR OPENINGS.
- 2. BOXES IN DEMISING WALLS AND CEILINGS SHALL HAVE THEIR ANNULAR SPACE SEALED WITH ACOUSTIC SEALANT.
- 3. FLEXIBLE DUCTS AND AIR CONNECTORS SHALL NOT PASS THRU ANY RATED ASSEMBLY.
- 4. BATT INSULATION THICKNESS SHALL BE EQUAL TO DEPTH OF STUD CAVITY, U.N.O.
- 5. ALL RESILIENT CHANNEL SHALL BE "RC DELUXE" BY DIETRICH INDUSTRIES . RESILIENT CHANNEL ON WALLS SHALL BE INSTALLED OPEN SIDE UP. FASTEN GYPSUM BOARD TO CHANNEL WITH MAX. I" LONG SCREWS.
- 6. INSTALL ACOUSTIC SEALANT AT JOINT BETWEEN WALL AND CEILING GYPSUM BOARD AT ALL DEMISING WALLS.
- DESIGN HEAD OF PARTITION CONNECTIONS TO ACCOMMODATE DEFLECTION OF BUILDING STRUCTURE.

-EXISTING DEMISING WALL


TREATED PLYWOOD DECK

<sup>∠</sup> 800\$162-68 JOISTS @ 16" O.C.


—(2) #12 SCREWS

STUD FRAMING

---- 3/4" FIRE RETARDANT

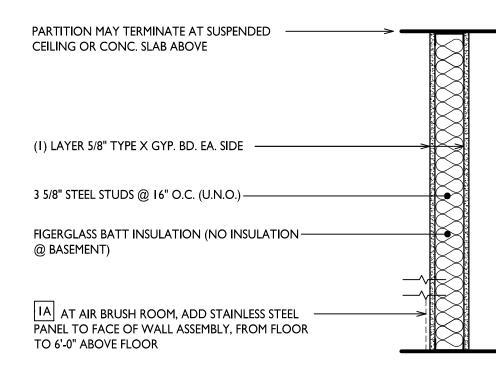




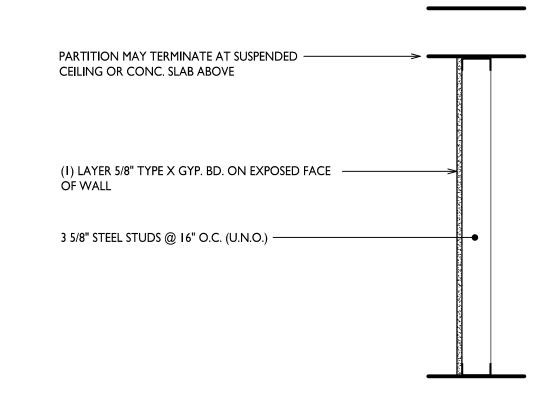


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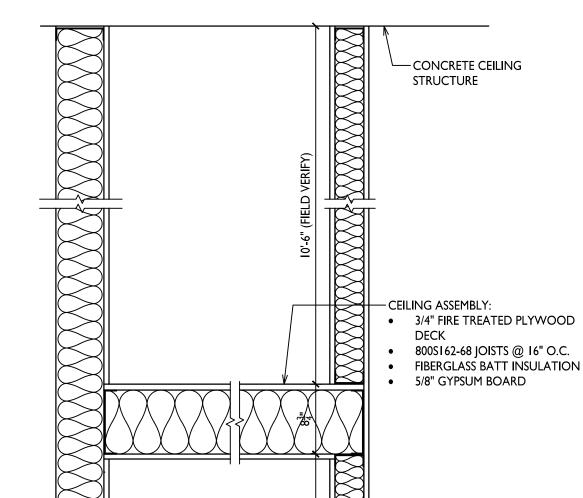
608.836.3690 Middleton, WI 53562

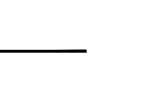

WALL TYPE: 2
UNRATED STEEL STUD FURRING WALL

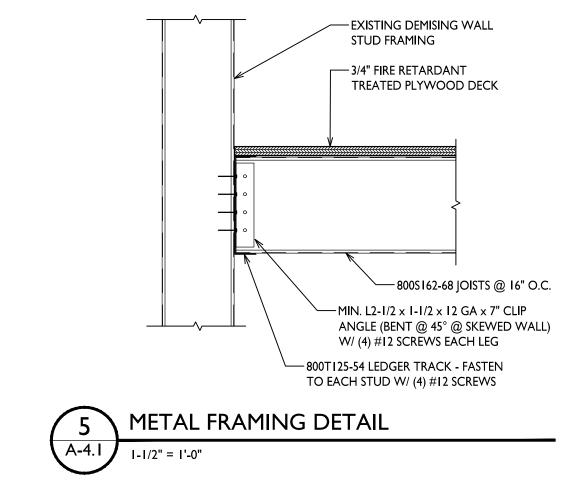

METAL FRAMING DETAIL



PROJECT TITLE

CocoVaa

at The Marling

BEARING WALL ASSEMBLY:

5/8" GYPSUM BOARD

BEARING WALL ASSEMBLY:

5/8" GYPSUM BOARD EACH FACE

362S162-43 STEEL STUD FRAMING

(@ 16" O.C.

FIBERGLASS BATT INSULATION

FIBERGLASS BATT INSULATION

TO SHELL STUD DEMISING

WALL, INSULATION AND

GYPSUM BOARD BY

LANDLORD

—CONCRETE FLOOR

STRUCTURE

East Washington Ave.
Madison, Wisconsin


Wall Types,
General Notes,
Door Schedule

SHEET NUMBER

A-4.1

PROJECT NO

SECTION AT COLD STORAGE

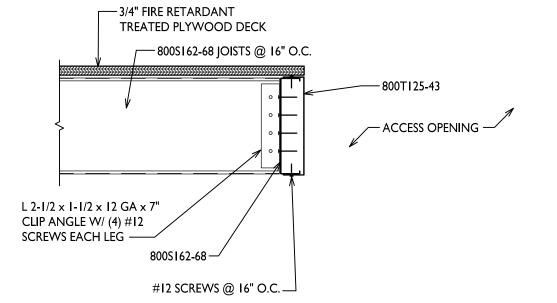

6 METAL FRAMING DETAIL

A-4.1 I-1/2" = 1'-0"

PROJECT NO. 1832
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#### **GENERAL NOTES:**

- I. "CLEAR FLOOR SPACE" = A 30" X 48" AREA FOR WHEELCHAIR ACCESS, U.N.O.
- 2. "ICC/ANSI" = REFERS TO THE AMERICAN NATIONAL STANDARD: ACCESSIBLE AND USABLE BUILDING AND FACILITIES, ICC/ANSI ATT. I-2003; PUBLISHED BY THE INTERNATIONAL CODE


#### ACCESSIBLE ROUTE NOTES:

- I. ROUTE HAS 1:20 RUNNING SLOPE MAX. / 1:50 CROSS SLOPE MAX.
- 2. ROUTE IS STABLE FIRM AND SLIP RESISTANT.
- 3. VARIATIONS IN FLOOR FINISH ARE 1/2" OR LESS. MAXIMUM 1/4" VERTICAL CHANGES IN LEVEL. CHANGES IN LEVEL BETWEEN 1/4" AND 1/2" MAX. SHALL BE BEVELED WITH SLOPE OF 1:2 MAX.
- 4. OPENINGS IN FLOOR OR GROUND DO NOT LET 1/2" DIA. SPHERE PASS AND ARE PERPENDICULAR TO PATH OF TRAVEL.
- 5. OBJECTS PROTRUDING INTO THE PATH OF TRAVEL WITH THEIR LEADING EDGES GREATER THAN 27" AND LESS THAN 80" AFF SHALL PROJECT 4" MAX. INTO THE CIRCULATION PATH.
- 6. ALL DOORS INTENDED FOR PASSAGE TO HAVE CLEAR OPENING OF 32".


#### ACCESSIBILITY NOTES:

#### <u>GENERAL:</u>


- I. ALL DOORS TO HAVE LEVER TYPE HARDWARE.
- 2. ACCESSIBLE ROUTE CONNECTS ALL SPACES AND ELEMENTS (SEE REQUIREMENTS ABOVE).
- 3. ALL DOORS, INCLUDING BOTH LEAVES OF DOUBLE LEAF DOORS SHALL HAVE ALL OPERATING HARDWARE BETWEEN 34" & 48" A.F.F.
- 4. ALL PUBLIC USE DOORS TO HAVE 80" MINIMUM CLEAR HEADROOM.
- 5. MAXIMUM THRESHOLD / CHANGE IN FLOOR ELEVATION IS 1/2" (SEE DETAIL HCI). STOOPS AT HANDICAP ACCESSIBLE ENTRY MAY SLOPE AWAY FROM BUILDING AT MAXIMUM OF 1/8" PER 1'-0".
- 6. LIGHT SWITCHES AND ENVIRONMENTAL CONTROLS MOUNTED AT 44" MAX. TO TOP ABOVE FINISH FLOOR. WALL OUTLETS MOUNTED AT 18" TO CENTER LINE ABOVE FINISH FLOOR.
- 7. DOOR CLOSERS SHALL BE ADJUSTED SO THAT DOOR TAKES 5 SECONDS MINIMUM TO CLOSE FROM AN OPEN POSITION OF 90 DEGREES TO AN OPEN POSITION OF 12 DEGREES.
- 8. THE INTERNATIONAL SYMBOL OF ACCESSIBILITY SHALL BE DISPLAYED AT ACCESSIBLE TOILET ROOMS. THE SIZE, STYLE, LOCATION, AND HEIGHT OF THE SYMBOL SHALL COMPLY WITH ICC/ANSI: 703.
- 9. BATHROOM TOILETS SHALL HAVE GRAB BARS INSTALLED AS PER DETAIL HC2.
- 10. PROVIDE ANTI-SCALD DEVICES ON ALL SINKS AND LAV FAUCETS. THERE SHALL BE NO SHARP OR ABRASIVE SURFACES UNDER SINKS AND LAVS. EXPOSED SUPPLY AND DRAIN PIPES UNDER LAVS TO BE INSULATED OR OTHERWISE CONFIGURED TO PROTECT AGAINST CONTACT.
- II. ACCESSIBLE TOILET SEAT HEIGHT TO BE 17"-19" ABOVE FINISH FLOOR.
- 12. CENTERLINE OF TOILET IS EXACTLY 18" FROM NEAREST SIDE WALL.
- 13. SINK MOUNTED AT 34" MAX. ABOVE FINISH FLOOR. 30" MIN. CLEAR WIDTH UNDER SINK WITH CLEARANCES PER HC4.BOTTOM OF MIRROR AT 40" MAX. AFF. TOP OF MIRROR 74" MIN. AFF.
- 14. OPERABLE PARTS ON TOWEL DISPENSERS / HAND DRYERS TO BE 48" MAX. AFF AND COMPLY W/ ICC/ANSI: 606.7.
- 15. FLUSH CONTROLS TO BE ON OPEN SIDE OF WATER CLOSET.
- 13. INSTALL TOILET PAPER DISPENSER ON SIDE WALL, 8" IN FRONT OF WATER CLOSET TO CENTER OF DISPENSER, AND 24" AFF TO CENTER OF OF DISPENSER.
- **DRINKING WATER:**
- 14. FILTERED AND/OR BOTTLED WATER TO BE AVAILABLE TO ALL CUSTOMERS SALES COUNTER:
- 15. EACH SERVICE COUNTER TO HAVE A 36" MIN. WIDE SECTION THAT IS 36" MAX. AFF FOR ACCESSIBLE SERVICE.

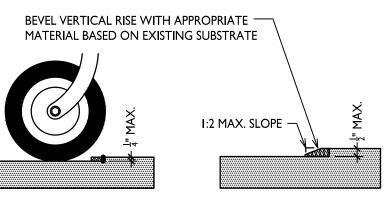



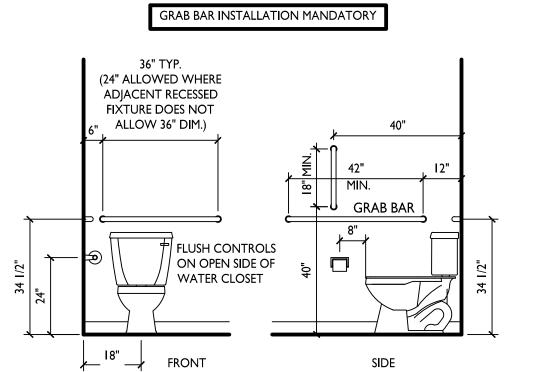


COMMON AREA TOILET ELEVATIONS

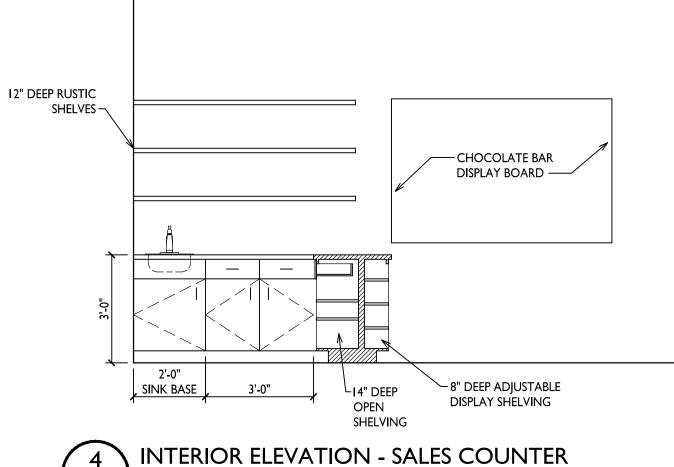


3/8" = I'-0"

— SUSPENDED "STAMPED TIN LOOK" CEILING SYSTEM

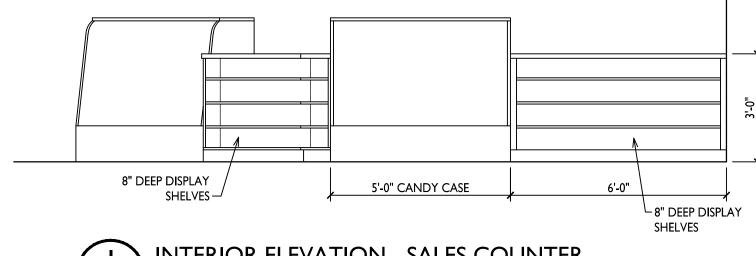





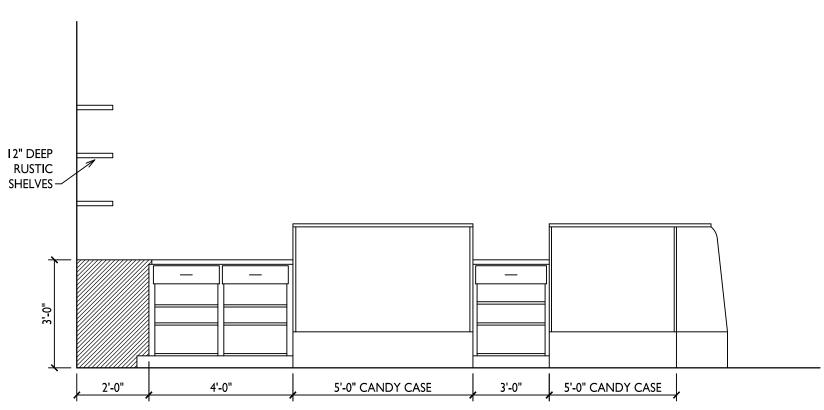



**INTERIOR ELEVATION - SALES COUNTER** 


3/8" = 1'-0"

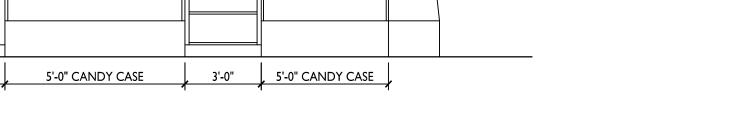

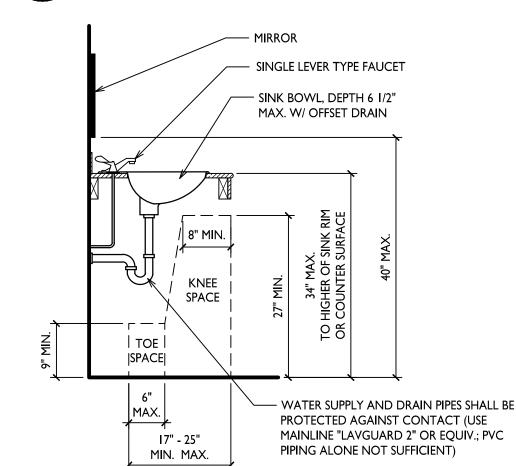

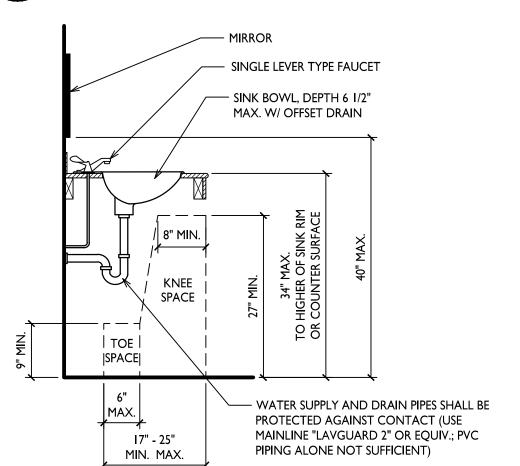

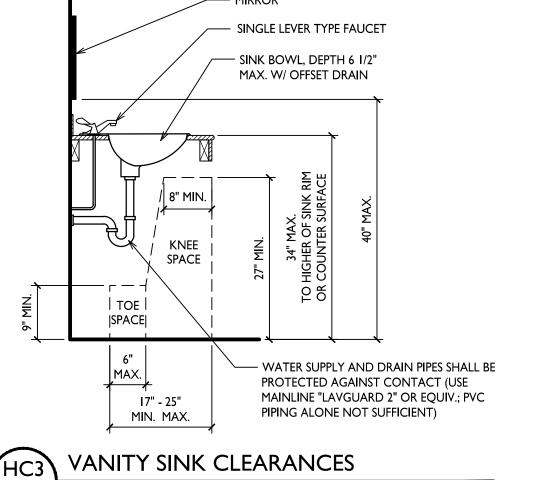

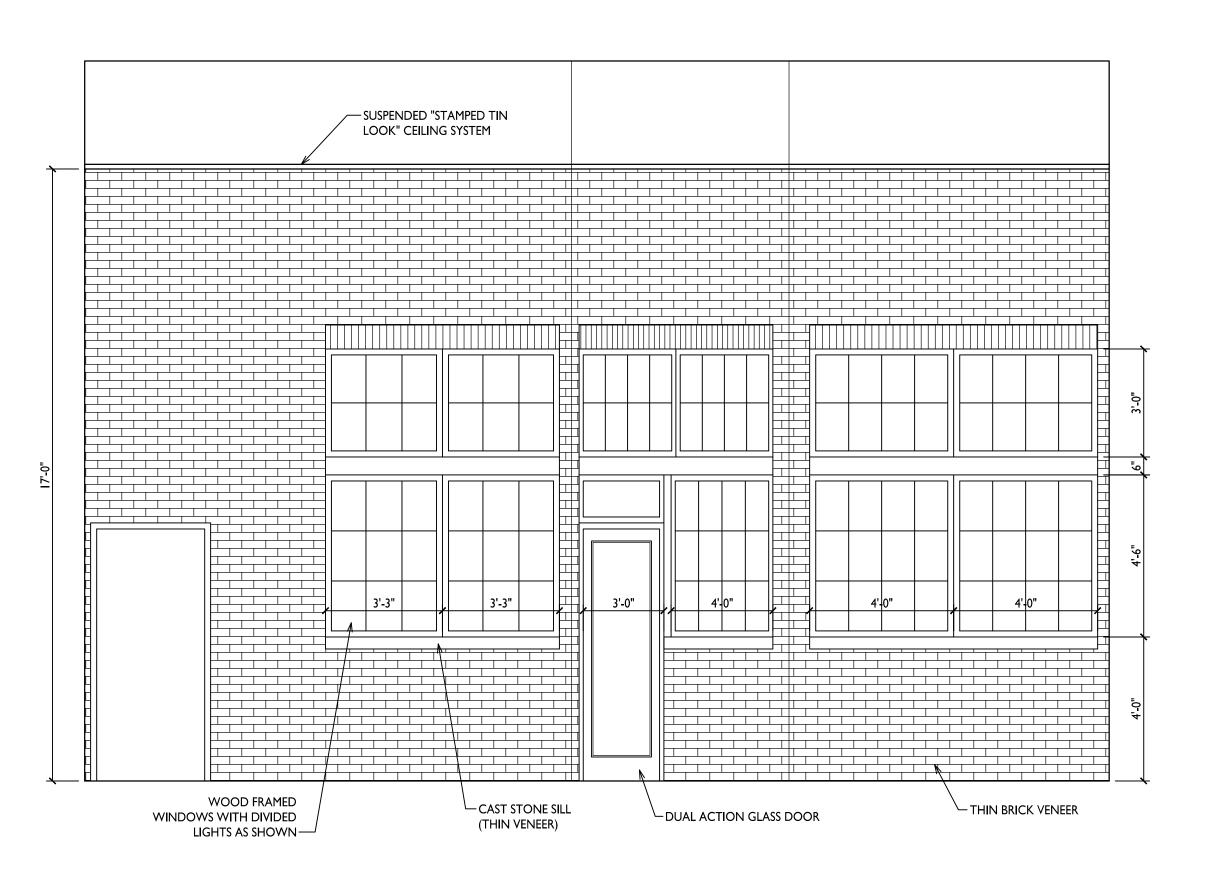

PROJECT TITLE CocoVaa at The Marling

Issued for Permitting - July 6, 2018

ARCHITECTS

Phone: 7601 University Ave, Ste 201 608.836.3690 Middleton, WI 53562

East Washington Ave. Madison, Wisconsin SHEET TITLE Interior Elevations, Accessibility

Requirements


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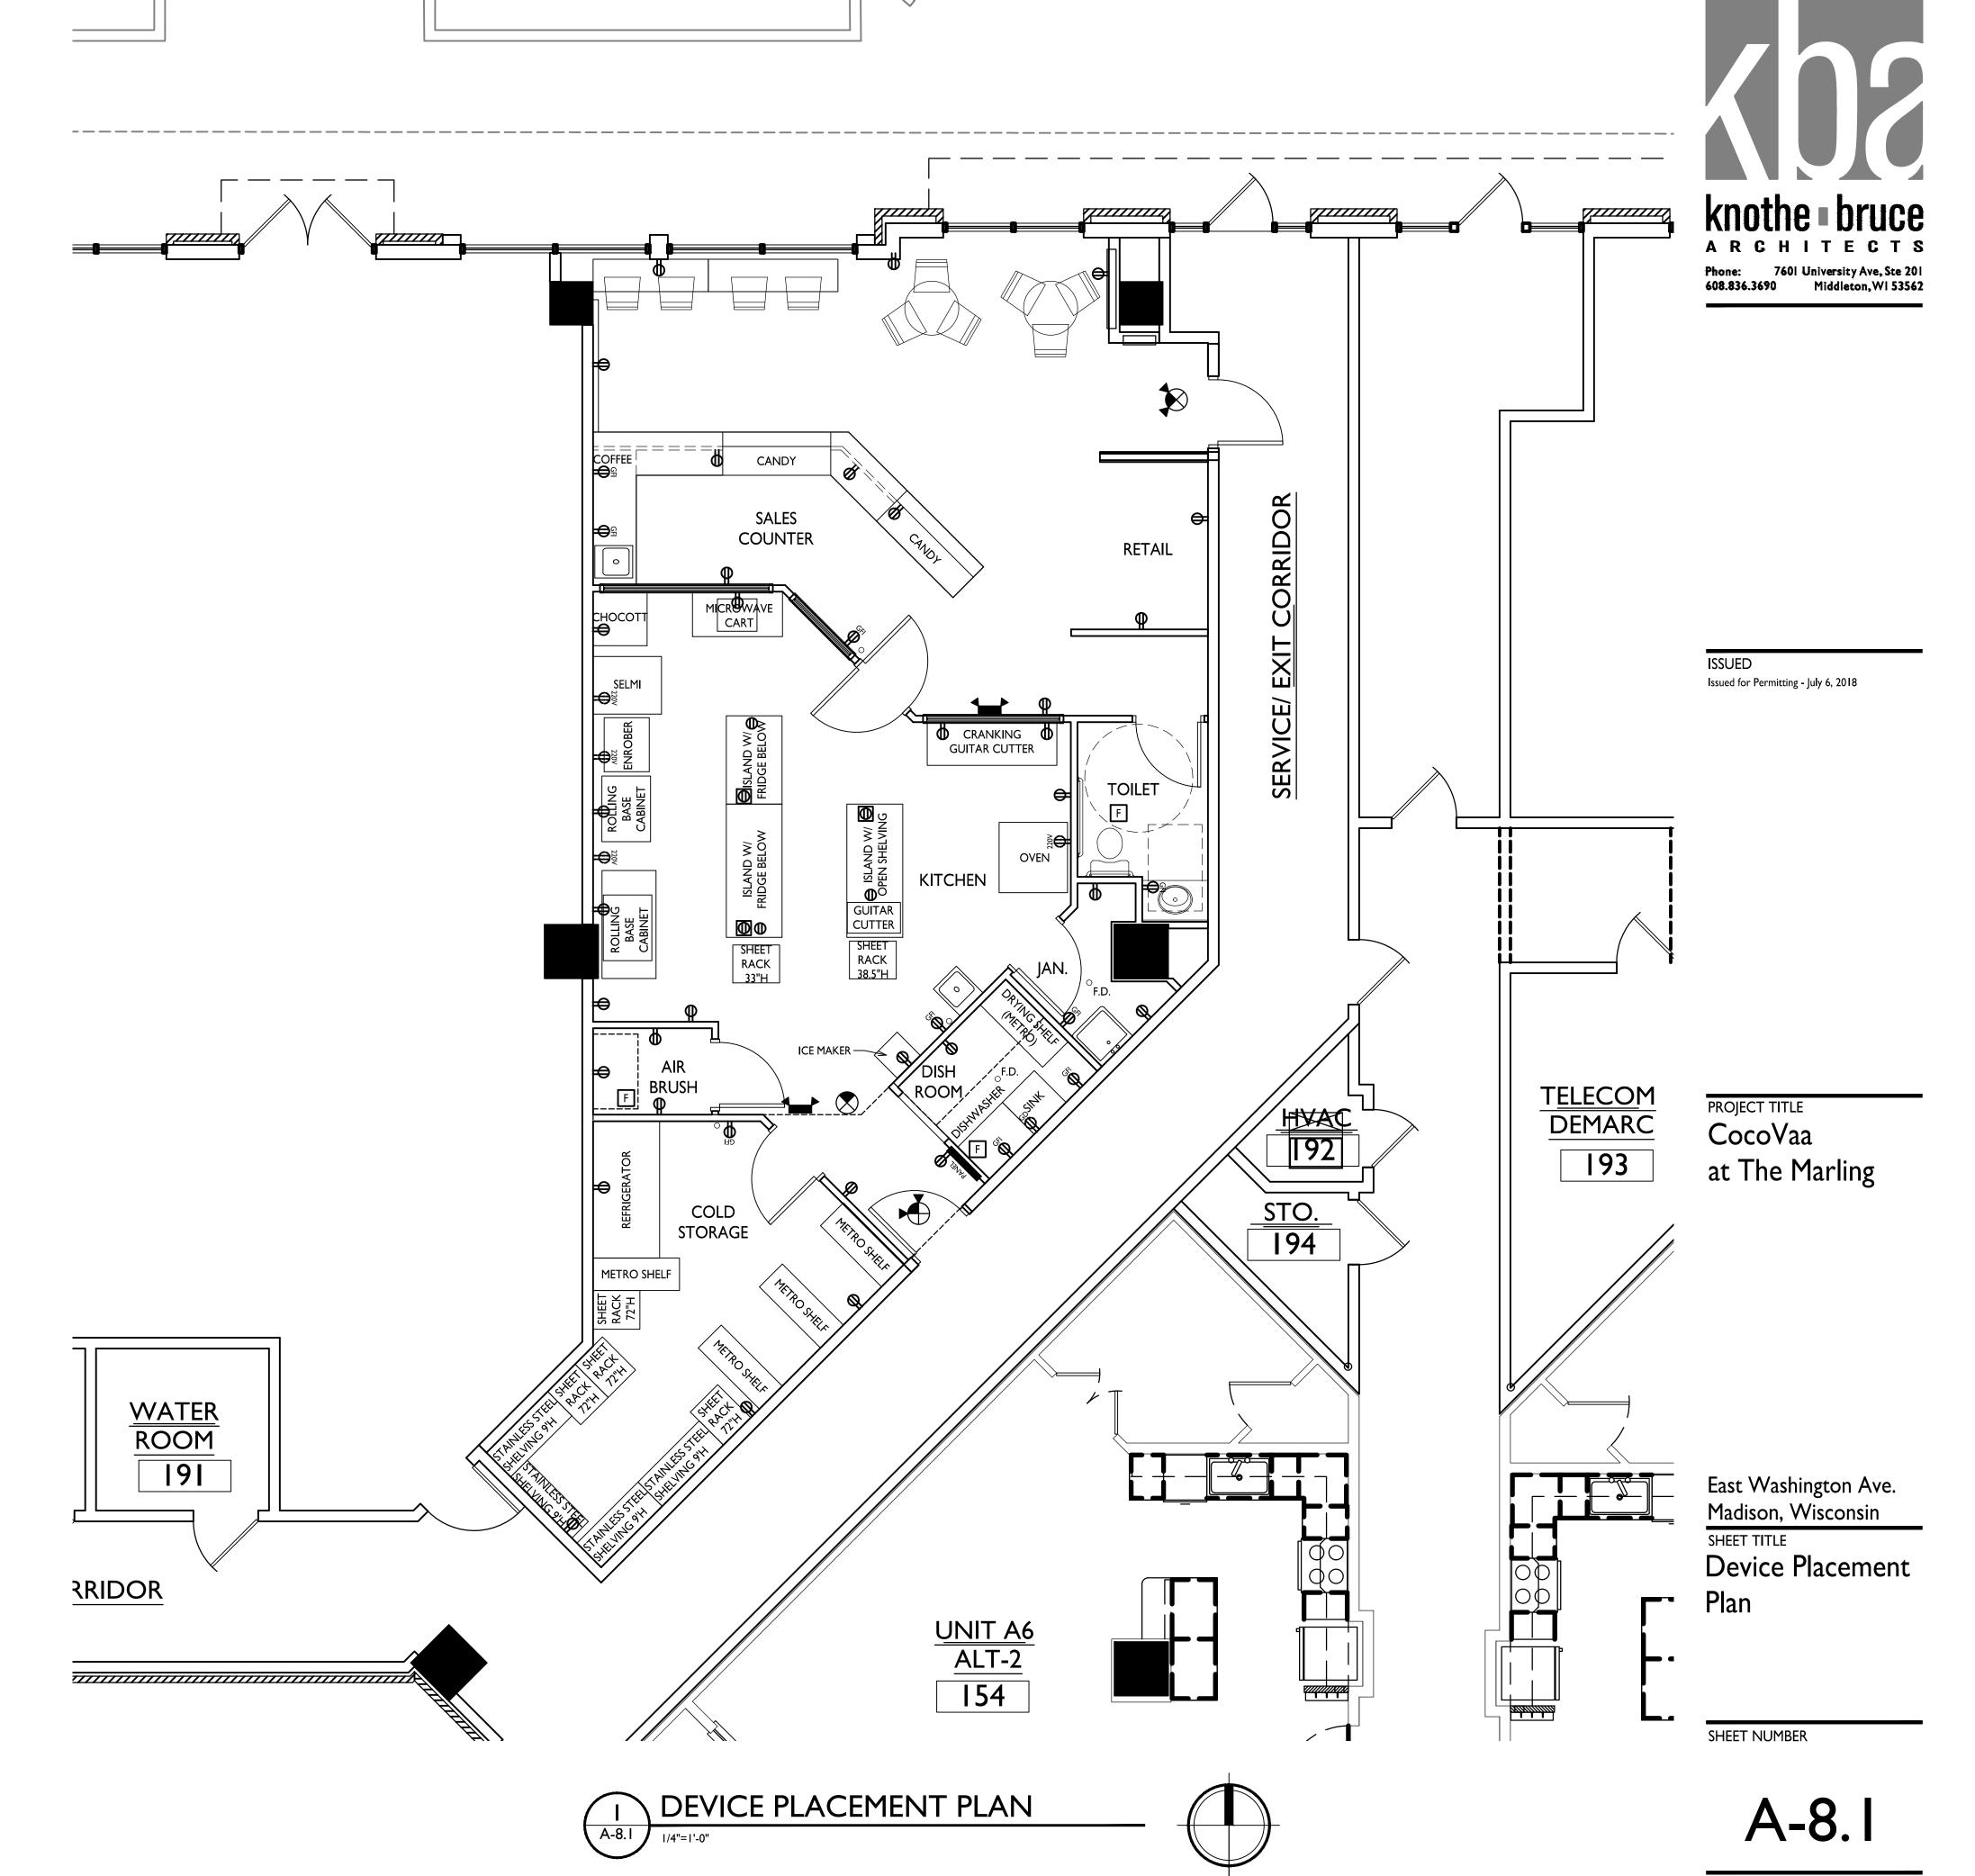
PROJECT NO.

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HC3 VANITY SINK CLEARANCES
A-6.1 N.T.S. FRONT APPROACH

> INTERIOR ELEVATION - KITCHEN WALL A-6. I 3/8" = 1'-0"



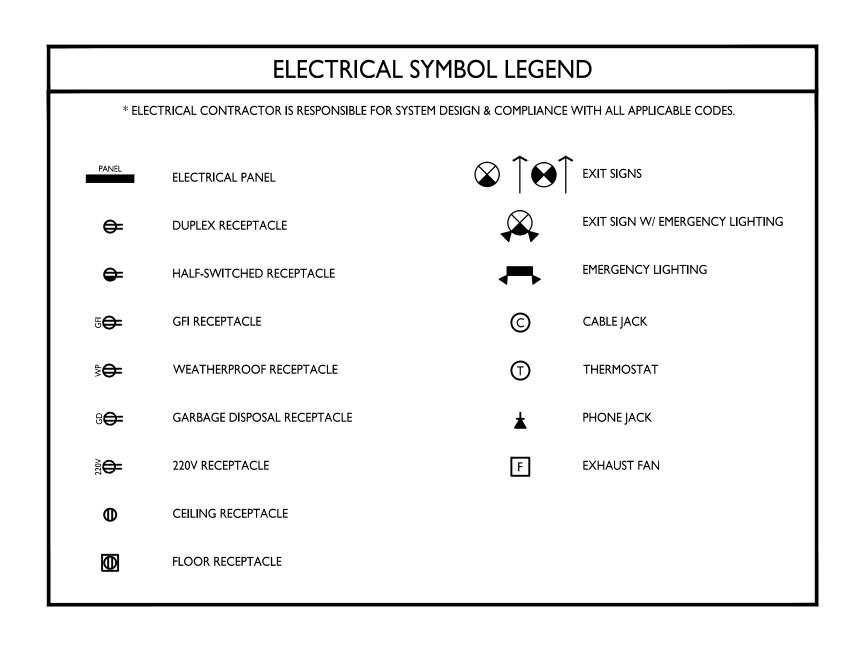

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1832