NOT FOR CONSTRUCTION




SCHEMATIC DESIGN Project No. 18VALO-00-01 Plot Date: 6/25/2019 8:57:53 AM Drawn by:

Sheet Title

EXTERIOR BUILDING ELEVATIONS

Sheet No.

A201

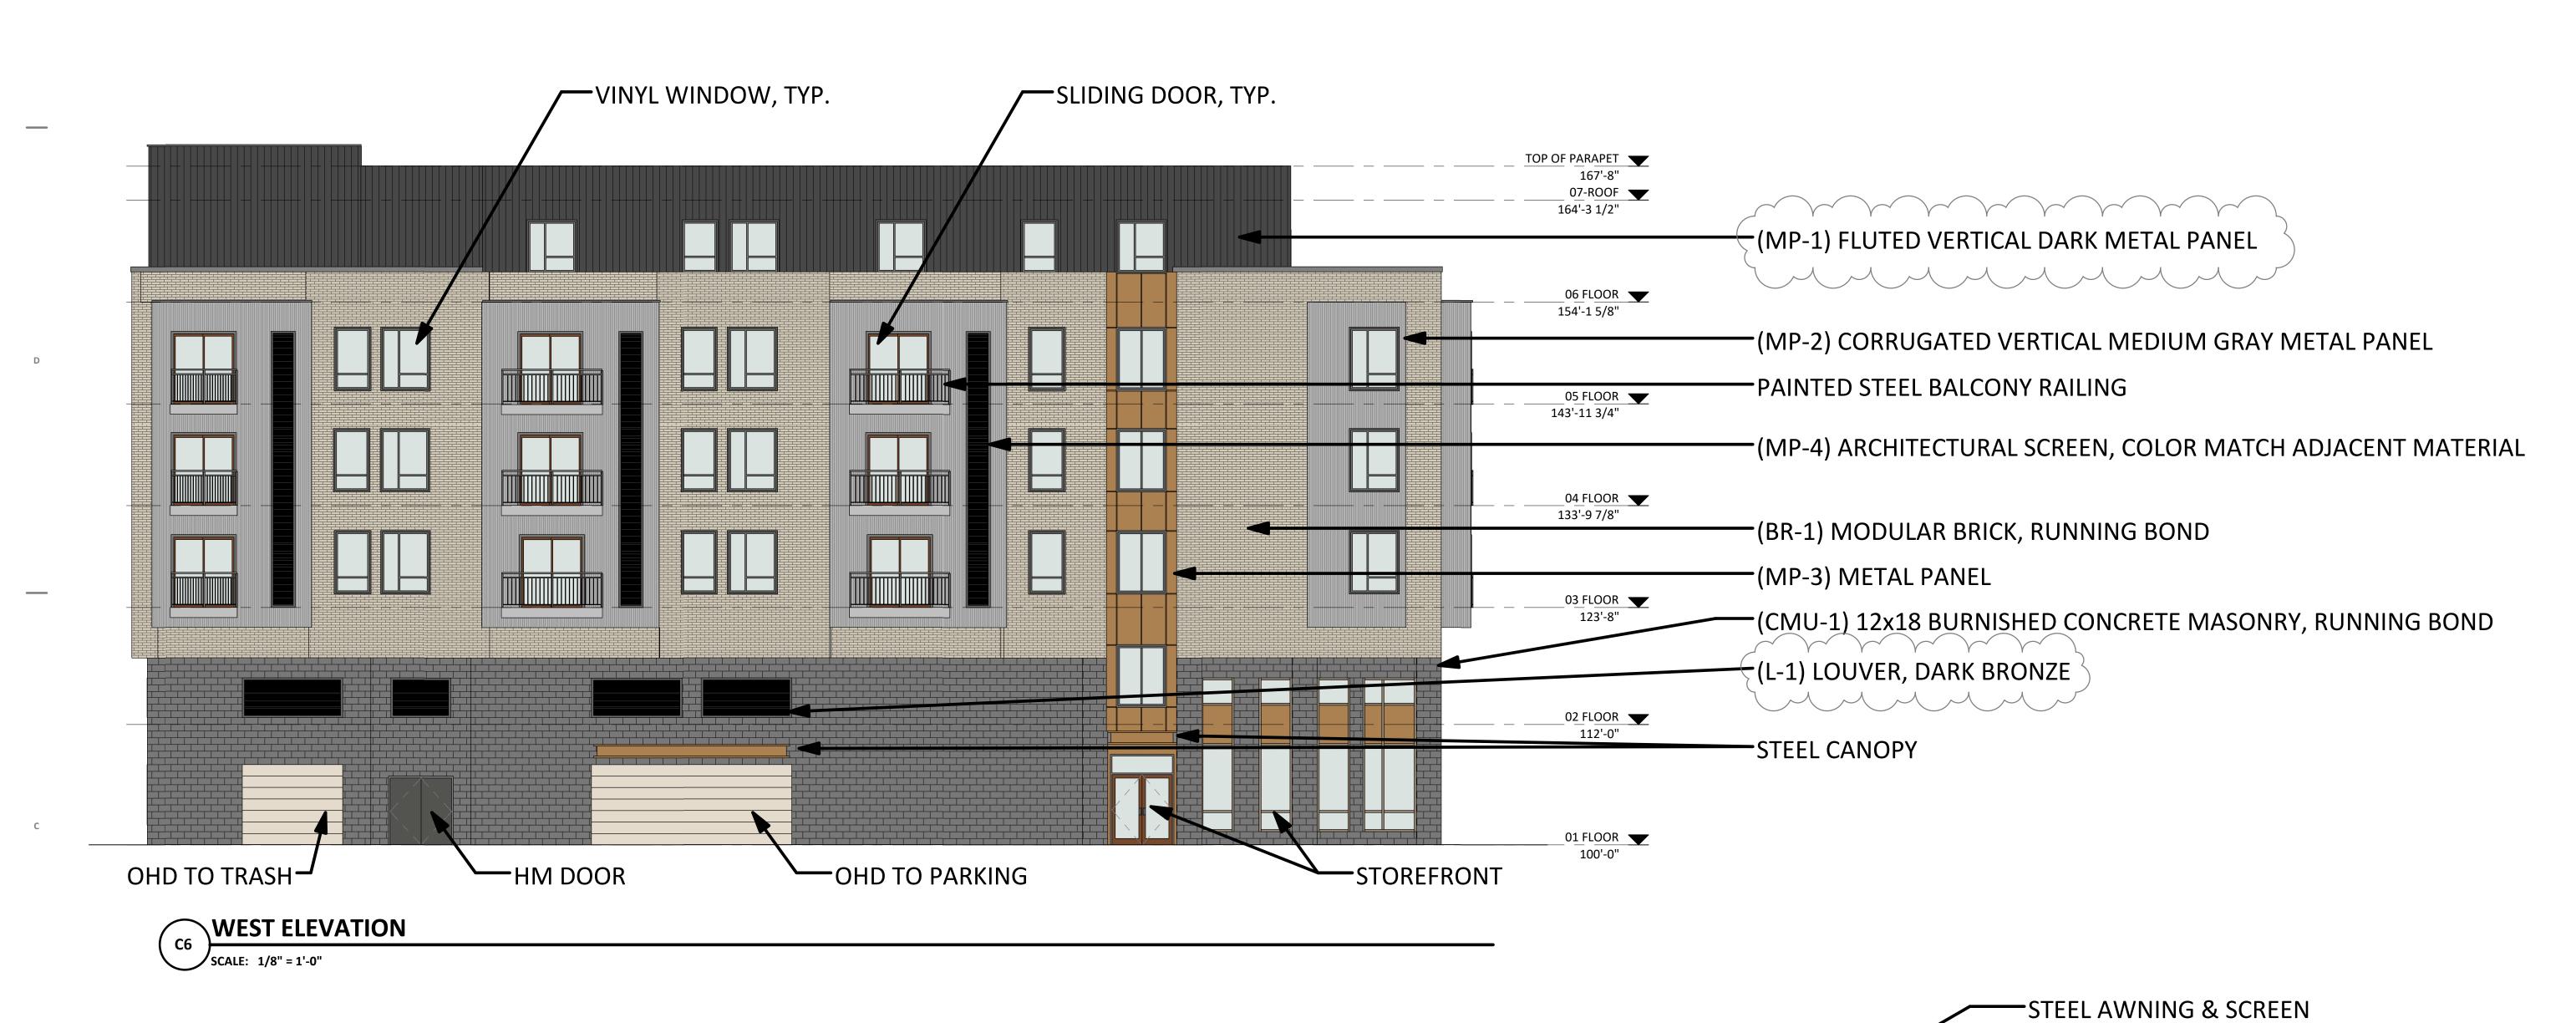

(MP-2) CORRUGATED VERTICAL MEDIUM GRAY METAL PANEL 06 FLOOR 154'-1 5/8" (MP-1) FLUTED VERTICAL DARK METAL PANEL PAINTED STEEL BALCONY RAILING 05 FLOOR 143'-11 3/4" (MP-4) ARCHITECTURAL SCREEN, COLOR MATCH ADJACENT MATERIAL (BR-1) MODULAR BRICK, RUNNING BOND 03 FLOOR 123'-8" (CMU-1) 12x18 BURNISHED CONCRETE MASONRY, RUNNING BOND (L-1) LOUVER, DARK BRONZE —STEEL CANOPY 01 FLOOR 100'-0" STOREFRONT OHD TO PARKING SOUTH ELEVATION


SCALE: 1/8" = 1'-0"

SCHEMATIC DESIGN

18VALO-00-01

6/25/2019 8:58:07 AM

Project No.

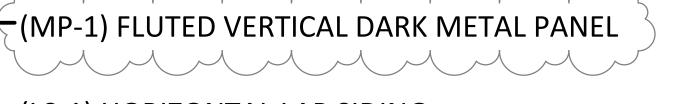

(LS-1) HORIZONTAL LAP SIDING

(MP-4) ARCHITECTURAL SCREEN, COLOR MATCH ADJACENT MATERIAL

(MP-2) CORRUGATED VERTICAL MEDIUM GRAY METAL PANEL

PAINTED STEEL BALCONY RAILING

(BR-1) MODULAR BRICK, RUNNING BOND

03 FLOOR 123'-8" (CMU-1) 12x18 BURNISHED CONCRETE MASONRY, RUNNING BOND


(BR-1) MODULAR BRICK, RUNNING BOND

(CMU-1) 12x18 CONCRETE MASONRY, RECESS BLOCK 1" MIN.,

RUNNING BOND

C6 EAST ELEVATION

SCALE: 1/8" = 1'-0"

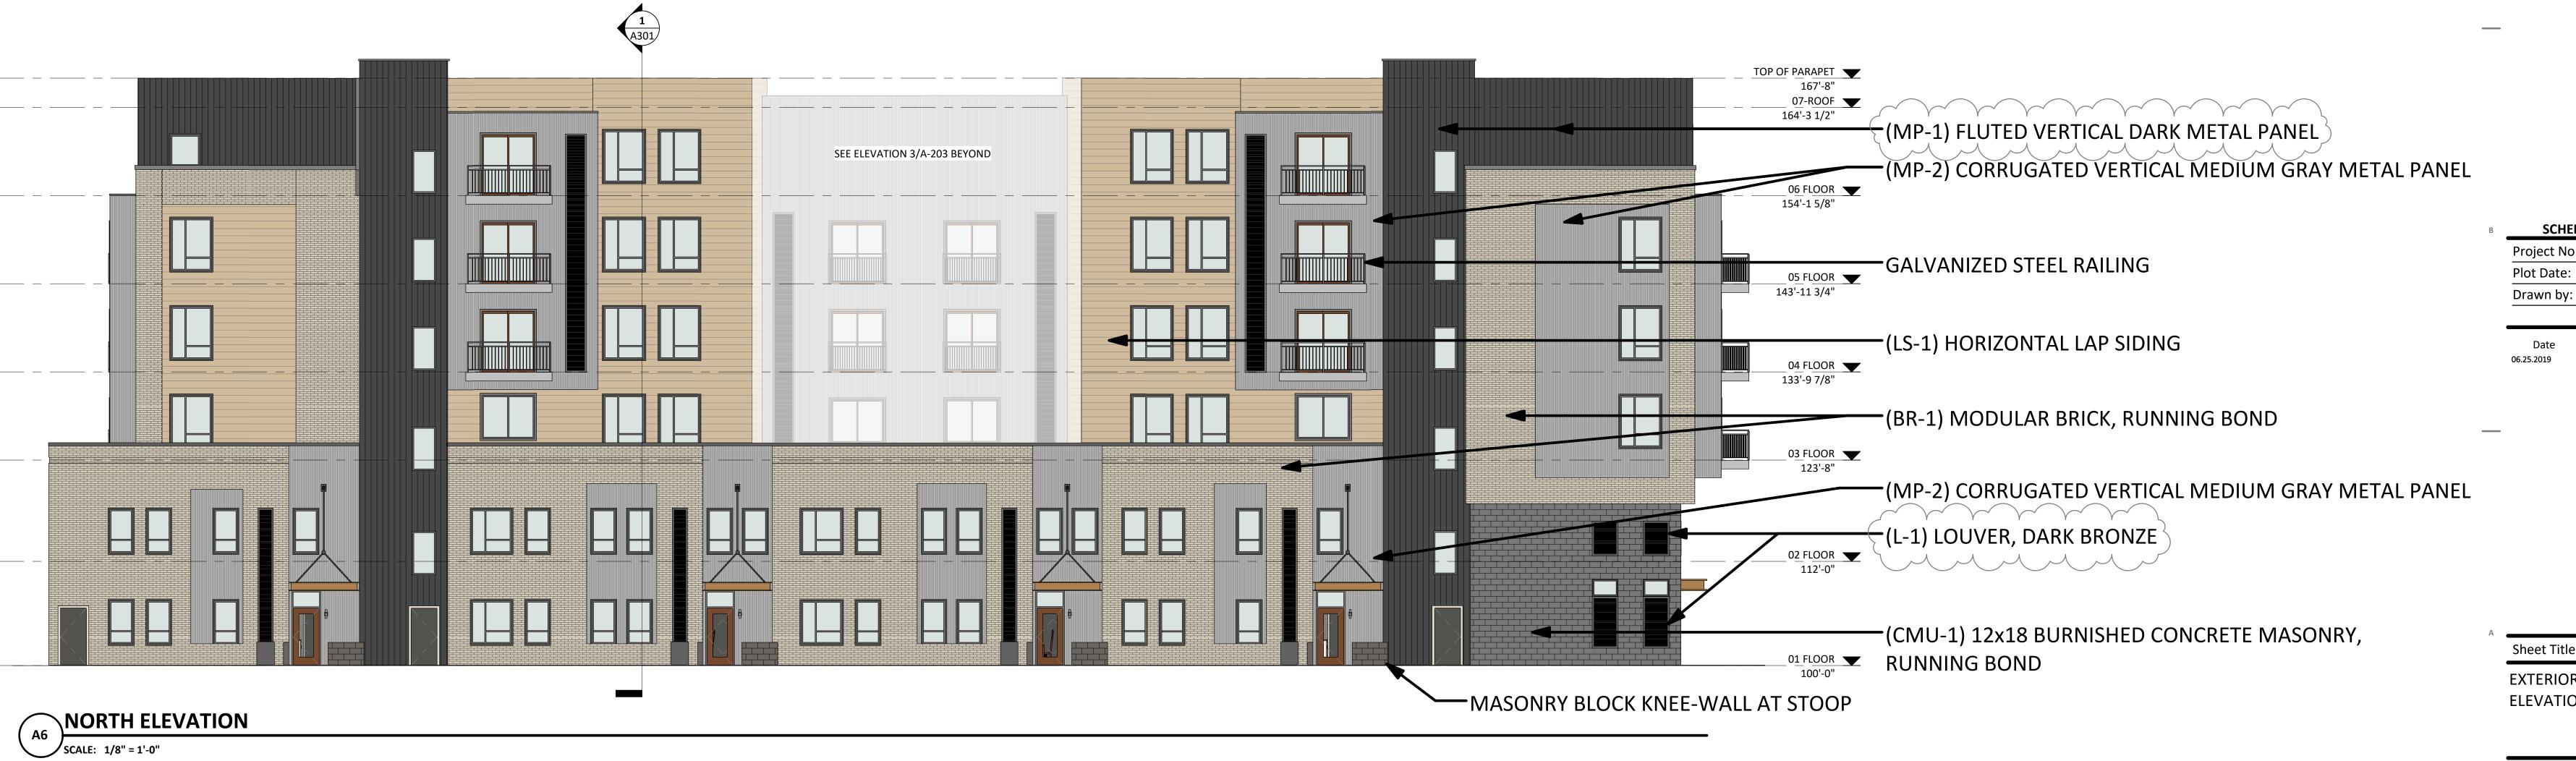

TOP OF PARAPET

167'-8"

07-ROOF

164'-3 1/2"

154'-1 5/8"

05 FLOOR 143'-11 3/4"

04 FLOOR

02 FLOOR 112'-0"

Sheet Title

EXTERIOR BUILDING ELEVATIONS

Sheet No.


A202

NOT FOR CONSTRUCTION

07-ROOF 164'-3 1/2" (MP-2) CORRUGATED VERTICAL MEDIUM **GRAY METAL PANEL** 06 FLOOR 154'-1 5/8" (LS-1) HORIZONTAL LAP SIDING 05 FLOOR 143'-11 3/4" PAINTED STEEL RAILING @ FAUX BALCONY (MP-4) ARCHITECTURAL SCREEN, COLOR MATCH ADJACENT MATERIAL

03 FLOOR 123'-8"

INTERIOR COURTYARD - SOUTH C3 SCALE: 1/8" = 1'-0"

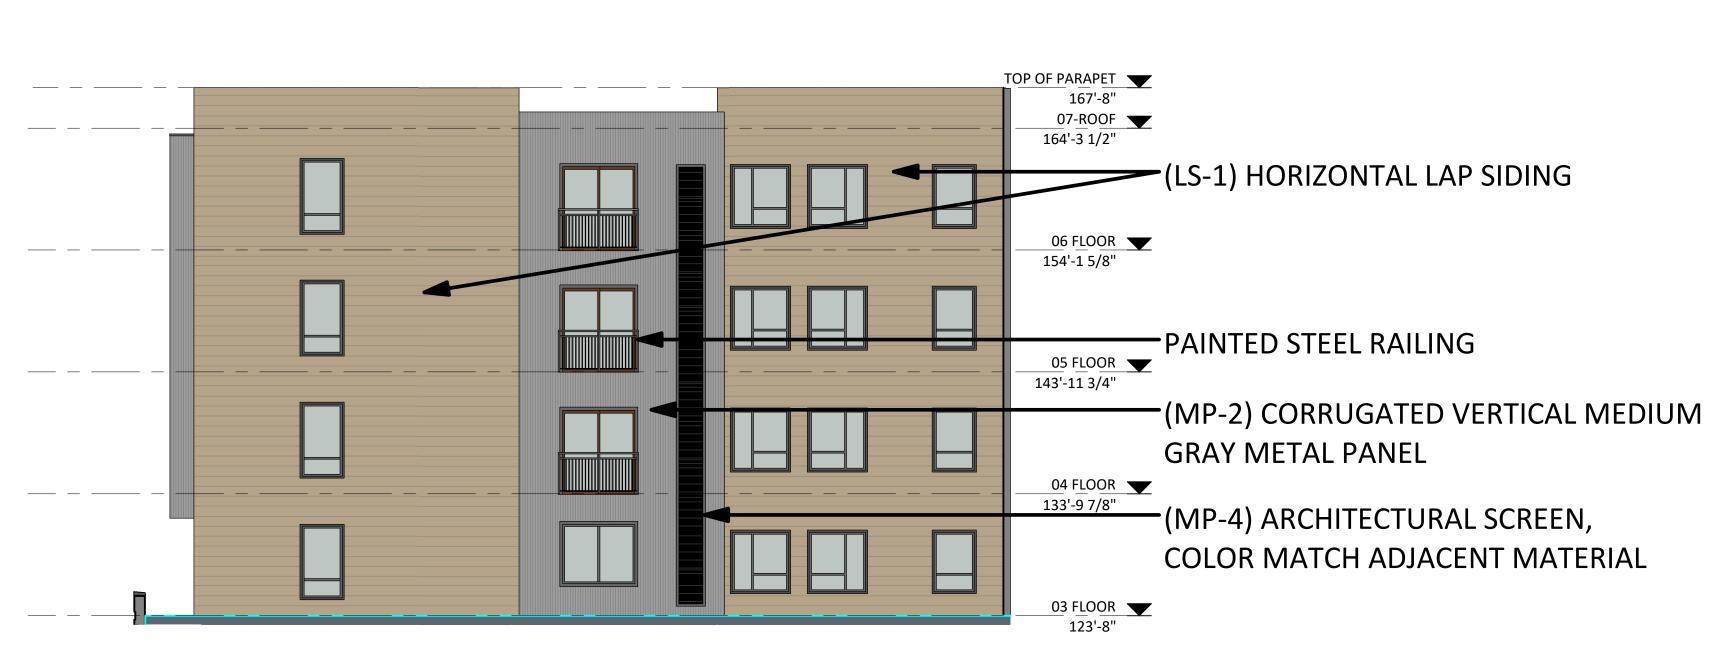

TOP OF PARAPET

167'-8"

07-ROOF

164'-3 1/2"

05 FLOOR 143'-11 3/4"

04 FLOOR 133'-9 7/8"

03 FLOOR 123'-8"

PAINTED STEEL RAILING @ FAUX BALCONY

(MP-2) CORRUGATED VERTICAL MEDIUM

(LS-1) HORIZONTAL LAP SIDING

(MP-4) ARCHITECTURAL SCREEN,

COLOR MATCH ADJACENT MATERIAL


GRAY METAL PANEL

INTERIOR COURTYARD - EAST

SCALE: 1/8" = 1'-0"

INTERIOR COURTYARD - WEST

SCALE: 1/8" = 1'-0"

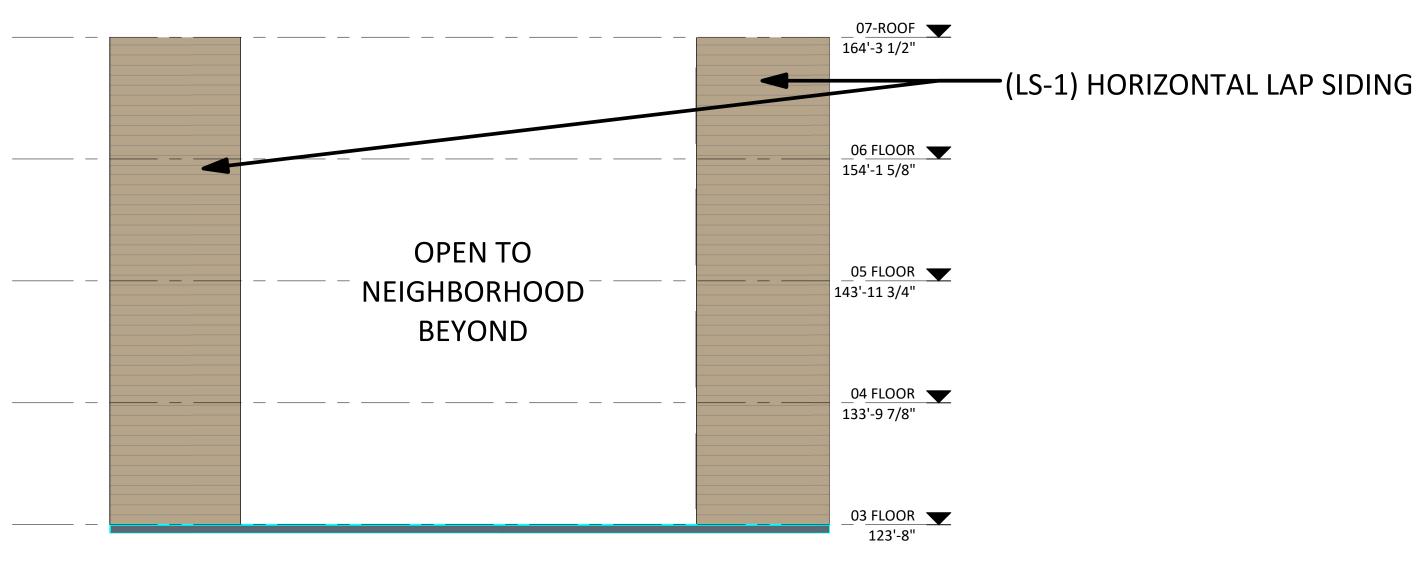

INTERIOR COURTYARD - NORTH

SCALE: 1/8" = 1'-0"

ELEVATIONS

Sheet Title

Sheet No.

EXTERIOR BUILDING

A203

SCHEMATIC DESIGN

18VALO-00-01

6/25/2019 8:58:13 AM

Project No.

Plot Date:

Drawn by:

MATERIALS

Fluted metal panel, *MP-1*McElroy Mega-Rib, vertical orientation, Patrician Bronze (McElroy)
24 Gauge

Corrugated metal panel , *MP-2* McElroy Multi-Cor, vertical orientation, Weathered Zinc (cmg) 24 Gauge

Flat metal panel, MP-3 McElroy Impression (Flat) insulated metal panel, copper penny (CMG) 26/24 Gauge

Perforated Architectural Screen metal panel, *MP-4*McNichols Perforated Metal Round hole pattern, Weathered zinc (cmg) 8 Gauge

Storefront R-Infill Spandrel Panel, *SP-1* Mapes-R, Copper Penny (mapes)

Louvers, *L-1* Greenheck, dark bronze

Brick, *BR-1* Hebron, Utility, velour texture, Sahara Utility brick – 4"x12"

Block, CMU-1

County Architectural Concrete Masonry Unit, Oversized (12x18), burnished finish, color black granite 12"x18"

Plaster Soffit, S-1 At brick/masonry

Metal Soffit Panel, S-2 At metal panel

Horizontal Lap Siding, *LS-1* LP Smartside, 38 Series Smooth Lap

PID: 4134 10"

Hallman Lindsay Custom color: Polished Marble 0274

Mega-Rib

Mega-Rib is a 7.2 panel that provides optimum strength and spanning capabilities. Mega-Rib is equally well suited for industrial and commercial applications.



Note: Mega-Rib is also available with a 28.8" coverage, which is standard for 26 gauge panels. Please specify if 36" coverage is required.



MP-1 FLUTED METAL PANEL 24 Gauge

VERTICAL ORIENTATION

Color: Patrician Bronze



Details

- Minimum slope: 1:12
- Tape sealant required on all slopes
- Adelanto standard coverage for 26 gauge is 36"
 All other locations, standard 26 gauge coverage is 28.8" specify if 36" coverage is required
- Can be installed vertically or horizontally

Panel Options

- Coating: Kynar 500® (PVDF)
- Substrate:
 - Standard 24 gauge Galvalume®
 - Optional 22 gauge Galvalume
- Optional 26 gauge Galvalume (narrow coverage)
- Optional 26 gauge Galvalume (full coverage Adelanto only)

- Optional 18 and 20 gauge (painted Galvalume) (limited availability)

• Testing Data

- Fire Rating: Class A
- Uplift Test: UL580 Class 90
- Air Infiltration: ASTM E1680
- Water Infiltration: ASTM E1646
- Class 4 Impact Resistance: UL2218
- Florida State Approval: 1832.8, 1747.6
- Fire Resistance: UL263
- Miami Dade Approval: NOA# 15-1013.06
- ICC-ES Approval: ESR-5896
- For any available Test Data, Section Properties or Load Tables, please visit our download section at www.mcelroymetal.com



MP-2 CORRUGATED METAL PANEL 24 Gauge

VERTICAL ORIENTATION


Color: Weathered Zinc



Multi-Cor & M-Cor

McElroy's corrugated panels were designed and engineered with greater-than-normal spans and load-carrying characteristics in mind. And, they quickly communicate their high-strength performance capabilities. McElroy's Multi-Cor and M-Cor are similar in design, with M-Cor offering a more subtle rib height and configuration.

Multi-Cor

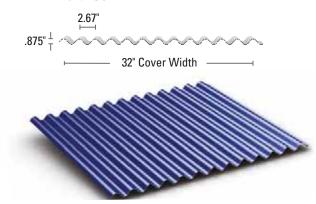



Multi-Cor & M-Cor

Details

- Multi-Cor minimum slope: 1:12
- M-Cor minimum slope: 1:12
- Tape Sealant required on all slopes
- Multi-Cor and M-Cor can be installed over solid deck or open framing
- Multi-Cor and M-Cor are produced in Bossier City, LA

Panel Options

- Coating:
 - Kynar 500® (PVDF)
 - Silicone Modified Polyester (SMP)
- Substrate:
- Standard 26 gauge Galvalume
- Multi-Cor is also available in 24 and 22 gauge Galvalume
- M-Cor is also available in 29 and 24 gauge Galvalume

Testing Data

- Fire Rating: Class A
- Uplift Test: UL580 Class 90 (Multi-Cor only)
- Class 4 Impact Resistance: UL 2218
- Florida State Approval: 10680.1 (Multi-Cor only)
- Texas Department of Insurance Approval: Evaluation RC-158 (Multi-Cor only)
- For any available Test Data, Section Properties or Load Tables, please visit our download section at www.mcelroymetal.com

MP-3 FLAT INSULATED METAL PANEL 24/26 Gauge

Color: Copper Penny




Copper Penny

 Reflectivity
 43.9%
 Available
 24 ga 40°

 Emissivity
 .84
 24 ga 48°

 SRI
 48
 26 ga 48°

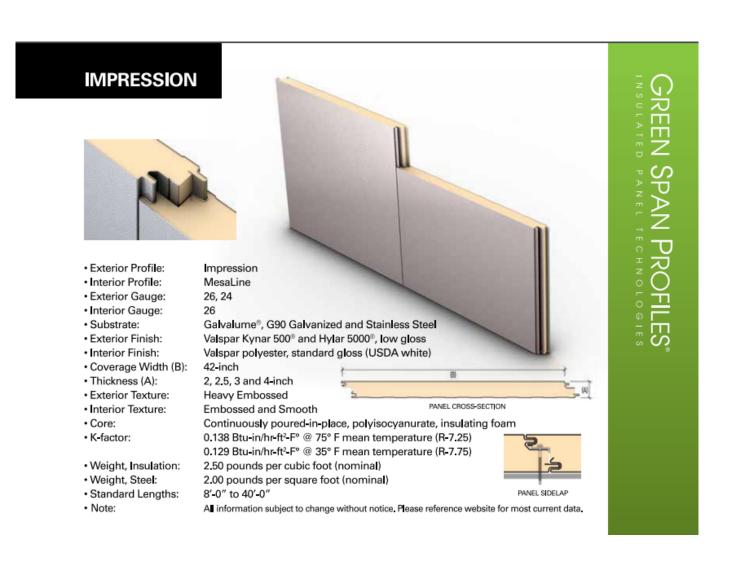


MP-4 PERFORATED ARCHITECTURAL METAL SCREEN (Round hole pattern) 8 Gauge

Weathered Zinc

Reflectivity 38.3% Available 24 ga 40°
Emissivity .85 24 ga 48°
SRI 41

Color: Weathered Zinc

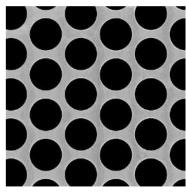


McNICHOLS® PERFORATED METAL

Round, Aluminum, Alloy 3003-H14, .1250" Thick (8 Gauge), 1" Round on 1-1/4" Staggered Centers, 58% Open Area

McNICHOLS® Perforated Metal, Round, Aluminum, Alloy 3003-H14, Mill Finish, .1250" Thick (8 Gauge), 1" Round on 1-1/4" Staggered Centers, 1/4" Bar Width, 0.74 Holes Per Square Inch (HPSI), Minimum Solid Margins Both Sides of Sheet Parallel to Length of Sheet, Holes Sheared Through Both Ends of Sheet Parallel to Width of Sheet, 58% Open Area

ITEM 1701921241 - 48" x 120"




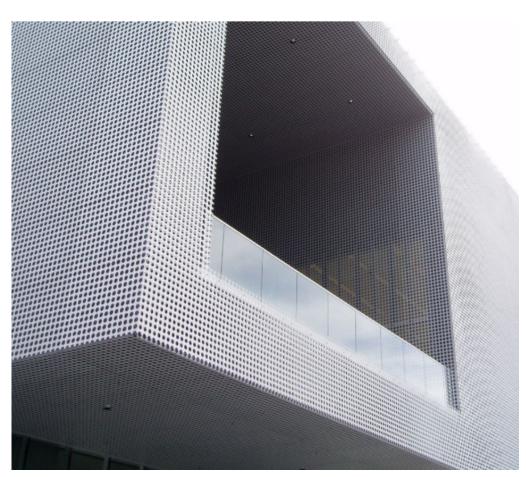

<u>SP-1</u> STOREFRONT R-INFILL SPANDREL PANEL

Color: Copper Penny

MAPES-R™

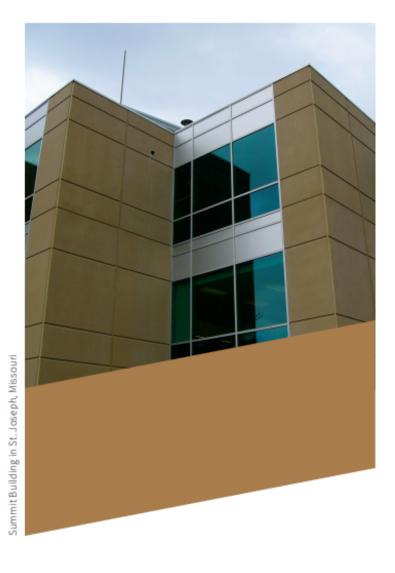



Copper Penny

Reflectivity	43.9%	Available	24 ga 40
Emissivity	.84		24 ga 48
SRI	48		26 ga 48

THE "GREEN" SOLUTION FOR GLAZING APPLICATIONS

With insulation values up to R=27.9, Mapes-R panels offer a wide variety of solutions to improve the thermal efficiency of window, spandrel, curtain wall and glazing applications. Mapes-R panels can be manufactured to match any architectural finish including Kynar, anodized, porcelain, and baked enamel. In addition to thermal improvement, Mapes-R panels can meet local building codes for sound, fire and impact resistance.

APPLICATIONS

- Passive Solar Control
- Curtain Wall
- Window Replacement
- Transoms
- Metal Spandrel Panel
- Door Sidelights
- Insulated Spandrel Glass

<u>L-1</u> LOUVERS (Greenheck)

Color: Dark Bronze



Dark Bronze

Reflectivity	27.7%	Available	22 ga 48'
Emissivity	.85		24 ga 40'
SRI	27		24 ga 48'
			26 ga 40°

Conventional Application Louvers

Fixed Blade

These conventional fixed blade louvers are among our most popular. All shown are AMCA Licensed for Air Performance and Water Penetration and may be applied in conventional intake or exhaust applications where provisions to manage water are present or some nuisance weather infiltration is acceptable or accounted for. These louvers shown are among the most economical options.

ESJ-401 4-inch depth Stationary Non-Drainable Extruded Aluminum J-Blade



ESJ-602 6-inch depth Stationary Non-Drainable Extruded Aluminum J-Blade





BR-1 Hebron Brick

Utility Brick (4"x12"), Velour texture

Color: Sahara



CMU-1 County Architectural Concrete Masonry Unit 12"x18"

Burnished Finish

Color: Black Granite





LS-1 Horizontal Lap Siding

LP Smartside, 38 Series Smooth 10" Lap

Color: Polished Marble 0274

Color Name: Polished Marble Number: 0274

Specifications: LP® SmartSide® Lap Siding

SMOOTH FINISH LAP (STRAND)

SMOOTH APPEARANCE, ADVANCED DURABILITY OF ENGINEERED WOOD

- With advanced durability for longer lasting beauty
- Engineered wood strand technology
- Holds up in extreme weather including moisture, hail, freeze/thaw cycles, and up to 200 mph wind gusts
- Treated with the SmartGuard® process for superior protection against the weather, fungal decay and termites
- 16' length can result in faster installation and fewer seams
- · Pre-primed for exceptional paint adhesion
- Backed by an industry-leading 5/50-year limited warranty





Smooth Finish

38 SERIES SMOOTH LAP (STRAND)

