

City of Madison Fire Department

30 West Mifflin Street, 8th & 9th Floors, Madison, WI 53703-2579 Phone: 608-266-4420 • Fax: 608-267-1100 • E-mail: fire@cityofmadison.com

Project Address: 2830	2830 Dryden Dr.		
Contact Name & Phone #	: Kevin Burow 608-836-3690		


FIRE APPARATUS ACCESS AND FIRE HYDRANT WORKSHEET


 Is the building completely protected by an NFPA 13 or 13R automatic fire sprinkler system? If non-sprinklered, fire lanes extend to within 150-feet of all portions of the exterior wall? If sprinklered, fire lanes are within 250-feet of all portions of the exterior wall? 	Yes Yes Yes	No No No	□ N/A ☑ N/A □ N/A
 2. Is the fire lane constructed of concrete or asphalt, designed to support a minimum load of 85,000 lbs? a) Is the fire lane a minimum unobstructed width of at least 20-feet? b) Is the fire lane unobstructed with a vertical clearance of at least 13½-feet? c) Is the minimum inside turning radius of the fire lane at least 28-feet? d) Is the grade of the fire lane not more than a slope of 8%? e) Is the fire lane posted as fire lane? (Provide detail of signage.) f) Is a roll-able curb used as part of the fire lane? (Provide detail of curb.) g) Is part of a sidewalk used as part of the required fire lane? (Must support +85,000 lbs.) 	 ✓ Yes ✓ Yes ✓ Yes ✓ Yes ✓ Yes ☐ Yes ☐ Yes 	No No No No No No No No	 N/A N/A N/A N/A N/A N/A N/A N/A N/A
3. Is the fire lane obstructed by security gates or barricades? If yes:a) Is the gate a minimum of 20-feet clear opening?b) Is an approved means of emergency operations installed, key vault, padlock or key switch?	Yes Yes Yes	No No No	□ N/A □ N/A □ N/A
4. Is the Fire lane dead-ended with a length greater than 150-feet? If yes, does the area for turning around fire apparatus comply with IFC D103?	Yes Yes	No No	□ N/A □ N/A
5. Is any portion of the building to be used for high-piled storage in accordance with IFC Chapter 3206.6 If yes, see IFC 3206.6 for further requirements.	Yes	No	□ N/A
6. Is any part of the building greater than 30-feet above the grade plane?	Yes	☐ No	□ N/A
 6. Is any part of the building greater than 30-feet above the grade plane? If yes, answer the following questions: a) Is the aerial apparatus fire lane parallel to one entire side of the building and covering at least 25% of the perimeter? b) Is the near edge of the aerial apparatus fire lane between 15' and 30' from the building? c) Are there any overhead power or utility lines located across the aerial apparatus fire lane? d) Are there any tree canopies expected to grow across the aerial fire lane? (Based on mature canopy width of tree species) 	Yes Yes Yes Yes Yes Yes	No No No No No No	 N/A N/A N/A N/A N/A
If yes, answer the following questions: a) Is the aerial apparatus fire lane parallel to one entire side of the building and covering at least 25% of the perimeter? b) Is the near edge of the aerial apparatus fire lane between 15' and 30' from the building? c) Are there any overhead power or utility lines located across the aerial apparatus fire lane?	Yes Yes Yes	□ No □ No ☑ No	□ N/A □ N/A □ N/A
If yes, answer the following questions: a) Is the aerial apparatus fire lane parallel to one entire side of the building and covering at least 25% of the perimeter? b) Is the near edge of the aerial apparatus fire lane between 15' and 30' from the building? c) Are there any overhead power or utility lines located across the aerial apparatus fire lane? d) Are there any tree canopies expected to grow across the aerial fire lane? (Based on mature canopy width of tree species) e) Does the aerial apparatus fire lane have a minimum unobstructed width of 26-feet? f) Is the space between the aerial lane and the building free of trees exceeding 20' in heights?	✓Yes ✓Yes ✓Yes ✓Yes ✓Yes ✓Yes	☐ No ☐ No ☑ No ☑ No ☑ No ☐ No ☐ No ☐ No	 N/A N/A N/A N/A N/A N/A N/A
If yes, answer the following questions: a) Is the aerial apparatus fire lane parallel to one entire side of the building and covering at least 25% of the perimeter? b) Is the near edge of the aerial apparatus fire lane between 15' and 30' from the building? c) Are there any overhead power or utility lines located across the aerial apparatus fire lane? d) Are there any tree canopies expected to grow across the aerial fire lane? (Based on mature canopy width of tree species) e) Does the aerial apparatus fire lane have a minimum unobstructed width of 26-feet?	Yes Yes Yes Yes Yes Yes	 No No No No No 	 N/A N/A N/A N/A N/A

Attach an additional sheet if further explanation is required for any answers.


This worksheet is based on MGO 34.503 and IFC 2012 Edition Chapter 5 and Appendix D; please see the codes for further information.

* See fire department access plan, sheet C-1.3 for diagram.

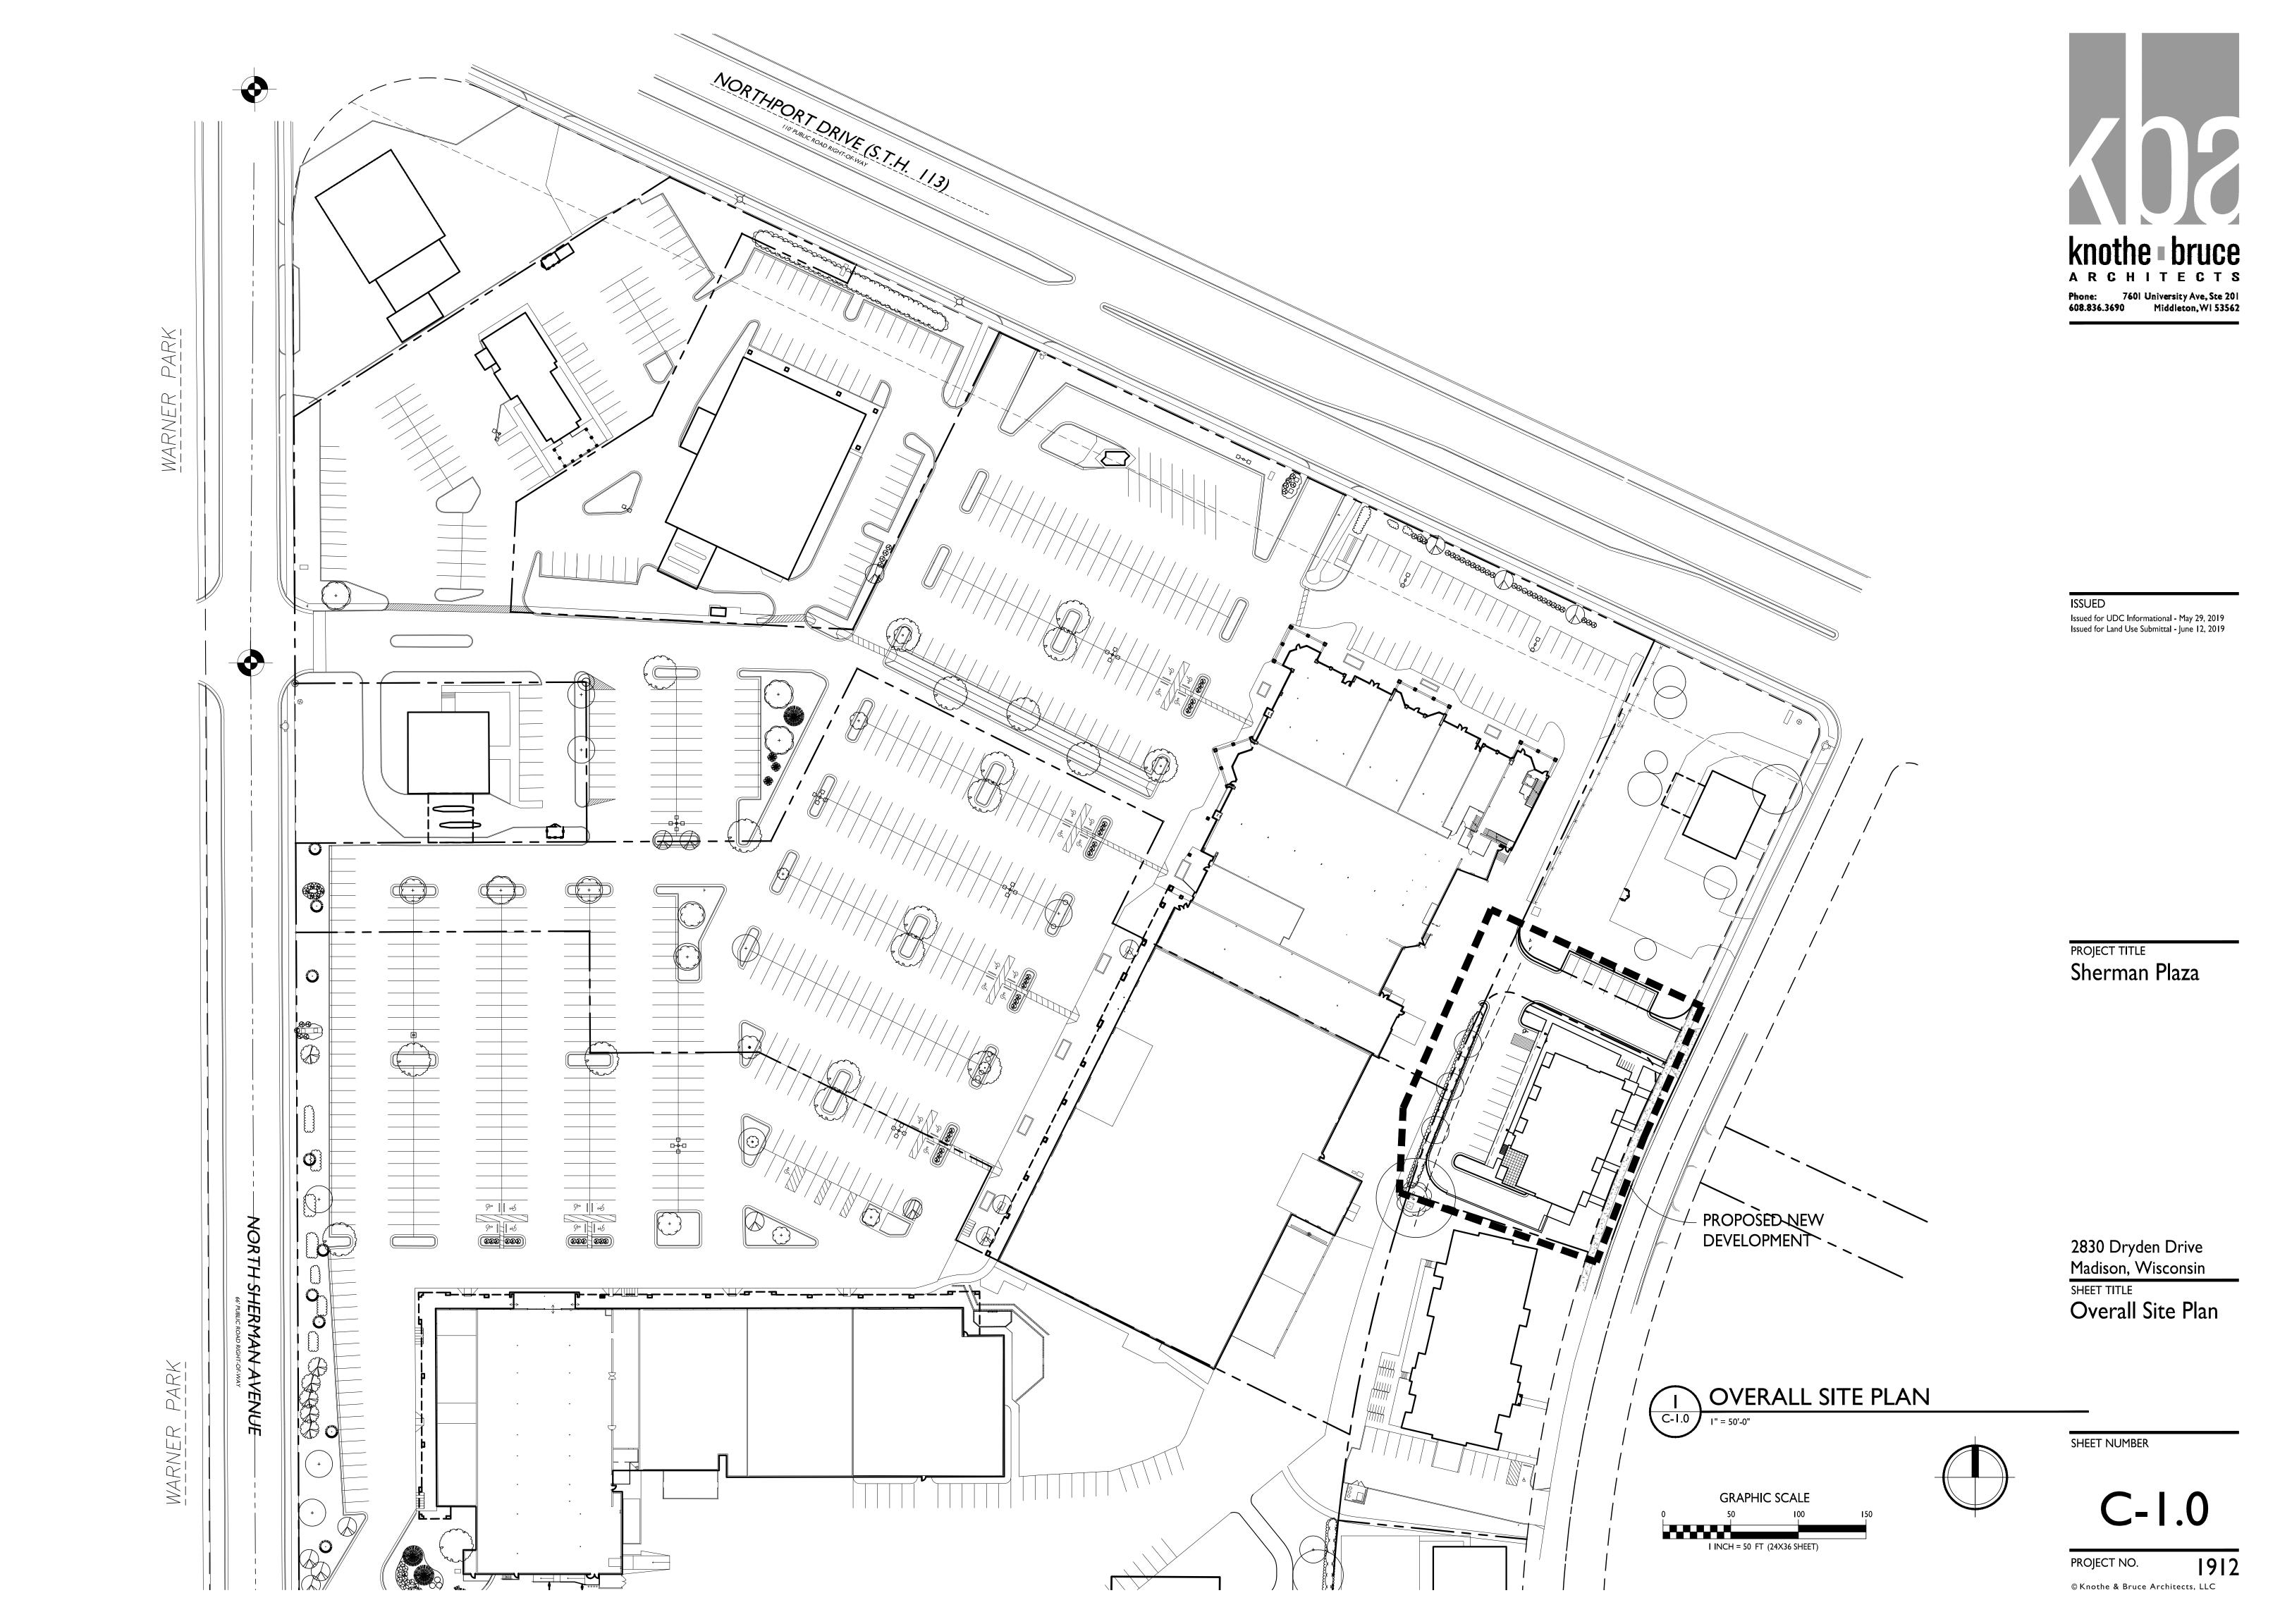

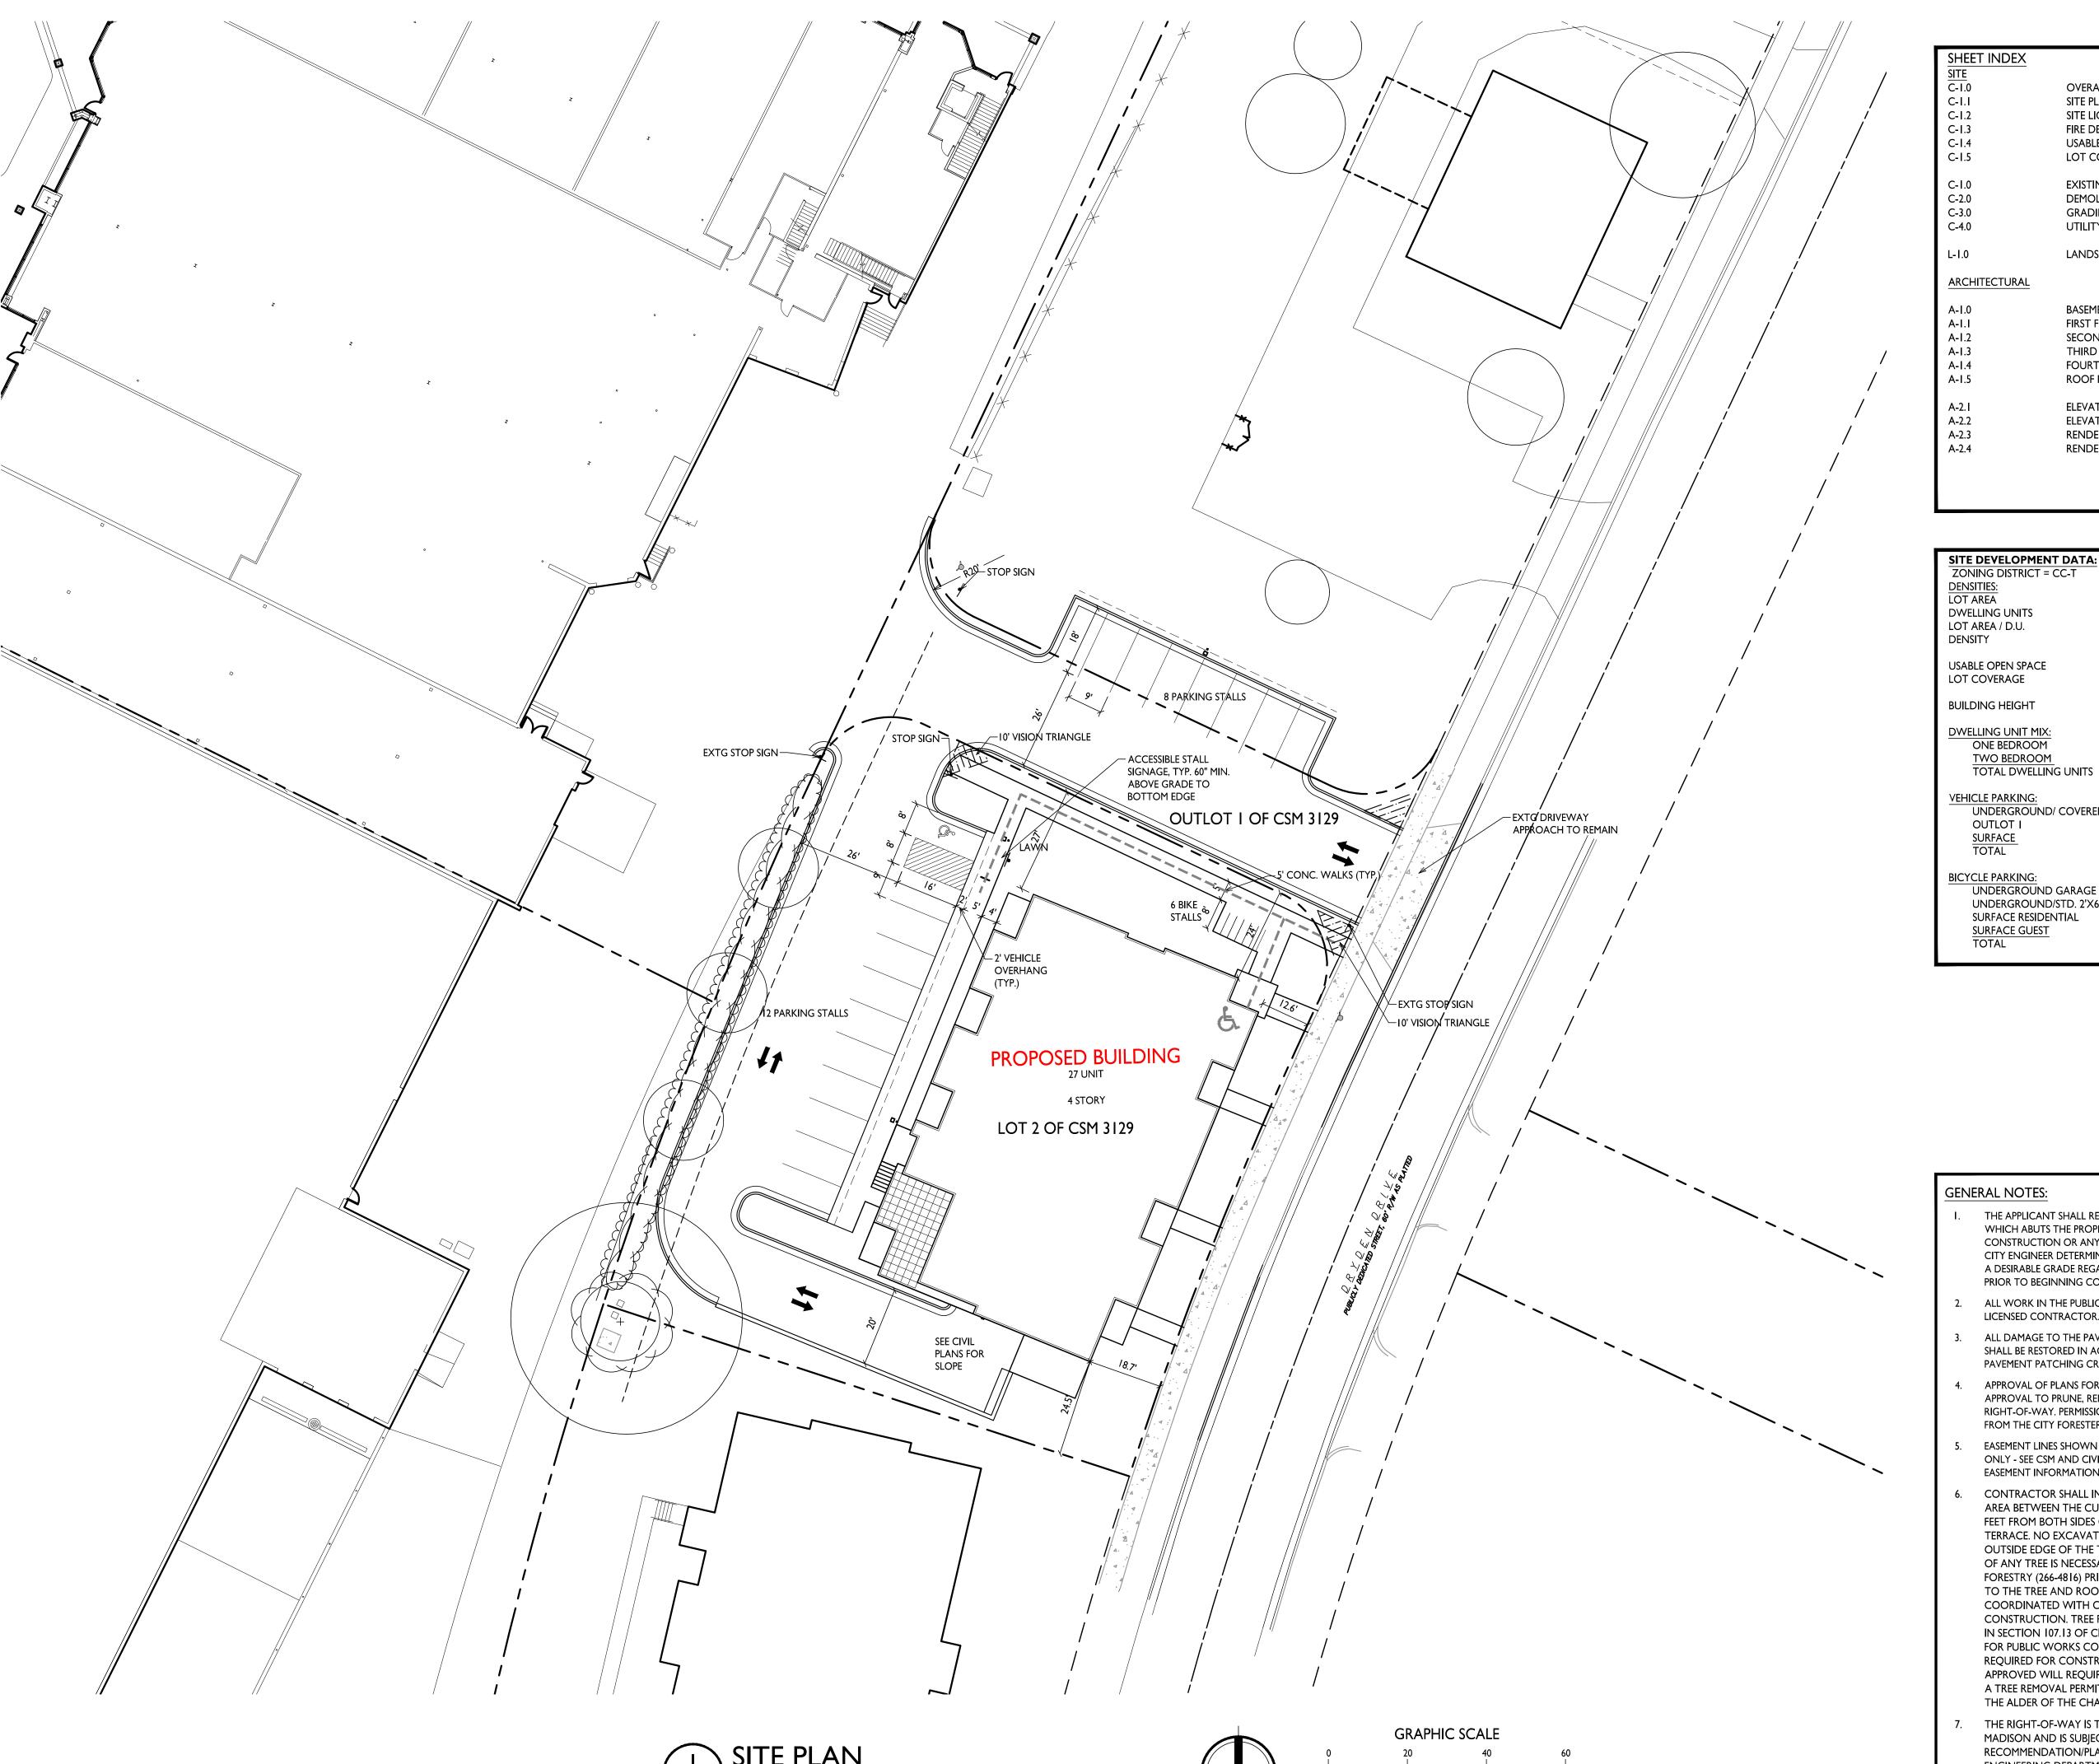

I INCH = $20 \text{ FT } (24 \times 36 \text{ SHEET})$

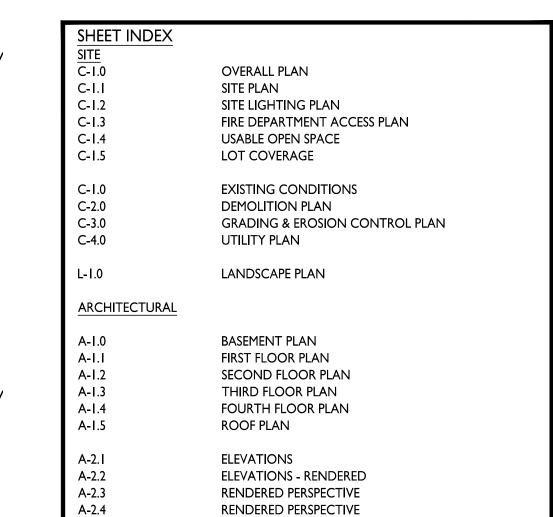



ISSUED

Issued for UDC Informational - May 29, 2019

Issued for Land Use Submittal - June 12, 2019

817 SF / UNIT 54 UNITS/ACRE 5,759 S.F.

27 DU

22,065 SF / .5 ACRES

LOT COVERAGE 14,621 S.F. = 66% **BUILDING HEIGHT** 4 STORIES

DWELLING UNIT MIX: ONE BEDROOM

TWO BEDROOM TOTAL DWELLING UNITS

VEHICLE PARKING: UNDERGROUND/ COVERED

19 STALLS 8 STALLS OUTLOT I 12 STALLS 39 STALLS SURFACE TOTAL

BICYCLE PARKING: UNDERGROUND GARAGE - WALL UNDERGROUND/STD. 2'X6' SURFACE RESIDENTIAL

SURFACE GUEST

5 STALLS (COVERED) 19 STALLS (COVERED) 3 STALL 3 STALLS (10% OF UNITS) 30 STALLS

Sherman Plaza

GENERAL NOTES:

- I. THE APPLICANT SHALL REPLACE ALL SIDEWALK AND CURB AND GUTTER WHICH ABUTS THE PROPERTY WHICH IS DAMAGED BY THE CONSTRUCTION OR ANY SIDEWALK AND CURB AND GUTTER WHICH THE CITY ENGINEER DETERMINES NEEDS TO BE REPLACED BECAUSE IT IS NOT AT A DESIRABLE GRADE REGARDLESS OF WHETHER THE CONDITION EXISTED PRIOR TO BEGINNING CONSTRUCTION.
- 2. ALL WORK IN THE PUBLIC RIGHT-OF-WAY SHALL BE PERFORMED BY A CITY LICENSED CONTRACTOR.
- ALL DAMAGE TO THE PAVEMENT, ADJACENT TO THIS DEVELOPMENT SHALL BE RESTORED IN ACCORDANCE WITH THE CITY OF MADISON'S PAVEMENT PATCHING CRITERIA.
- APPROVAL OF PLANS FOR THIS PROJECT DOES NOT INCLUDE ANY APPROVAL TO PRUNE, REMOVE, OR PLANT TREES IN THE PUBLIC RIGHT-OF-WAY. PERMISSION FOR SUCH ACTIVITIES MUST BE OBTAINED FROM THE CITY FORESTER, 266-4816.
- EASEMENT LINES SHOWN ON THIS SHEET ARE FOR GENERAL REFERENCE ONLY - SEE CSM AND CIVIL SHEETS FOR ADDITIONAL AND MORE COMPLETE EASEMENT INFORMATION
- 6. CONTRACTOR SHALL INSTALL TREE PROTECTION FENCING IN THE AREA BETWEEN THE CURB AND SIDEWALK AND EXTEND IT AT LEAST 5 FEET FROM BOTH SIDES OF THE TREE ALONG THE LENGTH OF THE TERRACE. NO EXCAVATION IS PERMITTED WITHIN 5 FEET OF THE OUTSIDE EDGE OF THE TREE TRUNK. IF EXCAVATION WITHIN 5 FEET OF ANY TREE IS NECESSARY, CONTRACTOR SHALL CONTACT CITY FORESTRY (266-4816) PRIOR TO EXCAVATION TO ASSESS THE IMPACT TO THE TREE AND ROOT SYSTEM. TREE PRUNING SHALL BE COORDINATED WITH CITY FORESTRY PRIOR TO THE START OF CONSTRUCTION. TREE PROTECTION SPECIFICATIONS CAN BE FOUND IN SECTION 107.13 OF CITY OF MADISON STANDARD SPECIFICATIONS FOR PUBLIC WORKS CONSTRUCTION. ANY TREE REMOVALS THAT ARE REQUIRED FOR CONSTRUCTION AFTER THE DEVELOPMENT PLAN IS APPROVED WILL REQUIRE AT LEAST A 72-HOUR WAIT PERIOD BEFORE A TREE REMOVAL PERMIT CAN BE ISSUED BY FORESTRY, TO NOTIFY THE ALDER OF THE CHANGE IN THE TREE PLAN.
- 7. THE RIGHT-OF-WAY IS THE SOLE JURISDICTION OF THE CITY OF MADISON AND IS SUBJECT TO CHANGE AT ANY TIME PER THE RECOMMENDATION/PLAN OF TRAFFIC ENGINEERING AND CITY ENGINEERING DEPARTMENTS.

2830 Dryden Drive Madison, Wisconsin


SHEET TITLE Site Plan

PROJECT TITLE

SHEET NUMBER



PROJECT NO.

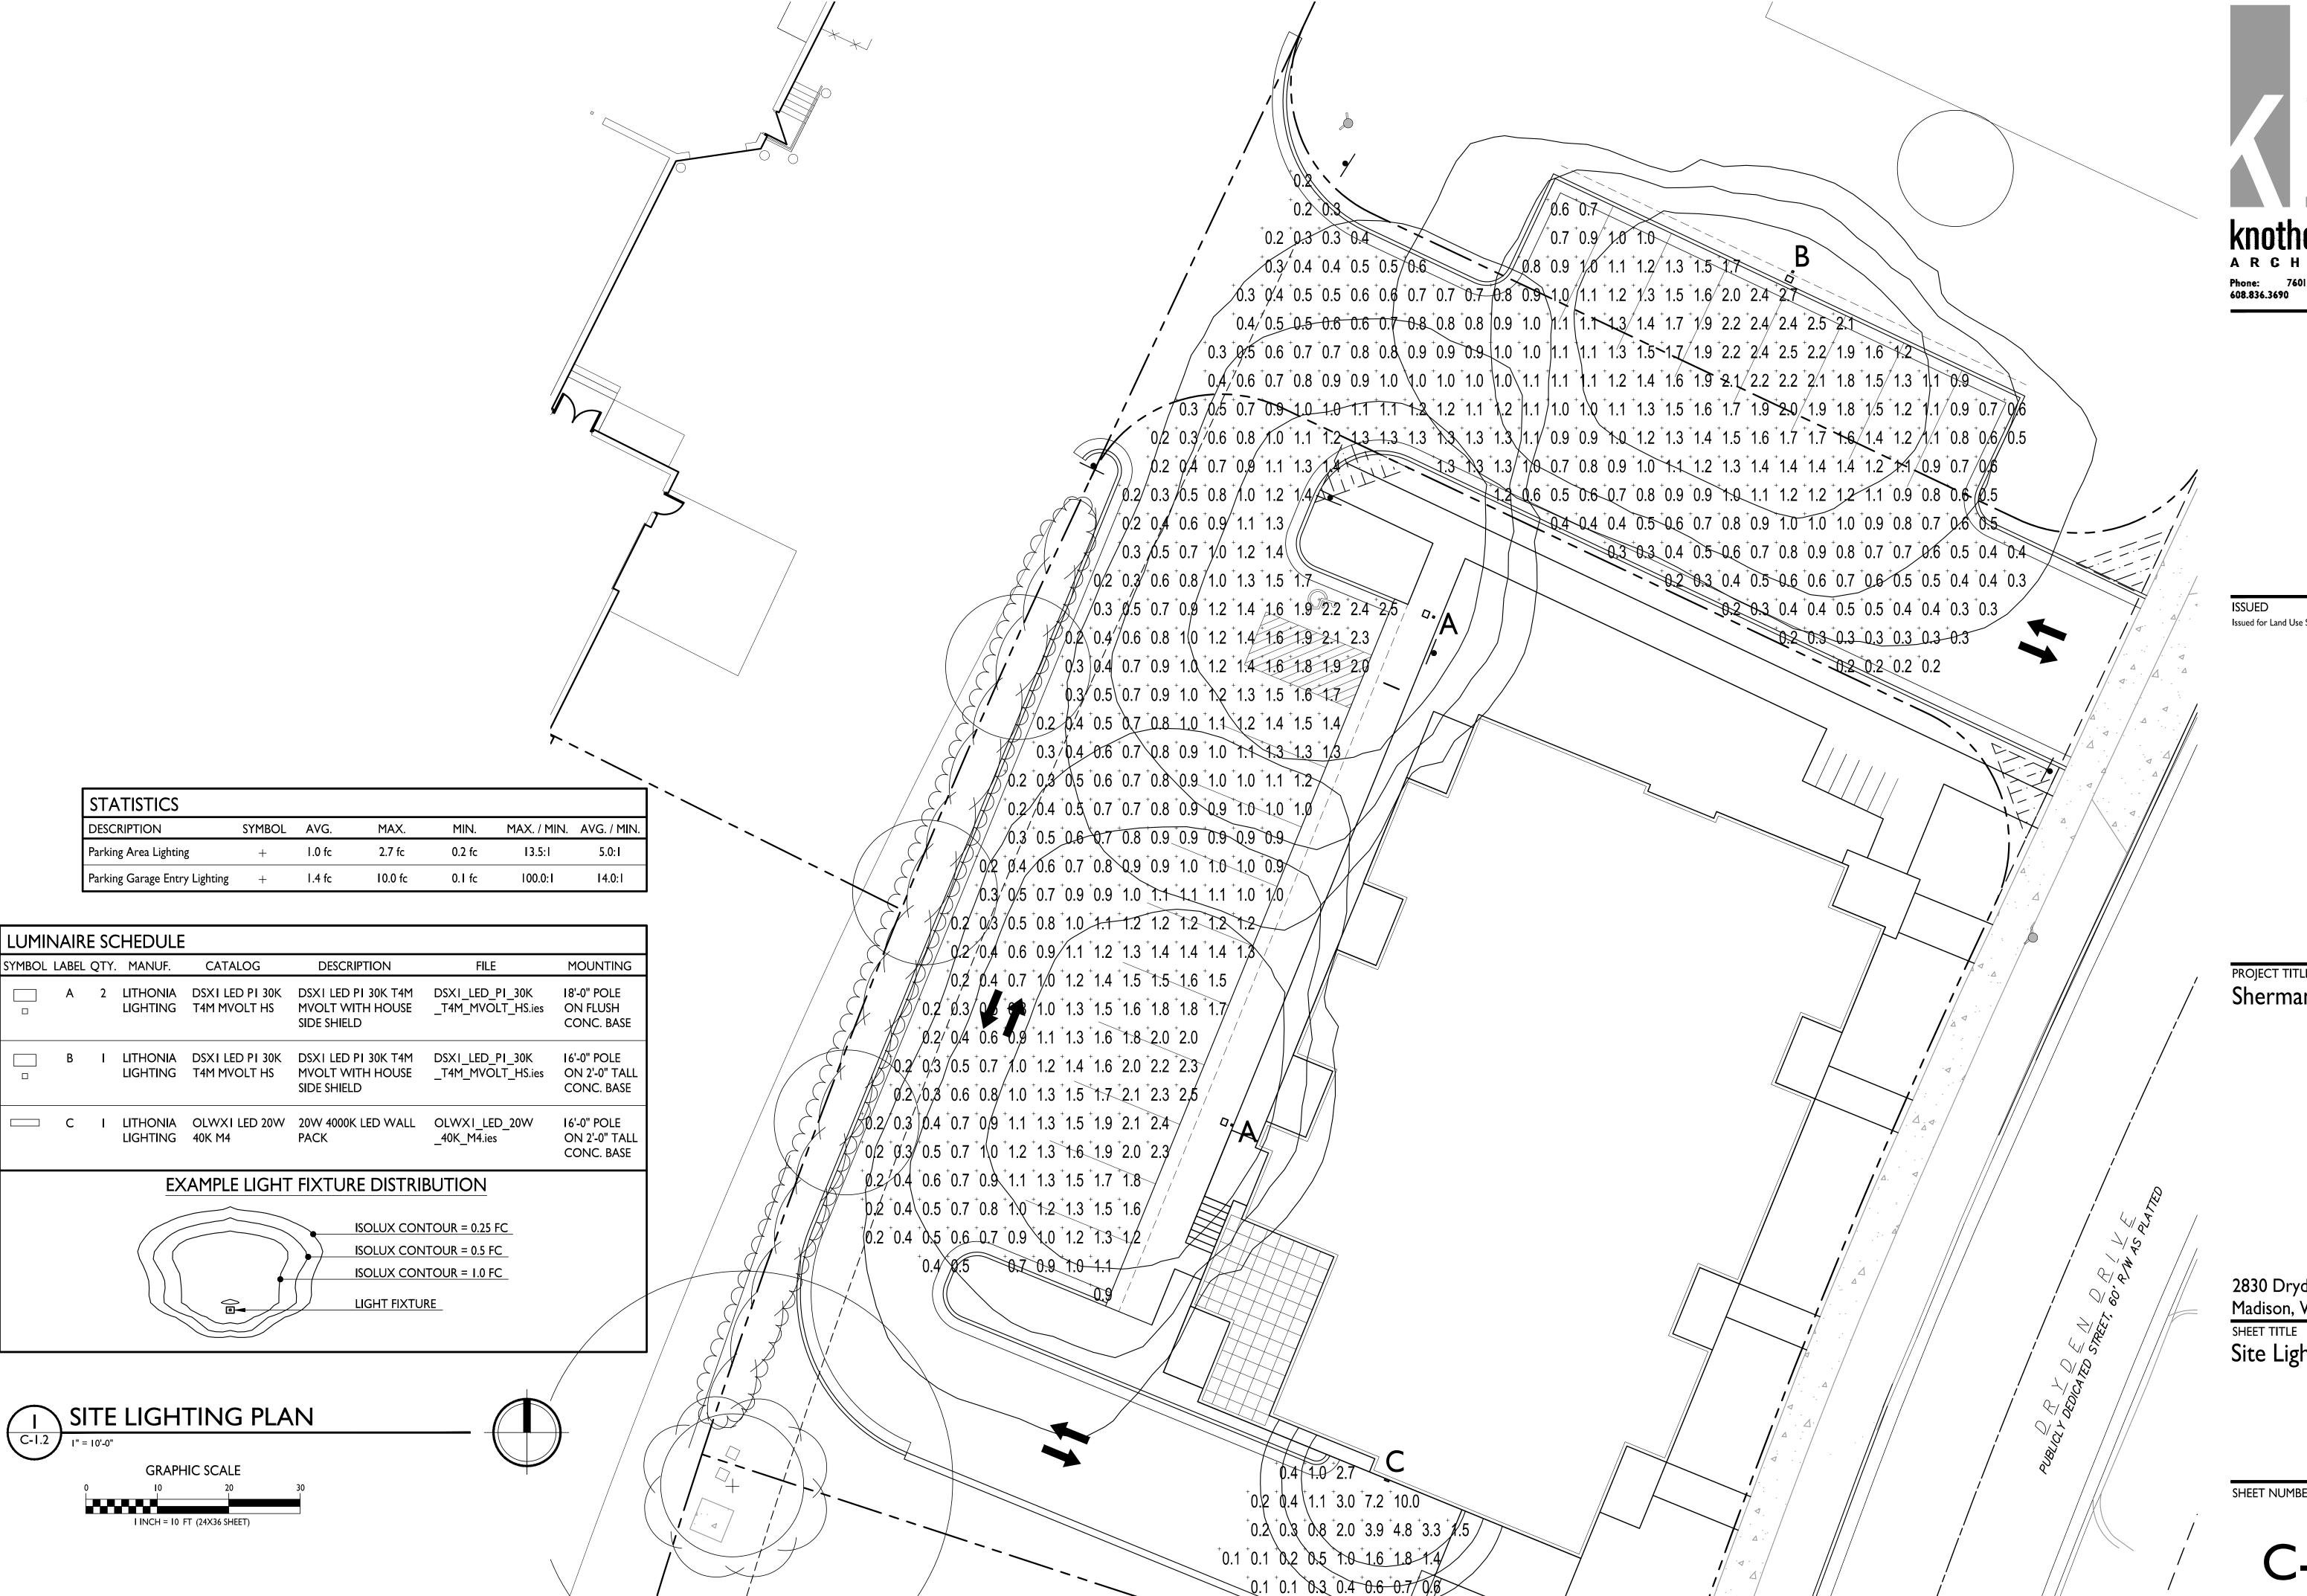

0.1 0.2 0.2 0/3/0.2

DESCRIPTION

Issued for Land Use Submittal - June 12, 2019


PROJECT TITLE Sherman Plaza


2830 Dryden Drive Madison, Wisconsin

Site Lighting Plan

SHEET NUMBER

PROJECT NO.

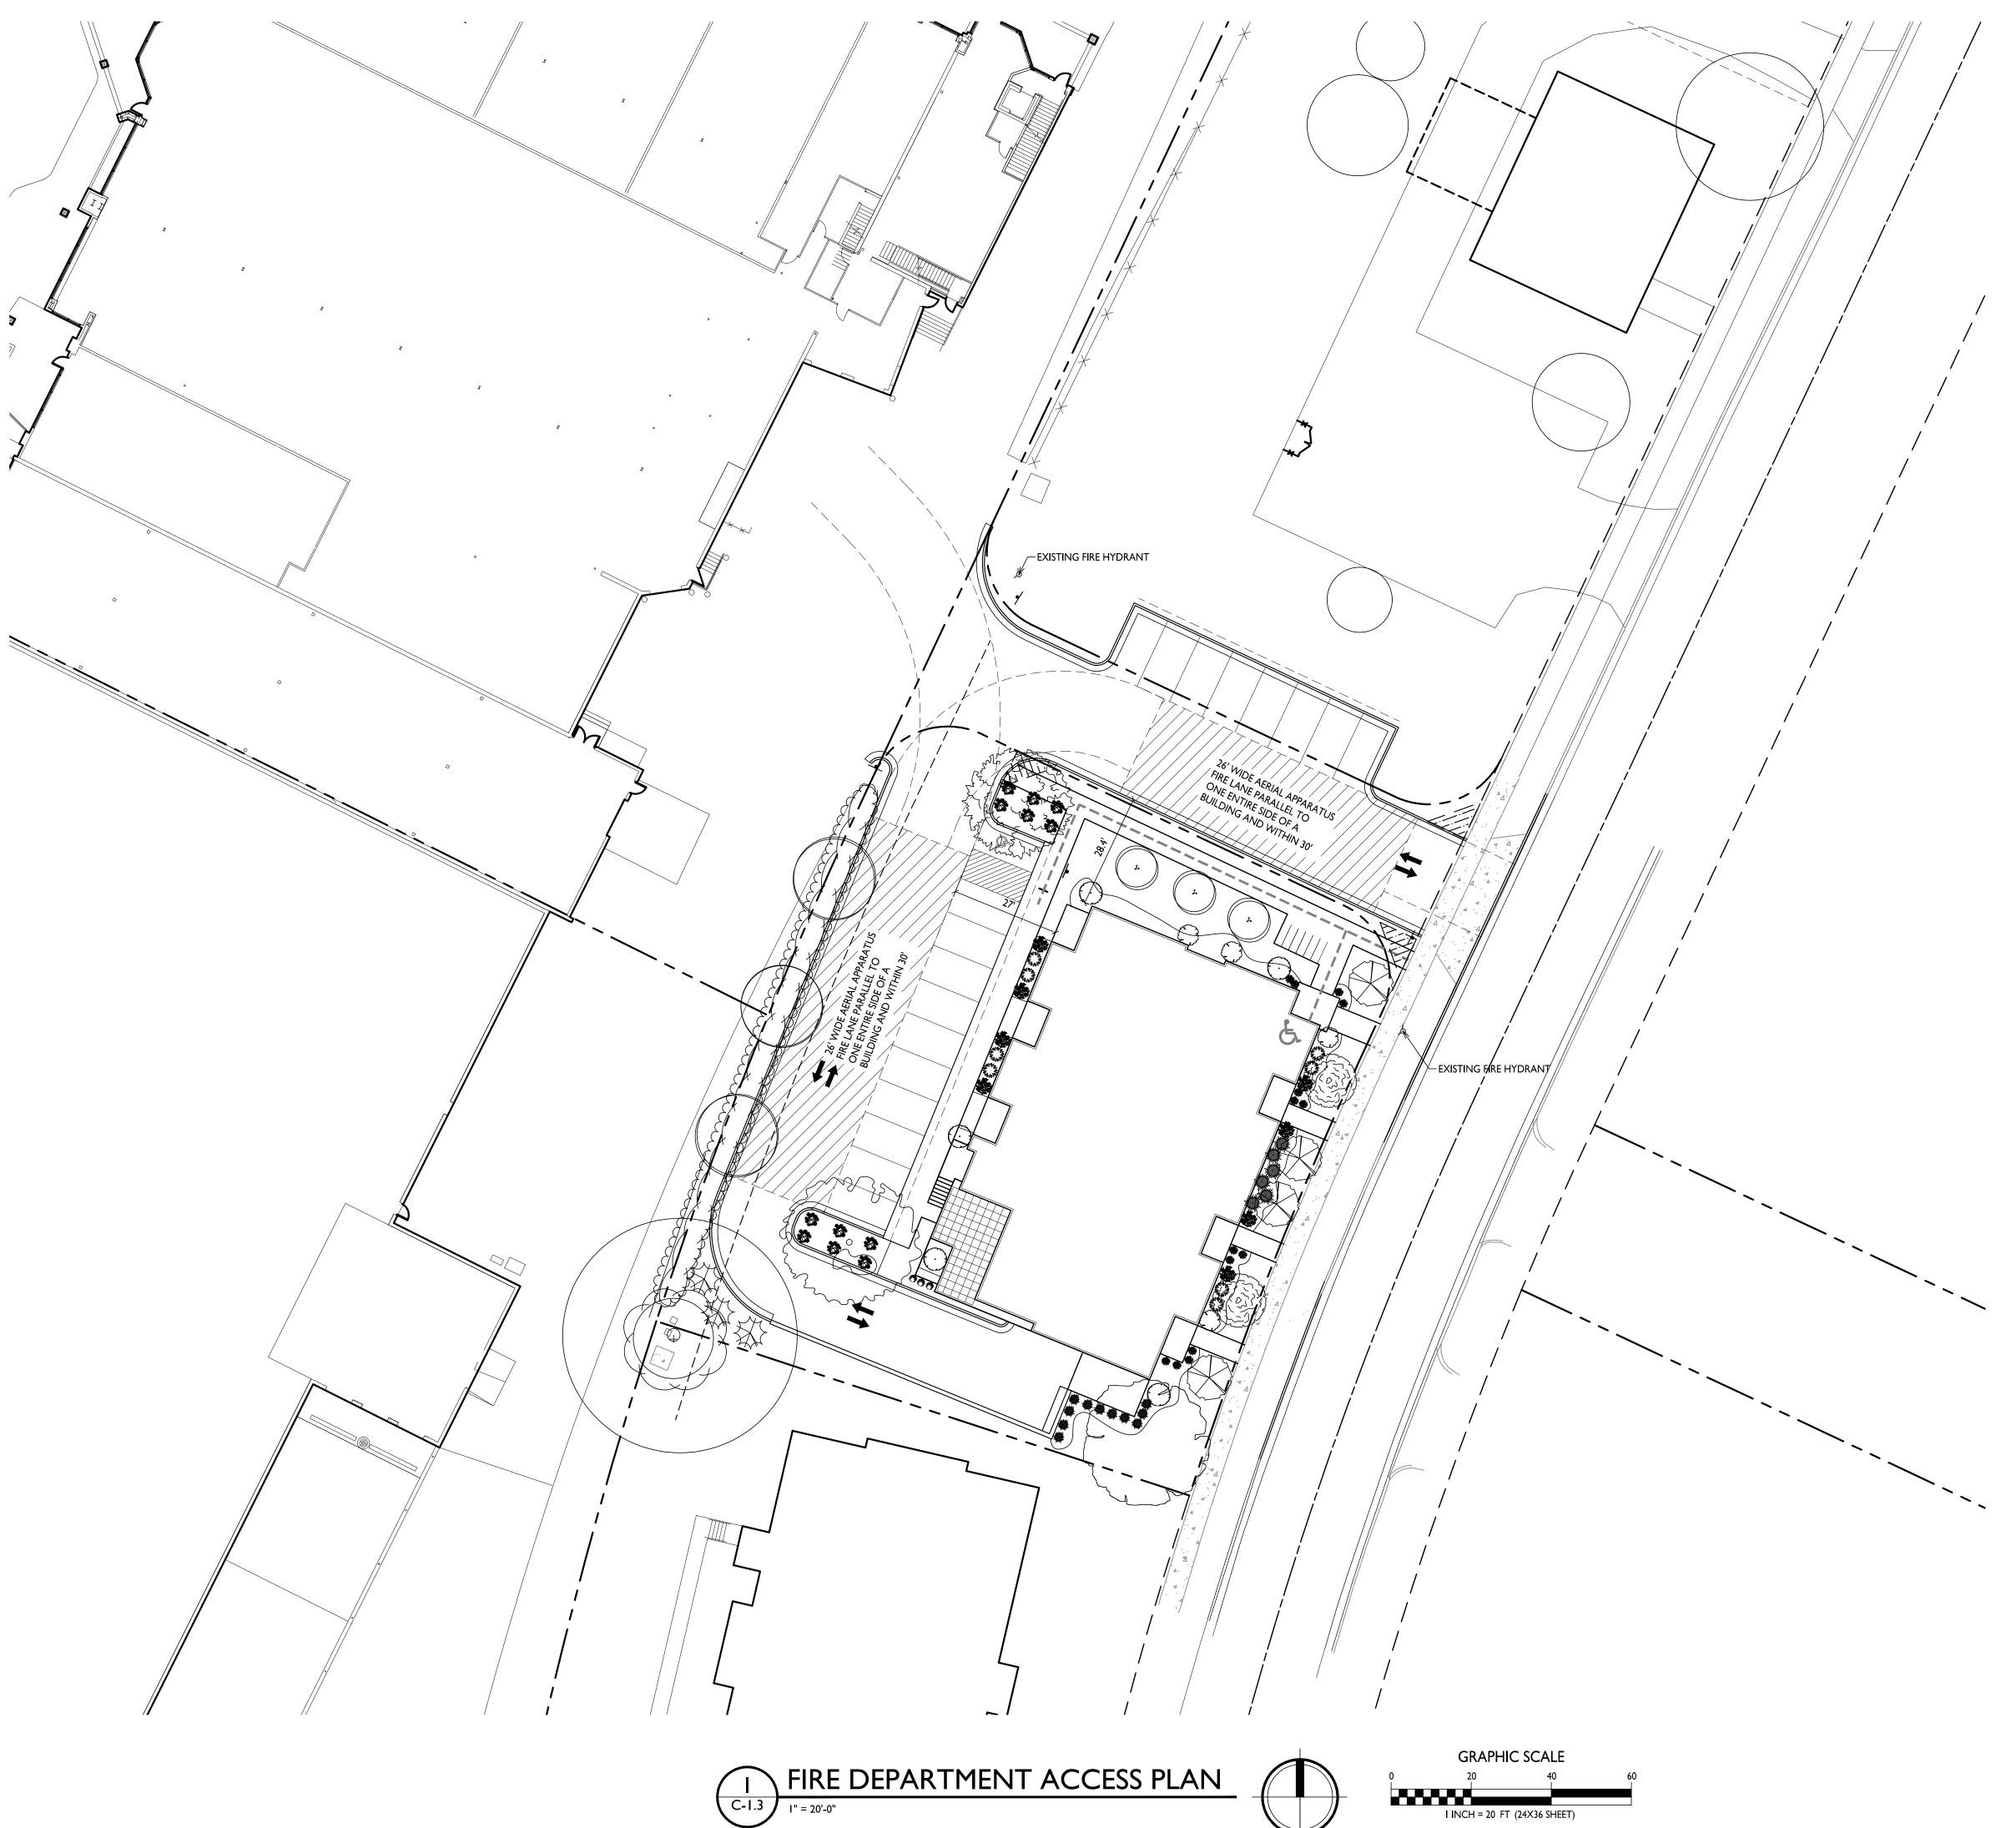

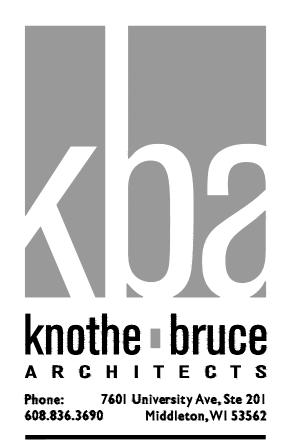

PROJECT TITLE

Sherman Plaza


2830 Dryden Drive Madison, Wisconsin


Fire Department
Access Plan

SHEET NUMBER

C-1.3



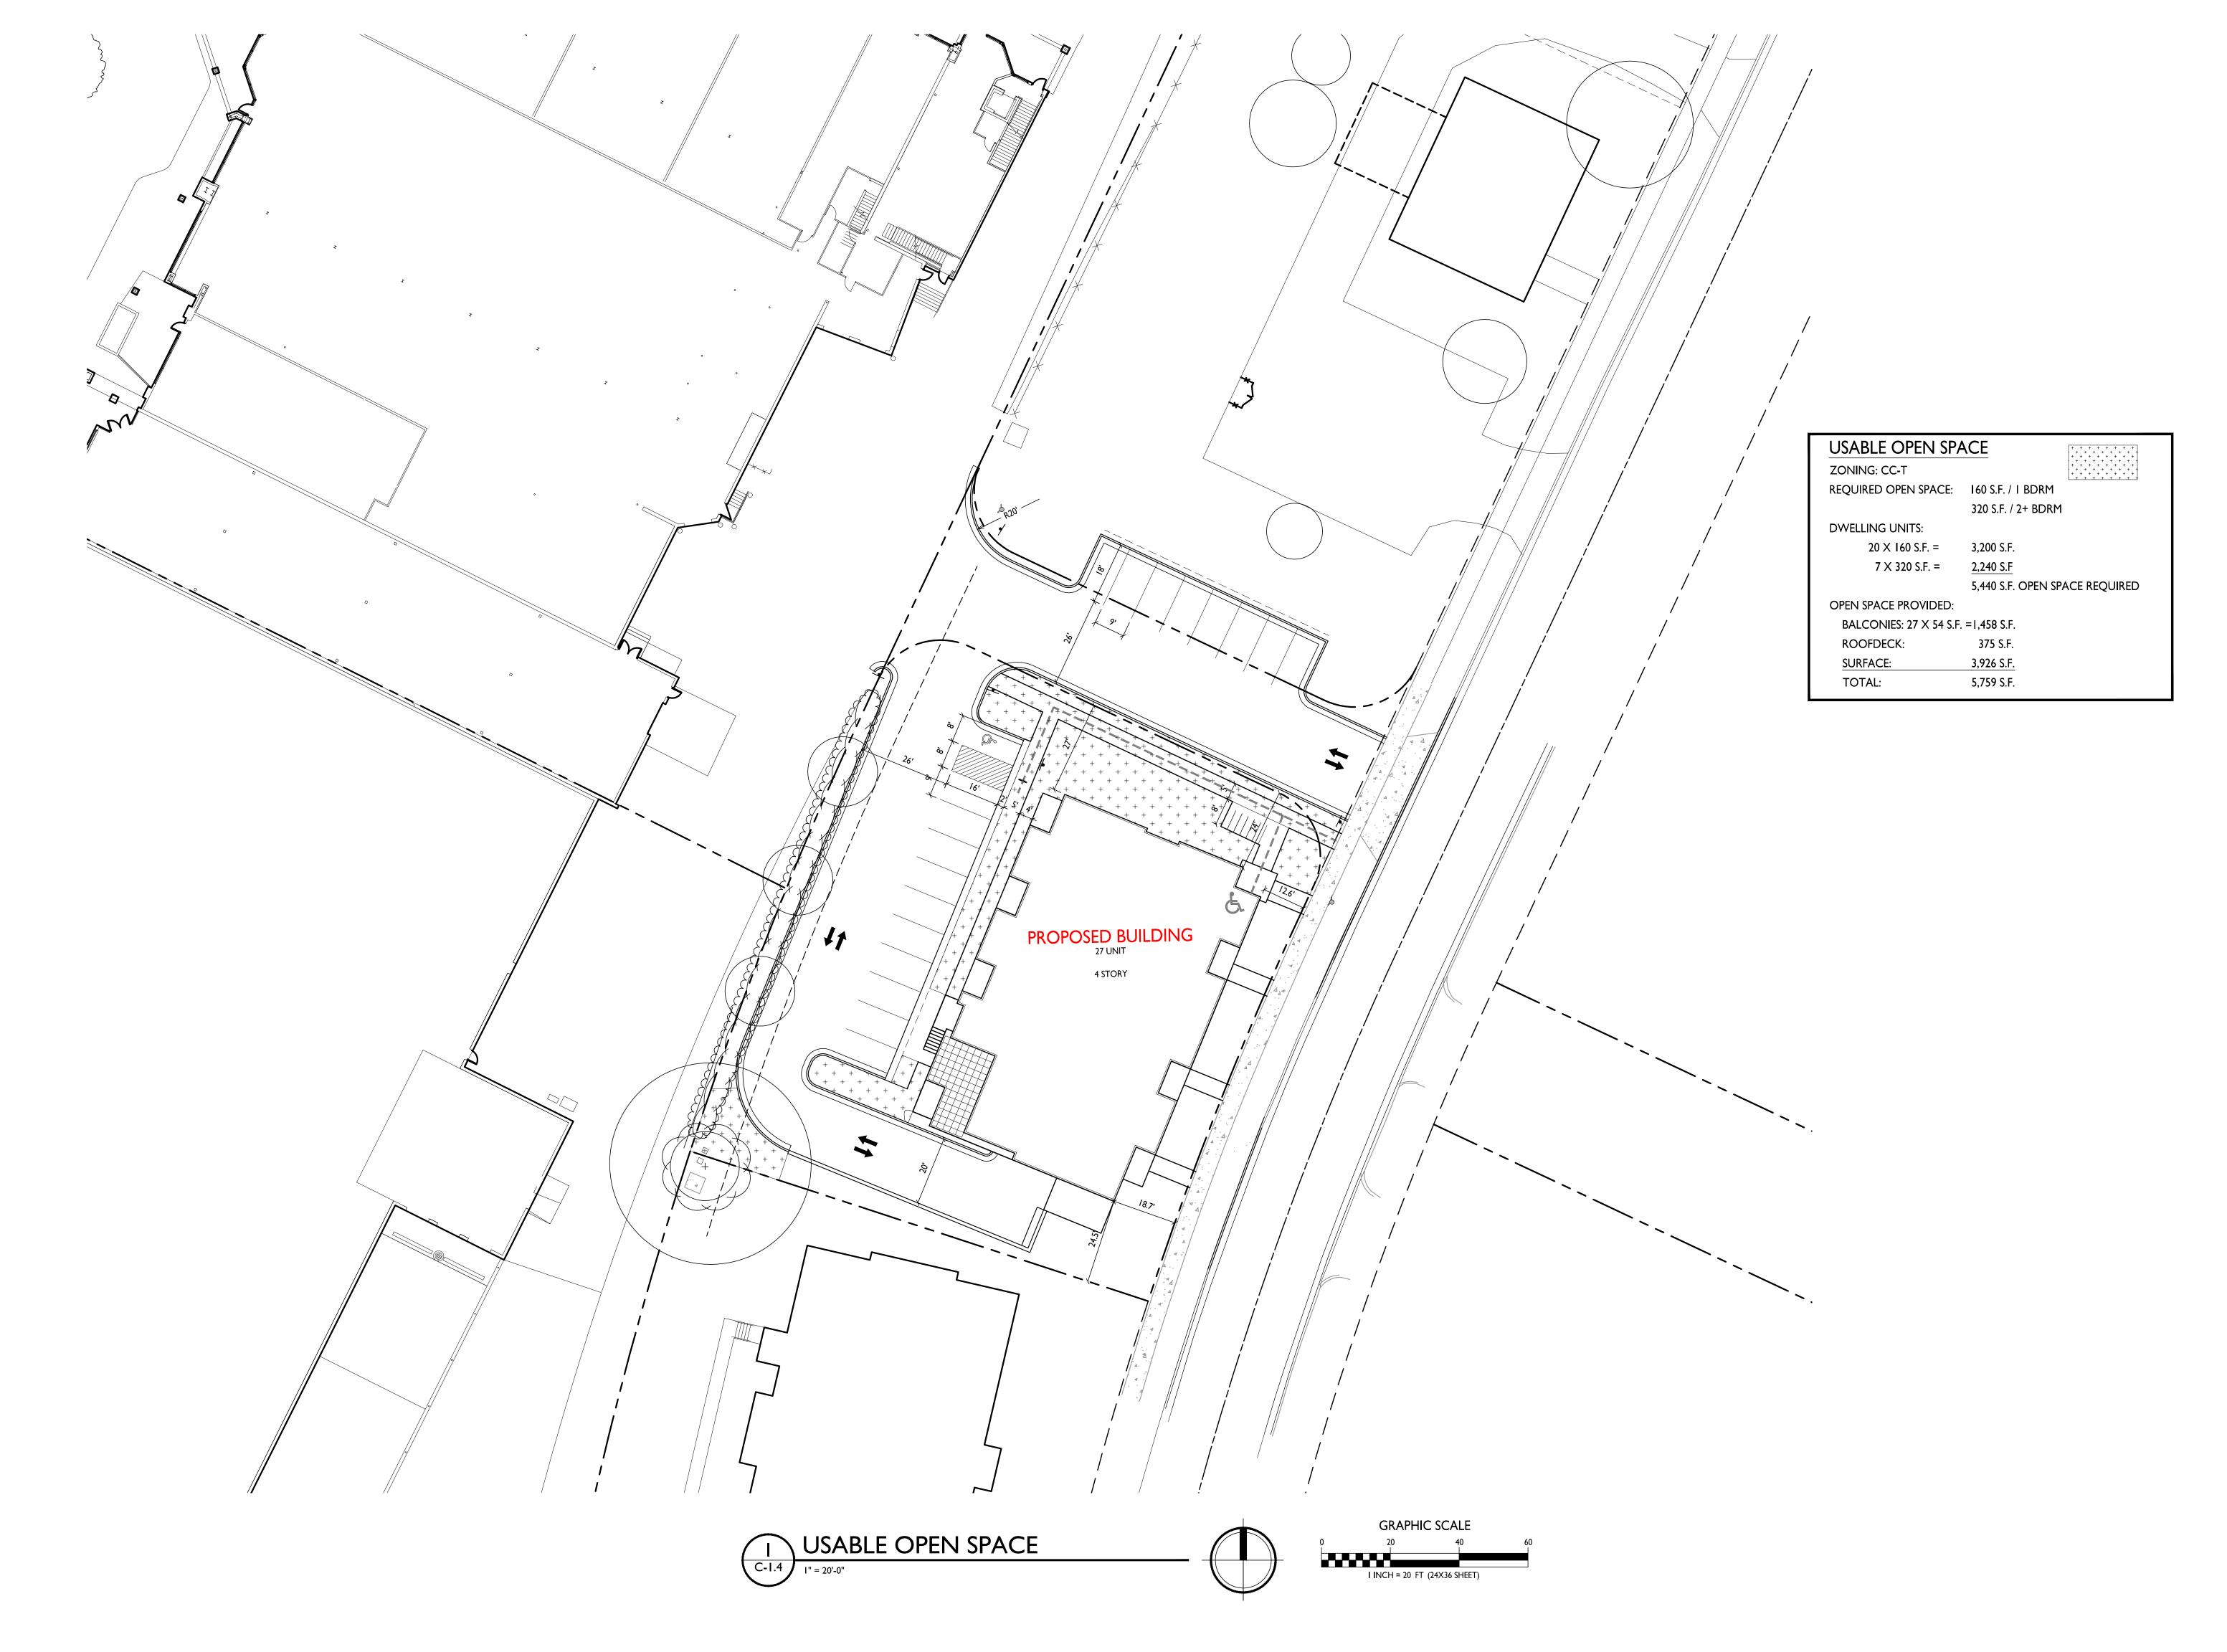

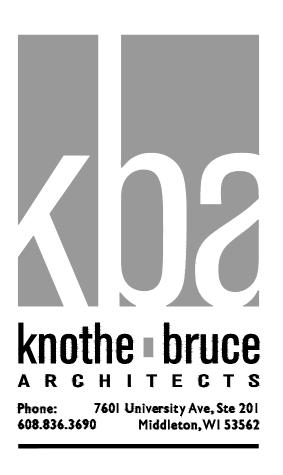

SSUED

Issued for Land Use Submittal - June 12, 2019

PROJECT TITLE


Sherman Plaza

2830 Dryden Drive Madison, Wisconsin

SHEET TITLE
Usable Open
Space

SHEET NUMBER

C-1.4

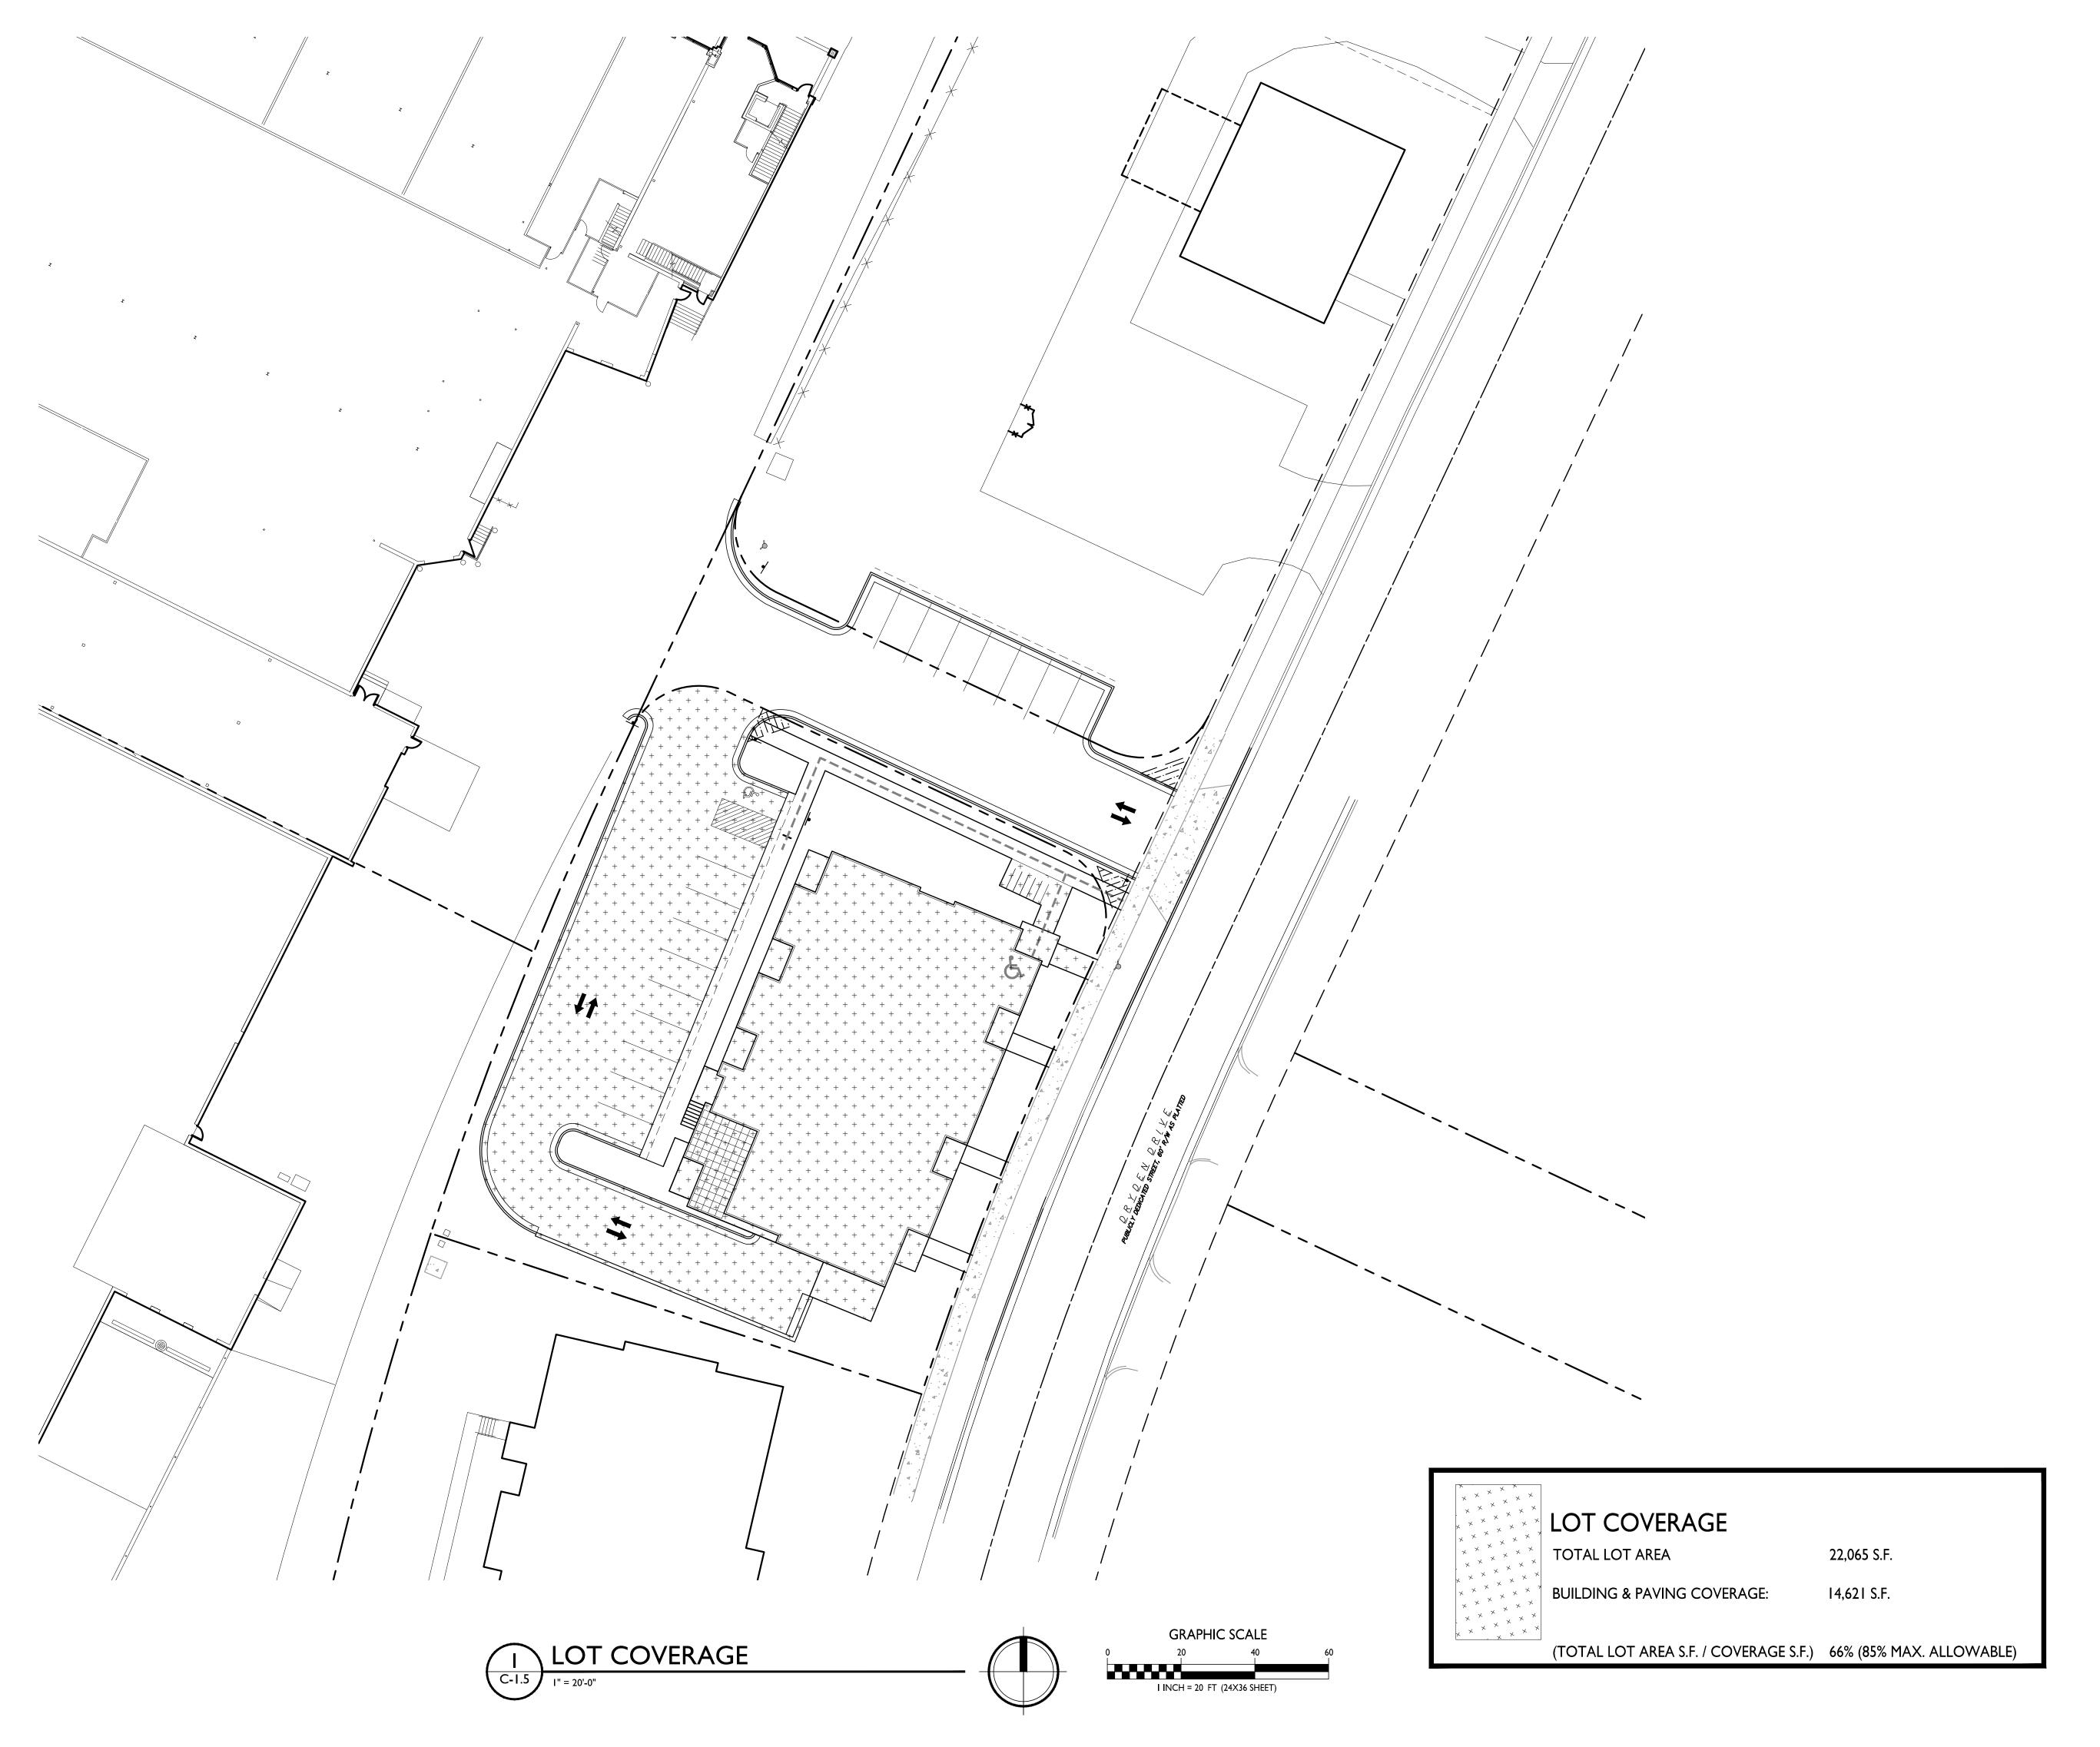



PROJECT TITLE

Sherman Plaza

2830 Dryden Drive Madison, Wisconsin

SHEET TITLE

Lot Coverage

SHEET NUMBER

C-1.5

SURVEY LEGEND

---- 6 ---- EXISTING GAS LINE

EXISTING EDGE OF BUSHES

— — 820 — — EXISTING MAJOR CONTOUR

--- 818 --- EXISTING MINOR CONTOUR

EXISTING CURB INLET

EXISTING FIELD INLET

TEXISTING FIRE HYDRANT

Contraction

EXISTING LIGHT POLE

EXISTING GAS METER

EXISTING BOLLARD

EXISTING SIGN

CURVE TABLE

C1 | 144.42' | 1163.93' | 7°06'34" | N22°45'40"E | 144.33' C2 | 31.44' | 20.00' | 90°03'54" | N69°50'18"E | 28.30'

C3 | 32.25' | 20.00' | 92°23'13" | S18°57'49"E | 28.87'

C4 | 127.12' | 1023.93' | 7°06'48" | S22°45'32"W | 127.04 C5 | 217.48' | 1023.93' | 12°10'10" | S13°07'03"W | 217.07

C6 | 247.71' | 1163.93' | 1241'38" | N13406'34"E | 247.24'

C7 | 31.54' | 20.00' | 90°21'29" | N72°22'35"E | 28.37'

C9 | 81.18' | 1163.93' | 3*59'45" | N21*12'16"E | 81.16' C10 | 63.25' | 1163.93' | 3°06'48" | N24*45'33"E | 63.24'

45.02' | 963.93' | 2°40'33" | S24°58'40"W | 45.01'

Dial or (800) 242-8511

www.DiggersHotline.com

RADIUS

CENTRAL ANGLE

CURVE ARC NUMBER LENGTH

▼ EXISTING TRANSFORMER

S EXISTING SANITARY MANHOLE

EXISTING WATER MAIN VALVE

- FOUND 3/4" Ø IRON ROD
- ◎ FOUND 1" Ø IRON PIPE

TOPOGRAPHIC LINEWORK LEGEND

---- UE ---- EXISTING UNDERGROUND ELECTRIC LINE

—— UT —— UT —— EXISTING UNDERGROUND TELEPHONE

— SAN 8 — SAN 8 — EXISTING 8" SANITARY SEWER LINE

--- PROPERTY BOUNDARY

TOPOGRAPHIC HATCHING LEGEND

CONCRETE SIDEWALK

ASPHALT PAVEMENT

TOPOGRAPHIC SYMBOL LEGEND

M EXISTING AIR CONDITIONING PEDESTAL

EXISTING UNIDENTIFIED UTILITY VAULT

CHORD CHORD DIRECTION LENGTH

■ EXISTING TELEPHONE PEDESTAL

EXISTING DECIDUOUS TREE

EXISTING HANDICAP PARKING

--- WM8 ---- WM8 --- EXISTING 8" D.I. WATER MAIN

<u>Ö</u> • —

onditions 2830 D City of Dane (

> 24x36 - 1:20 11x17 - 1:40

6/12/2019

JNOR CHECKED

JKAS

PROJECT NO. 190139

1 OF 4 DWG. NO.

C - 1.0

CALL DIGGER'S HOTLINE 1-800-242-8511

AND PRESERVE ANY AND ALL UTILITIES.

THE LOCATION OF EXISTING UTILITIES, BOTH UNDERGROUND


AND OVERHEAD ARE APPROXIMATE ONLY AND HAVE NOT BEEN INDEPENDENTLY VERIFIED BY THE OWNER OR ITS REPRESENTATIVE.

EXACT LOCATION OF ALL EXISTING UTILITIES WHETHER SHOWN

THE CONTRACTOR SHALL BE RESPONSIBLE FOR DETERMINING THE

ON THESE PLANS OR NOT, BEFORE COMMENCING WORK, AND SHALL BE FULLY RESPONSIBLE FOR ANY AND ALL DAMAGES WHICH MIGHT

BE CAUSED BY THE CONTRACTOR'S FAILURE TO EXACTLY LOCATE

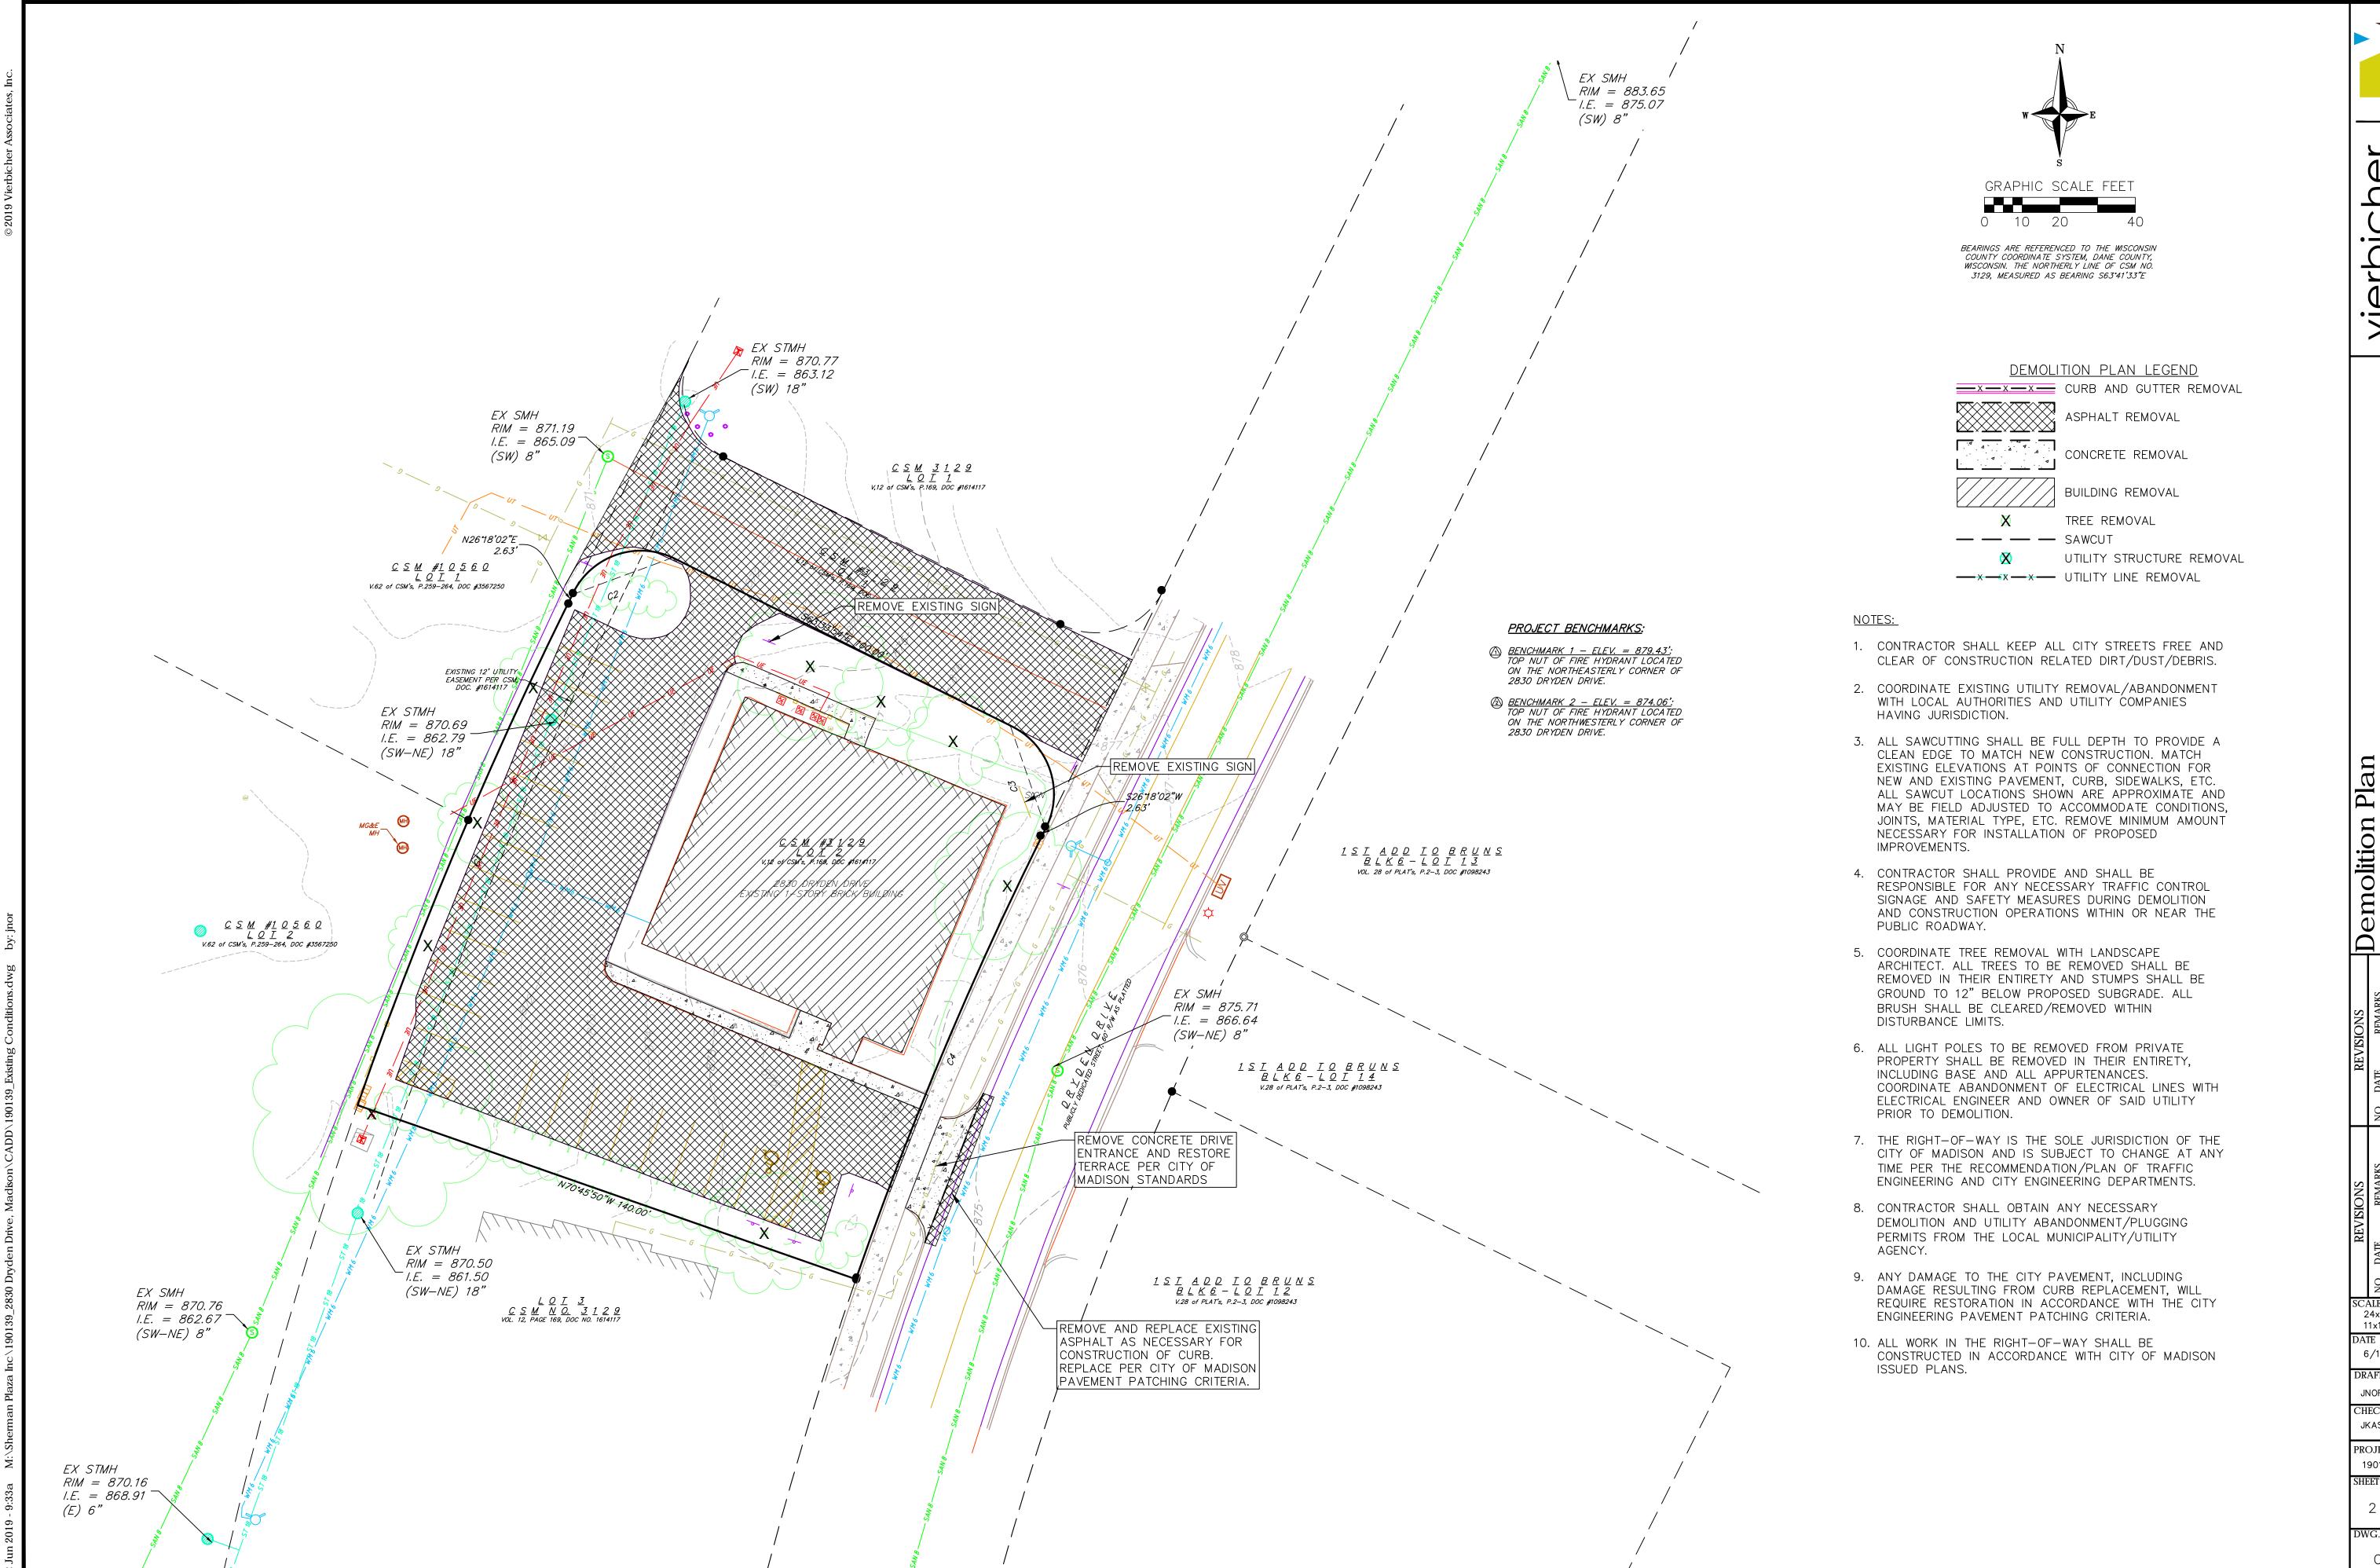

vierbic

Demo 2830 Dr City of I Dane C

24x36 - 1:20 11x17 - 1:40

6/12/2019 DRAFTER


JNOR CHECKED

JKAS PROJECT NO. 190139

2 OF 4

C - 2.0

DWG. NO.

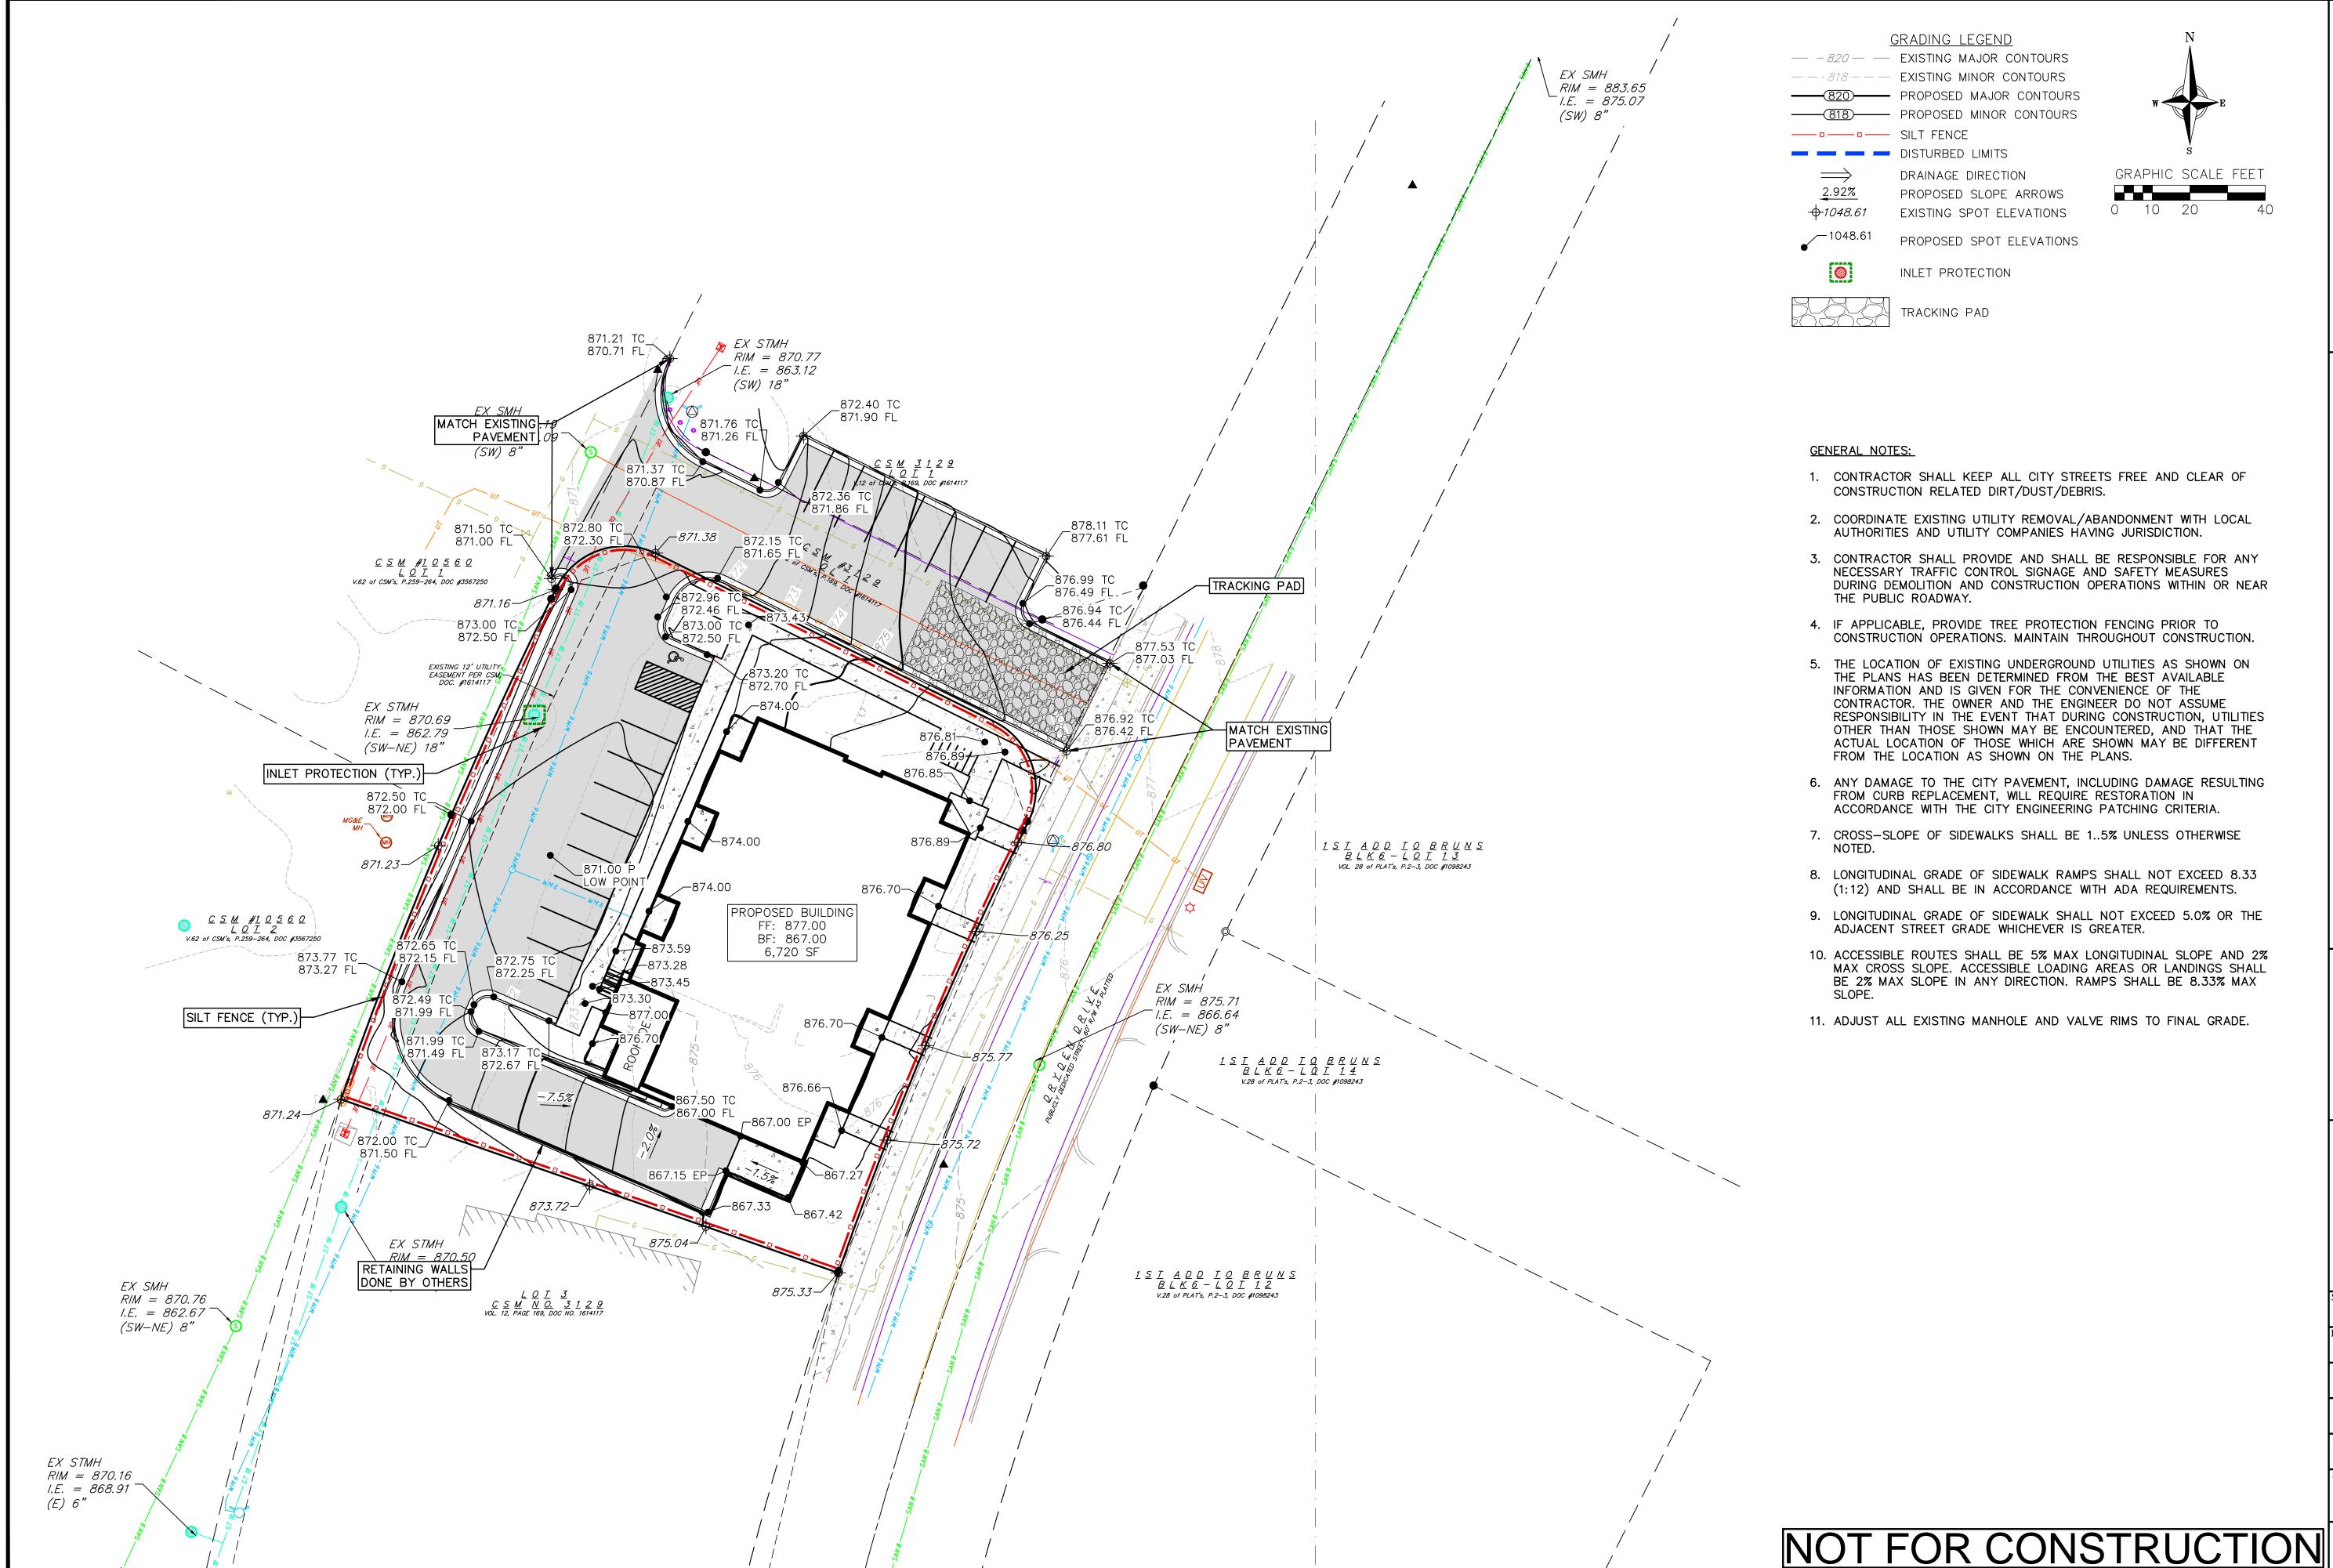

- 2. COORDINATE EXISTING UTILITY REMOVAL/ABANDONMENT WITH LOCAL
- 3. CONTRACTOR SHALL PROVIDE AND SHALL BE RESPONSIBLE FOR ANY DURING DEMOLITION AND CONSTRUCTION OPERATIONS WITHIN OR NEAR
- CONSTRUCTION OPERATIONS. MAINTAIN THROUGHOUT CONSTRUCTION
- RESPONSIBILITY IN THE EVENT THAT DURING CONSTRUCTION, UTILITIES OTHER THAN THOSE SHOWN MAY BE ENCOUNTERED, AND THAT THE ACTUAL LOCATION OF THOSE WHICH ARE SHOWN MAY BE DIFFERENT
- 6. ANY DAMAGE TO THE CITY PAVEMENT, INCLUDING DAMAGE RESULTING

- MAX CROSS SLOPE. ACCESSIBLE LOADING AREAS OR LANDINGS SHALL BE 2% MAX SLOPE IN ANY DIRECTION. RAMPS SHALL BE 8.33% MAX

erbi


Grading 2830 Dryden City of Madi Dane Count SCALE 24x36 - 1:20 11x17 - 1:40 6/12/2019


JNOR CHECKED JKAS


PROJECT NO. 190139

3 OF 4

C - 3.0

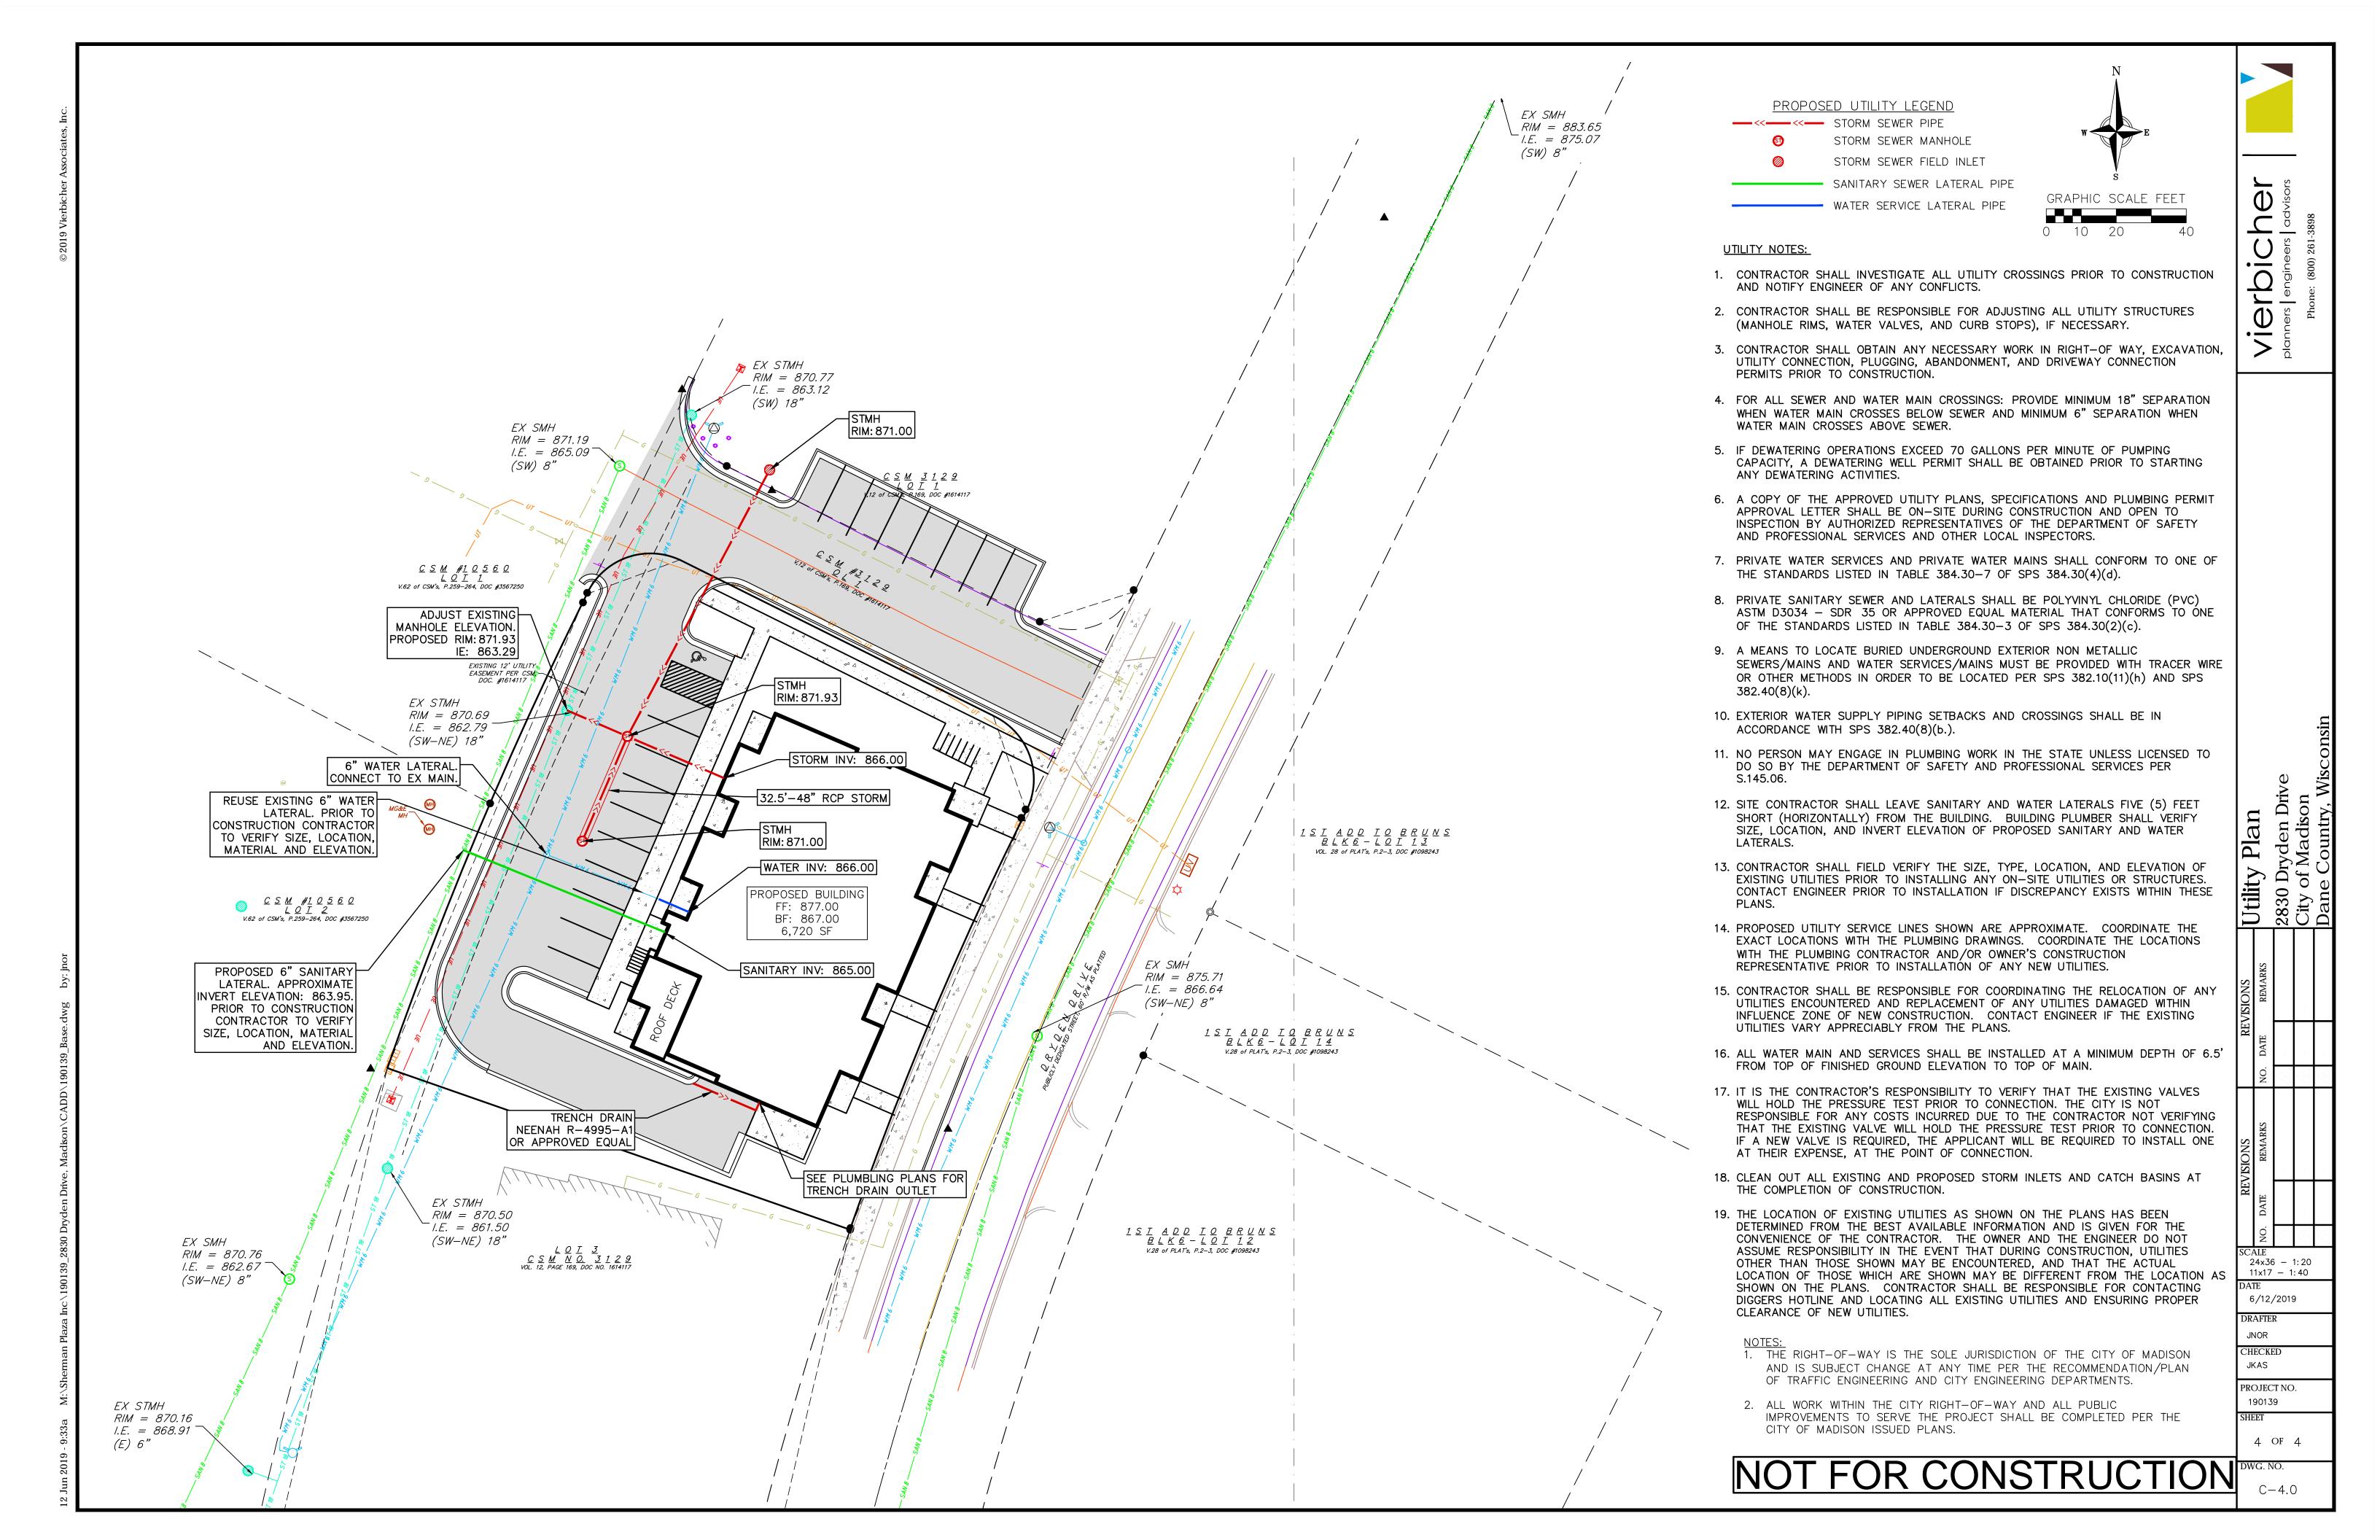

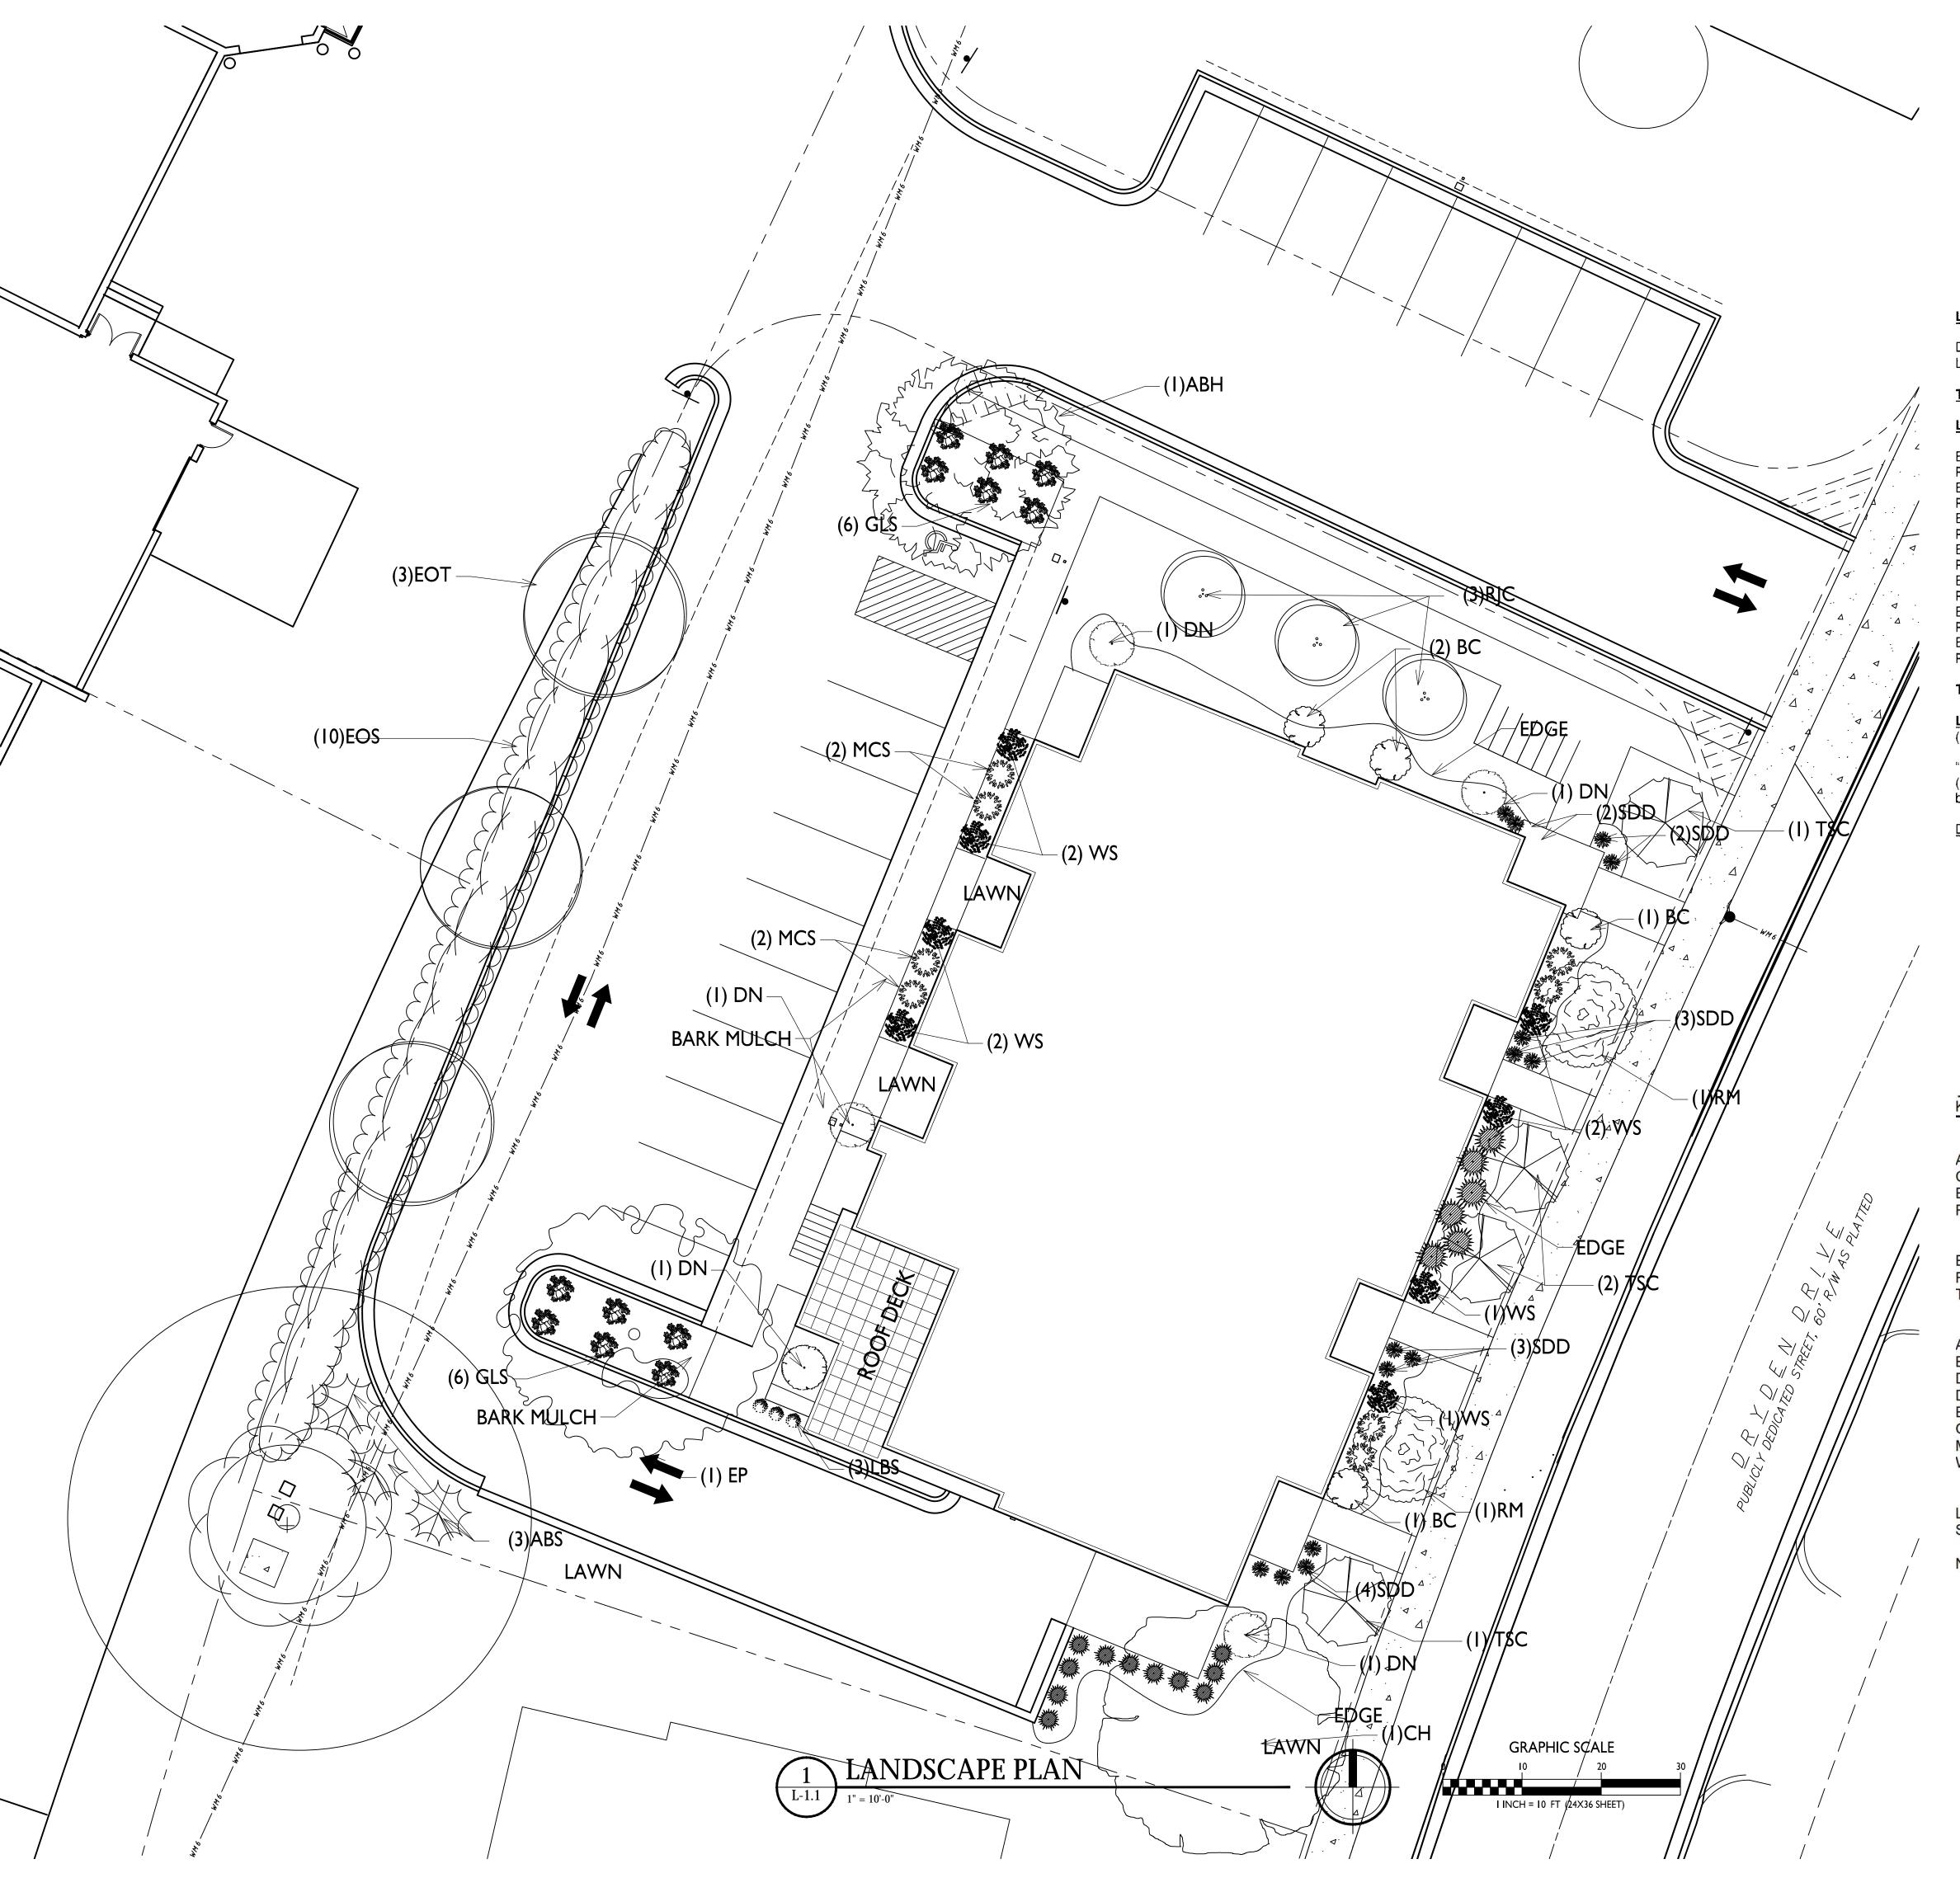

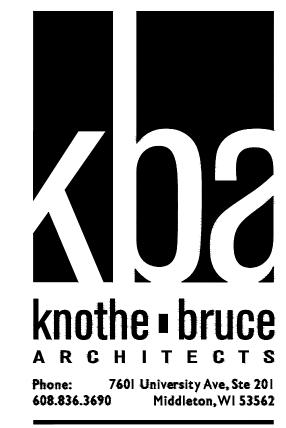

LANDSCAPE WORKSHEET Dryden Drive

Landscape Points Required

Developed Area = Landscape Points: 9,213/300 x 5 =	9,213 SF <u>154 points</u>
Total Landscape Points Required	154 points
Landscape Points Supplied	
Existing canopy trees – 0 @ 35 = Proposed canopy trees - 6 @ 35 = Existing evergreen trees – 0 @ 35 = Proposed evergreen trees – 0 @ 35 Existing ornamental trees - 3 @ 15 =	·

Proposed ornamental trees -8 @ 15 = 120 points Existing upright evergreen shrubs – 0 @ 10 = Proposed upright evergreen shrubs – 0 @ 10 = Existing deciduous shrubs – 11 @ 3 = 0 points 0 points 33 points Proposed deciduous shrubs - 40 @ 3 = 120 points Existing evergreen shrubs – 0 @ 4 = Proposed evergreen shrubs – 0 @ 4 = 0 points 0 points Existing perennials & grasses 0 @ 2 = 0 points Proposed perennials & grasses 12 @ 2 = 24 points

Total landscape points supplied = 552 points

Lot Frontage Landscape Required
(Section 28.142(5) Development Frontage Landscaping)

"One (1) over-story deciduous tree and five (5) shrubs shall be planted for each thirty (30) lineal feet of lot frontage. Two (2) ornamental trees or two (2) evergreen trees may be used in place of one (1) over-story deciduous tree."

<u>Dryden Drive</u> =	150 LF

Overstory trees required $150^{\circ}/30^{\circ} = 5$	<u>5 trees</u>
Shrubs required $(150^{\circ}/30^{\circ}) \times 5 = 25.0$	25 shrubs
Over story trees supplied Ornamental/Evergreen trees supplied Shrubs supplied	4 trees 4 trees 25 shrubs

Issued for Land Use Submittal - June 12, 2019

PLANT LIST

KEY (QUAN	SIZE	COMMON NAME	ROOT
ABM CH EP RM	<u>6</u> 1 2 1 2	2 ½" 2 ½" 2 ½" 2 ½"	Canopy trees Autumn Blaze Maple Hackberry Exclamation Planetree Red Maple	BB BB BB
EOT RJC TSC	9 3 4 4	3" + 1 ½" 1 ½"	Ornamental trees Existing crab trees Red Jade Crab Tina Sergeant Crab	EX BB BB
ABS BC DBH DN EDS GLS MCS WS	4 3 4 11 5 10 12 8 8	5' 24" 24" 24" 6' + 18" 18" 24"	Deciduous shrubs Autumn Brilliance Serviceberry Black Chokeberry Dwarf Bush Honeysuckle Diablo Ninebark Existing deciduous shrubs Gro Low Sumac Magic Carpet Spirea White Snowberry	BB Pot Pot EX Pot Pot Pot
LBS SDD	21 9 12	1 G 1 G	Perennials Little Bluestem Grass Stella de Oro Day Lily	Con Con

NOTES:

- 1) Designated lawn areas to be seeded (Madison Parks seed mix), fertilized, and mulched with straw mat.
- 2) Drainage swales and lawns with slopes steeper than 3/1 shall be mulched
- with erosion control fabric (installed per manufacturer's specifications).

 3) Foundation planting beds to be mulched with shredded hardwood bark
- mulch spread to a depth of 3".
- 4) Individual trees and shrub groupings in lawn areas to receive shredded hardwood bark mulch plant rings (4' diameter) spread to a depth of 3"
- 5) Designated planting beds to be separated from lawn areas with 5" black
- vinyl edge.
- 6) Owner will be responsible for landscape maintenance after completion.

PROJECT TITLE Sherman Plaza



2830 Dryden Drive Madison, Wisconsin

SHEET TITLE

Landscape Plan

SHEET NUMBER

PROJECT NO. 1912



PROJECT TITLE

Sherman Plaza

2830 Dryden Drive Madison, Wisconsin

SHEET TITLE


Basement Floor Plan


SHEET NUMBER

A-1.0

PROJECT NO. 1912



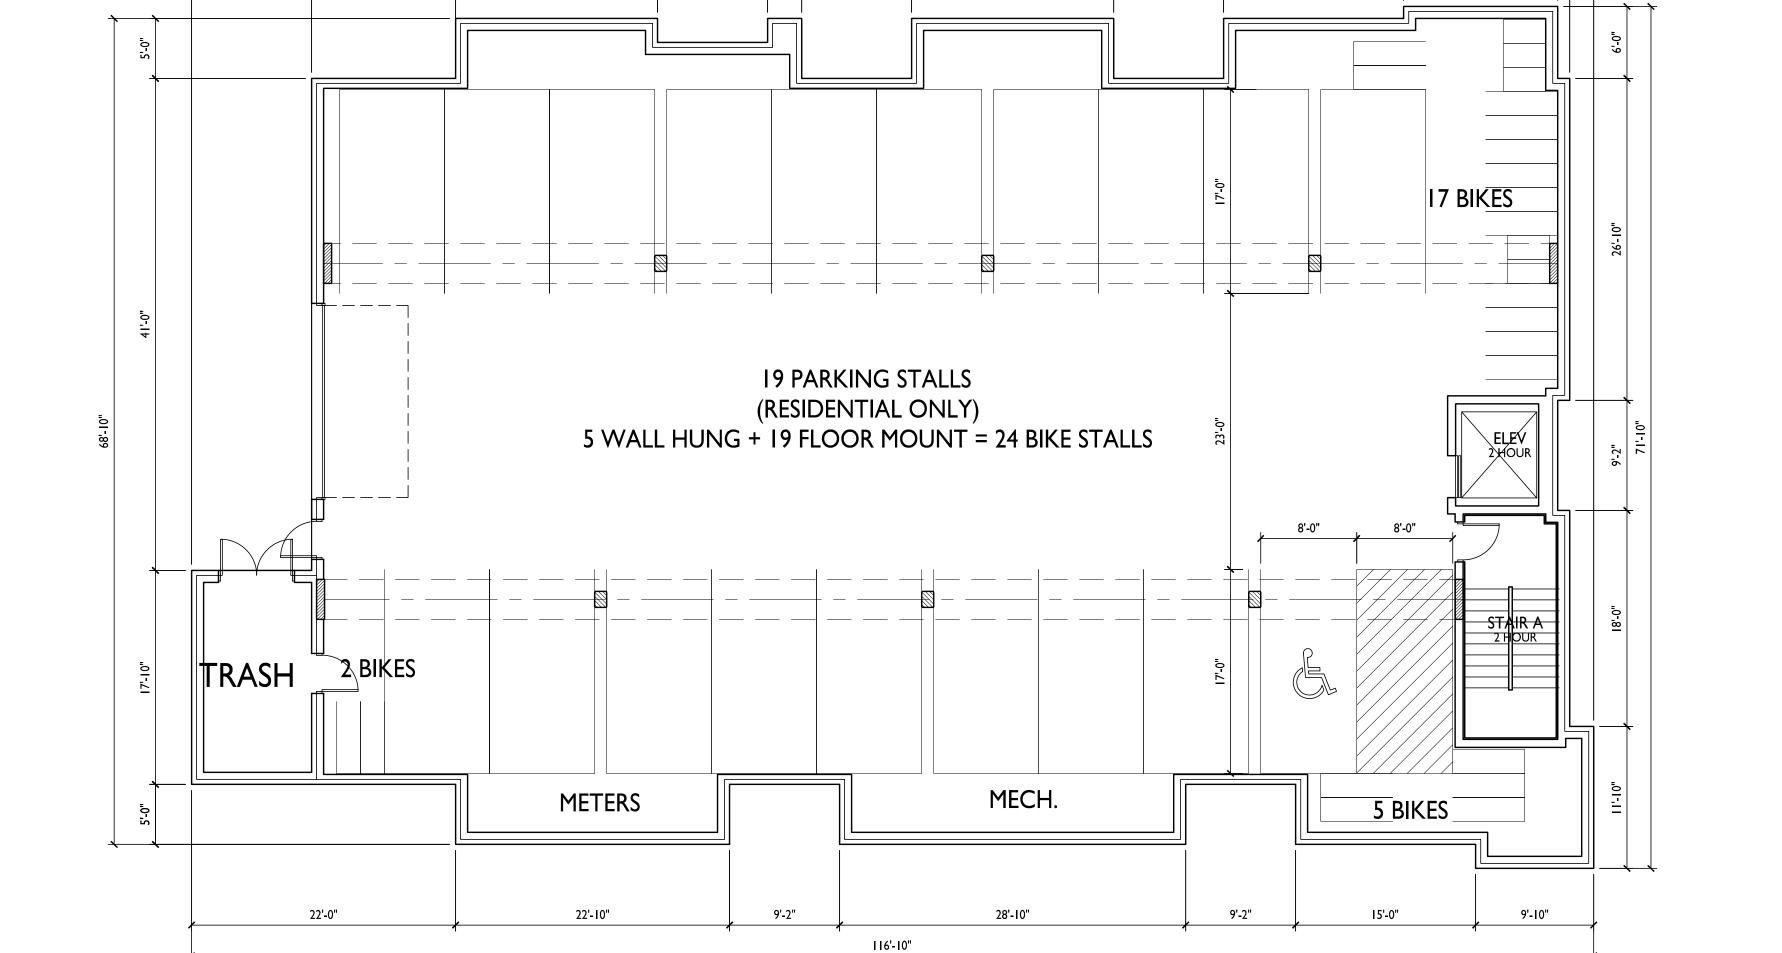

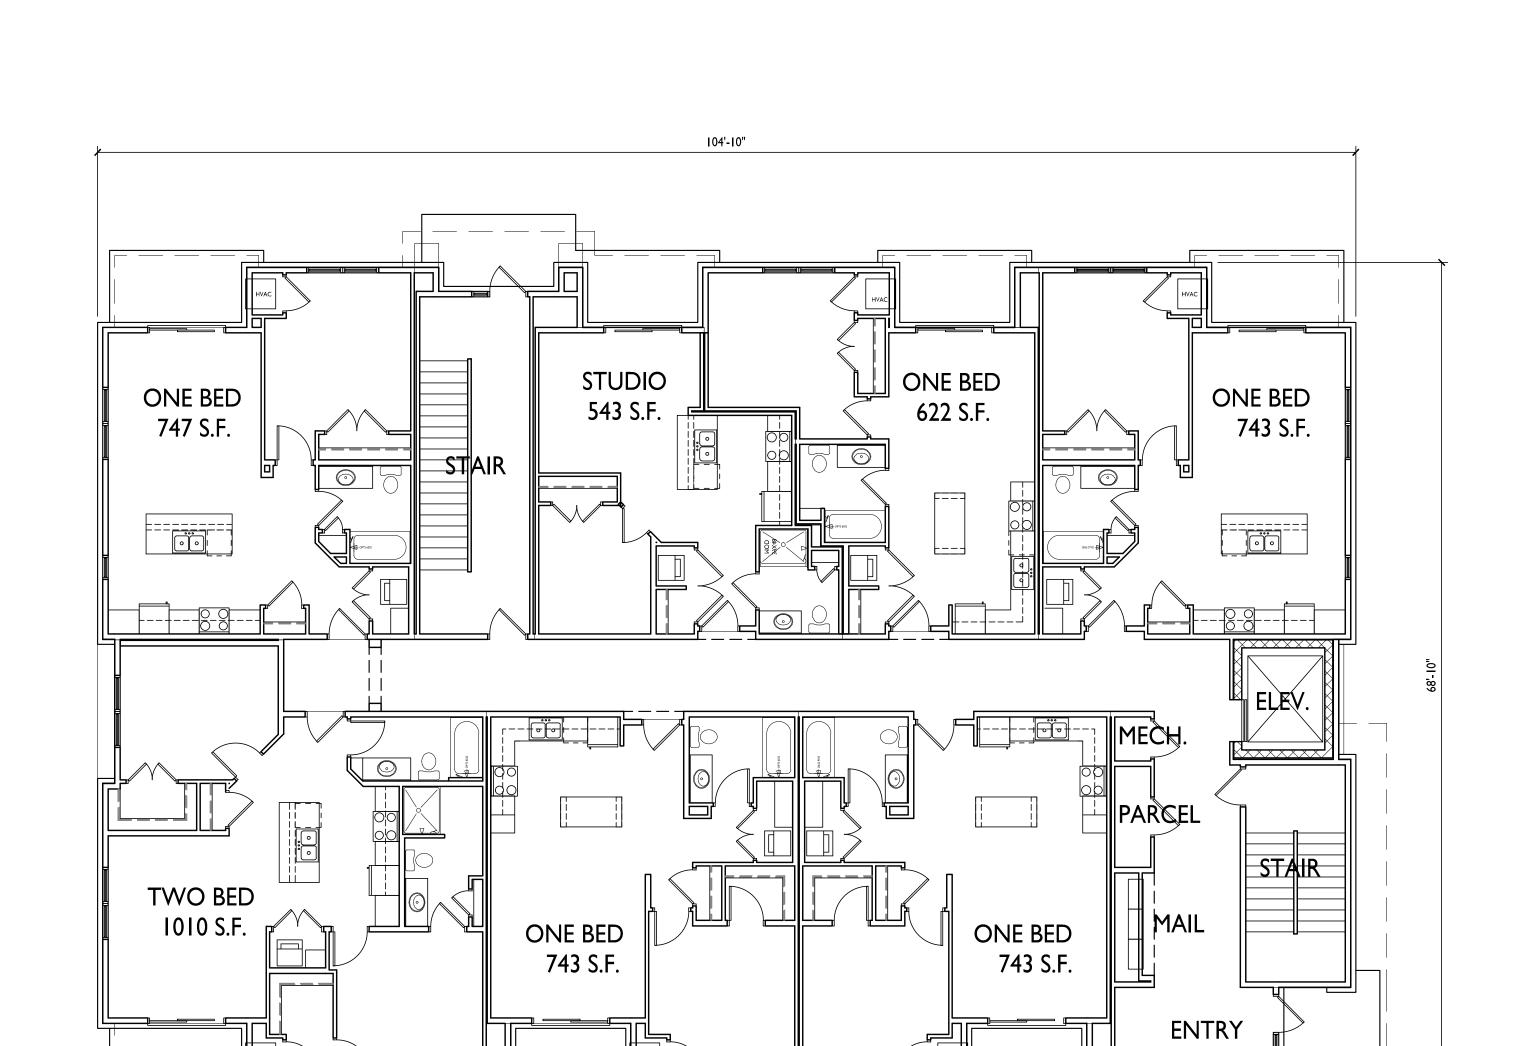



PROJECT TITLE

Sherman Plaza


2830 Dryden Drive Madison, Wisconsin


SHEET TITLE
First Floor Plan


SHEET NUMBER





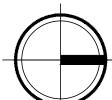

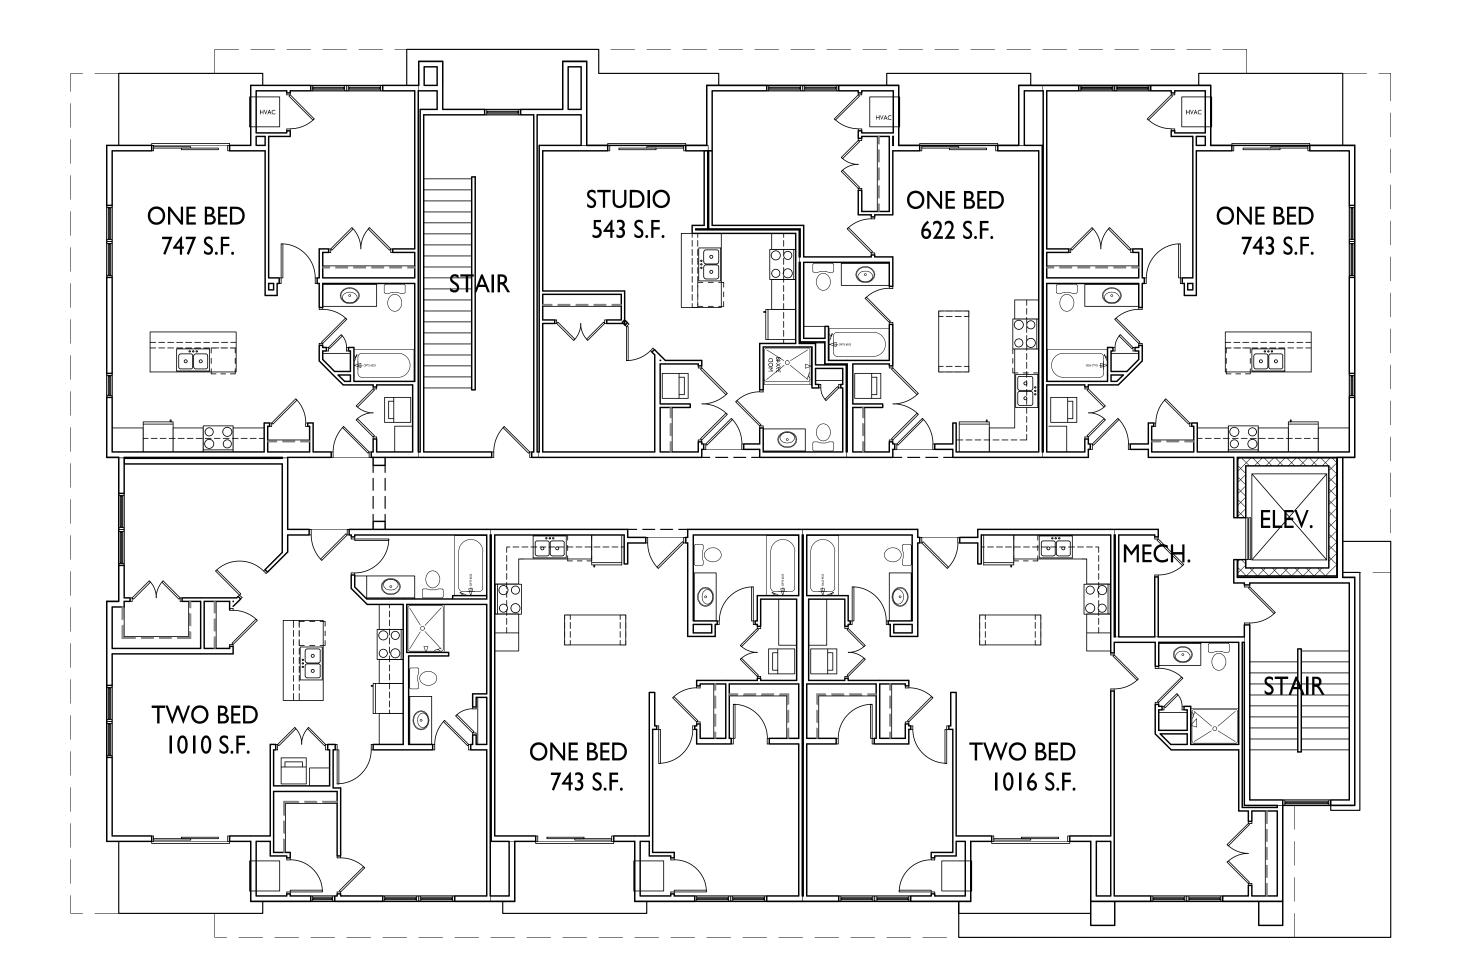

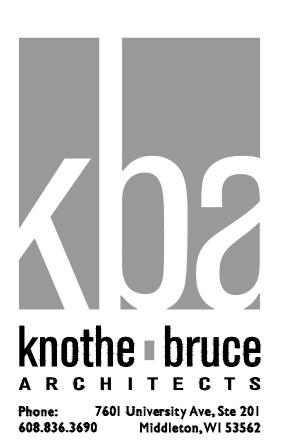

PROJECT TITLE

Sherman Plaza

2830 Dryden Drive Madison, Wisconsin

SHEET TITLE
Second Floor Plan

SHEET NUMBER

A-1.2


© Knothe & Bruce Architects, LLC

1912

PROJECT NO.

SECOND FLOOR PLAN

1/8" = 1'-0"

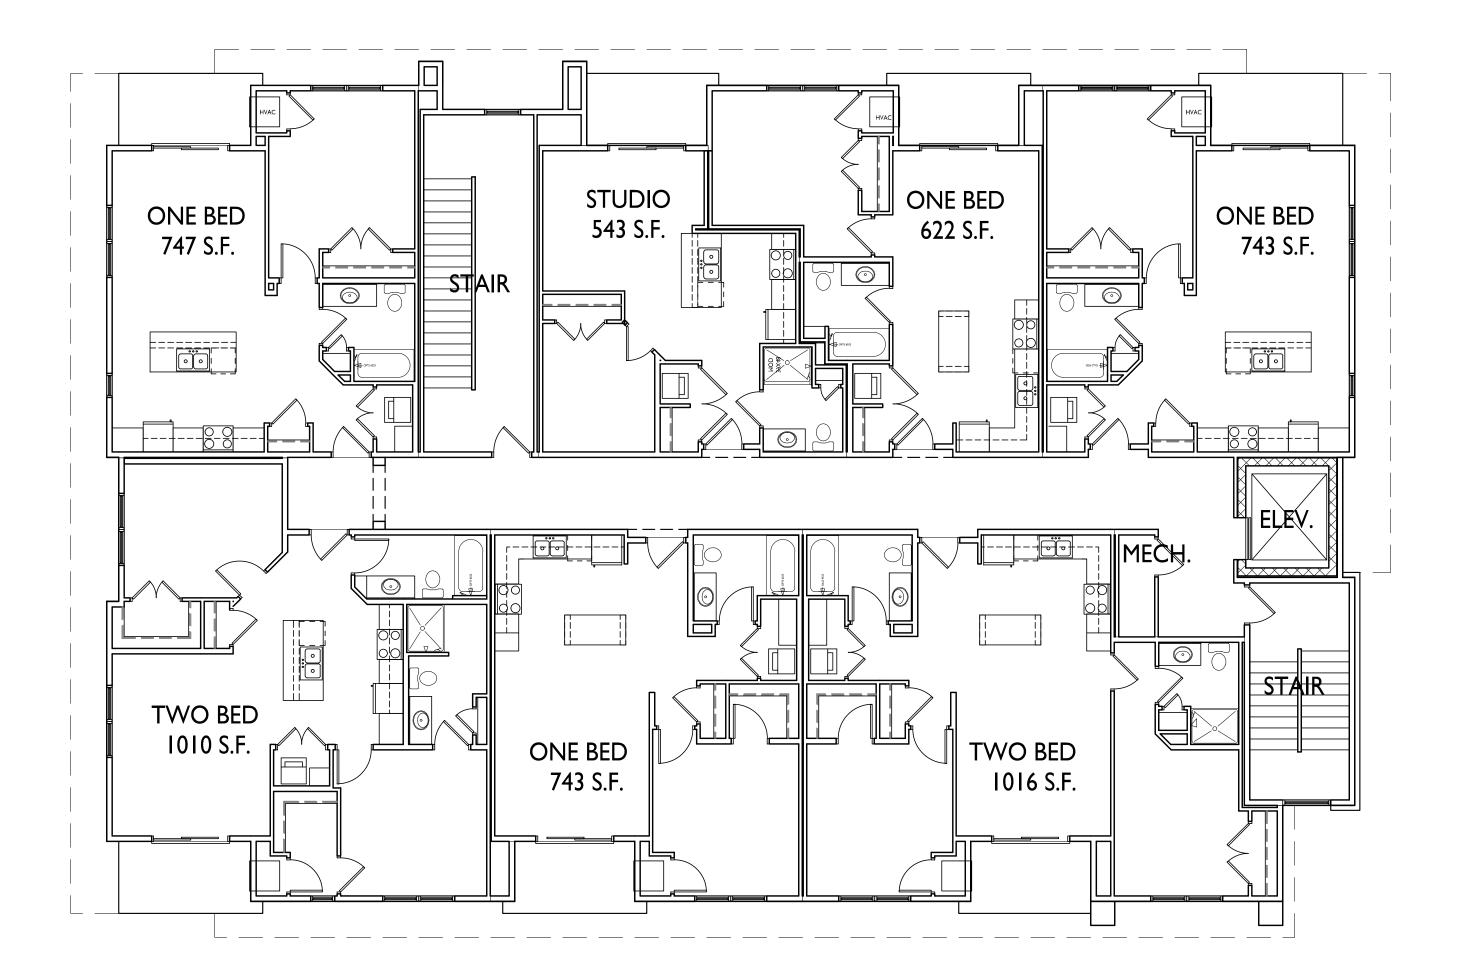



PROJECT TITLE

Sherman Plaza

2830 Dryden Drive Madison, Wisconsin


SHEET TITLE
Third Floor Plan


SHEET NUMBER

A-1.3





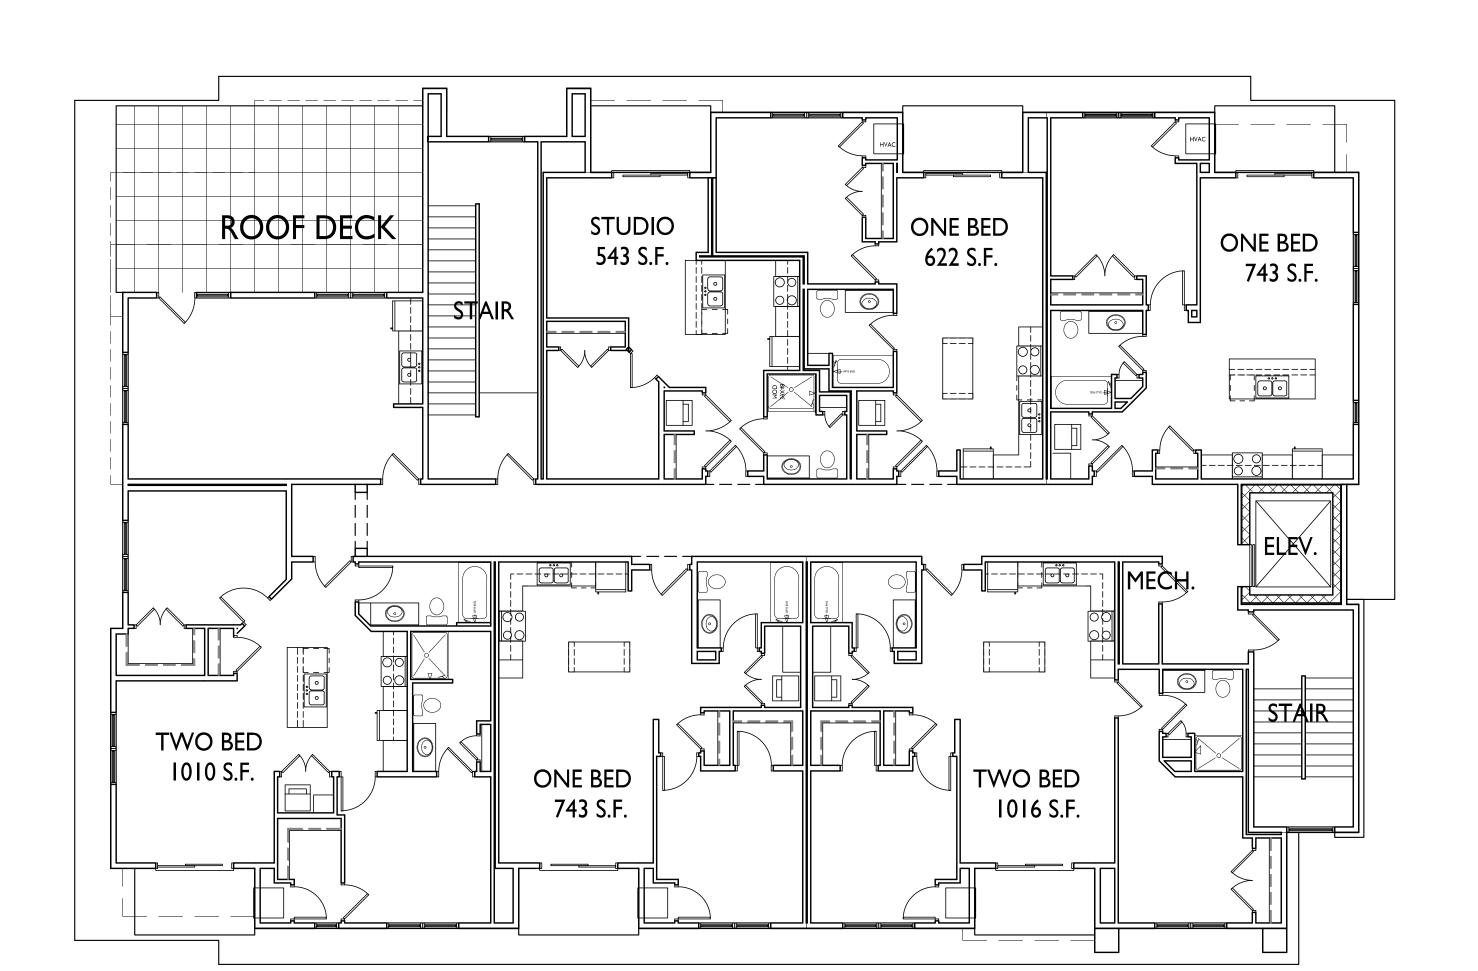

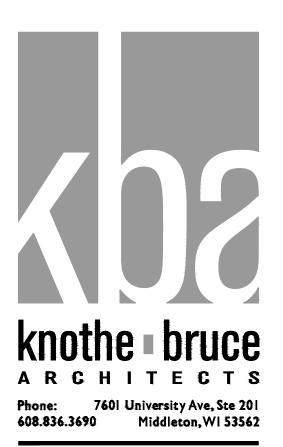

PROJECT TITLE

Sherman Plaza

2830 Dryden Drive Madison, Wisconsin


SHEET TITLE
Fourth Floor Plan

SHEET NUMBER

A-1.4





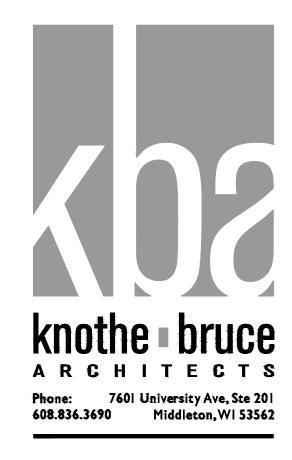

PROJECT TITLE

Sherman Plaza


2830 Dryden Drive Madison, Wisconsin

SHEET TITLE
Roof Plan

SHEET NUMBER

A-1.5

PROJECT NO. 1912

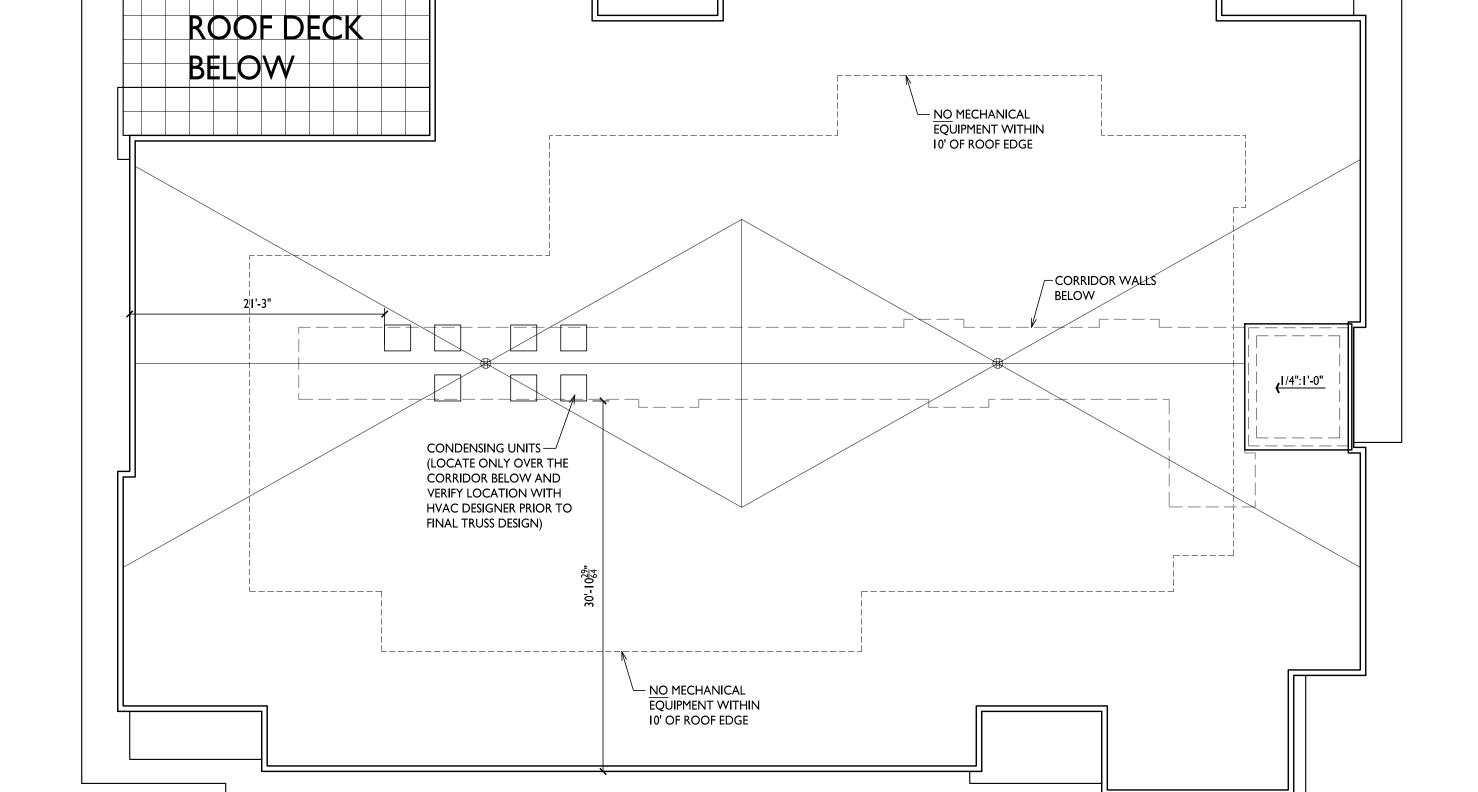









Knothe • bruce
ARCHITECTS
knothebruce.com 608.836.3690
7601 University Ave. • Suite 201 • Middleton, WI 53562

KEY PLAN

ISSUED
Issued for Land Use Submittal - June 12, 2019

NORTHWEST ELEVATION

A-2.1 1/8" = 1'-0"





SOUTHEAST ELEVATION

A-2.1 1/8" = 1'-0"

SOUTHWEST ELEVATION

A-2.1 1/8" = 1'-0"

PROJECT TITLE
SHERMAN
PLAZA

Dryden Drive Madison, WI

Exterior Elevations

SHEET NUMBER

A-2.1

PROJECT NUMBER 1912
© 2015 Knothe & Bruce Architects, LLC





knothe bruce
ARCHITECTS
knothebruce.com
608.836.3690
7601 University Ave. Suite 201 Middleton, WI 53562
KEY PLAN

NORTHWEST ELEVATION - RENDERED

1/8" = 1'-0"



2 SOUTHWEST ELEVATION - RENDERED

PROJECT TITLE
SHERMAN
PLAZA

Dryden Drive Madison, WI

Exterior
Elevations Rendered

SHEET NUMBER

PROJECT NUMBER 1912
© 2015 Knothe & Bruce Architects, LLC



SHERMAN PLAZA

Dryden Drive Madison, WI Rendered Perspective 1





SHERMAN PLAZA

Dryden Drive Madison, WI Rendered Perspective 2

