URBAN DESIGN COMMISSION APPLICATION

FOR OFFICE USE ONLY:

City of Madison Planning Division Madison Municipal Building, Suite 017 215 Martin Luther King, Jr. Blvd. P.O. Box 2985 Madison, WI 53701-2985 (608) 266-4635

Complete all sections of this application, including the desired meeting date and the action requested.

If you need an interpreter, translator, materials in alternate formats or other accommodations to access these forms, please call the phone number above immediately.

| Paid | Receipt # |
|-----------------------|-----------|
| Date received | |
| Received by | |
| Aldermanic District | |
| Zoning District | |
| Urban Design District | |
| Submittal reviewed by | |
| Legistar # | |

1. Project Information

Address: 1322 East Washington Avenue

Title: Valor on Washington

2. Application Type (check all that apply) and Requested Date

- UDC meeting date requested _____June 12, 2019
- New development
- Alteration to an existing or previously-approved development
- Informational

3. Project Type

- District Project in an Urban Design District
- Project in the Downtown Core District (DC), Urban Mixed-Use District (UMX), or Mixed-Use Center District (MXC)
- Project in the Suburban Employment Center District (SEC), Campus Institutional District (CI), or Employment Campus District (EC)
- Planned Development (PD)
 - General Development Plan (GDP)
 - Specific Implementation Plan (SIP)
- Planned Multi-Use Site or Residential Building Complex

4. Applicant, Agent, and Property Owner Information

| Applicant name | Ben Marshall | Company Gorman & Company, LLC |
|--------------------|---------------------------------------|--------------------------------------|
| Street address | 200 N. Main St | City/State/Zip Oregon, WI 53575 |
| Telephone | (608)835-3900 | Email _ bmarshall@gormanusa.com |
| Project contact pe | rson Mark Smith | Company Gorman & Company, LLC |
| Street address | 200 N. Main St | City/State/Zip Oregon, WI 53575 |
| Telephone | (608)835-3900 | Email <u>marksmith@gormanusa.com</u> |
| Property owner (in | f not applicant) <u>County of Dar</u> | ne, Wisconsin |
| | 210 Mortin Luther Ving Ir | Plud ou to the Madicon M/LE2702 |

| Street address | 210 Martin Luther King Jr. Blvd | City/State/ZipMadison, WI 53703 |
|----------------|---------------------------------|---------------------------------|
| Telephone | (608)266-4941 | Email Violante@countyofdane.com |

Signage

- Comprehensive Design Review (CDR)
- Signage Variance (i.e. modification of signage height, area, and setback)

Other

Please specify

I Final approval

Urban Design Commission Application (continued)

5. Required Submittal Materials

- Application Form
- Letter of Intent
 - If the project is within an Urban Design District, a summary of how the development proposal addresses the district criteria is required
 - For signage applications, a summary of how the proposed signage is consistent with the applicable CDR or Signage Variance review criteria is required.
- Development plans (Refer to checklist on Page 4 for plan details)
- Filing fee (Previously paid)
- Electronic Submittal*

Both the paper copies and electronic copies <u>must</u> be submitted prior to the application deadline before an application will be scheduled for a UDC meeting. Late materials will not be accepted. A completed application form is required for each UDC appearance.

For projects also requiring Plan Commission approval, applicants must also have submitted an accepted application for Plan Commission consideration prior to obtaining any formal action (initial or final approval) from the UDC. All plans must be legible when reduced.

*Electronic copies of all items submitted in hard copy are required. Individual PDF files of each item submitted should be compiled on a CD or flash drive, or submitted via email to <u>udcapplications@cityofmadison.com</u>. The email must include the project address, project name, and applicant name. Electronic submittals via file hosting services (such as Dropbox.com) are not allowed. Applicants who are unable to provide the materials electronically should contact the Planning Division at (608) 266-4635 for assistance.

6. Applicant Declarations

- Prior to submitting this application, the applicant is required to discuss the proposed project with Urban Design Commission staff. This application was discussed with <u>Janine Glaeser</u> on June 1, 2018
- The applicant attests that all required materials are included in this submittal and understands that if any required information is not provided by the application deadline, the application will not be placed on an Urban Design Commission agenda for consideration.

| Name of applicant Gorman & Company, LLC | NK | Relationship to prop | erty P | rope | rty under contract | |
|--|---------------------|----------------------|--------|------|--------------------|--|
| Ben Marshall, Direct Authorizing signature of property owner Dane County: | IOI OF AICHILECIULE | ishente . | Date | 1000 | 19 | |
| Todd Violante, | Planning & Der | elopment Dept Direct | or | | 1 | |

7. Application Filing Fees

Fees are required to be paid with the first application for either initial or final approval of a project, unless the project is part of the combined application process involving the Urban Design Commission in conjunction with Plan Commission and/or Common Council consideration. Make checks payable to City Treasurer. Credit cards may be used for application fees of less than \$1,000.

Please consult the schedule below for the appropriate fee for your request:

- (Previously Paid) Urban Design Districts: \$350 (per §35.24(6) MGO).
- Minor Alteration in the Downtown Core District (DC) or Urban Mixed-Use District (UMX) : \$150 (per §33.24(6)(b) MGO)
- Comprehensive Design Review: \$500 (per §31.041(3)(d)(1)(a) MGO)
- Minor Alteration to a Comprehensive Sign Plan: \$100 (per §31.041(3)(d)(1)(c) MGO)
- All other sign requests to the Urban Design Commission, including, but not limited to: appeals from the decisions of the Zoning Administrator, requests for signage variances (i.e. modifications of signage height, area, and setback), and additional sign code approvals: \$300 (per §31.041(3)(d)(2) MGO)

A filing fee is not required for the following project applications if part of the combined application process involving both Urban Design Commission and Plan Commission:

- Project in the Downtown Core District (DC), Urban Mixed-Use District (UMX), or Mixed-Use Center District (MXC)
- Project in the Suburban Employment Center District (SEC), Campus Institutional District (CI), or Employment Campus District (EC)
- Planned Development (PD): General Development Plan (GDP) and/or Specific Implementation Plan (SIP)
- Planned Multi-Use Site or Residential Building Complex

Each submittal must include fourteen (14) 11" x 17" <u>collated</u> paper copies. Landscape and Lighting plans (if required) must be <u>full-sized and legible</u>. Please refrain from using plastic covers or spiral binding.





P: (608) 835-3900 F: (608) 835-3922

REAL ESTATE DEVELOPMENT

MILWAUKEE MIAMI PHOENIX CHICAGO DENVER

May 8, 2019

Janine Glaeser, UDC Secretary City of Madison 215 Martin Luther King, Jr. Blvd Madison, WI 53703

Re: Letter of Intent **Urban Design Commission Application - Final** Valor on Washington: 1322 East Washington Avenue

Project Intent:

Valor on Washington is the result of a unique public-private partnership with the goal of providing quality affordable housing, services, and support targeted to Veteran families. Valor is located on E. Washington Avenue in the Tenney-Lapham neighborhood, close to schools, parks, and downtown. The development will contribute to the recent revitalization of the East Washington Corridor and provide much-needed affordable housing for families.

Valor on Washington is a mixed-use development that will feature a ground floor location for a Veterans service provider. The upper floors include 59 apartment units total, consisting of two- and threebedroom units. Valor on Washington will have an on-site leasing office so that residents will have convenient access to property management and maintenance staff. The building will also include a community room, fitness room, storage units, and indoor play area for kids. Apartment units will feature an open concept design with a large kitchen and living space, energy efficient appliances and fixtures, closets and storage spaces, secure entry, high-speed internet and cable hookups, in-unit washer/dryers, and modern finishes. The building will be developed in compliance with accessibility standards of the Fair Housing Act and will include Universal Design features per WHEDA requirements so that units are accessible to residents with disabilities.

An outdoor amenity area will be located to the rear of the site, featuring raised garden beds, a playground area, and outdoor seating space. An outdoor common area patio will provide additional amenity space for residents.

This development provides internal, covered automobile and bicycle parking for residents. A small amount of surface parking is available for the ground floor commercial tenant. Entrance and exit are both on E. Washington Avenue, no traffic is routed onto side streets. The proposed mixed-use building is in line with the planned future land use outlined in the Tenney-Lapham, East Washington Gateway Corridor, and City of Madison Comprehensive Plans, all of which call for Community-Mixed Use.

This site is located in Urban Design District 8, and the site and building design incorporate the principles of this district, including:

- Concealed parking (side parking and covered)
- Landscaping, lighting, and site features within E. Washington setback to create a pleasing environment for pedestrians
- Green building design with focus on energy efficient features
- Setbacks and stepbacks compliant with UDD8 and TE
- Primary exterior materials include brick, stone, metal panel

Project Team:

Applicant: Gorman & Company, LLC 200 N. Main Street Oregon, WI 53575 414-617-9997 Contact: Ted Matkom <u>tmatkom@gormanusa.com</u>

Architect: Gorman & Company, LLC 200 N. Main Street Oregon, WI 53575 Contact: Ben Marshall <u>bmarshall@gormanusa.com</u>

Civil: JSD Professional Services, Inc. 7402 Stone Ridge Dr, Ste 4 Weston, WI 54476 Contact: Justin Frahm justin.frahm@jsdinc.com Owner: Dane County 210 Martin Luther King Jr Blvd Madison, WI 53703 608-266-4109 Contact: Todd Violante Violante@countyofdane.com

General Gorman General Contractors, LLC Contractor: 200 N. Main Street Oregon, WI 5375 Contact: Ron Swiggum <u>rswiggum@gormanusa.com</u>

Project Schedule: The project was re-zoned to TE in Fall 2018; we are seeking Final Approval from UDC. UDC Informational – June 26, 2018 UDC Initial Approval – October 22, 2018 Plan Commission Approval – November 5, 2018 Common Council Approval – November 20, 2018

Meeting Dates: We are requesting a UDC meeting date of June 12, 2019.

Thank you for your time in reviewing our proposal.

Sincerely,

B.MM

Ben Marshall Director of Architecture, Gorman & Company









BALDWIN STREET @ EAST WASHINGTON AVENUE

1314 EAST WASHINGTON AVENUE

BALDWIN STREET GRILLE 1304 EAST WASHINGTON AVENUE

1310 EAST WASHINGTON AVENUE




1314—1326 EAST WASHINGTON AVENUE VALOR ON WASHINGTON CONTEXT MADISONN WI 53708

Project No Plot Date Drawn by: Issue dates

DICKINSON STREET @ EAST WASHINGTON AVENUE

PASQUAL'S CANTINA 1344 EAST WASHINGTON AVENUE

Sheet Title

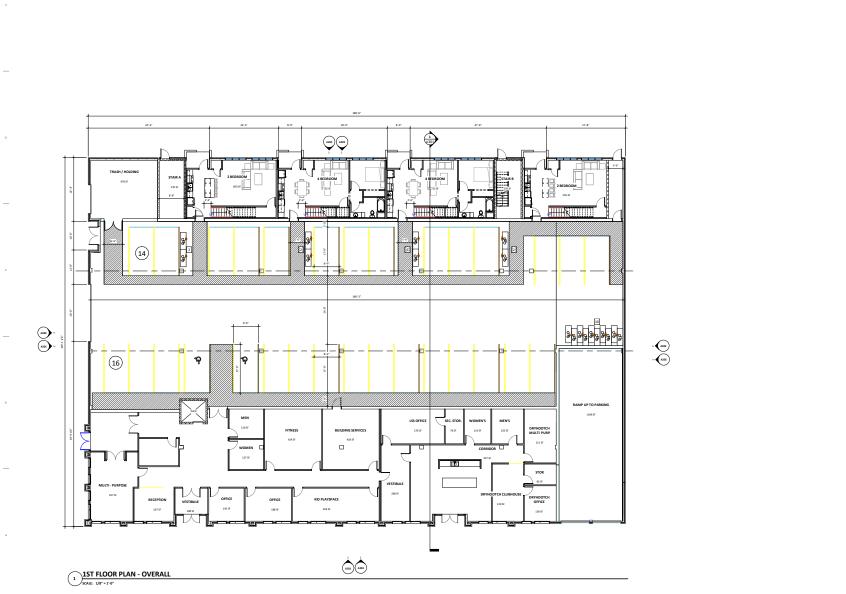

VALOR ON WASHINGTON EAST WASHINGTON AVE. MADISON, WI

Project No. Project Number

Date Issue Descriptio OL 15 2018 LAND USE RESUBUTION COLOS 2018 LAND USE RESUBUTION


Plot Date

Drawn by

Sheet Title 1ST FLOOR PLAN -OVERALL

Sheet No. A111

REAL ESTATE DEVELOPMENT & MANAGEMENT 200 N. MAIN STREET OREGON, WI 53575

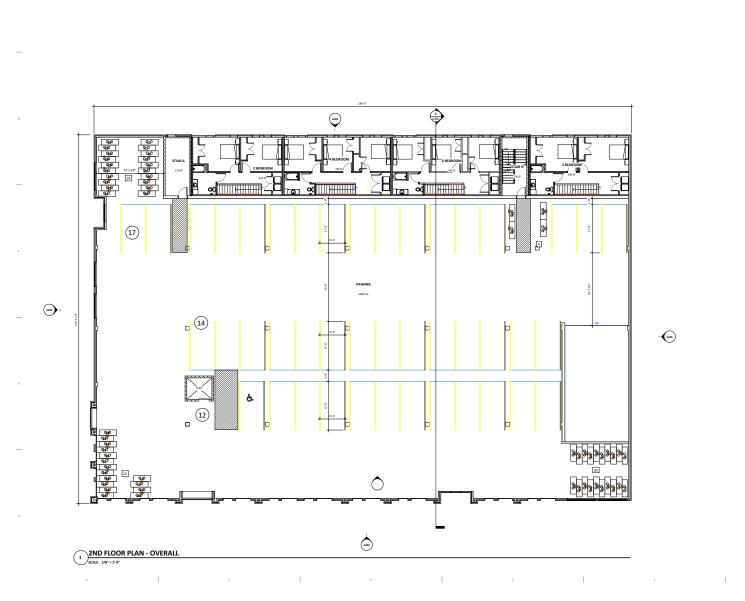

VALOR ON WASHINGTON EAST WASHINGTON AVE. MADISON, WI

REAL ESTATE DEVELOPMENT & MANAGEMENT 200 N. MAIN STREET OREGON, WI 53575

Schematic
 Project No. Project Number
 Plot Date:
 GORMAN TEAM
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Sheet Title 2ND FLOOR PLAN -OVERALL

Sheet No.






GORMAN

VALOR ON WASHINGTON EAST WASHINGTON AVE. MADISON, WI




Sheet Title 3RD FLOOR PLAN -OVERALL


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Sheet No. A141

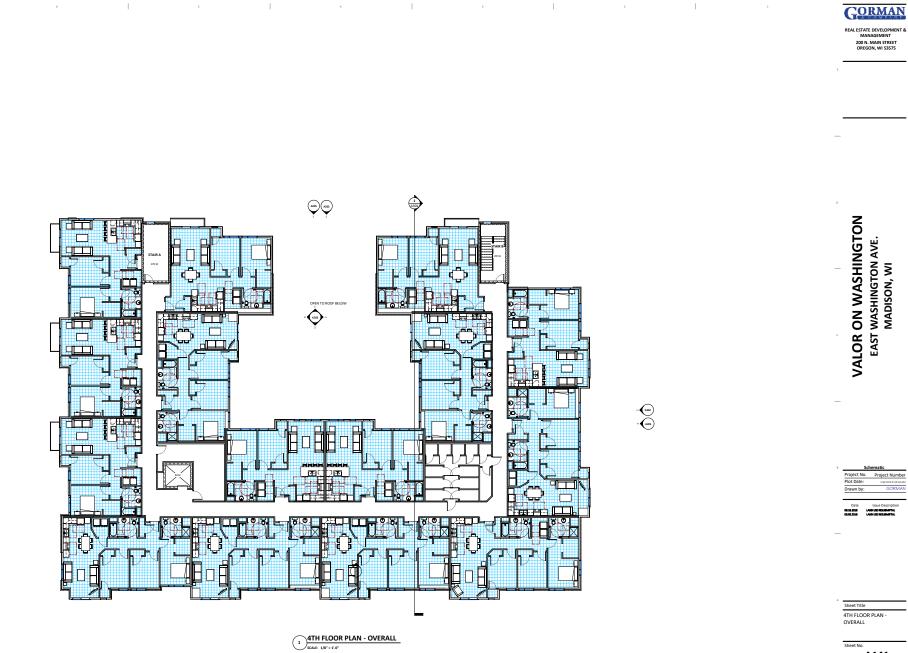


A151

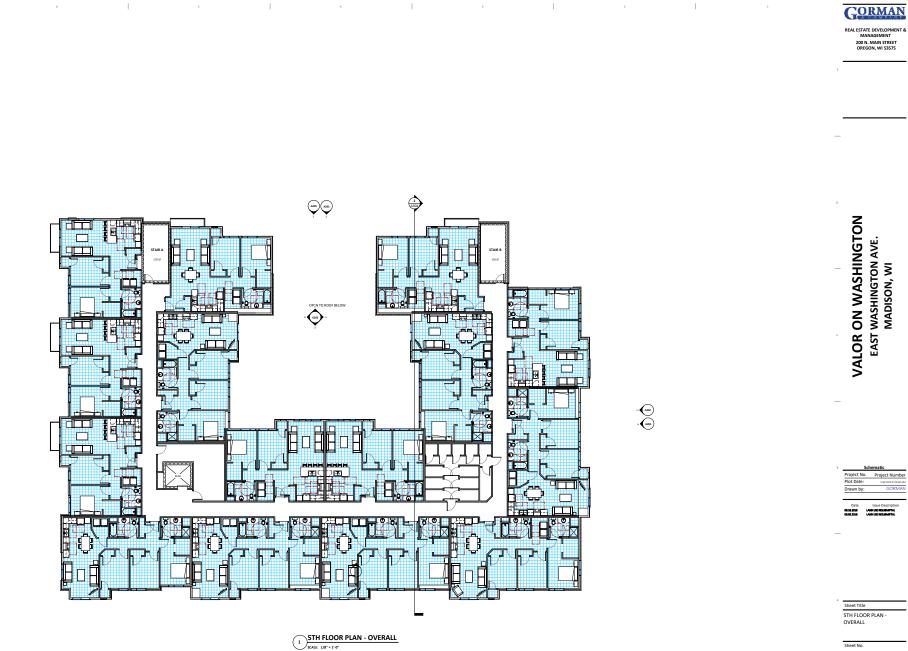

A161

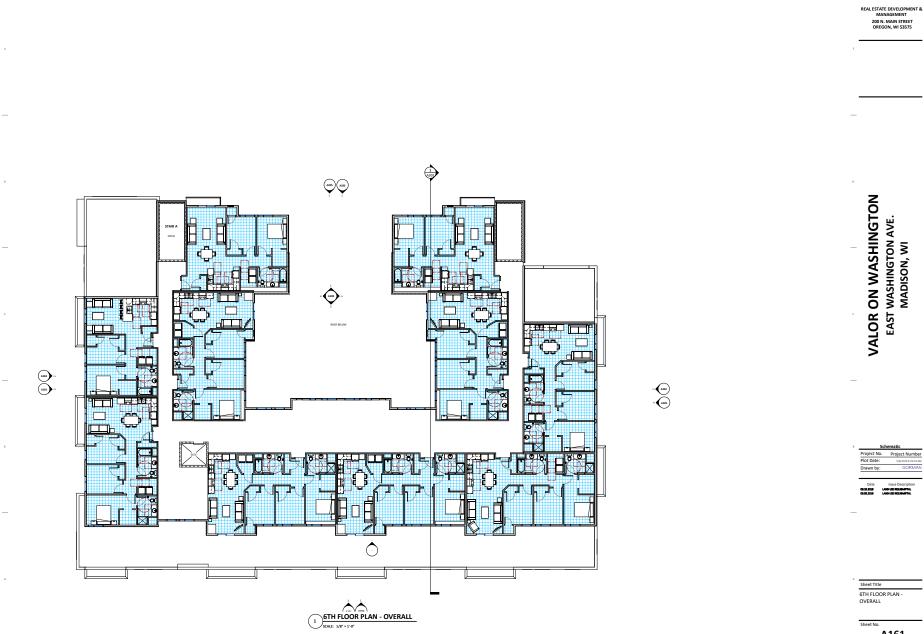GORMAN

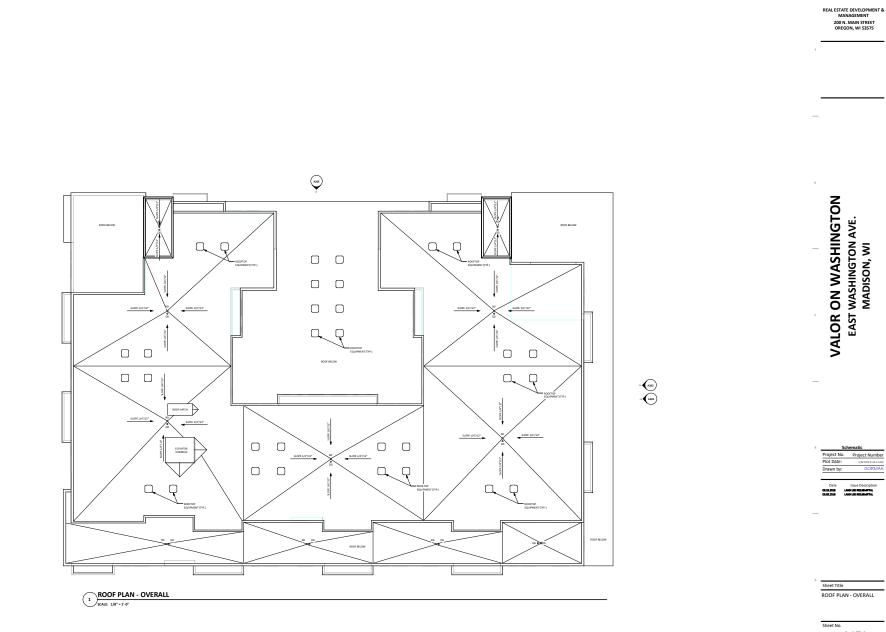

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GORMAN






1 SCALE: 1/4" = 1'-0"

Sheet Title BUILDING SECTIONS



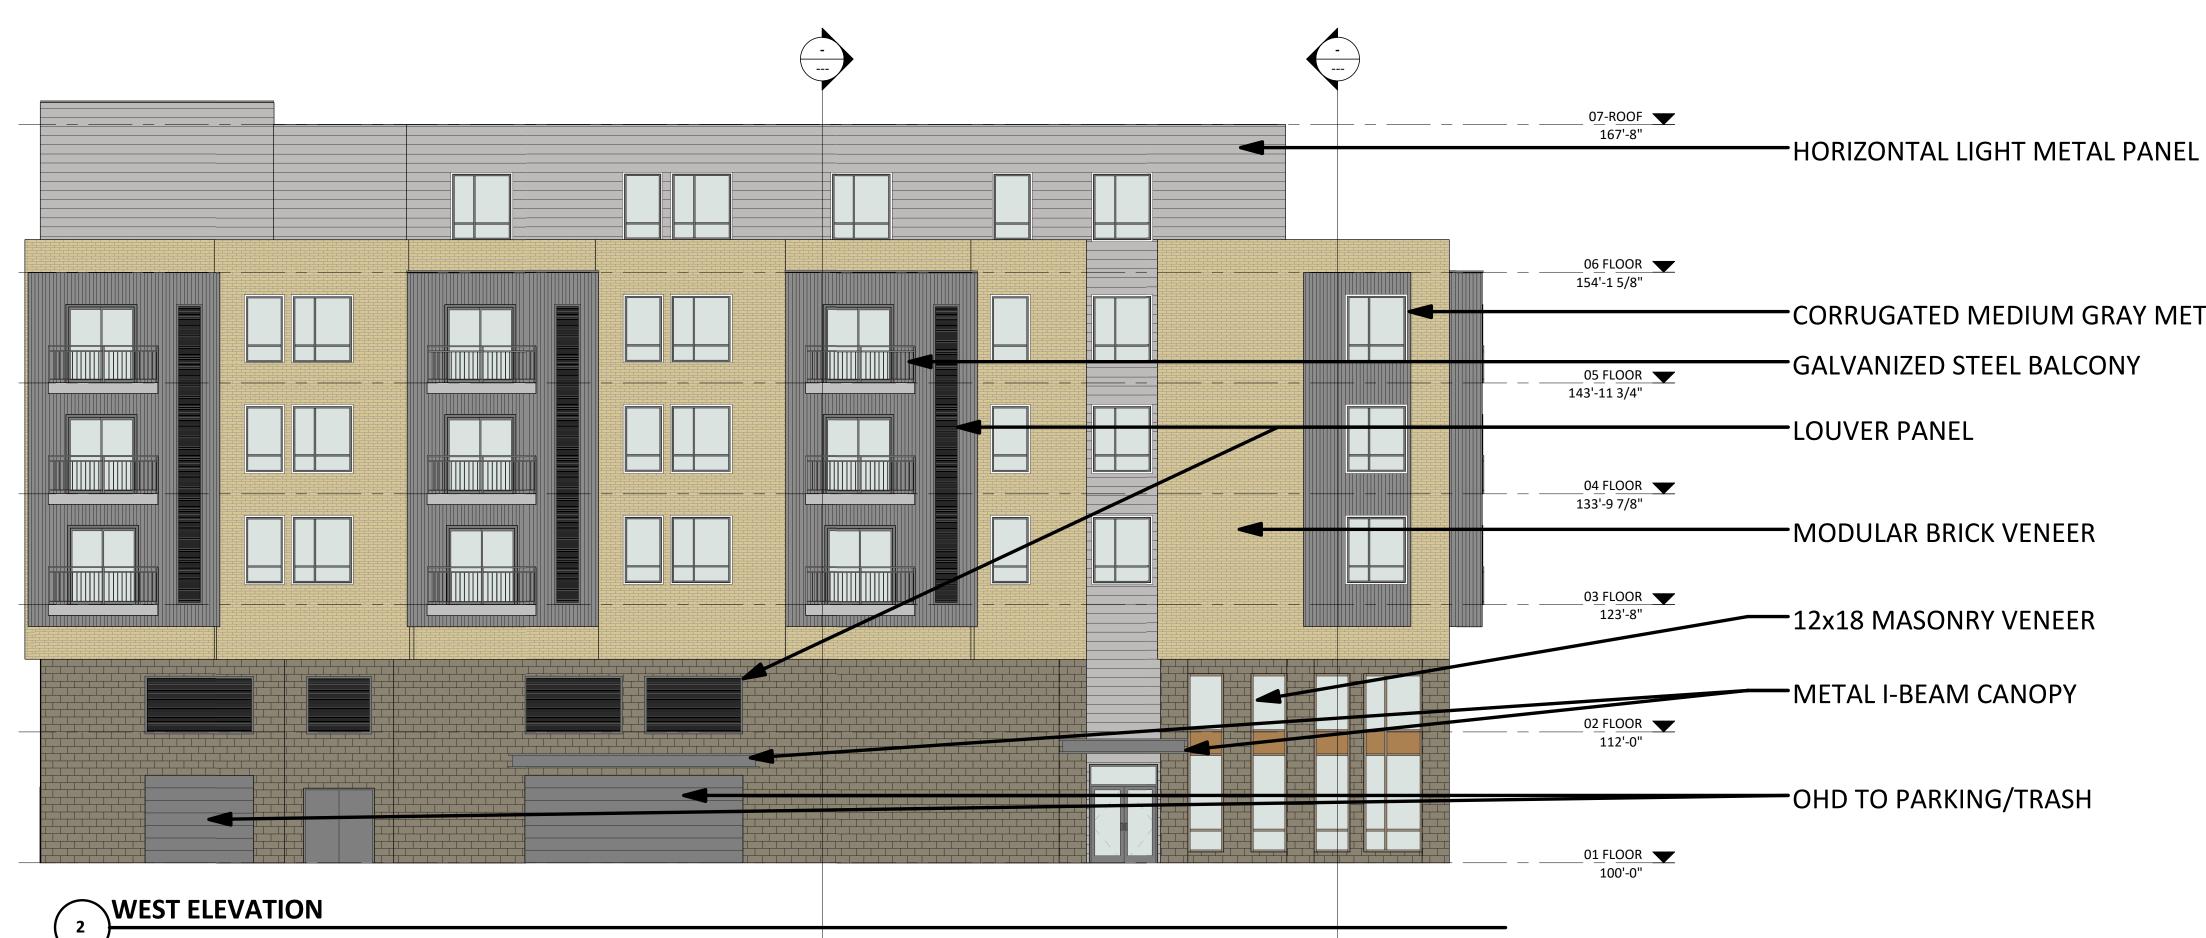

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CORRUGATED MEDIUM GRAY METAL PANEL

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REAL ESTATE DEVELOPMENT & MANAGEMENT 200 N. MAIN STREET OREGON, WI 53575

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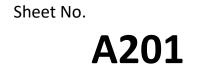
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| Schematic | | | | |
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| Project No | · Project Number | | | |
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| 8.15.2018 | LAND USE RESUBMITTAL | | | |
| 9.05.2018 | LAND USE RESUBMITTAL | | | |
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Sheet Title EXTERIOR BUILDING ELEVATIONS MATERIAL



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1 NORTH ELEVATION SCALE: 1/8" = 1'-0"

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07-ROOF 167'-8" HORIZONTAL LIGHT METAL PANEL -CORRUGATED MEDIUM GRAY METAL PANEL 06 FLOOR 🗙 154'-1 5/8" -GALVANIZED STEEL RAILING -LAP SIDING 04 FLOOR 133'-9 7/8" - MODULAR BRICK VENEER 03 FLOOR 123'-8" CORRUGATED MEDIUM GRAY METAL PANEL 02 FLOOR 112'-0" -12x18 MASONRY VENEER 01 FLOOR 100'-0"

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REAL ESTATE DEVELOPMENT & MANAGEMENT 200 N. MAIN STREET OREGON, WI 53575

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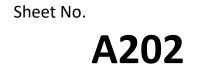
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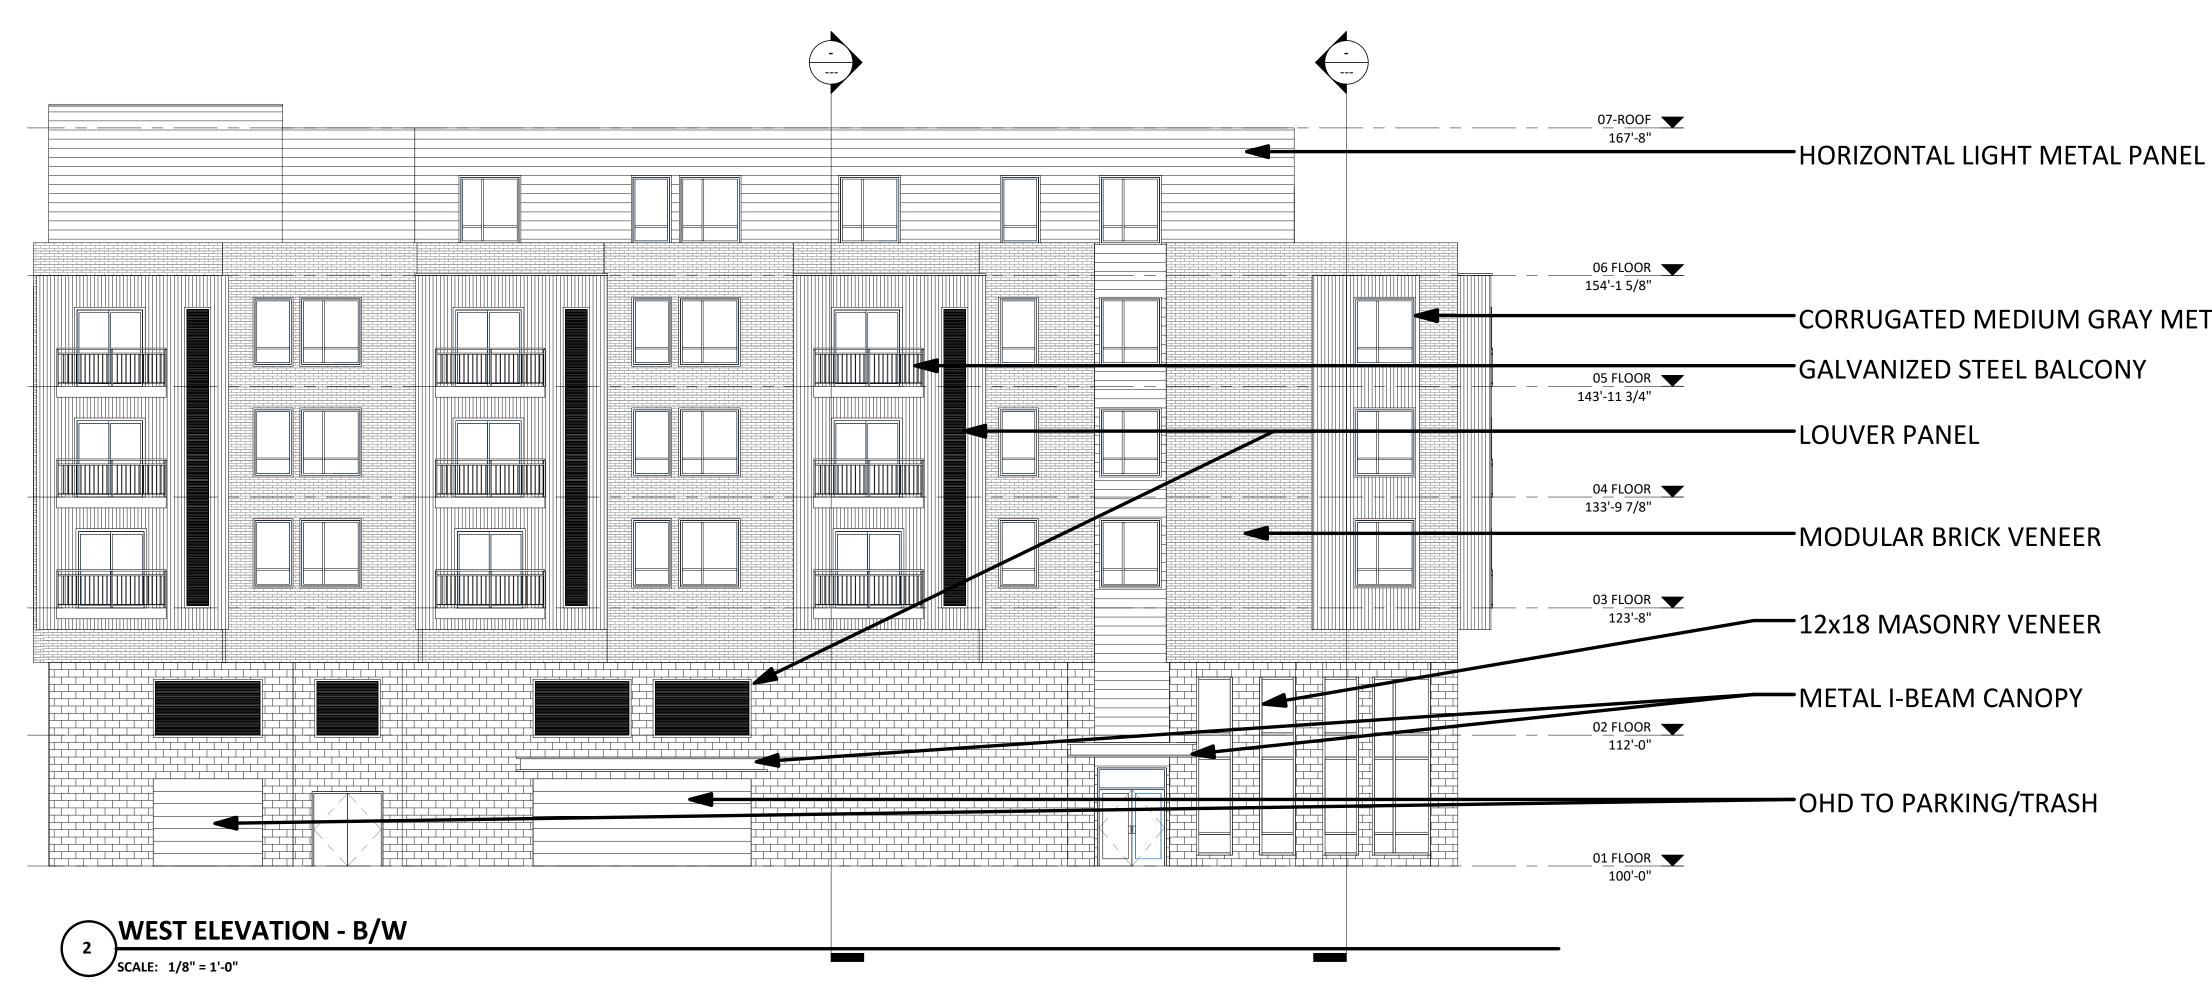


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Sheet Title EXTERIOR BUILDING ELEVATIONS MATERIAL



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CORRUGATED MEDIUM GRAY METAL PANEL

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REAL ESTATE DEVELOPMENT & MANAGEMENT 200 N. MAIN STREET OREGON, WI 53575

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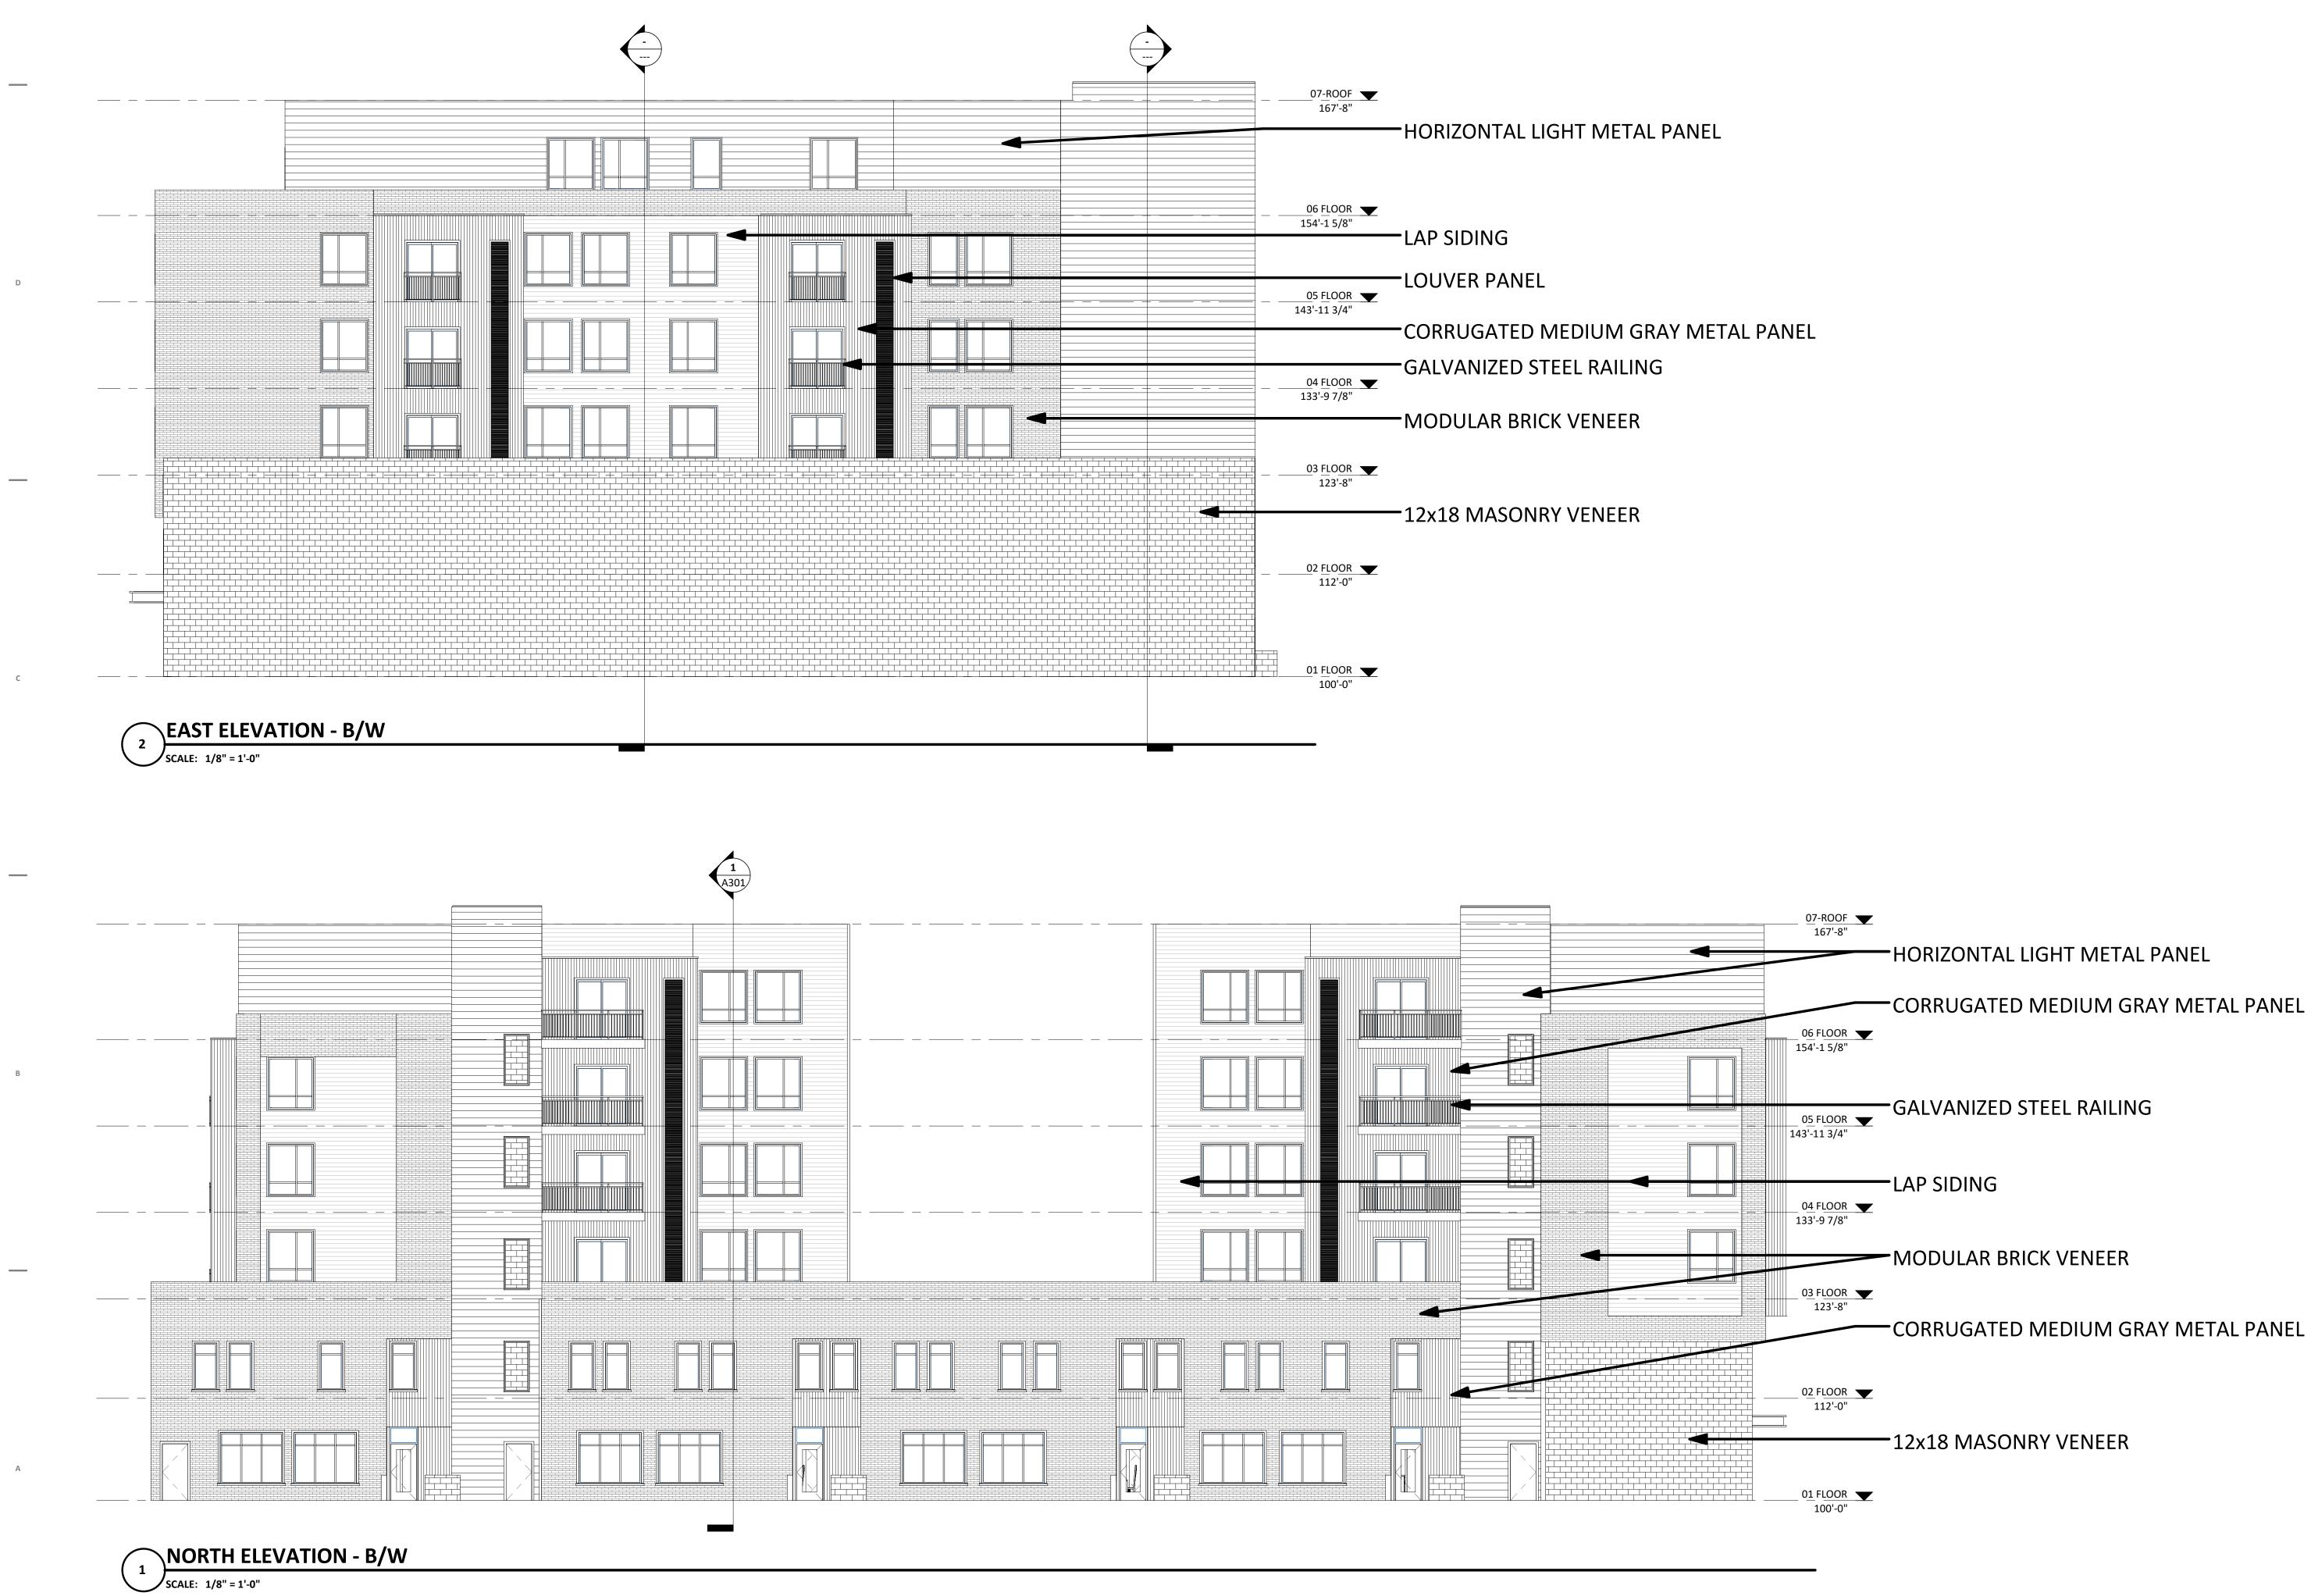
Sheet Title EXTERIOR BUILDING

ELEVATIONS B/W

Sheet No.

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REAL ESTATE DEVELOPMENT & MANAGEMENT 200 N. MAIN STREET OREGON, WI 53575



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Date

Issue Description

Sheet Title

EXTERIOR BUILDING ELEVATIONS B/W

Sheet No.

A205



VALOR ON EAST WASHINGTON AVE

Location: Madison, Wisconsin

PROPOSED BUILDING

OPEN SPACE

E. WASHINGTON AVE


CONCEPT MASTER PLAN

PLEASE NOTE: POTENTIAL BUILDING AND SITE LAYOUTS SHOWN ON THIS ONLY AND ARE COPYRIGHT PROTECTED BY JSD PROFESSIONAL SERVICES. © 2018

TERRACE PATIO

12

PARKING ENTRANCE

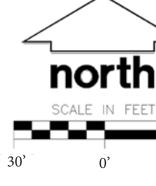



LAND USE KEY:

LOT 1 - 0.987 ACRES

Building: Multi-Family Residential - 23,752 sq. ft. Building Height - 6 stories

Parking: Surface Parking - 12 stalls Structured Parking - 73 stalls Total Parking - 85 stalls

Bike Surface Parking - 30 stalls

<u>Impervious vs. Pervious:</u> Impervious (SAR) - .79





VALOR ON EAST WASHINGTON AVE


Location: Madison, Wisconsin

CONCEPT MASTER PLAN TERRACE

PLEASE NOTE: POTENTIAL BUILDING AND SITE LAYOUTS SHOWN ON THIS PLAN ARE FOR ILLUSTRATION ONLY AND ARE COPYRIGHT PROTECTED BY JSD PROFESSIONAL SERVICES. © 2018






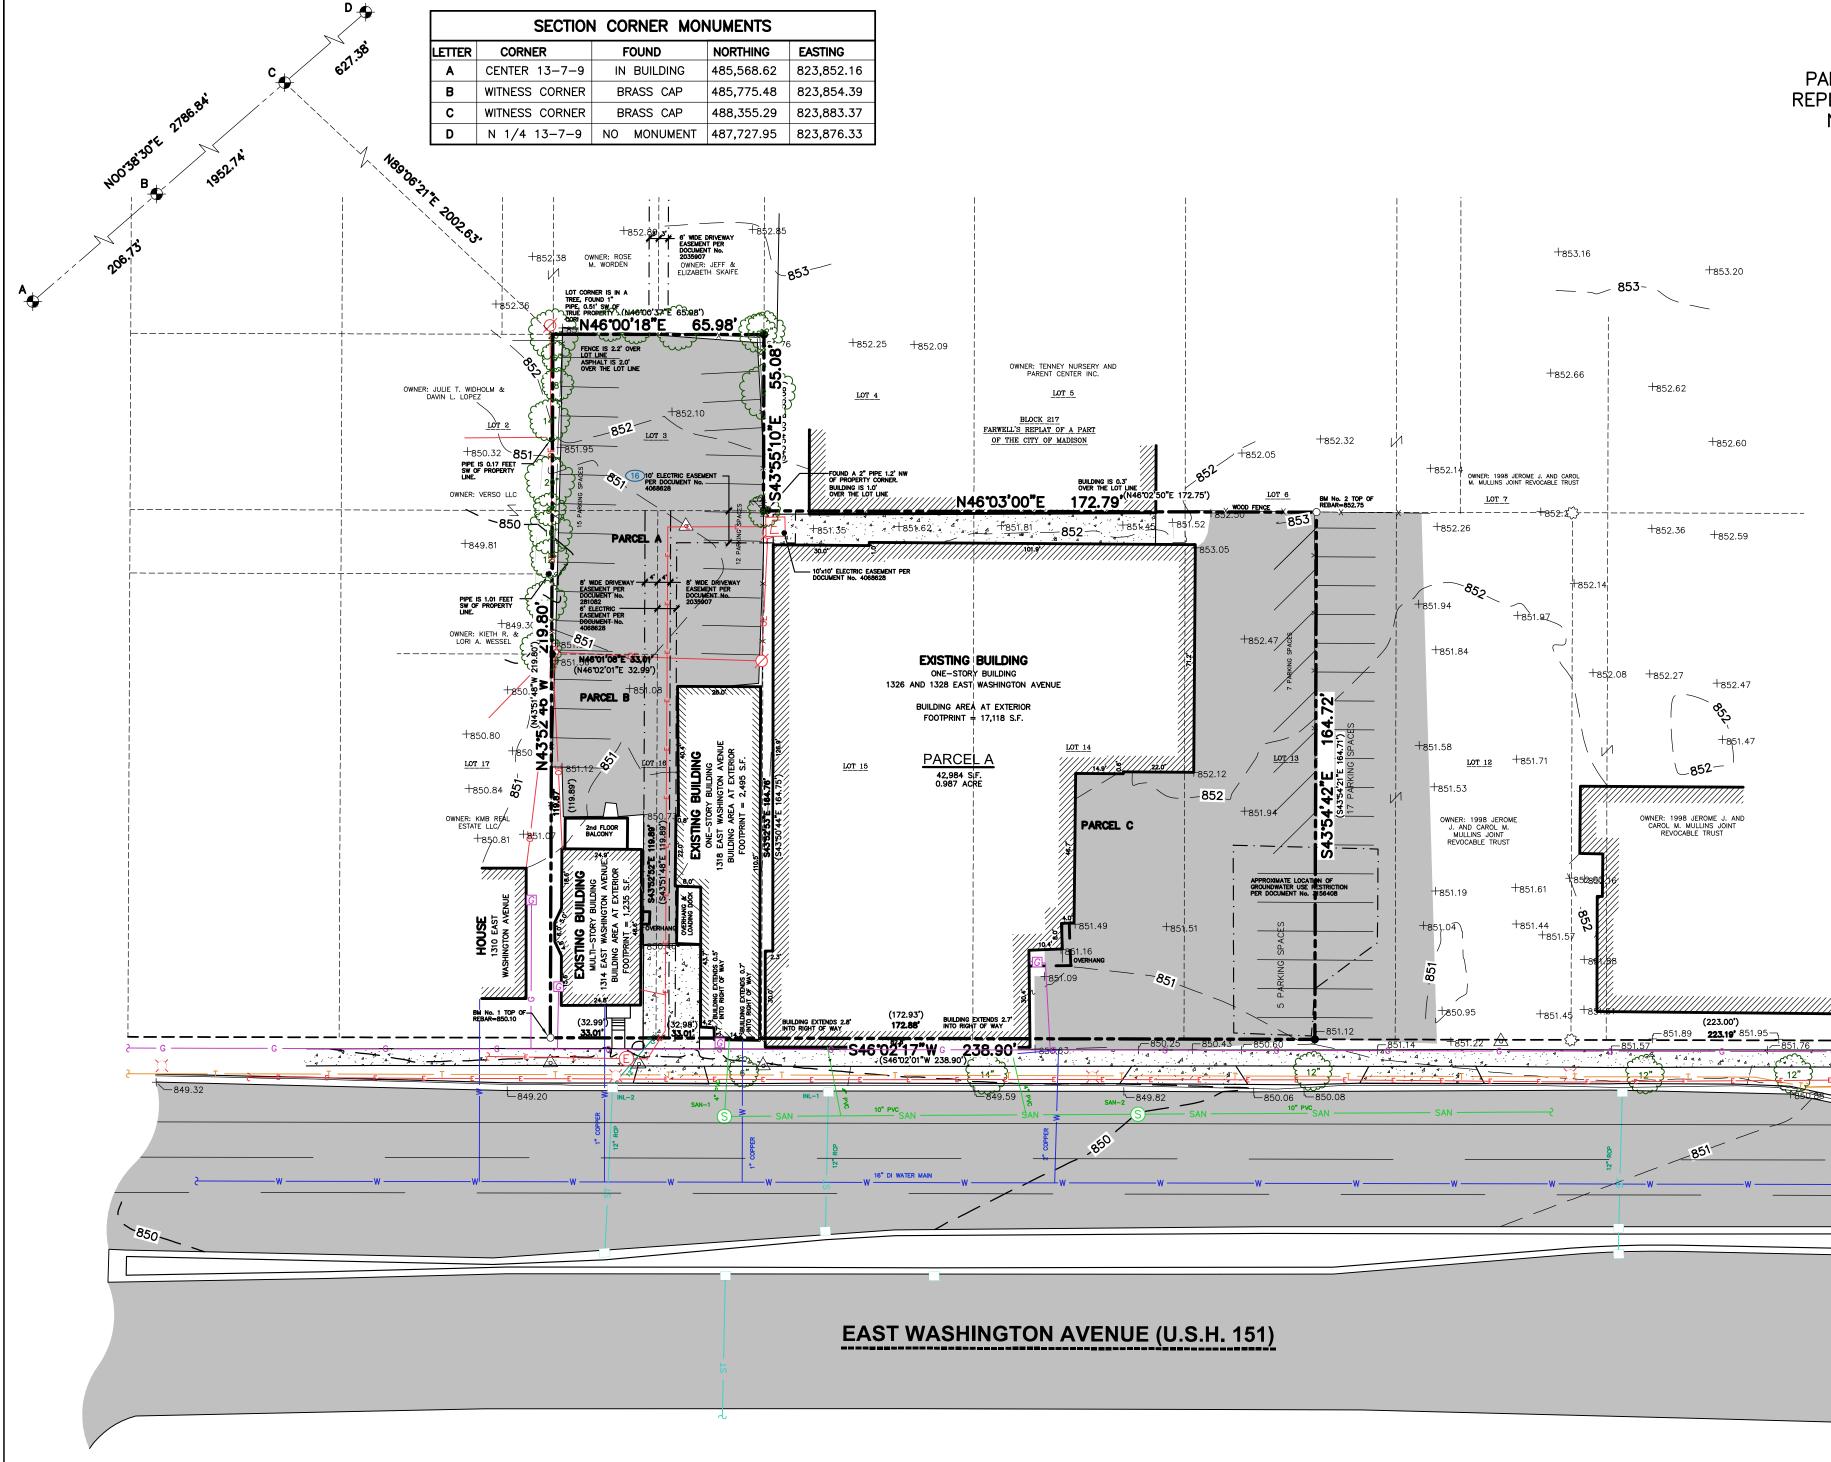

| SANITARY SEWER MANHOLES | | | | | |
|-------------------------|---------------|--------|-----------|-----------|-----------|
| STRUCT. ID | RIM ELEVATION | INVERT | ELEVATION | PIPE SIZE | PIPE TYPE |
| SAN-1 | 849.41 | NW | 840.19 | 4" | PVC |
| | | NE | 840.05 | 10" | PVC |
| SAN-2 | 850.01 | SW | 839.51 | 10" | PVC |
| | | NW | 842.25 | 4" | PVC |
| | | NE | 839.48 | 10" | PVC |

| STORM SEWER INLETS | | | | | |
|--------------------|---------------|--------|-----------|-----------|-----------|
| INLET ID | RIM ELEVATION | INVERT | ELEVATION | PIPE SIZE | PIPE TYPE |
| INL-1 | 849.31 | SE | 845.61 | 12" | RCP |
| INL-2 | 848.81 | NW | 845.61 | 12" | _ |
| | | SE | 845.61 | 12" | RCP |

EXISTING CONDITIONS MAP PART OF LOTS 3 AND 12 AND ALL OF LOTS 13, 14, 15, AND 16, BLOCK 217, FARWELL'S REPLAT OF A PART OF THE CITY OF MADISON, LOCATED IN THE NORTHEAST QUARTER OF THE NORTHEAST QUARTER OF SECTION 13, TOWNSHIP 07 NORTH, RANGE 09 EAST, CITY OF MADISON, DANE COUNTY, WISCONSIN Professional Services, Inc. Engineers • Surveyors • Planners $-\cdot - \cdot -$ EASEMENT LINE -x-X- FENCE LINE ----- EDGE OF PAVEMENT CONCRETE CURB & GUTTER CREATE THE VISION TELL THE STORY - ST - STORM SEWER -----G----- NATURAL GAS MADISON MILWAUKEE ------OVERHEAD ELECTRIC DISTRIBUTION KENOSHA APPLETON WAUSAU ---- E ----- UNDERGROUND ELECTRIC MADISON REGIONAL OFFICE //////// BUILDING 161 HORIZON DRIVE, SUITE 101 -850- INDEX CONTOUR VERONA, WISCONSIN 53593 -851- INTERMEDIATE CONTOUR P. 608.848.5060 、ちっ^{.29} SPOT ELEVATION CLIENT: BITUMINOUS PAVEMENT GORMAN & COMPANY, CONCRETE PAVEMENT INC. \sim END OF FLAGGED UTILITIES () DENOTES RECORD DATA DEPICTING THE SAME LINE ON THE GROUND AS RETRACED BY THIS SURVEY 1. FIELD WORK PERFORMED BY JSD PROFESSIONAL SERVICES, INC. ON MAY 17 AND 18, 2018. CLIENT ADDRESS: 2. BEARINGS FOR THIS SURVEY AND MAP ARE REFERENCED TO THE WISCONSIN COUNTY COORDINATE SYSTEM, (DANE **200 NORTH MAIN STREET** COUNTY). THE WEST LINE OF THE NORTHEAST QUARTER OF SECTION 13-07-09, BEARS N00'38'30"E. **OREGON, WI 53575** 3. ELEVATIONS ARE BASED ON THE NORTH AMERICAN VERTICAL DATUM OF 1988 (NAVD88). BENCHMARK IS A BRASS CAP IN CONCRETE WITNESSING THE CENTER OF SECTION 13, TO7N, R09E, ELEVATION = 849.79'. 5. SPOT ELEVATIONS IN CURBED AREAS REFERENCE THE PAVEMENT EDGE ELEVATIONS. 6. SUBSURFACE UTILITIES AND FEATURES SHOWN ON THIS MAP HAVE BEEN APPROXIMATED BY LOCATING SURFICIAL FEATURES AND APPURTENANCES, LOCATING DIGGERS HOTLINE FIELD MARKINGS AND BY REFERENCE TO UTILITY RECORDS AND MAPS. DIGGER'S HOTLINE TICKET No.'s 20181904182, 20181904524 AND 20181904560, WITH A CLEAR DATE OF MAY WISCONSIN DEPARTMENT OF TTRANSPORTATION-ITS EQUIPMENT Toll Free (800) 242-8511 ROJECT: VALOR ON WASHINGTON 8. BEFORE EXCAVATION, APPROPRIATE UTILITY COMPANIES SHOULD BE CONTACTED. FOR EXACT LOCATION OF UNDERGROUND DEVELOPMENT UTILITIES, CONTACT DIGGERS HOTLINE, AT 1.800.242.8511. 9. JSD PROFESSIONAL SERVICES, INC. DOES NOT GUARANTEE THAT THE BENCHMARKS ELEVATIONS LISTED ON THIS MAP HAVE NOT BEEN DISTURBED SINCE THE DATE OF THIS SURVEY AND SHOULD BE VERIFIED PRIOR TO CONSTRUCTION 10. PARCEL A IS ZONED TR-V (TRADITIONAL RESIDENTIAL-VARIED DISTRICT 1); PARCEL B IS ZONED CC-T (COMMERCIAL CORRIDOR-TRANSITIONAL DISTRICT); PARCEL C IS ZONED TE (TRADITIONAL EMPLOYMENT DISTRICT) PER THE CITY OF 11. WATER MAIN WAS NOT MARKED BY DIGGERS HOTLINE TICKET No.'s 20181904182, 20181904524 AND 20181904560 AND IS PROJECT LOCATION: **CITY OF MADISON** DANE COUNTY, WI 12. GAS MAIN AND UNDERGROUND ELECTRIC IS SHOWN PER A PLAT OF SURVEY BY WILLIAMSON SURVEYING & ASSOCIATES, LLC, DATED JANUARY 21, 2016, COUNTY MAP No. 2016-00305. GAS MAIN AND UNDERGROUND ELECTRIC WERE NOT MARKED BY DIGGERS HOTLINE TICKET No.'s 20181904182, 20181904524 AND 20181904560. (FIRST AMERICAN TITLE INSURANCE COMPANY, COMMITMENT No.: NCS-907830-MAD, COMMITMENT DATE: MAY 24, 2018 AT 7:30 LAN MODIFICATIONS: Date: Description: THE SE 55 FEET OF LOT 3, THE NW 45 FEET OF LOT 16, AND THE NE 33 FEET OF THE SOUTHEAST 120 FEET OF LOT 16, ALL IN BLOCK 217, FARWELL'S REPLAT OF PART OF THE CITY OF MADISON, IN THE CITY OF MADISON, DANE COUNTY, WISCONSIN. THE SW 33 FEET OF THE SE 120 FEET OF LOT 16, BLOCK 217, FARWELL'S REPLAT OF PART OF THE CITY OF MADISON, IN THE CITY THE SOUTHWEST 41 FEET OF LOT 13, AND ALL OF LOTS 14 AND 15 OF BLOCK 217, IN THE CITY OF MADISON ACCORDING TO FARWELL'S REPLAT THEREOF, IN THE CITY OF MADISON, DANE COUNTY, WISCONSIN. esign/Drawn: Approved: TJB SHEET TITLE: THE SOUTHWEST FIFTY-FIVE (55) FEET OF LOT TWELVE (12), IN BLOCK TWO-HUNDRED SEVENTEEN (217), ORIGINAL PLAT OF **EXISTING CONDITIONS** MAP THE NORTHEAST TWENTY-FIVE (25) FEET OF LOT THIRTEEN (13), IN BLOCK TWO-HUNDRED SEVENTEEN (217), ORIGNIAL PLAT OF SHEET NUMBER:

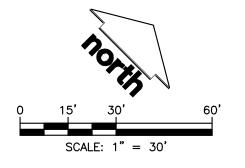

| <u>LEGEND</u> | |
|---------------|------------------------------------|
| \bullet | GOVERNMENT CORNER |
| ė | ¾" REBAR FOUND |
| ٠ | 1" IRON PIPE FOUND |
| 2 "● | 2" IRON PIPE FOUND |
| × | CHISELED 'X' FOUND |
| 0 | 3/4" x 24" REBAR SET (1.50 LBS/LF) |
| \Box | COTTON SPINDLE SET |
| -0- | SIGN |
| S | SANITARY MANHOLE |
| | CURB INLET |
| G | GAS REGULATOR/METER |
| E | ELECTRIC TRANSFORMER |
| X | LIGHT POLE |
| $\sim \sim$ | POWER POLE W/GUY |
| Ī | TELEPHONE PEDESTAL |
| \odot | DECIDUOUS TREE |
| | SECTION LINE |
| | PARCEL BOUNDARY |

ARCEL BOUNDAR

----- PLATTED LOT LINE

NOTES

- 4. CONTOUR INTERVAL IS ONE FOOT.
- 10, 2018.
- 7. UTILITY COMPANIES CONTACTED THRU DIGGERS HOTLINE: CITY OF MADISON ENGINEERING MADISON GAS AND ELECTRIC COMPANY (ELECTRIC AND GAS) AMERICAN TRANSMISSION COMPANT (ATC) CENTURYLINK KMC CHARTER COMMUNICATIONS AT&T TRANSMISSION AT&T DISTRIBUTION
- ACTIVITIES.
- MADISON ZONING MAP DATED JANUARY 2013.
- SHOWN PER CITY RECORDS (GTWeb).

LEGAL DESCRIPTION (AS FURNISHED)

A.M.)

PARCEL A:

ADDRESS PER TAX ROLL: 1316 & 1318 E WASHINGTON AVE TAX PARCEL No. 251/0709-131-0201-2

PARCEL B:

OF MADISON, DANE COUNTY, WISCONSIN.

ADDRESS PER TAX ROLL: 1314 E WASHINGTON AVE

TAX PARCEL No.: 251/0709-131-0209-5

PARCEL C:


ADDRESS PER TAX ROLL: 1326 & 1328 E WASHINGTON AVE TAX PARCEL No.: 251/0709-131-0211-0

PARCEL D:


MADISON, IN THE CITY OF MADISON, DANE COUNTY, WISCONSIN. ADDRESS PER TAX ROLL: 1334 E WASHINGTON AVE TAX PARCEL No.: 251/0709-131-0212-8 PARCEL E:


MADISON, IN THE CITY OF MADISON, DANE COUNTY, WISCONSIN. ADDRESS PER TAX ROLL: 1334 E WASHINGTON AVE TAX PARCEL No.: 251/0709-131-0212-8

SD PROJECT NO:

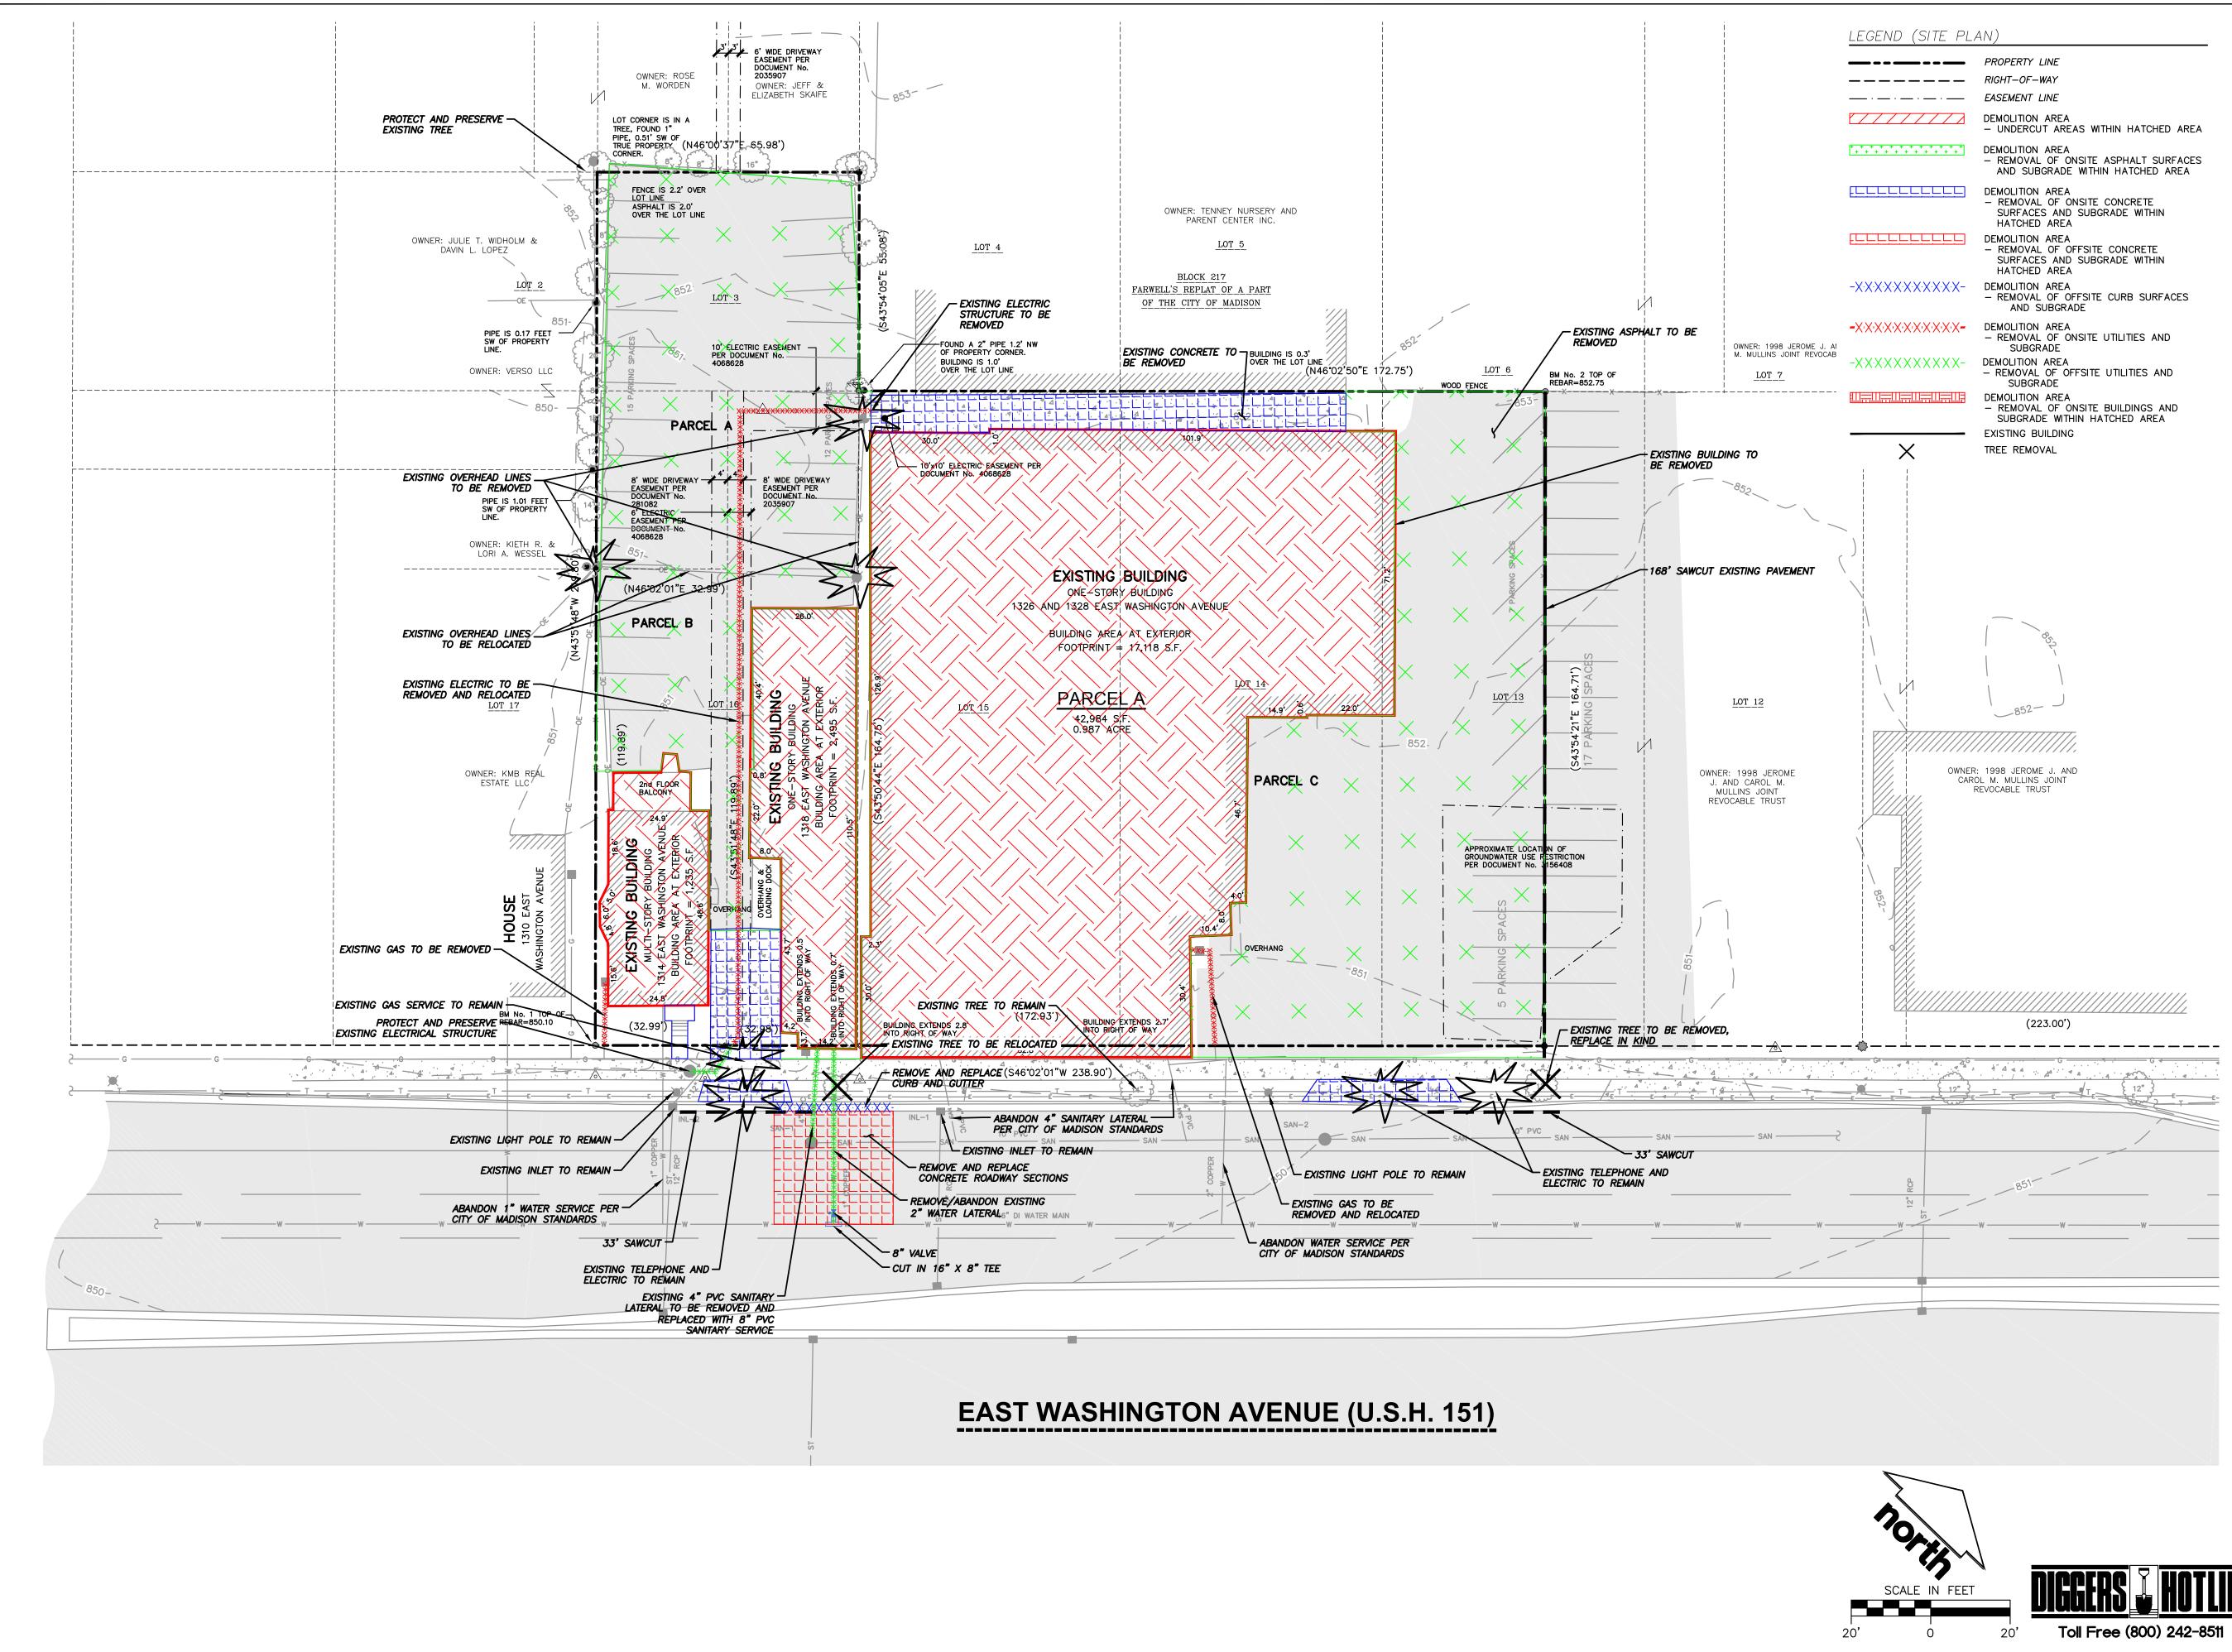


| | PROPERTY LINE |
|--|--|
| | RIGHT-OF-WAY |
| · · · · | EASEMENT LINE |
| | DEMOLITION AREA — UNDERCUT AREAS WITHIN HATCHED AREA |
| * * * * * * * * * * * * • * * * * * * * | DEMOLITION AREA - REMOVAL OF ONSITE ASPHALT SURFACES AND SUBGRADE WITHIN HATCHED AREA |
| | DEMOLITION AREA – REMOVAL OF ONSITE CONCRETE SURFACES AND SUBGRADE WITHIN HATCHED AREA |
| | DEMOLITION AREA – REMOVAL OF OFFSITE CONCRETE SURFACES AND SUBGRADE WITHIN HATCHED AREA |
| X*X*X*X*X*X*X*X*X*X*X- | DEMOLITION AREA - REMOVAL OF OFFSITE CURB SURFACES AND SUBGRADE |
| ×·×·×·×·×·×·×·×·×- | DEMOLITION AREA — REMOVAL OF ONSITE UTILITIES AND SUBGRADE |
| X*X*X*X*X*X*X*X*X*X*X- | DEMOLITION AREA - REMOVAL OF OFFSITE UTILITIES AND SUBGRADE |
| | DEMOLITION AREA - REMOVAL OF ONSITE BUILDINGS AND SUBGRADE WITHIN HATCHED AREA |
| | EXISTING BUILDING |
| × | TREE REMOVAL |
| | |

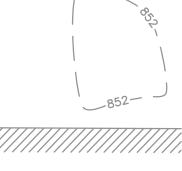

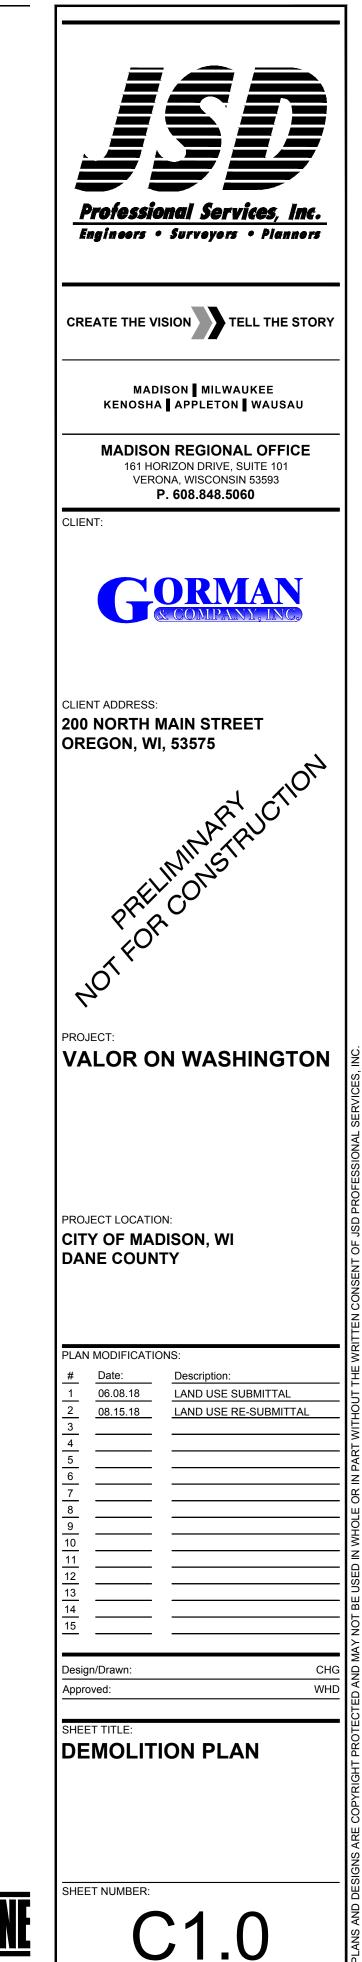

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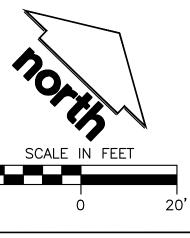

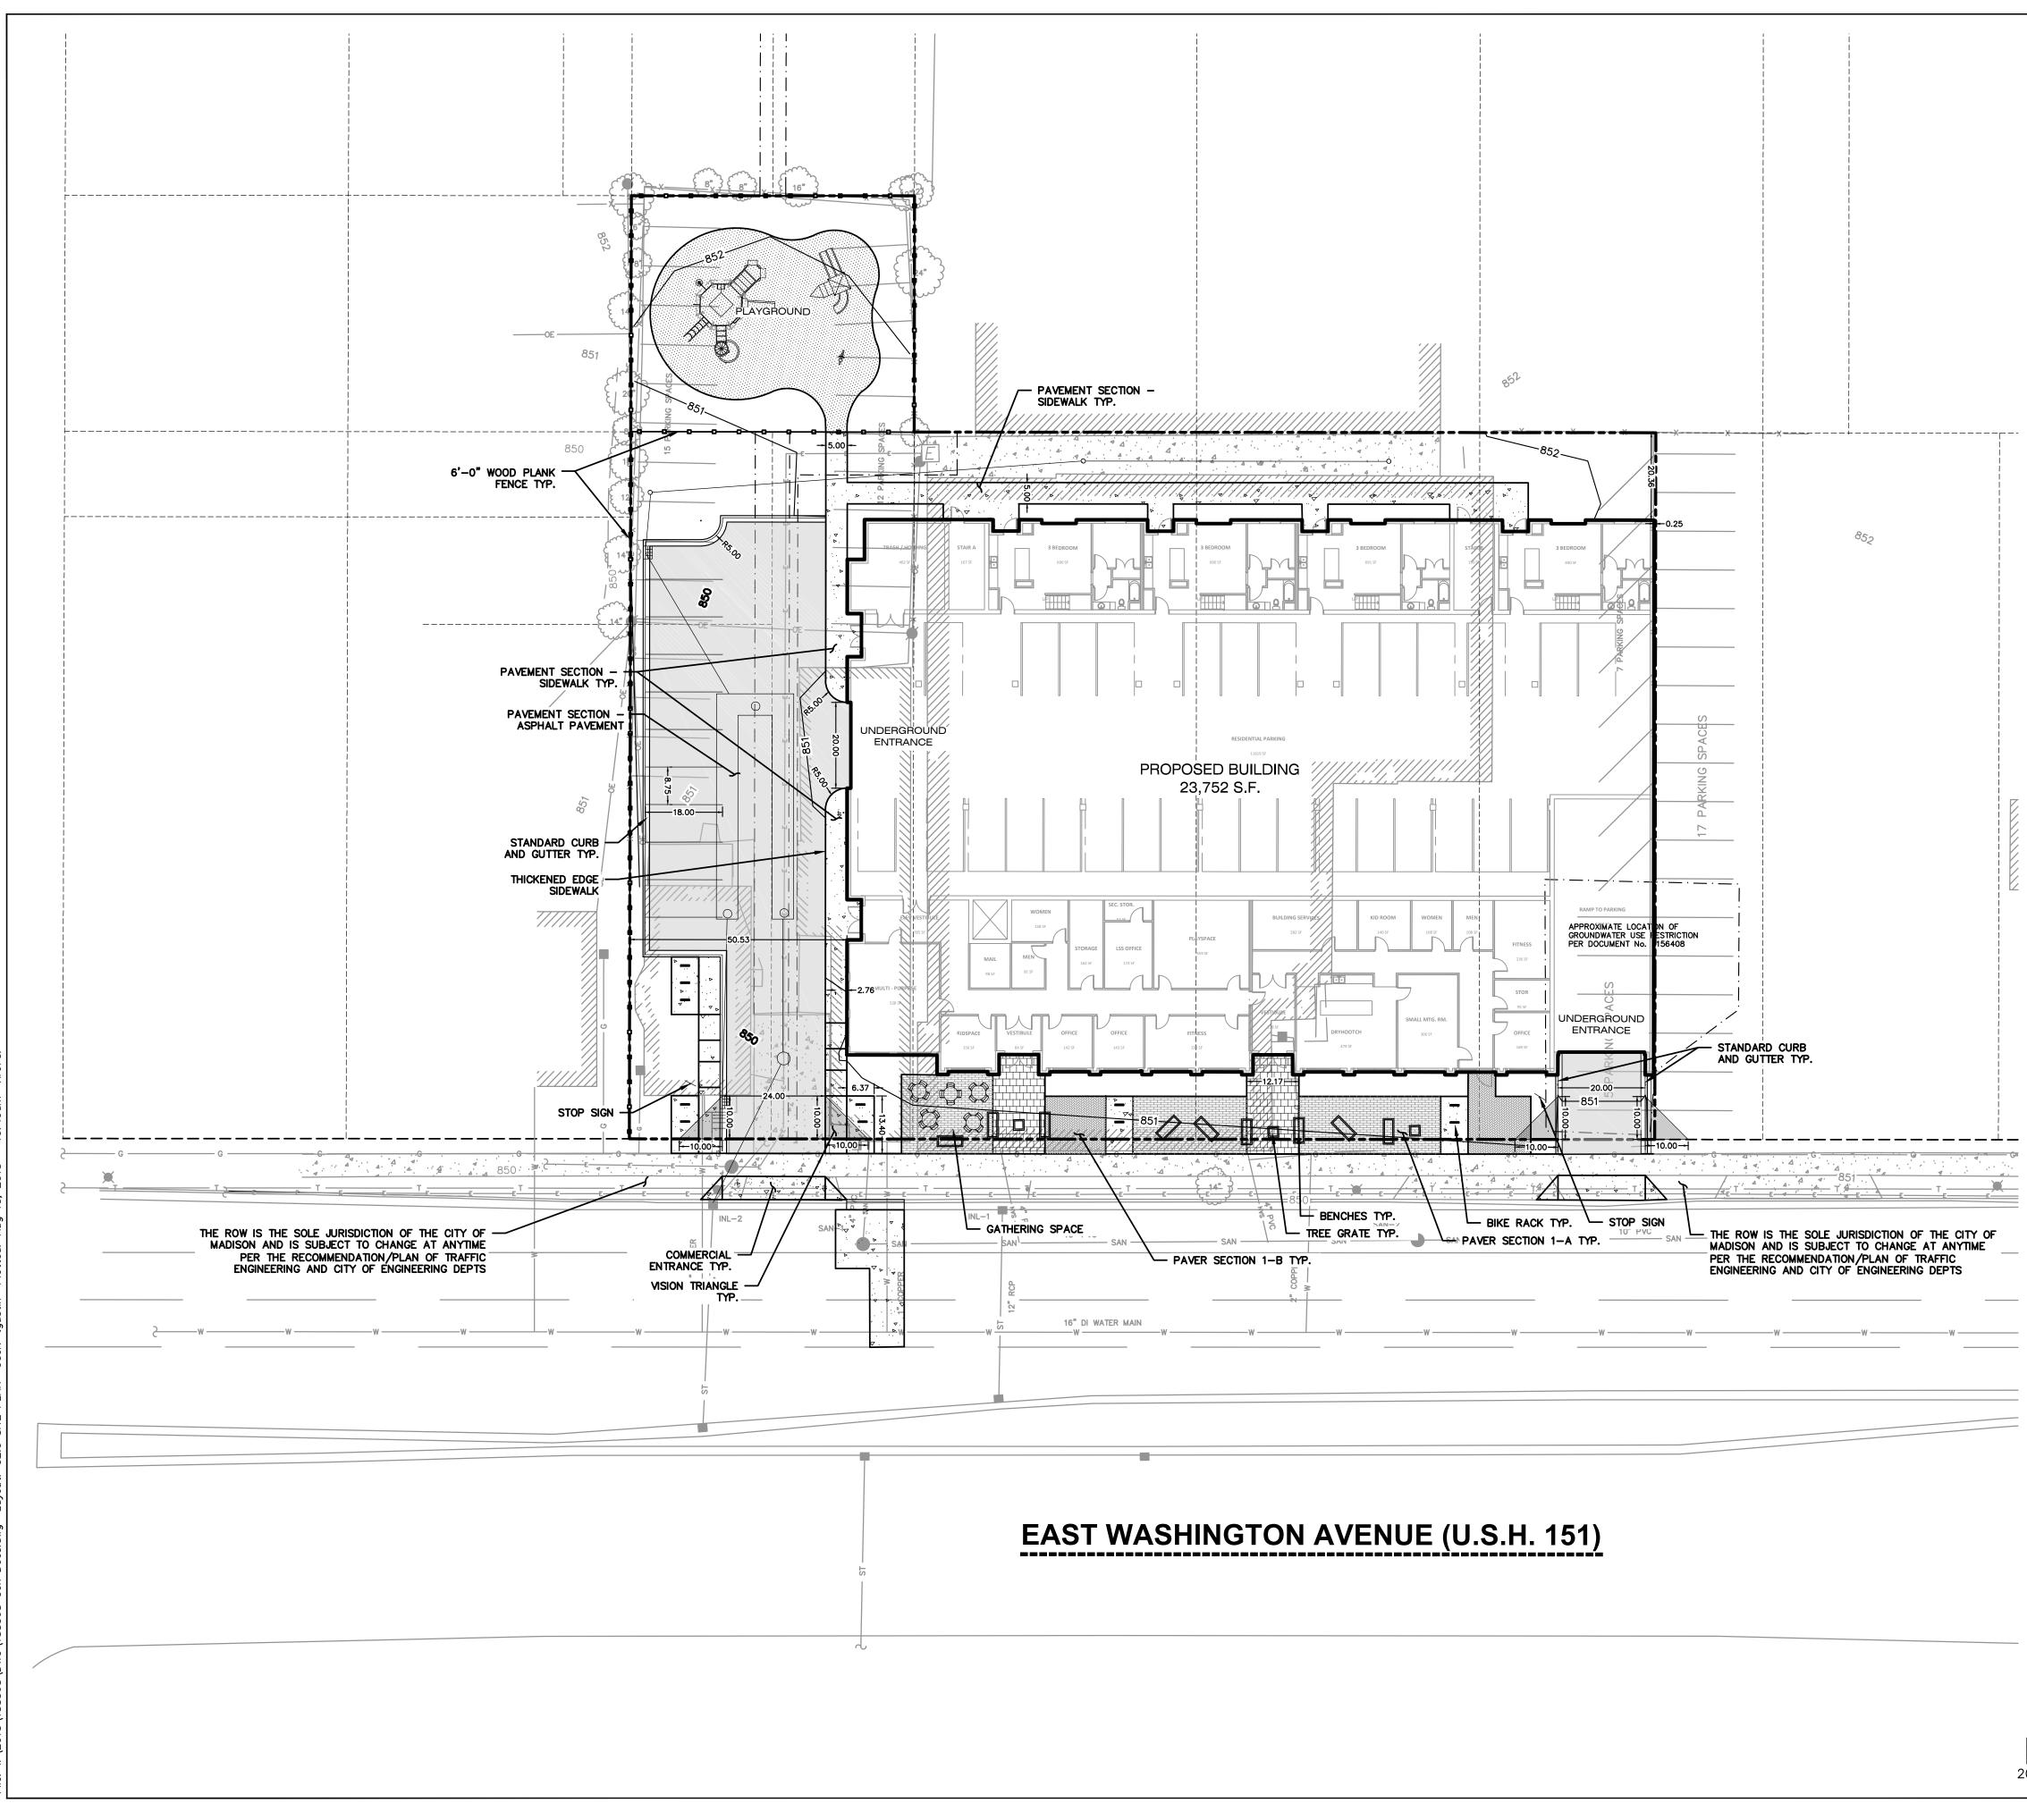
| LEGEND (SITE PL/ | AN) |
|---|------------------------------|
| | PROPERTY LINE |
| | RIGHT-OF-WAY |
| · · · · | EASEMENT LINE |
| | BUILDING OUTLINE |
| | EDGE OF PAVEMENT |
| | STANDARD CURB AND GUTTER |
| | REJECT CURB AND GUTTER |
| | MOUNTABLE CURB |
| | ASPHALT PAVEMENT |
| ••••• | HEAVY DUTY ASPHALT PAVEMENT |
| 4 | CONCRETE PAVEMENT |
| · + + + + + + + + + + + + + + + + + + + | HEAVY DUTY CONCRETE PAVEMENT |
| | SAWCUT EXISTING PAVEMENT |
| <u> </u> | ADA PARKING BOLLARDS/SIGNS |
| -00 | FENCE |
| | |

GENERAL NOTES:


- 1. REFER TO THE EXISTING CONDITIONS SURVEY FOR EXISTING CONDITIONS NOTES AND LEGENDS.
- 2. ALL WORK IN THE ROW AND/OR PUBLIC EASEMENTS SHALL BE IN ACCORDANCE WITH THE STANDARD SPECIFICATIONS FOR SEWER & WATER CONSTRUCTION IN WISCONSIN AND THE MUNICIPAL REQUIREMENTS.
- 3. EXISTING GRADE SPOT ELEVATIONS SHOWN FOR INFORMATIONAL PURPOSES. DURING CONSTRUCTION MATCH EXISTING GRADES AT CONSTRUCTION LIMITS.
- 4. NO SITE GRADING OUTSIDE OR DOWNSLOPE OF PROPOSED SILT FENCE LOCATION. NO LAND DISTURBANCE BEYOND PROPERTY LINES.
- 5. JSD SHALL BE HELD HARMLESS AND DOES NOT WARRANT ANY DEVIATIONS BY THE OWNER/CONTRACTOR FROM THE APPROVED CONSTRUCTION PLANS THAT MAY RESULT IN DISCIPLINARY ACTIONS BY ANY OR ALL REGULATORY AGENCIES.
- SITE PLAN NOTES 1. ALL DIMENSIONS TO FACE OF CURB AND/OR EDGING OF CONCRETE UNLESS OTHERWISE NOTED.
- 2. ALL RADII TO FACE OF CURB AND/OR EDGING OF CONCRETE UNLESS OTHERWISE NOTED.
- 3. ANY REQUIRED REPLACEMENT OF PUBLIC CURB AND GUTTER SHALL MATCH EXISTING AND MEET THE REQUIREMENTS OF THE CITY OF MADISON.
- 4. CONTRACTOR SHALL PROVIDE CONTROL JOINTS AND CONSTRUCTION JOINTS OF ONE-QUARTER CONCRETE THICKNESS AT AN EQUAL RATIO OF LENGTH TO WIDTH WHEREVER POSSIBLE WITH A MAXIMUM LENGTH BETWEEN JOINTS OF 8' ON CENTER
- 5. CONTRACTOR SHALL PROVIDE EXPANSION JOINTS IN SIDEWALKS AT A MAXIMUM 24' ON CENTER
- 6. EXTERIOR CONCRETE SURFACES SHALL BE BROOM FINISHED.
- 7. ALL CONCRETE SURFACES TO BE SEALED WITH TYPE TK-26UV CONCRETE SEALANT.
- 8. MARK AND STRIPE ADA PARKING SPACES APPROPRIATELY.
- 9. 2' x 4' TRUNCATED DOME WARNING DETECTION FIELD SHALL BE PLACED AT ALL ADA RAMPS.
- 10. ALL PAVEMENT MARKINGS INCLUDING: STOP BARS, CROSSWALKS, DIRECTIONAL ARROWS, PARKING STALL LINES, ADA STALL MARKINGS, NO PARKING ZONES, DROP-OFF/PICK-UP ZONES SHALL BE PAINTED WITH HIGH VISIBILITY YELLOW LATEX PAINT PER SPECIFICATIONS.


| SITE INFORMATION | N BLOCK | | |
|--------------------------------------|-------------|--------------|-------|
| Site Address | 1326 E | . WASHINGTON | AVE |
| Existing Site Acreage (total) | | | .987 |
| Number of Building Stories | | | |
| (above grade) | | | 5 |
| | | | |
| Total Building Square Footage | | 23,75 | 2 SF |
| | | | |
| Proposed Zoning | TRADITIONAL | _ EMPLOYMENT | (TE) |
| Number of parking stalls: | | | |
| Surface | | | 11 |
| Underground | | | 74 |
| Accessible | | | 3 |
| Total Stalls | | | 88 |
| | | | |
| Existing vs. Proposed Site Coverage: | | | |
| Existing Impervious Surface Area | | 41,276 | 5 S.F |
| Existing Pervious Surface Area | | 3,780 |) S.F |
| Proposed Impervious Surface Area | | 34,042 | 2 S.F |
| Proposed Pervious Surface Area | | 9,083 | 3 S.F |
| Proposed Impervious Surface Area Ra | tio | | .79 |
| | | | |





JSD PROJECT NO:

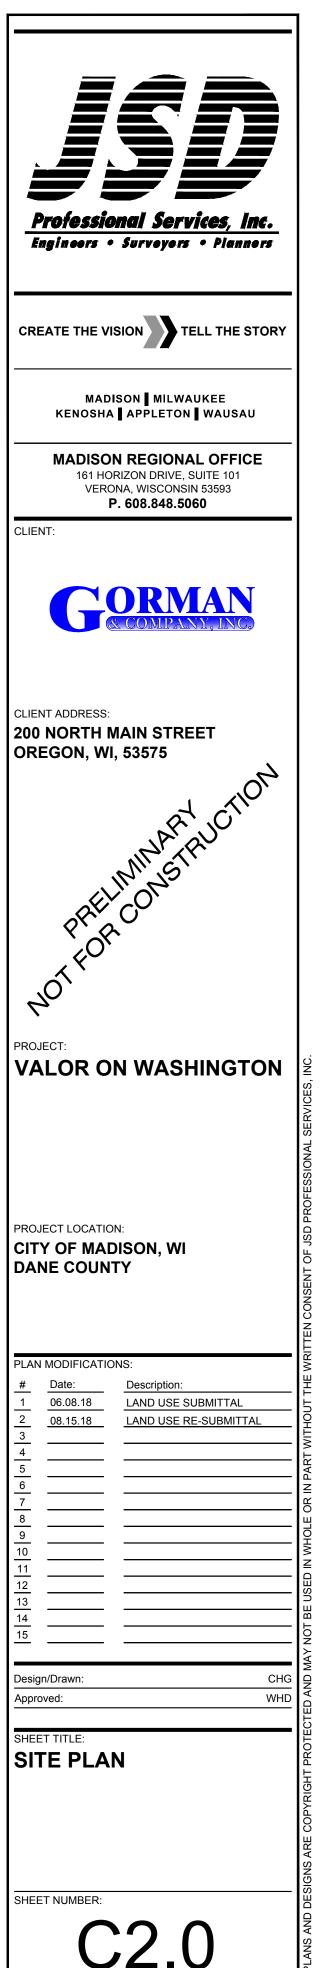

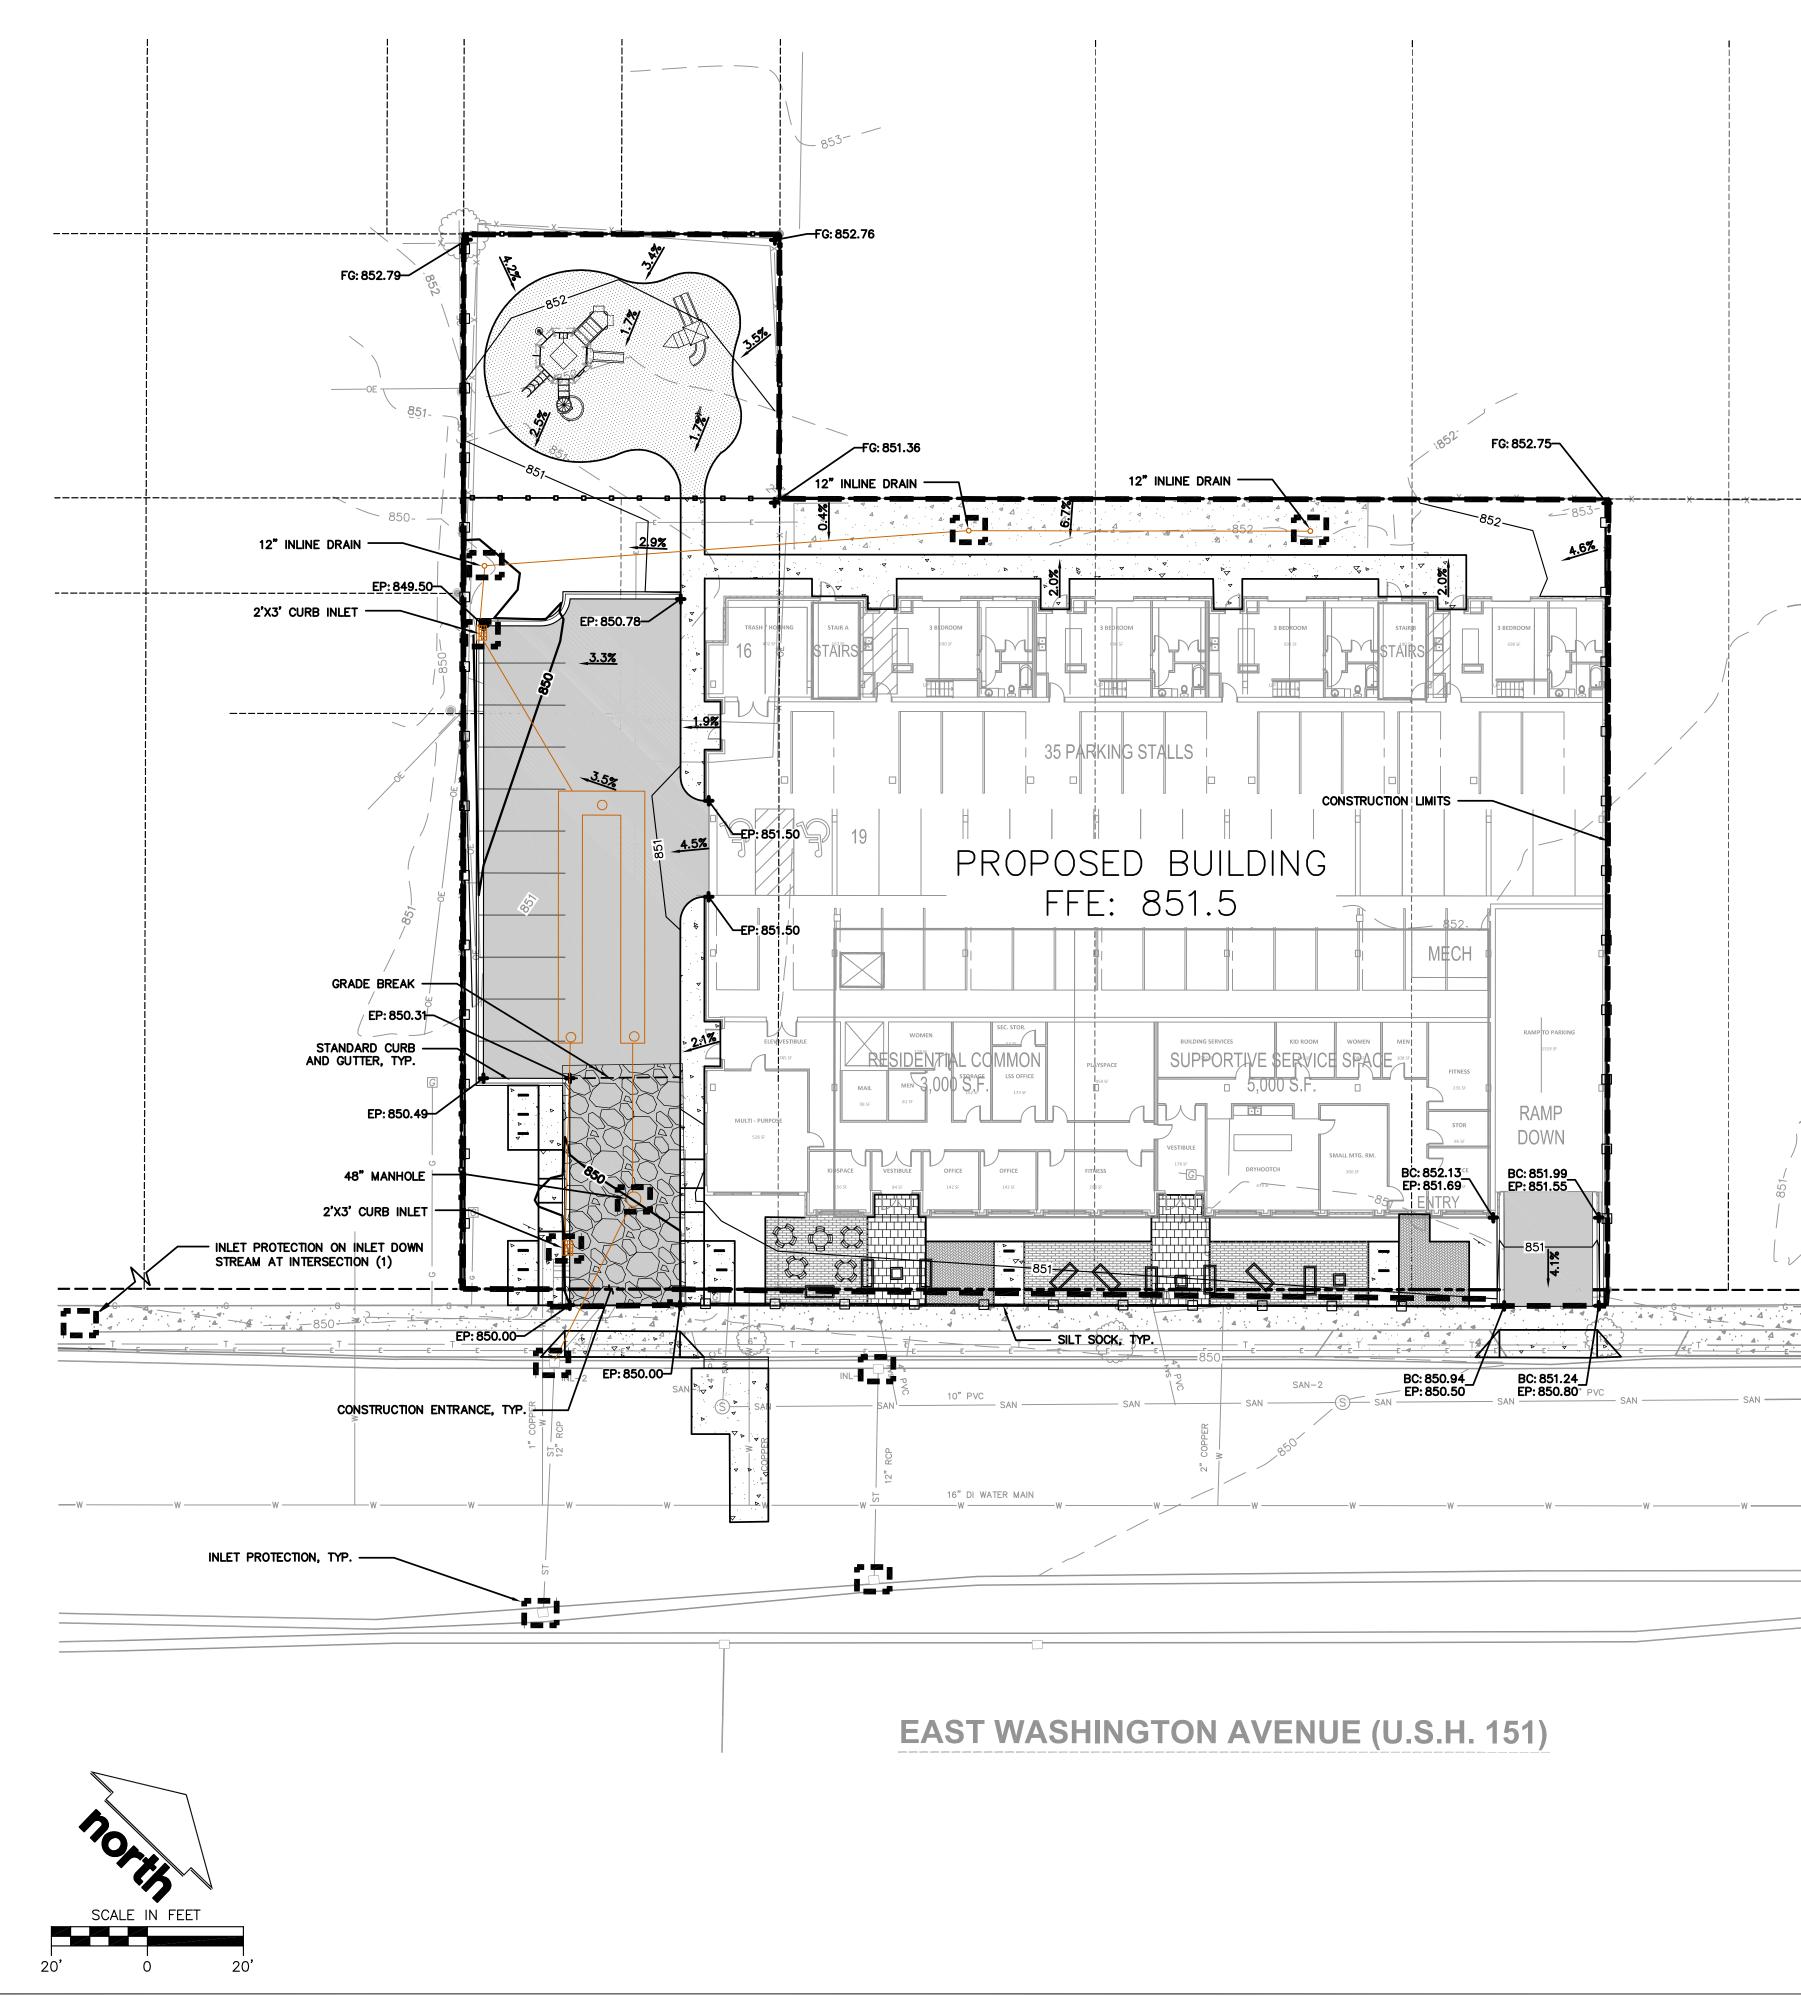

| LEGEND (GRADING | A & EROSION CONTROL PLAN) | | |
|--|--|---|---|
| | PROPERTY LINE | <u> </u> | PROPOSED 1 FOOT CONTOUR |
| | RIGHT-OF-WAY | 935 —— | PROPOSED 1 FOOT CONTOUR |
| · · · · · | EASEMENT LINE | \rightarrow | DRAINAGE DIRECTION |
| | BUILDING OUTLINE | <u> </u> | STORM SEWER |
| | BUILDING OVERHANG | | SILT SOCK |
| | EDGE OF PAVEMENT | | CONSTRUCTION LIMITS |
| | STANDARD CURB AND GUTTER | <u>[]</u> | INLET PROTECTION, TYPE D |
| | REJECT CURB AND GUTTER | | SPOT ELEVATION |
| | ASPHALT PAVEMENT | 934.20 FG | EP – EDGE OF PAVEMENT FG – FINISH GRADE |
| | HEAVY DUTY ASPHALT PAVEMENT | ¥ 337.2010 | EC – EDGE OF CONCRETE TS – TOP OF STEP |
| а са | CONCRETE PAVEMENT | | TS - BOTTOM OF STEP RIM - RIM ELEVATION |
| | HEAVY DUTY CONCRETE PAVEMENT STORMWATER MANAGEMENT AREA | | GRADE BREAK |
| | BOULDER RETAINING WALL | | |
| | MODULAR BLOCK RETAINING WALL | | |
| ~- □ | LIGHT POLE (REFER TO PHOTOMETRIC PLAN) |) | |
| <u> </u> | ADA PARKING BOLLARDS/SIGNS | , | |
| RUCTION SITE EROSION | CONTROL REQUIREMENTS (CSECI | R) NOTES: | |
| ROSION AND SEDIMENT CONTROL PI | RACTICES SHALL BE DESIGNED AND IMPLEMENT MENT CONTROL TECHNICAL STANDARDS WHICH | ED IN ACCORDANCE WITH THE | CURRENT DEPARTMENT OF |
| | RIOR TO ANY SITE WORK, INCLUDING GRADING DIMENT CONTROL DESIGN MAY BE CONDUCTED DS. | | |
| CTIONS AND MAINTENANCE OF ALL ROSION CONTROLS AT ALL TIMES. I | EROSION CONTROL MEASURES SHALL BE ROUT EROSION CONTROL MEASURES ARE TO BE IN W | TINE (ONCE PER WEEK MINIMUN VORKING ORDER AT THE END O | i) TO ENSURE PROPER FUNCTIONDF EACH WORK DAY. |
| CT EROSION CONTROL MEASURES A | FTER EACH 1/2" OR GREATER RAINFALL. REF | PAIR ANY DAMAGE OBSERVED | DURING THE INSPECTION. |
| ON CONTROL MEASURES SHALL NOT | BE REMOVED UNTIL ALL LAND DISTURBING C | ONSTRUCTION ACTIVITY AT THE | SITE HAS BEEN COMPLETED |
| THAT A UNIFORM PERENNIAL VEGET. | ATIVE COVER HAS BEEN ESTABLISHED WITH A RMANENT STRUCTURES OR THAT EMPLOY EQUI | DENSITY OF AT LEAST 70% OF | F THE COVER FOR THE UNPAVED |
| | D NO LESS THAN 12" THICK BY USE OF 3" CL _ PREVENT THE TRACKING OF MUD OR DRY SE REQUIRED. | | |
| LL EROSION CONTROLS ON THE DOV | WNSTREAM SIDE OF STOCKPILES. | | |
| ENT CONTROL STANDARDS NOTE 10 SPECTED WITHIN 24 HOURS AFTER VED WHEN SEDIMENT REACHES A DI | ER LATEST EDITION OF WDNR STORM WATER CO 63. SEDIMENT TRAPS SHALL BE SIZED BASED EVERY RAIN EVENT PRODUCING 0.5 INCHES OF EPTH OF 1 FOOT OR WHEN OUTLET BECOMES O BED AREA DRAINING TO THE SEDIMENT TRAP I 0. | ON MEDIUM SOIL TEXTURAL C RAIN OR MORE AND AT A MI CLOGGED. SEDIMENT TRAPS SH | LASS. SEDIMENT TRAPS SHALL INIMUM SEDIMENT SHALL BE IALL BE REMOVED AND THE |
| LL CHECK DAMS WITHIN DRAINAGE DARDS. | DITCHES AND IN FRONT OF SILT FENCING IN A | NY LOW AREA ALL IN ACCORD | ANCE WITH WONR TECHNICAL |
| IE INVERT OF THE SWALE. CHECK D E SIDE SLOPES, EACH WAY. STONE EL SURFACE ON PARKING LOT. TEMI | SOUTH OF THE PROPOSED GRAVEL PARKING LO AMS SHALL BE A MINIMUM OF 1.5 FEET IN HE CHECK DAMS SHALL BE INSTALLED FOLLOWING PORARY SEDIMENT TRAPS SHALL BE REMOVED CTION DETAILS OF STONE CHECK DAM. | IGHT ABOVE THE INVERT OF T | THE SWALE AND EXTENDED TO PRIOR TO PLACEMENT OF |
| PLACE EXCAVATED TRENCH MATER BACKFILL, COMPACT, AND STABILIZ DISCHARGE TRENCH WATER INTO A | CTION (STORM SEWER, SANITARY SEWER, WATE IAL ON THE HIGH SIDE OF THE TRENCH. E THE TRENCH IMMEDIATELY AFTER PIPE CONS SEDIMENTATION BASIN OR FILTERING TANK IN THE STORM SEWER, RECEIVING STREAM, OR D | STRUCTION. | ATERING TECHNICAL STANDARD |
| IONAL EROSION CONTROL MEASURES | S, AS REQUESTED BY STATE INSPECTORS, LOC | AL INSPECTORS, AND/OR ENG | NEER SHALL BE INSTALLED |
| 5 II, TYPE B EROSION MATTING, WITH | STABILIZED WITH CLASS I, TYPE B EROSION M HIN 7 DAYS OF REACHING FINAL GRADE AND/ ABILIZATION PRACTICES FOR POTENTIAL INTERI | OR AS SOON AS CONDITIONS / | |
| RACTOR/OWNER SHALL FILE A NOTIOR | CE OF TERMINATION UPON VEGETATIVE STABILI | ZATION AND/OR PROPERTY SA | ALE IN ACCORDANCE WITH WONR |
| RACTOR SHALL TAKE ALL NECESSAF DARD 1068. | RY STEPS TO CONTROL DUST ARISING FROM CO | ONSTRUCTION OPERATIONS. RE | FER TO WDNR TECHNICAL |
| SITE GRADING AND DISTURBANCE SH | ALL BE OUTSIDE 10' WETLAND SETBACK(BUFF | ER ZONE) | |
| FENCE LOCATION REPRESENTED ON | SHEET C2.0 INDICATES DISTURBANCE LIMITS. R | REFER TO CSECR NOTE 14 FOR | R DETAILS. |
| LIZATION PRACTICES: | | | |

CONST 1. ALL E NATUF http:/

- INSTAL SHOWN
- 3. INSPEC OF ER
- 4. INSPEC 5. EROSIO AND
- AREAS 6. INSTAL CONTR WORKI
- 7. INSTAL
- 8. INSTAL SEDIME BE INS REMOV LOCAT SEDIME
- 9. INSTAL STAND
- 10. INSTAL AT TH SWALE GRAVE REFER
- 11. EROSIC
- 11. ADDITI WITHIN
- 12. ALL SI CLASS "CSECI
- 13. CONTR REQU
- 14. CONTR STAND
- 15. ALL SI
- 16. SILT F
- 17. <u>STABI</u>
- * STABILIZATION MEASURES SHALL BE INITIATED AS SOON AS PRACTICABLE IN PORTIONS OF THE SITE WHERE CONSTRUCTION ACTIVITIES 17.1. PORTION OF THE SITE HAS CEASED UNLESS:
- * THE INITIATION STABILIZATION MEASURES BY THE SEVENTH (7) DAY AFTER CONSTRUCTION ACTIVITY HAS CEASED IS PRECLUDED BY SNOW COVER. IN THAT EVENT, STABILIZATION SHALL BE INITIATED AS SOON AS PRACTICABLE. 17.2. 17.3
- ACTIVITY HAS TEMPORARILY CEASED. 17.4. ACCEPTABLE STABILIZATION MEASURES:
 - * PERMANENT SEEDING; IN ACCORDANCE WITH APPROVED CONSTRUCTION SPECIFICATION
 - * HYDRO-MULCHING WITH A TACKIFIER * GEOTEXTILE EROSION MATTING
 - * SODDING

GRADING AND SEEDING NOTES

- 1. ALL DISTURBED AREAS SHALL BE SODDED AND/OR SEEDED AND MULCHED IMMEDIATELY FOLLOWING GRADING ACTIVITIES. SOD/SEED MIX TO BE IN ACCORDANCE WITH LANDSCAPE PLAN.
- OF TERMINATION FILED.
- 4. CONTRACTOR SHALL CHISEL-PLOW OR DEEP TILL WITH DOUBLE TINES ALL STORMWATER MANAGEMENT FACILITIES JUST PRIOR TO SODDING AND/OR SEEDING AND MULCHING TO PROMOTE INFILTRATION.
- 5. CONTRACTOR SHALL WATER ALL NEWLY SODDED/SEEDED AREAS DURING THE SUMMER MONTHS WHENEVER THERE IS A 7 DAY LAPSE WITH NO SIGNIFICANT RAINFALL.
- 6. CONTRACTOR TO DEEP TILL ALL COMPACTED PERVIOUS SURFACES PRIOR TO SODDING AND/OR SEEDING AND MULCHING.
- 7. THE CONTRACTOR SHALL NOTIFY THE CITY OF MADISON TWO (2) WORKING DAYS IN ADVANCE OF ANY SOIL DISTURBING ACTIVITY.
- 8. IF GRADING ACTIVITIES STOP ON ANY PORTION OF LAND FOR 14 OR MORE CALENDAR DAYS, THE AREA IN QUESTION MUST BE TEMPORARILY STABILIZED.
- 9. ALL SLOPES 20% OR GREATER SHALL BE TEMPORARY SEEDED, MULCHED, OR OTHER MEANS OF COVER PLACED ON THEM WITHIN 2 WEEKS OF DISTURBANCE.

HAVE TEMPORARILY OR PERMANENTLY CEASED. NO MORE THAN SEVEN (7) DAYS SHALL PASS AFTER THE CONSTRUCTION ACTIVITY IN THAT

* CONSTRUCTION ACTIVITY WILL RESUME ON A PORTION OF THE SITE WITHIN FOURTEEN (14) DAYS FROM WHEN ACTIVITY CEASED, (I.E. THE TOTAL TIME PERIOD THAT THE CONSTRUCTION ACTIVITY IS TEMPORARILY CEASED IS LESS THAN FOURTEEN (14) DAYS. IN THAT EVENT, STABILIZATION MEASURES DO NOT HAVE TO BE INITIATED ON THAT PORTION OF THE SITE BY THE SEVENTH (7) DAY AFTER CONSTRUCTION * STABILIZATION MEASURES SHALL BE DETERMINED BASED ON SITE CONDITIONS AT THE TIME OF CONSTRUCTION ACTIVITY HAS CEASED,


INCLUDING BUT NOT LIMITED TO WEATHER CONDITIONS AND LENGTH OF TIME MEASURE MUST BE EFFECTIVE. THE FOLLOWING ARE

* TEMPORARY SEEDING; MAY CONSIST OF SPRING OATS(100LBS/ACRE) AND/OR WHEAT OR CEREAL RYE (150LB/ACRE)


2. ALL PROPOSED GRADES SHOWN ARE FINISHED GRADES. CONTRACTOR SHALL VERIFY ALL GRADES, MAKE SURE ALL AREAS DRAIN PROPERLY AND SHALL REPORT ANY DISCREPANCIES TO THE ENGINEER PRIOR TO CONSTRUCTION. 5. CONTRACTOR SHALL PROTECT ADJACENT PROPERTIES WITH SILT FENCING FOR EROSION CONTROL UNTIL CONSTRUCTION IS COMPLETED AND NOTICE



Toll Free (800) 242-8511

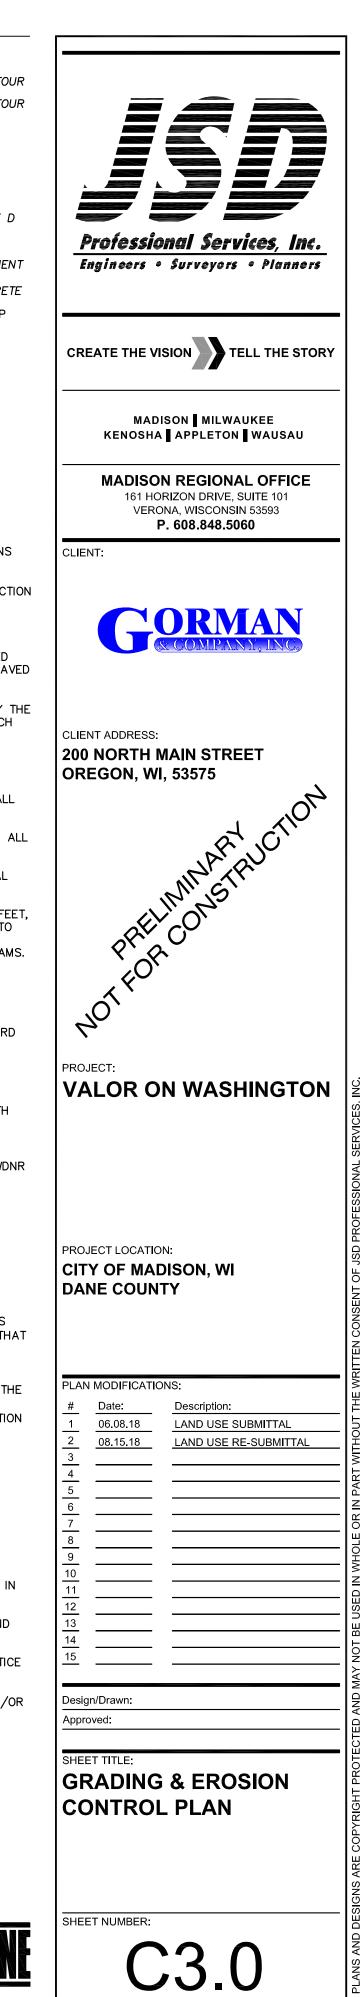

JSD PROJECT NO:

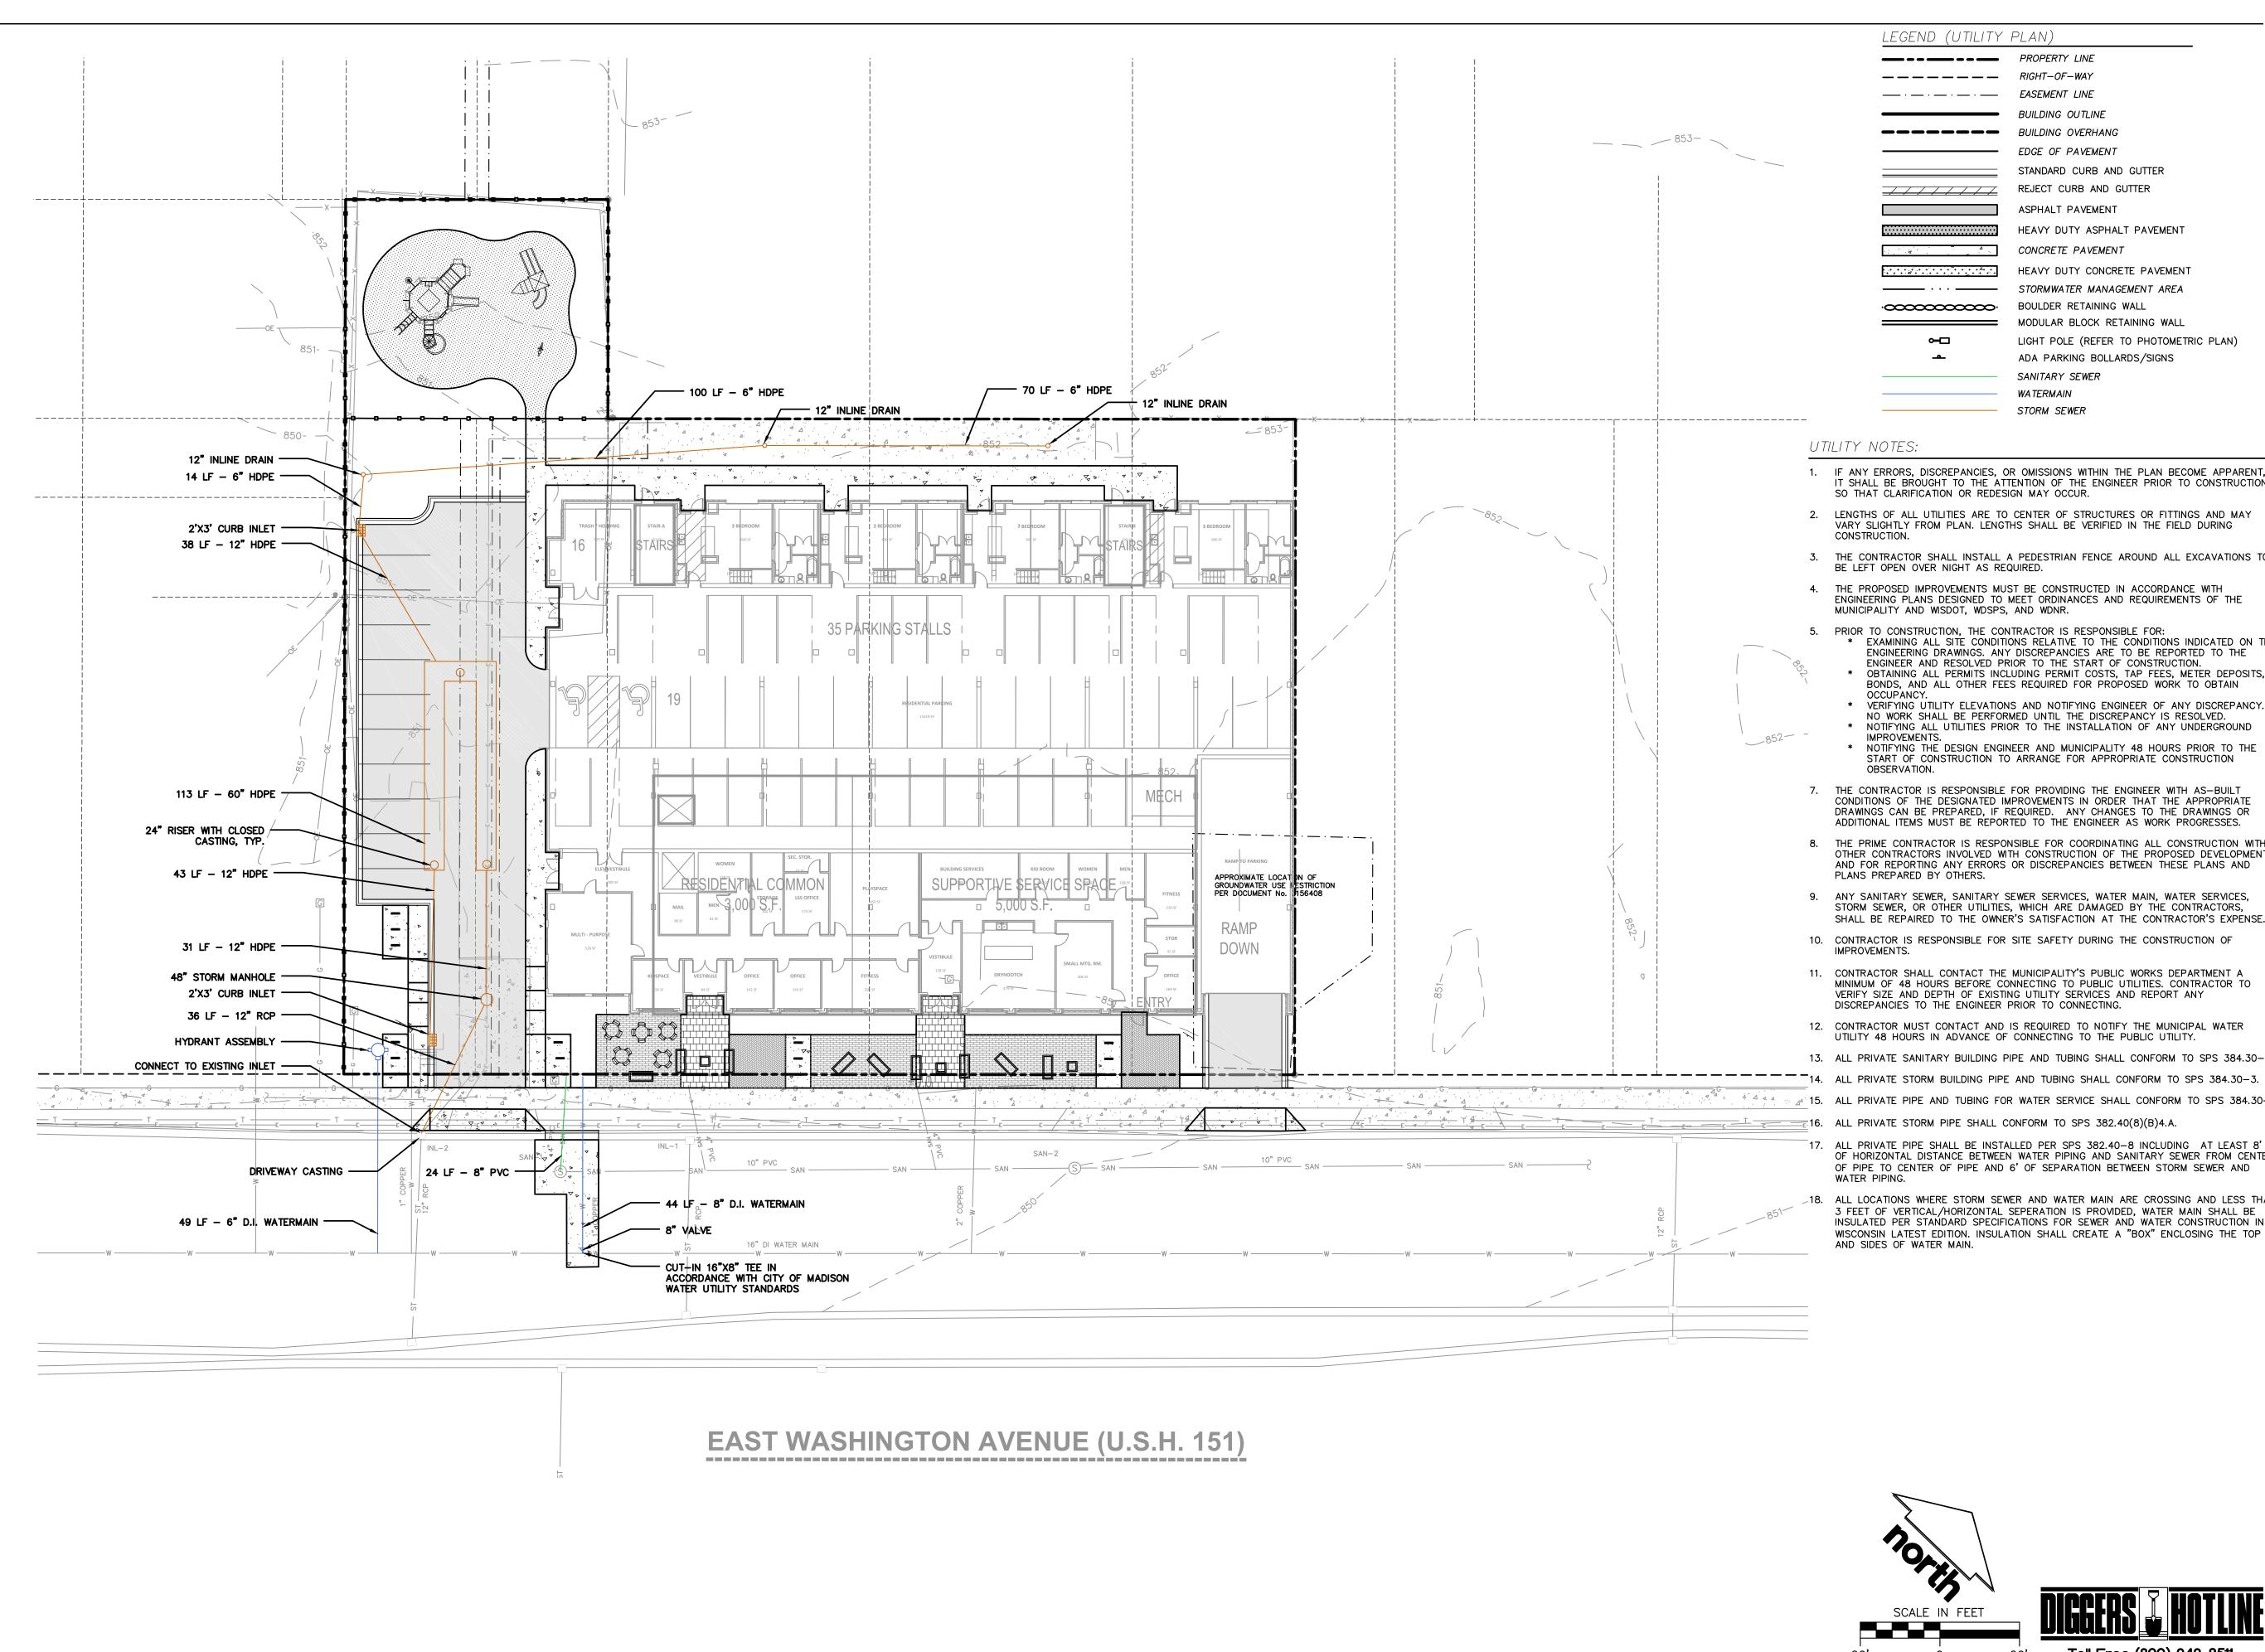

| LEGEND (UTILITY | ρι ΔΝ) |
|---------------------------------------|--|
| | PROPERTY LINE |
| | RIGHT-OF-WAY |
| | EASEMENT LINE |
| | BUILDING OUTLINE |
| | BUILDING OVERHANG |
| | EDGE OF PAVEMENT |
| | |
| | STANDARD CURB AND GUTTER |
| | REJECT CURB AND GUTTER |
| | ASPHALT PAVEMENT |
| | HEAVY DUTY ASPHALT PAVEMENT |
| ۵. | CONCRETE PAVEMENT |
| · · · · · · · · · · · · · · · · · · · | HEAVY DUTY CONCRETE PAVEMENT |
| · · · · | STORMWATER MANAGEMENT AREA |
| • | BOULDER RETAINING WALL |
| | MODULAR BLOCK RETAINING WALL |
| ⊶⊡ | LIGHT POLE (REFER TO PHOTOMETRIC PLAN) |
| <u> </u> | ADA PARKING BOLLARDS/SIGNS |
| | SANITARY SEWER |
| | WATERMAIN |
| | STORM SEWER |
| | |

1. IF ANY ERRORS, DISCREPANCIES, OR OMISSIONS WITHIN THE PLAN BECOME APPARENT, IT SHALL BE BROUGHT TO THE ATTENTION OF THE ENGINEER PRIOR TO CONSTRUCTION SO THAT CLARIFICATION OR REDESIGN MAY OCCUR.

2. LENGTHS OF ALL UTILITIES ARE TO CENTER OF STRUCTURES OR FITTINGS AND MAY VARY SLIGHTLY FROM PLAN. LENGTHS SHALL BE VERIFIED IN THE FIELD DURING

3. THE CONTRACTOR SHALL INSTALL A PEDESTRIAN FENCE AROUND ALL EXCAVATIONS TO BE LEFT OPEN OVER NIGHT AS REQUIRED.

4. THE PROPOSED IMPROVEMENTS MUST BE CONSTRUCTED IN ACCORDANCE WITH ENGINEERING PLANS DESIGNED TO MEET ORDINANCES AND REQUIREMENTS OF THE MUNICIPALITY AND WISDOT, WDSPS, AND WDNR.

PRIOR TO CONSTRUCTION, THE CONTRACTOR IS RESPONSIBLE FOR: * EXAMINING ALL SITE CONDITIONS RELATIVE TO THE CONDITIONS INDICATED ON THE ENGINEERING DRAWINGS. ANY DISCREPANCIES ARE TO BE REPORTED TO THE ENGINEER AND RESOLVED PRIOR TO THE START OF CONSTRUCTION. OBTAINING ALL PERMITS INCLUDING PERMIT COSTS, TAP FEES, METER DEPOSITS, BONDS, AND ALL OTHER FEES REQUIRED FOR PROPOSED WORK TO OBTAIN OCCUPANCY.

* VERIFYING UTILITY ELEVATIONS AND NOTIFYING ENGINEER OF ANY DISCREPANCY. NO WORK SHALL BE PERFORMED UNTIL THE DISCREPANCY IS RESOLVED. * NOTIFYING ALL UTILITIES PRIOR TO THE INSTALLATION OF ANY UNDERGROUND IMPROVEMENTS. NOTIFYING THE DESIGN ENGINEER AND MUNICIPALITY 48 HOURS PRIOR TO THE START OF CONSTRUCTION TO ARRANGE FOR APPROPRIATE CONSTRUCTION

OBSERVATION. 7. THE CONTRACTOR IS RESPONSIBLE FOR PROVIDING THE ENGINEER WITH AS-BUILT

CONDITIONS OF THE DESIGNATED IMPROVEMENTS IN ORDER THAT THE APPROPRIATE DRAWINGS CAN BE PREPARED, IF REQUIRED. ANY CHANGES TO THE DRAWINGS OR ADDITIONAL ITEMS MUST BE REPORTED TO THE ENGINEER AS WORK PROGRESSES.

THE PRIME CONTRACTOR IS RESPONSIBLE FOR COORDINATING ALL CONSTRUCTION WITH OTHER CONTRACTORS INVOLVED WITH CONSTRUCTION OF THE PROPOSED DEVELOPMENT AND FOR REPORTING ANY ERRORS OR DISCREPANCIES BETWEEN THESE PLANS AND PLANS PREPARED BY OTHERS.

9. ANY SANITARY SEWER, SANITARY SEWER SERVICES, WATER MAIN, WATER SERVICES, STORM SEWER, OR OTHER UTILITIES, WHICH ARE DAMAGED BY THE CONTRACTORS, SHALL BE REPAIRED TO THE OWNER'S SATISFACTION AT THE CONTRACTOR'S EXPENSE. 10. CONTRACTOR IS RESPONSIBLE FOR SITE SAFETY DURING THE CONSTRUCTION OF

11. CONTRACTOR SHALL CONTACT THE MUNICIPALITY'S PUBLIC WORKS DEPARTMENT A MINIMUM OF 48 HOURS BEFORE CONNECTING TO PUBLIC UTILITIES. CONTRACTOR TO VERIFY SIZE AND DEPTH OF EXISTING UTILITY SERVICES AND REPORT ANY DISCREPANCIES TO THE ENGINEER PRIOR TO CONNECTING.


12. CONTRACTOR MUST CONTACT AND IS REQUIRED TO NOTIFY THE MUNICIPAL WATER UTILITY 48 HOURS IN ADVANCE OF CONNECTING TO THE PUBLIC UTILITY.


13. ALL PRIVATE SANITARY BUILDING PIPE AND TUBING SHALL CONFORM TO SPS 384.30-2.

E16. ALL PRIVATE STORM PIPE SHALL CONFORM TO SPS 382.40(8)(B)4.A.

> 17. ALL PRIVATE PIPE SHALL BE INSTALLED PER SPS 382.40-8 INCLUDING AT LEAST 8' OF HORIZONTAL DISTANCE BETWEEN WATER PIPING AND SANITARY SEWER FROM CENTER OF PIPE TO CENTER OF PIPE AND 6' OF SEPARATION BETWEEN STORM SEWER AND

>18. ALL LOCATIONS WHERE STORM SEWER AND WATER MAIN ARE CROSSING AND LESS THAN 3 FEET OF VERTICAL/HORIZONTAL SEPERATION IS PROVIDED, WATER MAIN SHALL BE INSULATED PER STANDARD SPECIFICATIONS FOR SEWER AND WATER CONSTRUCTION IN WISCONSIN LATEST EDITION. INSULATION SHALL CREATE A "BOX" ENCLOSING THE TOP AND SIDES OF WATER MAIN.

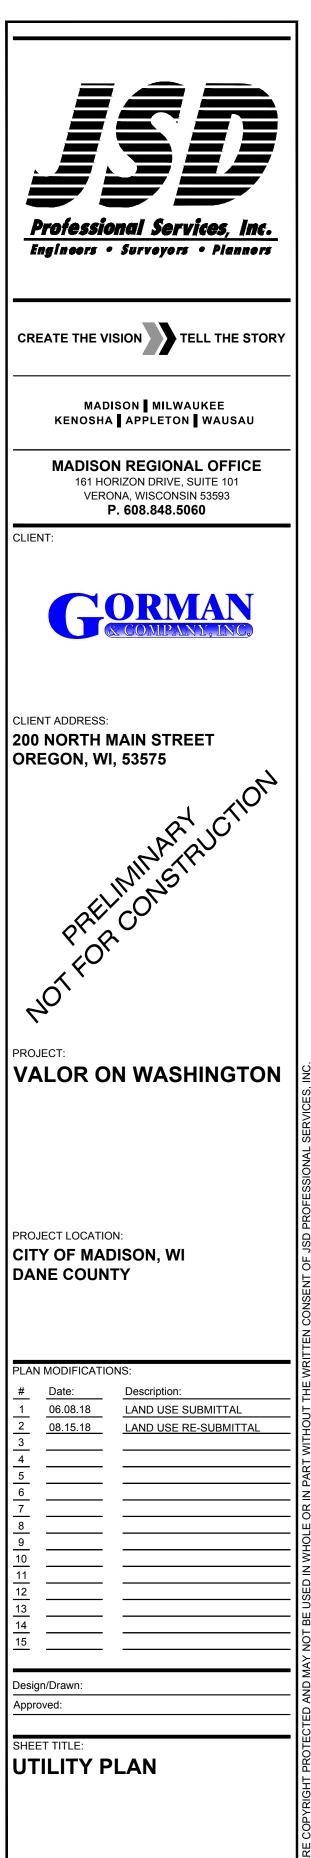

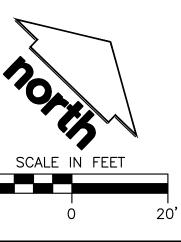





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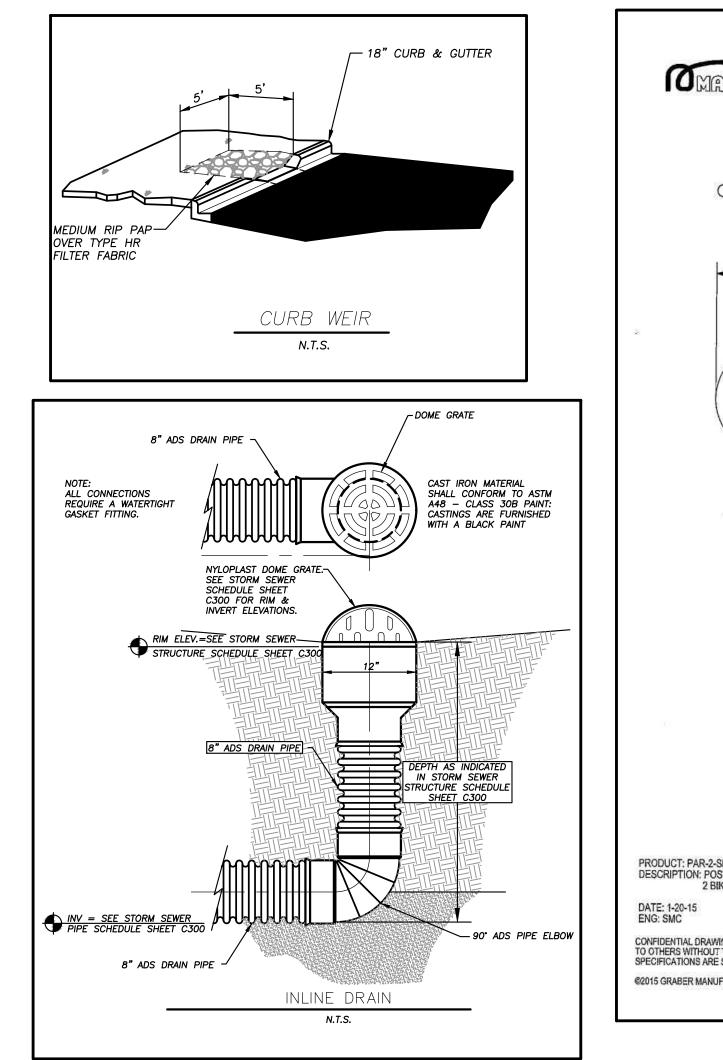



| | Mal Services, Inc. Surveyors • Planners |
|---|---|
| CREATE THE VI | SION TELL THE STORY |
| MADISO 161 HO VERC | APPLETON WAUSAU N REGIONAL OFFICE RIZON DRIVE, SUITE 101 DNA, WISCONSIN 53593 2. 608.848.5060 |
| | ORMAN COMPANY, INC. |
| PROJECT: | N WASHINGTON |
| PROJECT LOCATIO CITY OF MAE DANE COUN | DISON, WI |
| PLAN MODIFICATIO | DNS: Description: LAND USE SUBMITTAL LAND USE RE-SUBMITTAL |
| 7 8 9 10 11 12 13 14 15 | |
| Design/Drawn: Approved: SHEET TITLE: | CHG WHD ESS PLAN |
| SHEET NUMBER: | |
| | 5.0 |

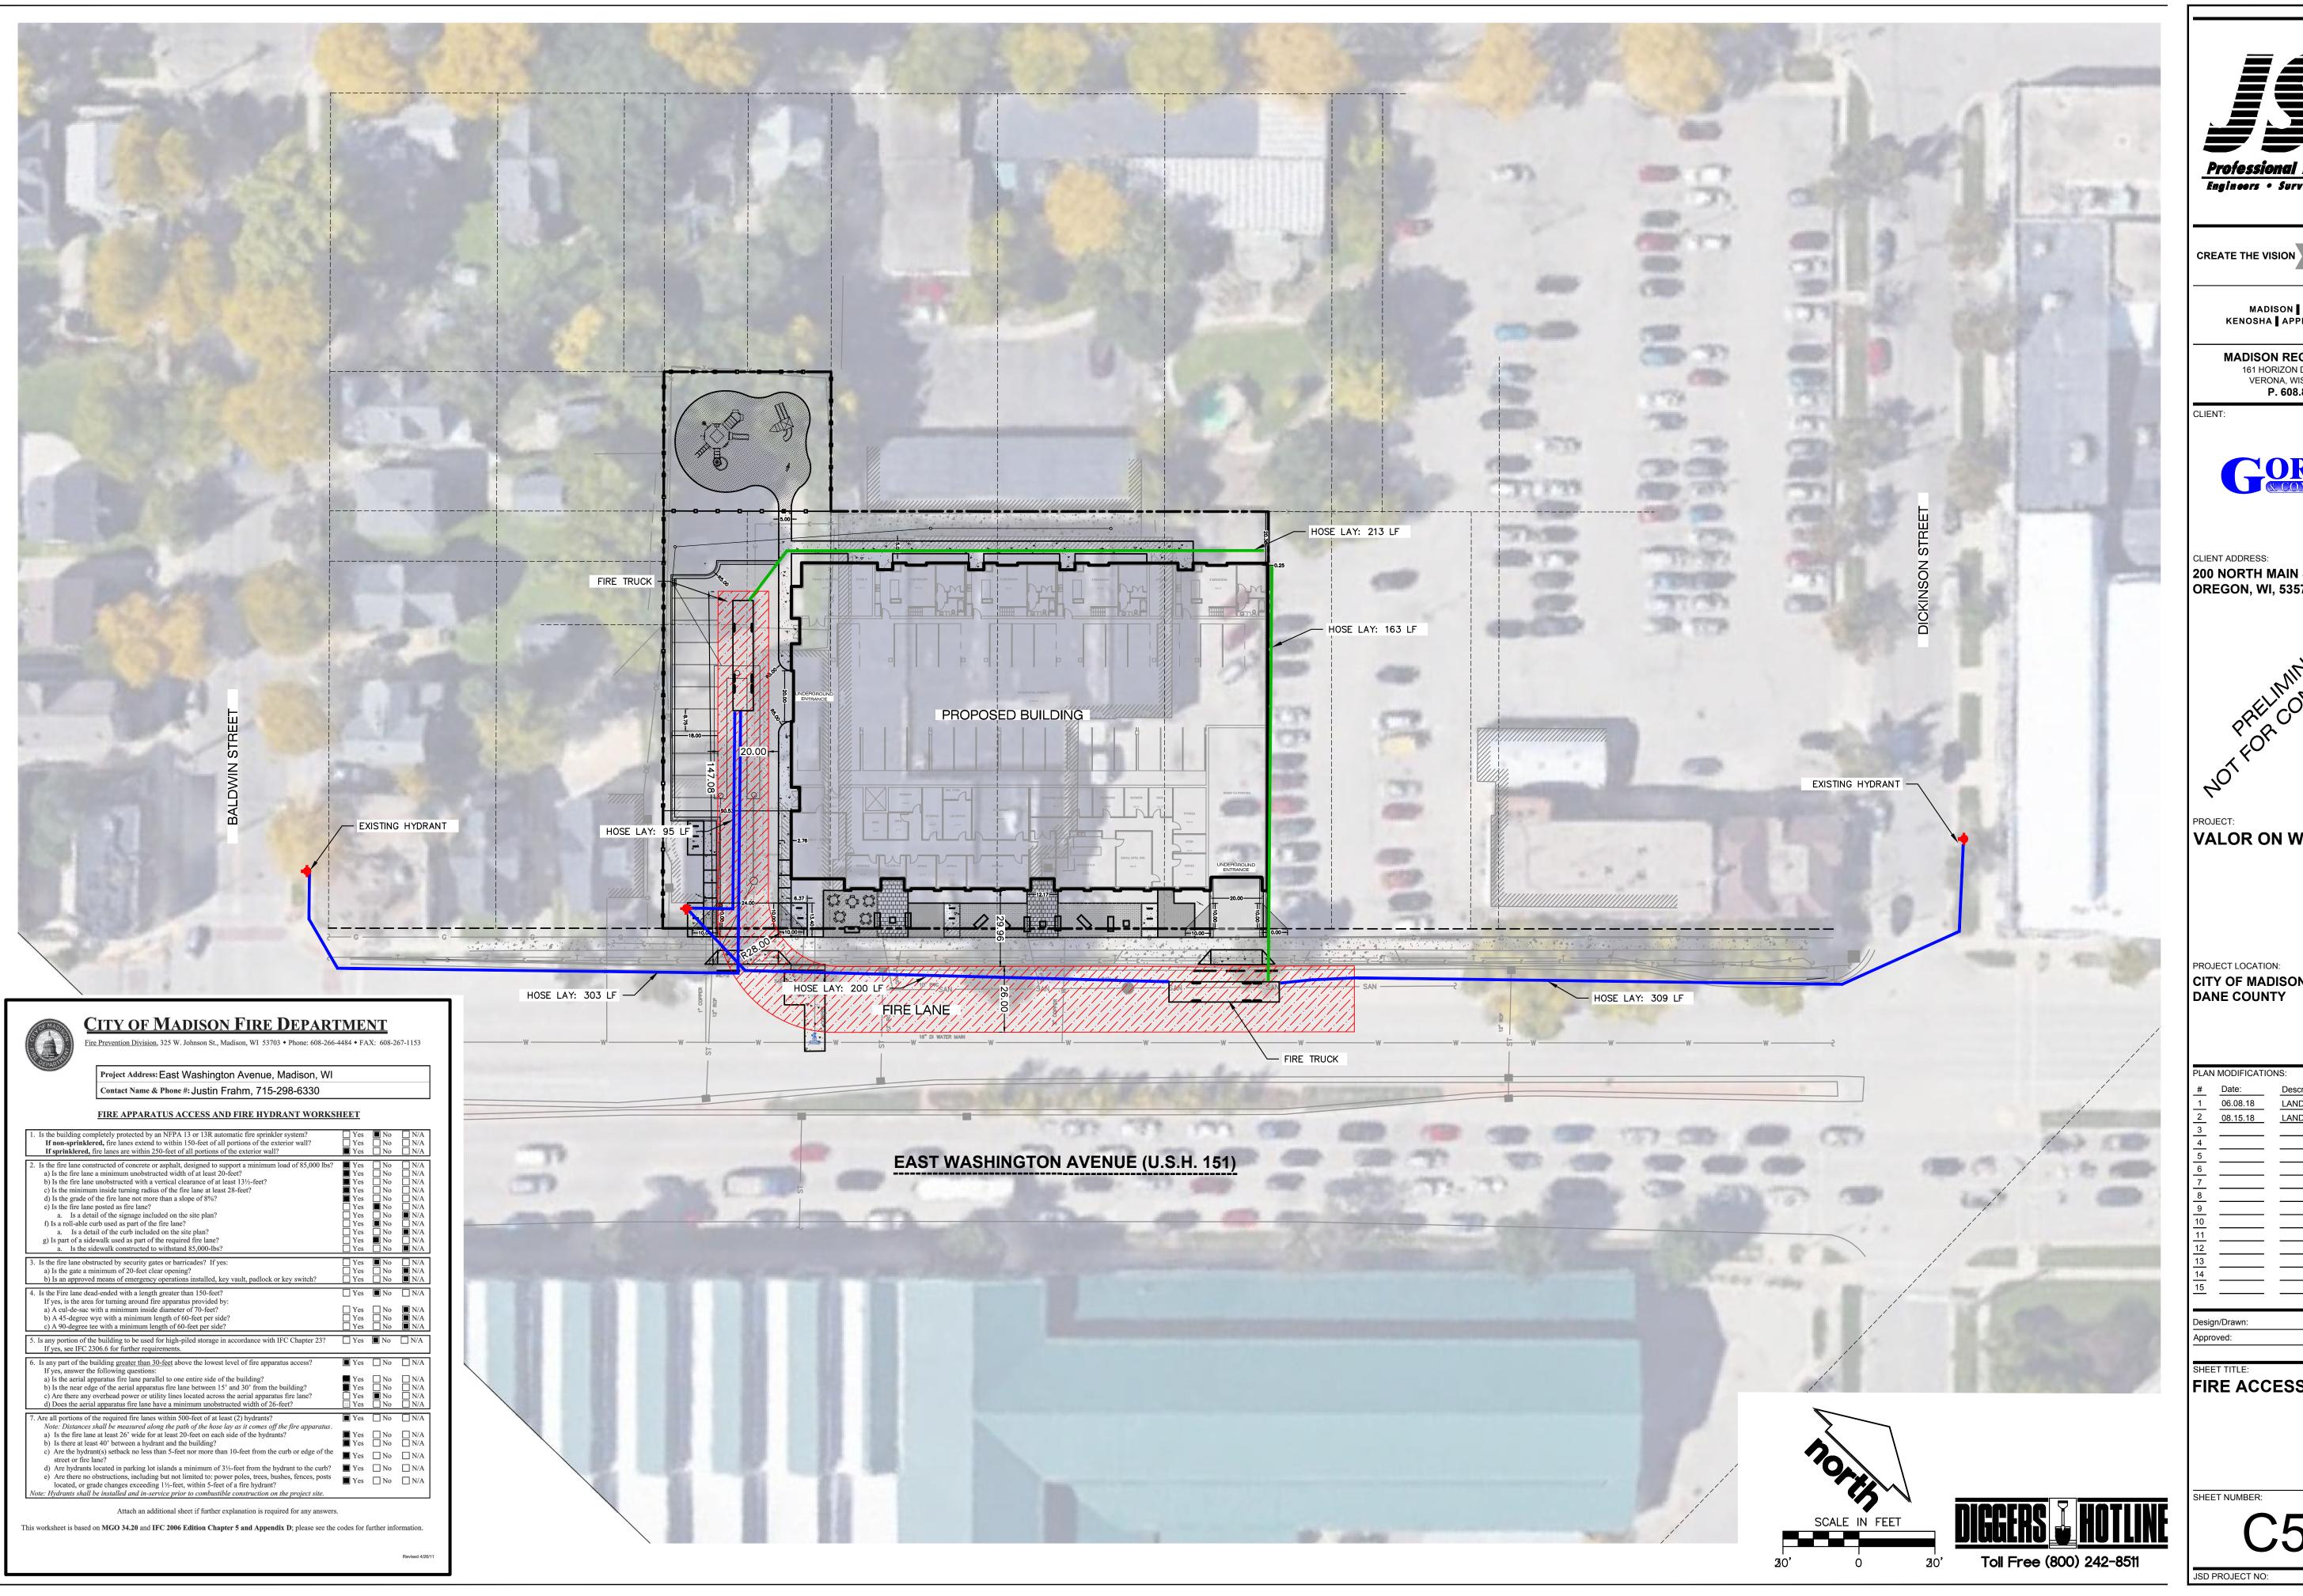

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| | Mal Services, Inc. Surveyors • Planners |
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| CREATE THE VI | SION TELL THE STORY |
| | ISON MILWAUKEE |
| 161 HO VERC | N REGIONAL OFFICE RIZON DRIVE, SUITE 101 DNA, WISCONSIN 53593 P. 608.848.5060 |
| LIENT: | |
| G | ORMAN COMPANY, INC. |
| CLIENT ADDRESS: 200 NORTH N DREGON, WI | MAIN STREET |
| NOTFOR | MAIN STREET 53575 MARTAUCTION |
| ROJECT: | N WASHINGTON |
| PROJECT LOCATIO CITY OF MAE DANE COUN | DISON, WI |
| PLAN MODIFICATIO | DNS: |
| # Date: 1 06.08.18 | Description: LAND USE SUBMITTAL |
| 2 08.15.18 3 | LAND USE RE-SUBMITTAL |
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| Design/Drawn: Approved: | CHG WHD |
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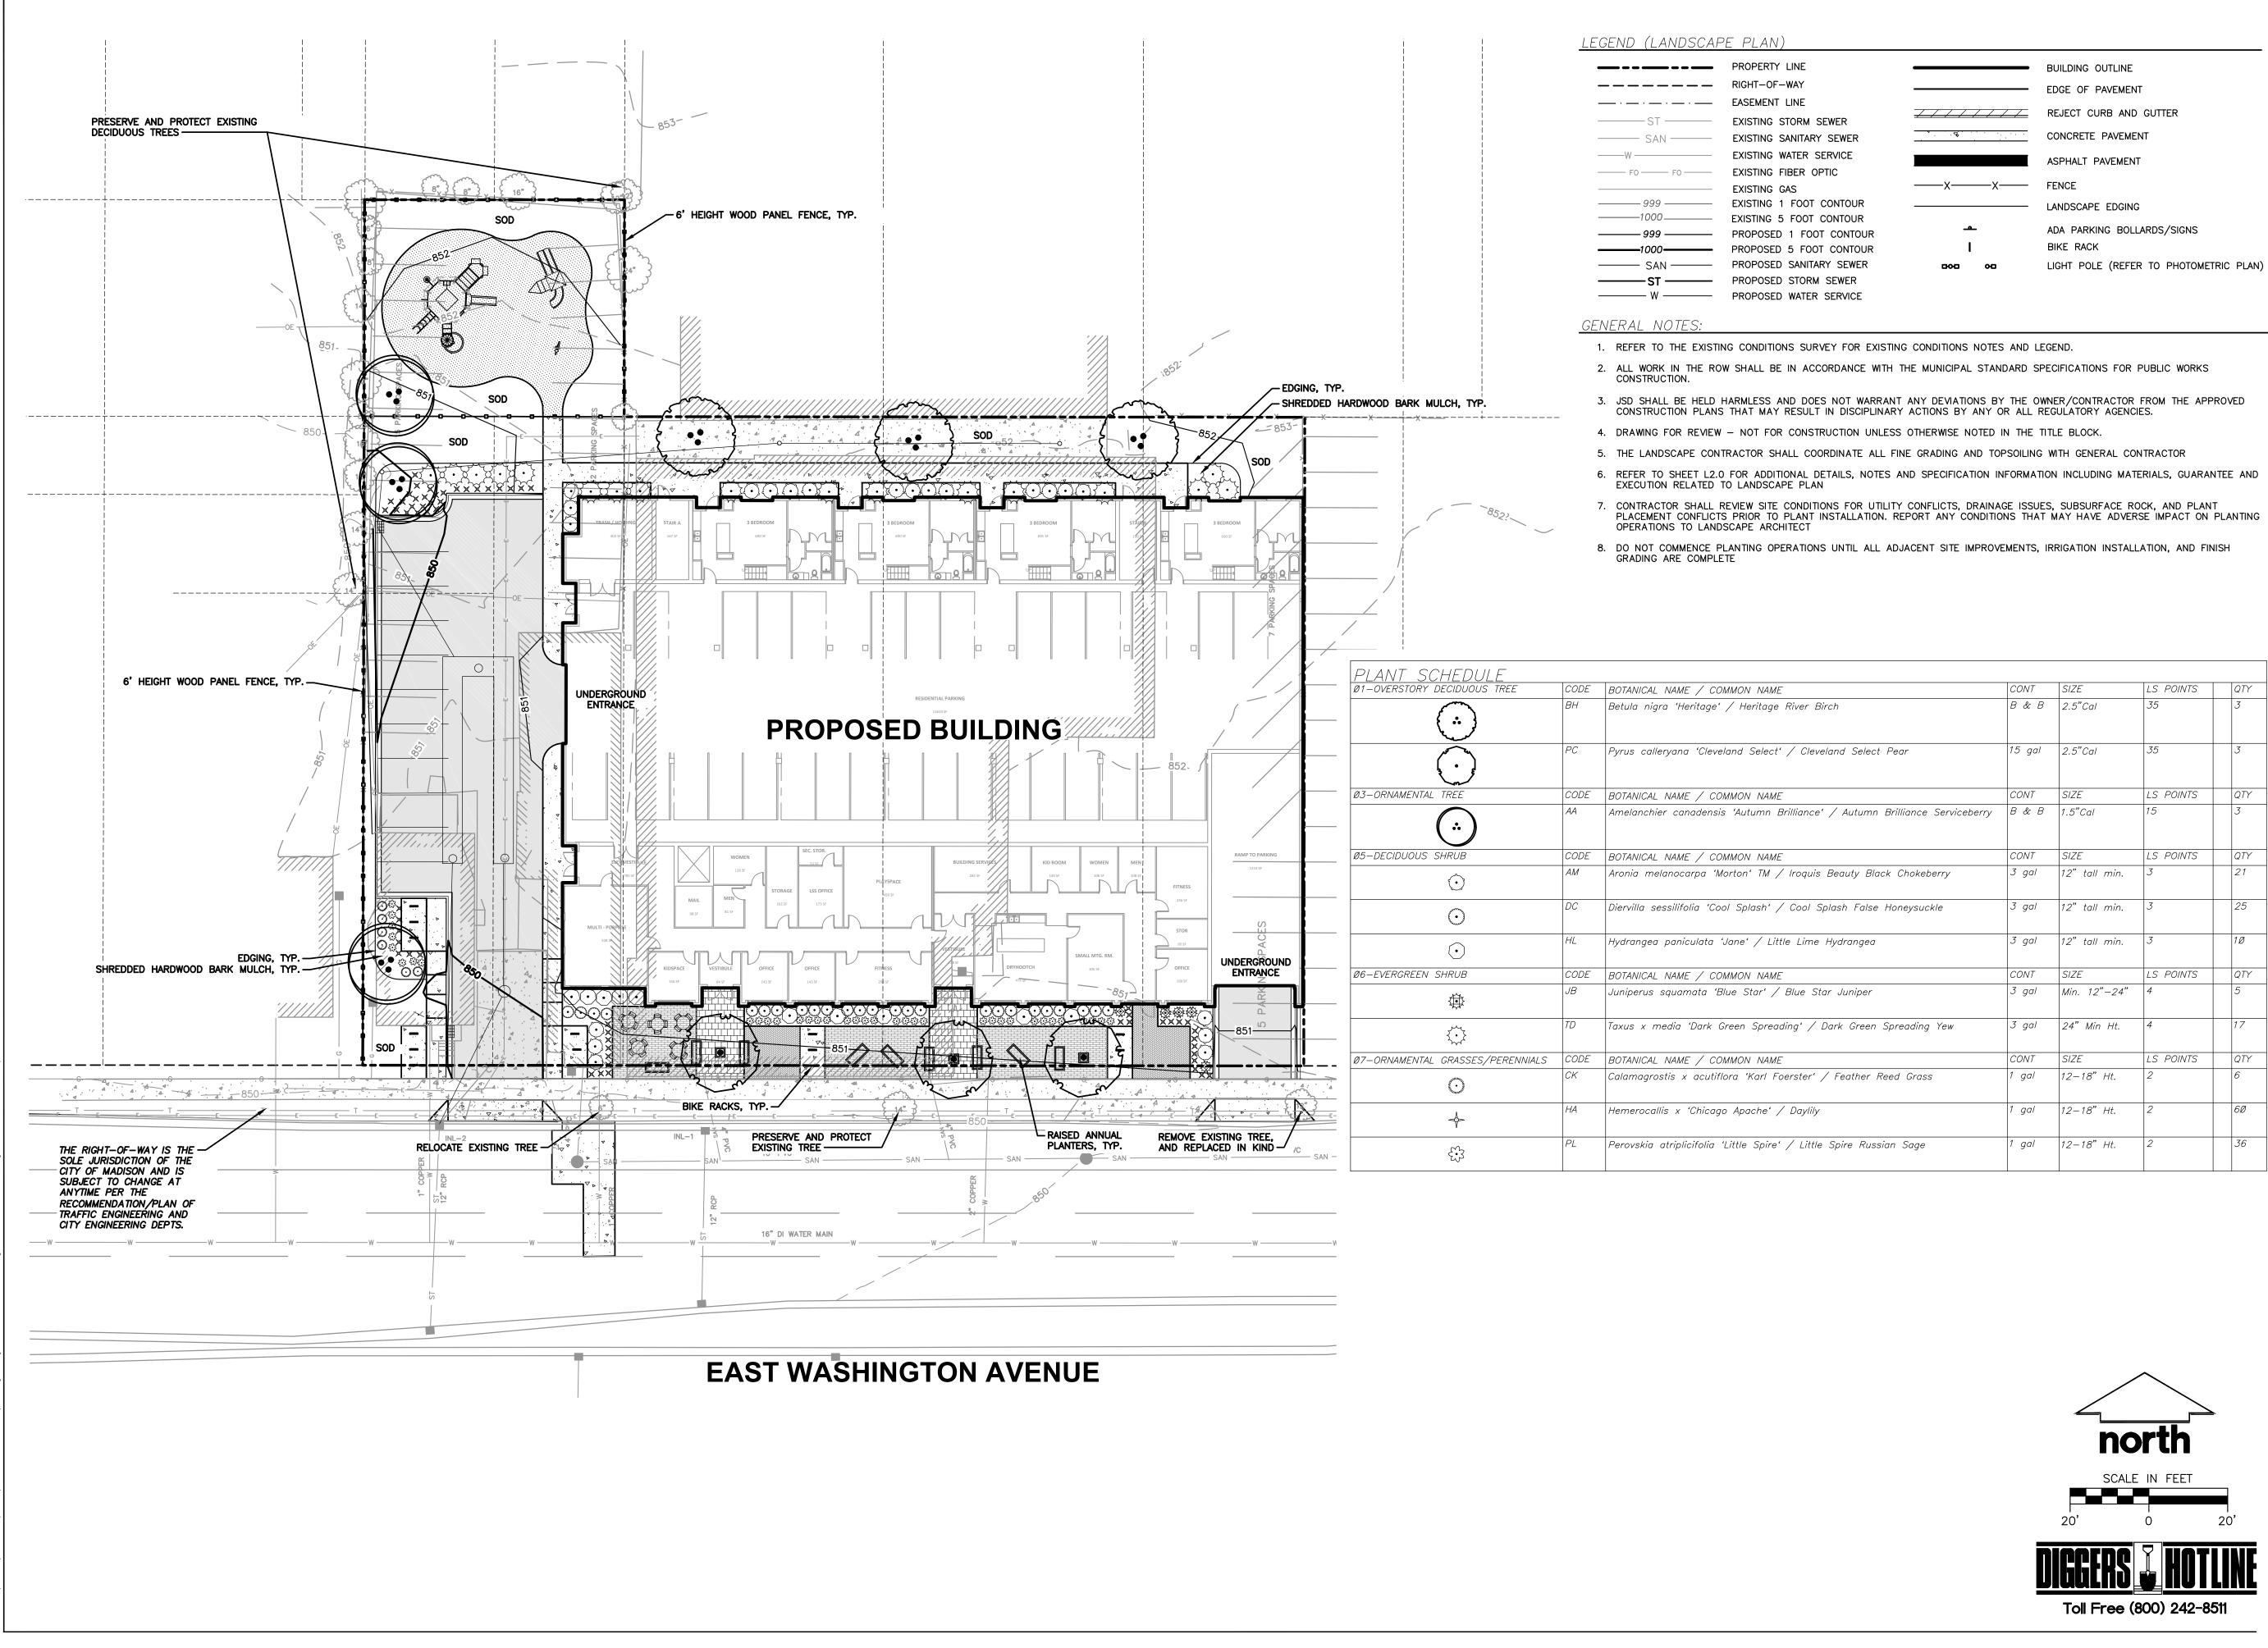


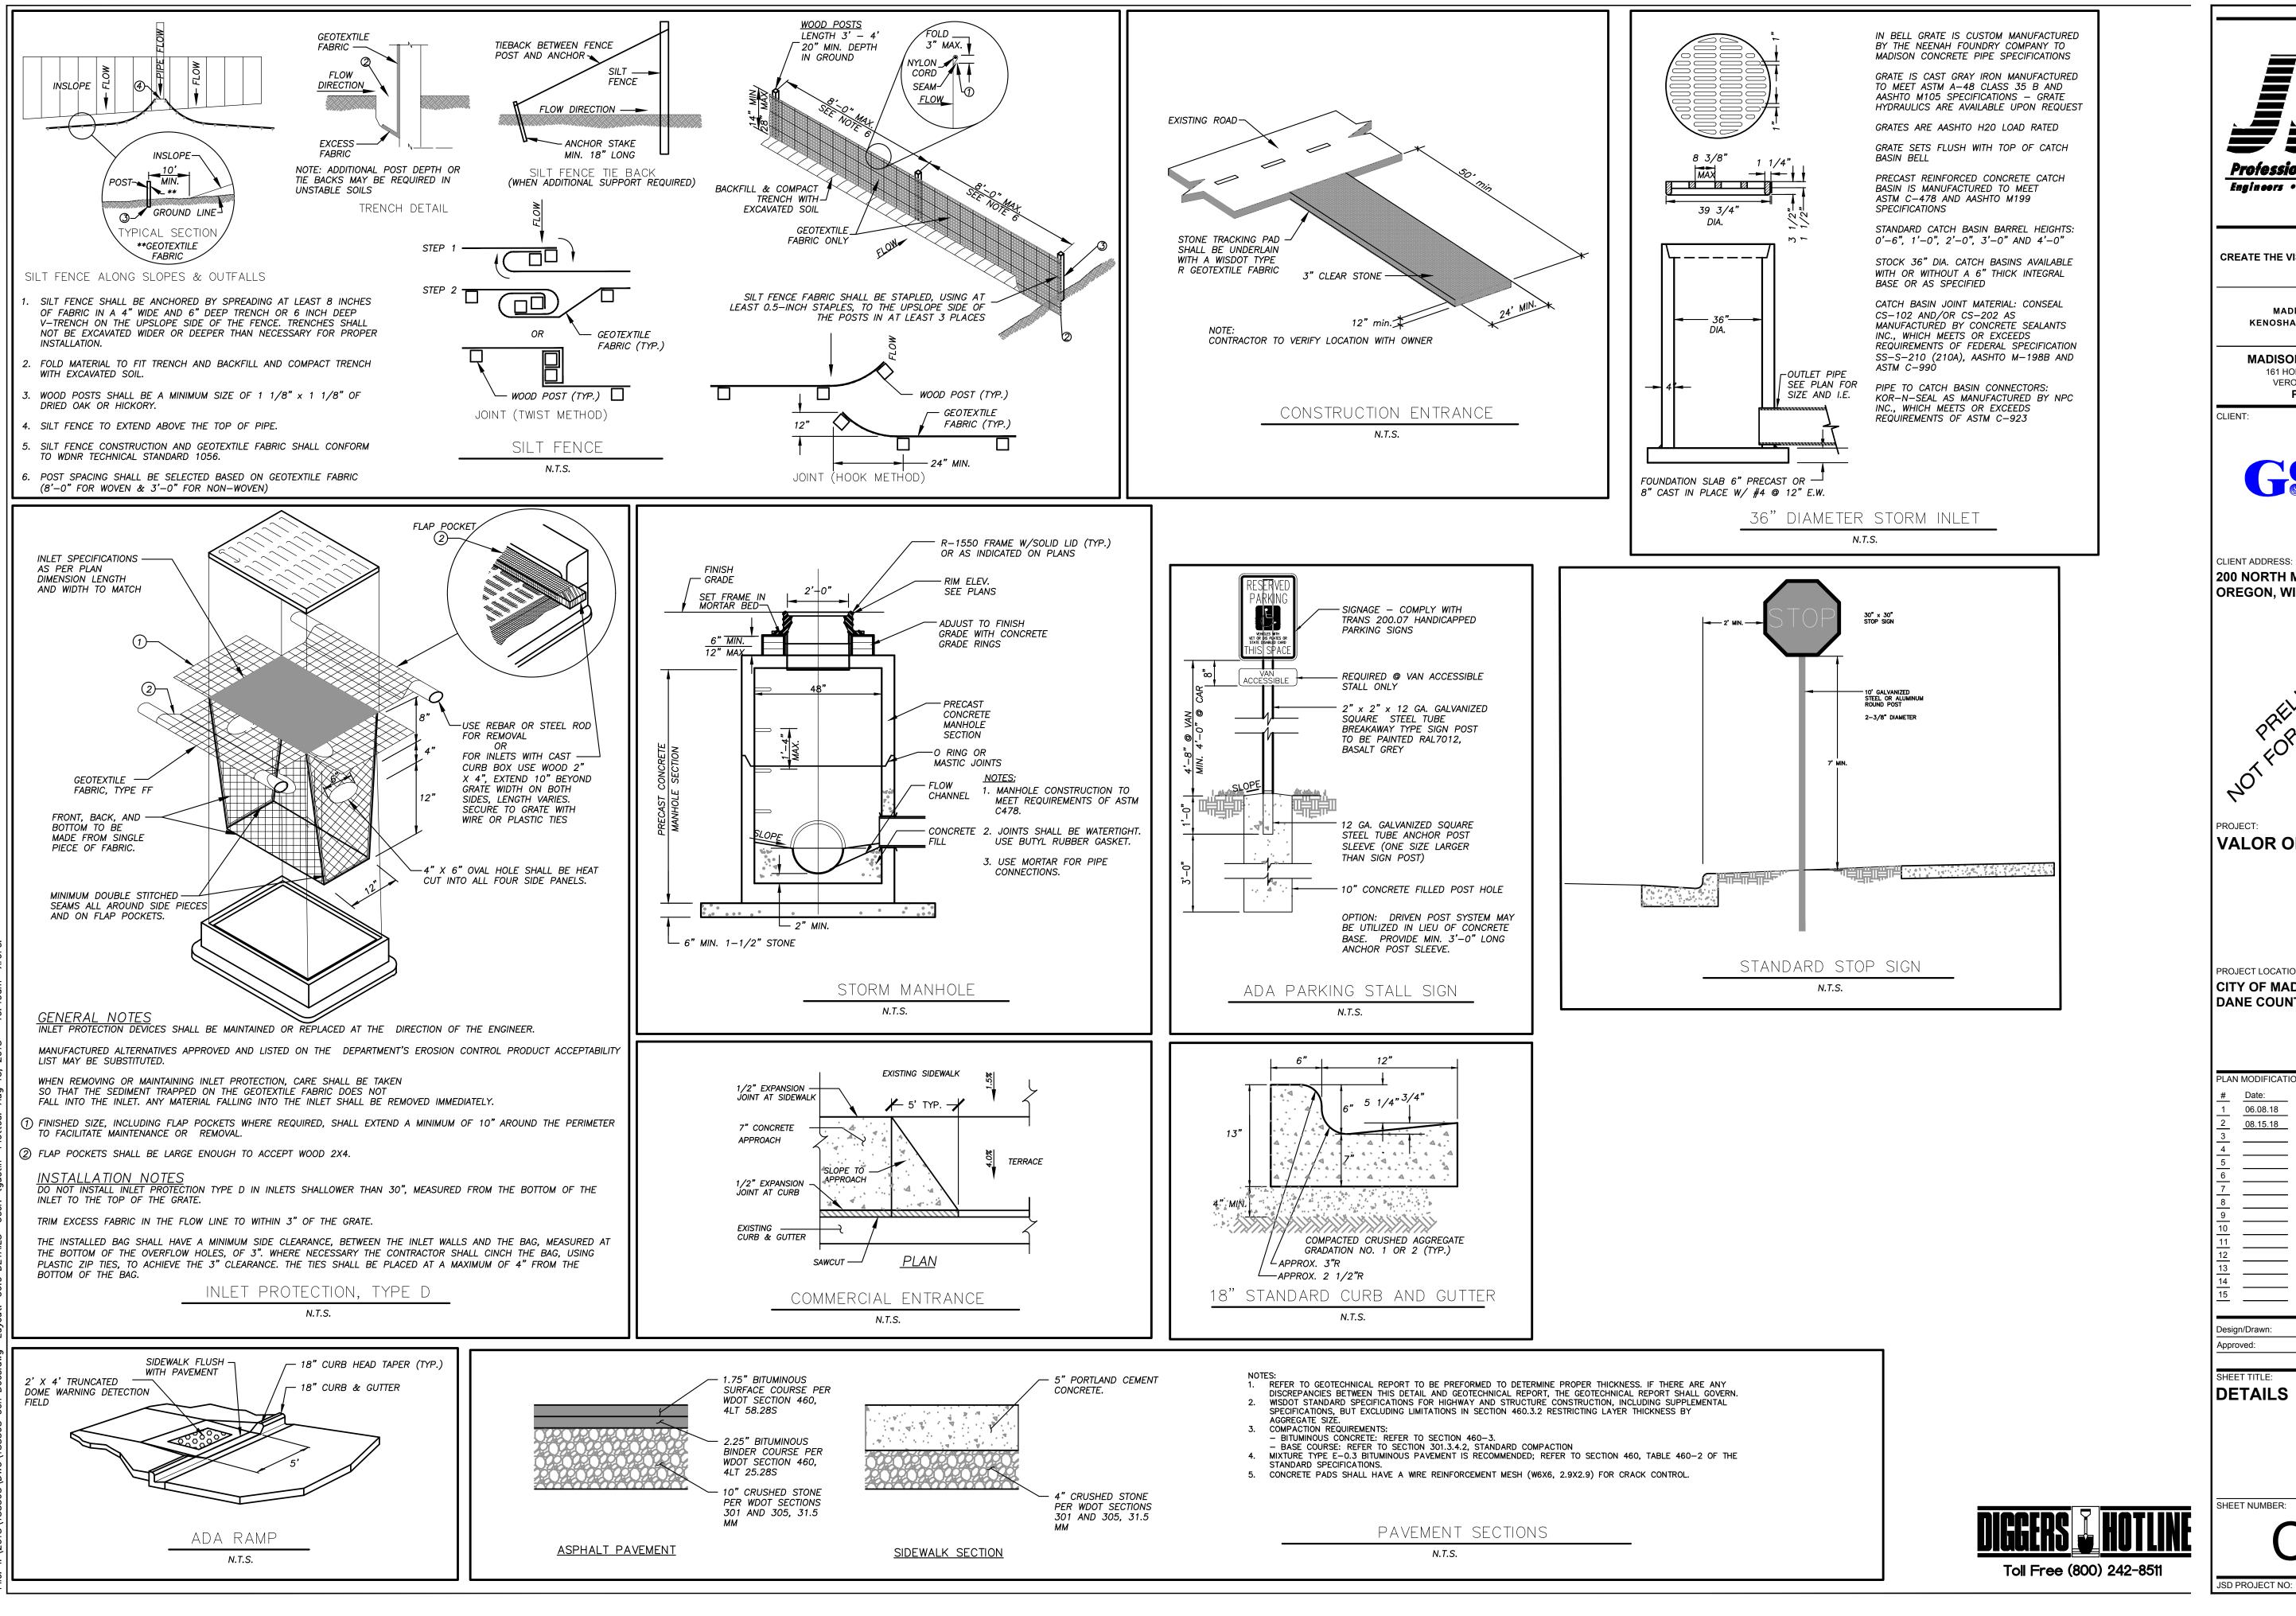


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| Professional Services, Inc. Engineers • Surveyors • Planners |
|---|
| CREATE THE VISION TELL THE STORY |
| MADISON MILWAUKEE KENOSHA APPLETON WAUSAU |
| MADISON REGIONAL OFFICE 161 HORIZON DRIVE, SUITE 101 VERONA, WISCONSIN 53593 P. 608.848.5060 |
| CLIENT: |
| GORMAN COMIPANY, INC. |
| CLIENT ADDRESS: 200 NORTH MAIN STREET OREGON, WI, 53575 |
| CLIENT ADDRESS: 200 NORTH MAIN STREET OREGON, WI, 53575 WALOR ON WASHINGTON |
| PROJECT LOCATION: CITY OF MADISON, WI DANE COUNTY |
| PLAN MODIFICATIONS: |
| # Date: Description: 1 06.08.18 LAND USE SUBMITTAL 2 08.15.18 LAND USE RE-SUBMITTAL |
| 3 4 5 |
| 6 |
| 9 10 11 |
| $ \begin{array}{c c} \hline 12\\ \hline 13\\ \hline 14 \end{array} $ |
| |
| Design/Drawn: CHG Approved: WHD |
| SHEET TITLE: DETAILS |
| SHEET NUMBER: |
| C6.1 |
| JSD PROJECT NO: 18-8568 |

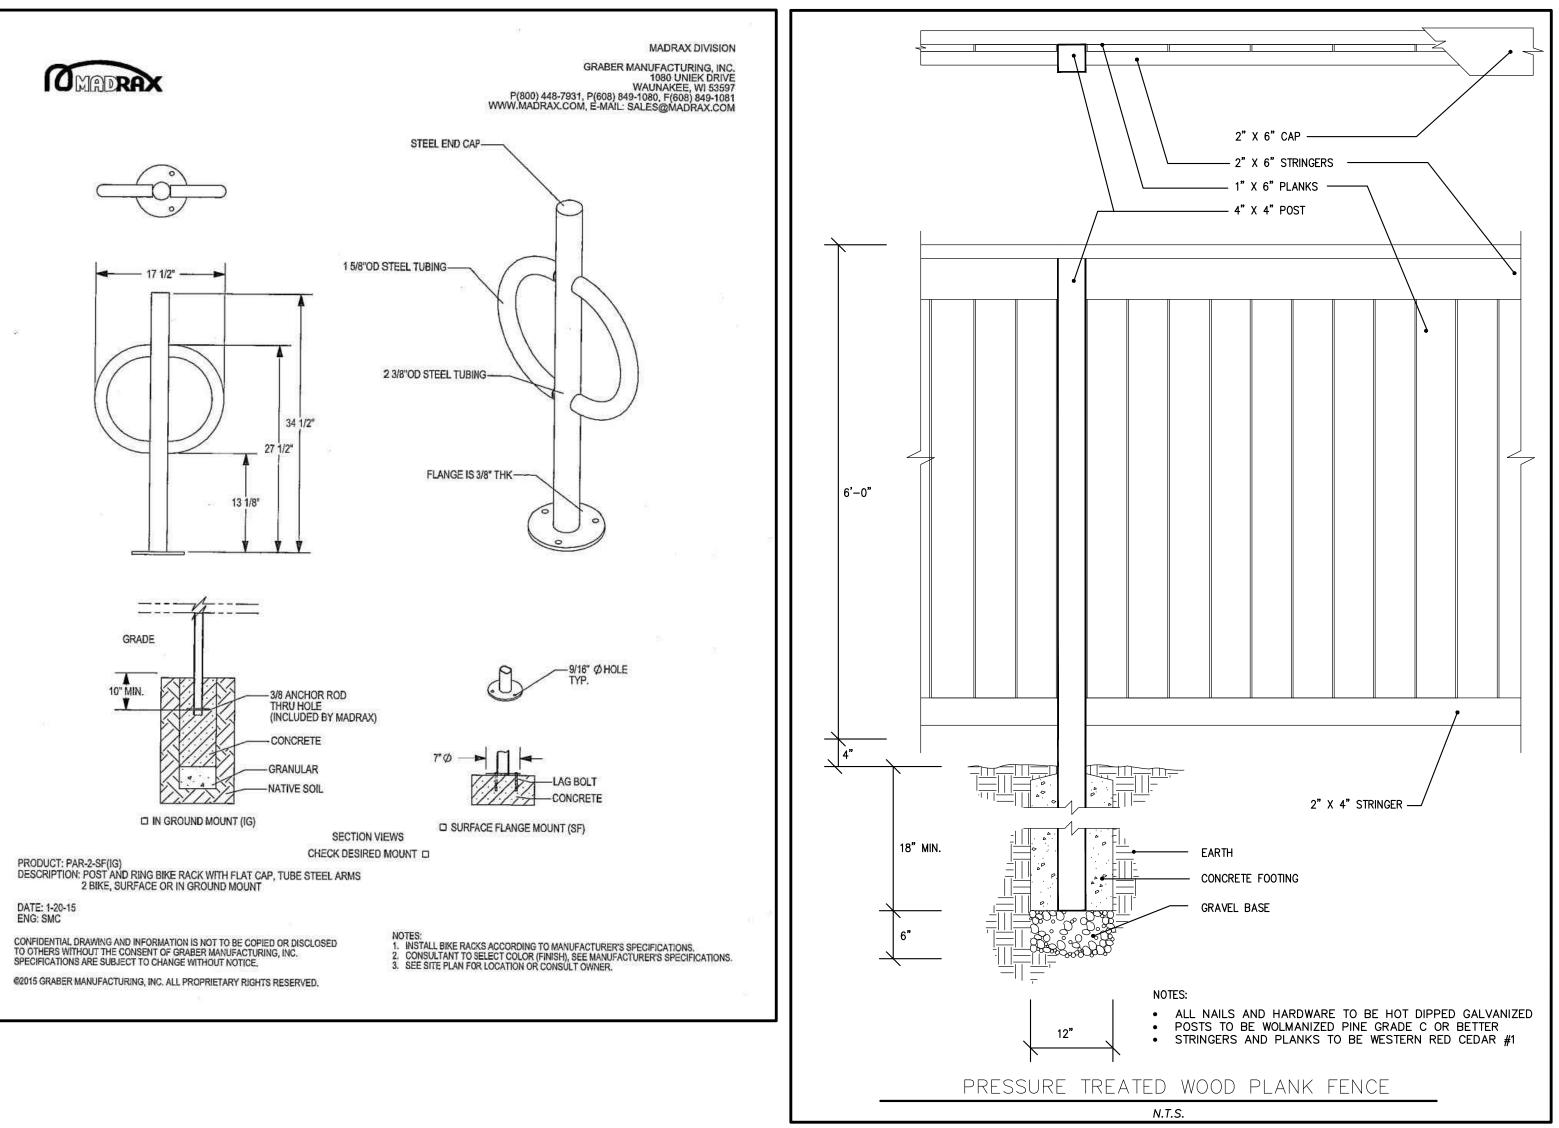




| | CONT | SIZE | LS POINTS | QTY |
|----------------------------|--------|---------------|-----------|-----|
| | B & B | 2.5"Cal | 35 | 3 |
| lect Pear | 15 gal | 2.5"Cal | 35 | 3 |
| | CONT | SIZE | LS POINTS | QTY |
| mn Brilliance Serviceberry | B & B | 1.5"Cal | 15 | 3 |
| | CONT | SIZE | LS POINTS | QTY |
| Black Chokeberry | 3 gal | 12" tall min. | 3 | 21 |
| ilse Honeysuckle | 3 gal | 12" tall min. | 3 | 25 |
| ea | 3 gal | 12" tall min. | 3 | 1Ø |
| | CONT | SIZE | LS POINTS | QTY |
| er | 3 gal | Min. 12"-24" | 4 | 5 |
| een Spreading Yew | 3 gal | 24" Min Ht. | 4 | 17 |
| | CONT | SIZE | LS POINTS | QTY |
| er Reed Grass | 1 gal | 12–18" Ht. | 2 | 6 |
| | 1 gal | 12–18" Ht. | 2 | 6Ø |
| Russian Sage | 1 gal | 12–18" Ht. | 2 | 36 |

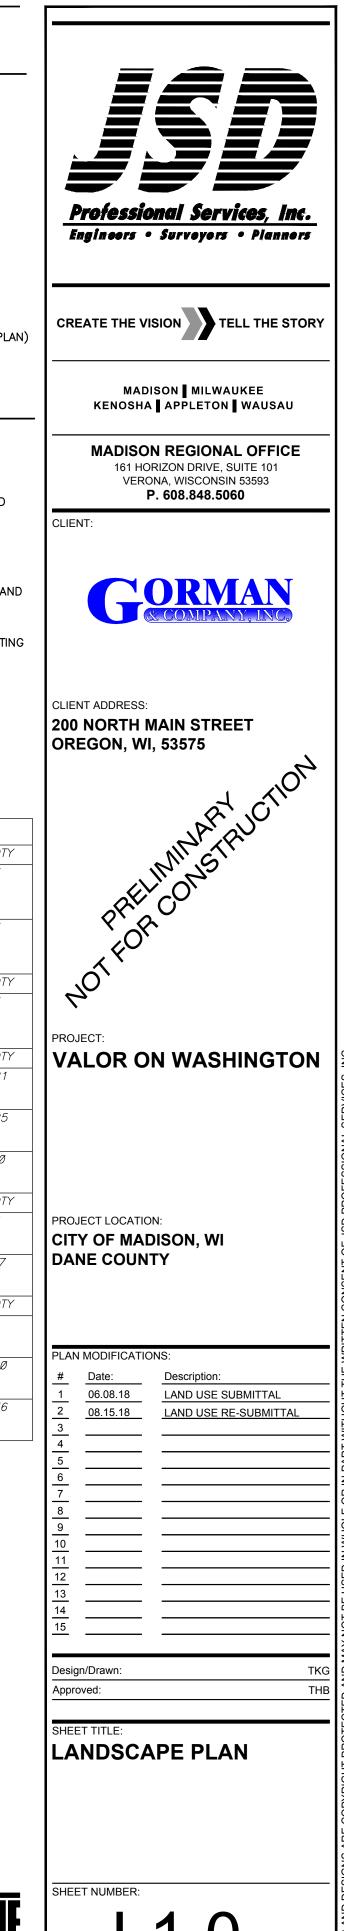

SD PROJECT NO:



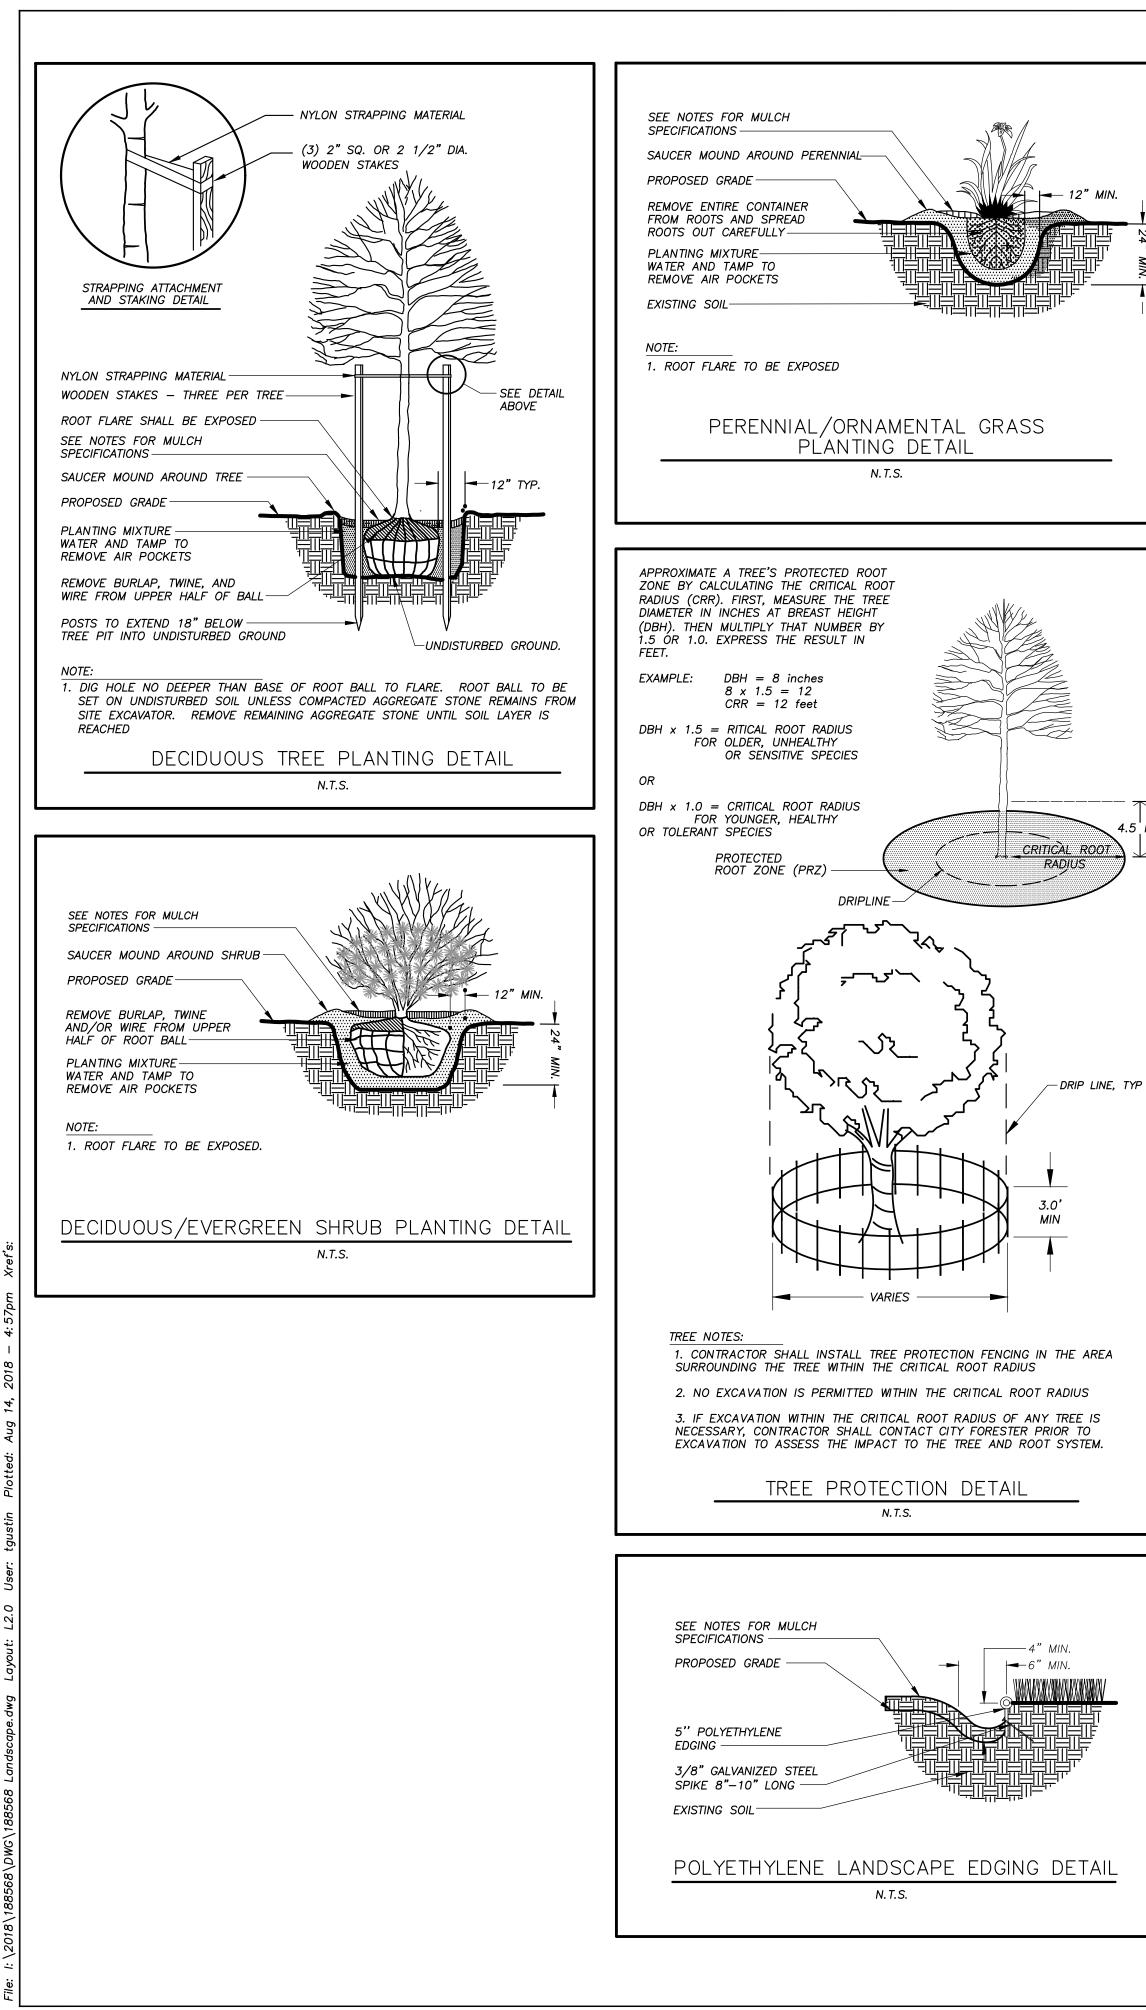

GENERAL NOTES

- GENERAL: ALL WORK IN THE R-O-W AND PUBLIC EASEMENTS SHALL BE IN ACCORDANCE WITH LOCAL MUNICIPAL REQUIREMENTS. JSD SHALL BE HELD HARMLESS AND DOES NOT WARRANT ANY DEVIATIONS BY THE OWNER/CONTRACTOR FROM THE APPROVED CONSTRUCTION PLANS THAT MAY RESULT IN DISCIPLINARY ACTIONS BY ANY OR ALL REGULATORY AGENCIES. LOCATE ALL UTILITIES PRIOR TO CONSTRUCTION. THE CONTRACTOR IS RESPONSIBLE FOR REPAIRING ANY DAMAGE DONE TO UTILITIES. CONTRACTOR MUST CALL 1-800-382-5544 FOR UTILITY LOCATIONS AT LEAST THREE DAYS PRIOR TO DIGGING. HAND DIG AND INSTALL ALL PLANTS THAT ARE NEAR EXISTING UTILITIES. PROTECT PREVIOUSLY INSTALLED WORK OF OTHER TRADES. CONTRACTOR IS RESPONSIBLE FOR STAKING THE PLANT MATERIALS FOR REVIEW BY OWNER PRIOR TO DIGGING AND PLACEMENT AND SHALL COORDINATE ALL FINE GRADING AND RESTORATION WITH THE GRADING CONTRACTOR.
- 2. DELIVERY AND HANDLING: DO NOT DELIVER MORE PLANT MATERIALS THAN CAN BE PLANTED IN ONE DAY, UNLESS ADEQUATE, APPROPRIATE AND SECURE STORAGE IS PROVIDED AND APPROVED BY OWNER'S REPRESENTATIVE. AT ALL TIMES, PROTECT ALL PLANT MATERIALS FROM WIND AND DIRECT SUN. DELIVER PLANTS WITH LEGIBLE IDENTIFICATION LABELS. PROTECT PLANTS DURING DELIVERY AND DO NOT PRUNE PRIOR TO DELIVERY. ALL TREES AND SHRUBS SHALL BE PLANTED ON THE DAY OF DELIVERY; IF THIS IS NOT POSSIBLE, PROTECT THE PLANT MATERIALS NOT PLANTED BY STORING THEM IN A SHADED, SECURE AREA, PROTECTING THE ROOT MASS WITH WET SOIL, MULCH, HAY OR OTHER SUITABLE MEDIUM. CONTRACTOR TO KEEP ALL PLANT MATERIALS ADEQUATELY WATERED TO PREVENT ROOT DESICCATION. DO NOT REMOVE CONTAINER GROWN STOCK FROM CONTAINERS BEFORE TIME OF PLANTING. DO NOT PICK UP CONTAINER OR BALLED PLANTS BY STEM OR ROOTS. ALL PLANTS SHALL BE LIFTED AND HANDLED FROM THE BOTTOM OF THE CONTAINER OR BALL. PERFORM ACTUAL PLANTING ONLY WHEN WEATHER AND SOIL CONDITIONS ARE SUITABLE IN ACCORDANCE WITH LOCALLY ACCEPTED BEST HORTICULTURAL PRACTICES.
- MATERIALS PLANTS: ALL PLANTS SHALL CONFORM TO THE LATEST VERSION OF THE AMERICAN STANDARD FOR NURSERY STOCK ANSI Z60.1-2004 PLANTS SHALL BE TRUE TO SPECIES AND VARIETY SPECIFIED AND NURSERY GROWN IN ACCORDANCE WITH GOOD HORTICULTURAL PRACTICES UNDER CLIMATIC CONDITIONS SIMILAR TO THOSE IN THE LOCALITY OF THE PROJECT FOR AT LEAST 2 YEARS. PLANTS SHALL BE FRESHLY DUG (DURING THE MOST RECENT FAVORABLE HARVEST SEASON). PLANTS SHALL BE SO TRAINED IN DEVELOPMENT AND APPEARANCE AS TO BE UNQUESTIONABLY SUPERIOR IN FORM, COMPACTNESS, AND SYMMETRY. PLANTS SHALL BE SOUND, HEALTHY, VIGOROUS, WELL BRANCHED AND DENSELY FOLIATED WHEN IN LEAF, AND FREE OF DISEASE AND INSECTS (ADULT EGGS, PUPAE OR LARVAE). THEY SHALL HAVE HEALTHY, WELL-DEVELOPED ROOT SYSTEMS AND SHALL BE FREE FROM PHYSICAL DAMAGE OR OTHER CONDITIONS THAT WOULD PREVENT THRIVING GROWTH OR PREMATURE MORTALITY. PLANTS SHALL BE OF THE HIGHEST QUALITY, POSSESS TYPICAL GROWTH HABITS AND FORM FOR THEIR SPECIES AND BE FREE OF INJURY. PARKWAY TREES AND PARKING LOT TREES SHALL HAVE A MINIMUM BRANCHING HEIGHT OF SIX (6) FEET ABOVE THE GROUND TO ALLOW ADEQUATE VISUAL AND PHYSICAL CLEARANCE.
- 4. PRUNING: THE CONTRACTOR SHALL PRUNE ALL TREES AND REPAIR ANY INJURIES THAT OCCURRED DURING THE PLANTING PROCESS. DOUBLE LEADERS, DEAD BRANCHES, AND LIMBS DAMAGED OR BROKEN DURING THE PLANTING PROCESS, SHALL BE PRUNED. THIS SHALL BE THE ONLY PRUNING ALLOWED AT PLANTING. PRUNING SHALL CONFORM TO THE LATEST VERSION OF THE AMERICAN STANDARD FOR TREE CARE OPERATIONS, ANSI A300 PRUNE TREES IN ACCORDANCE WITH NAA GUIDELINES. DO NOT TOP TREES. PRUNE SHRUBS ACCORDING TO STANDARD HORTICULTURAL PRACTICES ON CUTS OVER 3/4" IN DIAMETER AND BRUISES OR SCARS ON BARK, TRACE THE INJURED CAMBIUM LAYER BACK TO LIVING TISSUE AND REMOVE. SMOOTH AND SHAPE WOUNDS SO AS NOT TO RETAIN WATER. TREAT THE AREA WITH AN APPROVED INCONSPICUOUS LATEX BASED ANTISEPTIC TREE PAINT, IF PRUNING OCCURS "IN SEASON". DO NOT PRUNE ANY OAK TREES DURING THE MONTHS FROM APRIL TO OCTOBER.
- CLEANUP: THE WORK AREA SHALL BE KEPT SAFE AND NEAT AT ALL TIMES. DISPOSED OF EXCESS SOIL. REMOVE ALL CUTTINGS AND WASTE MATERIALS, SOIL AND BRANCHES, BIND AND WRAP THESE MATERIALS, ANY REJECTED PLANTS, AND ANY OTHER DEBRIS RESULTING FROM ALL PLANTING TASKS AND PROMPTLY CLEAN UP AND REMOVE FROM THE PROJECT SITE. UNDER NO CIRCUMSTANCES SHALL THE ACCUMULATION OF SOIL, BRANCHES OR OTHER DEBRIS BE ALLOWED UPON A PUBLIC PROPERTY IN SUCH A MANNER AS TO RESULT IN A PUBLIC SAFETY HAZARD OR DAMAGE. LIKEWISE, UNDER NO CIRCUMSTANCES SHALL ANY DEBRIS OR INCIDENTAL MATERIALS BE ALLOWED UPON ADJACENT PRIVATE PROPERTY.
- 6. ANY SUBSTITUTIONS IN PLANT TYPE, LOCATION, OR SIZE SHALL BE APPROVED BY LANDSCAPE ARCHITECT PRIOR TO INSTALLATION.
- 7. CONTRACTOR TO VERIFY PLANT MATERIAL QUANTITIES. QUANTITIES SHOWN ON PLAN TAKE PRECEDENCE OVER THOSE ON SCHEDULE.

LANDSCAPE MATERIAL NOTES

- MATERIALS PLANTING MIXTURE: ALL HOLES EXCAVATED FOR TREES, SHRUBS, PERENNIALS AND ORNAMENTAL GRASSES SHALL BE BACKFILLED WITH TWO (2) PARTS TOPSOIL, ONE (1) PART SAND AND ONE (1) PART COMPOST. SOIL MIXTURE SHALL BE WELL BLENDED PRIOR TO INSTALLATION.
- 2. MATERIALS TOPSOIL: TOPSOIL TO BE CLEAN, FRIABLE LOAM FROM A LOCAL SOURCE, FREE FROM STONES OR DEBRIS OVER 3/4" IN DIAMETER, AND FREE FROM TOXINS OR OTHER DELETERIOUS MATERIALS. TOPSOIL SHALL HAVE A DH VALUE BETWEEN 6 AND 7. TOPSOIL AND PLANTING SOIL SHALL BE TESTED TO ENSURE CONFORMANCE WITH THESE SPECIFICATIONS AND SHALL BE AMENDED TO MEET THESE SPECIFICATIONS. PROVIDE TEST RESULTS TO OWNER'S REPRESENTATIVE PRIOR TO PLACEMENT. DO NOT PLACE FROZEN OR MUDDY TOPSOIL. APPLY SOIL AMENDMENTS TO ALL LANDSCAPE AREAS PER SOIL TEST.
- MATERIALS SHREDDED HARDWOOD BARK MULCH: ALL PLANTING AREAS LABELED ON PLAN SHALL RECEIVE CERTIFIED WEED FREE SHREDDED HARDWOOD BARK MULCH INSTALLED TO A MINIMUM AND CONSISTENT DEPTH OF 3-INCHES. SHREDDED HARDWOOD BARK MULCH SIZE & COLOR TO BE APPROVED BY OWNER'S REPRESENTATIVE PRIOR TO INSTALLATION. FERTILIZER SHALL BE IN ACCORDANCE WITH APPLICABLE LOCAL, COUNTY AND STATE OF WISCONSIN REQUIREMENTS. SHREDDED HARDWOOD BARK MULCH AREAS SHALL NOT RECEIVE WOVEN WEED BARRIER FABRIC.
- MATERIALS TREE & SHRUB RINGS: ALL TREES AND/OR SHRUBS PLANTED IN SEEDED LAWN AREAS TO BE INSTALLED WITH A MINIMUM 4' DIAMETER SHREDDED HARDWOOD BARK MULCH TREE RING SPREAD TO A CONSISTENT DEPTH OF 3-INCHES. ALL TREE RINGS SHOULD BE INSTALLED WITH A 5" DEPTH SHOVEL CUT EDGE, ANGLED 45 DEGREES INTO SOIL AT A 5' DIAMETER ABOUT THE CENTER OF THE TREE PLANTING. A PRE-EMERGENT GRANULAR HERBICIDE WEED-PREVENTER SHOULD BE MIXED WITH MULCH USED TO INSTALL TREE RING AS WELL AS TOPICALLY APPLIED TO COMPLETED INSTALLATION OF TREE RING.
- 5. MATERIALS POLYETHYLENE EDGING: EDGING SHALL BE 5" DEEP, POLYETHYLENE EDGING. OWNER'S REPRESENTATIVE SHALL APPROVE PRODUCT SPECIFICATION PROVIDED BY LANDSCAPE CONTRACTOR.

SEEDING & SODDING NOTES

- MATERIALS TURFGRASS SEED: DISTURBED LAWN AREAS LABELED ON PLAN AS SUCH, SHALL RECEIVE 6" OF TOPSOIL AND EARTH CARPET'S "MADISON PARKS" GRASS SEED, OR EQUIVALENT AS APPROVED BY THE OWNER'S REPRESENTATIVE, INSTALLED PER MANUFACTURER'S RECOMMENDATIONS. IN ADDITION TO TURFGRASS SEED, ANNUAL RYE SHALL BE APPLIED TO ALL DISTURBED AREAS AT A RATE OF 1 1/2 LBS PER 1000 SQUARE FEET. FERTILIZE AND MULCH PER MANUFACTURER'S RECOMMENDATIONS
- MATERIALS SOD: DISTURBED LAWN AREAS LABELED ON PLAN AS SUCH, SHALL RECEIVE 6" OF TOPSOIL AND A PREMIUM GRADE TURFGRASS SOD. ONLY IMPROVED TYPES OF SOD (ELITE) ARE ACCEPTABLE. TURFGRASS SHALL BE MACHINE CUT AT A UNIFORM THICKNESS OF .60 INCH. PLUS OR MINUS .25 INCH. AT TIME OF CUTTING, MEASUREMENT FOR THICKNESS SHALL EXCLUDE TOP GROWTH AND THATCH. LARGE ROLL TUREGRASS SOF SHALL BE CUT TO THE SUPPLIER'S STANDARD WIDTH (36-48 INCHES) AND LENGTH. BROKEN PADS AND TORN OR UNEVEN ENDS WILL NOT BE ACCEPTABLE. STANDARD SIZE SECTIONS OF TURGRASS SOD SHALL BE STRONG ENOUGH SO THAT THEY CAN BE PICKED UP AND HANDLED WITHOUT DAMAGE. TURFGRASS SOD SHALL NOT BE HARVESTED OR TRANSPLANTED WHEN MOISTURE CONTENT IS EXCESSIVELY DRY OR WET, AS THIS MAY ADVERSELY AFFECT ITS SURVIVAL, POST-PLANT IRRIGATION WILL BE NECESSARY TO ENSURE SOD STAYS ALIVE AND ROOTS INTO SOIL. THE CONTRACTOR IS RESPONSIBLE FOR WATERING SOD UNTIL TIME OF ACCEPTANCE BY THE OWNER. TURFGRASS SOD SHALL BE HARVESTED, DELIVERED, AND INSTALLED/TRANSPLANTED WITHIN A PERIOD OF 24 HOURS. TURFGRASS SOD SHALL BE RELATIVELY FREE OF THATCH, UP TO 0.5 INCH ALLOWABLE (UNCOMPRESSED). TURFGRASS SOD SHALL BE REASONABLY FREE (10 WEEDS/100 SQ. FT.) OF DISEASES, NEMATODES AND SOIL-BORNE INSECTS. ALL TURFGRASS SOD SHALL BE FREE OF GRASSY AND BROAD LEAF WEEDS. THE SOD SUPPLIER SHALL MAKE RECOMMENDATIONS TO THE CONTRACTOR REGARDING WATERING SCHEDULE. THE WATERING SCHEDULE SHOULD BEGIN IMMEDIATELY AFTER SOD IS INSTALLED.

CONTRACTOR AND OWNER RESPONSIBILITY NOTES

- GUARANTEE: THE CONTRACTOR SHALL GUARANTEE ALL PLANTS THROUGH ONE (1) YEAR AFTER ACCEPTANCE BY THE OWNER'S REPRESENTATIVE. PLANTS SHALL BE ALIVE AND IN HEALTHY AND FLOURISHING CONDITION AT THE END OF THE GUARANTEE PERIOD. THE CONTRACTOR SHALL REPLACE (AT NO COST TO OWNER) ANY PLANTS THAT ARE DEAD OR NOT IN A VIGOROUS THRIVING CONDITION. REPLACEMENT PLANTS SHALL BE OF THE SAME KIND AND SIZE AS ORIGINALLY SPECIFIED UNLESS OTHERWISE DIRECTED BY OWNER'S REPRESENTATIVE. RESTORE BEDS AS NECESSARY FOLLOWING PLANT REPLACEMENT, INCLUDING BUT NOT LIMITED TO BEDDING, EDGING, MULCH. ETC. REPLACE PLANTS DAMAGED AT TIME OF PLANTING. REPAIR AREAS DISTURBED IN ANY WAY DURING PLANT REPLACEMENT AT NO COST TO OWNER. CONTRACTOR SHALL PROVIDE A ONE (1)-YEAR STRAIGHTENING GUARANTEE FOR ALL TREES.
- CONTRACTOR IS RESPONSIBLE FOR STAKING THE PLANT MATERIALS FOR REVIEW BY OWNER'S REPRESENTATIVE PRIOR TO DIGGING AND PLACEMENT AND SHALL COORDINATE ALL FINE GRADING AND RESTORATION WITH THE GRADING CONTRACTOR.
- MAINTENANCE: (CONTRACTOR) FOR ALL PLANTINGS, SEEDED AREAS AND SODDED LAWN AREAS: THE CONTRACTOR SHALL MAINTAIN ALL PLANTINGS AND LAWN AREAS FOR A MINIMUM TIME PERIOD OF 60 DAYS, UNTIL FINAL ACCEPTANCE BY OWNER'S REPRESENTATIVE. THE CONTRACTOR IS RESPONSIBLE FOR ADEQUATELY WATERING PLANTS AND LAWN/TURFGRASS DURING THIS 60 DAY ESTABLISHMENT PERIOD. CONTRACTOR IS RESPONSIBLE FOR THE ESTABLISHMENT OF HEALTHY VIGOROUS PLANT MATERIALS AND LAWN/TURFGRASS GROWTH. CONTRACTOR IS ALSO RESPONSIBLE FOR ANY PRUNING OF PLANT MATERIALS, AND SHAPING AND/OR REPLACEMENT OR SUPPLEMENT OF DEFICIENT SHREDDED HARDWOOD BARK MULCH DURING THIS PERIOD. LONG TERM PLANT MATERIALS AND LAWN/TURFGRASS MAINTENANCE AND ANY PROGRAM FOR SUCH IS THE RESPONSIBILITY OF THE OWNER. ALL PLANTINGS AND LAWN/TURFGRASS AREAS SHALL BE MAINTAINED IN A MANICURED CONDITION UNTIL THE TIME WHEN THE OWNER'S ACCEPTANCE IS GIVEN.
- MAINTENANCE: (OWNER) THE OWNER IS RESPONSIBLE FOR THE CONTINUED MAINTENANCE, REPAIR AND REPLACEMENT OF ALL LANDSCAPING MATERIALS AND WEED BARRIER FABRIC AS NECESSARY FOLLOWING THE ONE (1) YEAR CONTRACTOR GUARANTEE PERIOD.



Madison

Project Location / Addr Name of Project VAL Owner / Contact JUS Contact Phone (608) 848–5060

Applicabilit

year period.

(c) No demolition of a principal building is involved.

Landscape Calculations and Distribution Required landscaped areas shall be calculated based upon the total developed area of the property. Developed area is defined as that area within a single contiguous boundary which is made up of structures, parking, driveways and docking/loading facilities, but excluding the area of any building footprint at grade, land designated for open space uses such as athletic fields, and undeveloped land area on the same zoning lot. There are three methods for calculating landscape points depending on the size of the lot and Zoning District.

(a) For all lots except those described in (b) and (c) below, five (5) landscape points shall be provided for each three hundred (300) square feet of developed area.

acres

(c) For the Industrial – Limited (IL) and Industrial – General (IG) districts, one (1) point shall be provided per one hundred (100) square feet of developed area.

10/2013

Tabulation of Points and Credits

Plant Type/ Elem

Overstory deciduous

Tall evergreen tree (i.e. pine, spruce)

Ornamental tree Upright evergreen shi

(i.e. arborvitae) Shrub, deciduous

Shrub, evergreen

Ornamental grasses/ perennials

Ornamental/ decorative fencing or wall

Existing significant specimen tree

Landscape furniture public seating and/or transit connections

Sub Totals

CITY OF MADISON LANDSCAPE WORKSHEET

Section 28.142 Madison General Ordinance

| ress | ess 1328 EAST WASHINGTON AVENUE | | | | | |
|------|---------------------------------|---------------|-------------------------|--|--|--|
| OR | ON WASHINGTON | | | | | |
| STIN | FRAHM | | | | | |
| 8) 8 | 848-5060 | Contact Email | JUSTIN.FRAHM@JSDINC.COM | | | |

** Landscape plans for zoning lots greater than ten thousand (10,000) square feet in size MUST be prepared by a registered landscape architect. **

The following standards apply to all exterior construction and development activity, including the expansion of existing buildings, structures and parking lots, except the construction of detached single-family and two-family dwellings and their accessory structures. The entire development site must be brought up to compliance with this section unless **all** of the following conditions apply, in which case only the affected areas need to be brought up to compliance:

(a) The area of site disturbance is less than ten percent (10%) of the entire development site during any ten-(10)

(b) Gross floor area is only increased by ten percent (10%) during any ten-(10) year period.

(d) Any displaced landscaping elements must be replaced on the site and shown on a revised landscaping plan.

Total square footage of developed area 10,290 172 Total landscape points required

(b) For lots larger than five (5) acres, points shall be provided at five (5) points per three hundred (300) square feet for the first five (5) developed acres, and one (1) point per one hundred (100) square feet for all additional

Total square footage of developed area

Five (5) acres = 217,800 square feet

First five (5) developed acres = 3,630 points

Remainder of developed area

Total landscape points required

Total square footage of developed area


Total landscape points required _____

Use the table to indicate the quantity and points for all existing and proposed landscape elements.

| | Minimum Size at | | | Existing caping | New/ Proposed Landscaping | | |
|----------|---|--|----------|--------------------|------------------------------|--------------------|--|
| nent | Installation | Points | Quantity | Points Achieved | Quantity | Points Achieved | |
| s tree | 2½ inch caliper measured diameter at breast height (dbh) | 35 | | | 6 | 210 | |
| | 5-6 feet tall | 35 | | | | | |
| | 1 1/2 inch caliper | 15 | | | 3 | 45 | |
| hrub | 3-4 feet tall | 10 | | | | | |
| | #3 gallon container size, Min. 12"-24" | 3 | | | 56 | 168 | |
| | #3 gallon container size, Min. 12"-24" | 4 | | | 22 | 88 | |
| (| #1 gallon container size, Min. 8"-18" | 2 | | | 102 | 204 | |
| or | n/a | 4 per 10 lineal ft. | | | | | |
| | Minimum size: 2 ¹ / ₂ inch caliper dbh. *Trees must be within developed area and cannot comprise more than 30% of total required points. | 14 per caliper inch dbh. Maximum points per tree: 200 | | | | | |
| for r | * Furniture must be within developed area, publically accessible, and cannot comprise more than 5% of total required points. | 5 points per "seat" | | | | | |
| | | | | | | 715 | |

Total Number of Points Provided 715

* As determined by ANSI, ANLA- American standards for nursery stock. For each size, minimum plant sizes shall conform to the specifications as stated in the current American Standard for Nursery Stock.

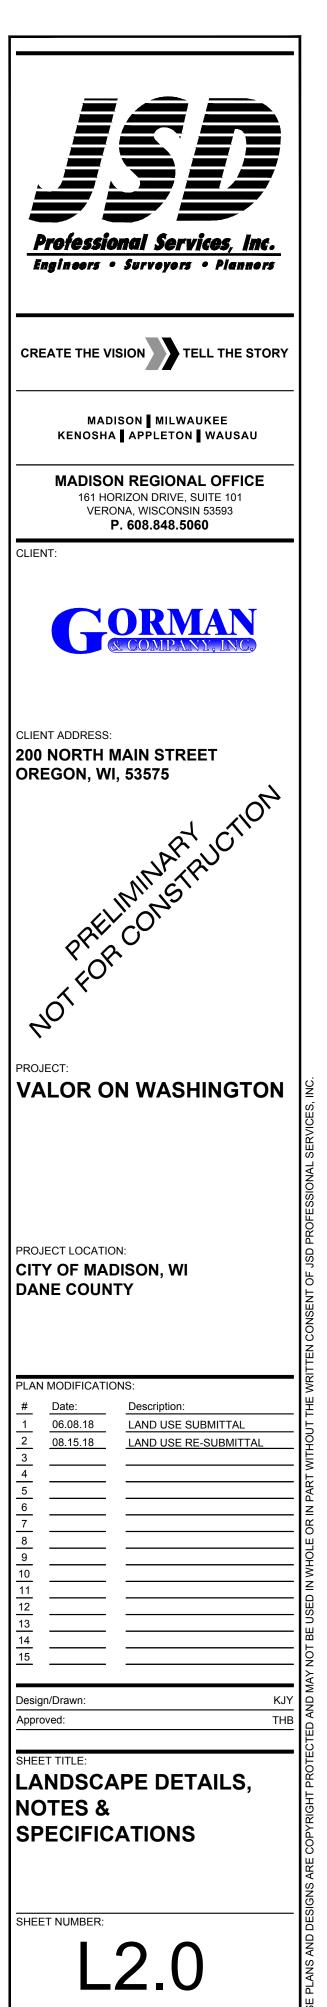

SD PROJECT NO:

| TYPE | DESCRIPTION | LAMP SOURCE | DEL. LUMENS | ССТ | MOUNTING | MANUFACTURER & SERIES | VOLTAGE | INPUT WATTS | DIMMING |
|------|--|----------------|----------------|------|----------|---|---------|----------------|---------|
| | | JOONEL | LOIVILING | | | | | WAIIS | |
| 01 | 6" RECESSED DOWNLIGHT, WHITE REFLECTOR AND TRIM RING. - EXTERIOR ENTRY SOFFITS | LED | 728 | 3000 | RECESSED | HALO ML5606930/692W/750ICAT | UNV | 10 | NON-DIM |
| 21 | TYPE 5 MEDIUM DISTRIBUTION AREA LIGHT. PROVIDE WITH SQUARE STRAIGHT STEEL 15' POLE. MOUNT ON FLUSH CONCRETE BASE. BLACK FINISH. - PLAYGROUND AREA LIGHT. | LED | 5130 | 3000 | POLE | MCGRAW EDISON GALLEON GLEON-AF-01-XXX-LED-E1-SL3-BK-7030 | UNV | 44 | NON-DIM |
| PL2 | TYPE 3 DISTRIBUTION AREA LIGHT WITH SHARP CUTOFF BACKLIGHT. PROVIDE WITH SQUARE STRAIGHT STEEL 20' POLE. MOUNT ON 2.5' RAISED CONCRETE BASE. BLACK FINISH. - PARKING LOT AREA LIGHT. | LED | 9211 | 3000 | POLE | MCGRAW EDISON GALLEON GLEON-AF-02-LED-E1-SL3-BK-7030 | UNV | 113 | NON-DIM |
| V1 | TRAPEZOIDAL CUTOFF LUMINAIRE TYPE 2 DISTRIBUTION, BLACK FINISH. - BACK OF BUILDING MAN DOORS AND PARKING GARAGE ENTRANCE . | LED | 2136 | 3000 | | MCGRAW EDISON IST-AF-350-LED-E1-SL2-BK-7030 | UNV | 20 | NON-DIM |
| W2 | DECORATIVE WALL SCONCE. MODIFIED FOR MAXIMUM 1000 DELIVERED LUMENS. SELECT FINISH. - MAIN ENTRANCE DOORS | LED | 1000 | 3000 | | SPI HARBOR AEW9980-MOD-120-277V-FINISH- 3000K-DR_OA | UNV | 15 | NON-DIM |
| V3 | WALL MOUNT EXTERIOR CYLINDER WITH 30 DEGREE BEAM SPREAD. SELECT FINISH. - E WASHINGTON BUILDING FACADE | LED | 1500 | 3000 | | FC LIGHITING FCC-10-WM-UNV-3K-CR83-15L-XX-D30 | UNV | 15 | NON-DIM |

HALO LED ICAT HOUSING for NEW CONSTRUCTION

The H750ICAT is a dedicated LED new construction housing to be used with designated HALO LED modules. The H750ICAT is designed for insulated ceilings and can be in direct contact with ceiling insulation*. This AIRTITE housing design prevents airflow between conditioned and unconditioned spaces and saves on both heating and air conditioning costs. The LED connector system provides high efficacy code compliance when used with designated HALO LED modules and trims.

D1HALO®Catalog #TypeProjectDateCommentsDatePrepared byIntellige

DESIGN FEATURES

Housings


Aluminum construction for greater heat dissipation. H750 ICAT housing is gasketed to prevent airflow from heated or air conditioned spaces.

Plaster Frame

Galvanized steel frame. Housing adjusts in plaster frame to accommodate up to 1" ceiling thickness. Regressed locking screw for securing hanger bars. Cutouts included for easily crimping hanger bars in position

Slide-N-Side[™] Junction Box

- Positioned to accommodate straight conduit runs.
- Seven 1/2" trade size conduit knockouts with true pry-out slots.
- Slide-N-Side wire traps allow non metallic sheathed cable to be installed without tools and without removing knockouts.
- Allows wiring connections to be made outside the box.
- Simply insert the cable directly into the trap after connections are made.
- Accommodates the following standard non-metallic sheathed cable type:
- U.S. #14/2, #14/3, #12/2, #12/3
- Canada: #14/2, #14/3, #12/2

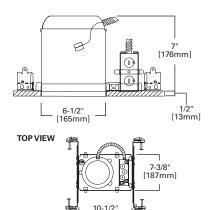

[267mm]

Cooper Lighting

by FATON

GOT NAIL! Pass -N-Thru™ Bar Hangers

Bar Hanger features include

- Pre-installed nail easily installs in regular lumber, engineered lumber and laminated beams.
- Safety and Guidance system prevents snagging, ensures smooth, straight nail penetration and allows bar hangers to be easily removed if necessary
- Automatic leveling flange aligns the housing and allows holding the housing in place with one hand while driving nails.
- Housing can be positioned at any point within 24" joist spans
- Score lines allow tool-free shortening for 12" joists and bar hangers do not need to be removed for shortening.
- Bar hangers may be repositioned 90° on plaster frame
- Integral T-bar clip snaps onto T-bars – no additional clips are required.

LED Module Connection

Halo LED modules simply install with a plug-in 120V-277V rated line voltage wiring connector (UL and CSA Listed Luminaire Disconnect). This non-screw-base connection preserves the high efficacy rating and prevents use of low efficacy incandescent sources (see LED Module specifications). **Caution**

aution

Connection is rated for 120V and 277V input. Installer must verify LED module voltage is compatible with the applicable voltage input. If uncertain, consult a qualified electrician.

Labels

- UL/cUL Listed 1598 Luminaire
- CE Marking "Conformité Européene" conformity with the Council of European Communities Directives, meeting internationally recognized compliance when used with ML56 Series LED modules
- UL/cUL Listed for Feed Through
- UL/cUL Listed for Damp Location
 UL/cUL Listed for Wet Location with select trims
- UL/cUL Listed for direct contact with insulation and combustible material*
- Rated for 20W maximum

Qualification

May be used with qualified Halo LED modules and designated trims for High Efficacy Luminaire Compliance:

- State of California Title 24
- International Energy
- Conservation Code (IECC) • Washington State Energy Code
- New York State Energy
- Conservation Construction Code - AIR-TITE™ Compliant
- Certified under ASTM-E283 standard for air-tight construction



H750ICAT

6" New Construction IC AIR-TITE™ Housing For Halo LED Modules and Trims - ML56 Series - RL56 Series - RA56 Series

High Efficacy LED Housing

FOR USE IN INSULATED CEILINGS

FOR DIRECT CONTACT WITH INSULATION*









Qualified and compliant with select trims. Refer to ENERGY STAR[®] Qualified Products List and CEC (T24) Appliance Database for listings.

H750ICAT

ORDERING INFORMATION - RL56 SERIES

SAMPLE NUMBER: H750ICAT - RL560WH6927 Order housing, light module, trim and separately.

| Housing | RL56 LED - Compatible LED Retrofit Modules |
|--|---|
| H750ICAT= 6" Aperture, New Construction, IC AIR-TITE™, High Efficacy LED Housing | 80 CRI RL560WH6827= 5"/6" Retrofit Baffle - Trim LED Module, 80CRI, 2700K, Matte White RL560SN6827= 5"/6" Retrofit Baffle - Trim LED Module, 80CRI, 2700K, Satin Nickel RL560SN6830= 5"/6" Retrofit Baffle - Trim LED Module, 80CRI, 3000K, Matte White RL560SN6835= 5"/6" Retrofit Baffle - Trim LED Module, 80CRI, 3000K, Satin Nickel RL560WH6835= 5"/6" Retrofit Baffle - Trim LED Module, 80CRI, 3500K, Matte White 90 CRI |
| | SO CHI RL560WH6927= 5"/6" Retrofit Baffle - Trim LED Module, 90CRI, 2700K, Matte White RL560SN6927= 5"/6" Retrofit Baffle - Trim LED Module, 90CRI, 2700K, Satin Nickel RL560WH6930= 5"/6" Retrofit Baffle - Trim LED Module, 90CRI, 3000K, Matte White RL560SN6930= 5"/6" Retrofit Baffle - Trim LED Module, 90CRI, 3000K, Satin Nickel RL560WH6935= 5"/6" Retrofit Baffle - Trim LED Module, 90CRI, 3500K, Matte White |

ORDERING INFORMATION - RA56 SERIES

SAMPLE NUMBER: H750ICAT - RA5606927WH Order housing, light module, trim and separately. RA56 LED - Compatible LED Retrofit Modules H750ICAT= 6" Aperture, New Construction, IC AIR-TITE™, High Efficacy LED Housing Very Wide Flood - VWFL Models RA5606927WH 5 "/6" LED Adjustable Gimbal, 90CRI, 2700K, White, Very Wide Flood RA5606930WH= 5"/6" LED Adjustable Gimbal, 90CRI, 3000K, White, Very Wide Flood Narrow Flood - NFL Models RA5606927NFLWH= 5"/6" LED Adjustable Gimbal, 90CRI, 2700K, White, Narrow Flood RA5606930NFLWH= 5"/6" LED Adjustable Gimbal, 90CRI, 3000K, White, Narrow Flood

ORDERING INFORMATION - ML56 SERIES

SAMPLE NUMBER: H750ICAT - ML5606830 - 693WB

| lousing | ML56 LED Light Modules | ML56 LED Trims | ML56 System Accessories |
|--|--|---|---|
| 50ICAT= 6" Aperture, New Construction, IC AIR-TITE TM , High Efficacy LED Housing | 600 Series / 80 CRI ML5606837 = 5"/6" LED Retrofit Downlight Light Module, 600 lumen, 80CRI, 2700K ML5606838 = 5"/6" LED Retrofit Downlight Light Module, 600 lumen, 80CRI, 3500K ML5606836 = 5"/6" LED Retrofit Downlight Light Module, 600 lumen, 80CRI, 4000K 600 Series / 90 CRI ML5606930 = 5"/6" LED Retrofit Downlight Light Module, 600 lumen, 90CRI, 2700K ML5606930 = 5"/6" LED Retrofit Downlight Light Module, 600 lumen, 90CRI, 3000K ML5606930 = 5"/6" LED Retrofit Downlight Light Module, 600 lumen, 90CRI, 3000K ML5606930 = 5"/6" LED Retrofit Downlight Light Module, 600 lumen, 90CRI, 3000K ML5606930 = 5"/6" LED Retrofit Downlight Light Module, 600 lumen, 90CRI, 3000K ML5609830 = 5"/6" LED Retrofit Downlight Light Module, 600 lumen, 90CRI, 3000K ML5609827 = 5"/6" LED Retrofit Downlight Light Module, 900 lumen, 80CRI, 2700K ML5609830 = 5"/6" LED Retrofit Downlight Light Module, 900 lumen, 80CRI, 2000K 900 Series / 80 CRI ML5609835 = 5"/6" LED Retrofit Downlight Light Module, 900 lumen, 80CRI, 3500K ML5609835 = 5"/6" LED Retrofit Downlight Light Module, 900 lumen, 80CRI, 3000K ML5609836 = 5"/6" LED Retrofit Downlight Light Module, 900 lumen, 80CRI, 2700K ML5609837 = 5"/6" LED Retrofit Downlight Light Module, 900 lumen, 90CRI, 3000K ML5609836 = 5"/6" LED Retrofit Downlight Light Module, 900 lumen, 90CRI, 3000K ML5609937 = 5"/6" LED Retrofit Downlight Light Module, 900 lumen, 90CRI, 3000K ML5609935 = 5"/6" LED Retrofit Downlight Light Module, 900 lumen, 90CRI, 3000K ML5612827 = 5"/6" LED Retrofit Downlight Light Module, 900 lumen, 90CRI, 3000K ML5612827 = 5"/6" LED Retrofit Downlight Light Module, 900 lumen, 90CRI, 3000K ML5612827 = 5"/6" LED Light Module, 1200 lumen, 80CRI, 2700K ML5612827 = 5"/6" LED Light Module, 1200 lumen, 80CRI, 3000K ML5612830 = 5"/6" LED Light Module, 1200 lumen, 90 | 690 Series - 6" LED Trims Non-Conductive "Dead Front" Baffles 691WB=6" LED Trim, Polymer "Dead-Front", Shallow White Baffle & Flange (For use with 600 Series LED Light Modules only) Reflectors 692E-6" LED Downlight Trim, Specular Reflector & White Flange 692H=6" LED Downlight Trim, Haze Reflector & White Flange 692W=6" LED Downlight Trim, White Reflector & Flange 693WB=6" LED Downlight Trim, White Micro-Step Baffle & Flange 693WB=6" LED Downlight Trim, Black Micro-Step Baffle & Flange 693WB=6" LED Downlight Trim, Satin Nickel Micro-Step Baffle & Flange 693TBZB=6" LED Downlight Trim, Tuscan Bronze Micro-Step Baffle & Flange 693TBZB=6" LED Directional Trim, Satin Nickel Eyeballs 694WB=6" LED Directional Trim, Satin Nickel Eyeball, Baffle & Flange 694WB=6" LED Directional Trim, Satin Nickel Eyeball, Baffle & Flange 694WB=6" LED Directional Trim, White Eyeball, Baffle & Flange 694WB=6" LED Directional Trim, White Eyeball, Baffle & Flange 694TBZB=6" LED Downlight Trim, Walt 694TBZB=6" LED Directional Trim, Satin Nickel Eyeball, Baffle & Flange 694TBZB=6" LED Directional Trim, Walt 694TBZB=6" LED Directional Trim, Walt 694WB=6" LED Directional Trim, Walt Wash with Specular Kick Reflector & White Flange Shallow Baffle 696WB=6" LED Trim, White Shallow Baffle & Flange | ML56CLIP= 6" Friction Clip Kit - For use with non-torsion spring housings. 6 clips included. WW6955C= Wall Wash Insert - Specular Kick Reflector for 695WW (1 include with trim). For double wall was or replacement. TRM690WH= 6" LED Oversize Tim Ring for with 59" series trims, White 6.1 I.D., 9.5" O.D. Ring slips over LED trim. Inset design allows 6" trim to fit into oversize ring for an even trim surface EBA560PK= Replacement screwbase adapti to LED disconnect with cap ML56-1200 Series Beam Forming Optic Mit BFR56MFL=Beam forming reflector kit, narro flood, 25° nominal BFR56MH=Media holder, accepts one 3.45" lens. Requires BFR56NFL & L34: order separately. L345SF=3.45" diameter soft focus lens. Requires BFR56NFL and BFR56MH- order separately. |

Cooper Lighting by **FAT**•N

Eaton

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Eaton's Cooper Lighting Business 1121 Highway 74 South Peachtree City, GA 30269 P: 770-486-4800 www.cooperlighting.com

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Specifications and dimensions subject to change without notice.

Description

The Halo ML56 LED Downlighting System is a series of modular LED Modules for use with designated 5" or 6" ML56 LED trims in new construction, remodel and retrofit installation Compatible with Halo 5" H550 and 6" H750, H2750 Series LED housings. And in retrofit of existing housings the ML56 Series fits 5" or 6" Halo and others. ML56 LED Modules are offered in 600 Series, 900 Series, and 1200 Series, 90CRI, and four color temperatures 2700K, 3000K, 3500K, 4000K. ML56 LED Modules are universal voltage 120V - 277V and dimmable at 120V. The ML56 lens provides uniform diffuse illumination standard.

Specification Features

Mechanical

Light Module

- Module includes LED package, LED driver, heat sink, and lens
- Durable die-cast aluminum construction. Heat sink designed to conduct heat away from the LED keeping the junction temperatures below specified maximums, including insulated ceiling environments

Lens

- Impact-resistant polycarbonate
- Convex form for lamp-like appearance
- High lumen transmission
- Diffusing for even illumination

Mounting

- Modules attach to reflector and baffle trims via locking tabs, and attach to eyeballs via keyed twist-to-lock mating bosses
- The complete module and trim assembly installs into housings with precision formed torsion springs located on the trim
- Friction Blade mounting is an alternate option using the accessory 6" Friction Blade Kit model ML56CLIP (order separately). Friction blades provide alternative to torsion springs for retrofit in 6" housings without torsion mounting tabs. ML56CLIP is compatible with 6" baffle and reflector trims only (691, 692, 693, 695, 696 series). For eyeball trim (694 series) use ML7RAB retrofit adapter band.

Housing Compatibility

A complete ML56 system includes a LED Module, LED trim, and a compatible housing (new construction, remodel, or existing retrofit). Housing compatibility in the ML56 System is determined by the ML56 trim dimensions. ML56 trims are available in 5" and 6" aperture (5" = 59xx series and 6" = 69xx series trims). Refer to Housing - Trim Section in this document.

LED

- 600 Series = 600 design lumens typical
- Delivered lumens vary depending upon 5" or 6", color temperature, and trim finish.
- Color Temperature options: 2700K, 3000K, 3500K, 4000K

• CRI: 90, R9>50

- L70 at 50,000 hours, projected in accordance with IES TM-21
- LED is a chip on board design consisting of a multiple LED package to create one virtual light source for a productive "cone of light

Color Specification & Quality Standards

- A tight chromaticity specification ensures LED color uniformity, sustainable Color Rendering Index (CRI) and Correlated Color Temperature (CCT) over the useful life of the LED
- LED color uniformity of 3 SDCM exceeds ENERGY STAR® color standards per ANSI C78.377- 2008.
- High color performance with 90CRI minimum, and R9 greater than 50.
- Every Halo LED Module is quality tested and performance measured, and then serialized in a permanent record to register lumens, wattage, CRI and CCT.
- · Halo LED serialized testing and measurement process ensures color and lumen consistency on a per-unit basis, and validates long-term product consistency over time
- Halo ML56 LED Modules include lumen, CRI, and CCT designations in the model number
- Example: ML5606930 56 = 5'' / 6'' aperture series
- **06** = 600 lumen series
- 9 = >90 CRI
- 30 = 3000K nominal CCT

Electrical Power Connections

- · LED connector is a non-screw base luminaire disconnect offering easy installation with the matching Halo 5" H550 series and 6" H750 and H2750 series housings (housing selected depends upon LED trim 5" or 6")
- · LED Connector meets high-efficacy luminaire requirement for a non-screw base, and where required.
- The included E26 medium screw-base Edison adapter*provides easy retrofit of incandescent housings (see Housing

Ground Connection

Catalog #

Project

Comments

Prepared by

Separate grounding cable included on the module for attachment to the housing during installation.

LED Driver

- Driver is universal voltage 120V-277V, and may be controlled from a switch in this range of main inputs (switchable at 120V, 220V, 230V, 240V, and 277V)
- · Driver is dimmable at 120V operation when connected to a compatible dimmer.
- Driver is a high efficiency, electronic power supply providing DC power to the LED.
- Driver meets FCC EMI/RFI Consumer Level limits on 120V main inputs, and is compliant for use in residential and commercial installations.
- Driver features high power factor, low THD, and has integral thermal protection in the event of over temperature or internal failure
- Driver is replaceable, if replacement should be required.

Dimming

Designed for dimming capability to nominal 5% in normal operation with standard 120V Leading Edge (LE) and Trailing Edge (TE) phase control dimmers (Consult dimmer manufacturer for dimmer compatibility and details. Note, some dimmers require a neutral in the wallbox.)

Warranty

Eaton provides a (5) five year limited warranty on the Halo ML56 LED Module.

LED Module in New or Retrofit Existing **Construction – Housings other than Halo**

- If used in recessed housings other than Halo the Eaton 5-year limited warranty applies to the LED Light Module and Trim only
- · As with any electrical installation, a qualified electrician must ensure compatibility of use with a particular housing; this includes all applicable national and local electrical and building codes. Installer is responsible to properly and securely retain the LED Module and LED Trim in the housing at time of installation.









Section)

ML5606930 5" or 6" LED 600 Series



ML5606935 5" or 6" LED 600 Series



ML5606940 5" or 6" LED 600 Series



ML56 LED System

600 Series / 90 CRI

ML5606927 ML5606930 ML5606935 ML5606940

5-Inch and 6-Inch 600 Lumen LED Module for New Construction, **Remodel and Retrofit**

For use with 59x and 69x Series Trims

FOR USE IN **INSULATED CEILING** AND NON-INSULATED **CEILING RATED** HOUSINGS

HIGH EFFICACY LED WITH INTEGRAL **DRIVER - DIMMABLE**

Energy Data

| ML56 600/90 Series | | |
|---|--|--|
| (Values at non-dimming line voltage) | | |
| Minimum Starting Temp: -30°C (-22°F) | | |
| EMI/RFI: FCC Title 47 CFR, Part 15, (Consumer) | | |
| Sound Rating: Class A | | |
| Input Voltage: UNV 120V-277V | | |
| Power Factor: >0.95 @ 120V and >0.9 @277V | | |
| Input Frequency: 50/60Hz | | |
| THD: <20% | | |
| Input Power: 9.5W | | |
| Input Current at 120V: 0.15A | | |
| Input Current at 277V: 0.08A | | |
| Driver Compliance: UL8750, Class II rated | | |
| Maximum IC (Insulated Ceiling) Ambient Continuous Operating Temperature: 25°C (77°F) | | |
| Maximum Non-IC Ambient Continuous Operating Temperature: 40°C (104°F) | | |



Туре

Date

| D1 | |
|----|--|
| | |
| | |

DESCRIPTION

692 Series LEDTrims - 6-inch Aperture Reflectors - are integral elements in the Halo ML56 LED Downlighting System. ML56 LED System is a series of modular LED Light Modules for use with dedicated 5" or 6" ML56 LED trims. The ML56 LED trims in 5" and 6" aperture sizes are designed to fit Halo, All-Pro and others 5" or 6" recessed housings. The ML56 system is suitable for new construction, remodel or retrofit installation.

| Catalog # | Туре |
|-------------|------|
| Project | |
| Comments | Date |
| Prepared by | |

SPECIFICATION FEATURES

692 Series LED trims are 6-inch aperture reflectors offered in Specular Clear, Haze (Semi-Specular Clear), and White (Matte White). 692 Series Reflectors also feature matte white finish flange. The precision spun aluminum reflector provides excellent optical performance. The 692 reflectors may be used in most standard height 6-inch aperture recessed housings; Halo, All-Pro, and more (refer to ML56 LED Light Module specifications for details).

- For use with ML56 Series LED light modules
- For use in standard housings
- · Reflectors with self-flange
- Wet location shower listed with ML56 LED Light Modules
- · Torsion springs pull trim and light module tight to ceiling
- ML56 downlight trims and modules make any housing AIR-TITE™ (ASTM E283)

Compatible with ML56 LED System of LED Downlight Light Modules

600 Series - 80CRI, 600lm


5"/6" LED Retrofit Downlight Engine ML5606827 - 2700K ML5606830 - 3000K ML5606835 - 3500K ML5606840 - 4000K

900 Series - 80CRI, 900lm

5"/6" LED Retrofit Downlight Engine ML5609827 - 2700K ML5609830 - 3000K ML5609835 - 3500K ML5609840 - 4000K

1200 Series - 80CRI, 1200Im

5"/6" LED Retrofit Downlight Engine ML5612827 - 2700K ML5612830 - 3000K ML5612835 - 3500K ML5612835 - 3500K ML5612840 - 4000K

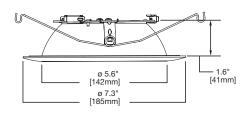

600 Series - 90CRI, 600Im 5"/6" LED Retrofit Downlight Engine ML5606927 - 2700K ML5606930 - 3000K ML5606935 - 3500K ML5606940 - 4000K

900 Series - 90CRI, 900Im <u>5"/6" LED Retrofit Downlight Engine</u> ML5609927 - 2700K

ML5609930 - 3000K ML5609935 - 3500K ML5609940 - 4000K

1200 Series - 90CRI, 1200Im <u>5"/6" LED Retrofit Downlight Engine</u> ML5612927 - 2700K ML5612930 - 3000K

ML5612935 - 3500K ML5612940 - 4000K

ORDERING INFORMATION

SAMPLE NUMBER: 692SC

| Trim | Finish | Accessory |
|-------------------|--|--|
| 692= 6" Reflector | SC=Specular Clear, White Flange H=Haze (Semi-Specular), White Flange W=White (Matte White), White Flange | TRM690WH=6" LED Oversize Trim Ring for use with 69* series trims, White 6.9" I.D., 9.5" O.D. Ring slips over LED trim. Inset design allows 6" trim to fit into oversize ring for an even trim surface ML56CLIP= Friction Clip Mounting Kit - For retrofitting nontorsion spring housings, 6" clips |

Cooper Lighting

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Specifications and dimensions subject to change without notice.

ADV141666 6/30/2014

ear), spun

692SC



692H



692 Series LED Trim


6-Inch Reflector

For use with Halo ML56 LED System Light Modules



D1

HALO

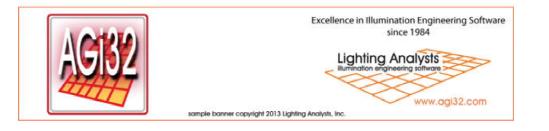

Photometric Report (Type C)

Filename: ML5606830-692H.ies
[TEST] P130308 TEST IS SCALED FROM IESNA LM-79-08 TEST
DATA (P24956)
[TESTLAB] Innovations Center P2
[ISSUEDATE] 11/10/2014
[MANUFAC] EATON - HALO (FORMER COOPER LIGHTING)
[LUMCAT] ML5606830-692H
[LUMINAIRE] HALO 6 INCH ML56 LED DOWNLIGHT WITH HAZE
REFLECTOR
[LAMP] (1) HIGH LUMEN LED 80CRI / 3000K CCT
Maximum Candela = 581.3 at 0 H 0 V


Classification:

Road Classification: Type V, Very Short, N.A. (deprecated) Upward Wast Light Ratio: 0.00 Luminaire Efficacy Rating (LER): 73 Indoor Classification: Direct BUG Rating : B1-U0-G0

Polar Candela Curves:

Vertical Plane Through: 1) 0 - 180 Horizontal

Horizontal Cone Through: 2) 0 Vertical

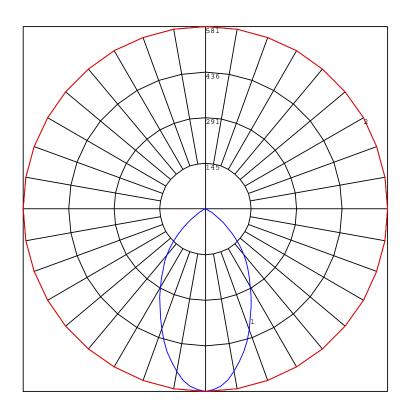

D1




Filename: ML5606830-692H.ies
[TEST] P130308 TEST IS SCALED FROM IESNA LM-79-08 TEST
DATA (P24956)
[TESTLAB] Innovations Center P2
[ISSUEDATE] 11/10/2014
[MANUFAC] EATON - HALO (FORMER COOPER LIGHTING)
[LUMCAT] ML5606830-692H
[LUMINAIRE] HALO 6 INCH ML56 LED DOWNLIGHT WITH HAZE
REFLECTOR
[LAMP] (1) HIGH LUMEN LED 80CRI / 3000K CCT
Maximum Candela = 581.3 at 0 H 0 V

Classification:

Road Classification: Type V, Very Short, N.A. (deprecated) Upward Waste Light Ratio: 0.00 Luminaire Efficacy Rating (LER): 73 Indoor Classification: Direct BUG Rating : B1-U0-G0

LCS Summary:

| BVH (80-90) 0.0 N.A. 0.0 UL (90-100) 0.0 N.A. 0.0 UH (100-180) 0.0 N.A. 0.0 Total 654.6 N.A. 100. BUG Rating B1-U0-G0 0.0 0.0 | LCS Zone FL (0-30) FM (30-60) FH (60-80) FVH (80-90) BL (0-30) BM (30-60) BH (60-80) | Lumens 171.2 151.7 4.4 0.0 171.2 151.7 4.4 | %Lamp N.A. N.A. N.A. N.A. N.A. N.A. N.A. | %Lum 26.2 23.2 0.7 0.0 26.2 23.2 0.7 |
|---|---|---|---|---|
| BM (30-60)151.7N.A.23.2BH (60-80)4.4N.A.0.7BVH (80-90)0.0N.A.0.0UL (90-100)0.0N.A.0.0UH (100-180)0.0N.A.0.0Total654.6N.A.100 | FVH (80-90) | 0.0 | N.A. | 0.0 |
| BH (60-80)4.4N.A.0.7BVH (80-90)0.0N.A.0.0UL (90-100)0.0N.A.0.0UH (100-180)0.0N.A.0.0Total654.6N.A.100 | BL (0-30) | 171.2 | N.A. | 26.2 |
| BVH (80-90)0.0N.A.0.0UL (90-100)0.0N.A.0.0UH (100-180)0.0N.A.0.0Total654.6N.A.100 | BM (30-60) | 151.7 | N.A. | 23.2 |
| UL (90-100)0.0N.A.0.0UH (100-180)0.0N.A.0.0Total654.6N.A.100 | BH (60-80) | 4.4 | N.A. | 0.7 |
| UH (100-180) 0.0 N.A. 0.0 Total 654.6 N.A. 100. | BVH (80-90) | 0.0 | N.A. | 0.0 |
| Total 654.6 N.A. 100. | UL (90-100) | 0.0 | N.A. | 0.0 |
| | UH (100-180) | 0.0 | N.A. | 0.0 |
| BUG Rating B1-U0-G0 | Total | 654.6 | N.A. | 100.0 |
| | BUG Rating | B1-U0-G0 | | |

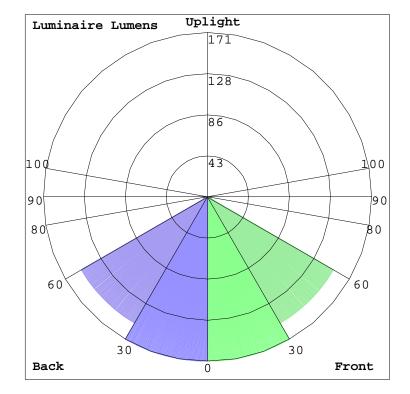

DESCRIPTION

The Galleon[™] LED luminaire delivers exceptional performance in a highly scalable, low-profile design. Patented, high-efficiency AccuLED Optics[™] system provides uniform and energy conscious illumination to walkways, parking lots, roadways, building areas and security lighting applications. IP66 rated and UL/cUL Listed for wet locations.

PL1 PL2

McGraw-Edison

| Catalog # | Туре |
|-------------|------|
| Project | |
| Comments | Date |
| Prepared by | |

SPECIFICATION FEATURES

Construction

Extruded aluminum driver enclosure thermally isolated from Light Squares for optimal thermal performance. Heavy-wall, diecast aluminum end caps enclose housing and die-cast aluminum heat sinks. A unique, patent pending interlocking housing and heat sink provides scalability with superior structural rigidity. 3G vibration tested and rated. Optional tool-less hardware available for ease of entry into electrical chamber. Housing is IP66 rated.

Optics

Patented, high-efficiency injection-molded AccuLED Optics technology. Optics are precisely designed to shape the distribution maximizing efficiency and application spacing. AccuLED Optics create consistent distributions with the scalability to meet customized application requirements. Offered standard in 4000K (+/- 275K) CCT 70 CRI. Optional 3000K, 5000K and 6000K CCT.

Electrical

LED drivers are mounted to removable tray assembly for ease of maintenance. 120-277V 50/60Hz, 347V 60Hz or 480V 60Hz operation. 480V is compatible for use with 480V Wye systems only. Standard with 0-10V dimming. Shipped standard with Eaton proprietary circuit module designed to withstand 10kV of transient line surge. The Galleon LED luminaire is suitable for operation in -40°C to 40°C ambient environments. For applications with ambient temperatures exceeding 40°C, specify the HA (High Ambient) option. Light Squares are IP66 rated. Greater than 90% lumen maintenance expected at 60,000 hours. Available in standard 1A drive current and optional 600mA. 800mA and 1200mA drive currents (nominal).

Mounting

STANDARD ARM MOUNT: Extruded aluminum arm includes internal bolt guides allowing for easy positioning of fixture during mounting. When mounting two or more luminaires at 90° and 120° apart, the EA extended arm may be required. Refer to the arm mounting requirement table. Round pole adapter included. For wall mounting, specify wall mount bracket option. QUICK MOUNT ARM: Adapter is bolted directly to the pole. Quick mount arm slide into place on the adapter and is secured via two screws, facilitating quick and easy installation. The versatile, patent pending, quick mount arm accommodates multiple drill patterns ranging from 1-1/2" to 4-7/8". Removal of the door on the quick mount arm enables wiring of the fixture without having to access the driver compartment. A knock-out enables round pole mounting.

Finish

Housing finished in super durable TGIC polyester powder coat paint, 2.5 mil nominal thickness for superior protection against fade and wear. Heat sink is powder coated black. Standard housing colors include black, bronze, grey, white, dark platinum and graphite metallic. RAL and custom color matches available.

Warranty

Five-year warranty.

DRILLING PATTERN

2

[51mm]

1-3/4"

[44mm]

TYPE "N"



GLEON GALLEON LED

1-10 Light Squares Solid State LED

AREA/SITE LUMINAIRE



CERTIFICATION DATA


UL/cUL Wet Location Listed ISO 9001 LM79 / LM80 Compliant 3G Vibration Rated IP66 Rated DesignLights Consortium® Qualified*

ENERGY DATA

Electronic LED Driver >0.9 Power Factor <20% Total Harmonic Distortion 120V-277V 50/60Hz 347V & 480V 60Hz -40°C Min. Temperature 40°C Max. Temperature 50°C Max. Temperature (HA Option)



TD500020EN June 21, 2018 4:04 PM

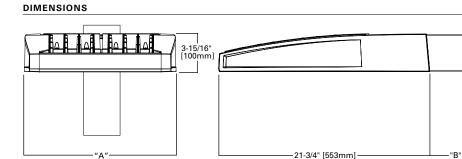

DIMENSION DATA

| Number of Light Squares | "A" Width | "B″ Standard Arm Length | "B" Optional Arm Length ¹ | Weight with Arm (Ibs.) | EPA with Arm ²(Sq. Ft.) |
|----------------------------|--------------------|-------------------------------|--|------------------------------|-------------------------------|
| 1-4 | 15-1/2" (394mm) | 7" (178mm) | 10" (254mm) | 33 (15.0 kgs.) | 0.96 |
| 5-6 | 21-5/8" (549mm) | 7" (178mm) | 10" (254mm) | 44 (20.0 kgs.) | 1.00 |
| 7-8 | 27-5/8" (702mm) | 7" (178mm) | 13" (330mm) | 54 (24.5 kgs.) | 1.07 |
| 9-10 | 33-3/4" (857mm) | 7" (178mm) | 16" (406mm) | 63 (28.6 kgs.) | 1.12 |

NOTES: 1. Optional arm length to be used when mounting two fixtures at 90° on a single pole. 2. EPA calculated with optional arm length.



(2) 9/16" [14mm]

Diameter Holes

3/4" [19mm]

Diameter Hole


7/8" [22mm]

PL1

PL2


ARM MOUNTING REQUIREMENTS


| Configuration | 90° Apart | 120° Apart |
|---------------|--------------------------------|--------------------------------|
| GLEON-AF-01 | 7" Arm (Standard) | 7" Arm (Standard) |
| GLEON-AF-02 | 7" Arm (Standard) | 7" Arm (Standard) |
| GLEON-AF-03 | 7" Arm (Standard) | 7" Arm (Standard) |
| GLEON-AF-04 | 7" Arm (Standard) | 7" Arm (Standard) |
| GLEON-AF-05 | 10" Extended Arm (Required) | 7" Arm (Standard) |
| GLEON-AF-06 | 10" Extended Arm (Required) | 7" Arm (Standard) |
| GLEON-AF-07 | 13" Extended Arm (Required) | 13" Extended Arm (Required) |
| GLEON-AF-08 | 13" Extended Arm (Required) | 13" Extended Arm (Required) |
| GLEON-AF-09 | 16" Extended Arm (Required) | 16" Extended Arm (Required) |
| GLEON-AF-10 | 16" Extended Arm (Required) | 16" Extended Arm (Required) |

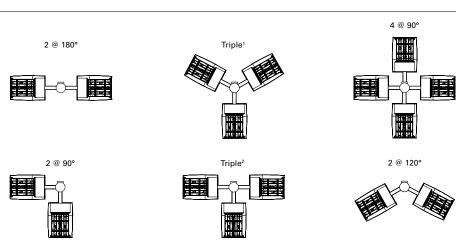


NOTES: 1 Round poles are 3 @ 120°. Square poles are 3 @ 90°. 2 Round poles are 3 @ 90°.

STANDARD WALL MOUNT

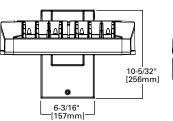


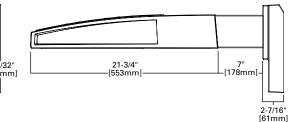


MAST ARM MOUNT

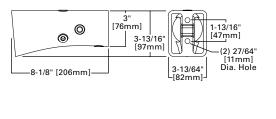


QUICK MOUNT ARM (INCLUDES FIXTURE ADAPTER)

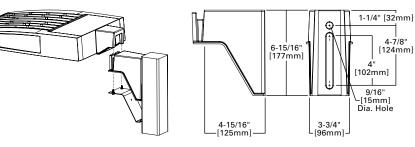

3-15/16" [100mm] "A" - 21-3/4" [553mm]–

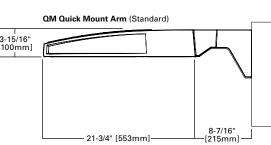

QMEA Quick Mount Arm (Extended)

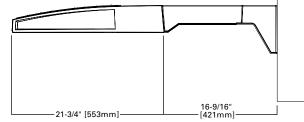


QUICK MOUNT ARM DATA

| Number of Light Squares ^{1, 2} | "A" Width | Weight with QM Arm (lbs.) | Weight with QMEA Arm (Ibs.) | EPA (Sq. Ft.) |
|--|-----------------|------------------------------|--------------------------------|-------------------------|
| 1-4 | 15-1/2" (394mm) | 35 (15.91 kgs.) | 38 (17.27 kgs.) | |
| 5-6 ³ | 21-5/8" (549mm) | 46 (20.91 kgs.) | 49 (22.27 kgs.) | 1.11 |
| 7-8 | 27-5/8" (702mm) | 56 (25.45 kgs.) | 59 (26.82 kgs.) | |

NOTES: 1 QM option available with 1-8 light square configurations. 2 QMEA option available with 1-6 light square configurations. 3 QMEA arm to be used when mounting two fixtures at 90° on a single pole.



Specifications and dimensions subject to change without notice. Sample Number: GLEON-AF-04-LED-E1-T3-GM-OM

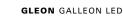

PL1

PL2

| Product Family ^{1, 2} | Light Engine | Number of Light Squares ³ | Lamp Type | Voltage | Distribution | | Color | Mounting |
|--|------------------------|--|--|---|--|--|--|---|
| GLEON =Galleon | AF=1A Drive Current | 01=1 02=2 03=3 04=4 06=5 ⁴ 06=6 07=7 ⁵ 08=8 ⁵ 09=9 ⁶ 10=10 ⁶ | LED=Solid State Light Emitting Diodes | E1=120-277V 347=347V ⁷ 480=480V ^{7.8} | T2=Type II T2R=Type II Roadway T3=Type III T3R=Type III Roadway T4FT=Type IV Forward Throw T4W=Type IV Wide SNQ=Type V Narrow 5MQ=Type V Square Medium 5WQ=Type V Square Medium 5WQ=Type II w/Spill Control SL3=Type II w/Spill Control SL4=Type IV m/Spill Control SL4=T | | AP=Grey BZ=Bronze BK=Black DP=Dark Platinum GM=Graphite Metallic WH=White | [Blank]=Arm for Round or Square Pole EA=Extended Arm ⁹ MA=Mast Arm Adapter ¹⁰ WM=Vall Mount QM=Quick Mount Arm (Standard Length) ¹¹ QMEA=Quick Mount Arm (Extended Length) ¹² |
| Options (Add as S | uffix) | | | | | Accessories (Order | Separately) | |
| Options (Add as Suffix) AFL=Automotive 7030=70 CRI 3000K ¹³ 8030=80 CRI 3000K ¹⁴ 8030=80 CRI 3000K ¹⁴ 7050=70 CRI 6000K ¹³ 600=Drive Current Factory Set to Nominal 600mA ¹⁵ 800=Drive Current Factory Set to Nominal 800mA ¹⁵ 800=Drive Current Factory Set to Nominal 800mA ¹⁵ 800=Drive Current Factory Set to Nominal 800mA ¹⁵ 800=Drive Current Factory Set to Nominal 200mA ^{15, 16} F=Single Fuse (120, 277 or 347. Wust Specify Voltage) FF=Double Fuse (208, 240 or 480V. Must Specify Voltage) F=Factore Current ^{13, 18} DIM=External 0-10V Dimming Leads ^{18, 20} P=Button Type Photocontrol Receptacle ²¹ PER7>=NEMA 7-PIN Twistlock Photocontrol Receptacle ²¹ AHD245=After Hours Dim, 6 Hours ²² AHD255=After Hours Dim, 7 Hours ²² AHD245=After Hours Dim, 8 Hours ²² AHD255=After Hours Dim, 8 Hours ²² AHD35=After Hours Dim, 8 Hours ²² MS/DIM-L20=Motion Sensor for Dimming Operation, 9' - 20' Mounting Height ^{24, 25} MS/XL30=Bi-Level Motion Sensor, 7 aiximum 8' Mounting Height ^{24, 25} MS/X-L20=Bi-Level Motion Sensor, 7 21' - 40' Mounting Height ^{24, 25} MS/X-L40=Bi-Level Motion Sensor, 21' - 40' Mounting Height ^{24, 25} MS/X-L40=Bi-Level Motion Sensor, 21' - 40' Mounting Height ^{24, 25} MS/X-L40=Bi-Level Motion Sensor, 21' - 40' Mounting Height ^{24, 25} MS/X-L40=Bi-Level | | | | | | OA/RA1027=NEMA OA/RA1021=NEMA OA/RA1013=Photo OA/RA1013=Photo OA/RA1014=120V MA1036-XX=Single MA1037-XX=2@18 MA1197-XX=3@12 MA1189-XX=2@30 MA1190-XX=3@90 MA1190-XX=3@90 MA1192-XX=2@18 MA1039-XX=2@18 MA1039-XX=2@30 MA1192-XX=3@90 MA1193-XX=4@90 MA1193-XX=4@90 MA1193-XX=3@90 FSIR-100=Wireless GLEON-MT3=Field GLEON-MT3=Field GLEON-MT4=Field GLEON-MT4=Field GLEON-MT4=Field | ge Module Replacement a Tenon Adapter for 2-3/8 0° Tenon Adapter for 2-3/3 ° Tenon Adapter for 2-3/3 ° Tenon Adapter for 2-3/8 ° Tenon Adapter for 2-3/8 0° Tenon Adapter for 2-3/8 0° Tenon Adapter for 3-1/2 0° Tenon Adapter for 3-1/2 0° Tenon Adapter for 3-1/2 ° Inon Adapter for 3-1/2 ° Tenon Adapter fo | " O.D. Tenon 8" O.D. Tenon 8" O.D. Tenon " O.D. Tenon " O.D. Tenon " O.D. Tenon 8" O.D. Tenon 2" O.D. Tenon 2" O.D. Tenon 2" O.D. Tenon " O.D. |

NOTES

1. Customer is responsible for engineering analysis to confirm pole and fixture compatibility for all applications. Refer to our white paper WP513001EN for additional support information.

2. Designlights Consortium Qualified. Refer to www.designlights.org Qualified Products List under Family Models for details.
3. Standard 4000K CCT and minimum 70 CRI.
4. Not compatible with MS/4-LXX or MS/1-LXX sensors.

- Not compatible with standard guick mount arm (QMEA).
 Not compatible with standard guick mount arm (QM) or extended guick mount arm (QMEA).
 Not compatible with standard guick mount arm (QM) or extended guick mount arm (QMEA).
 Requires the use of an internal step down transformer when combined with sensor options. Not available with sensor at 1200mA. Not available in combination with the HA high ambient and sensor options at 1A.
 Only for use with 4800 Wye systems. Per NEC, not for use with ungrounded systems, impedance grounded systems or corner grounded systems (commonly known as Three Phase Three Wire Delta, Three Phase

High Leg Delta and Three Phase Corner Grounded Delta systems). 9. May be required when two or more luminaires are oriented on a 90° or 120° drilling pattern. Refer to arm mounting requirement table. 10. Factory installed.

- 11. Maximum 8 light squares.
- Maximum 6 light squares.
 Maximum 6 light squares.
 Extended lead times apply. Use dedicated IES files for 3000K, 5000K and 6000K when performing layouts. These files are published on the Galleon luminaire product page on the website.
 Extended lead times apply. Use dedicated IES files for 3000K, 5000K and 6000K when performing layouts. These files are published on the Galleon luminaire product page on the website.

15. 1 Amp standard. Use dedicated IES files for 600mA, 800mA and 1200mA when performing layouts. These files are published on the Galleon luminaire product page on the website

16. Namp Statistical. Use decidated its first on booling, option and recome when performing system to be a performed as performed as a performance of the performance of th

Eaton

- Not available with LumaWatt Pro wireless sensors.
 Cannot be used with other control options.
 Cannot be used with other control lead brought out 18" outside fixture.
 Not available if any "MS" sensor is selected. Motion sensor has an integral photocell.
 Requires the use of P photocontrol or the PERT or R photocontrol receptacle with photocontrol accessory. See After Hours Dim supplemental guide for additional information.
 Go"C lumen maintenance data applies to 600mA, 800mA and 1A drive currents.
 The FSR-100 configuration tool is required to adjust parameters including high and low modes, sensitivity, time delay, cutoff and more. Consult your lighting representative at Eaton for more information.
 Approximately 22' detection diameter at 8' mounting height.
 Approximately 40' detection diameter at 20' mounting height.
 Approximately 100' detection diameter at 40' mounting height.
 Approximately 100' detection diameter at 40' mounting height.
 Approximately 100' detection diameter at 40' mounting height.
 Beplace X with number of Light Suares operationa in low output mode.

- 29. Replace X with number of Light Squares operating in low output mode.
 30. LumaWatt Pro wireless sensors are factory installed only requiring network components LWP-EM-1, LWP-GW-1 and LWP-PoE8 in appropriate quantities. See www.eaton.com/lighting for LumaWatt Pro application information.
- 31. Not available with house side shield (HSS).
- Only for use with FUSSE stude sineta (FISS).
 Only for use with FUSS (SLS, SL4 and AFL distributions. The Light Square trim plate is painted black when the HSS option is selected.
 Cel is not available with the LWR, MS, MS/X, MS/DIM, P, R or PER7 options. Available in 120-277V only.
 One required for each Light Square.

- 35. Requires 7-pin NEMA twistlock photocontrol receptacle.



1121 Highway 74 South Peachtree City, GA 30269 P: 770-486-4800 www.eaton.com/lighting

Specifications and dimensions subject to change without notice.



Filename: GLEON-AF-01-LED-E1-5MQ-7030-600.ies
[TEST] P192529 TEST IS SCALED FROM IESNA LM-79-08 TEST
DATA (P24142)
[TESTLAB] Innovations Center P2
[ISSUEDATE] 8/2/2018
[MANUFAC] EATON - McGRAW-EDISON (FORMER COOPER
LIGHTING)
[LUMCAT] GLEON-AF-01-LED-E1-5MQ-7030-600
[LUMINAIRE] GALLEON AREA AND ROADWAY LUMINAIRE (1) 70
CRI, 3000K, 615mA LIGHTSQUARE WITH 16 LEDS EACH AND
TYPE V MEDIUM OPTICS

Maximum Candela = 2455.7 at 45 H 67.5 V


Classification:

Road Classification: Type VS, Short, N.A. (deprecated) Upward Wast Light Ratio: 0.00 Luminaire Efficacy Rating (LER): 123 Indoor Classification: Direct BUG Rating : B2-U0-G1

Polar Candela Curves:

Vertical Plane Through: 1) 45 - 225 Horizontal

Horizontal Cone Through: 2) 67.5 Vertical

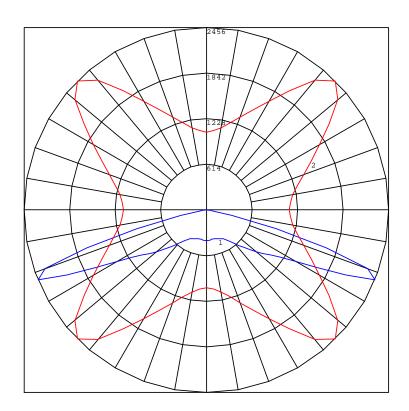

PL1



Filename: GLEON-AF-01-LED-E1-5MQ-7030-600.ies
[TEST] P192529 TEST IS SCALED FROM IESNA LM-79-08 TEST
DATA (P24142)
[TESTLAB] Innovations Center P2
[ISSUEDATE] 8/2/2018
[MANUFAC] EATON - McGRAW-EDISON (FORMER COOPER
LIGHTING)
[LUMCAT] GLEON-AF-01-LED-E1-5MQ-7030-600
[LUMINAIRE] GALLEON AREA AND ROADWAY LUMINAIRE (1) 70
CRI, 3000K, 615mA LIGHTSQUARE WITH 16 LEDS EACH AND
TYPE V MEDIUM OPTICS


Maximum Candela = 2455.7 at 45 H 67.5 V

Classification:

Road Classification: Type VS, Short, N.A. (deprecated) Upward Waste Light Ratio: 0.00 Luminaire Efficacy Rating (LER): 123 Indoor Classification: Direct BUG Rating : B2-U0-G1

LCS Summary:

| LCS Zone | Lumens | %Lamp | %Lum |
|-------------------------------------|---------------------------|--------------|--------------|
| FL (0-30) | 171.9 | N.A. | 4.1 |
| FM (30-60) | 909.4 | N.A. | 21.8 |
| FH (60-80) | 990.5 | N.A. | 23.7 |
| FVH (80-90) | 14.5 | N.A. | 0.3 |
| FVH (80-90) | 14.5 | N.A. | 0.3 |
| BL (0-30) | 171.9 | N.A. | 4.1 |
| BM (30-60) | 909.4 | N.A. | 21.8 |
| BH (60-80) | 990.5 | N.A. | 23.7 |
| BVH (80-90) | 14.5 | N.A. | 0.3 |
| UL (90-100) | 0.0 | N.A. | 0.0 |
| UH (100-180) Total BUG Rating | 0.0 4172.6 B2-U0-G1 | N.A. N.A. | 0.0 100.0 |

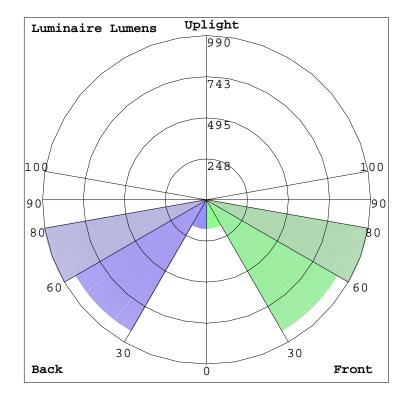



Filename: GLEON-AF-02-LED-E1-SL3-7030-HSS.ies
[TEST] P192870 TEST IS SCALED FROM IESNA LM-79-08 TEST
DATA (P24289)
[TESTLAB] Innovations Center P2
[ISSUEDATE] 7/21/2016
[MANUFAC] EATON - McGRAW-EDISON (FORMER COOPER
LIGHTING)
[LUMCAT] GLEON-AF-02-LED-E1-SL3-7030-HSS
[LUMINAIRE] GALLEON AREA AND ROADWAY LUMINAIRE (2) 70
CRI, 3000K, 1050mA LIGHTSQUARES WITH 16 LEDS EACH AND
TYPE III SPILL LIGHT ELIMINATOR OPTICS WITH HOUSE SIDE SHIELD

Maximum Candela = 10512.9 at 59 H 69 V


Classification:

Road Classification: Type III, Short, N.A. (deprecated) Upward Wast Light Ratio: 0.00 Luminaire Efficacy Rating (LER): 82 Indoor Classification: Direct BUG Rating : B1-U0-G2

Polar Candela Curves:

Vertical Plane Through: 1) 59 - 239 Horizontal

Horizontal Cone Through: 2) 69 Vertical

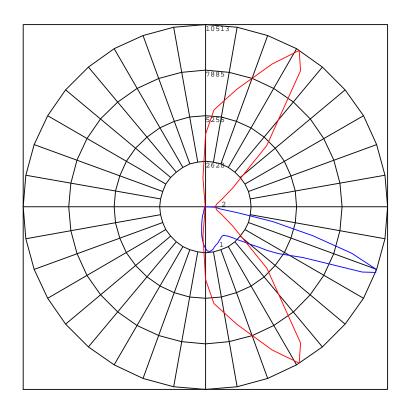



Filename: GLEON-AF-02-LED-E1-SL3-7030-HSS.ies
[TEST] P192870 TEST IS SCALED FROM IESNA LM-79-08 TEST
DATA (P24289)
[TESTLAB] Innovations Center P2
[ISSUEDATE] 7/21/2016
[MANUFAC] EATON - McGRAW-EDISON (FORMER COOPER
LIGHTING)
[LUMCAT] GLEON-AF-02-LED-E1-SL3-7030-HSS
[LUMINAIRE] GALLEON AREA AND ROADWAY LUMINAIRE (2) 70
CRI, 3000K, 1050mA LIGHTSQUARES WITH 16 LEDS EACH AND
TYPE III SPILL LIGHT ELIMINATOR OPTICS WITH HOUSE SIDE SHIELD


Maximum Candela = 10512.9 at 59 H 69 V

Classification:

Road Classification: Type III, Short, N.A. (deprecated) Upward Waste Light Ratio: 0.00 Luminaire Efficacy Rating (LER): 82 Indoor Classification: Direct BUG Rating : B1-U0-G2

LCS Summary:

| LCS Zone FL (0-30) FM (30-60) FH (60-80) FVH (80-90) BL (0-30) BM (30-60) PU (60-80) | Lumens 878.2 3851.8 3601.2 129.8 259.6 282.6 | %Lamp N.A. N.A. N.A. N.A. N.A. N.A. | %Lum 9.5 41.8 39.1 1.4 2.8 3.1 2.2 |
|---|--|---|---|
| | 129.8 | N.A. | 1.4 |
| . , | | | - • • |
| , , | | | |
| BH (60-80) | 203.7 | N.A. | 2.2 |
| BVH (80-90) | 4.1 | N.A. | 0.0 |
| UL (90-100) UH (100-180) | 0.0 | N.A. N.A. | 0.0 |
| Total | 9211.0 | N.A. | 100.0 |
| BUG Rating | B1-U0-G2 | | |

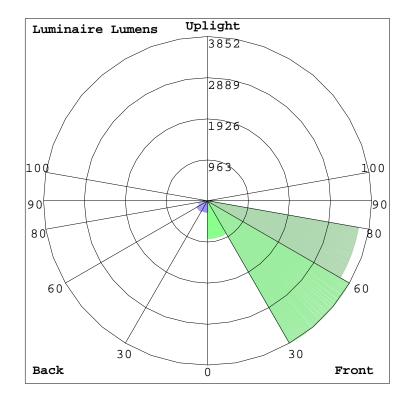

DESCRIPTION

The Impact Elite family of wall luminaires is the ideal complement to site design. Incorporating modular LightSquares technology, the Impact Elite luminaire provides outstanding uniformity and energy-conscious illumination. Combined with a rugged construction, the Impact Elite luminaire is the ideal facade and security luminaire for zones surrounding schools, office complexes, apartments and recreational facilities. UL/cUL listed for wet locations.

SPECIFICATION FEATURES

Construction

Heavy-wall, die-cast aluminum housing and removable hinged door frame for precise tolerance control and repeatability. Hinged door inset for clean mating with housing surface and secured via two captive fasteners. Optional tamper-resistant Torx[™] head fasteners offer vandal resistant access to the electrical chamber.

Optics

Choice of 10 patented, highefficiency AccuLED Optics[™] distributions. Optics are precisely designed to shape the light output, maximizing efficiency and application spacing. AccuLED Optics technology creates consistent distributions with the scalability to meet customized application requirements. Offered Standard in 4000K (+/- 275K) CCT and minimum 70 CRI. Optional 3000K, 5000K and 5700K CCT.

Electrical

LED drivers mount to die-cast aluminum back housing for optimal heat sinking, operation efficacy, and prolonged life. Standard drivers feature electronic universal voltage (120-277V 50/60Hz), 347V 60Hz or 480V 60Hz operation, greater than 0.9 power factor, less than 20% harmonic distortion, and are suitable for operation in -40°C to 40°C ambient environments. All fixtures are shipped standard with 10kV/10kA common - and differential - mode surge protection. LightSquares feature an IP66 enclosure rating and maintain greater than 90% lumen maintenance at 60,000 hours per IESNA TM-21. Emergency egress options for -20°C ambient environments and occupancy sensor available.

W1

McGraw-Edison

| Catalog # | Туре |
|-------------|------|
| Project | |
| Comments | Date |
| Prepared by | |

Mounting

Gasketed and zinc plated rigid steel mounting attachment fits directly to 4" j-box or wall with the Impact Elite "Hook-N-Lock" mechanism for quick installation. Secured with two captive corrosion resistant black oxide coated allen head set screws concealed but accessible from bottom of fixture.

Finish

Cast components finished in a five-stage super TGIC polyester powder coat paint, 2.5 mil nominal thickness for superior protection against fade and wear. Standard colors include black, bronze, grey, white, dark platinum and graphite metallic. RAL and custom color matches available. Consult the McGraw-Edison Architectural Colors brochure for the complete selection.

- 9" [229mm]

Warranty

Five-year warranty.

9"['] [229mm]









ISC/ISS/IST/ISW IMPACT ELITE LED

1 LightSquare Solid State LED

WALL MOUNT LUMINAIRE

CERTIFICATION DATA UL/cUL Listed LM79 / LM80 Compliant IP66 LightSquare DesignLights Consortium® Qualified* ISO 9001

ENERGY DATA

Electronic LED Driver >0.9 Power Factor <20% Total Harmonic Distortion 120-277V/50 & 60Hz, 347V/60Hz, 480V/60Hz -40°C Minimum Temperature 40°C Ambient Temperature Rating

SHIPPING DATA


Approximate Net Weight: 18 lbs. (8 kgs.)







TD514030EN February 20, 2019 1:35 PM

DIMENSIONS

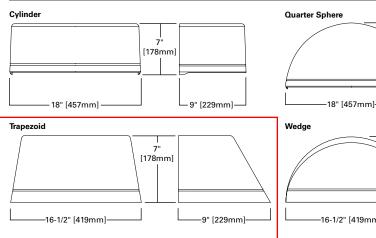

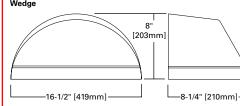

HOOK-N-LOCK MOUNTING

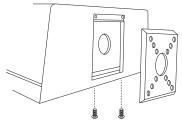



*www.designlights.org

POWER AND LUMENS

| 1 LightSqu | uare (AF) | | Cylinder (ISC) and Quarter Sphere (ISS) | | | | | | Trap | ezoid (IST) a | and Wedge (I | SW) | |
|------------|-----------------------------|----------|---|----------|----------|----------|----------|----------|----------|---------------|--------------|----------|----------|
| Drive Curr | urrent (mA) 350 450 600 800 | | | 1000 | 1200 | 350 | 450 | 600 | 800 | 1000 | 1200 | | |
| Power (Wa | atts) 120-277V | 20.3 | 25.5 | 33.4 | 43.9 | 55.1 | 66.2 | 20.3 | 25.5 | 33.4 | 43.9 | 55.1 | 66.2 |
| | 120V | 0.17 | 0.22 | 0.29 | 0.38 | 0.48 | 0.56 | 0.17 | 0.22 | 0.29 | 0.38 | 0.48 | 0.56 |
| Current (A | 277V | 0.09 | 0.10 | 0.13 | 0.17 | 0.21 | 0.25 | 0.09 | 0.10 | 0.13 | 0.17 | 0.21 | 0.25 |
| Power (Wa | atts) 347V or 480V | 23.3 | 28.7 | 36.6 | 49.5 | 60.7 | 70.1 | 23.3 | 28.7 | 36.6 | 49.5 | 60.7 | 70.1 |
| • | 347V | 0.07 | 0.08 | 0.11 | 0.15 | 0.18 | 0.21 | 0.07 | 0.08 | 0.11 | 0.15 | 0.18 | 0.21 |
| Current (A | 480V | 0.05 | 0.06 | 0.08 | 0.11 | 0.13 | 0.16 | 0.05 | 0.06 | 0.08 | 0.11 | 0.13 | 0.16 |
| Optics | | - | | | | | | | | | | | |
| T2 | Lumens | 2,390 | 3,001 | 3,915 | 4,901 | 5,793 | 6,592 | 2,555 | 3,208 | 4,185 | 5,239 | 6,193 | 7,047 |
| 12 | BUG Rating | B1-U0-G1 | B1-U0-G1 | B1-U0-G1 | B1-U0-G1 | B1-U0-G2 | B1-U0-G2 | B1-U1-G1 | B1-U1-G1 | B1-U1-G1 | B1-U1-G1 | B1-U1-G2 | B1-U1-G2 |
| T 2 | Lumens | 2,440 | 3,063 | 3,996 | 5,001 | 5,912 | 6,728 | 2,561 | 3,216 | 4,195 | 5,251 | 6,207 | 7,063 |
| Т3 | BUG Rating | B1-U0-G1 | B1-U0-G1 | B1-U0-G1 | B1-U0-G1 | B1-U0-G2 | B1-U0-G2 | B1-U1-G1 | B1-U1-G1 | B1-U1-G1 | B1-U1-G1 | B1-U1-G2 | B1-U1-G2 |
| | Lumens | 2,414 | 3,031 | 3,955 | 4,950 | 5,851 | 6,658 | 2,589 | 3,250 | 4,240 | 5,308 | 6,274 | 7,139 |
| T4FT | BUG Rating | B1-U0-G1 | B1-U0-G1 | B1-U0-G1 | B1-U0-G2 | B1-U0-G2 | B1-U0-G2 | B1-U1-G1 | B1-U1-G1 | B1-U1-G1 | B1-U1-G2 | B1-U1-G2 | B1-U1-G2 |
| T4W | Lumens | 2,441 | 3,065 | 3,998 | 5,004 | 5,916 | 6,732 | 2,557 | 3,211 | 4,189 | 5,244 | 6,198 | 7,053 |
| 1400 | BUG Rating | B1-U0-G1 | B1-U0-G1 | B1-U0-G1 | B1-U0-G2 | B1-U0-G2 | B1-U0-G2 | B1-U1-G1 | B1-U1-G1 | B1-U1-G1 | B1-U1-G2 | B1-U1-G2 | B1-U1-G2 |
| SL2 | Lumens | 2,309 | 2,899 | 3,782 | 4,734 | 5,596 | 6,368 | 2,469 | 3,100 | 4,044 | 5,062 | 5,983 | 6,809 |
| 312 | BUG Rating | B1-U0-G1 | B1-U0-G1 | B1-U0-G1 | B1-U0-G2 | B1-U0-G2 | B1-U0-G2 | B1-U1-G1 | B1-U1-G1 | B1-U1-G1 | B1-U1-G1 | B1-U1-G2 | B1-U1-G2 |
| SL3 | Lumens | 2,271 | 2,851 | 3,719 | 4,656 | 5,503 | 6,262 | 2,419 | 3,038 | 3,963 | 4,961 | 5,864 | 6,673 |
| 313 | BUG Rating | B0-U0-G1 | B1-U0-G1 | B1-U0-G1 | B1-U0-G2 | B1-U0-G2 | B1-U0-G2 | B0-U1-G1 | B1-U1-G1 | B1-U1-G1 | B1-U1-G1 | B1-U1-G2 | B1-U1-G2 |
| SL4 | Lumens | 2,158 | 2,710 | 3,535 | 4,425 | 5,230 | 5,951 | 2,286 | 2,870 | 3,744 | 4,686 | 5,539 | 6,303 |
| 314 | BUG Rating | B0-U0-G1 | B0-U0-G1 | B1-U0-G1 | B1-U0-G2 | B1-U0-G2 | B1-U0-G2 | B0-U1-G1 | B0-U1-G1 | B1-U1-G1 | B1-U1-G2 | B1-U1-G2 | B1-U1-G2 |
| SLL/SLR | Lumens | 2,036 | 2,555 | 3,334 | 4,174 | 4,934 | 5,614 | 2,204 | 2,767 | 3,610 | 4,519 | 5,341 | 6,078 |
| SLL/SLK | BUG Rating | B0-U0-G1 | B1-U0-G1 | B1-U0-G1 | B1-U0-G2 | B1-U0-G2 | B1-U0-G2 | B1-U1-G1 | B1-U1-G1 | B1-U1-G2 | B1-U1-G2 | B1-U1-G2 | B1-U1-G2 |
| RW | Lumens | 2,435 | 3,057 | 3,987 | 4,992 | 5,900 | 6,715 | 2,521 | 3,166 | 4,130 | 5,170 | 6,111 | 6,954 |
| n VV | BUG Rating | B1-U0-G0 | B2-U0-G0 | B2-U0-G1 | B2-U0-G1 | B2-U0-G1 | B3-U0-G1 | B1-U1-G1 | B2-U1-G1 | B2-U1-G1 | B2-U1-G1 | B2-U1-G1 | B3-U1-G1 |

LUMEN MAINTENANCE


| С | Current | Ambient Temperature | 25000 Hours* | 50000 Hours* | 60000 Hours* | 100000 Hours* | Theoretical L70 (Hours)* |
|---|---------------|------------------------|-----------------|-----------------|-----------------|------------------|-----------------------------|
| | Up to 1.2A | Up to 40°C | >95% | >91% | >90% | >83% | 20,4000 |


*Data calculated based on TM-21 calculator.


LUMEN MULTIPLIER


| Ambient Temperature | Lumen Multiplier |
|------------------------|---------------------|
| 10°C | 1.02 |
| 15°C | 1.01 |
| 25°C | 1.00 |
| 40°C | 0.99 |

THRUWAY BACK BOX

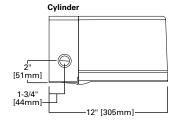

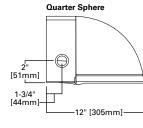

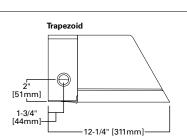

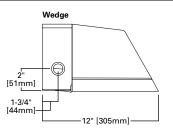



Eaton 1121 Highway 74 South Peachtree City, GA 30269 P: 770-486-4800 www.eaton.com/lighting

Specifications and dimensions subject to change without notice.

W1

ORDERING INFORMATION

Sample Number: ISC-AF-1200-LED-E1-T3-BZ

| Product Family ¹ | Light Engine | Drive Current | Lamp Type | Voltage | Distribution | Color |
|--|----------------------------|---|---|---|---|--|
| ISC=Impact Elite LED Small Cylinder ISS=Impact Elite LED Small Quarter Sphere IST=Impact Elite LED Small Trapezoid ISW=Impact Elite LED Small Wedge | AF =(1) LightSquare | 350 =Drive Current Factory Set to 350mA 450 =Drive Current Factory Set to 450mA 600 =Drive Current Factory Set to 600mA 800 =Drive Current Factory Set to 800mA 1000 =Drive Current Factory Set to 1200mA ² | LED=Solid State Light Emitting Diodes | E1=Electronic (120-277V) 347=347V ² 480=480V ^{2,3} | T2=Type II T3=Type IV Forward Throw T4W=Type IV Forward Throw T4W=Type IV Wide SL2=Type II w/Spill Control SL3=Type II w/Spill Control SL4=Type IV w/Spill Control SL4=90° Spill Light Eliminator Left SLR=90° Spill Light Eliminator Right RW=Rectangular Wide Type I | AP=Grey BZ=Bronze BK=Black DP=Dark Platinum GM=Graphite Metallic WH=White |
| Options (Add as Suffix) | 1 | | | Accessories (O | rder Separately) ¹⁷ | |
| 7027=70 CRI / 2700K CCT ⁴ 7050=70 CRI / 3000K CCT ⁴ 7050=70 CRI / 5000K CCT ⁴ 7060=70 CRI / 5700K CCT ⁴ 9ER7=NEMA 7-PIN Twistlock Photocontrol Receptacle ^{2,5,6} P=Button Type Photocontrol (Available in 120, 208, 240 or 277V. Must Specify Voltage) ^{2,6} HA=50°C High Ambient ⁷ AHD145=After Hours Dim, 5 Hours, 50% ⁸ AHD245=After Hours Dim, 6 Hours, 50% ⁸ AHD255=After Hours Dim, 7 Hours, 50% ⁸ MS/DIM-LXX=Motion Sensor for Dimming Operation ^{9,10,11} LWR-LW=LumaWatt Pro Wireless Sensor, Wide Lens for 8' - 16' Mounting Height ^{6,11,12} LWR-LN=LumaWatt Pro Wireless Sensor, Narrow Lens for 16' - 40' Mounting Height ^{6,11,12} LWR-LN=LumaWatt Pro Wireless Sensor, Narrow Lens for 16' - 40' Mounting Height ^{6,11,12} LWB=Cold Weather Battery Pack with Back Box (Specify 120V or 277V) ¹⁴ LCF=LightSquare Trim Plate Matches Housing Finish HSS=Factory Installed House Side Shield ¹⁵ ULG=Uplight Glow ^{5,6} TR=Tamper Resistant Hardware X=Driver Surce Protection (6kV) Only ¹⁶ | | | | MA1254-XX=Th MA1255-XX=Th MA1256-XX=Th MA1257-XX=Th FSIR-100=Wirel | Circuit Module Replacement ruway Back Box - Impact Elite Tra ruway Back Box - Impact Elite Cy ruway Back Box - Impact Elite Qu ruway Back Box - Impact Elite We ess Configuration Tool for Occup WaveLinx Outdoor Control Modu | inder larter Sphere edge ancy Sensor |

NOTES: 1. Standard 4000K CCT and greater than 70 CRI. 2. Not available with ULG option. 3. Only for use with 480V Wye systems. Per NEC, not for use with ungrounded systems, impedance grounded systems or corner grounded systems (commonly known as Three Phase Three Wire Delta, Three Phase High Leg Delta and Three Phase Corner Grounded Delta systems). 4. Exentended lead times apply. 5. Not available with UNEXX or MS/DIM-LXX

Not available with USS or ISW.
 6. Not available with UNR-XX or MS/DIM-LXX.
 7. Suitable for 50°C provided no options other than motion sensor are included and driver output set to 1.A or less.
 8. Requires the use of P photocontrol or the PER7 photocontrol receptacle with photocontrol accessory. Not available with USG Advise current. See After Hours Dim supplemental guide for additional information.
 9. Specify lens in place of XX. Round to next highest option based on mounting height. Available options are 08, 20 and 40W.
 10. The FSIR-100 configuration tool is required to adjust parameters including high and low modes, sensitivity, time delay, cutoff and more. Consult your lighting representative at Eaton for more information.
 11. Includes integral photocell.
 12. LumaWatt Pro wireless sensors are factory installed and requiring network components in appropriate quantities. See www.eaton.com/lighting for LumaWatt Pro application information.
 13. LED standard integral battery pack is rated for minimum operating temperature 32°F (0°C). Operates downlight for 90-minutes.
 14. LED cold weather integral battery pack is rated for minimum operating temperature 4°F (-20°C). Operates downlight for 90-minutes.
 15. Only for use with SL2, SL3 and SL4 distributions. The LightSquare trim plate is painted black when the HSS option is selected.
 16. Removes additional surge module.

Removes additional surge module.
 Specify color in place of XX.

18. Requires 7-pin NEMA twistlock photocontrol receptacle. The WOLC-7 cannot be used in conjunction with additional sensors or controls.





Filename: ISW-AF-350-LED-E1-SL2-7030.ies
[TEST] P226804 TEST IS SCALED FROM IESNA LM-79-08 TEST
DATA (P35945)
[TESTLAB] INNOVATION CENTER-P3
[ISSUEDATE] 7/28/2017
[MANUFAC] EATON - McGRAW-EDISON (FORMER COOPER
LIGHTING)
[LUMCAT] ISW-AF-350-LED-E1-SL2-7030
[LUMINAIRE] IMPACT ELITE LED WEDGE LUMINAIRE LIGHT
SQUARE WITH ACCULED OPTICS-TYPE II W/SPILL CONTROL
[LAMP] (16) 3000K CCT, 70 CRI LEDs

Maximum Candela = 2609.4 at 67 H 66 V


Classification:

Road Classification: Type II, Short, N.A. (deprecated) Upward Wast Light Ratio: 0.00 Luminaire Efficacy Rating (LER): 106 Indoor Classification: Direct BUG Rating : B1-U1-G1


Polar Candela Curves:

Vertical Plane Through: 1) 67 - 247 Horizontal

Horizontal Cone Through: 2) 66 Vertical

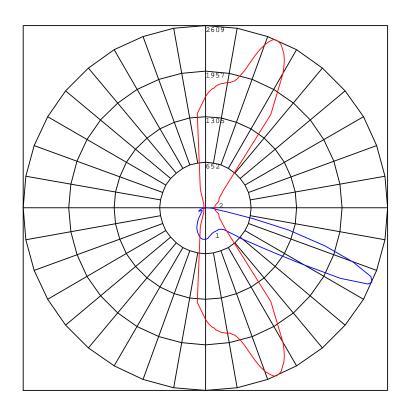

W1

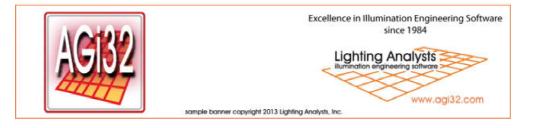

Filename: ISW-AF-350-LED-E1-SL2-7030.ies
[TEST] P226804 TEST IS SCALED FROM IESNA LM-79-08 TEST
DATA (P35945)
[TESTLAB] INNOVATION CENTER-P3
[ISSUEDATE] 7/28/2017
[MANUFAC] EATON - McGRAW-EDISON (FORMER COOPER
LIGHTING)
[LUMCAT] ISW-AF-350-LED-E1-SL2-7030
[LUMINAIRE] IMPACT ELITE LED WEDGE LUMINAIRE LIGHT
SQUARE WITH ACCULED OPTICS-TYPE II W/SPILL CONTROL
[LAMP] (16) 3000K CCT, 70 CRI LEDs


Maximum Candela = 2609.4 at 67 H 66 V

Classification:

Road Classification: Type II, Short, N.A. (deprecated) Upward Waste Light Ratio: 0.00 Luminaire Efficacy Rating (LER): 106 Indoor Classification: Direct BUG Rating : B1-U1-G1

LCS Summary:

| LCS Zone | Lumens | %Lamp | %Lum |
|--------------|----------|-------|-------|
| FL (0-30) | 154.8 | N.A. | 7.2 |
| FM (30-60) | 812.7 | N.A. | 38.0 |
| FH (60-80) | 734.6 | N.A. | 34.4 |
| FVH (80-90) | 39.1 | N.A. | 1.8 |
| BL (0-30) | 104.3 | N.A. | 4.9 |
| BM (30-60) | 131.0 | N.A. | 6.1 |
| BH (60-80) | 151.6 | N.A. | 7.1 |
| BVH (80-90) | 7.5 | N.A. | 0.4 |
| UL (90-100) | 0.8 | N.A. | 0.0 |
| UH (100-180) | 0.0 | N.A. | 0.0 |
| Total | 2136.4 | N.A. | 100.0 |
| BUG Rating | B1-U1-G1 | | |
| | | | |

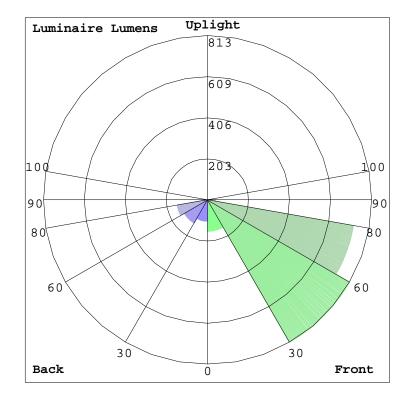

Harbor Exterior - Crosshatch



JOB NAME: Valor on Washington TYPE: W2 NOTES:

DESCRIPTION


The Harbor half cylinder sconce features a clean look for a simple architectural statement. The clean lines of this exterior sconce are perfect for multiple applications including offices, retail buildings, and health care facilities. Choose from a palette of both painted and metal finishes.

FEATURES & BENEFITS

- Opal top and bottom lens protects fixture and provides uniform illumination
- Optional VAN (vanity mount) features solid end caps for a fully enclosed fixture
- Handcrafted in USA

SPECIFICATIONS


- LIGHT SOURCE: White LED light engine
- LUMEN MAINTENANCE: L70 life = 50,000+ hours
- CCT: 3000K, 3500K, or 4000K
- **DRIVER:** Integral power supply included with low wattage LED lamping; remote power supply required with high wattage LED lamping
- **DIMMING:** 0-10V controls standard on LED light engines
- EMERGENCY: Emergency battery remote optional
- DIFFUSER: Formed opal acrylic lens
- MOUNTING: Mounts to standard 4" octagonal junction box
- MODIFICATIONS: Consult factory for all modification requests
- APPROVALS: ETL listed to UL standards (US & Canada) for use in wet locations

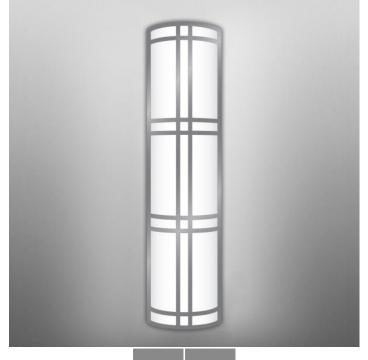

WET EMR





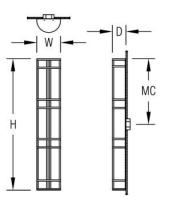

| 36 in | 5 in | 18 in | | |
|--|---------------|-----------------|-----------------------------|--|
| 91.4 cm | 12.7 cm | 45.7 cm | | |
| Mounting Weight Approximate: 25 lb (12 kg) | | | | |
| | 91.4 cm | 91.4 cm 12.7 cm | 91.4 cm 12.7 cm 45.7 cm | |
| | /eight | /eight | Veight | |

CONFIGURATOR -

To configure your spec sheet online, go to <u>www.spilighting.com/AEW9980</u>. Not all options are available in all configurations; consult factory for details.

Required Field *

| Catalog | Light Source: | Primary Finish: | Voltage: | Lamp Options: | Diffuser: | Mounting: |
|---------|---------------|-----------------|----------|---------------|-----------|-----------|
| | | | | | | |
| | | | | | | |
| | A | 1 | В | С | D | E |

A - LIGHT SOURCE *

To ensure color consistency, SPI uses precise bin selection and strict quality processes to maintain a 3-step (MacAdam) SDCM on all white LED lampings. Published LED luminaire wattages are calculated using a typical power supply efficiency of 88%; exact wattages may vary based on application.

L36W | White 36W LED Light Engine | Delivered Lumens: 2,395

L72W¹ | White 72W LED Light Engine Delivered Lumens: 4,790

See last page for finish options

¹ Remote Power Supply Only.

B - VOLTAGE

120-277V | Universal Voltage



C - LAMP OPTIONS

Delivered lumens shown are at 4000K CCT; apply multiplier for delivered lumens at other CCT.

| 🗌 ЗОООК ² ЗОООК ССТ |
|---|
| 🗌 3500К ³ 3500К ССТ |
| 4000К 4000К ССТ |

² Apply .95 multiplier for delivered lumens

³ Apply .97 multiplier for delivered lumens

D - **DIFFUSER**





E - MOUNTING

Vanity mount features solid end caps.

VAN01⁴ | Vanity Vertical Mount
VAN02⁴ | Vanity Horizontal Mount

⁴ Solid end caps standard.



Available Finishes

Not all finishes are available in all configurations; consult factory for details.

Brushed Aluminum

| BAL | |
|------------------|--|
| Brushed Aluminum | |
| | |

Paint Colors

| PT01 | PT02 | PT03 | PT04 | PT05 |
|---------------------------|------------------------|------------------------|---------------------------|----------------------|
| Super White | White | Morning Light | Warm White | Putty |
| PT06 | PT07 | PT08 | PT09 | PT10 |
| Warm Beige | Light Taupe | Medium Taupe | Medium Grey | Dark Grey |
| PT11 | PT12 | PT13 | PT14 | PT15 |
| Black | Dark Chocolate | Warm Grey | Light Grey | Sage |
| PT16 | PT17 | PT18 | PT19 | PT20 |
| Spruce | Red | Deep Red | Blue | Dark Green |
| PT21 | PT22 | PT27 | PT28 | PT29 |
| Pearl White (Metallic) | Platinum (Metallic) | Deep Copper (Metallic) | Dark Stainless (Metallic) | Red Brass (Metallic) |
| PT31 | PT32 | PT33 | PT40 | PT41 |
| Medium Bronze (Metallic) | Dark Bronze (Metallic) | Dark Blue | Yellow | Orange |
| PT42 | PT43 | PT44 | PT45 | PT46 |
| Sky Blue | Teal | Green | Purple | Aluminum (Metallic) |
| PT47 | PT48 | PT49 | PT51 | |
| Deep Red Brass (Metallic) | Brass (Metallic) | Bronze (Metallic) | Matte White | |





Filename: W4_SPI_Harbor Exterior - Crosshatch-36in-column-ws-led-low.ies
[TEST] *PRORATED* ITL79561 4000K Prorated for your
convenience by SPI.
[TESTLAB] INDEPENDENT TESTING LABORATORIES, INC.
[ISSUEDATE] 10/30/13
[MANUFAC] SPI LIGHTING, INC.
[LUMCAT] SPI LIGHTING INC OPTICAL #5303
[LUMINAIRE] SPI LIGHTING 14.5" Column WS LED.
FABRICATED WHITE PAINTED METAL MOUNTING
PLATE/REFLECTOR, FLAT SPECULAR METAL CIRCUIT BOARD MOUNTING PLATE, 2 WHITE CIRCUIT BOARDS EACH W
[LAMP] ONE HUNDRED FORTY-FOUR WHITE LIGHT EMITTING
DIODES (LEDS), AIMED AT THE HORIZON.

Maximum Candela = 517.670984208584 at 0 H 92.5 V


Classification:

Road Classification: N.A., N.A., N.A. (deprecated) Upward Wast Light Ratio: 0.51 Luminaire Efficacy Rating (LER): 67 Indoor Classification: General Diffuse BUG Rating : B0-U4-G2


Polar Candela Curves:

Vertical Plane Through: 1) 0 - 180 Horizontal

Horizontal Cone Through: 2) 92.5 Vertical

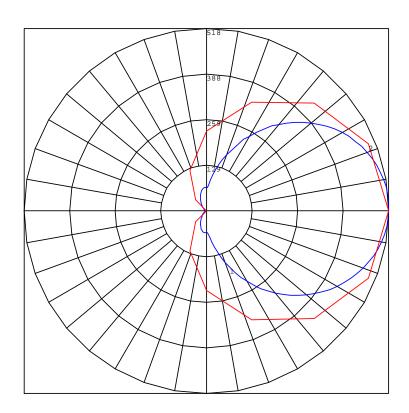

W2

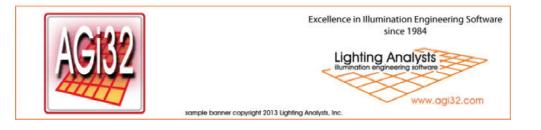


Filename: W4_SPI_Harbor Exterior - Crosshatch-36in-column-ws-led-low.ies
[TEST] *PRORATED* ITL79561 4000K Prorated for your
convenience by SPI.
[TESTLAB] INDEPENDENT TESTING LABORATORIES, INC.
[ISSUEDATE] 10/30/13
[MANUFAC] SPI LIGHTING, INC.
[LUMCAT] SPI LIGHTING INC OPTICAL #5303
[LUMINAIRE] SPI LIGHTING 14.5" Column WS LED.
FABRICATED WHITE PAINTED METAL MOUNTING
PLATE/REFLECTOR, FLAT SPECULAR METAL CIRCUIT BOARD MOUNTING PLATE, 2 WHITE CIRCUIT BOARDS EACH W
[LAMP] ONE HUNDRED FORTY-FOUR WHITE LIGHT EMITTING
DIODES (LEDS), AIMED AT THE HORIZON.

Maximum Candela = 517.670984208584 at 0 H 92.5 V

Classification:

Road Classification: N.A., N.A., N.A. (deprecated) Upward Waste Light Ratio: 0.51 Luminaire Efficacy Rating (LER): 67 Indoor Classification: General Diffuse BUG Rating : B0-U4-G2

LCS Summary:

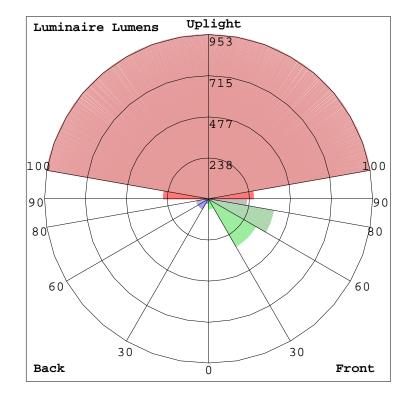

AGi32/Photometric Report Generator - Copyright 1999-2019 by Lighting Analysts, Inc. Calculations based on published IES Methods and recommendations, values rounded for display purposes. Results derived from content of manufacturers photometric file.



SPECIFICATIONS

| Date: | | Approved: |
|----------|---------------------|-----------|
| Туре: | W3 | |
| Fixture: | Facade "Wall Wash" | |
| Project: | Valor on Washington | |

FCC400 Series Cylinders are the most versatile high output exterior cylinders in the market. These Cylinders are designed with outdoor applications in mind. Dry, damp or wet conditions and developed with the highest variety of mounting capabilities, power and output levels, optical distributions, and many featured options.

| PHYSICAL | |
|----------------------|---|
| beam spread | 10° 15° 25° 35° 40° 60° 72° 90° |
| diameter/height | diameter: 4.5" height: 9.92" 13.92" 21.86" |
| weight | 8 lb |
| housing | heavy-walled, extruded aluminum housing with die-cast lens ring and cap with stainless steel hardware |
| lens | IK05 impact compliant, clear anti-glare tempered glass |
| mounting | mounts directly to standard recessed junction box additional holes allow unit to be attached directly to mounting surface |
| ingress protection | continuous silicone gasket to seal out contaminants, IP65 rated for dry, damp or wet locations |
| vibration resistance | compliant with 1G ANSI C136.31, Seismic rated AC-156 |
| finish | 7-stage chemical stage pre-treatment process that includes iron phosphate, to prepare the substrate for a UV stable, super durable standard polyester powder coat |

| PERFORMANCE | |
|-------------------|--|
| color temperature | 2700K 3000K 3500K 4000K 5700K |
| delivered lumens | 3000 Lm max - Selectable in 500 Lm increments |
| lifetime | > 70,000 hours / L70 or better |
| color consistency | 2-step MacAdam Ellipse 83 CRI standard optional 93 and 97 CRI |
| temperature | operating: -4°F to 104°F (-20°C to 40°C) start up: -4°F to 104°F (-20°C to 40°C) storage: -40°F to 176°F (-40°C to 80°C) |
| warranty | 5 year limited warranty (refer to website for details) |

| NON-LED | |
|---------|--|
| CFL | 13Q, 18T, 26T socket: PL: four pin plug-in type compact fluorescent lamp holder (lamp by others) |
| ballast | fluorescent electronic, UL listed ballast standard |
| HID | 20W MH G12, 30W MH G12 socket: G12 base porcelain socket (lamp by others) |
| ballast | electronic ballast standard: ballast has a manufacturer issued 5 year warranty |

| ELECTRICAL | |
|-------------------|--|
| input voltage | Universal 120–277V AC standard 347V optional |
| power supply | integral Class II, electronic high-power factor > 94% EldoLED & Lutron optional |
| certification | CEC Title 24 - JA8 Compliant |
| standards | ETL / cETL or CE, tested to UL 1598 and UL 8750 standards / UL-Class I / IES LM-79 / LM-80 / FCC Part 15 |
| power consumption | up to 35W max @ 120V |
| dimming interface | standard: LED dimming: 0-10V, 1% |
| dimming interface | optional: ELV TRIAC dim to off DMX DALI |

Expanded Disclaimer: Due to continuous development and improvements, specifications are subject to change without notice. FC Lighting and Solid State Luminaires reserves the right to change lab test details or specifications without notice. Product use certifies agreement to FC Lighting terms and conditions. FCC Series Cylinder Lights are engineered and produced in our Illinois manufacturing facility.



2

RP Rev. 12/05/2018

W3

FCC400 Series

ORDERING INFORMATION

| FCC400 | | | | | | | | | | | | | | | | | | | |
|---------------|--------|------|---------|-------|-----------|------|---------|--------------|--------|----------|-------|-----------------------------|------------|--------|------|--------------|------------------|-------------------|-------|
| model | height | mour | nting | volta | ge | sour | ce C | CT | CRI | | lume | en output | | | fini | sh | optics | | |
| FCC400 Ø4.25" | 10 | SF | Surface | UNV | 120V-277V | LED | 27K | 2700K | CR83 | 83 CRI | | Down | Up | | BK | black | Down | | Up |
| | 12 | WM | Wall | 347V | 347V | | 3K | 3000K | CR93 S | Standard | 5L | 500 Lm | (5W) | 5L | ΒZ | bronze | D 10 | 10° Narrow Spot | U 10 |
| | 14 | PD | Pendant | | | | 35K | 3500K | CR93 | 93 CRI | 10L | 1000 Lm | (10W) | 10L | WH | l white | D 10 | ° – 1500 Lm max – | U 10° |
| | 16 | СМ | Cord | | | | No 97 | r CRI on 35K | CR97 | 97 CRI | 15L | 1500 Lm | (15W) | 15L | SL | silver | D 15 | 15° Spot | U 15 |
| | 18 | SM | Slope | | | | 4K | 4000K | | | 20L | 2000 Lm | (21W) | 20L | CC | custom color | D 15 | ° – 2500 Lm max – | U 15° |
| | 20 | | | | | | 57K | 5700K | | | 25L | 2500 Lm | (27W) | 25L | | | D 25 | 25° Mid-Spot | U 25 |
| | | | | | | | No 97 | r CRI on 57K | | | Total | Total fixture lumens cannot | | | | D 30 | 30° Narrow Flood | U 30 | |
| | | | | | | | R | Red | | | | de 3000 Lr | | | | • | D 50 | 50° Flood | U 50 |
| | | | | | | | G | Green | | | | er required ut selectio | | | | | D 90 | 90° Flat | U 90 |
| | | | | | | | В | Blue | | | only | available in | n one dire | ction. | | | | | |
| | | | | | | Cont | act the | Factory for | | | 30L | 3000 Lm | (34W) | 30L | | | | | |
| | | | | | | | | urce options | | | 83 C | RI only on | 30L | | | | | | |

Standard Driver Included: LED dimming: 0-10V, 1%

Driver Options (all drivers are 120V-277V unless otherwise specified)

MATCH SELECTION FROM CCT COLUMN ABOVE TO ONE CHOICE OF DRIVER FROM TABLE BELOW - review Driver Table on Pg 10 for driver specifications

| LUTRON DRIVER OPTIONS | eldoLED DRIVER OPTIONS | STANDARD CCT (347V) DRIVER OPTIONS |
|--|--|--|
| L2 Lutron 1%, 2-Wire, Forward Phase | E1 eldoLED 0-10V, Dim-to-Off | A3 347V 0-10V, Dim to 10% |
| L5 Lutron Ecosystem, 0.1%, Soft-on, Dim-to-Off | E2 eldoLED DALI, Dim-to-Off | |
| | E5 <i>eldoLED</i> 0-10, Dim to 1% | |
| | E6 eldoLED DALI, Dim to 1% | |
| | E7 eldoLED DMX, Dim-to-Off | |
| | | |
| | | |
| | L2 Lutron 1%, 2-Wire, Forward Phase | L2 Lutron 1%, 2-Wire, Forward PhaseE1 eldoLED 0-10V, Dim-to-OffL5 Lutron Ecosystem, 0.1%, Soft-on, Dim-to-OffE2 eldoLED DALI, Dim-to-OffE5 eldoLED 0-10, Dim to 1%E6 eldoLED DALI, Dim to 1% |

Options (choose one per fixture) Soft Field (solite)

BBU Battery Backup (Remote)

- **CPLX** Custom Length Pendant (X=inches)
- CBLX Custom Length Cable (X=inches)
- OPC Opal Polycarbonate Lens
- Cut-Off Visor CV

SF







W3

| MOUNTING OPTIONS | | | |
|---|---------------|---|---------|
| SURFACE MOUNT | PENDANT MOUNT | WALL MOUNT | |
| SF - surface mount 4.25" W | | WM - wall mount | 2.05" D |
| add to fixture height 1.4" | | total fixture depth | 8.36" D |
| 1.4 in 9.92 in 9.92 in 9.92 in 0.05 bolt spacing 0.05 bolt spacing 0.05 bolt spacing 0.05 bolt spacing | | 6.52 9.92 in Ø 4.5 ir Ø 4.5 ir | 5.52 in |





Filename: FCC410W-D.IES
[TEST] TypeC Intensity
[TESTLAB] FC/SSL Lab
[MANUFAC] FC/SSL Lighting
[LUMINAIRE] 4†Round Wall, Pendant or Surface Mounted
Die-Cast Aluminum Cylinder.
[LAMP] LED

Maximum Candela = 2038.4 at 0 H 5 V


Classification:

Road Classification: Type V, Very Short, N.A. (deprecated) Luminaire Efficacy Rating (LER): 127 Indoor Classification: Direct BUG Rating : B0-U4-G2

Polar Candela Curves:

Vertical Plane Through: 1) 0 - 180 Horizontal

Horizontal Cone Through: 2) 5 Vertical

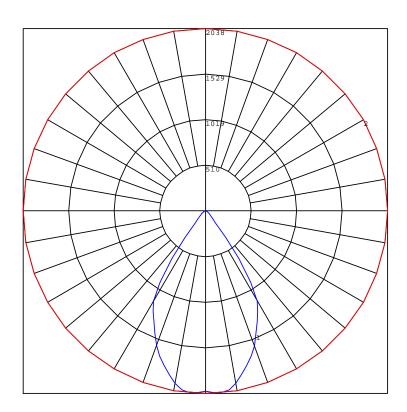

| Calculation Summary | | | | | | | |
|---------------------|-------------|-------|------|-----|-----|---------|---------|
| Label | CalcType | Units | Avg | Max | Min | Avg/Min | Max/Min |
| NORTH WALK | Illuminance | Fc | 1.30 | 7.1 | 0.0 | N.A. | N.A. |
| PARKING | Illuminance | Fc | 1.35 | 5.0 | 0.3 | 4.50 | 16.67 |
| PLAYGROUND | Illuminance | Fc | 0.62 | 1.7 | 0.0 | N.A. | N.A. |
| SOUTH TERRACE | Illuminance | FC | 2.34 | 8.0 | 0.0 | N.A. | N.A. |
| TRESPASS | Illuminance | Fc | 0.05 | 0.2 | 0.0 | N.A. | N.A. |

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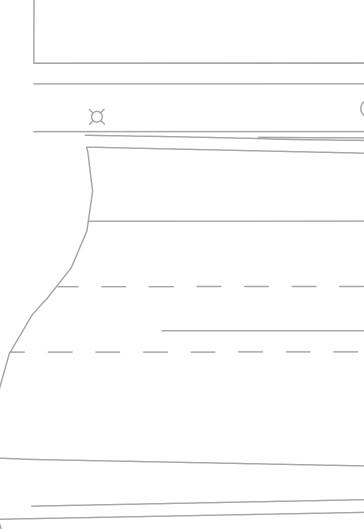
6

| Luminaire ScheduleSymbolQtyTag7D11PL11PL24W14W28W3 | Label ML5606830-692H GLEON-AF-01-LED-E1-5MQ-7030-6 GLEON-AF-02-LED-E1-SL3-7030-H ISW-AF-350-LED-E1-SL2-7030 SPI Harbor Exterior FCC410W-D | Description 6 INCH RECESSED DOWNLIGHT PEDESTRIAN POLE AREA LIGHT WALL MOUNTED AREA LIGHT DECORATIVE WALL SCONCE EXTERIOR DOWNIGHT CYLINDER | Lum. Watts 9 34 113 20.09 35.8 15 | 4173 0. 9211 0. 2136 0. 2394 0. | F 900 900 900 900 450 800 |
|--|---|--|--|---|--|
| | | | 6" \$\$.10.10.10.40.10.1 50.20.20.20.20.2 8" 0.30.30.30.30.30.4 5.50.50.50.50.50.50.50.50 5.60.60.60.60.60.70 5.60.60.60.60.60.70 5.60.70.91.01.11.11.21.4 5.70.81.01.11.21.4 5.70.81.01.11.21.4 5.70.70.70.70.70.70 6.60.60.60.60.60 6.50.50.50.50.50 5.60.60.60.60.60 6.70.70.70.70.70.70 7.60.60.60.60.60 6.50.50.50.50.50 5.60.60.60.60 6.70.70.70.70.70 7.60.60.60.60.60 6.70.70.70.70.70 7.60.60.60.60.60 6.70.70.70.70.70 7.60.60.60.60.60 6.70.70.70.70.70 7.60.60.60.60 6.70.70.70.70.70 7.71.71.21.41.51 8.71.11.62.02.42 8.71.11.62.02.42 8.71.11.62.02.42 8.71.11.62.02.42 8.71.11.62.02.42 8.71.11.62.02.42 8.71.11.62.02.42 8.71.11.62.02.42 8.71.11.62.02.42 9.71.11.62.02.42 9.71.11.62.02.42 9.71.11.62.02.42 9.71.11.62.02.42 9.71.11.62.02.42 9.71.11.62.02.42 9.71.11.62.02.42 9.71.11.62.02.44 9.71.11.62.02.44 9.71.11.62.02.44 9.71.11.62.02.44 9.71.11.62.02.44 9.71.11.62.02.44 9.71.11.62.02.44 9.71.11.62.02.44 9.71.11.62.02.44 9.71.11.62.02.44 9.71.11.62.02.44 9.71.11.62.02.44 9.71.11.62.02.44 9.71.11.62.02.44 9.71.11.62.02.44 9.71.11.62.02.44 9.71.11.62.02.44 9.71.11.62.04.44 9.71.11.64.04 9.71.11.64.04 9.71.11.64.04 9.71.11.64.04 9.71.11.64.04 9.71.11.64.04 9.71.11.64.04 <td>$\begin{array}{c} 0.40.40.40.40.40.40.40.40.20.30.20.30.20.30.20.40.40.40.40.40.40.40.40.20.20.50.50.50.50.50.50.50.50.60.80.70.20.20.20.20.20.20.20.20.20.20.20.20.20$</td> <td>.10.1 .10.1 .10.1 .10.1 .10.1 .10.1 .10.1 .10.1 .10.1 .10.1 .10.1 .10.1 .10.1 .10.1 .10.1 .10.1 .10.1 .10.1 .10.2 .1</td> | $\begin{array}{c} 0.40.40.40.40.40.40.40.40.20.30.20.30.20.30.20.40.40.40.40.40.40.40.40.20.20.50.50.50.50.50.50.50.50.60.80.70.20.20.20.20.20.20.20.20.20.20.20.20.20$ | .10.1 .10.1 .10.1 .10.1 .10.1 .10.1 .10.1 .10.1 .10.1 .10.1 .10.1 .10.1 .10.1 .10.1 .10.1 .10.1 .10.1 .10.1 .10.2 .1 |
| | | | 1.21 1.11 1.00 0.90 0.80 | 0.70.70.70.70.70.70.70.60.40.81 | D1 W3 V1.5338 3.74, v1.92, 053 34 15, 56 v1.92, 053 34 15, 56 v1.92, 053 34 15, 56 v1.92, 053 34 15, 56 v1.92, 052 32, 054 3 o55 55, 052, 052, 05, 01, 61, 71, 61, 6 v1.92, 12, 22, 32, 054 3 o55 55, 052, 051, 051, 051, 051, 051, 051, 051, 051 |


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1 SITE PLAN - LIGHTING CALCULATIONS

2

SCALE: 1/16" = 1'-0"

3

GORMAN & COMPANY **REAL ESTATE DEVELOPMENT &** MANAGEMENT 200 N. MAIN STREET OREGON, WI 53575 Seal E Consultant BEAR VALLEY ENGINEERING, INC. COMMERCIAL BUILDING SPECIALISTS 1250 FEMRITE DRIVE, SUITE 200 MADISON, WI 53716 D \bigcirc DZ ____ Ζ Ζ 0 S S 3 \mathbf{O} **U** SCHEMATIC DESIGN 19-XXX-00 Project No. Plot Date: 2019-05-07 BVE Drawn by: Issue Description Date 2019.05.07 LOCAL PERMIT PACKAGE Sheet Title SITE PLAN - LIGHTING CALCULATION Sheet No. ES101-CALC
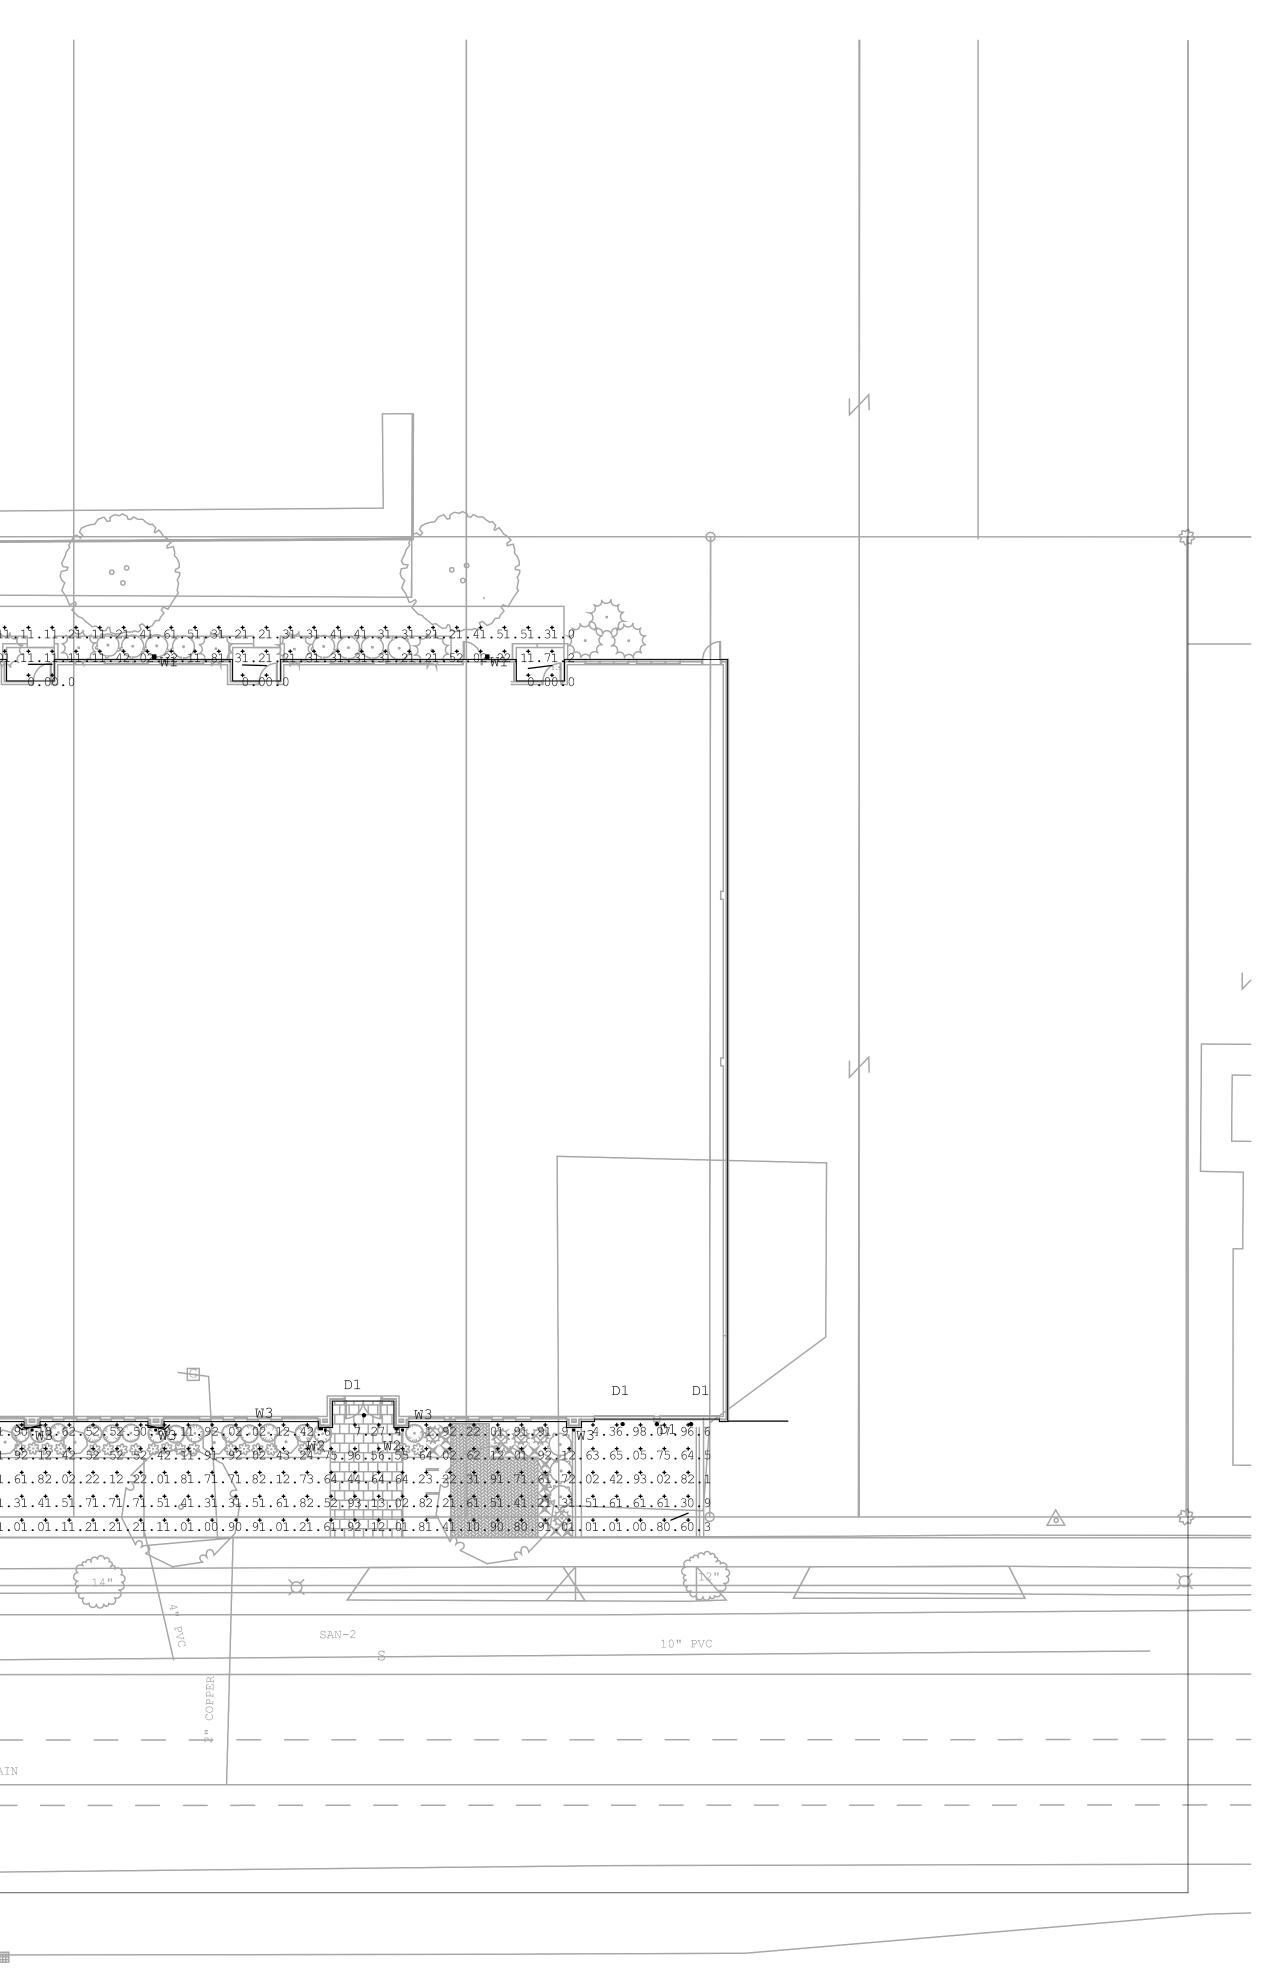
| Calculation Summary | | | | | | | |
|---------------------|-------------|-------|------|-----|-----|---------|---------|
| Label | CalcType | Units | Avg | Max | Min | Avg/Min | Max/Min |
| NORTH WALK | Illuminance | Fc | 1.30 | 7.1 | 0.0 | N.A. | N.A. |
| PARKING | Illuminance | Fc | 1.35 | 5.0 | 0.3 | 4.50 | 16.67 |
| PLAYGROUND | Illuminance | FC | 0.62 | 1.7 | 0.0 | N.A. | N.A. |
| SOUTH TERRACE | Illuminance | FC | 2.34 | 8.0 | 0.0 | N.A. | N.A. |
| TRESPASS | Illuminance | Fc | 0.05 | 0.2 | 0.0 | N.A. | N.A. |

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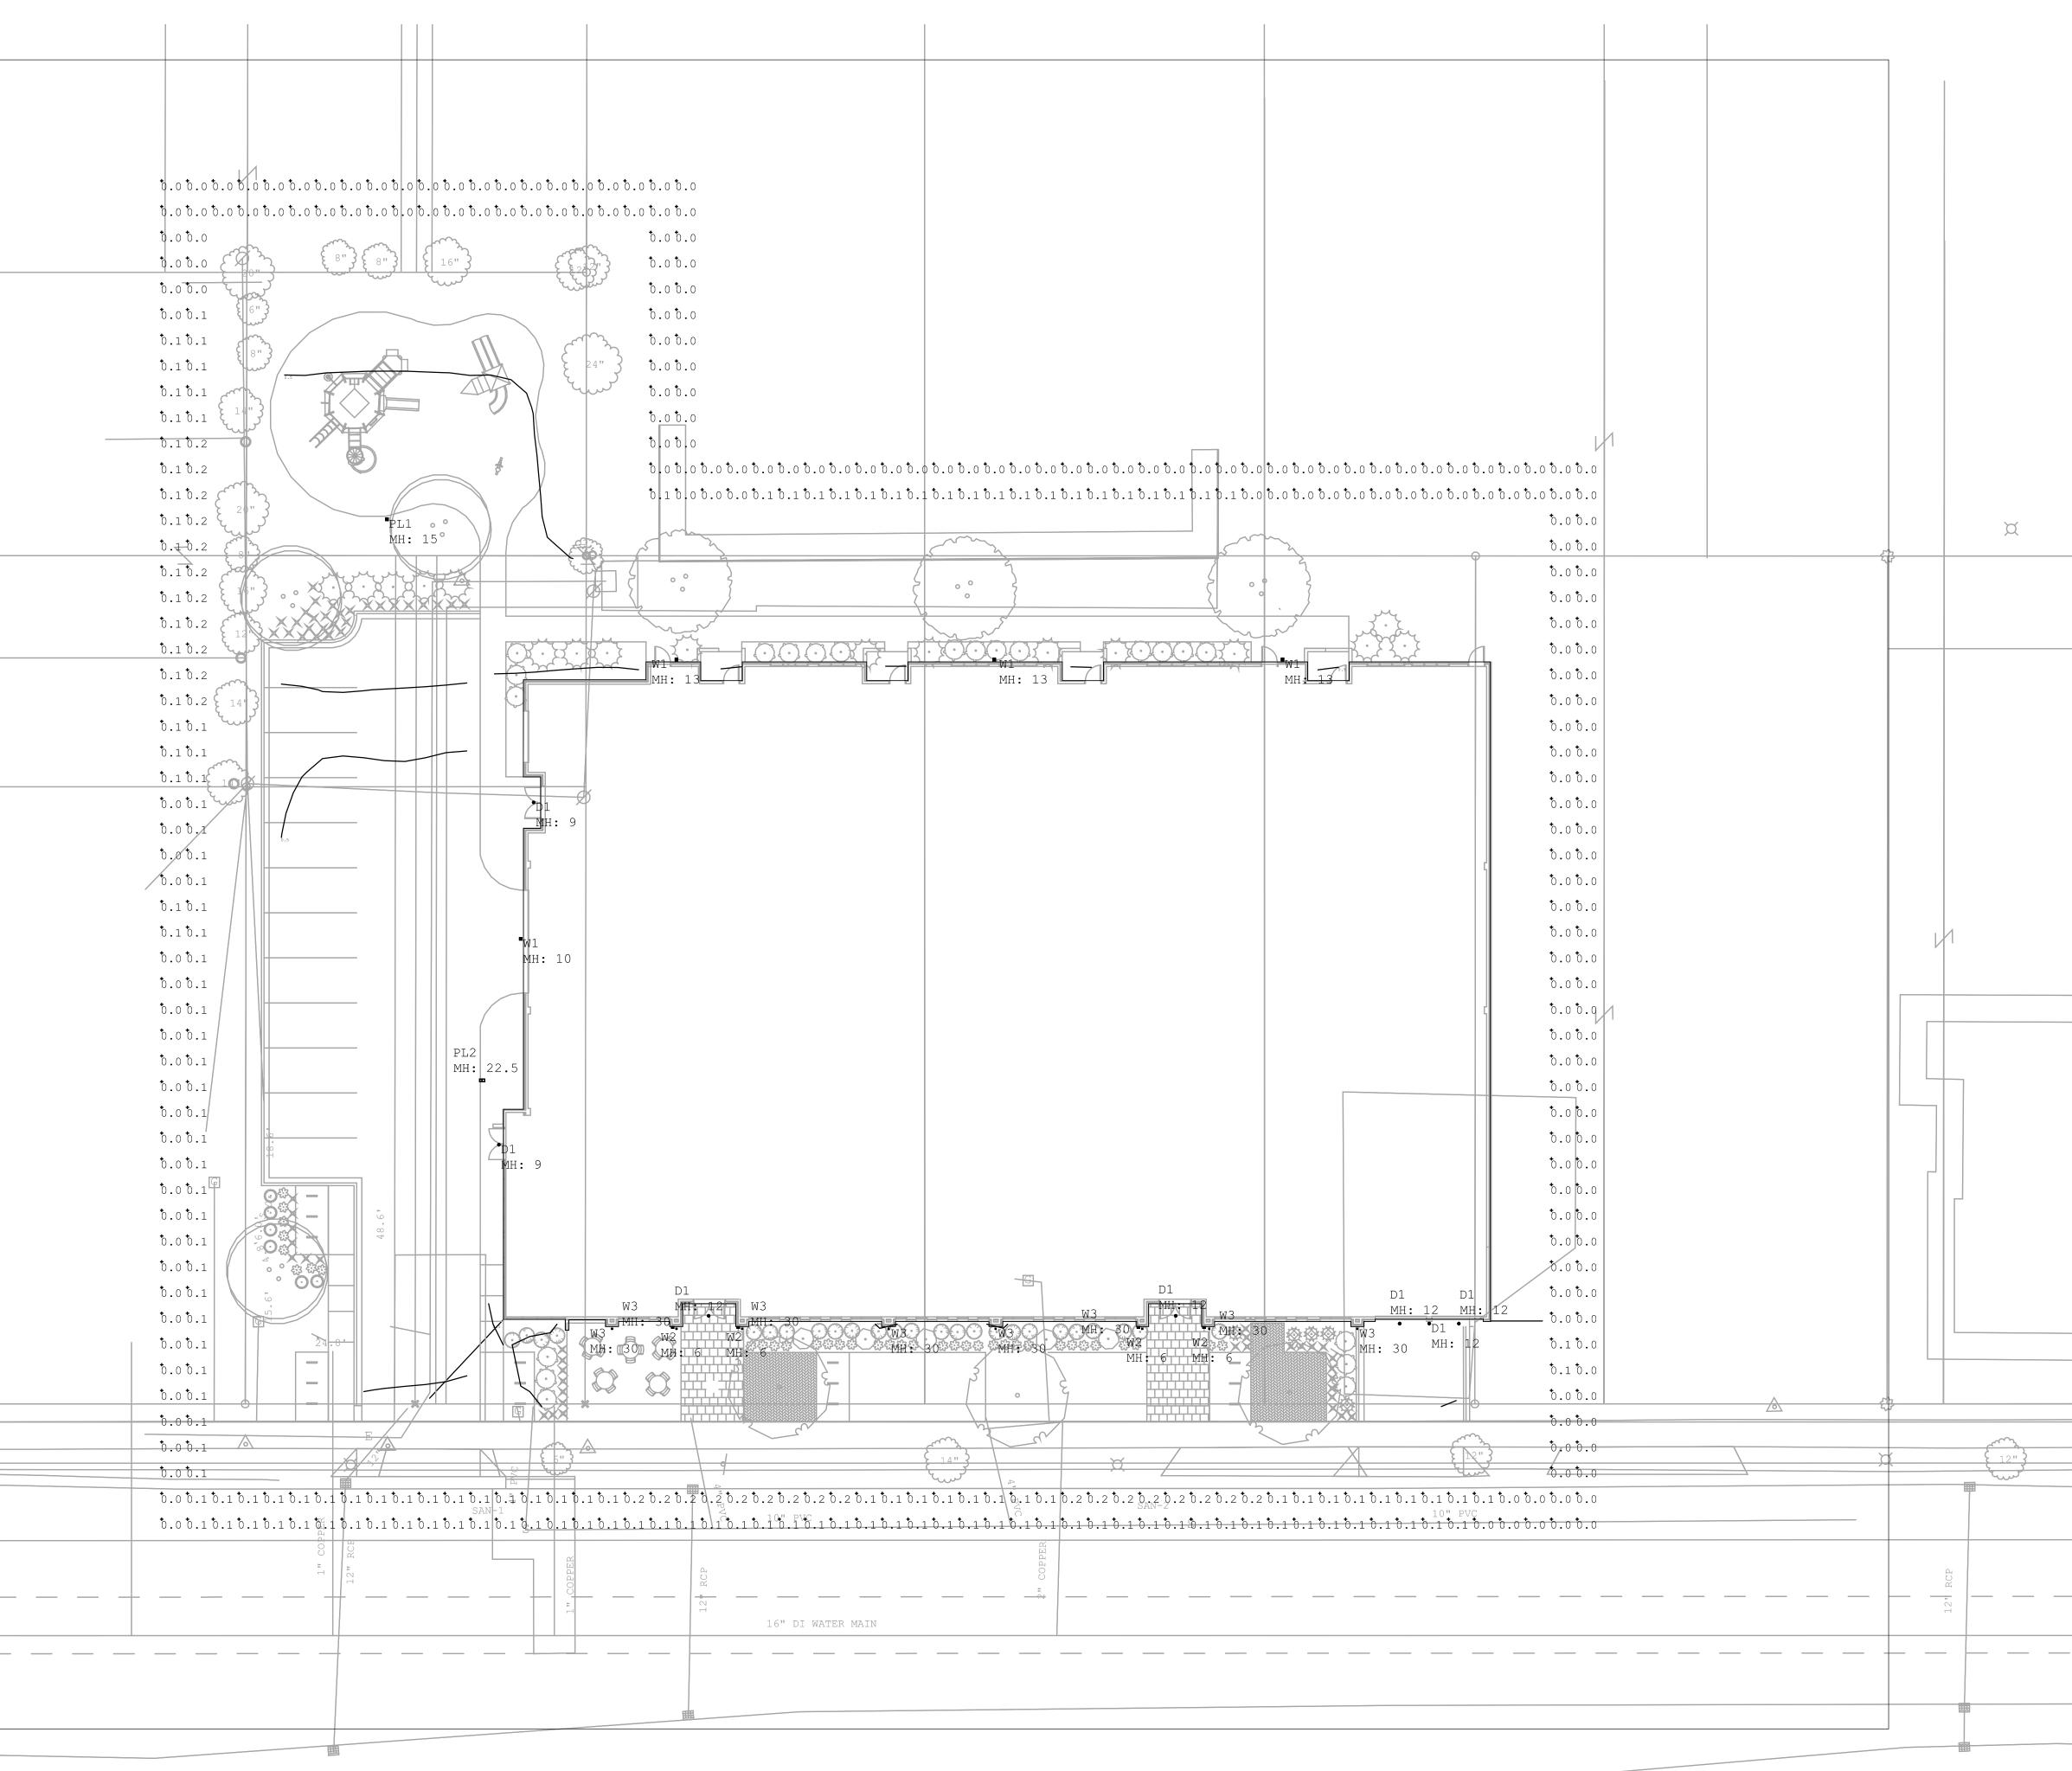
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| Luminaire | Schedule | ý | | | | | |
|------------|----------|-----|-------------------------------|----------------------------|------------|-------------|-------|
| Symbol | Qty | Tag | Label | Description | Lum. Watts | Lum. Lumens | LLF |
| \bigcirc | 7 | D1 | ML5606830-692H | 6 INCH RECESSED DOWNLIGHT | 9 | 655 | 0.900 |
| → | 1 | PL1 | GLEON-AF-01-LED-E1-5MQ-7030-6 | PEDESTRIAN POLE | 34 | 4173 | 0.900 |
| → | 1 | PL2 | GLEON-AF-02-LED-E1-SL3-7030-H | AREA LIGHT | 113 | 9211 | 0.900 |
| + | 4 | W1 | ISW-AF-350-LED-E1-SL2-7030 | WALL MOUNTED AREA LIGHT | 20.09 | 2136 | 0.900 |
| → | 4 | W2 | SPI_Harbor Exterior | DECORATIVE WALL SCONCE | 35.8 | 2394 | 0.450 |
| + | 8 | W3 | FCC410W-D | EXTERIOR DOWNIGHT CYLINDER | 15 | 1900 | 0.800 |



1 SITE PLAN - LIGHTING CALCULATIONS - TRESSPASS

