URBAN DESIGN COMMISSION APPLICATION



City of Madison



FOR OFFICE USE ONLY: Paid Receipt # Date received Received by Aldermanic District Zoning District Urban Design District Submittal reviewed by _____ Legistar #

Planning Division Madison Municipal Building, Suite 017 215 Martin Luther King, Jr. Blvd. P.O. Box 2985 Madison, WI 53701-2985 (608) 266-4635 Complete all sections of this application, including the desired meeting date and the action requested. If you need an interpreter, translator, materials in alternate formats or other accommodations to access these forms, please call the phone number above immediately. 1. Project Information Address: 760 Regent Street (Requested) Title: UW Campus Hotel 2. Application Type (check all that apply) and Requested Date UDC meeting date requested May 29, 2019 New development ☐ Alteration to an existing or previously-approved development Informational Initial approval Final approval 3. Project Type ☐ Project in an Urban Design District Signage Project in the Downtown Core District (DC), Urban Comprehensive Design Review (CDR) Mixed-Use District (UMX), or Mixed-Use Center District (MXC) Signage Variance (i.e. modification of signage height, Project in the Suburban Employment Center District (SEC), area, and setback) Campus Institutional District (CI), or Employment Campus Other District (EC) ☐ Please specify Planned Development (PD) General Development Plan (GDP) Specific Implementation Plan (SIP) ☐ Planned Multi-Use Site or Residential Building Complex 4. Applicant, Agent, and Property Owner Information Company Mortenson Dave Merrick Applicant name 17975 Sarah Lane #200 Street address

City/State/Zip Brookfield, WI 53045 Email dave.merrick@mortenson.com Telephone 262-879-2563 Company Kahler Slater Project contact person Glenn Roby 111 W Wisconsin, 3rd Floor City/State/Zip Milwaukee, WI 53203 Street address Email groby@kahlerslater.com 414-290-3770 Telephone Property owner (if not applicant) City/State/Zip _____ Street address

Email

Telephone

Each submittal must include

fourteen (14) 11" x 17" collated

paper copies. Landscape and

Lighting plans (if required)

must be full-sized and legible.

Please refrain from using

plastic covers or spiral binding.

5. Required Submittal Mate	rials
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Application Form

M Letter of Intent

- If the project is within an Urban Design District, a summary of how the development proposal addresses the district criteria is required
- For signage applications, a summary of how the proposed signage is consistent with the applicable CDR or Signage Variance review criteria is required.
- Development plans (Refer to checklist on Page 4 for plan details)

NA D Filing fee

☑ Electronic Submittal*

Both the paper copies and electronic copies <u>must</u> be submitted prior to the application deadline before an application will be scheduled for a UDC meeting. Late materials will not be accepted. A completed application form is required for each UDC appearance.

For projects also requiring Plan Commission approval, applicants must also have submitted an accepted application for Plan Commission consideration prior to obtaining any formal action (initial or final approval) from the UDC. All plans must be legible when reduced.

*Electronic copies of all items submitted in hard copy are required. Individual PDF files of each item submitted should be compiled on a CD or flash drive, or submitted via email to udcapplications@cityofmadison.com. The email must include the project address, project name, and applicant name. Electronic submittals via file hosting services (such as Dropbox.com) are not allowed. Applicants who are unable to provide the materials electronically should contact the Planning Division at (608) 266-4635 for assistance.

6. Applicant Declarations

- 1. Prior to submitting this application, the applicant is required to discuss the proposed project with Urban Design Commission staff. This application was discussed with $\frac{\text{Heather Stouder}}{2/13/2019}$ on $\frac{2}{13}$
- The applicant attests that all required materials are included in this submittal and understands that if any required information is not provided by the application deadline, the application will not be placed on an Urban Design Commission agenda for consideration.

Name of applicant	Dave Merrick	Relationship to property	Owner	
	re of property owner	Dail Wind Date	5/16/2019	

7. Application Filing Fees

Fees are required to be paid with the first application for either initial or final approval of a project, unless the project is part of the combined application process involving the Urban Design Commission in conjunction with Plan Commission and/or Common Council consideration. Make checks payable to City Treasurer. Credit cards may be used for application fees of less than \$1,000.

Please consult the schedule below for the appropriate fee for your request: Urban Design Districts: \$350 (per §35.24(6) MGO).

- ☐ Minor Alteration in the Downtown Core District (DC) or Urban Mixed-Use District (UMX): \$150 (per §33.24(6)(b) MGO)
- ☐ Comprehensive Design Review: \$500 (per §31.041(3)(d)(1)(a) MGO)
- ☐ Minor Alteration to a Comprehensive Sign Plan: \$100 (per §31.041(3)(d)(1)(c) MGO)
- □ All other sign requests to the Urban Design Commission, including, but not limited to: appeals from the decisions of the Zoning Administrator, requests for signage variances (i.e. modifications of signage height, area, and setback), and additional sign code approvals: \$300 (per §31.041(3)(d)(2) MGO)
- A filing fee is not required for the following project applications if part of the combined application process involving both Urban Design Commission and Plan Commission:
- Project in the Downtown Core District (DC), Urban Mixed-Use District (UMX), or Mixed-Use Center District (MXC)
- Project in the Suburban Employment Center District (SEC), Campus Institutional District (CI), or Employment Campus District (EC)
- Planned Development (PD): General Development Plan (GDP) and/or Specific Implementation Plan (SIP)
- Planned Multi-Use Site or Residential Building Complex

URBAN DESIGN COMMISSION APPROVAL PROCESS



Introduction

The City of Madison's Urban Design Commission (UDC) has been created to:

- Encourage and promote high quality in the design of new buildings, developments, remodeling, and additions so as to maintain and improve the established standards of property values within the City.
- Foster civic pride in the beauty and nobler assets of the City, and in all other ways possible assure a functionally efficient and visually attractive City in the future.

Types of Approvals

There are three types of requests considered by the UDC:

- <u>Informational Presentation</u>. Applicants may, at their discretion, request to make an Informational Presentation to the UDC prior to seeking any approvals to obtain early feedback and direction before undertaking detailed design. Applicants should provide details on the context of the site, design concept, site and building plans, and other relevant information to help the UDC understand the proposal and provide feedback. (Does not apply to CDR's or Signage Variance requests)
- <u>Initial Approval</u>. Applicants may, at their discretion, request initial approval of a proposal by presenting preliminary design information. As part of their review, the Commission will provide feedback on the design information that should be addressed at Final Approval stage.
- <u>Final Approval</u>. Applicants may request Final Approval of a proposal by presenting all final project details. Recommendations or concerns expressed by the UDC in the initial approval must be addressed at this time.

Presentations to the Commission

Primarily, the UDC is interested in the appearance and design quality of projects. Emphasis should be given to the site plan, landscape plan, lighting plan, building elevations, exterior building materials, color scheme, and graphics.

When presenting projects to the UDC, applicants must fill out a registration slip provided in the meeting room and present it to the Secretary. Presentations should generally be limited to 5 minutes or as extended by motion by consent of the Commission. The Commission will withhold questions until the end of the presentation.

Applicants are encouraged to consider the use of various graphic presentation material including a locator map, photographs, renderings/model, scale drawings of the proposal in context with adjacent buildings/uses/signs, etc., as may be deemed appropriate to describe the project and its surroundings. Graphics should be mounted on rigid boards so that they may be easily displayed. Applicants/presenters are responsible for all presentation materials, AV equipment and easels.

URBAN DESIGN DEVELOPMENT PLANS CHECKLIST



The items listed below are minimal application requirements for the type of approval indicated. Please note that the UDC and/or staff may require additional information in order to have a complete understanding of the project.

1. Informational Presentation

- Locator Map
- Letter of Intent (If the project is within an Urban Design District, a summary of how.the.destrict.proposal.addresses the district criteria is required)
- Contextual site information, including photographs and layout of adjacent buildings/structures
- X Site Plan
- Two-dimensional (2D) images of proposed buildings or structures.

Providing additional information beyond these minimums may generate a greater level of feedback from the Commission.

Requirements for All Plan Sheets

- 1. Title block
- 2. Sheet number
- 3. North arrow
- 4. Scale, both written and graphic
- 5. Date
- 6. Fully dimensioned plans, scaled at 1"= 40' or larger

** All plans must be legible, including the full-sized landscape and lighting plans (if required)

2. Initial Approval

- ☑ Locator Map
- Letter of Intent (If the project is within a Urban Design District, a summary of <u>how</u> the development proposal addresses the district criteria is required)
- Contextual site information, including photographs and layout of adjacent buildings/ structures
- Site Plan showing location of existing and proposed buildings, walks, drives, bike lanes, bike parking, and existing trees over 18" diameter
- 🛛 Landscape Plan and Plant List (must be legible)
- Building Elevations in both black & white and color for all building sides (include material callouts)
- M PD text and Letter of Intent (if applicable)

Providing additional information beyond these minimums may generate a greater level of feedback from the Commission.

3. Final Approval

All the requirements of the Initial Approval (see above), plus:

- ☑ Grading Plan
- Proposed Signage (if applicable)
- Lighting Plan, including fixture cut sheets and photometrics plan (must be legible)
- Utility/HVAC equipment location and screening details (with a rooftop plan if roof-mounted)
- PD text and Letter of Intent (if applicable)
- Samples of the exterior building materials (presented at the UDC meeting)

4. Comprehensive Design Review (CDR) and Variance Requests (Signage applications only)

A	Locator Map
	Letter of Intent (a summary of <u>how</u> the proposed signage is consistent with the CDR or Signage Variance criteria is required
NA	Contextual site information, including photographs of existing signage both on site and within proximity to the project site
	Site Plan showing the location of existing signage and proposed signage, dimensioned signage setbacks, sidewalks driveways, and right-of-ways
	Proposed signage graphics (fully dimensioned, scaled drawings, including materials and colors, and night view)
	Perspective renderings (emphasis on pedestrian/automobile scale viewsheds)
	Illustration of the proposed signage that meets Ch. 31, MGO compared to what is being requested.
*	Graphic of the proposed signage as it relates to what the Ch. 31, MGO would permit

UW CAMPUS HOTEL



760 REGENT STREET | MADISON, WISCONSIN

CONTENTS

- 01 COVER
- 02 SITE DIAGRAMS
- 06 BIKE PATH ENTRY
- 09 EAST CAMPUS MALL ENTRY
- 11 POCKET PARK
- 16 VEHICLE ENTRY
- 18 MATERIAL PALETTE

ATTACHMENTS

11x17 ARCHITECTURAL DRAWINGS
11x17 CIVIL DRAWINGS
11x17 LANDSCAPE DRAWINGS
11x17 SITE LIGHTING DRAWINGS
8.5x11 SUPPORTING DOCUMENTS
30x42 CIVIL, LANDSCAPE AND SITE LIGHTING DRAWINGS






LOCATION PLAN

CITY OF MADISON UDC | 05-29-2019 | PAGE 02

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VIEW NORTH AT EAST CAMPUS MALL

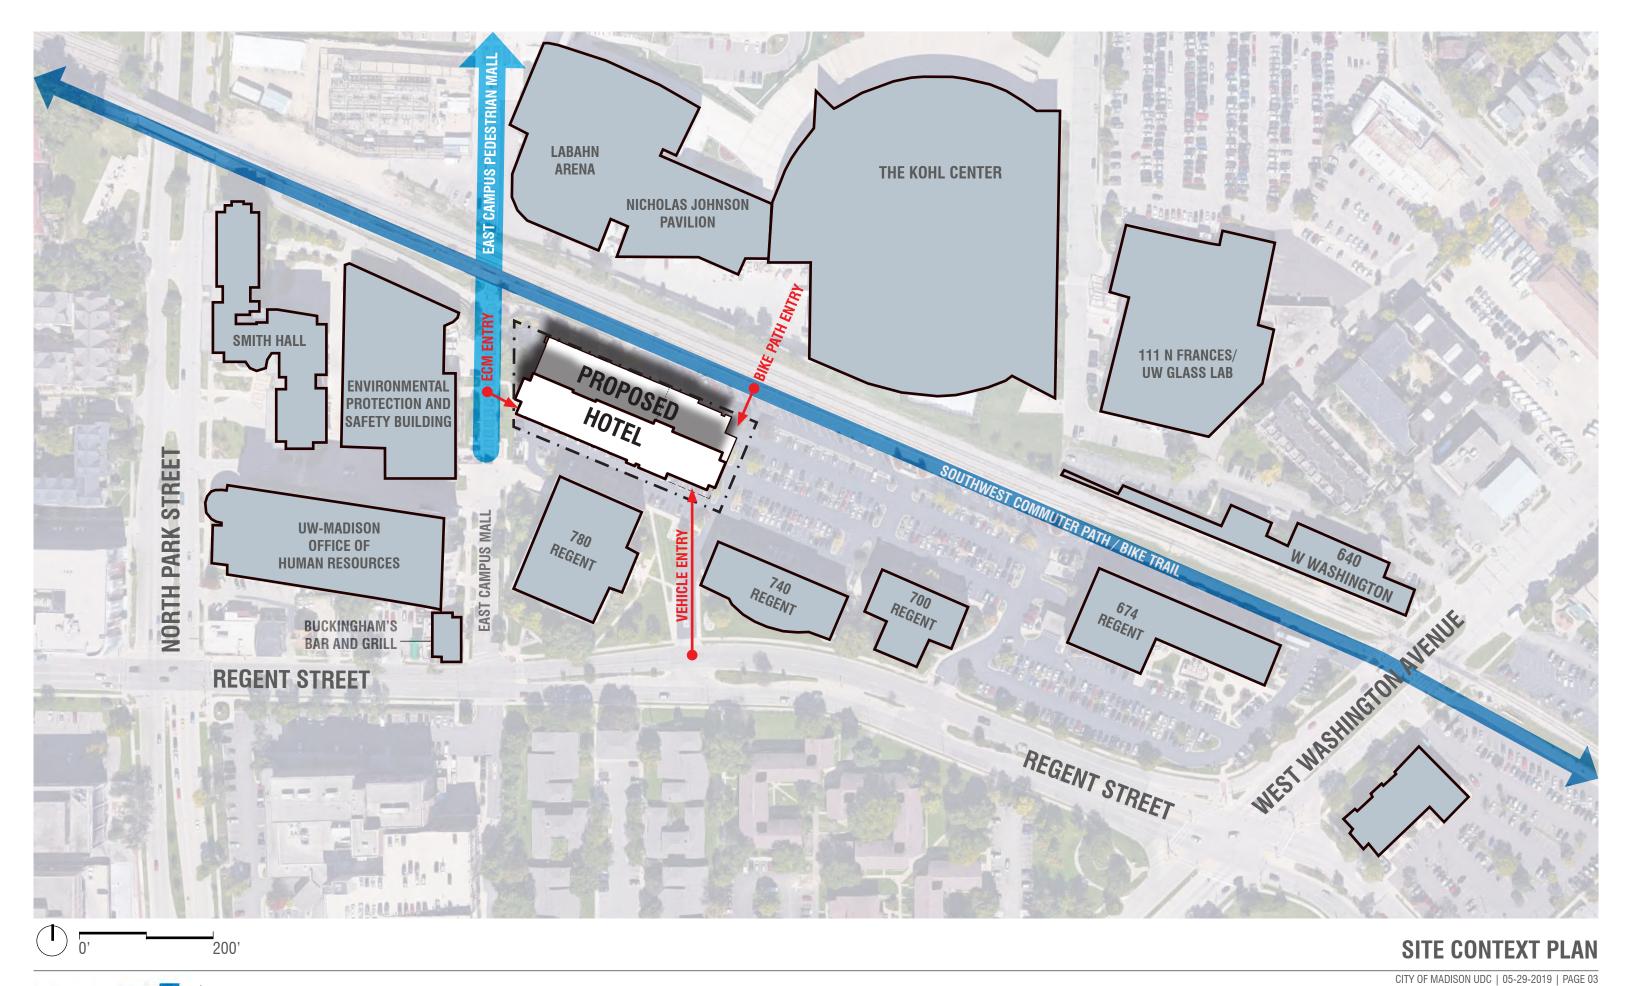

VIEW WEST TO THE DEVELOPMENT



VIEW SOUTH ON EAST CAMPUS MALL AT BIKE TRAIL



VIEW NORTH FROM REGENT STREET



VIEW WEST ON BIKE TRAIL





VIEW WEST FROM KOHL CENTER

SITE & CONTEXT VIEWS






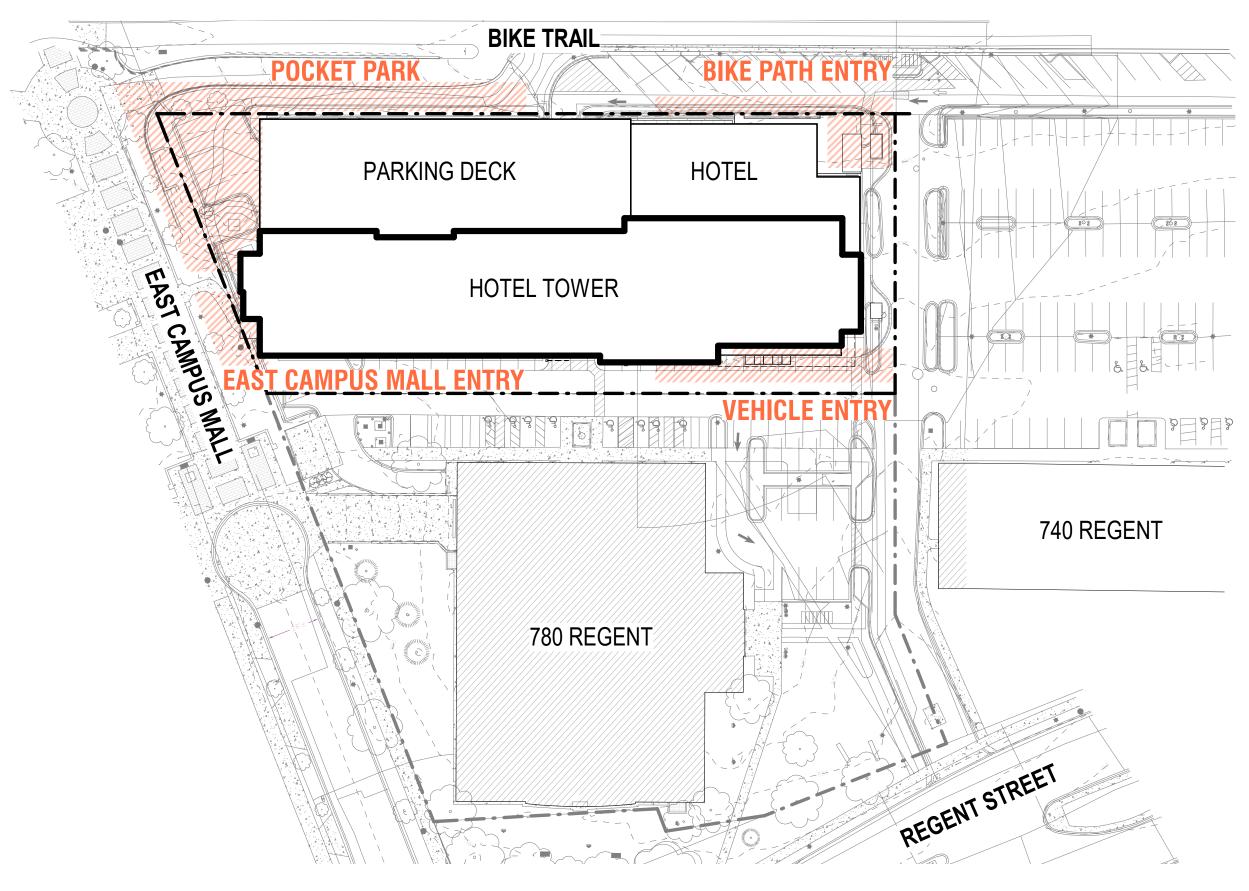

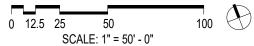





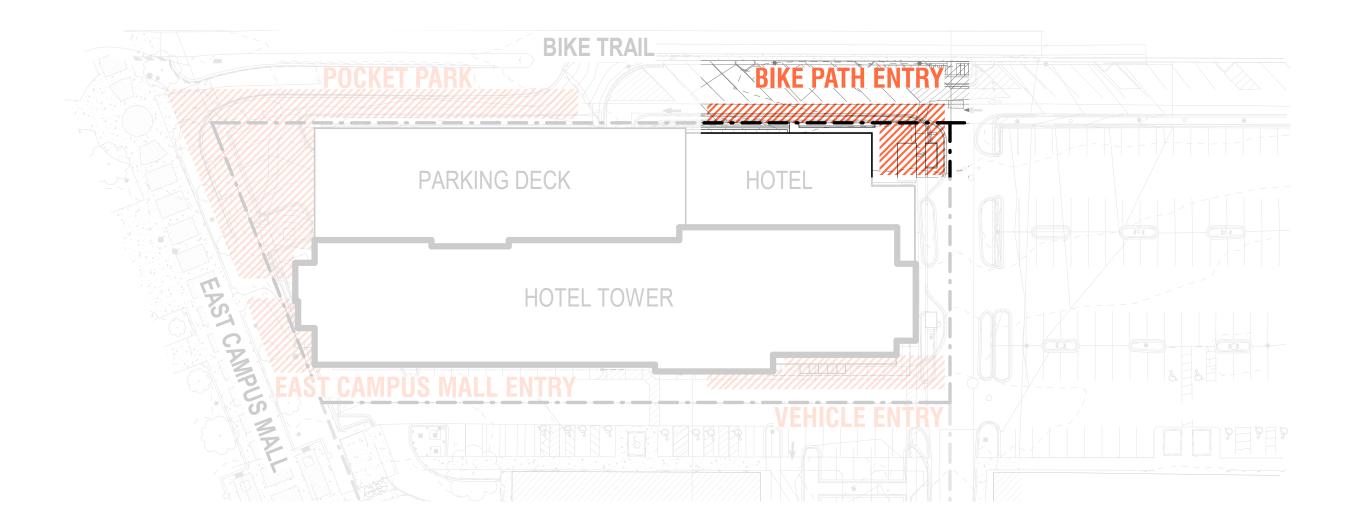


BIKE PATH ENTRY

- Identify entry ► Glass canopy + signage
- Activate facade ➤ Windows + outdoor space
- Animate corner ➤ Restaurant program
- Engage bike path ➤ Bike parking + access
- Connect to south entry ► Canvas canopies + landscape







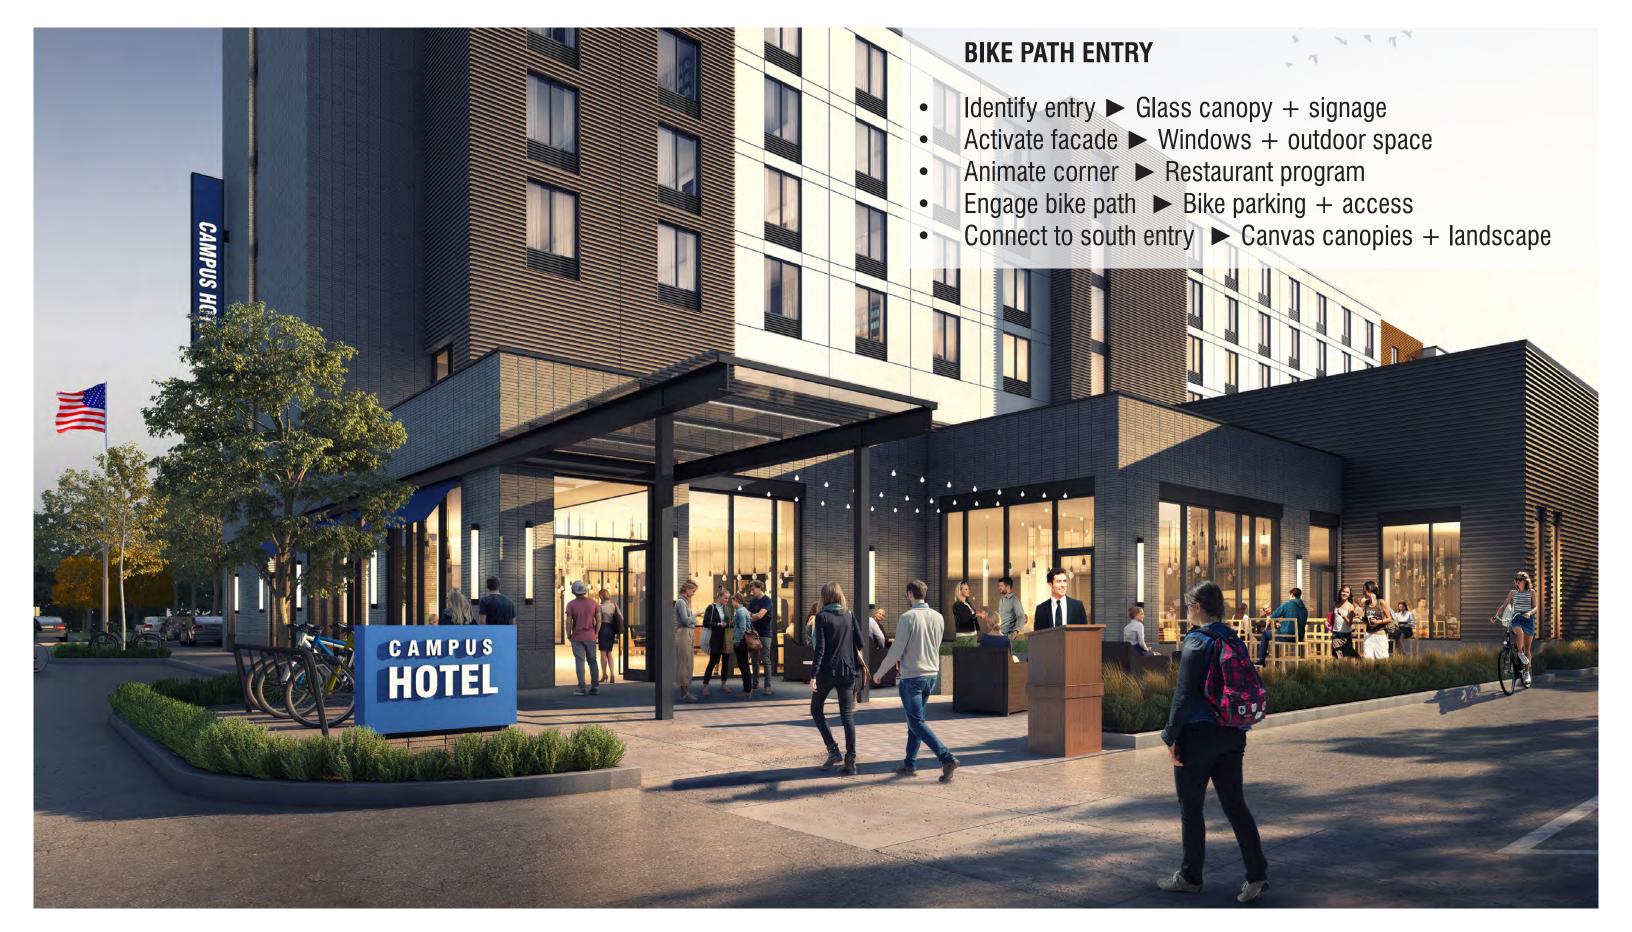

VIEW OF BIKE PATH ENTRY




- PUBLIC HOTEL USE CIRCULATION / SUPPORT
- ACTIVE SPACES INCLUDING BAR / RESTAURANT / LOUNGE
- BACK OF HOUSE
- GUESTROOMS







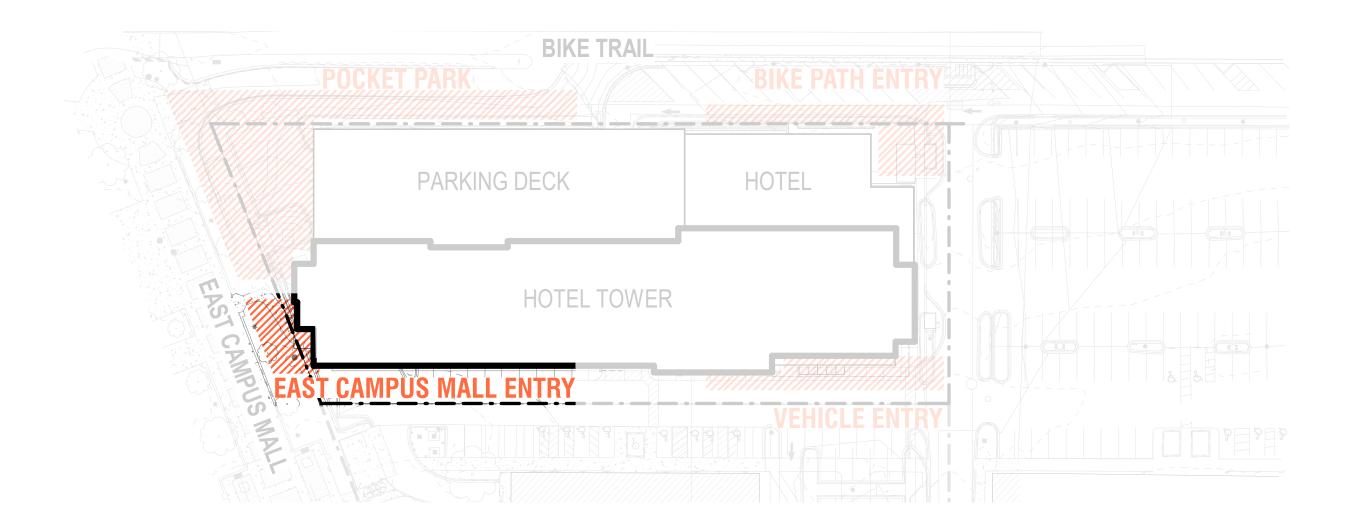


EAST CAMPUS MALL ENTRY

- Identify entry ➤ Steel + glass canopy
- Enliven corner ➤ Unique signage + connectivity
- Enhance safety ➤ Windows + transparency








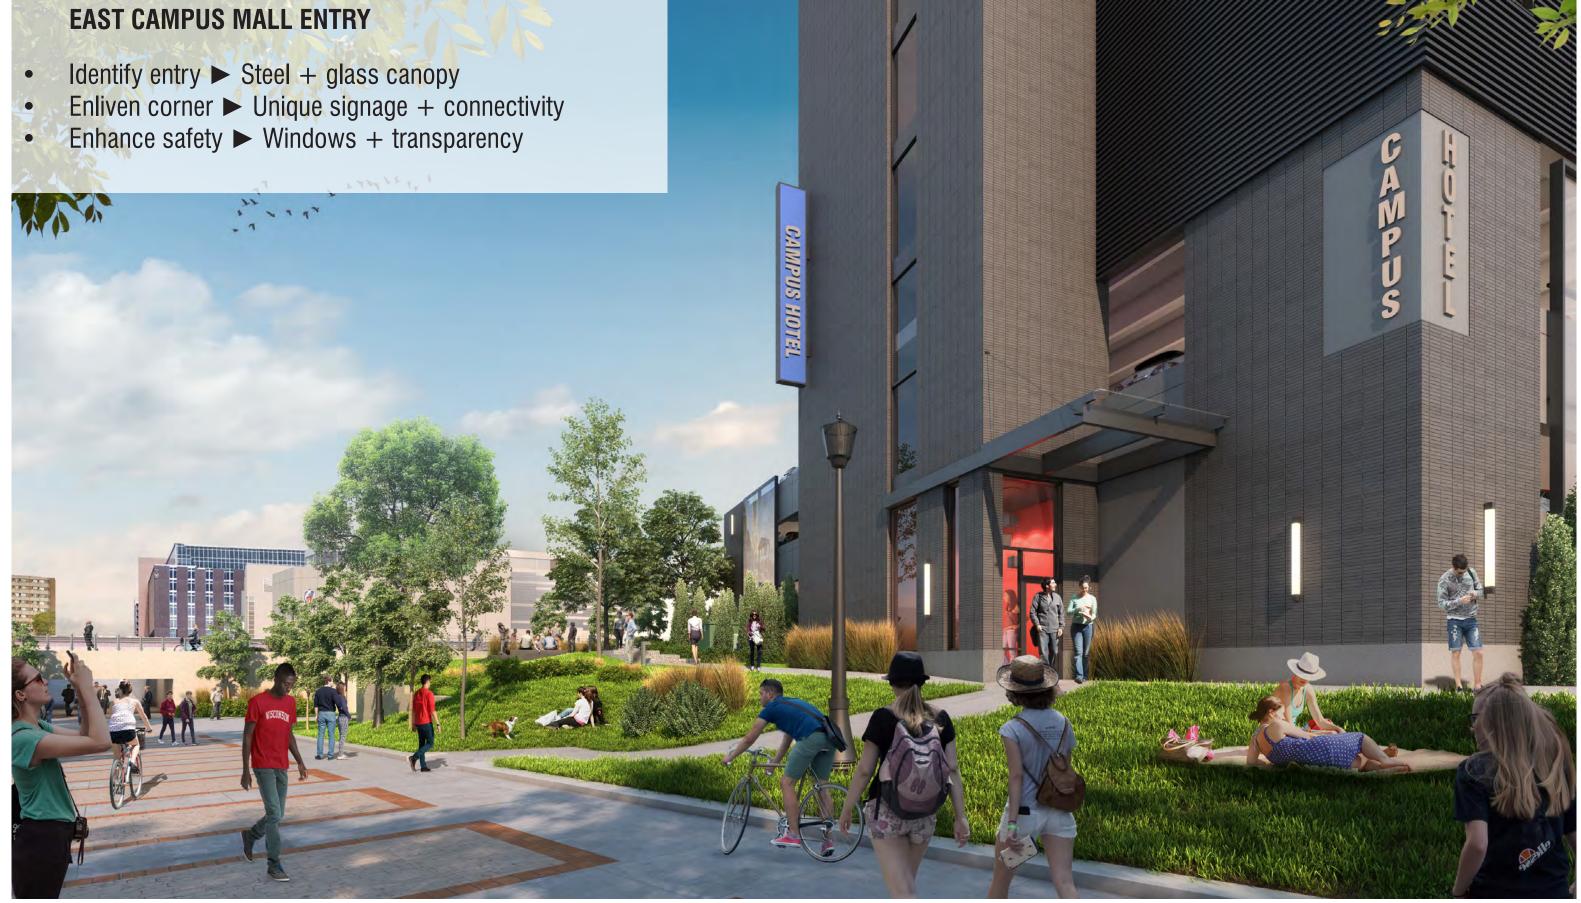

VIEW OF EAST CAMPUS MALL ENTRY



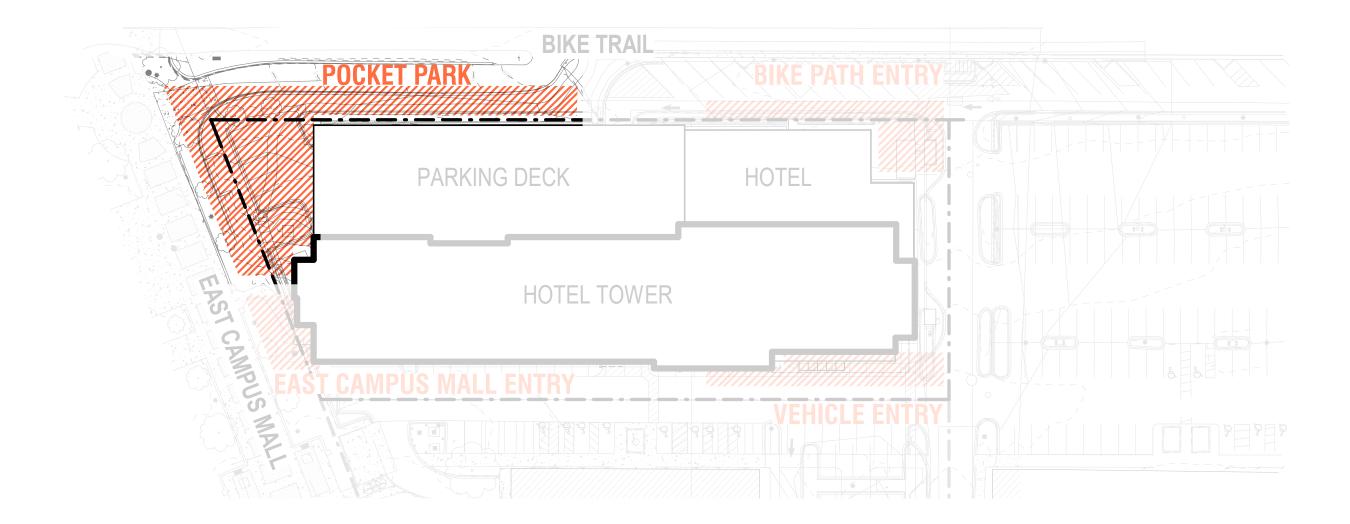

POCKET PARK AND GALLERY WALK

- Screen facade ► Unique local artwork
- Create a gallery experience ➤ Rhythm of art + plantings
- Activate corner ➤ Pocket park overlook + playful landscape
- Illuminate the walk ➤ Bollards + accent lighting









VIEW OF POCKET PARK






VIEW OF POCKET PARK FROM BIKE TRAIL

CITY OF MADISON UDC | 05-29-2019 | PAGE 13

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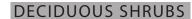
CITY OF MADISON UDC | 05-29-2019 | PAGE 14

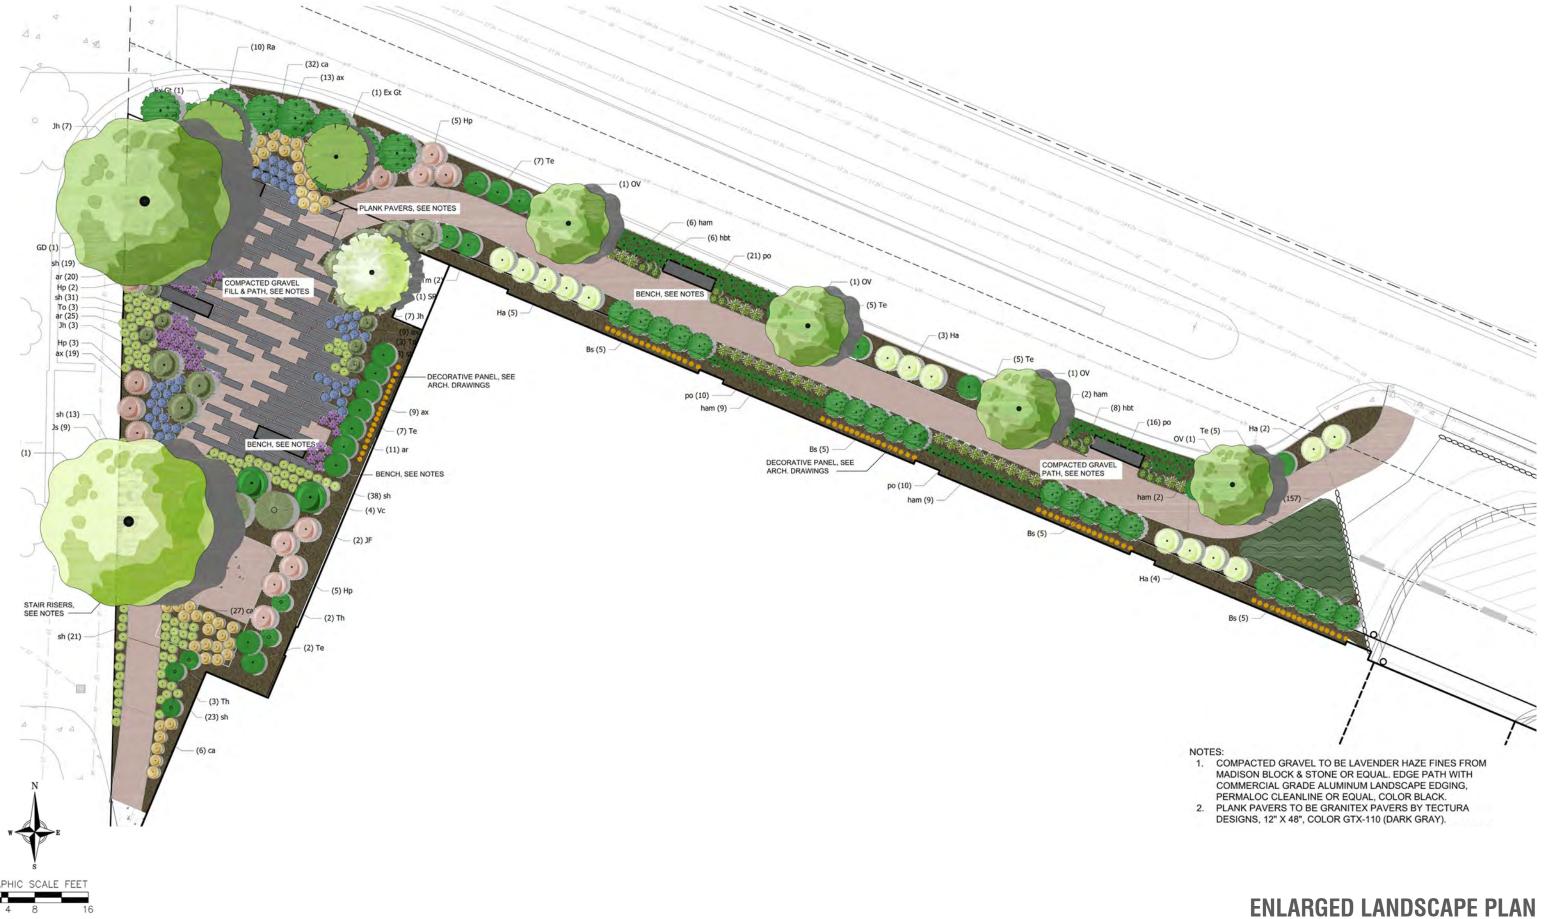

DECIDUOUS TREES



UNDERSTORY TREES





WINTERGREEN BOXWOOD



EVERLOW YEW

HICKS YEW

PERENNIALS

CHOCOLATE CHIP CARPET BUGLE

BLUE ICE STAR FLOWER

KARL FOERSTER FEATHER REED GRASS

NORTHERN SEA OATS

ZAGREB COREOPSIS





AUGUST MOON HOSTA





CHRISTMAS FERN














COMMON HACKBERRY



IVORY SILK TREE LILAC

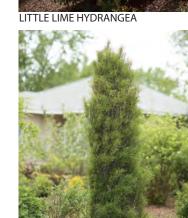



GRO-LOW SUMAC



FAIRVIEW JUNIPER



HOLMSTRUP ARBORVITAE



WITHEROD VIBURNUM





NORTHERN ACCLAIM HONEYLOCUST

DECAF KENTUCKY COFFEE TREE



AMERICAN HOPHORNBEAM/IRONWOOD





DWARF BUSH HONEYSUCKLE



ANNABELLE HYDRANGEA










CORAL BELLS

PLANT SELECTION



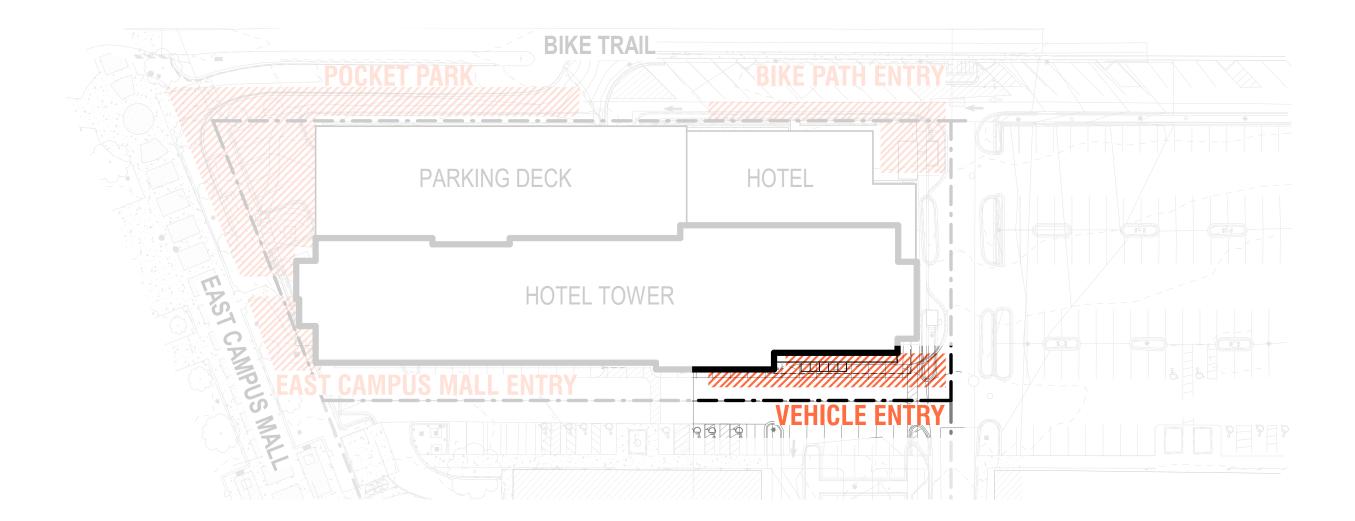

VEHICLE ENTRY

- Provide shelter ➤ Steel + glass canopy
- Emphasize openness ➤ Double story vertical glazing
- Activate facade ➤ Lounge, gym and prefunction spaces
- Illuminate the building ➤ Pedestrian scale sconces
- Balance building appeal ➤ Simple material palette
















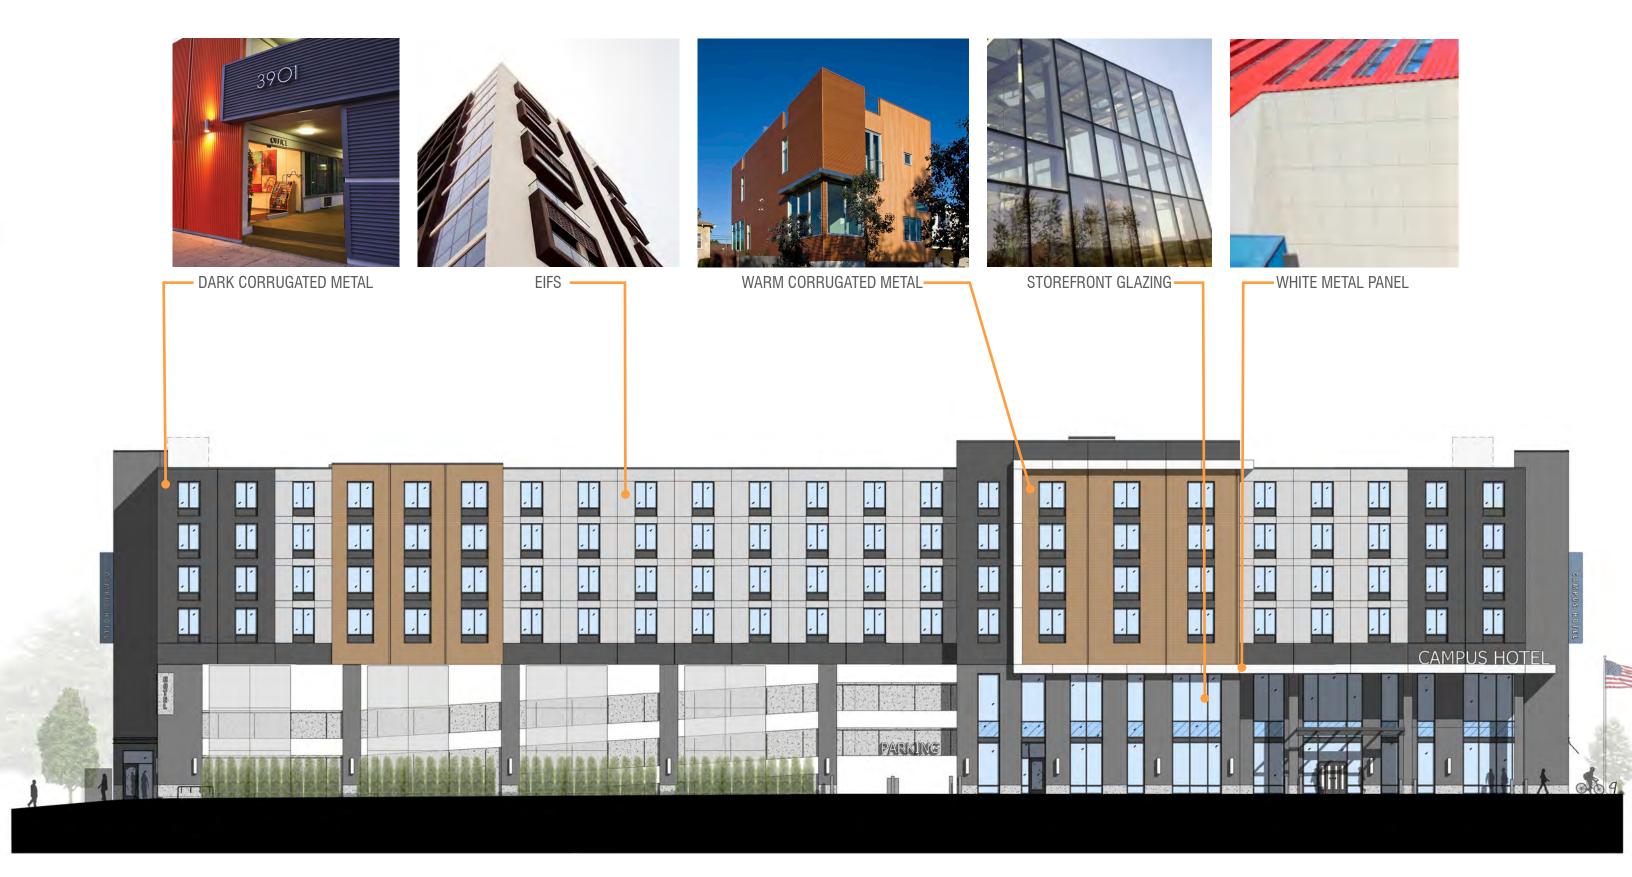


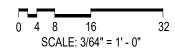

Mortenson



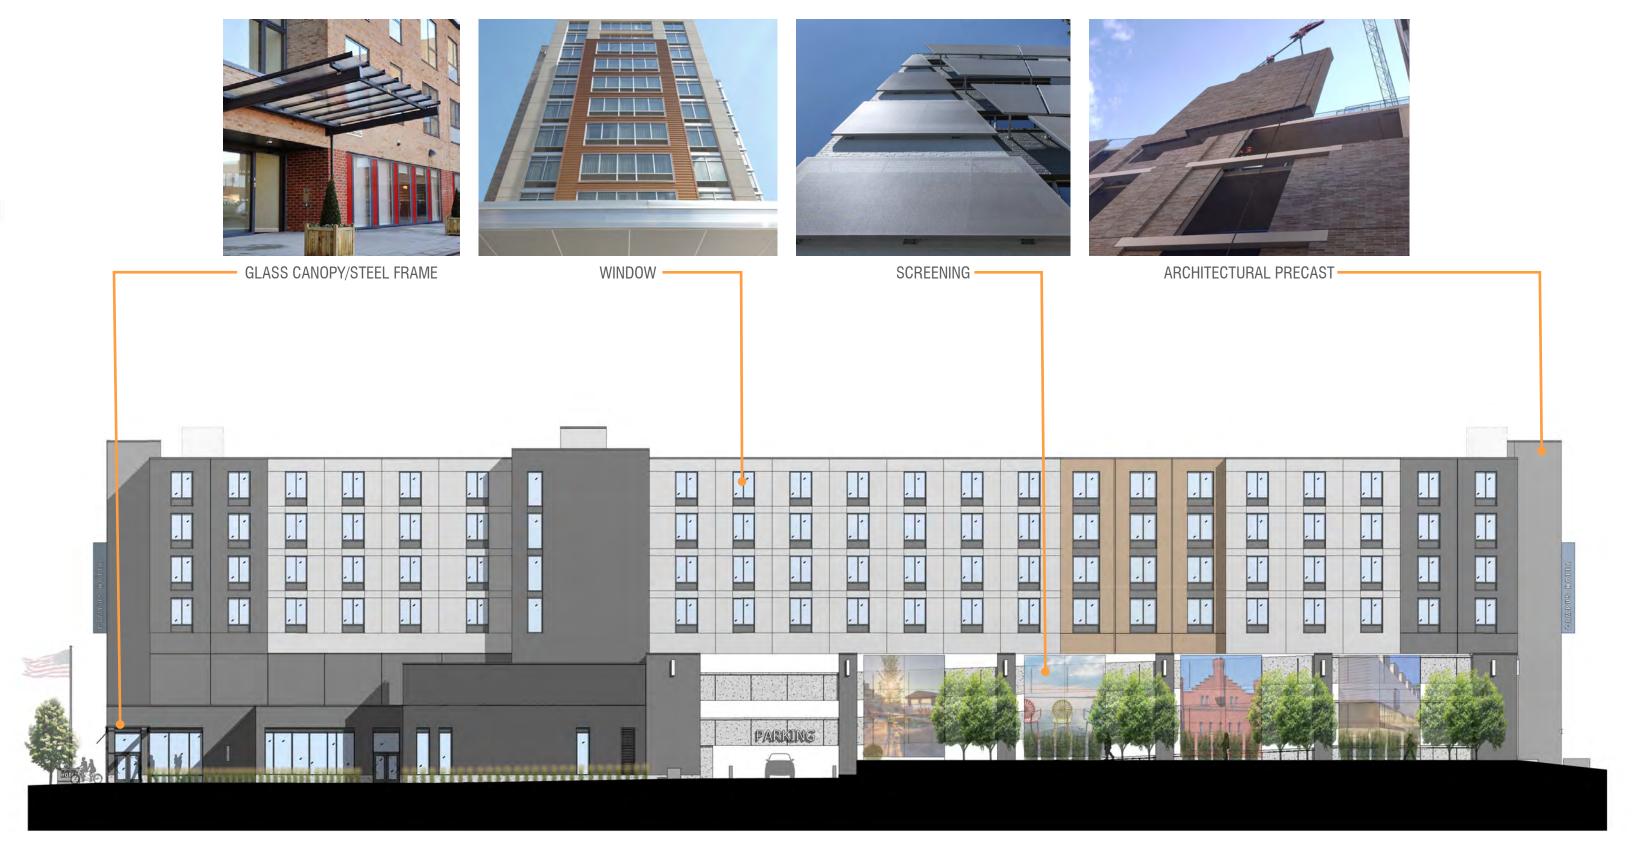

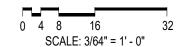









EAST ELEVATION



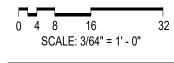







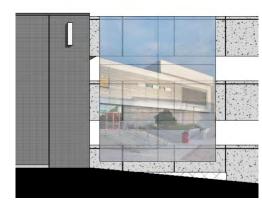

EAST CAMPUS MALL LANDMARKS

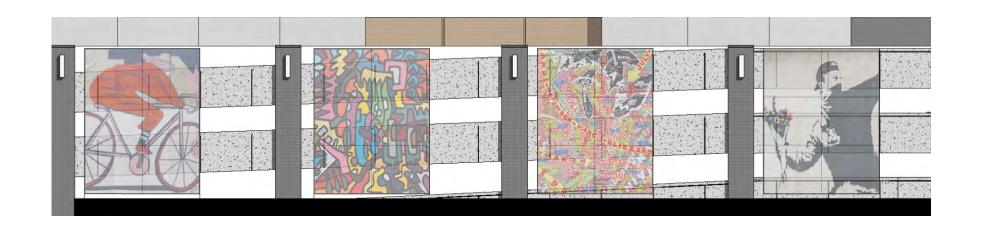

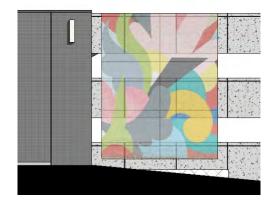

LOCALLY SOURCED ART

CONCEPTS FOR ART PANELS



ATTACHMENTS
















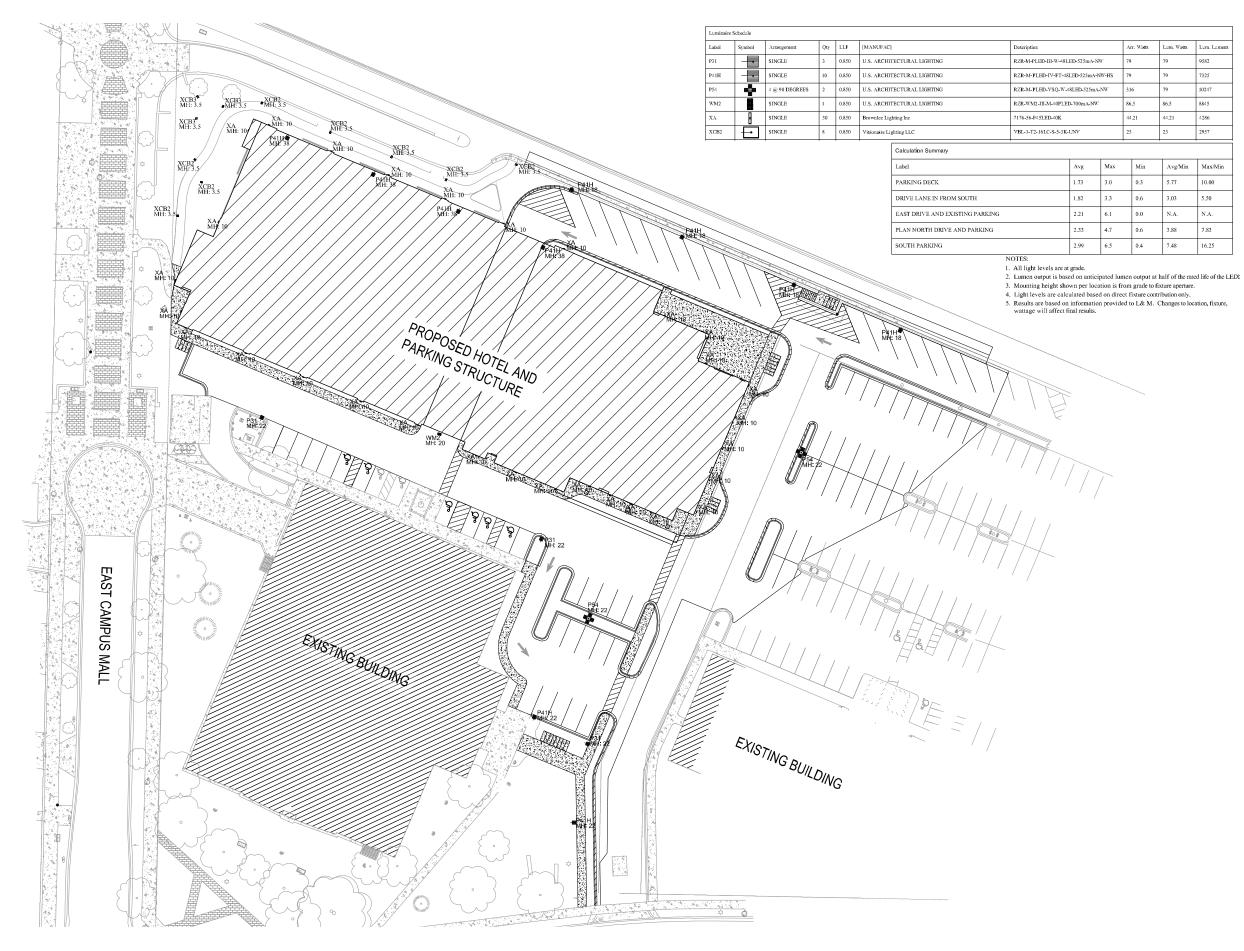






LIGHTING PLAN




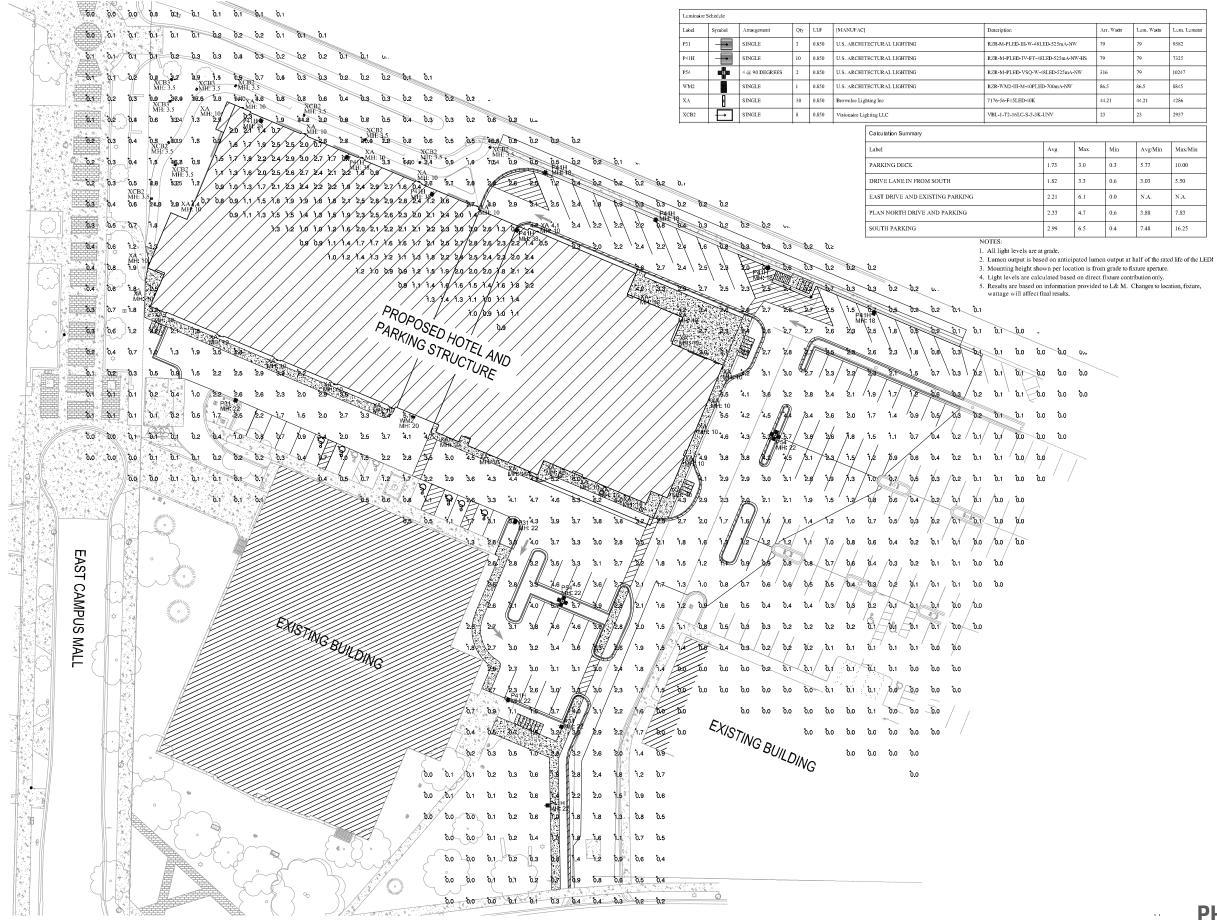







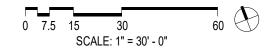







PUBLIC HOTEL USE - CIRCULATION / SUPPORT

ACTIVE SPACES INCLUDING BAR / RESTAURANT / LOUNGE

BACK OF HOUSE

GUESTROOMS

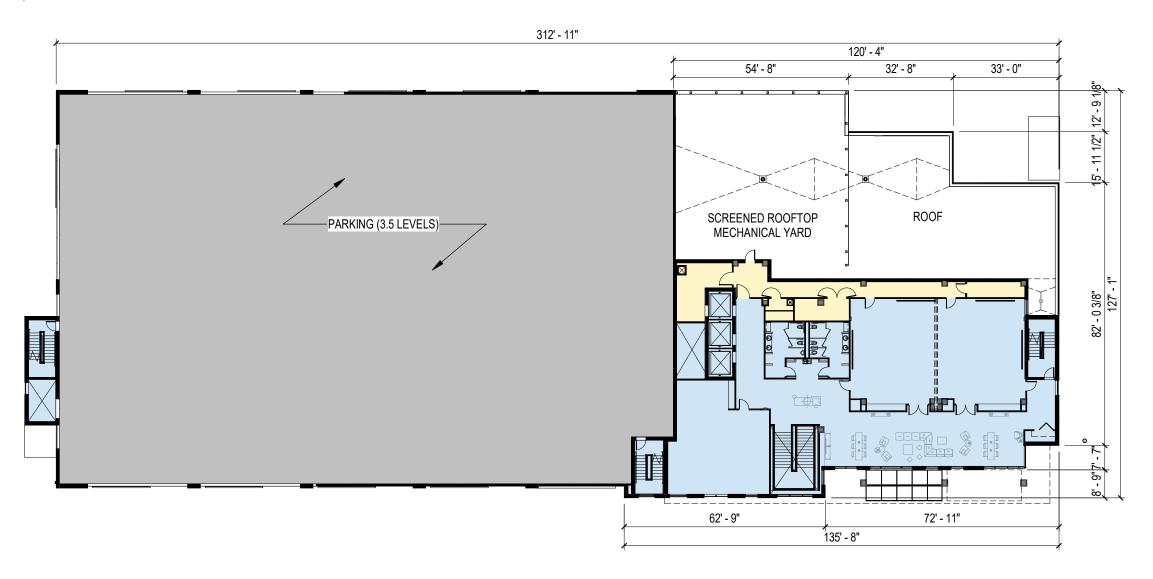

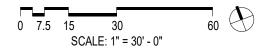









- PUBLIC HOTEL USE CIRCULATION / SUPPORT
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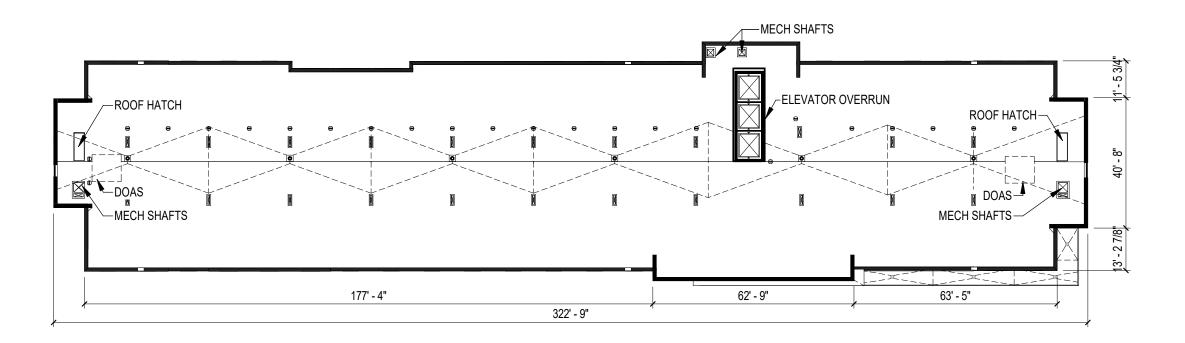


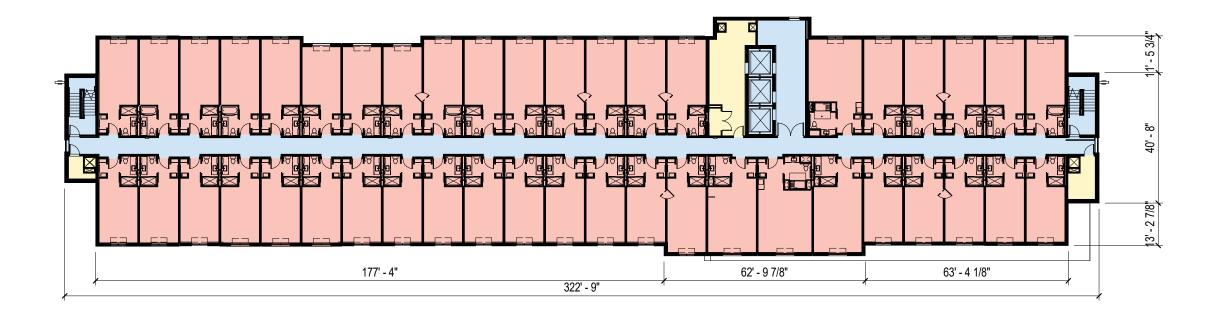


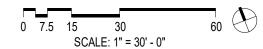



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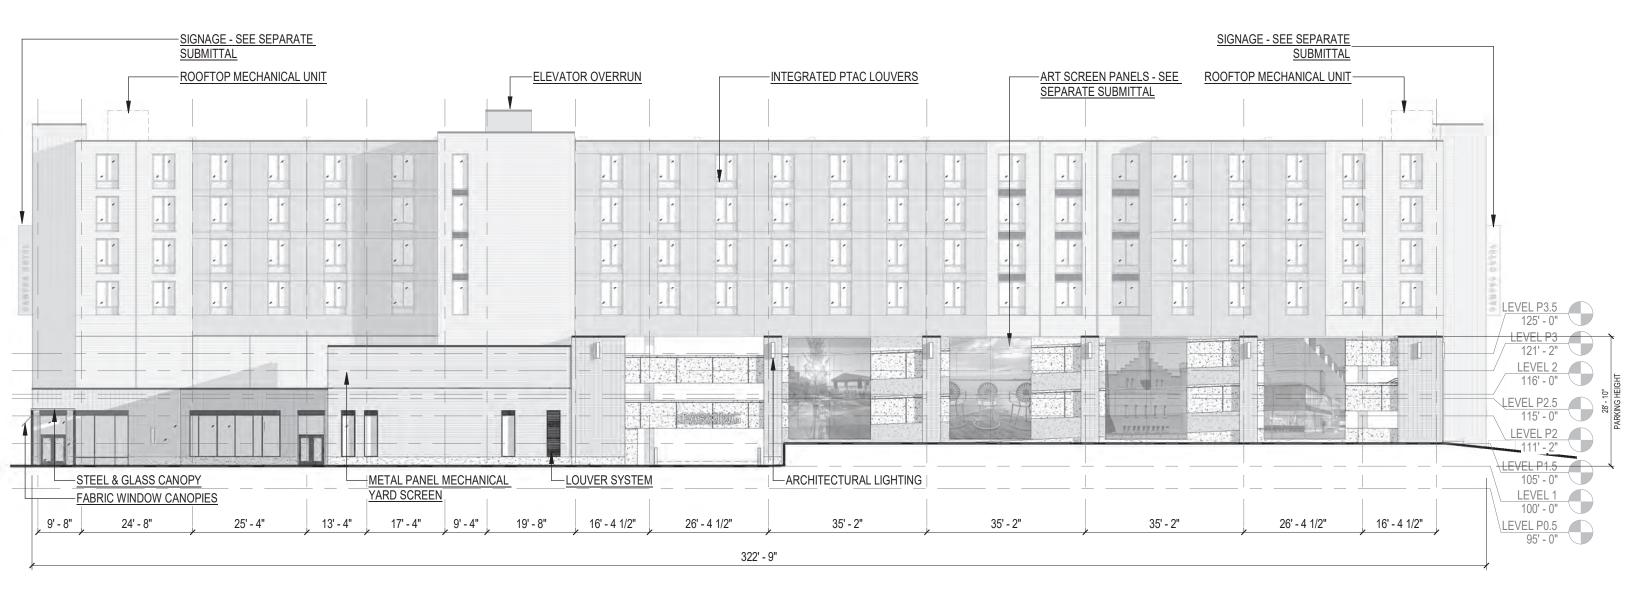





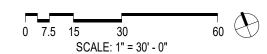









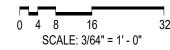






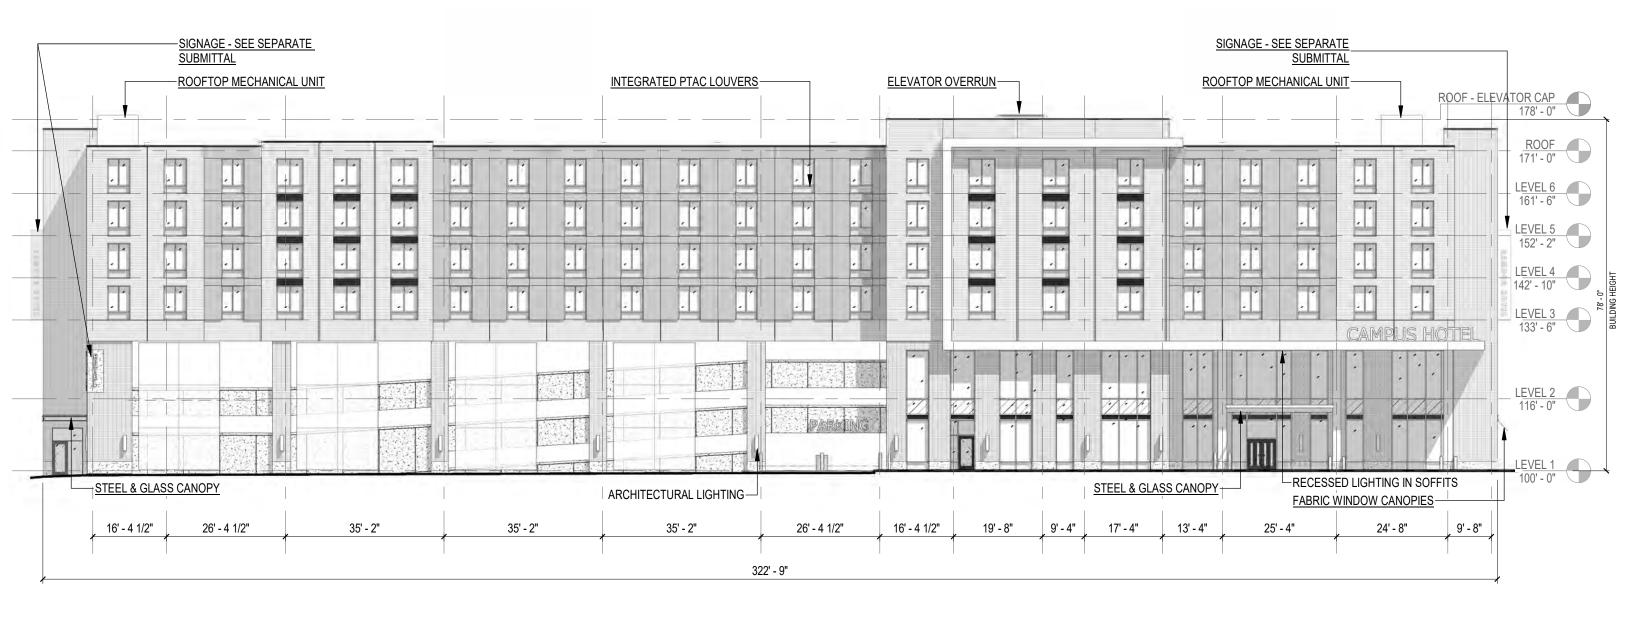


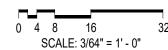






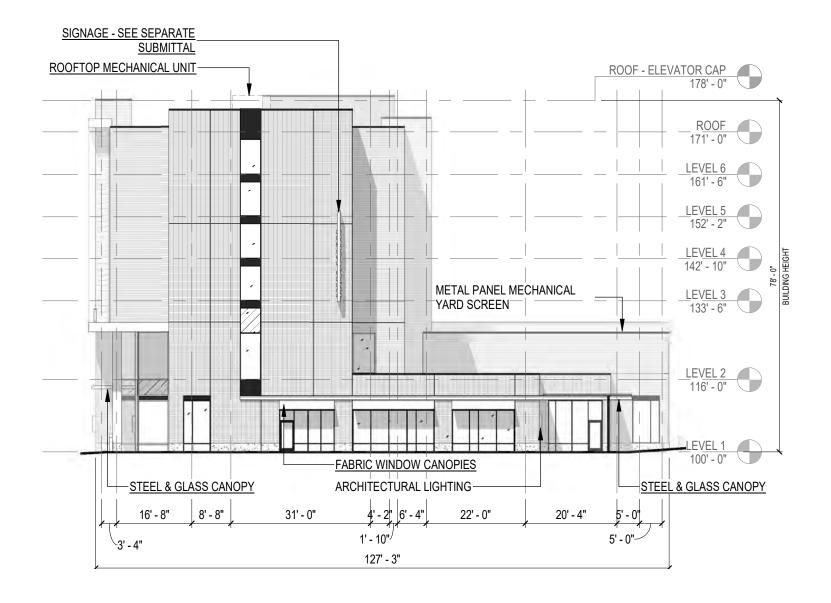


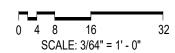





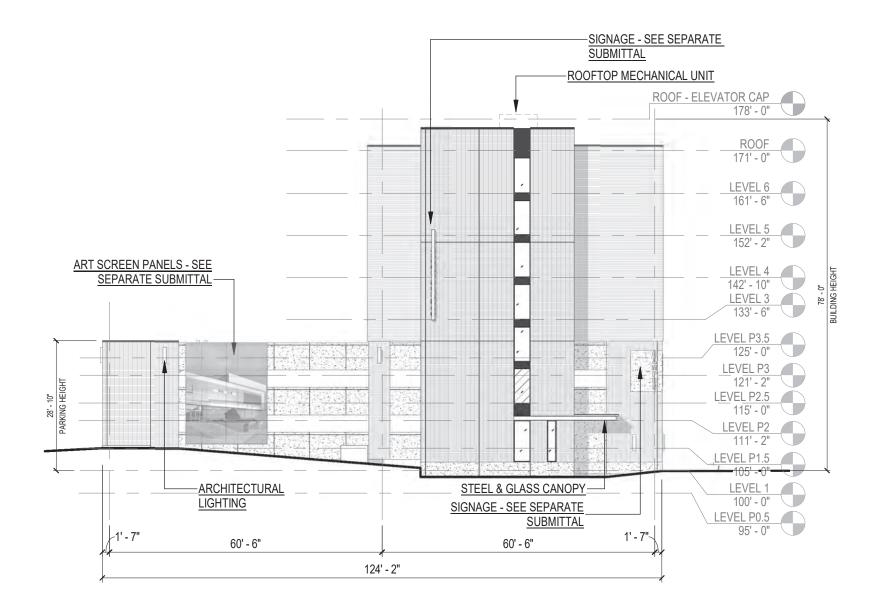


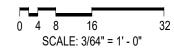







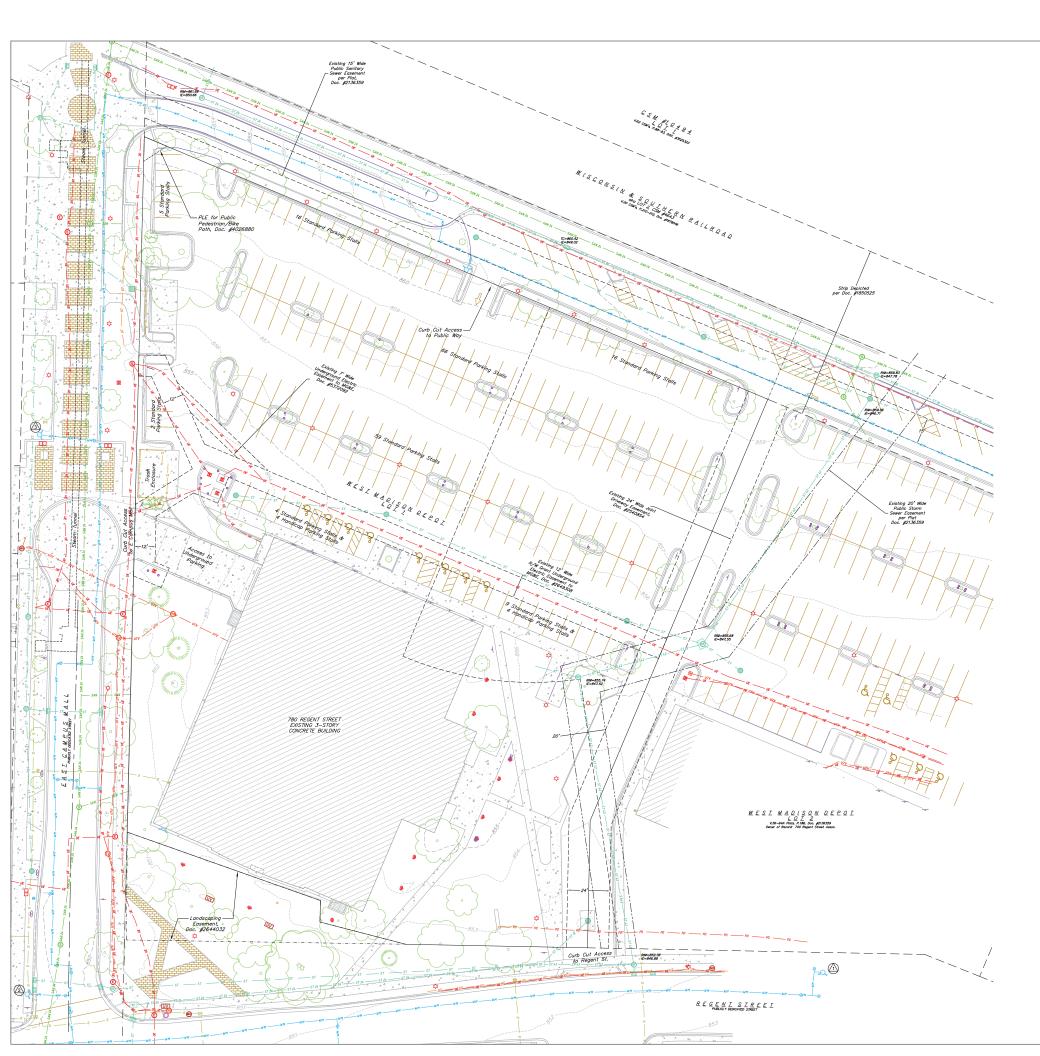



TOPOGRAPHIC SYMBOL LEGEND

TOPOGRAPHIC LINEWORK LEGEND — UTV — UTV — EXISTING UNDERGROUND CABLE TV

— UT — UT — EXISTING UNDERGROUND TELEPHONE

- UE - UE - EXISTING UNDERGROUND ELECTRIC LINE
- SAN - SAN - EXISTING SANITARY SEWER LINE (SIZE NOTED)

- * - * EXISTING GENERAL FENCE

EXISTING WOOD FENCE

S S EXISTING GAS LINE

 EXISTING BOLLARD EXISTING ELECTRIC RECTANGULAR MANHOLE

EXISTING FLAG POLE EXISTING SIGN

D EXISTING PARKING METER EXISTING CURB INLET

■ EXISTING TRANSFORMER EXISTING LIGHT POLE

EXISTING GENERIC LIGHT M EXISTING TV MANHOLE

EXISTING FIELD INLET EXISTING STORM MANHOLE FI EXISTING STORM MANHOLE RECTANGULAR

T EXISTING FIRE HYDRANT EXISTING FIRE DEPARTMENT CO EXISTING WATER MAIN VALVE

EXISTING GAS METER EXISTING ELECTRIC MANHOLE

EXISTING TV PEDESTAL EXISTING TELEPHONE MANHOLE EXISTING UNIDENTIFIED MANHOLE

EXISTING UNIDENTIFIED UTILITY VAULE

EXISTING HANDICAP PARKING O EXISTING TRAFFIC SIGNAL EXISTING SHRUB O EXISTING CONIFEROUS TREE EXISTING DECIDUOUS TREE

HATCHING LEGEND EXISTING CONCRETE


EXISTING BRICK PAVERS

- NOTES:

 1. THIS SURVEY IS BASED UPON FIELD SURVEY WORK PERFORMED ON AUGUST 16 THROUGH AUGUST 23, 2018. ANY CHANGES IN SITE CONDITIONS AFTER AUGUST 23, 2018 ARE NOT REFLECTED BY THIS SURVEY. ADDITIONAL FIELD SURVEY WORK WAS FERFORMED ON FERDURATY 22, 2019. SERVATIONS AND/OF PLAN OF RECORD DRAWINGS. CONTRACTOR SHALL VERIFY TOPOGRAPHIC INFORMATION FINDS TO STARTING CONSTRUCTION.

 2. CONTRACTOR SHALL FIELD VERIFY LOCATION OF ENSITING SANITARY SEWER, STORM SEMER AND WATER MAIN PRIOR TO CONSTRUCTION TO ENSURE ALL VECESSARY PRECALITIONS. TO PROTECT THE EMISTING LITUTIES DURBNUC CONSTRUCTION. ANY DAMAGE TO THE EMISTING LITUTIES AND ANY REPAIRS NEEDED AS A RESULT OF THE DAMAGE SHALL BE AT THE EXPENSE OF THE CONTRACTOR SEASONS THE LOCATION MARKED IN THE FIELD OR SHOWN ON THE PLANS.

 4. THE LOCATIONS OF EXISTING UTILITY INSTALLATIONS AND THE PLANS WE APPROXIMATE. THERE MAY BE OTHER UTILITY INSTALLATIONS WITHIN THE PROJECT AREA THAT ARE NOT SHOWN. CONTRACTOR SHALL BE RESPONSIBLE FOR CONTACTION DE NEW OTHER UTILITY INSTALLATIONS WITHIN THE PROJECT AREA THAT ARE NOT SHOWN. CONTRACTOR SHALL BE RESPONSIBLE FOR CONTACTIONS DISCONSIBLE FOR CONTACTIONS DISCONSIBLE OF CONTACTIONS DISCONSIBLE FOR CONTACTIONS DISCONSIBLE OF NEW UTILITY INSTALLATIONS AS SHOWN OF THE PLAN ARE APPROXIMATE. THERE MAY BE OTHER UTILITY INSTALLATIONS WITHIN THE PROJECT AREA THAT ARE NOT SHOWN. CONTRACTOR SHALL BE RESPONSIBLE FOR CONTACTIONS DISCONSIBLE FOR CONTACTIONS DISCONSIBLE.

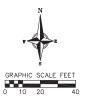

Revisions

SITE BENCHMARKS

ARROW BOLT ON FIRE HYDRANT LOCATED ON NORTH SIDE OF REGENT STREET, APPROXIMATELY 450 EAST OF THE INTERSECTION WITH EAST CAMPUS MALL. ELEV = 855.83

ARROW BOLT ON FIRE HYDRANT LOCATED IN THE NORTHWEST QUADRANT OF REGENT STREET AND EAST CAMPUS MALL. ELEV = 852.43 **②**

3



CALL DIGGER'S HOTLINE 1-800-242-8511

CITY OF MADISON UDC

SCOPE DOCUMENTS

Drawing Date MAY 29, 2019

UW CAMPUS HOTEL

760 Regent Street Madison, WI 53715


Project No. 218051

Sheet Title

EXISTING CONDITIONS PLAN

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Sheet No. C100



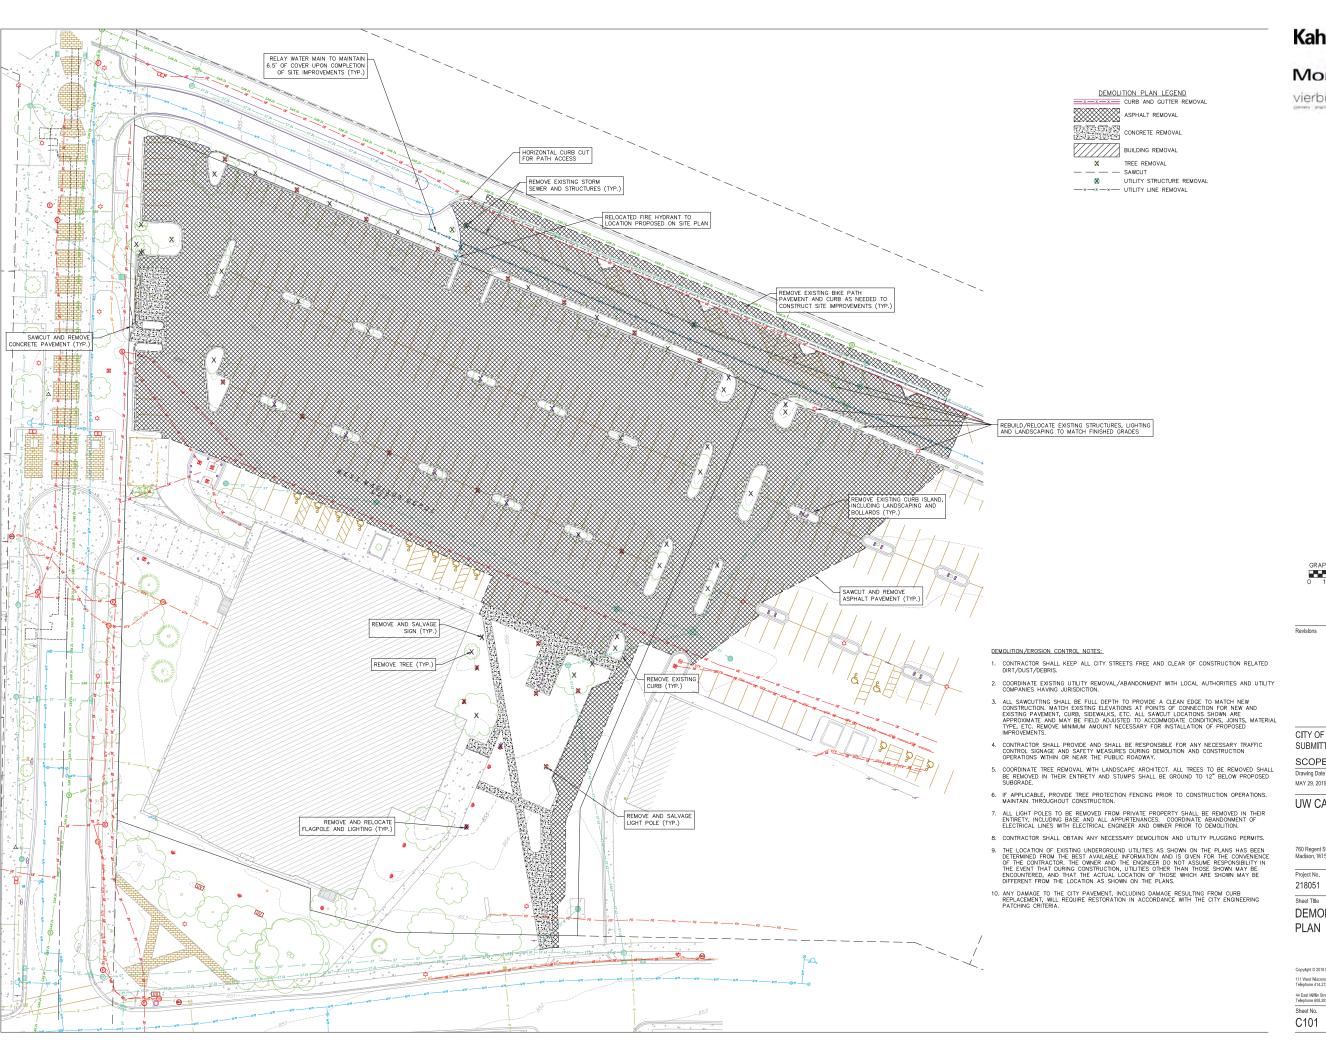

CITY OF MADISON UDC

SCOPE DOCUMENTS

Drawing Date MAY 29, 2019


UW CAMPUS HOTEL


760 Regent Street Madison, WI 53715

Sheet Title

DEMOLITION

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GRADING LEGEND

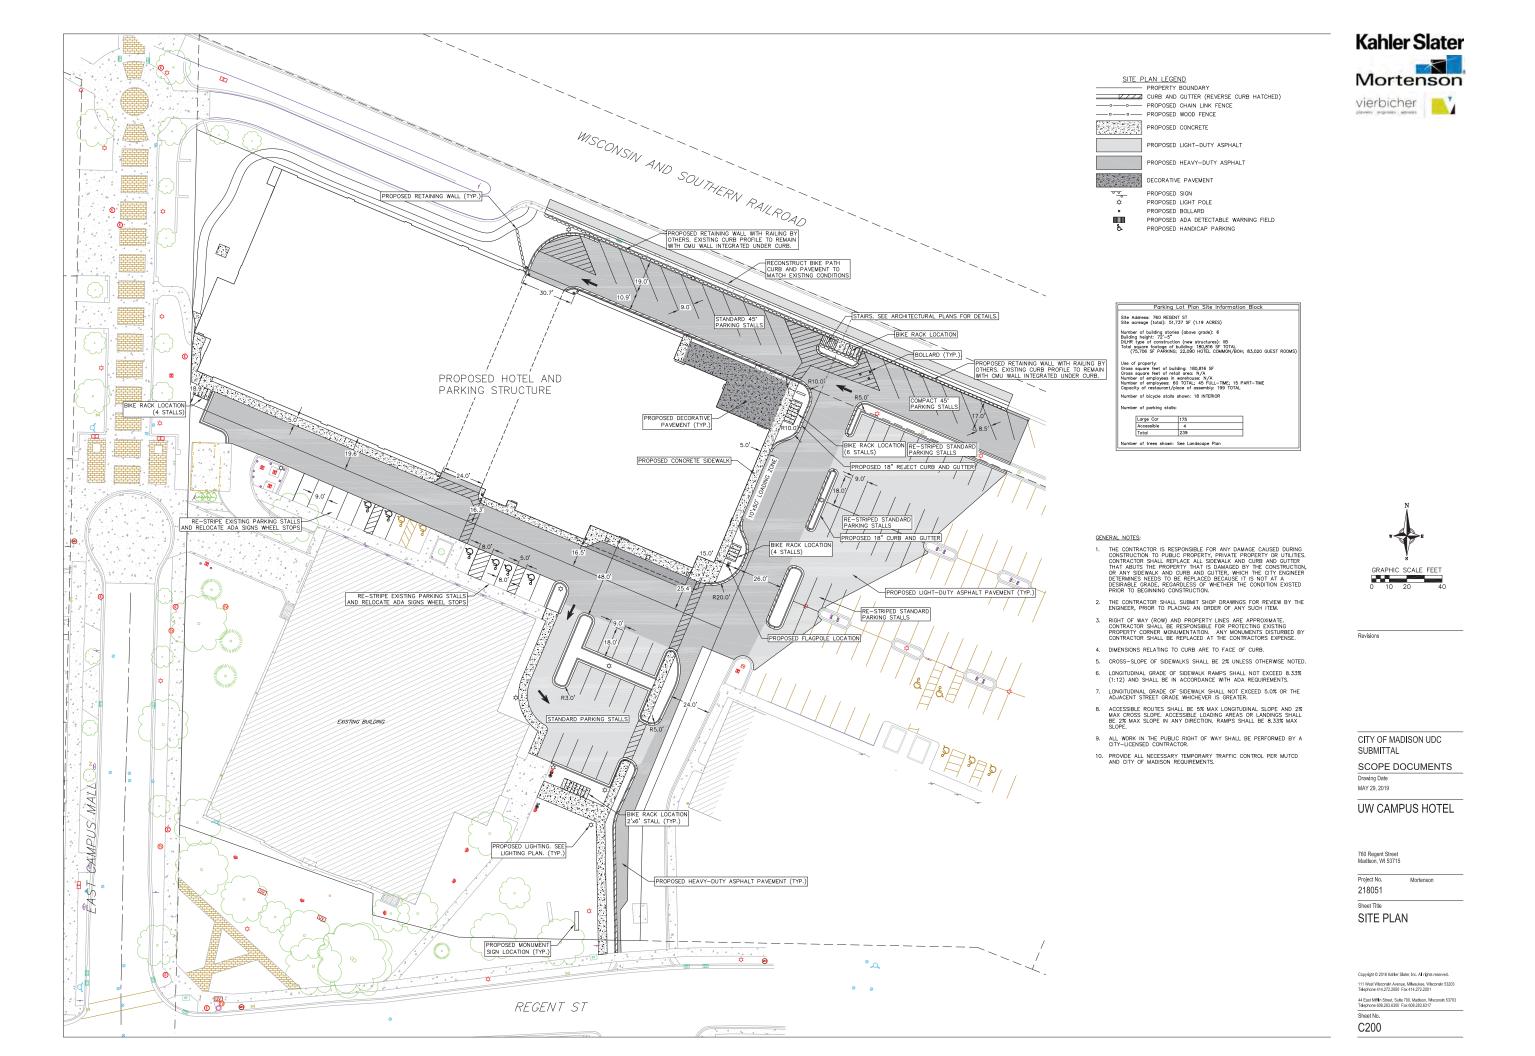EXISTING MAJOR CONTOURS

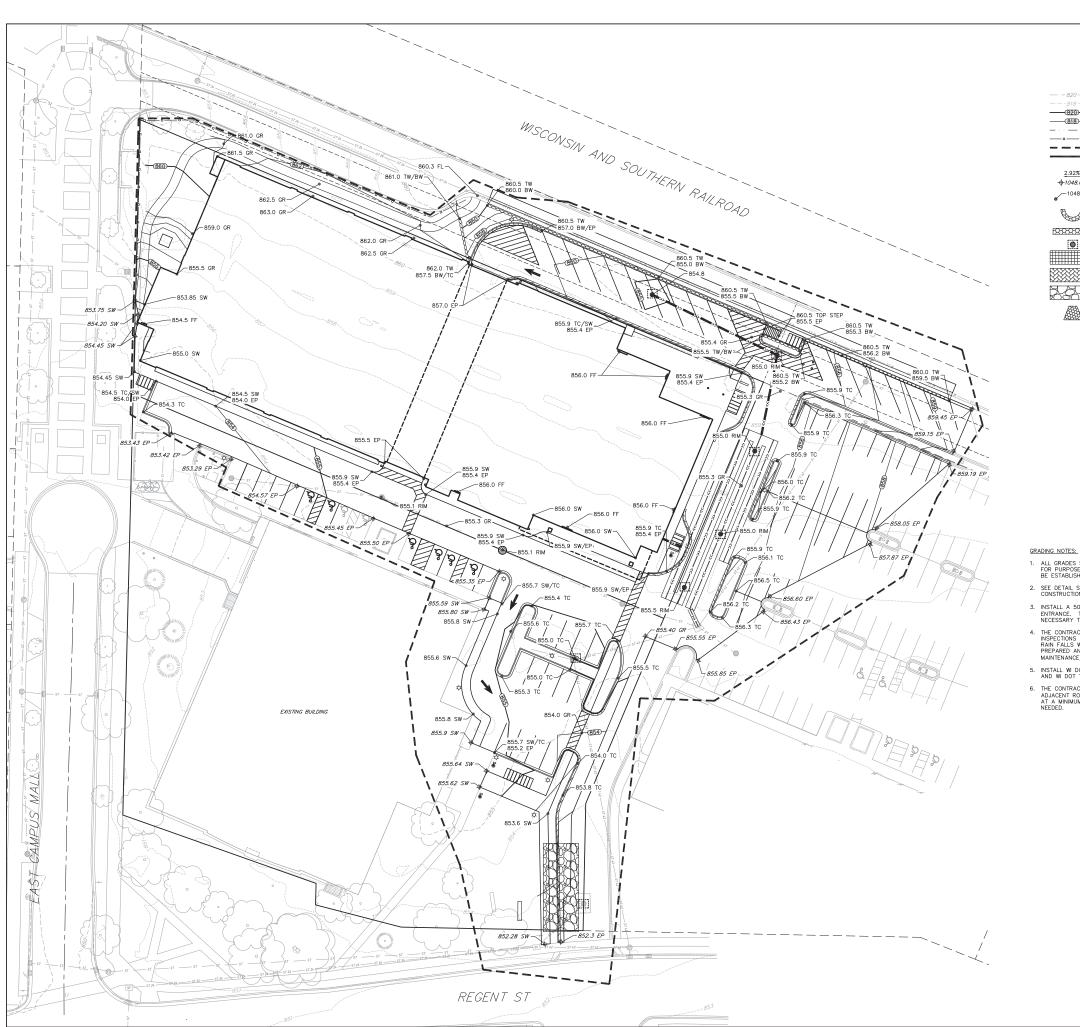EXISTING MINOR CONTOURS

DRAINAGE DIRECTION PROPOSED SLOPE ARROWS

EXISTING SPOT ELEVATIONS

PROPOSED SPOT ELEVATIONS

- · · - · · - DITCH CENTERLINE - - - DISTURBED LIMITS - BERM

-0-1048.61

1048.61



- ALL GRADES SHOWN ARE FINISHED GRADES. CONTOURS ARE SHOWN
 FOR PURPOSES OF INDICATING ROUGH GRADING. FINAL GRADE SHALL
 BE ESTABLISHED ON PAVED SURFACES BY USING SPOT GRADES ONLY.
- SEE DETAIL SHEETS FOR EROSION CONTROL NOTES AND CONSTRUCTION SEQUENCE.
- INSTALL A 50'L X 20'W X 1.5'D TRACKING PAD AT THE SITE ENTRANCE. THE TRACKING PAD SHALL BE MAINTAINED/REPAIRED AS NECESSARY TO ACCOMMODATE CONSTRUCTION.
- 4. THE CONTRACTOR IS REQUIRED TO MAKE EROSION CONTROL INSPECTIONS AT THE END OF EACH WEEK AND WHEN 0.5 INCHES OF RAIN FALLS WITHIN 24 HOURS. INSPECTION REPORTS SHALL BE PREPARED AND FILED AS REQUIRED BY THE DNR. ALL MAINTENANCE/REPAIR WILL FOLLOW AN INSPECTION WITHIN 24 HOURS.
- 5. INSTALL WI DOT TYPE D INLET PROTECTION IN EXISTING CURB INLETS AND WI DOT TYPE A IN FIELD INLETS.
- 6. THE CONTRACTOR SHALL REMOVE ANY SEDIMENT TRACKED ONTO ADJACENT ROADS BY MEANS OF STREET SWEEPING (NOT FLUSHING) AT A MINIMUM OF THE END OF EACH WORK DAY OR MORE AS NEEDED.



CITY OF MADISON UDC SUBMITTAL

SCOPE DOCUMENTS

MAY 29, 2019

UW CAMPUS HOTEL

760 Regent Street Madlson, WI 53715

Project No.


218051

GRADING & EROSION CONTROL PLAN

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UW CAMPUS HOTEL

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Project No.

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UTILITY PLAN
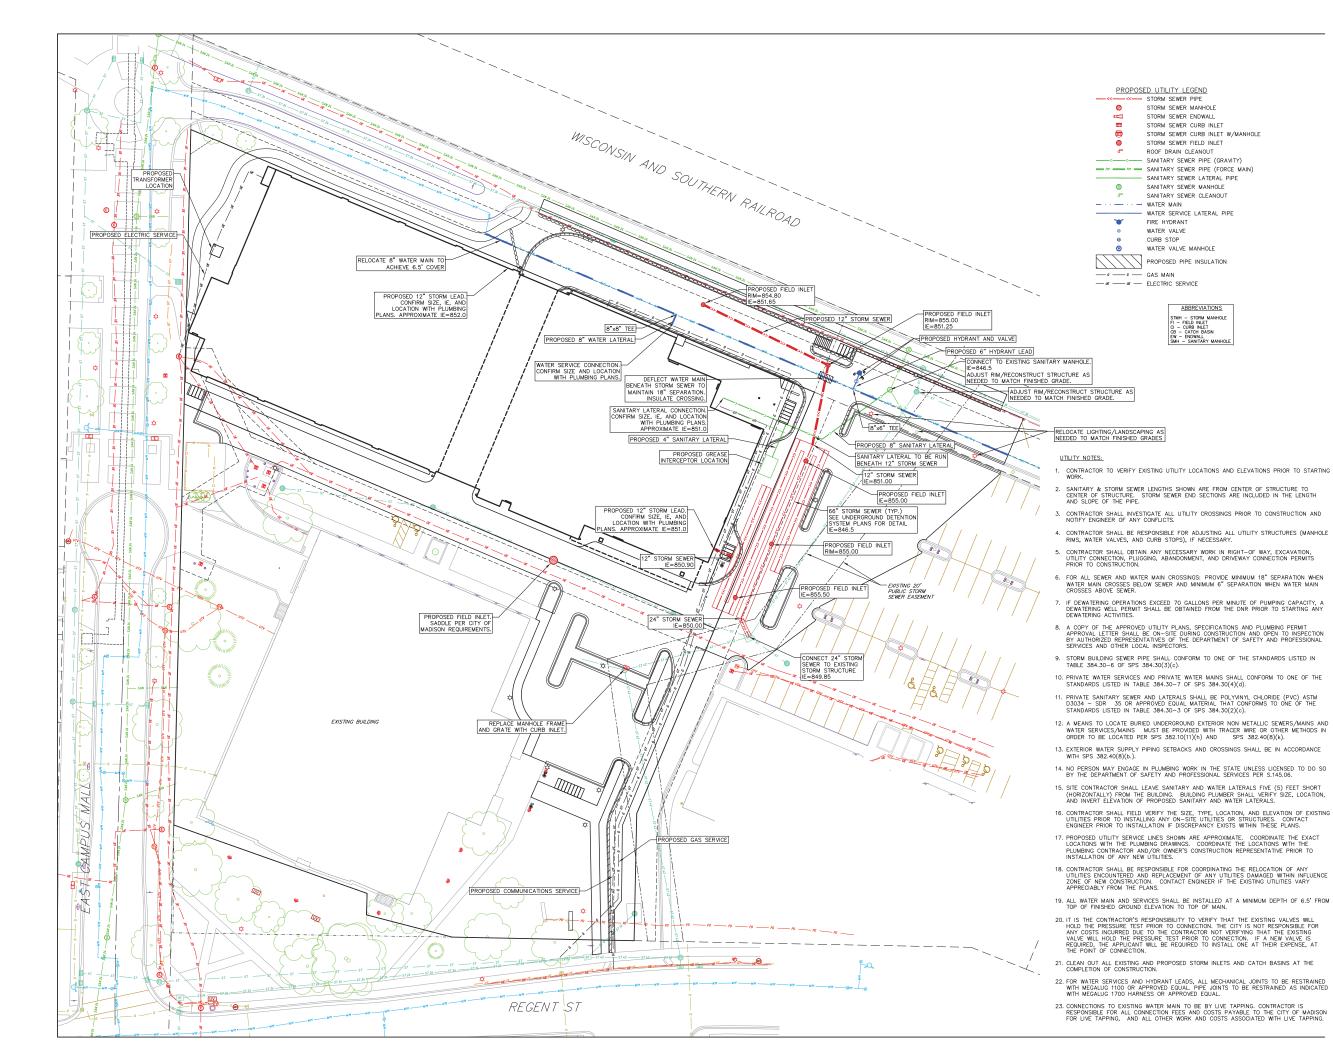
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Sheet No. C400

EROSION CONTROL MEASURES

- 1. EROSION CONTROL SHALL BE IN ACCORDANCE WITH THE CITY OF MADISON EROSION CONTROL ORDINANCE AND CHAPTER NR 216 OF THE WISCONSIN ADMINISTRATIVE CODE.
- CONSTRUCT AND MAINTAIN ALL EROSION AND SEDIMENT CONTROL MEASURES IN ACCORDANCE WITH WISCONSIN DNR TECHNICAL STANDARDS
 (http://dnr.wi.gov/runoff/stormwater/techstds.htm) AND WISCONSIN CONSTRUCTION SITE BEST MANAGEMENT PRACTICE HANDBOOK.
- 3. INSTALL SEDIMENT CONTROL PRACTICES (TRACKING PAD, PERIMETER SILT FENCE, SEDIMENT BASINS, ETC.) PRIOR TO INITIATING OTHER LAND DISTURBING CONSTRUCTION ACTIVITIES.
- 4. THE CONTRACTOR IS REQUIRED TO MAKE EROSION CONTROL INSPECTIONS AT THE END OF EACH WEEK AND WHEN 0.5 INCHES OF RAIN FALLS WITHIN 24 HOURS. INSPECTION REPORTS SHALL BE PREPARED AND FILED AS REQUIRED BY THE DNR AND/OR CITY. ALL MAINTENANCE WILL FOLLOW AN INSPECTION WITHIN 24 HOURS.
- 5. EROSION CONTROL IS THE RESPONSIBILITY OF THE CONTRACTOR UNTIL ACCEPTANCE OF THIS PROJECT. EROSION CONTROL MEASURES AS SHOWN SHALL BE THE MINIMUM PRECAUTIONS THAT WILL BE ALLOWED. ADDITIONAL EROSION CONTROL MEASURES, AS REQUESTED IN WRITING BY THE STATE OR LOCAL INSPECTORS, OR THE DEVELOPER'S ENDINEER, SHALL BE INSTALLED WITHIN 24 HOURS.
- PUBLIC ROAD SHALL BE REMOVED BY STREET CLEANING (NOT HYDRAULIC FLUSHING) BEFORE THE END OF EACH WORK DAY.
- 7. CHANNELIZED RUNOFF: FROM ADJACENT AREAS PASSING THROUGH THE SITE SHALL BE DIVERTED AROUND DISTURBED AREAS.
- 8. STABILIZED DISTURBED GROUND: ANY SOIL OR DIRT PILES WHICH WILL REMAIN IN EXISTENCE FOR MORE THAN 7-CONSECUTIVE DAYS, WHETHER TO BE WORKED DURING THAT PERIOD OR NOT, SHALL NOT BE LOCATED WITHIN 25-FEET OF ANY ROADWAY, PARKING LOT, PAVED AREA, OR DRAINAGE STRUCTURE OR CHANNEL (UNLESS INTENDED TO BE USED AS PART OF THE EROSION CONTROL MEASURES). TEMPORARY STABILIZATION AND CONTROL MEASURES (SEEDING, MOLICHING, TARRING, EROSION MATTING, BARRIER FENOING, ETC.) ARE RECURDE FOR THE PROTECTION OF DISTURBED AREAS AND SOIL PILES, WHICH WILL REMAIN UN-WORKED FOR A PERIOD OF MORE THAN 14-CONSECUTIVE CALENDAR DAYS. THESE MEASURES SHALL REMAIN IN PLACE UNTIL SITE HAS STABILIZED.
- 9. SITE DE-WATERING: WATER PUMPED FROM THE SITE SHALL BE TREATED BY TEMPORARY SEDIMENTATION BASINS OR OTHER APPROPRIATE CONTROL MEASURES. SEDIMENTATION BASINS SHALL HAVE A DEPTH OF AT LEAST 3 FEET, BE SURROUNDED BY SKOWERNCE OR EQUIVALENT BARRIER AND HAVE SUFFICIENT SURFACE RACE AT O PROVIDE A SURFACE SETTLING RATE OF NO MORE THAN 750 GALLONS PER SOLDAR FOOT PER DAY AT THE HIGHEST DEWATERING PUMPING RATE. WATER MAY NOT BE DISCHARGED IN A MANNER THAT CAUSES EROSION OF THE SITE, A NEIGHBORING SITE, OR THE BED OR BANKS OF THE RECEIVENOW WATER. POLYMERS MAY BE USED AS DIRECTED BY DON'T EICHNICAL STANDARD 1061 (DE-WATERING) (DE-WATERING)
- O. WASHED STONE WEEPERS OR TEMPORARY EARTH BERMS SHALL BE BUILT PER PLAN BY CONTRACTOR TO TRAP SEDIMENT OR SLOW THE VELOCITY OF STORM WATER.
- 11. INLET FILTERS ARE TO BE PLACED IN STORMWATER INLET STRUCTURES AS SOON AS THEY ARE INSTALLED. ALL PROJECT AREA STORM INLETS NEED WISCONSIN D.O.T. TYPE D INLET PROTECTION. THE FILTERS SHALL BE MAINTAINED UNTIL THE CITY HAS ACCEPTED THE BINDER COURSE OF ASPHALT
- 12. RESTORATION (SEED, FERTILIZE AND MULCH) SHALL BE PER SPECIFICATIONS ON THIS SHEET UNLESS SPECIAL RESTORATION IS CALLED FOR ON THE LANDSCAPE PLAN OR THE DETENTION BASIN DETAIL SHEET.
- 13. SEED, FERTILIZER AND MULCH SHALL BE APPLIED WITHIN 7 DAYS AFTER FINAL GRADE HAS BEEN ESTABLISHED. IF DISTURBED AREAS WILL NOT BE RESTORED IMMEDIATELY AFTER ROUGH GRADING, TEMPORARY SEED SHALL BE PLACED.
- 14. FOR THE FIRST SIX WEEKS AFTER RESTORATION (E.G. SEED & MULCH, EROSION MAT, SOD) OF A DISTURBED AREA, INCLUDE SUMMER WATERING PROVISIONS OF ALL NEWLY SEEDED AND MULCHED AREAS WHENEVER 7 DAYS ELAPSE WITHOUT A RAIN EVENT.
- 16. SOIL STABILIZERS SHALL BE APPLIED TO DISTURBED AREAS WITH SLOPES BETWEEN 10% AND 3:1 (DO NOT USE IN CHANNELS). SOIL STABILIZERS SHALL BE TYPE B, PER WISCONSIN D.O.T. P.A.L. (PRODUCT ACCEPTABILITY LIST), OR EQUAL. APPLY AT RATES AND METHODS SPECIFIED PER THIS SHEET. SOIL STABILIZERS SHALL BE RE-APPLIED WHENEVER VEHICLES OR OTHER EQUIPMENT TRACK ON THE AREA.
- 17. SILT FENCE TO BE USED ACROSS AREAS OF THE LOT THAT SLOPE TOWARDS A PUBLIC STREET OR WATERWAY. SEE DETAILS
- 18. SEDIMENT SHALL BE CLEANED FROM CURB AND GUTTER AFTER EACH RAINFALL AND PRIOR TO PROJECT ACCEPTANCE
- 19. ACCUMULATED CONSTRUCTION SEDIMENT SHALL BE REMOVED FROM ALL PERMANENT BASINS TO THE ELEVATION SHOWN ON THE GRADING PLAN FOLLOWING THE STABILIZATION OF DRAINAGE AREAS.
- 20. ALL CONSTRUCTION ENTRANCES SHALL HAVE TEMPORARY ROAD CLOSED SIGNS THAT WILL BE IN PLACE WHEN THE ENTRANCE IS NOT IN USE AND AT THE END OF EACH DAY.
- 21. ANY PROPOSED CHANGES TO THE EROSION CONTROL PLAN MUST BE SUBMITTED AND APPROVED BY DANE COUNTY LAND CONSERVATION OR PERMITTING MUNICIPALITY.
- 22. THE CITY, OWNER AND/OR ENGINEER MAY REQUIRE ADDITIONAL EROSION CONTROL MEASURES AT ANY TIME DURING CONSTRUCTION

CONSTRUCTION SEQUENCE:

- INSTALL SILT FENCE AND TRACKING
 PAD
- 2. STRIP TOPSOIL-DETENTION BASINS
- 3. ROUGH GRADE DETENTION BASINS
- 4. SEED DETENTION BASINS
- 5. STRIP TOPSOIL-STREETS & LOTS
- SEED LOT AREAS AND INSTALL DRIVE-OVER VELOCITY CHECKS
- 8. CONSTRUCT UNDERGROUND UTILITIES
- 9. INSTALL INLET PROTECTION
- 10. CONSTRUCT ROADS (STONE BASE, CURB & GUTTER, AND SIDEWALK). REMOVE DRIVE-OVER VELOCITY CHECKS WHEN BASE COURSE IS PLACED
- 12. REMOVE TRACKING PAD, SILT FENCE AND DIVERSION BERM MEASURES AFTER DISTURBED AREAS ARE RESTORED

SEEDING RATES:

- TEMPORARY:

 1. USE ANNUAL OATS AT 3.0 LB./1,000 S.F. FOR SPRING AND SUMMER PLANTINGS.

 2. CALL 3.0 LB./1,000 S.F. FOR SPRING AND SUMMER PLANTINGS.
- USE WINTER WHEAT OR RYE AT 3.0 LB./1,000 SF FOR FALL PLANTINGS STARTED


AFTER SEPTEMBER 15.

PERMANENT:
1. USE WISCONSIN D.O.T. SEED MIX #40 AT 2 LB./1,000 S.F. FERTILIZING RATES:

TEMPORARY AND PERMANENT: USE WISCONSIN D.O.T. TYPE A OR B AT 7 LB./1,000 S.F.


MULCHING RATES:


IEMPORARY AND PERHAMENT: USE OF TO 1-2" STRAW OR HAY MULCH, CRIMPED PER SECTION 80-73.2.3, OR OTHER RATE AND METHOD PER SECTION 627, USECNISM D.O.1. STANDARD SPECIFICATIONS FOR HIGHWAY AND STRUCTURE CONSTRUCTION.

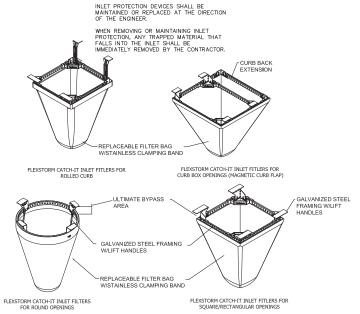



NEENAH CASTING	INLET TYPE	GRATE SIZE	OPENING SIZE	ADS P/N
1040/1642/1733	ROUND	26	24	62MRDFX
3067 W/FLAP	CURB BOX	35.25 X 17.75	33.0 X 15.0	62LCBEXTFX
3067 EXTENDED BACK	CURB BOX	35.25 X 17.75	33.0 X 15.0	62LCBEXTFX
3246A	CURB BOX	35.75 X 23.875	33.5 X 21.0	62LCBFX
3030	SQUARE/RECT	23 X 16	20.5 X 13.5	62MCBFX
3067-C	SQUARE/RECT	35.25 X 17.75	33 X 15	62LSQFX



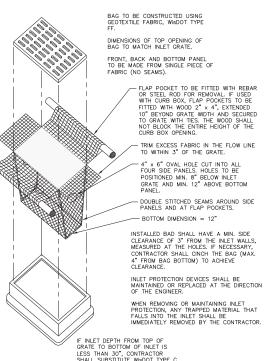

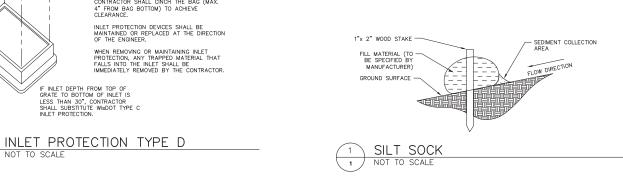


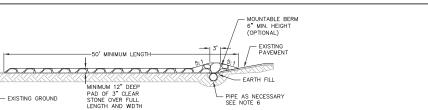

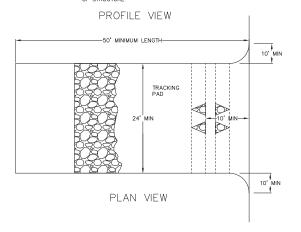

- 1. FOLLOW WISCONSIN DNR TECHNICAL STANDARD 1057 FOR FURTHER DETAILS AND INSTALLATION.
- 3. WIDTH 24' MINIMUM, SHOULD BE FLARED AT THE EXISTING ROAD TO PROVIDE A TURNING RADIUS.
- 4. ON SITES WITH A HIGH GROUND WATER TABLE OR WHERE SATURATED CONDITIONS EXIST, GEOTEXTILE FABRIC SHALL BE PLACED OVER EXISTING GROUND PRIOR TO PLACING STONE. FABRIC SHALL BE WISDOT TYPE—HR GEOTEXTILE FABRIC.
- 5. STONE CRUSHED 3" CLEAR STONE SHALL BE PLACED AT LEAST 12" DEEP OVER THE ENTIRE LENGTH AND WIDTH OF ENTRANCE.
- 6. SURFACE WATER ALL SURFACE WATER FLOWING TO OR DIVERTED TOWARDS CONSTRUCTION ENTRANCES SHALL BE PIPED THROUGH THE ENTRANCE. MAINTAINING POSITIVE DRAINAGE. PIPE INSTALLED THROUGH THE STABILIZED CONSTRUCTION ENTRANCE SHALL BE PROTECTED WITH A MOUNTABLE BERM WITH 5:1 SLOPES AND MINIMUM OF 6" STORD OVER THE PIPE. PIPE SHALL BE SIZED ACCORDING TO THE DRAINAGE REQUIREMENTS. WHEN THE ENTRANCE IS LOCATED AT A HIGH SPOT AND HAS NO DRAINAGE TO CONVEY A PIPE SHALL NOT BE NECESSARY. THE MINIMUM PIPE DIAMETER SHALL BE 6". CONTRACTOR SHALL BE RESPONSIBLED THE MAINTENANCE OF SAID PIPE.
- LOCATION A STABILIZED CONSTRUCTION ENTRANCE SHALL BE LOCATED WHERE CONSTRUCTION TRAFFIC ENTERS AND/OR LEAVES
 THE CONSTRUCTION SITE. VEHICLES LEAVING THE SITE MUST TRAVEL OVER THE ENTIRE LENGTH OF THE TRACKING PAD.



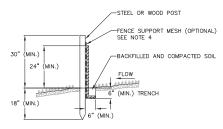

- INSTALL SILT FENCE TO FOLLOW THE GROUND CONTOURS AS CLOSELY AS POSSIBLE.
- CURVE THE SILT FENCE UP THE SLOPE TO PREVENT WATER FROM RUNNING AROUND THE ENDS.
- 3. POST SPACING WITH FENCE SUPPORT MESH = 10 FT. (MAX.)POST SPACING WITHOUT FENCE SUPPORT MESH = 6 FT. (MAX.)
- 4. SILT FENCE SUPPORT MESH CONSISTS OF 14-GAUGE STEEL WIRE WITH A MESH SPACING OF 6 IN, X 6 IN, OR PREFABRICATED POLYMERIC MESH OF EQUIVALENT STRENGTH



CITY OF MADISON UDC

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Mortenson

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SUBMITTAL SCOPE DOCUMENTS

MAY 29, 2019

Revisions

UW CAMPUS HOTEL

760 Regent Street Madlson, WI 53715


Project No. Mortensor 218051

Sheet Title


CONSTRUCTION **DETAILS**

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Sheet No. C500




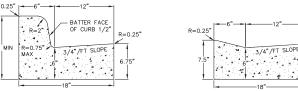

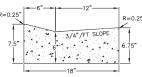

DRIVEWAY GUTTER CROSS SECTION




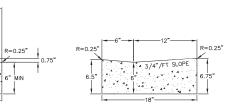


CURB AND GUTTER REJECT SECTION

HANDICAP RAMP GUTTER CROSS SECTION




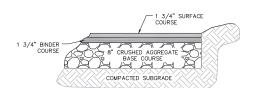


LIGHT DUTY ASPHALT PAVEMENT

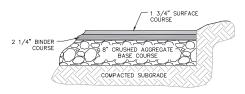


HEAVY DUTY ASPHALT PAVEMENT

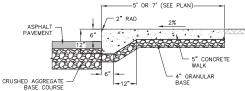




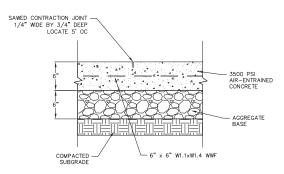



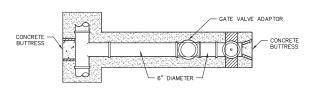

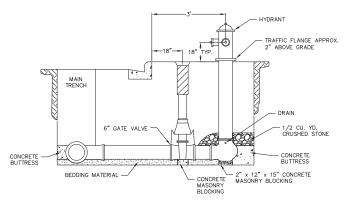





Revisions

CITY OF MADISON UDC SUBMITTAL

SCOPE DOCUMENTS

MAY 29, 2019

UW CAMPUS HOTEL

760 Regent Street Madlson, WI 53715

Project No.

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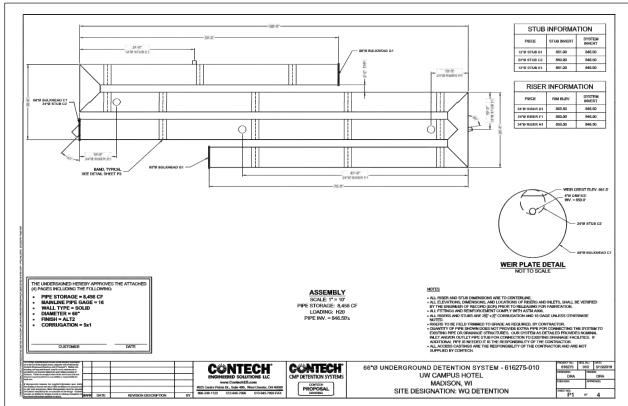
CONSTRUCTION **DETAILS**


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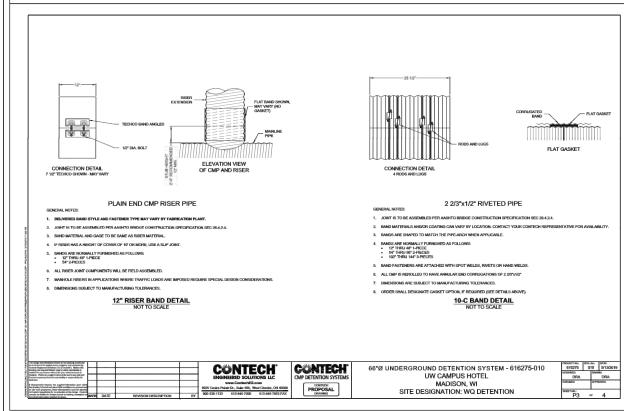
44 East Mifth Street, Suite 700, Madison, Wisconsin 53703 Telephone 608.283.6300 Fax 608.283.6317 Sheet No.


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SCOPE DOCUMENTS

Drawing Date MAY 29, 2019

UW CAMPUS HOTEL

760 Regent Street Madlson, WI 53715

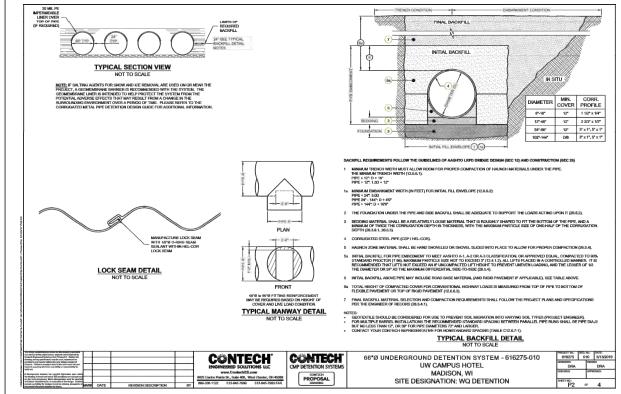Project No. Mortens
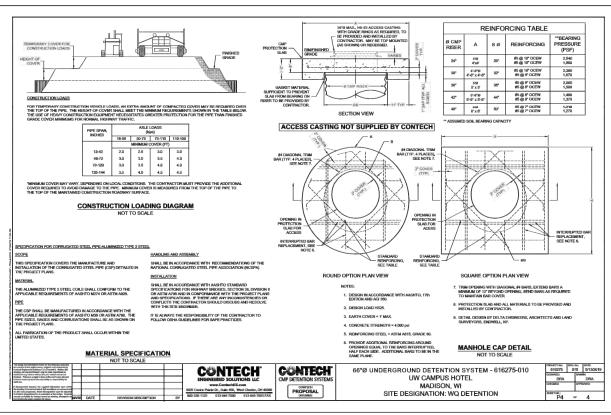
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CONSTRUCTION DETAILS

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Sheet No.

C502



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PLANT SCHEDULE						
DECIDUOUS TREES CO	BOTANICAL NAME / COMMON NAME Celts occidentalis / Common Hackberry	CONT B & B	CAL 2.5"Cal		QTY 1	
GT GD	40-60' x 40-60' Gleditsia triacanthos `Northern Acclaim' / Northern Acclaim Honeylocust Gymnocladus diolca `McKBranched' / Decaf Kentucky Coffee Tree	B & B B & B	2.5"Cal 2.5"Cal		5 1	
OV	50` x 40` Ostrya virginiana / American Hophornbeam 25` x 15`	B & B	2.5"Cal		4	
EXISTING TREES Ex Gt	BOTANICAL NAME / COMMON NAME Gleditsia triacanthos / Honey Locust	CONT Existing	CAL 6"		QTY 2	
UNDERSTORY TREES MP	BOTANICAL NAME / COMMON NAME Malus x `Prairie Maid` / Prairie Maid Crabapple 20` x 25`	CONT B & B	CAL 2"Cal		QTY 2	
SR	Syringa reticulata `Ivory Silk` / Ivory Silk Japanese Tree Lilac 25` x 15`	B & B	2"Cal		3	
DECIDUOUS SHRUBS	BOTANICAL NAME / COMMON NAME Diervilla lonicera / Dwarf Bush Honeysuckle 3-4 x 4-5	SIZE 5 gal	FIELD2 Cont		QTY 5	
На	Hydrangea arborescens `Annabelle` / Annabelle Smooth Hydrangea 4` x 4-5`	3 gal	24" ht.		14	
Нр	Hydrangea paniculata 'Jane' / Little Lime Hydrangea 3-5' x 3-5'	5 gal	Cont		20	
Rf	Rhamnus frangula `Fine Line` / Fine Line Buckthom 5-7` x 2`	5 gal	Cont		64	
Ra	Rhus aromatica `Gro-Low` / Gro-Low Fragrant Sumac 2-3` x 6-8`	5 gal	Cont		15	
Sf	Spiraea fritschiana `Pink-a-licious` / Pink-a-licious Fritch Spirea 2-3` x 2-3`	3 gal	Cont		13	
Vc	2-3 x 2-3 Viburnum cassinoides / Witherod Viburnum 5-6` x 5-6`	5 gal	Cont		8	
EVERGREEN SHRUBS Bs	BOTANICAL NAME / COMMON NAME Buxus sinica insularis `Wintergreen` / Wintergreen Korean Littleleaf Boxwood 3-4` x 3-4`	SIZE 5 gal	FIELD2 Cont		<u>QTY</u> 20	
JF	Juniperus chinensis `Fairview` / Fairview Juniper 15-20` x 6-7`	B & B	6' ht.		2	
Jh	Juniperus horizontalis 'Blue Chip' / Blue Chip Juniper	5 gal	Cont		52	
Js	8-10" x 6-8' Juniperus sabina `Blue Forest` / Blue Forest Juniper 12" x 3-4'	3 gal	Cont		20	
Te	Taxus x medla 'Everlow' / Everlow Yew	5 gal	Cont		31	
Tm	2-3` x 4-5` Taxus x medla `Hicksll` / Hicks Yew	10 gal	Cont		2	
То	6-15` x 4-6` Thuja occidentalls `Hetz Midget` / Hetz Midget Arborvitae	5 gal	24" ht.		11	
Th	2-3' x 2-3' Thuja occidentalis `Holmstrup` / Holmstrup Cedar 12-16' x 2-4'	10 gal	6' ht.		10	
PERENNIALS ar	BOTANICAL NAME / COMMON NAME Ajuga reptans "Chocolate Chip" / Chocolate Chip Carpet Bugle 4-10" x 18"	SIZE 4" pot	FIELD2		<u>QTY</u> 56	
ax	Amsonia x `Blue Ice` / Blue Ice Star Flower 18" x 20"	4" pot	Cont		84	
ca	Calamagrostis x acutiflora `Karl Foerster` / Feather Reed Grass 3-5` x 2`	1 gal	Cont		247	
d	Chasmanthium latifolium / Northern Sea Oats 30-36" x 12-18"	1 gal	Cont		103	
cv	Coreopsis verticillata `Zagreb` / Zagreb Thread Leaf Coreopsis	4" pot	Cont		17	
hbt	12-18" x 18" Heuchera x `Berry Timeless` / Coral Bells	4" pot	Cont		21	
ham	8-10" x 20" Hosta x `August Moon` / Plantain Lily	1 gal	Cont		28	
po	20" x 24-30" Polystichum acrostichoides / Christmas Fern	1 gal	Cont		57	
sh	1-3' Sporobolus heterolepis / Prairie Dropseed 2' x 18"	1 gal	Cont		305	
GROUND COVERS	BOTANICAL NAME / COMMON NAME	CONT	FIELD2	SPACING	QTY	
<u> </u>	OTHER STATE OF THE PARTY OF THE	00.41	· ILLUZ	517101110	9.11	
	Vinca minor `Bowles` / Bowles` Common Periwinkle 6" ht.	flat	2" pot	12" o.c.	151 sf	



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SEEDING/DECORATIVE PAVING SCHEDULE

COMPACTED CRUSHED GRANITE 2,214 sf

- CENERAL NOTES:

 1. All plantings shall conform to quality requirements as per ANSI Z60.1.

 2. All plant materials shall be true to the species, variety and size specified, nursery grown in accordance with good horticultural practices, and under climactic conditions similar to those of the project site.

 3. Contact Landscape Architect, in writing, to request and plant material substitutions due to availability issues.

 4. All disturbed areas, unless otherwise noted, to be solded with kentucky bluegrass tuf sod grown in soil.

 5. All plants shall be guaranteed to be in healthy and flourishing condition during the growing season following installation. All plant materials shall be guaranteed for one year from the time of installation.

 6. Contractor shall provide a suitable amended topsoil blend for all planting areas where soil conditions are unsuitable for plant growth. Topsoil shall conform to quality requirements as per Section 625.2(1) of the Standard Specifications for Highway Construction. Provide a minimum of 12" of topsoil in all planting areas and 6" of topsoil in areas to be seeded/sodded.

 7. Landscape beds to be mulched with stredded hardwood bark mulch to 3" depth min., and edged with commercial grade aluminum landscape edging. Permaloc Cleanline \(\frac{1}{16}\) "x 4" or equal, color black anodized.

City of Madison Landscape We	orksheet								
Address:	760 Regent St		Date:	05.03.2019					
Total Square Footage of Developed Area:	(Site Area)	51737	-	(Building Footprint at Grade)		38023	-	13714	sf
Total Landscape Points Required:		13,714	/ 300 =	46	x 5 =	229			
			Credits/ Existing Landscaping		New/ Proposed Landscaping				
Plant Type/ Element	Min. Size at Installation	Points	Quantity	Points Achieved	Quantity	Points Achieved			
Overstory deciduous tree	2.5" cal	35		0	2	70			
Tall Evergreen Tree	5-6 feet tall	35		0		0			
Ornamental tree	1.5" cal	15		0	3	45			
Upright evergreen shrub	3-4 feet tall	10		0	7	70			
Shrub, deciduous	#3 gallon container size, Min. 12-24"	3		0	82	246			
Shrub, evergreen	#3 gallon container size, Min. 12-24"	4		0	53	212			
Ornamental grasses/perennials	#1 gallon container size, Min. 8-18"	2		0	254	508			
Ornamental/decorative fencing or wall	n/a	4 per 10 LF		0		0			
Existing significant specimen tree	Min. Size 2.5" cal. Trees must be within developed area and cannot comprise more than 30% of total required points.	14 per caliper inch. Max. points per tree: 200		0		0			
Landscape Furniture for public seating and/or transit connections	Furniture must be within developed area, publicly accessible, and cannot comprise more than 5% of total required points	5 points per "seat"		0	6	30			
Sub Totals				0		1181			
			Total P	oints Provided:	1181				Г

CITY OF MADISON UDC

SCOPE DOCUMENTS Drawing Date MAY 29, 2019

UW CAMPUS HOTEL


760 Regent Street Madlson, WI 53715

218051 Sheet Title

LANDSCAPE PLAN

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Mortenson

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SCOPE DOCUMENTS

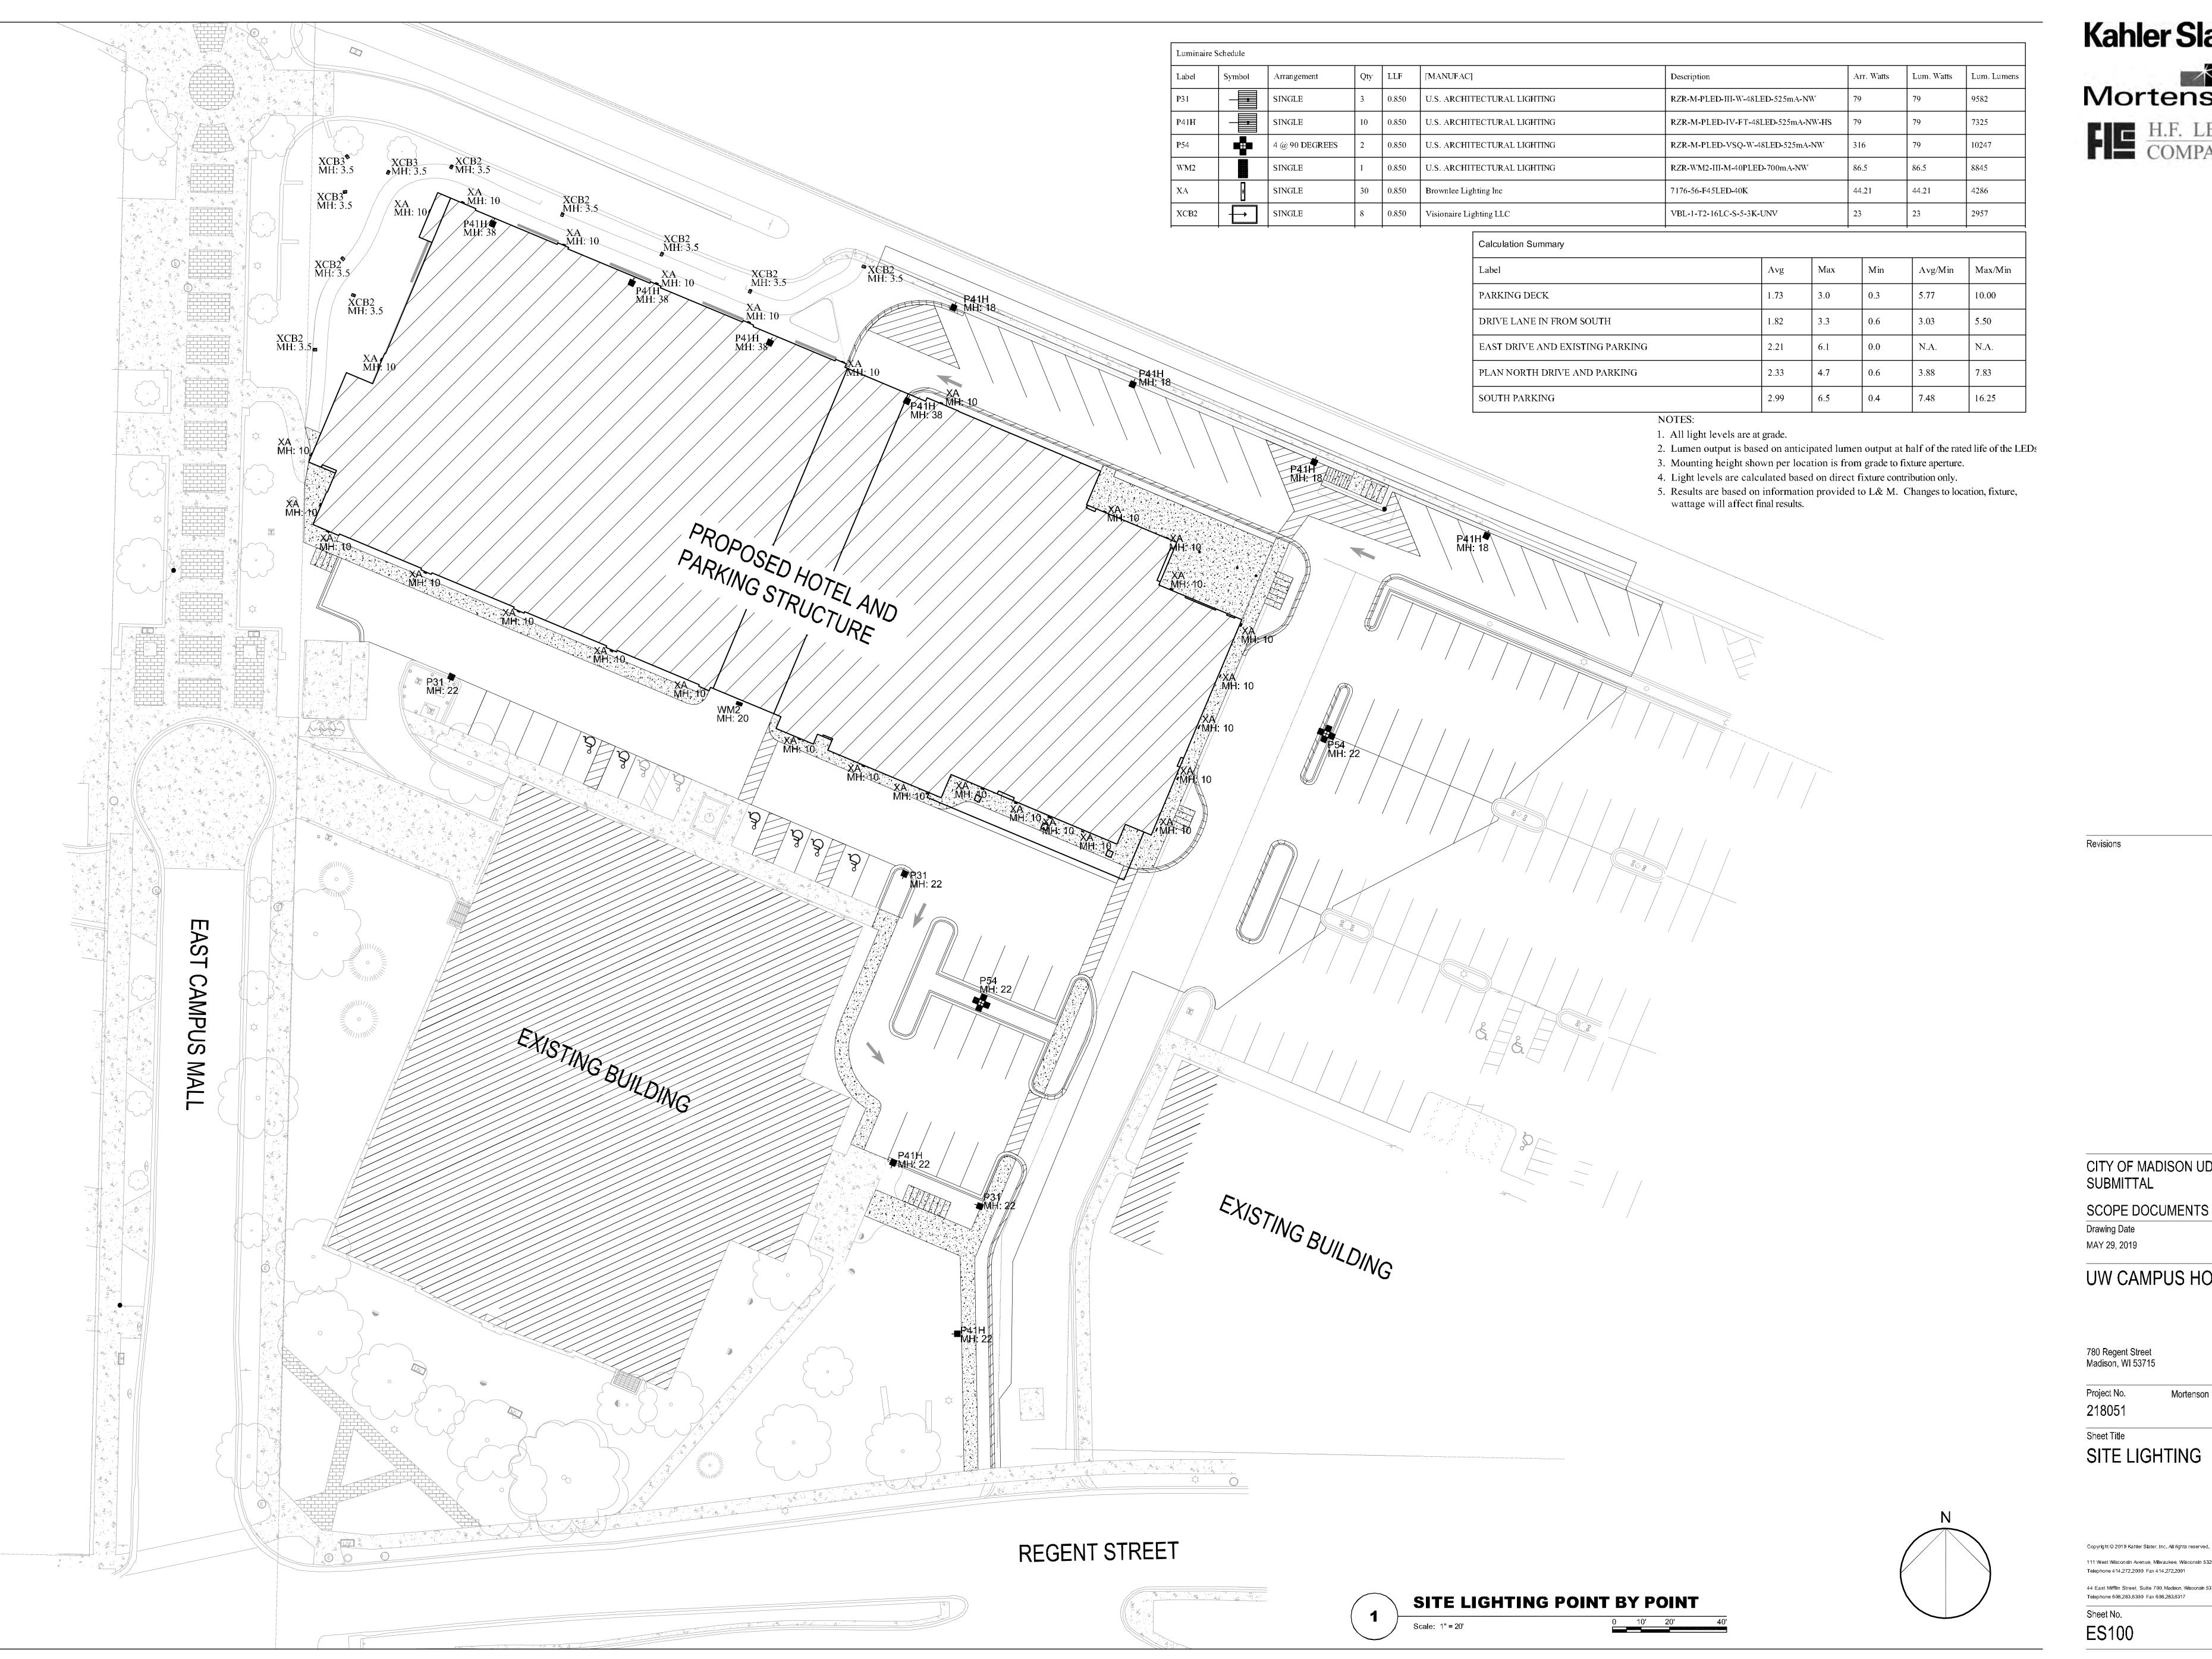UW CAMPUS HOTEL

780 Regent Street Madison, WI 53715

218051


Sheet Title SITE LIGHTING

111 West Wisconsin Avenue, Milwaukee, Wisconsin 53203

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UW CAMPUS HOTEL

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SITE LIGHTING POINT BY POINT

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SITE LIGHTING POINT BY POINT

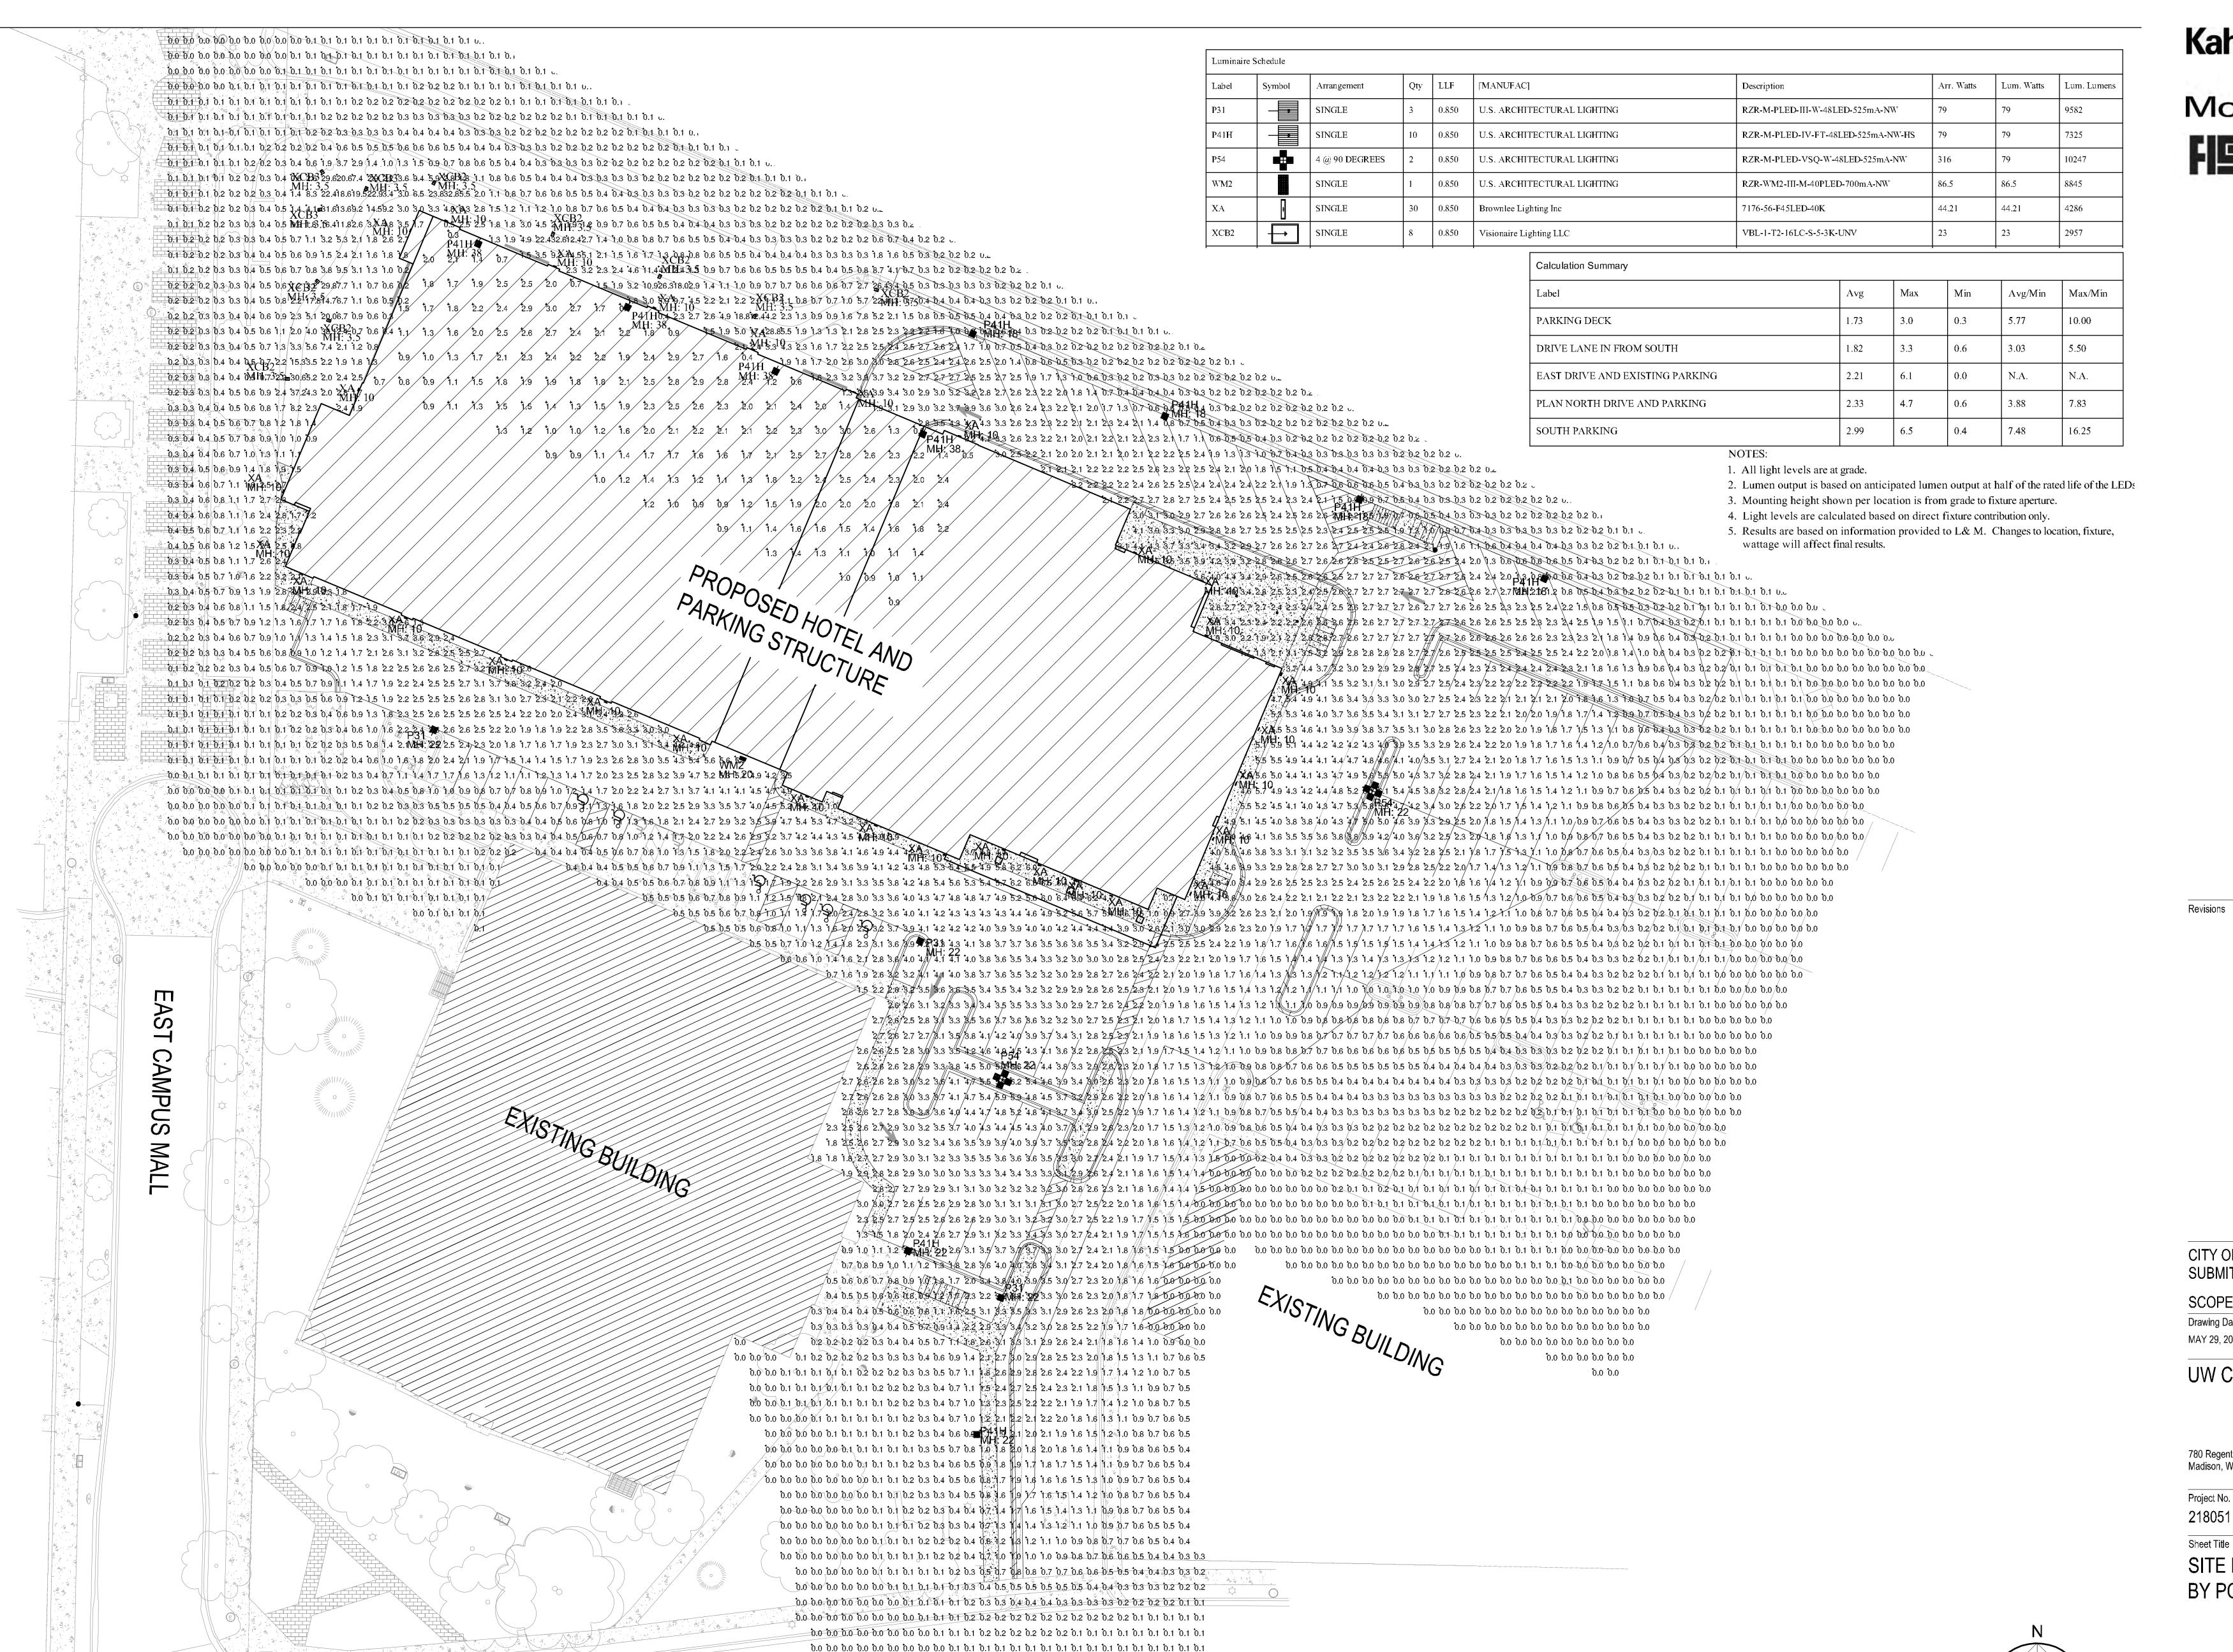Scale: 1" = 20'