
GENERAL CONSTRUCTION NOTES

- WORK SHALL BE IN ACCORDANCE WITH APPLICABLE BUILDING CODES AND COMPLY WITH ALL GOVERNING LAWS, CODES, ORDINANCES, RULES AND REGULATIONS OF THE STATE AND GENERAL JURISDICTION
- THE DRAWINGS ARE NOT TO BE SCALED FOR INFORMATION CONCERNING EXISTING CONDITIONS, VERIFY IN FIELD.
- VERIFY DIMENSIONS AND EXISTING CONDITIONS. IMMEDIATELY NOTIFY
- THE ARCHITECT OF ANY DISCREPANCIES.
 USE MEANS NECESSARY TO PREVENT DUST FROM BECOMING A NUISANCE TO THE PUBLIC, NEIGHBORS, AND OTHER WORK BEING PERFORMED ON
- MAINTAIN ACCESS TO ADJACENT AREAS OF THE BUILDING AT ALL TIMES.
- VERIFY AND COORDINATE DIMENSIONS OF FIXTURES AND EQUIPMENT INCLUDING ITEMS SUPPLIED AND/OR INSTALLED BY OTHERS, PRIOR TO
- ALL PENETRATIONS IN WALL REQUIRING PROTECTED OPENINGS SHALL BE FIRE-STOPPED USING UL TESTED OR EQUIVALENT TESTING AGENT MATERIALS AND METHODS
- DIMENSIONS FOR NEW INTERIOR STUD WALLS ARE DIMENSIONED FROM FACE OF STUD TO FACE OF STUD OR FROM FACE OF STUD TO EXISTING FINISH FACE (U.N.O.).
- ALL NEW PARTITIONS TO BE 3-5/8" METAL STUDS WITH 5/8" GWB EACH SIDE OR MOISTURE RESISTANT GWB IN BATHROOMS.
- PROVIDE CONCEALED WOOD/STEEL BLOCKING FOR WALL SUPPORTED ITEMS.
- CONTRACTOR SHALL PATCH EXISTING FLOOR/WALL/CEILING PENETRATIONS TO MAINTAIN WALL RATINGS.
- PATCH FLOORS/WALLS WHERE EXISTING WALLS AND/OR PARTITIONS HAVE
- ALL ELECTRICAL WORK, LIGHTING & LIGHTING PLAN TO BE COORDINATED
- REFER TO ROOM FINISH SCHEDULE FOR MATERIALS, COLOR SELECTIONS. **NEW CEILING LOCATIONS & HEIGHTS.**
- REFER TO DOOR SCHEDULE FOR DOOR & FRAME TYPES.
- CENTER FLOORING TRANSITIONS UNDER DOOR IN CLOSED POSITION (U.N.O.).
- REFER TO DOOR SCHEDULE FOR DOOR & FRAME TYPES.
- CENTER FLOORING TRANSITIONS UNDER DOOR IN CLOSED POSITION (U.N.O.)
- ALL NEW SINGLE SWING DOORS TO BE 3'-0" WIDE, DOUBLE DOOR TO HAVE A CLEAR OPENING OF 32" FOR AT LEAST ONE ACTIVE LEAF (ANSI 404.2.1) AND FEATURE ADA APPROVED HARDWARE.
- ALL NEW DOORS TO BE FLUSH WOOD DOOR WITH HOLLOW METAL FRAMES (U.N.O.) SIZE & FINISH PER DOOR SCHEDULE.
- ALL NEW DOOR HARDWARE TO BE COORDINATED WITH OWNER. ALL PUBLIC ACCESS DOORS ALONG THE ACCESSIBLE ROUTE TO HAVE 32" CLEAR OPENING AND ADA HARDWARE.
- SEE TYPICAL DOOR JAMB DETAIL FOR DOORS JUSTIFIED HINGE SIDE TO ADJACENT WALL.
- SEE SECTIONS FOR EXTERIOR WALL TYPES


ARCHITECTURAL SYMBOLS LEGEND

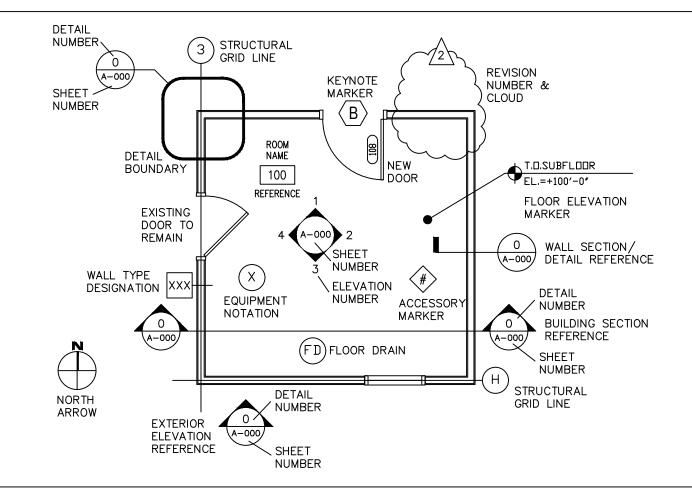

PROJECT LOCATION CITY / AREA MAP

PROJECT SCOPE

EXHIBIT "B"

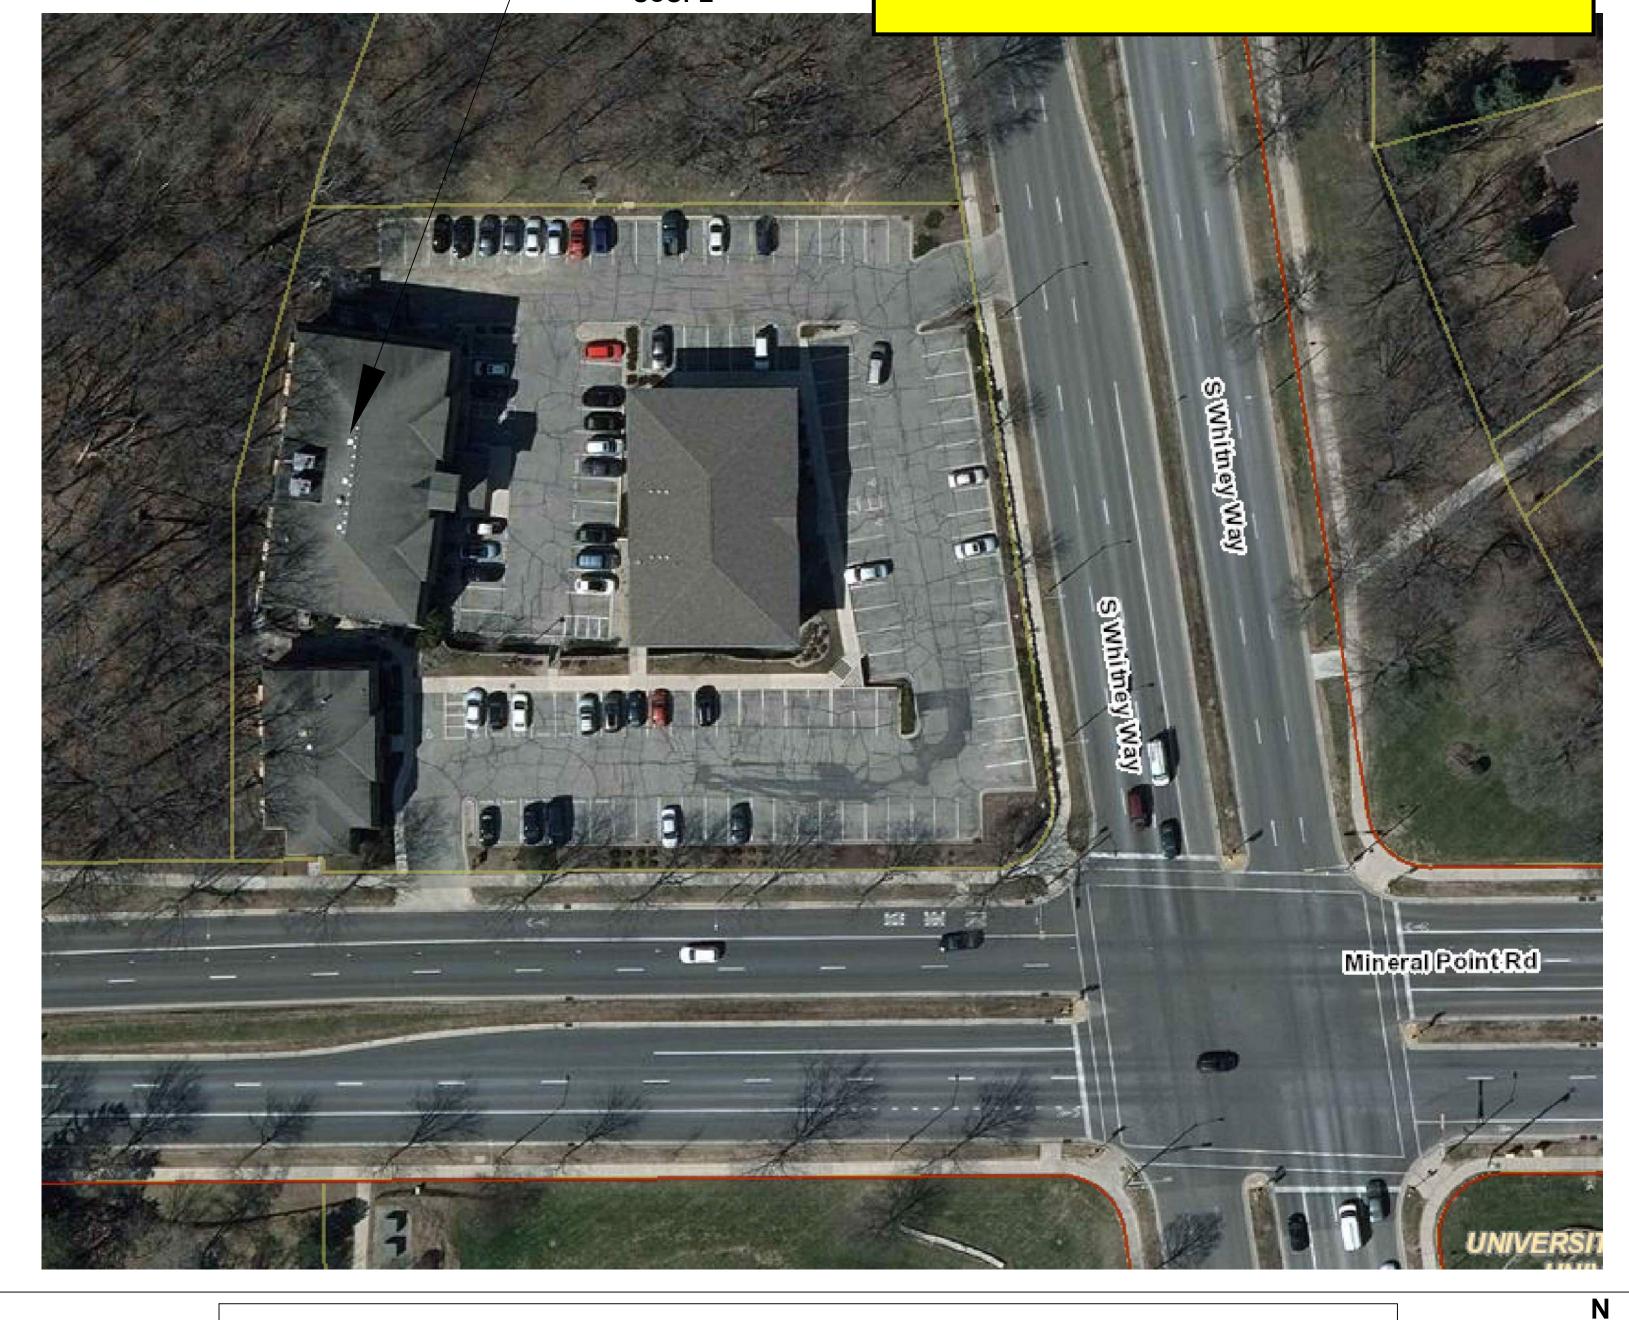

SITE PLAN LAND USE SUMMARY

STIE AREA: LOT 1 51,213 SF, 1.176 ACRES OPEN SPACE 13,661 SF **BUILDING FOOTPRINT:** 15.690 SF REQUIRED = 10,880 SF **BUILDING SF:**

15,690 SF LOWER LEVEL 15,323 SF FIRST FLOOR 15,323 SF SECOND FLOOR 15,323 SF THIRD FLOOR 61,659 SF TOTAL SF

LOT COVERAGE: LOT SF 51,213 -15,690 SF LESS BUILDING LESS PAVED AREA -20,945 SF

71.5% IMPERVIOUS

PROJECT INFORMATION

WHITNEY POINT APARTMENTS 5402 S. WHITNEY WAY MADISON, WI 53705

CODE SUMMARY

BUILDING OCCUPANCY- R2 RESIDENTIAL CONSTRUCTION TYPE VB & 1A PARKING LEVEL **EXISTING SPRINKLER = NFPA 13**

APPLICABLE CODE-2015 INTERNATIONAL BUILDING CODE

SCOPE OF WORK: LOWER LEVEL PARKING

FIRST FLOOR UNITS SECOND FLOOR UNITS THIRD FLOOR UNITS

PROJECT SQUARE FOOTAGE SCOPE:

LOWER LEVEL PARKING SF = 15,690 SF FIRST FLOOR SF = 15,323 SF SECOND FLOOR SF = 15.323 SF THIRD FLOOR SF = 15,323 SF TOTAL BUILDING SF = 61,659 SF

LOT SQUARE FOOTAGE = 51,213 SF

NEW MECHANICAL, PLUMBING, ELECTRICAL ELEVATOR, FIRE ALARMS & SYSTEMS TO BE **DESIGN BUILD**

OCCUPANCY SUMMARY

UNIT TYPE QUANTITY PER FLOOR 1ST FLR 2ND FLR 3RD FLR 1 BEDROOM UNITS 2 BEDROOM UNITS STUDIO UNITS

TOTAL UNITS

(48) UNITS TOTAL

1 BEDROOM - 25 UNITS 2 BEDROOM - 20 UNITS STUDIO UNITS - 3

CONTACT INFORMATION

GENERAL CONTRACTOR:

TRI-NORTH BUILDERS 2525 RESEARCH PARK DRIVE FITCHBURG, WI 53711

SHEET INDEX

T-100 TITLE SHEET

TOPO EXISTING SURVEY PLAN C-1.0 DEMOLITION PLAN

C-2.0 LAYOUT PLAN C-3.0 GRADING PLAN

C-4.0 EROSION CONTROL PLAN C-5.0 UTILITY PLAN

C-6.0 FIRE ACCESS PLAN L-100 LANDSCAPE PLAN

L-101 COLORED SITE PLAN

A-100 LOWER LEVEL PARKING GARAGE A-101 FIRST LEVEL FLOOR PLAN

A-102 SECOND & THIRD LEVEL FLOOR PLANS A-103 UNIT FLOOR PLANS- TYPICALS

A-104 WALL TYPES & DETAILS

A-104.1WALL TYPES & DETAILS A-105 EXTERIOR ELEVATIONS

A-106 NOT USED A-107 ROOF PLAN

A-108 EXTERIOR RENDERING


A-109 EXISTING EXTERIOR BUILDING IMAGES

WHITNEY POINT APARTMENTS 5402 S. WHITNEY WAY MADISON, WI 53705

TITLE SHEET


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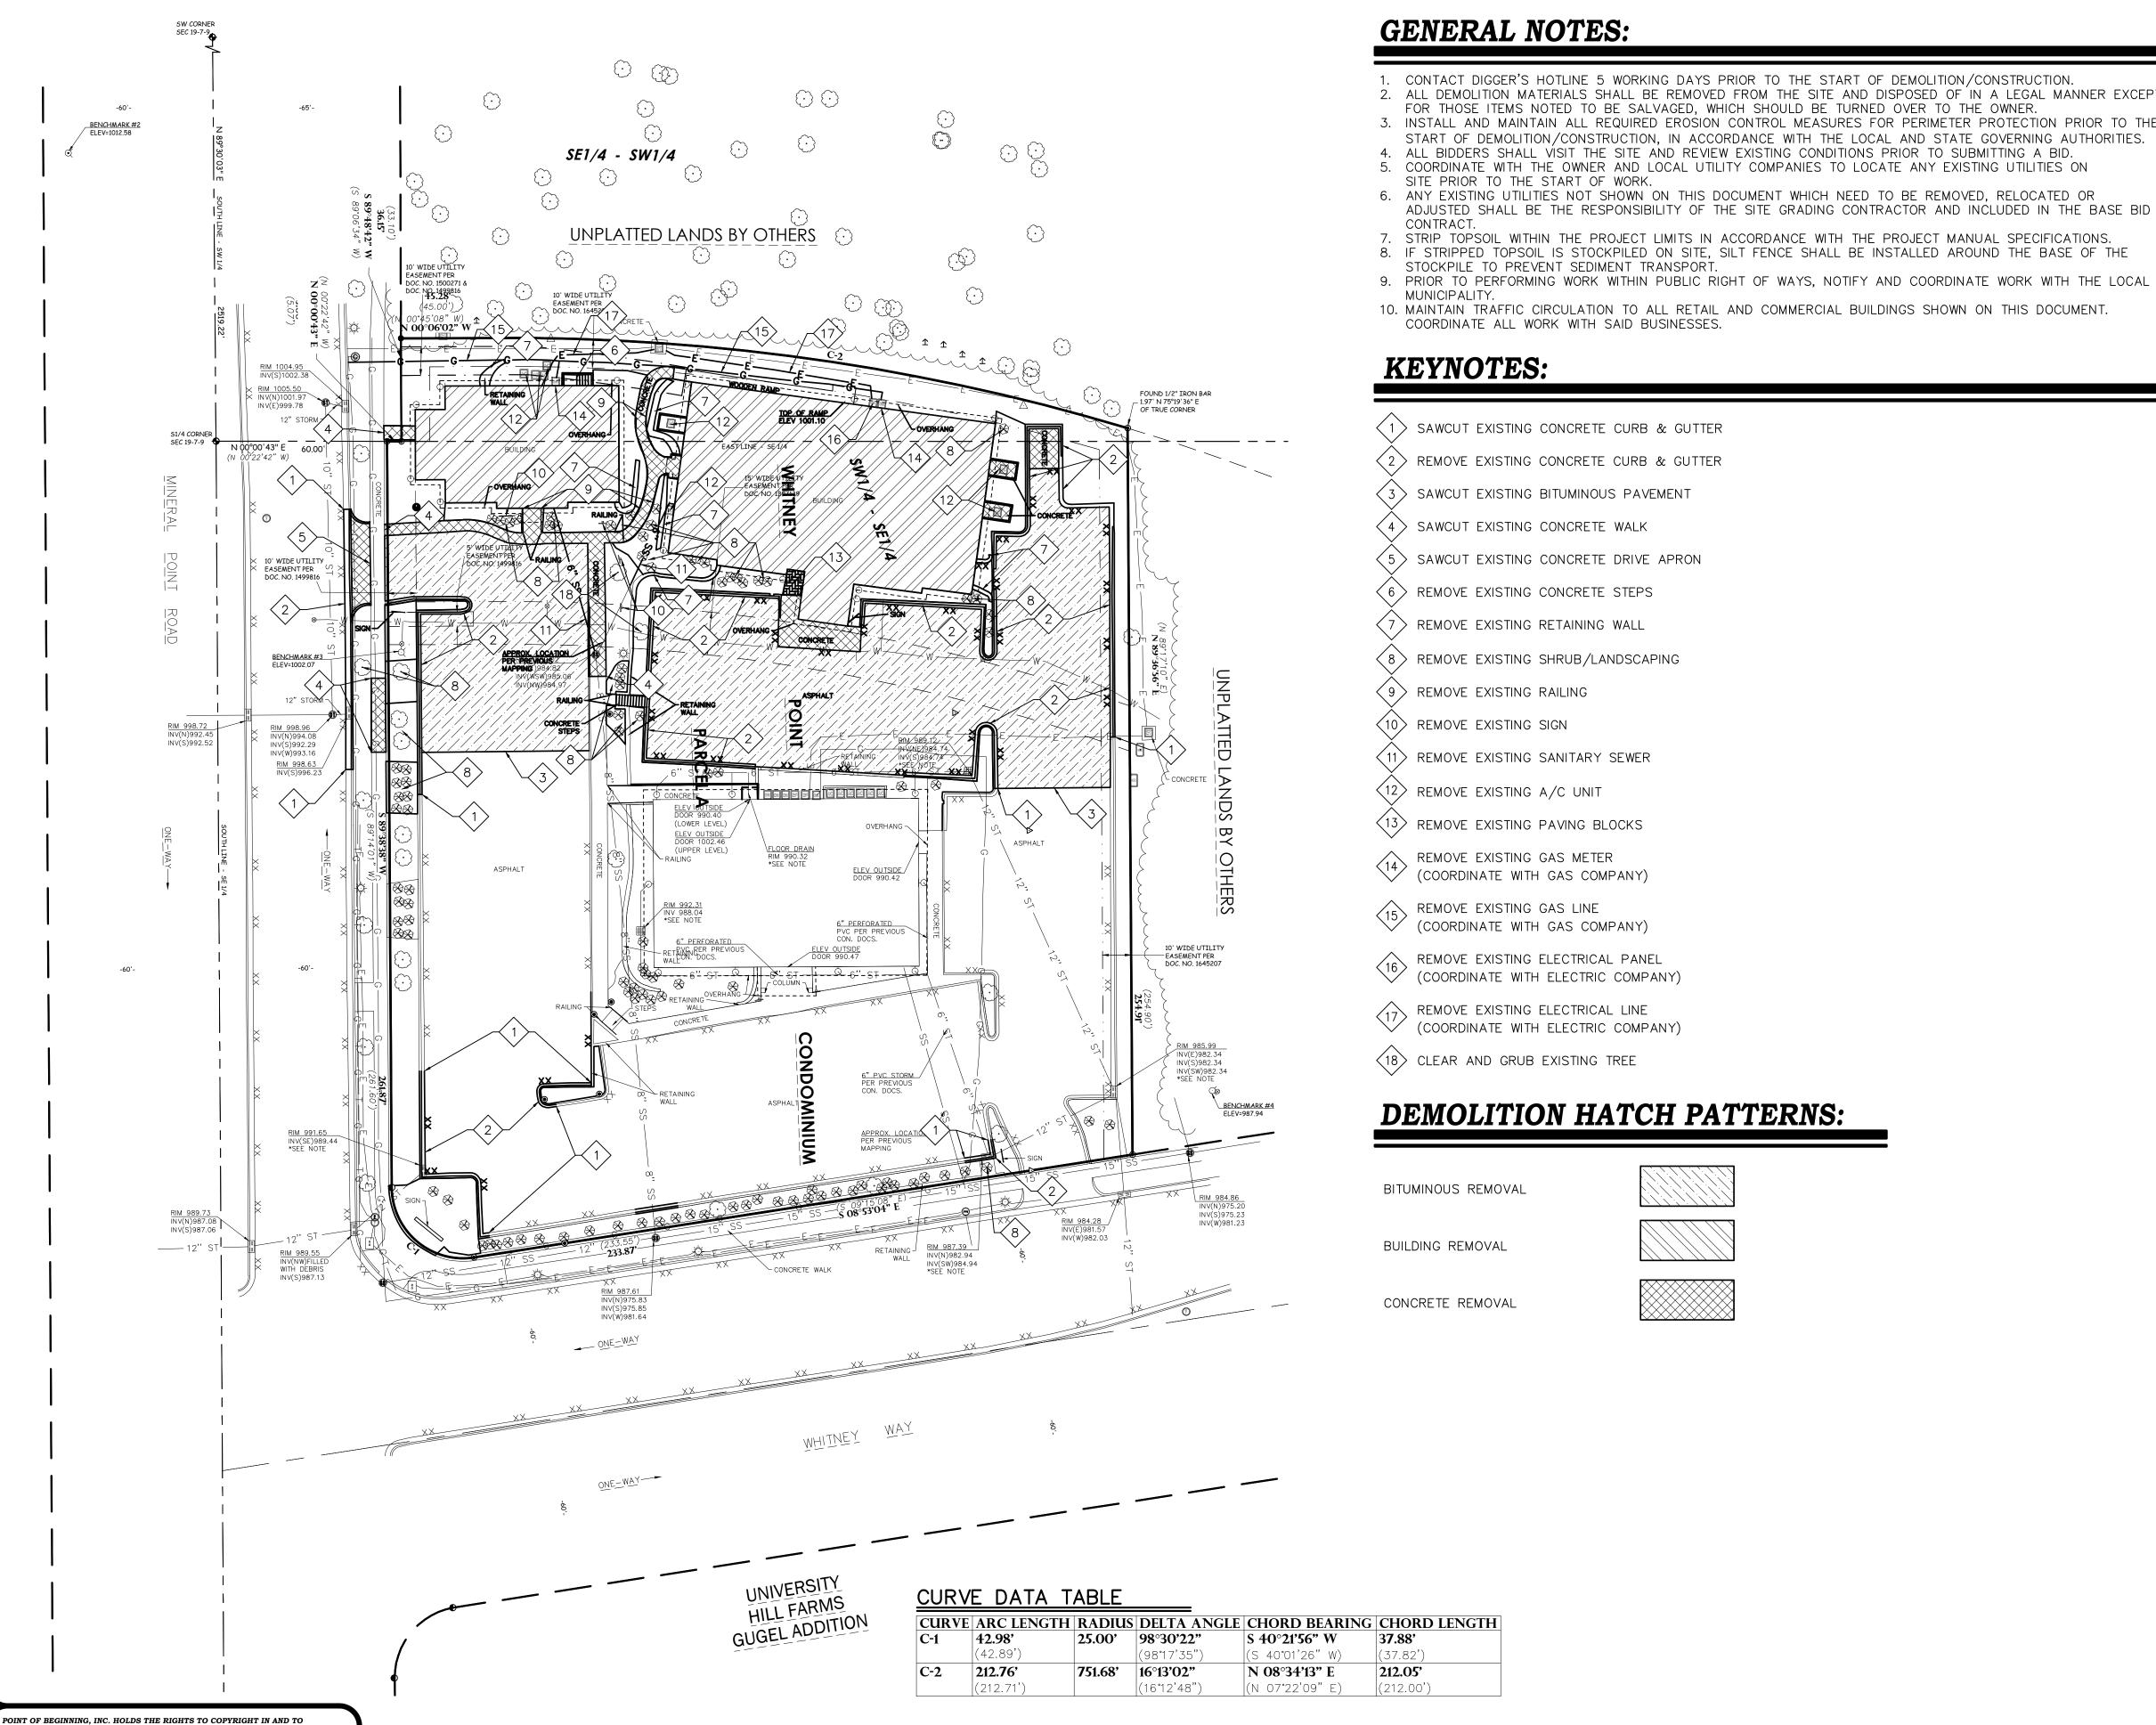
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WRITTEN CONSENT OF TRI-NORTH BUILDERS

REPRESENTS A VIOLATION OF FEDERAL LAWS

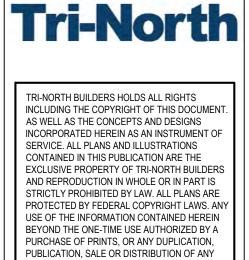




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OF POINT OF BEGINNING, INC. © 2018 POINT OF BEGINNING, INC. 2. ALL DEMOLITION MATERIALS SHALL BE REMOVED FROM THE SITE AND DISPOSED OF IN A LEGAL MANNER EXCEPT

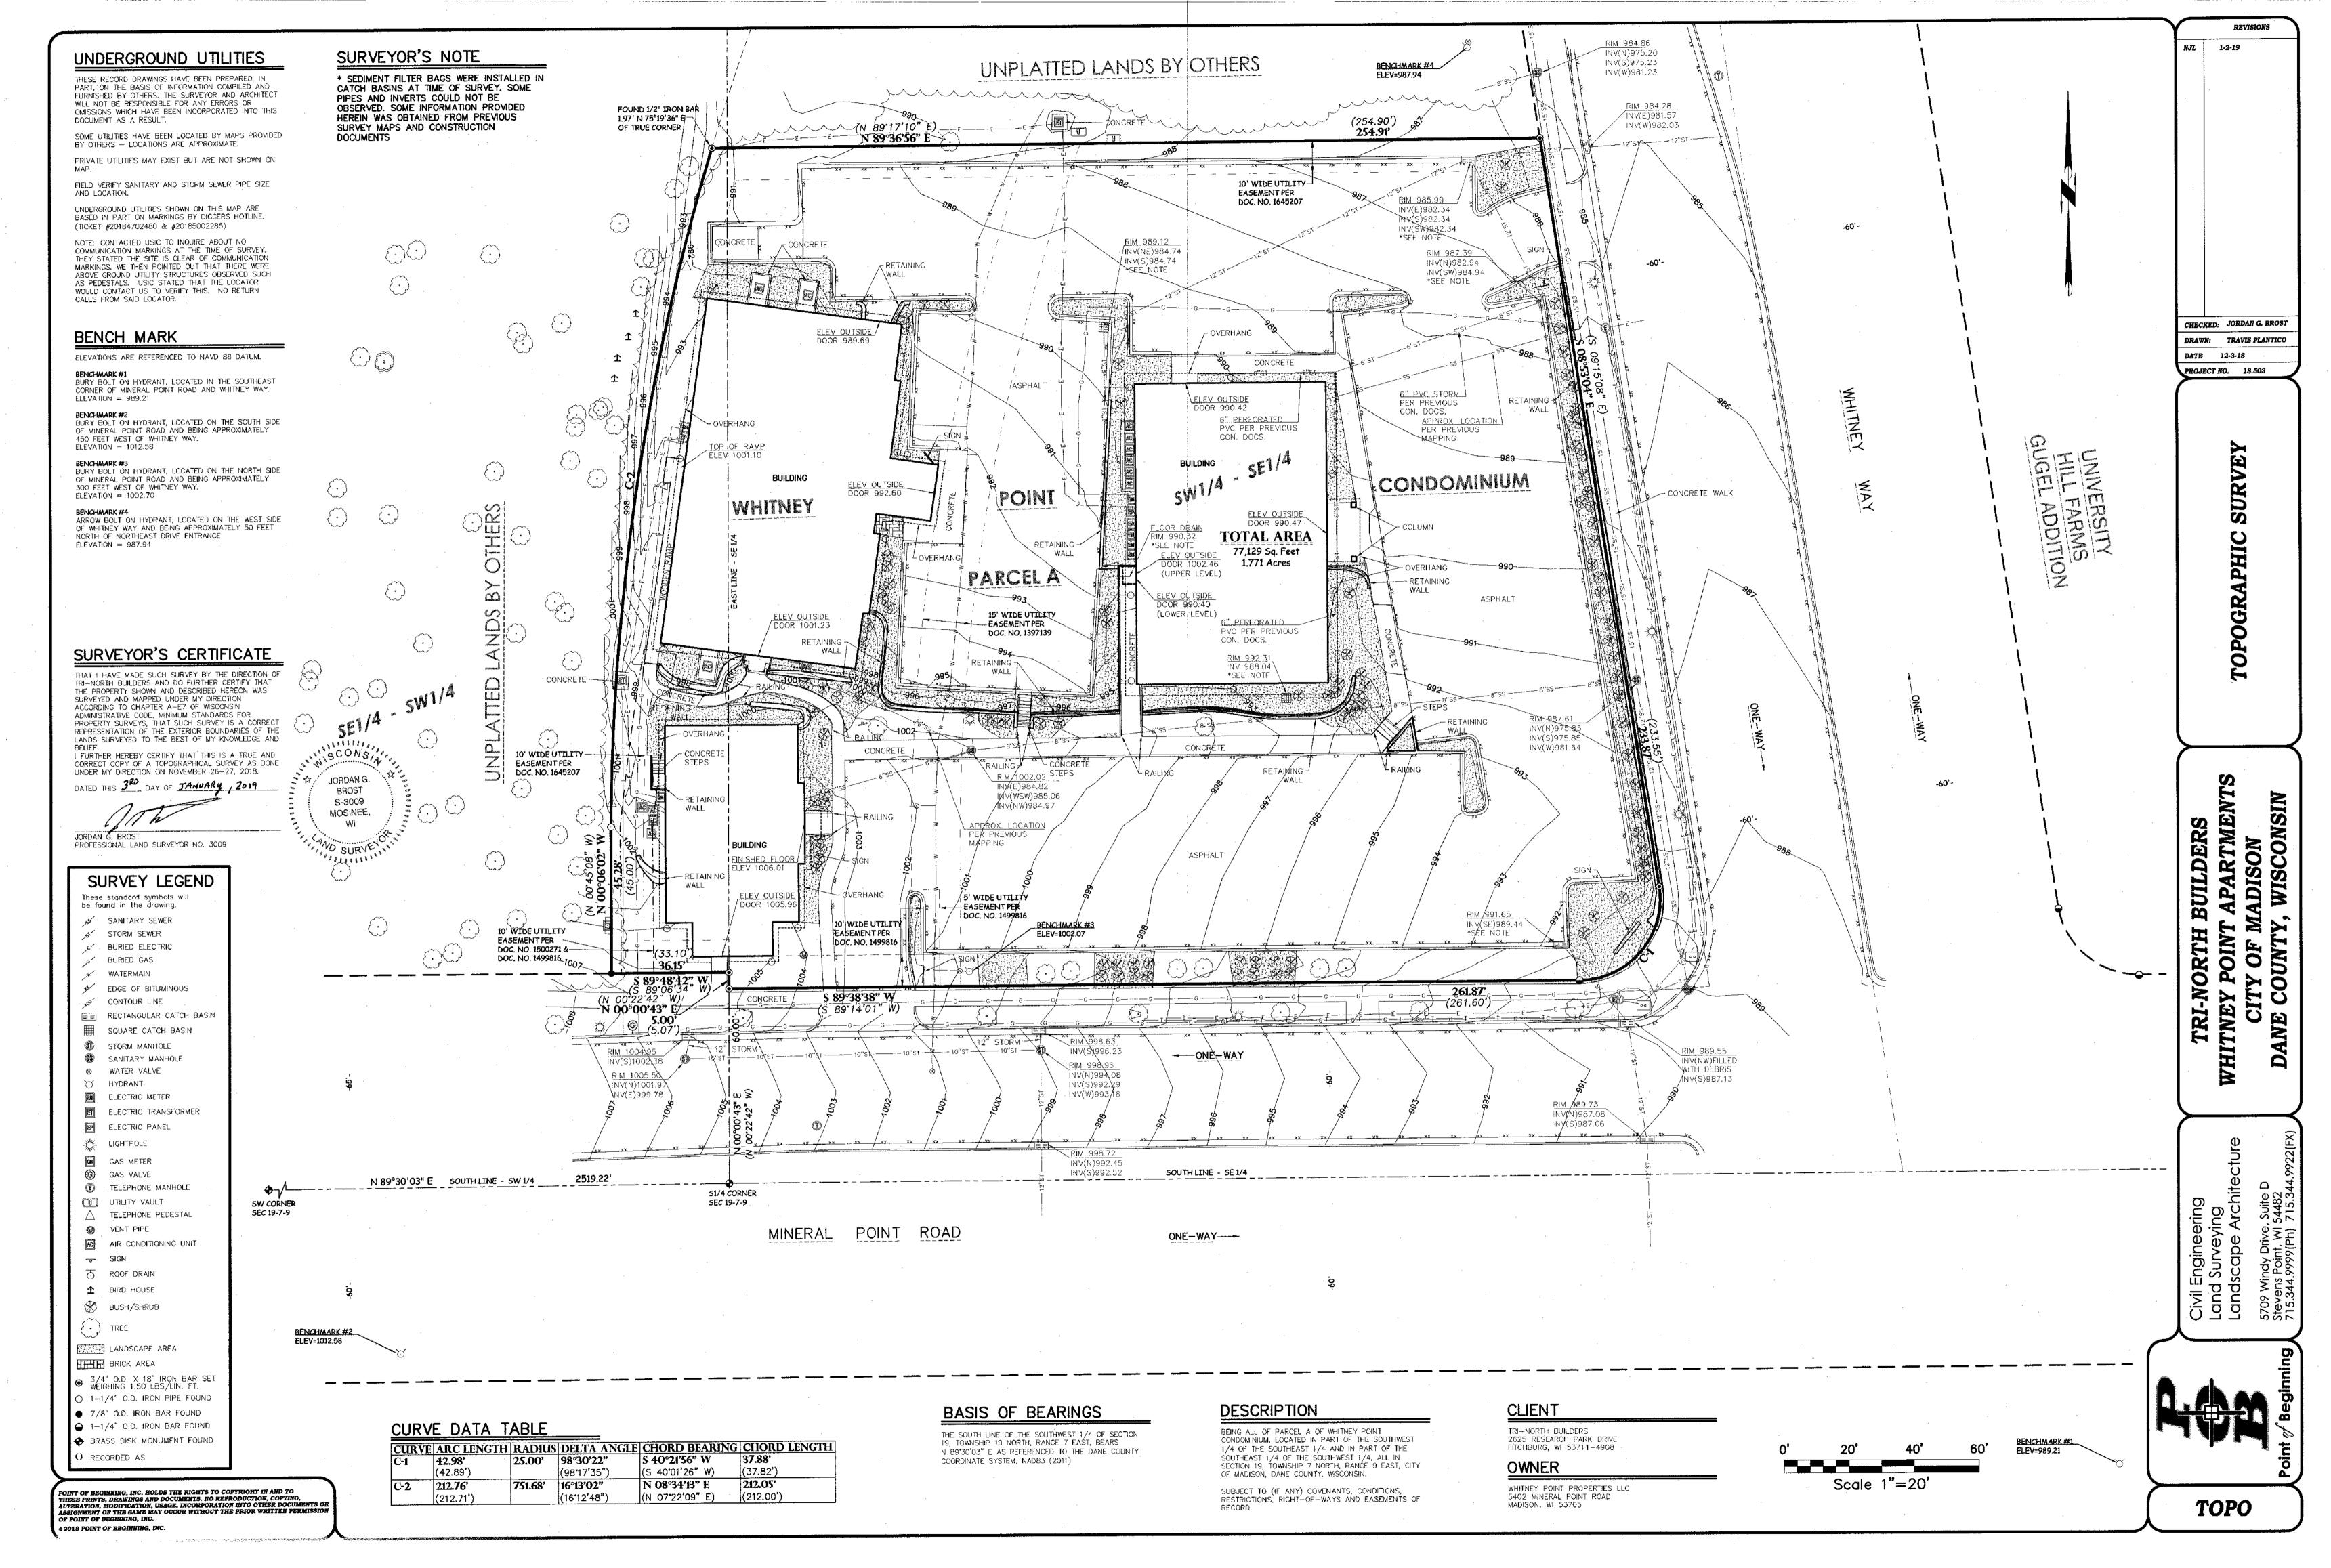3. INSTALL AND MAINTAIN ALL REQUIRED EROSION CONTROL MEASURES FOR PERIMETER PROTECTION PRIOR TO THE

ADJUSTED SHALL BE THE RESPONSIBILITY OF THE SITE GRADING CONTRACTOR AND INCLUDED IN THE BASE BID

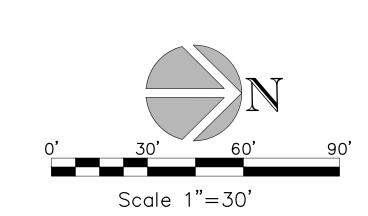


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- CONTACT DIGGER'S HOTLINE 5 WORKING DAYS PRIOR TO THE START OF DEMOLITION/CONSTRUCTION.
- GRADE, LINE, AND LEVEL TO BE REVIEWED IN THE FIELD BY THE CONSTRUCTION MANAGER.
- 3. ALL REQUIRED EROSION CONTROL MEASURES ARE TO BE INSTALLED AND MAINTAINED IN ACCORDANCE WITH LOCAL MUNICIPAL AND DEPARTMENT OF NATURAL RESOURCES REGULATIONS.
- 4. SEE SHEET ___ FOR ALL REQUIRED EROSION CONTROL ELEMENTS.
- 5. ANY EXISTING UTILITIES NOT SHOWN ON THIS DOCUMENT WHICH NEED TO BE REMOVED, RELOCATED AND OR ADJUSTED SHALL BE THE RESPONSIBILITY OF THE SITE GRADING CONTRACTOR AND INCLUDED IN THE BASE BID CONTRACT.
- 6. VERIFY THE LOCATION OF ALL EXISTING UTILITIES PRIOR TO THE START OF DEMOLITION/CONSTRUCTION. 7. ALL BIDDERS SHALL VISIT THE SITE AND REVIEW EXISTING CONDITIONS PRIOR TO SUBMITTING A BID.
- 8. PRIOR TO THE START OF WORK VERIFY WITH THE LOCAL AUTHORITIES THAT ALL REQUIRED PERMITS
- HAVE BEEN ACQUIRED. 9. COORDINATE CONSTRUCTION IN THE RIGHT OF WAY WITH THE LOCAL AUTHORITIES.
- 10. PROVIDE PROPER BARRICADES, SIGNS AND TRAFFIC CONTROL TO MAINTAIN THRU TRAFFIC ALONG
- ADJACENT STREETS IN ACCORDANCE WITH LOCAL MUNICIPAL REQUIREMENTS.
- 11. SIDEWALK JOINTS TO BE AS INDICATED OR AS APPROVED BY CONSTRUCTION MANAGER. 12. ALL SAWCUTS SHALL BE AT AN EXISTING JOINT IN THE CURB AND PAVEMENT.
- 13. ALL GENERAL LANDSCAPE AREAS SHALL BE SEEDED/FERTILIZED/CRIMP HAY MULCHED IN ACCORDANCE WITH THE PROJECT SPECIFICATIONS.

KEYNOTES:

- 1) THICKENED EDGE WALK
- $\langle 2 \rangle$ 18" CONCRETE CURB & GUTTER
- $\langle 3 \rangle$ 18" CONCRETE CURB & GUTTER (REJECT)
- $\overline{\langle 4 \rangle}$ 6" CURB TAPER SECTION
- (5) CONCRETE DRIVE APRON PER MADISON REQ'S
- 6 HANDI-CAP RAMP
- 7 PARKING LOT STRIPING
- 8 HANDICAP PARKING STALL
- HANDICAP PARKING SIGN -
- 2'x6' BIKE STALL
- (VERIFY RACK STYLE WITH OWNER/ARCH)
- (11) CONCRETE TRANSFORMER PAD
- CONCRETE CONDENSER PAD
- 6' CHAIN LINK FENCE
- 4' WIDE CHAIN LINK MAN-GATE
- DUMPSTER ENCLOSURE
- (TO MATCH BUILDING SIDING, SEE ARCH PLANS)
- (16) STRIPED CROSSWALK

PAVEMENT HATCH PATTERNS:

PROPOSED _" ASPHALTIC CONCRETE PAVEMENT W/ XX BASE COURSE PROPOSED _" CONCRETE PAVEMENT PROPOSED _" REINFORCED CONCRETE PAVEMENT

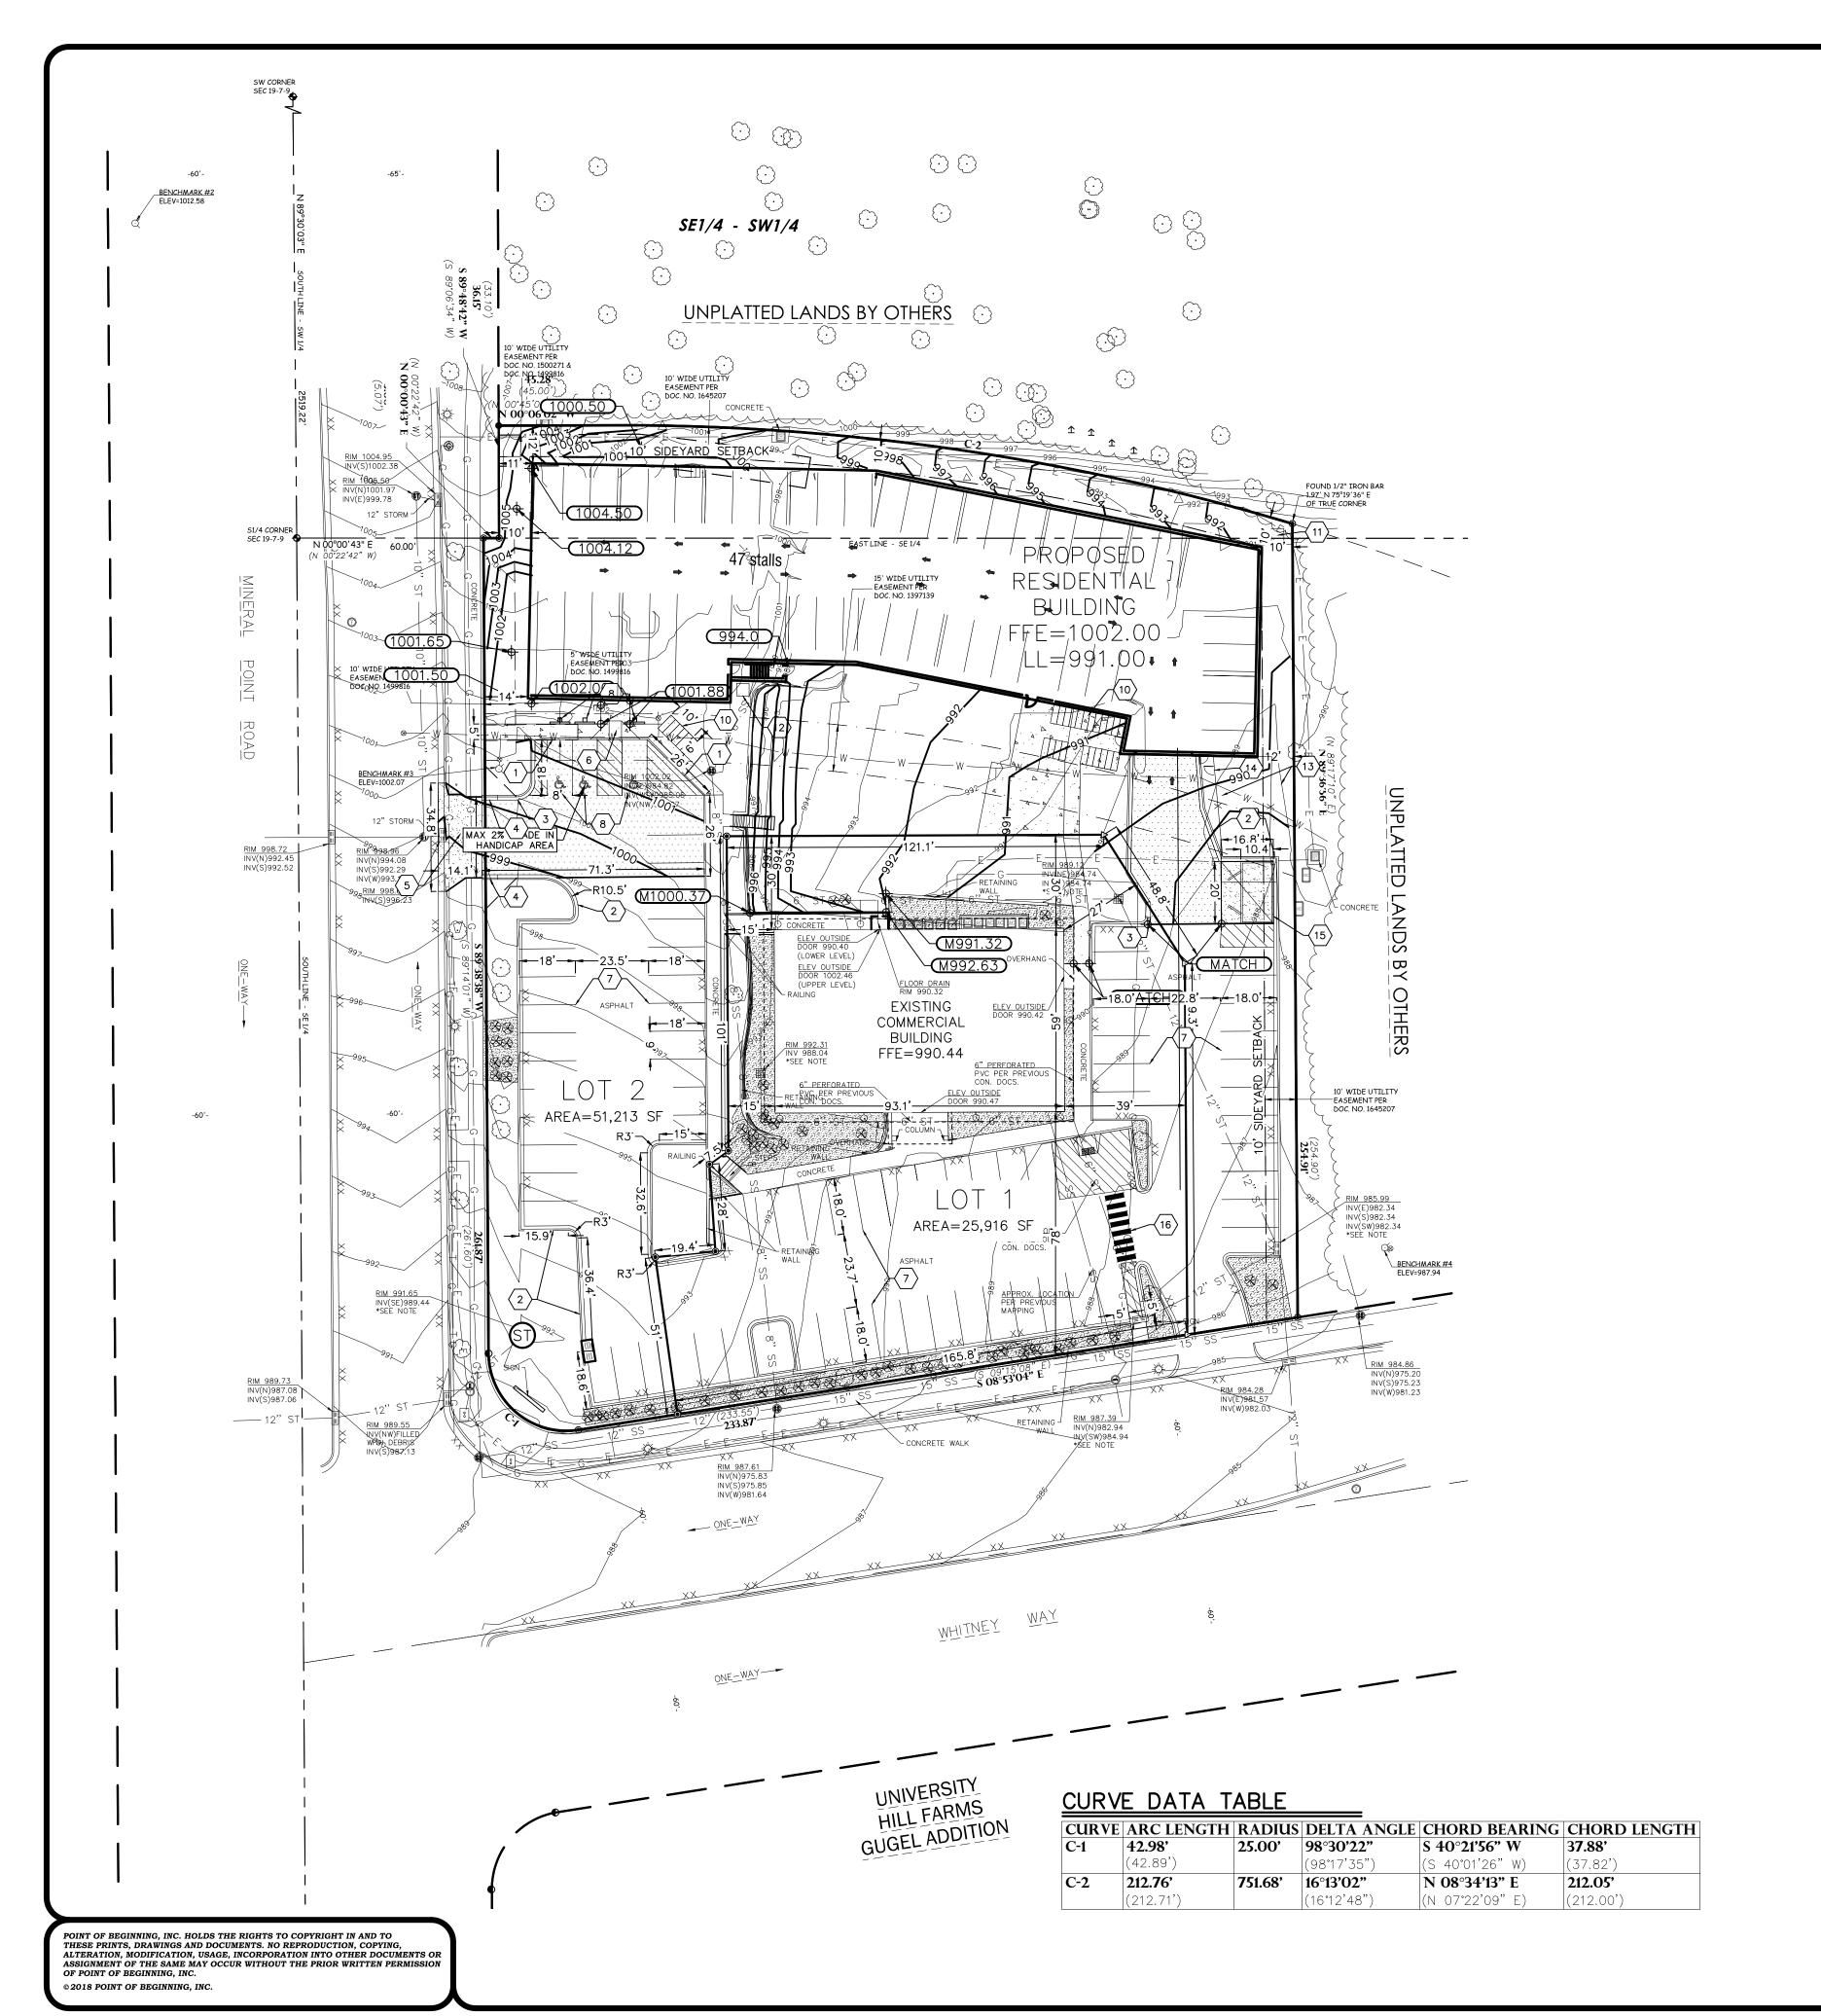SITE PARKING RE-CAP

OFF-STREET PARKING-PROPOSED 74 TOTAL PARKING STALLS PROPOSED

- -3 HANDICAP STALLS
- -71 STANDARD STALLS

Scale 1"=30'

CHECKED: ACG DRAWN: JHB

2/5/19

DATE


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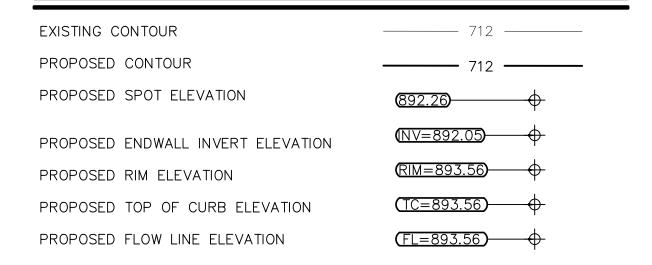
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- CONTACT DIGGER'S HOTLINE 5 WORKING DAYS PRIOR TO THE START OF DEMOLITION/CONSTRUCTION. 2. THE PROPOSED SITE PLAN FINISH FLOOR ELEVATION OF _____ EQUALS THE PROPOSED BUILDING
- ARCHITECTURAL FINISH FLOOR ELEVATION OF 100.00'. 3. GRADE, LINE, AND LEVEL TO BE REVIEWED IN THE FIELD BY THE CONSTRUCTION MANAGER.
- 4. INSTALL AND MAINTAIN ALL REQUIRED EROSION CONTROL MEASURES IN ACCORDANCE WITH LOCAL AUTHORITIES AND THE DEPARTMENT OF NATURAL RESOURCES REGULATIONS.
- 5. 6" OF TOPSOIL SHALL BE PROVIDED IN ALL GENERAL LAWN AREAS AND 12" SHALL BE PROVIDED IN ALL PLANTING BED AREAS.
- 6. SEE SHEET ____ FOR ALL REQUIRED EROSION CONTROL ELEMENTS.
- 7. ANY EXISTING UTILITIES NOT SHOWN ON THIS DOCUMENT WHICH NEED TO BE REMOVED, RELOCATED OR ADJUSTED SHALL BE THE RESPONSIBILITY OF THE SITE GRADING CONTRACTOR AND INCLUDED IN THE BASE BID
- 8. COORDINATE ALL EARTHWORK ACTIVITIES WITH THE RESPECTIVE TRADES RESPONSIBLE FOR THE INSTALLATION OF GAS, CABLE, TELEPHONE AND ELECTRICAL (INCLUDING MAIN SERVICE, SITE LIGHTING, CONDUITS AND
- 9. PROVIDE RIP RAP AT PROPOSED CULVERT ENDWALL STRUCTURES TO PREVENT WASHOUT AND EROSION.
- 10. RIP RAP SHALL HAVE WISDOT TYPE HR FILTER FABRIC PLACED BENEATH.
- 11. EXCESS TOPSOIL SHALL BE REMOVED FROM SITE, UNLESS OTHERWISE DIRECTED BY THE OWNER. COORDINATE WITH OWNER FOR LOCATION OF STOCKPILE IF THE OWNER CHOOSES TO SALVAGE EXCESS TOPSOIL FOR FUTURE
- USE. SILT FENCE SHALL BE PLACED AROUND STOCKPILE.

 12. THE ENGINEERED SOIL SHALL NOT BE PLACED IN THE BIORETENTION AREAS UNTIL THE SURROUNDING DRAINAGE AREA HAS BEEN FULLY STABILIZED. ALL CONSTRUCTION SITE SEDIMENT SHALL BE REMOVED FROM THE SUBGRADE OF THE BIORETENTION AREA PRIOR TO PLACEMENT OF THE ENGINEERED SOIL.
- 13. TESTING AND INSPECTION SHALL BE DONE IN ACCORDANCE WITH SPS 382.21.
- 14. THE LOCAL MUNICIPALITY SHALL BE CONTACTED PRIOR TO ANY EXCAVATION IN THE PUBLIC RIGHT-OF-WAY. THE CONTRACTOR SHALL HAVE HIS TRAFFIC CONTROL PLAN APPROVED PRIOR TO WORK COMMENCING. THE LOCAL MUNICIPALITY SHALL OPERATE ALL EXISTING WATER VALVES IF NEEDED.
- 15. GRADES AT BUILDING EDGE SHALL BE 6" BELOW FINISHED FLOOR ELEVATION EXCEPT AT DOOR WAY ENTRANCES OR UNLESS OTHERWISE NOTED.

GRADING LEGEND:



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DATE 2/5/19 PROJECT NO. 18.141

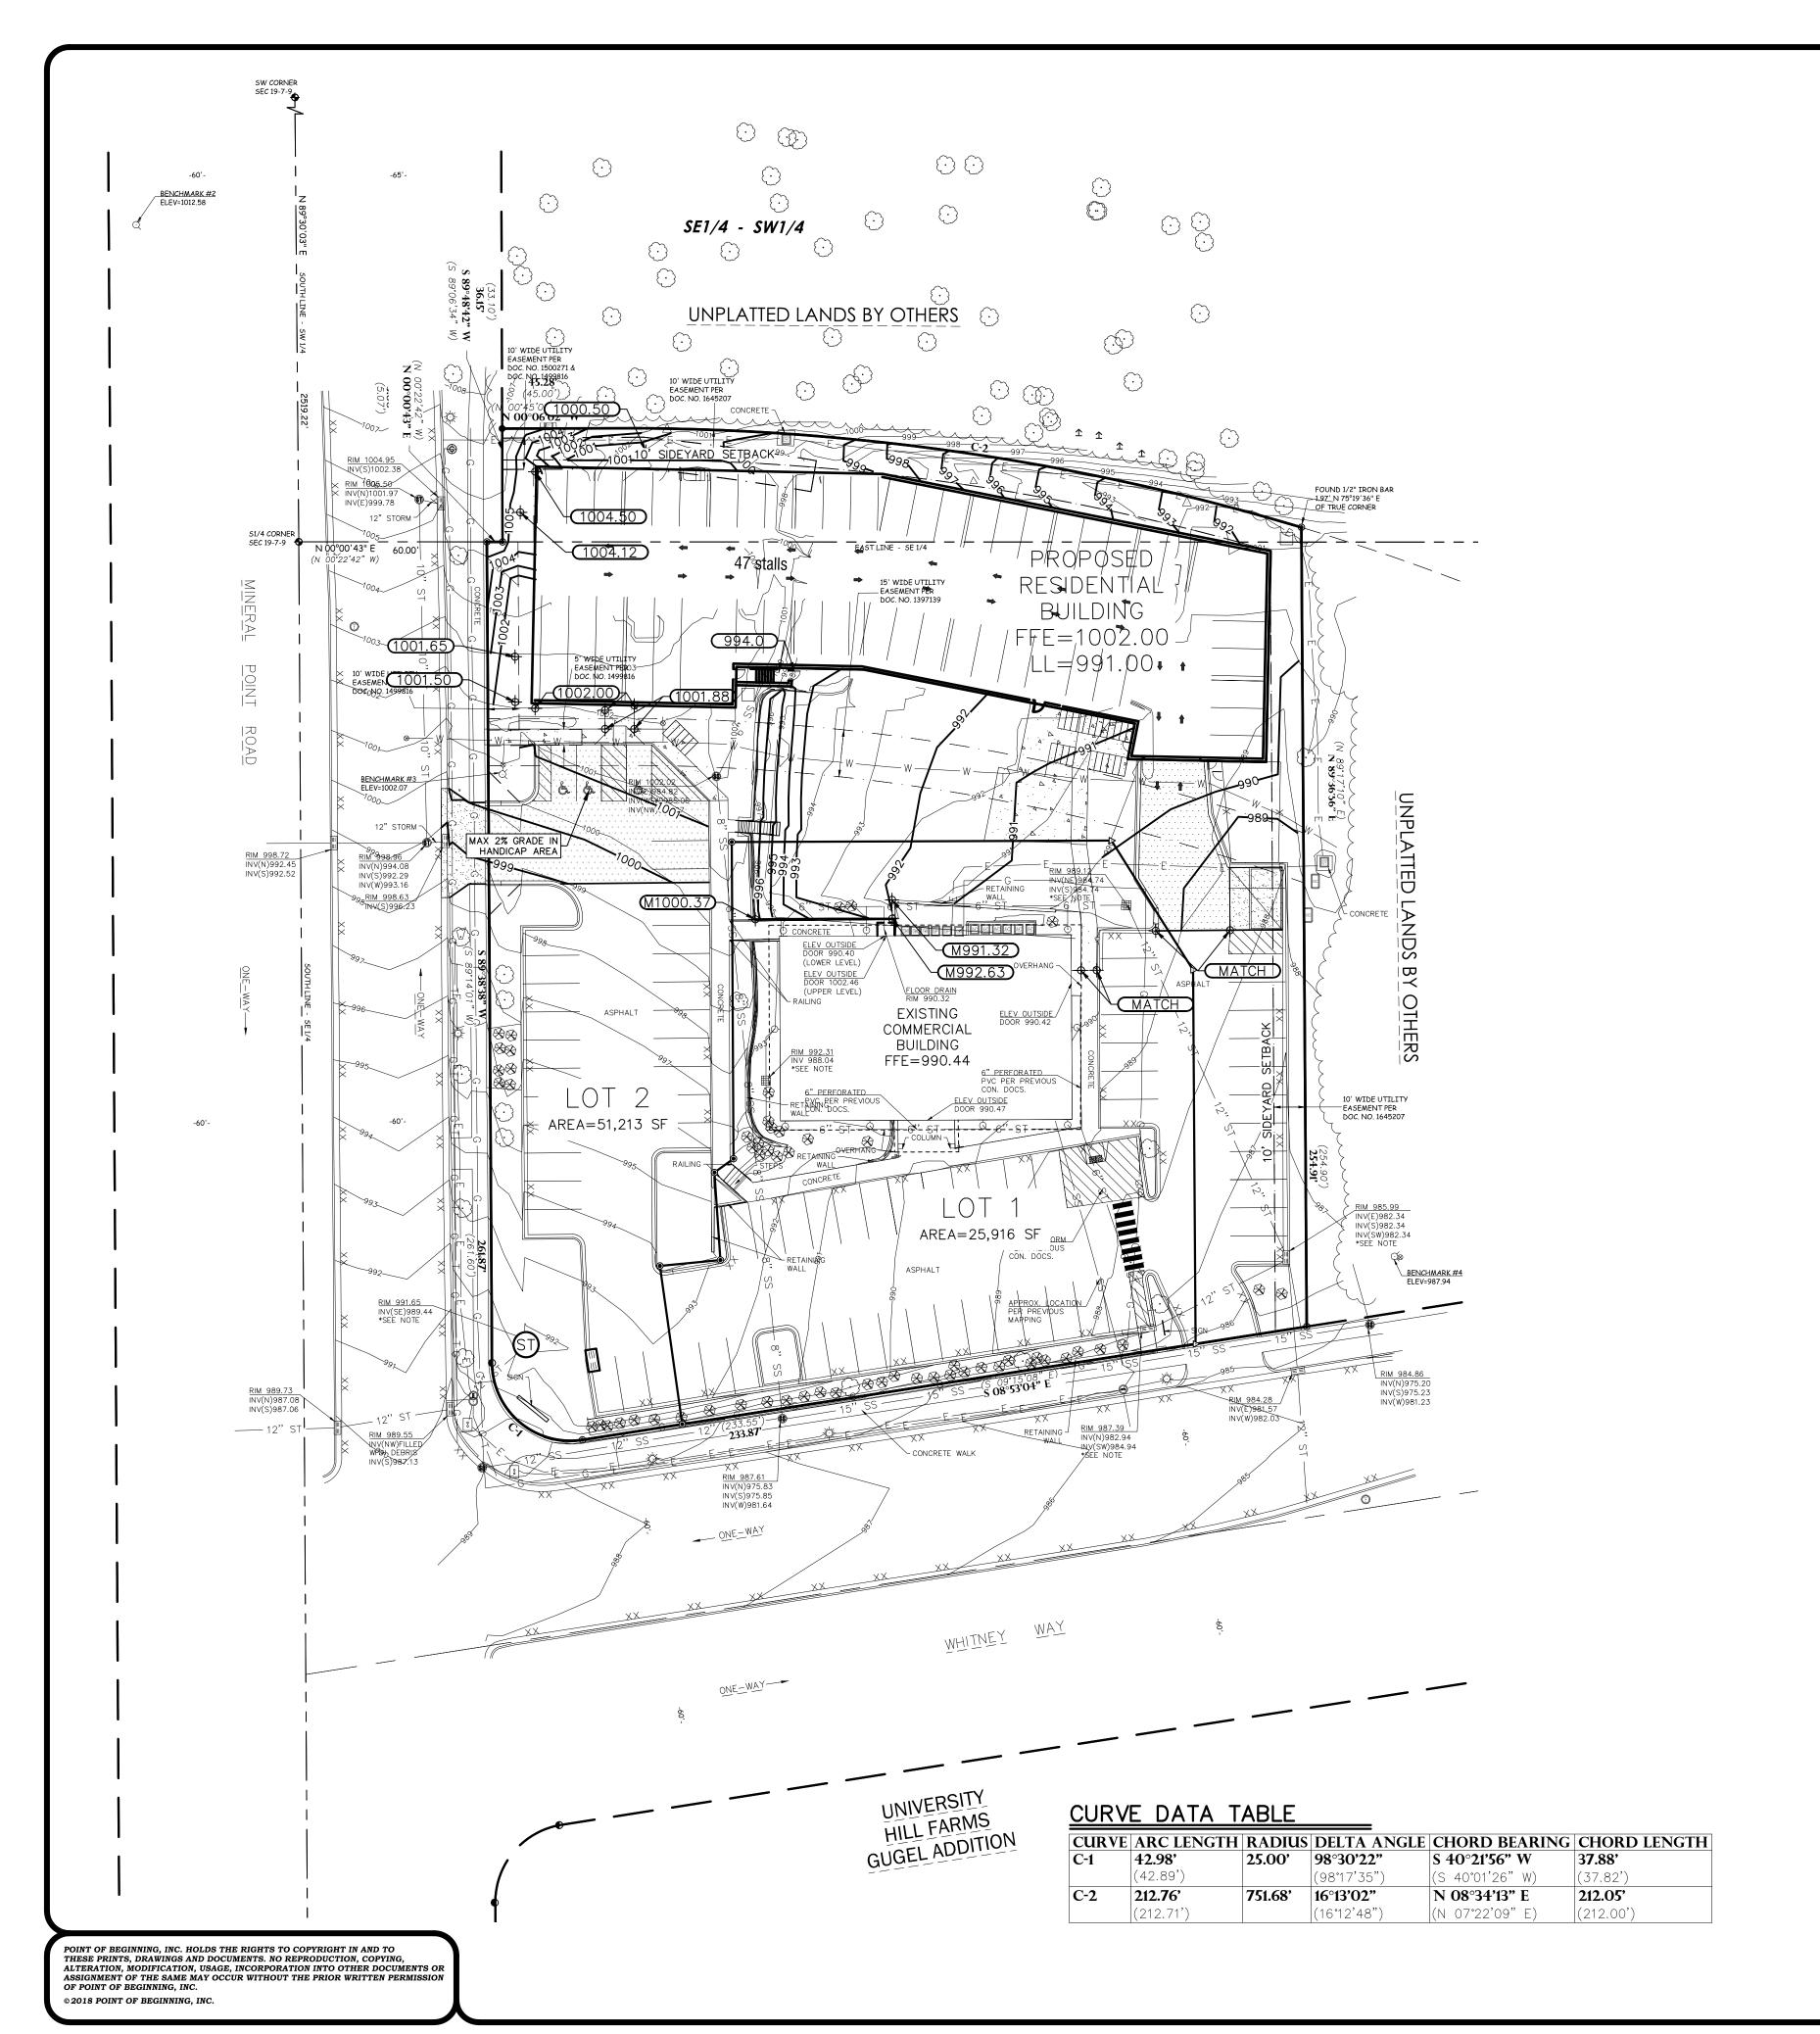
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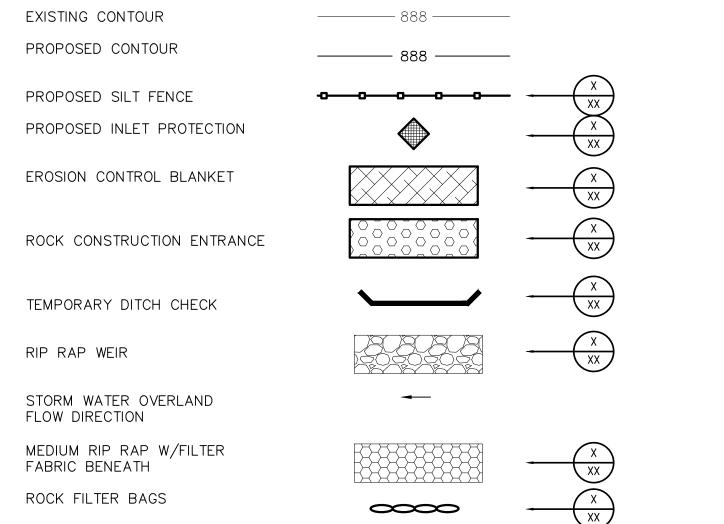
Scale 1"=30'

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- 1. CONTACT DIGGER'S HOTLINE 5 WORKING DAYS PRIOR TO THE START OF DEMOLTION/CONSTRUCTION.
- 2. NOTIFY THE LOCAL MUNICIPALITY AT LEAST 2 WORKING DAYS PRIOR TO THE START OF SOIL DISTURBING ACTIVITIES.
- 3. INSTALL ALL TEMPORARY EROSION CONTROL ELEMENTS PRIOR TO THE START OF DEMOLITION/CONSTRUCTION.
 4. ALL ACTIVITIES SHALL BE CONDUCTED IN A LOGICAL SEQUENCE AS TO MINIMIZE THE AMOUNT OF BARE SOIL EXPOSED AT ANY ONE TIME. MAINTAIN EXISTING VEGETATION AS LONG AS POSSIBLE.
- 5. CRUSHED ROCK DRIVES FOR SEDIMENT TRACKING UTILIZING 3" CRUSHED ROCK SHALL BE MAINTAINED AT ALL CONSTRUCTION ENTRANCES TO THE SITE. THE ROCK DRIVE SHALL BE A MINIMUM OF 12" THICK AND BE A MINIMUM OF 50 FEET IN LENGTH BY THE WIDTH OF THE DRIVEWAY.
- 6. OFF SITE SEDIMENT DEPOSITS OCCURRING AS A RESULT OF A STORM EVENT SHALL BE CLEANED UP BY THE END OF THE NEXT WORK DAY. ALL OFF SITE SEDIMENT DEPOSITS OCCURRING AS A RESULT OF CONSTRUCTION ACTIVITIES, INCLUDING SOIL TRACKED BY CONSTRUCTION TRAFFIC, SHALL AT A MINIMUM BE CLEANED BY THE END OF EACH WORK DAY. EXCESSIVE AMOUNTS OF SEDIMENT OR OTHER DEBRIS TRACKED ONTO ADJACENT STREETS SHALL BE CLEANED IMMEDIATELY. FINE SEDIMENT ACCUMULATIONS SHALL BE CLEANED FROM ADJACENT STREETS BY THE USE OF MECHANICAL OR MANUAL SWEEPING OPERATIONS ONCE A WEEK AT A MINIMUM AND BEFORE IMMINENT RAIN EVENTS.
- 7. DISTURBED GROUND OUTSIDE OF THE EVERYDAY CONSTRUCTION AREAS, INCLUDING SOIL STOCKPILES, THAT IS LEFT INACTIVE FOR MORE THAN 7 DAYS SHALL BE TEMPORARILY STABILIZED BY SEEDING/MULCHING OR OTHER APPROVED
- 8. WASTE MATERIAL THAT IS GENERATED ON THE CONSTRUCTION SITE SHALL BE PROPERLY DISPOSED OF AND NOT ALLOWED TO RUN INTO RECEIVING WATERS.
- 9. EROSION CONTROL DEVICES DESTROYED AS A RESULT OF CONSTRUCTION ACTIVITIES SHALL BE REPAIRED BY THE END
- 10. INSPECT ALL EROSION CONTROL MEASURES AT LEAST ONCE A WEEK AND AFTER ANY RAINFALL OF 0.5" OR MORE. MAKE NEEDED REPAIRS AND DOCUMENT ALL ACTIVITIES AS PER THE REQUIREMENTS OF THE NOTICE OF INTENT SUBMITTED BY THE PROJECT CIVIL ENGINEER.
- 11. ALL TEMPORARY EROSION CONTROL ELEMENTS SHALL REMAIN IN PLACE UNTIL A SUFFICIENT GROWTH OF VEGETATION IS ESTABLISHED AND THEN BE REMOVED AS PART OF THE BASE BID.
- 12. IF SEDIMENT LADEN WATER NEEDS TO BE REMOVED FROM THE SITE, FILTER BAGS OR SCREENING SHALL BE USED IN ACCORDANCE WITH WDNR TECHNICAL STANDARD 1061 TO PREVENT SEDIMENT DISCHARGE TO THE MAXIMUM EXTENT PRACTICABLE.
- 12. PROVIDE RIP RAP AT PROPOSED CULVERT ENDWALL STRUCTURES TO PREVENT WASHOUT AND EROSION.
- 13. RIP RAP SHALL HAVE WisDOT TYPE HR FILTER FABRIC PLACED BENEATH.
- 14. IF BARE SOIL IS EXPOSED DURING THE WINTER MONTHS, STABILIZATION BY MULCHING OR ANIONIC POLYACRYLAMIDE SHALL OCCUR PRIOR TO SNOW OR FROZEN GROUND.
- 15. SILT FENCE SHALL BE INSTALLED AROUND THE TOPSOIL STOCKPILE.
- 16. SILT FENCE SHALL BE INSTALLED AROUND THE BIORETENTION AREA IMMEDIATELY FOLLOWING INSTALLATION OF THE ENGINEERED SOIL TO PROTECT IT FROM SILT CONTAMINATION.
- 17. THE ENGINEERED SOIL SHALL NOT BE PLACED IN THE BIORETENTION AREAS UNTIL THE SURROUNDING DRAINAGE AREA HAS BEEN FULLY STABILIZED. ALL CONSTRUCTION SITE SEDIMENT SHALL BE REMOVED FROM THE SUBGRADE OF THE BIORETENTION AREA PRIOR TO PLACEMENT OF THE ENGINEERED SOIL.
- 18. THE CONTRACTOR SHALL PERFORM INSPECTIONS AND MONITORING OF EROSION CONTROL PRACTICES IN ACCORDANCE WITH THE WI DNR "CONSTRUCTION SITE INSPECTION REPORT" FORM 3400-187. THIS FORM CAN BE FOUND IN THE CONSTRUCTION SPECIFICATIONS.

EROSION CONTROL LEGEND:




EROSION CONTROL SEQUENCING

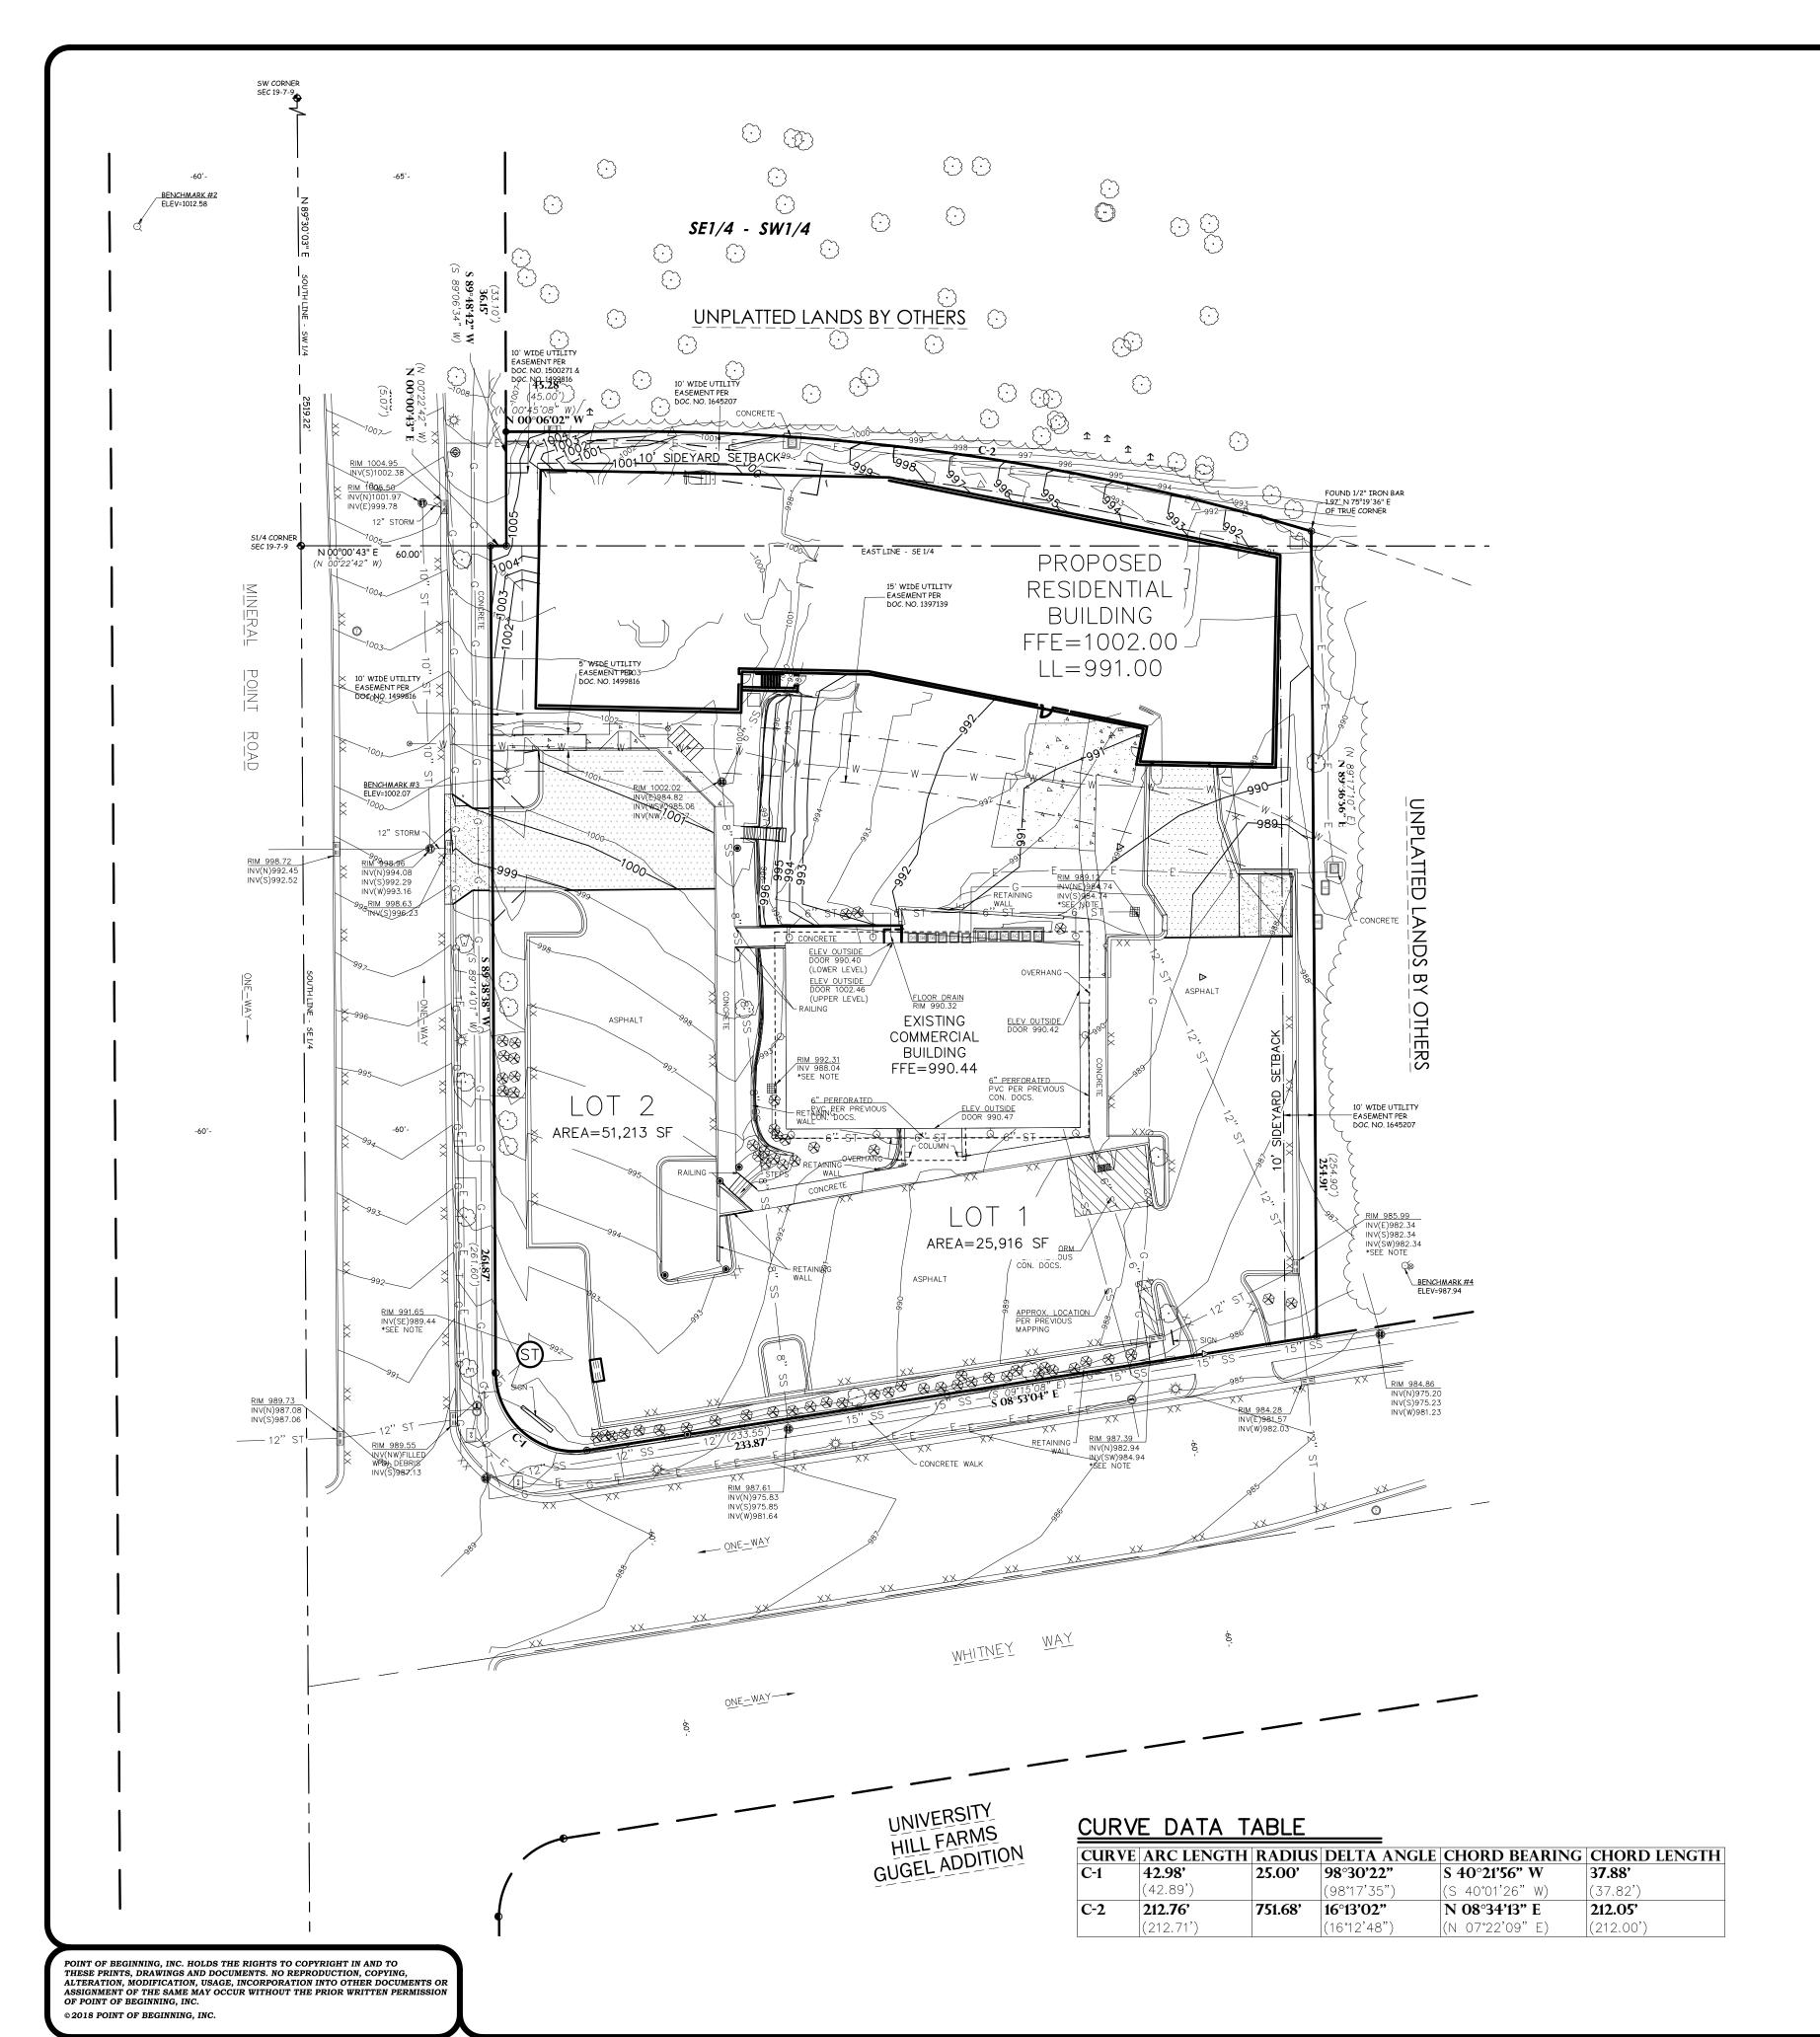- I. INSTALL PERIMETER EROSION CONTROL
- 2. EXCAVATE A TEMPORARY SEDIMENT TRAP AT THE PROPOSED BIO-RETENTION AREA IN ACCORDANCE WITH DNR TECHNICAL STANDARD 1063
- 2.1. SEDIMENT TRAP BOTTOM BASIN ELEVATION SHALL BE _____
- 2.2. INSTALL STONE OUTLET/OVERFLOW WEIR PER GRADING PLAN DETAIL _____2.3. EXCAVATE SWALES NORTH AND EAST FROM THE BASIN TO DIRECT AND MAXIMIZE STORMWATER RUNOFF TO THIS BASIN DURING CONSTRUCTION
- 3. BEGIN DEMOLITION
- 4. BEGIN ROUGH GRADING AND UTILITY INSTALLATION
- 4. BEGIN ROUGH GRADING AND UTILITY INSTALLATION
 5. DURING GRADING ACTIVITIES EXISTING GRASS AND VEGETATION, TO BE REMOVED, SHALL REMAIN IN PLACE FOR AS LONG AS POSSIBLE, TO AVOID SEDIMENT TRANSPORT.
- 6. TEMPORARY STABILIZATION ACTIVITY SHALL COMMENCE WHEN LAND DISTURBING CONSTRUCTION ACTIVITIES HAVE TEMPORARILY CEASED AND WILL NOT RESUME FOR A
- PERIOD EXCEEDING 14 CALENDAR DAYS.

 7. FINAL STABILIZATION ACTIVITY SHALL COMMENCE WHEN LAND DISTURBING ACTIVITIES CEASE
- AND FINAL GRADE HAS BEEN REACHED ON ANY PORTION OF THE SITE.

 8. PER GENERAL NOTE #20, THE SEDIMENT TRAP SHALL BE RECONSTRUCTED INTO THE PROPOSED BIO—RETENTION AREA AFTER THE SURROUNDING AREA HAS BEEN FULLY
- 8.1. ANY CONSTRUCTION SITE SEDIMENT BUILD UP SHALL BE REMOVED FROM THE PROPOSED BIO—RETENTION BASIN BEFORE EXCAVATION TO THE FINAL DEPTH AND INSTALLATION OF THE ENGINEERED SOIL
- 9. IF DISTURBED AREAS MUST BE LEFT OVER WINTER, AN ANIONIC POLYACRYLAMIDE SHALL BE APPLIED TO ALL DISTURBED AREAS PRIOR TO GROUND FREEZE. SEE SPECIFICATIONS FOR

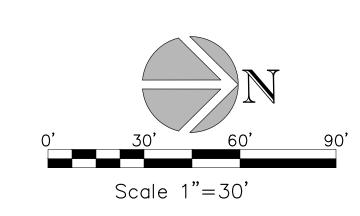

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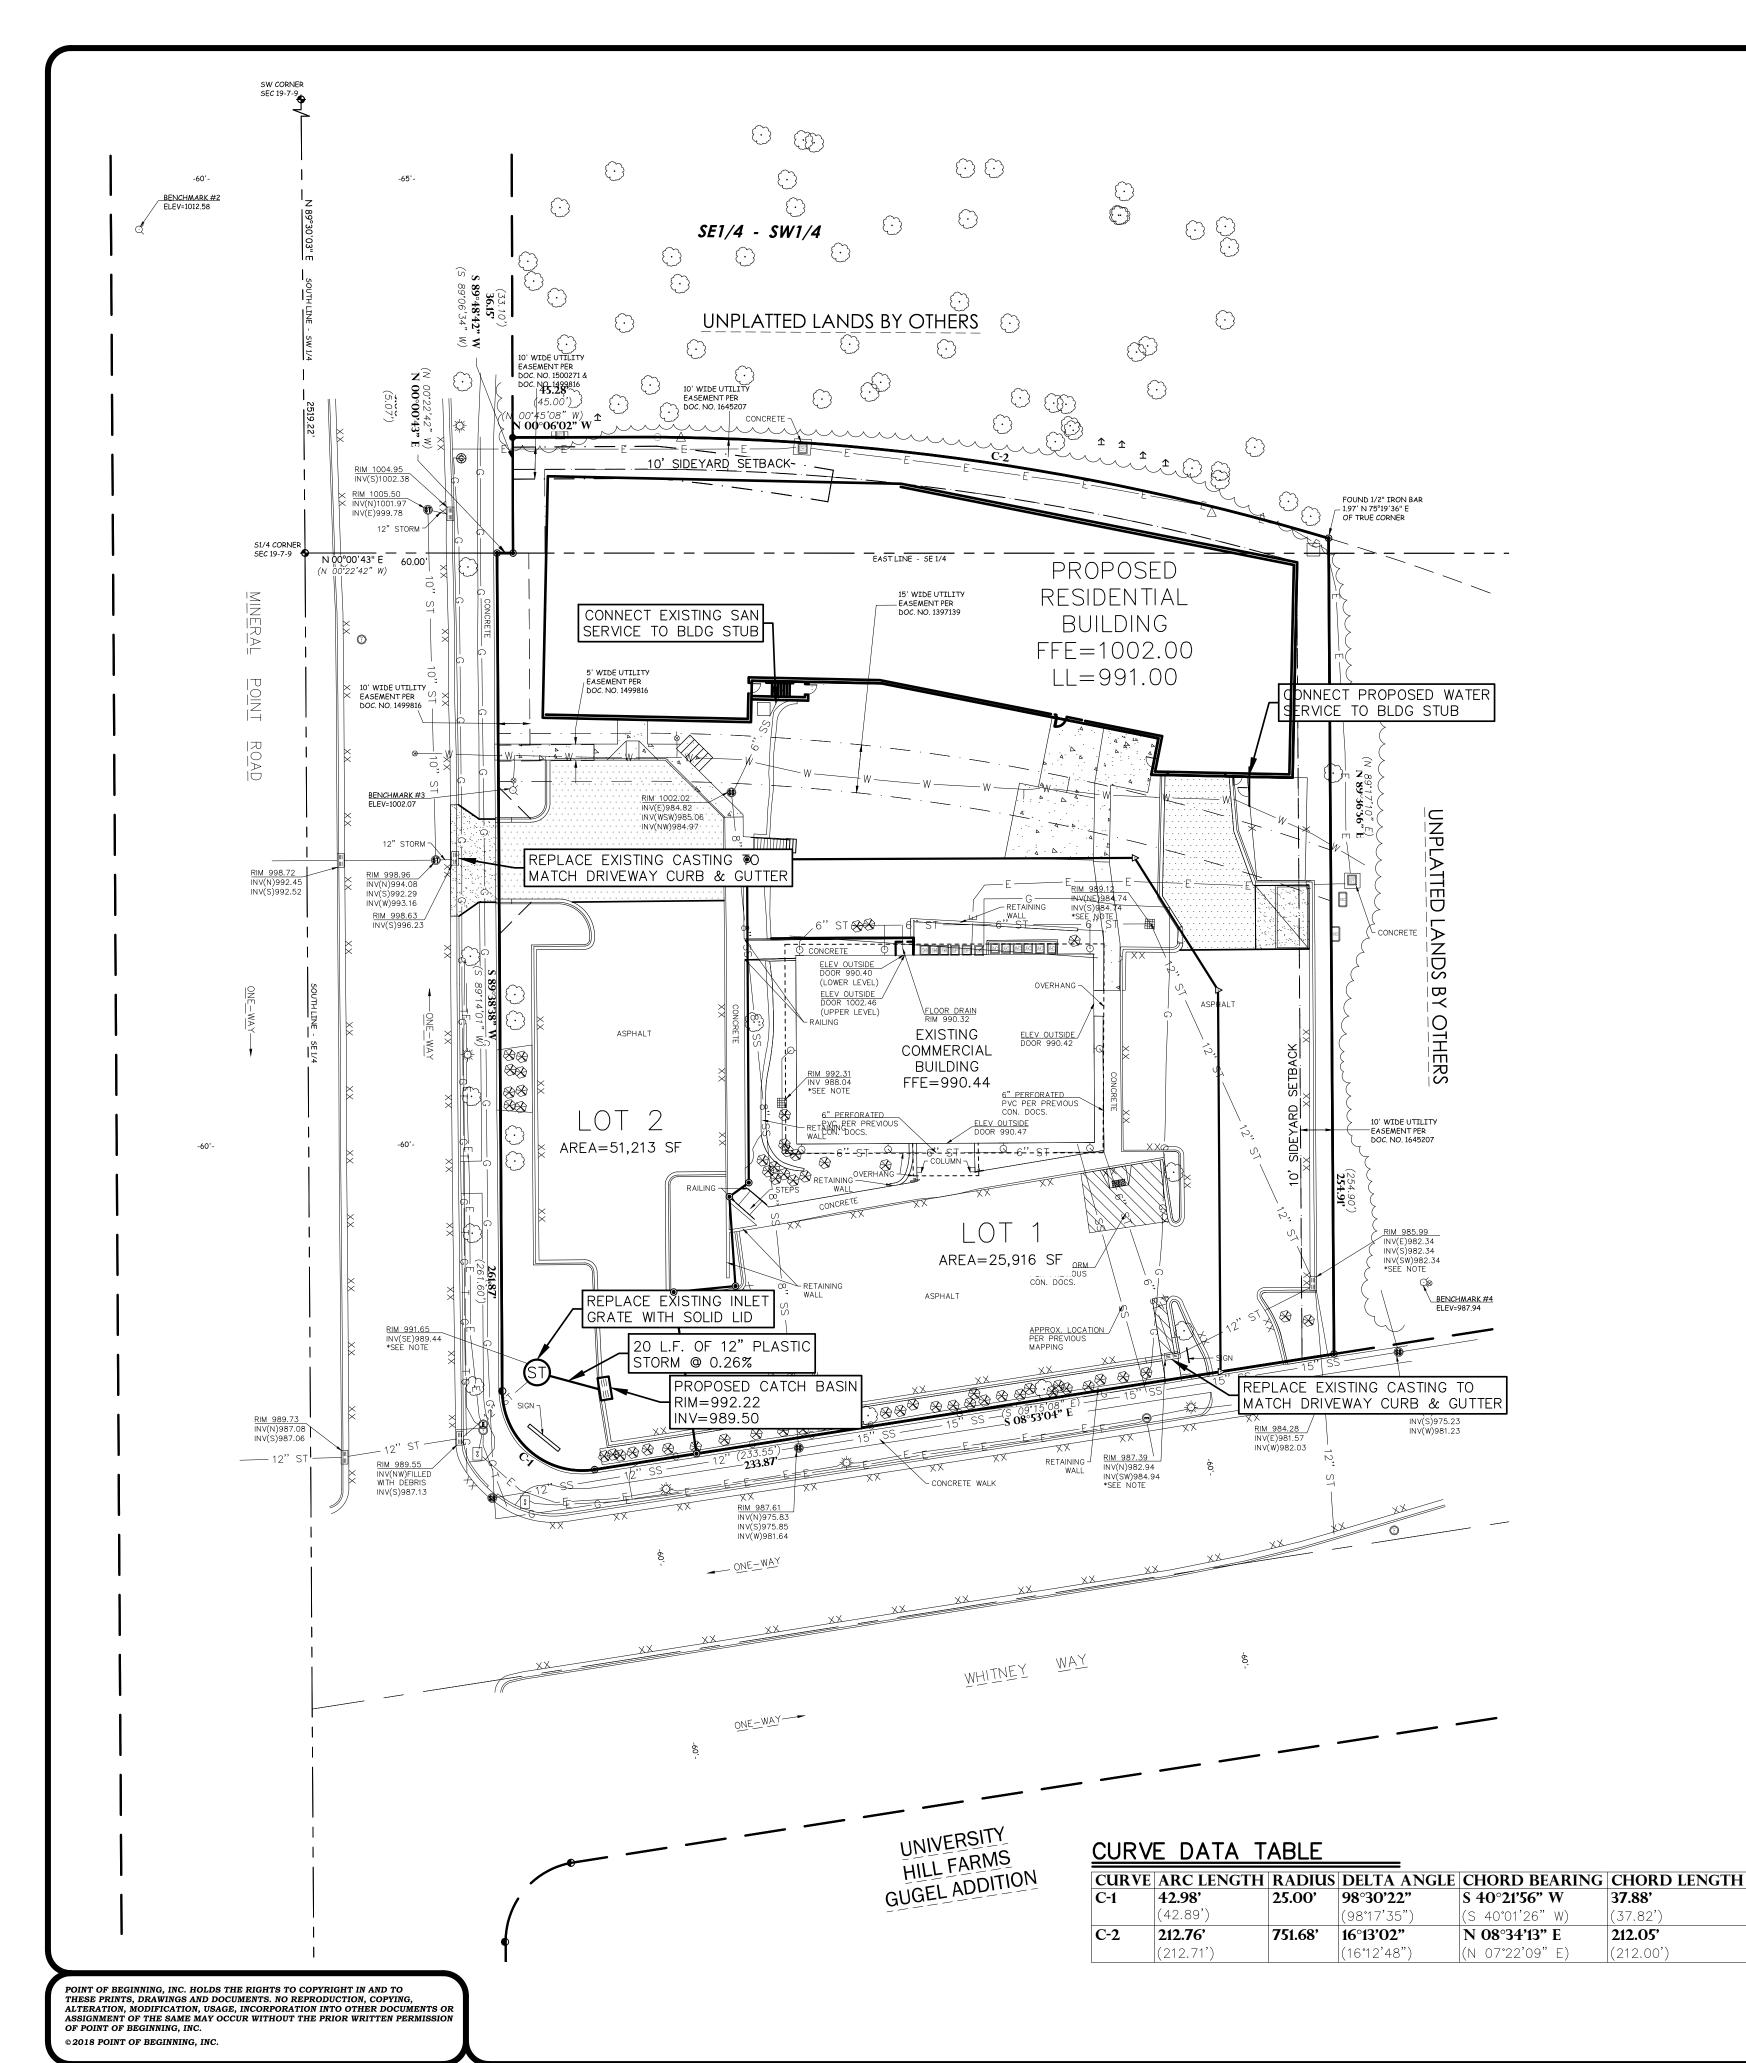
EROSION CONTROL PLAI

TRI-NORTH BUILDERS
IITNEY POINT APARTMENTS
CITY OF MADISON
ANE COUNTY, WISCONSIN

and Surveying
andscape Architecture
709 Windy Drive, Suite D
evens Point, WI 54482



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- CONTACT DIGGER'S HOTLINE 5 WORKING DAYS PRIOR TO THE START OF CONSTRUCTION.
- GRADE, LINE, AND LEVEL SHALL BE REVIEWED IN THE FIELD BY THE CONSTRUCTION MANAGER.
- 3. ANY EXISTING UTILITIES NOT SHOWN ON THIS DOCUMENT WHICH NEED TO BE REMOVED, RELOCATED OR ADJUSTED SHALL BE THE RESPONSIBILITY OF THE SITE GRADING CONTRACTOR.
- 4. VERIFY EXACT SANITARY SEWER/WATER LATERAL CONNECTION LOCATIONS AND SIZES WITH THE BUILDING MECHANICAL/PLUMBING PLANS.
- 5. COORDINATE ALL UTILITY WORK WITH THE RESPECTIVE TRADES RESPONSIBLE FOR THE INSTALLATION OF GAS, CABLE,
- TELEPHONE AND ELECTRICAL (INCLUDING MAIN SERVICE, SITE LIGHTING, CONDUITS AND SIGNAGE).
- COORDINATE ALL WORK WITHIN THE PUBLIC RIGHT OF WAY WITH THE LOCAL MUNICIPALITY. TESTING AND INSPECTION SHALL BE DONE IN ACCORDANCE WITH SPS 382.21.
- 8. THE PROPOSED WATER MAIN/LATERAL SHALL HAVE A MINIMUM COVER OF 7'-6" FROM TOP OF PIPE TO PROPOSED FINISHED GRADES. SEE SHEET _____ FOR PROPOSED GRADES.
- 9. THE MUNICIPALITY SHALL BE CONTACTED PRIOR TO ANY EXCAVATION IN THE PUBLIC RIGHT-OF-WAY AND PRIOR TO CONNECTING SANITARY SEWER AND WATER LATERALS TO THE PUBLIC MAINS. THE CONTRACTOR SHALL HAVE A TRAFFIC CONTROL PLAN APPROVED PRIOR TO WORK COMMENCING. THE MUNICIPALITY SHALL OPERATE EXISTING WATER VALVES, IF
- 10. CONTRACTOR IS RESPONSIBLE FOR THE DESIGN, INSTALLATION AND PERMITTING OF THE WELL.
- 11. FIELD VERIFY INVERT ELEVATION OF THE SANITARY SEWER AND WATER PUBLIC MAIN AT THE LOCATION OF THE SERVICE
- LATERAL CONNECTIONS, PRIOR TO CONNECTING THE LATERALS TO THE PUBLIC MAIN. 12. PROVIDE RIP RAP AT PROPOSED CULVERT ENDWALL STRUCTURES TO PREVENT WASHOUT AND EROSION.
- 13. RIP RAP SHALL HAVE WisDOT TYPE HR FILTER FABRIC PLACED BENEATH.

UTILITY LEGEND:

PROPOSED STORM SEWER

PROPOSED STORM SEWER MANHOLE

PROPOSED CURB BOX INLET

3/5/2019 ACG CHECKED:

DRAWN: JHB


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, WISCONSIN BUILDERS WHITNEY POIN CITY OF TRI-NORT COUN

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INT APARTMENTS

F MADISON

VTY, WISCONSIN TRI-NORTH BUILDERS
WHITNEY POINT APARTMEN
CITY OF MADISON
DANE COUNTY, WISCONSI

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PROJECT NO. 18.141
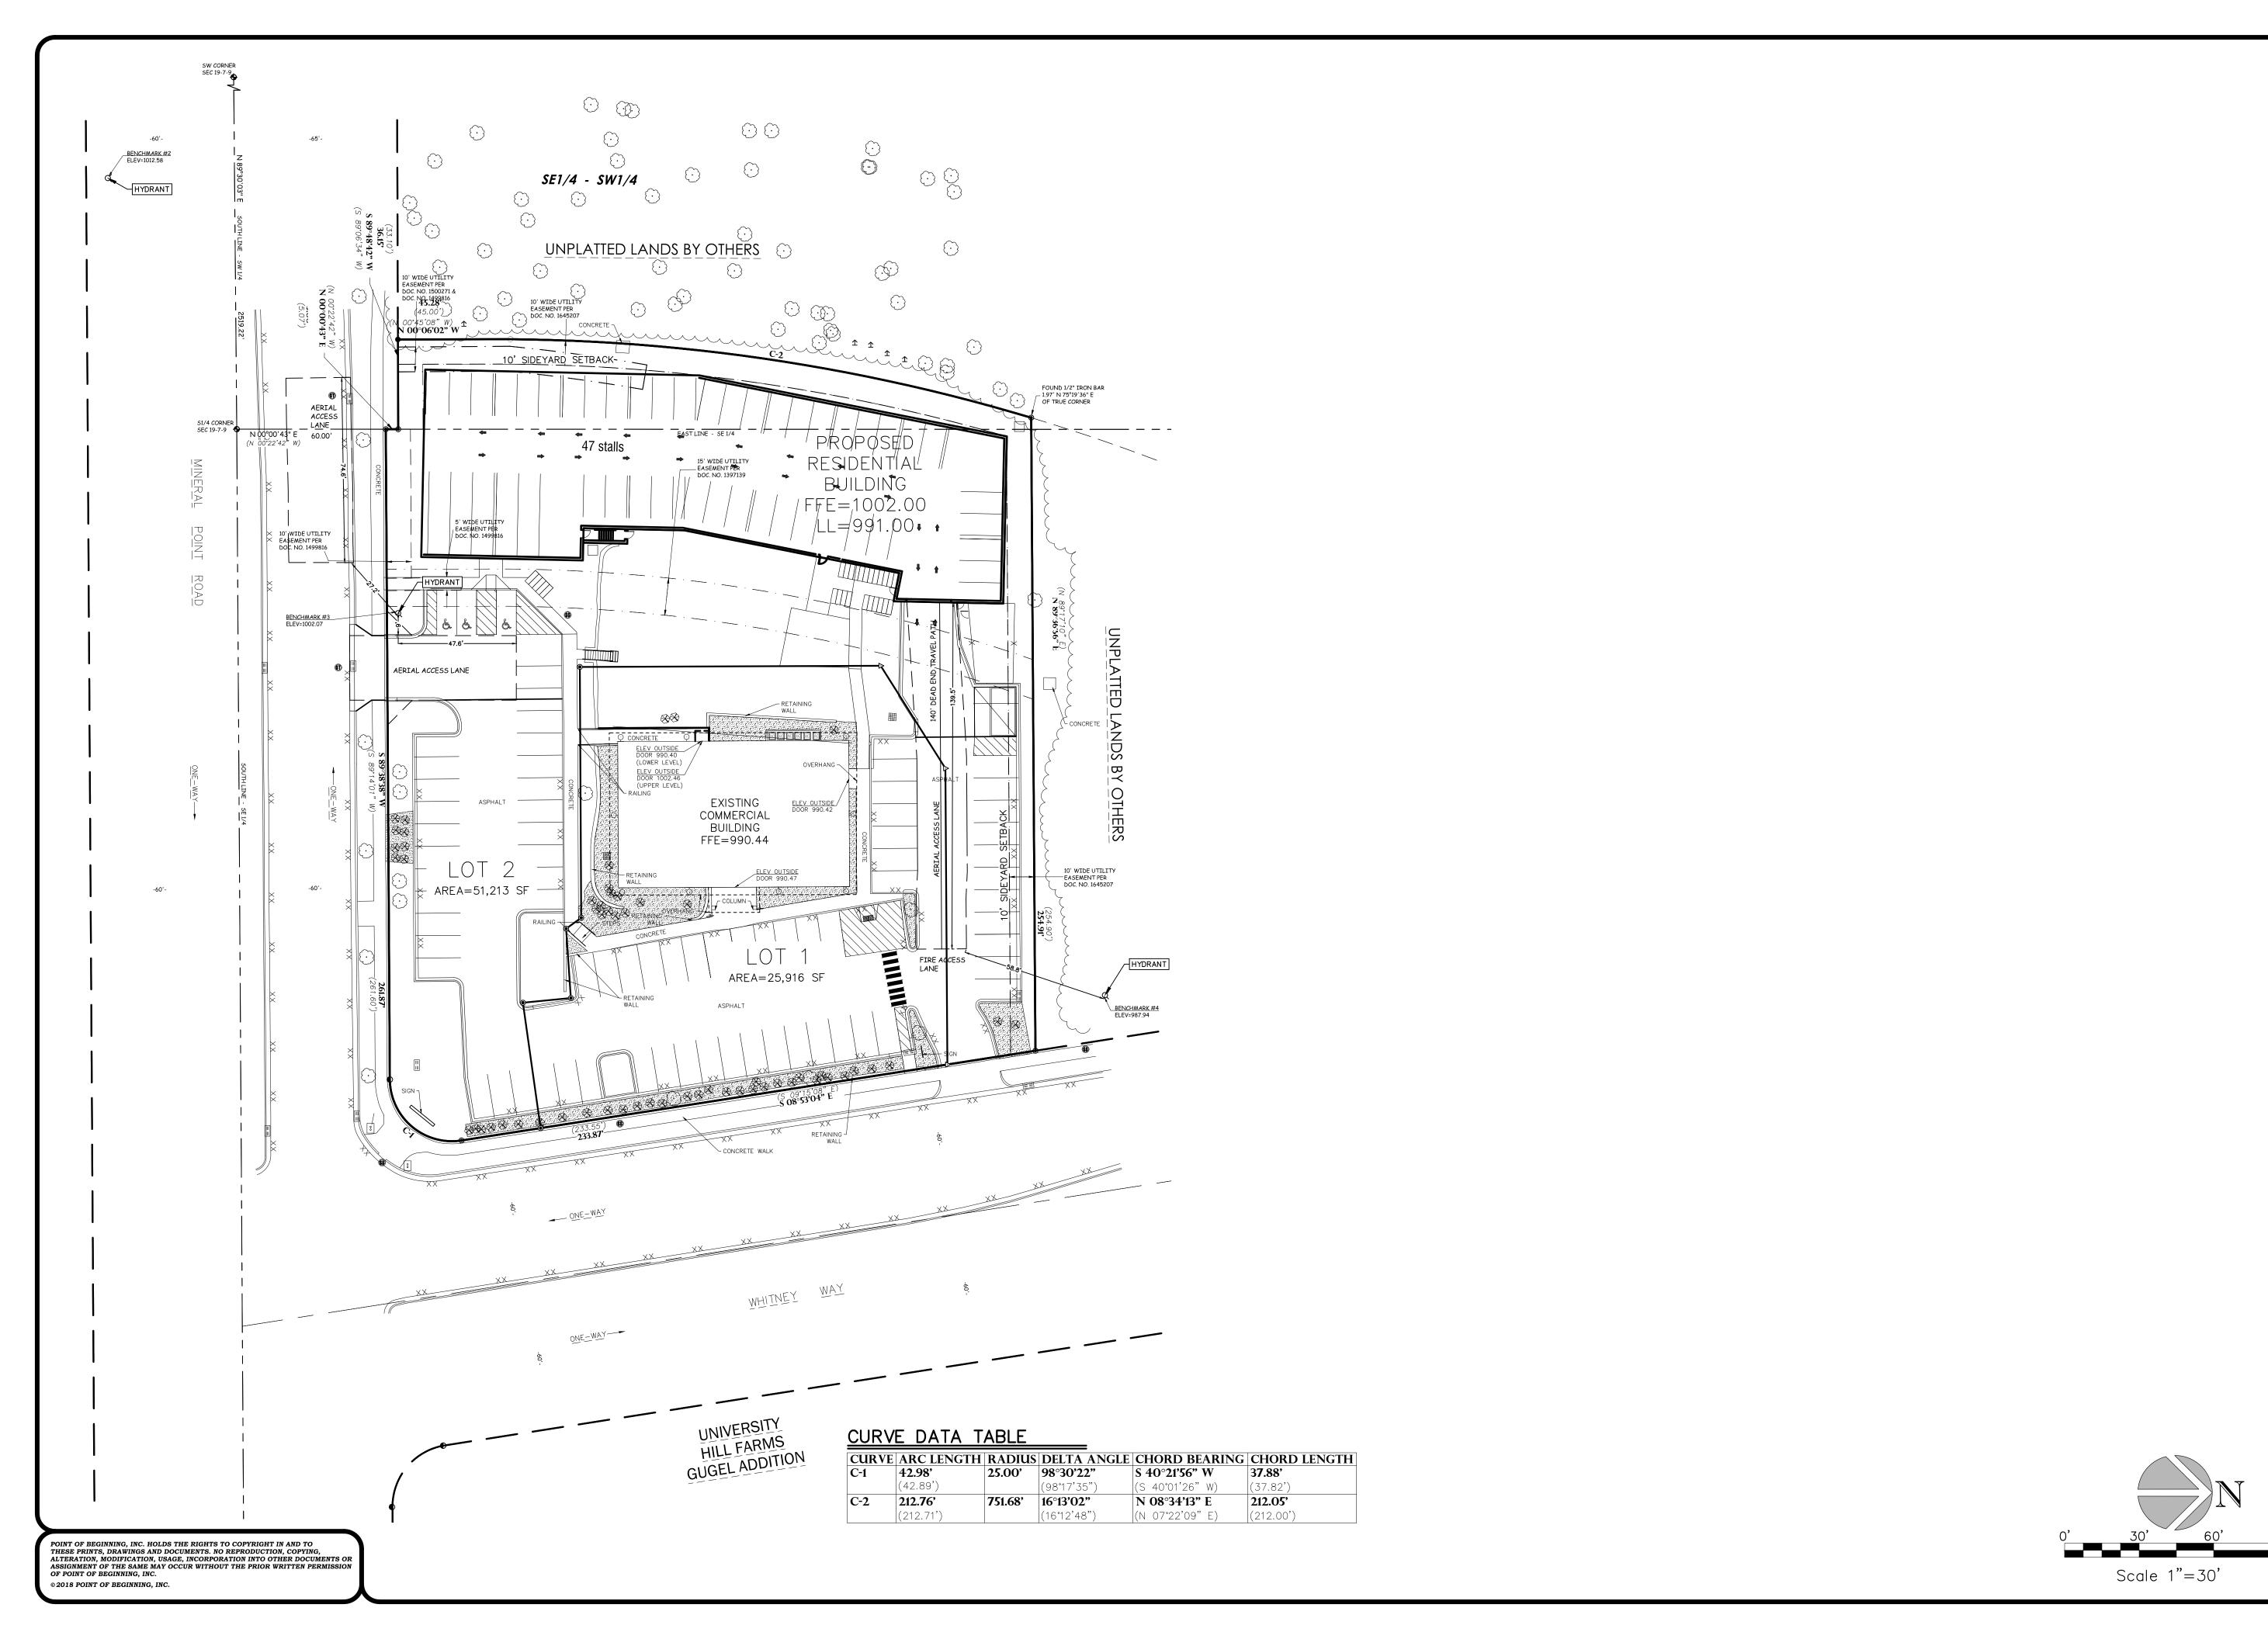
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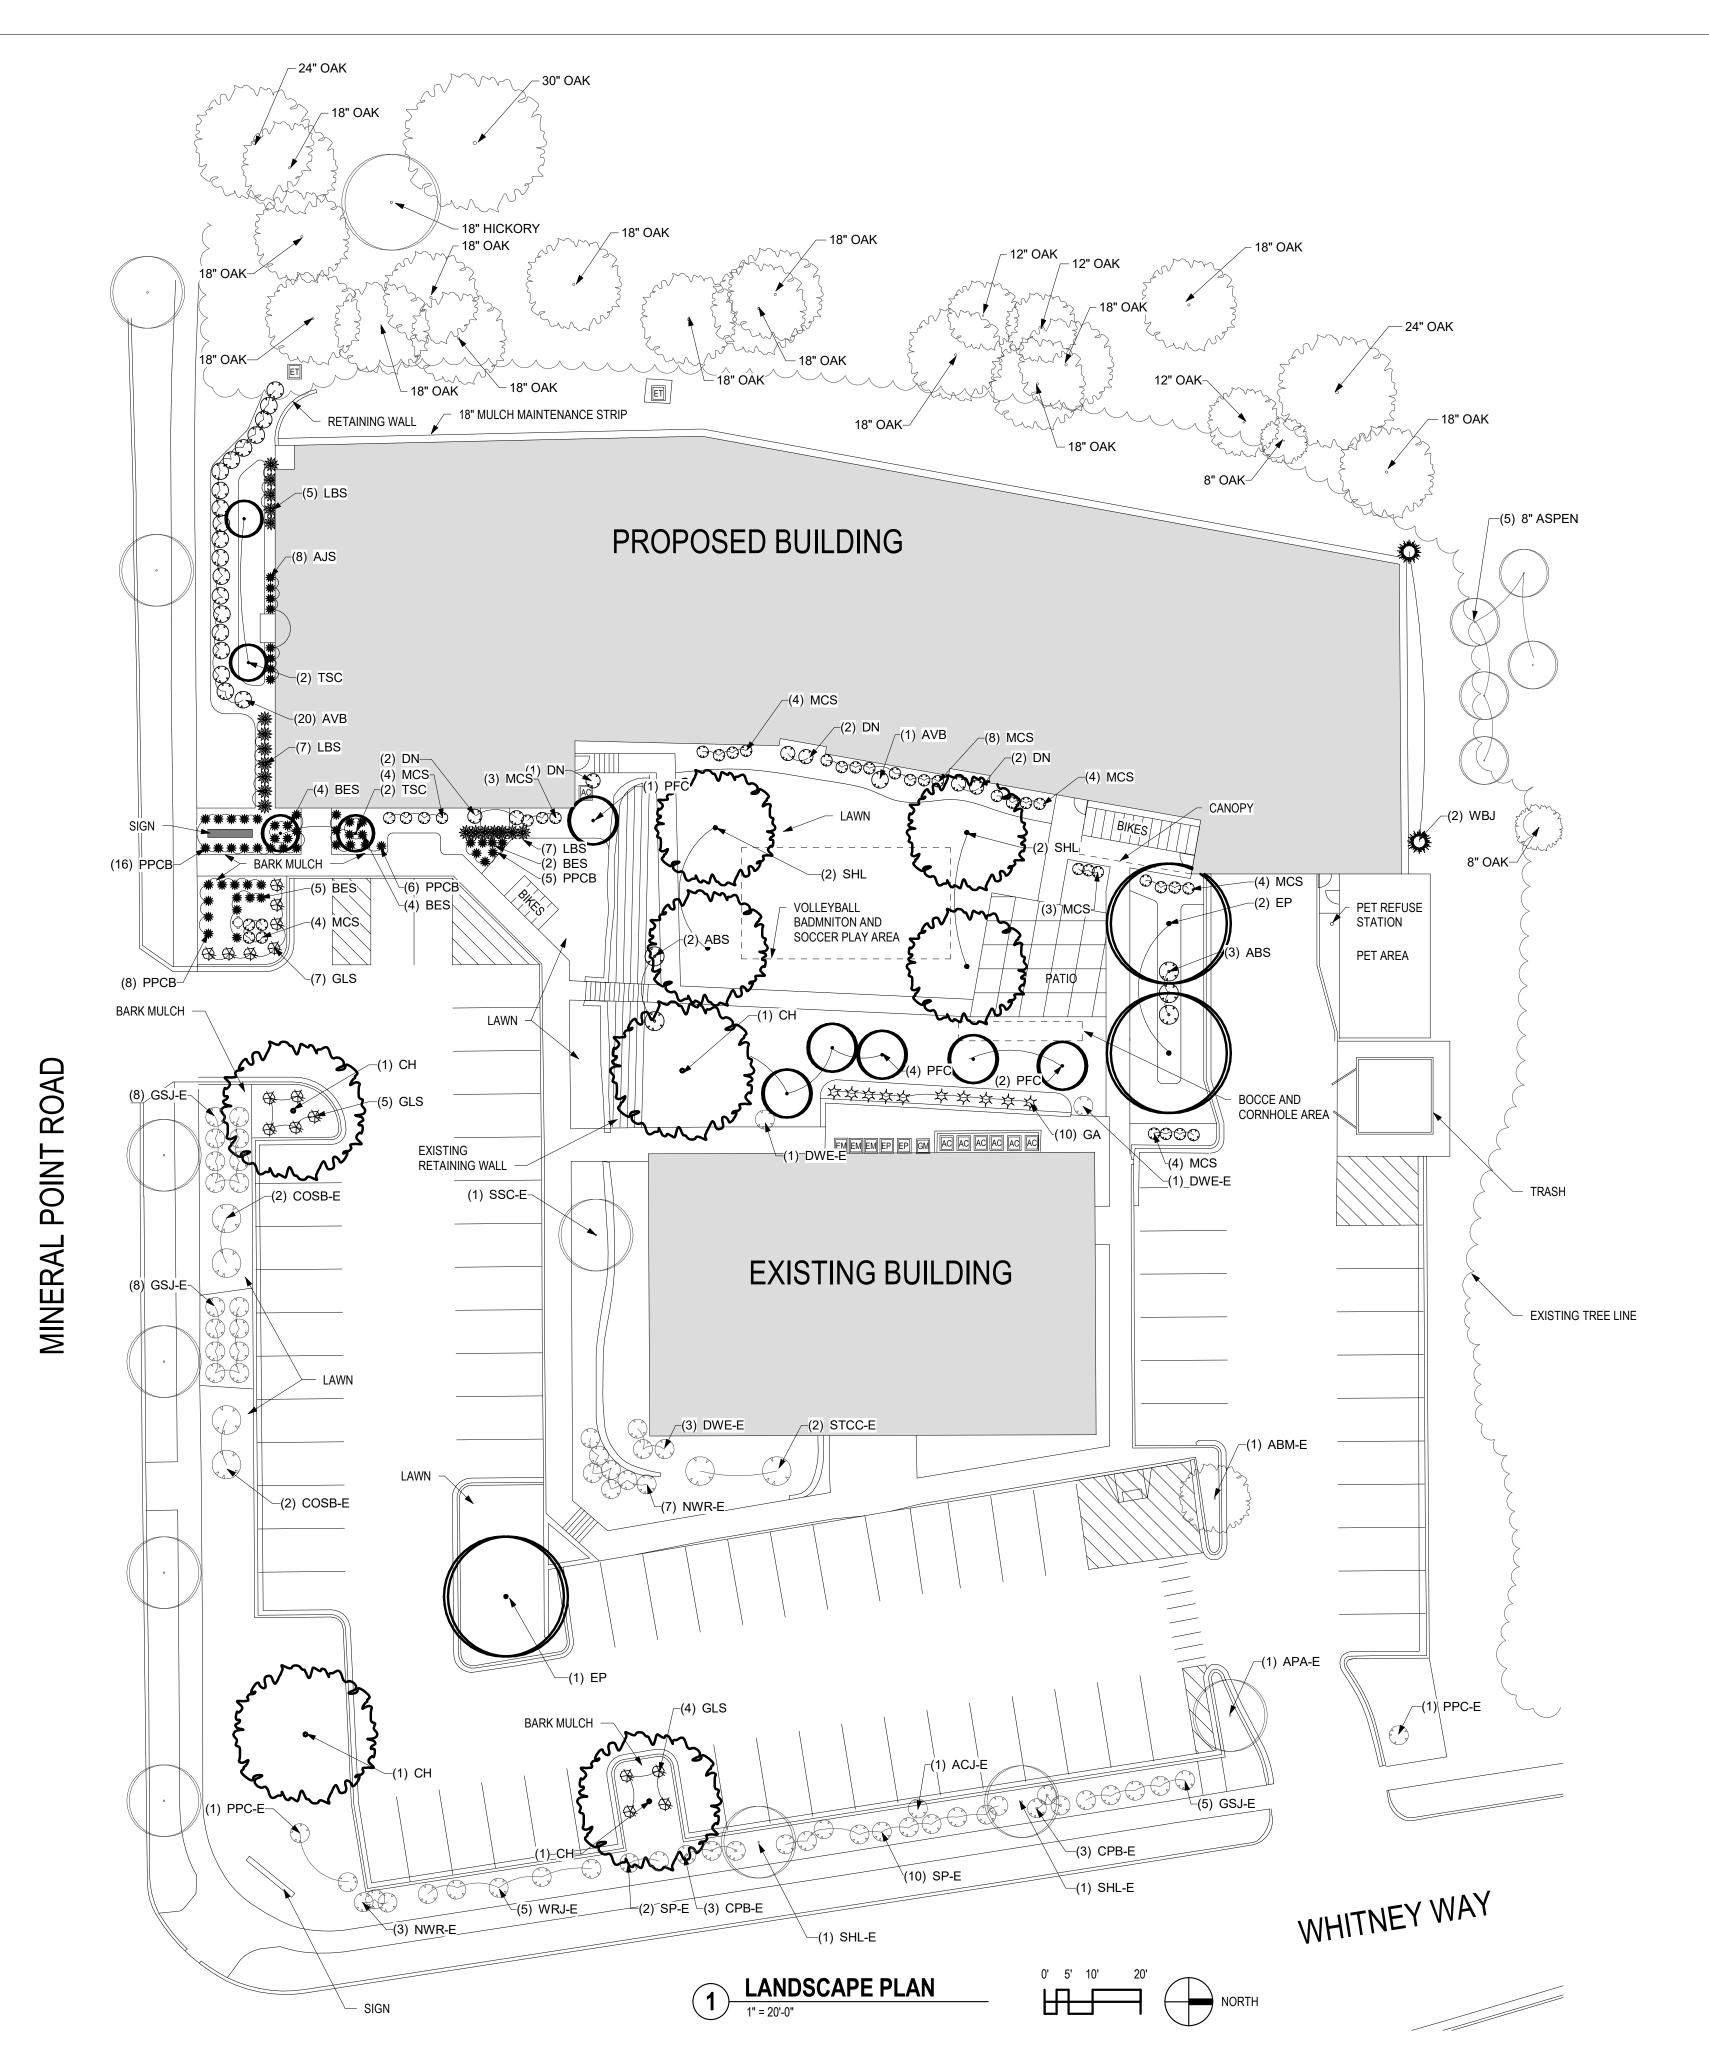
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Civil Engineering Land Surveying Landscape Architecture

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PLANT LIST

KEY	SIZE	QUANTITY	COMMON NAME	BOTANICAL NAME	ROOT					
CANOPY TREES										
CH	2 1/2"	4	COMMON HACKBERRY	CELTIS OCCIDENTALIS	BB					
EP	2 1/2"	3	EXCLAMATION PLANETREE	PLATANUS	BB					
SHL	2 1/2"	4	SKYLINE HONEYLOCUST	GLEDITSIA TRICANTHOS	BB					
DECIDUOUS SHRUBS										
ABS	4'	5	A B SERVICEBERRY	AMELANCHIER GRANDIFLORA 'A B'	BB					
AVB	36"	21	ARROWOOD VIBURNUM	VIBURNUM DENTATUM	POT					
DN	24"	7	DIABLO NINEBARK	PHYSOCARPUS	POT					
GLS	18"	16	GRO LOW SUMAC	RHUS AROMATICA	POT					
MCS	18"	38	MAGIC CARPET SPIREA	SPIREA JAPONICA 'MAGIC CARPET'	POT					
EVERGREEN SHRUBS										
GA	3'	10	GLOBE ARBORVITAE	THUJA OCCIDENTALIS 'WOODWARD'	BB					
WBJ	5'	2	WICHITA BLUE JUNIPER	THUJA	BB					
ORNAMENTAL TREES										
PFC	2"	7	PRAIRIE FIRE CRAB	MALUS 'PRAIRIE FIRE'	BB					
TSC	2"	4	TINA SARGENT CRAB	TINA MALUS SARGENTII 'TINA'	BB					
PERENNIALS										
AJS	1 G	8	AUTUMN JOY SEDUM		CON					
BES	1 G	15	BLACK EYED SUSAN		CON					
LBS	1 G	19	LITTLE BLUESTEM GRASS		CON					
PPCB	1 G	34	PURPLE PALACE CORAL BELLS		CON					

NOTES:

- Lawn areas to receive a minimum of 4" of topsoil, starter fertilizer, and # 1 locally grown bluegrass sod.
- Foundation planting beds to be mulched with shredded hardwood bark spread to a depth of 3".

 Individual trees and shrub groupings in lawn areas to receive shredded hardwood bark mulch spread to a depth of 3".

 Designated planting beds to be separated from lawn areas with 5" black vinyl bed edging.
- Owner will be responsible for maintenance after completion and acceptance.

<u>ISTING PLANT LIST</u>	LAND

		EXISTI	NG PLANT LIST	LANDSCAPE WORKSHEET		
KEY	SIZE	QUANTITY	COMMON NAME	ROOT	Whitney Point	
					Landscape Points Required	
CANOPY	TREES			Developed Area =	20,945 SF	
ABM-E	12" +	1	AUTUMN BLAZE MAPLE	EX	Landscape Points: 20,945 /300 x 5 =	349 points
APA-E	12" +	1	AUTUMN PURPLE WHITE ASH	EX	Total Landscape Points Required	349 points
SHL-E	12" +	2	SKYLINE HONEYLOCUST	EX	Landscape Points Supplied	-
						
DECIDUO	US SHR	UBS			Existing canopy trees – 4 @ 35 = Proposed canopy trees - 11 @ 35 =	140 points 385 points
CPB-E	24" +	6	CRIMSON PYGMY BARBERRY	EX	Existing evergreen trees – 0 @ 35 =	0 points
DWE-E	48" +	5	DWARF WINGED EUONYMUS	EX	Proposed evergreen trees – 0 @ 35 =	0 points
NWR-E	24" +	10	NEARLY WILD ROSE	EX	Existing ornamental trees - 10 @ 15 = Proposed ornamental trees -10 @ 15 =	150 points 150 points
					Existing upright evergreen shrubs – 0 @ 10 =	0 points
SP-E	24" +	12	SNOW MOUND SPIREA	EX	Proposed upright evergreen shrubs – 0 @ 10 = Existing deciduous shrubs – 33 @ 3 =	0 points 99 points
					Proposed deciduous shrubs – 87 @ 3 =	261 points
EVERGRE	EEN SHF	RUBS			Existing evergreen shrubs – 29 @ 4 =	116 points
ACJ-E	24" +	1	ANDORRA COMPACT JUNIPER	EX	Proposed evergreen shrubs – 12 @ 4 = Existing perennials & grasses 0 @ 2 =	48 points 0 points
GSJ-E	24" +	21	GREEN SARGENT JUNIPER	EX	Proposed perennials & grasses 73 @ 2 =	146 points
WRJ-E		5	WEBBER JUNIPER	EX	Total landscape points supplied =	<u>1,495 points</u>
					Lot Frontage Landscape Required	
ORNAME	NTAL TR	REES			(Section 28.142(5) Development Frontage Landscaping)	
COSB-E	6" +	4	COLE SERVICEBERRY	EX	"One (1) over-story deciduous tree and five (5) shrubs shall be planted for each thirty	v (30) lineal feet of lot
PPC-E	6" +	3	PINK PRINCESS CRABAPPLE	EX	frontage. Two (2) ornamental trees or two (2) evergreen trees may be used in place	
SSC-E	6" +	1	SPRING SNOW CRABAPPLE	EX	deciduous tree."	
STCC-E	6" +	2	SARGENT CRABAPPLE	EX	Mineral Point Road/Whitney Way =	560 LF
					Over story trees required 560'/30' = 18.6 Shrubs required (560'/30') x 5 = 26.6	19 trees 93 shrubs
					Over story trees supplied Ornamental/Evergreen trees supplied Shrubs supplied	15 trees 20 trees 238 shrubs





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PROJECT: WHITNEY POINT APARTMENTS 5402 S. WHITNEY WAY MADISON, WI 53705

LANDSCAPE PLAN

CHECKED BY: SH DRAWN BY: TMT PROJECT NO: 18001-025 DATE: 04/30/2019






PROJECT:
WHITNEY POINT APARTMENTS
5402 S. WHITNEY WAY
MADISON, WI 53705

SITE PLAN


 DRAWN BY: TMT
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 PROJECT NO: 18001-025
 DATE: 04/30/2019

OJECT NO: 18001-025 | DATE: 04/30/2019

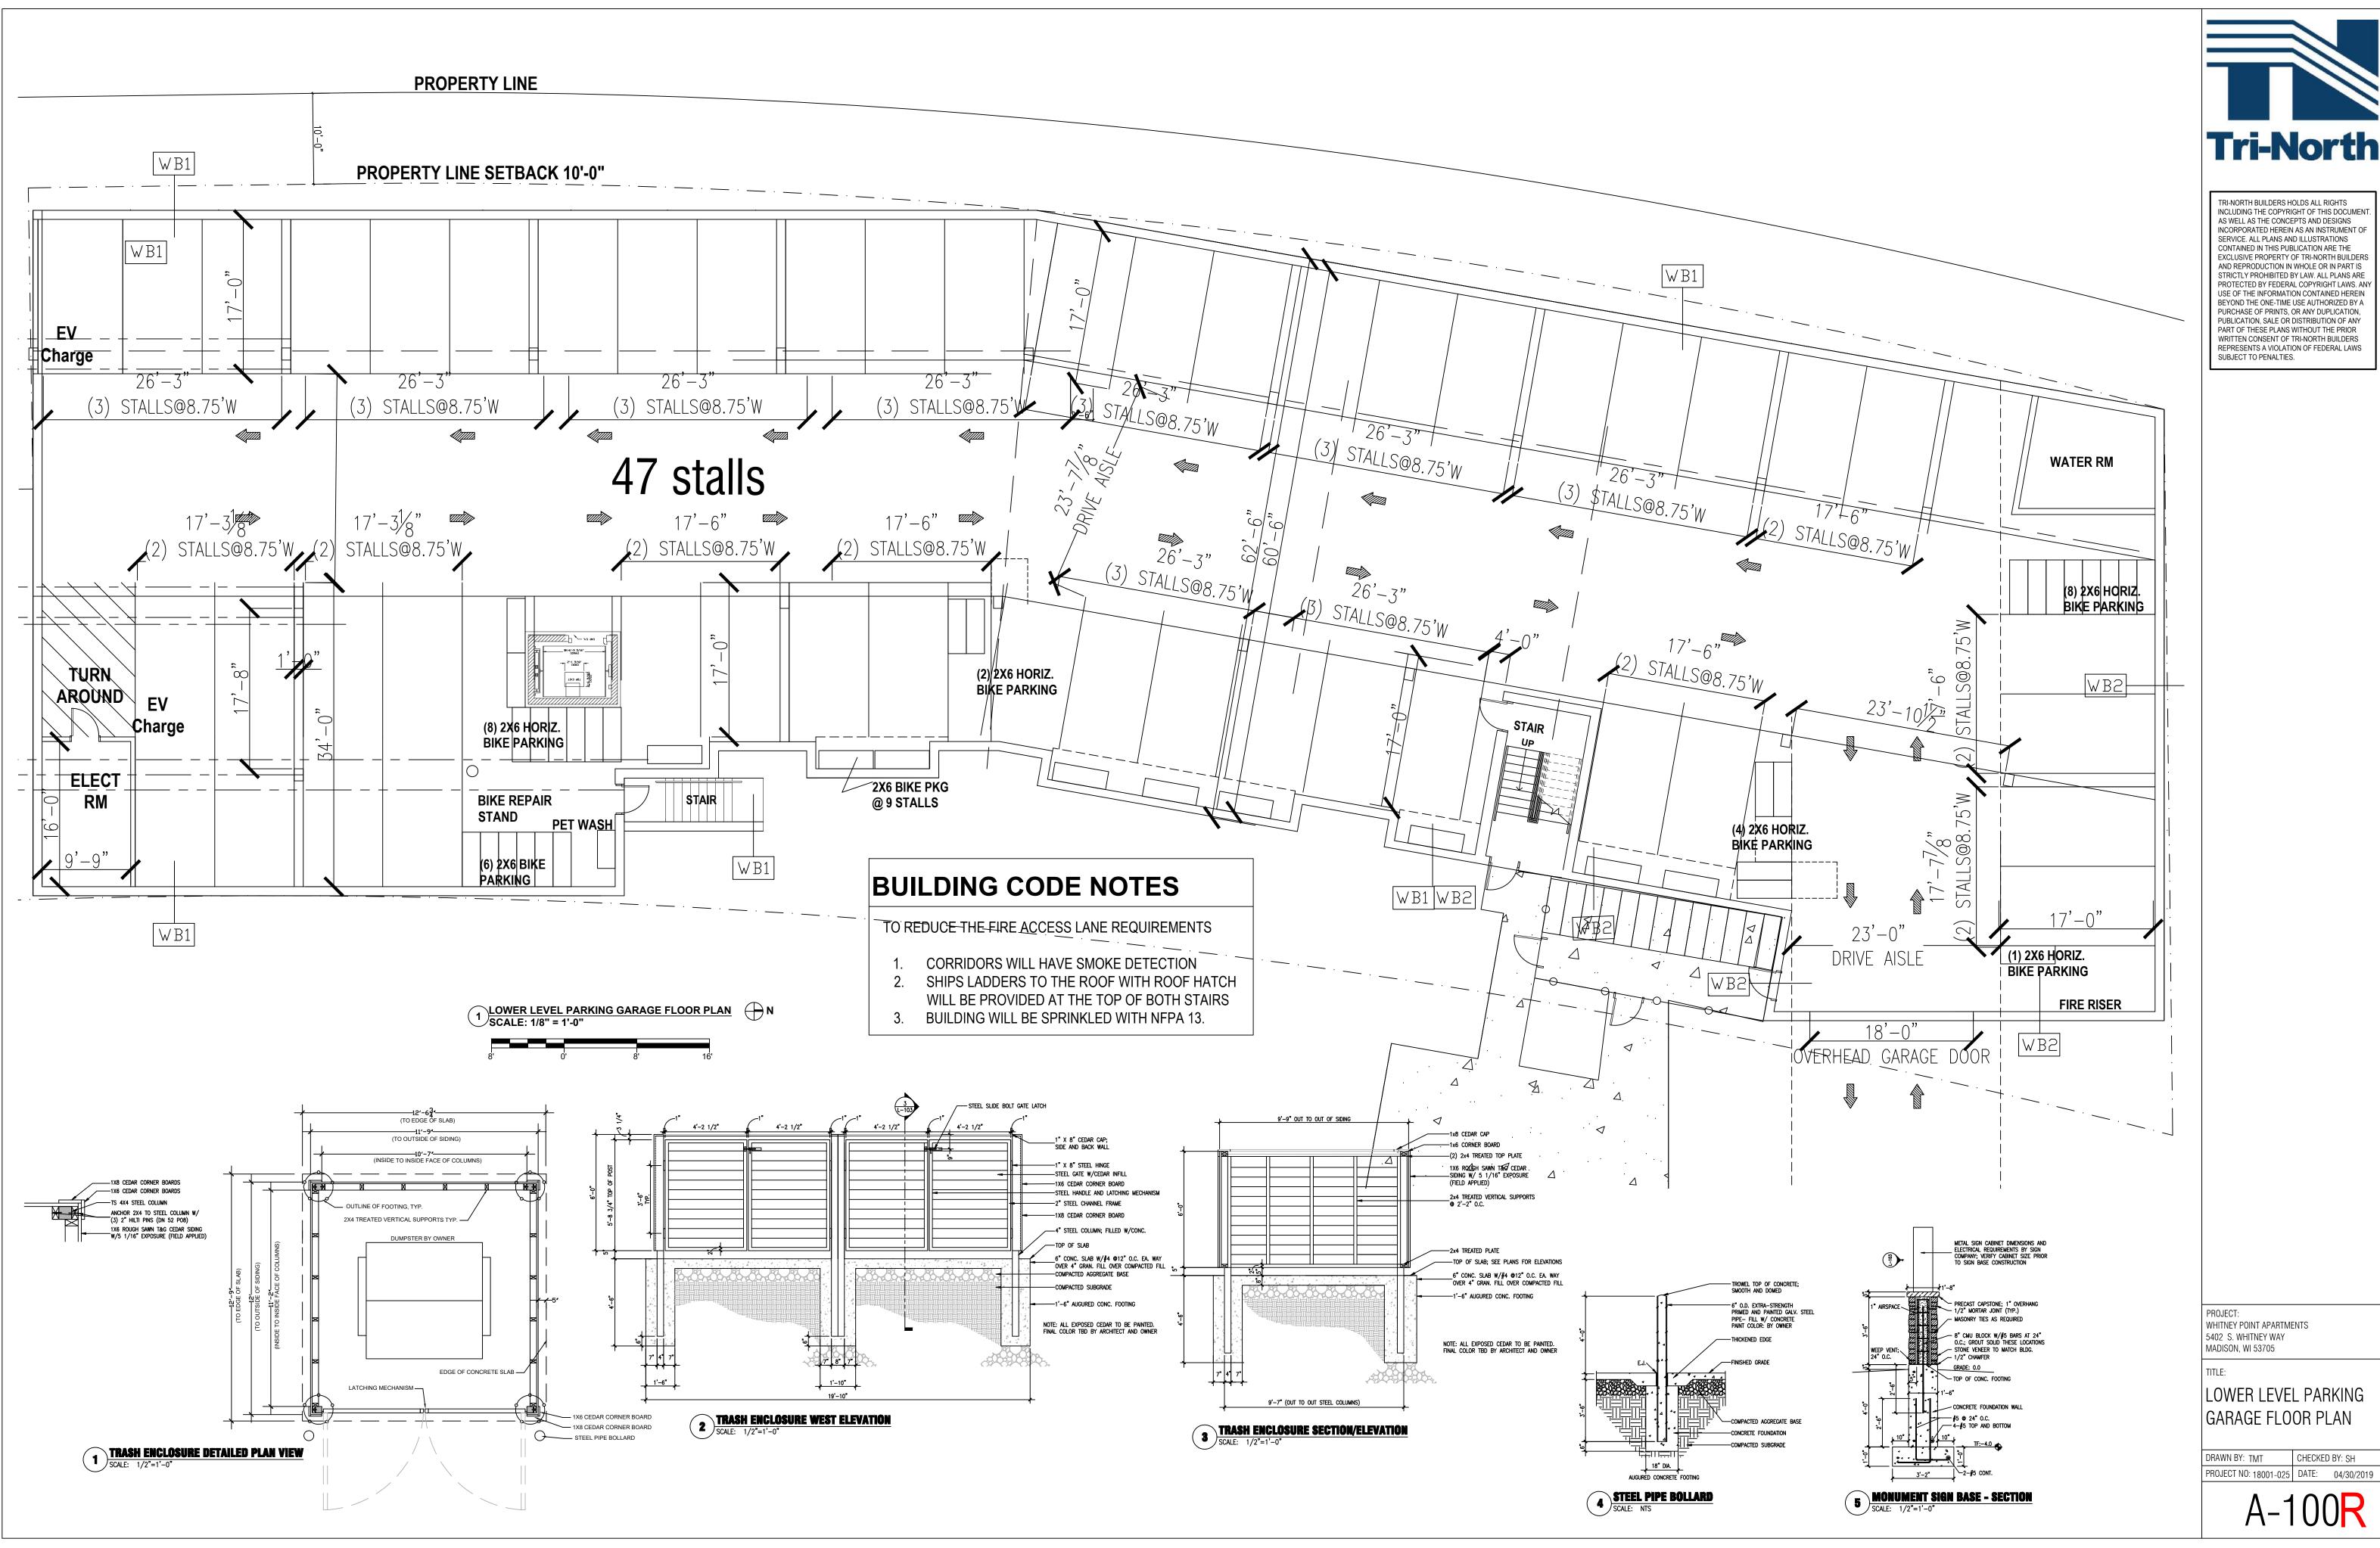

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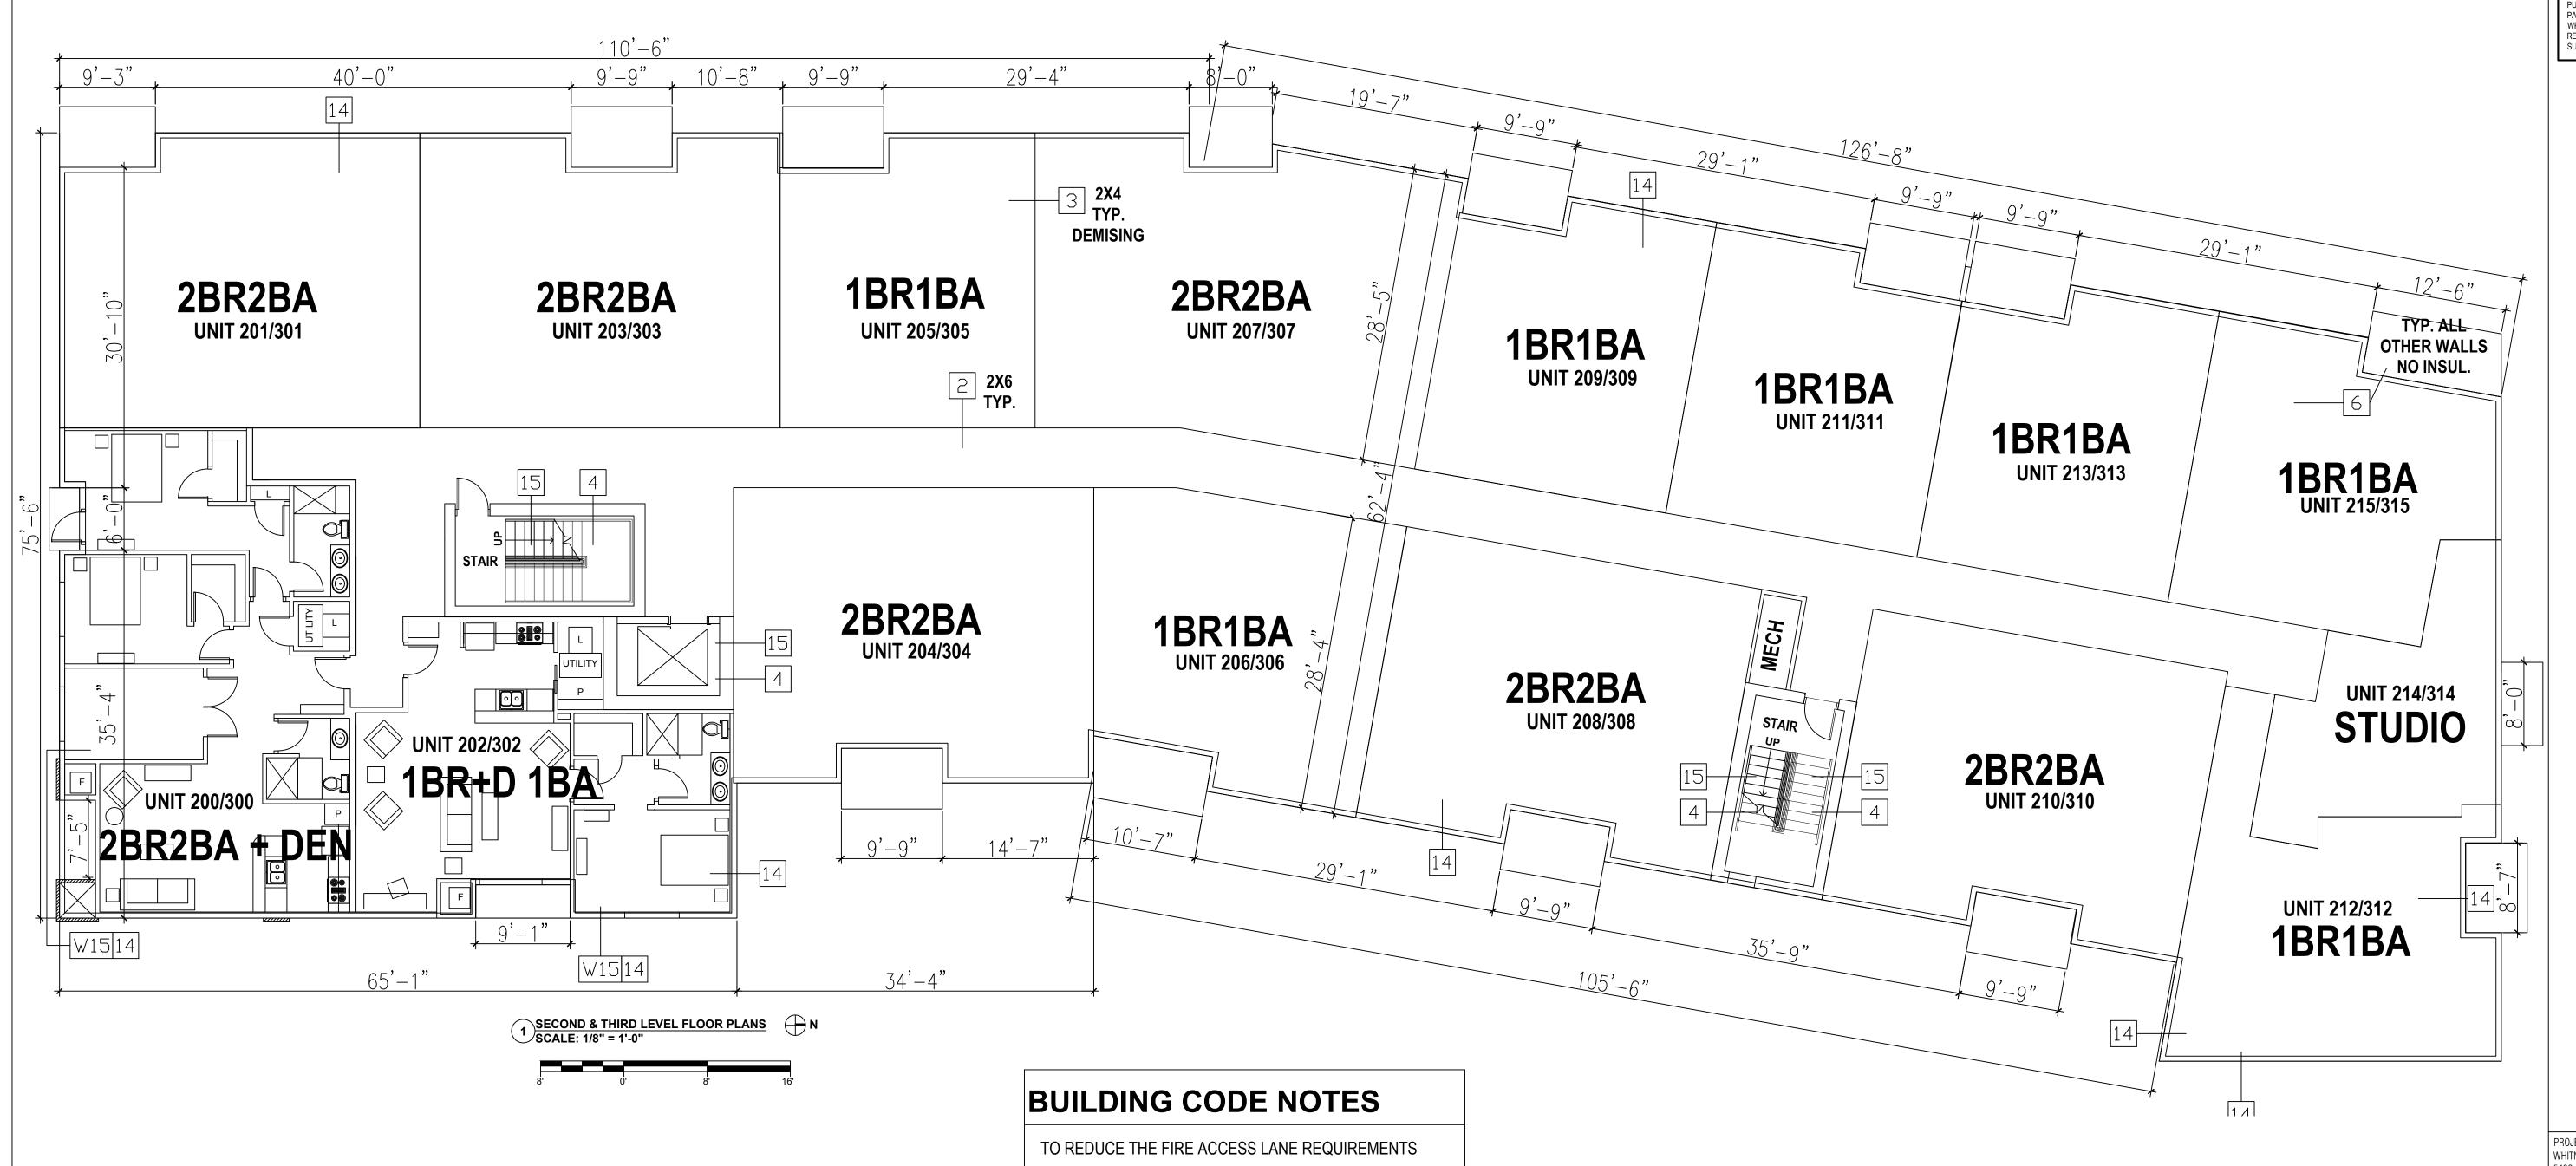
PROJECT: WHITNEY POINT APARTMENTS 5402 S. WHITNEY WAY MADISON, WI 53705

FIRST LEVEL FLOOR PLAN

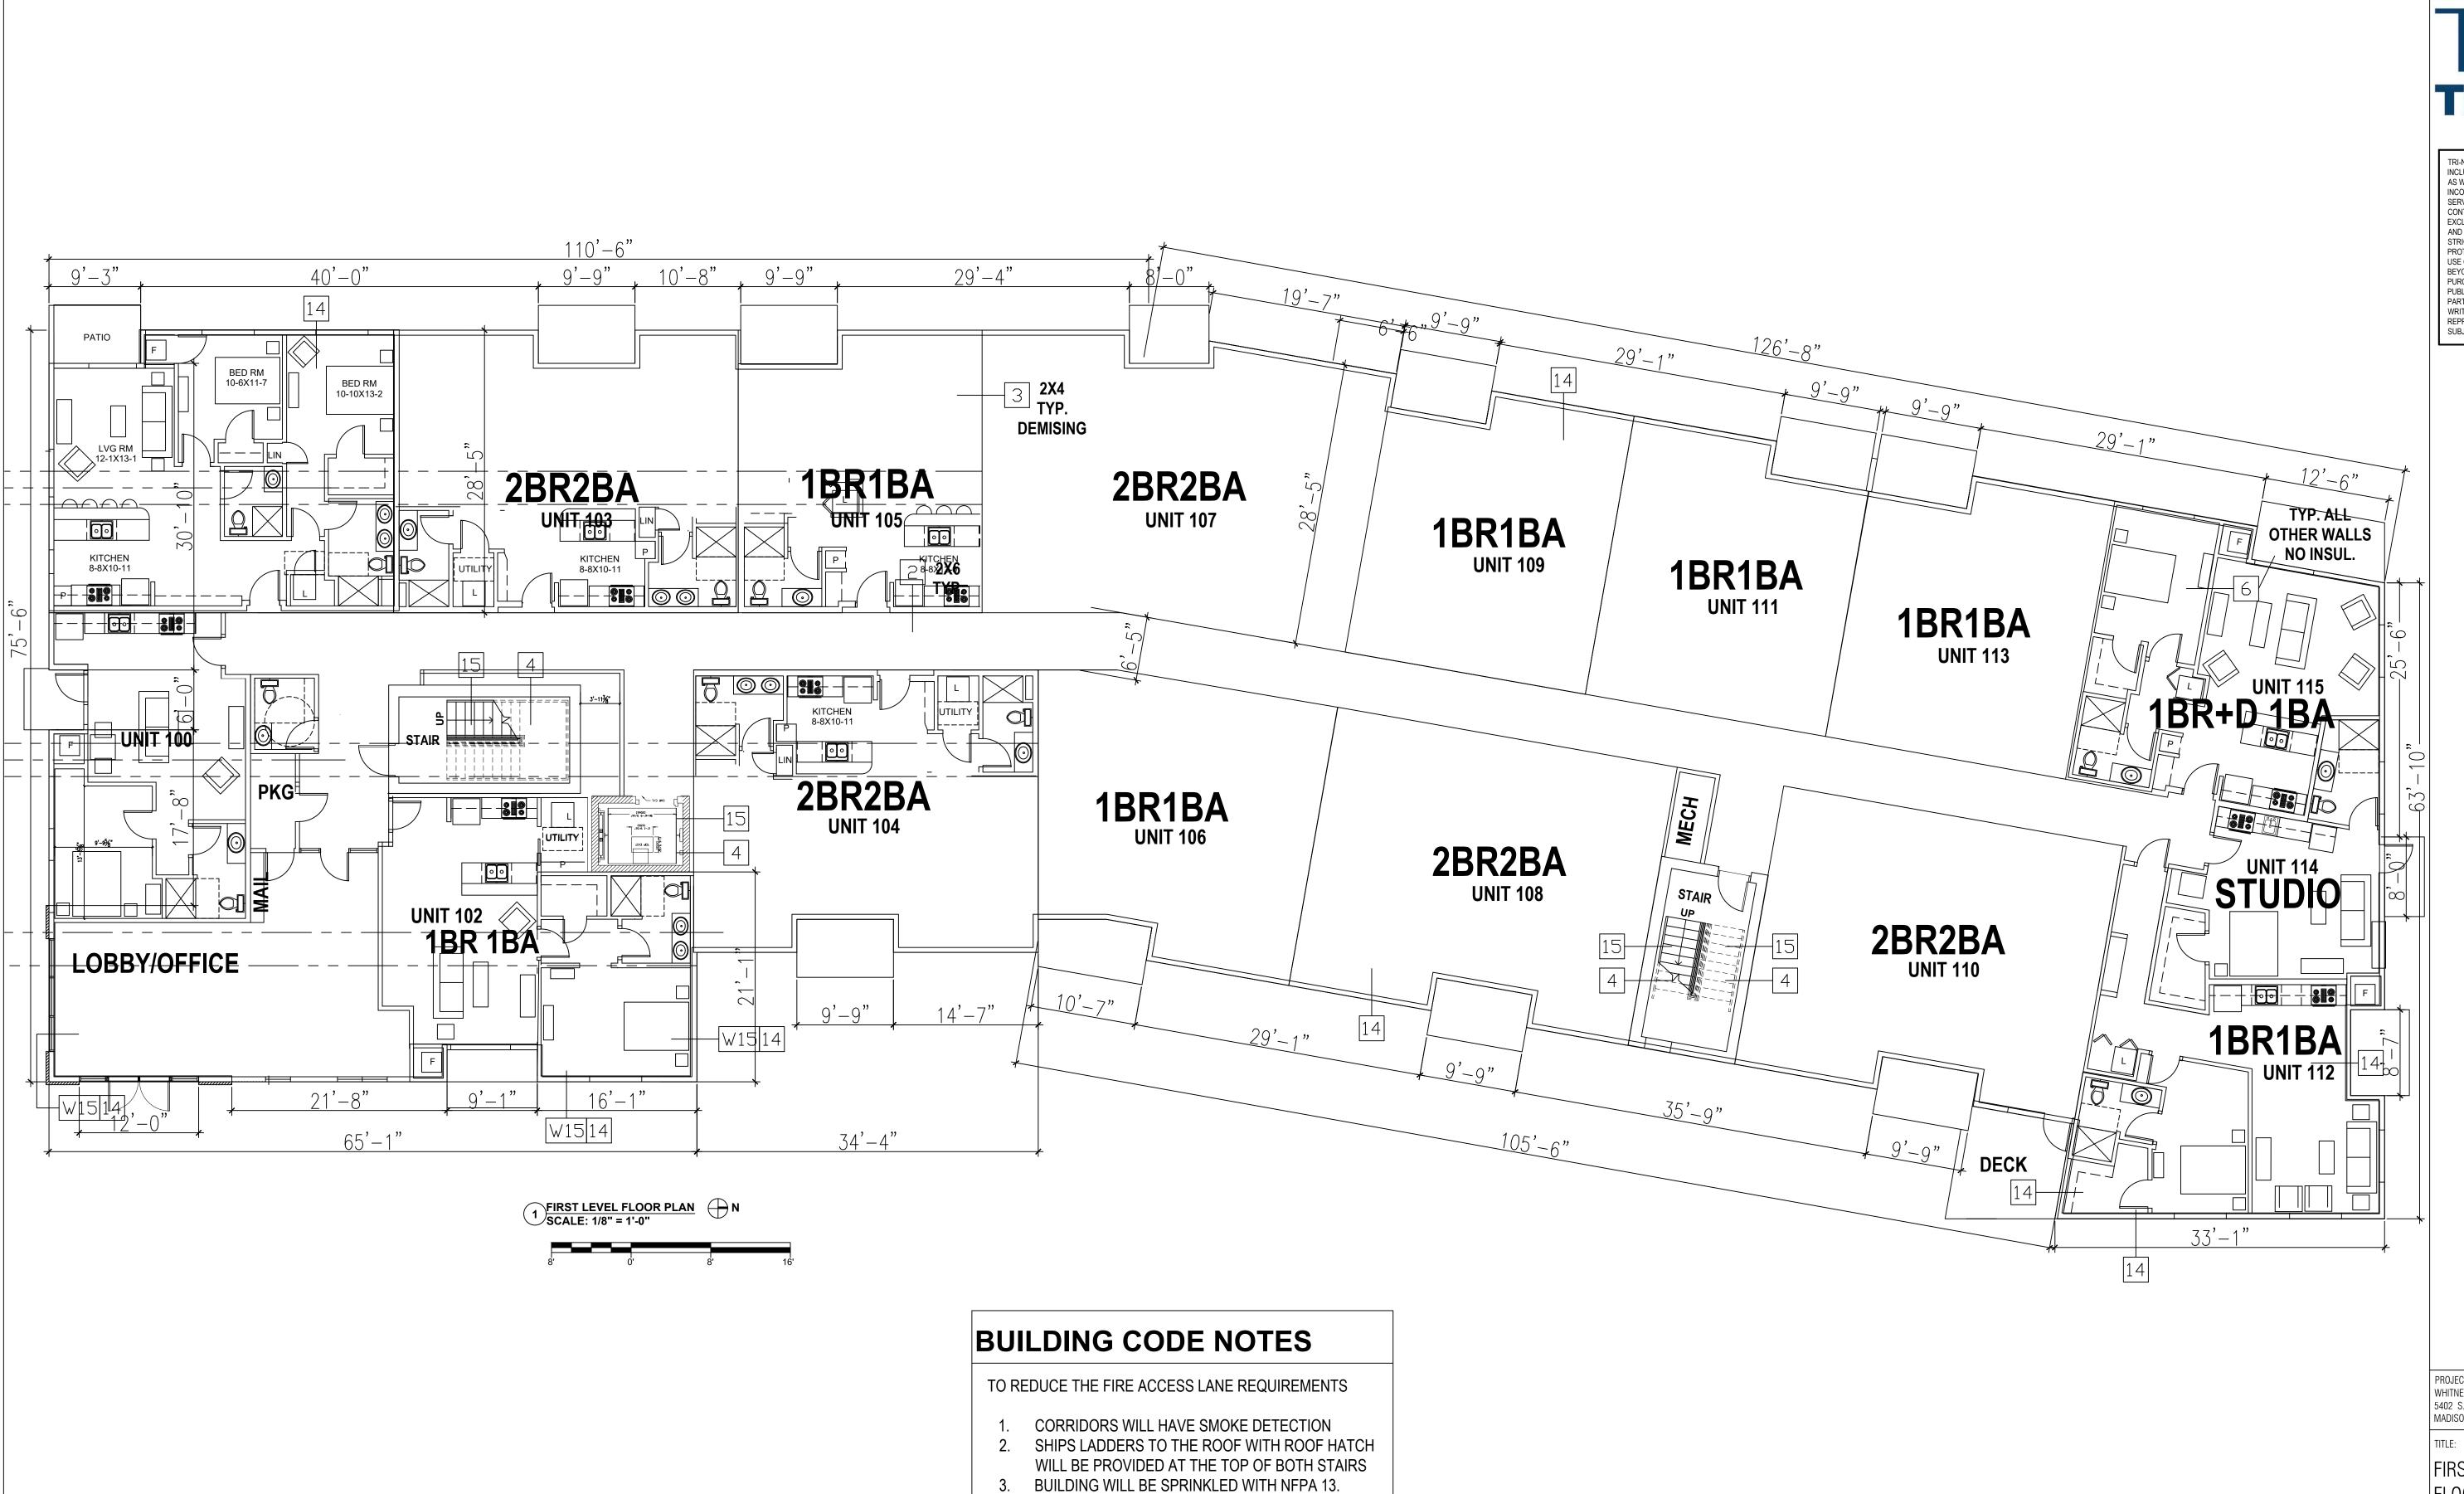DRAWN BY: TMT CHECKED BY: SH PROJECT NO: 18001-025 DATE: 04/30/2019

A-101R





CORRIDORS WILL HAVE SMOKE DETECTION
 SHIPS LADDERS TO THE ROOF WITH ROOF HATCH

3. BUILDING WILL BE SPRINKLED WITH NFPA 13.

WILL BE PROVIDED AT THE TOP OF BOTH STAIRS

PROJECT: WHITNEY POINT APARTMENTS 5402 S. WHITNEY WAY MADISON, WI 53705

TITLE:


SECOND & THIRD LEVEL FLOOR PLANS

 DRAWN BY: TMT
 CHECKED BY: SH

 PROJECT NO: 18001-025
 DATE: 02/05/2019

A-102



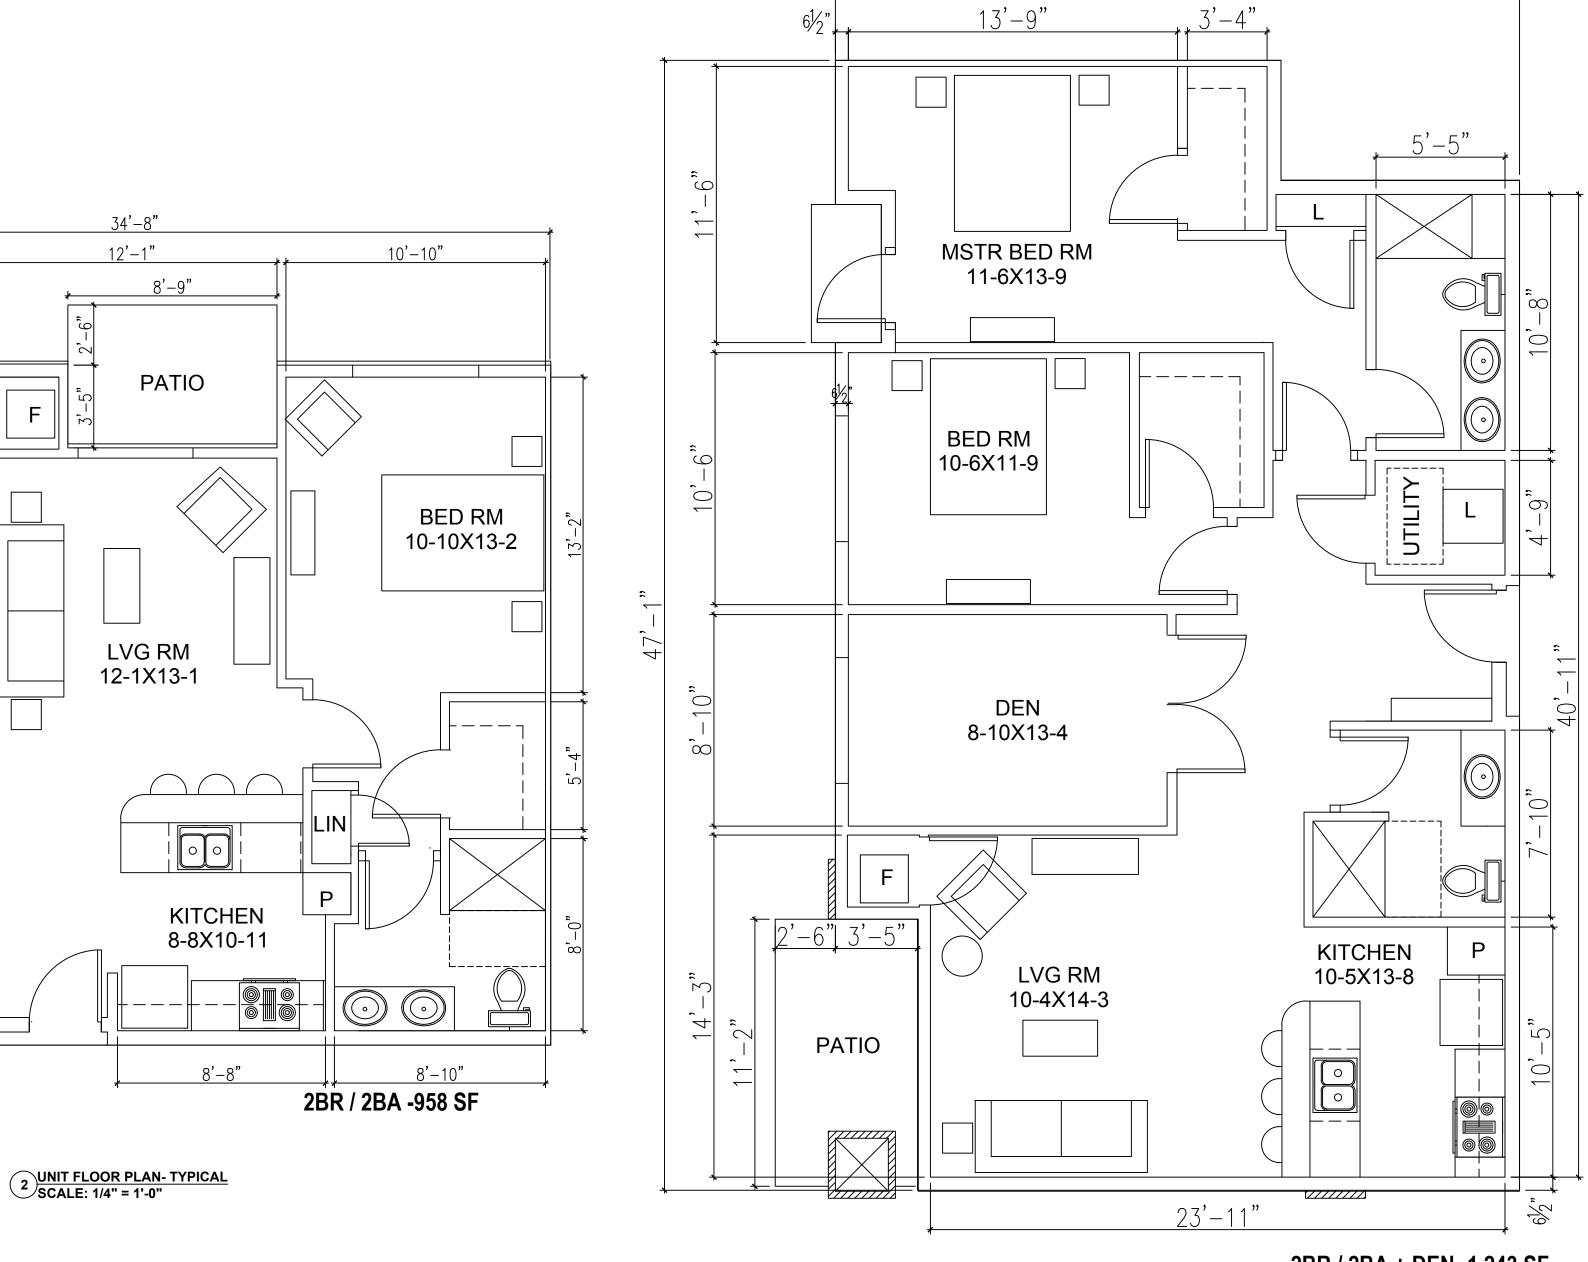

10'-6"

BED RM

10-6X11-7

UTILITY

10'-2"

B**Ė**D RM

10-2X12-9

.61/2"

13'-1"

LVG RM <

11-9X13-1

PATIO

KITCHEN

8-8X12-0

1BR / 1BA -654 SF

1 UNIT FLOOR PLAN- TYPICAL SCALE: 1/4" = 1'-0"

2BR / 2BA + DEN -1,243 SF

2 UNIT FLOOR PLAN SCALE: 1/4" = 1'-0"

28'-6"

PROJECT: WHITNEY POINT APARTMENTS 5402 S. WHITNEY WAY MADISON, WI 53705

TITLE:


UNIT FLOOR PLANS
TYPICALS

DRAWN BY: TMT CHECKED BY: SH
PROJECT NO: 18001-025 DATE: 02/05/2019

A-103



1) EAST EXTERIOR ELEVATION

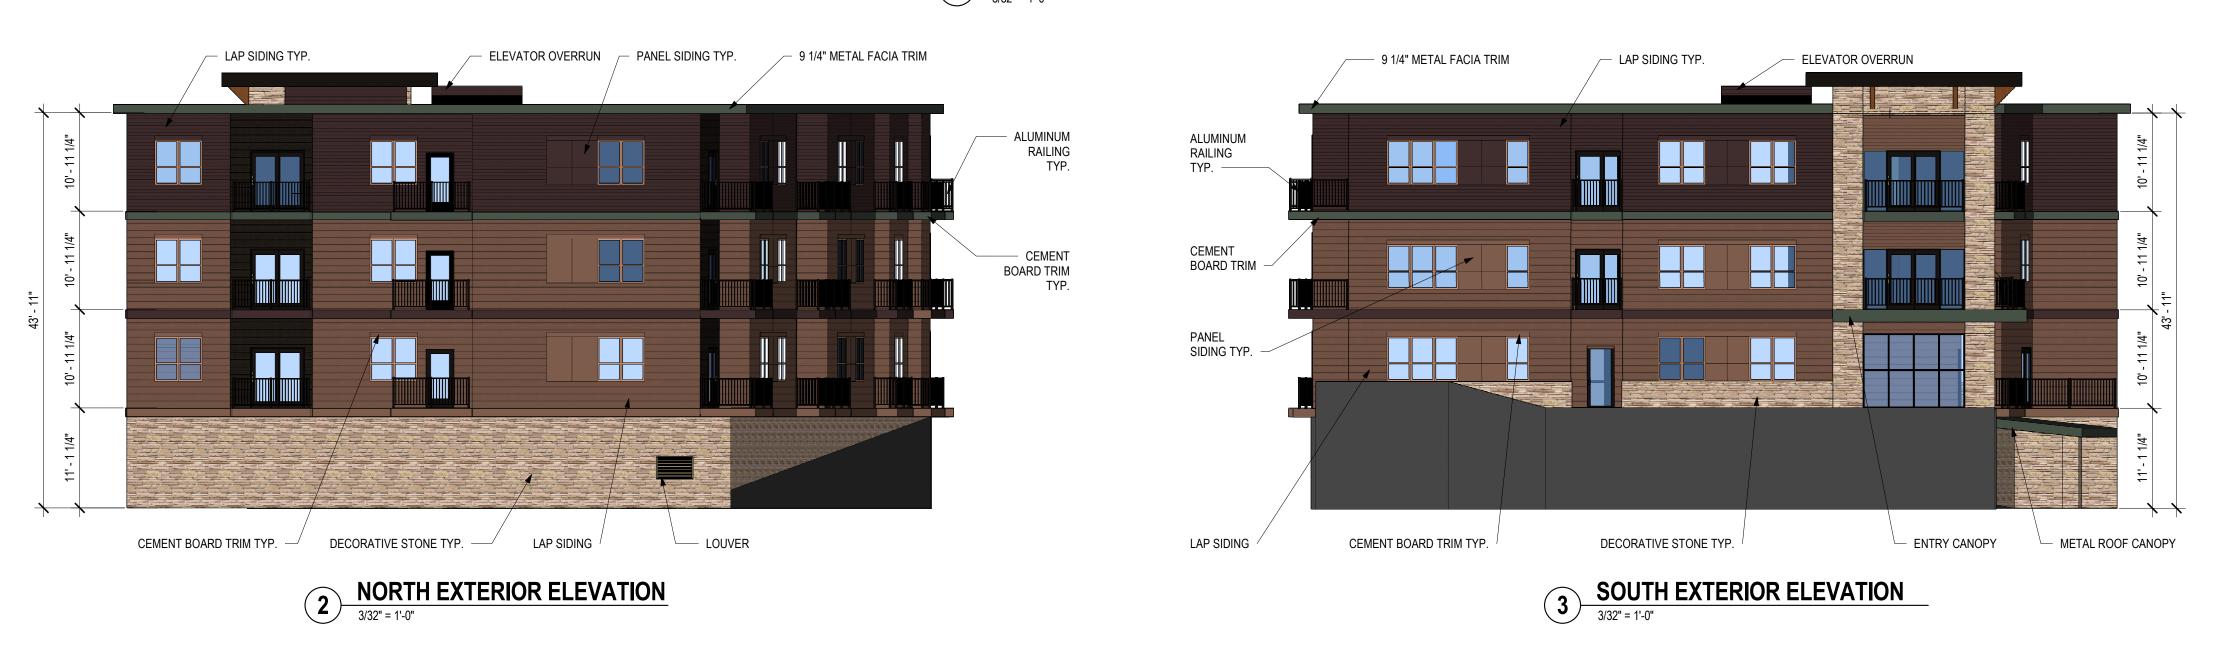



WEST EXTERIOR ELEVATION

3/32" - 1' 0"



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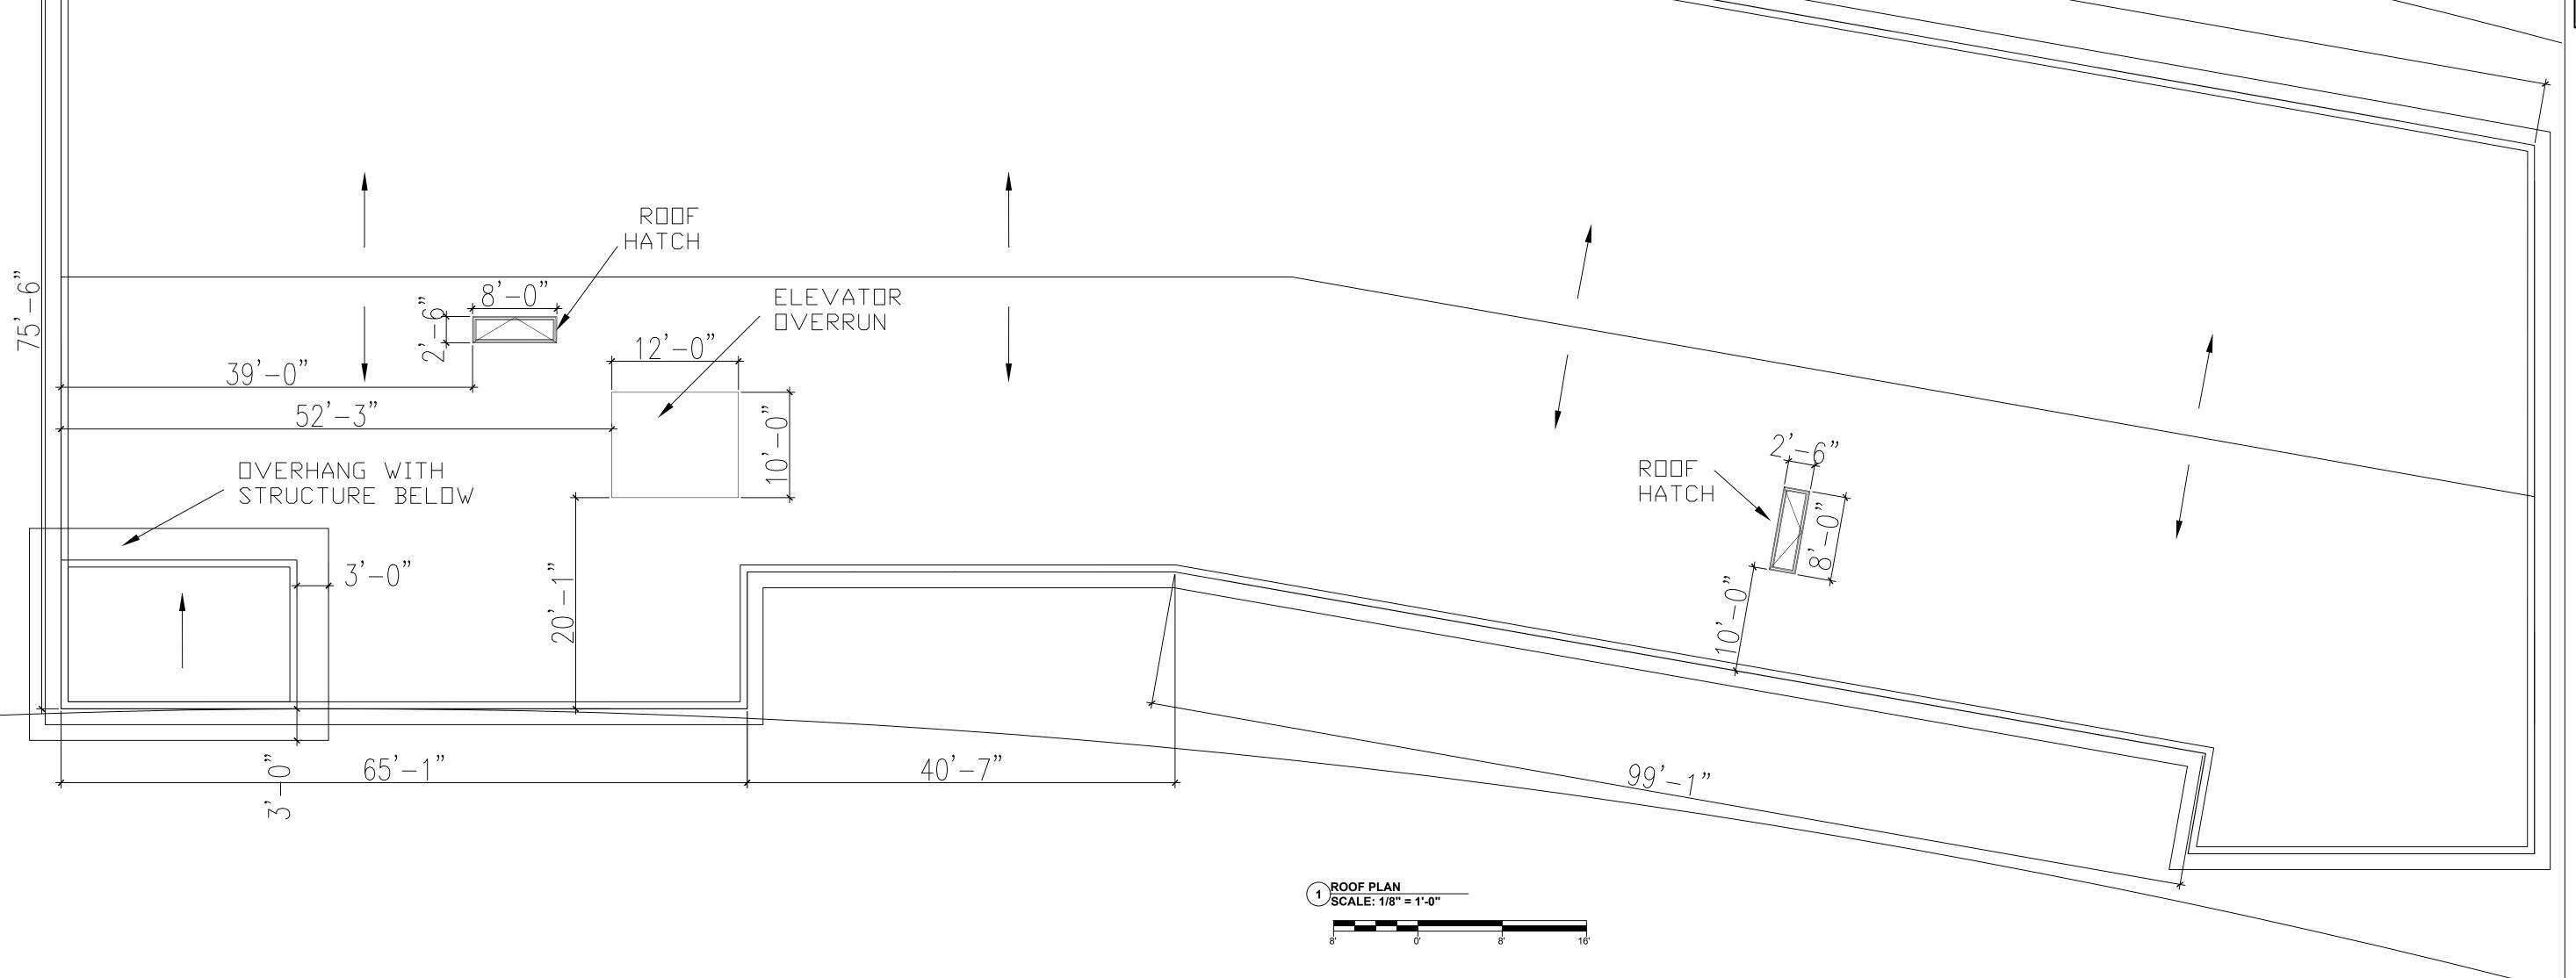
EXTERIOR ELEVATIONS

 DRAWN BY: TMT
 CHECKED BY: SH

 PROJECT NO: 18001-025
 DATE: 04/30/2019

A-105R





110'-6"

BUILDING CODE NOTES

TO REDUCE THE FIRE ACCESS LANE REQUIREMENTS

- CORRIDORS WILL HAVE SMOKE DETECTION
- 2. SHIPS LADDERS TO THE ROOF WITH ROOF HATCH WILL BE PROVIDED AT THE TOP OF BOTH STAIRS
- 3. BUILDING WILL BE SPRINKLED WITH NFPA 13.

PROJECT: WHITNEY POINT APARTMENTS 5402 S. WHITNEY WAY MADISON, WI 53705

ROOF PLAN

 DRAWN BY: TMT
 CHECKED BY: SH

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A-107







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MADISON, WI 53705

EXTERIOR RENDERING

 DRAWN BY: TMT
 CHECKED BY: SH

 PROJECT NO: 18001-025
 DATE: 04/30/2019

A-108R





3 EXISTING BUILDING- 330 INTERIOR IMAGE SCALE: NOT TO SCALE



EXISTING BUILDING- 330 SOUTH ELEVATION IMAGE SCALE: NOT TO SCALE









9 EXISTING BUILDING- 5402 INTERIOR IMAGE SCALE: NOT TO SCALE

8 EXISTING BUILDING- 5402 INTERIOR IMAGE SCALE: NOT TO SCALE



TEXISTING BUILDING- 5402 EAST ELEVATION IMAGE SCALE: NOT TO SCALE

13 EXISTING BUILDING- 340 SOUTH ELEVATION IMAGE SCALE: NOT TO SCALE

EXISTING BUILDING- 340 EAST ELEVATION IMAGE SCALE: NOT TO SCALE

WHITNEY POINT APARTMENTS 5402 S. WHITNEY WAY MADISON, WI 53705

EXISTING EXTERIOR BUILDING IMAGES

PROJECT NO: 18001-025 DATE: 02/05/2019

Tri-North

A-109



10 EXISTING BUILDING- 5402 WEST ELEVATION IMAGE SCALE: NOT TO SCALE