URBAN DESIGN COMMISSION APPLICATION



City of Madison **Planning Division**



FOR OFFICE USE ONLY: Paid Receipt # Date received Received by Aldermanic District Zoning District Urban Design District ____ Submittal reviewed by Legistar #

Madison Municipal Building, Suite 017 215 Martin Luther King, Jr. Blvd. P.O. Box 2985 Madison, WI 53701-2985 (608) 266-4635 Complete all sections of this application, including the desired meeting date and the action requested. If you need an interpreter, translator, materials in alternate formats or other accommodations to access these forms, please call the phone number above immediately. 1. Project Information 2161 Rimrock Road Madison, WI 53713 Address: Rimrock Retail Title: 2. Application Type (check all that apply) and Requested Date June 12, 2019 UDC meeting date requested New development ☑ Alteration to an existing or previously-approved development Informational ☐ Initial approval ☐ Final approval 3. Project Type Project in an Urban Design District Signage Project in the Downtown Core District (DC), Urban Comprehensive Design Review (CDR) Mixed-Use District (UMX), or Mixed-Use Center District (MXC) Signage Variance (i.e. modification of signage height, Project in the Suburban Employment Center District (SEC), area, and setback) Campus Institutional District (CI), or Employment Campus Other District (EC) ☐ Please specify Planned Development (PD) Alteration to Conditional Use Part of Hotel (LNDUSE ☐ General Development Plan (GDP) 2018-00001) ☐ Specific Implementation Plan (SIP) Planned Multi-Use Site or Residential Building Complex 4. Applicant, Agent, and Property Owner Information Josh Wilcox GBA Architecture | Design Company Applicant name City/State/Zip Middleton, WI 53562 2248 Deming Way, Suite 120 Street address Email josh.wilcox@garybrink.com 608-829-1750 Telephone

(same as applicant) Project contact person Company _____ Street address City/State/Zip _____ Email Telephone Property owner (if not applicant) Madison Rimrock Retail Investors I, LLC (c/o North Central Group) 1600 Aspen Commons, Suite 200 City/State/Zip Middleton, WI 53562 Street address Email ainman@ncghotels.com 608-662-3631 Telephone

Each submittal must include

fourteen (14) 11" x 17" collated

paper copies. Landscape and

Lighting plans (if required)

must be full-sized and legible.

Please refrain from using

plastic covers or spiral binding.

5. Required Submittal Materials

☑ Application Form

■ Letter of Intent

- If the project is within an Urban Design District, a summary of how the development proposal addresses the district criteria is required
- For signage applications, a summary of how the proposed signage is consistent with the applicable CDR or Signage Variance review criteria is required.
- Development plans (Refer to checklist on Page 4 for plan details)

☐ Filing fee

☑ Electronic Submittal*

Both the paper copies and electronic copies <u>must</u> be submitted prior to the application deadline before an application will be scheduled for a UDC meeting. Late materials will not be accepted. A completed application form is required for each UDC appearance.

For projects also requiring Plan Commission approval, applicants must also have submitted an accepted application for Plan Commission consideration prior to obtaining any formal action (initial or final approval) from the UDC. All plans must be legible when reduced.

*Electronic copies of all items submitted in hard copy are required. Individual PDF files of each item submitted should be compiled on a CD or flash drive, or submitted via email to udcapplications@cityofmadison.com. The email must include the project address, project name, and applicant name. Electronic submittals via file hosting services (such as Dropbox.com) are not allowed. Applicants who are unable to provide the materials electronically should contact the Planning Division at (608) 266-4635 for assistance.

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- 1. Prior to submitting this application, the applicant is required to discuss the proposed project with Urban Design Commission staff. This application was discussed with ______ on 11/22/17 (as part of original conditional use submittal)
- The applicant attests that all required materials are included in this submittal and understands that if any required information is not provided by the application deadline, the application will not be placed on an Urban Design Commission agenda for consideration.

7. Application Filing Fees

Fees are required to be paid with the first application for either initial or final approval of a project, unless the project is part of the combined application process involving the Urban Design Commission in conjunction with Plan Commission and/or Common Council consideration. Make checks payable to City Treasurer. Credit cards may be used for application fees of less than \$1,000.

Please consult the schedule below for the appropriate fee for your request: Urban Design Districts: \$350 (per §35.246) MGO).

- ☐ Minor Alteration in the Downtown Core District (DC) or Urban Mixed-Use District (UMX): \$150 (per §33.24(6)(b) MGO)
- ☐ Comprehensive Design Review: \$500 (per §31.041(3)(d)(1)(a) MGO)
- ☐ Minor Alteration to a Comprehensive Sign Plan: \$100 (per §31.041(3)(d)(1)(c) MGO)
- □ All other sign requests to the Urban Design Commission, including, but not limited to: appeals from the decisions of the Zoning Administrator, requests for signage variances (i.e. modifications of signage height, area, and setback), and additional sign code approvals: \$300 (per §31.041(3)(d)(2) MGO)
- A filing fee is not required for the following project applications if part of the combined application process involving both Urban Design Commission and Plan Commission:
- Project in the Downtown Core District (DC), Urban Mixed-Use District (UMX), or Mixed-Use Center District (MXC)
- Project in the Suburban Employment Center District (SEC), Campus Institutional District (CI), or Employment Campus District (EC)
- Planned Development (PD): General Development Plan (GDP) and/or Specific Implementation Plan (SIP)
- Planned Multi-Use Site or Residential Building Complex



April 24, 2019

Tim Parks
Department of Planning & Development
126 S. Hamilton Street
Madison, WI 53703

Re: Letter of Intent

2161 Rimrock Road – Alteration of Existing Conditional Use

Dear Tim:

This is our Letter of Intent (Alteration of Existing Conditional Use) for the property located at 2161 Rimrock Road. The owner, Madison Rimrock Retail Investors, LLC is planning to develop two new retail buildings at this location. The lot is currently vacant, and demolition of existing structures will not be required.

The total gross area of the new buildings is 9,128 sf (Building A: 5,300 sf, Building B: 3,600 sf. The lot area is 62,726 sf (or 1.44 acres).

Total Parking/Bicycle Stalls will be as follows:

Parcel 1 (Retail Parcel along Rimrock Road)

Small Car Parking: 0 Large Car Parking: 69 Accessible Parking: 4

Bicycle Stall: 0 Total Parcel 1 Parking: 73

Parcel 2 (Hotel – Under Construction)

Small Car Parking: 28 Large Car Parking: 107 Accessible Parking: 5 Bicycle Stall: 16

Total Parcel 2 Parking: 140

Parcel 3 (DOR Overflow Lot - Under Construction)

Small Car Parking: 0 Large Car Parking: 24 Accessible Parking: 0

Bicycle Stall: 0

Total Parcel 3 Parking: 24

Total Site Parking

Small Car Parking: 28 Large Car Parking: 131 Accessible Parking: 5 Bicycle Stall: 16

Total Site Car Parking: 164

All maintenance, including trash and snow removal, will be provided by private contract.

The proposed hotel hours of operation will be 24 hours a day/365 days a year, the retail and restaurant hours of operation are anticipated to be no more than from 5AM to 1AM. Building A's proposed use is a restaurant and will include an outdoor seating area with approximately 105 seats & 3,300 square feet. Building B's proposed use will be a restaurant/coffee shop and will include an outdoor seating area with approximately 10 seats and 100 square feet. Building B will also include a drive through lane. The drive through lane will comply with all applicable City of Madison drive through requirements and restrictions.

The number of construction jobs created as a result of this new development will be 30 and the number of full time equivalent jobs created is approximately 80 FTE.

The current assessed value of the land is approximately \$3,000,000.

The hotel construction is expected to be complete in June of 2019. The retail construction will continue upon the completion of the hotel and be complete in 2020.

The Development Team includes the following:

Developer/Owner: Madison Rimrock Retail Investors, LLC

c/o North Central Group

1600 Aspen Commons, Suite 200

Middleton, WI 53562 Phone: 608-662-3631 Fax: 608-836-6399

Principal Contact: Andy Inman, P.E.

<u>ainman@ncghotels.com</u>

Architect: GBA

2248 Deming Way, Suite 120

Middleton, WI 53562 Phone: 608-829-1750 Fax: 608-829-3056

Principal Contact: Josh Wilcox josh.wilcox@garybrink.com

Civil/Landscape: Vierbicher

N27 W23957 Paul Road, Suite 105

Pewaukee, WI 53072 Phone: 262-408-5708

Principal Contact: John Kastner, P.E.

ikas@vierbicher.com

Please refer to the attached plans for additional information.

Sincerely,

Josh Wilcox Partner

fred William

PROPOSED Rimrock Retail


2161 Rimrock Road Madison, Wisconsin


UDC/ LANDUSE SUBMITTAL April 24, 2019

PROJECT BUILDING & PARKING MATRIX

Building	Square Footag	Square Footage							
A	5,300	,300							
В	3,600	3,600							
		Parking S	talls (Previous	ly Approved Hote	el)				
ACC-Parking Stalls	5		140	Total			145		
			Parking Stalls (Parcel #1)					
ACC-Parking Stalls	4		69	Total			73		
Site Information						Area Total			
By Parcels	Parcel #1	1.44 acres	Parcel #2	2.72 acres Parcel #3 .28 acres 3. acres					

PROJECT LOCATION MAP

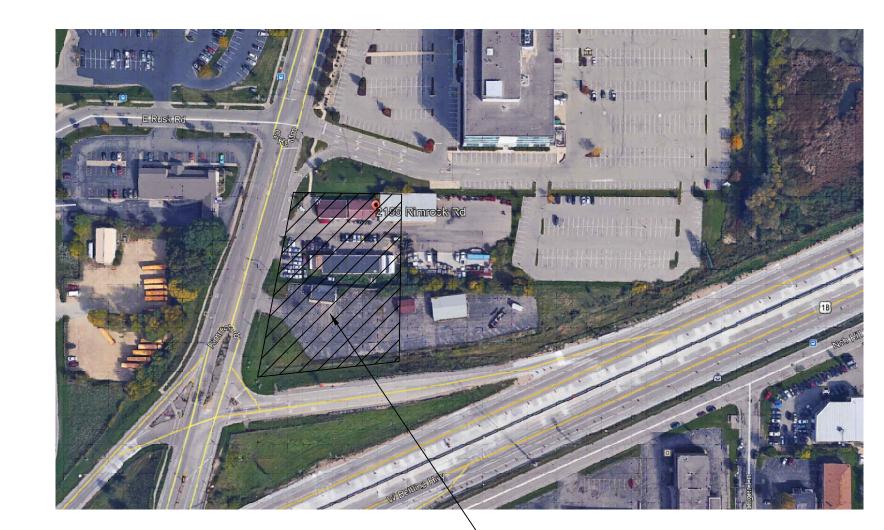

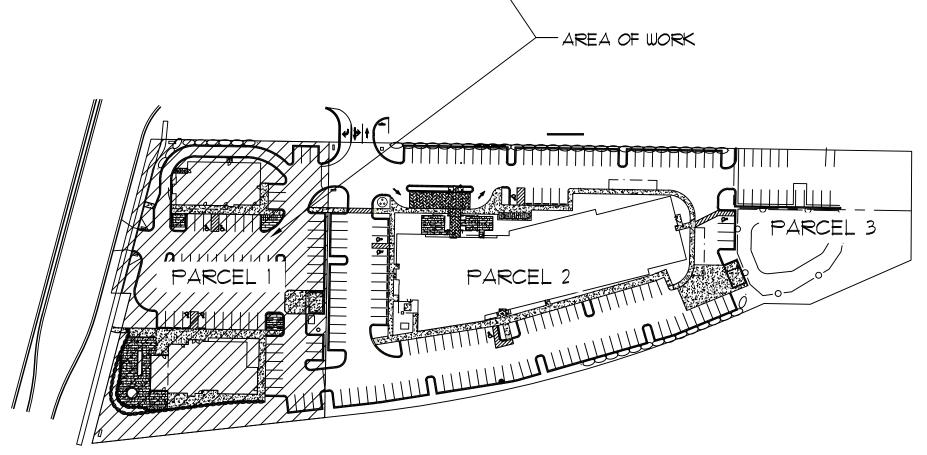

CONDITIONAL USE APPROVED AS PART OF HOTEL PROJECT LEGISTAR #49924 # 50223 (LNDUSE 2018-00001)

SHEET INDEX:

TITLE SHEET

CIVIL DRAWINGS

EXISTING CONDITIONS PLAN

DEMOLITION PLAN SITE PLAN

GRADING PLAN

UTILITY PLAN

CONSTRUCTION DETAILS

CONSTRUCTION DETAILS

CONSTRUCTION DETAILS

CONSTRUCTION DETAILS CONSTRUCTION DETAILS

CONSTRUCTION DETAILS

CONSTRUCTION DETAILS

CONSTRUCTION DETAILS LANDSCAPE PLAN

FIRE ACCESS PLAN

LIGHTING DRAWINGS

SITE LIGHTING PLAN SITE LIGHTING DETAILS

ARCHITECTURAL DRAWINGS

A2.01a BUILDING "A" FLOOR PLAN & ROOF PLAN A2.01b BUILDING "B" FLOOR PLAN & ROOF PLAN A6.01a BUILDING "A" BUILDING ELEVATIONS A6.01b BUILDING "B" BUILDING ELEVATIONS

NCG.
NORTH CENTRAL GROUP

DEVELOPER:

MADISON RIMROCK LODGING INVESTORS I, LLC. C/O NORTH CENTRAL GROUP

1600 ASPEN COMMONS, SUITE 200 MIDDLETON. WISCONSIN 53562 PHONE: (608) 662-3631

AINMAN@NCGHOTELS.COM

CONTACT: ANDY INMAN



ARCHITECT:

GBA ARCHITECTURE & DESIGN

2248 DEMING WAY, SUITE 120 MIDDLETON. WISCONSIN 53562 PHONE: (608) 829-1750

JOSH.WILCOX@GARYBRINK.COM

CONTACT: JOSH WILCOX





CIVIL ENGINEER / LANDSCAPE ARCHITECT

VIERBICHER

N27 W23957 PAUL ROAD, SUITE 105 PEWAUKEE, WISCONSIN 53072 (262) 408-5708 JKAS@VIERBICHER.COM

CONTACT: JOHN KASTNER

2248 DEMING WAY. STE. 120 MIDDLETON, WI 53562 (608) 829-1750 (608) 829-3056 (FAX)


CLIENT:
RIMROCK RETAIL INVESTORS,
C/O NORTH CENTRAL GROUP
1600 ASPEN COMMONS, SUITE 200
MIDDLETON, WI 54562


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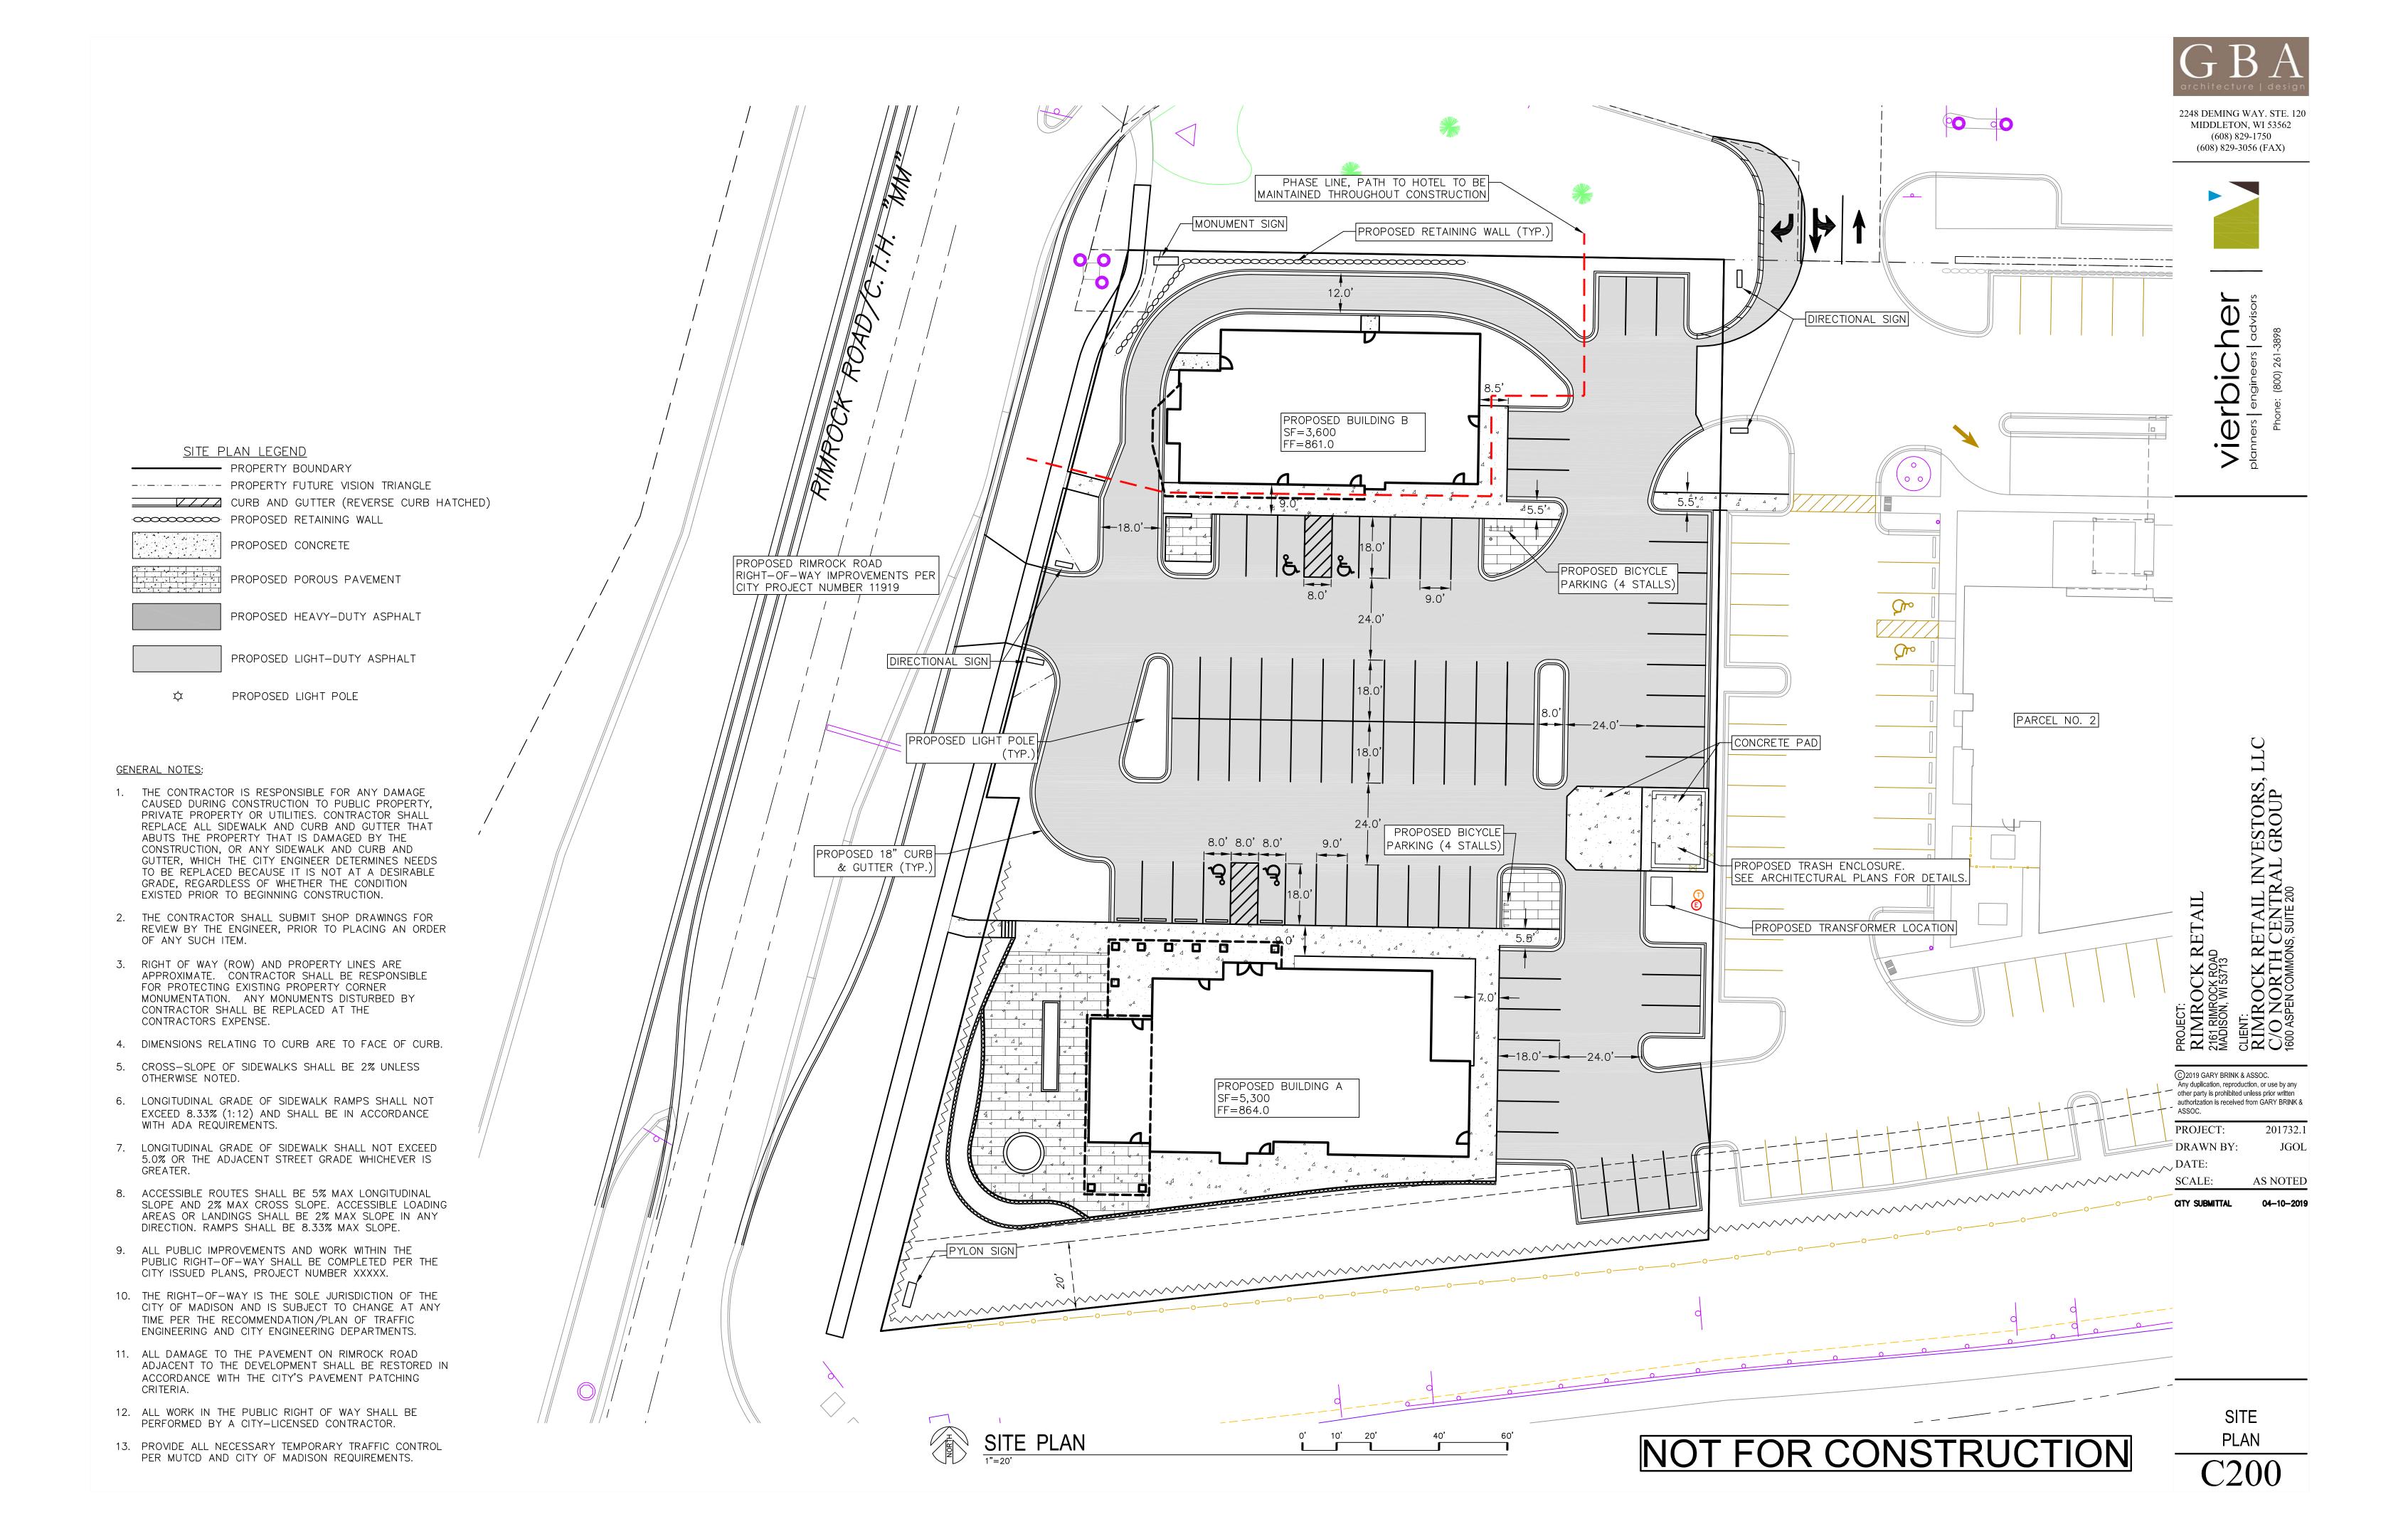
PROJECT: 201732.1 DRAWN BY: DSD DATE:


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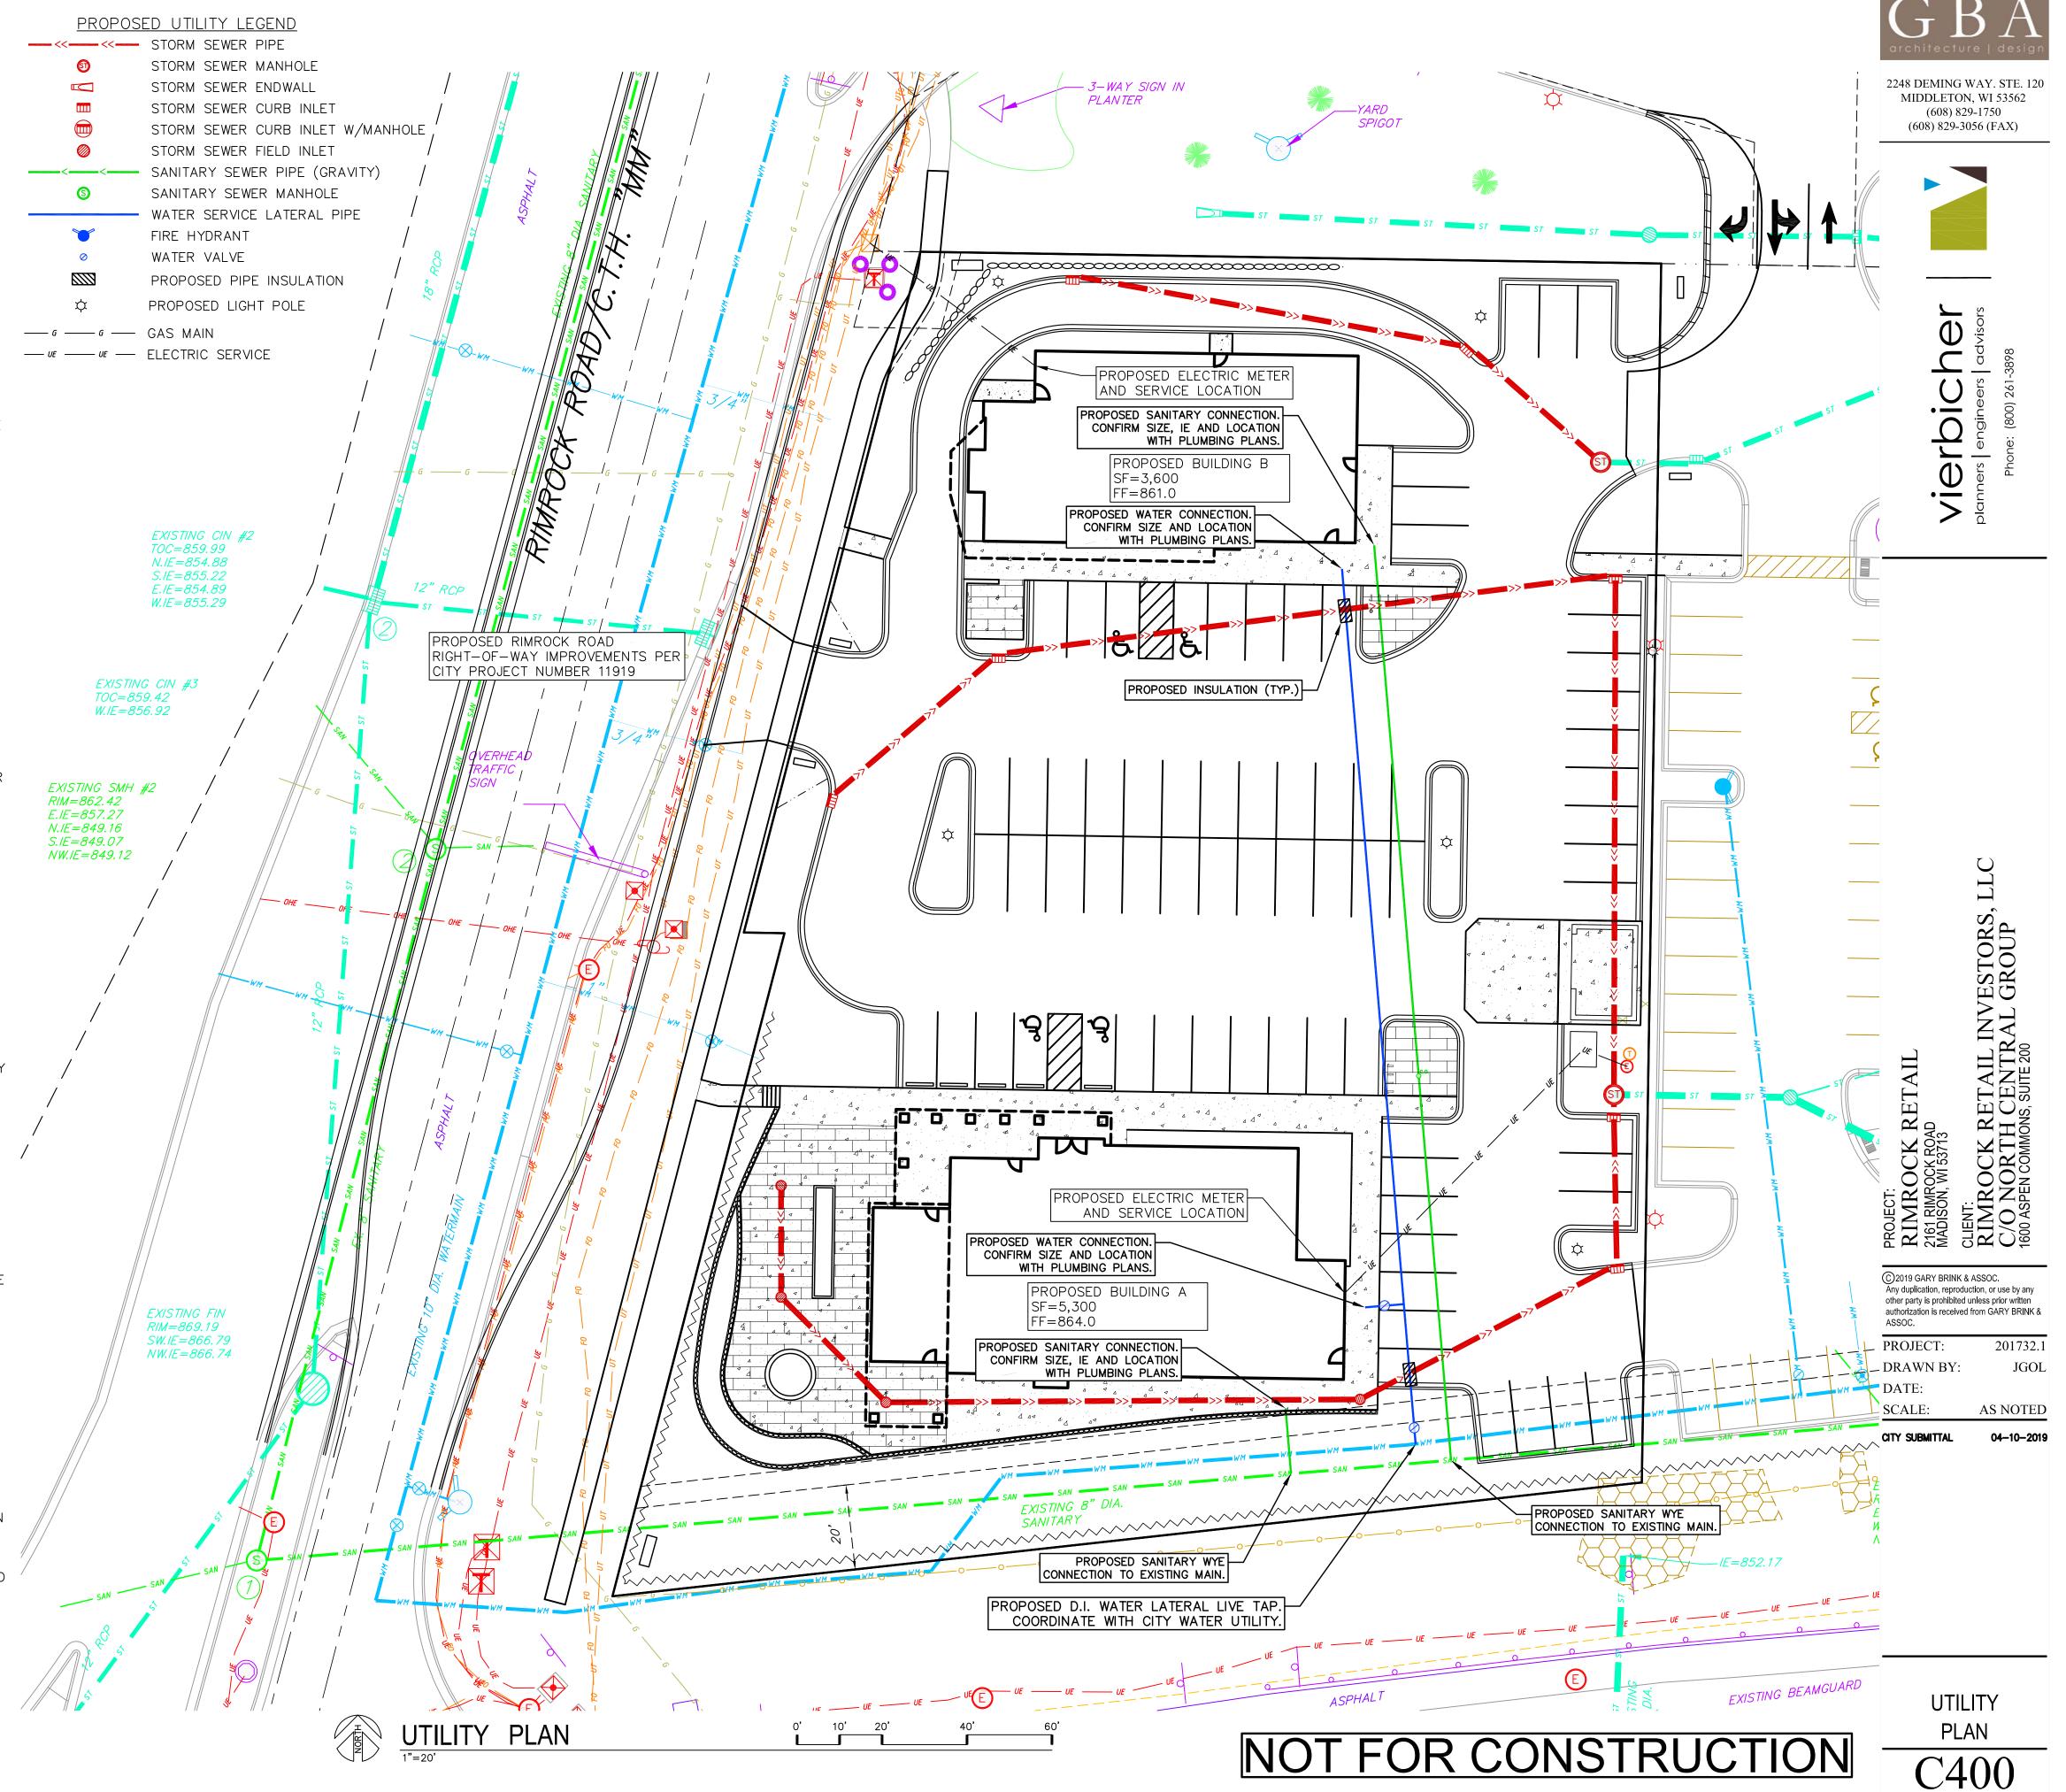




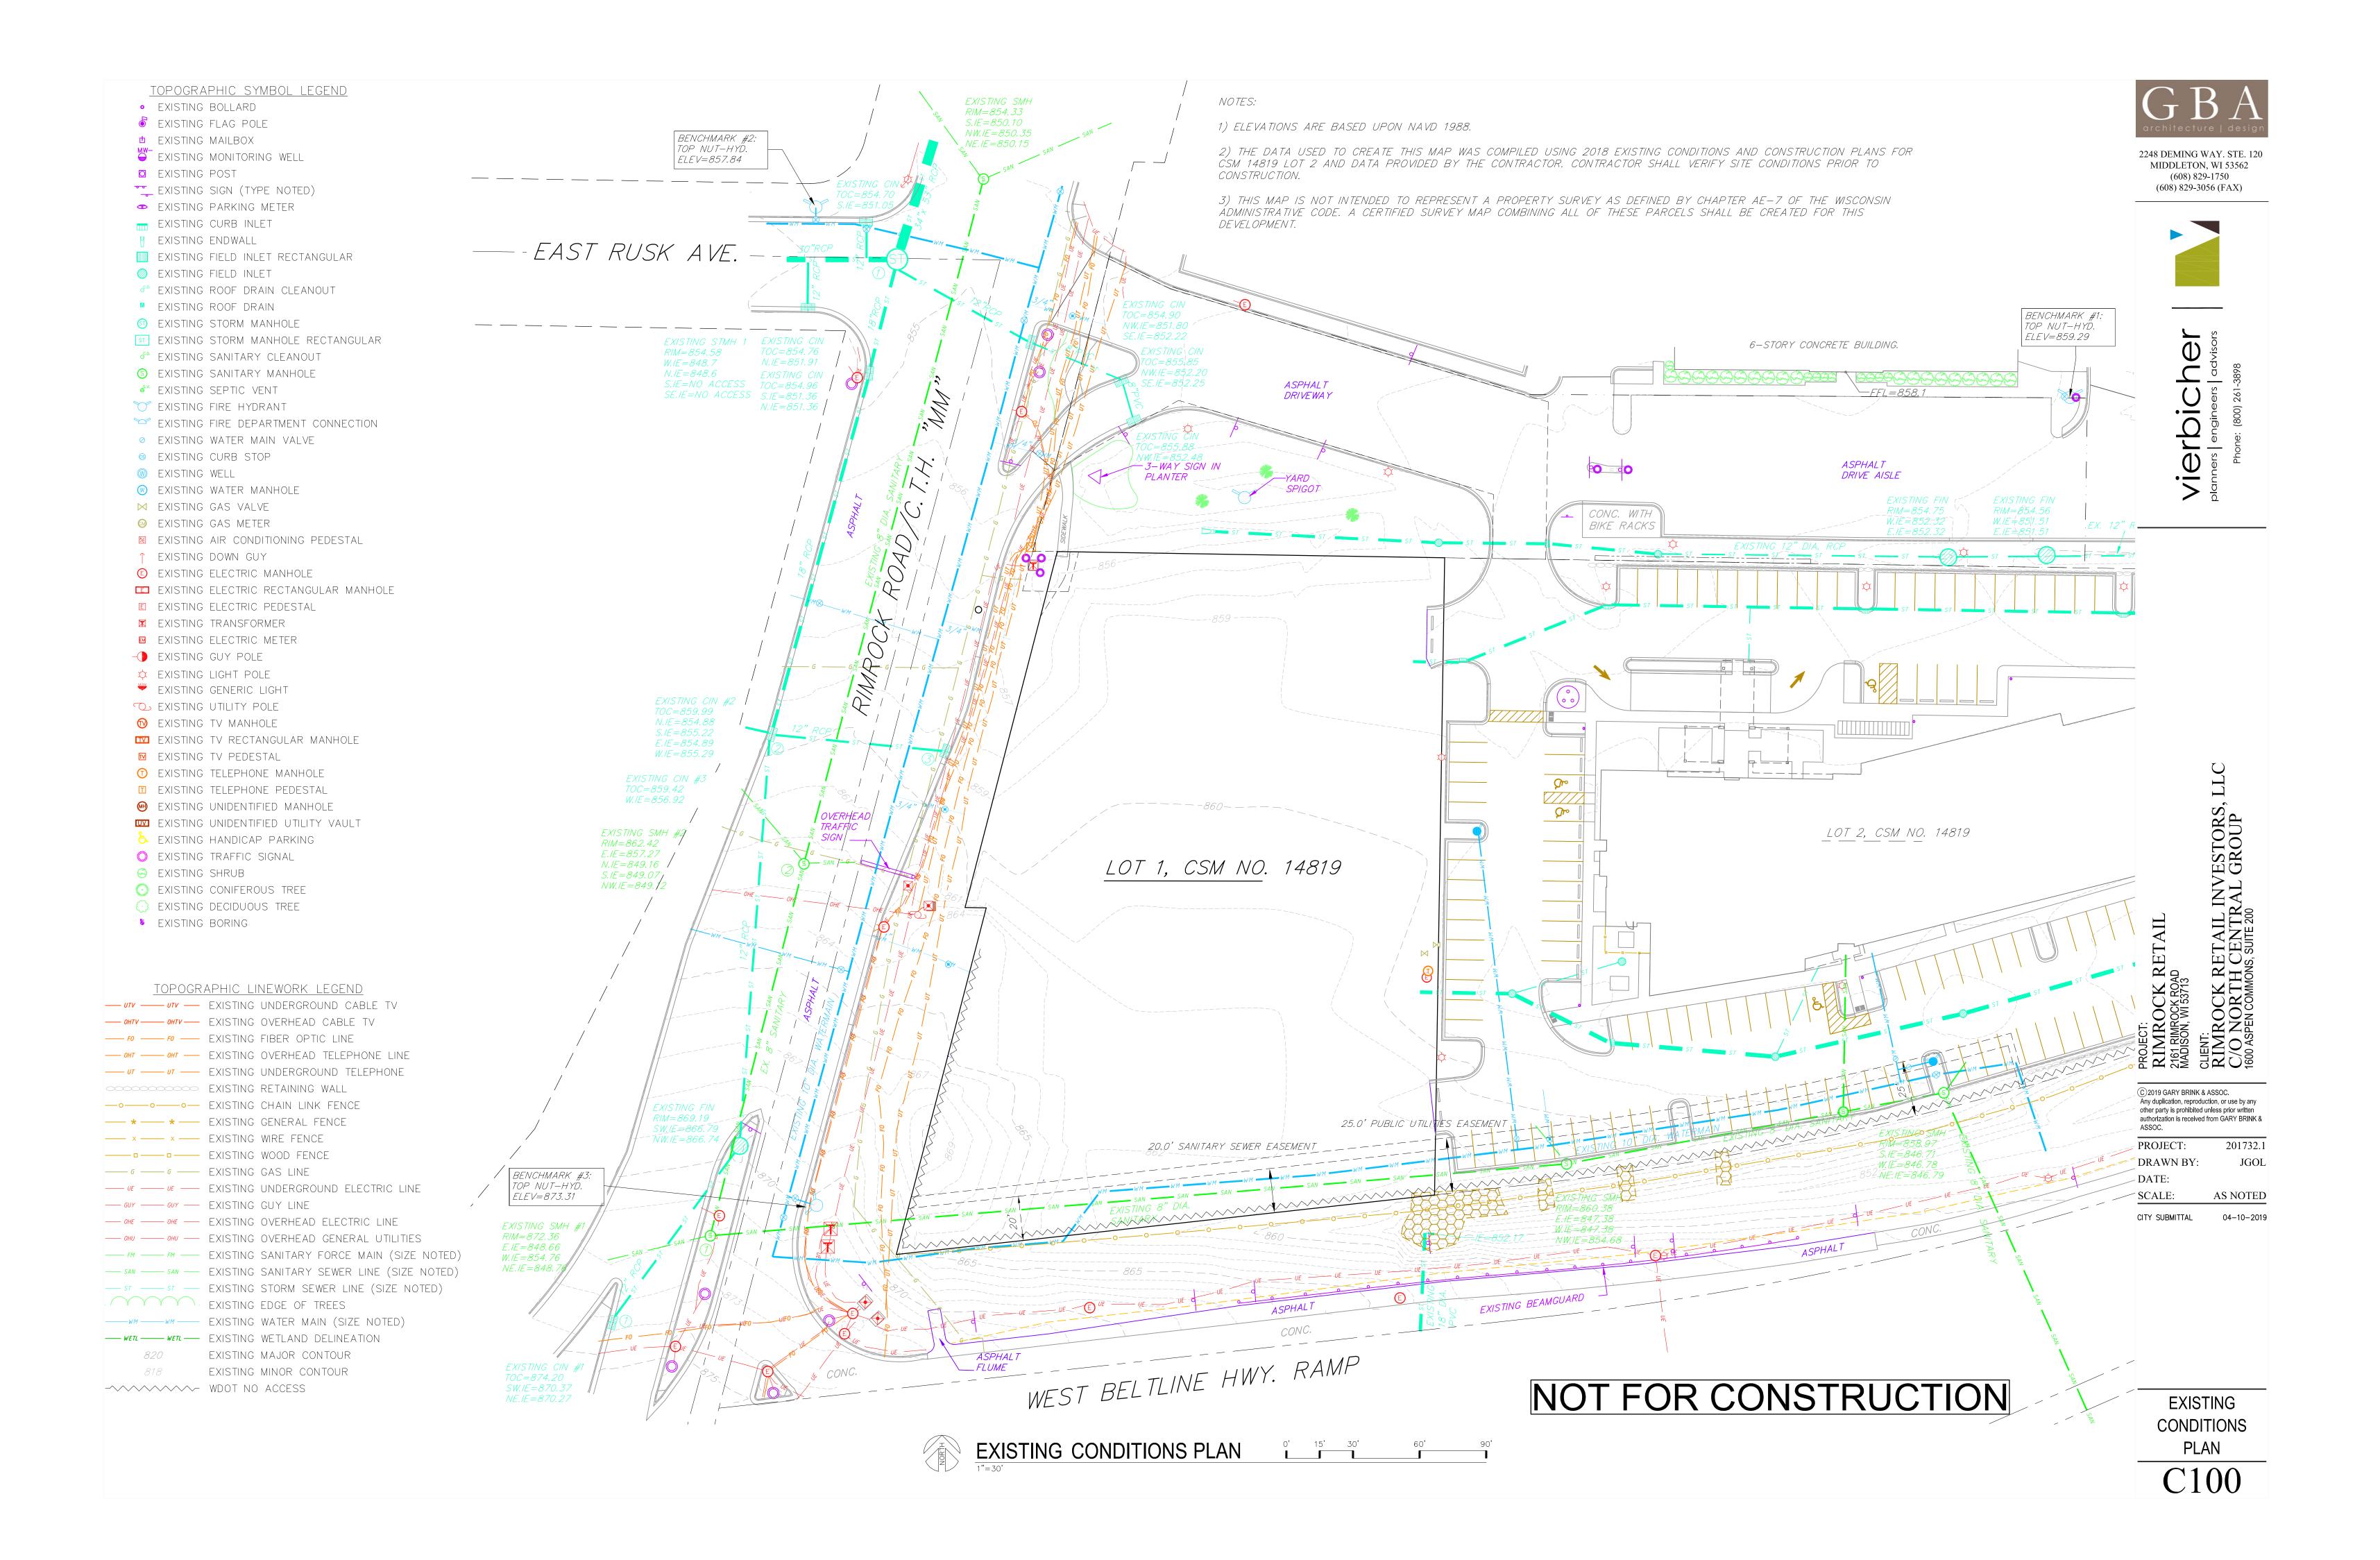

UTILITY NOTES:

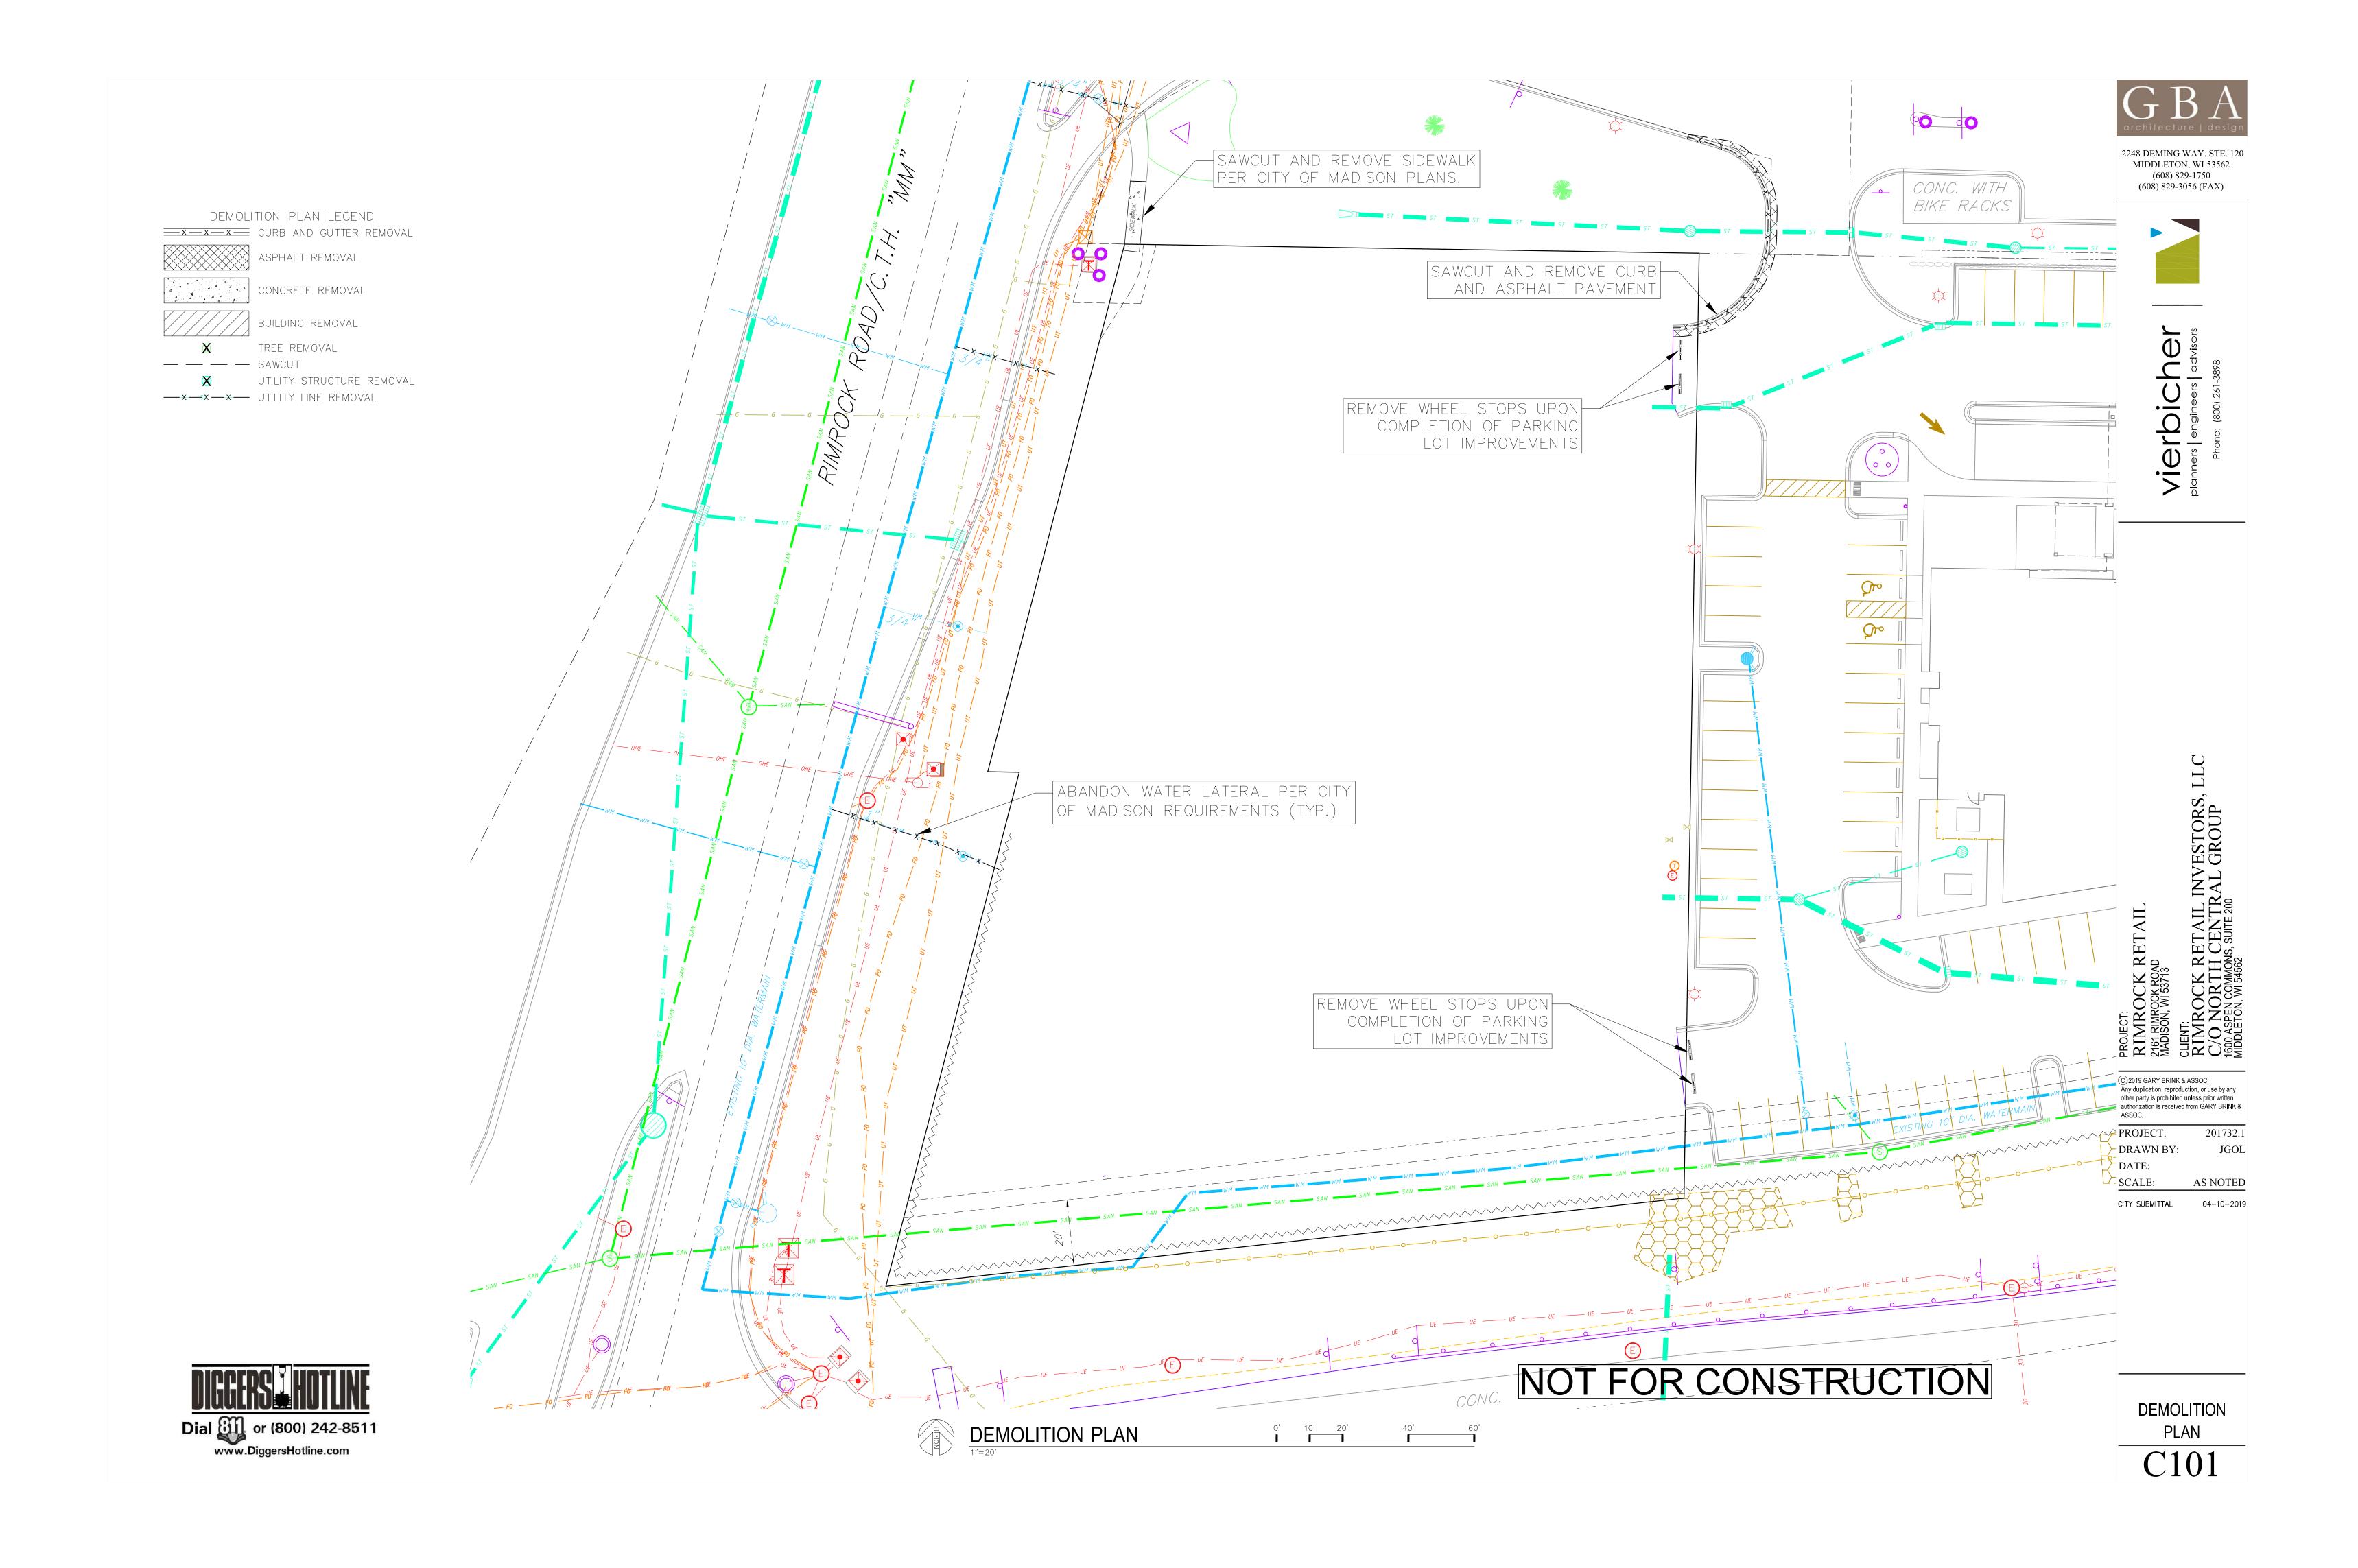- 1. CONTRACTOR TO VERIFY EXISTING UTILITY LOCATIONS AND ELEVATIONS PRIOR TO STARTING WORK.
- 2. SANITARY & STORM SEWER LENGTHS SHOWN ARE FROM CENTER OF STRUCTURE TO CENTER OF STRUCTURE. STORM SEWER END SECTIONS ARE INCLUDED IN THE LENGTH AND SLOPE OF THE
- 3. CONTRACTOR SHALL INVESTIGATE ALL UTILITY CROSSINGS PRIOR TO CONSTRUCTION AND NOTIFY ENGINEER OF ANY CONFLICTS.
- 4. CONTRACTOR SHALL BE RESPONSIBLE FOR ADJUSTING ALL UTILITY STRUCTURES (MANHOLE RIMS, WATER VALVES, AND CURB STOPS), IF NECESSARY.
- 5. CONTRACTOR SHALL OBTAIN ANY NECESSARY WORK IN RIGHT—OF WAY, EXCAVATION, UTILITY CONNECTION, PLUGGING, ABANDONMENT, AND DRIVEWAY CONNECTION PERMITS PRIOR TO CONSTRUCTION.
- 6. FOR ALL SEWER AND WATER MAIN CROSSINGS: PROVIDE MINIMUM 18" SEPARATION WHEN WATER MAIN CROSSES BELOW SEWER AND MINIMUM 6" SEPARATION WHEN WATER MAIN CROSSES ABOVE
- 7. IF DEWATERING OPERATIONS EXCEED 70 GALLONS PER MINUTE OF PUMPING CAPACITY, A DEWATERING WELL PERMIT SHALL BE OBTAINED FROM THE DNR PRIOR TO STARTING ANY DEWATERING ACTIVITIES.
- 8. A COPY OF THE APPROVED UTILITY PLANS, SPECIFICATIONS AND PLUMBING PERMIT APPROVAL LETTER SHALL BE ON—SITE DURING CONSTRUCTION AND OPEN TO INSPECTION BY AUTHORIZED REPRESENTATIVES OF THE DEPARTMENT OF SAFETY AND PROFESSIONAL SERVICES AND OTHER LOCAL INSPECTORS.
- 9. STORM BUILDING SEWER PIPE SHALL CONFORM TO ONE OF THE STANDARDS LISTED IN TABLE 384.30-6 OF SPS 384.30(3)(c).
- 10. PRIVATE WATER SERVICES AND PRIVATE WATER MAINS SHALL CONFORM TO ONE OF THE STANDARDS LISTED IN TABLE 384.30-7 OF SPS 384.30(4)(d).
- 11. PRIVATE SANITARY SEWER AND LATERALS SHALL BE POLYVINYL CHLORIDE (PVC) ASTM D3034 SDR 35 OR APPROVED EQUAL MATERIAL THAT CONFORMS TO ONE OF THE STANDARDS LISTED IN TABLE 384.30-3 OF SPS 384.30(2)(c).
- 12. A MEANS TO LOCATE BURIED UNDERGROUND EXTERIOR NON METALLIC SEWERS/MAINS AND WATER SERVICES/MAINS MUST BE PROVIDED WITH TRACER WIRE OR OTHER METHODS IN ORDER TO BE LOCATED PER SPS 382.10(11)(h) AND SPS 382.40(8)(k).
- 13. EXTERIOR WATER SUPPLY PIPING SETBACKS AND CROSSINGS SHALL BE IN ACCORDANCE WITH SPS 382.40(8)(b.).
- 14. NO PERSON MAY ENGAGE IN PLUMBING WORK IN THE STATE UNLESS LICENSED TO DO SO BY THE DEPARTMENT OF SAFETY AND PROFESSIONAL SERVICES PER S.145.06.
- 15. SITE CONTRACTOR SHALL LEAVE SANITARY AND WATER LATERALS FIVE (5) FEET SHORT (HORIZONTALLY) FROM THE BUILDING. BUILDING PLUMBER SHALL VERIFY SIZE, LOCATION, AND INVERT ELEVATION OF PROPOSED SANITARY AND WATER LATERALS.
- 16. CONTRACTOR SHALL FIELD VERIFY THE SIZE, TYPE, LOCATION, AND ELEVATION OF EXISTING UTILITIES PRIOR TO INSTALLING ANY ON—SITE UTILITIES OR STRUCTURES. CONTACT ENGINEER PRIOR TO INSTALLATION IF DISCREPANCY EXISTS WITHIN THESE PLANS.
- 17. PROPOSED UTILITY SERVICE LINES SHOWN ARE APPROXIMATE. COORDINATE THE EXACT LOCATIONS WITH THE PLUMBING DRAWINGS. COORDINATE THE LOCATIONS WITH THE PLUMBING CONTRACTOR AND/OR OWNER'S CONSTRUCTION REPRESENTATIVE PRIOR TO INSTALLATION OF ANY NEW UTILITIES.
- 18. CONTRACTOR SHALL BE RESPONSIBLE FOR COORDINATING THE RELOCATION OF ANY UTILITIES ENCOUNTERED AND REPLACEMENT OF ANY UTILITIES DAMAGED WITHIN INFLUENCE ZONE OF NEW CONSTRUCTION. CONTACT ENGINEER IF THE EXISTING UTILITIES VARY APPRECIABLY FROM THE PLANS.
- 19. ALL WATER MAIN AND SERVICES SHALL BE INSTALLED AT A MINIMUM DEPTH OF 6.5' FROM TOP OF FINISHED GROUND ELEVATION TO TOP OF MAIN.
- 20. IT IS THE CONTRACTOR'S RESPONSIBILITY TO VERIFY THAT THE EXISTING VALVES WILL HOLD THE PRESSURE TEST PRIOR TO CONNECTION. THE CITY IS NOT RESPONSIBLE FOR ANY COSTS INCURRED DUE TO THE CONTRACTOR NOT VERIFYING THAT THE EXISTING VALVE WILL HOLD THE PRESSURE TEST PRIOR TO CONNECTION. IF A NEW VALVE IS REQUIRED, THE APPLICANT WILL BE REQUIRED TO INSTALL ONE AT THEIR EXPENSE, AT THE POINT OF CONNECTION.
- 21. CLEAN OUT ALL EXISTING AND PROPOSED STORM INLETS AND CATCH BASINS AT THE COMPLETION OF CONSTRUCTION.
- 22. FOR WATER SERVICES AND HYDRANT LEADS, ALL MECHANICAL JOINTS TO BE RESTRAINED WITH MEGALUG 1100 OR APPROVED EQUAL. PIPE JOINTS TO BE RESTRAINED AS INDICATED WITH MEGALUG 1700 HARNESS OR APPROVED EQUAL.
- 23. CONNECTIONS TO EXISTING WATER MAIN TO BE BY LIVE TAPPING. CONTRACTOR IS RESPONSIBLE FOR ALL CONNECTION FEES AND COSTS PAYABLE TO THE CITY OF MADISON FOR LIVE TAPPING, AND ALL OTHER WORK AND COSTS ASSOCIATED WITH LIVE TAPPING.
- 24. NEW SANITARY MANHOLE TO BE CONSTRUCTED WITH FLAT CAP OR ECCENTRIC CONE. OPENING FOR ACCESS TO BE ROTATED SUCH THAT MANHOLE FRAME AND GRATE IS WITHIN PROPOSED PARKING AREA. CONTRACTOR TO CONFIRM THAT PROPOSED FRAME AND GRATE WILL FALL WITHIN PARKING AREA PRIOR TO CONSTRUCTING MANHOLE AND ADVISE THE CONSULTANT OF ANY DISCREPANCIES.
- 25. ALL PUBLIC IMPROVEMENTS AND WORK WITHIN THE PUBLIC RIGHT-OF-WAY SHALL BE COMPLETED PER THE CITY ISSUED PLANS, PROJECT NUMBER XXXXX.
- 26. THE RIGHT-OF-WAY IS THE SOLE JURISDICTION OF THE CITY OF MADISON AND IS SUBJECT TO CHANGE AT ANY TIME PER THE RECOMMENDATION/PLAN OF TRAFFIC ENGINEERING AND CITY ENGINEERING DEPARTMENTS.

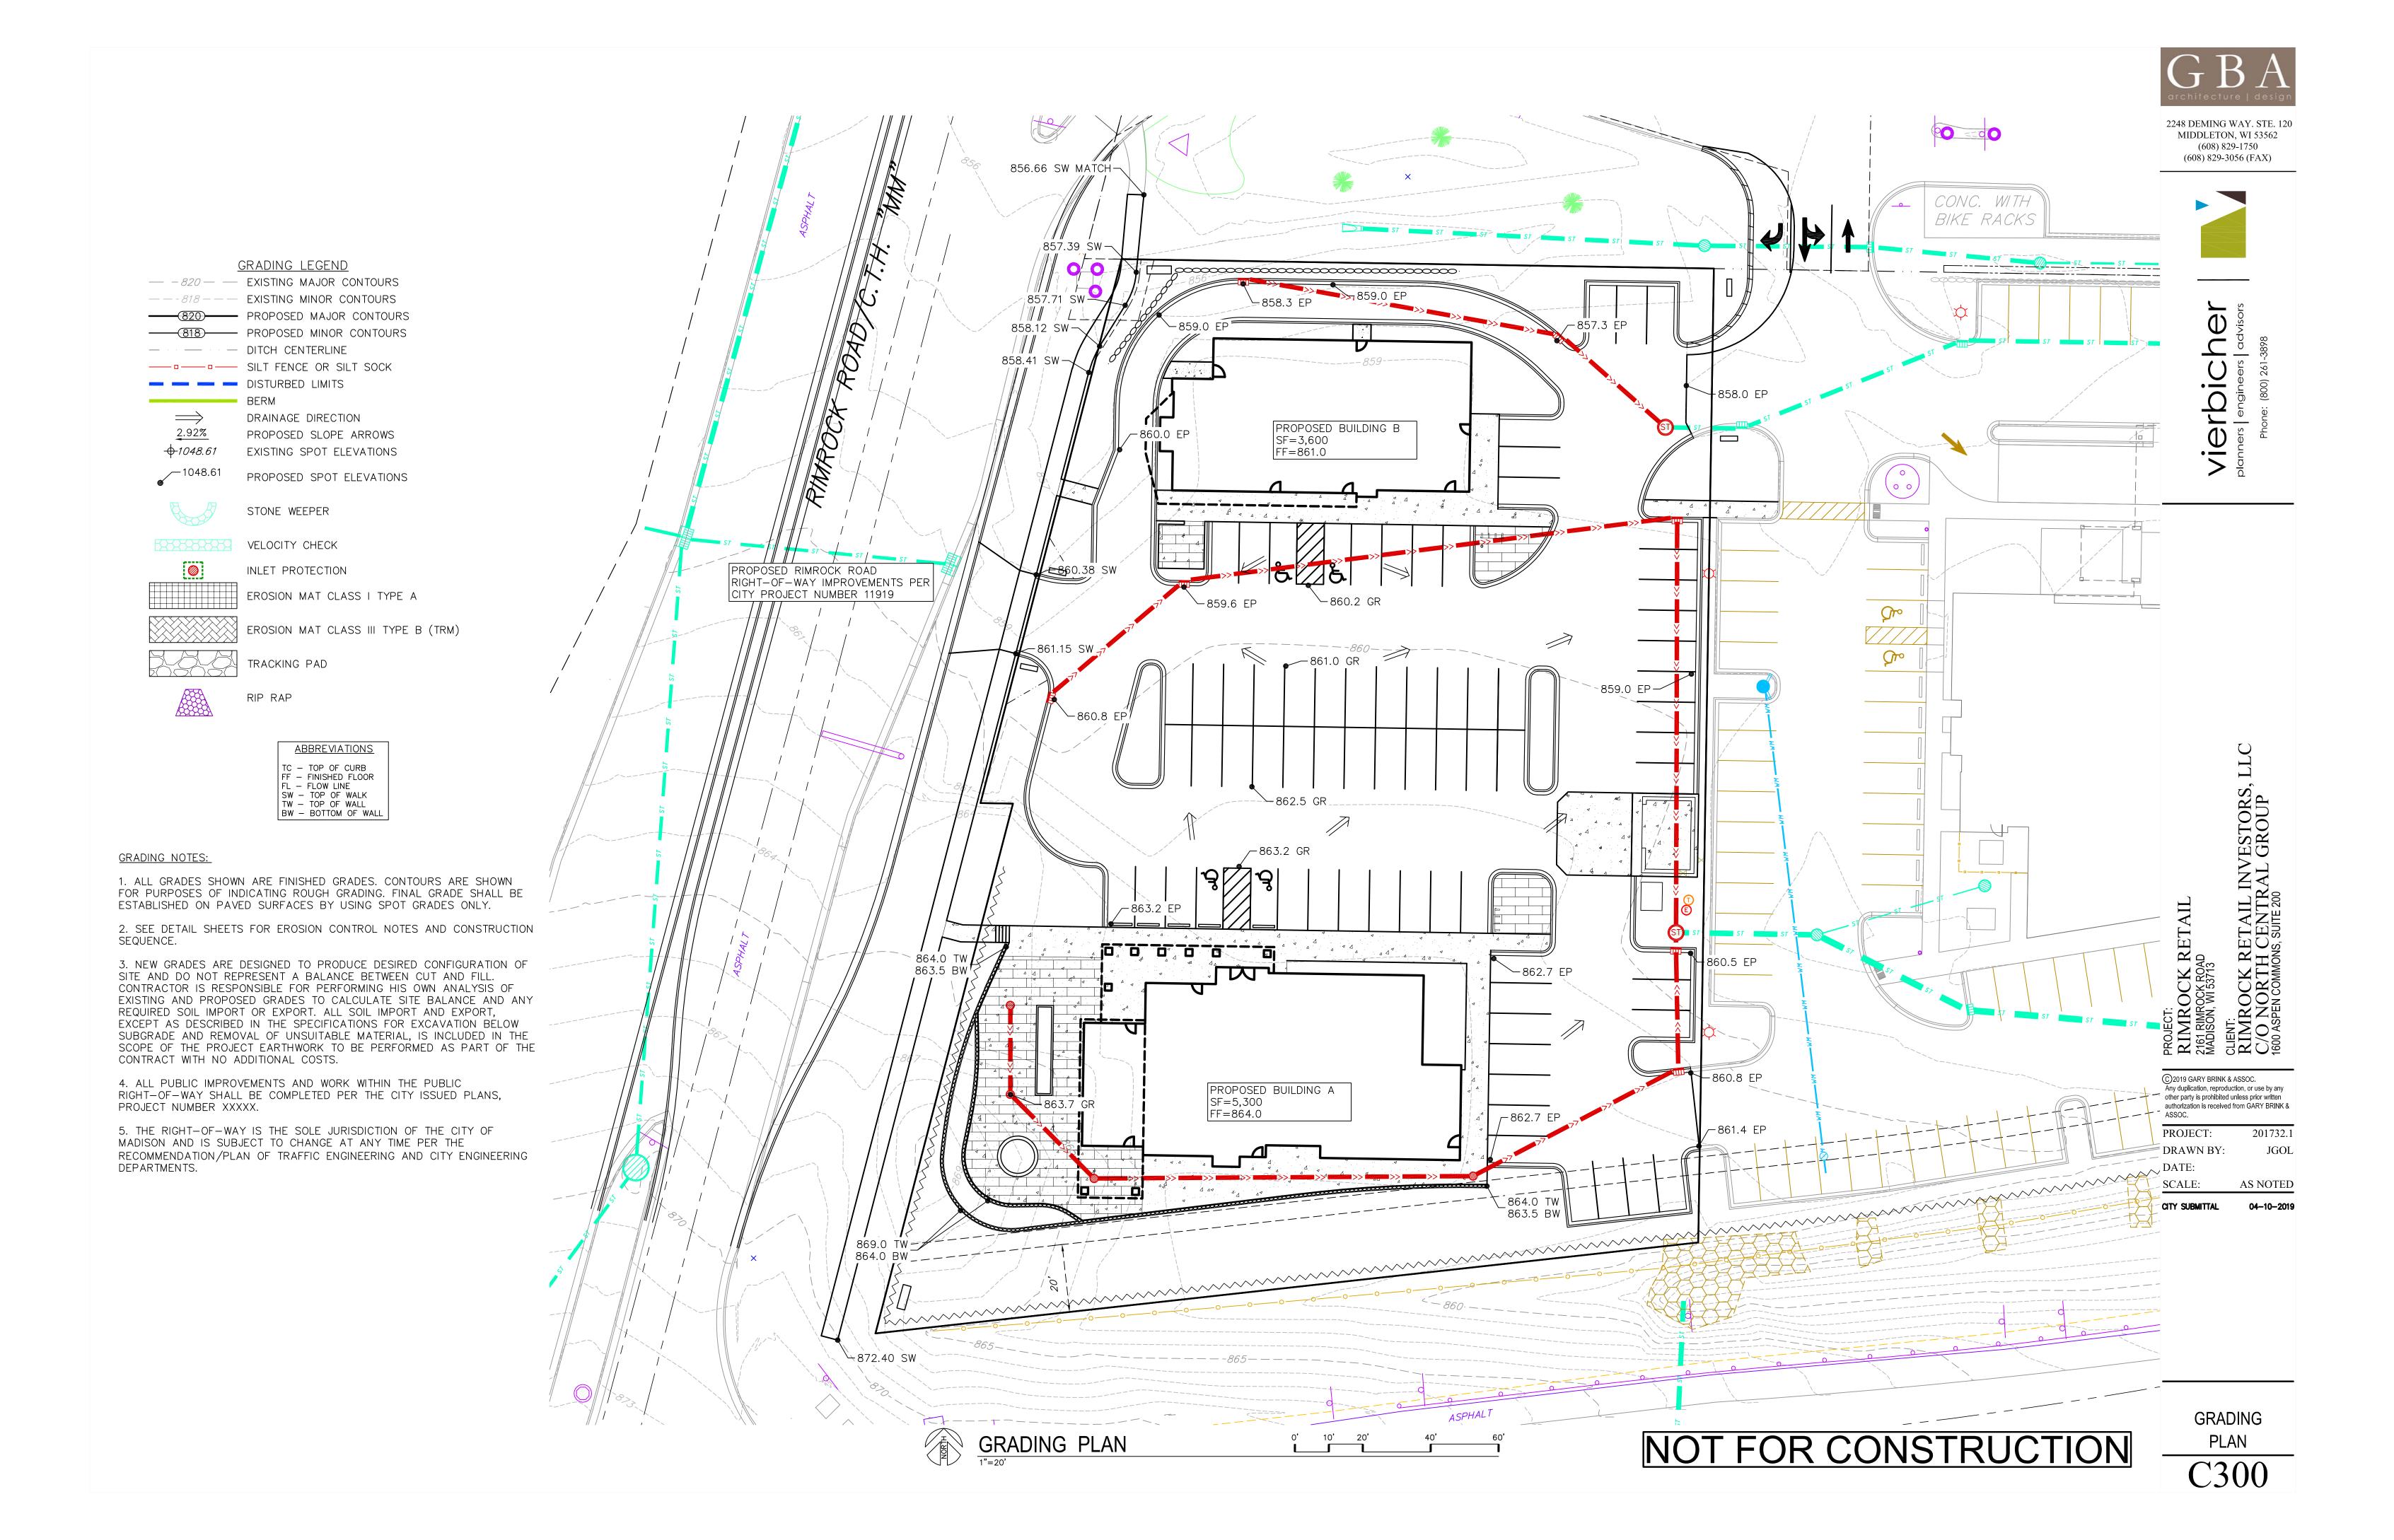

EROSION CONTROL MEASURES

- EROSION CONTROL SHALL BE IN ACCORDANCE WITH THE CITY OF MADISON EROSION CONTROL ORDINANCE AND CHAPTER NR 216 OF THE WISCONSIN ADMINISTRATIVE CODE.
- 2. CONSTRUCT AND MAINTAIN ALL EROSION AND SEDIMENT CONTROL MEASURES IN ACCORDANCE WITH WISCONSIN DNR TECHNICAL STANDARDS (http://dnr.wi.gov/runoff/stormwater/techstds.htm) AND WISCONSIN CONSTRUCTION SITE BEST MANAGEMENT PRACTICE HANDBOOK.
- 3. INSTALL SEDIMENT CONTROL PRACTICES (TRACKING PAD, PERIMETER SILT FENCE, SEDIMENT BASINS, ETC.) PRIOR TO INITIATING OTHER LAND DISTURBING CONSTRUCTION ACTIVITIES.
- 4. THE CONTRACTOR IS REQUIRED TO MAKE EROSION CONTROL INSPECTIONS AT THE END OF EACH WEEK AND WHEN 0.5 INCHES OF RAIN FALLS WITHIN 24 HOURS. INSPECTION REPORTS SHALL BE PREPARED AND FILED AS REQUIRED BY THE DNR AND/OR CITY. ALL MAINTENANCE WILL FOLLOW AN INSPECTION WITHIN 24 HOURS.
- 5. EROSION CONTROL IS THE RESPONSIBILITY OF THE CONTRACTOR UNTIL ACCEPTANCE OF THIS PROJECT. EROSION CONTROL MEASURES AS SHOWN SHALL BE THE MINIMUM PRECAUTIONS THAT WILL BE ALLOWED. ADDITIONAL EROSION CONTROL MEASURES, AS REQUESTED IN WRITING BY THE STATE OR LOCAL INSPECTORS, OR THE DEVELOPER'S ENGINEER, SHALL BE INSTALLED WITHIN 24 HOURS.
- 6. A 3" CLEAR STONE TRACKING PAD SHALL BE INSTALLED AT THE END OF ROAD CONSTRUCTION LIMITS TO PREVENT SEDIMENT FROM BEING TRACKED ONTO THE ADJACENT PAVED PUBLIC ROADWAY. SEDIMENT TRACKING PAD SHALL CONFORM TO WISDNR TECHNICAL STANDARD 1057. SEDIMENT REACHING THE PUBLIC ROAD SHALL BE REMOVED BY STREET CLEANING (NOT HYDRAULIC FLUSHING) BEFORE THE END OF EACH WORK DAY.
- 7. CHANNELIZED RUNOFF: FROM ADJACENT AREAS PASSING THROUGH THE SITE SHALL BE DIVERTED AROUND DISTURBED AREAS.
- 8. STABILIZED DISTURBED GROUND: ANY SOIL OR DIRT PILES WHICH WILL REMAIN IN EXISTENCE FOR MORE THAN 7-CONSECUTIVE DAYS, WHETHER TO BE WORKED DURING THAT PERIOD OR NOT, SHALL NOT BE LOCATED WITHIN 25-FEET OF ANY ROADWAY, PARKING LOT, PAVED AREA, OR DRAINAGE STRUCTURE OR CHANNEL (UNLESS INTENDED TO BE USED AS PART OF THE EROSION CONTROL MEASURES). TEMPORARY STABILIZATION AND CONTROL MEASURES (SEEDING, MULCHING, TARPING, EROSION MATTING, BARRIER FENCING, ETC.) ARE REQUIRED FOR THE PROTECTION OF DISTURBED AREAS AND SOIL PILES, WHICH WILL REMAIN UN-WORKED FOR A PERIOD OF MORE THAN 14-CONSECUTIVE CALENDAR DAYS. THESE MEASURES SHALL REMAIN IN PLACE UNTIL SITE HAS STABILIZED.
- 9. <u>SITE DE-WATERING:</u> WATER PUMPED FROM THE SITE SHALL BE TREATED BY TEMPORARY SEDIMENTATION BASINS OR OTHER APPROPRIATE CONTROL MEASURES. SEDIMENTATION BASINS SHALL HAVE A DEPTH OF AT LEAST 3 FEET, BE SURROUNDED BY SNOWFENCE OR EQUIVALENT BARRIER AND HAVE SUFFICIENT SURFACE AREA TO PROVIDE A SURFACE SETTLING RATE OF NO MORE THAN 750 GALLONS PER SQUARE FOOT PER DAY AT THE HIGHEST DEWATERING PUMPING RATE. WATER MAY NOT BE DISCHARGED IN A MANNER THAT CAUSES EROSION OF THE SITE. A NEIGHBORING SITE. OR THE BED OR BANKS OF THE RECEIVING WATER. POLYMERS MAY BE USED AS DIRECTED BY DNR TECHNICAL STANDARD 1061 (DE-WATERING).

10. INLET FILTERS ARE TO BE PLACED IN STORMWATER INLET STRUCTURES AS SOON AS THEY ARE INSTALLED. ALL PROJECT AREA STORM INLETS NEED WISCONSIN D.O.T. TYPE D INLET PROTECTION. THE FILTERS SHALL BE MAINTAINED UNTIL THE SITE HAS 70% ESTABLISHED VEGETATION.

- 11. USE DETENTION BASINS AS SEDIMENT BASINS DURING CONSTRUCTION. AT THE END OF CONSTRUCTION, REMOVE SEDIMENT AND RESTORE PER PLAN.
- 12. RESTORATION (SEED, FERTILIZE AND MULCH) SHALL BE PER SPECIFICATIONS ON THIS SHEET.
- 13. TERRACES SHALL BE RESTORED WITH 6" TOPSOIL, PERMANENT SEED, FERTILIZER AND MULCH. OTHER AREAS SHALL BE RESTORED WITH 6" TOPSOIL, TEMPORARY SEED, FERTILIZER AND MULCH.
- 14. SEED, FERTILIZER AND MULCH SHALL BE APPLIED WITHIN 7 DAYS AFTER FINAL GRADE HAS BEEN ESTABLISHED. IF DISTURBED AREAS WILL NOT BE RESTORED IMMEDIATELY AFTER ROUGH GRADING, TEMPORARY SEED SHALL BE PLACED.

15. FOR THE FIRST SIX WEEKS AFTER RESTORATION (E.G. SEED & MULCH, EROSION MAT, SOD) OF A DISTURBED AREA, INCLUDE SUMMER WATERING PROVISIONS OF ALL NEWLY SEEDED AND MULCHED AREAS WHENEVER 7 DAYS ELAPSE WITHOUT A RAIN EVENT.

16. SILT FENCE OR EROSION MAT SHALL BE INSTALLED ALONG THE CONTOURS AT 100 FOOT INTERVALS DOWN THE SLOPE ON THE DISTURBED SLOPES STEEPER THAN 5% AND MORE THAN 100 FEET LONG THAT SHEET FLOW TO THE ROADWAY UNLESS SOIL STABILIZERS ARE USED.

17. INSTALL MINIMUM 6'-7' WIDE EROSION MAT ALONG THE BACK OF CURB AFTER TOPSOIL HAS BEEN PLACED IN THE TERRACE IF THIS AREA WILL NOT BE SEEDED AND MULCHED WITHIN 48 HOURS OF PLACING TOPSOIL

- 18. SILT FENCE TO BE USED ACROSS AREAS OF THE LOT THAT SLOPE TOWARDS A PUBLIC STREET OR WATERWAY. SEE DETAILS.
- 19. SEDIMENT SHALL BE CLEANED FROM CURB AND GUTTER AFTER EACH RAINFALL AND PRIOR TO PROJECT ACCEPTANCE.

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- 20. ACCUMULATED CONSTRUCTION SEDIMENT SHALL BE REMOVED FROM ALL PERMANENT BASINS TO THE ELEVATION SHOWN ON THE GRADING PLAN FOLLOWING THE STABILIZATION OF DRAINAGE AREAS.
- 21. ALL CONSTRUCTION ENTRANCES SHALL HAVE TEMPORARY ROAD CLOSED SIGNS THAT WILL BE IN PLACE WHEN THE ENTRANCE IS NOT IN USE AND AT THE END OF EACH DAY.
- 22. ANY PROPOSED CHANGES TO THE EROSION CONTROL PLAN MUST BE SUBMITTED AND APPROVED BY DANE COUNTY LAND CONSERVATION OR PERMITTING MUNICIPALITY.
- 23. THE CITY, OWNER AND/OR ENGINEER MAY REQUIRE ADDITIONAL EROSION CONTROL MEASURES AT ANY TIME DURING CONSTRUCTION.

CONSTRUCTION SEQUENCE:

- 1. INSTALL SILT FENCE, INLET PROTECTION IN EXISTING STORM INLETS WHERE INDICATED, AND TRACKING PAD
- 2. DEMOLITION PER PLAN
- 3. STRIP TOPSOIL-DETENTION BASIN
- 4. ROUGH GRADE-DETENTION BASIN
- 5. SEED AND EROSION MAT DETENTION BASIN
- 6. STRIP TOPSOIL
- 7. ROUGH GRADE
- 8. CONSTRUCT UNDERGROUND UTILITIES
- 9. INSTALL INLET PROTECTION
- 10. CONSTRUCT SITE IMPROVEMENTS
- 11. RESTORE ALL DISTURBED AREAS
- 12. REMOVE INLET PROTECTION AND SILT FENCE ONCE SITE HAS 70% ESTABLISHED VEGETATION
- 13. INSTALL OIL & GREASE FILTERS WHERE INDICATED ON GRADING AND EROSION CONTROL PLAN

SEEDING RATES:

1. USE ANNUAL OATS AT 3.0 LB./1,000 S.F. FOR SPRING AND SUMMER PLANTINGS.

2. USE WINTER WHEAT OR RYE AT 3.0 LB./1,000 SF FOR FALL PLANTINGS STARTED AFTER SEPTEMBER 15.

1. USE WISCONSIN D.O.T. SEED MIX #40 AT 2 LB./1,000 S.F.


FERTILIZING RATES:

USE WISCONSIN D.O.T. TYPE A OR B AT 7 LB./1,000 S.F.

MULCHING RATES:

TEMPORARY AND PERMANENT:

USE ½" TO 1-½" STRAW OR HAY MULCH, CRIMPED PER SECTION 607.3.2.3, OR OTHER RATE AND METHOD PER SECTION HIGHWAY AND STRUCTURE CONSTRUCTION

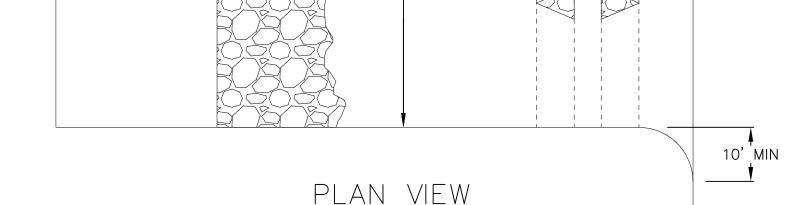

24' MIN

TRACKING

-50' MINIMUM LENGTH

MINIMUM 12" DEEP

PAD OF 3" CLEAR

STONE OVER FULL

OF STRUCTURE

LENGTH AND WIDTH

PROFILE VIEW

-50' MINIMUM LENGTH

1. FOLLOW WISCONSIN DNR TECHNICAL STANDARD 1057 FOR FURTHER DETAILS AND INSTALLATION.

2. LENGTH - MINIMUM OF 50'.

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— EXISTING GROUND

3. WIDTH - 24' MINIMUM, SHOULD BE FLARED AT THE EXISTING ROAD TO PROVIDE A TURNING RADIUS.


4. ON SITES WITH A HIGH GROUND WATER TABLE OR WHERE SATURATED CONDITIONS EXIST, GEOTEXTILE FABRIC SHALL BE PLACED OVER EXISTING GROUND PRIOR TO PLACING STONE. FABRIC SHALL BE WISDOT TYPE-HR GEOTEXTILE

5. STONE - CRUSHED 3" CLEAR STONE SHALL BE PLACED AT LEAST 12" DEEP OVER THE ENTIRE LENGTH AND WIDTH

6. SURFACE WATER - ALL SURFACE WATER FLOWING TO OR DIVERTED TOWARDS CONSTRUCTION ENTRANCES SHALL BE PIPED THROUGH THE ENTRANCE. MAINTAINING POSITIVE DRAINAGE. PIPE INSTALLED THROUGH THE STABILIZED CONSTRUCTION ENTRANCE SHALL BE PROTECTED WITH A MOUNTABLE BERM WITH 5:1 SLOPES AND MINIMIUM OF 6" STONE OVER THE PIPE. PIPE SHALL BE SIZED ACCORDING TO THE DRAINAGE REQUIREMENTS. WHEN THE ENTRANCE IS LOCATED AT A HIGH SPOT AND HAS NO DRAINAGE TO CONVEY A PIPE SHALL NOT BE NECESSARY. THE MINIMUM PIPE DIAMETER SHALL BE 6". CONTRACTOR SHALL BE RESPONSIBLE FOR THE MAINTENANCE OF SAID PIPE.

7. LOCATION - A STABILIZED CONSTRUCTION ENTRANCE SHALL BE LOCATED WHERE CONSTRUCTION TRAFFIC ENTERS AND/OR LEAVES THE CONSTRUCTION SITE. VEHICLES LEAVING THE SITE MUST TRAVEL OVER THE ENTIRE LENGTH OF THE TRACKING PAD.

NOT FOR CONSTRUCTION

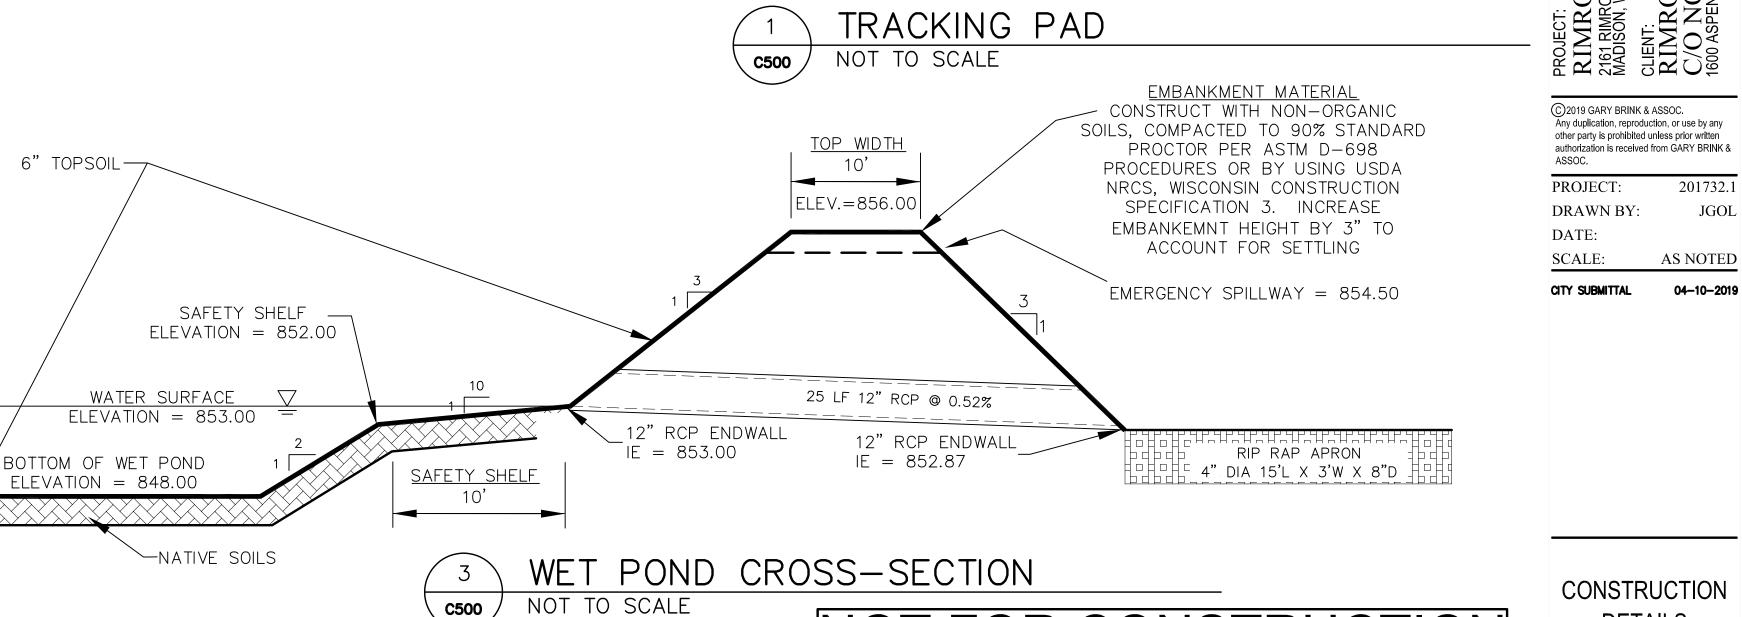

- MOUNTABLE BERM

6" MIN. HEIGHT (OPTIONAL)

EXISTING

EARTH FILL

- PIPE AS NECESSARY

SEE NOTE 6

PAVEMENT

10' MIN


2248 DEMING WAY. STE. 120 MIDDLETON, WI 53562 (608) 829-1750 (608) 829-3056 (FAX)



PROJECT:
RIMROCK RETAIL
2161 RIMROCK ROAD
MADISON, WI 53713
CLIENT:
RIMROCK RETAIL INVESTOR;
C/O NORTH CENTRAL GROUP
1600 ASPEN COMMONS, SUITE 200

CONSTRUCTION **DETAILS**

C500

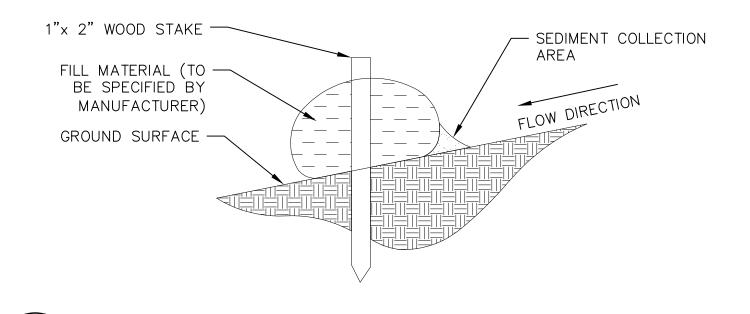



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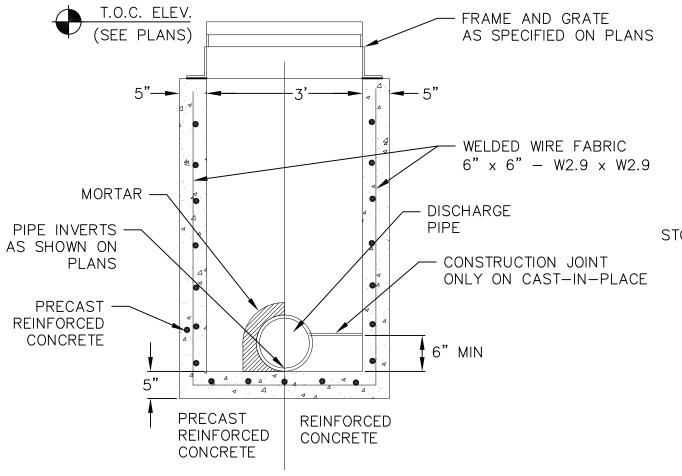
- 1. INSTALL SILT FENCE TO FOLLOW THE GROUND CONTOURS AS CLOSELY AS POSSIBLE.
- 2. CURVE THE SILT FENCE UP THE SLOPE TO PREVENT WATER FROM RUNNING AROUND THE
- 3. POST SPACING WITH FENCE SUPPORT MESH = 10 FT. (MAX.)
 - POST SPACING WITHOUT FENCE SUPPORT MESH = 6 FT. (MAX.)
- 4. SILT FENCE SUPPORT MESH CONSISTS OF 14-GAUGE STEEL WIRE WITH A MESH SPACING OF 6 IN. X 6 IN. OR PREFABRICATED POLYMERIC MESH OF EQUIVALENT STRENGTH

SILT FENCE

NOT TO SCALE



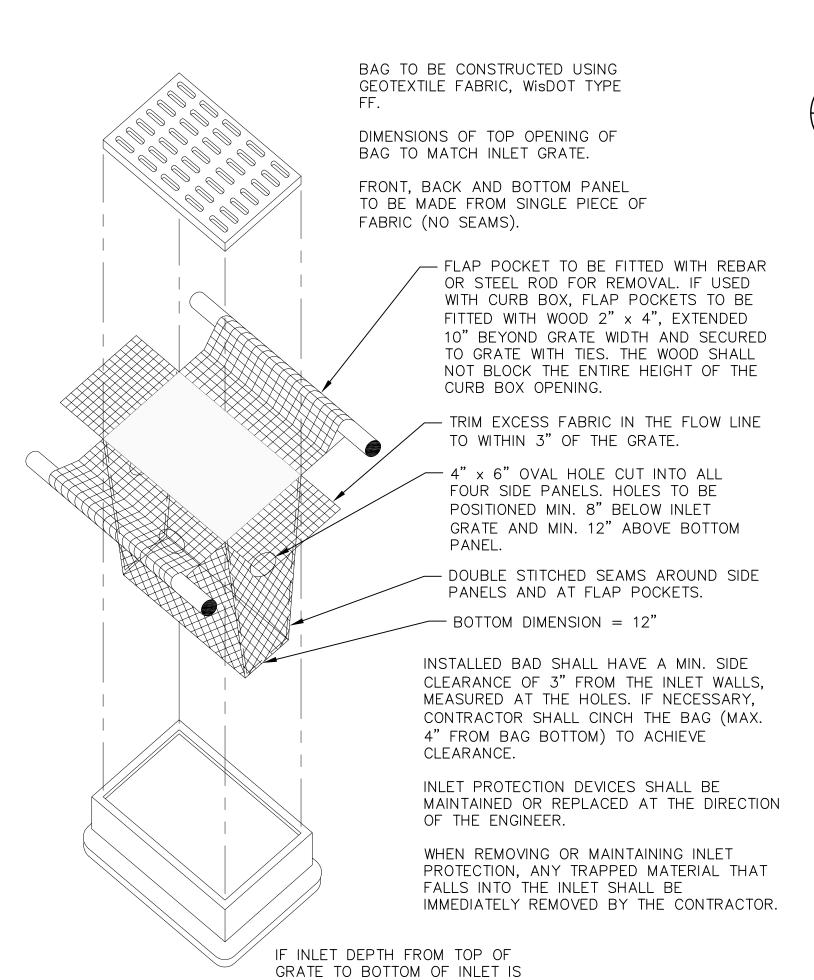

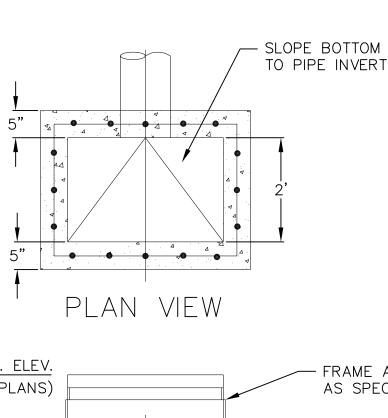

CURB INLET - TYPE 3, 2' x 3' BASIN

CROSS SECTION

NOT TO SCALE

BACKPLASTER -& MASTIC RINGS TOGETHER - JOINTS SHALL BE SEALED WITH MASTIC STEPS AT 16" O.C. CUT-OUT FOR -STORM SEWER BENCH SLOPE STORM MANHOLE - 1" PER FOOT INVERT : ELEVATION - 6" GRAVEL FILL REQUIRED (WASHED STONE W/WET SUBGRADE

CASTING SHALL BE 1/2" BELOW FINISHED PAVEMENT OR AS ESTABLISHED BY THE ENGINEER

— ADJUSTING RINGS

MANHOLE CASTING SHALL BE HEAVY DUTY, NEENAH FOUNDRY CO. CATALOG LISTING NO. R-1550, WITH TYPE "B" NON-ROCKING LID, GASKET SEAL AND CONCEALED PICKHOLES

ADJUST FRAME TO GRADE WITH AT LEAST TWO PRECAST CONCRETE RINGS OF DIFFERENT THICKNESSES.

CONCRETE SHALL BE 4000 PSI, 28 DAY COMPRESSIVE STRENGTH, 6.5 BAG MIX WITH $1\sim2\%$ AIR ENTRAINMENT.

MANHOLE STEPS SHALL CONFORM TO ASTM-C478 & SHALL BE NEENAH FOUNDRY CO. R-1981-N OR APPROVED EQUAL. STEPS SHALL BE SPACED 16" ON CENTER.


A MINIMUM OF 3" TO A MAXIMUM OF 9" OF ADJUSTING RINGS SHALL BE USED TO ADJUST THE MANHOLE CASTING TO THE FINISHED GRADE. ALL RINGS SHALL BE SEALED TOGETHER USING MASTIC AND ALL JOINTS SHALL BE BACK PLASTERED INSIDE AND OUT WITH CEMENT MORTAR.

2x3 OPENING IS REQUIRED FOR STORM INLET MANHOLES WITH CASTING AND RINGS AS SPECIFIED IN DETAIL 02721-A.

STORM MANHOLE DIMENSIONS

PICIVI IVII CILL BIIVILING							
	MANHOLE	DIMENSION					
	SIZE	Α	B (MIN.)				
	48"	48"	5"				
	60"	60"	6"				
	72"	72"	7"				
	84"	84"	7"				
	96"	96"	9"				

STORM SEWER MANHOLE NOT TO SCALE C501

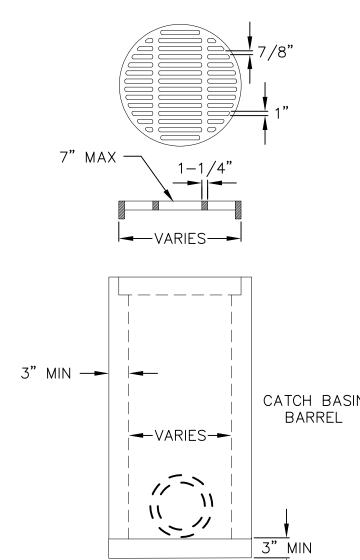

CONTRACTOR TO VERIFY COMPATIBILITY OF FRAME AND GRATE WITH CATCH BASIN PRIOR TO PROCUREMENT.

FRAME AND GRATE AS SPECIFIED ON THE PLANS. WHERE NOT OTHERWISE SPECIFIED, FRAME AND GRATE SHALL ADHERE TO THE FOLLOWING:

GRATE IS CAST GRAY IRON MANUFACTURED TO MEET ASTM A-48 CLASS 35 B AND AASHTO M105 SPECIFICATIONS


GRATES ARE AASHTO H20 LOAD RATED

GRATE SETS FLUSH WITH TOP OF CATCH BASIN BELL

PRECAST REINFORCED CONCRETE CATCH BASIN IN MANUFACTURED TO MEET ASTM CATCH BASIN C-478 AND AASHTO M199 SPECIFICATIONS

> CATCH BASIN JOINT MATERIAL: CONSEAL CS-102 AND/OR CS-202 OR EQUIVALENT WHICH MEETS OR EXCEEDS FEDERAL SPECIFICATION SS-S-210 (210A), AASHTO M-198B AND ASTM C-990

PIPE TO CATCH BASIN CONNECTORS: KOR-N-SEAL OR EQUIVALENT WHICH MEETS OR EXCEEDS REQUIREMENTS OF ASTM C-923

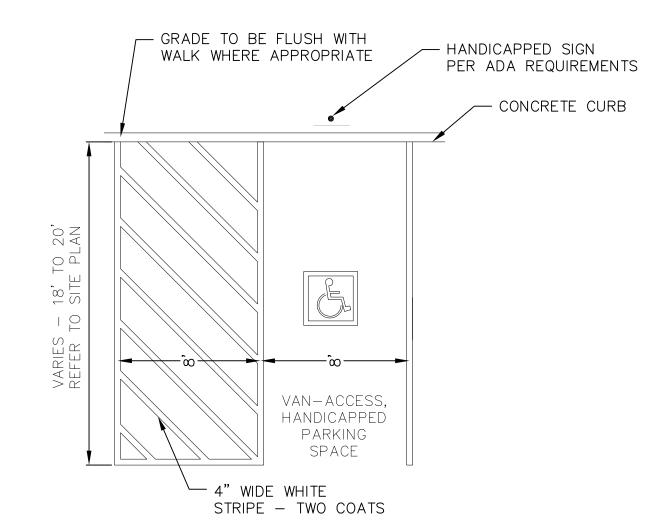

HANDICAP STRIPING NOT TO SCALE C501

24" - DIA. FIELD INLET (FI) & GRATE NOT TO SCALE

NOT FOR CONSTRUCTION

2248 DEMING WAY. STE. 120 MIDDLETON, WI 53562 (608) 829-1750 (608) 829-3056 (FAX)



Vierbic | planners | engineers |

PROJECT:
RIMROCK RETAIL
2161 RIMROCK ROAD
MADISON, WI 53713
CLIENT:
RIMROCK RETAIL INVESTORS
C/O NORTH CENTRAL GROUP
1600 ASPEN COMMONS, SUITE 200

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DRAWN BY: JGOL DATE: SCALE: AS NOTED

CONSTRUCTION **DETAILS**

C501


INLET PROTECTION TYPE D

LESS THAN 30", CONTRACTOR

INLET PROTECTION.


SHALL SUBSTITUTE WisDOT TYPE C

NOT TO SCALE

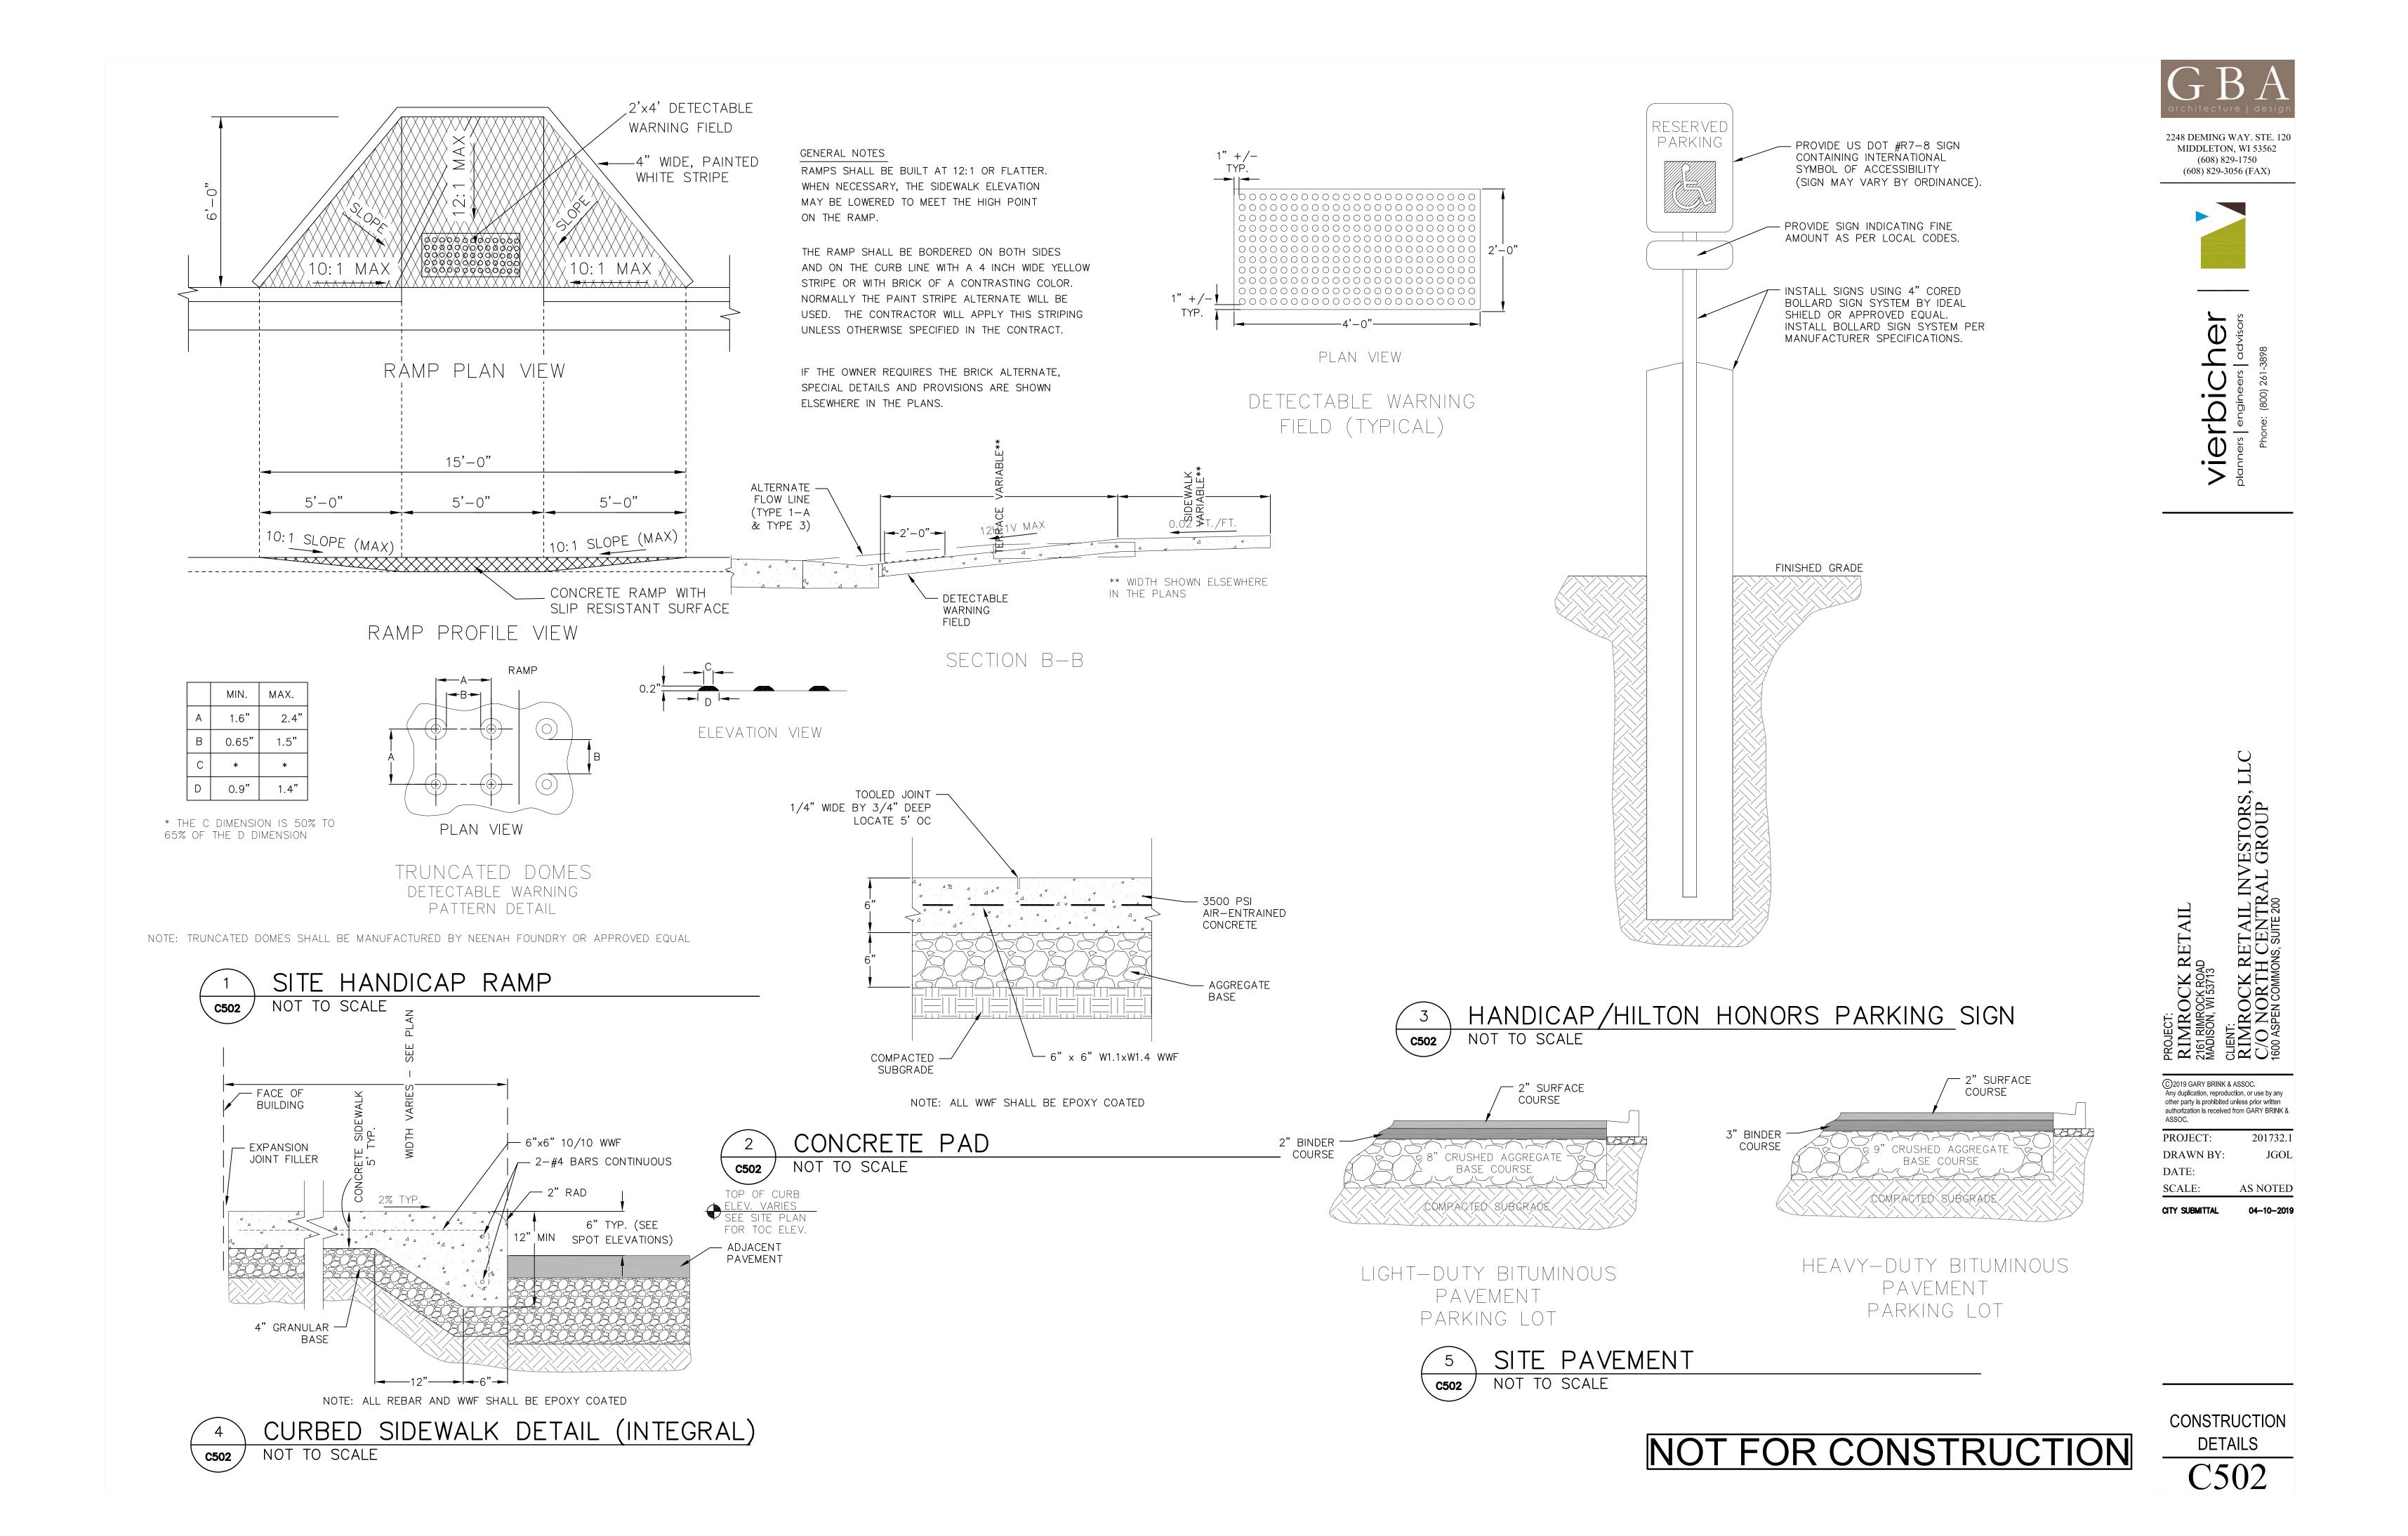


CONSTRUCTION SPECIFICATIONS


- 1. LOCATE WASHOUT STRUCTURE A MINIMUM OF 50 FEET AWAY FROM OPEN CHANNELS, STORM DRAIN INLETS, SENSITIVE AREAS, WETLANDS, BUFFERS AND WATER COURSES AND AWAY FROM CONSTRUCTION TRAFFIC.
- 2.PREPARE SOIL BASE FREE OF ROCKS OR OTHER DEBRIS THAT MAY CAUSE TEARS OR HOLES IN THE LINER. FOR LINER, USE 10 MIL OR THICKER UV RESISTANT, IMPERMEABLE SHEETING, FREE OF HOLES AND TEARS OR OTHER DEFECTS THAT COMPROMISE IMPERMEABILITY OF THE MATERIAL.
- 3.KEEP CONCRETE WASHOUT STRUCTURE WATER TIGHT. REPLACE IMPERMEABLE LINER IF DAMAGED (E.G., RIPPED OR PUNCTURED). EMPTY OR REPLACE WASHOUT STRUCTURE THAT IS 75 PERCENT FULL, AND DISPOSE OF ACCUMULATED MATERIAL PROPERLY. DO NOT REUSE PLASTIC LINER. WET-VACUUM STORED LIQUIDS THAT HAVE NOT EVAPORATED AND DISPOSE OF IN AN APPROVED MANNER. REMOVE HARDENED SOLIDS, WHOLE OR BROKEN UP, FOR DISPOSAL OR RECYCLING. MAINTAIN RUNOFF DIVERSION AROUND EXCAVATED WASHOUT STRUCTURE UNTIL STRUCTURE IS REMOVED.

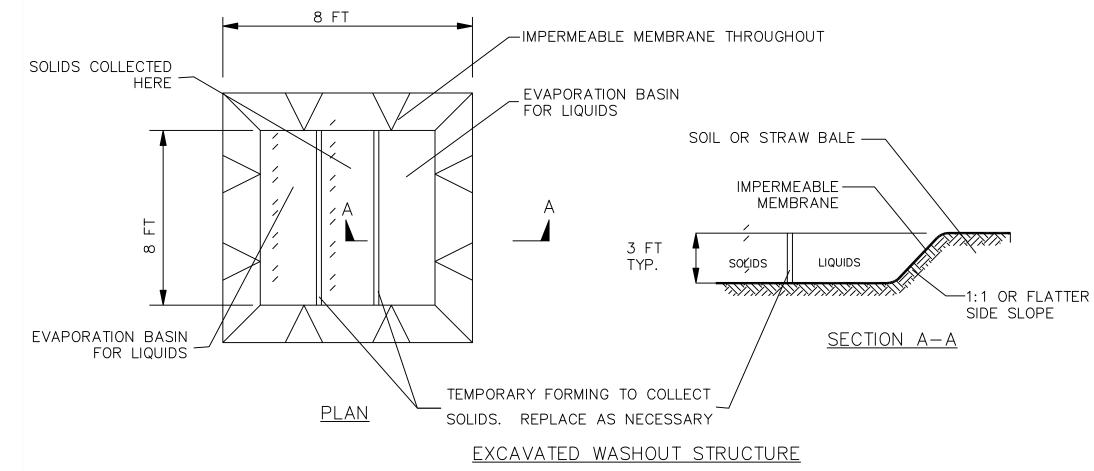



CONCRETE WASHOUT AREA NOT TO SCALE C503

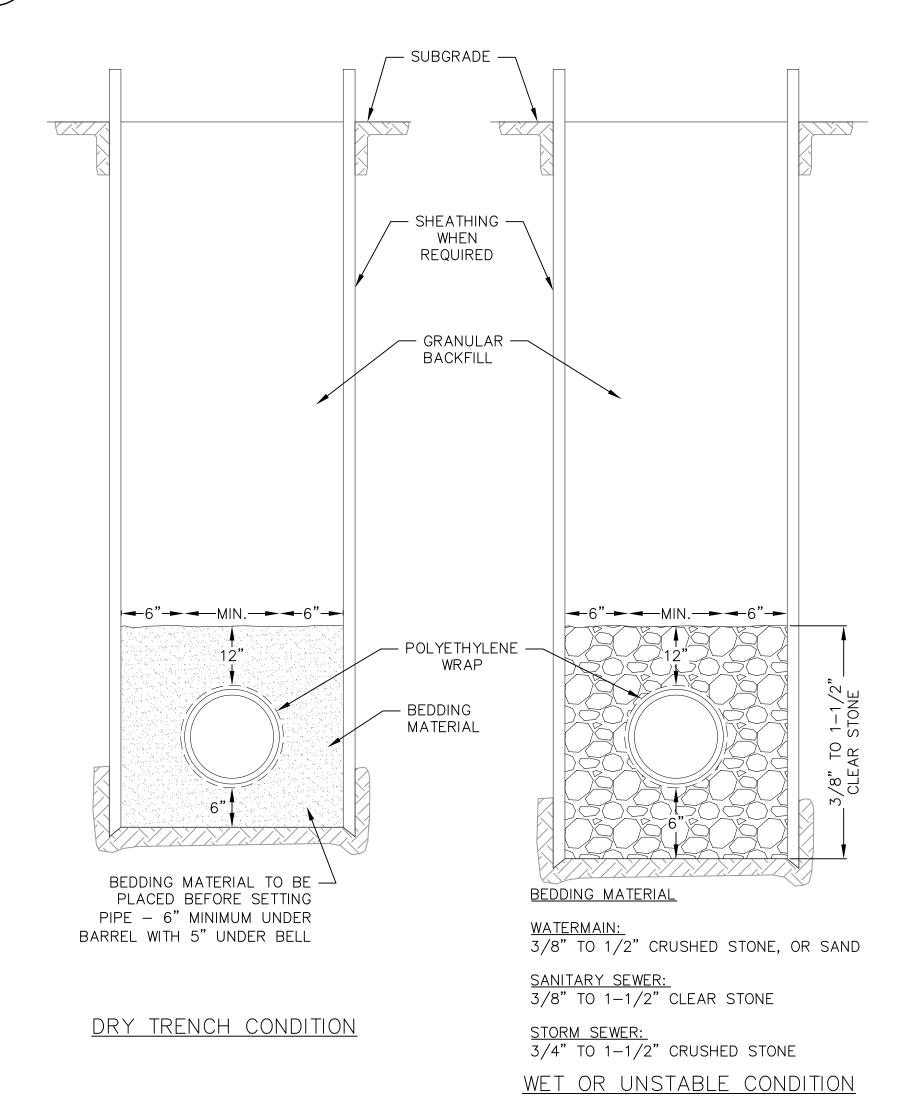



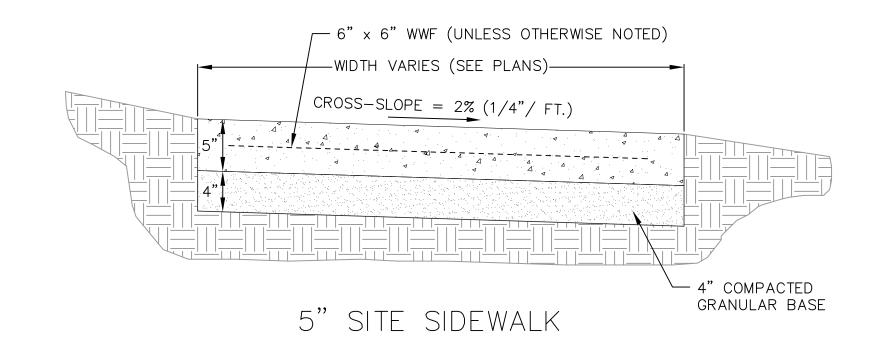


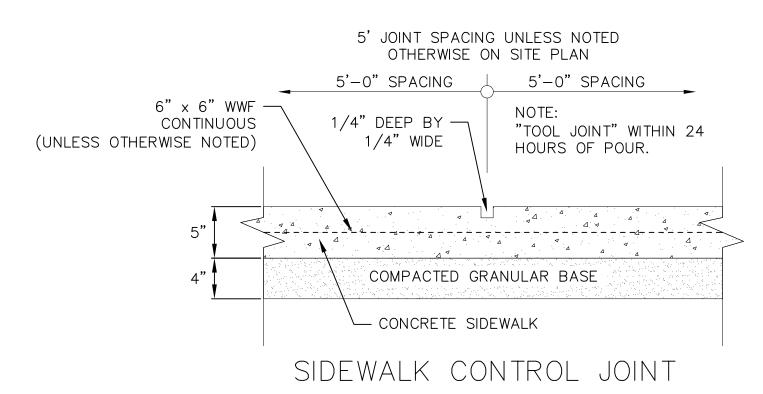

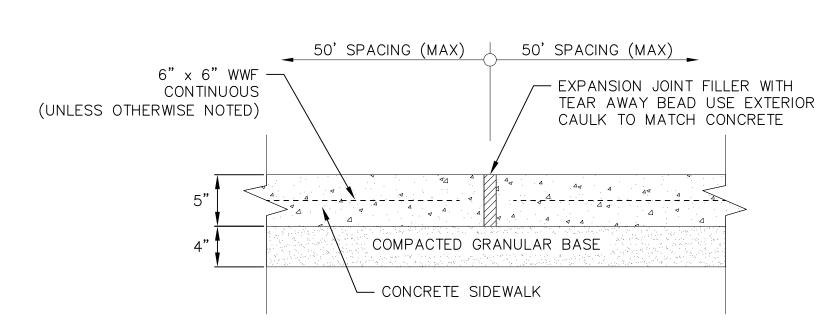

NOTE: ALL WWF SHALL BE EPOXY COATED


SIDEWALK EXPANSION JOINT

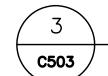



SIDEWALK NOT TO SCALE


SIGNAGE NOTES:

- 1. ALL SIGNS SHALL BE FABRICATED AND INSTALLED IN ACCORDANCE WITH THE MANUAL ON UNIFORM TRAFFIC CONTROL DEVICES.
- 2. SIGNS SHALL BE A DISTANCE OF 7' FROM GROUND LEVEL TO THE BOTTOM OF THE SIGN
- MOUNTED ON THE POST AND LOCATED 3' BEHIND THE BACK OF CURB. 3. STREET NAME SIGNS SHALL HAVE WHITE LETTERS AND GREEN BACKGROUND.
- 4. SIGN POSTS SHALL BE 2-3/8" O.D., GALVANIZED 10 FT LONG, 13 GAUGE, AND 0.095 WALL THICKNESS. MOUNT SIGN AT TOP OF THE POST, AND INSTALL POSTS 3' DEEP AND MIX 1/2 BAG OF 80 LB SAKRETE CONCRETE, POURING IT AROUND THE POST BELOW THE GROUND BEFORE COVERING WITH 8" OF TOPSOIL.

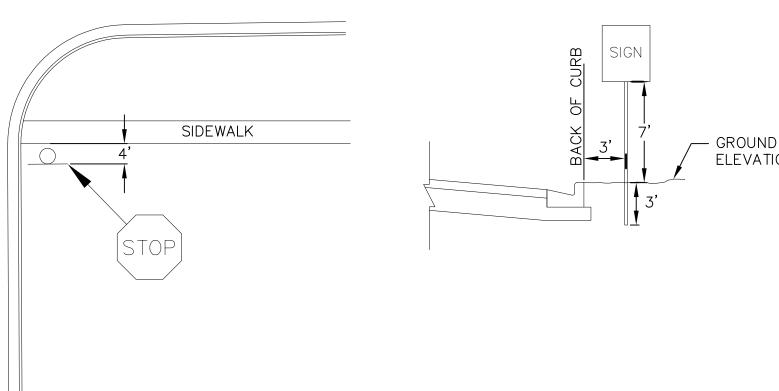


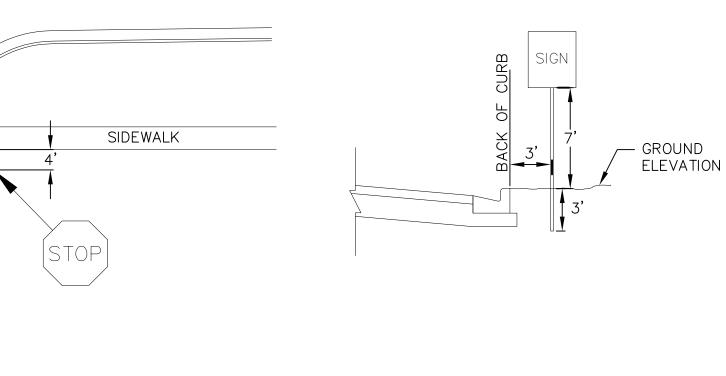


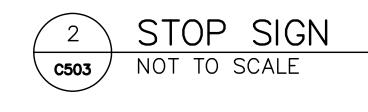

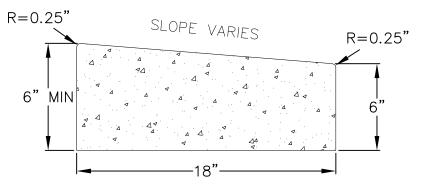


RIBBON CURB CROSS SECTION

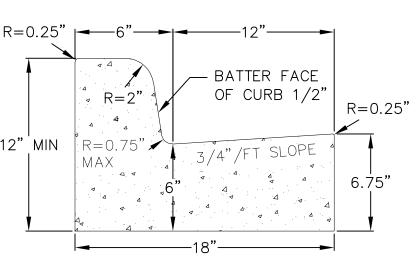

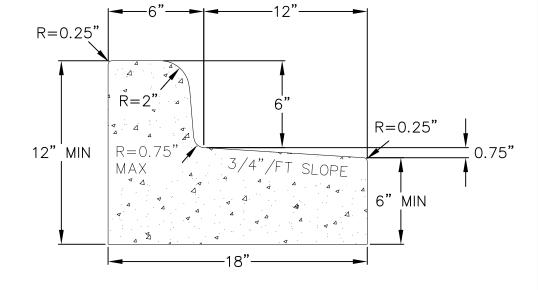

CURB AND GUTTER CROSS SECTION

CURB AND GUTTER REJECT SECTION

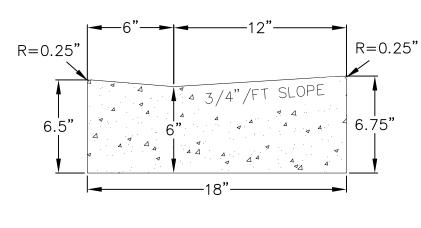

HANDICAP RAMP GUTTER CROSS SECTION

ROLL FACE GUTTER CROSS SECTION

NOT FOR CONSTRUCTION



2248 DEMING WAY. STE. 120 MIDDLETON, WI 53562 (608) 829-1750 (608) 829-3056 (FAX)



CLIENT:
RIMROCK RETAIL INVESTOR
C/O NORTH CENTRAL GROU PROJECT:
RIMROCK RETAIL
2161 RIMROCK ROAD
MADISON, WI 53713


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201732.1 DRAWN BY: JGOL DATE: SCALE: AS NOTED

CONSTRUCTION **DETAILS**

C503

NOT FOR CONSTRUCTION

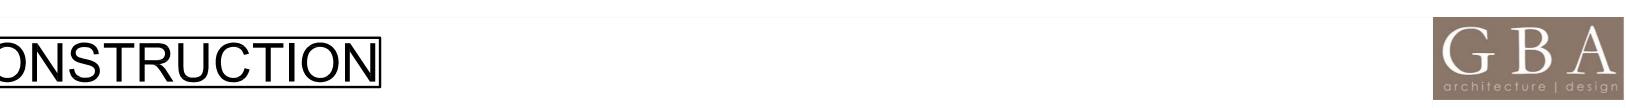

PART VII - WATER MAINS AND SERVICE LATERALS

INSIDE DIAMETER D1 = 5-1/4"

<u>SECTION</u>

CROSS SECTION

GRATE FRAME . (GRATE NOT SHOWN FOR CLARITY)

CONCRETE DROP INLET. —

REFER TO SPECIFIER CHART — FOR CATCH BASIN & FILTER SIZING. SEE SHEET 1 OF 2.

FOSSIL ROCK™

CONCRETE DROP INLET.

FloGard®

WATER UTILITY

NOT TO SCALE

---- SEE DETAIL

ABSORBANT POUCHES.

PAVEMENT SURFACE.

-- OUTLET

SECTION VIEW

Oldcastle®

NOT TO SCALE

City of Madison Standard Specifications for Public Works Construction

STANDARD GATE VALVE BOX SETTING



2248 DEMING WAY. STE. 120 MIDDLETON, WI 53562 (608) 829-1750

(608) 829-3056 (FAX)



DETAIL DRAWING NO. 7.06
REVISED: 12/2015

-ROAD BASE SECTION

— TRENCH ZONE

1. VALVE BOX SHALL BE LOCATED SEENOTE 3
PLUMB AND CENTERED WITH RESPECT
TO THE VALVE OPERATING NUT.

2. ALLOWABLE TOLERANCE SHALL BE 3/4"

3. PLUMBNESS AND ALIGNMENT SHALL BE VERIFIED WITH A PLUMB BOB, LOCATING THE VALVE NUT WITHIN THE ALLOWABLE TOLERANCE, AND CONFIRMING THE VALVE IS OPERATIONAL WITHOUSE HUBE 2 VALVE KEY TOUCHING THE INSIDE EDGE OF THE VALVE BOX.

4. FOR STREETS WITH SLOPE GREW作時 竹柏內 3% THAT DOES NOT ALLOW EASY PLUMBNESS VERIFICATION, THE VALVE BOX STRAIGHTNESS SHALL BE VISUALLYAGGESGEDVERIFYING ITS RELATIVE CENTERED POSITION, CONFIRMING THAT THE VALVE IS OPERATIONAL WITHOUT THE VALVE FOR THE INSIDE FOR

THE VALVE KEY TOUCHING THE INSIDE EDGE OF THE VALVE BOX AND RESTRICTING ITS USE

DETAIL

T = 3/4" T = 3/4" T = 3/4"

(*) TOLERANCE T = 3/4"

ALIGNMENT

JENT:
JIMROCK RETAIL INVESTOR

//O NORTH CENTRAL GROU

00 ASPEN COMMONS, SUITE 200

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ASSOC.	
PROJECT:	201732.
DRAWN BY:	JGO
DATE:	
SCALE:	AS NOTE

CONSTRUCTION DETAILS

C504



CITY RACK, 2400 SERIES, SGL, BG



SARIS CYCLING GROUP

SARIS CYCLING GROUP. ANY


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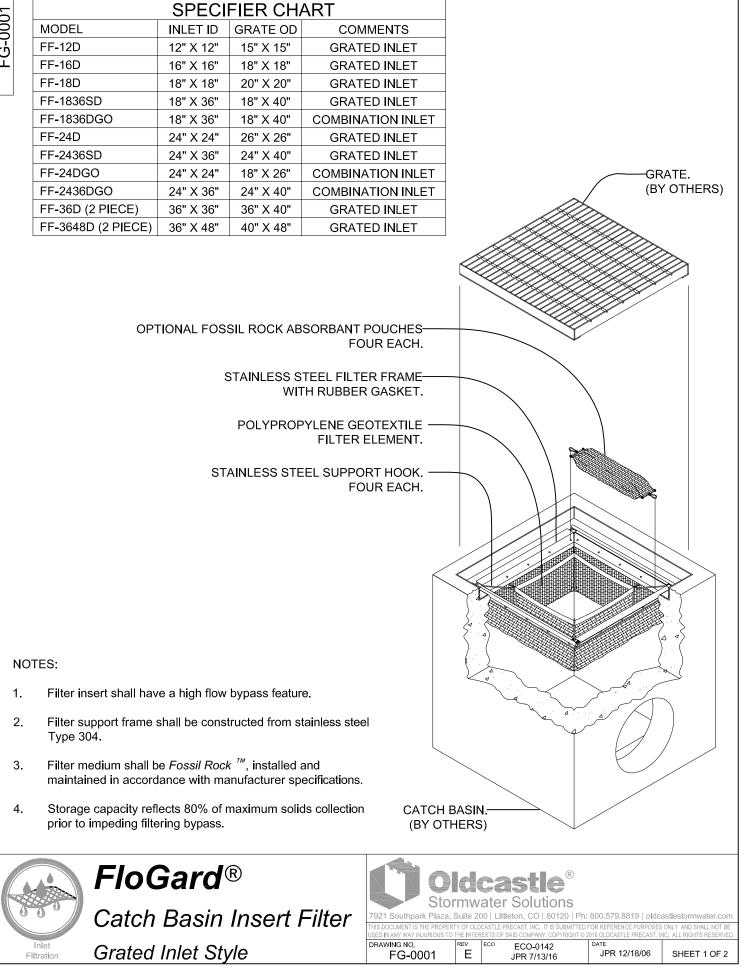
REPRODUCTION IN PART OF WHOLE WITHOUT THE WRITTEN PERMISSION OF SARIS CYCLING GROUP IS PROHIBITED.


WE BRING CYCLING TO LIFE. 5253 VERDNA RD., MADISON VI. 53711 1-800-783-7257 / 1-608-274-1702 VVV.SARISPARKING.COM

- 1. DO NOT SCALE DRAWING.
- 2. INSTALLATION TO BE COMPLETED IN ACCORDANCE WITH MANUFACTURER'S SPECIFICATIONS.
- 3. WEIGHT IS RACK ONLY, NOT TO BE CONSIDERED AS SHIPPING WEIGHT.
- 4. FINISHING OPTIONS INCLUDE SUPER DURABLE POLYESTER POWDERCOAT AND HOT DIP
- GALVANIZING. 5. SEE WEBSITE OR CATALOG FOR POLYESTER POWDERCOAT COLOR OPTIONS.

BIKE RACK DETAIL (4-STALL SHOWN) NOT TO SCALE




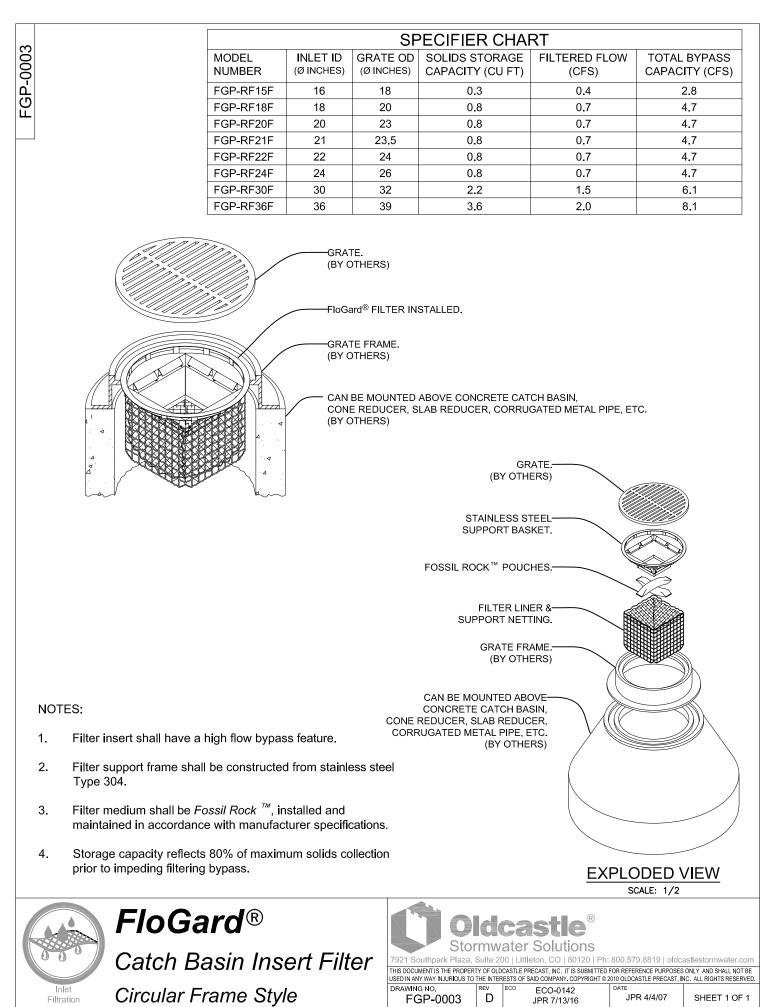

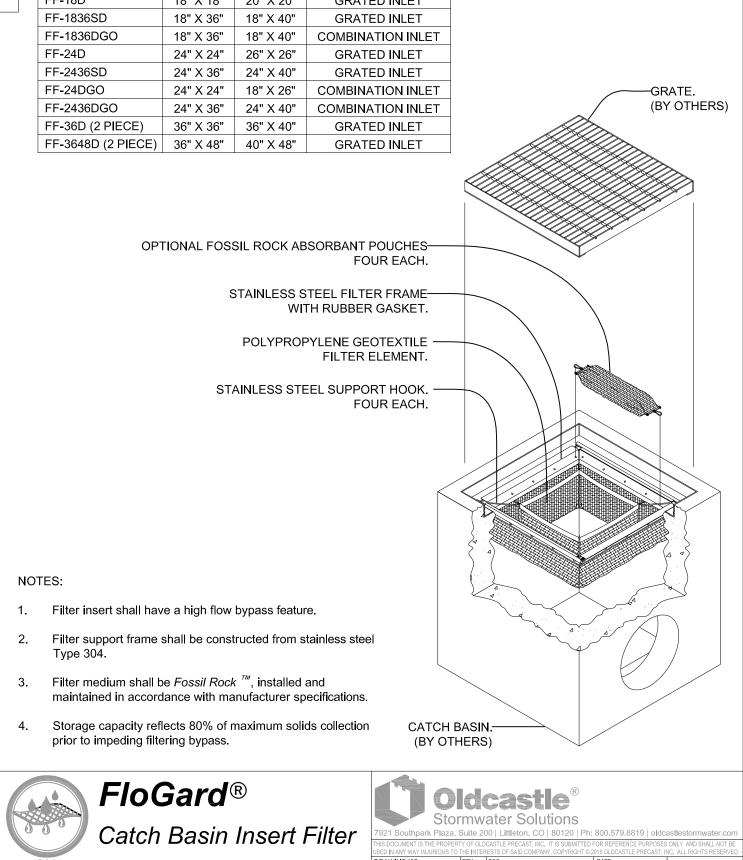






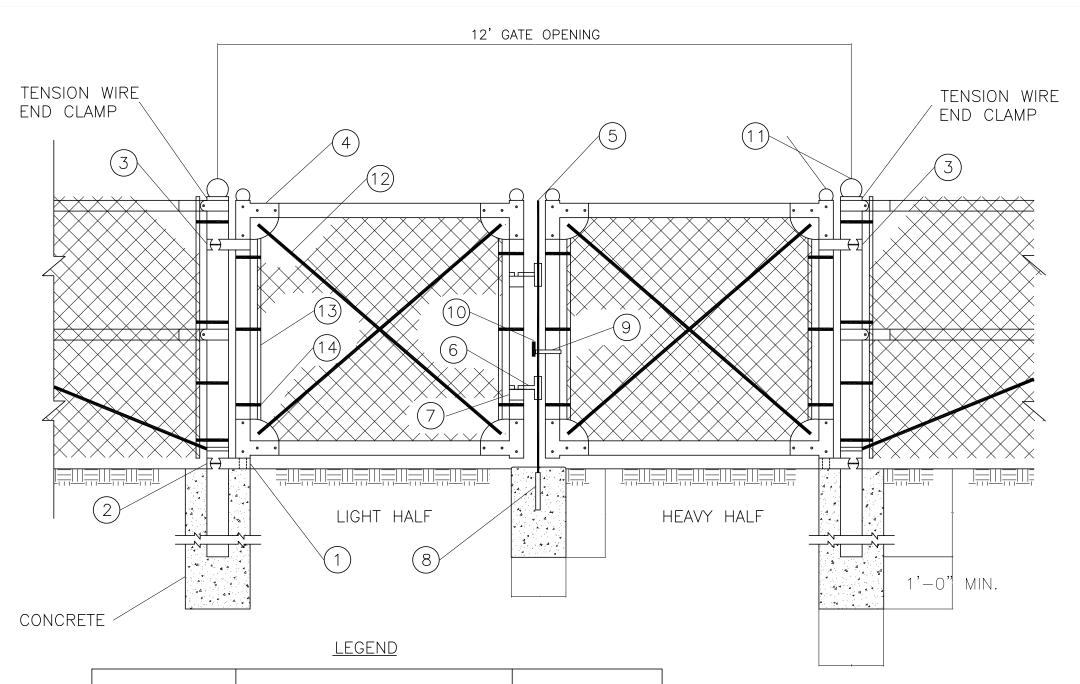

PART NO.	DESCRIPTION	QUANTITY
1	STRAIGHT PLUG	2
2	BOTTOM HINGE	2
3	TOP HINGE	2
4	CORNER ELBOW	8
5	PLUNGER ROD	1
6	LATCH FORK	2
7	FORK CATCH	2
8	PLUNGER ROD CATCH	1
9	LOCK KEEPER GUIDE	1
10	LOCK KEEPER	1
11	ORNAMENTAL TOPS	6
12	TRUSS RODS	4
13	STRETCHER BAR	4
14	HOOK BOLTS	12

NOTE:
THE FENCING SHALL BE BLACK
VINYL COATED #9 GAGE FENCE
FABRIC, STANDARD 2—INCH CHAIN
LINK DIAMOND MESH.

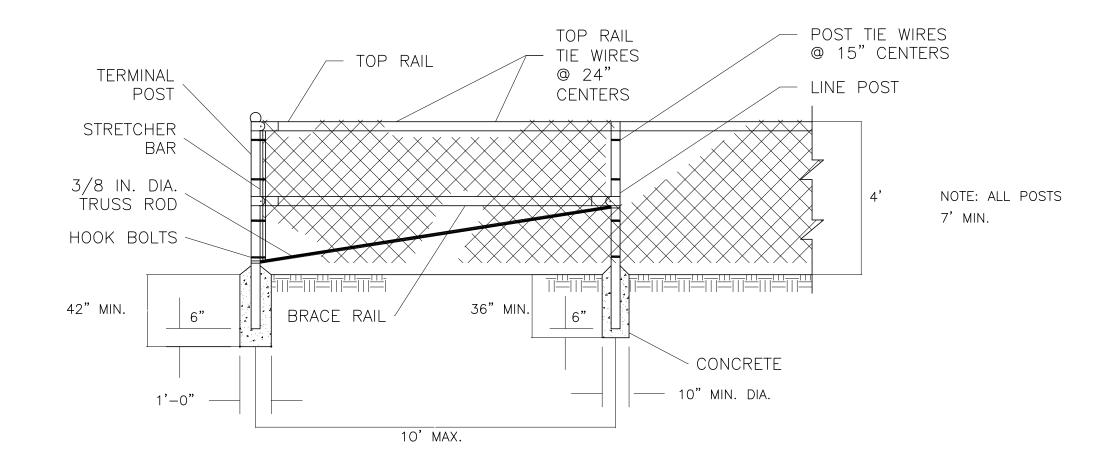

CONSTRUCTION NOTES


1. MATERIALS, INSTALLATION, AND WORKMANSHIP SHALL CONFORM TO THE MANUFACTURER'S SPECIFICATIONS. MANUFACTURER TO BE QUAL—LINE, STRUCK AND IRWIN, OR APPROVED EQUAL.

2. ALL POSTS SHALL BE INSTALLED VERTICALLY. WHERE POSTS ARE INSTALLED ON AN INCLINED SURFACE, THE ANGLE OF THE POST SHALL BE ADJUSTED SO THAT THE POST WILL BE VERTICAL.

3. THE FENCING SHALL BE BLACK VINYL COATED #9 GAUGE FENCE FABRIC, STANDARD 2 IN. CHAIN LINK DIAMOND MESH.



NOT FOR CONSTRUCTION

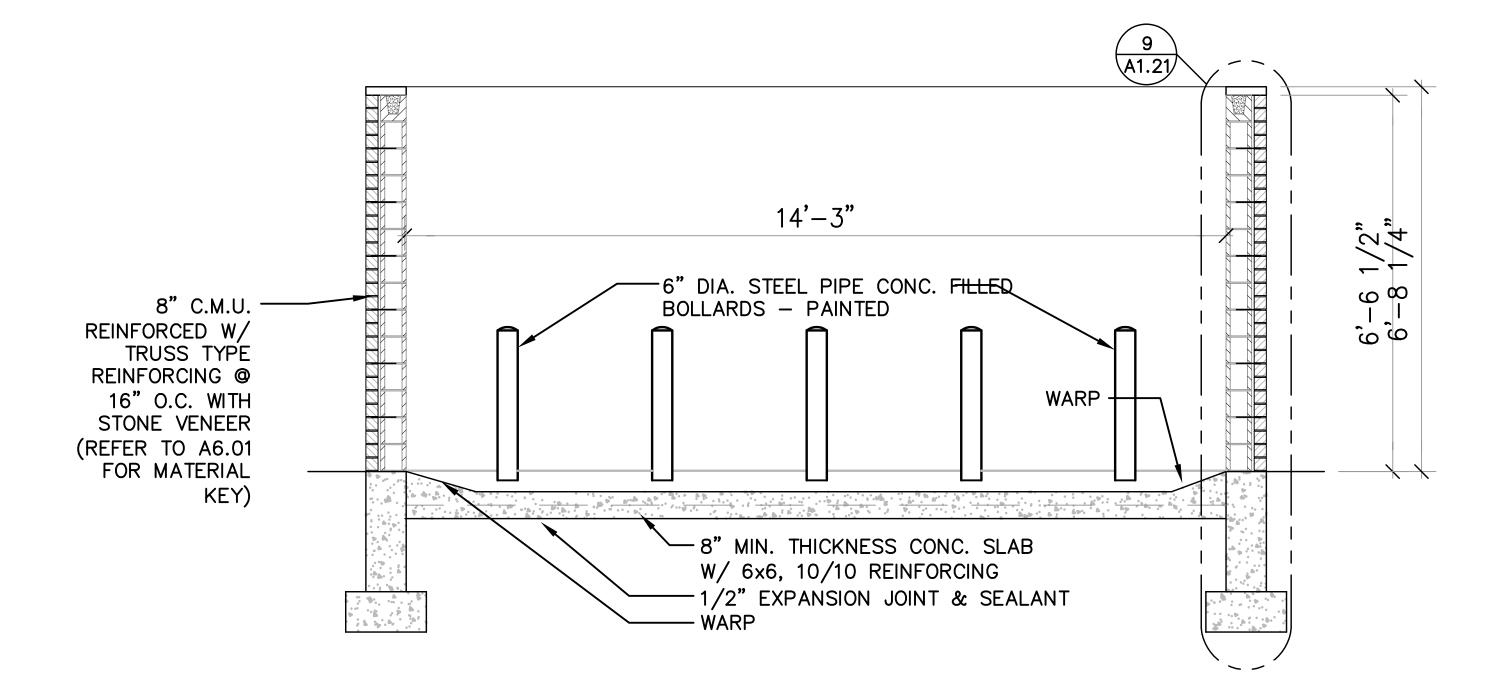

REFUSE ENCLOSURE — LONGITUDINAL SECTION NOT TO SCALE



2248 DEMING WAY. STE. 120 MIDDLETON, WI 53562 (608) 829-1750 (608) 829-3056 (FAX)



Vierbicher Manners | engineers | advisors

RIMROCK RETAIL

2161 RIMROCK ROAD
MADISON, WI 53713

CLIENT:
RIMROCK RETAIL INVESTORS, LLC
C/O NORTH CENTRAL GROUP

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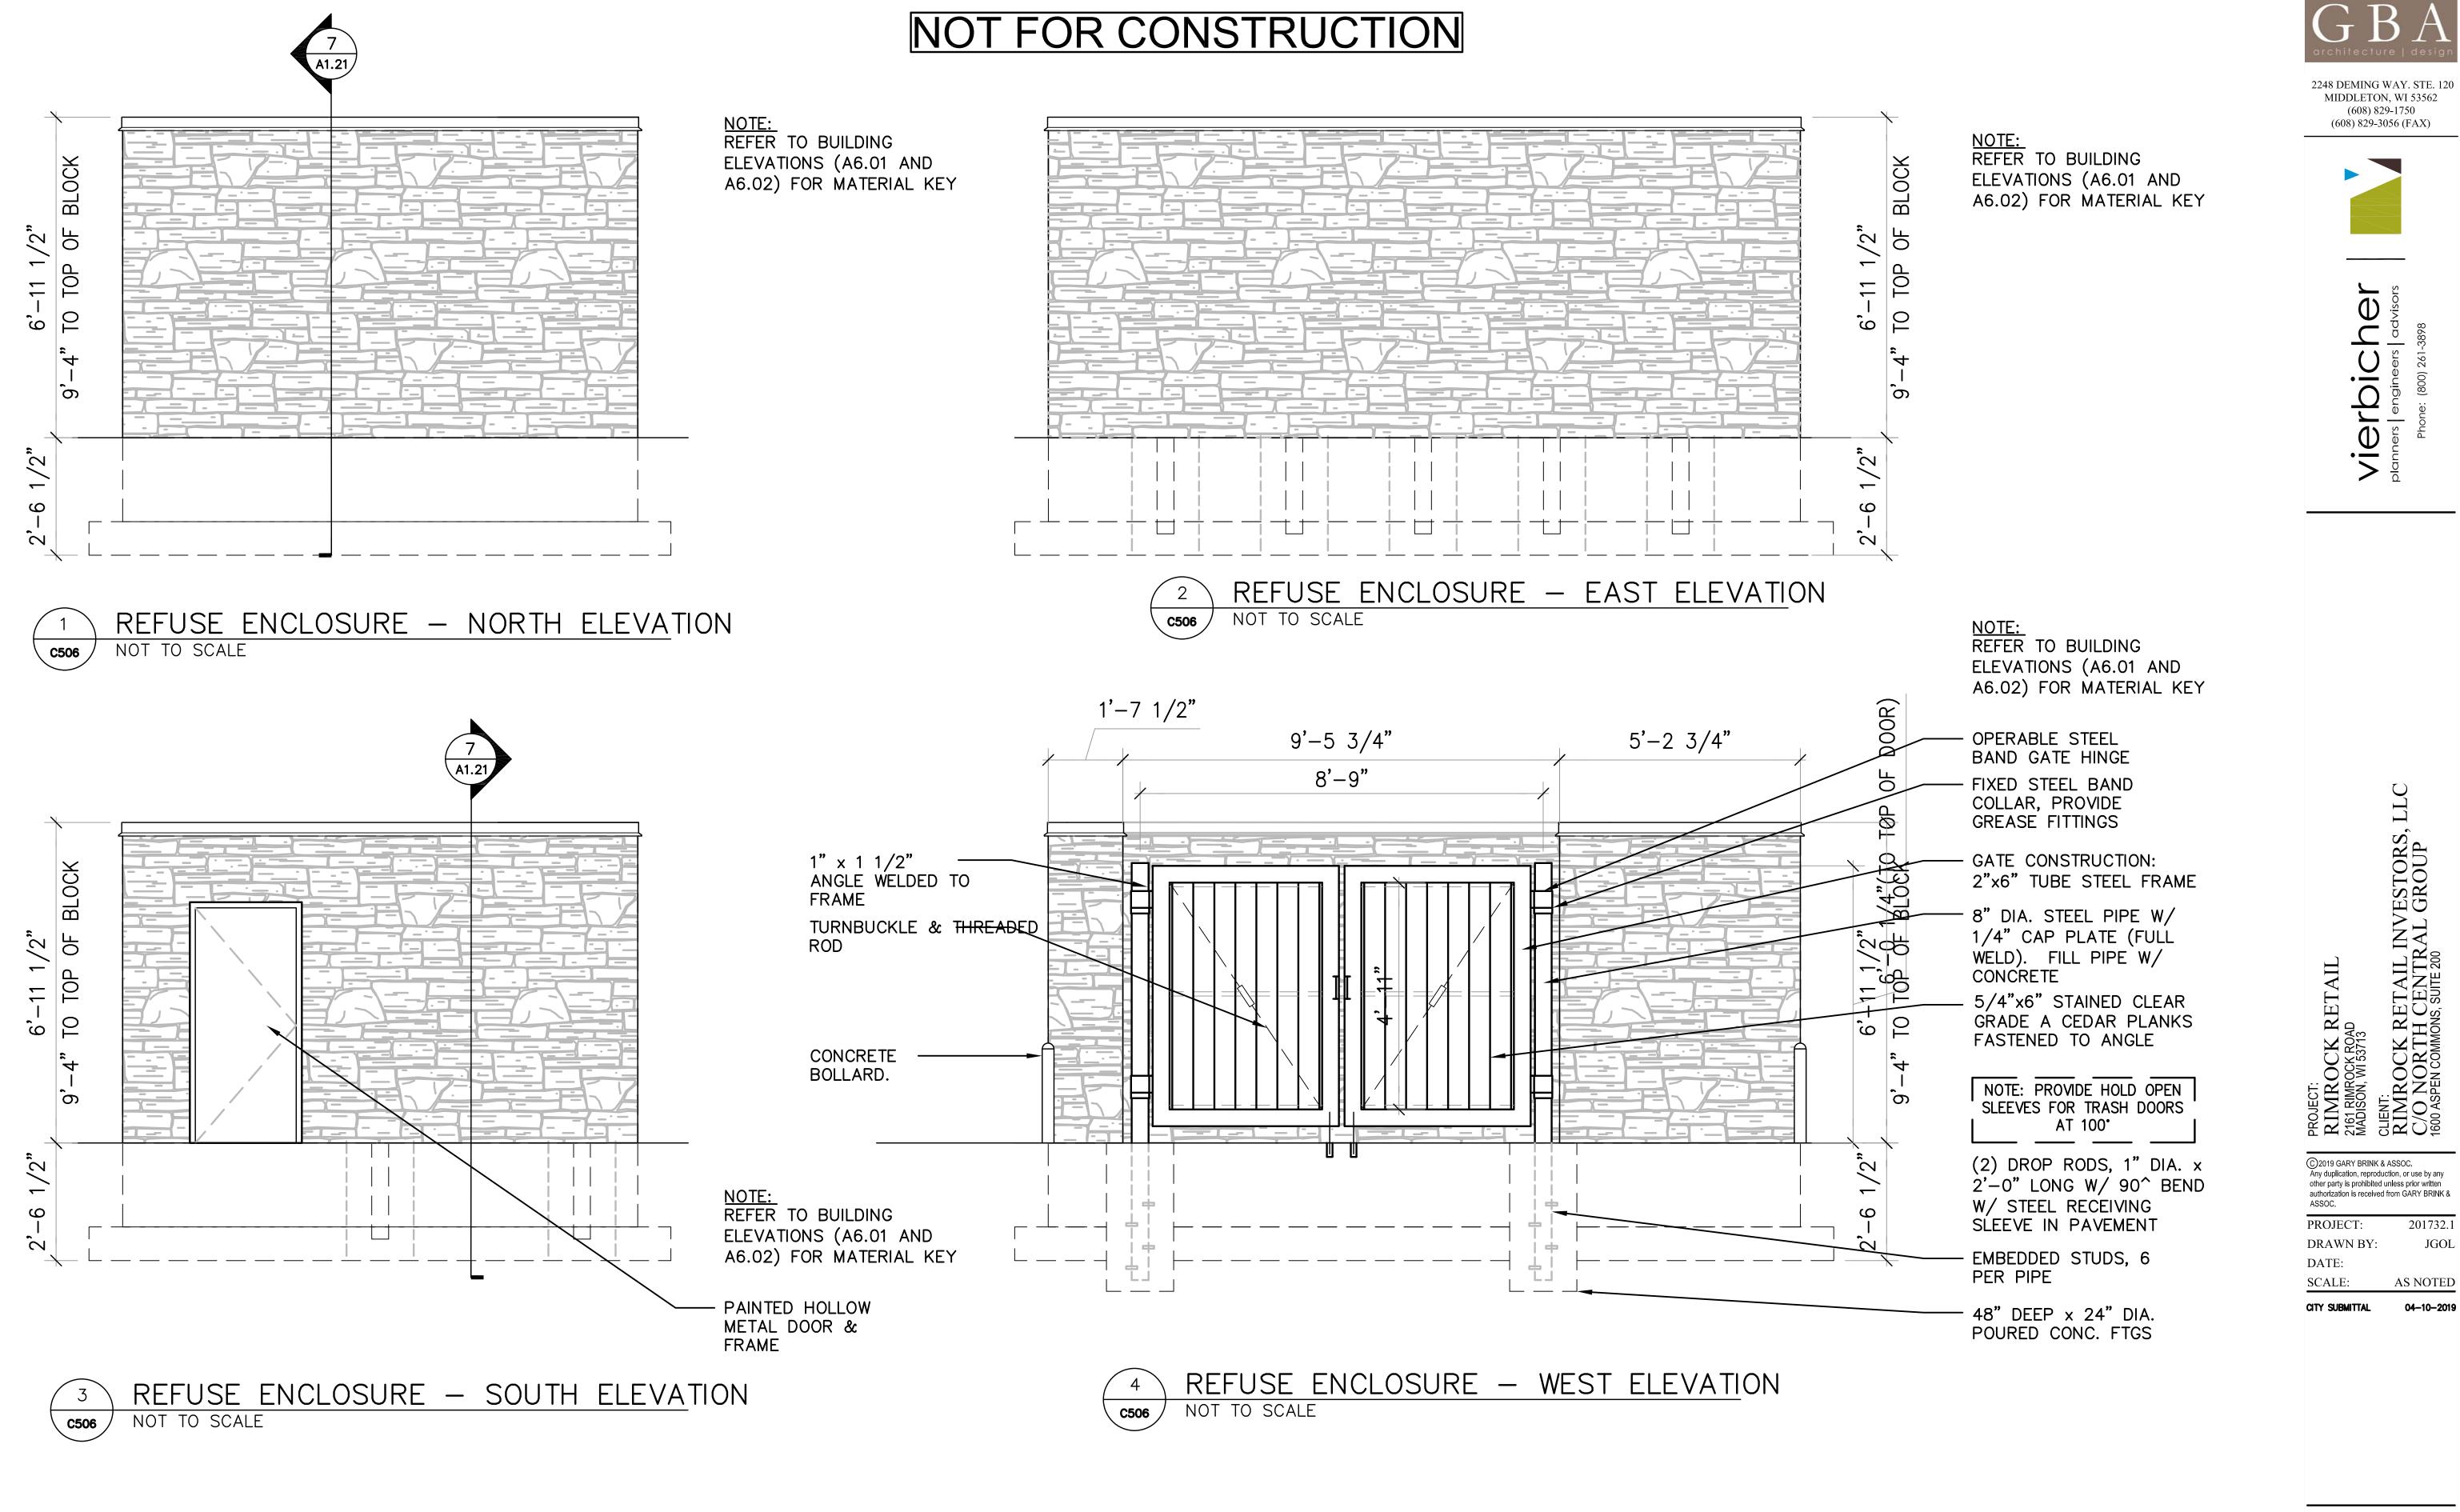
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PROJECT: 201732.1
DRAWN BY: JGOL
DATE:
SCALE: AS NOTED

CITY SUBMITTAL 04-10-

CONSTRUCTION DETAILS

 $\overline{C505}$



2248 DEMING WAY. STE. 120

CONSTRUCTION **DETAILS**

C506

NOT FOR CONSTRUCTION



2248 DEMING WAY. STE. 120 MIDDLETON, WI 53562 (608) 829-1750 (608) 829-3056 (FAX)




Vierbich planners | engineers | c

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DRAWN BY: DATE: AS NOTED



ROOF PLAN - REFUSE/RECYCLING ENCLOSURE NOT TO SCALE C507

5/A1.21

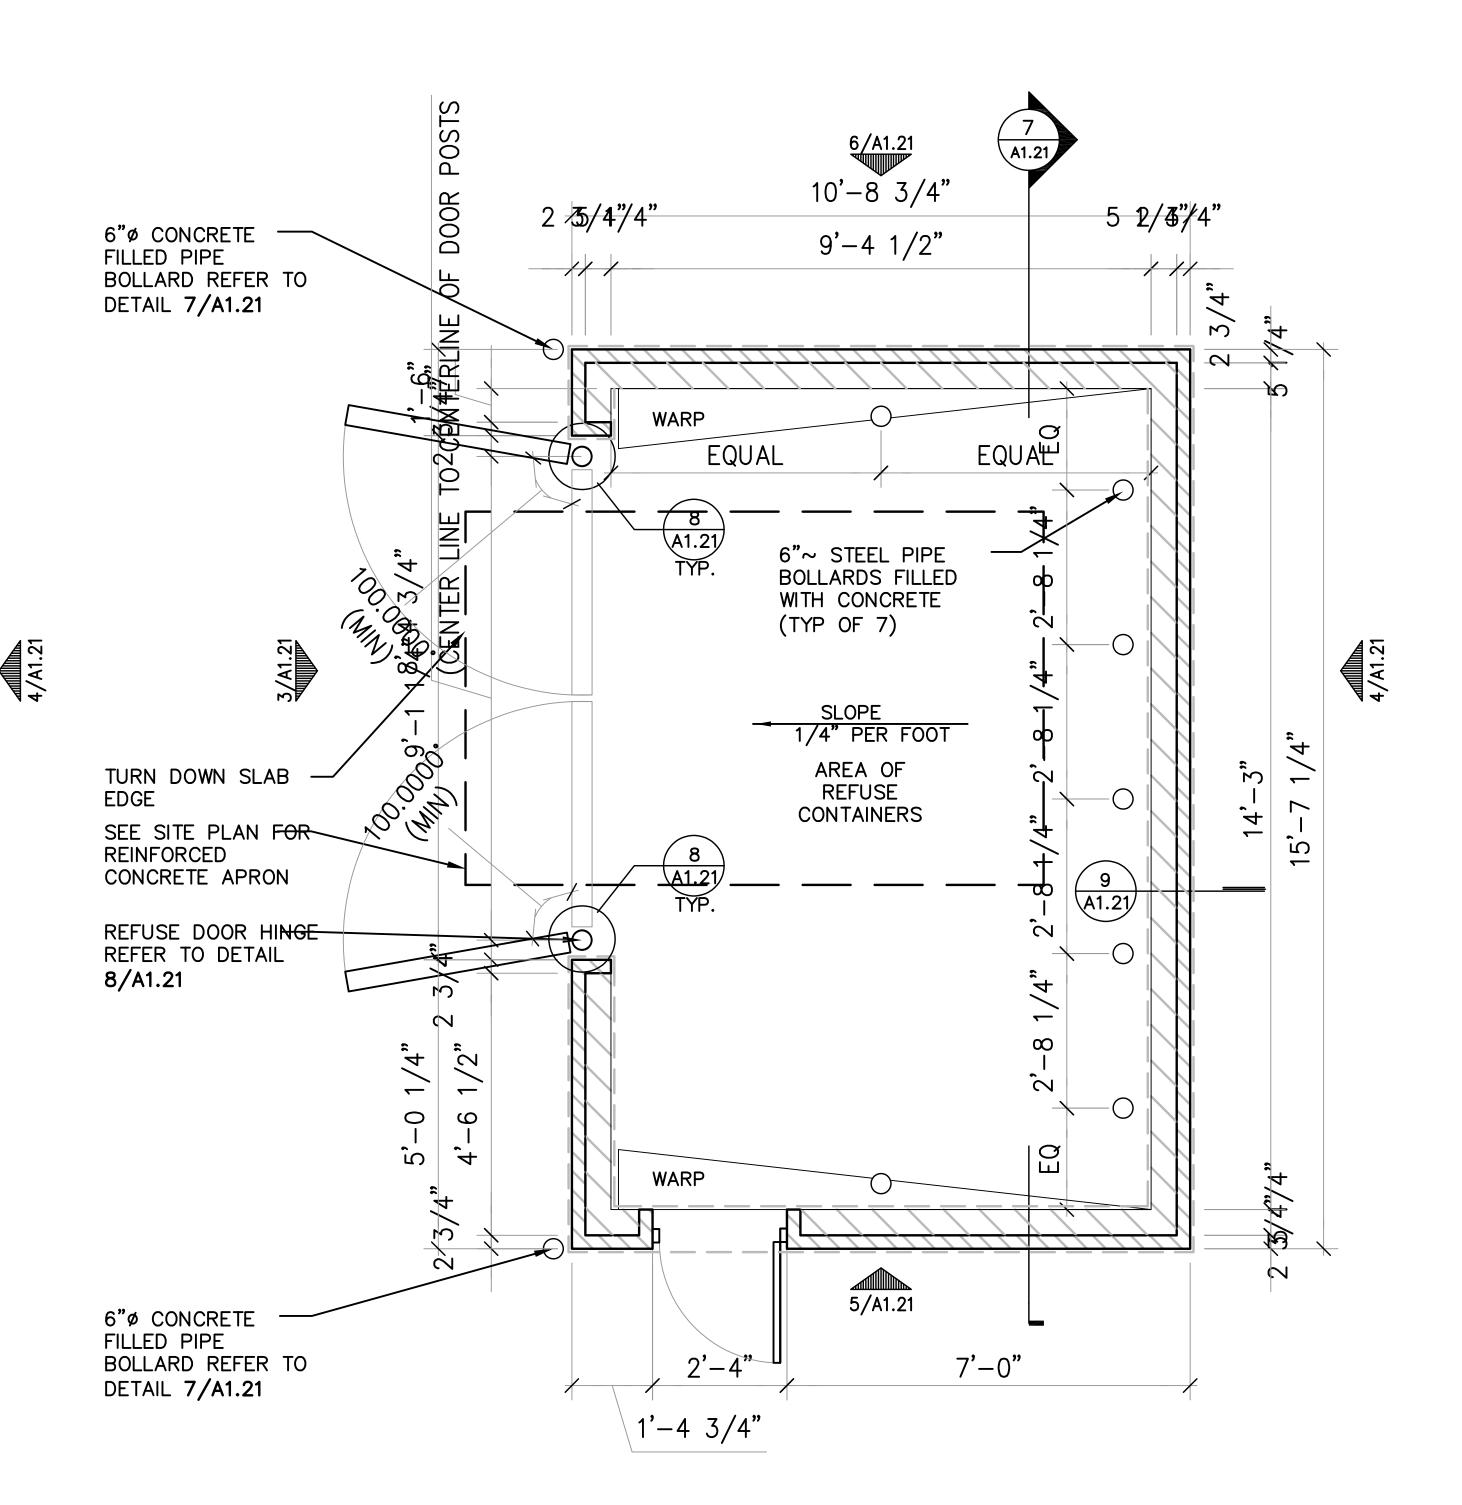10'-10 1/4"

10'-10 1/4"

9'-3"

9 1/2"

3/4"

5,-8

ENLARGED PLAN — REFUSE/RECYCLING ENCLOSURE C507

> CONSTRUCTION DETAILS C507

LANDSCAPE PLAN



2248 DEMING WAY. STE. 120 MIDDLETON, WI 53562 (608) 829-1750 (608) 829-3056 (FAX)



PLANT SCHEDULE LOT 1 BOTANICAL NAME / COMMON NAME

1. All plantings shall conform to quality requirements as per ANSI Z60.1.

growth is established, apply $\frac{1}{2}$ " water twice weekly until final acceptance.

12" of topsoil in all planting areas and 6" of topsoil in areas to be seeded/sodded.

2. All plant material shall be true to the species, variety and size specified, nursery grown in

accordance with good horticultural practices, and under climactic conditions similar to those of

3. Contact Landscape Architect, in writing, to request and plant material substitutions due to

4. All disturbed areas, unless otherwise noted, to be seeded with Tuff-Stuff Turf Mix by LaCrosse Seed Company or equivalent, per manufacturer's specified application rates. All seeded areas are to be watered daily to maintain adequate soil moisture for proper germination. After vigorous

5. All plants shall be guaranteed to be in healthy and flourishing condition during the growing season following installation. All plant material shall be guaranteed for one year from the time of

6. Contractor shall provide a suitable amended topsoil blend for all planting areas where soil conditions are unsuitable for plant growth. Topsoil shall conform to quality requirements as per Section 625.2(1) of the Standard Specifications for Highway Construction. Provide a minimum of

7. Landscape beds to be mulched with undyed shredded hardwood bark mulch to 3" depth min. and edged with commercial grade aluminum landscape edging, Permaloc CleanLine $\frac{3}{16}$ " x 4" or

<u>DECIDUOUS TREES</u> AF CEL GT QR	BOTANICAL NAME / COMMON NAME Acer freemanii `Celzam` TM / Celebration Maple Celtis occidentalis / Common Hackberry Gleditsia triacanthos inermis `Skycole` TM / Skyline Thornless Honey Locust Quercus rubra / Red Oak	CONT B & B B & B B & B B & B	<u>CAL</u> 2"Cal 2.5"Cal 2.5"Cal 2.5"Cal	<u>SIZE</u>	
FLOWERING TREES AC CA CRA	BOTANICAL NAME / COMMON NAME Amelanchier Canadensis/Shadblow Serviceberry Cornus alternifolia / Pagoda Dogwood Crataegus crus-galli `Inermis` / Thornless Hawthorn	CONT B & B B & B B & B	<u>CAL</u> 1.5"Cal	SIZE 6`ht. 6`ht. multi stem	
ANNUALS/PERENNIALS hsd hb ss sh	BOTANICAL NAME / COMMON NAME Hemerocallis x `Stella de Oro` / Stella de Oro Daylily Hosta x `Blue Cadet` / Plantain Lily Schizachyrium scoparium / Little Bluestem Grass Sporobolus heterolepis / Prairie Dropseed	<u>SIZE</u> 4" pot 1 gal 1 gal 1 gal	FIELD2 Cont Cont	FIELD3	
DECIDUOUS SHRUBS DI Hp Ra Sb Sy Vd	BOTANICAL NAME / COMMON NAME Diervilla lonicera / Dwarf Bush Honeysuckle Hydrangea paniculata `Limelight` TM / Limelight Hydrangea Rhus aromatica `Gro-Low` / Gro-Low Fragrant Sumac Spiraea x bumalda `Anthony Waterer` / Anthony Waterer Spiraea Syringa vulgaris / Common Lilac Viburnum dentatum / Viburnum	<u>SIZE</u> 3 gal 5 gal 3 gal 3 gal 7 gal 5 gal	FIELD2 Cont Cont Cont Cont Cont Cont Cont	FIELD3	
EVERGREEN SHRUBS BG JcM JcP Jh TxE	BOTANICAL NAME / COMMON NAME Buxus x `Green Gem` / Green Gem Boxwood 2` x 2` Juniperus chinensis `Mountbatten` / Chinese Juniper Juniperus chinensis `Pfitzerana Kallays Compacta` / Kally Pfitzer Compact Juniper Juniperus horizontalis `Blue Chip` / Blue Chip Juniper Taxus x media `Everlow` / Yew	<u>SIZE</u> 3 gal 10 gal 5 gal 3 gal 3 gal	Cont Cont Cont Cont	FIELD3	
GROUND COVERS vmb	BOTANICAL NAME / COMMON NAME Vinca minor `Bowles` / Bowles` Common Periwinkle	<u>CONT</u> flat	FIELD2 2" pot	FIELD3	SPACING 18" o.c.

STORMWATER SEEDING LOT 1



GENERAL NOTES:

the project site.

equal, color black anodized.

BASIC PRAIRIE SEED MIX 2,506 sf


RIMROCK RETAIL INVESTOR C/O NORTH CENTRAL GROU 600 ASPEN COMMONS, SUITE 200

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SCALE:	AS NOTE
DATE:	4/8/2019
DRAWN BY:	CHI
PROJECT:	201732.
A0000.	

NOT FOR CONSTRUCTION

LANDSCAPE PLAN L100

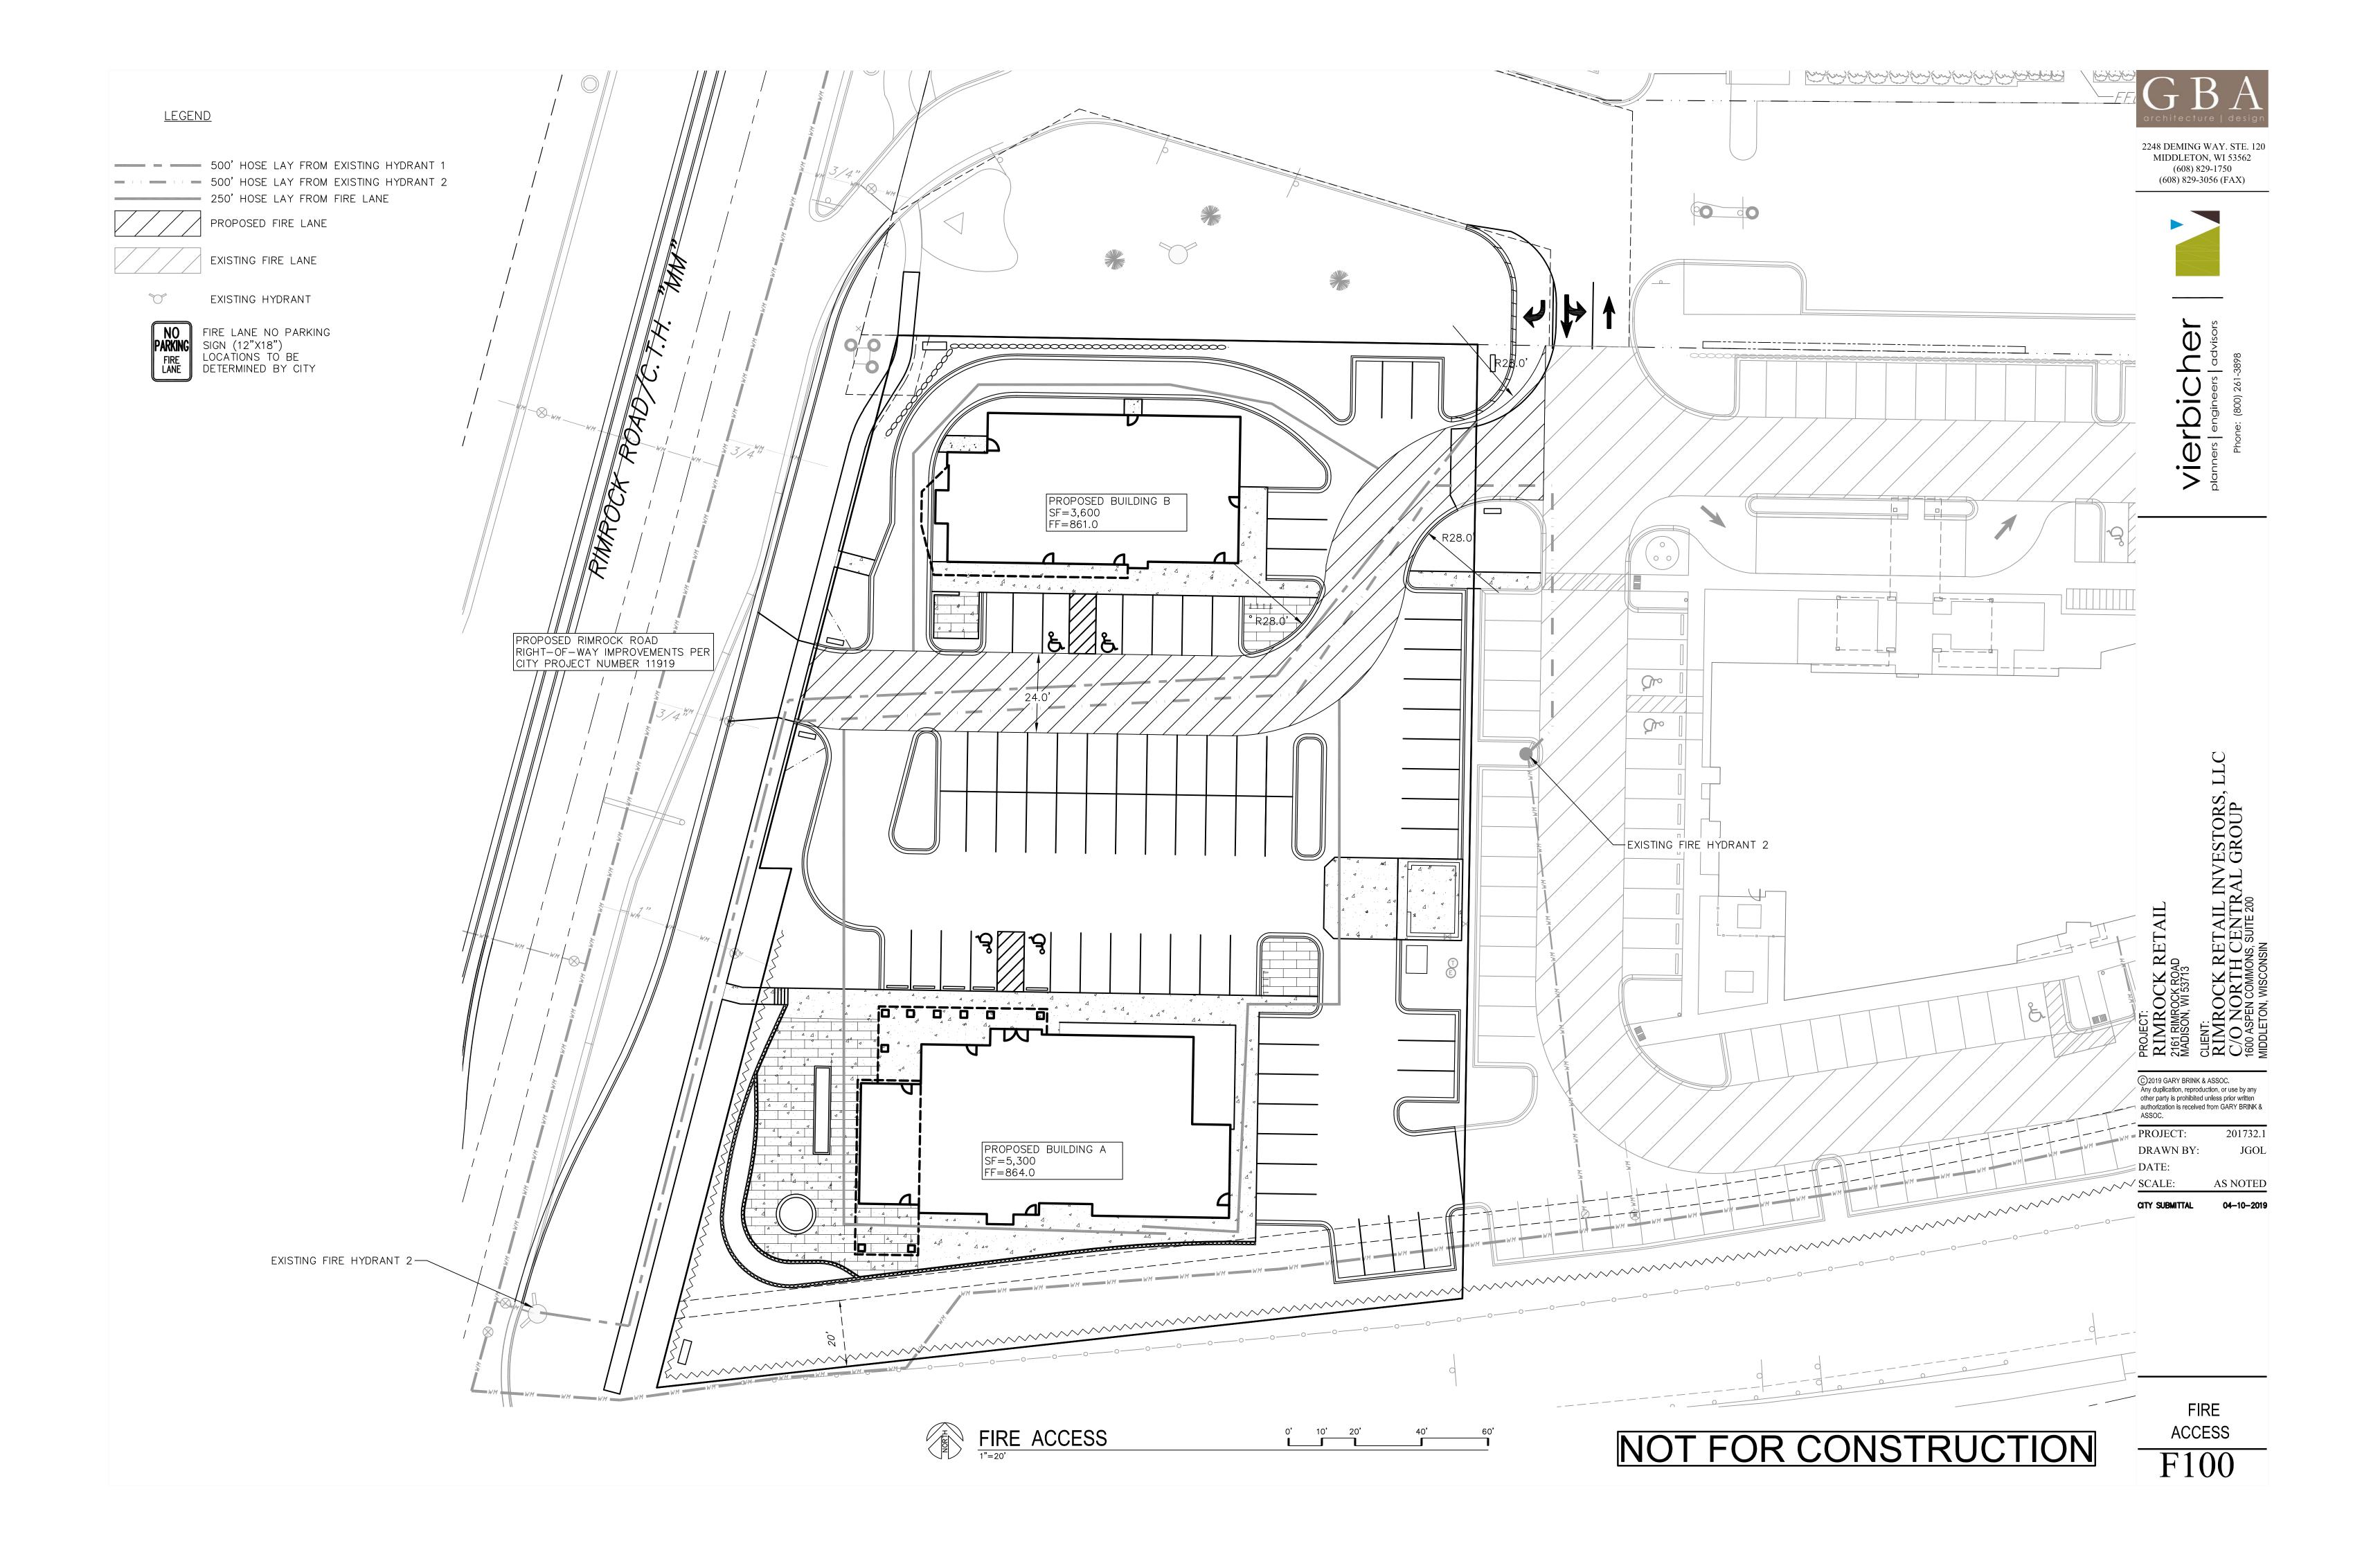

CALCULATION SUMMARY CALCTYPE PARKING LOT - PAVEMENT ILLUMINANCE

1.1 1.4 1.6 1.7 1.5 1.3 1.1 1.0 1.0 1.0 1.0 1.0 1.2 1.3 1.4 1.6 1.9 1.9 1.7

1.1 1.3 1.5 1.4 1.3 1.1 1.1 1.2 1.1 1.1 1.2 1.4 1.5 1.6 1.7 1.7 1.6

1.0 1.0 1.1 1.1 1.1 1.1 1.0 1.2 1.5 1.4 1.4 1.3 1.3 1.4 1.4 1.3 1.2 1.1 1.1

to 5.9 to 5.9 to 5.9 to 1.0 to 1.1 to 2.2 to 1.5 to 1.4 to 1.3 to 1.1 to 1.0 to 1.9 to 1.1 t

0.5 0.7 0.9 1.0 1.2 1.3 1.5 1.3 1.3 2.0 1.9 1.6 1.2 1.0 0.7 0.5 0.2 0.1 0.1

0.4 0.6 0.8 0.9 1.2 1.3 1.4 2.0 2.0 1.9 1.6 1.2 1.0 0.7 0.5 0.2 0.1 0.1

0.4 0.6 0.8 0.9 1.2 1.3 1.6 1.4 12 1.7 1.7 1.7 1.5 1.2 1.0 0.7 0.5 0.2 0.1 0.1

\$\dots \dots \dots

0.2 0.2 0.2

/b.o b.o b.o /b/0///b.o ***b.o b.o/ b.o/ b.o/ b.1 *** b/1 //b/3 b.5 b/7 b/8 1.0///1.1 1.d

| b.0 | b.0 | b.0 | b.0 | b.0 | b.0 | b.1 | b.1 | b.1 | b.3 | b.4 | b.6 | b.7 | b.8 | b.9 |

5.0 5.0 5.0 b.0 b.0 5.0 5.0 5.0 5.1 5.1 / 5.2 6.4 / 5.5 / 5.5 / 5.6 b.7 5.8

♥ b.o b.o b.o /b.o//b.o b.o b.o/ b.1 b.1 b/2 /b/3/ b.4 b.5 /b.9 b.9/ b.7 b.7 b.7

/b.o b.o b.o b.ø;/b.o b,o/b.o/b.1 ≥b.1 b.2 b/3///b.4/b.5/b/6 b.6 //b.7 b.8

 UNITS
 MIN
 AVG
 AVG/MIN

 FC
 0.3
 1.14
 3.80

SUGGESTED CONTROL SEQUENCE: POLE, BOLLARD AND BUILDING MOUNTED

LUMINAIRES AUTOMATICALLY ON AT SUNSET. POLE, BOLLARD AND BUILDING MOUNTED LUMINAIRES AUTOMATICALLY OFF AT SUNRISE

2248 DEMING WAY. STE. 120 MIDDLETON, WI 53562

> (608) 829-1750 (608) 829-3056 (FAX)

POLE TYPE DISTRIBUTION KEY: 25'-0" TALL POLE WITH LED LUMINAIRE; IES TYPE 4 DISTRIBUTION, DUAL HEAD 25'-0" TALL POLE WITH LED LUMINAIRE; IES TYPE 3 DISTRIBUTION 25'-0" TALL POLE WITH LED LUMINAIRE; IES TYPE 4

DISTRIBUTION

BOLLARD LED LUMINAIRE; IES TYPE 5 DISTRIBUTION

EXISTING HOTEL LIGHTING INCLUDED IN ILLUMINANCE STUDY. PROJECT:
RIMROCK RETAIL
2161 RIMROCK ROAD
MADISON, WI 53713
CLIENT:
RIMROCK RETAIL INVESTORS, I
RIMROCK RETAIL INVESTORS, I
C/O NORTH CENTRAL GROUP
1600 ASPEN COMMONS, SUITE 200
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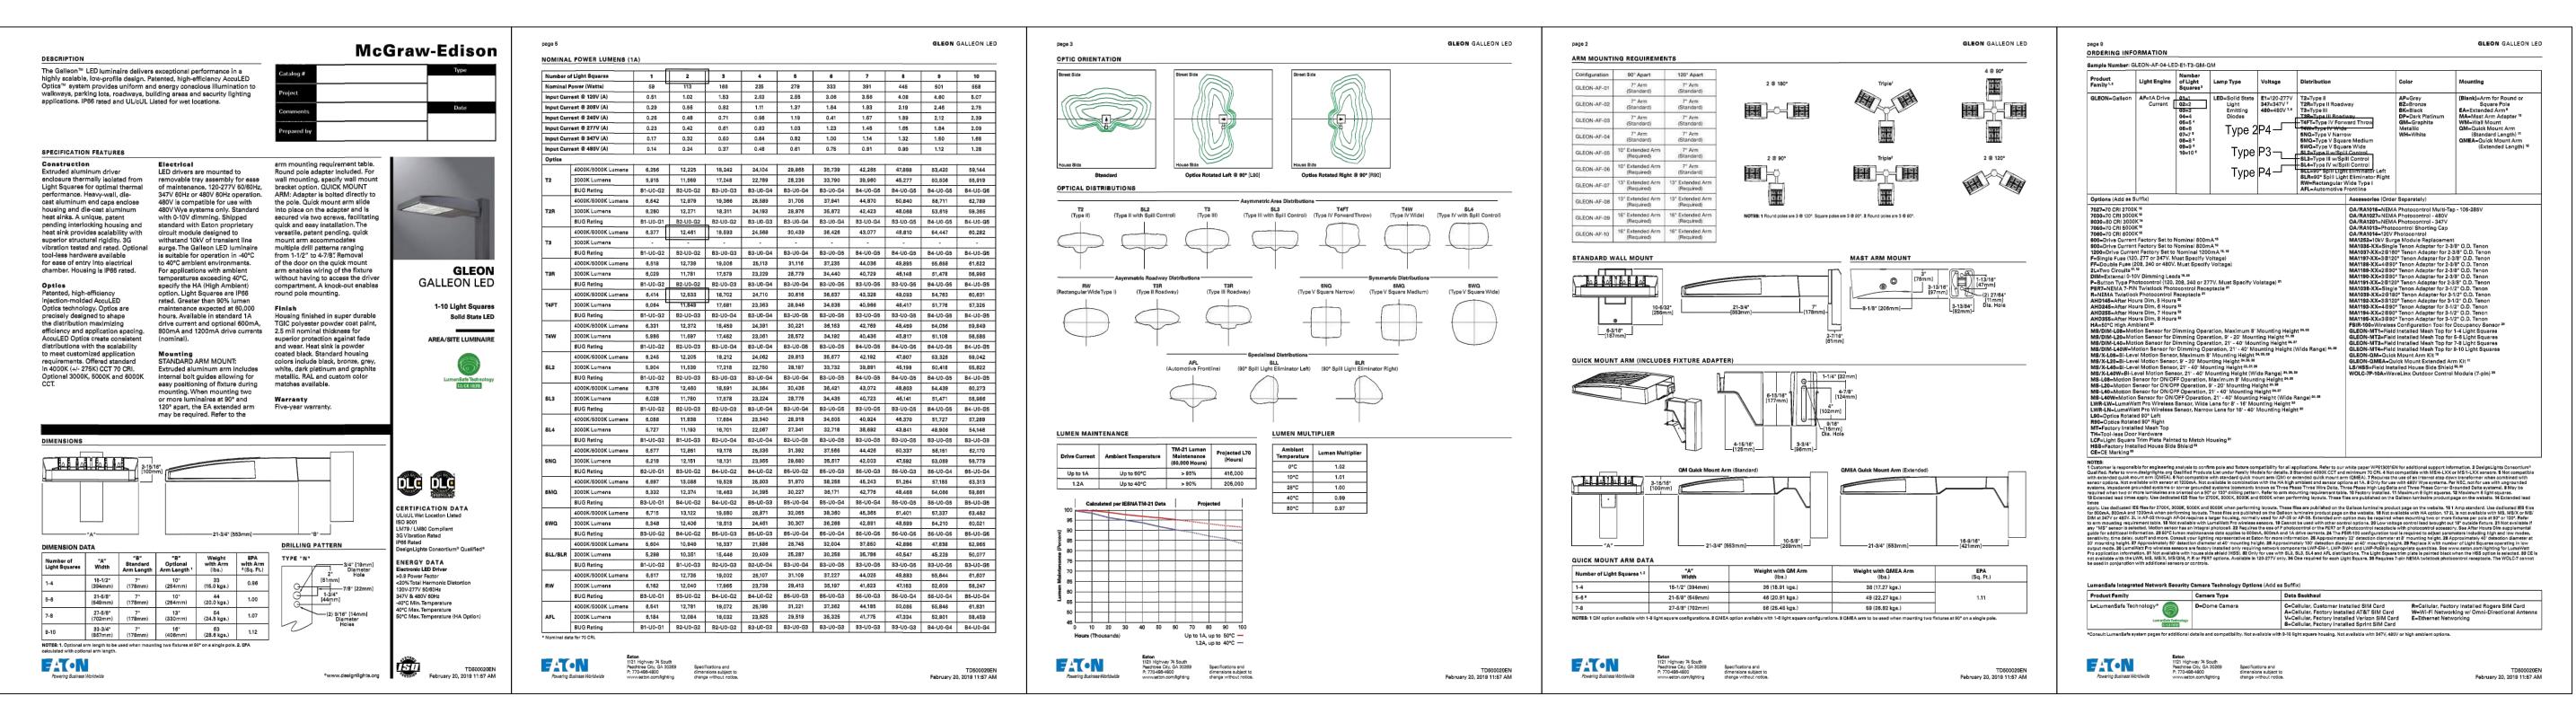
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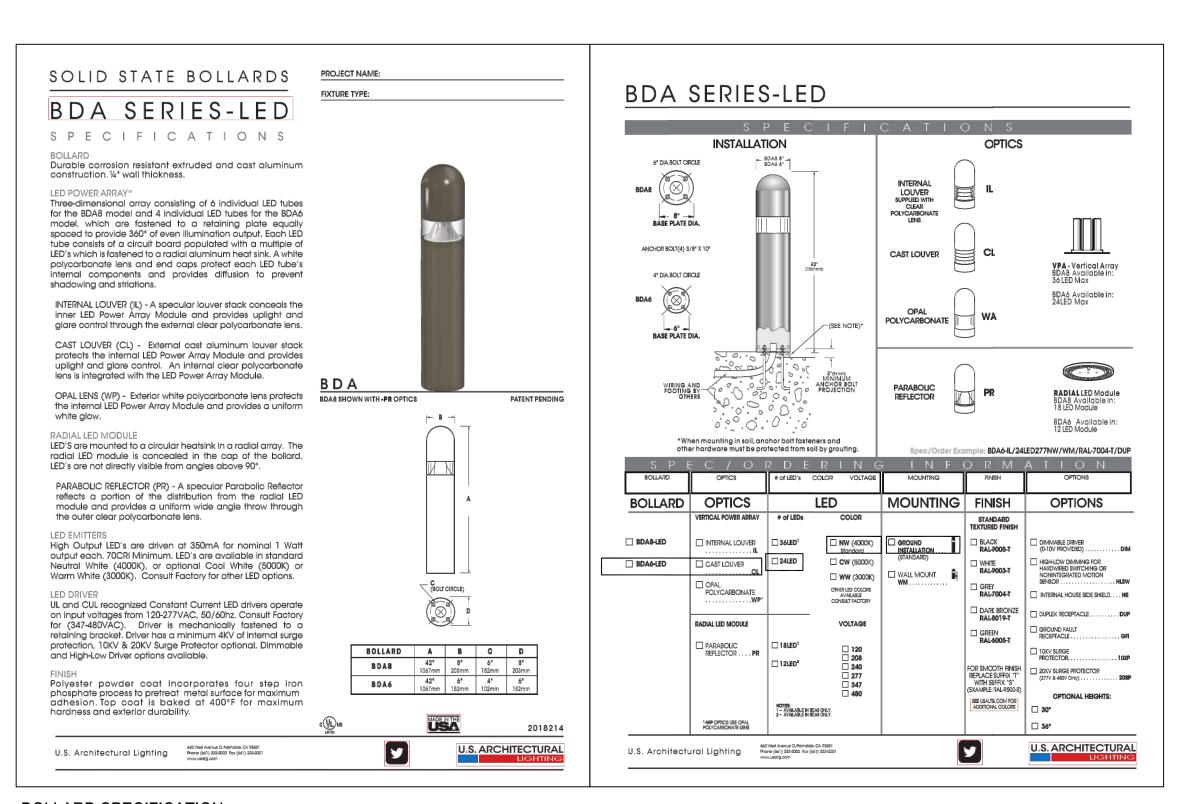
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SITE LIGHTING PLAN

SITE LIGHTING PLAN E101



AREA LIGHTING SPECIFICATION



BOLLARD SPECIFICATION



2248 DEMING WAY, STE, 120

MIDDLETON, WI 53562

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0' 4' 8' 16' 24'



PROJECT:
RIMROCK RETAIL
2161 RIMROCK ROAD
MADISON, WI 53713
CLIENT:
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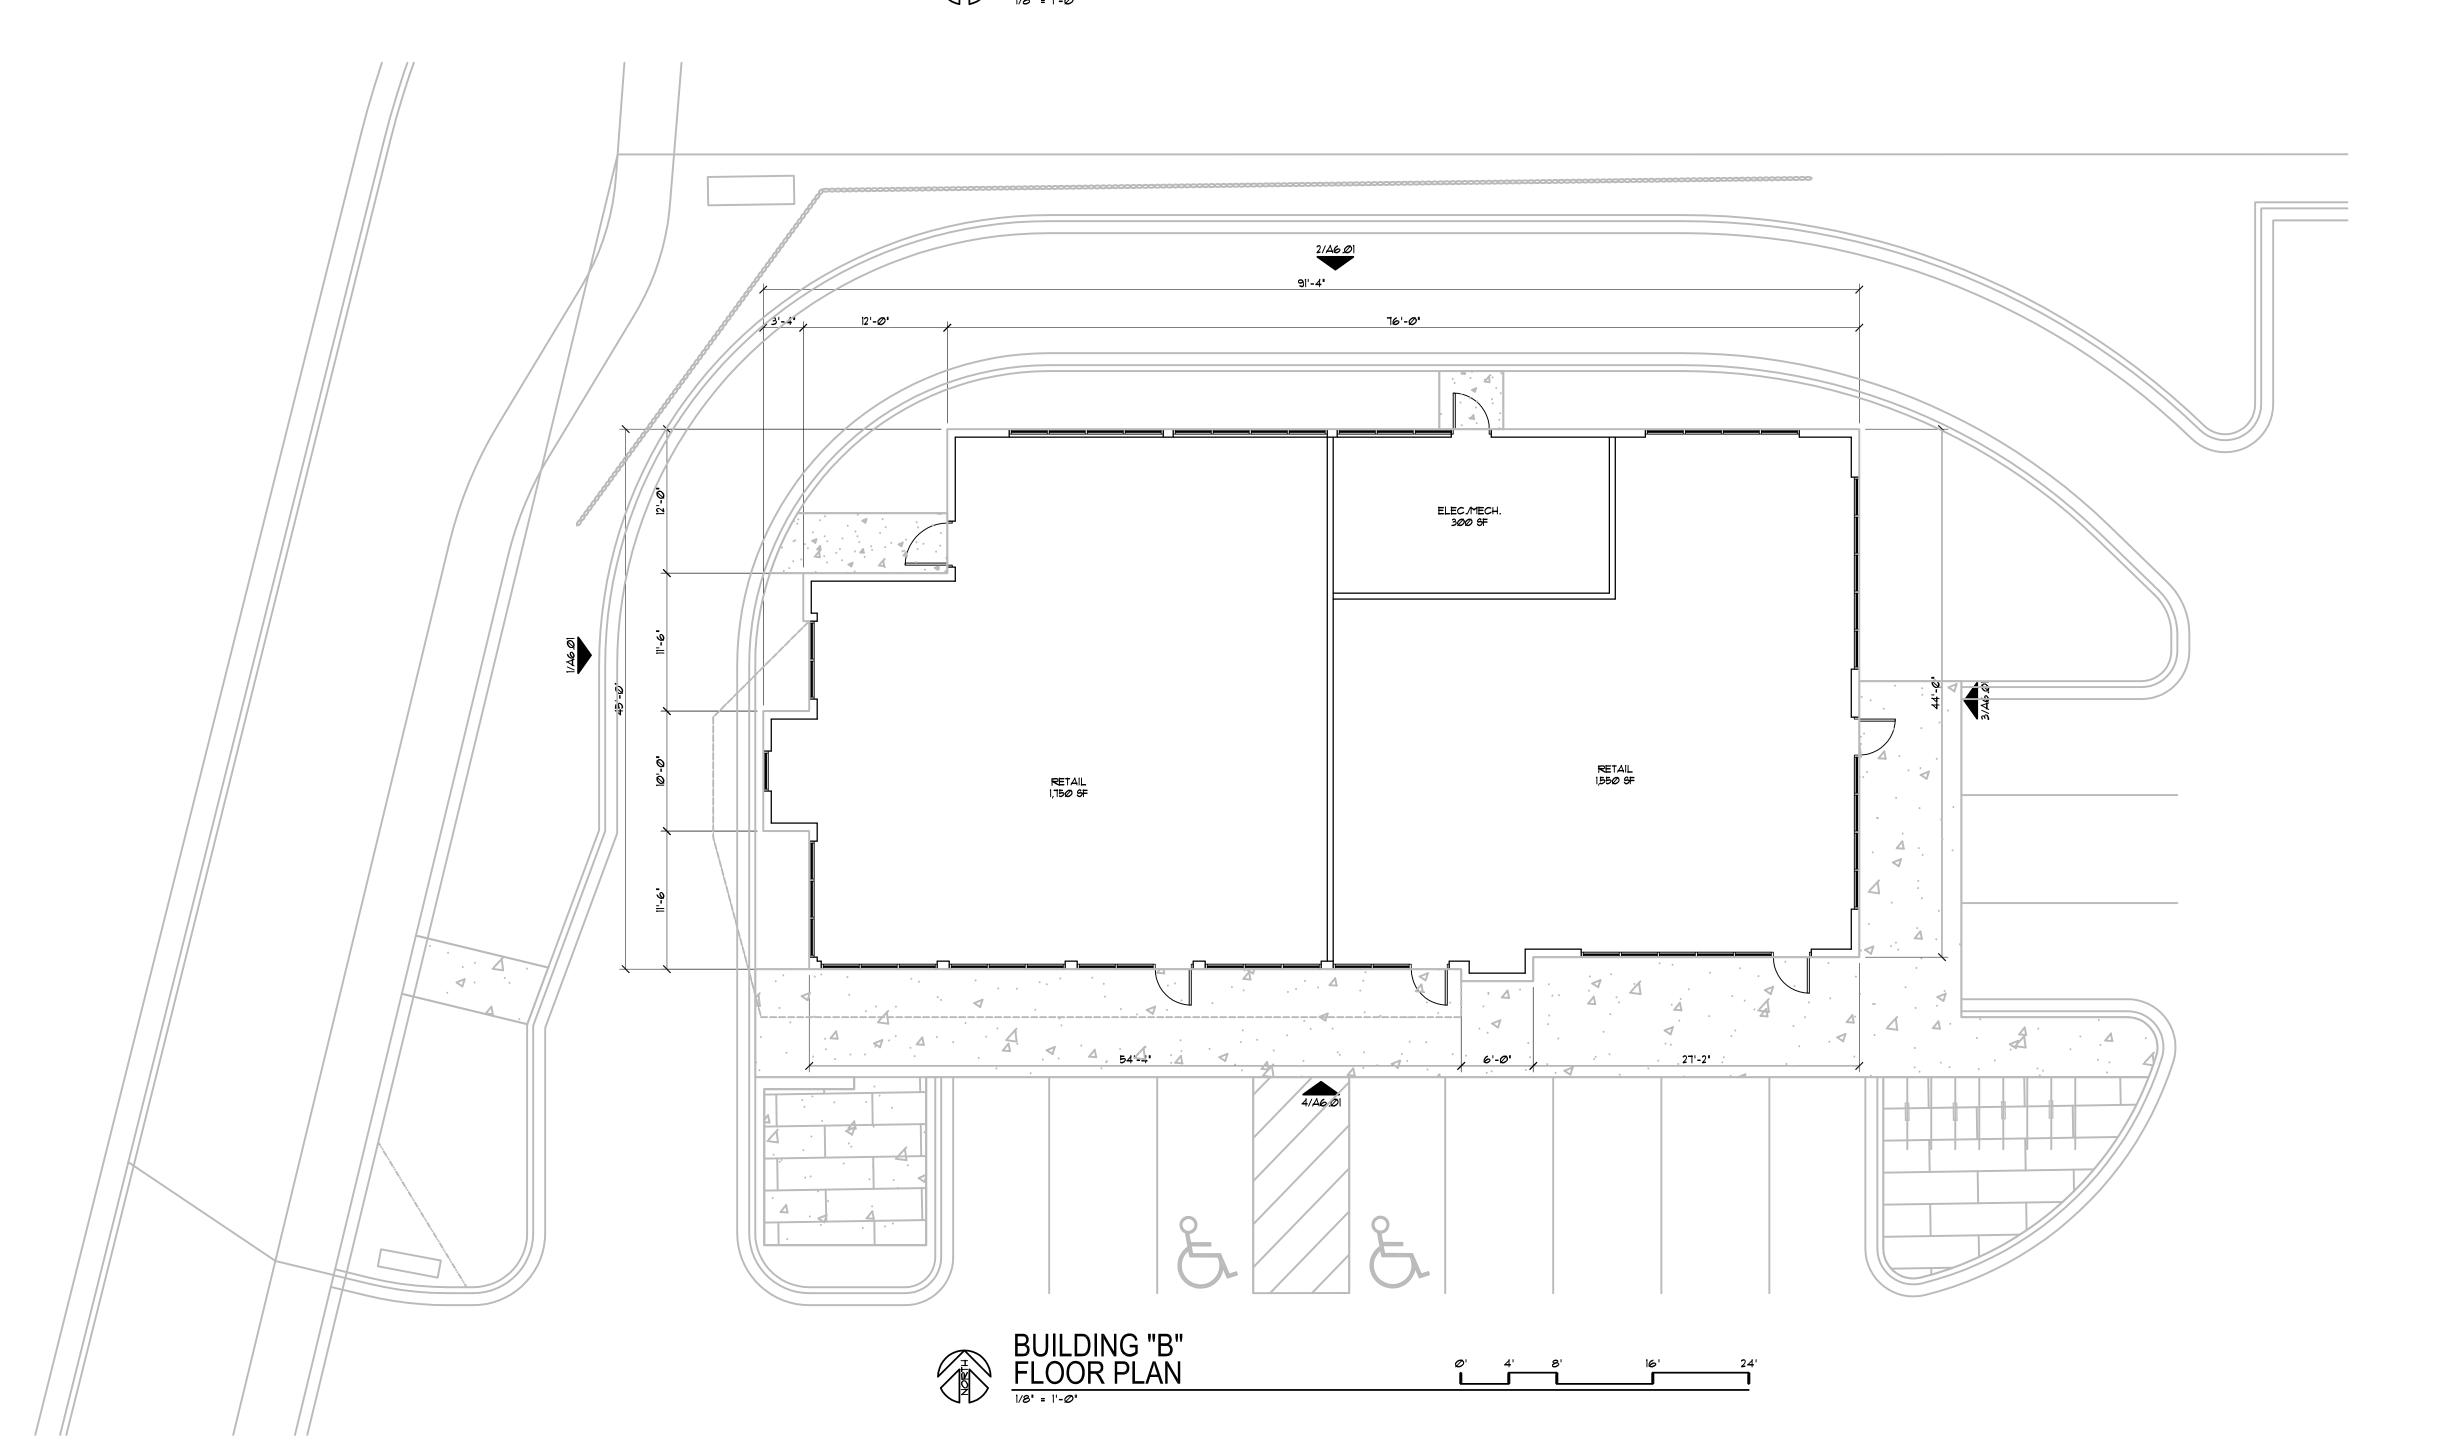
*0*4-10-2019

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BUILDING "A" FLOOR PLAN & ROOF PLAN

A2.01a





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MADISON, WI 53713
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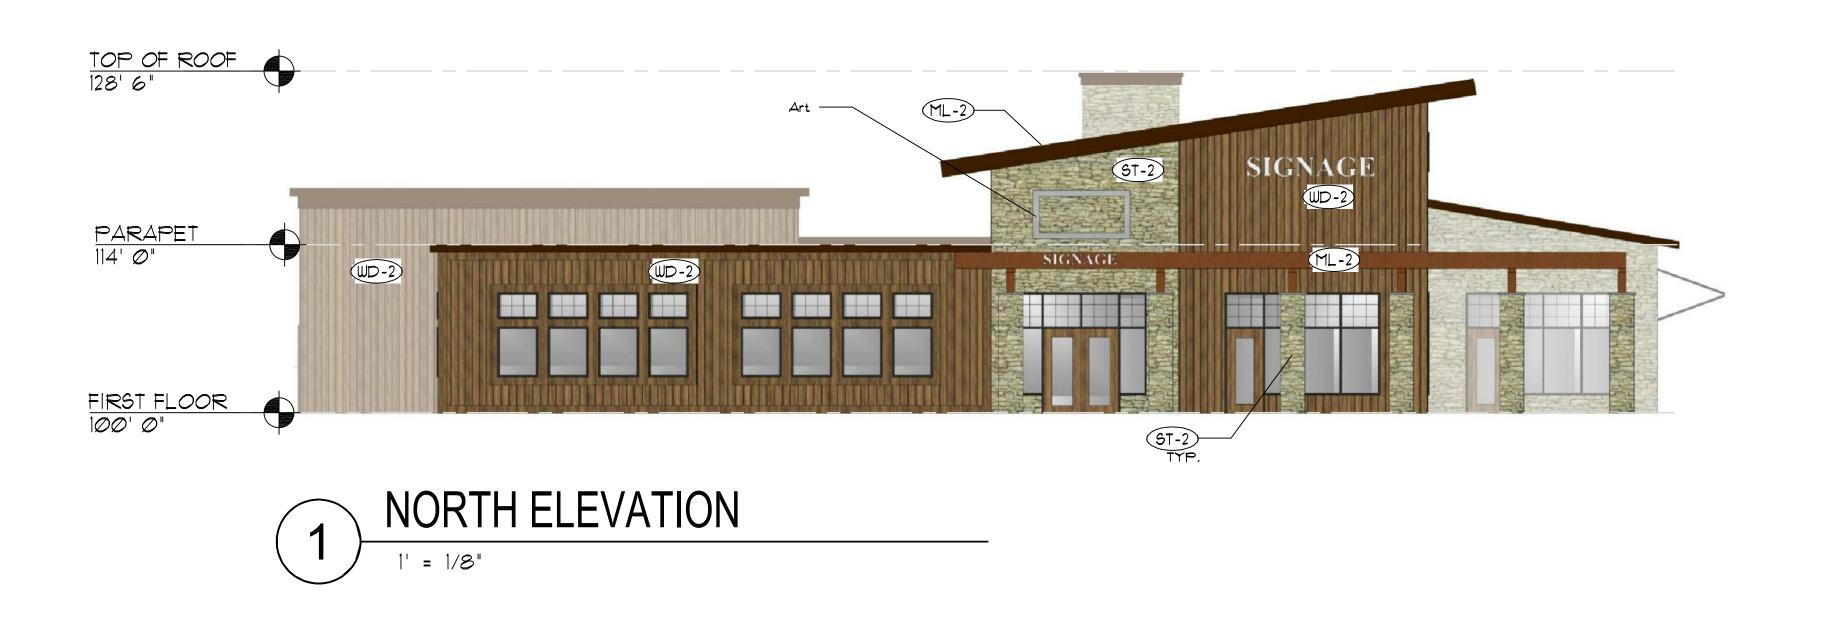
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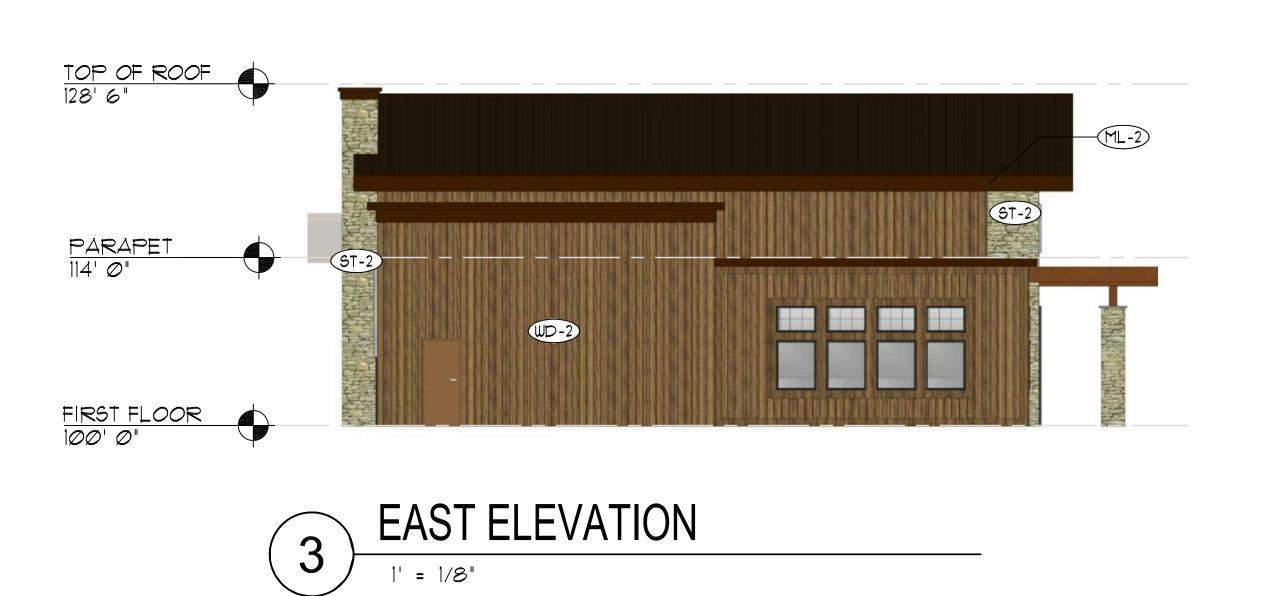
BUILDING "B"
FLOOR PLAN &
ROOF PLAN

A2.01b












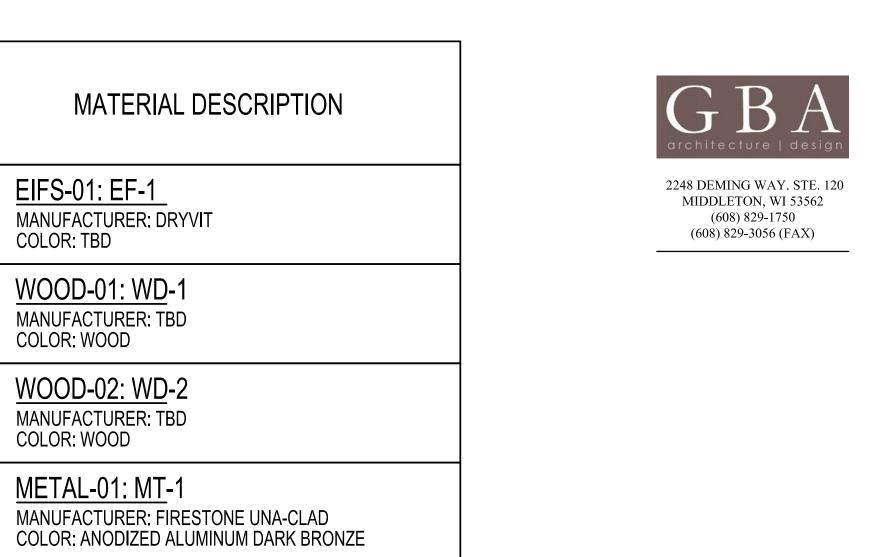

EIFS-01: EF-1

WOOD-01: WD-1

MANUFACTURER: TBD

MANUFACTURER: TBD

METAL-01: MT-1

METAL-01: MT-2

STONE-01: ST-1

STONE-02: ST-2

CLEAR GLASS W\
DARK BRONZE FRAME

COLOR: TBD

WINDOW:

MANUFACTURER: LIMESTONE

MANUFACTURER: FIRESTONE UNA-CLAD COLOR: WEATHER STEEL

MANUFACTURER: ELDERADO STONE COLOR: STORMCLOUD

COLOR: TBD

COLOR: WOOD

COLOR: WOOD

CLIENT:
RIMROCK RETAIL INVESTORS, LLC
C/O NORTH CENTRAL GROUP
1600 ASPEN COMMONS, SUITE 200
MIDDLETON, WI 54562 PROJECT:
RIMROCK RETAIL
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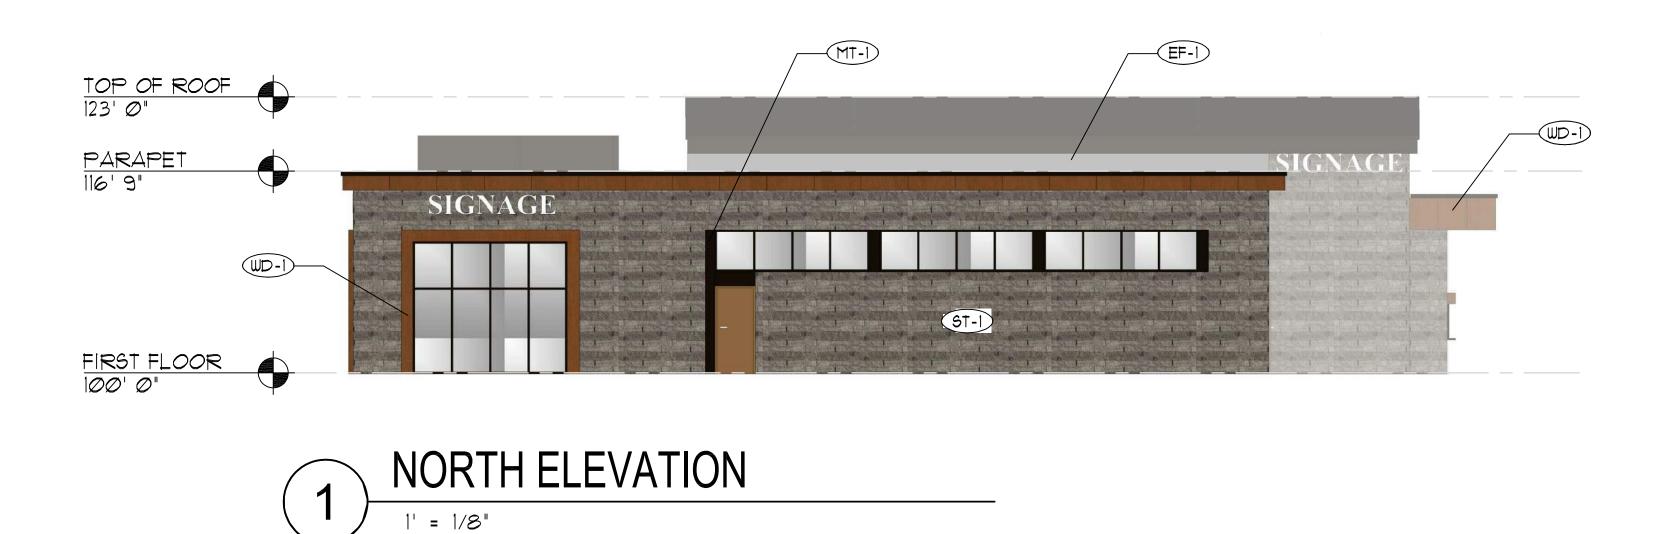
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> **BUILDING A ELEVATIONS**

A6.01






SOUTH ELEVATION 1' = 1/8"









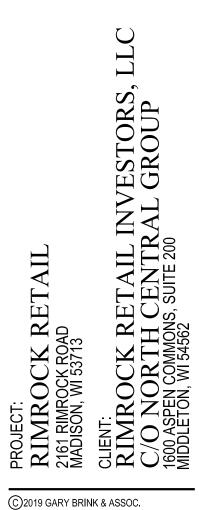

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PROJECT: DRAWN BY:

DATE:

COFFEE

WD-1

SCALE: AS NOTED 04-10-2019 CITY SUBMITTAL



ST-I

TOP OF ROOF 123' Ø"

FIRST FLOOR 100' 0"

<u>PARAPET</u> 116' 9"

BUILDING B ELEVATIONS

A6.02

PLANT SCHEDULE LOT 1

DECIDUOUS TREES AF CEL GT QR	BOTANICAL NAME / COMMON NAME Acer freemanii `Celzam` TM / Celebration Maple Celtis occidentalis / Common Hackberry Gleditsia triacanthos inermis `Skycole` TM / Skyline Thornless Honey Locust Quercus rubra / Red Oak	CONT B & B B & B B & B B & B	<u>CAL</u> 2"Cal 2.5"Cal 2.5"Cal 2.5"Cal	<u>SIZE</u>		QTY 3 4 9 1
FLOWERING TREES AC CA CRA	BOTANICAL NAME / COMMON NAME Amelanchier Canadensis/Shadblow Serviceberry Cornus alternifolia / Pagoda Dogwood Crataegus crus-galli `Inermis` / Thornless Hawthorn	CONT B & B B & B B & B	<u>CAL</u> 1.5"Cal	SIZE 6` ht. 6` ht. multi stem		<u>QTY</u> 4 1 5
ANNUALS/PERENNIALS hsd hb ss sh	BOTANICAL NAME / COMMON NAME Hemerocallis x `Stella de Oro` / Stella de Oro Daylily Hosta x `Blue Cadet` / Plantain Lily Schizachyrium scoparium / Little Bluestem Grass Sporobolus heterolepis / Prairie Dropseed	<u>SIZE</u> 4" pot 1 gal 1 gal 1 gal	FIELD2 Cont Cont	FIELD3		QTY 41 29 12 68
DECIDUOUS SHRUBS DI Hp Ra Sb Sy Vd	BOTANICAL NAME / COMMON NAME Diervilla lonicera / Dwarf Bush Honeysuckle Hydrangea paniculata `Limelight` TM / Limelight Hydrangea Rhus aromatica `Gro-Low` / Gro-Low Fragrant Sumac Spiraea x bumalda `Anthony Waterer` / Anthony Waterer Spiraea Syringa vulgaris / Common Lilac Viburnum dentatum / Viburnum	<u>SIZE</u> 3 gal 5 gal 3 gal 3 gal 7 gal 5 gal	FIELD2 Cont Cont Cont Cont Cont Cont Cont Cont	FIELD3		QTY 19 2 38 14 12 5
EVERGREEN SHRUBS BG	BOTANICAL NAME / COMMON NAME Buxus x `Green Gem` / Green Gem Boxwood	<u>SIZE</u> 3 gal	FIELD2	FIELD3		<u>QTY</u> 13
JcM JcP Jh TxE	2`x 2` Juniperus chinensis `Mountbatten` / Chinese Juniper Juniperus chinensis `Pfitzerana Kallays Compacta` / Kally Pfitzer Compact Juniper Juniperus horizontalis `Blue Chip` / Blue Chip Juniper Taxus x media `Everlow` / Yew	10 gal 5 gal 3 gal 3 gal	Cont Cont Cont Cont			7 18 20 4
GROUND COVERS vmb	BOTANICAL NAME / COMMON NAME Vinca minor `Bowles` / Bowles` Common Periwinkle	<u>CONT</u> flat	FIELD2 2" pot	FIELD3	SPACING 18" o.c.	<u>QTY</u> 430

STORMWATER SEEDING LOT 1



BASIC PRAIRIE SEED MIX 2,506 sf

GENERAL NOTES:

- 1. All plantings shall conform to quality requirements as per ANSI Z60.1.
- **2**. All plant material shall be true to the species, variety and size specified, nursery grown in accordance with good horticultural practices, and under climactic conditions similar to those of the project site.
- **3**. Contact Landscape Architect, in writing, to request and plant material substitutions due to availability issues.
- **4**. All disturbed areas, unless otherwise noted, to be seeded with Tuff-Stuff Turf Mix by LaCrosse Seed Company or equivalent, per manufacturer's specified application rates. All seeded areas are to be watered daily to maintain adequate soil moisture for proper germination. After vigorous growth is established, apply $\frac{1}{2}$ " water twice weekly until final acceptance.
- **5**. All plants shall be guaranteed to be in healthy and flourishing condition during the growing season following installation. All plant material shall be guaranteed for one year from the time of installation.
- **6.** Contractor shall provide a suitable amended topsoil blend for all planting areas where soil conditions are unsuitable for plant growth. Topsoil shall conform to quality requirements as per Section 625.2(1) of the Standard Specifications for Highway Construction. Provide a minimum of 12" of topsoil in all planting areas and 6" of topsoil in areas to be seeded/sodded.
- **7**. Landscape beds to be mulched with undyed shredded hardwood bark mulch to 3" depth min. and edged with commercial grade aluminum landscape edging, Permaloc CleanLine $\frac{3}{16}$ " x 4" or equal, color black anodized.



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Vierbicher Idanners | engineers | advisors

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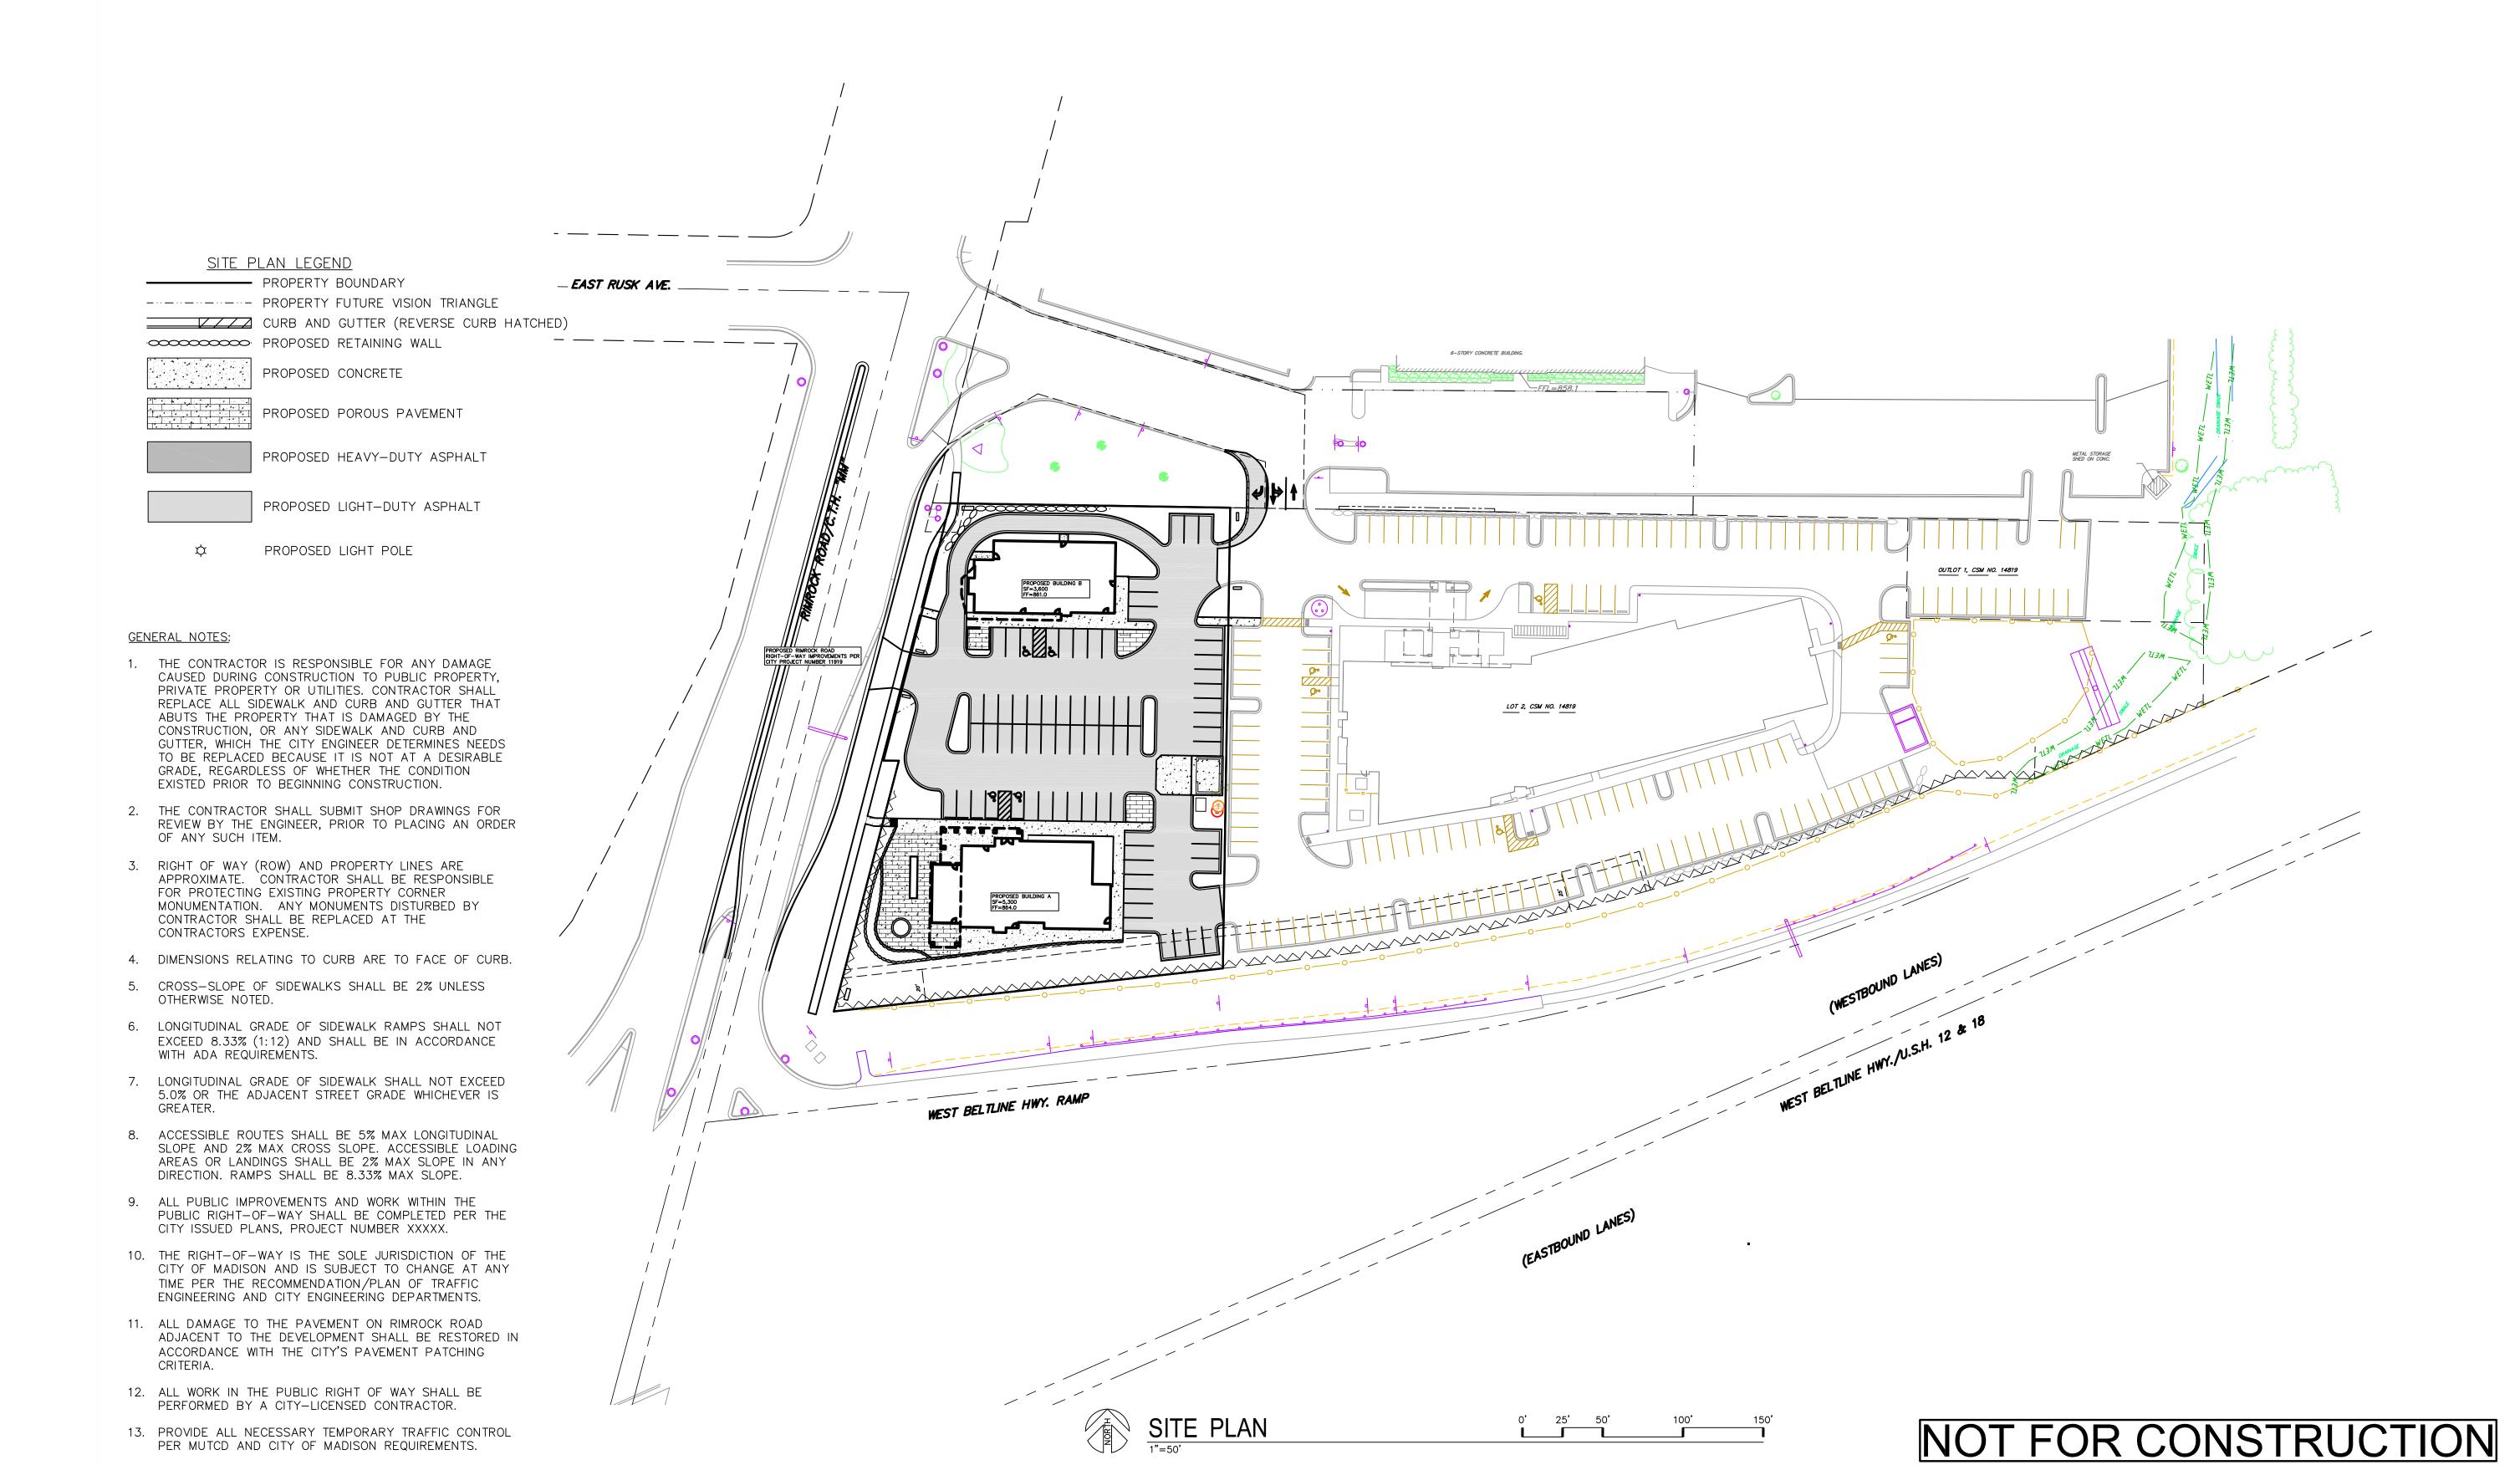
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DRAWN BY: JGOL
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SCALE: AS NOT CITY SUBMITTAL 04–10–

OVERALL SITE PLAN

C200X






VIEW OF BUILDING ON E RUSK AVE



VIEW OF BUILDING ON OPPOSITE CORNER OF RIMROCK AND E RUSK

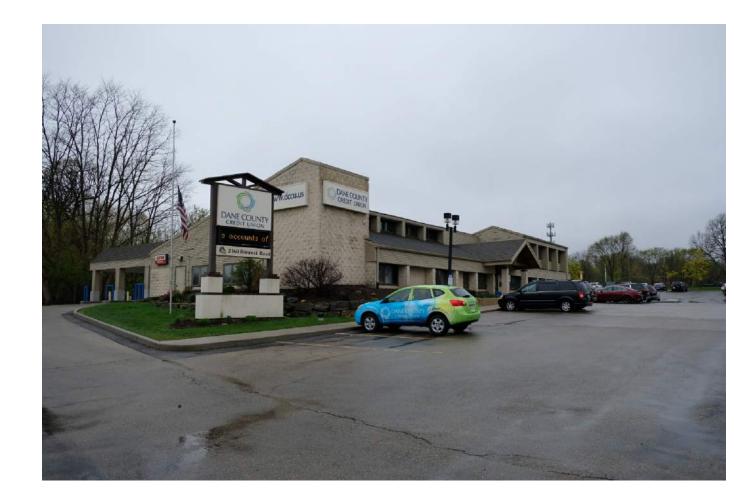

VIEW OF DEVELOPMENT DIRECTLY ACROSS RIMROCK ROAD



NORTHWEST CORNER OF LOT LOOKING NORTHEAST



NORTHWEST CORNER OF LOT LOOKING SOUTHEAST



NORTHEAST CORNER OF LOT LOOKING SOUTHEAST



SOUTHEAST CORNER OF LOT LOOKING NORTHEAST




SOUTHEAST CORNER OF LOT LOOKING NORTHWEST



NORTHEAST CORNER OF LOT LOOKING SOUTHWEST



NORTHWEST CORNER OF LOT LOOKING NORTHWEST

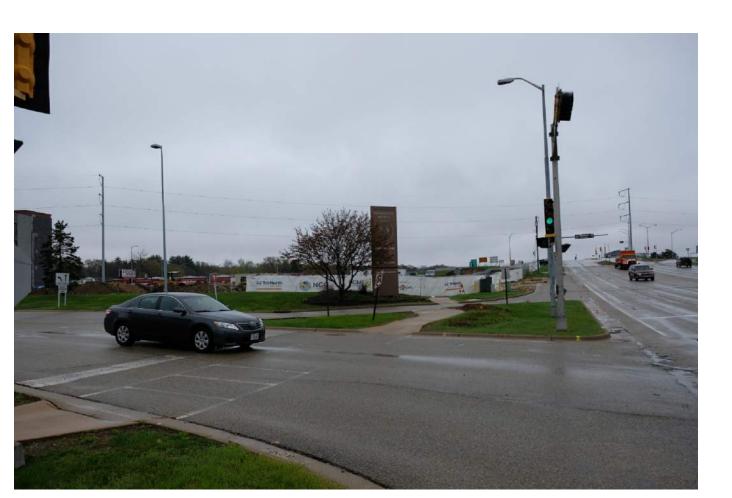

SOUTHEAST VIEW FROM RIMROCK E RUSK INTERSECTION



NORTHEAST VIEW FROM RIMROCK AND W BELTLINE HIGHWAY

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SITE CONTEXT PHOTOS

 $\frac{10000}{EC.01}$