# **UW CAMPUS HOTEL**



760 REGENT STREET | MADISON, WISCONSIN

### CONTENTS


- 01 COVER
- 02 LOCATION PLAN
- 03 SITE CONTEXT PLAN
- 04 SITE & CONTEXT VIEWS
- 05 SITE PLAN
- 06 1ST FLOOR PLAN
- 07 2ND & 3RD-6TH FLOOR PLANS
- 08 ENTRY VIEW
- 09 APPROACH FROM EAST CAMPUS MALL
- 10 APPROACH FROM NORTH EAST
- 11 VIGNETTES
- 12 SOUTH ELEVATION
- 13 NORTH ELEVATION
- 14 WEST & EAST ELEVATIONS
- 15 EXPOSED FASTENER METAL PANEL IMAGES
- 16 PTAC LOUVER IMAGES
- 17 SCREEN IMAGES

### **ATTACHMENTS**

11x17 VERSIONS OF ARCHITECTURAL, LANDSCAPE, CIVIL, AND LIGHTING DETAILED DRAWINGS






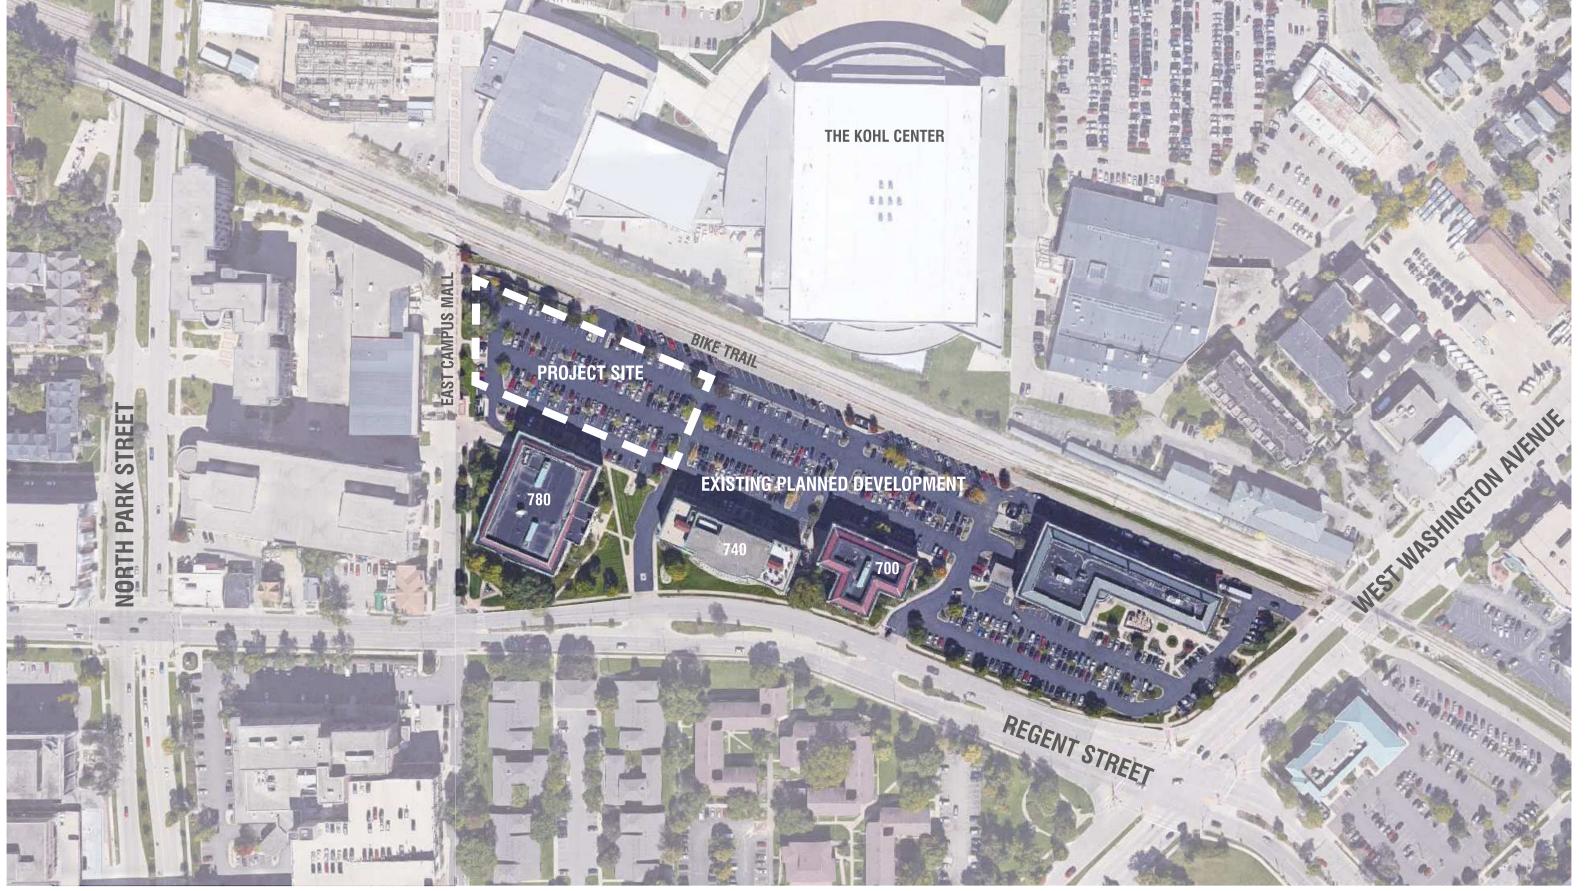

NOT TO SCALE

**LOCATION PLAN** 



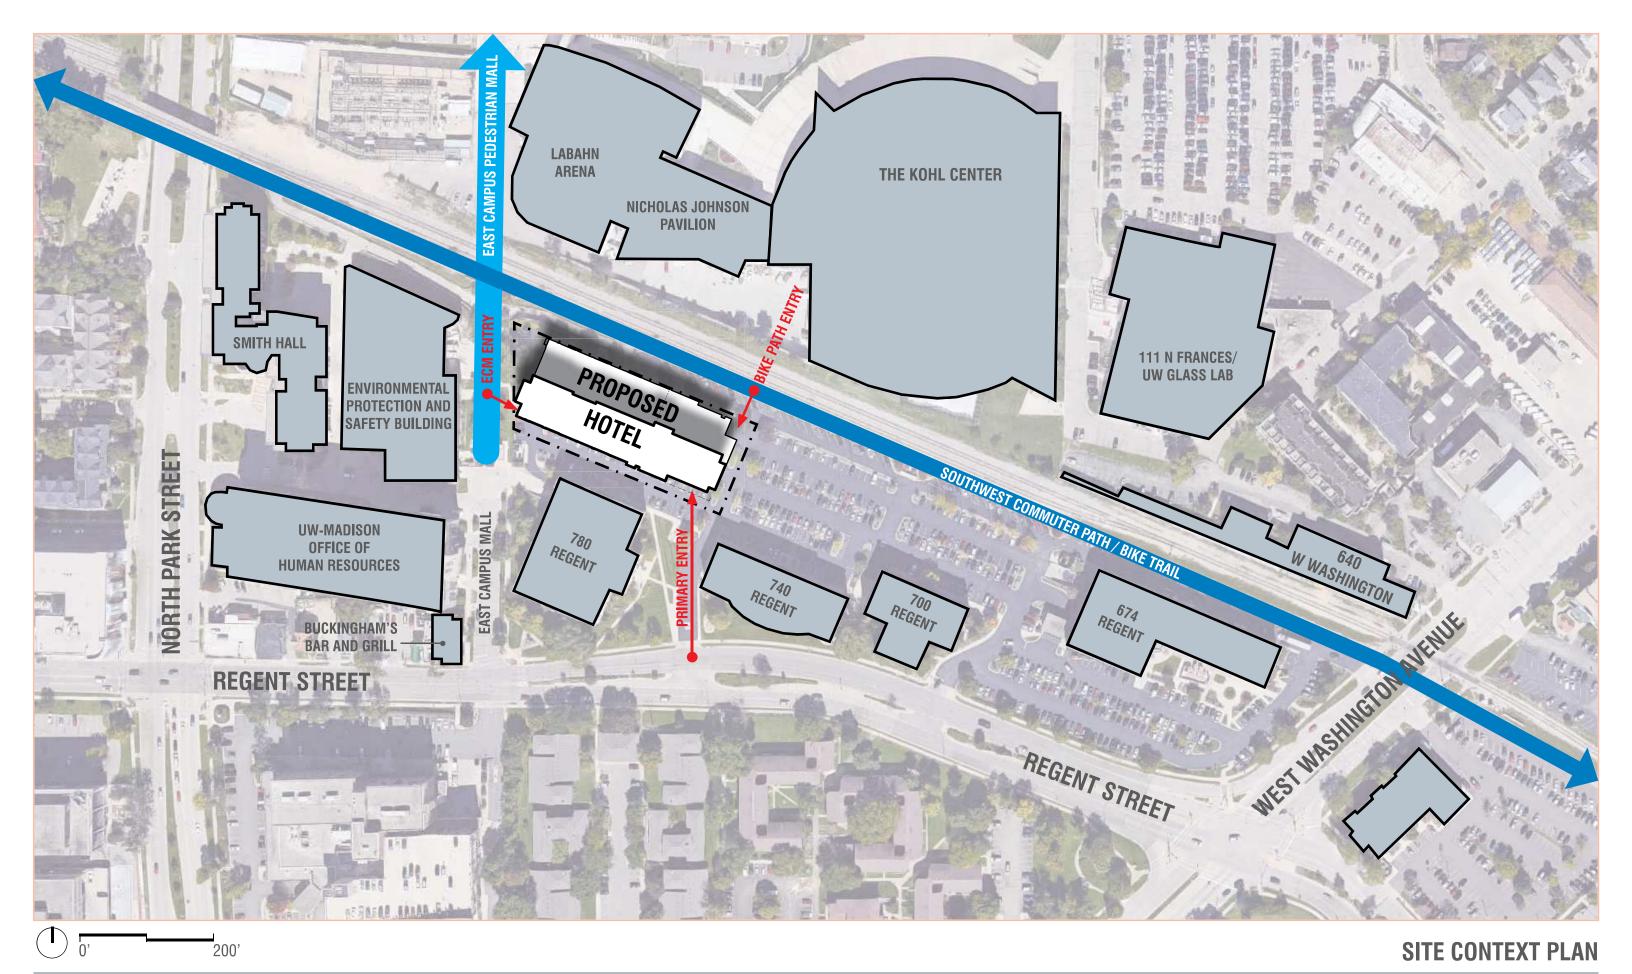







VIEW NORTH AT EAST CAMPUS MALL



VIEW WEST TO THE DEVELOPMENT



VIEW SOUTH ON EAST CAMPUS MALL AT BIKE TRAIL



VIEW NORTH FROM REGENT STREET



VIEW WEST ON BIKE TRAIL




VIEW WEST FROM KOHL CENTER

**SITE & CONTEXT VIEWS** 






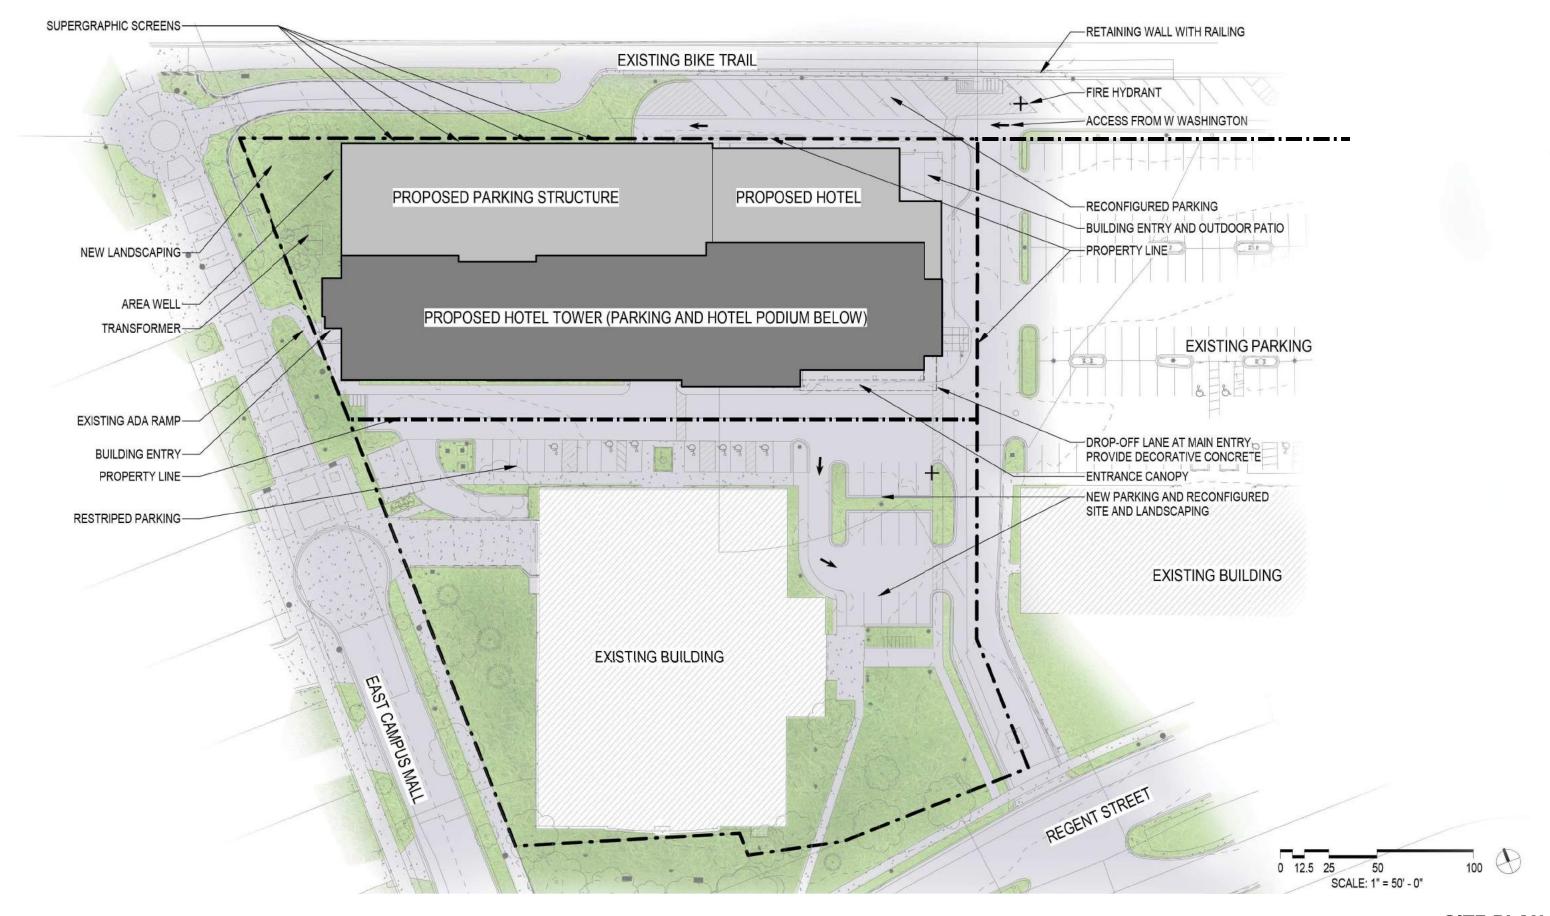




GUESTROOMS



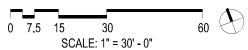


# **1ST FLOOR PLAN**

GUESTROOMS

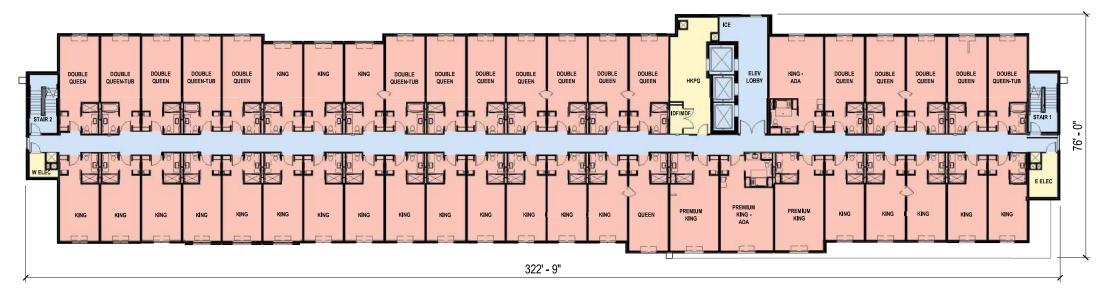

## **3RD-6TH FLOOR PLAN**



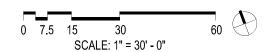


### 2ND FLOOR PLAN





# **ENTRY VIEW**

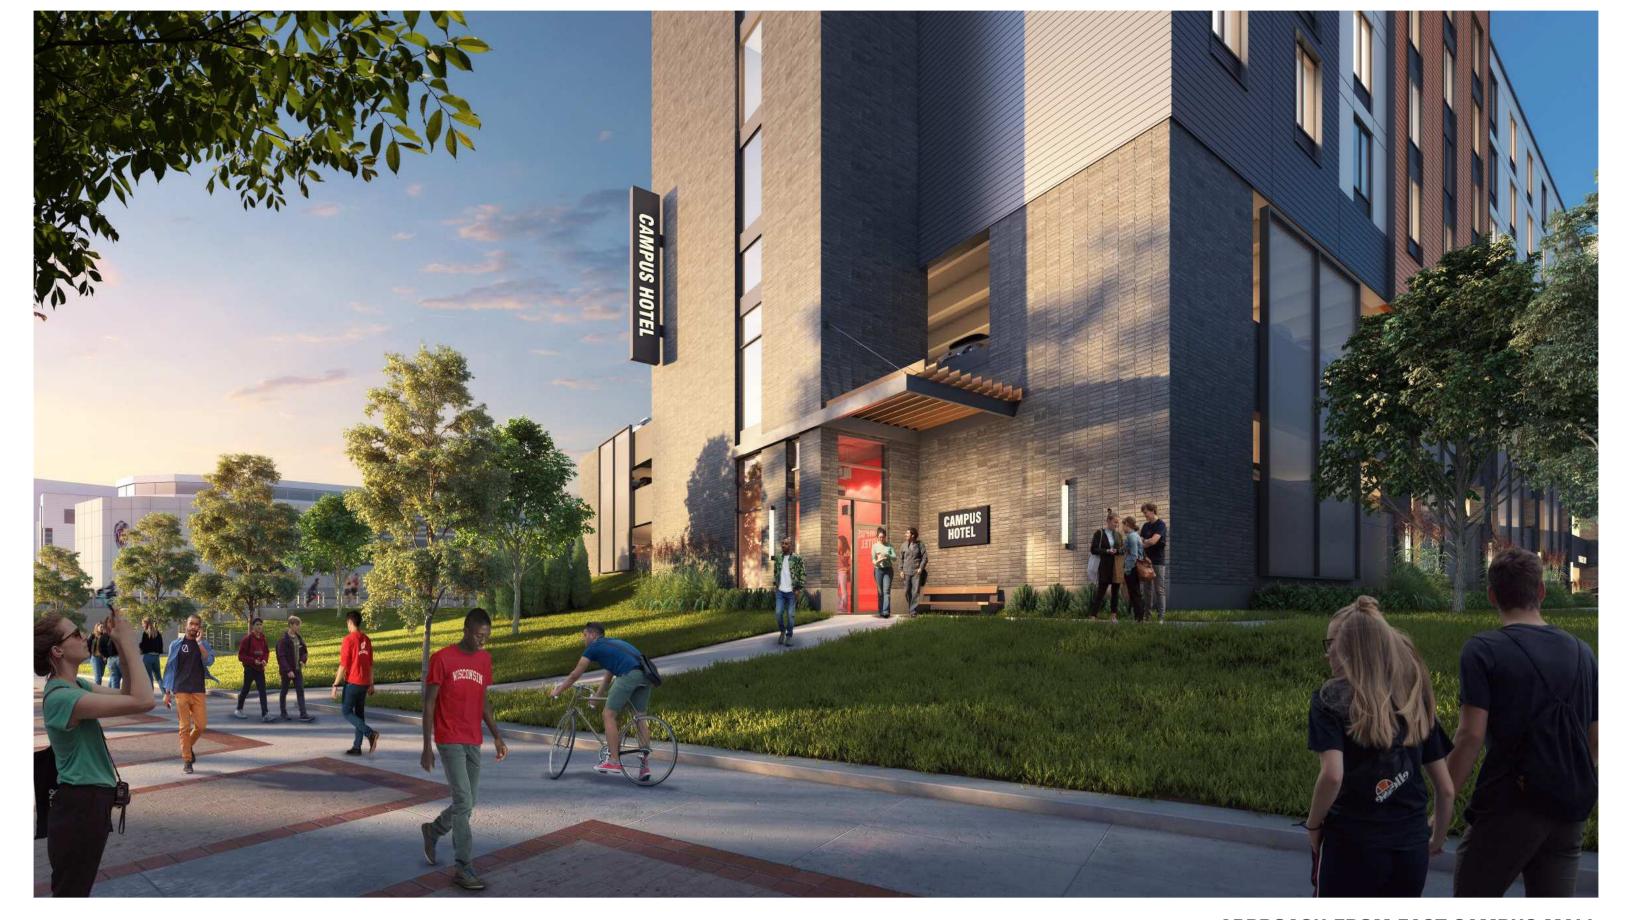

APPROACH FROM EAST CAMPUS MALL

CITY OF MADISON UDC UPDATE | 04-12-2019 | PAGE 09

Kahler Slater

COPYRIGHT © 2019 KAHLER SLATER, INC. ALL RIGHTS RESERVED





# APPROACH FROM NORTH EAST









**REGENT VIEW TO NORTH** 





A CITY ON THE MOVE








BIKE PATH VIEW TO SOUTH







1) METAL: SMOOTH, CORRUGATED, PAINTED DARK GRAY COPPER ORANGE

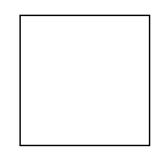

2) METAL: WHITE SMOOTH



3) CONCRETE: BRICK TEXTURE, STAINED CHARCOAL





5) SCREEN: TENSIONED MESH



SOUTH ELEVATION

NOT TO SCALE | PLEASE REFER TO BLACK & WHITE ELEVATIONS FOR DETAILED INFORMATION










1) METAL: SMOOTH, CORRUGATED, PAINTED DARK GRAY COPPER ORANGE

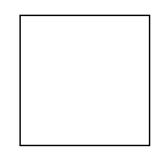

2) METAL: WHITE SMOOTH



3) CONCRETE: BRICK TEXTURE, STAINED CHARCOAL



4) EIFS: GRAY



5) SCREEN: TENSIONED MESH



NORTH ELEVATION

NOT TO SCALE | PLEASE REFER TO BLACK & WHITE ELEVATIONS FOR DETAILED INFORMATION


**NORTH ELEVATION** 







1) METAL: SMOOTH, CORRUGATED, PAINTED DARK GRAY COPPER ORANGE

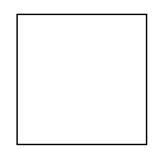

2) METAL: WHITE SMOOTH



3) CONCRETE: BRICK TEXTURE, STAINED CHARCOAL






5) SCREEN: TENSIONED MESH



WEST ELEVATION NOT TO SCALE | PLEASE REFER TO BLACK & WHITE ELEVATIONS FOR DETAILED INFORMATION

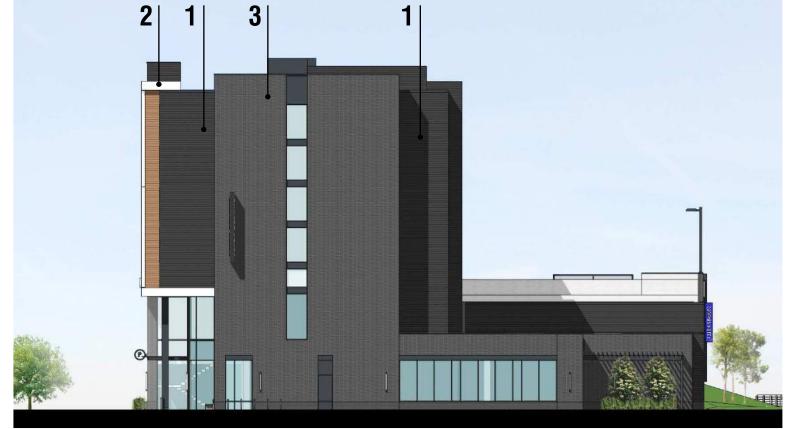

EAST ELEVATION

**WEST & EAST ELEVATIONS** 




Mortenson








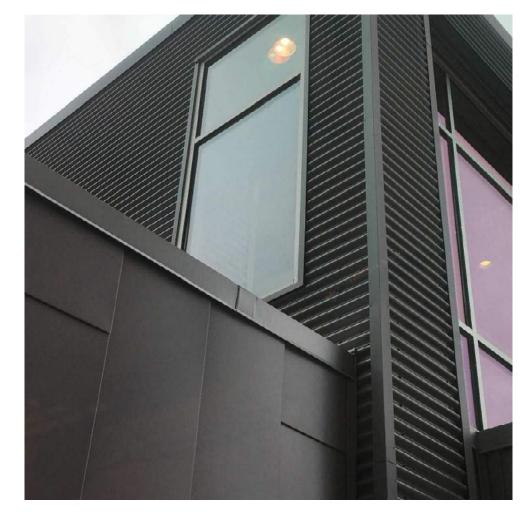






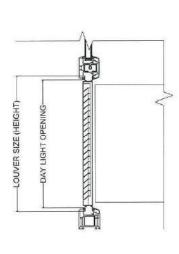










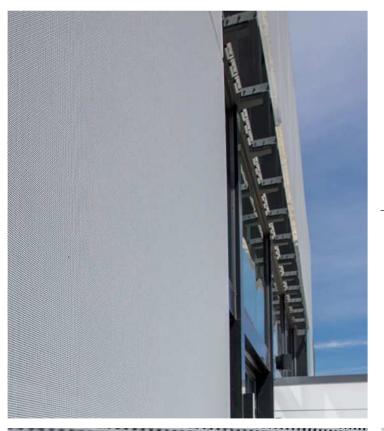

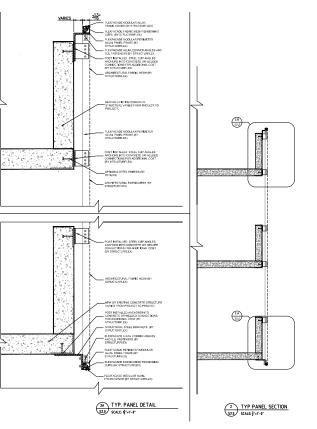

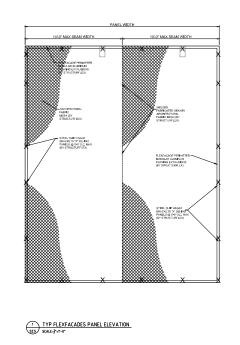



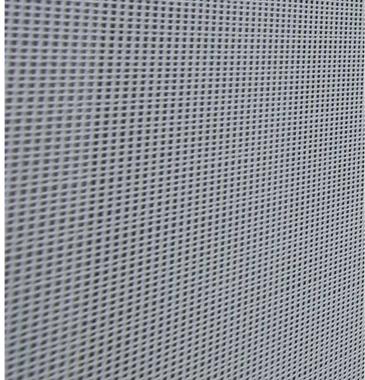









# LUA SUBMITTAL **UW CAMPUS HOTEL**

780 Regent Street Madison, WI 53715

KAHLER SLATER PROJECT: 218051 04/12/2019

Sheet Number	Sheet Name	
	Sneet Name	
G000	COVER SHEET	
	HEET INDEX	
Sheet Number	Sheet Name	
	Sheet Name EXISTING CONDITIONS PLAN	
C100		
C100 C101	EXISTING CONDITIONS PLAN	
C100 C101 C200	EXISTING CONDITIONS PLAN DEMOLITION PLAN	
C100 C101 C200 C300	EXISTING CONDITIONS PLAN DEMOLITION PLAN SITE PLAN	
C100 C101 C200 C300 C400	EXISTING CONDITIONS PLAN DEMOLITION PLAN SITE PLAN GRADING & EROSION CONTROL PLAN	
Sheet Number C100 C101 C200 C300 C400 C500	EXISTING CONDITIONS PLAN DEMOLITION PLAN SITE PLAN GRADING & EROSION CONTROL PLAN UTILITY PLAN	

LAND2	CAPE SHEET INDEX
Sheet Number	Sheet Name
L101	LANDSCAPE PLAN
ARCHI	FECTURAL SHEET INDEX
Sheet Number	Sheet Name
A000	ARCHITECTURAL SITE PLAN/SIGNAGE
A101	LEVEL 1 PLAN
A102	LEVEL P2 PLAN - PARKING
A103	LEVEL 2 PLAN - HOTEL
A104	LEVEL P3 AND P3.5 PLAN - PARKING
A106	LEVEL 3 & 4 PLAN
A107	LEVEL 5 & 6 PLAN
A108	LEVEL 7 - ROOF PLAN
A200	EXTERIOR ELEVATIONS
A201	EXTERIOR ELEVATIONS
A300	BUILDING SECTIONS
1001	DULL DAVIG OFFICIALO









NOT FOR CONSTRUCTION

LUA SUBMITTAL

SCOPE DOCUMENTS
Drawing Date
APRIL 12, 2019

UW CAMPUS HOTEL


780 Regent Street Madison, WI 53715

Project No. 218051

**COVER SHEET** 

44 East Miffl street, Sube 700, Madison, W Telephone 608,283,6300 Fax 608,283,6317 Sheet No. G0000



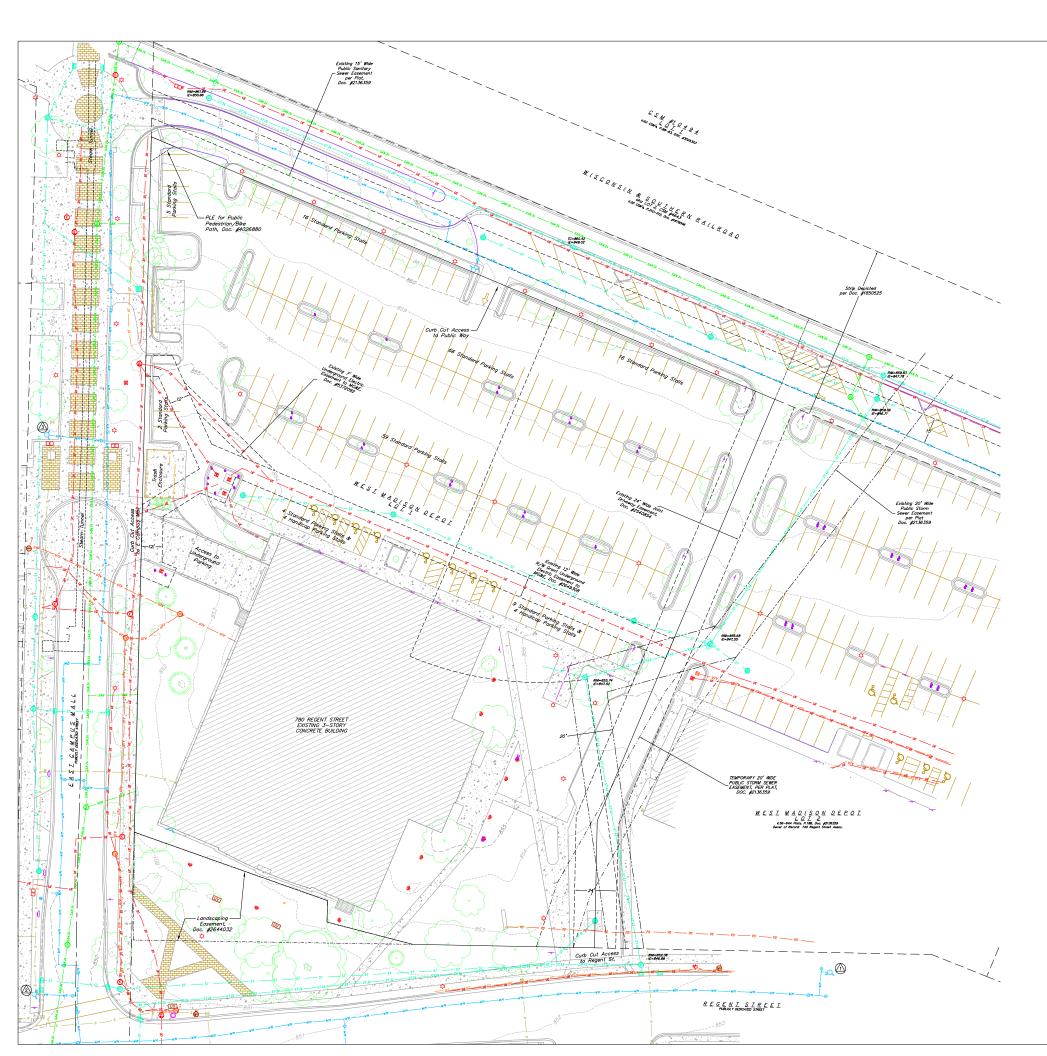



#### TOPOGRAPHIC SYMBOL LEGEND

--- 818 --- EXISTING MINOR CONTOUR

EXISTING BOLLARD EXISTING ELECTRIC RECTANGULAR MANHOLE

TOPOGRAPHIC LINEWORK LEGEND --- UTV --- EXISTING UNDERGROUND CABLE TV

EXISTING WOOD FENCE

- UT - UT - EXISTING UNDERGROUND TELEPHONE - \* - \* EXISTING GENERAL FENCE

\_\_\_\_ 6 \_\_\_\_ 6 \_\_\_ EXISTING GAS LINE - us - EXISTING UNDERGROUND ELECTRIC LINE - SAN - SAN - EXISTING SANITARY SEWER LINE (SIZE NOTED) \_\_\_\_ ST \_\_\_\_\_ ST \_\_\_ EXISTING STORM SEWER LINE (SIZE NOTED) --- - 820 - EXISTING MAJOR CONTOUR

& EXISTING FLAG POLE EXISTING SIGN EXISTING PARKING METER

EXISTING CURB INLET

EXISTING LIGHT POLE

EXISTING GENERIC LIGHT

EXISTING FIELD INLET EXISTING STORM MANHOLE I EXISTING STORM MANHOLE RECTANGULAR

C EXISTING FIRE HYDRANT EXISTING FIRE DEPARTMENT EXISTING WATER MAIN VALVE

EXISTING GAS METER EXISTING ELECTRIC MANHOLE M EXISTING TV MANHOLE EXISTING TV PEDESTAL EXISTING TELEPHONE MANHOLE EXISTING UNIDENTIFIED MANHOLE

■ EXISTING TRANSFORMER

EXISTING HANDICAP PARKING EXISTING TRAFFIC SIGNAL EXISTING SHRUB EXISTING CONFEROUS TREE EXISTING DECIDUOUS TREE

EXISTING UNIDENTIFIED UTILITY VAUL

HATCHING LEGEND EXISTING CONCRETE


EXISTING BRICK PAVERS

- THIS SURVEY IS BASED UPON FIELD SURVEY WORK PERFORMED ON AUGUST 16 THROUGH AUGUST 23, 2018. ANY CHANGES IN SITE CONDITIONS AFTER AUGUST 23, 2018 ARE NOT REFLECTED BY THIS SURVEY, ADDITIONAL FIELD SURVEY WORK WAS PERFORMED ON FEBRUARY 22, 2019.
- SURVEY WORK WAS PERFORMED ON FEBRUARY 22, 2019.

  EXISTING TOPOGRAPHIC INFORMATION IS BASED ON FIELD OBSERVATIONS AND/OR PLAN OF RECORD DRAWINGS. CONTRACTOR SHALL VERIFIT TOPOGRAPHIC INFORMATION PRIOR TO STRATING CONSTRUCTION.

  3. CONTRACTOR SHALL FIELD VERIFY LOCATION OF EXISTING SANITARY SEWER, STORM SEWER AND WASTER MAIN PRIOR TO CONSTRUCTION TO ENSURE PROPER CLEARANCE OF THE NEW UTILITIES. CONTRACTOR MUST TAKE ALL NCESSARY PRECAUTIONS TO PROTECT THE EXISTING UTILITIES DURING CONSTRUCTION. ANY DAMAGE TO THE EXISTING UTILITIES AND ANY REPARS OCCUPIED AS A RECULT OF THE DAMAGE SHALL BE AT THE EXPENSE OF THE OWNER OF THE CONSTRUCTION. THE FLANS.
- SHOWN ON THE YEARS.

  4. THE LOCATIONS OF EXISTING UTILITY INSTALLATIONS AS SHOWN ON THE PLAN ARE APPROXIMATE. THERE MAY BE OTHER UTILITY INSTALLATIONS WITHIN THE PROJECT AREA THAT ARE NOT SHOWN. CONTRACTOR SHALL BE RESPONSIBLE FOR CONTACTING DIGGERS HOTLINE AND LOCATING ALL EXISTING UTILITIES AND ENSURE PROPER CLEARANCE OF NEW UTILITIES.

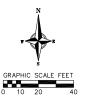

Revisions

### SITE BENCHMARKS

ARROW BOLT ON FIRE HYDRANT LOCATED ON NORTH SIDE OF REGENT STREET, APPROXIMATELY 450° EAST OF THE INTERSECTION WITH EAST CAMPUS MALL. ELEV = 855.83 

ARROW BOLT ON FIRE HYDRANT LOCATED IN THE NORTHWEST QUADRANT OF REGENT STREET AND EAST CAMPUS MALL. ELEV = 852.43 **②** 

**3** 



CALL DIGGER'S HOTLINE 1-800-242-8511

LUA SUBM**I**TTAL

SCOPE DOCUMENTS Drawing Date

April 12, 2019

UW CAMPUS HOTEL

780 Regent Street Madison, WI 53715

Project No. 218051


Sheet Title **EXISTING** CONDITIONS

PLAN Copyright © 2018 Kahler Slater, Inc. A lirights reserved

111 West Wiscons in Avenue, Milwaukee, Wiscons in 53203 Telephone 414-272-2000 Fax 414-272-2001

44 East Millin Street, Suite 700, Madison, Wiscons n 53703 Telephone 608,283,6300 Fax 608,283,6317 Sheet No.

C100

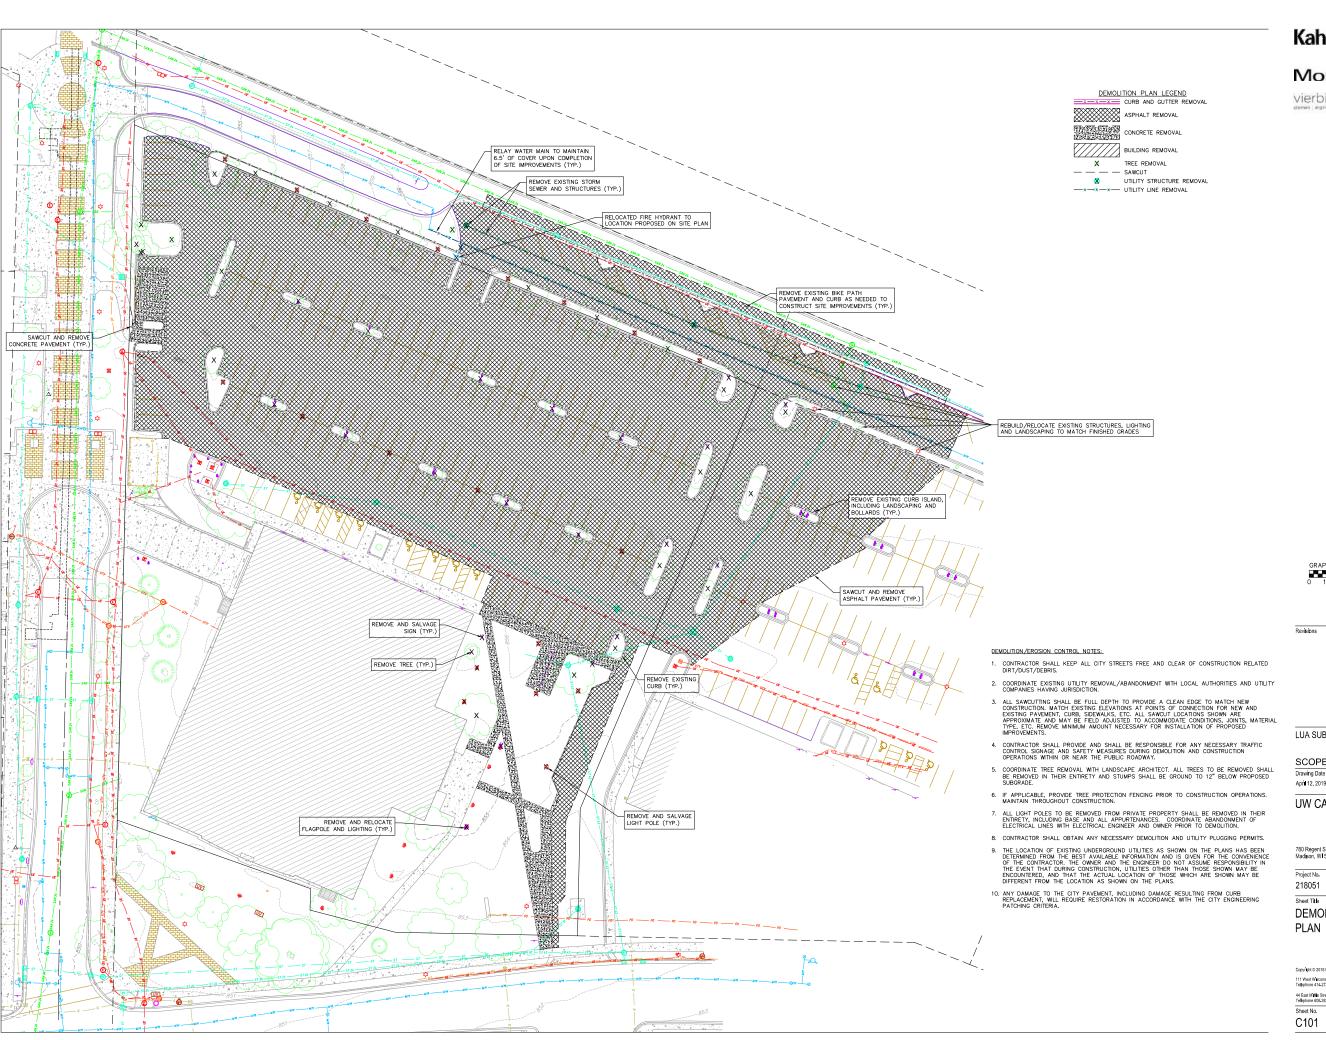



LUA SUBM**I**TTAL

SCOPE DOCUMENTS

Drawing Date April 12, 2019

UW CAMPUS HOTEL


780 Regent Street Madison, WI 53715


Sheet Title

**DEMOLITION** 

111 West Wiscons in Avenue, Maraukee, Wiscons in 53203 Telephone 414-272-2000 Fax 414-272-2001

Sheet No. C101

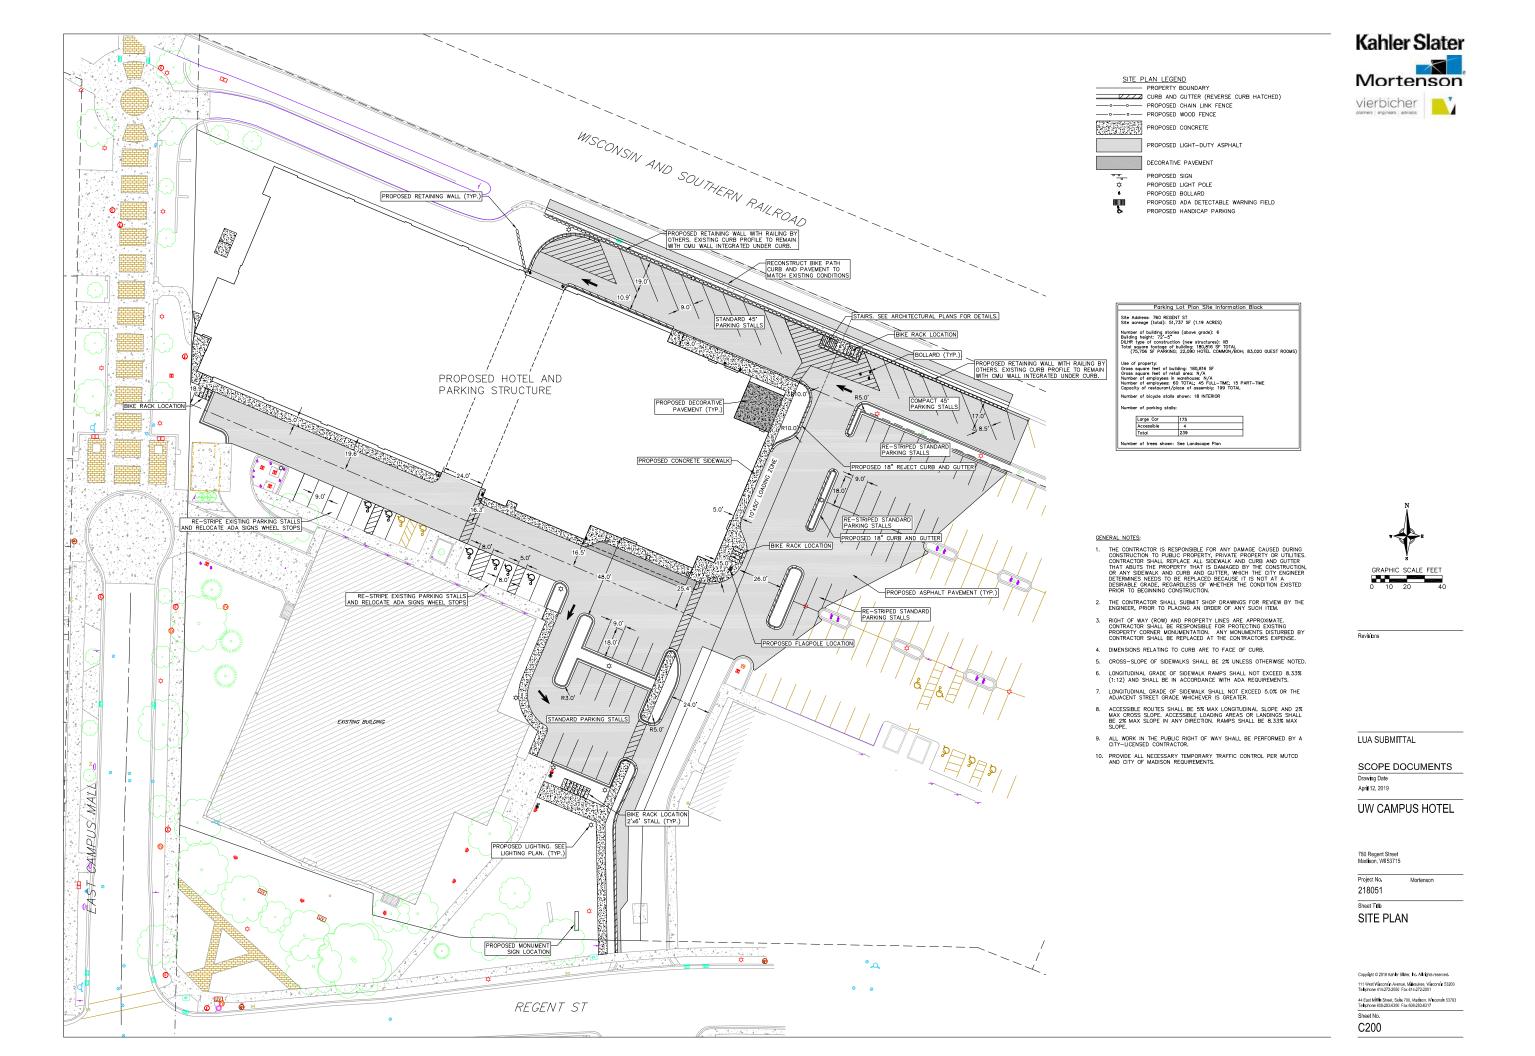

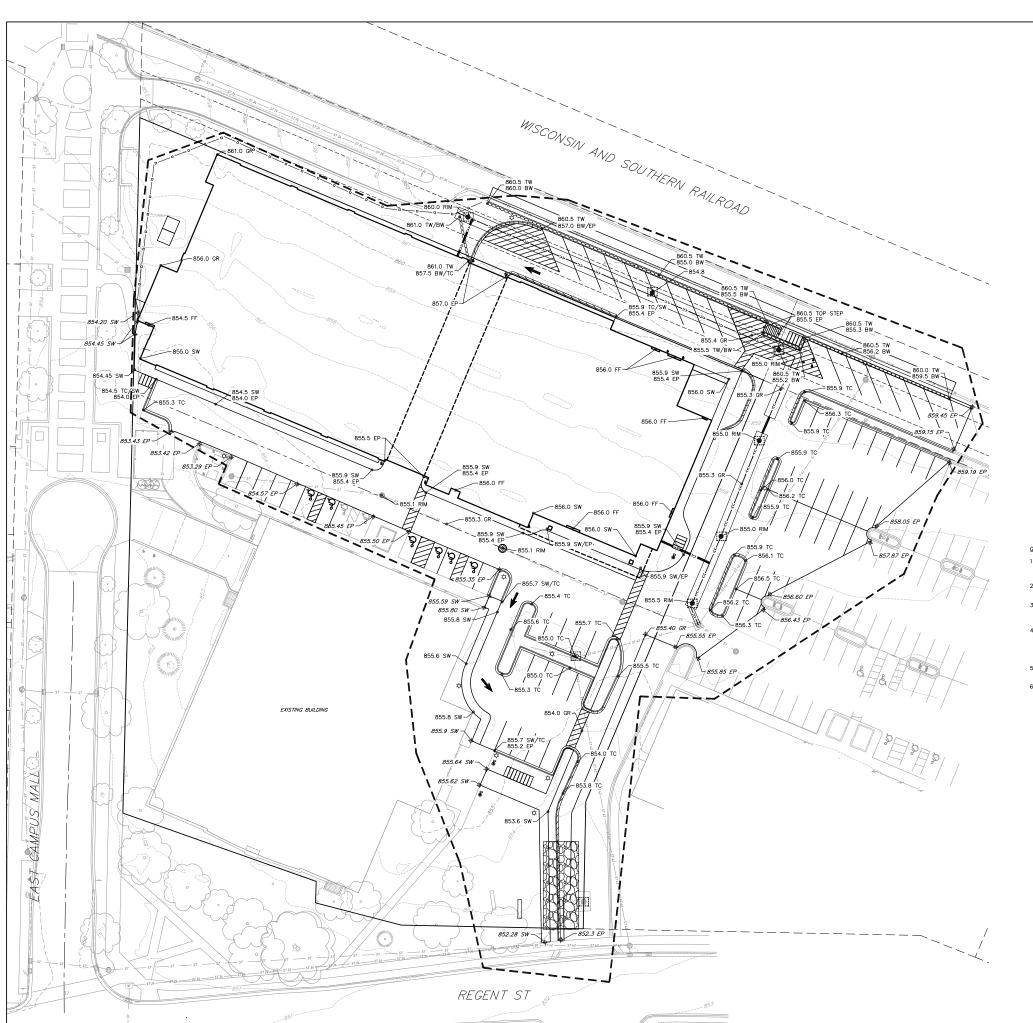



PROPOSED MAJOR CONTOURS
PROPOSED MINOR CONTOURS
DITCH CENTERINE
SILT FENCE
DISTURBED LIMITS
BERM
PROPOSED SLOPE ARROWS
EXISTING SPOT ELEVATIONS
PROPOSED SPOT ELEVATIONS
STONE WEEPER
PROPOSED SPOT ELEVATIONS
STONE WEEPER
PROPOSED SPOT ELEVATIONS
EROSION MAT CLASS I, TYPE A
EROSION MAT CLASS II, TYPE B
TRACKING PAD
RIP RAP

ABBREVIATIONS

TC - TOP OF CURB

FF - FINISHED FLOOR

FL - FLOW LINE

SW - TOP OF WALK

TW - TOP OF WALK

BW - BOTTOM OF WALL

EP - EDGE OF PAVEMENT

GR - GRADE


GRADING LEGEND

EXISTING MAJOR CONTOURS

EXISTING MINOR CONTOURS



- ALL GRADES SHOWN ARE FINISHED GRADES. CONTOURS ARE SHOWN FOR PURPOSES OF INDICATING ROUGH GRADING. FINAL GRADE SHALL BE ESTABLISHED ON PAVED SURFACES BY USING SPOT GRADES ONLY.
- SEE DETAIL SHEETS FOR EROSION CONTROL NOTES AND CONSTRUCTION SEQUENCE.
- INSTALL A 50'L X 20'W X 1.5'D TRACKING PAD AT THE SITE ENTRANCE. THE TRACKING PAD SHALL BE MAINTAINED/REPAIRED AS NECESSARY TO ACCOMMODATE CONSTRUCTION.
- 4. THE CONTRACTOR IS REQUIRED TO MAKE EROSION CONTROL INSPECTIONS AT THE END OF EACH WEEK AND WHEN 0.5 INCHES OF RAIN FALLS WITHIN 24 HOURS. INSPECTION REPORTS SHALL BE PREPARED AND FILED AS REQUIRED BY THE DNR. ALL MANTENANCE/REPAR MILL FOLLOW AN INSPECTION WITHIN 24 HOURS.
- INSTALL WI DOT TYPE D INLET PROTECTION IN EXISTING CURB INLETS AND WI DOT TYPE A IN FIELD INLETS.
- 6. THE CONTRACTOR SHALL REMOVE ANY SEDIMENT TRACKED ONTO ADJACENT ROADS BY MEANS OF STREET SWEEPING (NOT FLUSHING) AT A MINIMUM OF THE END OF EACH WORK DAY OR MORE AS NEEDED.

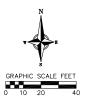

Revisions

LUA SUBMITTAL

SCOPE DOCUMENTS

April 12, 2019

UW CAMPUS HOTEL

780 Regent Street Madison, WI 53715

Project No. Mo

218051


Sheet Title

GRADING & EROSION CONTROL PLAN

Copyright © 2018 Kahler Stater, Inc. A linghts reserved. 111 West Wecons in Avenue, Makaukee, Wiscons in 53203 Telephone 414-272-2000 Fax 414-272-2001

44 East Miffin Street, Suite 700, Madison, Wisconsin 5370 Telephone 608 283 6300 Fax 608 283 6317 Sheet No.

C300

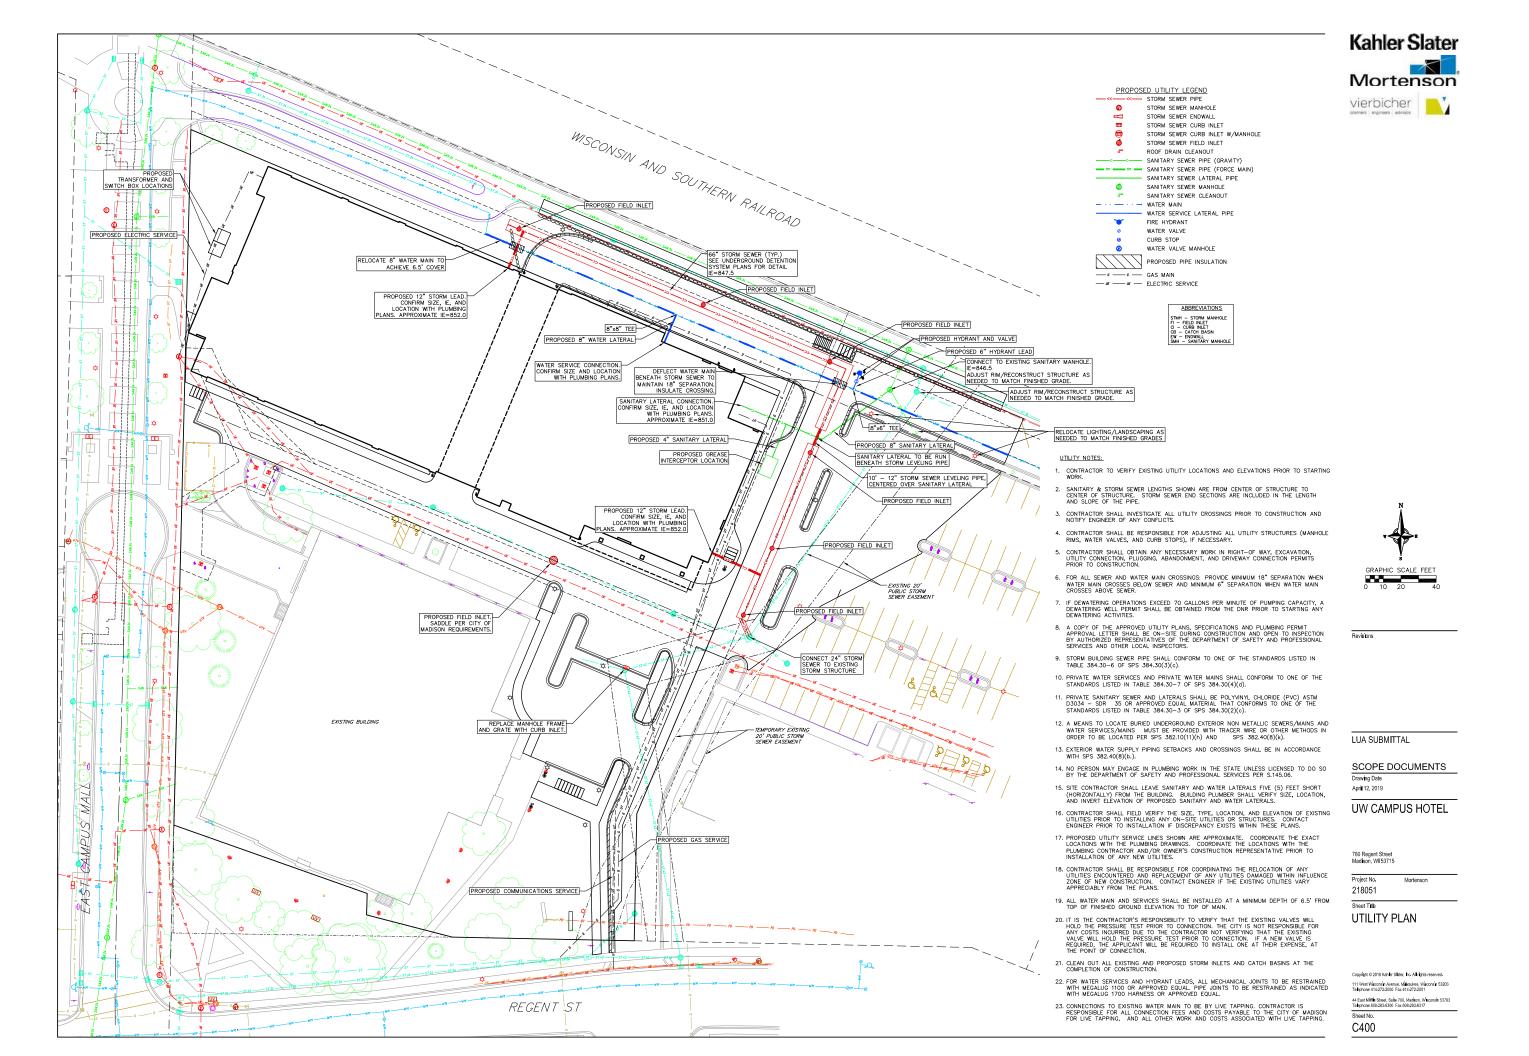

### EROSION CONTROL MEASURES

- 1. EROSION CONTROL SHALL BE IN ACCORDANCE WITH THE CITY OF MADISON EROSION CONTROL ORDINANCE AND CHAPTER NR 216 OF THE WISCONSIN ADMINISTRATIVE CODE.
- CONSTRUCT AND MAINTAIN ALL EROSION AND SEDIMENT CONTROL MEASURES IN ACCORDANCE WITH WISCONSIN DNR TECHNICAL STANDARDS
  (http://dnr.wi.gov/runoff/stormwater/techstds.htm) AND WISCONSIN CONSTRUCTION SITE BEST MANAGEMENT PRACTICE HANDBOOK.
- INSTALL SEDIMENT CONTROL PRACTICES (TRACKING PAD, PERIMETER SILT FENCE, SEDIMENT BASINS, ETC.) PRIOR TO INITIATING OTHER LAND DISTURBING CONSTRUCTION ACTIVITIES.
- 4. THE CONTRACTOR IS REQUIRED TO MAKE EROSION CONTROL INSPECTIONS AT THE END OF EACH WEEK AND WHEN 0.5 INCHES OF RAIN FALLS WITHIN 24 HOURS. INSPECTION REPORTS SHALL BE PREPARED AND FILED AS REQUIRED BY THE DNR AND/OR CITY. ALL MAINTENANCE WILL FOLLOW AN INSPECTION WITHIN 24 HOURS.
- 5. EROSION CONTROL IS THE RESPONSIBILITY OF THE CONTRACTOR UNTIL ACCEPTANCE OF THIS PROJECT. EROSION CONTROL MEASURES AS SHOWN SHALL BE THE MINIMUM PRECAUTIONS THAT MILL BE ALLOWED. ADDITIONAL EROSION CONTROL MEASURES, AS REQUESTED IN WRITING BY THE STATE OR LOCAL INSPECTORS, OR THE DEVELOPER'S ENGINEER, SHALL BE INSTALLED WITHIN 24 HOURS.
- 6. A 3" CLEAR STONE TRACKING PAD SHALL BE INSTALLED AT THE END OF ROAD CONSTRUCTION LIMITS TO PREVENT SEDIMENT FROM BEING TRACKED ONTO THE ADJACENT PAVED PUBLIC ROADWAY. SEDIMENT TRACKING PAD SHALL CONFORM TO WISDING TECHNICAL STANDARD 1057. SEDIMENT REACHING THE PUBLIC ROAD SHALL BE REMOVED BY STREET CLEANING (NOT HOTRALLIC FLUSHING) BEFORE THE END OF EACH WORK DAY.
- 7. CHANNEUZED RUNOFF: FROM ADJACENT AREAS PASSING THROUGH THE SITE SHALL BE DIVERTED AROUND DISTURBED AREAS.
- 8. STABILIZED DISTURBED GROUND. ANY SOIL OR DIRT PILES WHICH WILL REMAIN IN EXISTENCE FOR MORE THAN 7-CONSECUTIVE DAYS, WHETHER TO BE WORKED DURING THAT PERIOD OR NOT, SHALL NOT BE LOCATED WITHIN 25-FEET OF ANY ROADWAY, PARKING LOT, PAVED AREA, OR DRAINAGE STRUCTURE OR CHANNEL (UNLESS NITENDED TO BE USED AS PART OF THE EROSION CONTROL MEASURESS). TEMPORARY STABILIZATION AND CONTROL MEASURESS (SEEDING, MULCHING, TARRHING, EROSION MATTING, BARRIER FENCING, ETC.) ARE REQUIRED FOR THE PROTECTION OF DISTURBED AREAS AND SOIL PILES, WHICH WILL REMAIN UN-WORKED FOR A PERIOD OF MORE THAN 14-CONSECUTIVE CALENDAR DAYS. THESE MEASURES SHALL REMAIN IN PLACE UNTIL STEP HAS STABILIZED.
- 9. SITE DE-WATERING: WATER PUMPED FROM THE SITE SHALL BE TREATED BY TEMPORARY SEDIMENTATION BASINS OR OTHER APPROPRIATE CONTROL MEASURES. SEDIMENTATION BASINS SHALL HAVE A DEPTH OF AT LEAST 3 FEET, BE SURROUNDED BY SKOWTENCE OR EQUIVALENT BARRIER AND HAVE SUFFICIENT SURFACE AREA TO PROVIDE A SURFACE SETTLING RATE OF NO MORE THAN 750 GALLONS PER SQUARE FOOT PER DAY AT THE HIGHEST DEWATERING PUMPING RATE. WATER MAY NOT BE DISCHARGED IN A MANNER THAT CAUSES EROSION OF THE SITE, A NEIGHBORING SITE, OR THE BED OR BANKS OF THE RECEIVING WATER. POLYMERS MAY BE USED AS DIRECTED BY DONE TECHNICAL STANDARD 1061 (DE-WATERING) (DE-WATERING)
- .

  NASHED STONE WEEPERS OR TEMPORARY EARTH BERMS SHALL BE BUILT PER PLAN BY CONTRACTOR TO TRAP SEDIMENT OR SLOW THE VELOCITY OF STORM WATER.
- 11. INLET FILTERS ARE TO BE PLACED IN STORMWATER INLET STRUCTURES AS SOON AS THEY ARE INSTALLED. ALL PROJECT AREA STORM INLETS NEED WISCONSIN D.O.T. TYPE D INLET PROTECTION. THE FILTERS SHALL BE MAINTAINED UNTIL THE CITY HAS ACCEPTED THE BINDER COURSE OF ASPHALT.
- 12. RESTORATION (SEED, FERTILIZE AND MULCH) SHALL BE PER SPECIFICATIONS ON THIS SHEET UNLESS SPECIAL RESTORATION IS CALLED FOR ON THE LANDSCAPE PLAN OR THE DETENTION BASIN DETAIL SHEET.
- 13. SEED, FERTILIZER AND MULCH SHALL BE APPLIED WITHIN 7 DAYS AFTER FINAL GRADE HAS BEEN ESTABLISHED. IF DISTURBED AREAS WILL NOT BE RESTORED IMMEDIATELY AFTER ROUGH GRADING, TEMPORARY SEED SHALL BE PLACED.
- 14. FOR THE FIRST SIX WEEKS AFTER RESTORATION (E.G. SEED & MULCH, EROSION MAT, SOD) OF A DISTURBED AREA, INCLUDE SUMMER WATERING PROVISIONS OF ALL NEWLY SEEDED AND MULCHED AREAS WHENEVER 7 DAYS ELAPSE WITHOUT A RAIN EVENT.
- 16. SOIL STABILIZERS SHALL BE APPLIED TO DISTURBED AREAS WITH SLOPES BETWEEN 10% AND 3:1 (DO NOT USE IN CHANNELS). SOIL STABILIZERS SHALL
- BE TYPE B, PER WISCONSIN D.O.T. P.A.L. (PRODUCT ACCEPTABILITY LIST), OR EQUAL. APPLY AT RATES AND METHODS SPECIFIED PER THIS SHEET. SOIL STABILIZERS SHALL BE RE-APPLIED WHENEVER VEHICLES OR OTHER EQUIPMENT TRACK ON THE AREA.
- 17. SILT FENCE TO BE USED ACROSS AREAS OF THE LOT THAT SLOPE TOWARDS A PUBLIC STREET OR WATERWAY. SEE DETAILS
- 18. SEDIMENT SHALL BE CLEANED FROM CURB AND GUTTER AFTER EACH RAINFALL AND PRIOR TO PROJECT ACCEPTANCE
- 19. ACCUMULATED CONSTRUCTION SEDIMENT SHALL BE REMOVED FROM ALL PERMANENT BASINS TO THE ELEVATION SHOWN ON THE GRADING PLAN FOLLOWING THE STABILIZATION OF DRAINAGE AREAS.
- 20. ALL CONSTRUCTION ENTRANCES SHALL HAVE TEMPORARY ROAD CLOSED SIGNS THAT WILL BE IN PLACE WHEN THE ENTRANCE IS NOT IN USE AND AT THE END OF EACH DAY.
- 21. ANY PROPOSED CHANGES TO THE EROSION CONTROL PLAN MUST BE SUBMITTED AND APPROVED BY DANE COUNTY LAND CONSERVATION OR PERMITTING MUNICIPALITY.
- 22. THE CITY, OWNER AND/OR ENGINEER MAY REQUIRE ADDITIONAL EROSION CONTROL MEASURES AT ANY TIME DURING CONSTRUCTION

### CONSTRUCTION SEQUENCE:

- 1. INSTALL SILT FENCE AND TRACKING PAD
- 2. STRIP TOPSOIL-DETENTION BASINS
- 3. ROUGH GRADE DETENTION BASINS
- 4. SEED DETENTION BASINS
- 5. STRIP TOPSOIL-STREETS & LOTS
- SEED LOT AREAS AND INSTALL DRIVE-OVER VELOCITY CHECKS
- 8. CONSTRUCT UNDERGROUND UTILITIES
- 9. INSTALL INLET PROTECTION
- 10. CONSTRUCT ROADS (STONE BASE, CURB & GUTTER, AND SIDEWALK). REMOVE DRIVE-OVER VELOCITY CHECKS WHEN BASE COURSE IS PLACED
- 12. REMOVE TRACKING PAD, SILT FENCE AND DIVERSION BERM MEASURES AFTER DISTURBED AREAS ARE RESTORED

#### SEEDING RATES:

- TEMPORARY:

  1. USE ANNUAL OATS AT 3.0 LB./1,000 S.F. FOR SPRING AND SUMMER PLANTINGS.

  2. DVE AT 3.0 LB /1,000 SF FOR
- USE WINTER WHEAT OR RYE AT 3.0 LB./1,000 SF FOR FALL PLANTINGS STARTED


AFTER SEPTEMBER 15.

### PERMANENT: 1. USE WISCONSIN D.O.T. SEED MIX #40 AT 2 LB./1,000 S.F.

### TEMPORARY AND PERMANENT: USE WISCONSIN D.O.T. TYPE A OR B AT 7 LB./1,000 S.F.


#### MULCHING RATES:


TEMPORARY AND PERMANENT:
USE & TO 1—& STRAW OR HAY MULCH, CRIMPED PER
SECTION TO 607.3.2.3, OR OTHER RATE AND METHOD PER SECTION
627, WISCONSIN D.O.1. STANDARD SPECIFICATIONS FOR
HIGHWAY AND STRUCTURE CONSTRUCTIONS

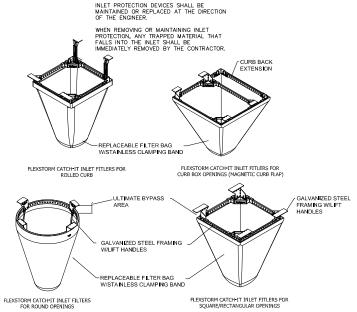



NEENAH CASTING	NLET TYPE	GRATE SIZE	OPENING SIZE	ADS P/N
1040/1642/1733	ROUND	26	24	62MRDFX
3067 W/FLAP	CURB BOX	35.25 X 17.75	33.0 X 15.0	62LCBEXTFX
3067 EXTENDED BACK	CURB BOX	35.25 X 17.75	33.0 X 15.0	62LCBEXTFX
3246A	CURB BOX	35.75 X 23.875	33.5 X 21.0	62LCBFX
3030	SQUARE/RECT	23 X 16	20.5 X 13.5	62MCBFX
3067-C	SQUARE/RECT	35.25 X 17.75	33 X 15	62LSQFX



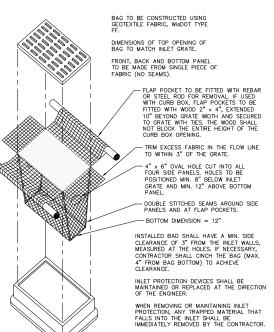

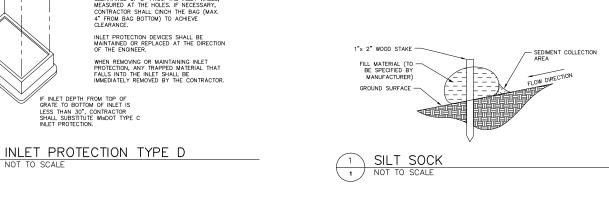

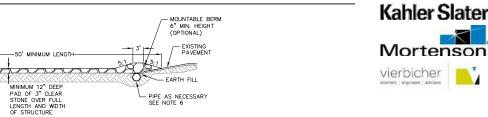


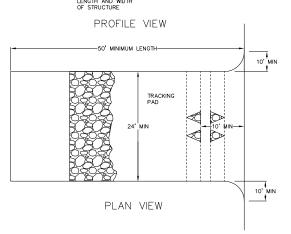


- 1. FOLLOW WISCONSIN DNR TECHNICAL STANDARD 1057 FOR FURTHER DETAILS AND INSTALLATION.

- EXISTING GROUND


- 3. WIDTH 24' MINIMUM, SHOULD BE FLARED AT THE EXISTING ROAD TO PROVIDE A TURNING RADIUS.
- 4. ON SITES WITH A HIGH GROUND WATER TABLE OR WHERE SATURATED CONDITIONS EXIST, GEOTEXTILE FABRIC SHALL BE PLACED OVER EXISTING GROUND PRIOR TO PLACING STONE. FABRIC SHALL BE WISDOT TYPE—HR GEOTEXTILE FABRIC.
- 5. STONE CRUSHED 3" CLEAR STONE SHALL BE PLACED AT LEAST 12" DEEP OVER THE ENTIRE LENGTH AND WIDTH OF ENTRANCE.
- 6. SURFACE WATER ALL SURFACE WATER FLOWING TO OR DIVERTED TOWARDS CONSTRUCTION ENTRANCES SHALL BE PIPED THROUGH THE ENTRANCE. MAINTAINING POSITIVE DRAINAGE. PIPE INSTALLED THROUGH THE STABILIZED CONSTRUCTION ENTRANCE SHALL BE PROTECTED WITH A MOUNTABLE BERM WITH 5:1 SLOPES AND MINIMUM OF 6" STONE OVER THE PIPE. PIPE SHALL BE SIZED ACCORDING TO THE DRAINAGE REQUIREMENTS. WHEN THE ENTRANCE IS LOCATED AT A HIGH SPOT AND HAS NO DRAINAGE TO CONVEY A PIPE SHALL NOT BE NECESSARY. THE MINIMUM PIPE DIAMETER SHALL BE 6". CONTRACTOR SHALL BE RESPONSIBLE FOR THE MAINTENANCE OF SAID PIPE.
- LOCATION A STABILIZED CONSTRUCTION ENTRANCE SHALL BE LOCATED WHERE CONSTRUCTION TRAFFIC ENTERS AND/OR LEAVES
  THE CONSTRUCTION SITE. VEHICLES LEAVING THE SITE MUST TRAVEL OVER THE ENTIRE LENGTH OF THE TRACKING PAD.

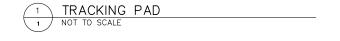

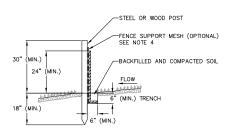

- INSTALL SILT FENCE TO FOLLOW THE GROUND CONTOURS AS CLOSELY AS POSSIBLE.
- CURVE THE SILT FENCE UP THE SLOPE TO PREVENT WATER FROM RUNNING AROUND THE ENDS.
- POST SPACING WITH FENCE SUPPORT MESH = 10 FT. (MAX.)
- POST SPACING WITHOUT FENCE SUPPORT MESH = 6 FT. (MAX.)
- 4. SILT FENCE SUPPORT MESH CONSISTS OF 14-CAUGE STEEL WRE WITH A MESH SPACING OF 6 IN. X 6 IN. OR PREFABRICATED POLYMERIC MESH OF EQUIVALENT STRENGTH



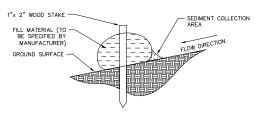

Revisions

LUA SUBMITTAL

SCOPE DOCUMENTS

April 12, 2019

**UW CAMPUS HOTEL** 

780 Regent Street Madison, WI 53715

Project No.


218051

CONSTRUCTION


**DETAILS** 

Copyright © 2018 Kahler Stater, Inc. All rights reserved 111 West Wisconsin Avenue, Maraukee, Wisconsin 53203 Telephone 414-272-2000 Fax 414-272-2001


Sheet No. C500

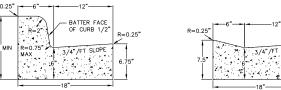


CURB AND GUTTER CROSS SECTION

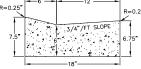

DRIVEWAY GUTTER CROSS SECTION

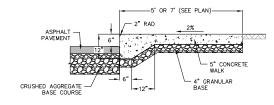


CURBED SIDEWALK SITE DETAIL NOT TO SCALE

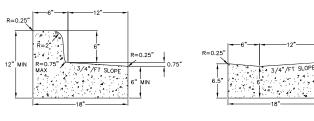


CURB AND GUTTER REJECT SECTION

HANDICAP RAMP GUTTER CROSS SECTION

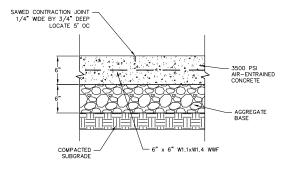


CONCRETE PAD NOT TO SCALE




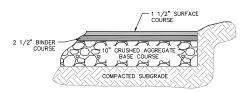

BITUMINOUS PAVEMENT DRIVES

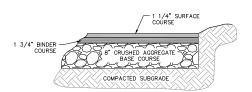



BITUMINOUS PAVEMENT PARKING LOT

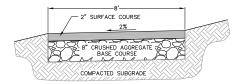

BITUMINOUS PAVEMENT BIKE PATH



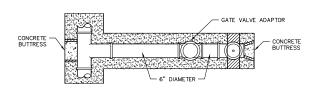

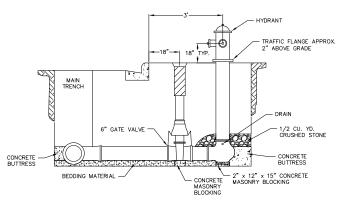

STANDARD HYDRANT SETTING NOT TO SCALE



Revisions

LUA SUBM**I**TTAL

SCOPE DOCUMENTS

April 12, 2019

UW CAMPUS HOTEL

780 Regent Street Madison, WI 53715

Project No.

218051


CONSTRUCTION **DETAILS** 


Copyright © 2018 Kahler Slater, Inc. A linights reserved 111 West Wisconsin Avenue, Maraukee, Wisconsin 53203 Telephone 414 272 2000 Fax 414 272 2001


44 East Miffilm Street, Suite 700, Madison, Wisconsin 53703 Telliphone 608-283-6300 Fax 608-283-6317 Sheet No.


C501



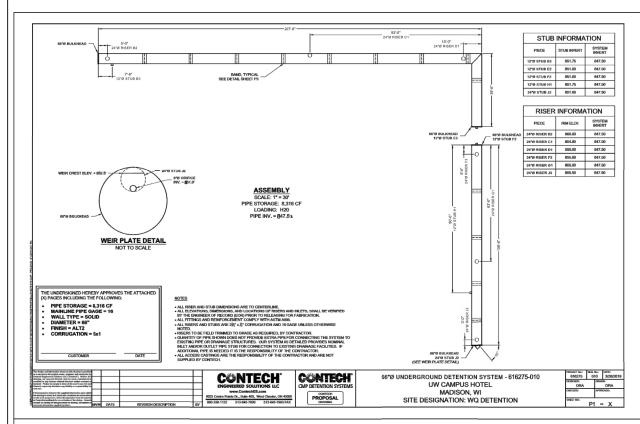

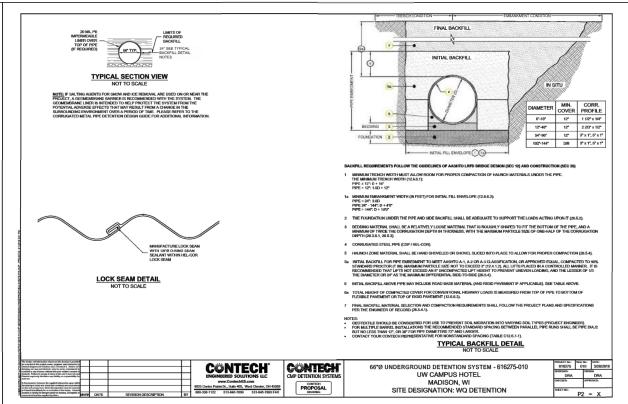

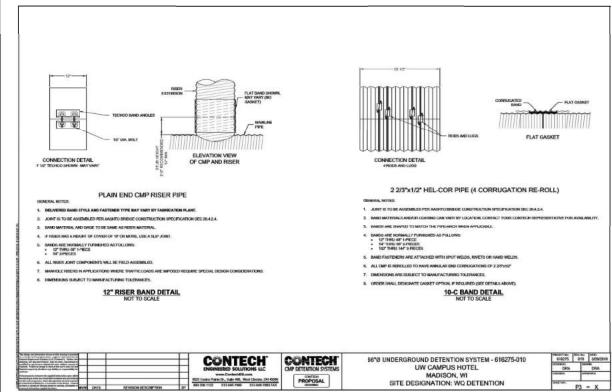

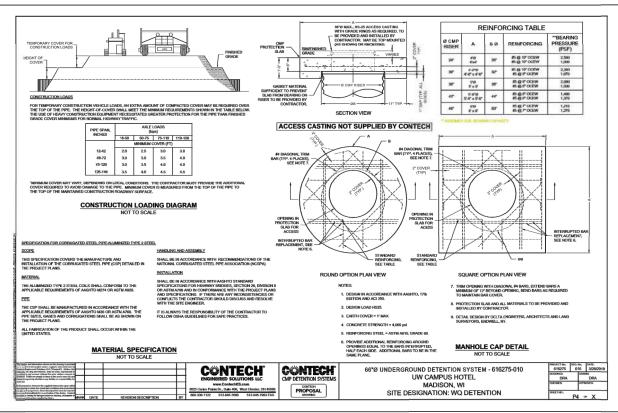

Revisions

LUA SUBMITTAL

SCOPE DOCUMENTS

Drawing Date April 12, 2019

UW CAMPUS HOTEL

780 Regent Street Madison, WI 53715

\_\_\_\_

218051

Sheet Title

CONSTRUCTION DETAILS

Copyright © 2018 Kahler Slater, Inc. All rights reserved.


111 West Wiscons in Avenue, Manaukee, Wiscons in 53203
Telaphone 414-272-2000 Fax 414-272-2001

44 East Millin Street, Suite 700, Madison, Wiscons in 53703

Telephone 608-283-6300 Fax 608-283-6317

Sheet No.

C502

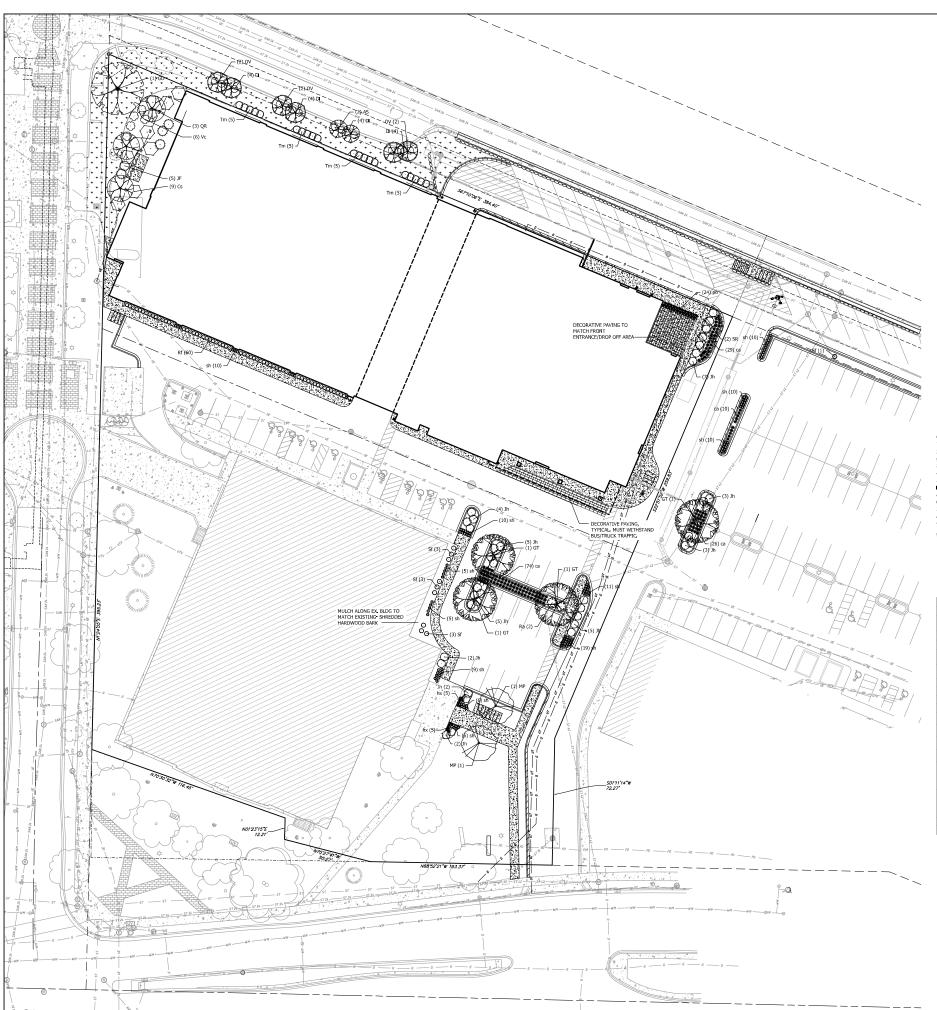

#### PLANT SCHEDULE

DECIDUOUS TREES	BOTANICAL NAME / COMMON NAME	CONT	CAL	QTY
AS	Acer saccharum `Apdilo` TM / Apdilo Sugar Maple 30` x 10`	B & B	2.5"Cal	2
GT	Gledita a triacanthos 'Northern Acdam' / Northern Acdam Honeylocust	B & B	2.5"Ca	4
GD	Gymnod adus diolca `McKBranched` / Decaf Kentucky Coffee Tree 50` x 40`	B & B	2.5"Cal	1
ov	Ostrya ving niana / American Hophornbeam 25` x 15`	B & B	2.5"Cal	6
QR	Quercus robur x blcclor `Long` / Regal Prince Oak 45` x 18`	B & B	2.5"Cal	3
UNDERSTORY TREES	BOTANICAL NAME / COMMON NAME	CONT	CAL	QTY
MP	Malus x `Prante Matd` / Prante Matd Crabapple 20` x 25`	B & B	2"Ca	-
SR	Sylinga reticulata `Ivory Silk` / Ivory Silk Japanese Tree Lilac 25` x 15`	B & B	2"Cal	2
DECIDUOUS SHRUBS	BOTANICAL NAME / COMMON NAME	SIZE	FIELD2	QTY
Cs	Cornus sericea / Red Twig Dogwood 7-9' x 8-10'	5 gal	Cont	9
Di	Dierv∎alonicera / Dwarf Bush Honeysuckle 3-4` x 4-5`	5 gal	Cont	16
Rf	Rhamnus frangula `Fine Line` / Fine Line Buckthorn 5-7` x 2`	5 gal	Cont	60
Ra	Rhus aromatica `Gro-Low` / Gro-Low Fragrant Sumac 2-3` x 6-8`	5 gal	Cont	2
Sf	Sciraea fritschiana `Pink a licious` / Pink a licious Fritch Spirea 2-3` x 2-3`	3 gal	Cont	10
Vc	Mburnum casand des / Witherod Mburnum 5-6`x 5-6`	5 gal	Cont	6
EVERGREEN SHRUBS	BOTANICAL NAME / COMMON NAME	SIZE	FIELD2	<u>QTY</u>
JF.	Juniperus chinensis `Fairview` / Fairview Juniper 15-20` x 6-7`	B & B	6` ht.	5
Jh	Juniperus horizontalis `Blue Chip` / Blue Chip Juniper 8-10" x 6-8'	5 gal	Cont	38
Tm	Taxus x media `Hicksii` / Hicks Yew 6-15` x 4-6`	10 ga	Cont	20
PERENNIALS	BOTANICAL NAME / COMMON NAME	SIZE	FIELD2	QTY
ca	Calamagrostis x aculiflora `Karl Foerster` / Feather Reed Grass 3-5` x 2`	1 ga	Cont	139
hx	Hemerocallis x `Stella de Oro` / Stella de Oro Daylly 12-18" x 16-24"	1 ga	Cont	10
ро	Polystichum acrosticho des / Christmas Fern 1-3'	1 ga	Cont	24

### SEEDING/DECORATIVE PAVING SCHEDULE

DECORATIVE PAVING 893 sf

TURF GRASS SOD 5,078 sf

- GENERAL NOTES:

  1. All plannings shall conform to quality requirements as per ANSI 260.1.

  2. All plann material shall be true to the species, variety and size specified, nursery grown in accordance with good hortical braid project side.

  3. Contact Landscape Architect, in writing, to request and plant material substitutions due to availability issues.

  4. All distributed areas, unless otherwise noted, to be solded with kentucky bluegrass fur sod grown in sod.

  5. All plants shall be guaranteed to be in healthy and louisting condition during the growing season following instellation. All plant material shall be guaranteed for one year from the time ofinistallation.

  6. Contractor shall provide a suitable amended topsall blend for all planning areas where sad conditions are unsuitable for glant growth. Topsal shall conform to qualify requirements as per Section 625.2(1) of the Standard Specifications for Highway Construction. Provide a minimum of 12° of topsal in all planting areas and 6° of topsal in areas to be seeded/socided.

  7. Landscape beds to be mulched with ½° washed stone mulch to 3° depth min. and edged with commercial grade duminum landscape edging, Permaloc Cleanline ½° x 4° or equal, color black anadzed.

Address:	780 Regent St		Date:	04.11.2019					
Total Square Footage of Developed Area:	(Site Area)	51737	-	(Building Footprint at Grac		38023	-	13714	st
Total Landscape Points Required:		13,714	/ 300 =	46	x 5 =	229			Γ
									I
			Credits/ Existing Landscaping		New/ Proposed Landscaping				
Plant Type/ Element	Min. Size at Installation	Points	Quantity	Points Achieved	Quantity	Points Achieved			Γ
Overstory deciduous tree	2.5" cal	35		0	4	140			Т
Tal Evergreen Tree	5-6 feet tall	35		0		0			Т
Ornamental tree	1.5" cal	15		0	2	30			Т
Jpright evergreen shrub	3-4 feet tall	10		0	5	50			Т
Shrub, deciduous	#3 gallon container size, Min. 12-24"	3		0	75	225			Ι
Shrub, evergreen	#3 gallon container size, Min. 12-24"	4		0	7	28			Τ
Ornamental grasses/perennials	#1 gallon container size, Min. 8-18"	2		0	63	126			Γ
Ornamental/decorative fencing or wall	n/a	4 per 10 LF		0		0			Γ
Existing significant specimen tree	Min. Size 2.5" cal. Trees must be within developed area and cannot comprise more than 30% of total required points.	14 per caliper inch. Max. points per tree: 200		0		0			
andscape Furniture for public leating and/or transit connections	Furniture must be within developed area, publicly accessible, and cannot comprise more than 5% of total required points	S points per "seat"		0		0			
Sub Totals				0		599			T







Revisions

LUA SUBM**I**TTAL

SCOPE DOCUMENTS Drawing Date APRIL 12, 2019

UW CAMPUS HOTEL

780 Regent Street Mad son, WI 53715

Project No. 218051

Sheet Title

LANDSCAPE PLAN

Copylight © 2018 Kahler Stater, Inc. / III lights reserved 111 West Wiscons in Avenue, Milwaukee, Wiscons in 53203 Telephone 414 272 2000 Fax 414 272 2001

Sheet No. L101

LUA SUBMITTAL

SCOPE DOCUMENTS
Drawing Date
APRIL 12, 2019

UW CAMPUS HOTEL

780 Regent Street Madison, WI 53715

218051


ARCHITECTURAL SITE PLAN/SIGNAGE

Copyright © 2019 Kahler Slater, Inc. All rights reserved.

111 West Wisconsin Avenue, Milwaukee, Wisconsin 53203 Telephone 414.272.2000 Fax 414.272.2001

44 East Mifflin Street, Suite 700, Madison, Wisconsin 53703 Telephone 508,263,6300 Fax 608,263,6317 Sheet No.

A000

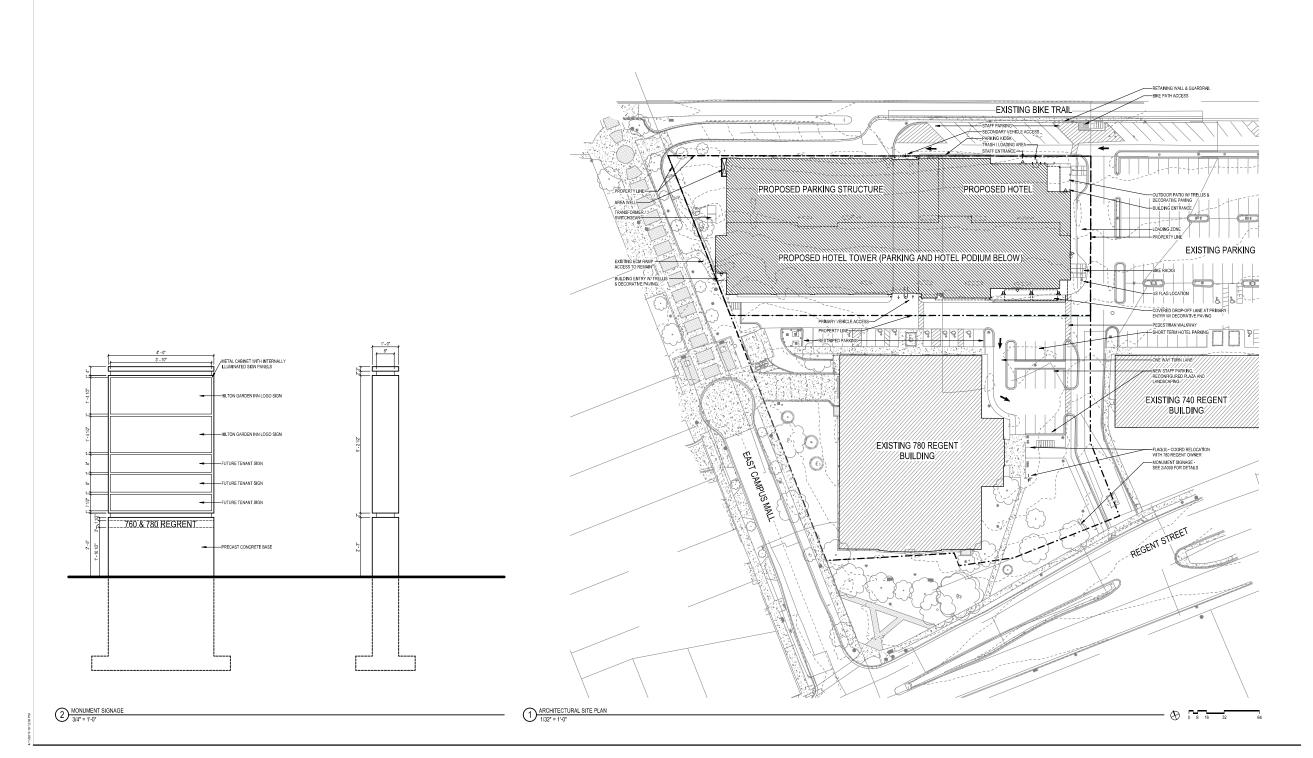

KEYNOTES

III LINES SUITE

III WALKEN FREZERCOOLER - PROVIDE CLOSURE PANEL FROM CÉLING TO TOP OF FREZERCOOLER
UNTS - COORDINATE RECESSED SLA REQUIREMENTS WITH OC J'STRUCTURAL EMGNEER

IZO STRUCTURAL EMGNEER

IZO STRUCTURAL EMGNEER

IZO MULTORE - DE ENTIRE CONTRAITE ALL PENETRATTANS WI NEP

IZO MULTORE - DE ENTIRE CONTRAITE - PRETINATION WITH PRETINATION WITH PRETINATION STATES

IZO ALL PROMISSION OF THE CHINOLUSE PROGRAMMAL

IZO ALL PROSERVE O' - PRETINATION FOLIATED PAREL

IZO ALL PROSERVE

GENERAL NO LES

1. BULDING SHALL BE CONSTRUCTED TO MEET THE REQUIREMENTS AND QUALITY LEVEL DESCRIBED IN CURRENT HILTON GARDENINN DESCRIBLAND.
2. VERIF DIMENSIONS, COMPRISON HILTON GARDENINN DESCRIBLAND.
2. VERIF DIMENSIONS, COMPRISONS AND FINANCIS FINENT TO PRICING OR OR CONTROL OF THE CONT

DRAWINGS.

11. PROVIDE FURRING PARTITION TYPE (IAD AT COLUMN LOCATIONS - TYPICAL.

NOT FOR CONSTRUCTION

LUA SUBMITTAL

SCOPE DOCUMENTS

APRIL 12, 2019

**UW CAMPUS HOTEL** 

780 Regent Street Madison, WI 53715

218051

Sheet Title LEVEL 1 PLAN

Copyright @ 2019 Kahler Slater, Inc. All rights reserved. 111 West Wisconsin Avenue, Milwaukee, Wisconsin 53203 Telephone 414.272.2000 Fax 414.272.2001

Sheet No. A101

PARKING REGULAR COMPACT ADA VAN ADA

PARKING TOTALS

CONC STOOP W/TRELLIS ABOVE - SEE STRUCT

01 FIRST FLOOR PLAN
3/32" = 1'-0"



PLAN LEGEND

OFD

FE

**Ø** 

Ğ


FIRE EXTINGUISHER (FE)

ALIGN FACE OF WALLS

FLOOR DRAIN

INDICATES HEARING IMPAIRED GUESTROOM INDICATES ACCESSIBLE GUESTROOM

KEYNOTES

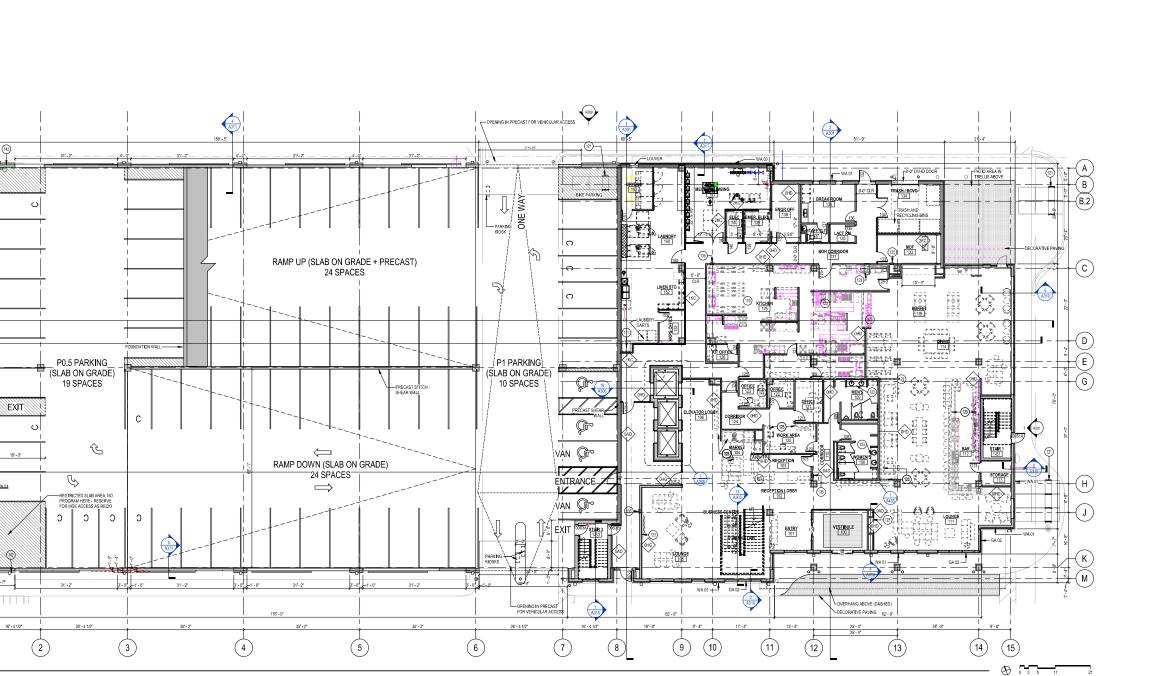

GENERAL NOTES

1. BUILDING SIANLI BE CONSTRUCTED TO MEET THE REQUIREMENTS AND QUALITY LEVEL DESCRIBED IN CURRENT HILTON GARDEN INN DESIGN U.M.O. OR LEVEL DESCRIBED IN CURRENT HILTON GARDEN INN DESIGN U.M.O. OR LEVEL DESCRIBED IN CURRENT OF HILDING OR PRICING OR AND THE CONTROL OR THE CONTROL OR C

NOT FOR CONSTRUCTION

LUA SUBMITTAL

SCOPE DOCUMENTS

Drawing Date
APRIL 12, 2019

UW CAMPUS HOTEL

780 Regent Street Madison, WI 53715

Project No. 218051

LEVEL P2 PLAN -PARKING

Copyright © 2019 Kahler Slater, Inc. All rights reserved. 111 West Wisconsin Avenue, Milwaukee, Wisconsin 53203 Telephone 414.272.2000 Fax 414.272.2001

44 East Mifflin Street, Suite 700, Madison, Wisconsin 53703 Telephone 608, 283,6300 Fax 608, 283,6317 Sheet No.

A102

- 📎 📆 📆







FE **Ø** 

INDICATES HEARING IMPAIRED GUESTROOM INDICATES ACCESSIBLE GUESTROOM


KEYNOTES

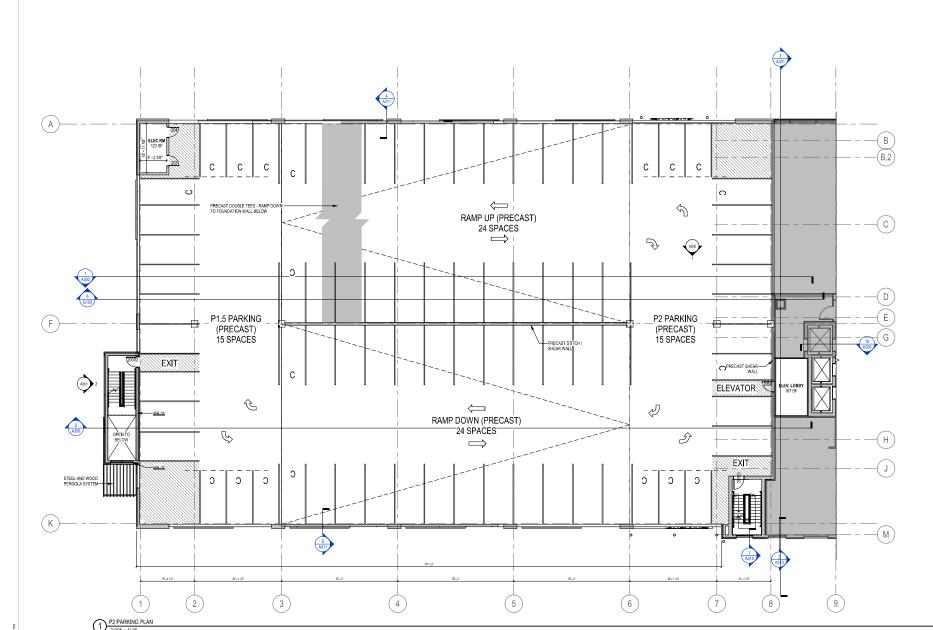


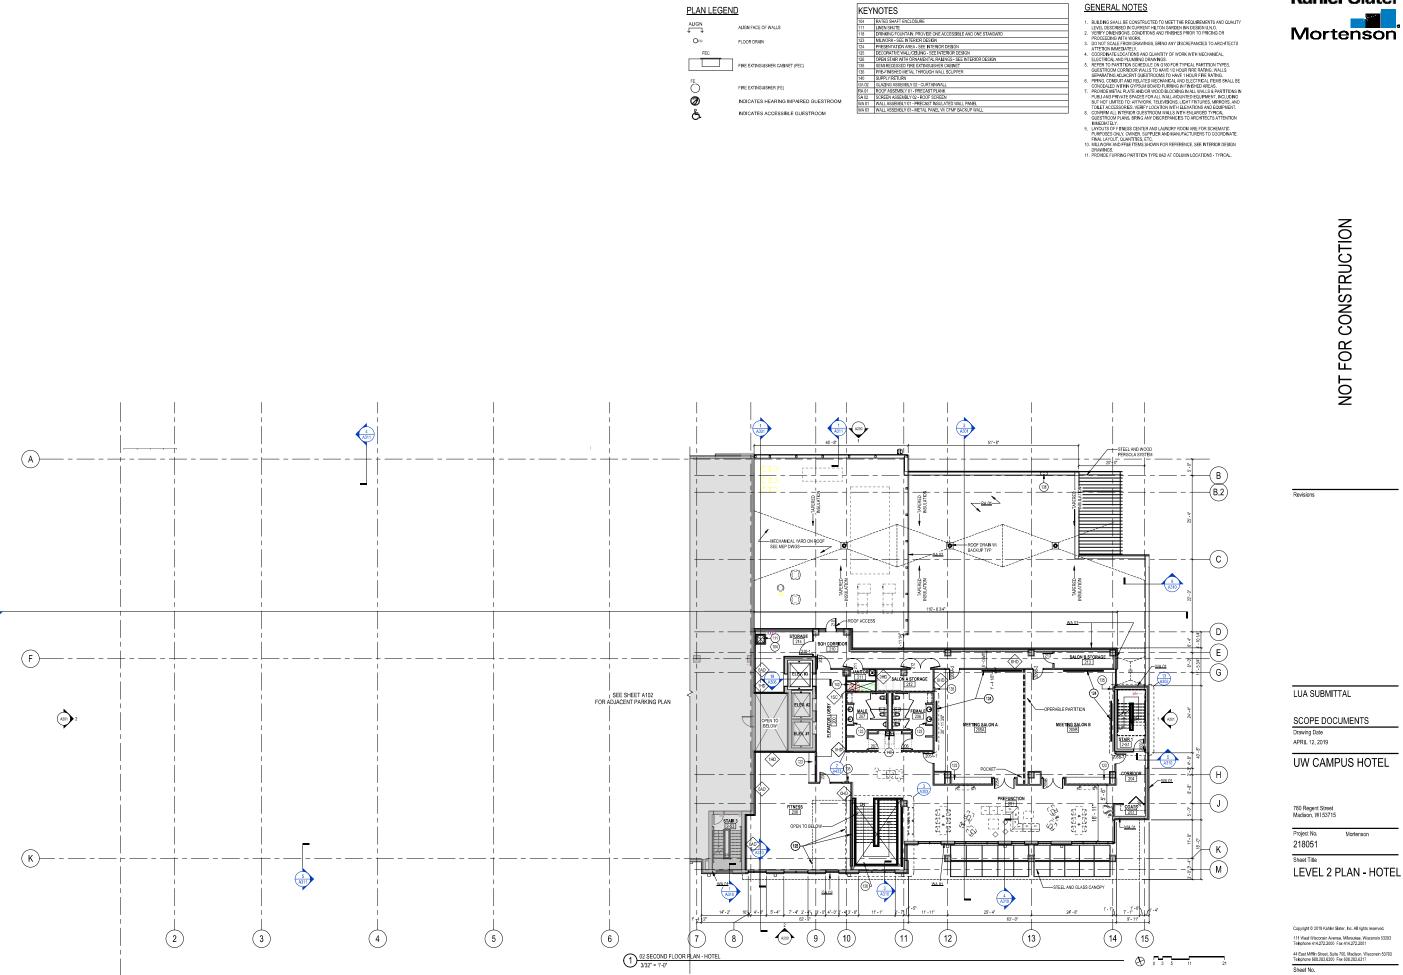




A103

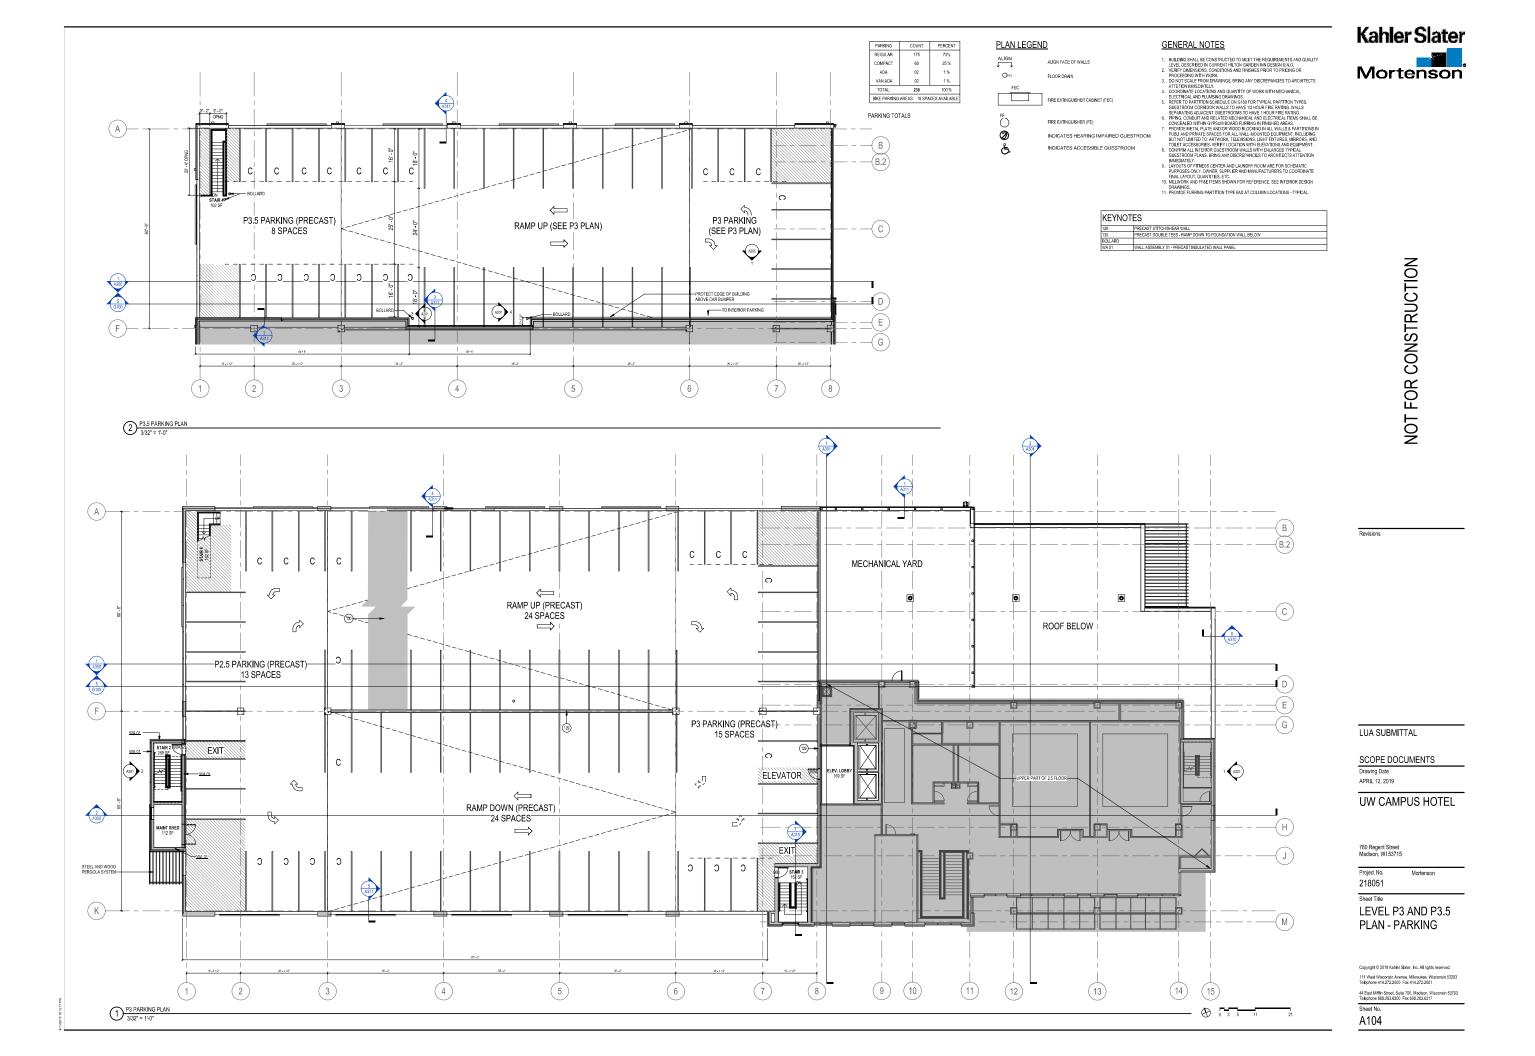

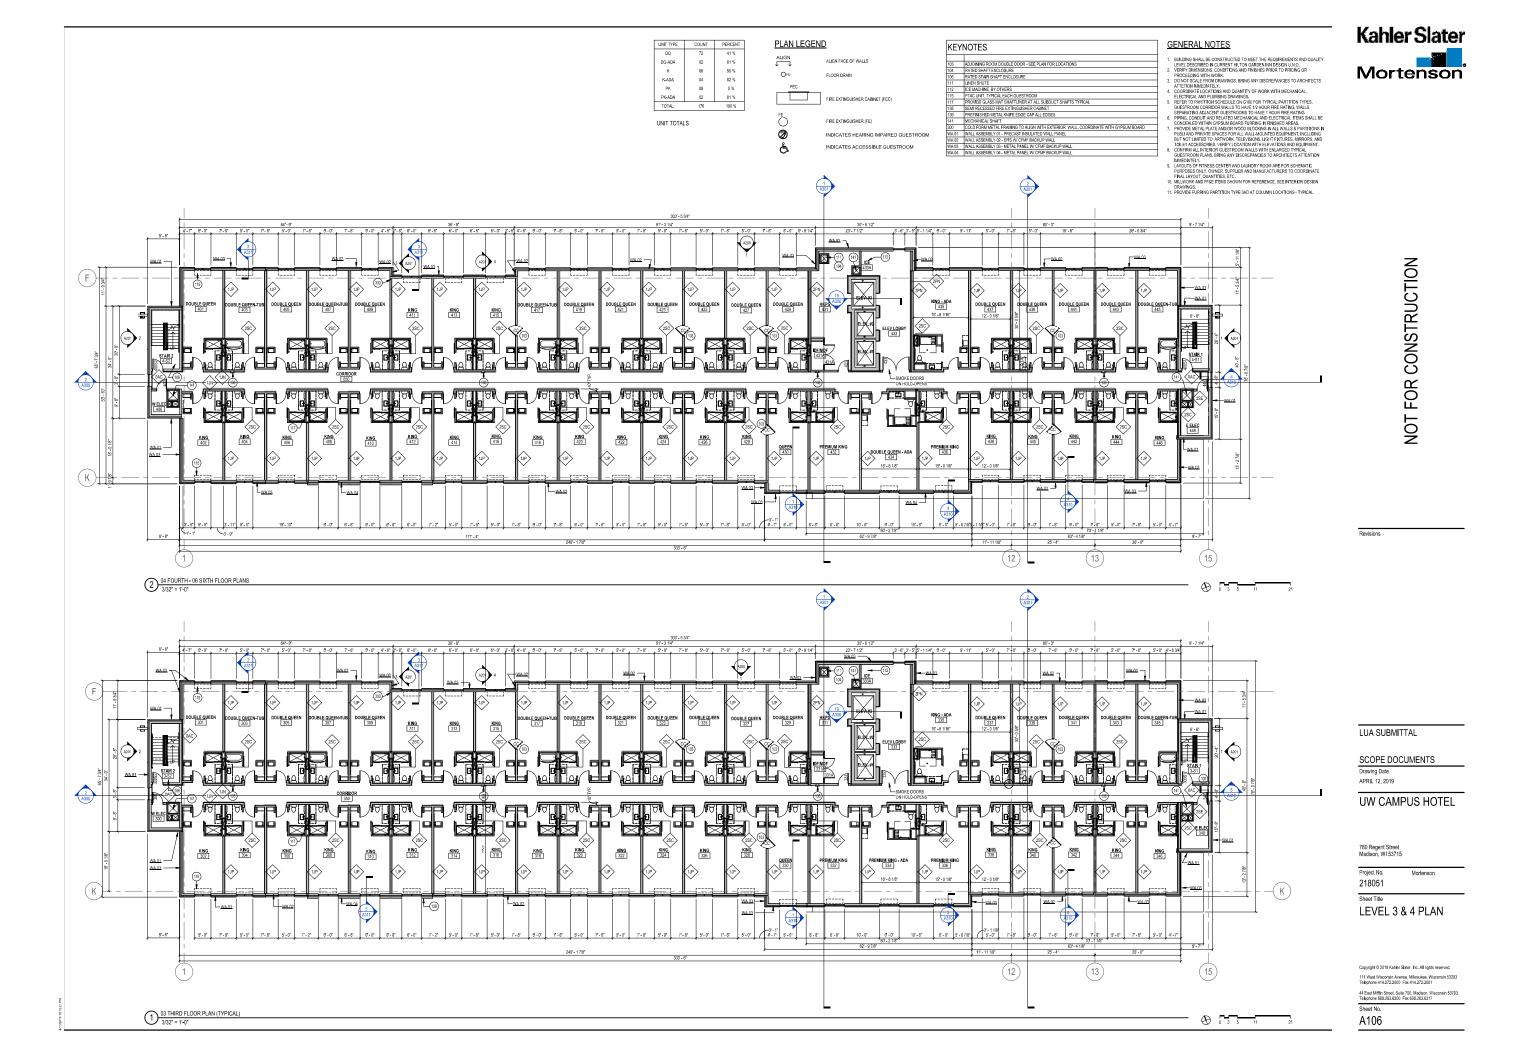

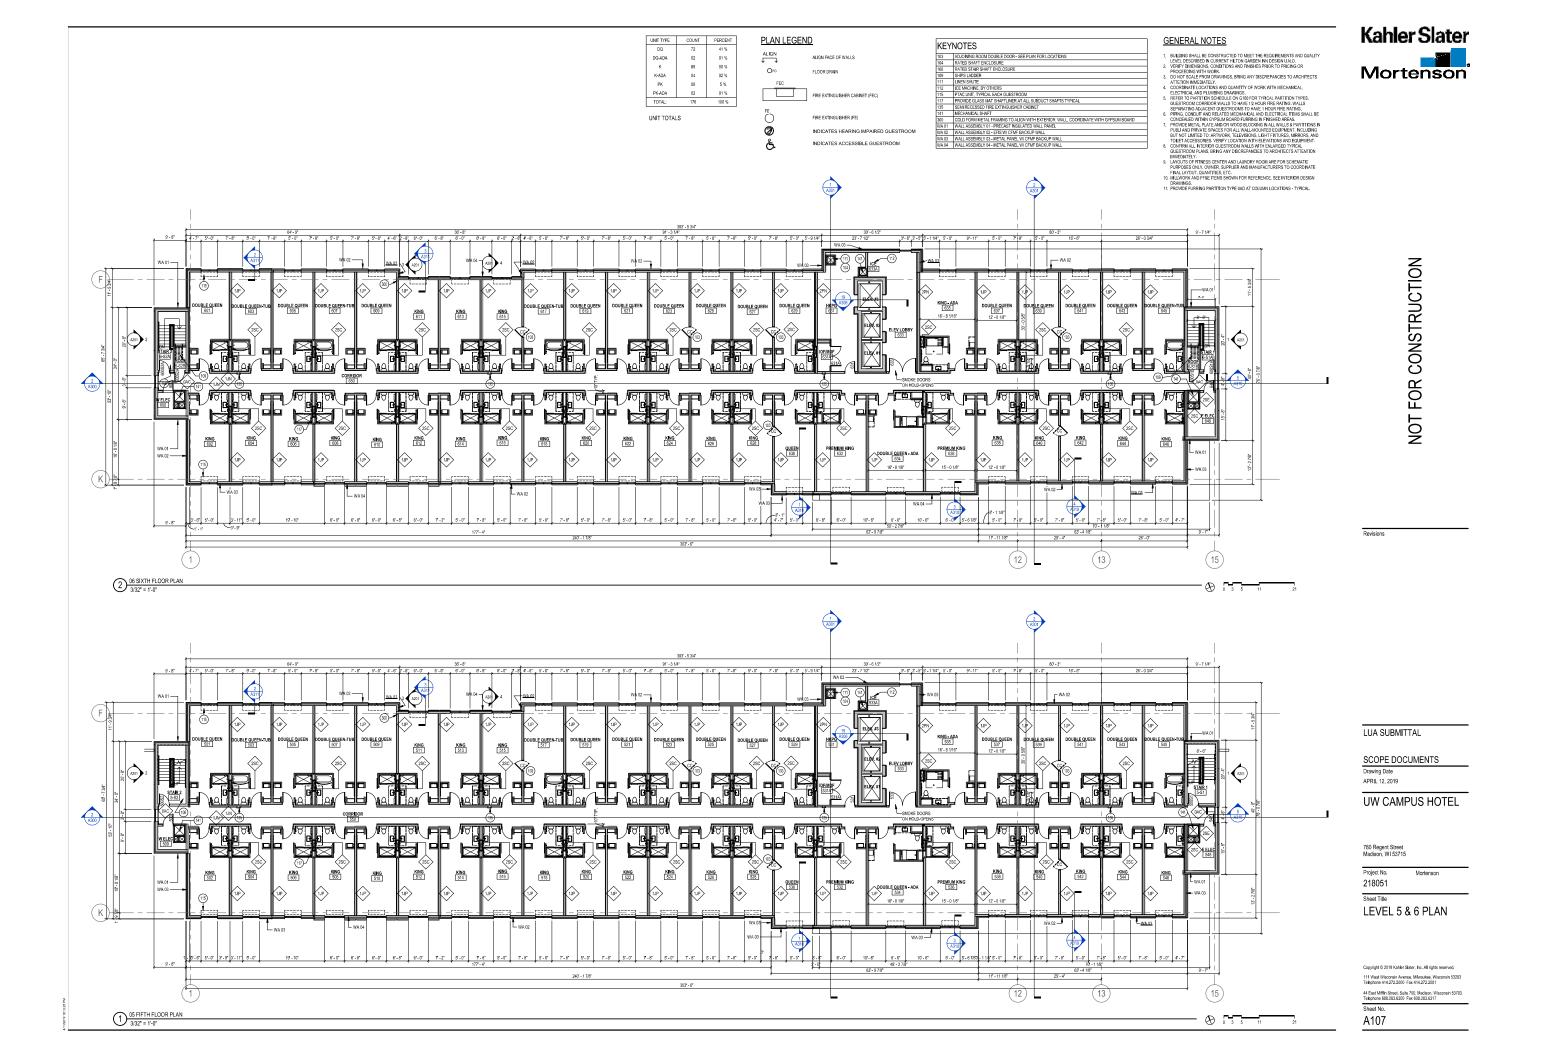




ALIGN FACE OF WALLS

KEYNOTES

PLAN LEGEND

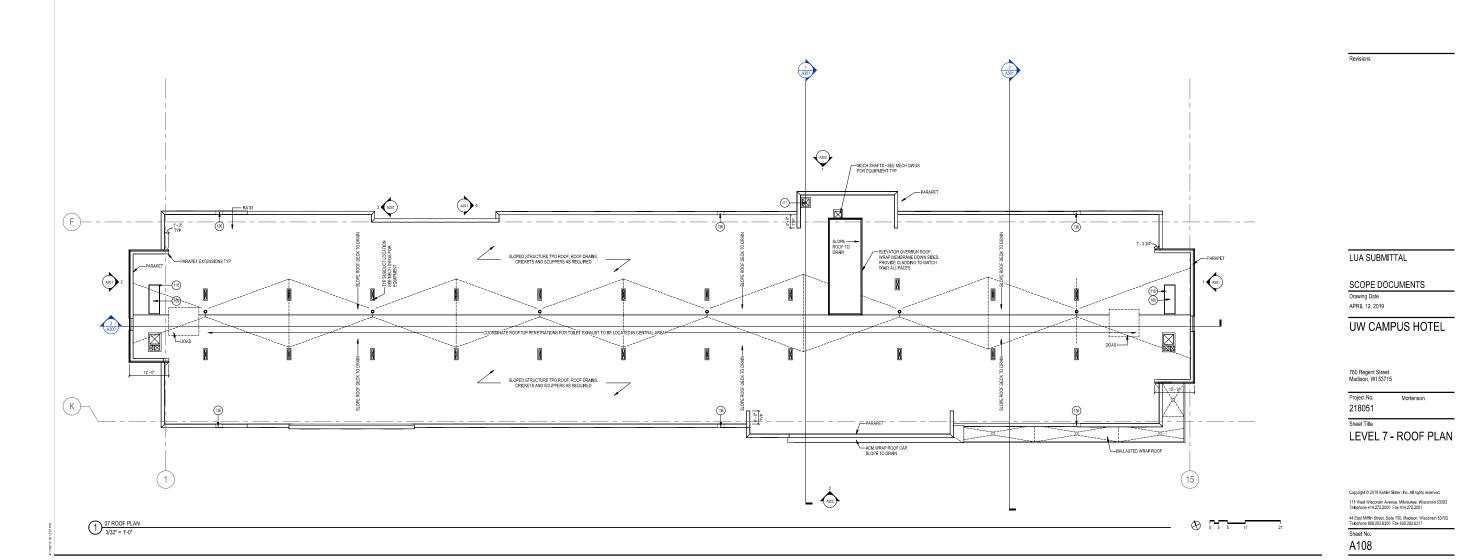



KEYNOTES

BIKE RACK
MESH PANEL WITH SUPER GRAPHIC
MESH PANEL
PREFINISHED METAL KNIFE EDGE CAP ALL EDGES
ALL WALLUAMS TO MATCH WARI FINISH OUTER 3

A200

