LAND USE APPLICATION

City of Madison Planning Division 215 Martin Luther King Jr. Blvd. P.O. Box 2985 Madison, WI 53701-2985 (608) 266-4635



All Land Use Applications must be filed with the Zoning Office at the above address.

This completed form is required for all applica or Plan Commission review except subdivisions or land divisions, which should be Subdivision Application found on the City's web site.

FOR OFFICE USE ONLY:

Paid		Receipt #	ŧ	
Date	received			
Rece	ived by			
Parc	el #			
Alde	rmanic district			
Zoni	ng district			
Spec	ial requirements			
Revi	ew required by			
	UDC		PC	
	Common Council		Other	
Revi	ewed By			

LND-B

1. Project Information

ŀ	٩dd	ess:1936 & 1938 Atwood Ave	
٦	Title		
2. 1	۲his	s an application for (check all that apply)	
[X	Zoning Map Amendment (rezoning) from PD to TSS	
[Major Amendment to an Approved Planned Development-General Development Plan (PD-GDP) Zoning	
[Major Amendment to an Approved Planned Development ta	
[Review of Altera o Planned Development (PD) (by Plan Commission)	
[X	era o an Approv	

□ ermit

□ Other requests

3. Applicant, Agent and Property Owner Information

Applicant name	Јое Кгирр	Company1938 Atwood Avenue LLC	
Street address	2030 Eastwood Drive	City/State/ZipMadison, WI 53704	
Telephone	608-233-6000	_Emailjoe@primeurbanproperties.com	
Project contact personKevin Burow		Company <u>Knothe & Bruce Architects, LLC</u>	
Street address	7601 University Ave. Suite 201	City/State/ZipMiddleton, WI 53562	
Telephone	(608)836-3690	Emailkburow@knothebruce.com	
Property owner (if not applicant)			
Street address		City/State/Zip	
Telephone		Email	

Land Use Application		LND-B
4. Project Description		
	of the project and all proposed uses of the apartment building with underground pa	
Scheduled start dateA	pril 2019 Planned completior	n date April 2020
5. Required Submittal Materi	als a la chaireann an an ann an ann	
Refer to the Land Use Appli	cation Checklist for detailed submittal requ	lirements.
I Filing fee	🖾 Pre-application notification	Land Use Application Checklist (LND-C)
🛛 Land Use Application	🛛 Vicinity map	Supplemental Requirements
🖾 Letter of intent	Survey or existing conditions site plan	Ilectronic Submittal*

*Electronic copies of all items submitted in hard copy are required. Individual PDF files of each item submitted should be compiled on a CD or flash drive, or submitted via email to pcapplications@cityofmadison.com. The email must include the project address, project name, and applicant name. Electronic submittals via file hosting services (such as Dropbox.com) are not allowed. Applicants who are unable to

I Development plans

provide the materials electronically should contact the Planning Division at (608) 266-4635 for assistance.

For concurrent UDC applications a separate pre-application meeting with the UDC Secretary is required prior to submittal. Following the pre-application meeting, a complete UDC Application form and all other submittal requirements must be submitted to the UDC Secretary. An electronic submittal, as noted above, is required. Electronic submittals should be compiled on a CD or flash drive, or sent via email to udcapplications@cityofmadison.com.

6. Applicant Declarations

Legal description

Pre-application meeting with staff. Prior to preparation of this application, the applicant is strongly encouraged to discuss the proposed development and review process with Zoning and Planning Division staff. Note staff persons and date.

Planning staff	Chris Wells	Date _	10/11/2018
Zoning staff	Jenny Kirchgatter (DAT Meeting)	Date _	10/11/2018

Demolition Listserv

□ Public subsidy is being requested (indicate in letter of intent)

Pre-application notification: The zoning code requires that the applicant notify the district alder and any nearby neighborhood and business associations in writing no later than 30 days prior to FILING this request. List the alderperson, neighborhood association(s), business association(s), AND the dates you sent the notices:

Alder Rummel #6, Schenk-Atwood-Starkweather-Yahara Neighorhood Assoc

Brad Kuse & Brad Hinkfuss, 9-24-2018

The alderperson and the Director of Planning & Community & Economic Development may reduce the 30-day requirement or waive the pre-application notification requirement altogether. Evidence of the pre-application notification is required as part of the application materials. A copy of the notification letters or any correspondence granting a waiver is required as part of the application materials.

The applicant attests that this form is accurately completed and all required materials are submitted:

Name of applicant	Relationship	to property _	
Authorizing signature of property owner _	J	Date _	11-21-18

City of Madison Planning Divisior 215 Martin Luihe P.O. Box 2985 Madison, WI 537 (608) 266-4635 All Land Use App Zoning Office at t	er King Jr. Blvd.	Date received Received by Parcei # Aldermanic district Zoning district	Receipt #
subdivisions or la	nd divisions, which should be bdivision Application found on		☐ PC ☐ Other
1. Project Information Address: Title:	on 1936 & 1938 Alwood Ave.		
 Zoning Map A Major Amend Major Amend Major Amend Review of Alto Conditional U Demolition Pe Other request 	ts	pment-General Develop pment-Specific Impleme (by Plan Commission)	ment Plan (PD-GDP) Zoning
Applicant name Street address Telephone	Ind Property Owner Information Joe Krupp 2010 Eastwood Drive 608-233-6000 rson Kevin Burow 7601 University Ave. Suite 201 (608)836-3690 not applicant) 1924 Alwood LLC	_Gity/State/Zip _Middle _Emailkburow@kn }	ilson, WI 53704 Irbanproperties.com Bruce Architects, LLC Iton, WI 53562 othebruce.com
Street address Telephone	<u>121 S. Pickney St, Suite 200</u> (608)-256-4200	_City/State/ZipMadis _Emailscotl@cmima	

Land/Use Application

e na

4. Project Description

Provide a brief description of the project and all proposed uses of the site:

A four story mixed-use apartment building with underground parking & public parking

Scheduled start date _____ April_2019 _____ Planned completion date _____ April_2020

5. Required Submittal Materials

Refer to the Land Use Application Checklist for detailed submittal requirements.

凶	Filing fee	凶	Pre-application notification	凶	Land Use Application Checklist (LND-C)
X	Land Use Application	X	Vicinity map	X	Supplemental Requirements
X	Letter of Intent	X	Survey or existing conditions site plan	X)	Electronic Submittal*
X)	legal description	X	Development plans		

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Planning staff	Chris Weils	Date10/11/2018	
Zoning staff	Jenny Kirchgalter (DAT Meeting)	Date 10/11/2018	

Demolition Listserv

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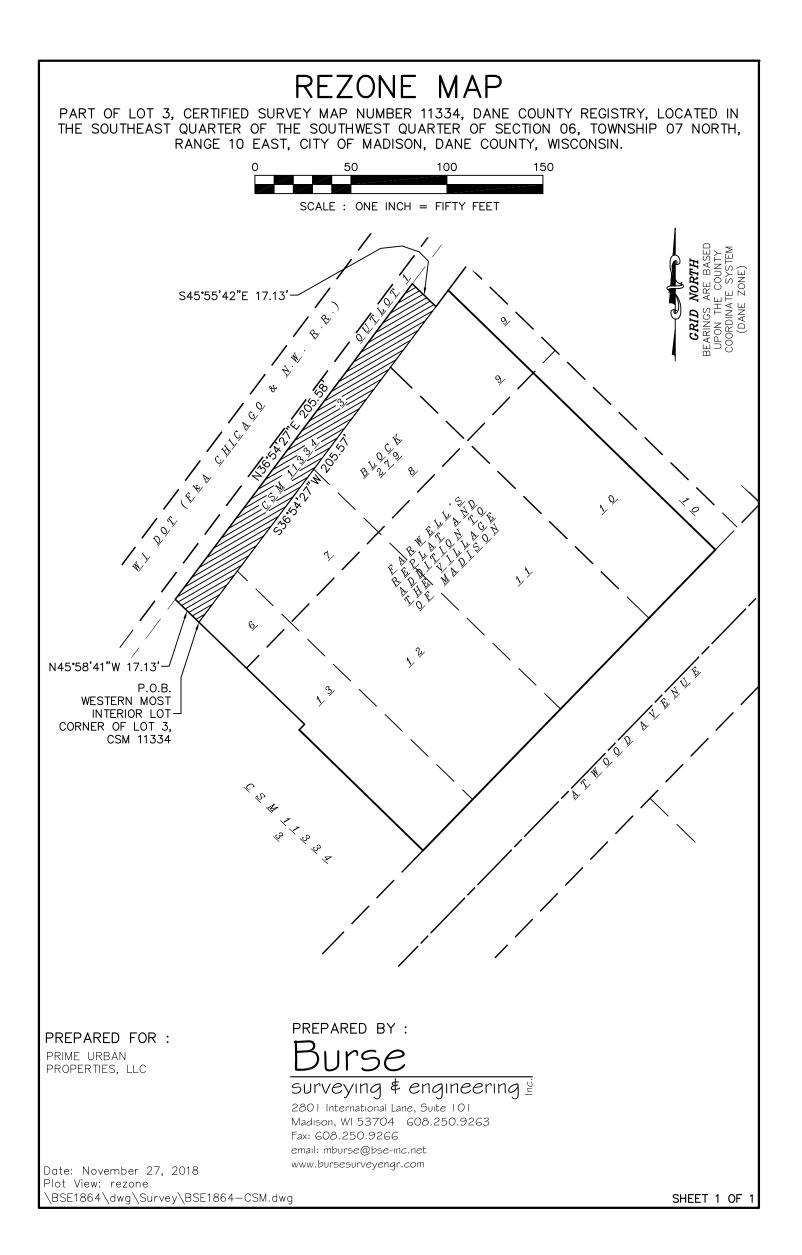
Alder Rummel #6, Schenk-Alwood-Starkweather-Yahara Neighorhood Assoc

Brad Kuse & Brad Hinkfuss, 9-24-2018

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The applicant attests that this form is accurately completed and all required materials are submitted:

Name of applicant Scott Lewis Relationship to property Owner	
Authorizing signature of property owner Congression Date DateDAteDAteDAte	
	-



FOR OFFICE USE ONLY: City of Madison Paid ______ Receipt # _____ **Planning Division** 215 Martin Luther King Jr. Blvd. Date received P.O. Box 2985 Madison, WI 53701-2985 Received by (608) 266-4635 Parcel # Aldermanic district Zoning district All Land Use Applications must be filed with the Zoning Office at the above address. Special requirements This completed form is required for all Review required by applications for Plan Commission review except D PC UDC subdivisions or land divisions, which should be Other _____ filed using the Subdivision Application found on Common Council the City's web site. Reviewed By 1. Project Information 1936 & 1938 Atwood Ave. Address: Title: 2. This is an application for (check all that apply) TSS PD ____to _____ Zoning Map Amendment (rezoning) from _____ X Major Amendment to an Approved Planned Development-General Development Plan (PD-GDP) Zoning □ Major Amendment to an Approved Planned Development-Specific Implementation Plan (PD-SIP) Review of Alteration to Planned Development (PD) (by Plan Commission) Conditional Use or Major Alteration to an Approved Conditional Use X **Demolition** Permit Other requests 3. Applicant, Agent and Property Owner Information Company _____1938 Atwood Avenue LLC Joe Krupp Applicant name City/State/Zip Madison, WI 53704 2010 Eastwood Drive Street address Email joe@primeurbanproperties.com 608-233-6000 Telephone Company Knothe & Bruce Architects, LLC Project contact person ___Kevin Burow 7601 University Ave. Suite 201 ____City/State/Zip __Middleton, WI 53562 Street address _Email ____kburow@knothebruce.com (608)836-3690 Telephone

 Property owner (if not applicant)
 Second Street Apartments, LLC

 Street address
 2209 Lakeland Ave.
 City/State/Zip
 Madison, WI 53704

 Telephone
 (608)-467-3220
 Email
 liz@lauerRealtyGroup.com

Land Use Application

Scheduled start date

4. Project Description

Provide a brief description of the project and all proposed uses of the site:

Rezoning only and will remain in it's current use of being part of the parcel of land for

Second Street Apar	tments	
المراجع		
Echodulad start date	n/a	Planned completion daten/a

5. Required Submittal Materials

n/a

Refer to the Land Use Application Checklist for detailed submittal requirements.

I Filing fee	Pre-application notification	凶 Land Use Application Checklist (LND-C)
Image and Use Application	🖾 Vicinity map	Supplemental Requirements
 ☑ Land Use Application ☑ Letter of intent 	区 Survey or existing conditions site plan	図 Electronic Submittal*
 Legal description 	Development plans	

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Alder Rummel #6, Schenk-Atwood-Starkweather-Yahara Neighorhood Assoc


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The applicant attests that this form is accurately completed and all required materials are submitted:

Name of applicant Ning Z Lebwonl, 1	member	Relationship to proper	y DUDNEr
Second Street Aper	topents up	$n \cap$	1 2- 2-18
Name of applicant <u>NMAX</u> CONDOMIC Second Street Aper Authorizing signature of property owner	Almar X	burn Dat	e <u>11-30-2018</u>
	171		

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September 24, 2018

Alder Marsha A. Rummel Alderperson – District # 6 district6@Cityofmadison.com

Schenk-Atwood-Starkweather-Yahara Neighborhood Association Brad Kuse bradkuse@gmail.com Brad Hinfuss bradhinkfuss@gmail.com

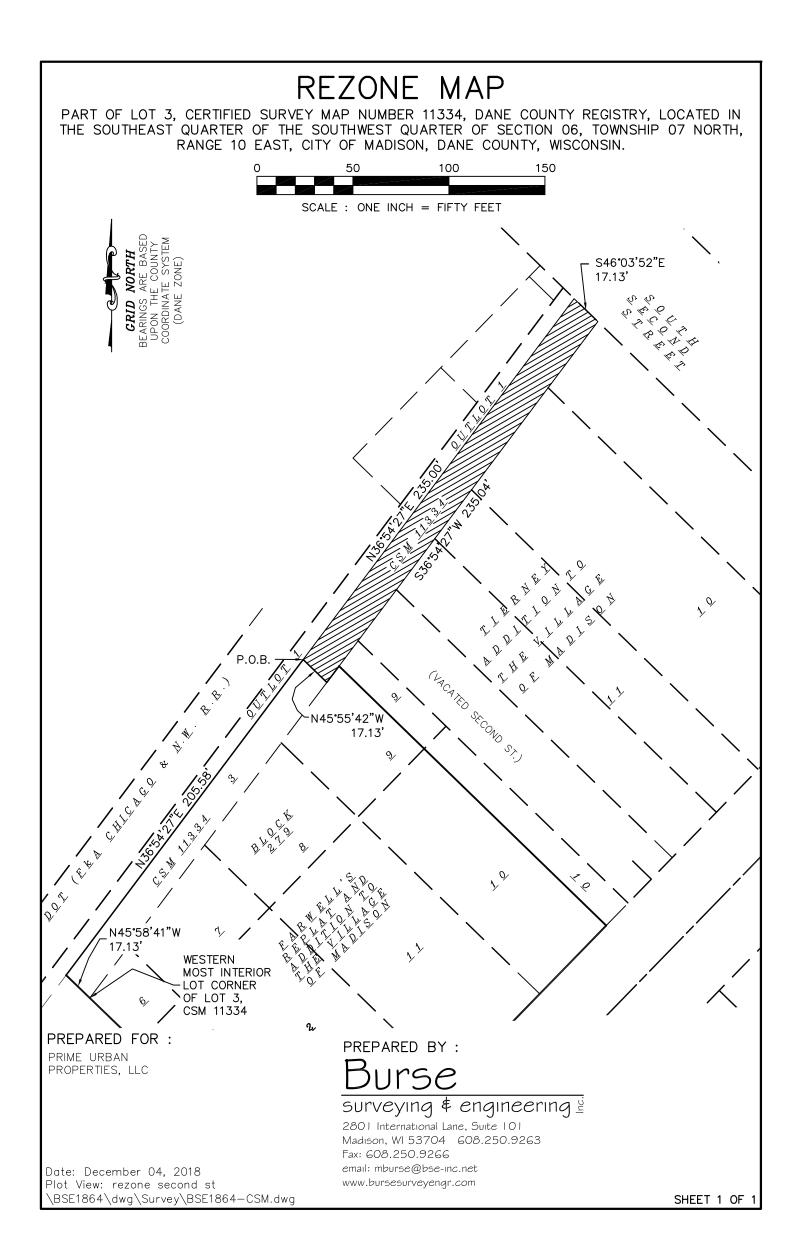Re: 1936 & 1938 Atwood Ave., Madison, WI

Marsha, Brad and Brad,

I would like to take this opportunity to formally notify you that we will be submitting an application for a rezoning & conditional use approval for a proposed redevelopment of the property at 1936 and 1938 Atwood Avenue. We will also be submitting an application for the demolition of the existing structure at 1936 Atwood Avenue.

The proposal envisions replacing the residence at 1936 and the adjacent surface parking lot with a fourstory mixed-use apartment building with 70-80 units in a range of sizes from studio, one and two bedroom apartments. The commercial area will be located on the first floor along Atwood Avenue. Parking will be provided behind the building and in an underground parking facility.

We look forward to working with you to design a successful development for this property. If you have any questions, please contact me at <u>kburow@knothebruce.com</u>.

Sincerely,

Kevin Burow

Managing Member

Legal Description

Site Address: 1936 & 1938 Atwood Avenue

PART OF LOTS 6-10, 13 AND ALL OF LOTS 11 AND 12, FARWELL'S ADDITION TO THE VILLAGE OF MADISON, PART OF LOT 3, CERTIFIED SURVEY MAP NUMBER 11334, DANE COUNTY REGISTRY, LOCATED IN THE SOUTHEAST QUARTER OF THE SOUTHWEST QUARTER OF SECTION 06, TOWNSHIP 07 NORTH, RANGE 10 EAST, CITY OF MADISON, DANE COUNTY, WISCONSIN, more fully described as follows:

Commencing at the Southwest corner of said Section 6; thence North 00 degrees 49 minutes 04 seconds East along the west line of said southwest quarter, 341.81 feet; thence South 89 degrees 10 minutes 57 seconds East, 1980.57 feet to the point of beginning; thence North 36 degrees 54 minutes 27 seconds East, 205.58 feet; thence South 45 degrees 55 minutes 42 seconds East, 17.13 feet; thence North 36 degrees 54 minutes 27 seconds East, 10.62 feet; thence South 45 degrees 50 minutes 24 seconds East, 193.95 feet to the northwest right of way of Atwood Avenue; thence South 44 degrees 11 minutes 44 seconds West along said northwest right of way, 218.44 feet; thence North 45 degrees 43 minutes 59 seconds West, 90.00 feet; thence North 44 degrees 16 minutes 01 second East, 4.00 feet; thence North 45 degrees 58 minutes 41 seconds West, 93.66 feet to the point of beginning.

November 28, 2018 Revised December 21, 2018

Heather Stouder Department of Planning & Development City of Madison 215 Martin Luther King Jr. Blvd PO Box 2985 Madison, Wisconsin 53701

Re: Letter of Intent – Conditional Use 1936 and 1938 Atwood Ave. Madison, WI

Ms. Heather Stouder,

The following is submitted together with the plans and application for the staff and plan commission consideration of approval.

Organizational Structure:

Owner/Developer:	1938 Atwood Avenue LLC 2030 Eastwood Drive Madison, WI 53704 Phone: 608-233-6000 Contact: Joe Krupp joe@primeurbanproperties.com	Engineer:	Burse Surveying & Engineering, Inc. 2801 International Lane, Ste. 101 Madison, WI 53704 Phone: 608-250-9263 Fax: 608-250-9266 Contact: Peter Fortlage
			<u>pfortlage@bse-inc.net</u>

Architect: Knothe & Bruce Architects, LLC 7601 University Avenue, Ste. 201 Middleton, WI 53562 Phone: 608-836-3690 Contact: Kevin Burow <u>kburow@knothebruce.com</u> Landscape Olson Toon Landscaping, Inc. Design: 3570 Pioneer Road Verona, WI 53593 Phone: 608-827-9401 Contact: Brad Fregien brad@olsontoon.com

Introduction:

The site is located at 1936 and 1938 Atwood Ave. on Madison's near east side. The majority of the site is currently utilized for surface parking with a converted house sitting on the southwest edge of the site. The proposed development entails the demolition of the existing rental building and the construction of a new four-story mixed-use building with include 79 apartments units, approximately 4,000 sq.ft. of commercial space and a total of 103 enclosed parking spaces.

Most of the subject site is zoned TSS, with a narrow strip of vacant land at the rear of the site currently zoned PD. The strip of land is being transferred from the owner of the apartment development to the southwest (the Hudson apartments) and is being requested to be rezoned to TSS. and is not essential to that development. The continuation of this strip of land to the east is also currently zoned PD and that is being requested to be rezoned to TSS as well.



Letter of Intent - December 21, 2018 – Conditional Use 1936 and 1938 Atwood Ave - Madison, WI Page 2 of 4

This application requests approval of the demolition, the rezoning of the strips of land to TSS and the conditional use approvals to allow for the proposed development. A CSM will be processed concurrently with this application that will combine the narrow strip of land with the balance of the parcel into a single lot.

Project Description:

The project continues the recent redevelopment and urban in-fill along the Atwood Avenue corridor. This development takes an underutilized site that is predominantly used for surface parking and creates a vibrant multi-use building that strengthens the urban architecture of Atwood Avenue. The building façades are well-proportioned and respect the rhythm of buildings on the street. The street level is activated with commercial storefront and a strong corner entry and lobby for the apartments above. The vehicular access to the enclosed parking is screened from street view by being located along the northeast side of the proposed building.

A three-foot to nine-foot building setback on Atwood allows for a comfortable pedestrian experience while also respecting the urban pattern that is established at Schenk's Corner and throughout the neighborhood commercial. The setback provides the room for landscaping to enhance the building and provide an attractive buffer for pedestrians. The streetscape will also be enhanced by planting the street terrace (the terrace is currently concrete) and adding street trees. The existing overhead utilities that consist solely of low voltage communication lines are planned to be buried as part of the redevelopment.

The exterior materials will be a combination of masonry at the lower levels, metal siding on the upper levels with a manufactured cut stone base. The architecture is contemporary and urban with detailing that reinforces the rhythm and scale of the building.

Neighborhood Input:

The SASY and MNA planning and development committees have been introduced to the development and are generally supportive of the proposal. A neighborhood meeting was hosted by Alder Rummel on November 19, 2018 and the attendees provided input to improve the project including suggestions on building architecture, landscaping and storm water management. Our application includes revisions to the initial plans in an effort to address the neighborhood input.

From the neighborhood's perspective, the most important feature of the project is the provision of public-use parking. Although privately owned, the existing surface parking lot is well used by the public and fills a critical parking need for neighborhood businesses, particularly the food and beverage establishments. With this plan we are able to provide parking on the first floor level that will be available to the public. The parking needs for the residential and commercial tenants of the building is accommodated in the basement level parking garage. All of the parking on the first floor can then be available for uses not associated with this building.

Parking:

Two levels of enclosed parking are provided with 84 stalls in the basement level and 36 stalls on the first floor level for a total of 120 stalls. This total will serve the needs of the residential tenants as well as provide employee parking for the commercial users and the employees at 1965 Atwood Avenue during their business hours. This will also have 5 stalls dedicated to exclusive use by tenants of the Second Street Apartments to fulfill the existing requirements of the easement that is on this parcel for their parking needs.

Letter of Intent - December 21, 2018 – Conditional Use 1936 and 1938 Atwood Ave - Madison, WI Page 3 of 4

The first floor parking level is available to the public and the functional use of this is described in the attached Parking Operation Plan.

Demolition Standards

We believe that the demolition standards can be met. The proposed development is compatible with the Shenk-Atwood Neighborhood Business District Master Plan and the recently adopted City Comprehensive Plan. The demolition allows for the long sought-after redevelopment of this site, enhancing the neighborhood business district and adjacent residential properties, and continuing the pattern of redevelopment that has been established along Atwood Ave.

A Re-use and Recycling Plan will be submitted prior to the deconstruction of the existing wood frame structure.

Conditional Use approvals:

The proposed redevelopment requires conditional uses to allow a building over three-stories in height and for a residential building with more than 8 units. The proposed building's size, scale and use are consistent with adjacent properties and the City and neighborhood plans for this property. The conditional use approvals are necessary to achieve the goals of those plans.

A conditional use approval is also required due to the fact that there will a paid private parking facility on the first floor. As noted earlier, this parking is needed to help support the neighboring businesses, especially for evening and weekend use.

Site Development Data:

Densities:	
Lot Area	42,491 S.F. / .97 acres
Dwelling Units	79 DU
Lot Area / D.U.	500 S.F./D.U.
Density	81 units/acre
Open Space	10,094 S.F. (3,160 S.F. Min. Required)
Open Space / Unit	128 S.F./Unit (40 S.F./Unit Required)
Lot Coverage	34,960 S.F. = 82% of total lot (85% Max.)
Building Height:	4 Stories
<u>Gross Floor Areas:</u>	
Residential Area	75,291 S.F.
Commercial Area	4,000 S.F.
	.,
<u>Floor Area Ratio</u>	2.0
Dwelling Unit Mix:	
Efficiency	15
One Bedroom	37
One Bedroom + Den	12
Two Bedroom	<u>15</u>
Total	79

Letter of Intent - December 21, 2018 – Conditional Use 1936 and 1938 Atwood Ave - Madison, WI Page 4 of 4

<u>Vehicle Parking:</u>	
Underground	84 stalls
First Floor (enclosed)	<u>36 Stalls</u>
Total	120 Stalls
<u>Bicycle Parking:</u>	
Guest Surface	II (Std. 2'x6' guest stalls)
Underground Wall-Mo	unt l6
Underground	20 (Std. 2'x6' floor mount - Permanent)
First Floor Wall-Mount	5
First Floor	40 (Std. 2'x6' floor mount - Permanent)
Total	92 stalls

Project Schedule:

It is anticipated that construction will start Spring of 2019 and be completed in Spring of 2020.

Thank you for your time reviewing our proposal.

Sincerely,

Kei B

Kevin Burow, AIA, NCARB Managing Member

1936 and 1938 Atwood Avenue



Parking Operation Plan:

For this proposed development, two levels of enclosed parking are provided. The basement parking garage will have 84 stalls and will serve the needs of the residential tenants in the evening as well as provide employee parking for the commercial users and also the users of the existing building at 1965 Atwood Avenue during the day. Access to this level is separate from the first-floor parking level and is controlled by a FOB reader so only credentialed users will be able to enter this area.

The first-floor parking will have 36 stalls and is proposed as a public-private parking facility that will serve the neighborhood food and beverage establishments, especially during evening and weekend hours when the demand is the highest. The first-floor parking will be paid parking with controlled access and will be entered off of the shared driveway on the northeast side. This area will have a rapid access garage door at the entry along with gates to control the access. These gates will be tied to a ticket machine and a card reader/FOB to operate. Public patrons will pull a ticket upon entry and will pay via a credit card reader upon exiting. Local businesses will have the option to provide their customers with ticket vouchers to cover the cost of the parking and these will be read by this same control system. This area will also have 5 stalls dedicated to exclusive use by tenants of the Second Street Apartments to fulfill the existing requirements of the easement that is on this parcel for their parking needs.

The first-floor garage entry door is located 54'-6" back from the face of the building or 70' back from the entry point at the street curb at Atwood Avenue. This will provide stacking for 3 vehicles off of the street before entering the parking. There will be signage on the corner of the building designating that there is public parking and there will also be a sign above the garage entry door stating the same. The driveway is 20' wide to accommodate two-way traffic and given that Atwood Avenue is a one-way street directly in front of the property, vehicles will only be able to make a right turn in and a right turn out from this driveway.

1936 and 1938 Atwood Avenue



Building Height Request:

For this proposed development we are requesting Conditional Use approval for the additional height of one story to achieve a four-story building within the TSS Zoning District. The recently adopted Comprehensive Plan for the City of Madison calls for this property to be a Neighborhood Mixed-Use which is "Relatively high-intensity mix of residential, retail, office, institutional, and civic uses, generally located adjacent to a major transportation corridor." It further states that structures of 2 to 4 stories are recommended. In order to achieve the recommended higher density, we need the 4th floor to be able to provide 26 additional units. Also, a four-story building will be in context for this section of Atwood Avenue given that the adjacent property to the west of this site is also a four-story structure and there are four-story buildings in the 2000 block of Atwood Avenue.

We have also completed Sun Studies for this proposed structure and you can see in these images that given the orientation of this building and the fact that we are located along a railway corridor, the shadows cast by this building have a very minimal impact on the adjacent properties. The approval of four stories will allow us to make the best use of this property by providing the needed additional housing units without taking up more land and further reinforces the massing and context for this area of the City.



City of Madison Fire Department

314 W Dayton Street, Madison, WI 53703-2506 Phone: 608-266-4420 • Fax: 608-267-1100 • E-mail: fire@cityofmadison.com

Project Address:

1936 & 1938 Atwood Avenue

Contact Name & Phone #: Kevi

Kevin Burow

FIRE APPARATUS ACCESS AND FIRE HYDRANT WORKSHEET

 Is the building completely protected by an NFPA 13 or 13R automatic fire sprinkler system? If non-sprinklered, fire lanes extend to within 150-feet of all portions of the exterior wall? If sprinklered, fire lanes are within 250-feet of all portions of the exterior wall? 	X Yes Yes Yes X Yes X	☐ No ☐ No ☐ No	N/A N/A N/A
 2. Is the fire lane constructed of concrete or asphalt, designed to support a minimum load of 85,000 lbs? a) Is the fire lane a minimum unobstructed width of at least 20-feet? b) Is the fire lane unobstructed with a vertical clearance of at least 13¹/₂-feet? c) Is the minimum inside turning radius of the fire lane at least 28-feet? d) Is the grade of the fire lane not more than a slope of 8%? e) Is the fire lane posted as fire lane? (Provide detail of signage.) f) Is a roll-able curb used as part of the fire lane? (Provide detail of curb.) g) Is part of a sidewalk used as part of the required fire lane? (Must support +85,000 lbs.) 	 ✗ Yes ✗ Yes ✗ Yes ✗ Yes ✗ Yes Yes Yes Yes 	No No	□ N/A □ N/A □ N/A □ N/A □ N/A ■ N/A ■ N/A □ N/A
3. Is the fire lane obstructed by security gates or barricades? If yes:a) Is the gate a minimum of 20-feet clear opening?b) Is an approved means of emergency operations installed, key vault, padlock or key switch?	☐ Yes ☐ Yes ☐ Yes	X No No No	□ N/A □ N/A □ N/A
4. Is the Fire lane dead-ended with a length greater than 150-feet? If yes, does the area for turning around fire apparatus comply with IFC D103?	Yes Yes	X No	N/A N/A
5. Is any portion of the building to be used for high-piled storage in accordance with IFC Chapter 3206.6 If yes, see IFC 3206.6 for further requirements.	Yes	X No	N/A
6. Is any part of the building greater than 30-feet above the grade plane?	X Yes	🗌 No	N/A
 If yes, answer the following questions: a) Is the aerial apparatus fire lane parallel to one entire side of the building and covering at least 25% of the perimeter? b) Is the near edge of the aerial apparatus fire lane between 15' and 30' from the building? c) Are there any overhead power or utility lines located across the aerial apparatus fire lane? d) Are there any tree canopies expected to grow across the aerial fire lane? (Based on mature canopy width of tree species) 	X Yes Yes Yes Yes	☐ No ☐ No ★ No ★ No	□ N/A □ N/A □ N/A □ N/A
 If yes, answer the following questions: a) Is the aerial apparatus fire lane parallel to one entire side of the building and covering at least 25% of the perimeter? b) Is the near edge of the aerial apparatus fire lane between 15' and 30' from the building? c) Are there any overhead power or utility lines located across the aerial apparatus fire lane? d) Are there any tree canopies expected to grow across the aerial fire lane? (Based on mature 	X Yes Yes Yes	☐ No ☐ No ✗ No	□ N/A □ N/A □ N/A
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 If yes, answer the following questions: a) Is the aerial apparatus fire lane parallel to one entire side of the building and covering at least 25% of the perimeter? b) Is the near edge of the aerial apparatus fire lane between 15' and 30' from the building? c) Are there any overhead power or utility lines located across the aerial apparatus fire lane? d) Are there any tree canopies expected to grow across the aerial fire lane? (Based on mature canopy width of tree species) e) Does the aerial apparatus fire lane have a minimum unobstructed width of 26-feet? f) Is the space between the aerial lane and the building free of trees exceeding 20' in heights? 7. Are all portions of the required fire lanes within 500-feet of at least (2) hydrants? see Utility Plan Note: Distances shall be measured along the path of the hose lay as it comes off the fire apparatus. a) Is the fire lane at least 26' wide for at least 20-feet on each side of the hydrants? b) Is there at least 40' between a hydrant and the building? 	 ✗ Yes ✗ Yes ☑ Yes ☑ Yes ✗ Yes ✗ Yes ✗ Yes ✗ Yes ✗ Yes ✗ Yes 	□ No □ No ➤ No ○ No □ No □ No □ No □ No	 N/A
 If yes, answer the following questions: a) Is the aerial apparatus fire lane parallel to one entire side of the building and covering at least 25% of the perimeter? b) Is the near edge of the aerial apparatus fire lane between 15' and 30' from the building? c) Are there any overhead power or utility lines located across the aerial apparatus fire lane? d) Are there any tree canopies expected to grow across the aerial fire lane? (Based on mature canopy width of tree species) e) Does the aerial apparatus fire lane have a minimum unobstructed width of 26-feet? f) Is the space between the aerial lane and the building free of trees exceeding 20' in heights? 7. Are all portions of the required fire lanes within 500-feet of at least (2) hydrants? see Utility Plan Note: Distances shall be measured along the path of the hose lay as it comes off the fire apparatus. a) Is the fire lane at least 26' wide for at least 20-feet on each side of the hydrants? b) Is there at least 40' between a hydrant and the building? c) Are the hydrant(s) setback no less than 5-feet nor more than 10-feet from the curb or edge of the street or fire lane? 	 ✗ Yes ☑ Yes ☑ Yes ☑ Yes ✗ Yes 	□ No □ No ➤ No ○ No □ No □ No □ No □ No □ No	 N/A
 If yes, answer the following questions: a) Is the aerial apparatus fire lane parallel to one entire side of the building and covering at least 25% of the perimeter? b) Is the near edge of the aerial apparatus fire lane between 15' and 30' from the building? c) Are there any overhead power or utility lines located across the aerial apparatus fire lane? d) Are there any tree canopies expected to grow across the aerial fire lane? (Based on mature canopy width of tree species) e) Does the aerial apparatus fire lane have a minimum unobstructed width of 26-feet? f) Is the space between the aerial lane and the building free of trees exceeding 20' in heights? 7. Are all portions of the required fire lanes within 500-feet of at least (2) hydrants? see Utility Plan Note: Distances shall be measured along the path of the hose lay as it comes off the fire apparatus. a) Is the fire lane at least 26' wide for at least 20-feet on each side of the hydrants? b) Is there at least 40' between a hydrant and the building? c) Are the hydrant(s) setback no less than 5-feet nor more than 10-feet from the curb or edge of the 	 ✗ Yes ✗ Yes ☑ Yes ☑ Yes ✗ Yes ✗ Yes ✗ Yes ✗ Yes ✗ Yes ✗ Yes 	□ No □ No ➤ No ○ No □ No □ No □ No □ No	 N/A

Attach an additional sheet if further explanation is required for any answers.

This worksheet is based on MGO 34.503 and IFC 2015 Edition Chapter 5 and Appendix D; please see the codes for further information.



FEATURES & SPECIFICATIONS

INTENDED USE

Provides years of maintenance-free general illumination for outdoor use in commercial applications such as retail, education, multi-unit housing and storage. Ideal for lighting building facades, parking areas, walkways, garages, loading areas and any other outdoor space requiring reliable safety and security.

CONSTRUCTION

Sturdy weather-resistant aluminum housing with a bronze finish, standard unless otherwise noted. A clear polycarbonate lens protects the optics from moisture, dirt and other contaminants.

OPTICS

8 high performance LEDs are powered by a multi-volt (120V-277V) LED driver that uses 18 input watts and provides 1,490 delivered lumens. 100,000 hour LED lifespan based on IESNA LM-80-08 results and calculated per IESNA TM-21-11 methodology.

ELECTRICAL

Rated for outdoor installations, -40°C minimum ambient.

Adjustable Dusk-to-dawn, multi-volt photocell standard automatically turns light on at dusk and off at dawn for convenience and energy savings.

Photocell can be disabled by rotating the photocell cover.

6KV

Surface or recessed mount. A universal junction box is included standard.

All mounting hardware included.

LISTINGS

UL Certified to US and Canadian safety standards. Wet location listed for mounting higher than 4 feet off the ground.


Tested in accordance with IESNA LM-79 and LM-80 standards.

WARRANTY

5-year limited warranty. Complete warranty terms located at www.acuitybrands.com/CustomerResources/Terms_and_conditions.aspx

Actual performance may differ as a result of end-user environment and application.

Note: Specifications subject to change without notice.

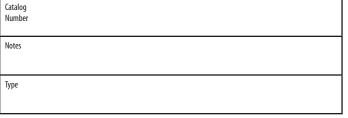



Outdoor General Purpose







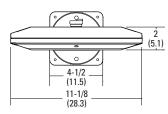

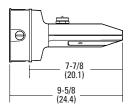

All dimensions are inches (centimeters) unless otherwise indicated.


ORDERING INFORMATION Example: 0LW14 For shortest lead times, configure product using **bolded options**. **OLW14** Series Color temperature (CCT)¹ Voltage Control Finish **OLW14** 1400 lumen LED wall pack (blank) 5000K¹ (blank) MVOLT (120V-277V) (blank) MVOLT photocell included (blank) Bronze WH White

Accessories: Order as separate catalog number.

FCOS M24 Full cutoff shield FCOS WH M24 Full cutoff shield, white

PHOTOMETRIC DIAGRAMS

Full photometric data report available within 2 weeks from request. Consult factory. Tested in accordance with IESNA LM-79 and LM-80 standards.

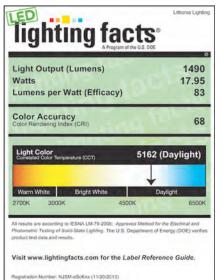

Model Number: OLW14 [Upgrade : 9/4/2013] Type: Luminaire - Area/Roadway





FEATURES	& SPECIFICATIONS
LUCIONE	

INTENDED USE

Provides maintenance-free general illumination for outdoor use in residential and commercial applications such as retail, education, multi-unit housing and storage. Ideal for lighting building facades, parking areas, walkways, garages, loading areas and any other outdoor space requiring reliable security lighting.

CONSTRUCTION

Sturdy weather-resistant aluminum housing with a dark bronze finish.

High performance LEDs are powered by an MVOLT driver providing 3020 and 4300 delivered lumens at 5000K. 100,000 hours LED lifespan based on IESNA LM-80-08 results and calculated per IESNA TM-21-11 methodology. Fixture is maintenance-free.

Rated for outdoor installations -40°C minimum ambient.

Adjustable Dusk-to-Dawn, photocell standard automatically turns light on at dusk and off at dawn for convenience and energy savings.

Photocell can be disabled by rotating the photocell cover.

OPTICS

Nighttime Friendly™ full cutoff above 90° angle, standard.

INSTALLATION

Wall or arm mount (mounting arm sold separately).

All mounting hardware included.

LISTINGS

UL Certified to US safety standards. C-UL Certified to Canadian safety standards. Wet location listed. Tested in accordance with IESNA LM-79 and LM-80 standards. DLC qualified product.

WARRANTY


5-year limited warranty. Complete warranty terms located at:

 $\underline{www.acuitybrands.com/CustomerResources/Terms_and_conditions.aspx}$

NOTE: Actual performance may differ as a result of end-user environment and application.

All values are design or typical values, measured under laboratory conditions at 25 °C.

Specifications are subject to change without notice.

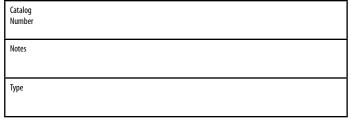













Outdoor General Purpose

Specifications

All dimensions are inches (centimeters)

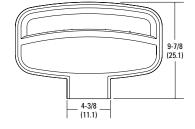

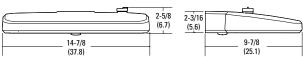

ORDERIN	G INFORMATION FO	or shortes	t lead times, configure products using bolde	d options.					Example: OLW 23
OLW									
Series		Lumei	ns / Color temperature (CCT)	Voltage		Features		Finish	
OLW	LED Wall Light	23 31	3,020 delivered lumens / 5000K ¹ 4,300 delivered lumens / 5000K ¹	(blank)	MVOLT (120V-277V)	(blank)	Photocell included	(blank)	DDB Dark Bronze

Accessories: Order as separate catalog number.					
OMA 18 DDB M6	18" Steel mounting arm				

Notes

1 Correlated Color Temperature (CCT) shown is nominal per ANSI C78,377-2008.

PHOTOMETRICS

Full photometric data report available within 2 weeks from request. Consult factory. Tested in accordance with IESNA LM-79 and LM-80 standards.

ight Output (Lumens)	3020
latts	31
umens per Watt (Efficacy)	97.42
and the second	
olor Accuracy olor Rendering Index (CRI)	70
	70 5000 (Daylight)
olor Rendering Index (CRI)	

Lithonia Lighting Lighting facts 4300 Light Output (Lumens) Watts 44.3 Lumens per Watt (Efficacy) 97.07 Color Accuracy 75 Light Color Correlated Color Temperature (CCT) 5000 (Daylight) Warm White Bright White Daylight 2700K 3000K 4500K 6500K All results are according to IESNA LM-79-2008: Approved Method for the Electrical and Photometric Testing of Solid-State Lighting The U.S. Department of Energy (DOE) verifies product test data and results. Visit www.lightingfacts.com for the Label Reference Guide. Registration Number: NJSM-7QIGR6 (1/5/2017) Model Number: OLW 31 [Upgrade : 1/5/2017] Type: Luminaire - Area/Roadway

Registration Number: NJSM-AJJOD2 (1/5/2017) Model Number: OLW 23 [Upgrade : 1/5/2017] Type: Luminaire - Area/Rondway

Context Photos & Building to be Demolished










1936 Atwood Ave






Interior photos of 1936 Atwood Ave

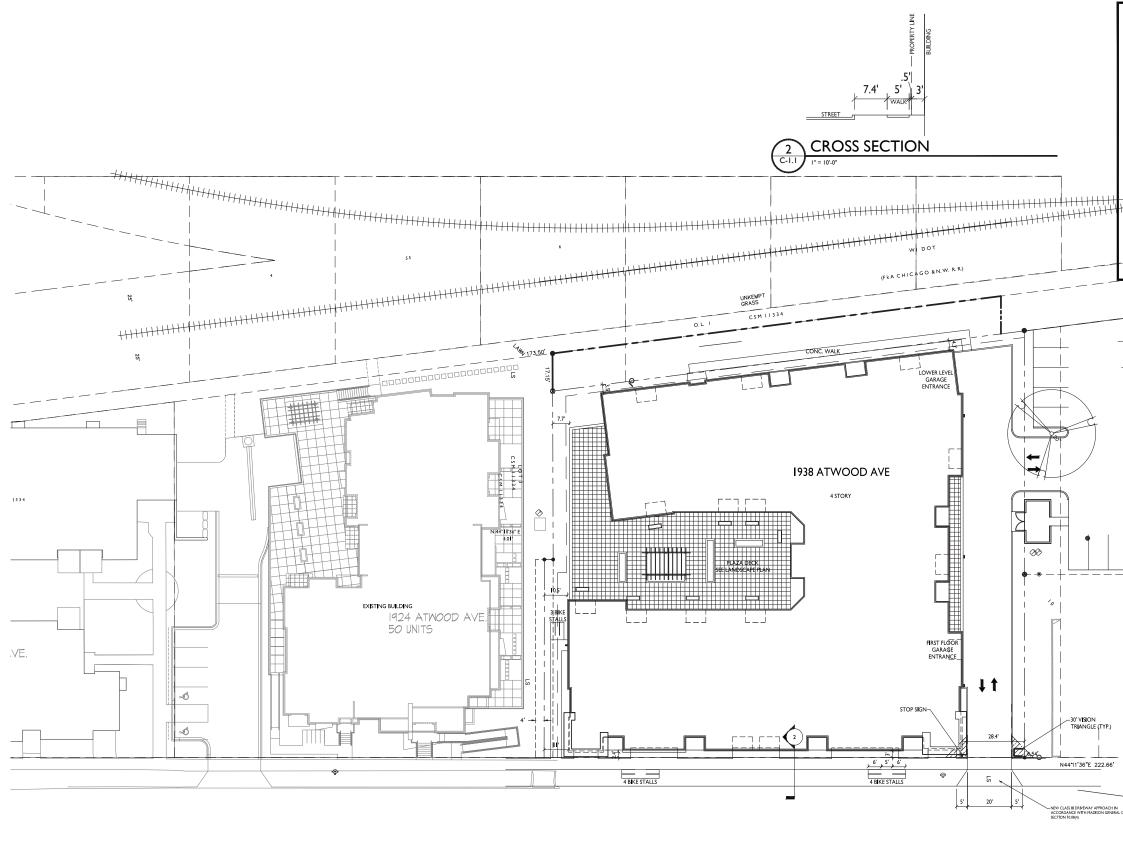



ATWOOD AVENUE

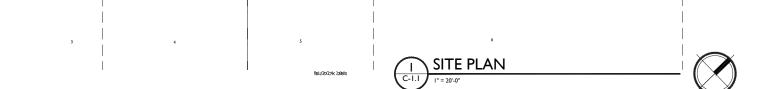




SITE DEVELOPM	IENT DATA	<u>.</u>		
ZONING-TSS DENSITIES: LOT AREA DWELLING UNITS COMMERCIAL ARI LOT AREA / D.U. DENSITY BUILDING HEIGH LOT COVERAGE USABLE OPEN SPA USABLE OPEN SPA GROSS FLOOR AR FLOOR AREA RAT DWELLING UNIT EFFICIENCY ONE BEDRO ONE BEDRO ONE BEDRO TOTAL DWE	EA ICE ICE / DU IEA - RESIDEN' IO MIX: OM OM + DEN	79 1 ~4,1 500 81 1 4 57 34,5 10,0 128 2,0 11AL 2,0 15 37 12 15		A R C H I T E C T S Mothe bruce A R C H I T E C T S Marcine 7601 Claimenty Air, Sin 201 Marcine Williams, Will Safet
UNDERGROU	JND/ COVERE		4 STALLS 6 STALLS	
TOTAL BICYCLE PARKING SURFACE GL SURFACE CC GARAGE - ST TOTAL	iest Mmercial 'All	9 : 2 : 21 : 60 :	D STALLS STALLS STALLS (COVERED) STALLS (COVERED) STALLS	
	SHEET II SITE C-I.I C-I.2	SITE	E PLAN IE DEPARTMENT ACCESS PLAN	ISSUED
-	C-1.3 C-1.4	LOT USA	IT COVERAGE ABLE OPEN SPACE	Issued for Land Use - December 21, 2018
	C-1.5 C-2.0 C-3.0 C-4.0 C-5.0 C-6.0 C-7.0 L-1.0	EXIS DEM ERC SITE GRA UTI	'E LIGHTING PLAN ISTING CONDITIONS MOLITION PLAN OSION CONTROL PLAN TE PLAN ADING PLAN ILITY PLAN NDSCAPE PLAN	
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				ATWOOD AVE. DEVELOPMENT
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	3. J	BY A CITY LICENSED ALL DAMAGE TO THI	OCONTRACTOR. HE PAVEMENT , ADJACENT TO TH I S	
	- ·	CITY OF MADISON'S	LL BE RESTORED IN ACCORDANCE WITH THE 5 PAVEMENT PATCHING CRITERIA.	,
	5. 6	APPROVAL TO PRUN RIGHT-OF-WAY. PERI OBTAINED FROM TH EASEMENT LINES SHO	IS FOR THIS PROJECT DOES NOT INCLUDE AN VE, REMOVE, OR PLANT TREES IN THE PUBLIC IMISSION FOR SUCH ACTIVITIES MUST BE HE CITY FORESTER, 266-4816. OWN ON THIS SHEET ARE FOR GENERAL SEE CSM AND CIVIL SHEETS FOR ADDITIONAL	1938 Atwood Ave. Madison, WI
N Vul ORD.	6.	AND MORE COMPLE CONTRACTOR SHA THE AREA BETWEED IT AT LEAST 5 FEET I THE LENGTH OF TH PERMITTED WITHIN TREE TRUNK. IF EXX NECESSARY, CONTF (266-4816) PRIOR TO THE TREE AND ROC	ETE EASEMENT INFORMATION ALL INSTALL TREE PROTECTION FENCING IN NI THE CURB AND SIDEVALK AND EXTEND FROM BOTH SIDES OF THE TREE ALONG HE TERRACE. NO EXCAVATION IS NS FEET OF THE OUTSIDE EDGE OF THE (CAVATION WITHIN'S FEET OF ANY TREE IS TRACTOR SHALL CONTACT CITY FORESTRY O EXCAVATION TO ASSESS THE IMPACT TO OF SYSTEM. TREE PRUNING SHALL BE	
		OF CONSTRUCTION BE FOUND IN SECTI STANDARD SPECIFIC CONSTRUCTION, A FOR CONSTRUCTIO APPROVED WILL RE BEFORE A TREE REM TO NOTIFY THE ALI	TH CITY FORESTRY PRIOR TO THE START NI TREE FROTECTION SPECIFICATIONS CAN FION 107.13 OF CITY OF MADISON ICATIONS FOR PUBLIC WORKS ANY TREE REMOVALS THAT ARE REQUIRED ON AFTER THE DEVELOPMENT PLAN IS EQUIRE AT LEAST A 72.HOUR WAIT FERIOD MOVAL PERMIT CAN BE ISSUED BY FORESTRY LDER OF THE CHANGE IN THE TREE PLAN. VIS THE SOLE IMPROCTONO OF THE CITY.	SHEET NUMBER
		OF MADISON AND	YY IS THE SOLE JURISDICTION OF THE CITY IS SUBJECT TO CHANGE AT ANY TIME PER ATIONIPLAN OF TRAFFIC ENGINEERING ANI 5 DEPARTMENTS.	PROJECT NO. 1544 © Knothe & Bruce Architects, LLC

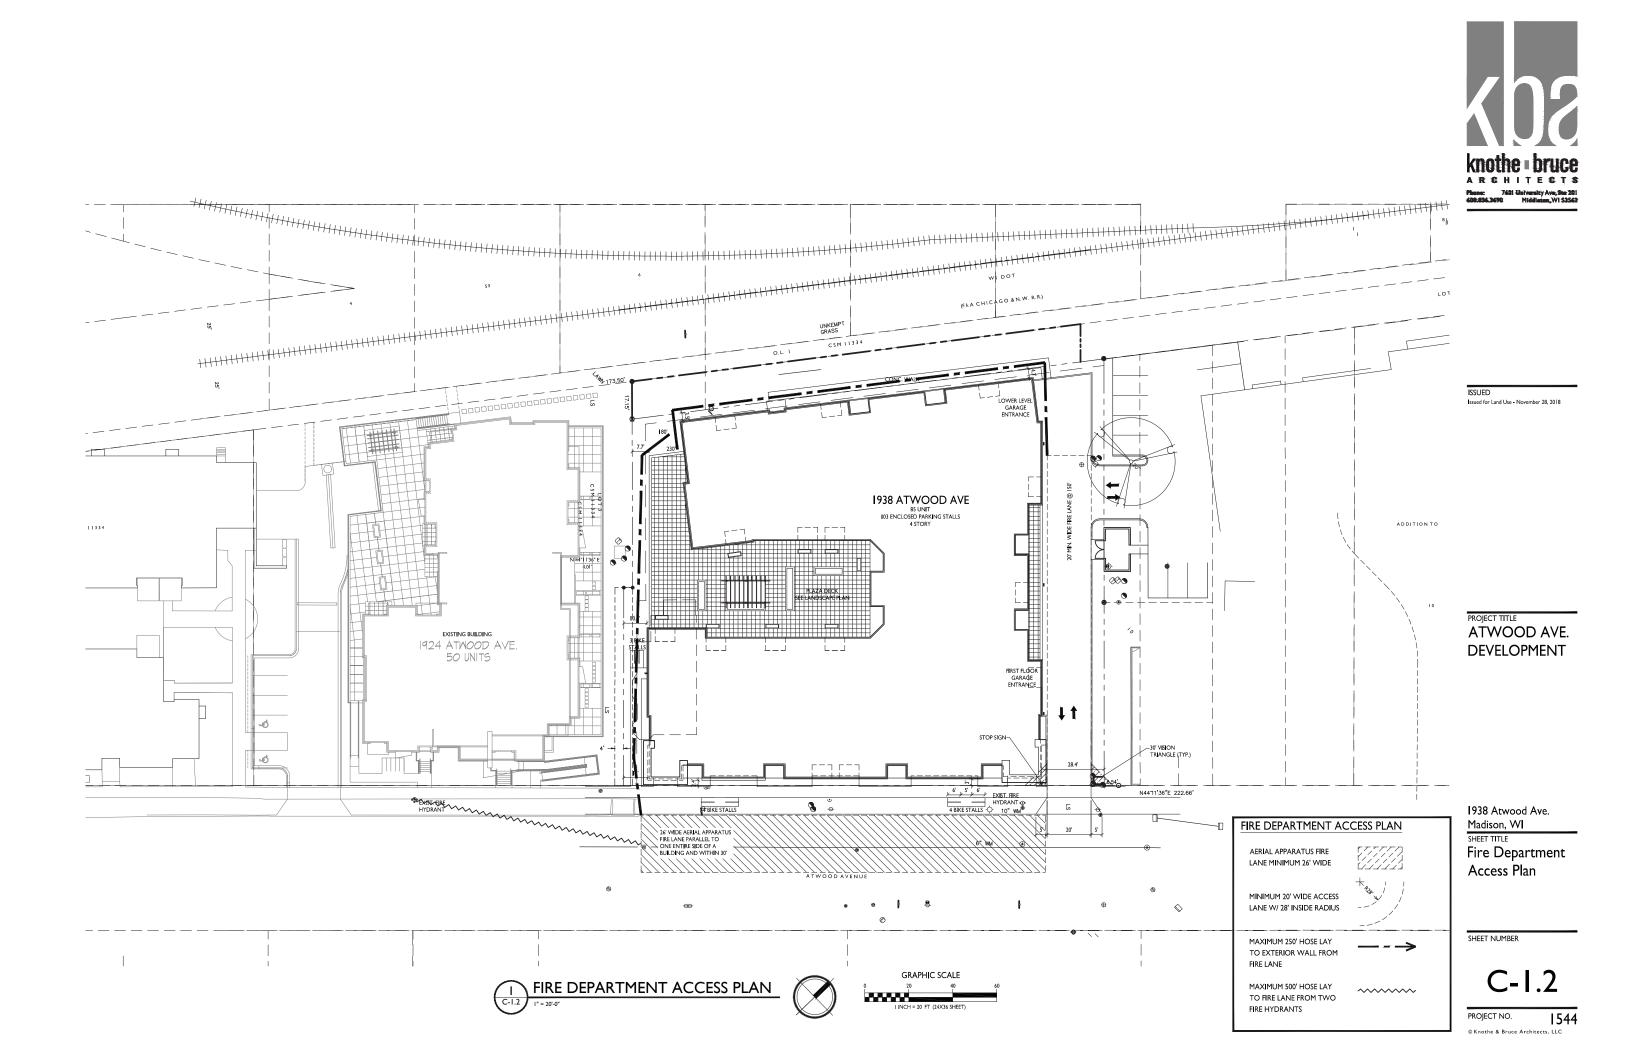

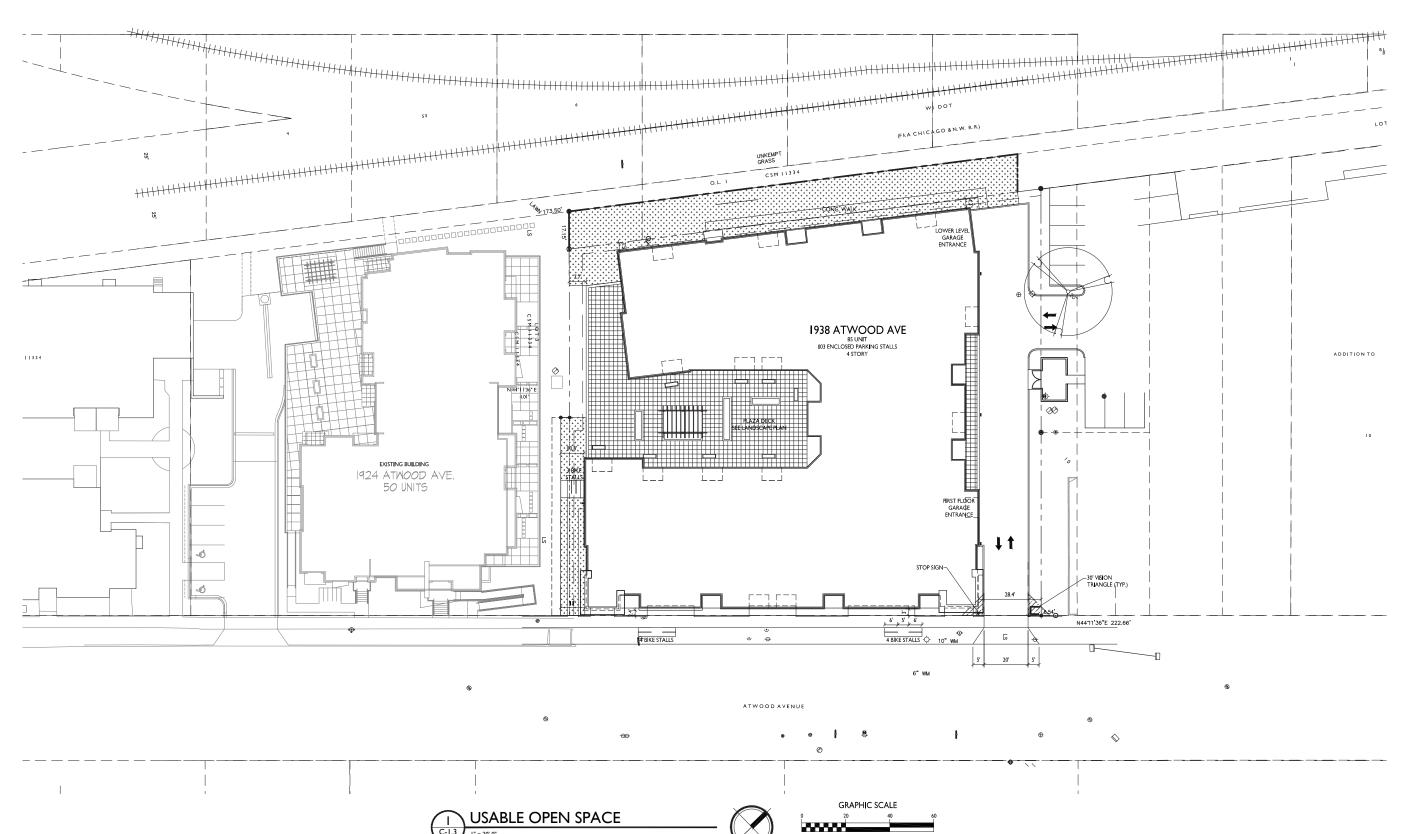

INCH = 20 FT (24X36 SHEE

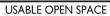

 ZONING: TSS

 REQUIRED OPEN SPACE: 40 S.F. / D.U.

 DWELLING UNITS: 85

 85 D.U. X 40 S.F. = 3,400 S.F. OPEN SPACE REQUIRED

 OPEN SPACE PROVIDED:

 BALCONIES: 85 x 54 S.F. = 4,590 S.F.

 <u>SURFACE:</u>
 5,504 S.F.

 TOTAL:
 10,094 S.F.




ISSUED Issued for Land Use - November 28, 2018



1938 Atwood Ave. Madison, WI SHEET TITLE Usable Open Space

SHEET NUMBER

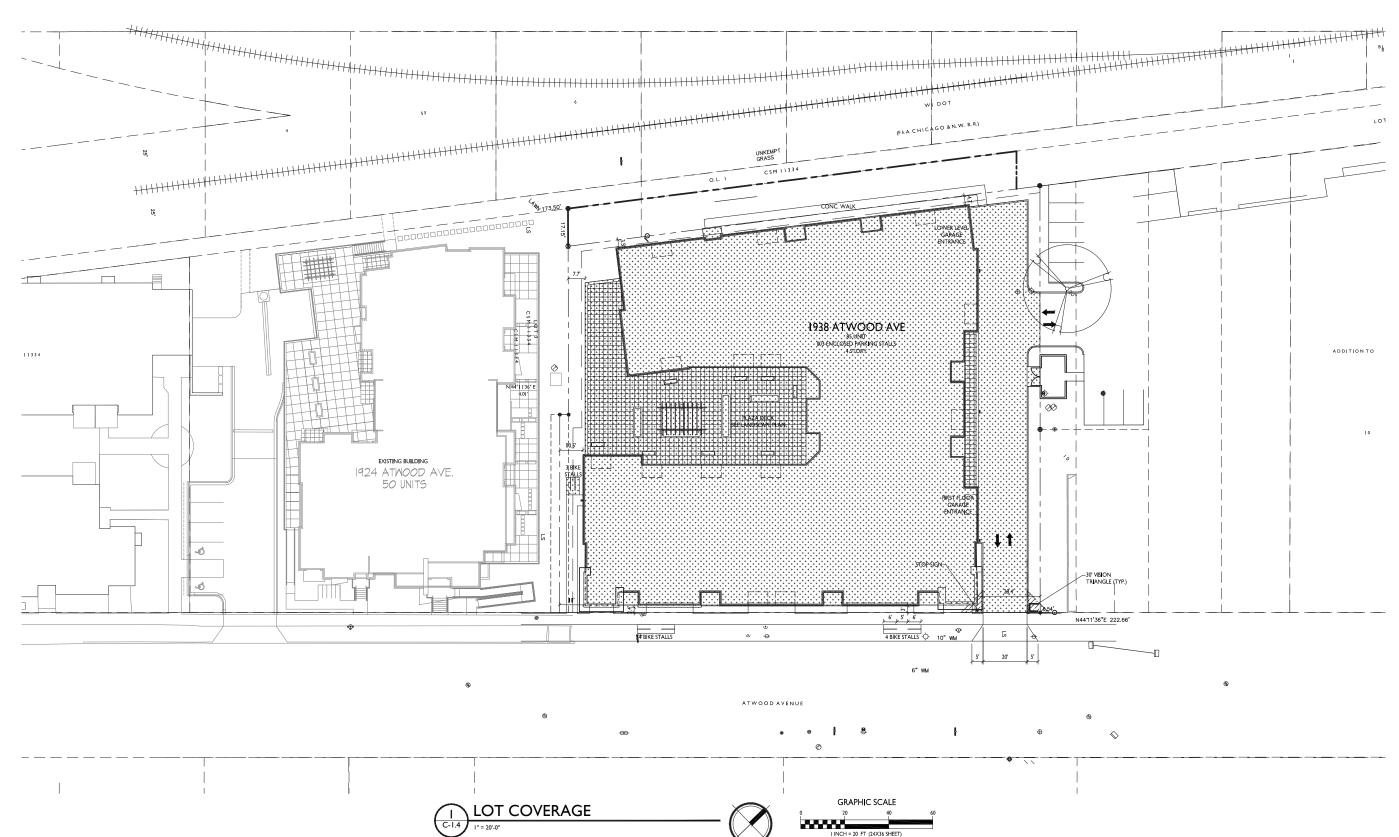

LOT COVERAGE



TOTAL LOT AREA BUILDING & PAVING COVERAGE: 42,491 S.F. (TOTAL LOT AREA S.F. / COVERAGE S.F.) 82 % (85% MAX ALLOWED)

34,960 S.F.



SSUED Issued for Land Use - November 28, 2018


PROJECT TITLE ATWOOD AVE. DEVELOPMENT

1938 Atwood Ave. Madison, WI SHEET TITLE Lot Coverage

SHEET NUMBER

C-1.4

STATISTICS						
DESCRIPTION	SYMBOL	AVG.	MAX.	MN.	MAX. / MIN.	AVG. / MIN.
Drive Aisle Lighting	+	1.4 fc	2.7 fc	0.4 fc	6.8:	3.5:
Security Lighting	+	4.3 fc	9.3 fc	1.5 fc	6.2:	2.9:

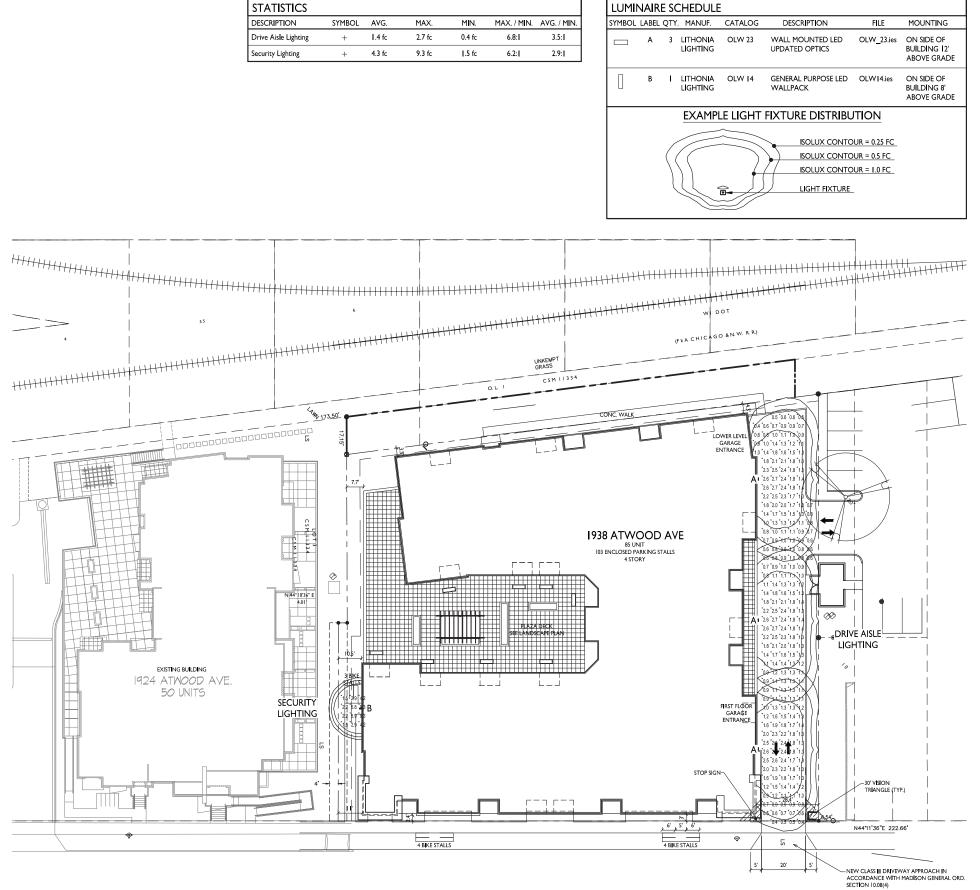

ATWOOD AVENUE











1938 Atwood Ave. Madison, WI SHEET TITLE Site Lighting Plan


SHEET NUMBER


C-1.5 PROJECT NO. 1544 © Knothe & Bruce Architects, LLC

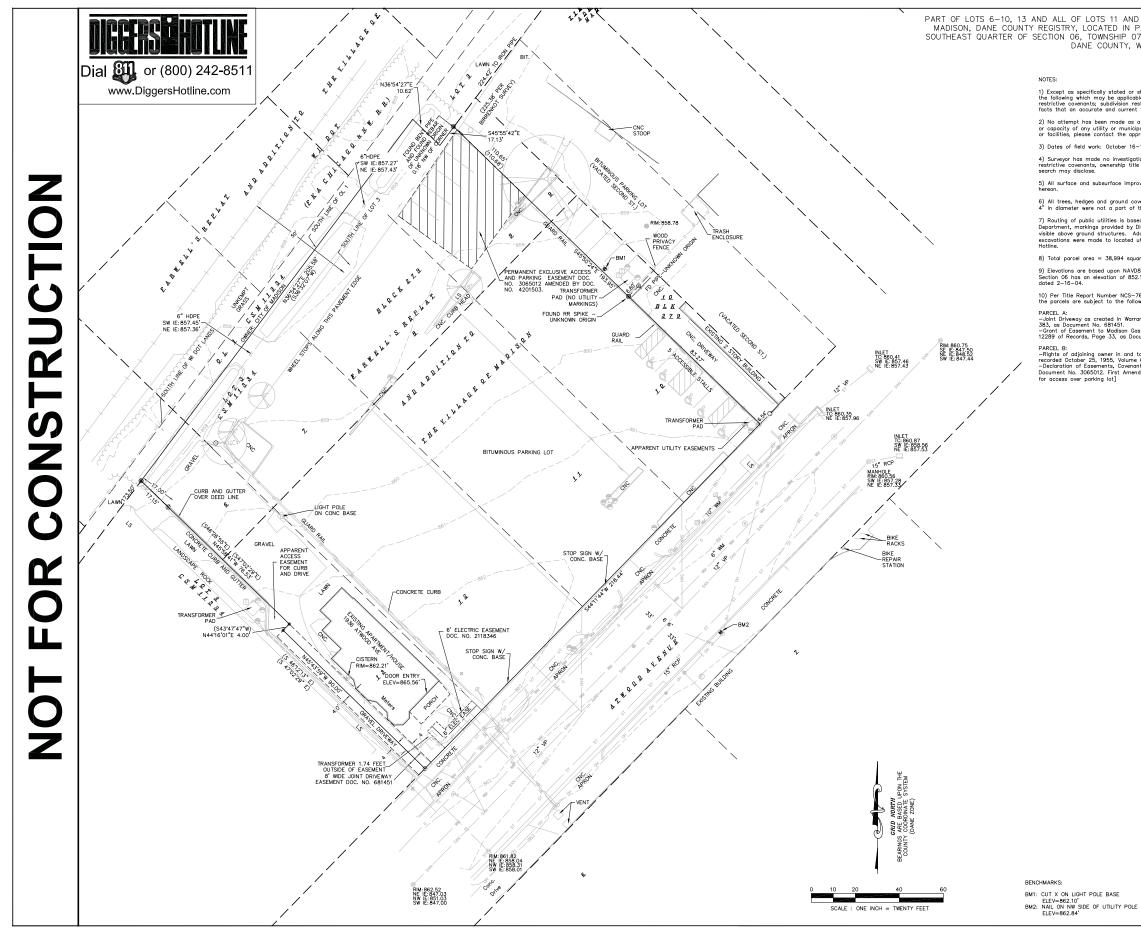



IN PART	OF THE RTH, RA	LS ADDITION TO THE VILLAGE OF SOUTHWEST QUARTER OF THE NGE 10 EAST, CITY OF MADISON,		-		Jrse and Engineering, Inc.	
ed or shown o pplicable to th sion restriction current title se	on this ma he subject hs; zoning earch may	b, this survey does not purport to reflect any of real estate: easements; building setback lines; or other land use regulations; and any other disclose.		P I e-mi	Madison, hone: 608 Fax: 608~ ail: Mburse	nal Lane, Suite 101 WI 53704 5-250-9263 250-9266 sØBSE-INC.net irveyengr.com	
de as a part municipal/publ he appropriate	of this sur lic service agencies.	vey to obtain or show data concerning condition facility. For information regarding these utilities		۲	_		
oer 16–17, 20 vestigation or		t search for easements of record, encumbrances,					
nip title eviden	ice, or any	t search for easements of record, encumbrances, other facts that an accurate and current title		VALS ENG:	MLB DBY: PDF	CRB BV DF DF MLB	
e improvement	s on and	adjacent to the site are not necessarily shown		APPROVAL PROJECT ENG	DESIGNED BY: PDF DRAWN BY:	CRB CHECKED BY: PDF APPROVEC	
und cover on art of this sur		ay not necessarily be shown hereon. Trees under					
is based upon d by Digger's es. Additional	i drawings Hotline Tic I buried uti	obtained from the City of Madison Engineering ket Numbers 20184108140 and 20184108243 litles/structures may be encountered. No cavations are performed contact Digger's					
4 square feet			Ш				
NAVD88 datu	um. The br	ass cap monument at the Southwest corner of benchmark on tiesheet by Carl M. Sandsnes,					
NCS—763733- e following:	-MAD prepo	re by First American Title Insurance Company		e.		LLC	
n Warranty De	ed recorde	i: January 10, 1994, Volume 442 of Deeds, Page	Ш	Ý	-	. 201	
1. son Gas and E as Document	Electric Cor No: 21183	npany recorded December 12, 1988, Volume 46.		0 0	d Ave. 5370	Venu Dr. Ste 53704	
i and to the i /olume 639 of Covenants, Cor Amendment	use of the f Deeds, Po nditions and recorded Ju	joint driveway as set forth in a certain deed ige 300, as Document No. 906604, i Restrictions recorded January 4, 1999, as ine 12, 2006, as Document No. 4201503. [Allows		938 Atwood Ave	1938 Atwood Ave. Madison, WI, 53704	938 Atwood Avenue, 2010 Eastwood Dr. Ste 20 Madlson, WI 53704	
				ω	10 Ma	Atv Ma	
	_	LEGEND		33		38	
	0	MAG NAIL SET 3/4" SOLID IRON ROD FOUND	Н	1 		19	
	o	1" IRON PIPE FOUND UNLESS NOTED	Н				Printed By: Survey
	×	FOUND CHISELED "X" IN CONCRETE	Н				su :
		FOUND RR SPIKE	Н				d B
	0	3/4" X 18" SOLID IRON RE-ROD SET, WT. 1.50	Н				intee
		lbs./ft.	Н				
			Н				- 8:59am
	— он —	OVERHEAD UTILITY WIRE BURIED GAS LINE	Н				8:5
		WATER MAIN	Н				0
		SANITARY SEWER	Н	PROJE	ECT #: B	SE1864	2018
		STORM SEWER	Н	PLOT	DATE:	11/28/2018	Printed: Nov 28,
	UT	BURIED TELEPHONE		DEVIO			Nov
		BURIED ELECTRIC		REVIS	ION DAT	IES:	ibe.
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	•	TELEPHONE MANHOLE		proprietar and Engin	y informatio eering, Inc.	n of Burse Surveying Neither the document on herein is to be	SB1
	9 •	STORM SEWER MANHOLE ROUND CATCH BASIN		reproduce	sd, distribute in whole or	ed, used or disclosed, in part, except as	¶ B
				specifical	ly authorize and Engine	d by Burse Surveying	⁴
	□ □ @	STORM SEWER STRUCTURE SANITARY SEWER MANHOLE		DR/	AWING	NUMBER	1864
	8	SANITARY SEWER MANHOLE MISC SYMBOL				າ ດີ	BSE
		INDICATES RECORDED AS			U-2	2.0	
		DISTANCES ARE MEASURED TO THE NEAREST		L			
		HUNDREDTH OF A FOOT. BUILDINGS ARE					

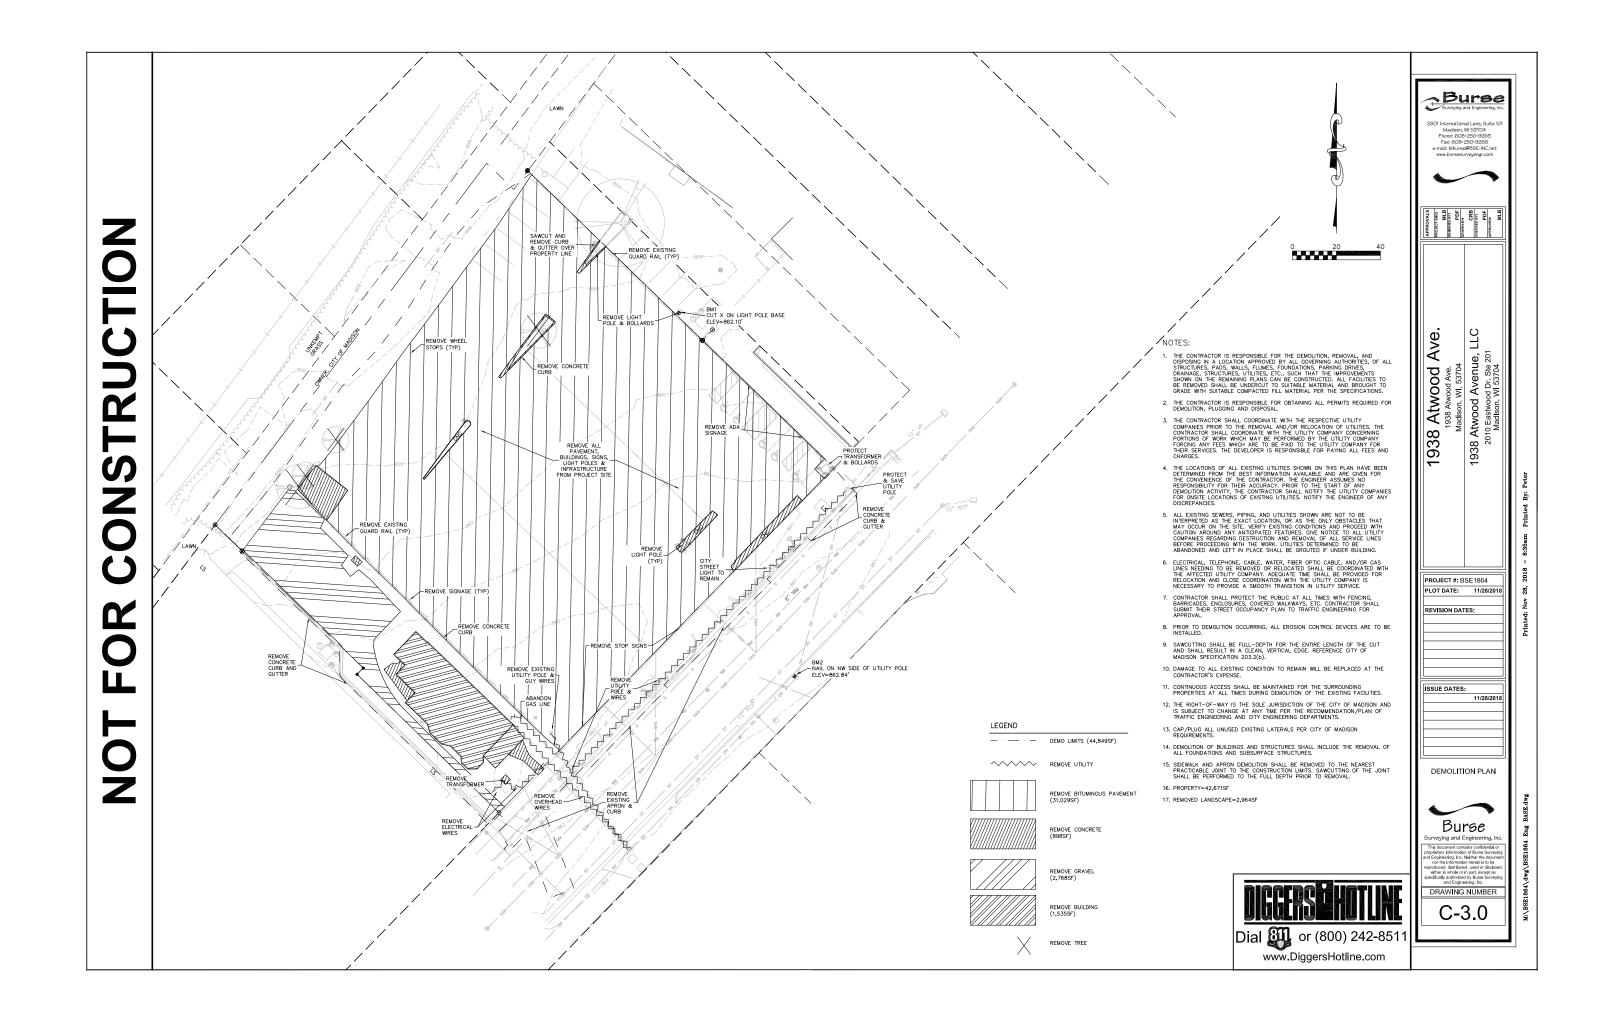


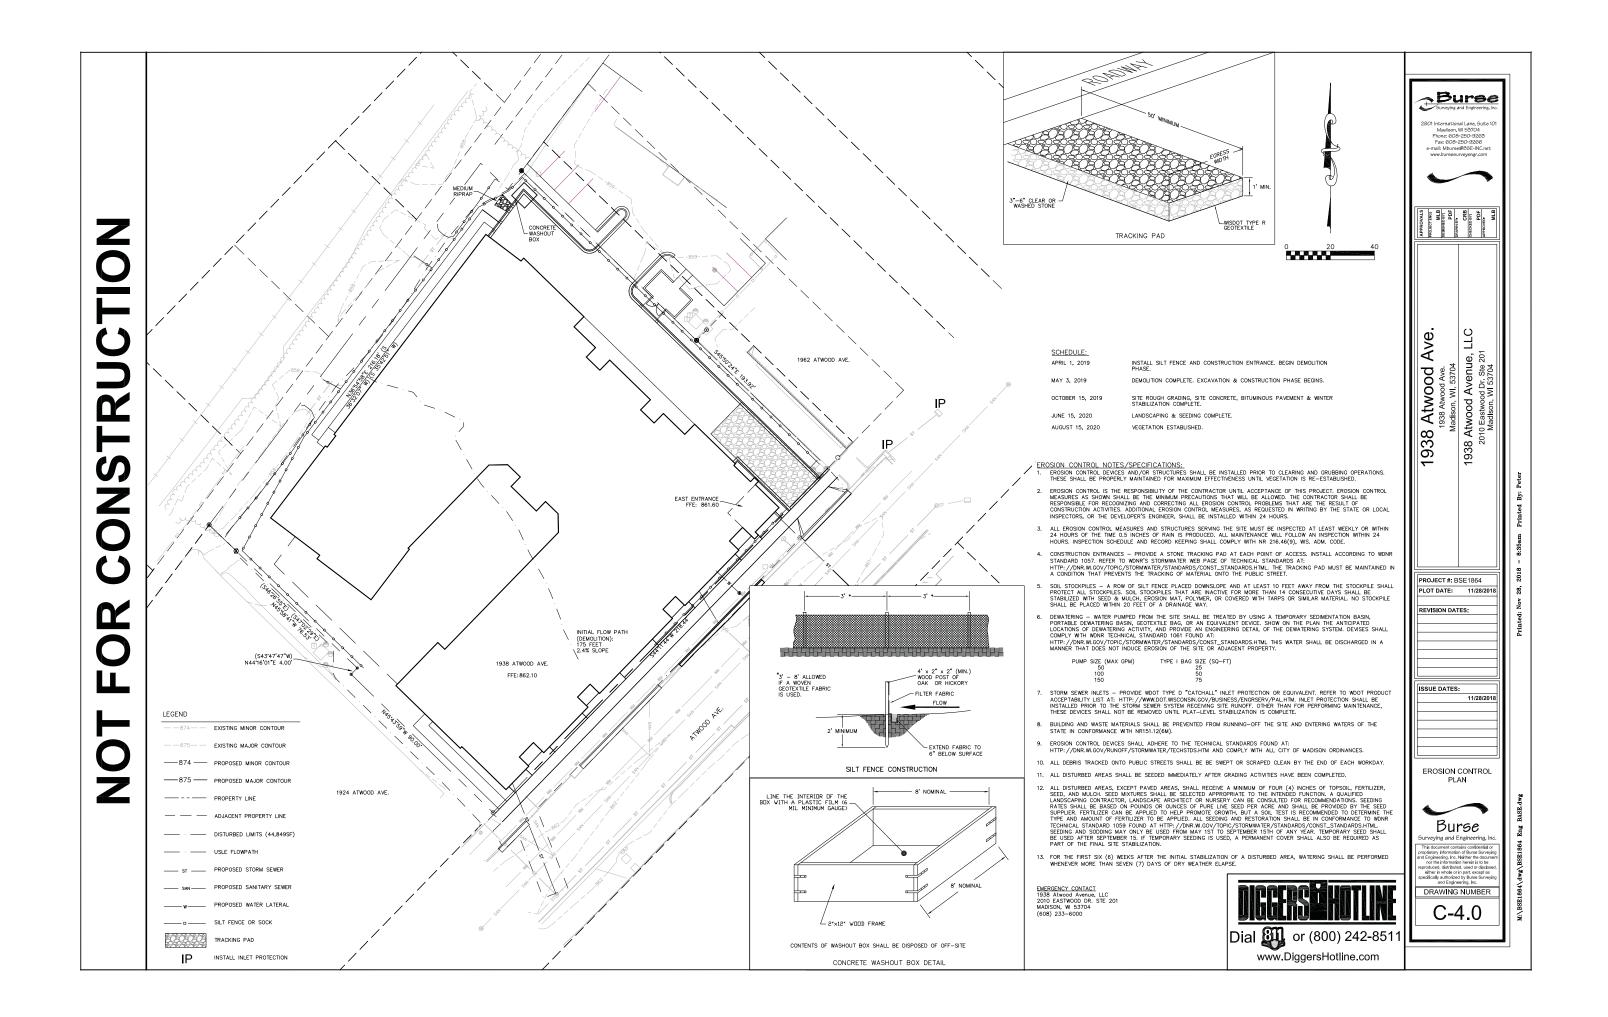

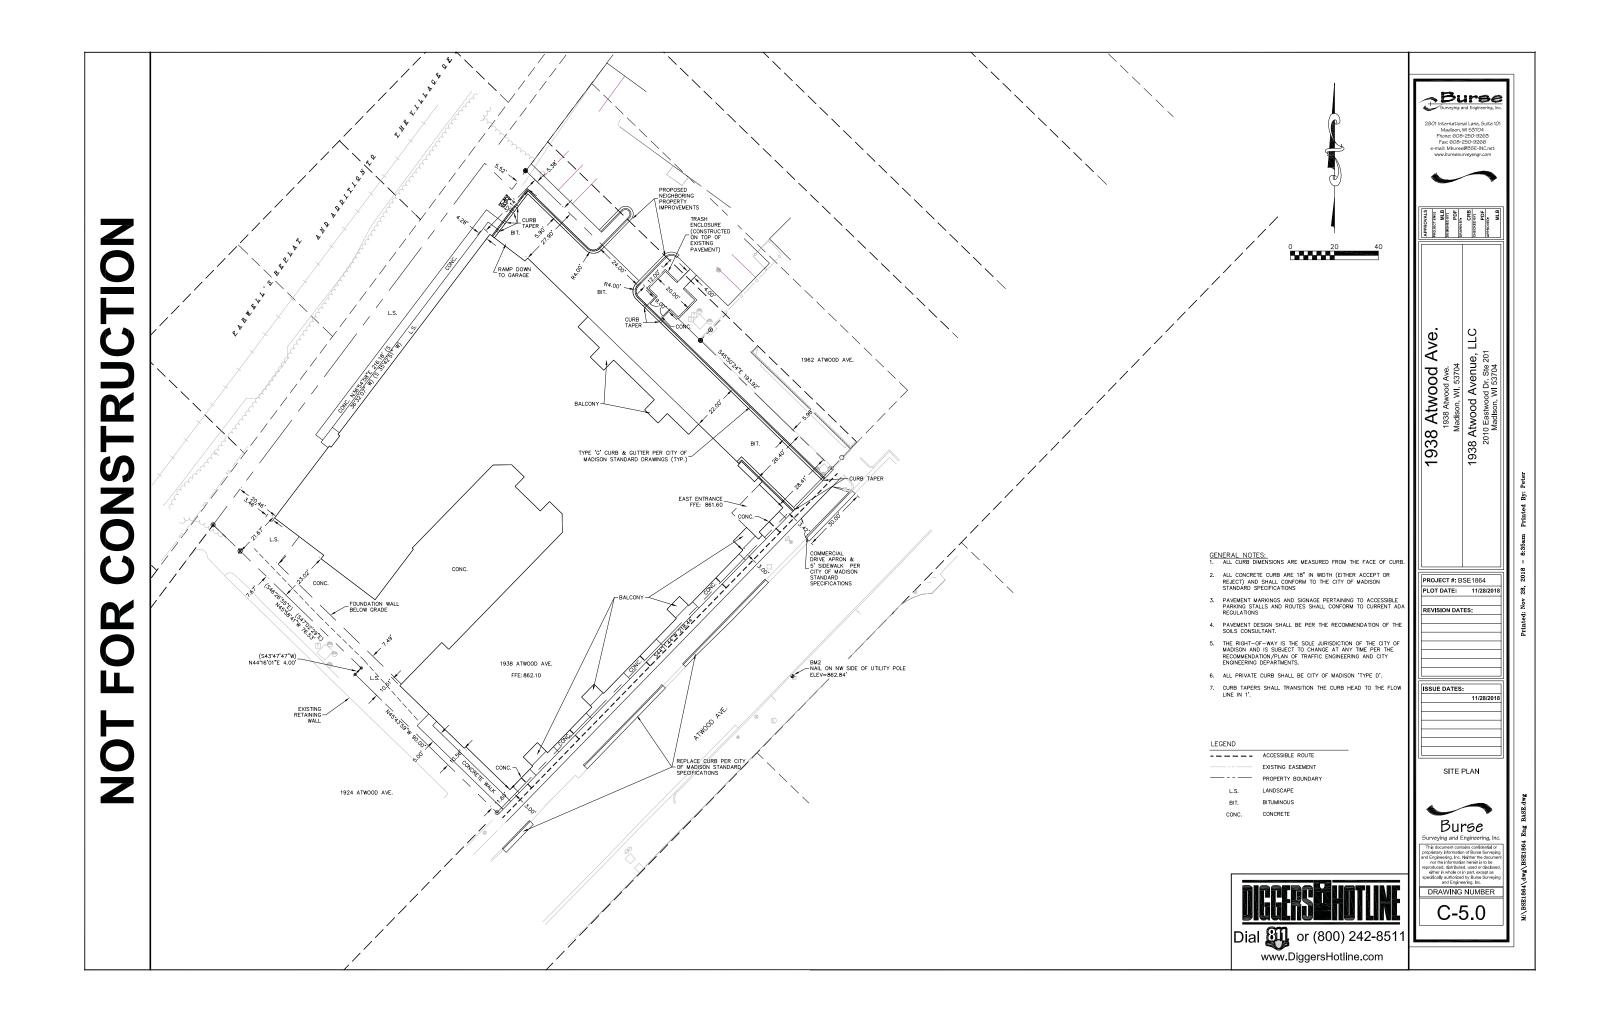

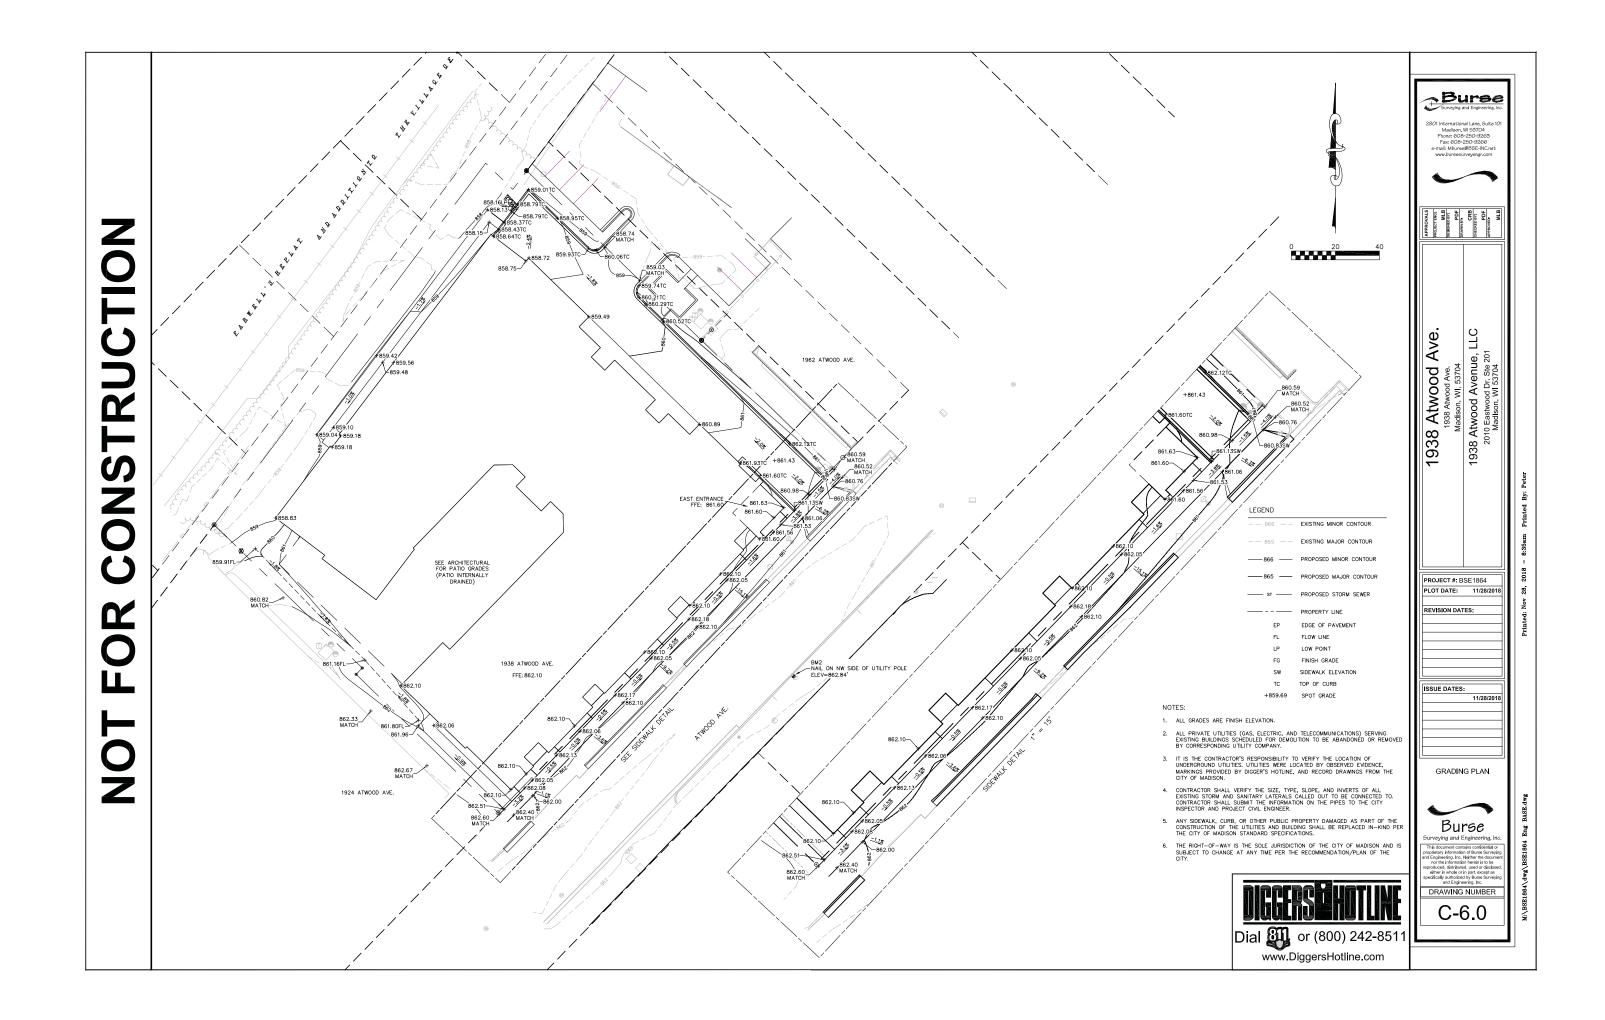

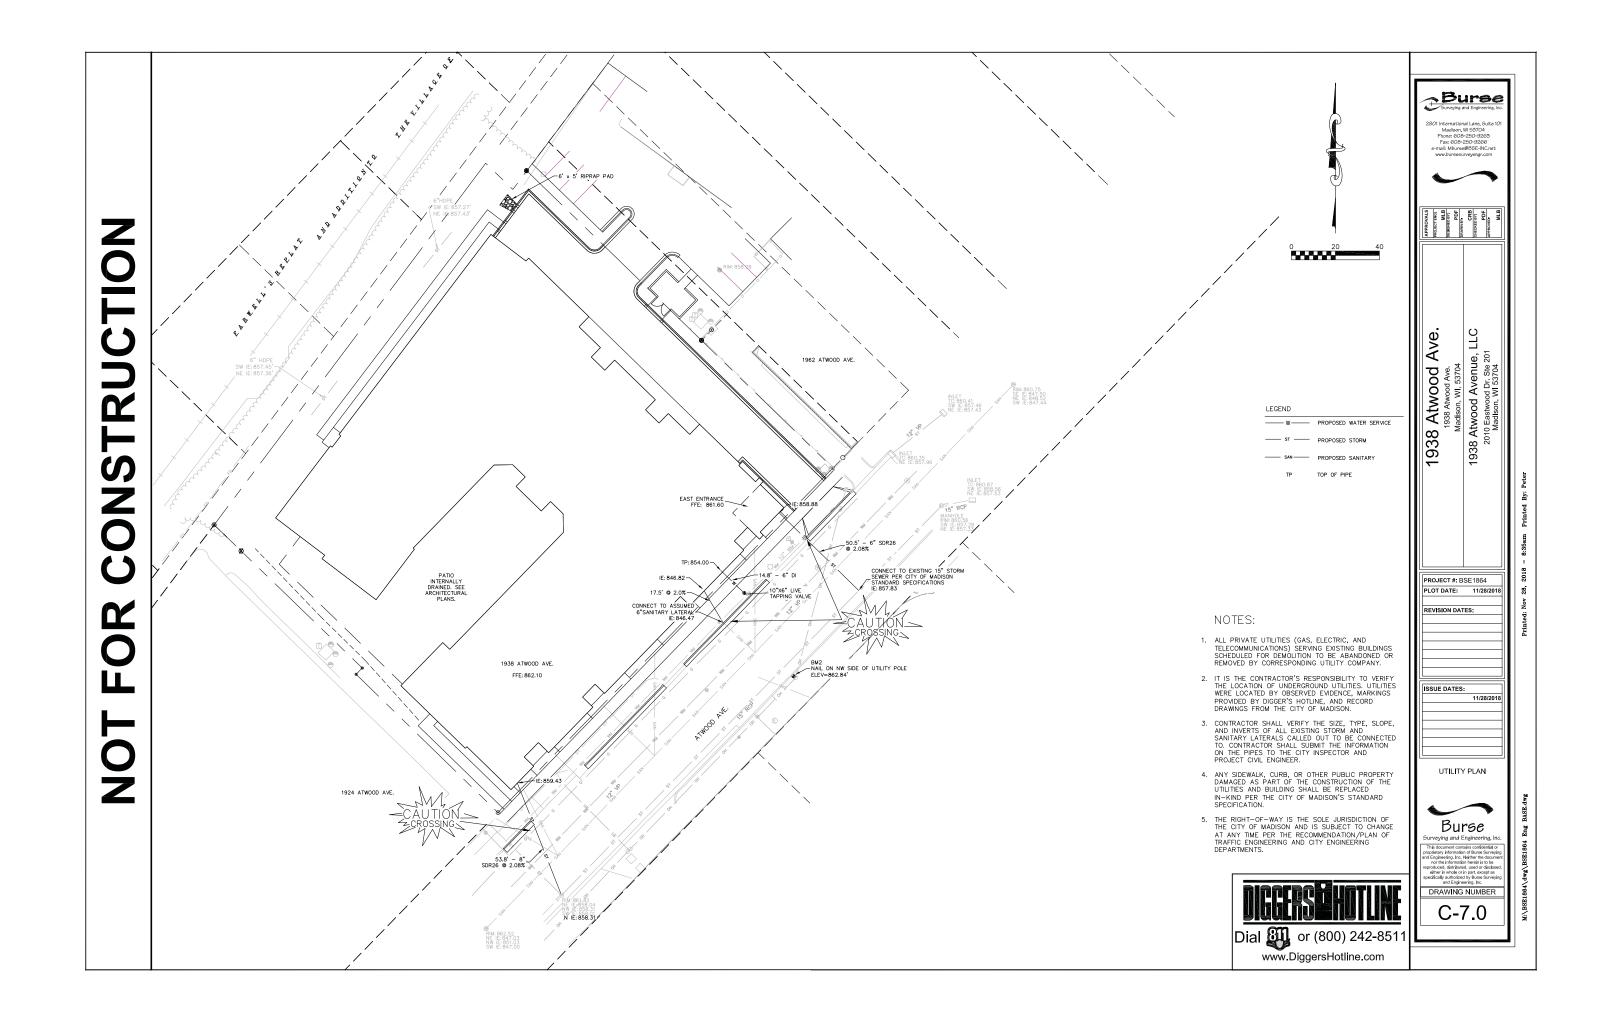


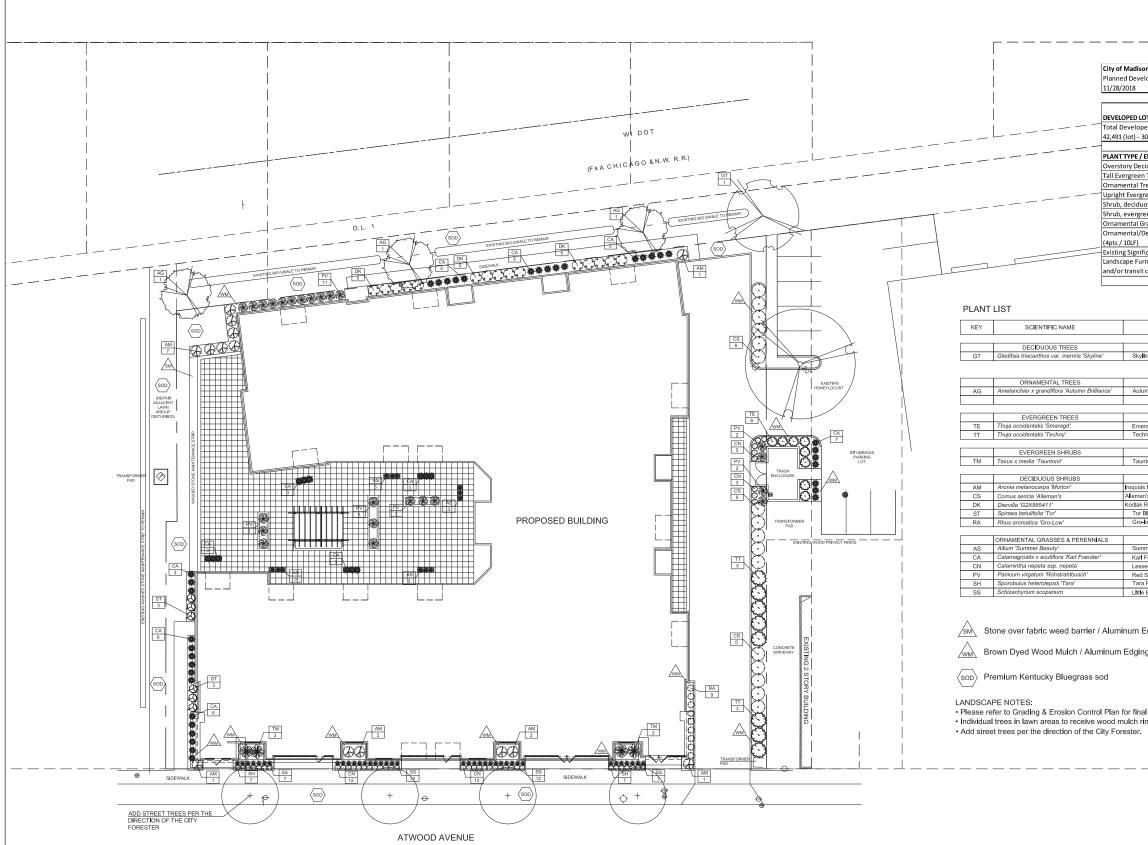

9

						LANDSCAPING 3570 Ploneer Road Verona, WI 53593 PH: (608) 827-9401 FAX: (608) 827-9402 WEE: www.dsontoon.com
on, WI Landscape Workshee elopment District	t					
iopinent bistite						
		5 pts per	LANDS	ADE	1	
OTS	SQUARE FEET		POINTS			
eed Area 30,224 (building footprint)	12,267			204		
50,224 (building 100tprint)	12,207			201		
ELEMENT	POINT VALUE		ΤΟΤΑ			
ciduous n Tree	35	1		35 0		
ree	15	3		45	-	
reen Shrub (i.e. arborvitae) ous	10 3	8 60		80 180	1	
een	4	4		16	1	
Grasses/Perennials Decorative Fencing or Wall	2	129		258	-	
	4			0		
ficant Specimen Tree rniture for public seating	14			0	-	
connections	5			0		
	POINT	S PROVIDED		614		
						ATWOOD AVENUE 1938 Atwood Avenue Madison, Wisconsin
COMMON NAME	QTY P	ANTING F	ROOT NDITION	STEM	7	
	1 1	0.000				ш
ne Honeylocust	1	2"	B&B		-	
						ω –
						TWOOD A 1938 Atwood Avenue Madison, Wisconsin
umn Brillance Serviceberry	3	6'	B&B	clump	-	
					-	
erald Arborvitae	8	5'	B&B		-	
hny Arborvitae	8	5'	B&B			Atw
nton Yew	4	15"	B&B			– (č ž
s Beauty Black Chokeberry	14	#5	Cont.		-	Δ
n's Compact Red Twig Dogwood	16	#3	Cont.		1	
Red Bush Honeysuckle Birchleaf Spirea	15 6		Cont. Cont.		-	
low Fragrant Sumac	9		Cont.		1	038
					Г	0
nmer Beauty Onlon Foerster Feather Reed Grass	12 49		Cont.		-	~
ser Calamint	32	#1	Cont. Cont.		1	
Switch Grass Prairle Dropseed	27		Cont. Cont.		-	
e Bluestem Grass	38		Cont.		1	
Edaina						
Edging						
ıg						
						Date: 2018.11.16
al contour information.						Scale: 1/16"=1'-0"
ings						Designer: BNF Job #
						Seal: To protect against legal liability, the plans presented herein are
		16	32		48	"schematic," and should not be outsourced as "biddable" or "construction documents" unless approved by the Landscape Designer. This is not an original document unless stamped in
						red, as ORIGINAL.
\langle / \rangle	SCALE: 1	/16"=1'-0"				
	SCALE: 1	/16"=1'-0"				Revisions:
	SCALE: 1	/16"=1'-0"				

L-1.0
Reference Name: Prime Urban Propert

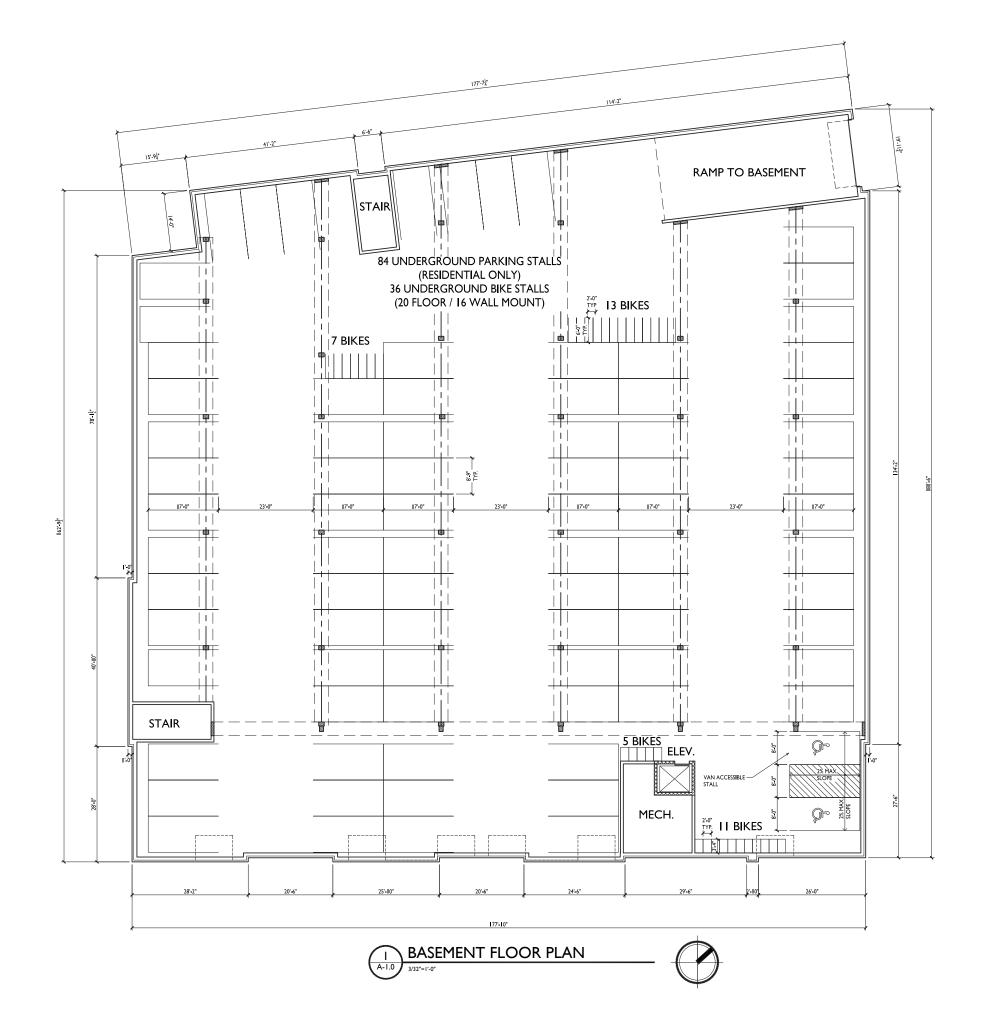




ISSUED Issued for Land Use - Nov 28, 2018

PROJECT TITLE ATWOOD AVE. DEVELOPMENT

1938 Atwood Ave. Madison, WI SHEET TITLE Basement Floor Plan

SHEET NUMBER

A-1.0 PROJECT NO. 1544 © 2013 Knothe & Bruce Architects, LLC

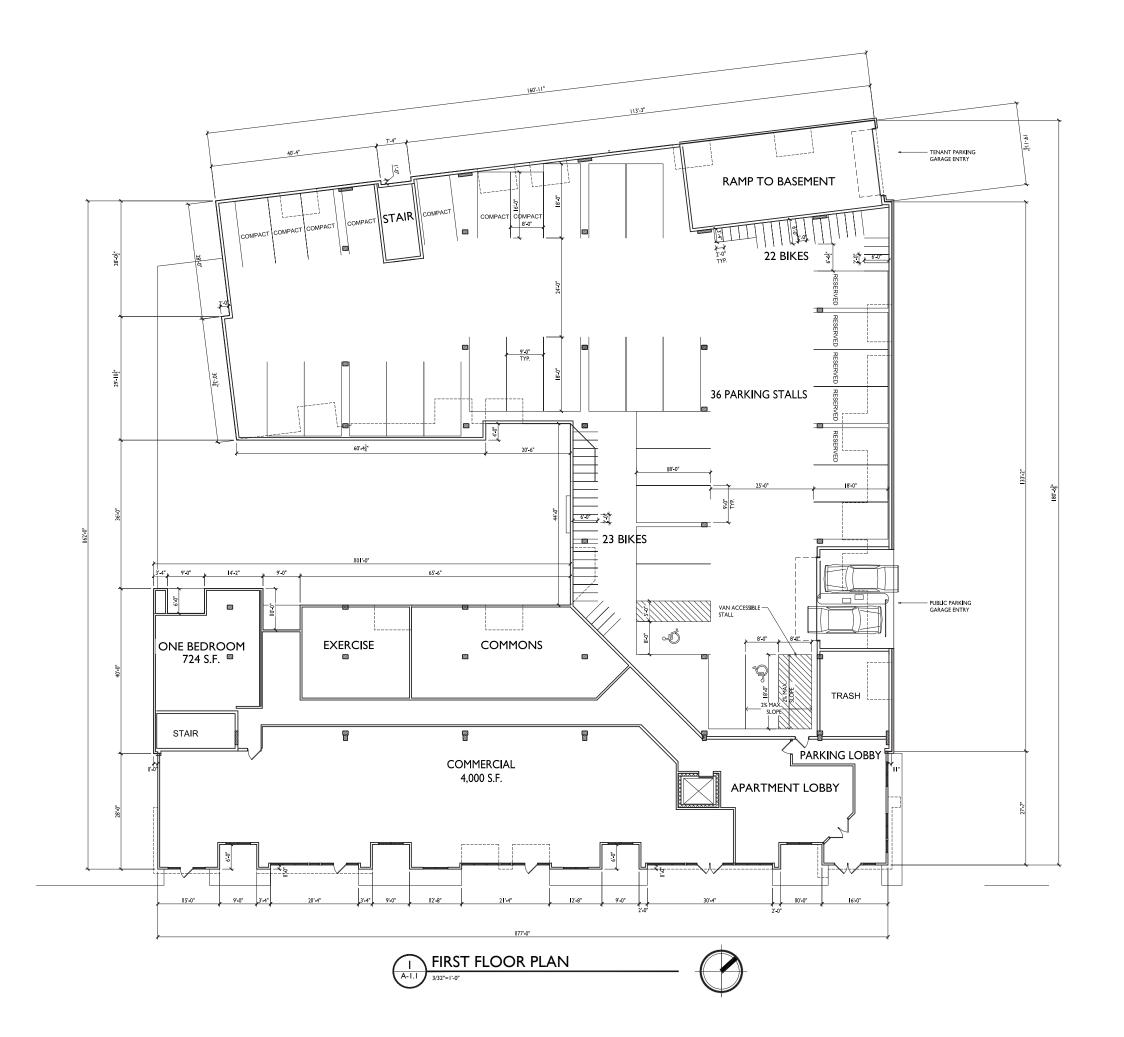




ISSUED Issued for Land Use - December 21, 2018

PROJECT TITLE ATWOOD AVE. DEVELOPMENT

1938 Atwood Ave. Madison, WI sheet title First Floor Plan

SHEET NUMBER

A-I.I PROJECT NO. 1544 © 2013 Knothe & Bruce Architects, LLC

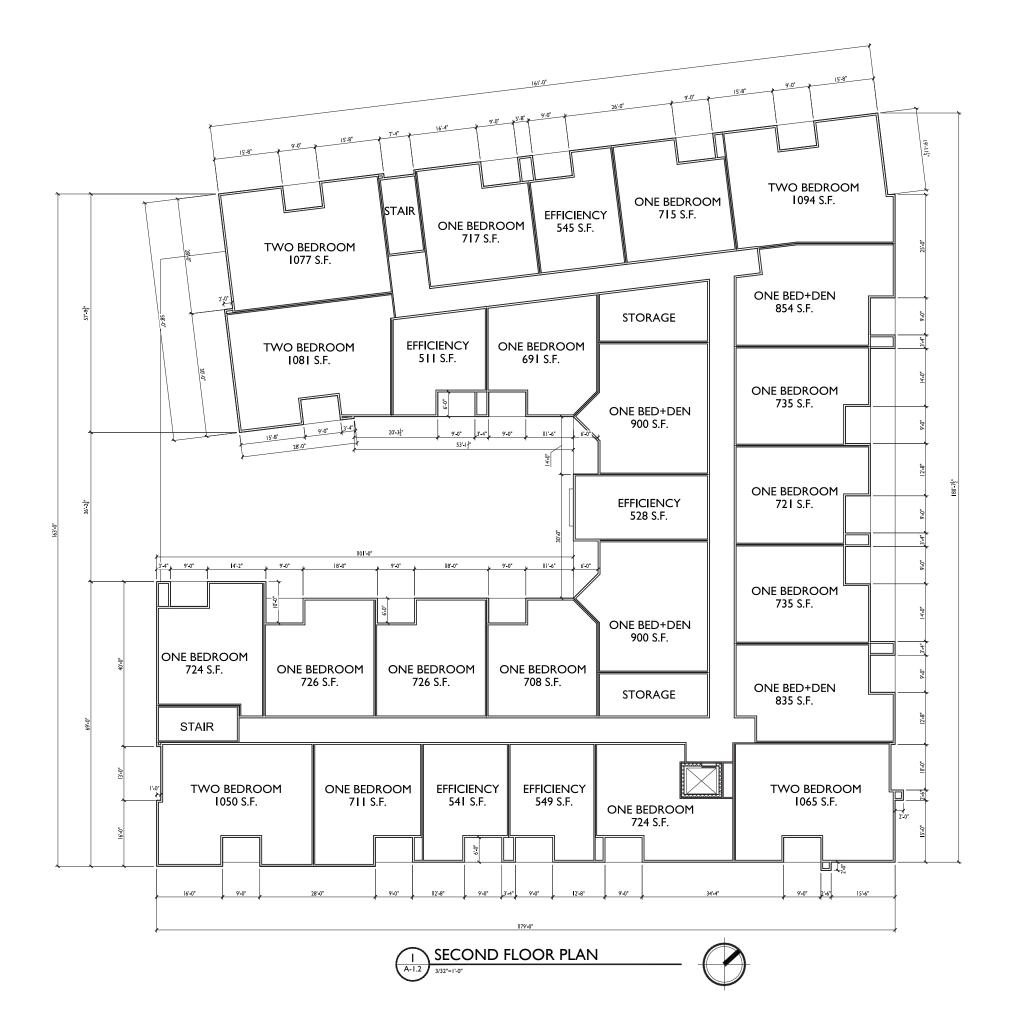



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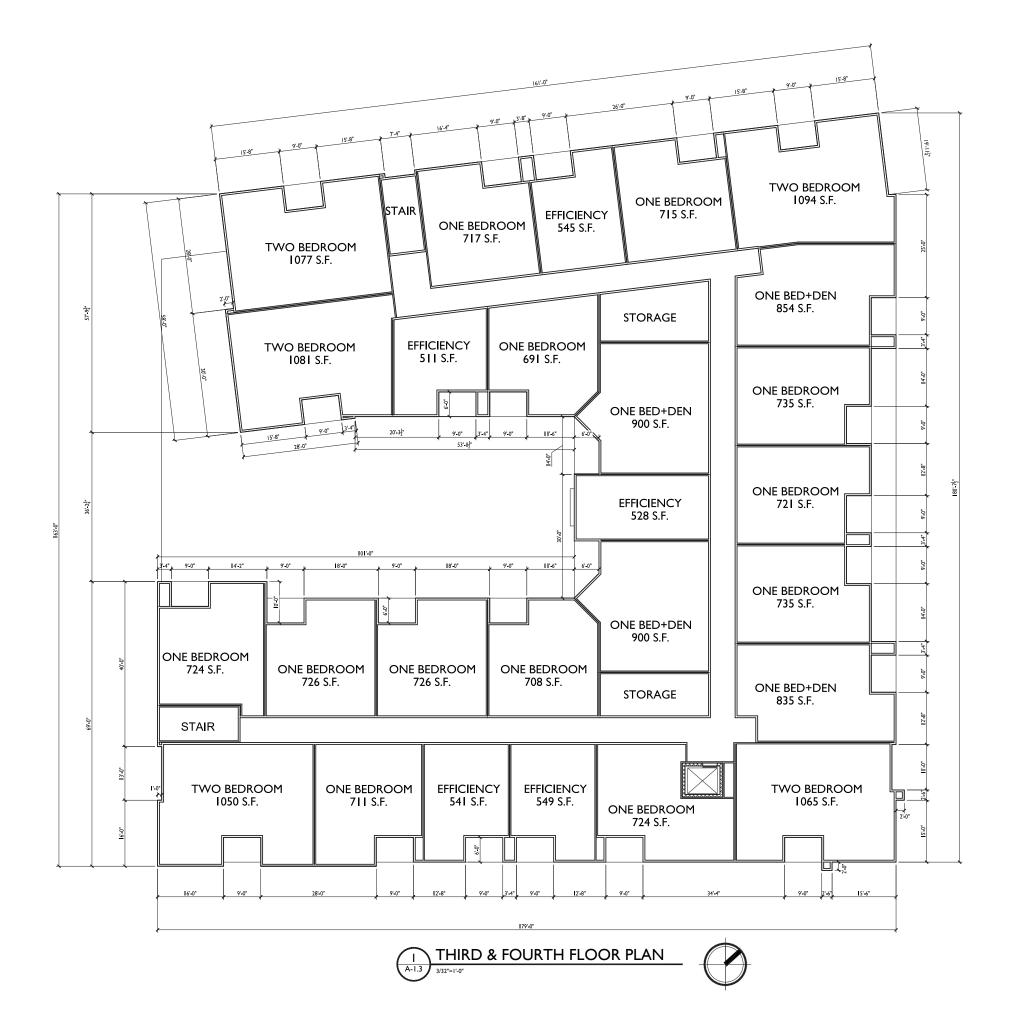
PROJECT TITLE ATWOOD AVE. DEVELOPMENT

1938 Atwood Ave. Madison, WI SHEET TITLE Second Floor Plan

SHEET NUMBER

A-1.2

PROJECT NO. 1544 © 2013 Knothe & Bruce Architects, LLC






ISSUED Issued for Land Use - Nov 28, 2018


PROJECT TITLE ATWOOD AVE. DEVELOPMENT

1938 Atwood Ave. Madison, WI SHEET TITLE Third & Fourth Floor Plan

SHEET NUMBER

A-1.3 PROJECT NO. 1544 © 2013 Knothe & Bruce Architects, LLC

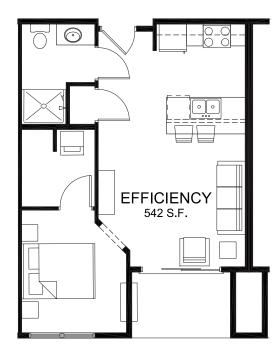

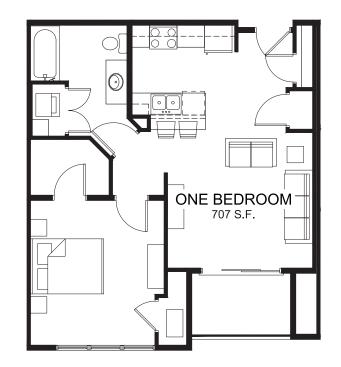











SSUED ssued for Land Use - Nov 28, 2018

PROJECT TITLE ATWOOD AVE. DEVELOPMENT

1938 Atwood Ave. Madison, WI SHEET TITLE Typical Unit Floor Plans

SHEET NUMBER

A-1.4

PROJECT NO. 1544 © 2013 Knothe & Bruce Architects, LLC

MASONRY CAST STONE ACCE COMPOSITE META METAL SIDING & T FASCIA / SOFFIT / WINDOWS RAILING BUILDING ENTRAM









EXTERIOR MATERIAL SCHEDULE

	YANKEE HILL - LIGHT IRON SPOT SMOOTH	
CENTS	EDWARDS CAST STONE - 18-018	
AL PANELS	COATED METAL GROUP - SLATE GRAY	
TRIM	COATED METAL GROUP - MUSKET GRAY	
TRIM	COATED METAL GROUP - SLATE GRAY	
	ANDERSON 100 - BLACK	
	ALUMINUM - BLACK	
NCES	ALUMINUM STOREFRONT - BLACK	



TYPICAL MATERIALS

METAL SIDING & TRIM

ALUMINUM RAILINGS

VINYL WINDOWS

1POSITE METAL PANEL

1ASONRY VENEER

METAL CANOPY

- ALUMINUM STOREFRONT

SSUED

ssued for Review - January 21, 2019

PROJECT TITLE ATWOOD AVE. DEVELOPMENT

1938 Atwood Ave. Madison, WI SHEET TITLE Exterior Elevations

SHEET NUMBER

A-2.

PROJECT NO. 1544 © 2013 Knothe & Bruce Architects, LLC









MASONRY CAST STONE ACCE COMPOSITE META METAL SIDING & T FASCIA / SOFFIT / WINDOWS RAILING BUILDING ENTRAN

EXTERIOR MATERIAL SCHEDULE

	YANKEE HILL - LIGHT IRON SPOT SMOOTH	
CENTS	EDWARDS CAST STONE - 18-018	
AL PANELS	COATED METAL GROUP - SLATE GRAY	
TRIM	COATED METAL GROUP - MUSKET GRAY	
TRIM	COATED METAL GROUP - SLATE GRAY	
	ANDERSON 100 - BLACK	
	ALUMINUM - BLACK	
NCES	ALUMINUM STOREFRONT - BLACK	



TYPICAL MATERIALS

ISSUED

Issued for Land Use - January 21, 2019

PROJECT TITLE ATWOOD AVE. DEVELOPMENT

1938 Atwood Ave. Madison, WI SHEET TITLE Exterior Elevations

SHEET NUMBER

A-2.2

PROJECT NO. 1544 © 2013 Knothe & Bruce Architects, LLC

			WINDOWS RAILING BUILDING ENTRANCES
PURTH B/L + .HT B/L + .HT		CAST STONE	

SOUTHEAST ELEVATION ALONG ATWOOD AVENUE



EXTERIOR MATERIAL SCHEDULE

MASONRY CAST STONE ACCENTS COMPOSITE METAL PANELS METAL SIDING & TRIM FASCIA / SOFFIT / TRIM

YANKEE HILL - LIGHT IRON SPOT SMOOTH
EDWARDS CAST STONE - 18-018
COATED METAL GROUP - SLATE GRAY
COATED METAL GROUP - MUSKET GRAY
COATED METAL GROUP - SLATE GRAY
ANDERSON 100 - BLACK
ALUMINUM - BLACK
ALUMINUM STOREFRONT - BLACK

	<u>tyf</u>
	SUN
	MET
	ALU
	VIN
	CON
	MAS
AGE 1	MET
	ALU
FONE SILLS, BANDS	

PICAL MATERIALS

N SHADE

TAL SIDING & TRIM

JMINUM RAILINGS

IYL WINDOWS

MPOSITE METAL PANELS

SONRY VENEER

TAL CANOPY

JMINUM STOREFRONT



KEY PLAN

ISSUED Issued for Land Use - January 21, 2019

PROJECT TITLE ATWOOD AVE. DEVELOPMENT

1938 Atwood Ave. Madison, WI

SHEET TITLE Exterior Elevations -Rendered

SHEET NUMBER

A-3.1 PROJECT NUMBER 1544 © 2015 Knothe & Bruce Architects, LLC





2 NORTHWEST ELEVATION 1/8" = 1'-0"

TYPICAL MATERIALS

METAL AWNING

METAL SIDING & TRIM

- VINYL WINDOWS

- COMPOSITE METAL PANELS

MASONRY VENEER

- CAST STONE SILLS, BANDS



KEY PLAN

ISSUED Issued for Land Use - January 21, 2019

ATWOOD AVE. DEVELOPMENT

1938 Atwood Ave. Madison, WI

SHEET TITLE Exterior Elevations -Rendered

SHEET NUMBER

A-3.2 PROJECT NUMBER 1544 © 2015 Knothe & Bruce Architects, LLC



ATWOOD AVE. DEVELOPMENT

VIEW FROM WINNEBAGO ST.

1938 Atwood Ave. Madison, WI Persepctive 1 A-3.3



SIGNAGE SIGNAGE

ATWOOD AVE. DEVELOPMENT

VIEW FROM EAST CORNER



1938 Atwood Ave. Madison, WI Perspective 2 A-3.4





VIEW FROM SOUTH EAST CORNER

ATWOOD AVE. DEVELOPMENT

1938 Atwood Ave. Madison, WI Perspective 3 A-3.5



VIEW FROM EAST - ACROSS STREET





ATWOOD AVE. DEVELOPMENT

1938 Atwood Ave. Madison, WI Perspective 4 A-3.6





ATWOOD AVE. DEVELOPMENT

1938 Atwood Ave. Madison, WI Perspective 5





ATWOOD AVE. DEVELOPMENT

1938 Atwood Ave. Madison, WI Perspective 6





March 21 - 8am



March 21 - 12pm



June 21 - 7am



June 21 - 12pm



March 21 - 4pm



June 21 - 5pm ATWOOD AVE. DEVELOPMENT

1938 Atwood Ave. Madison, WI Sun Study A-3.9





September 21 - 8am



September 21 - 12pm






December 21 - 9am



December 21 - 12pm

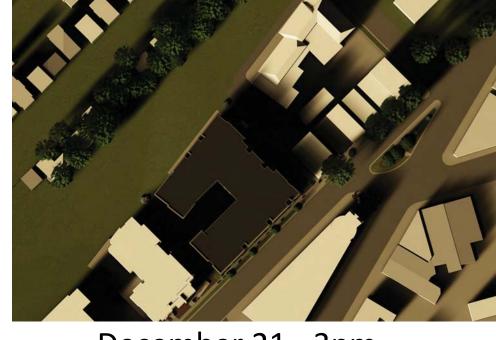

December 21 - 3pm ATWOOD AVE. DEVELOPMENT

1938 Atwood Ave. Madison, WI Sun Study A-3.10

