

LEGEND

- 1" IRON PIPE FOUND
- 3/4" REBAR FOUND

 © CHISELED 'X' SET
- O 3/4" x 24" REBAR SET (1.50 LBS/LF)
- --- PARCEL BOUNDARY
- --- RIGHT-OF-WAY LINE
- ---- CENTERLINE
- EDGE OF PAVEMENT
 CONCRETE CURB & GUTTER
- <u>////////</u> BUILDING
- CONCRETE PAVEMENT

NOTES

- 1. FIELD WORK PERFORMED BY JSD PROFESSIONAL SERVICES, INC. ON JUNE 5, 2012.
- 2. BEARINGS FOR THIS SURVEY AND MAP ARE REFERENCED TO THE NORTH LINE OF HARVEY STREET, ASSUMED TO BE SOUTH 86'51'05" WEST.
- 3. THIS PARCEL IS SUBJECT TO ALL EASEMENTS AND AGREEMENTS, BOTH RECORDED AND UNRECORDED.

LEGAL DESCRIPTION (AS FURNISHED)

(FIRST AMERICAN TITLE INSURANCE COMPANY COMMITMENT NUMBER: 2283611, EFFECTIVE DATE: MAY 25, 2012 AT 7:00 A.M.)

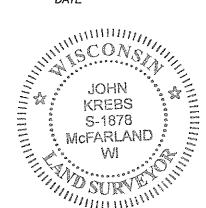
PART OF LOTS THREE (3), FOUR (4), AND FIVE (5), QUARRY TOWN, IN THE CITY OF MADISON, DANE COUNTY, WISCONSIN, DESCRIBED AS FOLLOWS:
BEGINNING AT AN IRON STAKE 300 FEET SOUTH OF THE CENTERLINE OF UNIVERSITY AVENUE AND 55.2
FEET WEST OF WEST LINE OF SCHMITT ADDITION TO FINDLAY PARK; THENCE SOUTH 123.1 FEET PARALLEL TO SAID WEST LINE TO AN IRON STAKE IN THE NORTHERLY LINE OF HARVEY STREET; THENCE WESTERLY 110 FEET MORE OR LESS ALONG THE SAID NORTHERLY LINE TO AN IRON STAKE, WHICH IS 165.2 FEET WEST OF THE WEST LINE OF SAID SCHMITT ADDITION; THENCE NORTH 128.3 FEET PARALLEL TO SAID WEST LINE TO AN IRON STAKE 300 FEET SOUTH OF CENTER LINE OF UNIVERSITY AVENUE; THENCE EAST 34.9 FEET PARALLEL TO SAID CENTER LINE TO AN IRON STAKE; THENCE NORTH 35 FEET PARALLEL TO SAID CENTER LINE TO AN IRON STAKE; THENCE EAST 75.1 FEET PARALLEL TO SAID CENTER LINE TO AN IRON STAKE; THENCE SOUTH 35 FEET PARALLEL TO SAID WEST LINE AND THE POINT OF BEGINNING.

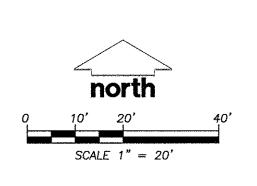
TAX KEY NO: 251/0709-212-0314-0 ADDRESS: 3118 HARVEY STREET MADISON, WI 53705

SURVEYOR'S CERTIFICATE

I, JOHN KREBS, WISCONSIN REGISTERED LAND SURVEYOR NO. S-1878, HEREBY CERTIFY THAT THIS PLAT OF SURVEY AND MAP IS CORRECT TO THE BEST OF MY KNOWLEDGE AND BELIEF IN ACCORDANCE WITH THE INFORMATION PROVIDED.

JOHN KREBS, S-1878 REGISTERED LAND SURVEYOR





2012-00568

PREPARED FOR

MR. DUKE DYKSTRA
3009 UNIVERSITY AVENUE
MADISON, WI 53705

 NORTHWEST
 APPROVED BY DWGNAME
 DATE 6-13-2012
 APPROVED BY DMJ
 DATE 6-14-2012

 NORTHWEST
 APPROVED BY DMJ
 DATE 6-14-2012
 APPROVED BY DWGNAME
 DATE 6-14-2012

 SIN.
 DWGNAME
 J:\2010A\104352\dwg\104352-POS.dwg
 REVISION
 DATE 6-14-2012

PART OF LOTS 3, 4 AND 5, QUARRY TOWN, BEING A QUARTER OF THE NORTHWEST QUARTER OF SECTION RANGE 9 EAST, CITY OF MADISON, DANE COL

Profession

Engineers **Survey

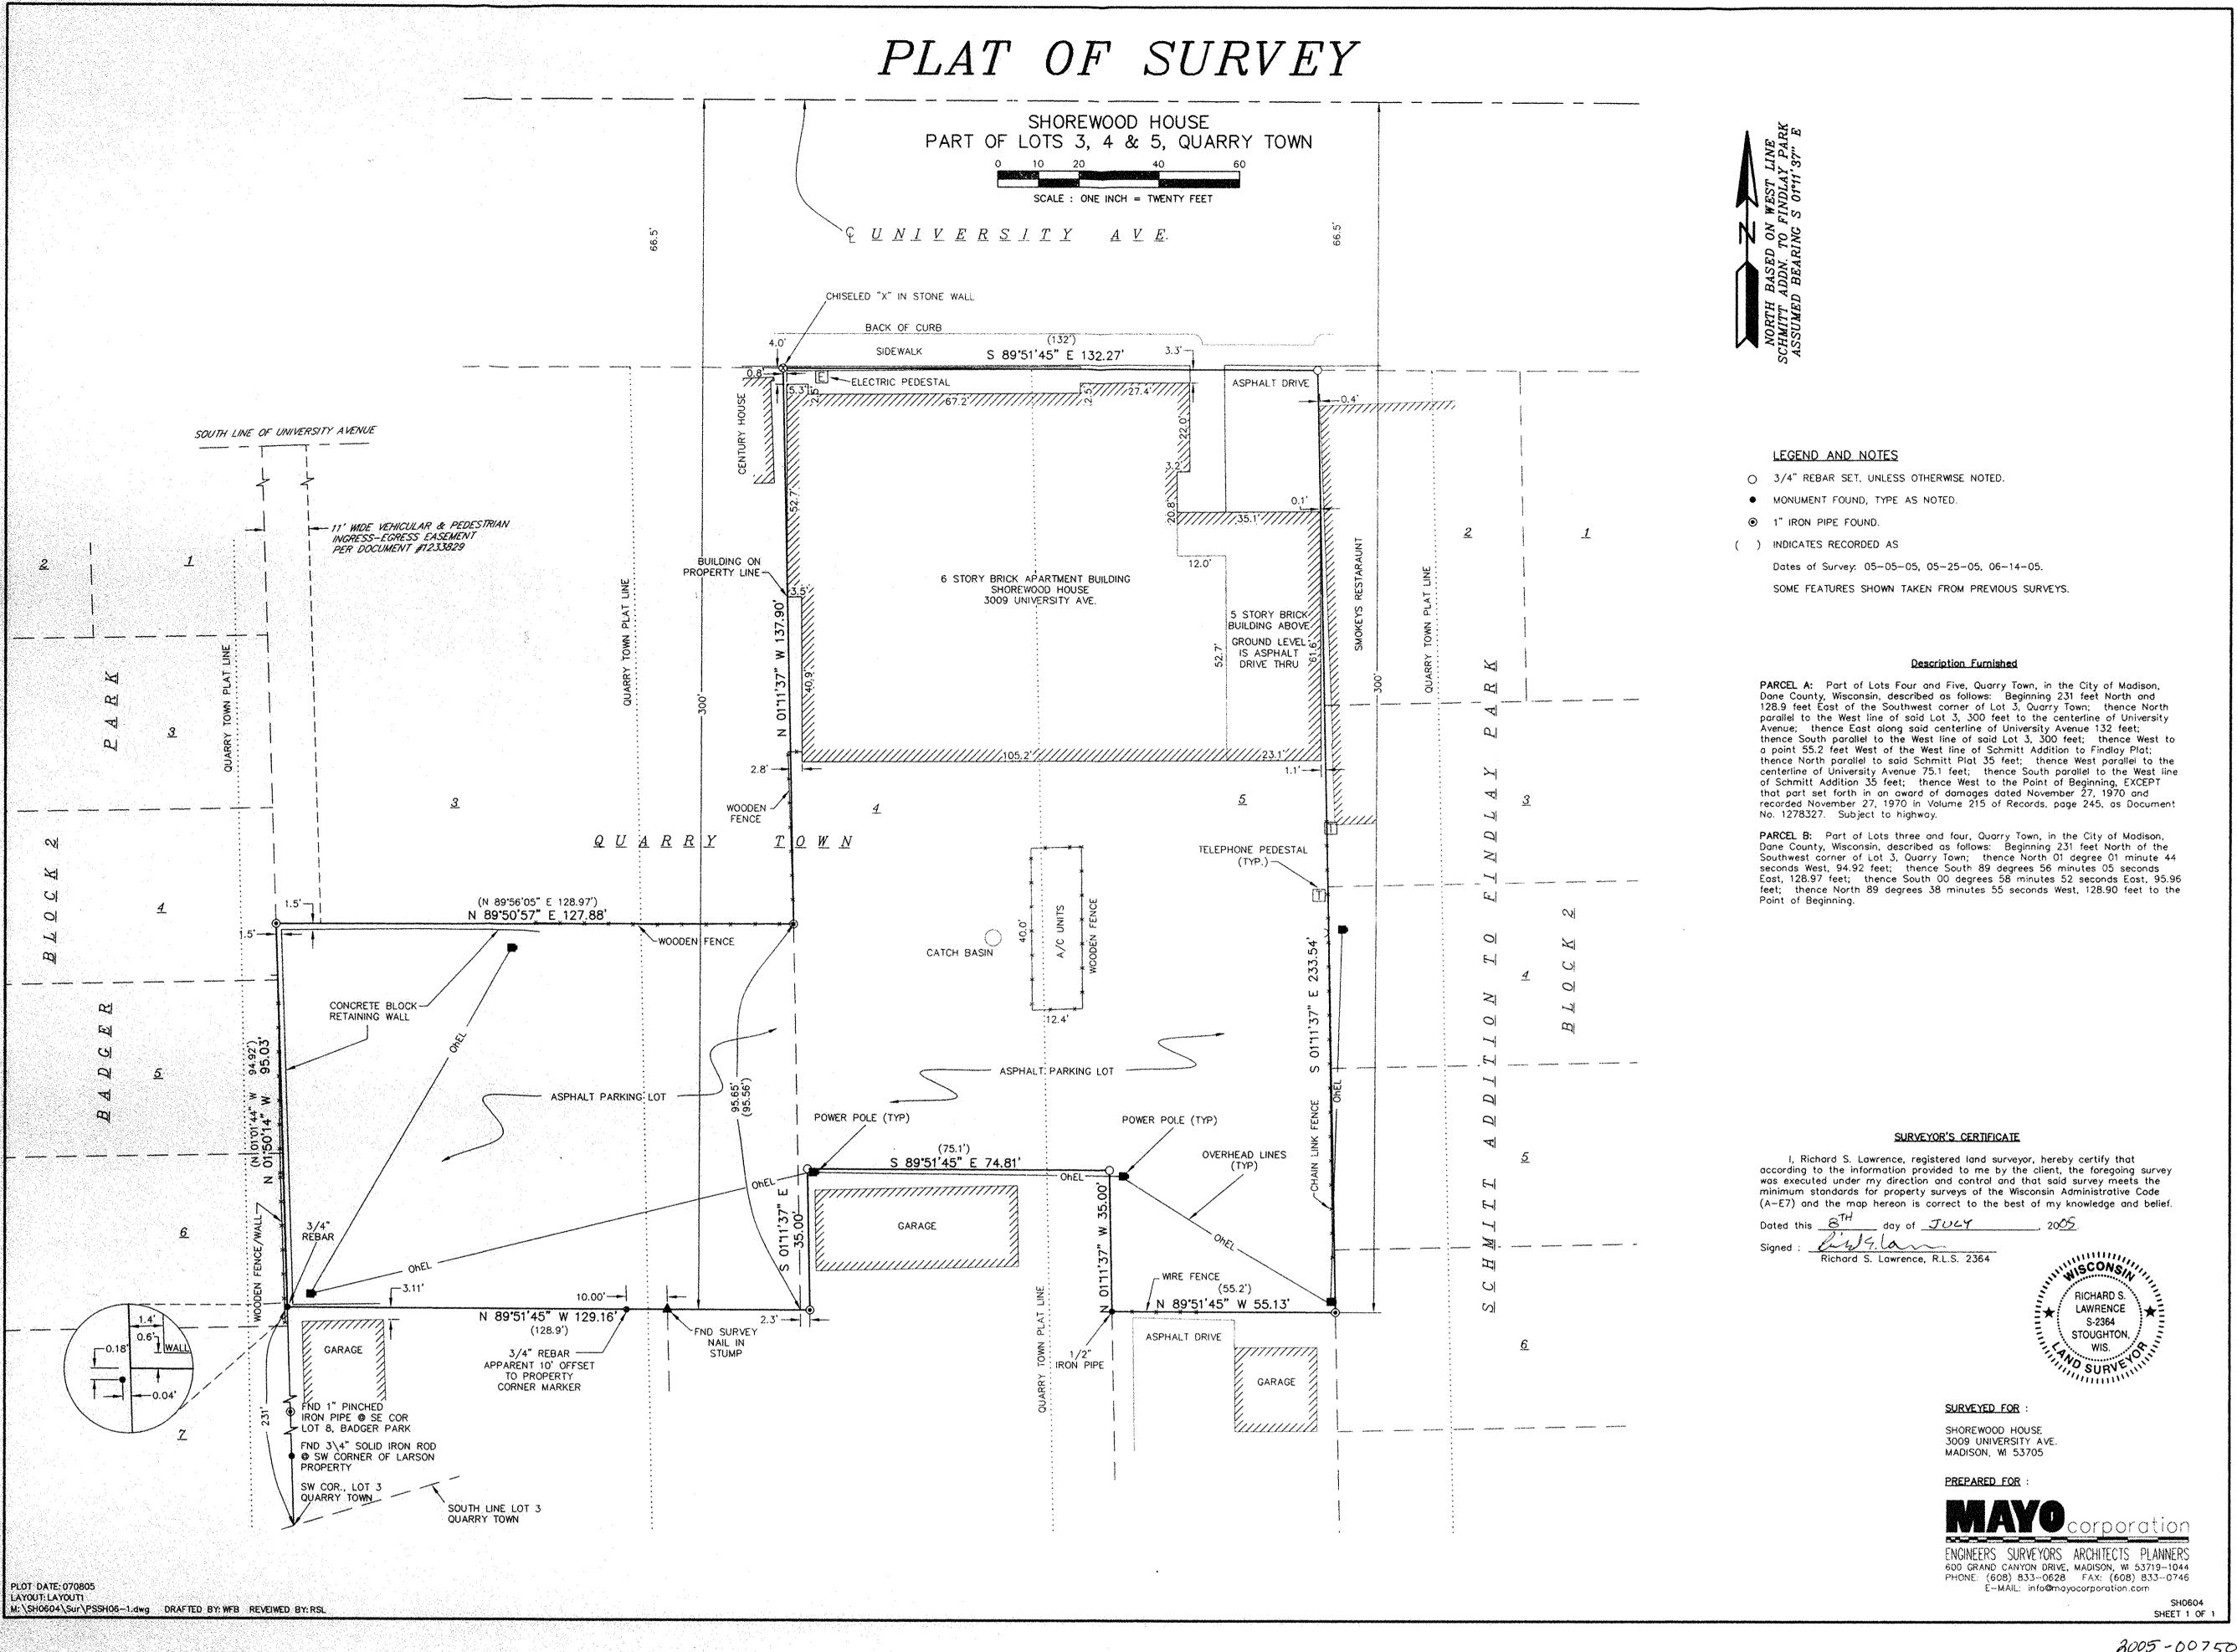
Engineers **Survey

**Let Horizon DRIVE, SUITE VERONA, WISCONSIN 5359.

PHONE: (608)848—5060

F.B. NO/PG: 248/96

SHEET NO: 1 OF 1





City of Madison Fire Department

314 W Dayton Street, Madison, WI 53703-2506

Phone: 608-266-4420 • Fax: 608-267-1100 • E-mail: fire@cityofmadison.com

Project Address: 3009 University Avenue				
Contact Name & Phone #: Duke Dykstra, 608-238-0501				

FIRE APPARATUS ACCESS AND FIRE HYDRANT WORKSHEET

 Is the building completely protected by an NFPA 13 or 13R automatic fire sprinkler system? If non-sprinklered, fire lanes extend to within 150-feet of all portions of the exterior wall? If sprinklered, fire lanes are within 250-feet of all portions of the exterior wall? 	Yes Yes Yes Yes	No No No	☐ N/A
 2. Is the fire lane constructed of concrete or asphalt, designed to support a minimum load of 85,000 lbs? a) Is the fire lane a minimum unobstructed width of at least 20-feet? b) Is the fire lane unobstructed with a vertical clearance of at least 13½-feet? c) Is the minimum inside turning radius of the fire lane at least 28-feet? d) Is the grade of the fire lane not more than a slope of 8%? e) Is the fire lane posted as fire lane? (Provide detail of signage.) f) Is a roll-able curb used as part of the fire lane? (Provide detail of curb.) g) Is part of a sidewalk used as part of the required fire lane? (Must support +85,000 lbs.) 	X Yes X Yes Yes Yes Yes Yes Yes Yes Yes Yes	No	 N/A
3. Is the fire lane obstructed by security gates or barricades? If yes:a) Is the gate a minimum of 20-feet clear opening?b) Is an approved means of emergency operations installed, key vault, padlock or key switch?	Yes Yes Yes Yes	No No No	□ N/A □ N/A □ N/A
4. Is the Fire lane dead-ended with a length greater than 150-feet? If yes, does the area for turning around fire apparatus comply with IFC D103?	X Yes ✓ Yes	□ No □ No	□ N/A □ N/A
5. Is any portion of the building to be used for high-piled storage in accordance with IFC Chapter 3206.6 If yes, see IFC 3206.6 for further requirements.	Yes	No No	□ N/A
6. Is any part of the building greater than 30-feet above the grade plane? If yes, answer the following questions:	X Yes	☐ No	□ N/A
If yes, answer the following questions: a) Is the aerial apparatus fire lane parallel to one entire side of the building and covering at least	X Yes	□ No	□ N/A
If yes, answer the following questions: a) Is the aerial apparatus fire lane parallel to one entire side of the building and covering at least 25% of the perimeter? b) Is the near edge of the aerial apparatus fire lane between 15' and 30' from the building? c) Are there any overhead power or utility lines located across the aerial apparatus fire lane?	((
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If yes, answer the following questions: a) Is the aerial apparatus fire lane parallel to one entire side of the building and covering at least 25% of the perimeter? b) Is the near edge of the aerial apparatus fire lane between 15' and 30' from the building? c) Are there any overhead power or utility lines located across the aerial apparatus fire lane? d) Are there any tree canopies expected to grow across the aerial fire lane? (Based on mature	X Yes X Yes Yes Yes	□ No □ No ■ No	□ N/A □ N/A □ N/A
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Attach an additional sheet if further explanation is required for any answers.

This worksheet is based on MGO 34.503 and IFC 2015 Edition Chapter 5 and Appendix D; please see the codes for further information.

Legal Descriptions

3009 University Avenue

Lot 1, Certified Survey Map Number 13842, recorded in Volume 92 of Certified Surveys on pages 4 through 8, as Document Number 5106910, Dane County Registry, Wisconsin.

3118 Harvey Street

Lot 2, Certified Survey Map Number 13842, recorded in Volume 92 of Certified Surveys on pages 4 through 8, as Document Number 5106910, Dane County Registry, Wisconsin.

Rezone Description from CC-T to TR-U1

Part of Lot 1, Certified Survey Map Number 13842, recorded in Volume 92 of Certified Surveys on pages 4 through 8, as Document Number 5106910, Dane County Registry, Wisconsin, more fully describes as follows:

Commencing at the southeast corner of said Lot 1;

thence North 88 degrees 41 minutes 44 seconds West along the south line of said Lot 1, 55.30 feet to the northeast corner of Lot 2, said CSM 13842 and to the Point of Beginning;

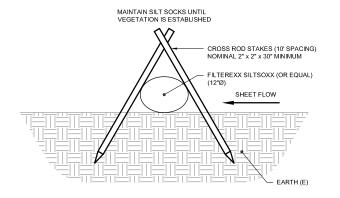
thence continuing North 88 degrees 41 minutes 44 seconds West along the south line of said Lot 1, 74.77 feet;

thence North 00 degrees 01 minute 25 seconds East, 35.16 feet;

thence South 88 degrees 38 minutes 37 seconds East, 74.77 feet;

thence South 00 degrees 01 minute 25 seconds East, 35.09 feet to the Point of Beginning.

This description contains 2,626 square feet





4"x4" COMPOSITE

FENCE POST TYP

1"x4"x6' COMPOSITE

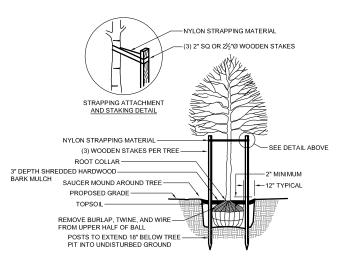
- EARTH (E)

FENCE SECTION DETAIL

- 1" - 3" GAP AT BASE

OF STONE FILL


18" CONCRETE BASE USE SONO TUBE OR EQUIVALENT



DECIDUOUS TREE PLANTING DETAIL C0.0

GENERAL NOTES:

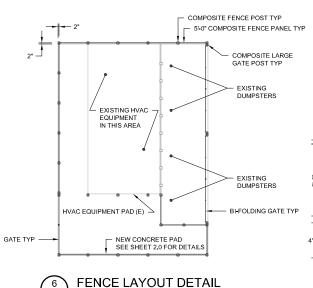
- 1. ROOT COLLAR TO BEAT GRADE.
- 2. DIG HOLE NO DEEPER THAN BASE OF ROOT BALL TO COLLAR.






GENERAL NOTES:

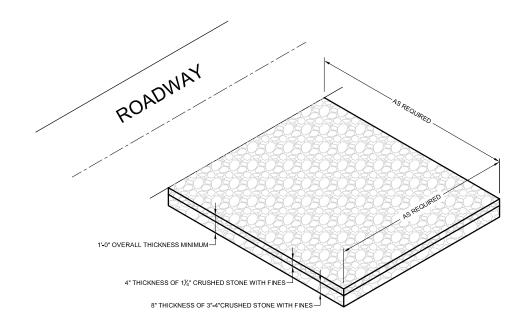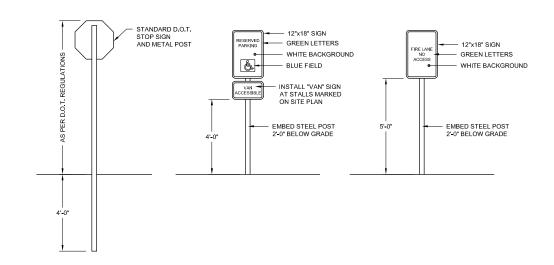
FENCE MATERIAL WILL BE GREEN TREATED WOOD, WITH COMPOSITE SLEEVE, AND END CAPS ON POST. THE ABOVE SHOWN LAYOUT IS TO PROVIDE AN OVERALL PICTURE OF WHAT THE FENCE SHOULD LOOK LIKE.







INSTRUCTIONAL SIGNAGE DETAIL

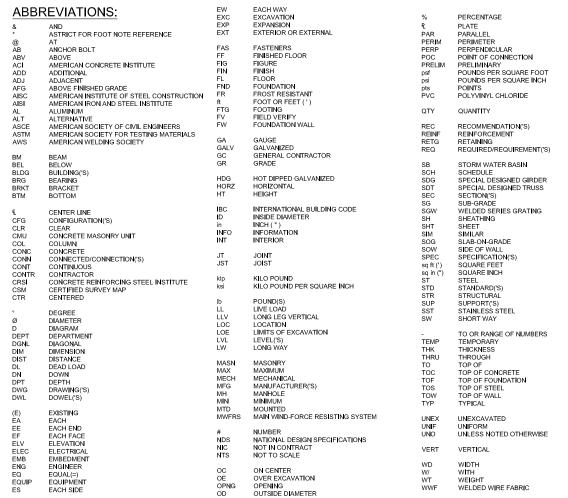

NOTE REGARDING EXISTING CONDITIONS:

INFORMATION PERTAINING TO EXISTING CONDITIONS GIVEN ON THESE CIVIL DRAWINGS REPRESENTS, TO THE BEST OF OUR KNOWLEDGE THE ACTUAL EXISTING FIELD CONDITIONS, TRUE BUSINESS LLC, MAKES NO WARRANTY AS TO THEIR ACCURACY. CONDITIONS, THE BUSINESS LICE, MARES NO WARRANTY AS TO THEIR ACCURACY. CONTRACTOR TO FIELD VERIFY EXISTING CONDITIONS IMPERATIVE TO THE NEW WORK, REPORT DISCREPANCIES BETWEEN THE DRAWINGS AND FIELD CONDITIONS TO THE ENGINEER OF RECORD FOR REVIEW, ANY WORK PERFORMED PRIOR TO RESOLUTION OF DISCREPANCIES BY THE ENGINEER OF RECORD IS SUBJECT TO REMOVAL AND REPLACEMENT AT NO ADDITIONAL COST TO THE CONTRACTOR

C5.1

CIVIL	SHEET INDEX
C0.0	ABBREVIATIONS, DETAILS, AND SYMBOLS
C1.0	EXISTING CONDITIONS/DEMOLITION PLAN - OVERALL SITE WORK
C1.1	EXISTING CONDITIONS/DEMOLITION PLAN - LANDSCAPING
C2.0	FIRE LANE NEW WORK PLAN - SITE WORK
C2.1	FIRE LANE NEW WORK PLAN - LANDSCAPING
C2.2	FIRE LANE NEW WORK PLAN - FINAL LAYOUT
C2.3	FIRE LANE GRADING PLAN
C5.0	SUPPLEMENTARY NEW WORK PLAN - CONCRETE WORK

SUPPLEMENTARY NEW WORK PLAN - FENCE WORK

C0.0

Phase: CD

Drawn By: AGM

Checked BvDND

Date: 06/18/18 Scale: AS NOTED

Job Number18-3009UN

⚠6-19-18 CONSTRUCTION DRAWN

⚠9-10-18 CD PER TRAFFIC ENG.

poo

S

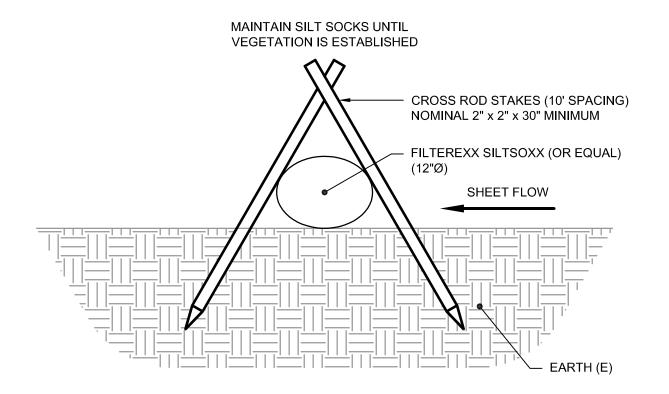
AVE - FIRE LANE PROPOSAL

SHOREWOOD HOUSE

SYMBOLS

ABBREVIATIONS, DETAILS, AND

12-19-18 LAND USE APPLICATION



EROSION CONTROL DETAIL

- 4"x4" COMPOSITE

FENCE POST TYP

- 1"x4"x6' COMPOSITE

FENCE PANEL TYP

─ EARTH (E)

FENCE SECTION DETAIL

— 1" - 3" GAP AT BASE

- NEW 5" - 6" THICK

CONCRETE PAD

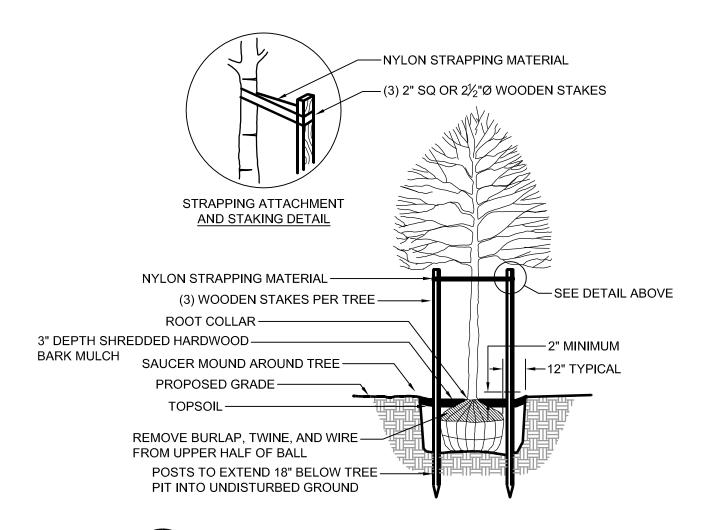
— 12" TOTAL DEPTH

OF STONE FILL

USE SONO TUBE

OR EQUIVALENT

- 18" CONCRETE BASE




DECIDUOUS TREE PLANTING DETAIL

GENERAL NOTES:

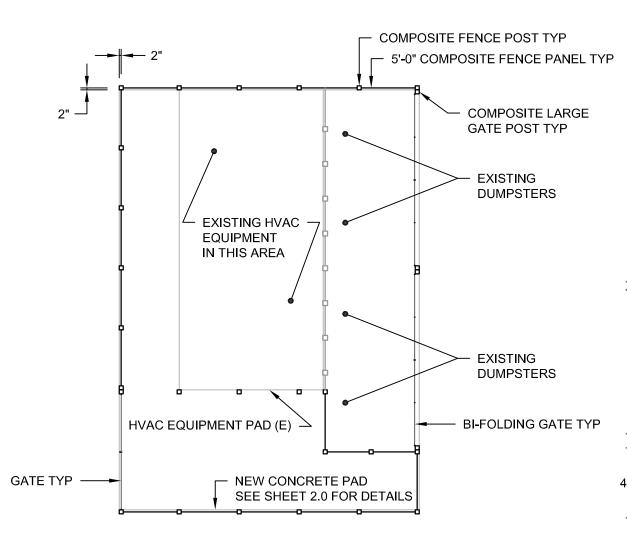1. ROOT COLLAR TO BEAT GRADE.

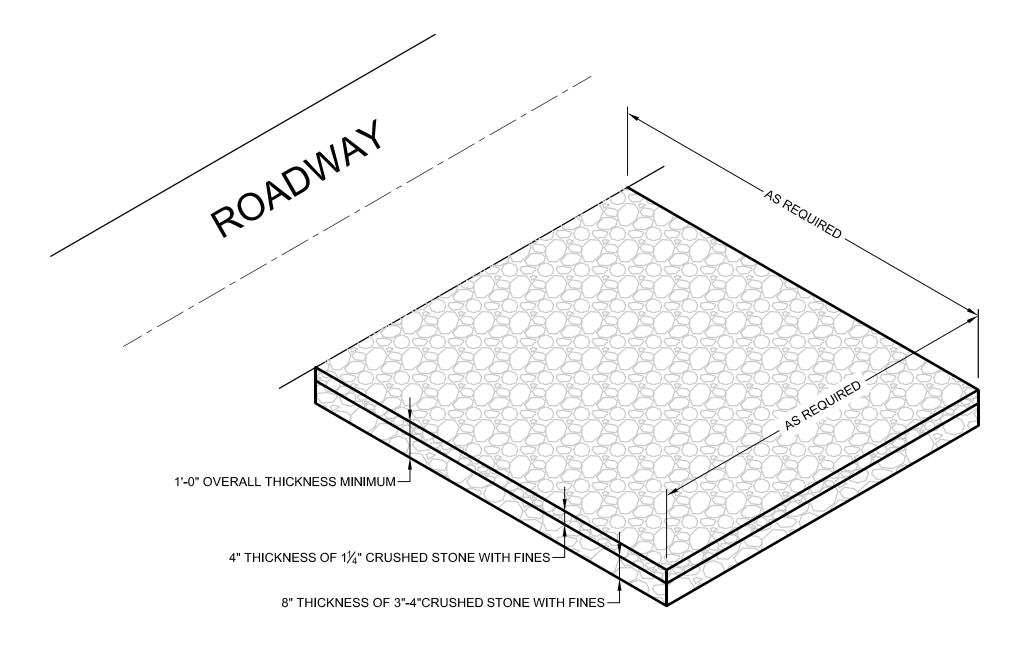
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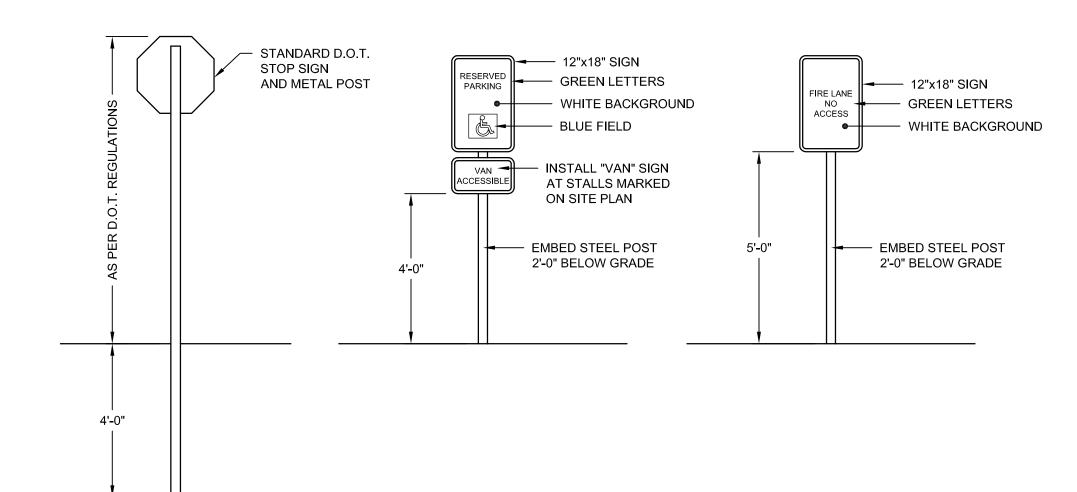


GENERAL NOTES:

1. FENCE MATERIAL WILL BE GREEN TREATED WOOD, WITH COMPOSITE SLEEVE, AND END CAPS ON POST. THE ABOVE SHOWN LAYOUT IS TO PROVIDE AN OVERALL PICTURE OF WHAT THE FENCE SHOULD LOOK LIKE.



ASPHALT BASE COURSE DETAIL





ABBF	REVIATIONS:	EW EXC	EACH WAY EXCAVATION	%	PERCENTAGE
		EXP	EXPANSION		
&	AND			ዊ	PLATE
*	ASTRICT FOR FOOT NOTE REFERENCE	EXT	EXTERIOR OR EXTERNAL	PAR	PARALLEL
@	AT	E40	FACTENEDO	PERIM	PERIMETER
AB	ANCHOR BOLT	FAS	FASTENERS	PERP	PERPENDICULAR
ABV	ABOVE	FF	FINISHED FLOOR	POC	POINT OF CONNECTION
ACI	AMERICAN CONCRETE INSTITUTE	FIG	FIGURE	PRELIM	PRELIMINARY
ADD	ADDITIONAL	FIN	FINISH	psf	POUNDS PER SQUARE FOOT
ADJ	ADJACENT	FL	FLOOR	psi	POUNDS PER SQUARE INCH
AFG	ABOVE FINISHED GRADE	FND	FOUNDATION	pts	POINTS
AISC	AMERICAN INSTITUTE OF STEEL CONSTRUCTION	FR	FROST RESISTANT	PVC	POLYVINYL CHLORIDE
AISI	AMERICAN IRON AND STEEL INSTITUTE	ft	FOOT OR FEET (')		
AL	ALUMINUM	FTG	FOOTING	QTY	QUANTITY
ALT	ALTERNATIVE	FV	FIELD VERIFY	Q(11	Q0/11/11
ASCE	AMERICAN SOCIETY OF CIVIL ENGINEERS	FW	FOUNDATION WALL	REC	RECOMMENDATION('S)
				REINF	REINFORCEMENT
ASTM	AMERICAN SOCIETY FOR TESTING MATERIALS	GA	GAUGE		
AWS	AMERICAN WELDING SOCIETY	GALV	GALVANIZED	RETG	RETAINING
				REQ	REQUIRED/REQUIREMENT('S)
BM	BEAM	GC CB	GENERAL CONTRACTOR		
BEL	BELOW	GR	GRADE	SB	STORM WATER BASIN
BLDG	BUILDING('S)	LIDO	HOT DIDDED ON MANUTED	SCH	SCHEDULE
BRG	BEARING	HDG	HOT DIPPED GALVANIZED	SDG	SPECIAL DESIGNED GIRDER
BRKT	BRACKET	HORZ	HORIZONTAL	SDT	SPECIAL DESIGNED TRUSS
втм	BOTTOM	HT	HEIGHT	SEC	SECTION('S)
				SG	SUB-GRADÉ
Ę	CENTER LINE	IBC	INTERNATIONAL BUILDING CODE	SGW	WELDED SERIES GRATING
		ID	INSIDE DIAMETER	SH	SHEATHING
CFG	CONFIGURATION('S)	in	INCH(")	SHT	SHEET
CLR	CLEAR	INFO	INFORMÁTION	SIM	SIMILAR
CMU	CONCRETE MASONRY UNIT	INT	INTERIOR	SOG	SLAB-ON-GRADE
COL	COLUMN			SOW	SIDE OF WALL
CONC	CONCRETE	JT	JOINT		
CONN	CONNECTED/CONNECTION('S)	JST	JOIST	SPEC	SPECIFICATION('S)
CONT	CONTINUOUS	J31	30131	sq ft (')	SQUARE FEET
CONTR	CONTRACTOR	lein	KILO BOLIND	sq in (")	SQUARE INCH
CRSI	CONCRETE REINFORCING STEEL INSTITUTE	kip	KILO POUND	ST	STEEL
CSM	CERTIFIED SURVEY MAP	ksi	KILO POUND PER SQUARE INCH	STD	STANDARD('S)
CTR	CENTERED			STR	STRUCTURAL
		lb	POUND(S)	SUP	SUPPORT('S)
0	DEGREE	LL	LIVE LOAD	SST	STAINLESS STEEL
Ø	DIAMETER	LLV	LONG LEG VERTICAL	SW	SHORT WAY
D	DIAGRAM	LOC	LOCATION		
DEPT	DEPARTMENT	LOE	LIMITS OF EXCAVATION	_	TO OR RANGE OF NUMBERS
		LVL	LEVEL('S)	TEMP	TEMPORARY
DGNL	DIAGONAL	LW	LONG WÁY	THK	THICKNESS
DIM	DIMENSION			THRU	THROUGH
DIST	DISTANCE	MASN	MASONRY	TO	TOP OF
DL	DEAD LOAD	MAX	MAXIMUM	TOC	
DN	DOWN	MECH	MECHANICAL		TOP OF CONCRETE
DPT	DEPTH	MFG	MANUFACTURER('S)	TOF	TOP OF FOUNDATION
DWG	DRAWING('S)	MH	MANHOLE	TOS	TOP OF STEEL
DWL	DOWEL('S)			TOW	TOP OF WALL
	` '	MIN	MINIMUM	TYP	TYPICAL
(E)	EXISTING	MTD	MOUNTED		
ĒΑ	EACH	MWFRS	MAIN WIND-FORCE RESISTING SYSTEM	UNEX	UNEXCAVATED
EE	EACH END			UNIF	UNIFORM
EF	EACH FACE	#	NUMBER	UNO	UNLESS NOTED OTHERWISE
ELV	ELEVATION	NDS	NATIONAL DESIGN SPECIFICATIONS		
ELEC	ELECTRICAL	NIC	NOT IN CONTRACT	VERT	VERTICAL
		NTS	NOT TO SCALE		
EMB	EMBEDMENT			WD	WIDTH
ENG	ENGINEER	OC	ON CENTER	W/	WITH
EQ	EQUAL(=)	OE	OVER EXCAVATION	WT	WEIGHT
EQUIP	EQUIPMENT	OPNG	OPENING	WWF	WELDED WIRE FABRIC
ES	EACH SIDE	OD	OUTSIDE DIAMETER	V V V I	VVLLDED VVIIVE I ADIVIO
		=			

NOTE REGARDING EXISTING CONDITIONS:

INFORMATION PERTAINING TO EXISTING CONDITIONS GIVEN ON THESE CIVIL DRAWINGS REPRESENTS, TO THE BEST OF OUR KNOWLEDGE THE ACTUAL EXISTING FIELD CONDITIONS. TRUE BUSINESS LLC, MAKES NO WARRANTY AS TO THEIR ACCURACY. CONTRACTOR TO FIELD VERIFY EXISTING CONDITIONS IMPERATIVE TO THE NEW WORK. REPORT DISCREPANCIES BETWEEN THE DRAWINGS AND FIELD CONDITIONS TO THE ENGINEER OF RECORD FOR REVIEW. ANY WORK PERFORMED PRIOR TO RESOLUTION OF DISCREPANCIES BY THE ENGINEER OF RECORD IS SUBJECT TO REMOVAL AND REPLACEMENT AT NO ADDITIONAL COST TO THE CONTRACTOR.

CIVIL SHEET INDEX

ABBREVIATIONS, DETAILS, AND SYMBOLS C1.0 EXISTING CONDITIONS/DEMOLITION PLAN - OVERALL SITE WORK C1.1 EXISTING CONDITIONS/DEMOLITION PLAN - LANDSCAPING C2.0 FIRE LANE NEW WORK PLAN - SITE WORK

FIRE LANE NEW WORK PLAN - LANDSCAPING

C2.1 C2.2 FIRE LANE NEW WORK PLAN - FINAL LAYOUT

C2.3 FIRE LANE GRADING PLAN

C5.0 SUPPLEMENTARY NEW WORK PLAN - CONCRETE WORK C5.1 SUPPLEMENTARY NEW WORK PLAN - FENCE WORK

Phase: CD Drawn By: AGM Checked ByDND Date: 06/18/18 Scale: AS NOTED Job Number18-3009UN SHEET NUMBER C0.0

REVISION:

S

6-19-18 CONSTRUCTION DRAWINGS

↑ 9-10-18 CD PER TRAFFIC ENG. 12-19-18 LAND USE APPLICATION

⚠6-19-18 CONSTRUCTION DRAWN -ewood S EXISTING CONDITIONS / DEMOLITION PLAN - OVERALL SITE WORK 3009 UNIVERSITY AVE - FIRE LANE PROPOSAL SHOREWOOD HOUSE Phase: CD Drawn By: AGM Checked ByDND Date: 06/18/18 Scale: AS NOTED lob Number18-3009UN C1.0

HARVEY STREET /

C1.0

EXISTING CONDITIONS / DEMOLITION PLAN - OVERALL SITE WORK

UNIVERSITY AVENUE

EXISTING CONDITIONS / DEMOLITION PLAN - OVERALL SITE WORK SCALE: 1"=20'

REVISION:

SHOREWOOD HOU
UNIVERSITY AVE - FIRE LANE P

Drawn By: AGM

Checked ByDND

Date: 06/18/18

Scale: AS NOTED

Job Number18-3009UN

SHEET NUMBER

C1.0

EXISTING

6-19-18 CONSTRUCTION DRAWINGS

↑9-10-18 CD PER TRAFFIC ENG. 12-19-18 LAND USE APPLICATION

₫6-19-18 CONSTRUCTION DRAWN poo S SHOREWOOD HOUSE 3009 UNIVERSITY AVE - FIRE LANE PROPOSAL EXISTING CONDITIONS / DEMOLITION PLAN LANDSCAPING Phase: CD Drawn By: AGM Checked ByDND Date: 06/18/18

Scale: AS NOTED

Job Number18-3009UN

C1.1

G 🗊

1 EXISTING CONDITIONS / DEMOLITION PLAN - LANDSCAPING

REVISION: 6-19-18 CONSTRUCTION DRAWINGS 10−18 CD PER TRAFFIC ENG. 12-19-18 LAND USE APPLICATION SHOREWOOD HOU
3009 UNIVERSITY AVE - FIRE LANE EXISTING CONDITIONS / DEMOR Checked ByDND Date: 06/18/18 Scale: AS NOTED Job Number18-3009UN

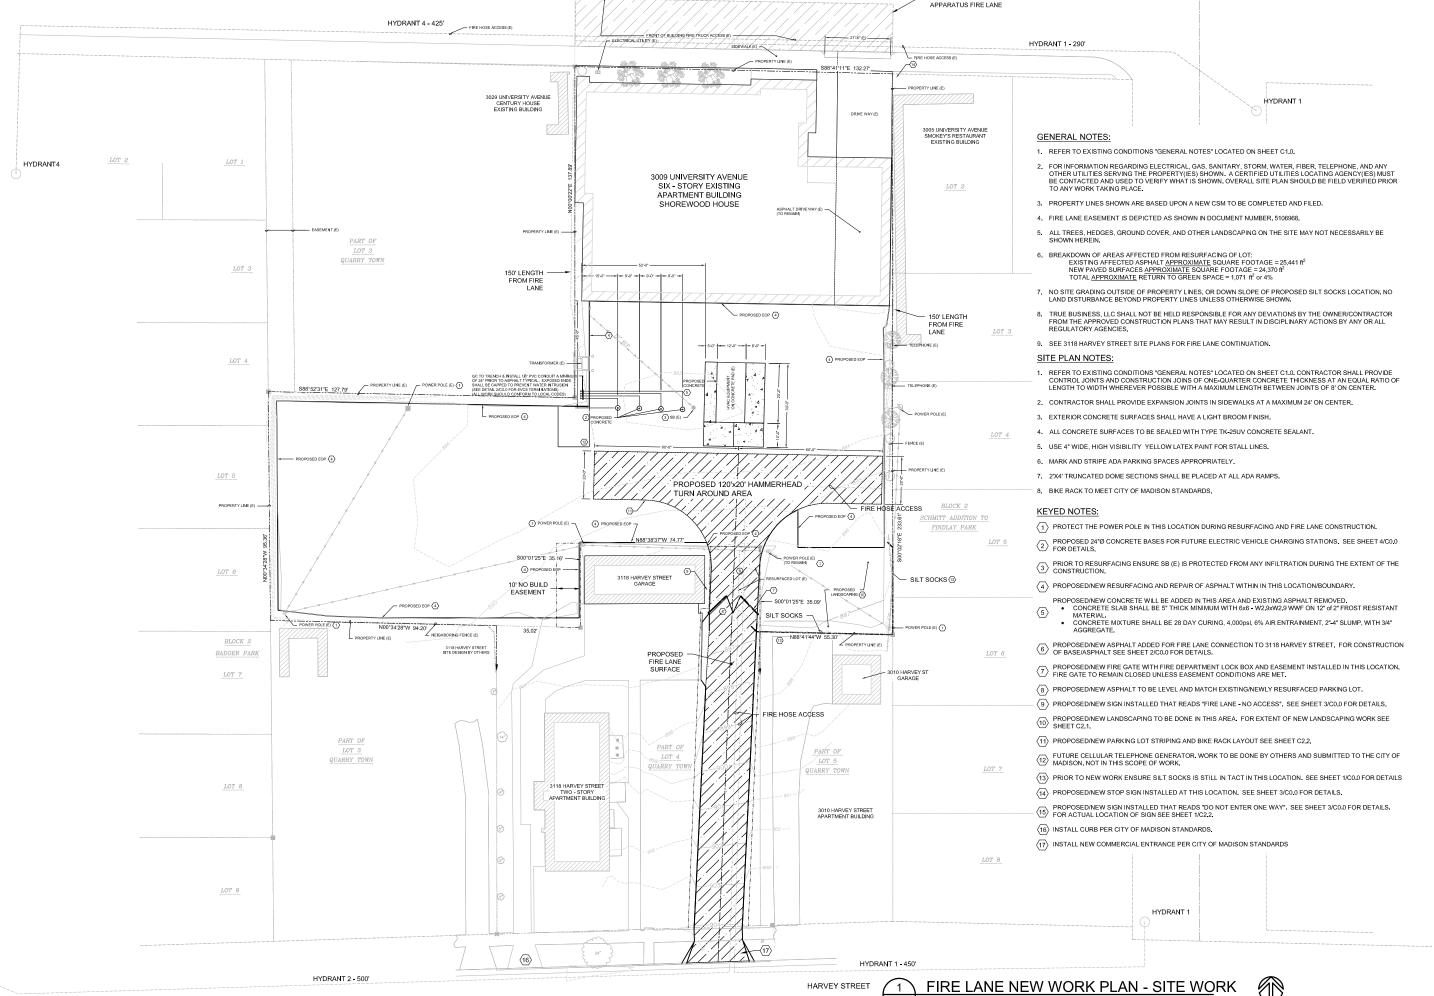
SHEET NUMBER

C1.1

EXISTING CONDITIONS / DEMOLITION PLAN - LANDSCAPING

C1.1 SCALE: 1"=20"






HYDRANT 2

REVISION: ⚠6-19-18 CONSTRUCTION DRAWN I po Ś OOD HOUSE
- FIRE LANE PROPOSAL NEW WORK PLAN - SITE SHOREWOOD UNIVERSITY AVE - FIRE I LANE FIRE Phase: CD Drawn By: AGM Checked ByDND Date: 06/18/18 Scale: AS NOTED

Job Number18-3009UN

C2.0

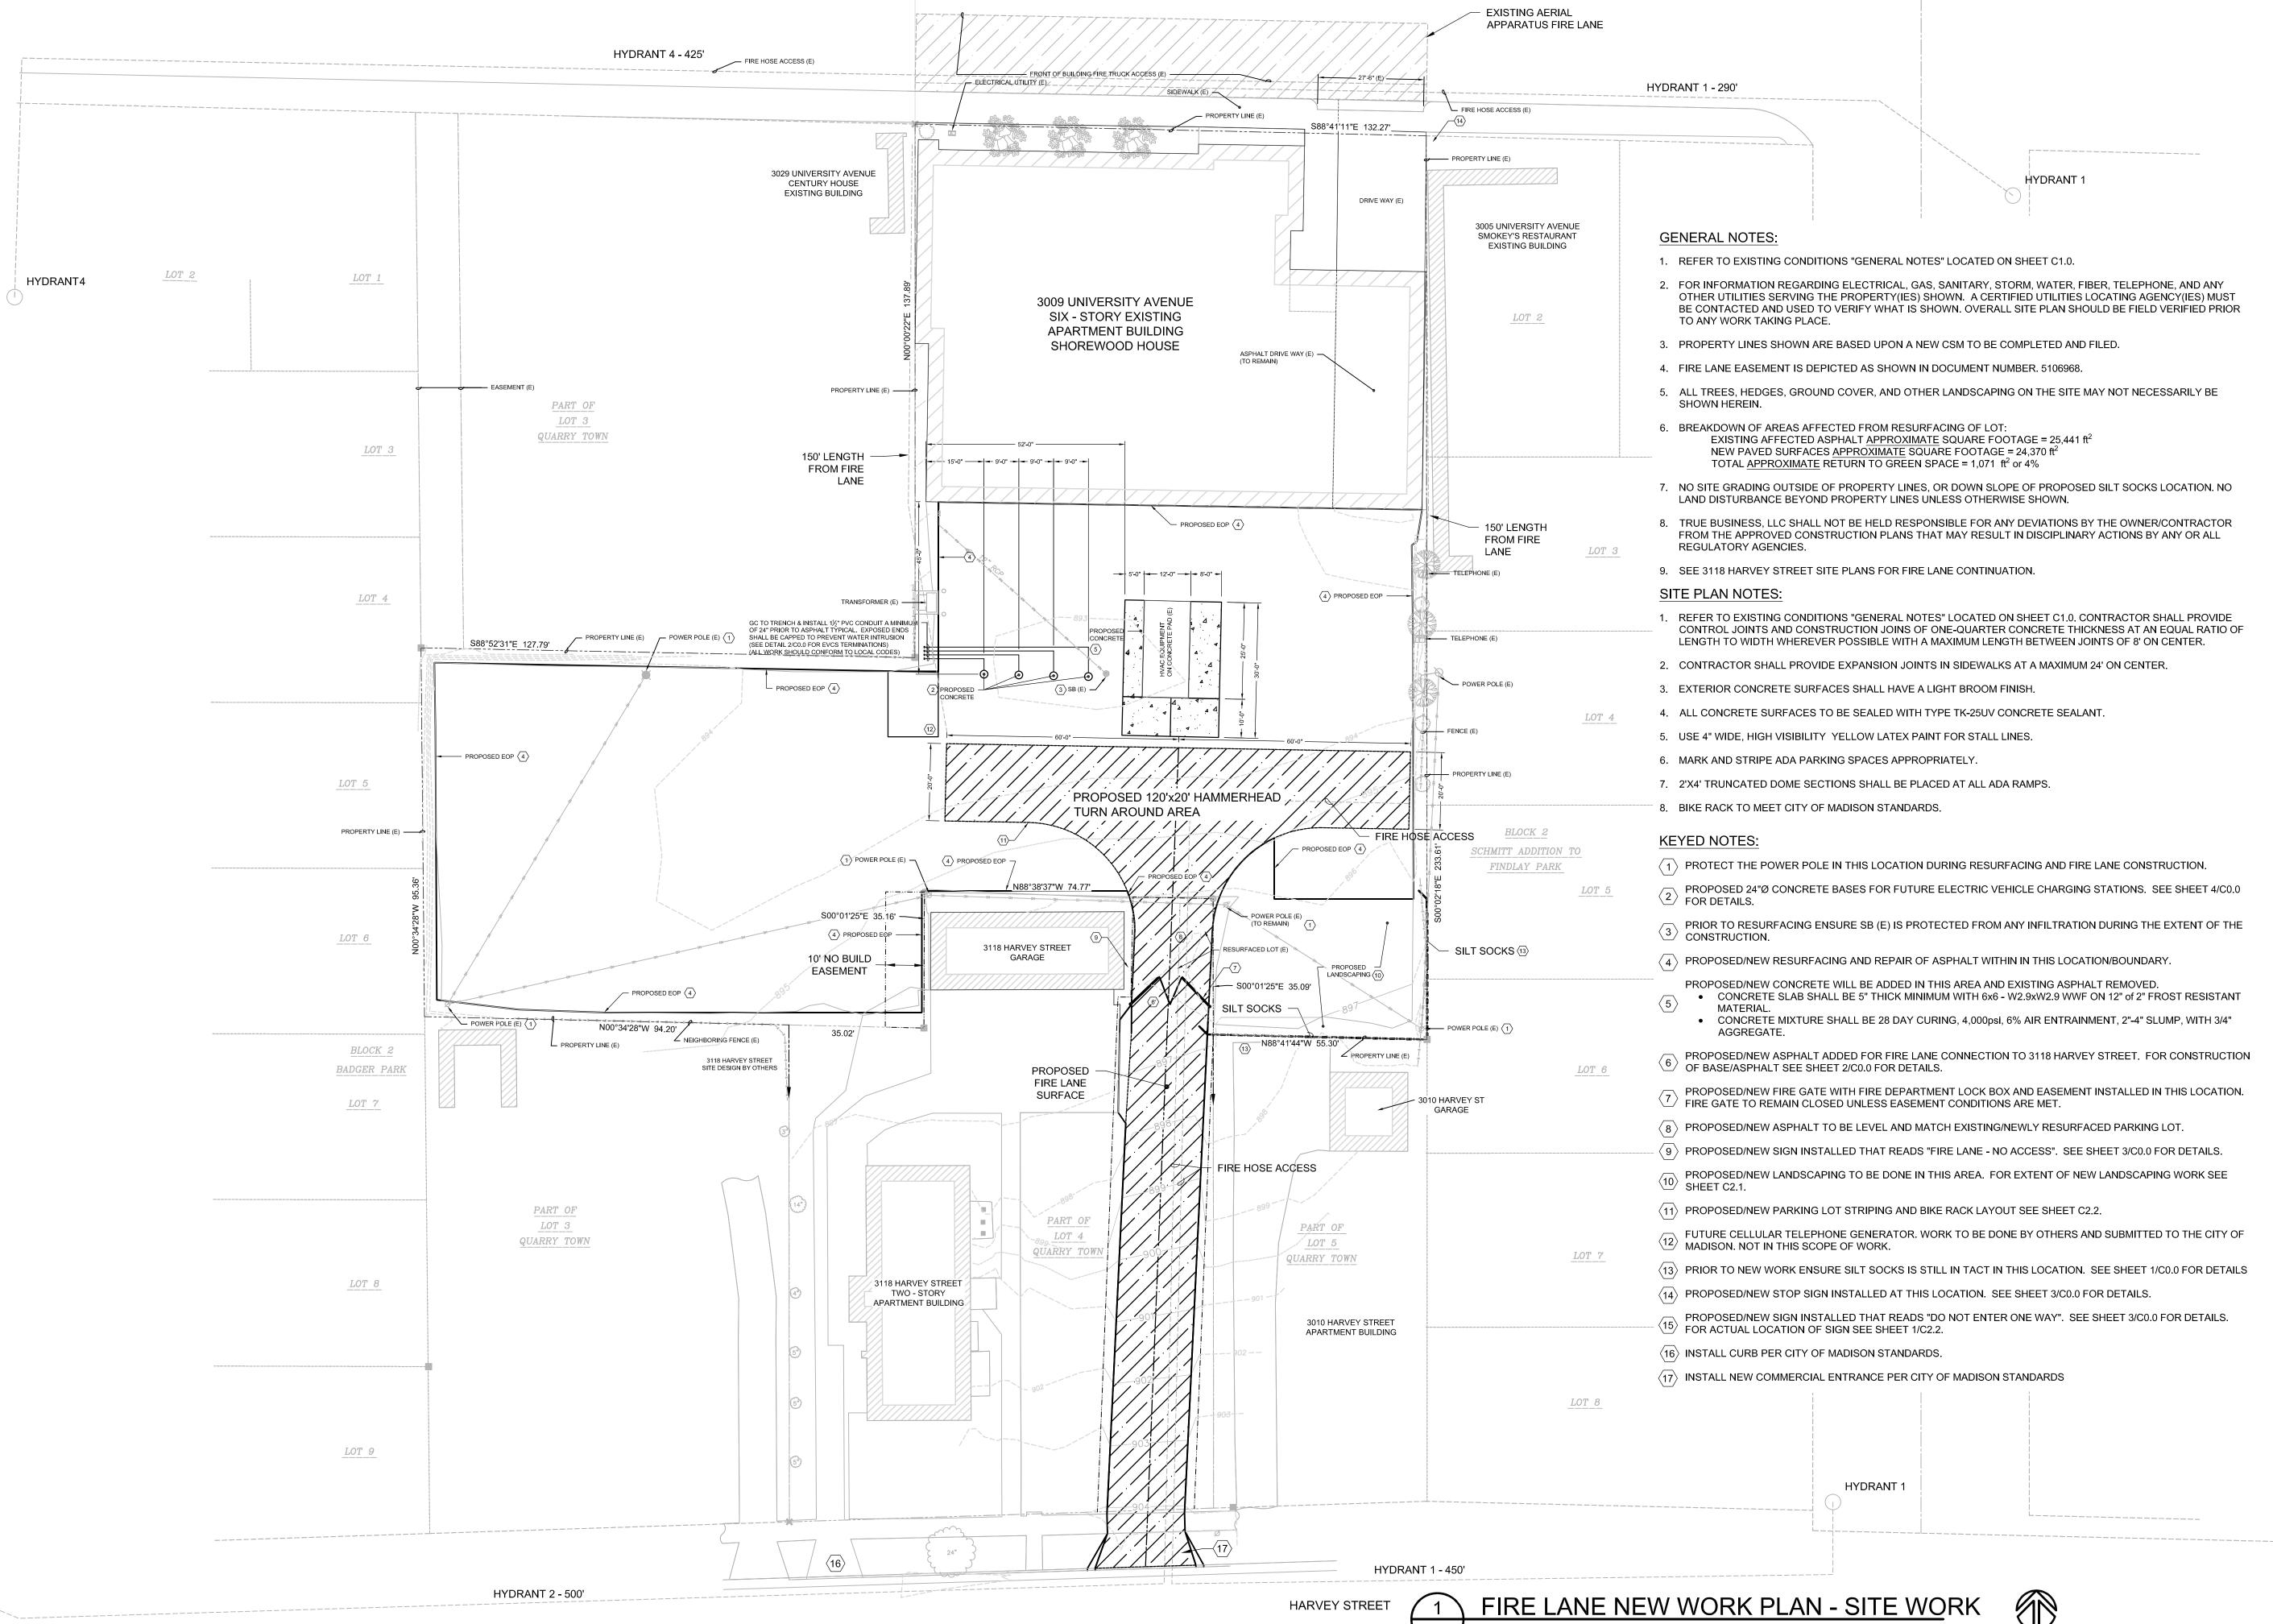C2.0



HYDRANT 2

UNIVERSITY AVENUE

C2.0 SCALE: 1"=20'

REVISION:

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Phase: CD

Drawn By: AGM Checked ByDND Date: 06/18/18

Scale: AS NOTED

Job Number18-3009UN

SHEET NUMBER

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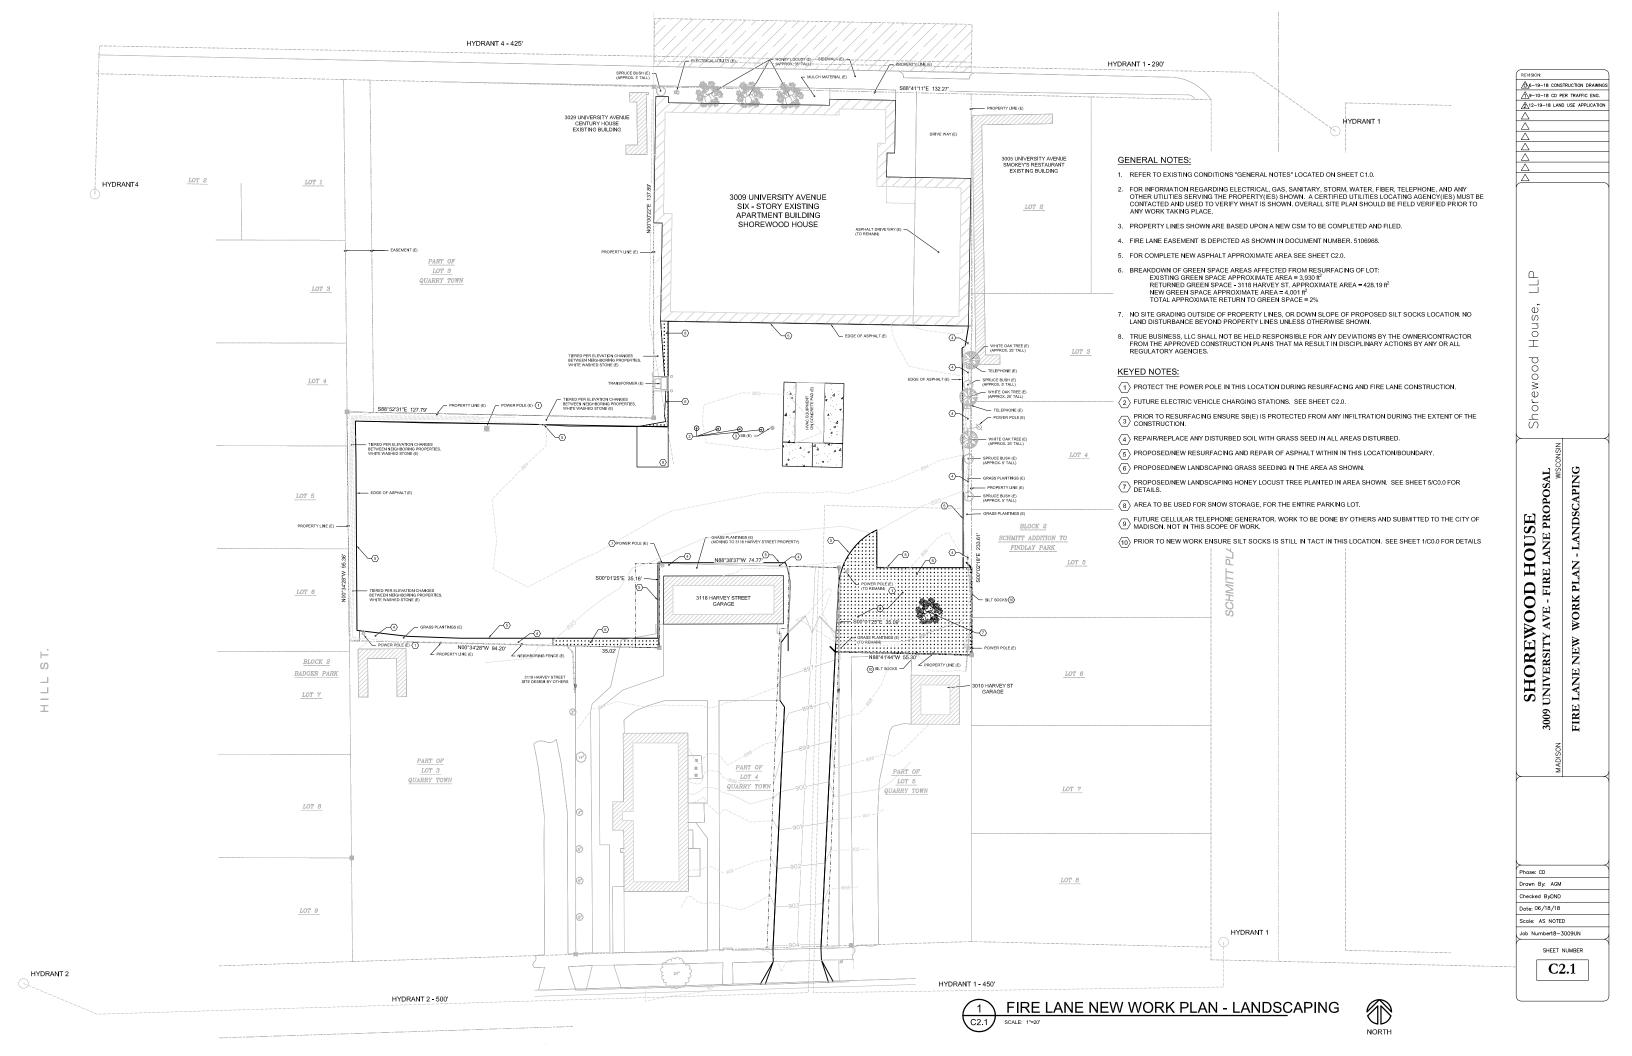
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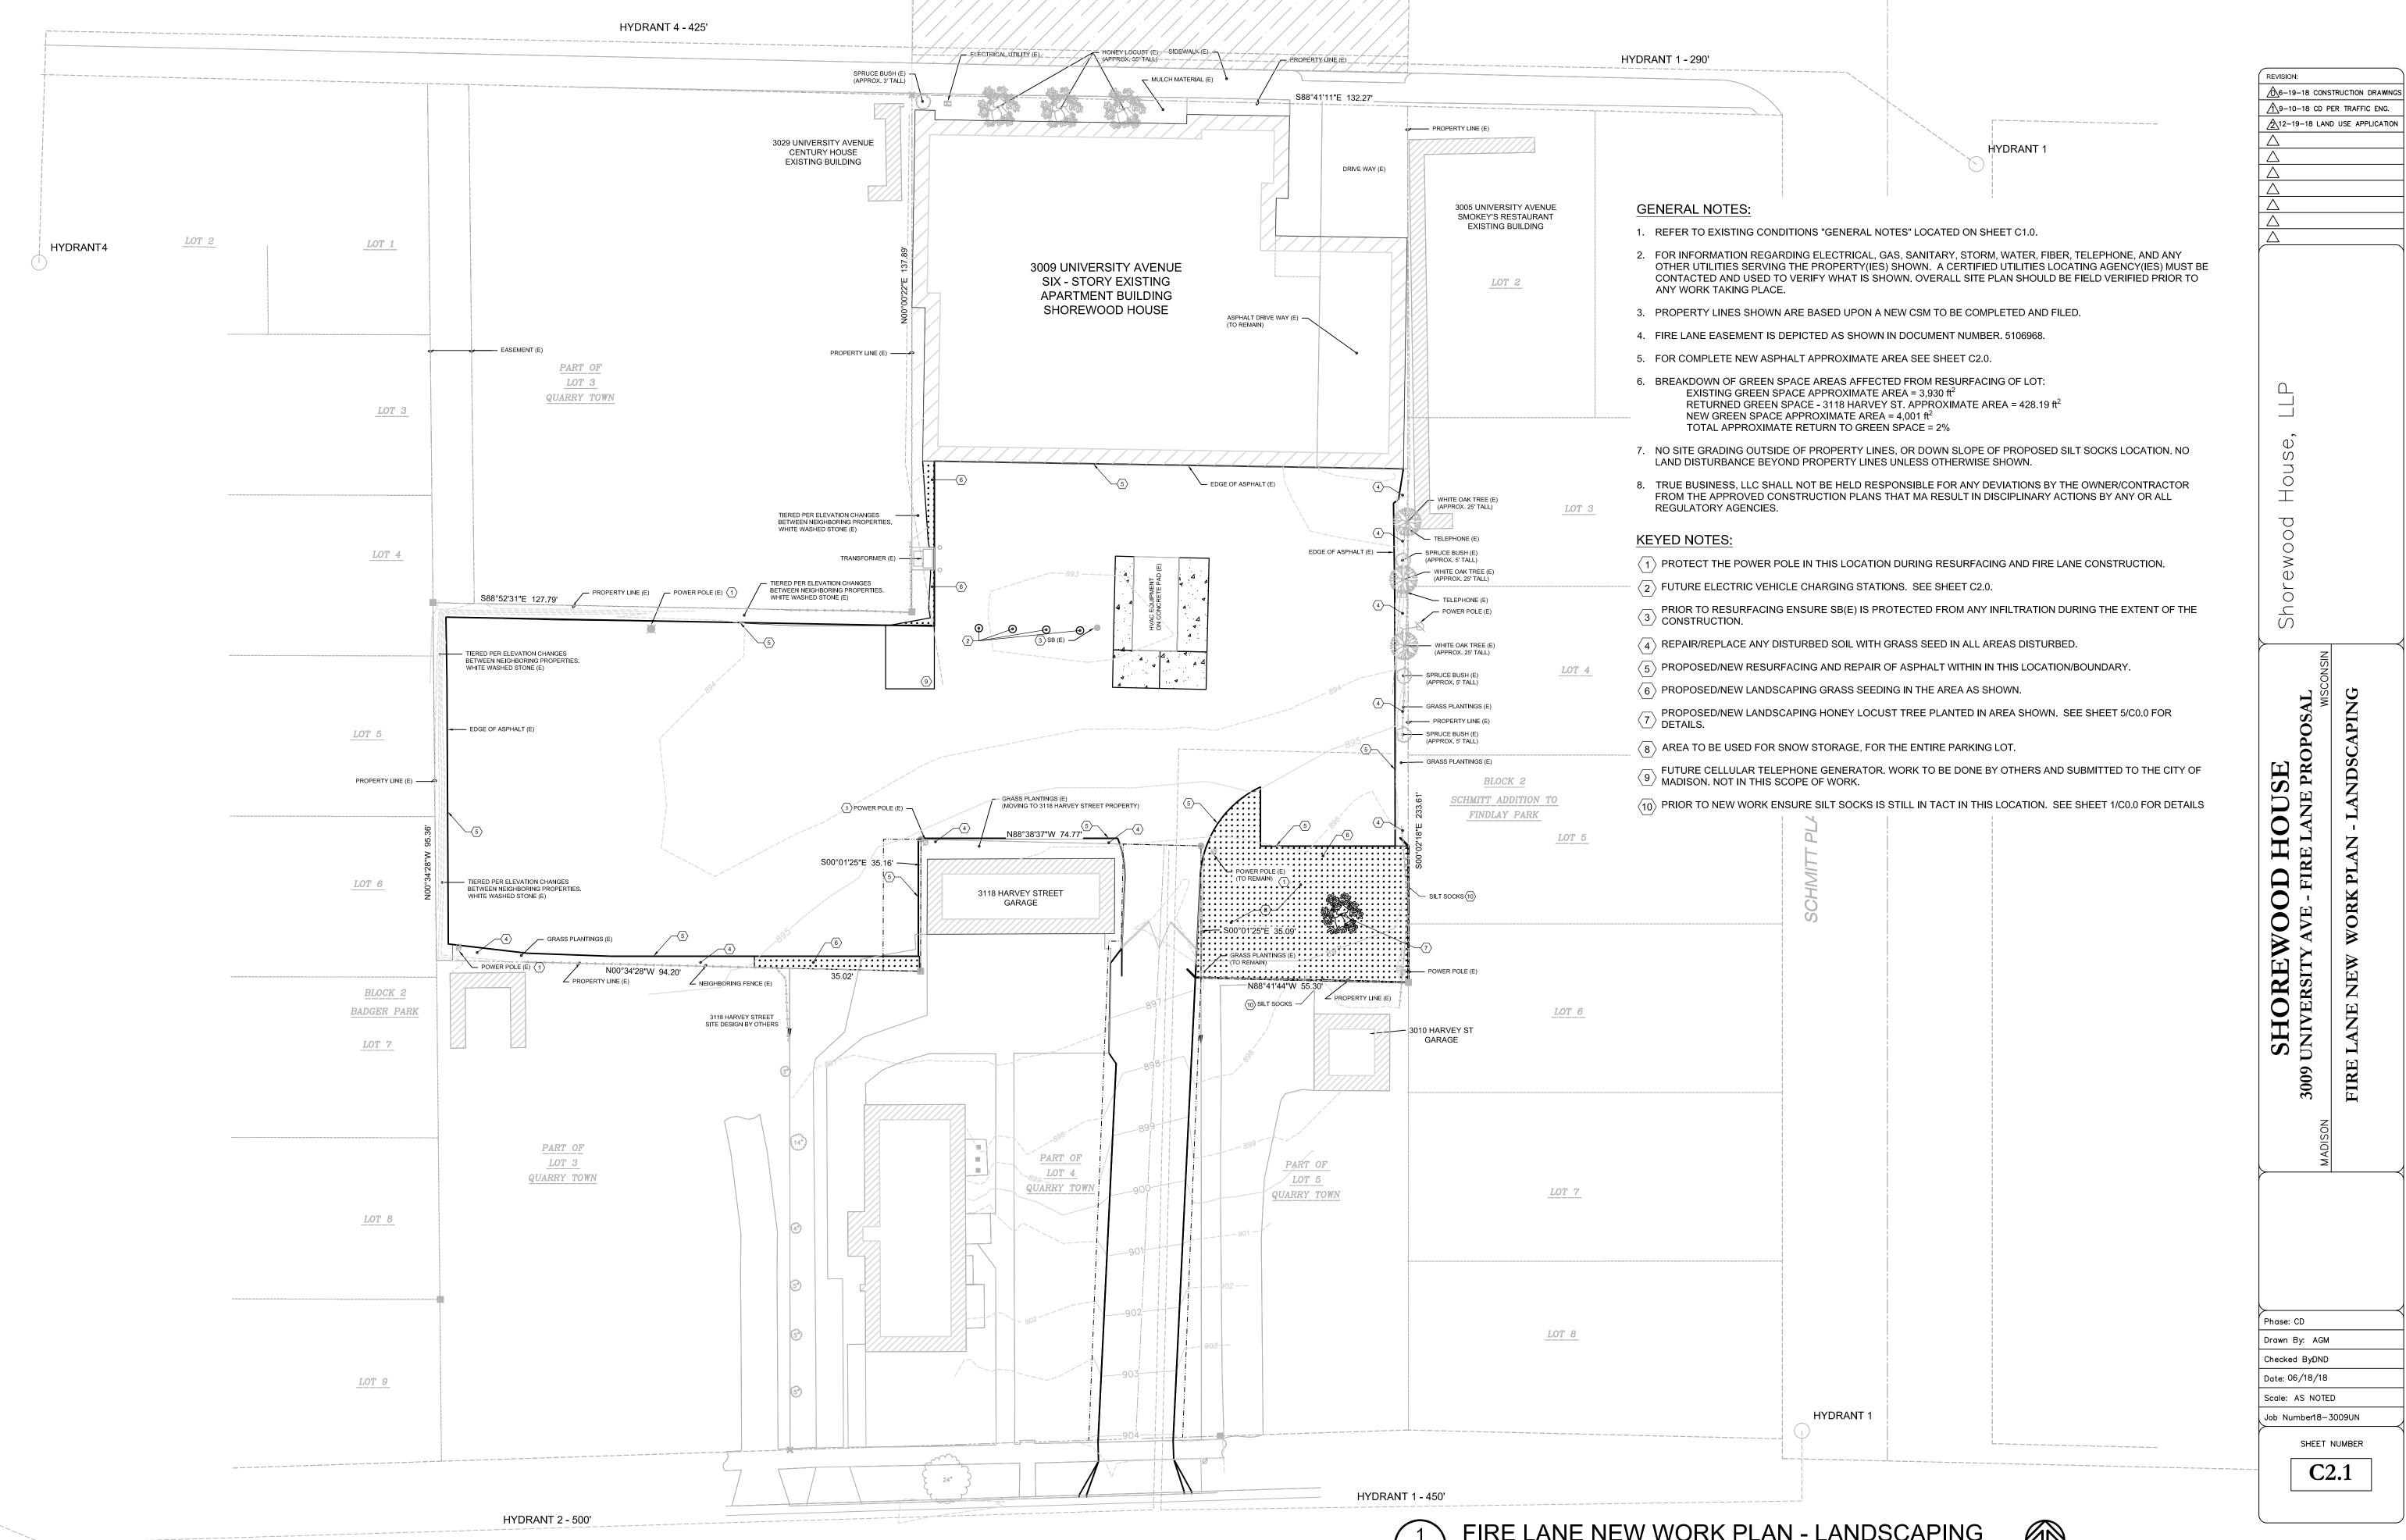
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FIRE

6-19-18 CONSTRUCTION DRAWINGS

19-10-18 CD PER TRAFFIC ENG. 12-19-18 LAND USE APPLICATION





HYDRANT 2

FIRE LANE NEW WORK PLAN - LANDSCAPING SCALE: 1"=20'



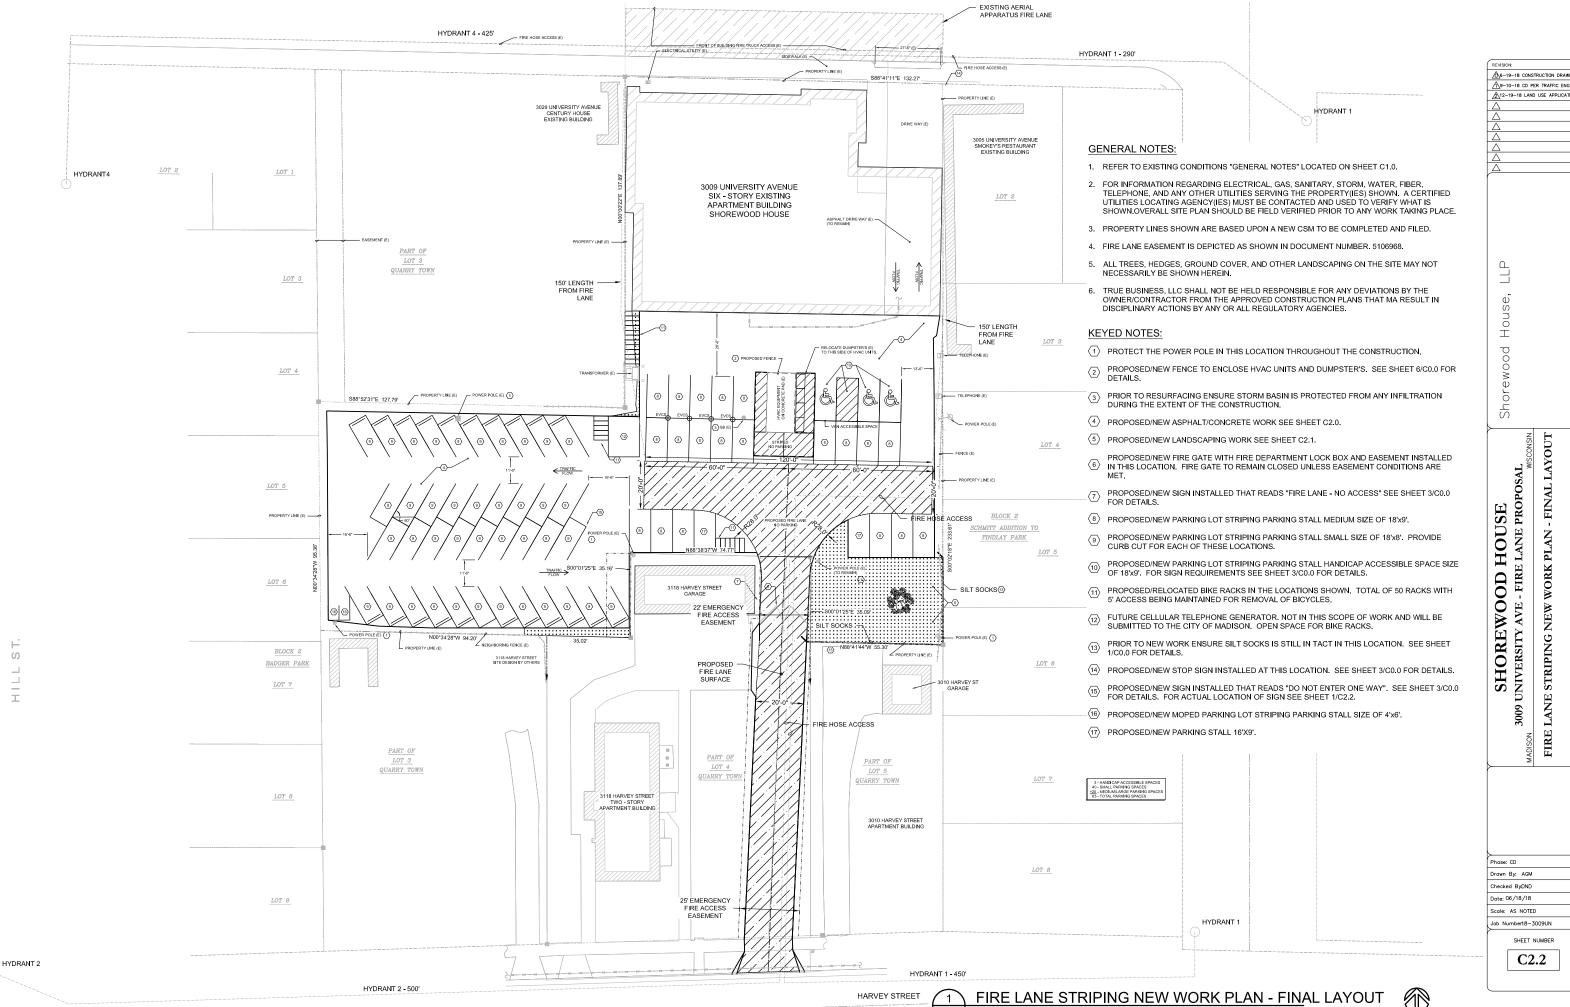
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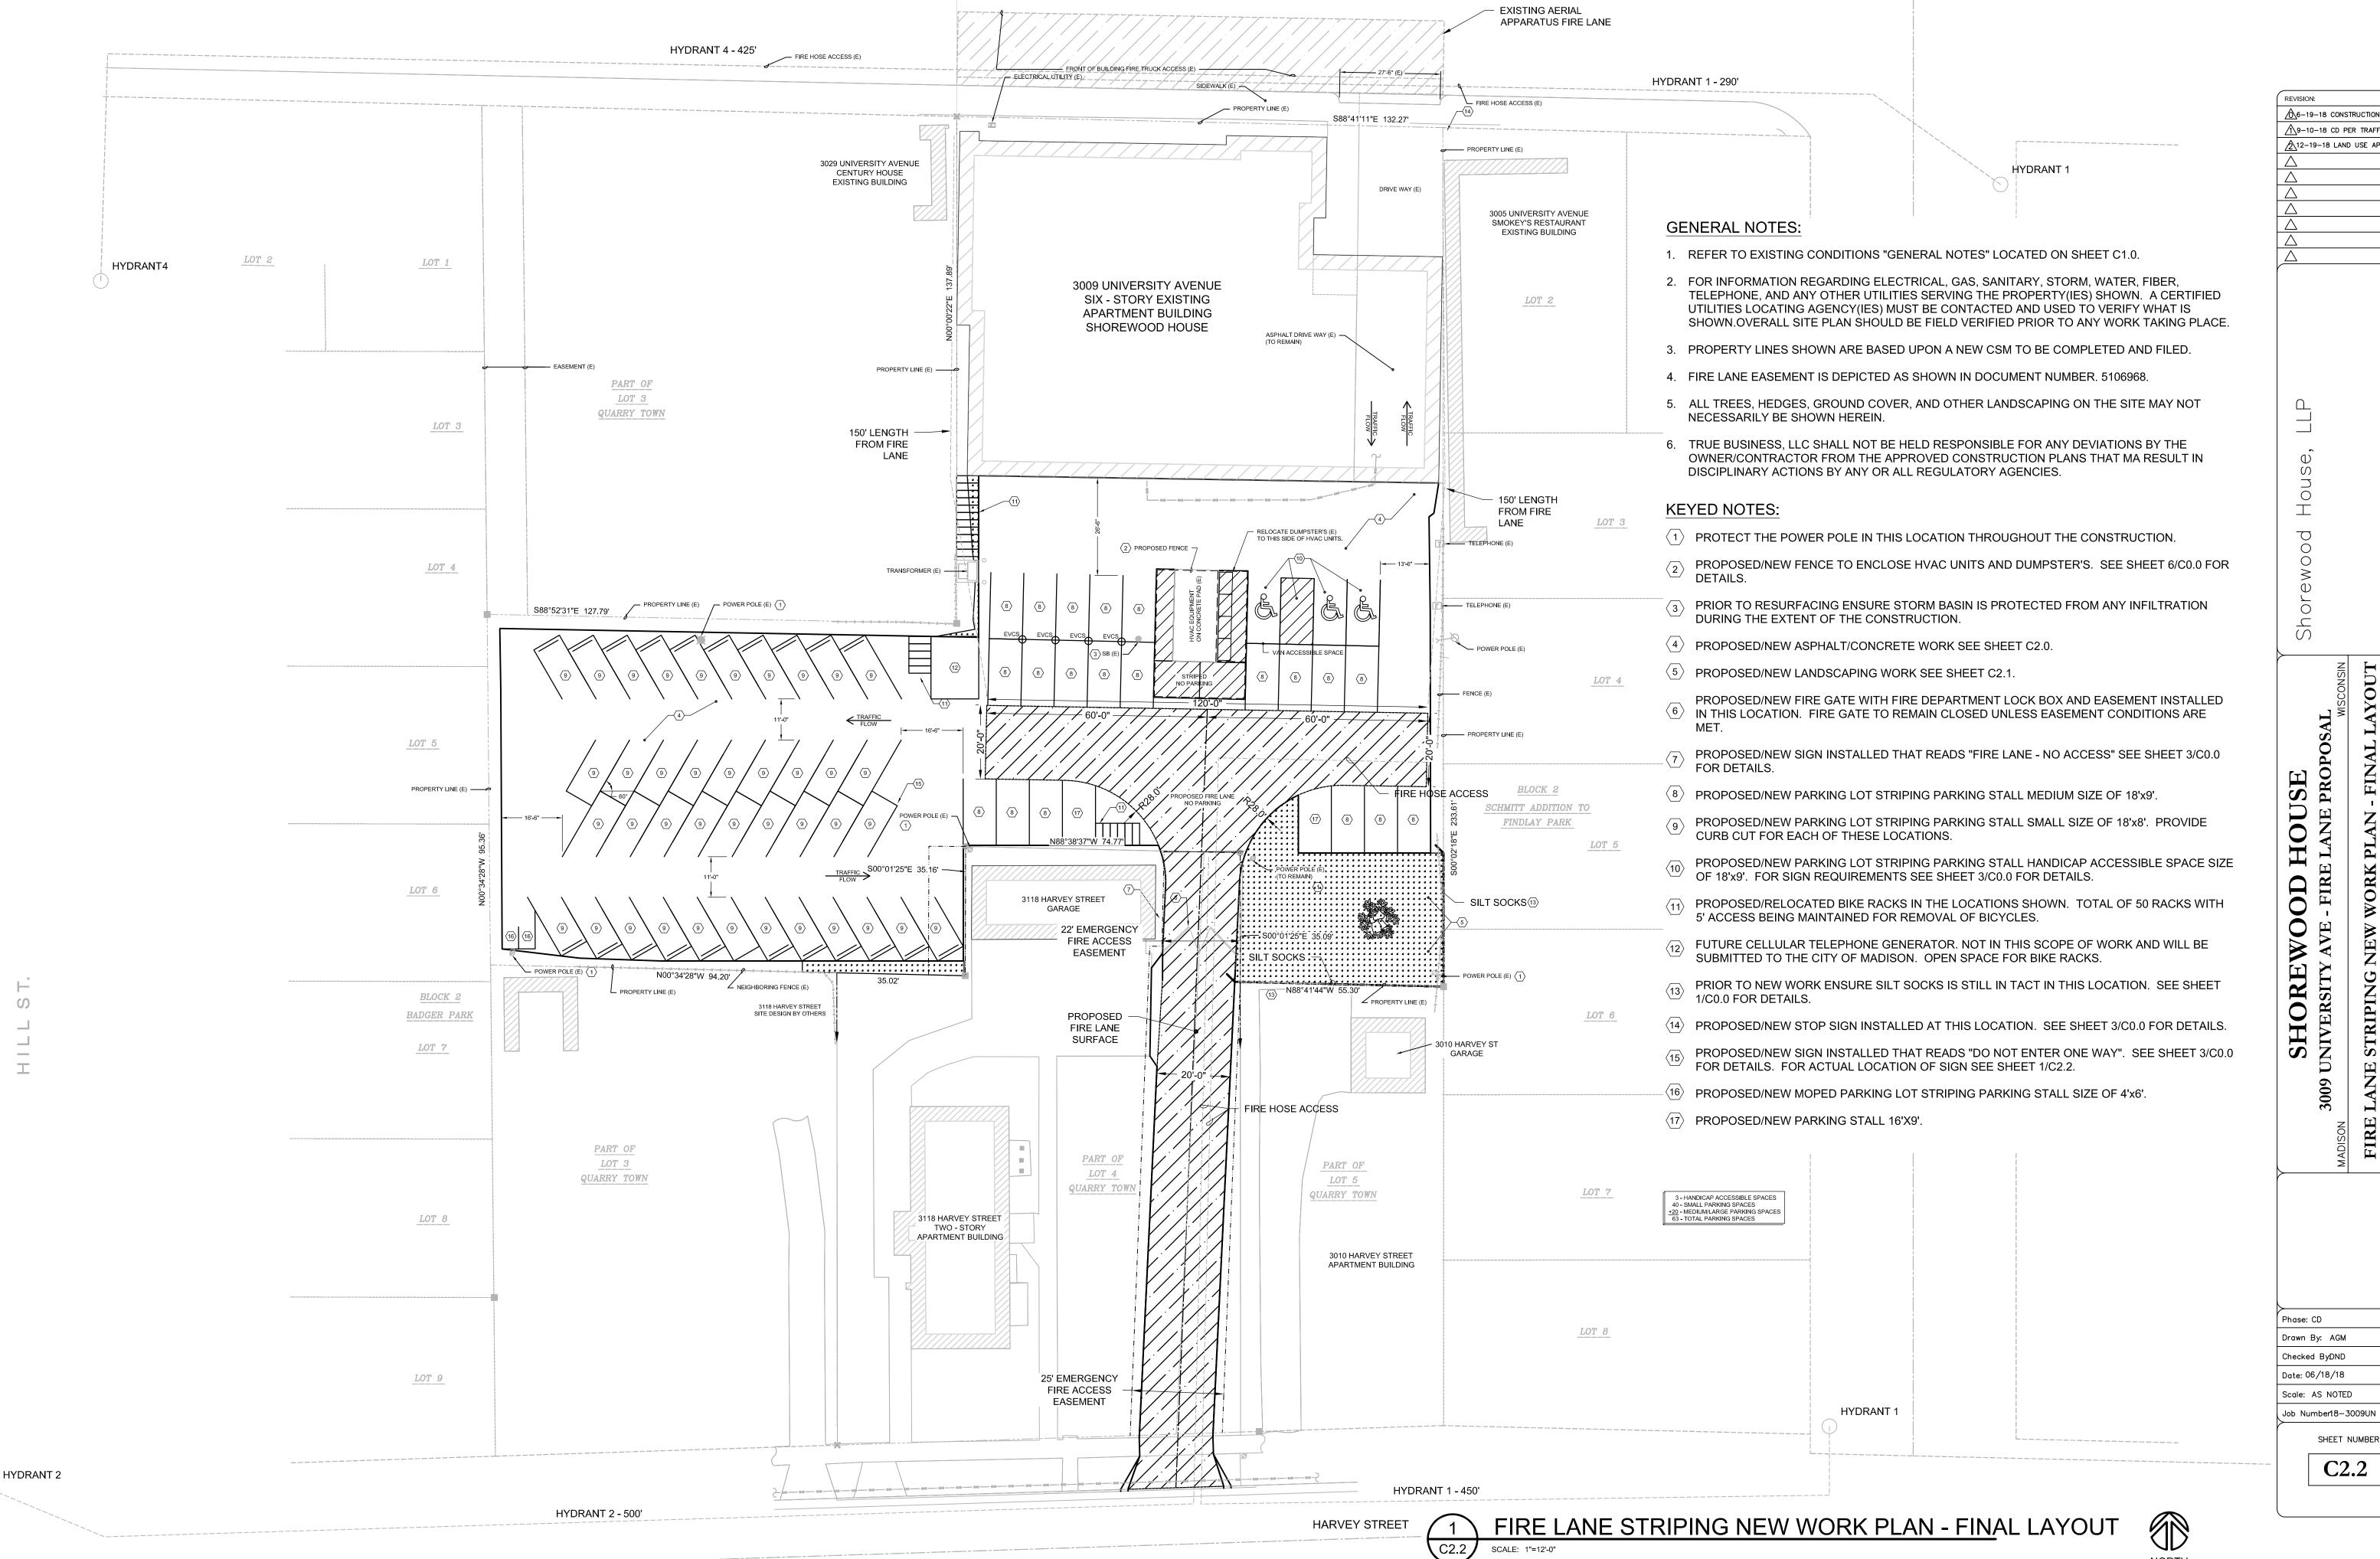
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Scale: AS NOTED

Job Number18-3009UN SHEET NUMBER

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UNIVERSITY AVENUE

6-19-18 CONSTRUCTION DRAWINGS

19-10-18 CD PER TRAFFIC ENG. 12-19-18 LAND USE APPLICATION

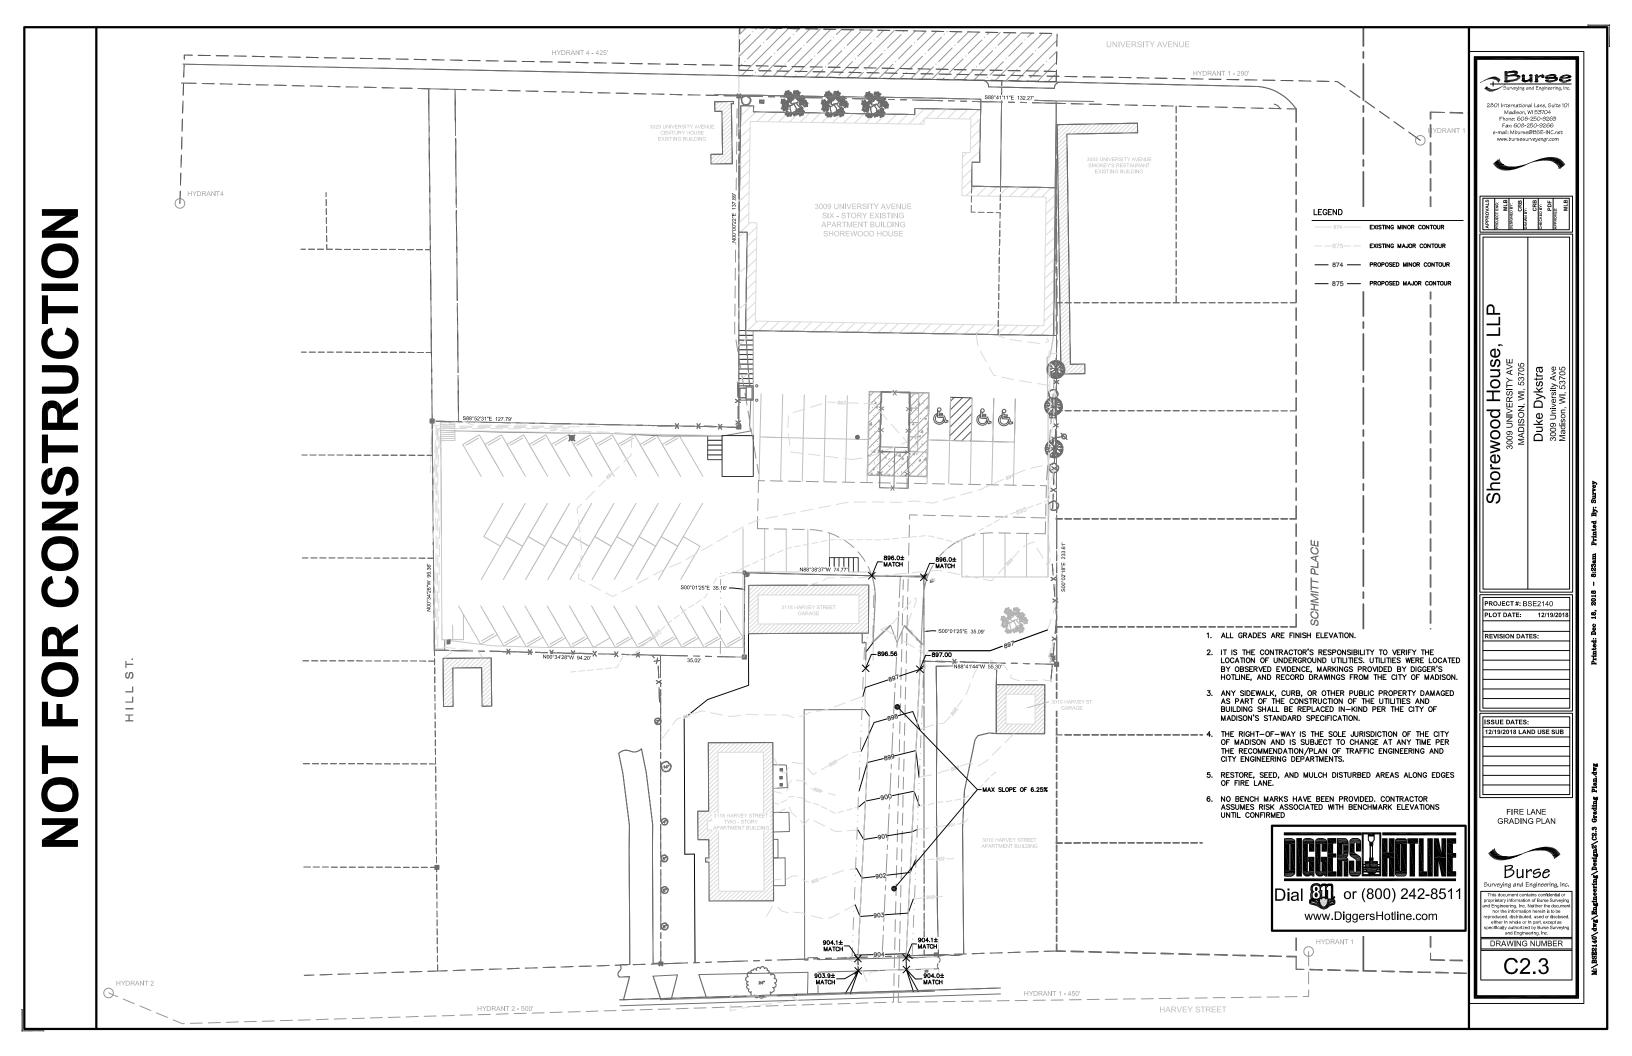
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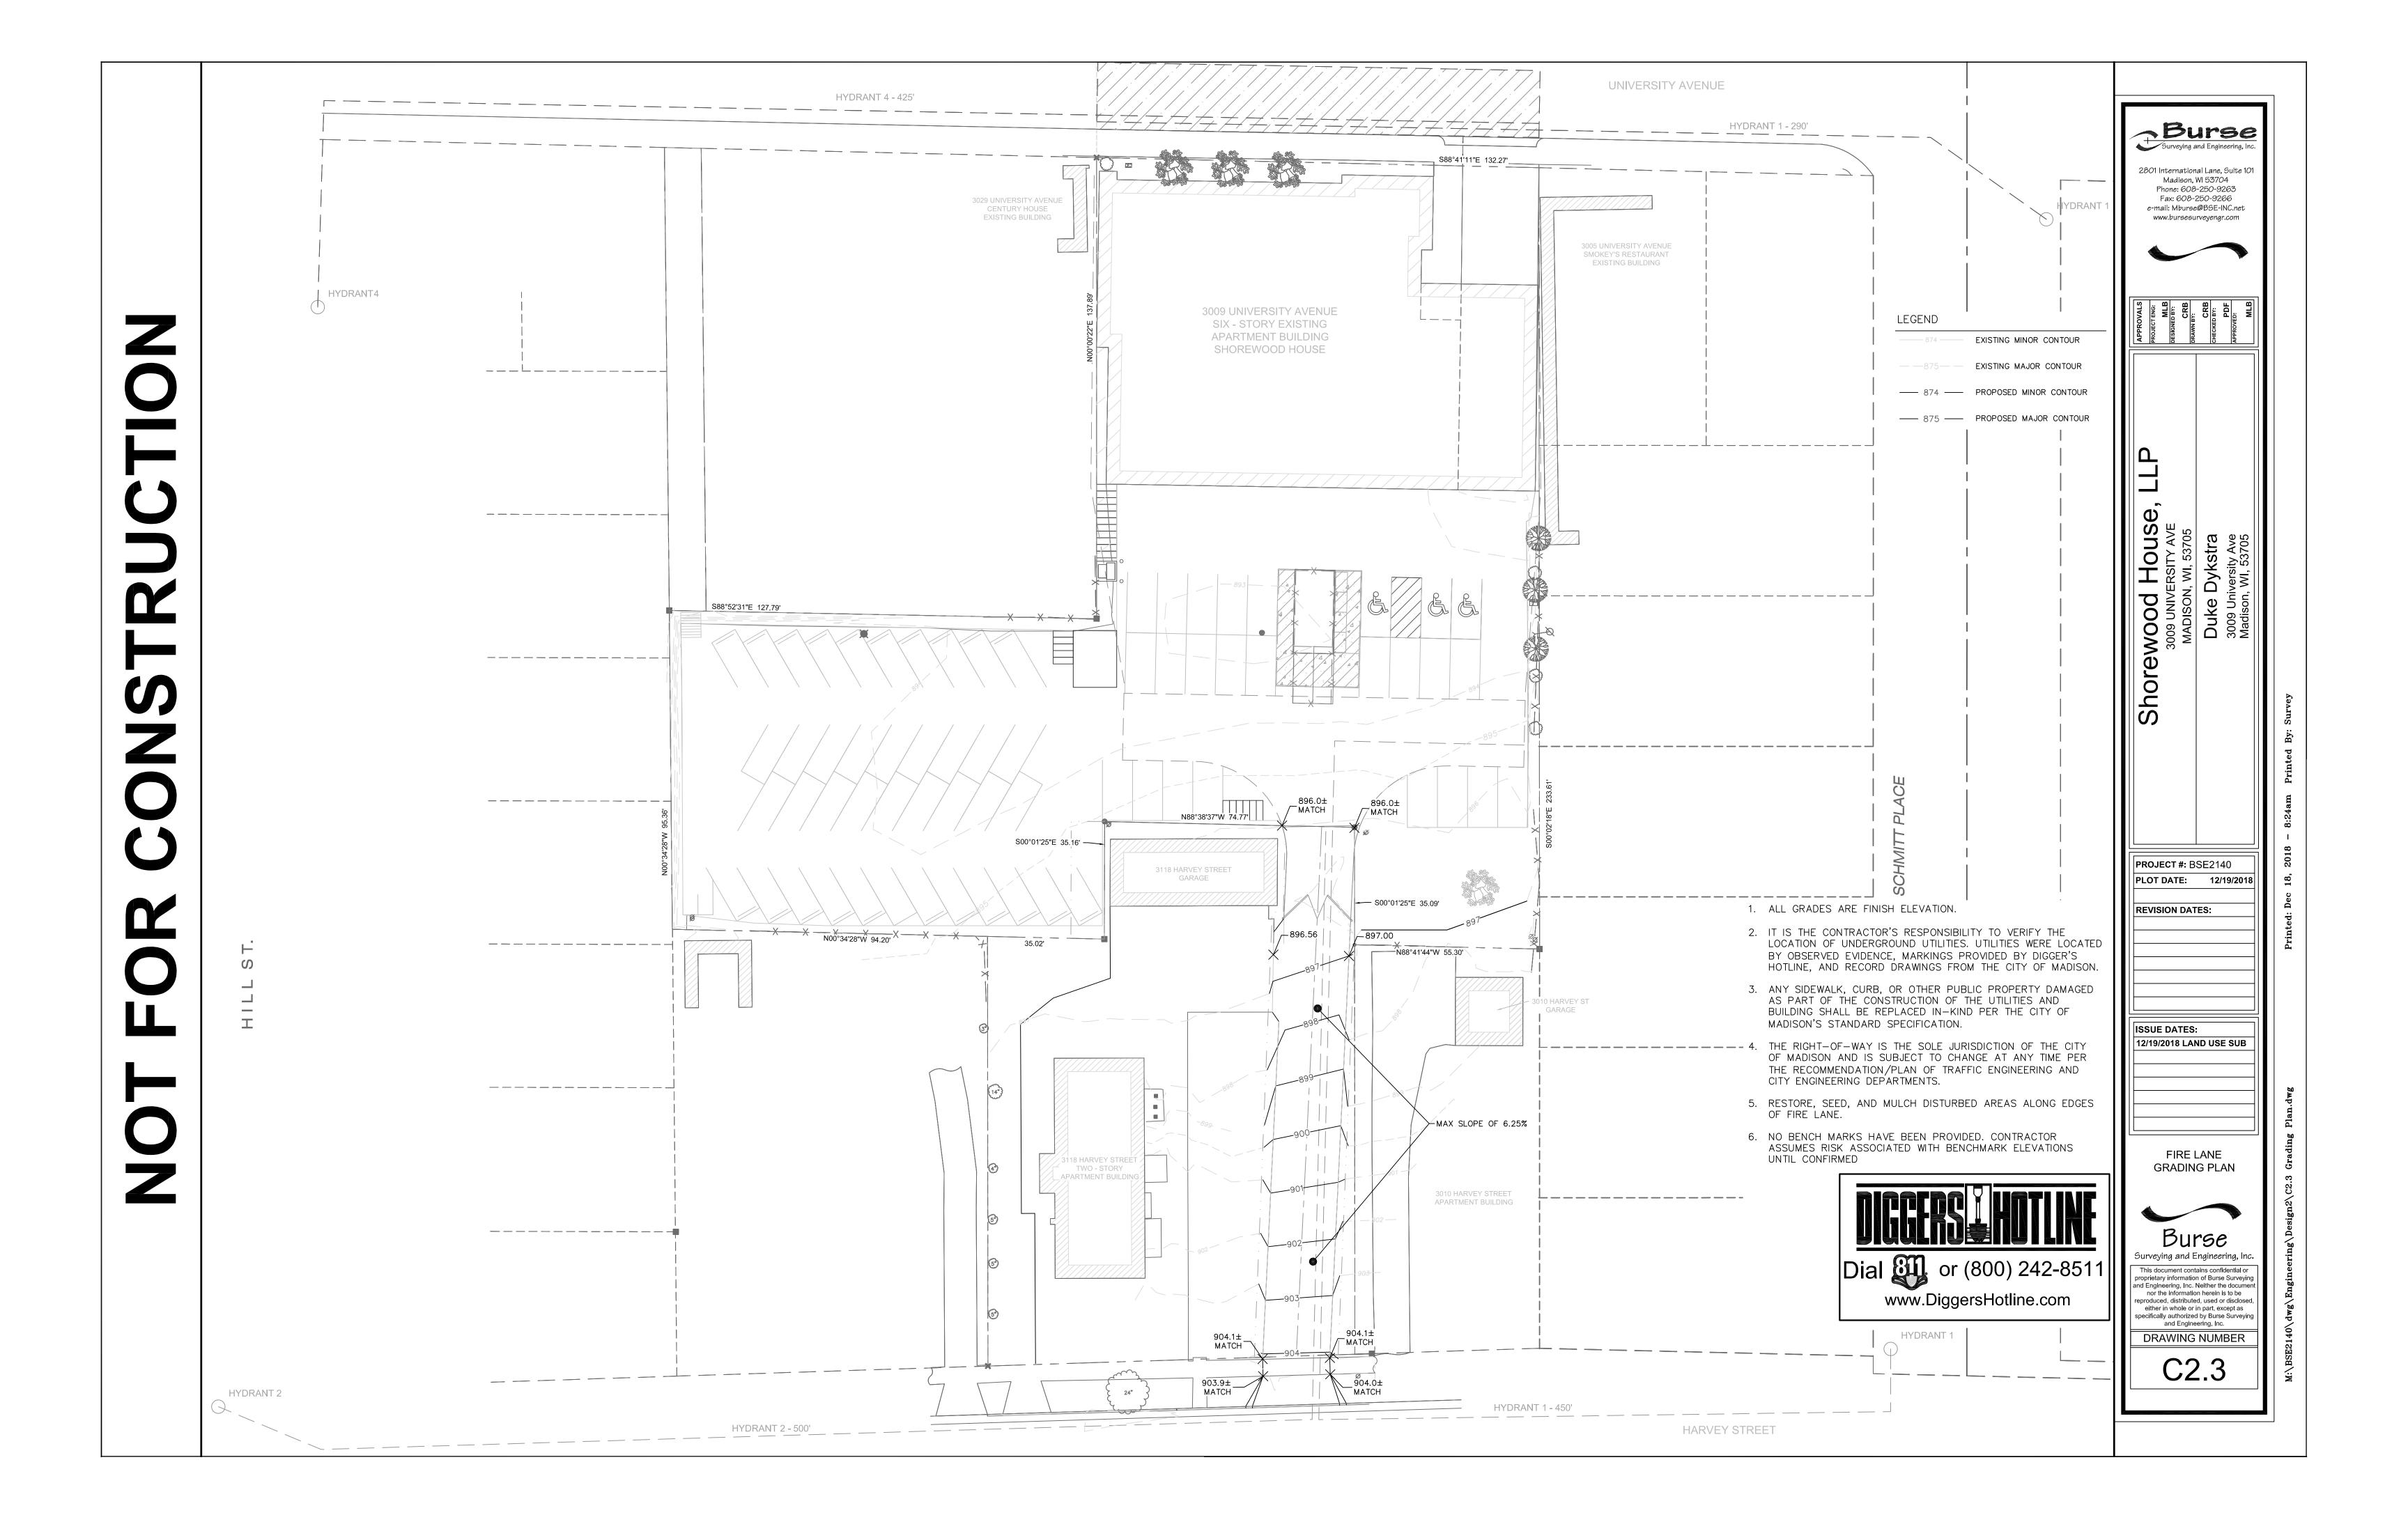
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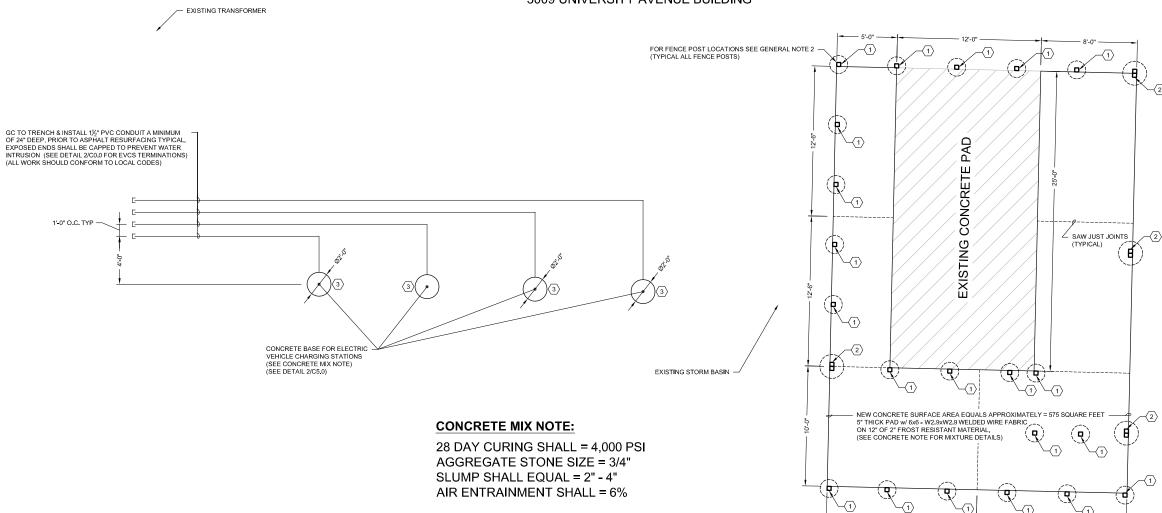
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C2.2





3009 UNIVERSITY AVENUE BUILDING





GENERAL NOTES:

- 1. THIS DOCUMENT IS SUPPLEMENTARY, FOR DIMENSIONS AND GENERAL SITE LAYOUT REFER TO THE CO.O C2.2 PLANS.
- 2. FENCE POSTS ARE 5'-0" ON CENTER UNLESS NOTED OTHERWISE. SEE SHEET C5.1 FOR LOCATIONS AND DIMENSIONS.
- 3. COORDINATE ALL WORK WITH THE OWNER PRIOR TO COMMENCEMENT,

KEYED NOTES:

- (1) 4x4 TREATED FENCE POST WITH 18"Ø SONO TUBE, FILLED WITH CONCRETE AROUND 4x4 POSTS, AND LOCATED 5" 6" BELOW FINISHED GRADE. SEE SHEET 6/C0.0 FOR DETAILS. (POSTS TO BE PERPENDICULAR TO FINISHED GRADE.)
- (3) SEE SUPPLEMENTARY DRAWING DETAIL 6/C5.1 FOR ELECTRIC VEHICLE CHARGING STATION STEEL WORK.

NOTE REGARDING EXISTING CONDITIONS:

INFORMATION PERTAINING TO EXISTING CONDITIONS GIVEN ON THESE CIVIL DRAWINGS INFORMATION PERTAINING TO EXISTING CONDITIONS GIVEN ON THESE CIVIL DRAWINGS REPRESENTS, TO THE BEST OF OUR KNOWLEDGE THE ACTUAL EXISTING FIELD CONDITIONS, TRUE BUSINESS LLC, MAKES NO WARRANTY AS TO THEIR ACCURACY, CONTRACTOR TO FIELD VERIFY EXISTING CONDITIONS IMPERATIVE TO THE NEW WORK, REPORT DISCREPANCIES BETWEEN THE DRAWINGS AND FIELD CONDITIONS TO THE ENGINEER OF RECORD FOR REVIEW. ANY WORK PERFORMED PRIOR TO RESOLUTION OF DISCREPANCIES BY THE ENGINEER OF RECORD IS SUBJECT TO REMOVAL AND REPLACEMENT AT NO ADDITIONAL COST TO THE CONTRACTOR.

	CD PE	TRUCTION DRAWINGS OR TRAFFIC ENG. USE APPLICATION
Shorewood House, LLP		
SHOREWOOD HOUSE 3009 UNIVERSITY AVE - CONSTRUCTION	MADISON	SUPPLEMENTARY NEW WORK PLAN - CONCRETE WORK

NEW SUPPLEMENTARY

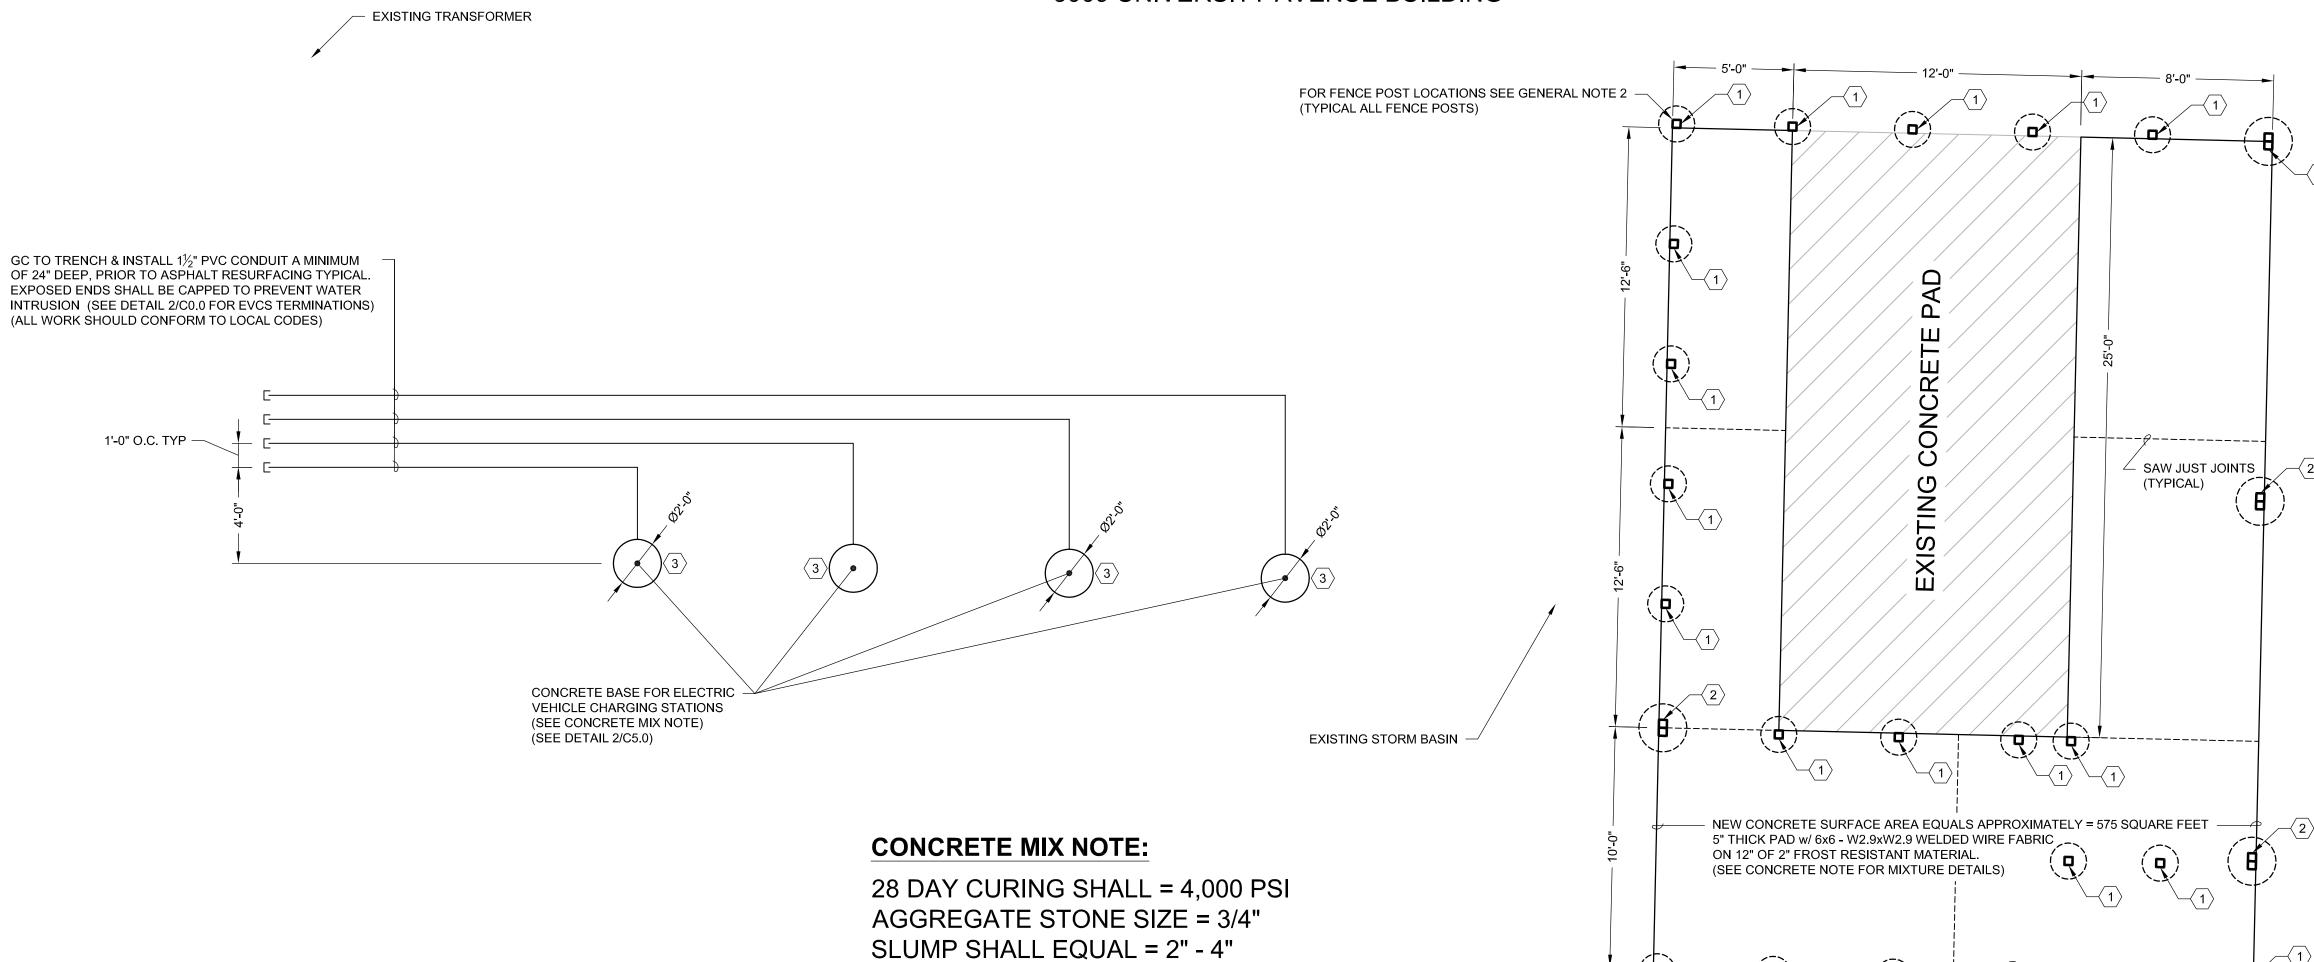
Phase: CD Drawn By: AGM

Checked ByDND

Date: 06/18/18 Scale: AS NOTED

SHEET NUMBER

3009 UNIVERSITY AVENUE BUILDING



AIR ENTRAINMENT SHALL = 6%



GENERAL NOTES:

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- 2. FENCE POSTS ARE 5'-0" ON CENTER UNLESS NOTED OTHERWISE. SEE SHEET C5.1 FOR LOCATIONS AND DIMENSIONS.
- 3. COORDINATE ALL WORK WITH THE OWNER PRIOR TO COMMENCEMENT.

KEYED NOTES:

- (1) 4x4 TREATED FENCE POST WITH 18"Ø SONO TUBE, FILLED WITH CONCRETE AROUND 4x4 POSTS, AND LOCATED 5" 6" BELOW FINISHED GRADE. SEE SHEET 6/C0.0 FOR DETAILS. (POSTS TO BE PERPENDICULAR TO FINISHED GRADE.)
- (2) 4x4 TREATED FENCE POST WITH 24"Ø SONO TUBE, FILLED WITH CONCRETE AROUND BOTH 4x4 POSTS, AND LOCATED 5" 6" BELOW FINISHED GRADE. SEE SHEET 6/C0.0 FOR DETAILS. (POSTS TO BE PERPENDICULAR TO FINISHED GRADE.)
- $\overline{\langle 3 \rangle}$ SEE SUPPLEMENTARY DRAWING DETAIL 6/C5.1 FOR ELECTRIC VEHICLE CHARGING STATION STEEL WORK.

NOTE REGARDING EXISTING CONDITIONS:

INFORMATION PERTAINING TO EXISTING CONDITIONS GIVEN ON THESE CIVIL DRAWINGS REPRESENTS, TO THE BEST OF OUR KNOWLEDGE THE ACTUAL EXISTING FIELD CONDITIONS. TRUE BUSINESS LLC, MAKES NO WARRANTY AS TO THEIR ACCURACY. CONTRACTOR TO FIELD VERIFY EXISTING CONDITIONS IMPERATIVE TO THE NEW WORK. REPORT DISCREPANCIES BETWEEN THE DRAWINGS AND FIELD CONDITIONS TO THE ENGINEER OF RECORD FOR REVIEW. ANY WORK PERFORMED PRIOR TO RESOLUTION OF DISCREPANCIES BY THE ENGINEER OF RECORD IS SUBJECT TO REMOVAL AND REPLACEMENT AT NO ADDITIONAL COST TO THE CONTRACTOR.

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3009 UNIVERSITY AVE - CONSTRUCTION

Phase: CD


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Checked ByDND
Date: 06/18/18

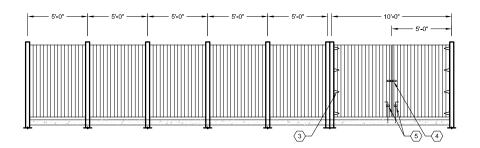Scale: AS NOTED

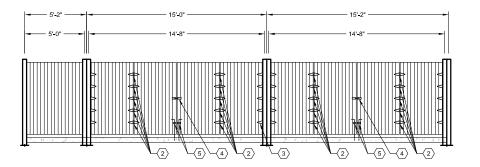
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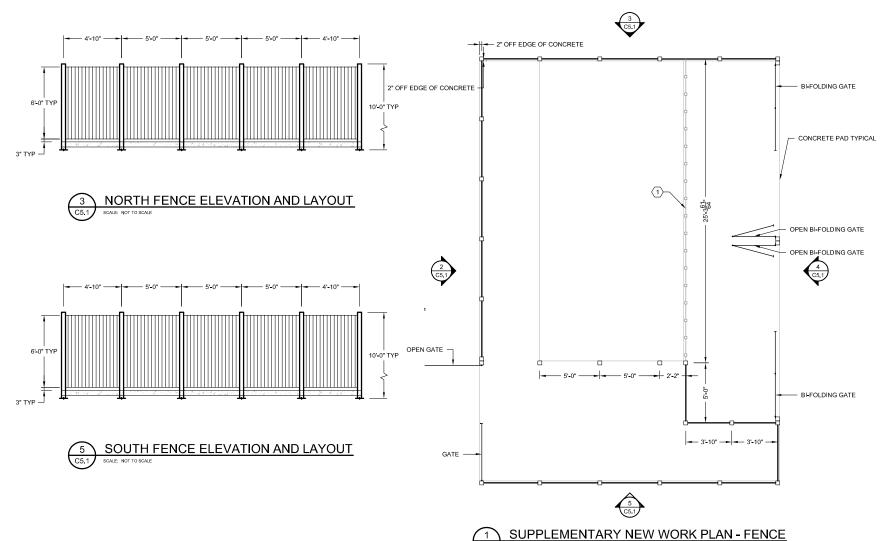












C5.1 SCALE: NOT TO SCALE

GENERAL NOTES:

- THIS DOCUMENT IS SUPPLEMENTARY, FOR GENERAL SITE LAYOUT REFER TO THE CO.0 C2.2 PLANS. SEE ELEVATION VIEWS FOR SPECIFIC DETAILS IN REGARDS TO KEYED NOTES BELOW.
- 2. FENCE POSTS ARE 4"x4"x10"-0" @ 5"-0" ON CENTER UNLESS NOTED OTHERWISE. COORDINATE WITH CONCRETE CONTRACTOR TO ENSURE FENCE POSTS ARE IN PLACE AT TIME OF CONCRETE WORK.
- 3. COORDINATE ALL WORK WITH THE OWNER PRIOR TO COMMENCEMENT. OWNER TO SELECT COMPOSITE FENCE POST COLOR AS WELL AS ALL HARDWARE COLOR.

KEYED NOTES:

- 1) EXISTING WOOD FENCING/PRIVACY SCREENING, SHALL BE SALVAGED AND USED TO FENCE OFF EXISTING AREA, IN COMBINATION WITH NEW AREA FENCING. SIMILAR TO WHAT IS SHOWN.
- $\fbox{2}$ GATE TO USE 3-1/2" HEAVY-DUTY TEE STYLE FENCE HINGE AS SHOWN AND ALLOW GATE DOOR TO OPEN IN A BI-FOLD MANNER BI-FOLD AS SHOWN.
- \bigcirc USE 3-1/2" HEAVY-DUTY TEE STYLE FENCE HINGE. TYPICAL ALL FENCE GATE/DOOR LOCATIONS.
- (4) USE HEAVY-DUTY GATE LATCH WITH THE ABILITY TO RECEIVE A LOCK. TYPICAL ALL GATE LOCATIONS.
- (5) USE 24" LONG HEAVY-DUTY FENCE DROP ROD. DRILL 3" DEEP HOLE IN CONCRETE TO ALLOW DROP ROD TO CATCH WHEN FENCE GATE IS CLOSED.

NOTE REGARDING EXISTING CONDITIONS:

INFORMATION PERTAINING TO EXISTING CONDITIONS GIVEN ON THESE CIVIL DRAWINGS REPRESENTS, TO THE BEST OF OUR KNOWLEDGE THE ACTUAL EXISTING FIELD CONDITIONS. TRUE BUSINESS LLC, MAKES NO WARRANTY AS TO THEIR ACCUPACY. CONTRACTOR TO FIELD VERIFY EXISTING CONDITIONS IMPERATIVE TO THE NEW WORK. REPORT DISCREPANCIES BETWEEN THE DRAWINGS AND FIELD CONDITIONS TO THE BUSINESS OF REVORD FOR REVIEW. ANY WORK PERFORMED PRIOR TO RESOLUTION OF DISCREPANCIES BY THE ENGINEER OF RECORD IS SUBJECT TO REMOVAL AND REPLACEMENT AT NO ADDITIONAL COST TO THE CONTRACTOR.

Phase: CD

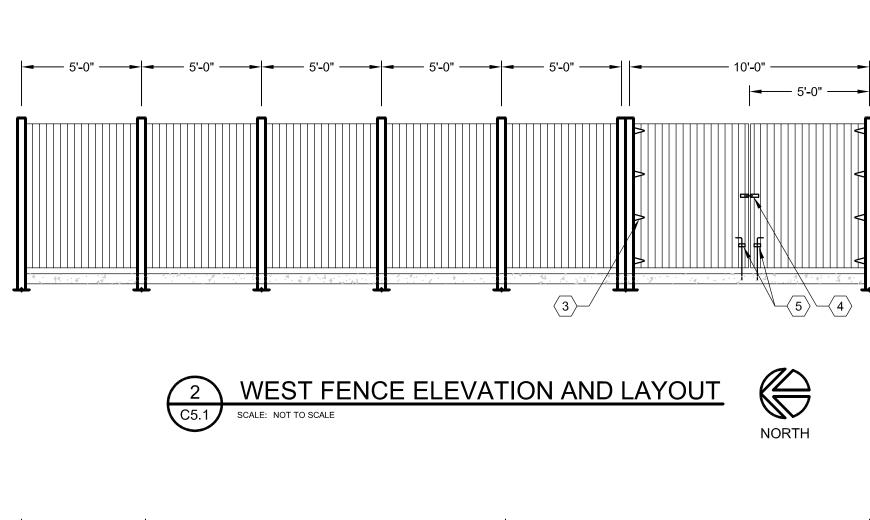
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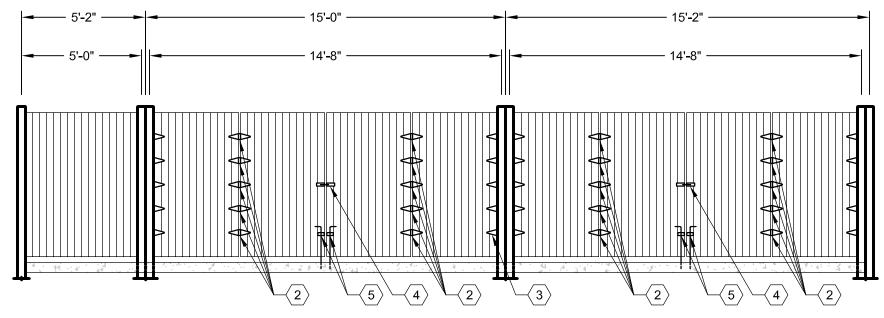
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Scale: AS NOTED

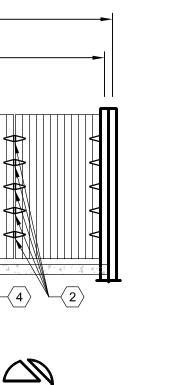
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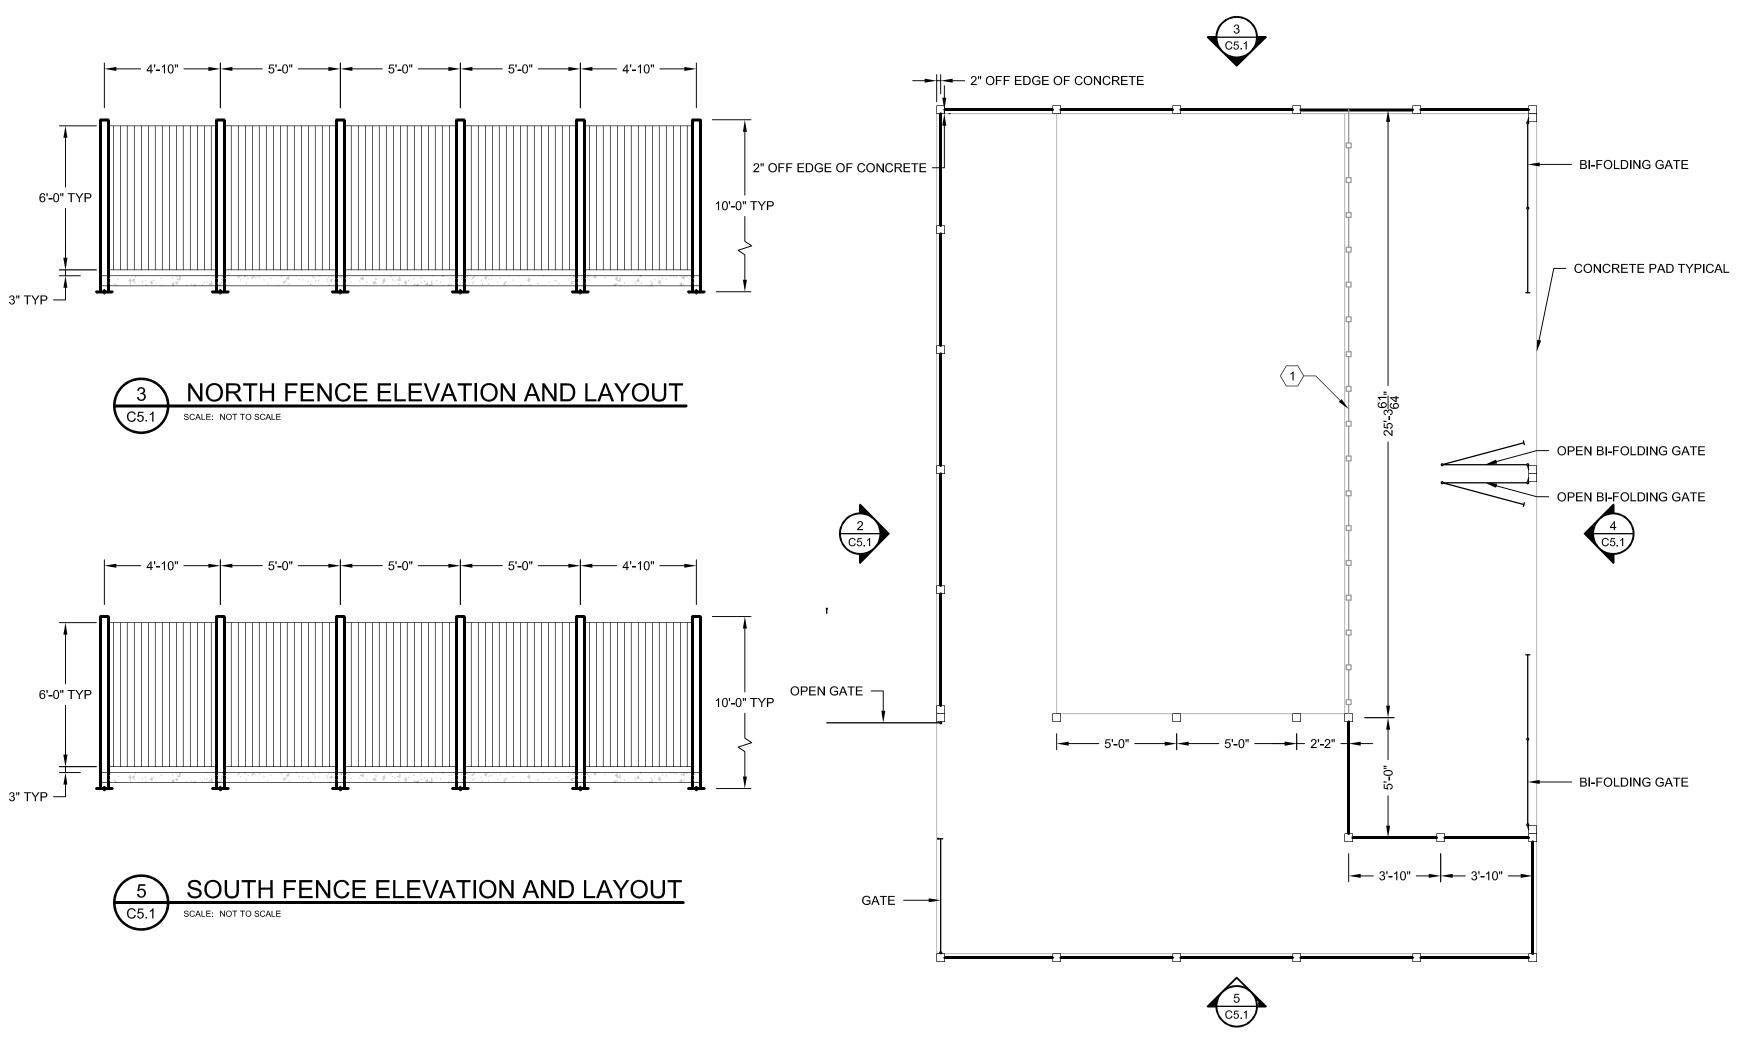
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SUPPLEMENTARY NEW WORK PLAN - FENCE

GENERAL NOTES:

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- 3. COORDINATE ALL WORK WITH THE OWNER PRIOR TO COMMENCEMENT. OWNER TO SELECT COMPOSITE FENCE POST COLOR AS WELL AS ALL HARDWARE COLOR.

KEYED NOTES:


- $raket{1}$ EXISTING WOOD FENCING/PRIVACY SCREENING, SHALL BE SALVAGED AND USED TO FENCE OFF EXISTING AREA, IN COMBINATION WITH NEW AREA FENCING. SIMILAR TO WHAT IS SHOWN.
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- $\sqrt{3}$ USE 3-1/2" HEAVY-DUTY TEE STYLE FENCE HINGE. TYPICAL ALL FENCE GATE/DOOR LOCATIONS.
- $\overline{\langle 4 \rangle}$ USE HEAVY-DUTY GATE LATCH WITH THE ABILITY TO RECEIVE A LOCK. TYPICAL ALL GATE LOCATIONS.
- USE 24" LONG HEAVY-DUTY FENCE DROP ROD. DRILL 3" DEEP HOLE IN CONCRETE TO ALLOW DROP ROD TO CATCH WHEN FENCE GATE IS CLOSED.

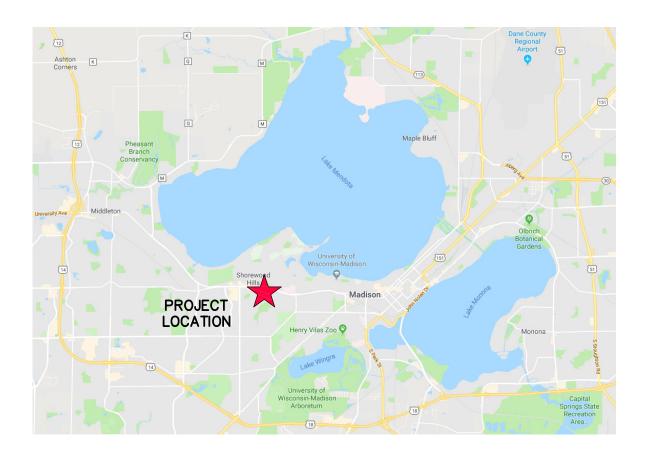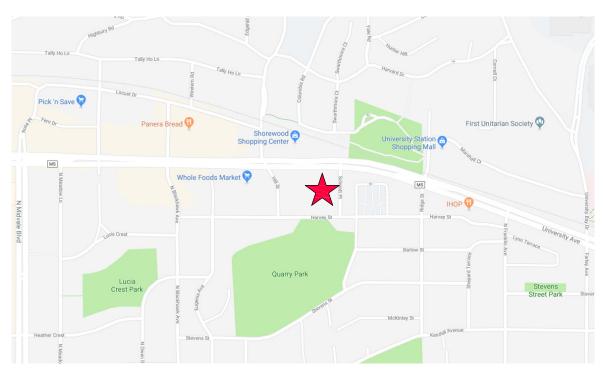
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Shorewood House, LLP			
SHOREWOOD HOUSE	3009 UNIVERSITY AVE - CONSTRUCTION WISCONSIN	SUPPLEMENTARY NEW WORK PLAN - FENCE WORK	
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VICINITY MAP