

48.517 SF / 1.1 ACRES

35,565 S.F. = 73.3% 11.968 S.F.

9,322 SF 4 STORIES

60 DU 60 BU 608 SF / UNIT 54 UNITS/ACRE APPROX. 5.617 SF (44% OF FIRST FLR)

Phone: 7601 University Ave, Ste 201 608.836.3690 Middleton, WI 53562

ISSUED

Issued for Land Use & UDC - September 5, 2018 Issued for Land Use Supplement - Nov. 2, 2018

PROJECT TITLE Mixed-Use Development

5535 University Ave. Madison, WI


SHEET TITLE

Site Plan


SHEET NUMBER

PROJECT NO.

1735

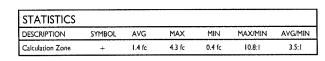

LUMINAIRE SCHEDULE											
SYMBOL LABEL	QTY	MANUF.	CATALOG	DESCRIPTION	FILE	MOUNTING					
A	ı	LITHONIA LIGHTING	DSX0 LED P4 30K T3M MVOLT	DSX0 LED P4 30K T3M MVOLT	DSX0_LED_P4_30K_ T3M_MVOLT.ies	18'-0" POLE ON FLUSH CONC. BASE					
B	2	LITHONIA LIGHTING	DSX0 LED P2 40K T2M MVOLT HS	DSX0 LED P2 40K T2M MVOLT WITH HOUSE-SIDE SHIELD	DSX0_LED_P2_40K_ T2M_MVOLT_HS.ies	16'-0" POLE ON 2'-0" TALL CONC. BASE					
ISOLUX CONTOUR = 0.25 FC ISOLUX CONTOUR = 0.5 FC ISOLUX CONTOUR = 1.0 FC LIGHT FIXTURE											

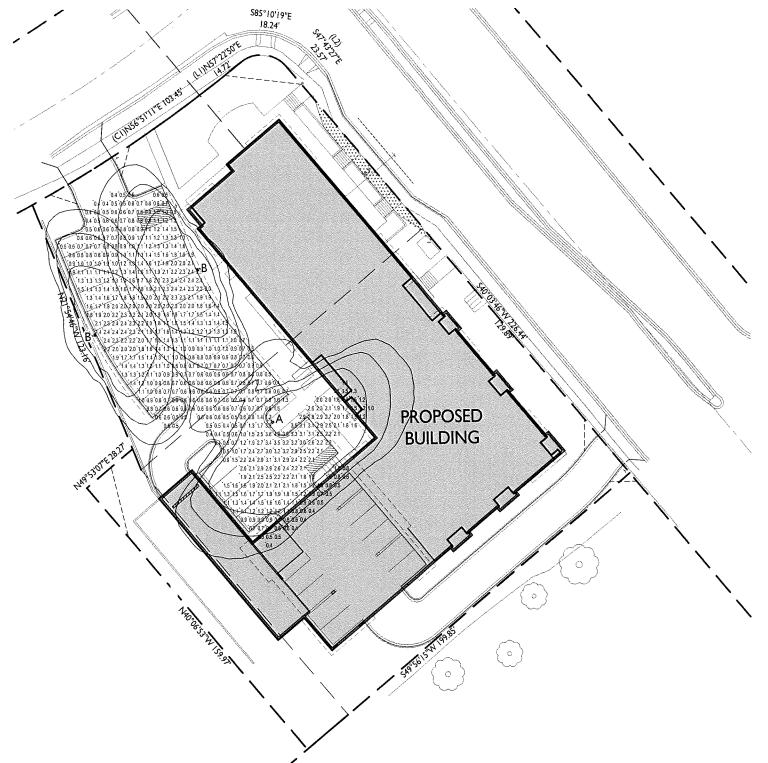

SITE LIGHTING PLAN



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PROJECT TITLE
Mixed-Use
Development


5535 University Ave. Madison, WI

SHEET TITLE
Site Lighting Plan

SHEET NUMBER

C-1.2

PROJECT NO. 1735

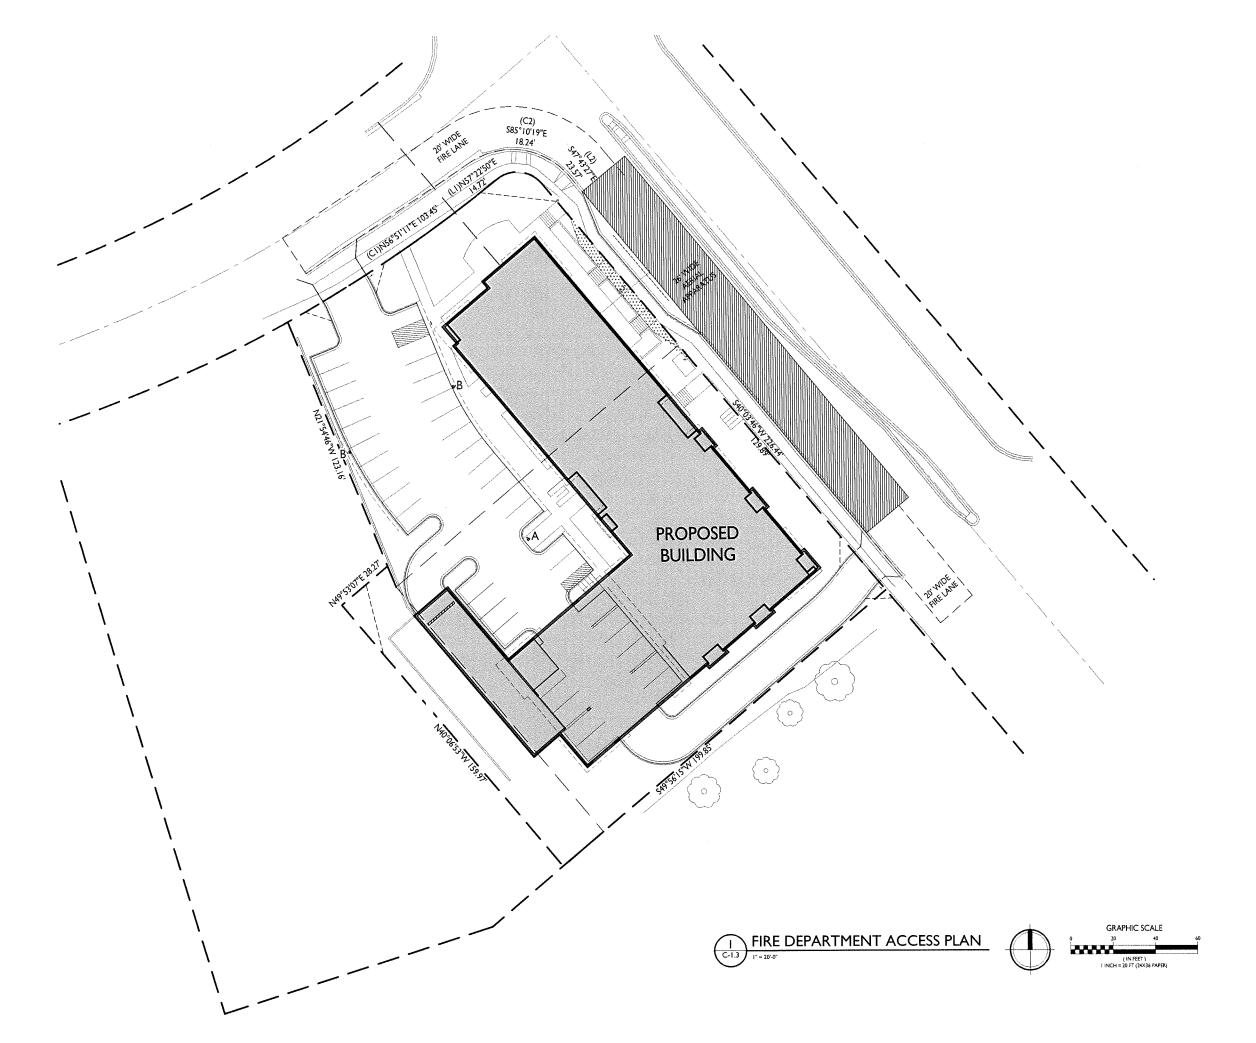



ISSUED
Issued for Land Use & UDC - September 5, 2018
Issued for Land Use Supplement - Nov. 2, 2018


PROJECT TITLE
Mixed-Use Development

5535 University Ave.
Madison, WI
SHEET ΤΙΤΙΣΕ
Fire Department Access Plan

SHEET NUMBER

C-1.3

1735 PROJECT NO. © Knothe & Bruce Architects, LLC

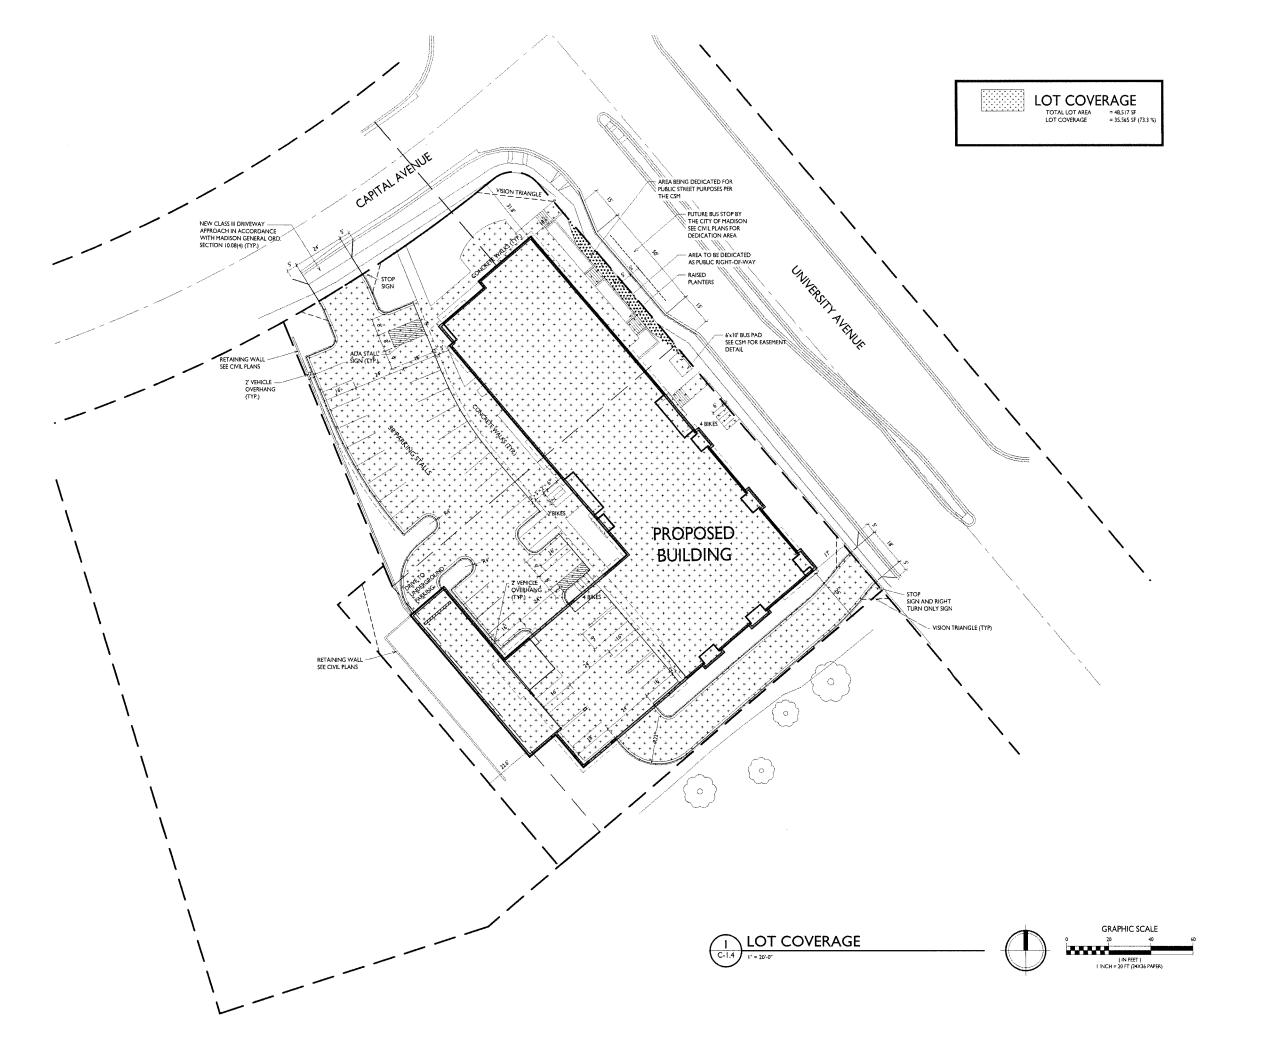



ISSUED

Issued for Land Use & UDC - September 5, 2018 Issued for Land Use Supplement - Nov. 2, 2018

PROJECT TITLE
Mixed-Use
Development

5535 University Ave. Madison, WI

SHEET TITLE


Lot Coverage

SHEET NUMBER

C-1.4

PROJECT NO. 1735

• Knothe & Bruce Architects, LLC

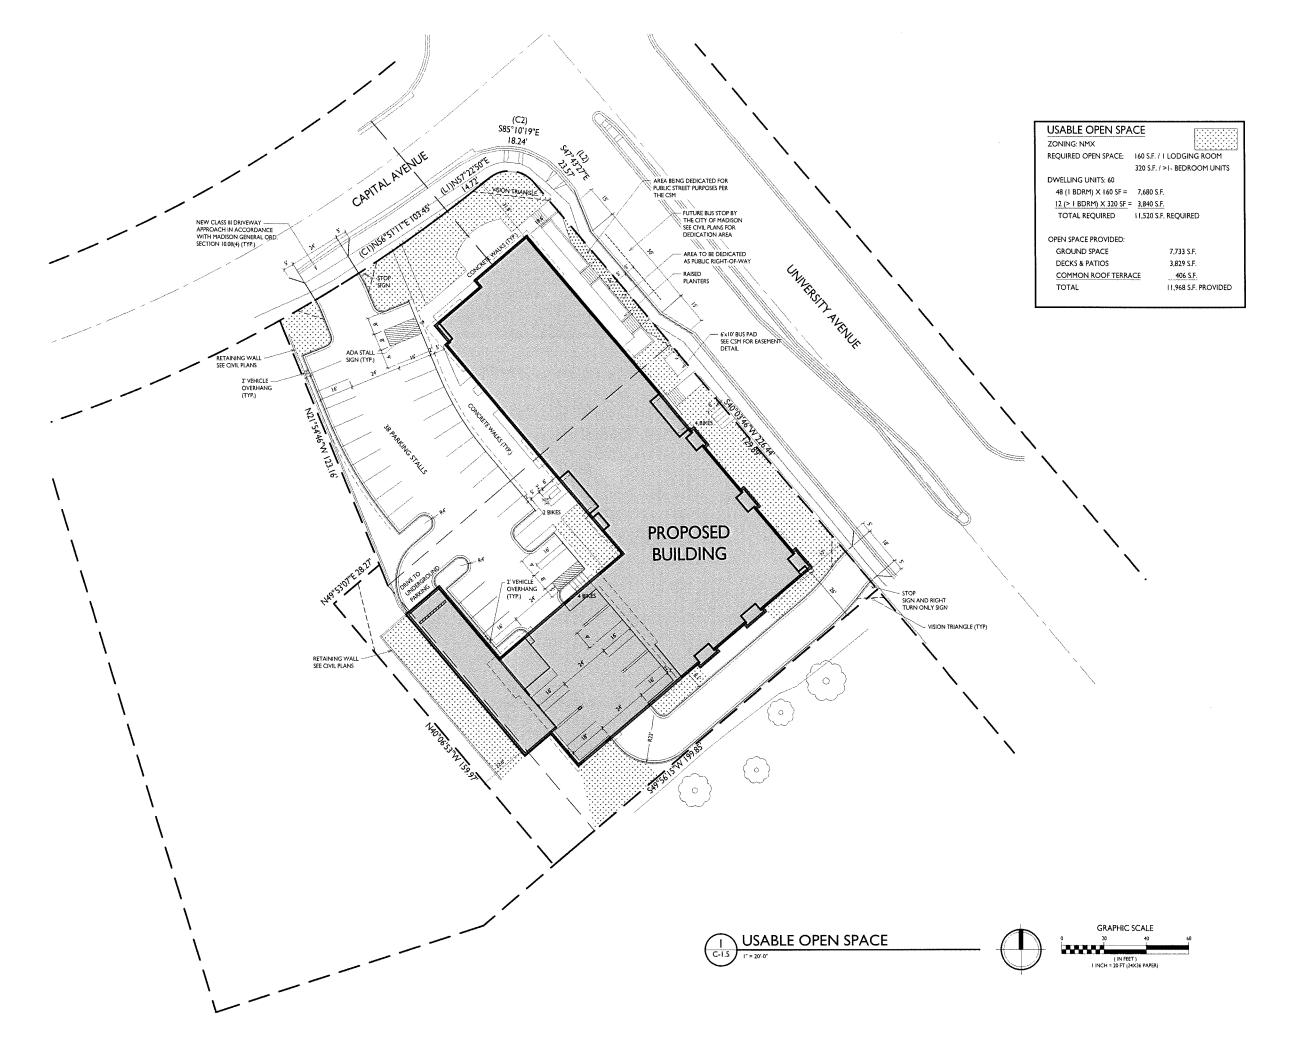



ISSUED

Issued for Land Use & UOC - September 5, 2018 Issued for Land Use Supplement - Nov. 2, 2018


PROJECT TITLE
Mixed-Use
Development


5535 University Ave.
Madison, WI
SHEET TITLE
Usable Open
Space

SHEET NUMBER

C-1.5

PROJECT NO. 1735

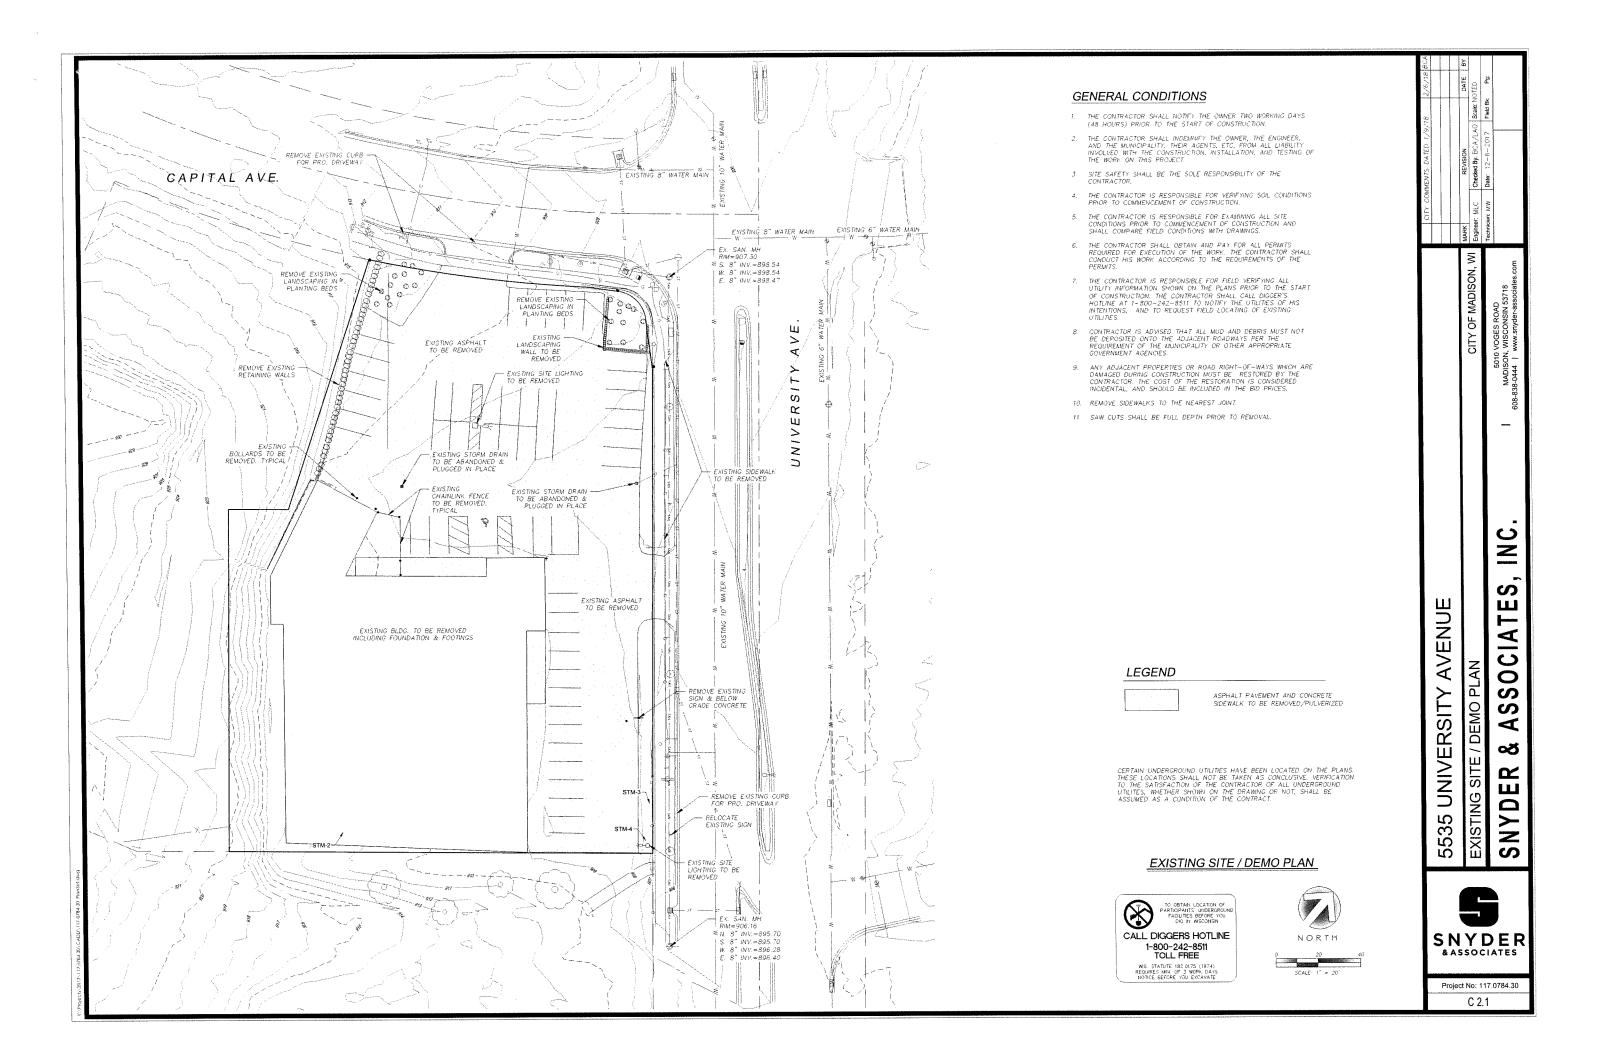

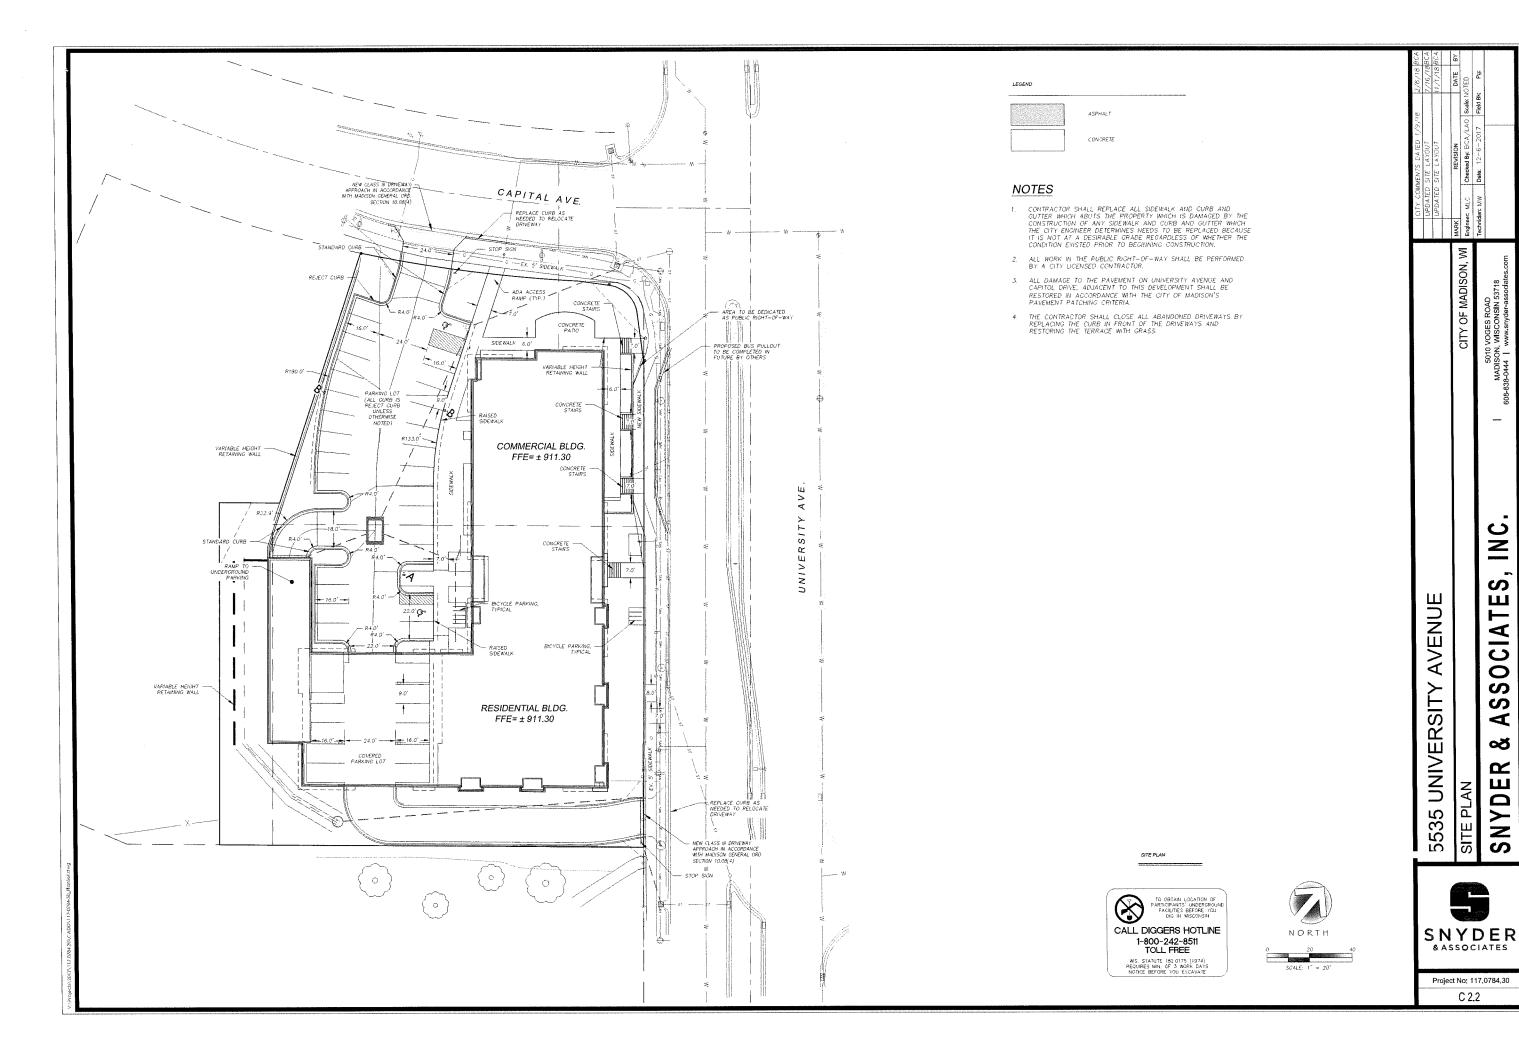

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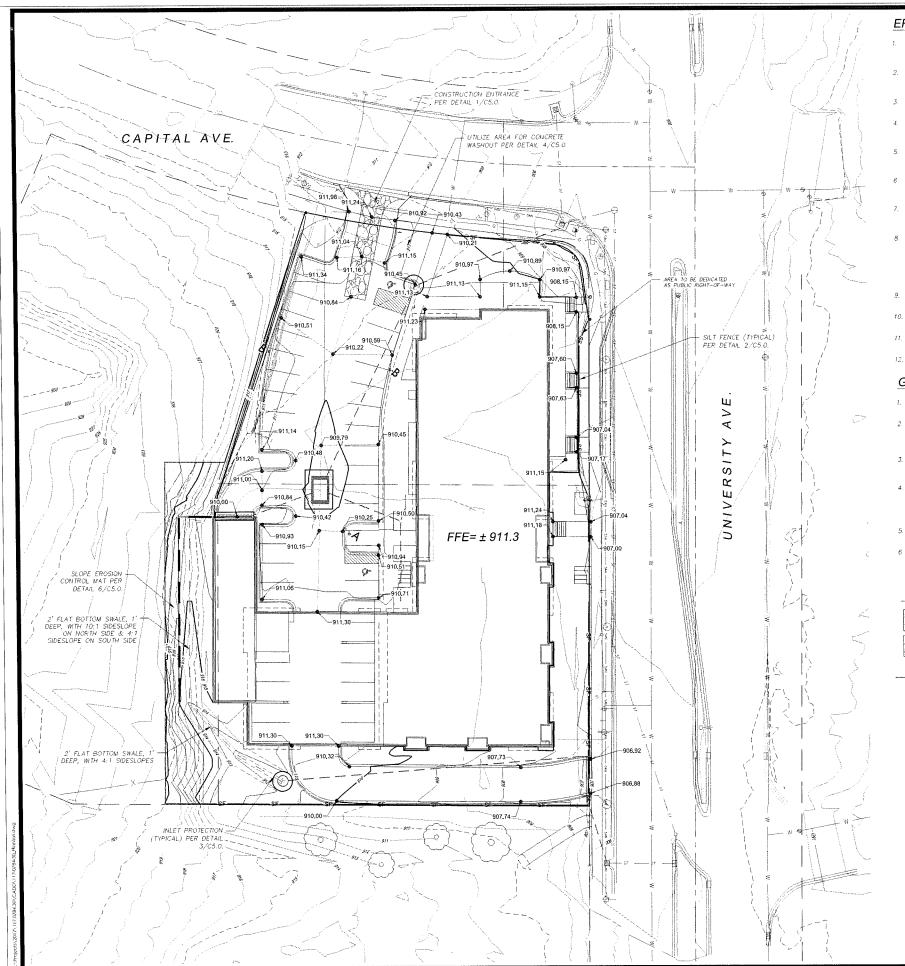
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SITE

& ASSOCIATES

Project No: 117,0784,30 C 2.2



EROSION CONTROL

- THE CONTRACTOR IS RESPONSIBLE FOR OBTAINING COPIES OF ALL PERMITS, INCLUDING WPDES DISCHARGE PERMITS (IF APPLICABLE). CONTRACTOR IS RESPONSIBLE FOR ABIDING BY ALL PERMIT REQUIREMENTS AND RESTRICTIONS.
- ALL INSTALLATION AND MAINTENANCE OF EROSION CONTROL PRACTICES SHALL BE IN ACCORDANCE WITH THE APPLICABLE WISCONSIN DEPARTMENT OF NATURAL RESOURCES (WDNR) TECHNICAL STANDARD.
- ALL EPOSION CONTROL FACILITIES SHALL BE MAINTAINED THROUGHOUT THE DURATION OF THE PROJECT AND WARRANTY PERIOD.
- ALL EROSION AND SEDIMENTATION CONTROL PRACTICES SHALL BE INSPECTED WEEKLY AND WITHIN 24 HOURS AFTER EVERY PRECIPITATION EVENT THAT PRODUCES 0.5 INCHES OF RAIN OR MORE DURING A 24 HOUR PERIOD. NEEDED REPAIRS WILL BE MADE IMMEDIATELY.
- ALL DISTURBED GROUND LEFT INACTIVE FOR THIRTY DAYS OR MORE SHALL BE STABILIZED WITH TOPSOIL SEED, AND MULCH IN ACCORDANCE WITH THE WONR TECHNICAL STANDARDS 1059 AND 1058.
- DISTURBED AREAS THAT CANNOT BE STABILIZED WITH A DENSE GROWTH OF VEGETATION BY SEEDING AND MULCHING DUE TO TEMPERATURE OR TIMING OF CONSTRUCTION, SHALL BE STABILIZED BY APPLYING EROSION MAT IN ACCORDANCE WITH WONR TECHNICAL STANDARD 1050.
- SEDIMENT WILL BE REMOVED FROM BEHIND THE SILT FENCE AND DITCH CHECKS WHEN IT REACHES HALF THE HEIGHT OF THE FENCE/BALE THE SILT FENCE AND DITCH CHECKS SHALL BE REPAIRED AS NECESSARY TO MAINTAIN A BARRIER.
- THE CONTRACTOR IS RESPONSIBLE FOR INSTALLATION OF ANY ADDITIONAL EROSION CONTROL MEASURES NECESSARY TO PREVENT EROSION AND SEDMENTATION. ALL DISTURBED AREAS ARE TO BRAIN TO APPROVED SEDMENT CONTROL MEASURES AT ALL TIMES DURING SITE DEVENDENT UNTIL FINAL STABILIZATION IS ACHIEVED. DEPENDING ON HOW THE CONTRACTOR GRADES THE SITE, IT MAY BE NECESSARY TO INSTALL TEMPORARY SEDMENT TRAPS IN VARIOUS LOCATIONS THROUGHOUT THE PROJECT. TEMPORARY SEDMENT TRAPS SHALL BE DESIGNED, INSTALLED, AND MAINTAINED IN ACCORDANCE WITH WONR TECHNICAL STANDARD 1063.
- ANY SEDIMENT TRACKED ONTO A PUBLIC OR PRIVATE ROAD SHOULD. BE REMOVED BY STREET CLEANING, NOT FLUSHING, BEFORE THE END OF EACH WORKING DAY.
- DUST CONTROL SHALL BE PROVIDED AS NECESSARY IN ACCORDANCE WITH WONR TECHNICAL STANDARD 1068
- 11. ALL EROSION CONTROL MEASURES SHALL BE INSTALLED FRIOR TO THE START OF LAND DISTURBING ACTIVITIES.
- 12. REFER TO SPECIFICATION SECTIONS 31 20 00, 31 25 00, 32 91 19, AND 32 92 00.

GRADING

- THE CONTRACTOR SHALL MAINTAIN SITE DRAINAGE THROUGHOUT CONSTRUCTION, THIS MAY INCLUDE THE EXCAVATION OF TEMPORARY DITCHES OR PUMPING TO ALLEVIATE WATER PONDING.
- 2 SILT FENCE AND OTHER EROSION CONTROL FACILITIES MUST BE INSTALLED PRIOR TO CONSTRUCTION OR ANY OTHER LAND DISTURBING ACTIVITY. THE CONTRACTOR SHALL BE RESPONSIBLE FOR REMOVING ALL EROSION CONTROL FACILITIES ONCE THE SITE HAS BEEN STABILIZED WITH VESETATION AND THE APPROVAL OF THE GOVERNING AGENCY.
- THE CONTRACTOR SHALL ASSUME SOLE RESPONSIBILITY FOR ALL GRADING, CUT AND FILL CALCULATIONS AND FOR ACTUAL LAND BALANCE, INCLUDING UTILITY TRENCH SPOIL. THE CONTRACTOR SHALL IMPORT OR EXPORT MATERIAL AS NECESSARY TO COMPLETE THE PROJECT.
- GRADING SHALL CONSIST OF CLEARING AND GRUBBING EXISTING VEGETATION, STRIPPING TOPSOIL, REMOVAL OF EXISTING PAVEMENT OR FOUNDATIONS, IMPORTING OR EXPORTING MATERIAL TO ACHIEVE AND ON-SITE EARTHWORK BALANCE, GRADING THE BUILDING PADS AND PAVEMENT AREAS, SCARIFYING AND FINAL COMPACTION OF THE PAVEMENT SUBGRADE,
- 5. NO FILL SHALL BE PLACED ON A WET OR SOFT SUBGRADE THE SUBGRADE SHALL BE PROOF—ROLLED AND INSPECTED BY THE ENGINEER BEFORE ANY MATERIAL IS PLACED
- REFER TO SPECIFICATION SECTIONS 31 20 00, 31 25 00, 32 91 19, AND 32 92 00.

LEGEND



ASPHALT

CONCRETE

PROJECT GRADING LIMITS ----- GL ---

GRADING / EROSION CONTROL PLAN





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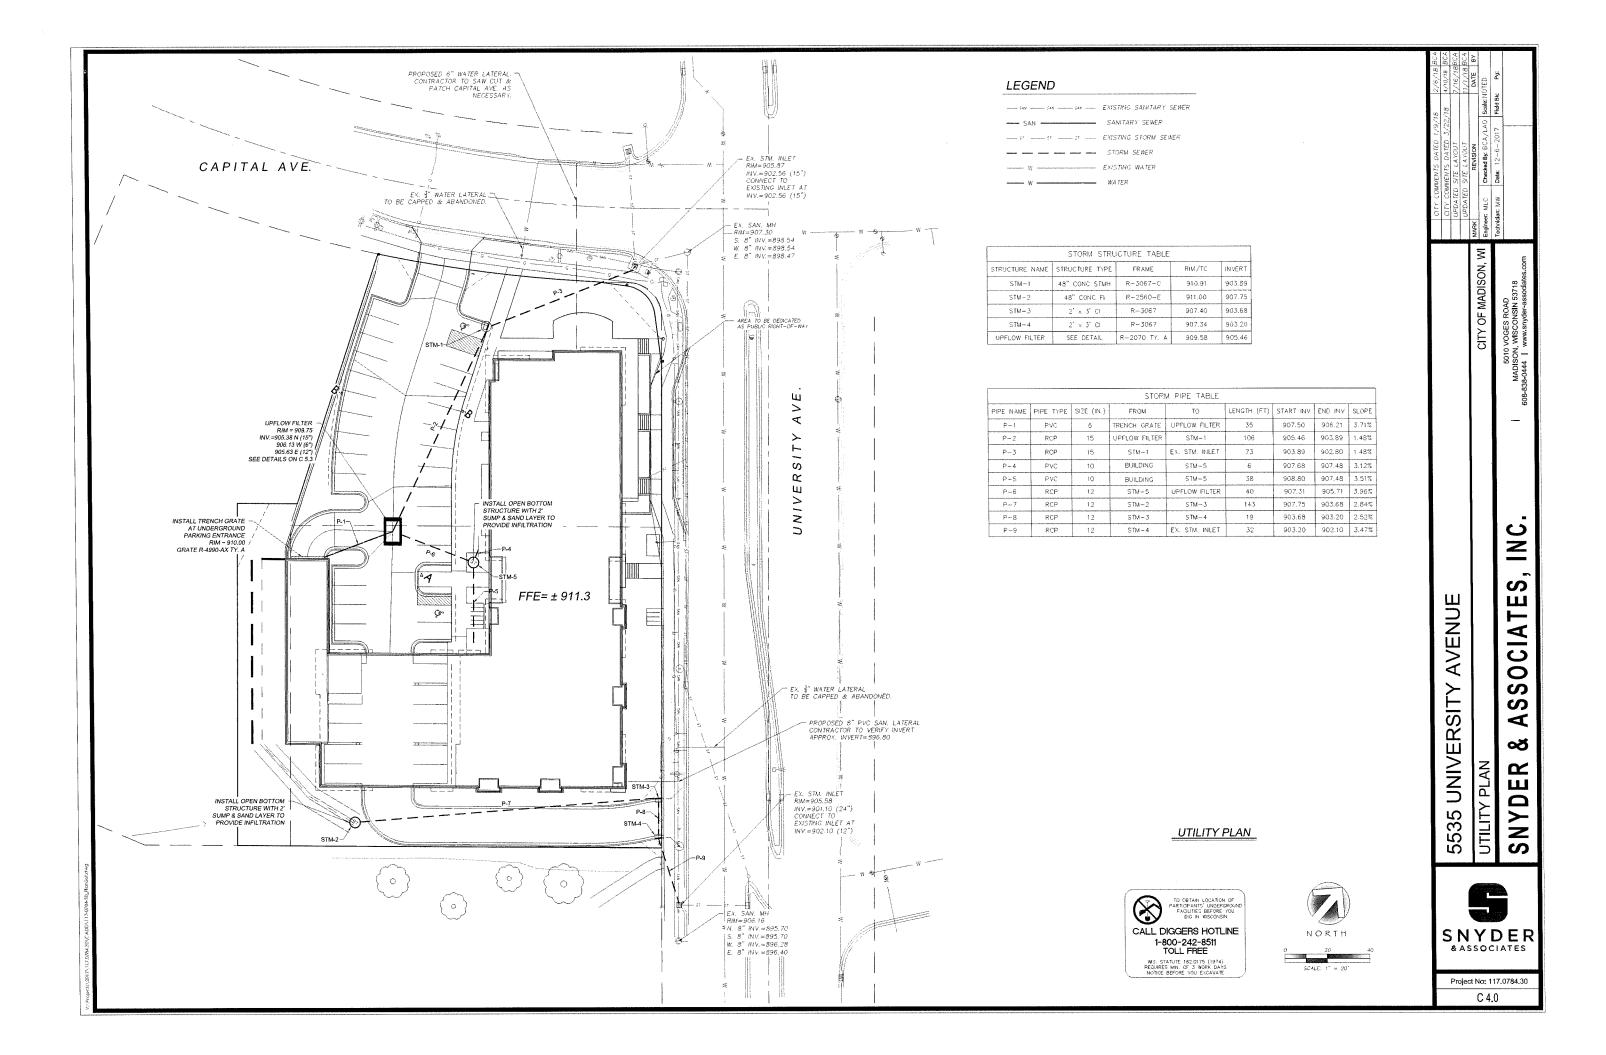
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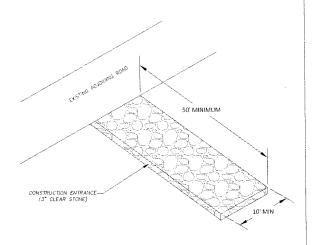
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SNYDER & ASSOCIATES

Project No: 117.0784.30

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- . CONSTRUCTION ENTRANCE TO BE INSTALLED PRIOR TO ANY TRAFFIC LEAVING THE SITE
- 2. THE AGGREGATE FOR THE CONSTRUCTION ENTRANCE SHALL BE 3 INCH CLEAR OR WASHED STONE.
- 3. AGGREGATE SHALL BE PLACED IN A LAYER AT LEAST 12 INCHES THICK.
- THE CONSTRUCTION ENTRANCE SHALL BE UNDERLAIN WITH A WOOT TYPE HR OF FF GEOTEXTILE FABRIC TO PREVENT MIGRATION OF UNDERLYING SOIL INTO THE STONE.
- SURFACE WATERS MUST BE PREVENTED FROM PASSING THROUGH THE CONSTRUCTION ENTRANCE. FLOWS SHALL BE DIVERTED AWAY FROM THE CONSTRUCTION ENTRANCE OR CONVEYED UNDER AND AROUND THEM BY USE OF A CULVERT, DIVERSION BERN OR OTHER PRACTICES AS APPROVED BY THE CONSTRUCTION ENGINEEY.
- 6. CLEANING BY SCRAPING OR ADDING NEW STONE SHALL BE REQUIRED IF ENTRANCE BECOMES MORE THAN 50% COVERED BY TRACKED MUD.




GENERAL NOTES
MANUFACTURED ALIERNATIVES APPROVED AND
HISTED ON THE WISDOT'S EROSION CONTROL
PRODUCT ACCEPTABILITY LIST MAY BE
SUBSTITUTED.

CLEANING SHALL BE PEOURED WHEN SEDIMENT OR STANDING WATER IS WITHIN 6" OF DIRRELOW HOLES OR AS DIRECTED BY THE CONSTRUCTION ENOMEER

WHEN REMOVING OR MAINTAINING INLET PROTECTION. CARE SHALL BE TAKEN SO THAT THE SEDIMENT TRAPPED ON THE GOOTEVILE FABRIC DOES NOT FALL INTO THE BILET. ANY MATERIAL FALLING INTO THE INLET SHALL BE REMOVED IMMEDIATELY.


THE INSTALLED BAG SHALL HAVE A MINIMUM SIDE CLEARING BETWEEN THE INLET WALLS AND THE BAG, MEASURED AT THE BOTTOM OF THE OVERFLOW HOLES, OF 3". WHERE RECESSARY THE CONTRACTOR SHALL CINCH THE BAG, USING THE FO "MODRIFO" = PLASING ZIP TIES. TO ACHIEVE THE 3" CLEARANCE. GEOTEXTILE FABRIC TYPE HE FLES SHALL BE PLACED AT 4 MANIMUM OF 4" FROM THE BOSTOM OF THE BAG.

- (2) FOR INLET PROTECTION WITH CURB BOX AN ADOITIONAL 18' OF FABRIC IS WRAPPED AROUND THE WOOD AND SECURED WITH STAPLES THE WOOD SHALL NOT BLOCK THE ENTIRE HEIGHT OF THE CURB BOX OPENING.
- (3) FLAP POCKETS SHALL BE LARGE ENOUGH TO ACCEPT WOOD 2X4.

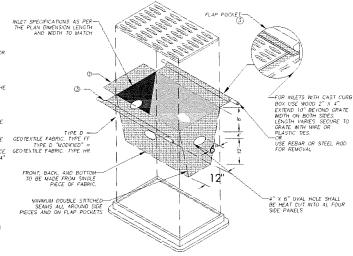

(CAN BE INSTALLED IN ANY OUTLET TYPE WITH OR WITHOUT A CURB BOX AS PER NOTE (2))

3 INLET PROTECTION TYPE "D" DETAIL (C5,0) SCALE: NTS

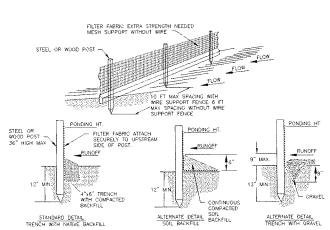

E: MISPECT FENCE WEERLY AND AFTER EACH RAHI EVENT OF 0.5 INCHES AND REPAIR IF REQUIRED, REMOVE SEDIMENT WHEN SEDIMENT REACHES 32 OF FENCE HEIGHT.


REMOVED SEDIMENT SHALL BE DEPOSITED TO AN AREA THAT WILL NOT CONTRIBUTE. SEDIMENT OFF-SITE AND CAN BE PERMANENTLY STABILIZED.

2 SILT FENCE DETAIL

C5.0 SCALE: NTS

- SILT FENCE SHALL BE PLACED ON SLOPE CONTOURS TO MAXIMIZE PONDING EFFICIENCY.


SILT FENCE B FABRIC TO BE WRAPPED AROUND ENCE A FENCE POST ROLL JOINTS

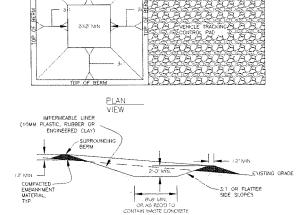

CONCRETE WASHOUT AREA INSTALLATION NOTES SECTION

TOP OF BERM

- SEE EROSION CONTROL PLAN FOR LOCATIONS OF CONCRETE WASHOUT AREA(5), TO BE PLACED
 A MIN OF 50' FROM DRAINAGEWAYS, BODIES OF WATER, AND INLETS.)
- THE CONCRETE WASHOUT AREA(S) SHALL BE INSTALLED PRIOR TO ANY CONCRETE PLACEMENT ON SITE.
- 3. VEHICLE TRACKING CONTROL PAD IS REG'D AT THE ACCESS POINT(S).
- 4. SIGNS SHALL BE PLACED AT THE CONSTRUCTION ENTRANCE, AT THE WASHOUT AREA(S), AND ELSEWHERE AS INCESSARY TO CLEARLY INDICATE THE LOCATION OF THE CONCRETE WASHOUT AREAS TO OPERATORS OF CONCRETE TRUCKS AND PUMP RIDS.
- 5. EXCAVATED MATERIAL SHALL BE UTILIZED IN PERIMETER BERM CONSTRUCTION. CONCRETE WASHOUT AREA MAINTENANCE NOTES
- 6. THE CONCRETE WASHOUT AREA SHALL BE REPAIRED AND ENLARGED OR CLEANED OUT AS NECESSARY TO MAINTAIN CAPACITY FOR WASTED CONCRETE.
- AT THE END OF CONSTRUCTION, ALL CONCRETE SHALL BE REMOVED FROM SITE AND DISPOSED OF AT AN APPROVED WASTE SITE.
- 8. WHEN CONCRETE WASHOUT AREA(S) IS REMOVED, THE DISTURBED AREA SHALL BE STABILIZED PEP SITE EROSION CONTROL MEASURES.
- INSPECT WEEKLY AND DURING AND AFTER ALL STORM EVENTS. CLEAN—OUT OF COVER WASHOUT
 AREA FRIOR TO PREDICTED STORM EVENTS TO PREVENT OVER—FLOW.
- 4 CONCRETE WASHOUT AREA C5.0 SCALE: HTS

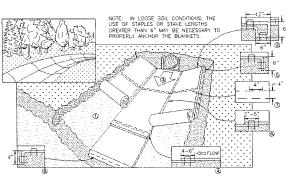


PREPARE SOIL BEFORE INSTALLING BLANKETS, INCLUDING APPLICATION OF FERTILIZER AND SEED 2. BEGIN AT THE TOP OF THE CHANNEL BY ANCHORING THE BLANKET IN A 6" DEEP X 6" WIDE TRENCH WITH APPROXIMATELY 12" OF BLANKET EXTENDED BEYOND THE UP-SLOPE PORTION OF THE TRENCH. ANCHOR THE BLANKET WITH A ROW OF STAPLES/STAKES APPROXIMATELY 12" APART IN THE BOTTOM OF THE TRENCH. BRANKET WITH A ROW OF STAPLES/STAKES APPROXIMATELY 12" APART IN THE BOTTOM OF STAPLES SOIL WITH A ROW OF STAPLES TO COMPACTED SOIL. SCIURE BLANKET OVER COMPACTED SOIL. SCIURE BLANKET OVER COMPACTED SOIL WITH A ROW OF STAPLES/STAKES SPACED APPROXIMATELY 12" APART ACROSS THE WIDTH OF THE BLANKET.

- ROLL CENTER BLANKET IN DIRECTION OF WATER FLOW IN BOTTOM OF CHANNEL. BLANKETS WILL UNROLL WITH APPROPRIATE SIDE AGAINST THE SOIL SUBFACE. ALL BLANKETS MUST BE SECURELY FASTENED TO THE SOIL SURFACE BY PLACING STAPLES/STAKES IN APPROPRIATE LOCATIONS AS RECOMMENDED BY THE MANUFACTURER.
- PLACE CONSECUTIVE BLANKETS END OVER END (SHINGLE STYLE) WITH A 4-6" OVERLAP. USE A
 DOUBLE ROW OF STAPLES STAGGERED 4" APART AND 4" ON CENTER TO SECURE BLANKETS.
- 5. FULL LENGTH EDGE OF BLANKETS AT TOP OF SIDE SLOPE MUST BE ANCHORED WITH A ROW OF STAPLES/STARES APPROXIMATELY 12" APART IN A 6" DEEP X 6" WIDE TRENCH BACKFILL AND COMPACT THE TERRICH AFTER STAPLING.
- 7. THE TERMINAL END OF THE BLANKETS MUST BE ANCHORED WITH A ROW OF STAPLES/STARES APPROXIMATELY 12" APART IN A 6" DEEP \times 6" WIDE TRENCH. BACKPILL AND COMPACT THE TRENCH AFTER STAPLING.
- EROSION MAT SHALL EXTEND FOR WHICHEVER IS GREATER: UPSLOPE ONE FOOT MIN. VERTICALLY FROM DITCH BOTTOM OR 6" HIGHER THAN DESIGN FLOW DEPTH.
- EROSION MAT SHALL BE INSTALLED AND MAINTAINED IN ACCORDANCE WITH WONR TECHNICAL STANDARDS 1053.

5 EROSION CONTROL MAT - CHANNEL INSTALLATION SCALE: NTS

EROSION CONTROL NOTES

- THE CONTRACTOR IS RESPONSIBLE FOR OBTAINING COPIES OF ALL PERMITS, INCLUDING WISDHR WPDES DISCHARGE PERMIT (IF APPLICABLE), COULINTY AND LOCAL EROSION CONTROL PERMIT CONTRACTOR IS RESPONSIBLE FOR ABBINS BY ALL PERMIT REQUIREMENTS AND RESTRICTIONS.
- ALL EROSION CONTROL MEASURES SHALL BE INSTALLED PRIOR TO LAND DISTURBING ACTIVITIES.
- ALL INSTALLATION AND MAINTENANCE OF EROSION CONTROL PRACTICES SHALL BE IN ACCORDANCE WITH THE APPLICABLE WISCONSIN DEPARTMENT OF NATURAL RESOURCES (WDNR) TECHNICAL STANDARD, FORUM AT: NICE/Jarn.wigov/100/c/sformmostr/stondards/cons_stondards and Inc. 3 to Nice with the Wisconsin Construction Site Best Management Practice Handbeock if a Technical Standard is NICT MAILAFEL.
- ALL EROSION CONTROL FACRITIES SHALL BE MAINTAINED THROUGHOUT THE DURATION OF THE PROJECT AND WARRANTY PERIOD IN CONFORMANCE WITH ALL APPLICABLE PERMITS ISSUED FOR THE PROJECT.
- ALL EPOSION AND SECIMENTATION CONTROL PRACTICES SHALL BE HISPECTED WEEKLY AND WITHIN 24 HOURS AFTER EVERY PRECIPITATION EVENT THAT PRODUCES 0.5 INCHES OF RAIN OR MORE DURING A 24 HOUR PERIOD. REPAIRS SHALL BE MADE IMMEDIATELY TO EROSION CONTROL PRACTICES AS NECESSARY.
- TEMPORARY STOCKPILES SHALL BE STABILIZED IF NOT REMOVED IN 10 DAYS, PERIMETER CONTROL ON THE COWNHILL SIDE SHALL BE IN PLACE AT ALL TIMES (SILT FENCE OR APPROVED EQUAL)
- TEMPORARY SEED MIXTURE SHALL CONFORM TO 630.2.1.5.1.4 OF THE WISDOT STANDARD SPECIFICATIONS USE WHITER WHEAT OR RYE FOR FALL PLANTINGS STARTED AFTER SEPTEMBER 1.
- 9. SEDIMENT SHALL BE REMOVED FROM THE SEDIMENT BASINS TO MAINTAIN A THREE FOOT DEPTH OF TREATMENT, MEASURED BELOW THE NORMAL WATER ELEVATION, SEDIMENT WILL BE REMOVED FROM THE DIVERSION DITCHES WHEN IT REACHES HALF THE HEIGHT OF THE DITCH. SEDIMENT WILL BE REMOVED FROM BEHIND THE SILT FENCE AND DITCH CHECKS WHEN IT REACHES HALF THE HEIGHT OF THE FENCE/BALE THE SILT FENCE AND DITCH CHECKS SHALL BE REPAIRED AS NECESSARY TO MAINTAIN A BARRIER.
- ALL WATER FROM CONSTRUCTION DEWATERING SHALL BE TREATED IN ACCORDANCE WITH WDNR TECHNICAL STANDARD 1061 PRIOR TO DISCHARGE TO WATERS OF THE STATE, WETLANDS, OR OFFSITE.
- 11. THE CONTRACTOR IS RESPONSIBLE FOR INSTALLATION OF ANY ADDITIONAL EROSION CONTROL MEASURES NECESSARY TO PREVENT EROSION AND SCOMMENTATION ALL DISTURBED AREAS ARE TO DRAIN TO APPROVED SEDIMENT CONTROL MEASURES AT ALL TIMES DURING SITE DEVELOPMENT UNTIL FINAL STABILIZATION IS ACHIEVED DEPENDING ON HOW THE CONTRACTOR GRADES THE SITE, If MAY BE NECESSARY TO INSTALL TEMPORARY REGISIAN CONTROL AND/OR SEDIMENT TRAPS IN VARIOUS LOCATIONS THROUGHOUT THE PROJECT. TEMPORARY SEDIMENT TRAPS SHALL BE DESIGNED, INSTALLED, AND MAINTAINED IN ACCORDANCE WITH WORST ECONOMICS ATMORPHIC DESIGNED, INSTALLED, AND MAINTAINED IN ACCORDANCE WITH WORST ECONOMICS ATMORPHOL DESIGNED.
- TRACKED MATERIAL TO ADJACENT STREETS SHALL BE COLLECTED AT THE END OF EACH WORKING DAY OR AS REQUIRED BY THE LOCAL MUNICIPALITY.
- DUST CONTROL SHALL BE PROVIDED AS NECESSARY IN ACCORDANCE WITH WORR TECHNICAL STANDARD 106B.
- FINAL STABILIZATION OF LANDSCAPED AREAS SHALL BE IN ACCORDANCE WITH THE APPROVED LANDSCAPE PLAN.
- 16. THE CONTRACTOR IS RESPONSIBLE FOR PROVIDING ALL EROSION CONTROL FACILITIES AND MEASURES NECESSARY TO CONTROL EROSION AND SEDIMENTATION AT THE PROJECT SITE. THESE FACILITIES AND MEASURES MAY OR MAY HOT BE SHOWN ON THE DRAWNINGS AND THEIR ASSENCE ON THE DRAWNINGS DOES NOT ALLEVARE THE CONTRACTOR FROM PROVIDING THEM, ANY MEASURES AND FACILITIES SHOWN ON THE DRAWNINGS ARE THE MINIMAM ACTIONS REQUIRED.
- 17. ERODED MATERIAL THAT HAS LEFT THE CONSTRUCTION SITE SHALL BE COLLECTED AND RETURNED TO THE SITE BY THE CONTRACTOR.
- AFTER FINAL VEGETATION IS ESTABLISHED, REMOVE ALL EROSION CONTROL FACILITIES. RESTORE AREAS DISTURBED BY THE REMOVALS.
- KEEP A COFY OF THE CURRENT EROSION CONTROL PLAN ON SITE THROUGHOUT THE DURATION OF THE PROJECT.
- 20. COMPLETE AND STABILIZE SEDIMENT BASINS/TRAPS PRIOR TO MASS LAND DISTURBANCE TO CONTROL RUNGEF DURING CONSTRUCTION, REMOVE SEDIMENT AS NEEDED TO MAINTAIN 3 FEET OF DEPTH TO THE OUTLET, AND PROPERTY DISPOSE OF SEDIMENT REMOVED DURING MAINTENANCE. CONSTRUCT AND MAINTAIN THE SEDIMENT BASIN PER WORR TECHNICAL STANDARDS.
- 21. PROPERLY DISPOSE OF ALL WASTE AND UNUSED BUILDING MATERIALS (INCLUDING GARBAGE, DEBRIG, CLEANING WASTES, OF OTHER CONSTRUCTION MATERIALS) AND DO NOT ALLOW THESE MATERIALS TO BE CARRIED BY RUNNEY FIND THE RECEDUNG CHANNEY.
- 22. MAKE PROVISIONS FOR WATERING DURING THE FIRST 8 WEEKS FOLLOWING SEEDING OR PLANTING OF DISTURBED AREAS WHENEVER MORE THAN 7 CONSECUTIVE DAYS OF DRY WEATHER OCCUR.

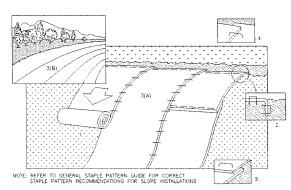

- PREPARE SOIL BEFORE INSTALLING BLANKETS, INCLUDING APPLICATION OF FERTILIZER AND SEED NOTE. WHEN USING CELL-O-SEED DO NOT SEED PREPARED AREA. CELL-O-SEED MUST BE INSTALLED WITH PAPER SIDE DOWN.
- BEGIN AT THE TOP OF THE SLOPE BY ANCHORING THE BLANKET IN 6" DEEP X 6" WIDE TRENCH. BACKFILL AND COMPACT THE TRENCH AFTER STAPLING.
- 3. ROLL THE BLANKETS (A.) DOWN OR (B.) HORIZONTALLY ACROSS THE SLOPE.
- 4. THE EDGES OF PARALLEL BLANKETS MUST BE STAPLED WITH APPROXIMATELY 2" OVERLAP.
- 5. WHEN BLAINETS MUST BE SPLICED DOWN THE SLOPE, PLACE BLANKETS END OVER RIN (SHIRLE STYLE) WITH APPROXIMATELY 4 OVERLAP, STAPLE THROUGH OVERLAPPED AREA, APPROXIMATELY 12 APACE.
- 6. ALL BLANKETS MUST BE SECURELY FASTENED TO THE SLOPE BY PLACING STAPLES/STAKES IN APPROPRIATE LOCATIONS AS RECOMMENDED BY THE MANUFACTURER.
- EROSION MAT SHALL BE INSTALLED AND MAINTAINED IN ACCORDANCE WITH WORR TECHNICAL STANDARD # 1052.

6 EROSION CONTROL MAT - SLOPE INSTALLATION SCALE: NTS



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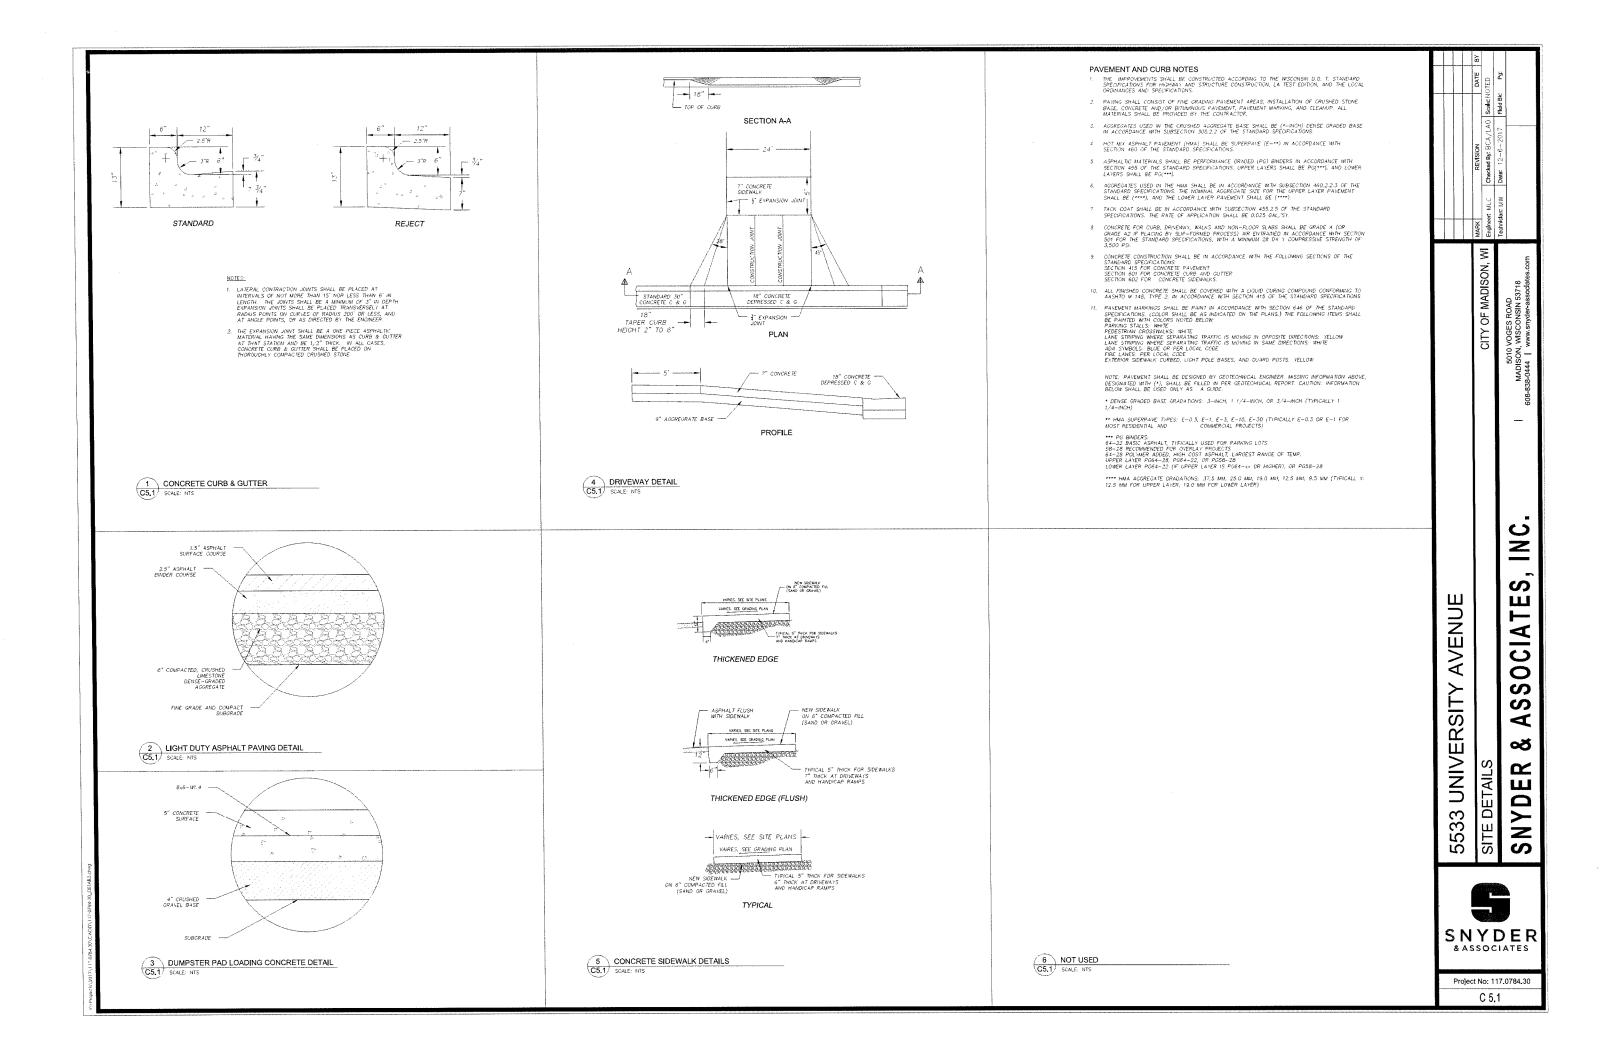
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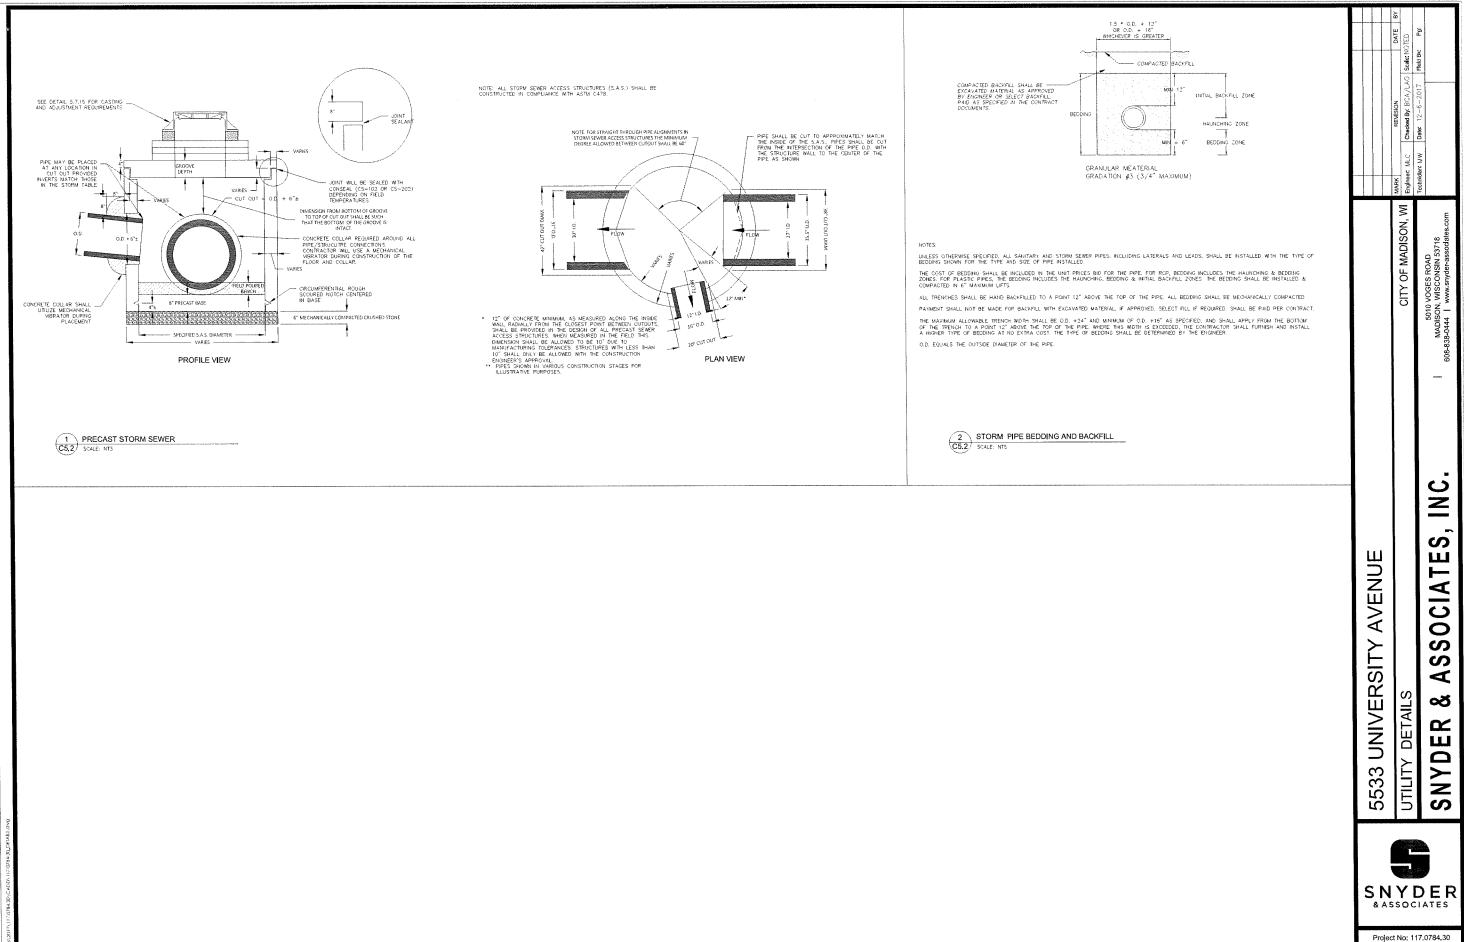
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Project No; 117,0784,30


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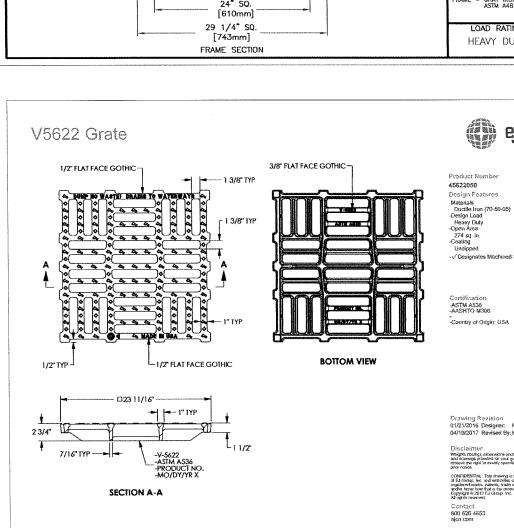








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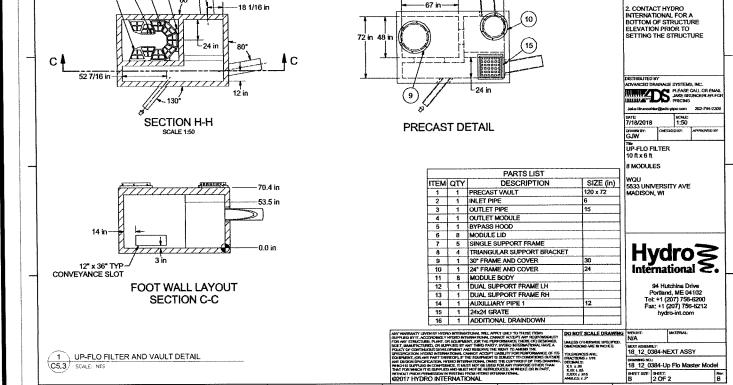
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	Botonical Name	Common Name	Size/Condition
Tre	73		
2	Amelorchier x grandiflara 'Auturm Brilliance'	AUTUM BRILLIANCE APPLE SERVCEBERRY (milti-stem)	8-17/b.b.
2	Acer miyobei Mortari	STATE STREET MYAGE MAPLE	2 1/2/b, b.
4	Carpinos betalus Frans Fontaine	FRANS FONTANE HORNBEAM	2 V7/b.b.
6	Jariperus virginiano Burkil	BURKLI BURK EAGTERN RED CEDAR	6/b. b.
3	Prints reacki	AFILE CHOKE CHERRY	2 1/2/b.b.
4	Querous 'Crimed midt'	CRITISON SPICE OAK	2 1/2/b.b.
38	Thuip accidentals 'Techny'	TECHNY ARBORVITAE	6/b b
2	Tilia conduta 'Greenspine'	GREENSPRE STALL-LEAVED UNDEN	2 1/2/h, b.
5m	to		
5	Arona melanacarpa Martari	ROQUOS BEAUTY BLACK BERRED ARONA	8-26/curt.
26	Buss Green Velvet	GREEN VELVET BOXHOOD	8-26/b b
5	Champecyparis pisifera 'Golden Mans'	GOLDEN MOPS JAPANESE FALSE CYPRESS	8-26/cont.
3	Comus stolarifera Xelneyl	KELSEYS DOGHOOD	B-26/cort.
6	Diervilla lonkera	BUSH HONEYSIKDOLE	B-26/cort
3	Digryilla nenoli(alia 'Cool Splani')	COOL SPLASH BLISH HONEYSLOKEE	8-26/cort
3	Excrymus Fortunal Emerold Galety	EMERALD GAETY EXPROPUS	9-26/cmt
2	Hydranges arbanescens 'Abetud pp#2057i, dpr#464 (Proven Hinners)	NORFORALL SYCOOTH HYDRANGEA (Proven Identity)	B-25/cort
5	Hydronaes arbanescens 'Armabelle'	ANABELE HYDRANGEA	8-74/cort.
q	Hydranaeo arbanescens NCHAI FP: 20765	hvinchete Spirit, Hydrongeo	8-24/cmt
14	Hydrangeo paria/lota SPIFFLOF pp#25/36, cbrail (Proven Hinners)	LITTLE GLICK FIRE HARDY HYDRANGEA (Proven Harsers)	B-24 /cont.
4	Physicianas anifidis Donna Pay	LITTLE DEVI. INVERABLE	24-30 /cont.
4	Pines doins Nidforms'	NDECRES NORMAY SERVE	B-25/unt
3	Pine may Compactal	COMPACTA MIGO PINE	8-24/cms
2	Physica aromatica (Gre-faul	GPO-LON FRAGRANT SUMAC	8-24 cms
B	Symphonicorpos Solid pp#2(226 (Proven Winners)	PROUD BERRY CORAL BERRY (Proven Himers)	8-26'/cmt
3	Syrings patulo Ples Krri	PIES KIT ITANCHURIAN LLAC	24-307(cm)
ũ	Tann z mydo Everlayl	EVERLON TEW	8-747cms
	med (case)	CTC/LOTT 101	0-24/014
B	Colomograpia y acutiflara Karl Foerstar'	KARL FOERSTER FEATHER REED GRASS	# cont
22	Calamanatia y autiflora 'Overdam'	DVFRDAM FEATHER REFD GRASS	# cont
	Descharronia compitano	TIFTED HAR GRASS	□ cont
6	Sporoboka heterolepia	PRARE DROPSEED GRASS	II cont
	erreis and Armais	TOPPLE DOLL SELD UNION	
ö	Ascletos tiberosa	BUTTERFLY WEED	≡ cont.
21	Brotein australia	BUE HLD NOGO	III cont
20	Echinocea parazina Kimy Knee Hoti	KETS KINEE HIGH CONFILOWER	# cont.
30	Gerarium v contabrigiome 'Bakova'	BOKOVO CRANESBILL	# cont.
37	Hemerocolle Proirie Blue Even	PRARE CLE ETES DATULY	# cont.
2	Hemmacollis Strauberry Condy	STRANBERRY CANDY DAYLLY	E cont.
19	Nepeto v foamerii Vialkers Lau/	HALKERS LOW CATTENT	FI cont.
p	Persterron dotals Hasker Red	HUSKER RED PENSTERION	El cont.
9	Peravskia strelcijala Little Seriel	LITTLE SPIKE RUSSIAN SAGE	# cont.
0	Pycryntherram vindrianam	VEGNA MOINTAN MET	al cont.
	Rudhedkia fulgida "Galdeturm"	GOLDSTURM BLACK-EYED SUSAN	# cont.
K	Sedum 'Asturm Joy'	AUTURN JOY SEDUM	Pi cont.
8	Soldour short i Solar Coscode'	SOLAR CASCADE GOLDENROD	#I cont
30	Starbus marrier Vicennels	HUTTELD COTTON BETON	
			ni cont.

LANDSCAPE CALCULATIONS & DISTRIBUTION:

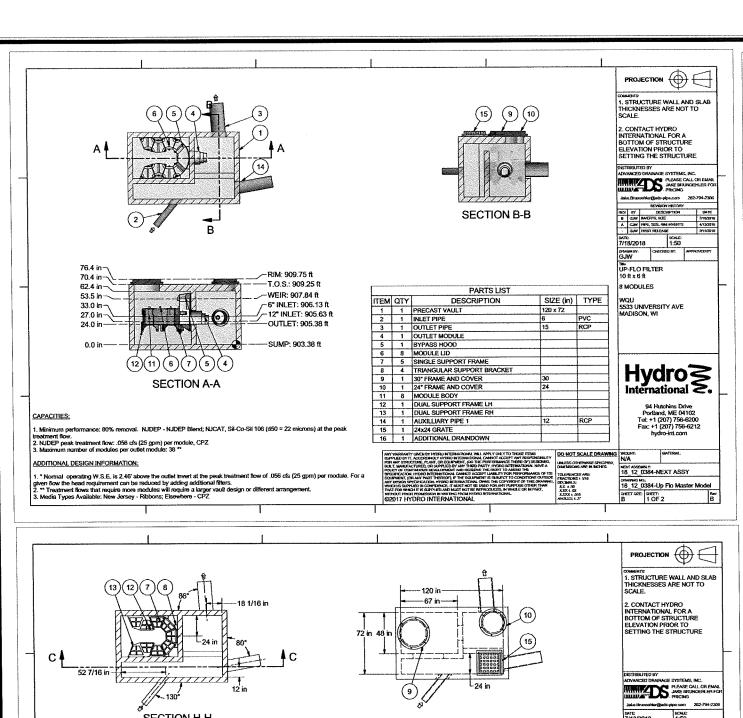TOTAL SQUARE FOOTAGE OF DEVELOPED AREA = 35,483 SQUARE FEET TOTAL LANDSCAPE POINTS REQUIRED = 595

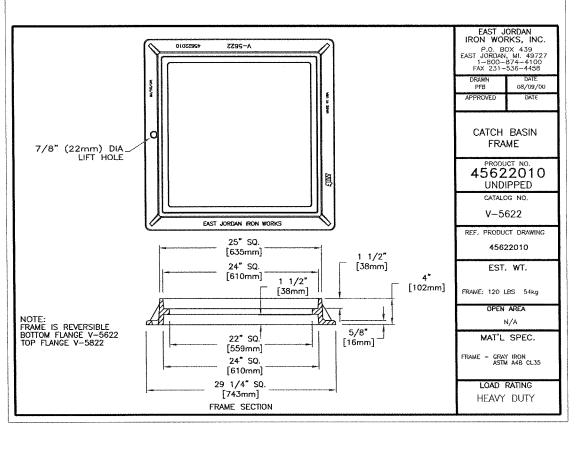Plant Type/ Element	Minimum Size at Installation 2's inch caliper measured diameter at breast height (dbh)	Points 35	Credits/ Existing Landscaping		New/Proposed Landscaping	
riant type/Element			Quantity	Points Achieved	Quantity 15	Points Achieved 525
Overstory deciduous tree						
Tall evergreen tree (i.e. pine, spruce)	5-6 feet tail	35				
Omamental tree	1.1/2 inch caliper	15			2	30
Upright evergreen shrub (i.e. arborvitae)	3-4 feet tail	10			27	270
Shrah, decidaous	83 gallon container size, Min. 12"-24"	3			96	288
Shrub, evergreen	53 gallon container size, Min. 12"-24"	4			49	196
Ornamental grasses perenenals	81 gallon container size, Min. 87-187	2			383	766
Ornamental/ decorative fencing or wall	n/a	4 per 10 lineal ft.				
lixisting significant specimen free	Minimum size: 2 % such caliper dith. *Trees must be within developed area and cannot comprise more than 30% of total required points.	14 per ualiper inch dbh Maximam points per tree: 200				
Landscape farmiture for public scaling and or transit connections	* Furniture must be within developed area, publically accessible, and cannot comprise ment than 5% of total required points.	3 points per "sear"				The second section is a second
Sub Totals			in an	İ	E SAITE	2,075

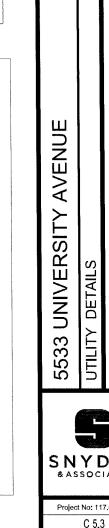Total Number of Points Provided 2,465


PLANTING NOTES:

DCONTRACTOR SHALL VERIFY LOCATION OF ALL ON-SITE UTILITIES PRIOR TO COMMENCING ANY WORK ON SITE. WISTATE STATUTE 1820/TIS REQUIRES THREE WORK DAYS HOTICE BEFORE YOU EXCAVATE, CALL DIGERS HOTINE AT 1-800-242-8511. 2519PLY AND INSTALL ALL WISCONSIN GROWN NIRSSEY STOCK, GUARANTEE ALL STOCK, FAR PERSON ONE YEAR ALL PLANTING MATERIAL IS TO MEET AMERICAN STOCK OF THE PROPERTY OF THE P

TREFER TO GRADING AND CIVIL PLANS FOR RETAINING WALLS. 2/SUPPLY AND INSTALL A DESIGNABULD IRRIGATION SYSTEM FOR ALL LANDSCAPED AREAS, CONTRACTOR TO PROVIDE CAD SHOP DRAWINGS AND ALL PRODUCT LITERATURE SUBMITTALS PRIOR TO FINAL APPROVAL. AS-SUILT DRAWINGS, MANUALS, JAND, WARRANTIES SHALL DE PROVIDED TO THE OWNER UPON PROJECT

MANUALS, AND, WARRANTIES SHALL BE PROVIDED TO THE OWNER UPON PROJECT COMPLETION.

STHE OWNER IS RESPONSIBLE FOR ALL ON-GOING MAINTENANCE OF LANDSCAPING ON THE SITE. ALL PLANTING BEDS SHALL BE KEPT FREE OF WEEDS, ANY PLANT MATERIAL THAT HAS DIED SHALL BE REPLACED NO LATER THAN THE UPCOMING JUNE 1. ANY PLANT MATERIAL THAT THAS DIED SHALL BE REPLACED BY THE REST YEAR WARRANTLY PERIOD SHALL BE REPLACED BY THE LANDSCAPE CONTRACTOR AT NO ADDITIONAL COST.

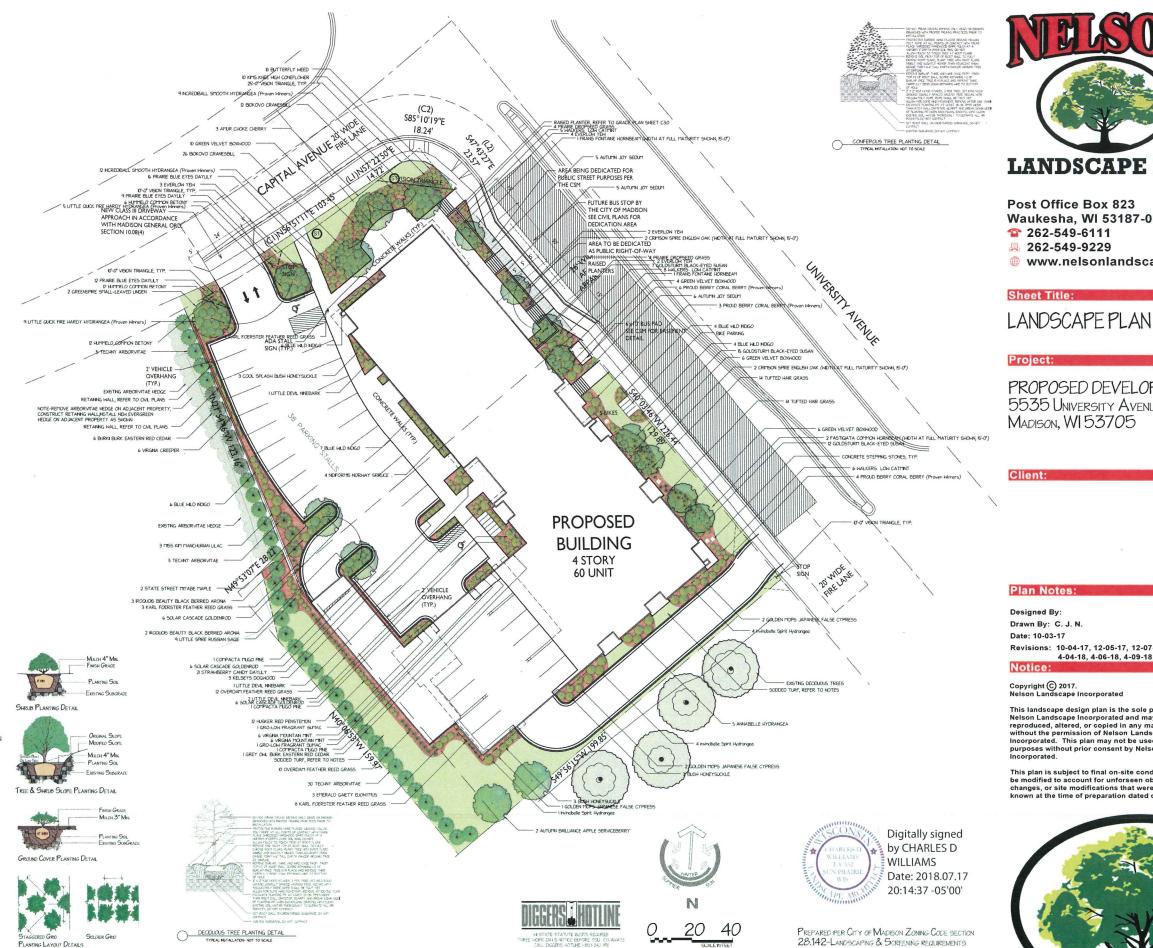

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PROPOSED DEVELOPMENT

Revisions: 10-04-17, 12-05-17, 12-07-17, 12-11-17, 4-04-18, 4-06-18, 4-09-18, 7-17-18

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This plan is subject to final on-site conditions and may be modified to account for unforseen obstacles, other changes, or site modifications that were not made

known at the time of preparation dated on this plan

5535 UNIVERSITY AVENUE

MADISON, WI 53705

Post Office Box 823

262-549-6111

262-549-9229

Sheet Title:

Project:


Designed By

Date: 10-03-17

Drawn By: C. J. N.

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Waukesha, WI 53187-0823



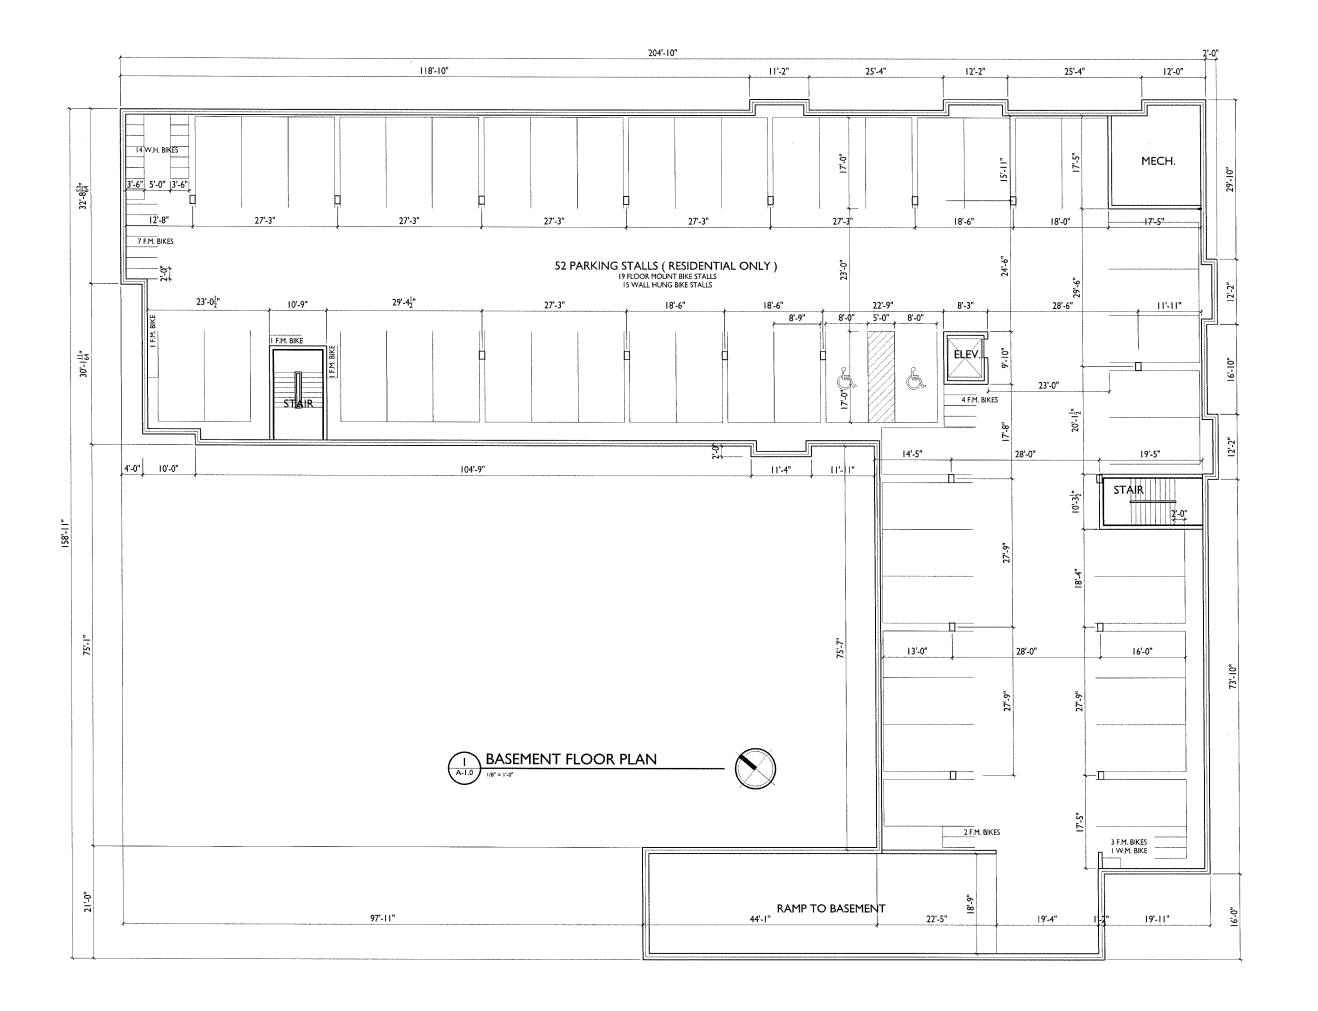

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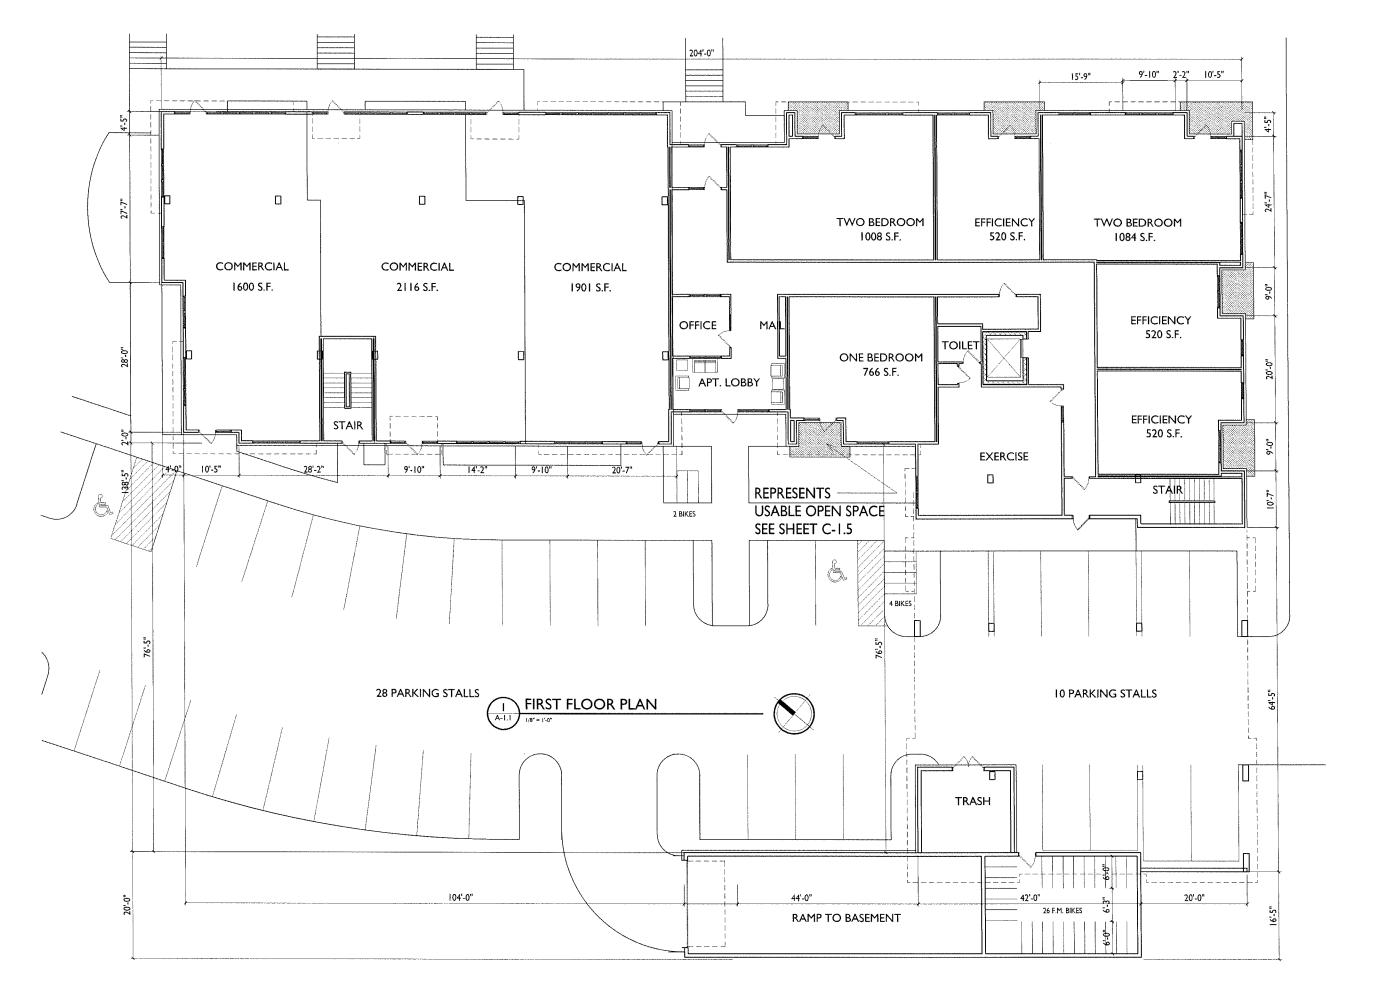
PROJECT TITLE
Mixed-Use Development

5535 University Ave. Madison, WI

Basement Floor Plan

SHEET NUMBER

PROJECT NO. 1735 Ø Knothe & Bruce Architects, LLC





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PROJECT TITLE
Mixed-Use
Development


5535 University Ave.
Madison, WI
SHEET TITLE

First Floor Plan

SHEET NUMBER

A-I.

PROJECT NO. 1735

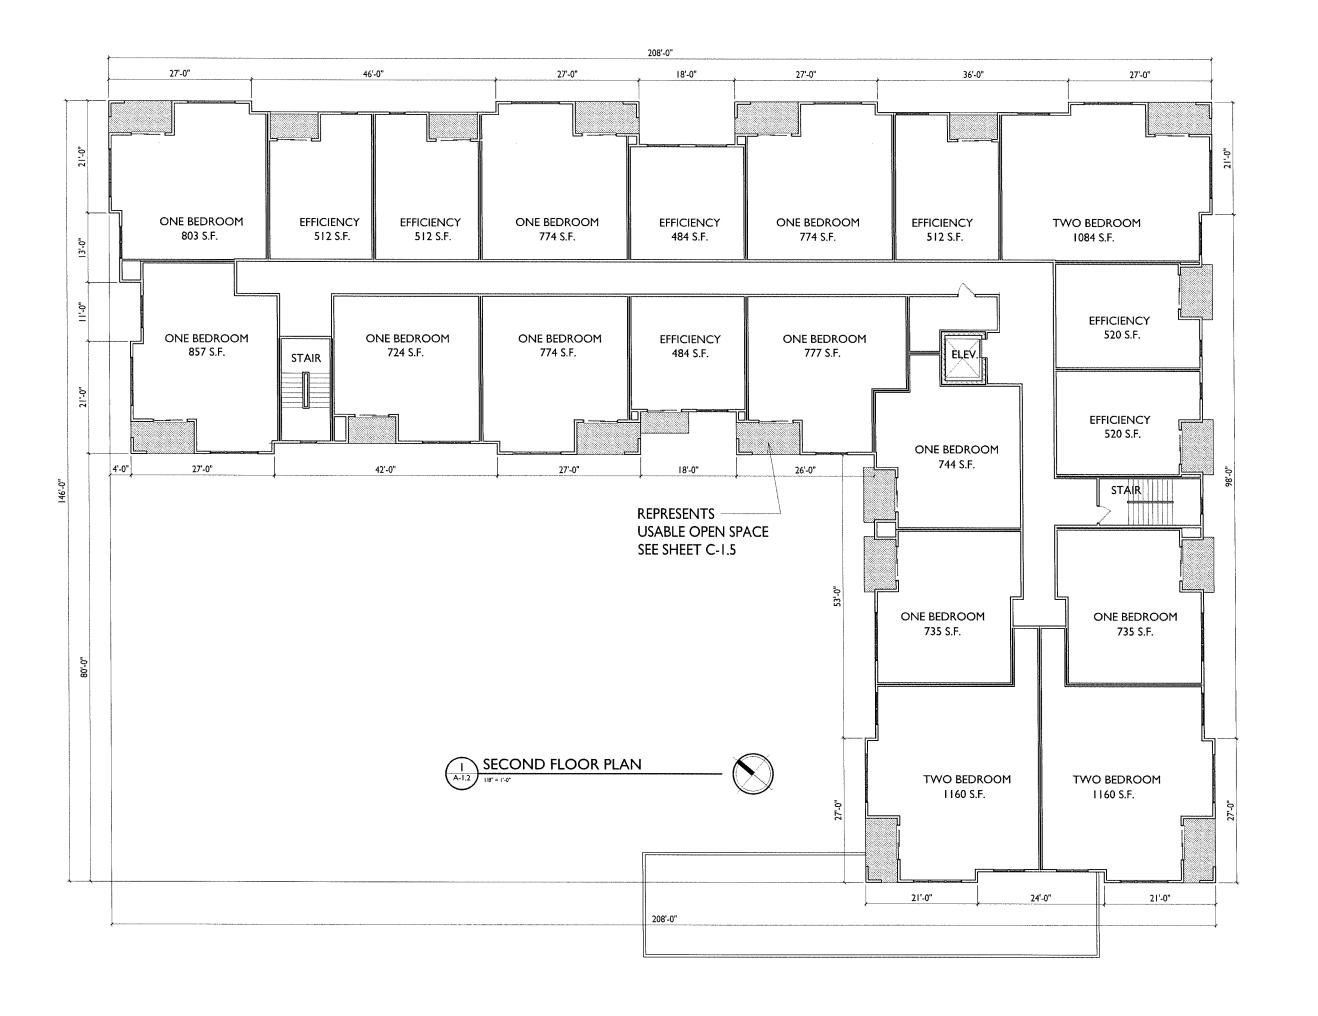



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Issued for Land Use Supplement - Nov. 2, 2018

PROJECT TITLE
Mixed-Use
Development

5535 University Ave.

Madison, WI

SHEET TITLE


Second Floor Plan

SHEET NUMBER

A-1.2

PROJECT NO. 1735

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PROJECT TITLE
Mixed-Use
Development

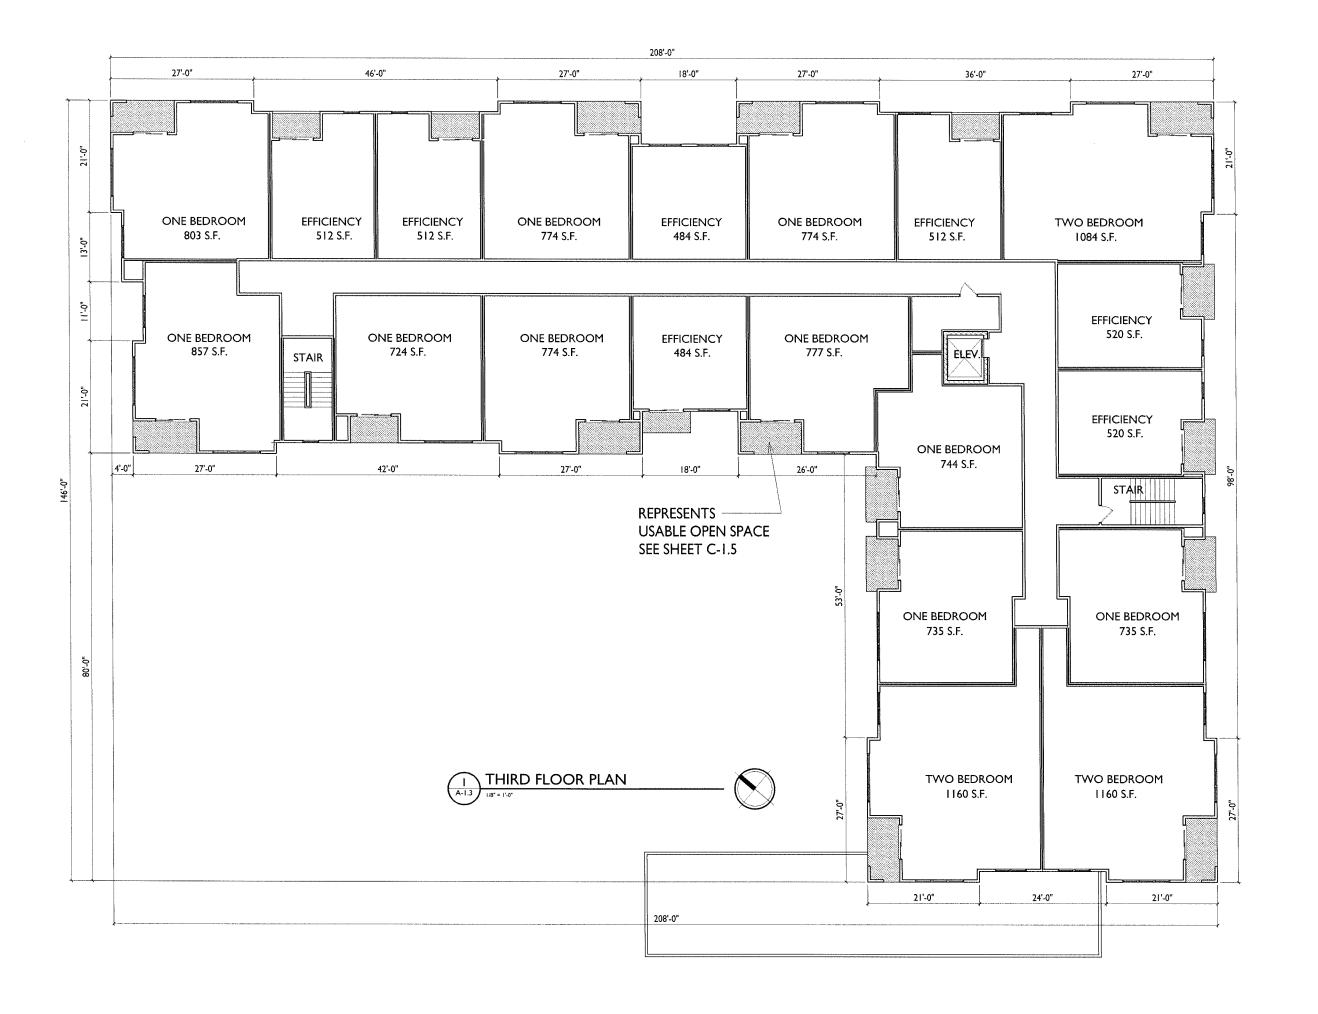5535 University Ave. Madison, WI SHEET TITLE


Third Floor Plan

SHEET NUMBER

A-1.3

PROJECT NO. 1735

Sknothe & Bruce Architects, LLC

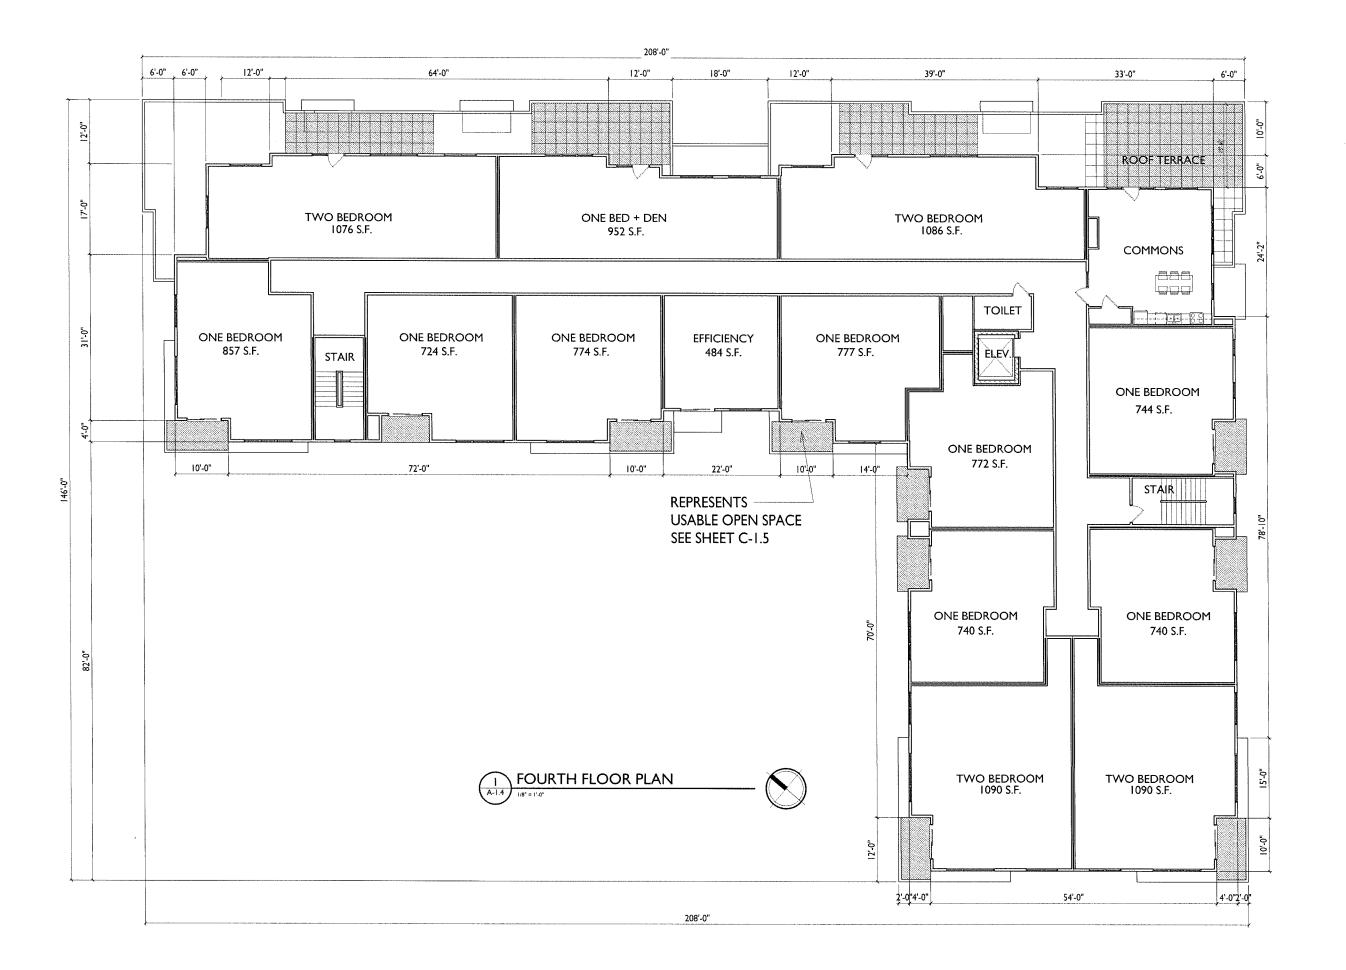



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PROJECT TITLE
Mixed-Use
Development

5535 University Ave. Madison, WI SHEET TITLE

Fourth Floor Plan

SHEET NUMBER

A-1.4

PROJECT NO. 1735



NORTH ELEVATION - ALONG UNIVERSITY AVE.



SOUTH ELEVATION



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PROJECT TITLE

SHEET TITLE

Exterior Elevations

SHEET NUMBER

A-2.1

PROJECT NUMBER 1735

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EAST ELEVATION



WEST ELEVATION - ALONG CAPITAL AVE.



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PROJECT TITLE

SHEET TITLE

Exterior Elevations

SHEET NUMBER

A-2.2

PROJECT NUMBER 1735

© 2015 Knothe & Bruce Architects, LLC

Exterior Material Set

- 1 BALCONY Metal-SW7026 GRIFFIN
- 2 BRICK VENEER METAL-SW7026 GRIFFIN
- 3 PRECAST ROCKFAST-WHEATSTONE
- 4 HORIZONTAL SIDING & TRIM COMPOSITE-MED CHARCOAL
- 5 HORIZONATAL SIDING & TRIM @ BAYS COMPOSITE-CEDAR
- 6 WINDOWS ANDERSON-CANVAS
- 7 RAILING ALUMINUM-DARK BRONZE
- 9 BUILDING ENTRANCES ALUMINUM STOREFRONT-ARCTIS SILVER



EAST ELEVATION



WEST ELEVATION - ALONG CAPITAL AVE.



ISSUED Issued for Land Use and UDC -2018

Issued for Planning + UDC - Supplement 9-21-2018

PROJECT TITLE

SHEET TITLE
Exterior
Elevations

SHEET NUMBER

A-2.3

PROJECT NUMBER 1735

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Exterior Material Set

- 1 BALCONY Metal-SW7026 GRIFFIN
- 2 BRICK VENEER METAL-SW7026 GRIFFIN
- 3 PRECAST ROCKFAST-WHEATSTONE
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- 6 WINDOWS ANDERSON-CANVAS
- 7 RAILING ALUMINUM-DARK BRONZE
- 9 BUILDING ENTRANCES ALUMINUM STOREFRONT-ARCTIS SILVER





ISSUED

Issued for Land Use and UDC -September 5, 2018

PROJECT TITLE

NORTH ELEVATION - ALONG UNIVERSITY AVE.



SHEET TITLE


Exterior Elevations

SHEET NUMBER


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PROJECT NUMBER 1735
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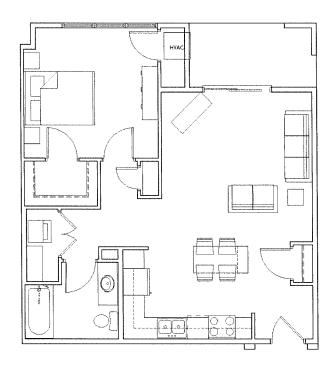






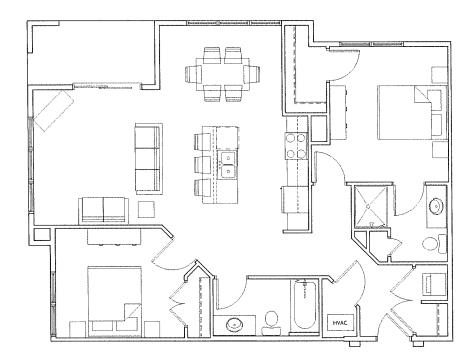

EFFICIENCY 520 S.F.

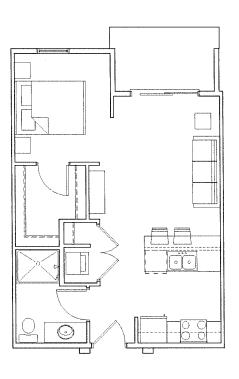

ONE BEDROOM 766 S.F.

ISSUED Issued for Land Use & UDC - September 5, 2018

PROJECT TITLE
Mixed-Use Development

5535 University Ave.
Madison, WI
SHEET TITLE
Typical Unit Plans

SHEET NUMBER

1735






















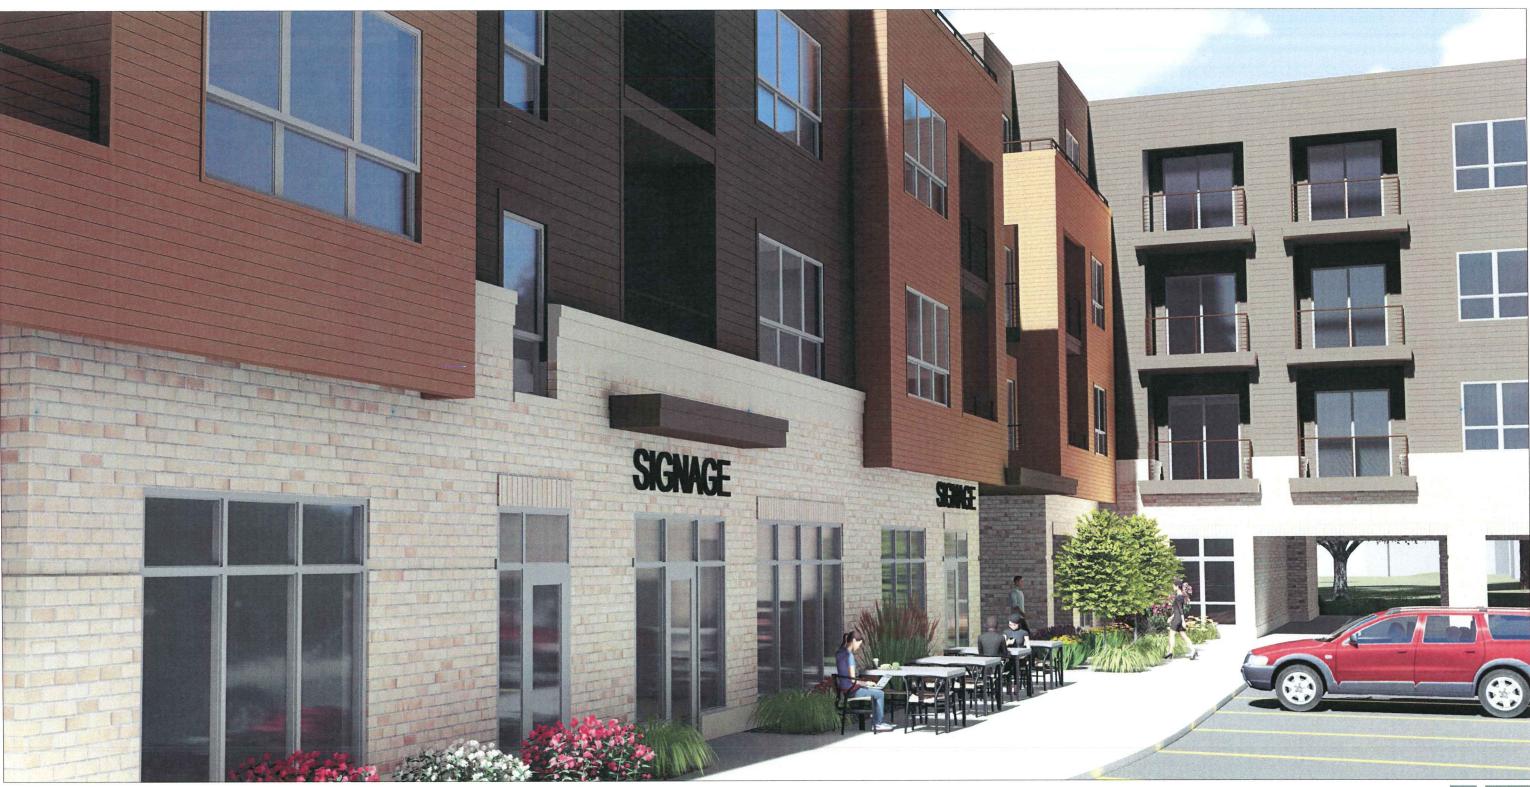








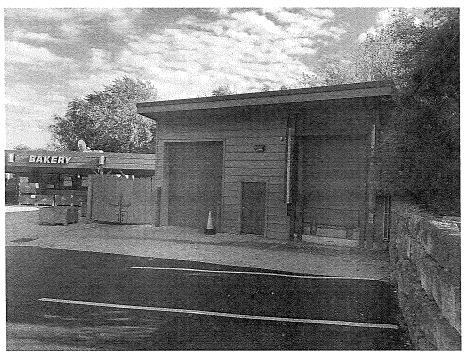

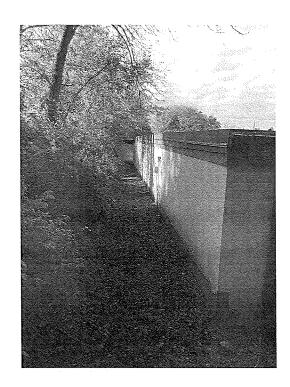

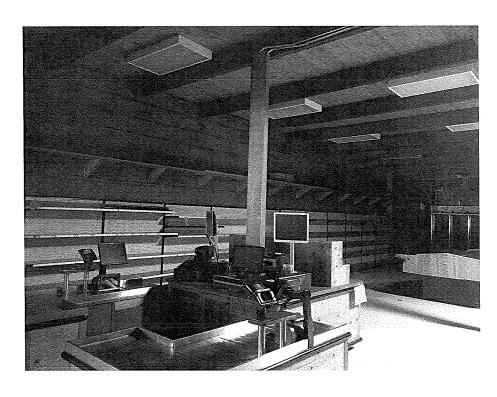

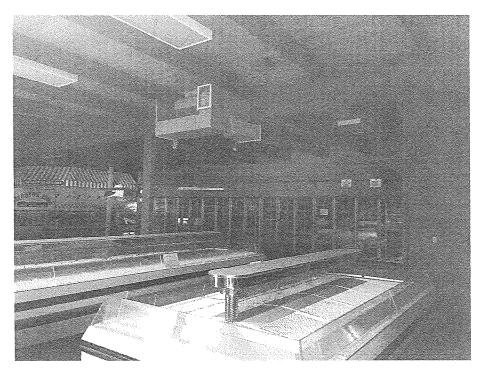

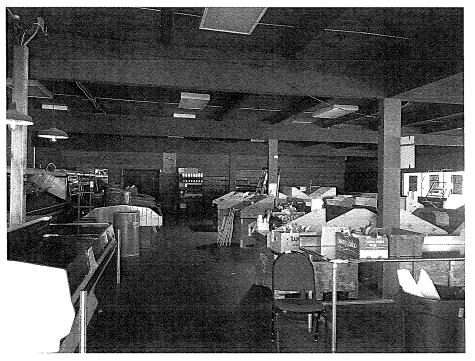

Demo Photos 5533 University Ave. October 10, 2017

