# **URBAN DESIGN COMMISSION APPLICATION**



City of Madison Planning Division 215 Martin Luther King Jr. Blvd. P.O. Box 2985 Madison, WI 53701-2985



FOR OFFICE USE ONLY:				
Paid	Receipt #			
Date received				
Received by				
Aldermanic District				
Zoning District				
Urban Design District				
Submittal reviewed by	'			

	(608	3)200-4035		MISCONSIN	Alderm	,	rict	
1.	If you form pleas	u need an interpreto ats or other accom se call the phone nu	date and the a er, translator, ma modations to acc umber above imn	terials in alternate sess these forms,	Zoning Urban I	Design Di		
	Title		miley street					
2.		lication Type (c meeting date re New developme Informational	equested _ ent 🖾	pply) and Requested Da Nov 21, 2018 Alteration to an existing of Initial approval	or previo	ously-app Final app	·	
3.	Proj	ect Type						
		Mixed-Use District Project in the Sul Campus Instituti District (EC) Planned Develop General Develop Specific Imp Planned Multi-U	wntown Core D t (UMX), or Mixe burban Employr onal District (CI oment (PD) velopment Plan olementation Pl se Site or Resid	istrict (DC), Urban d-Use Center District (MXC) ment Center District (SEC), ), or Employment Campus  (GDP) an (SIP) ential Building Complex	Sign	Comprei Signage area, ar	hensive Design Review (CDR) Variance (i.e. modification of signage height, nd setback) pecify	
4.				wner Information			DO Development III O	
	Stre Tele <b>Proj</b> Stre Tele	et address phone	7601 Unive (608) 836-3	ail Drive  12  nroeder  rsity Ave., Suite 201  3690	_ City/St _ Email _ Compa _ City/St _ Email	carl@r carl@r any Kno ate/Zip dschro	DC Development, LLC  Madison, WI 53704  ruedebusch.com  othe & Bruce Architects, LLC  Middleton, WI 53562  oeder@knothebruce.com	
		et address						
	Tele	phone			_ Email			

#### 5. Required Submittal Materials

- Application Form
- Letter of Intent
  - If the project is within an Urban Design District, a summary of how the development proposal addresses the district criteria is required
  - For signage applications, a summary of how the proposed signage is consistent with the applicable CDR or Signage Variance review criteria is required.
- **Development plans** (Refer to checklist provided below for plan details)
- ☐ Filing fee

#### ☑ Electronic Submittal\*

Each submittal must include fourteen (14) 11" x 17" collated paper copies. Landscape and Lighting plans (if required) must be full-sized. Please refrain from using plastic covers or spiral binding.

Both the paper copies and electronic copies <u>must</u> be submitted prior to the application deadline before an application will be scheduled for a UDC meeting. Late materials will not be accepted. A completed application form is required for each UDC appearance.

For projects also requiring Plan Commission approval, applicants must also have submitted an accepted application for Plan Commission consideration prior to obtaining any formal action (initial or final approval) from the UDC. All plans must be legible when reduced.

\*Electronic copies of all items submitted in hard copy are required. Individual PDF files of each item submitted should be compiled on a CD or flash drive, or submitted via email to <a href="mailto:udcapplications@cityofmadison.com">udcapplications@cityofmadison.com</a>. The email must include the project address, project name, and applicant name. Electronic submittals via file hosting services (such as Dropbox.com) are not allowed. Applicants who are unable to provide the materials electronically should contact the Planning Division at (608) 266-4635 for assistance.

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- 1. Prior to submitting this application, the applicant is required to discuss the proposed project with Urban Design Commission staff. This application was discussed with DAT Meeting on 8-29-2018
- 2. The applicant attests that all required materials are included in this submittal and understands that if any required information is not provided by the application deadline, the application will not be placed on an Urban Design Commission agenda for consideration.

Applicant name Carl Ruedebusch

Authorized signature of Property Owner

Authorized Signature of Property Owner

Date 11/6/2018

#### 7. Application Filing Fees

Fees are required to be paid with the first application for either initial or final approval of a project, unless the project is part of the combined application process involving the Urban Design Commission in conjunction with Plan Commission and/or Common Council consideration. Make checks payable to City Treasurer. Credit cards may be used for application fees of less than \$1,000.

Please consult the schedule below for the appropriate fee for your request:

- ☐ Urban Design Districts: \$350 (per §35.24(6) MGO).
- ☐ Minor Alteration in the Downtown Core District (DC) or Urban Mixed-Use District (UMX) : \$150 (per §33.24(6)(b) MGO)
- ☐ Comprehensive Design Review: \$500 (per §31.041(3)(d)(1)(a) MGO)
- ☐ Minor Alteration to a Comprehensive Sign Plan: \$100 (per §31.041(3)(d)(1)(c) MGO)
- ☐ All other sign requests to the Urban Design Commission, including, but not limited to: appeals from the decisions of the Zoning Administrator, requests for signage variances (i.e. modifications of signage height, area, and setback), and additional sign code approvals: \$300 (per §31.041(3)(d)(2) MGO)

A filing fee is not required for the following project applications if part of the combined application process involving both Urban Design Commission and Plan Commission:

- Project in the Downtown Core District (DC), Urban
   Mixed-Use District (UMX), or Mixed-Use Center District (MXC)
- Project in the Suburban Employment Center District (SEC), Campus Institutional District (CI), or Employment Campus District (EC)
- Planned Development (PD): General Development
   Plan (GDP) and/or Specific Implementation Plan (SIP)
- Planned Multi-Use Site or Residential Building Complex

### **URBAN DESIGN COMMISSION APPROVAL PROCESS**



#### Introduction

The City of Madison's Urban Design Commission (UDC) has been created to:

- Encourage and promote high quality in the design of new buildings, developments, remodeling, and additions so as to maintain and improve the established standards of property values within the City.
- Foster civic pride in the beauty and nobler assets of the City, and in all other ways possible assure a functionally efficient and visually attractive City in the future.

#### **Types of Approvals**

There are three types of requests considered by the UDC:

- <u>Informational Presentation</u>. Applicants may, at their discretion, request to make an Informational Presentation to the UDC prior to seeking any approvals to obtain early feedback and direction before undertaking detailed design. Applicants should provide details on the context of the site, design concept, site and building plans, and other relevant information to help the UDC understand the proposal and provide feedback. (Does not apply to CDR's or Signage Variance requests)
- <u>Initial Approval</u>. Applicants may, at their discretion, request initial approval of a proposal by presenting preliminary design information. As part of their review, the Commission will provide feedback on the design information what should be addressed at Final Approval stage.
- <u>Final Approval</u>. Applicants may request Final Approval of a proposal by presenting all final project details. Recommendations or concerns expressed by the UDC in the initial approval must be addressed at this time.

#### **Presentations to the Commission**

Primarily, the UDC is interested in the appearance and design quality of projects. Emphasis should be given to the site plan, landscape plan, lighting plan, building elevations, exterior building materials, color scheme, and graphics.

When presenting projects to the UDC, applicants must fill out a registration slip provided in the meeting room and present it to the Secretary. Presentations should generally be limited to 5 minutes or as extended by motion by consent of the Commission. The Commission will withhold questions until the end of the presentation.

Applicants are encouraged to consider the use of various graphic presentation material including a locator map, photographs, renderings/model, scale drawings of the proposal in context with adjacent buildings/uses/signs, etc., as may be deemed appropriate to describe the project and its surroundings. Graphics should be mounted on rigid boards so that they may be easily displayed. Applicants/presenters are responsible for all presentation materials, AV equipment and easels.

# **URBAN DESIGN DEVELOPMENT PLANS CHECKLIST**



The items listed below are minimal application requirements for the type of approval indicated. Please note that the UDC and/or staff may require additional information in order to have a complete understanding of the project.

1. Informa	itional Presentation			Requirements for All Plan Sheets			
	Locator Map	١		1. Title block			
	Letter of Intent (If the project is within a			2. Sheet number			
	Urban Design District, a summary of how			3. North arrow			
	the development proposal addresses the district criteria is required)	_	Providing additional information beyond these	4. Scale, both written and graphic			
	Contextual site information, including	Ì	minimums may generate	5. Date			
	photographs and layout of adjacent		a greater level of feedback	6. Fully dimensioned plans, scaled			
	buildings/structures		from the Commission.	at 1"= 40' or larger			
	Site Plan			** All plans must be legible, including			
	Two-dimensional (2D) images of			the full-sized landscape and lighting plans (if required)			
	proposed buildings or structures.			plans (ij requirea)			
2. Initial A	pproval						
X	Locator Map			)			
X	Letter of Intent (If the project is within a L how the development proposal addresses		•	·			
X	Contextual site information, including phobuildings/structures	oto	ographs and layout of adjace	Providing additional information beyond these			
X	Site Plan showing location of existing and lanes, bike parking, and existing trees ove						
X	Landscape Plan and Plant List ( <i>must be leg</i>			from the Commission.			
×	Building Elevations in both black & white a material callouts)	ar	nd color for all building sides	(include			
	PD text and Letter of Intent (if applicable)	,					
3. Final Ap	proval						
All the r	equirements of the Initial Approval (see abo	οv	re), <b>plus</b> :				
X	Grading Plan						
	Proposed Signage (if applicable)						
X	Lighting Plan, including fixture cut sheets	aı	nd photometrics plan (must i	be legible)			
	Utility/HVAC equipment location and scre	e	ning details (with a rooftop p	plan if roof-mounted)			
X	PD text and Letter of Intent (if applicable)						
X	Samples of the exterior building materials	5 (	presented at the UDC meeti	ng)			
4. Compre	hensive Design Review (CDR) and Varian	C	e Requests ( <i>Signage applic</i>	ations only)			
	Locator Map						
	Letter of Intent (a summary of <u>how</u> the pris required)	0	posed signage is consistent v	with the CDR or Signage Variance criteria			
	Contextual site information, including phoproject site	oto	ographs of existing signage b	ooth on site and within proximity to the			
	Site Plan showing the location of existing sidewalks, driveways, and right-of-ways	si	gnage and proposed signage	, dimensioned signage setbacks,			
	Proposed signage graphics (fully dimensic	n	ed, scaled drawings, includir	ng materials and colors, and night view)			

☐ Graphic of the proposed signage as it relates to what the Ch. 31, MGO would permit

Ms. Heather Stouder
Department of Planning & Development
City of Madison
126 S. Hamilton Street
PO Box 2985
Madison, Wisconsin 53701

Re: Letter of Intent – Conditional Use Application 515 Pinney Street

KBA Project # 1852

Ms. Heather Stouder:

The following is submitted together with the plans and application for staff, Plan Commission consideration of approval.

Owner: RDC Development, LLC Architect: Knothe & Bruce Architects, LLC

4605 Dovetail Drive 7601 University Ave., Ste 201 Madison, WI 53704 Middleton, WI 53562

(608) 249-2012 (608) 836-3690

Contact: Dave Nelsen

Contact: Don Schroeder

dschroeder@knothebruce.com

Engineer: Quam Engineering, LLC Landscape The Bruce Company

 44604 Siggelkow Rd, Ste A
 Design:
 2830 Parmenter St.

 McFarland, WI 53558
 P.O. Box 620330

 (608) 838-7750
 Middleton, WI 53562

 Contact: Ryan Quam
 (608) 836-7041

rquam@quamengineering.com (608) 836-7041

Contact: Rich Strohmenger

rstrohmenger@brucecompany.com

#### **Introduction:**

This proposal is a modification of a Conditional Use that was approved on December 16, 2013 that proposed two apartment buildings containing 80 units over a single underground parking garage. Although the Conditional Use was approved the project was never constructed and the owner has decided to prepare for a Spring 2019 construction start.

This proposal modifies the previously approved plan resulting in a unit count of 88 units. The building footprint (including the parking garage) has been reduced in size and the two above grade buildings have been connected providing a more efficient construction. The changes to the unit mix and count are summarized in the table below and indicate that although the unit count is increased, the bedroom count and the anticipated resident count is virtually identical to the originally approved plan. For these reasons we do not feel that the density of the project has changed in any material way from the originally approved plan.

In addition to the building changes, additional parking is added to the site plan on the east side of the building in response to concerns from the Library and nearby homeowners regarding adequate available parking.

Letter of Intent – Application for Conditional Use 515 Pinney Street – Lot of CSM 14166 – Royster Crossings September 19, 2018 Page 2 of 3

The Royster Clark site was formerly occupied by a fertilizing manufacturing plant and was rezoned on May 24, 2013, from "A" to "TR-U2." The Royster-Clark Special Area Plan has guided the development of the overall site and construction of a mix of single-family housing, affordable multifamily housing, and a mixed-use development with multifamily housing over commercial space, including the new Pinney Library, has been completed or underway. This proposal will continue the implementation of the special area plan.

#### **Project Description:**

The proposed site is located at the southeast corner of Pinney Street and Royster Oaks Drive. The site plan was designed to provide an integrated medium-density housing environment and provide for a variety of vehicular and pedestrian connections to the surrounding public and private streets. The newly constructed building forms an articulated street edge and rear courtyard space. Individual apartment entries with generous porches are emphasized on the street façades.

The apartment building is three stories in height with underground vehicle and bike parking. Additional surface parking is provided to the east and the private drive on the south portion of the site. The buildings have been designed to fit within the neighborhood context and use a palette of attractive, low-maintenance exterior materials including masonry, horizontal composite siding and asphalt shingles. The building includes elevator access encouraging a wider age range of residents.

Site [	Development Data:	Previously Approved	<b>Proposed</b>
Densi	ties:		•
	Lot Area		80,462 sf
	Acres		1.84
	Dwelling Units	80 units	88 units
	Lot Area/D.U.		914.3 sf/unit
	Density		47.8 units/acre
Dwell	ing Unit Mix:		
	Efficiency	6	7
	One Bedroom	48	59
	One Bedroom + Den	0	6
	Two Bedroom	<u> 26</u>	<u>16</u>
	Total Dwelling Units	80	88
	Total Bedrooms	106	104
Buildir	ng Height:	3 Stories	3 stories
Floor	Area:		
	Building Footprint	33,846 sf	30,062 sf
	Gross Floor Area (Excludes Underground parking)	85,162 sf	88,606 sf

Letter of Intent – Application for Conditional Use 515 Pinney Street – Lot of CSM 14166 – Royster Crossings September 19, 2018 Page 3 of 3

Ve	hic	le	Par	king	Stall	s

23	43
<u>81</u>	<u>81</u>
104	124
	81

Parking Ratio I.3 stalls/unit I.4 stall/unit

#### Bicycle Parking Stalls

Surface	8	8
Surface Guest	8	9 (10% of 88 units)
<u>Underground</u>	74 (54 @ 2'x6')	<u>80</u>
Total	90 (88 required)	97 (97 required)

#### Usable Open Space

Ground Level	13,762 sf
Balconies & Porches	<u>6,549 sf</u>
Total	20,311 sf (230 sf / unit)

<u>Lot Coverage</u> 57,561 sf (71.5%)

#### **Project Schedule:**


It is currently anticipated that construction will begin once the development approvals are in place in the Spring of 2019 and is anticipated to be completed in Fall of 2020.

Thank you for your time reviewing our proposal.

Sincerely,

Don Schroeder, AIA

Partner

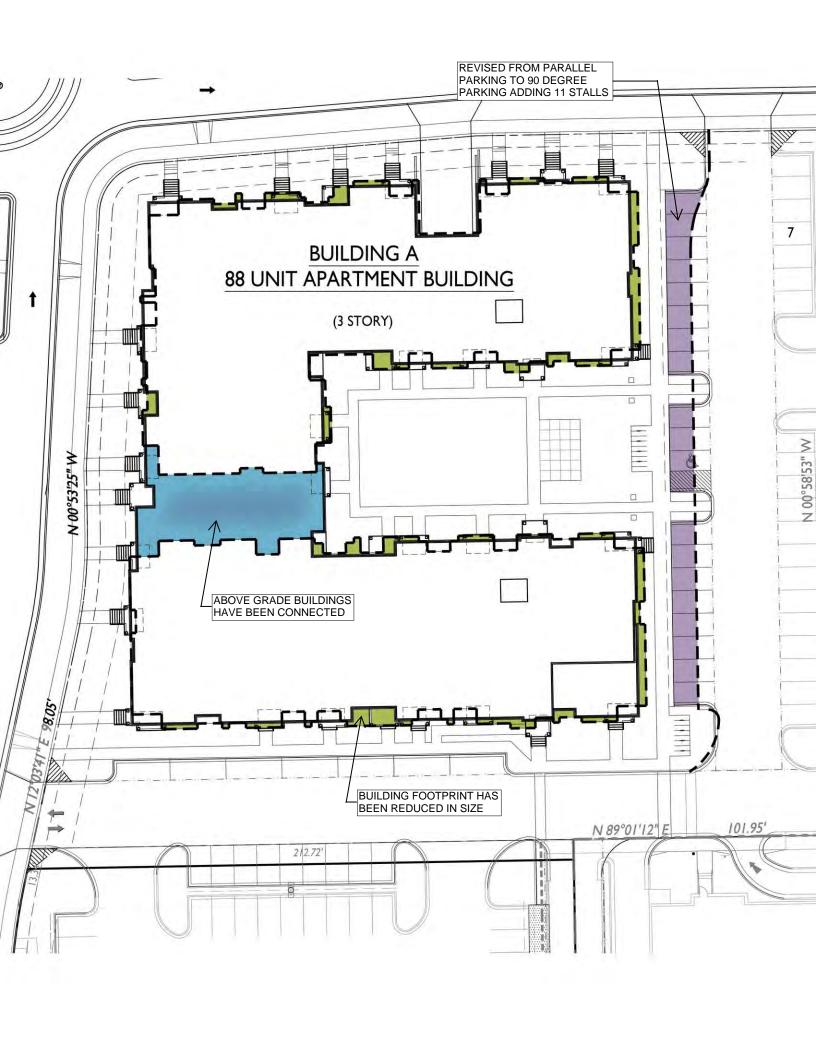

# **VSX** LED Specifications



Project Name:		
515 Pinney Street		

Catalog Number:

Type:

The VSX LED Series offers clean, functional styling that is defined by its sleek low profile design and rugged construction. It combines LED performance and advanced LED thermal management technology and provides outdoor lighting that is both energy efficient and aesthetically pleasing.

The LED's performance and the driver's life are maximized by enclosing them in two separate cast aluminum housings. Easy captive screw access for mounting and maintenance.

The LED light assemblies come with 16 to 48 LEDs. Seven optical distribution patterns are available. Choose between 3000, 4000 or 5000 Kelvin temperature of the LEDs.

A durable polyester powder coat finish is guaranteed for five years; and is available in standard or custom colors

The VSX LED series is an exceptional choice for commercial parking lots, office complexes, architectural projects, and other general lighting projects.

#### **Ordering Information**

MODEL	OPTICS	LEDs	CURRENT	KELVIN	VOLTAGE	MOUNTING	FINISH	OPTIONS	OPTIONS
VSX-1	T1 T2 T3 T4 T4A T5 T5W	16LC 32LC 48LC	3 350mA 5 530mA 7 700mA 10 1050mA	3K 3000K 4K 4000K 5K 5000K	UNV 120,277V  8 347V  5 4BOV	AM Arm Mount WM Wall Mount *Requires BAWP  Round Pole Plate Adaptors (RPP) are to be ordered separately.  BAWP to be ordered separately.	BZ Bronze BK Black SBK Smooth Black WH White SWH Smooth White GP Graphite GY Grey SL Silver Metallic CC Custom Color	PCR-120 Photocell & Receptacle PCR-208 Protocell & Receptacle PCR-240 Photocell & Receptacle PCR-240 Photocell & Receptacle PCR-277 Photocell & Receptacle PCR-480 Protocell & Receptacle PCR-480 PTPR-PTPR-8 PTPR-PTPR-8 PTPR-PTPR-8 PTPR-PTPR-PTPR-PTPR-PTPR-PTPR-PTPR-PTPR	RPP3 For 3"0 Pole - Round Pole Plate Adaptor RPP4 For 4"0 Pole - Round Pole Plate Adaptor RPP5 For 5"0 Pole - Round Pole Plate Adaptor RPP5 For 5"0 Pole - Round Pole Plate Adaptor RPP5 For 5"0 Pole - Round Pole Plate Adaptor RPP5 For 5"0 Pole - Round Pole Plate Adaptor RPP5 For 5"0 Pole - Round Pole Plate Adaptor RPP5 For 5"0 Pole - Round Pole Plate Adaptor RPP5 For State Registration RPP5 For State RPP5 For State RPP5 For State RPP5 For State Coptes Loft State Cutoff Lower Shield LCLS Loft Side Cutoff Lower Shield

# Features & Specifications



#### Housing

· Cast aluminum LED housing with integral cooling fins for thermal management.

#### **Mounting Arm/Driver Compartment**

•Durable two-piece cast aluminum driver compartment utilizes a captive screw for ease of maintenance and sealed with a one-piece silicone gasket.

#### **Thermal Management**

- The VSX series provides excellent thermal management by mounting the LEDs to the substantial heat sink of the housing. This enables the Luminaire to withstand higher ambient temperatures and driver currents without degrading LED life.
- The L70 test determines the point in an LEDs life when it reaches 70 percent of its initial output. The VSX series LEDs have been determined to last 100,000+ hours in 25° C environments when driven at 350 mA.

#### **Optical System**

- $\cdot$  The highest lumen output LEDs are utilized in the VSX series. IES distribution Types I, II, III, IV, IV-A , V and V-W are available. The optical system qualifies as IES full cutoff to restrict light trespass, glare and light pollution.
- · CRI values are 70.

#### Quali-Guard® Finish

- The finish is a Quali-Guard® textured, chemically pretreated through a multiple-stage washer, electrostatically applied, thermoset polyester powder coat finish, with a minimum of 3-5 millimeter thickness. Finish is oven-baked at 400° F to promote maximum adherence and finish hardness. All finishes are available in standard and custom colors.
- · Finish is guaranteed for five (5) years.

#### **Electrical Assembly**

- The VSX LED series is supplied with a choice of 350, 530, 700 or 1000 mA high-performance LED drivers that accept 120v thru 480v, 50 Hz to 60 Hz, input. Power factor of 90%. Rated for -40°C operations.
- · 10 kV surge protector supplied as standard.
- · Terminal block supplied as standard.

#### Warranty

• Five (5) year Limited Warranty on entire system, including finish. For full warranty information, please visit visionairelighting.com.

#### **Options**

- · Photocell & receptacle
- · Photo receptacle
- · 0-10v Dimming Driver
- · Motion Sensor
- · Wireless Control
- · Round pole plate adapter
- · Universal Pole Mount Adaptor
- · Cast Wall Plate
- · Cut-Off Louver Shield
- · Rotated Optics

#### Listings

- · The VSX Series is cUL Listed
- · DLC Listed
- · IP65 Rated
- · IDA Certification
- · Powder Coated Tough













DesignLights Consortium (DLC) qualified Product. Some configurations of this product family may not be DesignLights Consortium (DLC) listed, please refer to the DLC qualified products list to confirm listed configurations. http://www.designlights.org/3000K must be selected for IDA certification.

For more detailed information on mounting, wiring or installation instructions, please consult factory. If poles are not ordered with fixtures, please specify mounting requirements. This document contains proprietary information of Visionaire Lighting, LLC. In keeping with our TQM policy of continuous improvement, Visionaire reserves the right to change any specifications contained herein without prior notice.

# **VSX** LED Specifications

#### **Photometric Optical Summary**

Not all optics are available on all fixtures. Check ordering chart for availability

Type I **(T1)** 





























VSX EPA Data					
Front	Side				
.45	.58				

#### **Dimensions**

Width:	VSX-1	12.5"
Depth:	VSX-1	23"
Height:	VSX-1	4"
Overall Height:	VSX-1	8"
Weight:	25 LBS	3

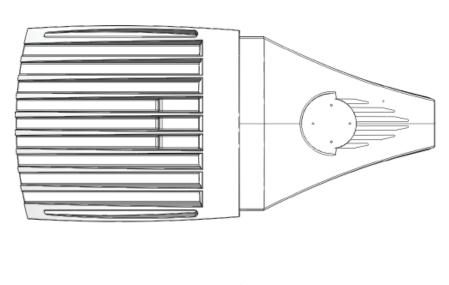

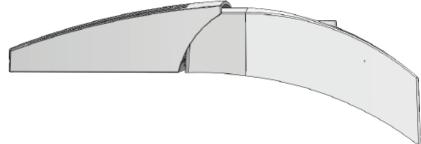



				VSX 3	K Lumen D	ata				
#LED's	mA	Type 1	Type 2	Type 3	Type 4	Type 4A	Type 5	Type 5W	Type 5WR	Watts
16	350	2413	2220	2238	2190	2422	2359	2231	2187	18
	530	3237	2978	3002	2938	3249	3165	2993	2935	26
	700	4273	3931	3963	3878	4289	4177	3950	3874	37
	1050	6049	5565	5610	5490	6071	5913	5592	5484	56
32	350	4859	4470	4506	4410	4876	4750	4492	4405	37
	530	6519	5997	6046	5917	6543	6373	6026	5910	52
	700	8604	7916	7980	7810	8636	8412	7955	7801	74
	1050	12097	11130	11219	10980	12141	11826	11184	10967	112
48	350	7288	6705	6759	6615	7315	7125	6738	6607	55
	530	9778	8996	9069	8875	9814	9559	9040	8865	78
	700	12906	11874	11970	11715	12954	12617	11932	11701	105
	1050	18146	16694	16829	16470	18212	17739	16775	16451	160
				VSX 4	K Lumen D	ata				
#LED's	mA	Type 1	Type 2	Туре 3	Type 4	Type 4A	Type 5	Type 5W	Type 5WR	Watts
16	350	2540	2337	2355	2305	2549	2483	2348	2320	18
	530	3408	3135	3160	3093	3420	3331	3150	3113	26
	700	4498	4138	4171	4082	4514	4397	4158	4109	37
	1050	6367	5858	5905	5779	6390	6224	5886	5816	56
32	350	5114	4705	4743	4642	5133	5000	4728	4672	37
	530	6862	6313	6364	6228	6887	6708	6344	6268	52
	700	9057	8333	8400	8221	9090	8854	8373	8273	74
	1050	12734	11715	11810	11558	12781	12448	11772	11632	112
48	350	7671	7058	7115	6963	7700	7500	7092	7008	55
	530	10293	9470	9546	9342	10331	10062	9516	9402	78
	700	13586	12499	12600	12331	13636	13281	12560	12410	105
	1050	19101	17573	17715	17337	19171	18673	17658	17448	160
				VSX 5	K Lumen D	ata				
#LED's	mA	Type 1	Type 2	Type 3	Type 4	Type 4A	Type 5	Type 5W	Type 5WR	Watts
16	350	2437	2242	2260	2212	2446	2383	2253	2210	18
	530	3270	3008	3033	2968	3282	3197	3023	2965	26
	700	4316	3971	4003	3918	4332	4219	3990	3913	37
	1050	6110	5621	5666	5545	6132	5973	5648	5539	56
32	350	4908	4515	4552	4454	4926	4798	4537	4449	37
	530	6585	6058	6107	5977	6609	6437	6087	5970	52
	700	8691	7996	8061	7889	8723	8496	8035	7880	74
	1050	12219	11242	11333	11091	12264	11945	11297	11078	112
48	350	7362	6773	6827	6682	7389	7197	6806	6674	55
	530	9877	9087	9160	8965	9913	9656	9131	8954	78
	700	13037	11994	12091	11833	13085	12745	12052	11819	105
	1050	18329	16863	16999	16636	18396	17918	16945	16617	160

Lumen values are from photometric tests performed in accordance with IESNA LM-79-08. Data is considered to be representative of the configuration shown, within the tolerances allowed by Lighting Facts. Contact the factory for performance data on any configuration not shown here.

# **VSX** LED Specifications


		\	/SX 3K LPV	V Data					
#LED's	mA	Type 1	Type 2	Type 3	Type 4	Type 4A	Type 5	Type 5W	Type 5WR
16	350	134	123	124	122	135	131	124	122
	530	125	115	115	113	125	122	115	113
	700	115	106	107	105	116	113	107	105
	1050	108	99	100	98	108	106	100	98
32	350	131	121	122	119	132	128	121	119
	530	125	115	116	114	126	123	116	114
	700	116	107	108	106	117	114	108	105
	1050	108	99	100	98	108	106	100	98
48	350	133	122	123	120	133	130	123	120
	530	125	115	116	114	126	123	116	114
	700	123	113	114	112	123	120	114	111
	1050	113	104	105	103	114	111	105	103
			VSX 4K LPV	V Data					
#LED's	mA	Type 1	Type 2	Type 3	Type 4	Type 4A	Type 5	Type 5W	Type 5WR
16	350	141	130	131	128	142	138	130	129
	530	131	121	122	119	132	128	121	120
	700	122	112	113	110	122	119	112	111
	1050	114	105	105	103	114	111	105	104
32	350	138	127	128	125	139	135	128	126
	530	132	121	122	120	132	129	122	121
	700	122	113	114	111	123	120	113	112
	1050	114	105	105	103	114	111	105	104
48	350	139	128	129	127	140	136	129	127
	530	132	121	122	120	132	129	122	121
	700	129	119	120	117	130	126	120	118
	1050	119	110	111	108	120	117	110	109
		'	VSX 5K LPV	V Data		'			
#LED's	mA	Type 1	Type 2	Type 3	Type 4	Type 4A	Type 5	Type 5W	Type 5WR
16	350	135	125	126	123	136	132	125	123
	530	126	116	117	114	126	123	116	114
	700	117	107	108	106	117	114	108	106
	1050	109	100	101	99	110	107	101	99
32	350	133	122	123	120	133	130	123	120
	530	127	117	117	115	127	124	117	115
	700	117	108	109	107	118	115	109	106
	1050	109	100	101	99	110	107	101	99
48	350	134	123	124	121	134	131	124	121
	530	127	117	117	115	127	124	117	115
	700	124	114	115	113	125	121	115	113
	1050	115	105	106	104	115	112	106	104




VSX 3K BUG Data								- - Da	ta																
			Type 1			Type 2			lla Type :	3	-	Гуре 4	1		Гуре 4	Δ		Type 5	5	Ιτ	ype 5	N	Tvr	pe T5V	N/R
#LED's	mA	В	U	G	В	U	G	В	U	G	В	U	G	В	U U	G	В	U	G	В.	U	G	В	U	G
16	350	1	0	1	1	0	1	0	0	1	1	0	1	1	0	1	1	0	1	2	0	1	2	0	1
	530	2	0	2	1	0	1	1	0	1	1	0	1	1	0	1	2	0	1	2	0	1	2	0	1
	700	2	0	2	1	0	2	1	0	1	1	0	1	1	0	1	2	0	1	2	0	1	3	0	1
	1050	3	0	3	1	0	2	1	0	1	1	0	2	1	0	1	3	0	1	3	0	1	3	0	1
32	350	2	0	2	1	0	2	1	0	1	1	0	1	1	0	1	2	0	1	3	0	1	3	0	1
	530	3	0	3	1	0	2	1	0	2	1	0	2	1	0	1	3	0	1	3	0	1	3	0	1
	700	3	0	3	2	0	3	1	0	2	2	0	2	1	0	1	3	0	1	3	0	2	3	0	2
	1050	3	0	3	2	0	3	2	0	2	2	0	2	2	0	1	3	0	2	4	0	2	4	0	2
48	350	3	0	3	2	0	2	1	0	2	1	0	2	1	0	1	3	0	1	3	0	1	3	0	2
	530	3	0	3	2	0	3	1	0	2	2	0	2	2	0	1	3	0	2	3	0	2	3	0	2
	700	3	0	3	2	0	3	2	0	2	2	0	3	2	0	2	3	0	2	4	0	2	4	0	2
	1050	4	0	4	3	0	3	2	0	3	3	0	3	2	0	2	4	0	2	4	0	2	4	0	2
		'	,	,	VS	X 4K	BUC	a Da	ta	,	,	,							'	,					
			Type 1			Type 2	)	-	Гуре 3	3	1	Гуре 4	1		Гуре 4	Д	-	Type 5	5	Т	ype 5	N	Тур	pe T5V	NR
#LED's	mA	В	U	G	В	U	G	В	U	G	В	U	G	В	U	G	В	U	G	В	U	G	В	U	G
16	350	1	0	1	1	0	1	1	0	1	1	0	1	1	0	1	1	0	1	2	0	1	2	0	1
	530	2	0	2	1	0	1	1	0	1	1	0	1	1	0	1	2	0	1	2	0	1	2	0	1
	700	2	0	2	1	0	2	1	0	1	1	0	1	1	0	1	2	0	1	2	0	1	3	0	1
	1050	3	0	3	1	0	2	1	0	2	1	0	2	1	0	1	3	0	1	3	0	1	3	0	1
32	350	2	0	2	1	0	2	1	0	1	1	0	1	1	0	1	2	0	1	3	0	1	3	0	1
	530	3	0	3	2	0	2	1	0	2	1	0	2	1	0	1	3	0	1	3	0	1	3	0	1
	700	3	0	3	2	0	3	1	0	2	2	0	2	1	0	1	3	0	1	3	0	2	3	0	2
	1050	3	0	3	2	0	3	2	0	2	2	0	3	2	0	2	3	0	2	4	0	2	4	0	2
48	350	3	0	3	2	0	2	1	0	2	2	0	2	1	0	1	3	0	1	3	0	1	3	0	2
	530	3	0	3	2	0	3	1	0	2	2	0	2	2	0	1	3	0	2	3	0	2	4	0	2
	700	3	0	3	2	0	3	2	0	2	2	0	3	2	0	2	3	0	2	4	0	2	4	0	2
	1050	4	0	4	3	0	4	2	0	3	3	0	3	2	0	2	4	0	2	4	0	2	4	0	2
					VS.	X 5K	BUC	a Da	ta																
			Type 1			Type 2	2		Гуре 3	3	1	Гуре 4	1	-	Гуре 4	Ą	_	Type 5	5	Т	ype 5\	N	Тур	pe T5V	٧R
#LED's	mA	В	U	G	В	U	G	В	U	G	В	U	G	В	U	G	В	U	G	В	U	G	В	U	G
16	350	1	0	1	1	0	1	1	0	1	1	0	1	1	0	1	1	0	1	2	0	1	2	0	1
	530	2	0	2	1	0	1	1	0	1	1	0	1	1	0	1	2	0	1	2	0	1	2	0	1
	700	2	0	2	1	0	2	1	0	1	1	0	1	1	0	1	2	0	1	2	0	1	3	0	1
	1050	3	0	3	1	0	2	1	0	1	1	0	2	1	0	1	3	0	1	3	0	1	3	0	1
32	350	2	0	2	1	0	2	1	0	1	1	0	1	1	0	1	2	0	1	3	0	1	3	0	1
	530	3	0	3	1	0	2	1	0	2	1	0	2	1	0	1	3	0	1	3	0	1	3	0	1
	700	3	0	3	2	0	3	1	0	2	2	0	2	1	0	1	3	0	1	3	0	2	3	0	2
	1050	3	0	3	2	0	3	2	0	2	2	0	2	2	0	1	3	0	2	4	0	2	4	0	2
48	350	3	0	3	2	0	2	1	0	2	1	0	2	1	0	1	3	0	1	3	0	1	3	0	2
	530	3	0	3	2	0	3	1	0	2	2	0	2	2	0	1	3	0	2	3	0	2	3	0	2
	700	3	0	3	2	0	3	2	0	2	2	0	3	2	0	2	3	0	2	4	0	2	4	0	2
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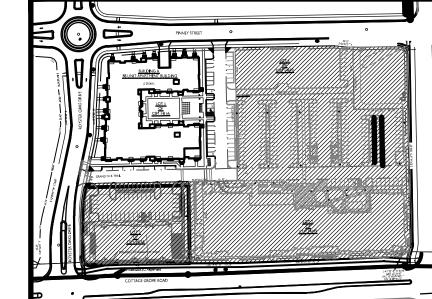



# Looking from intersection of Royster Oaks Drive and Cottage Grove Road



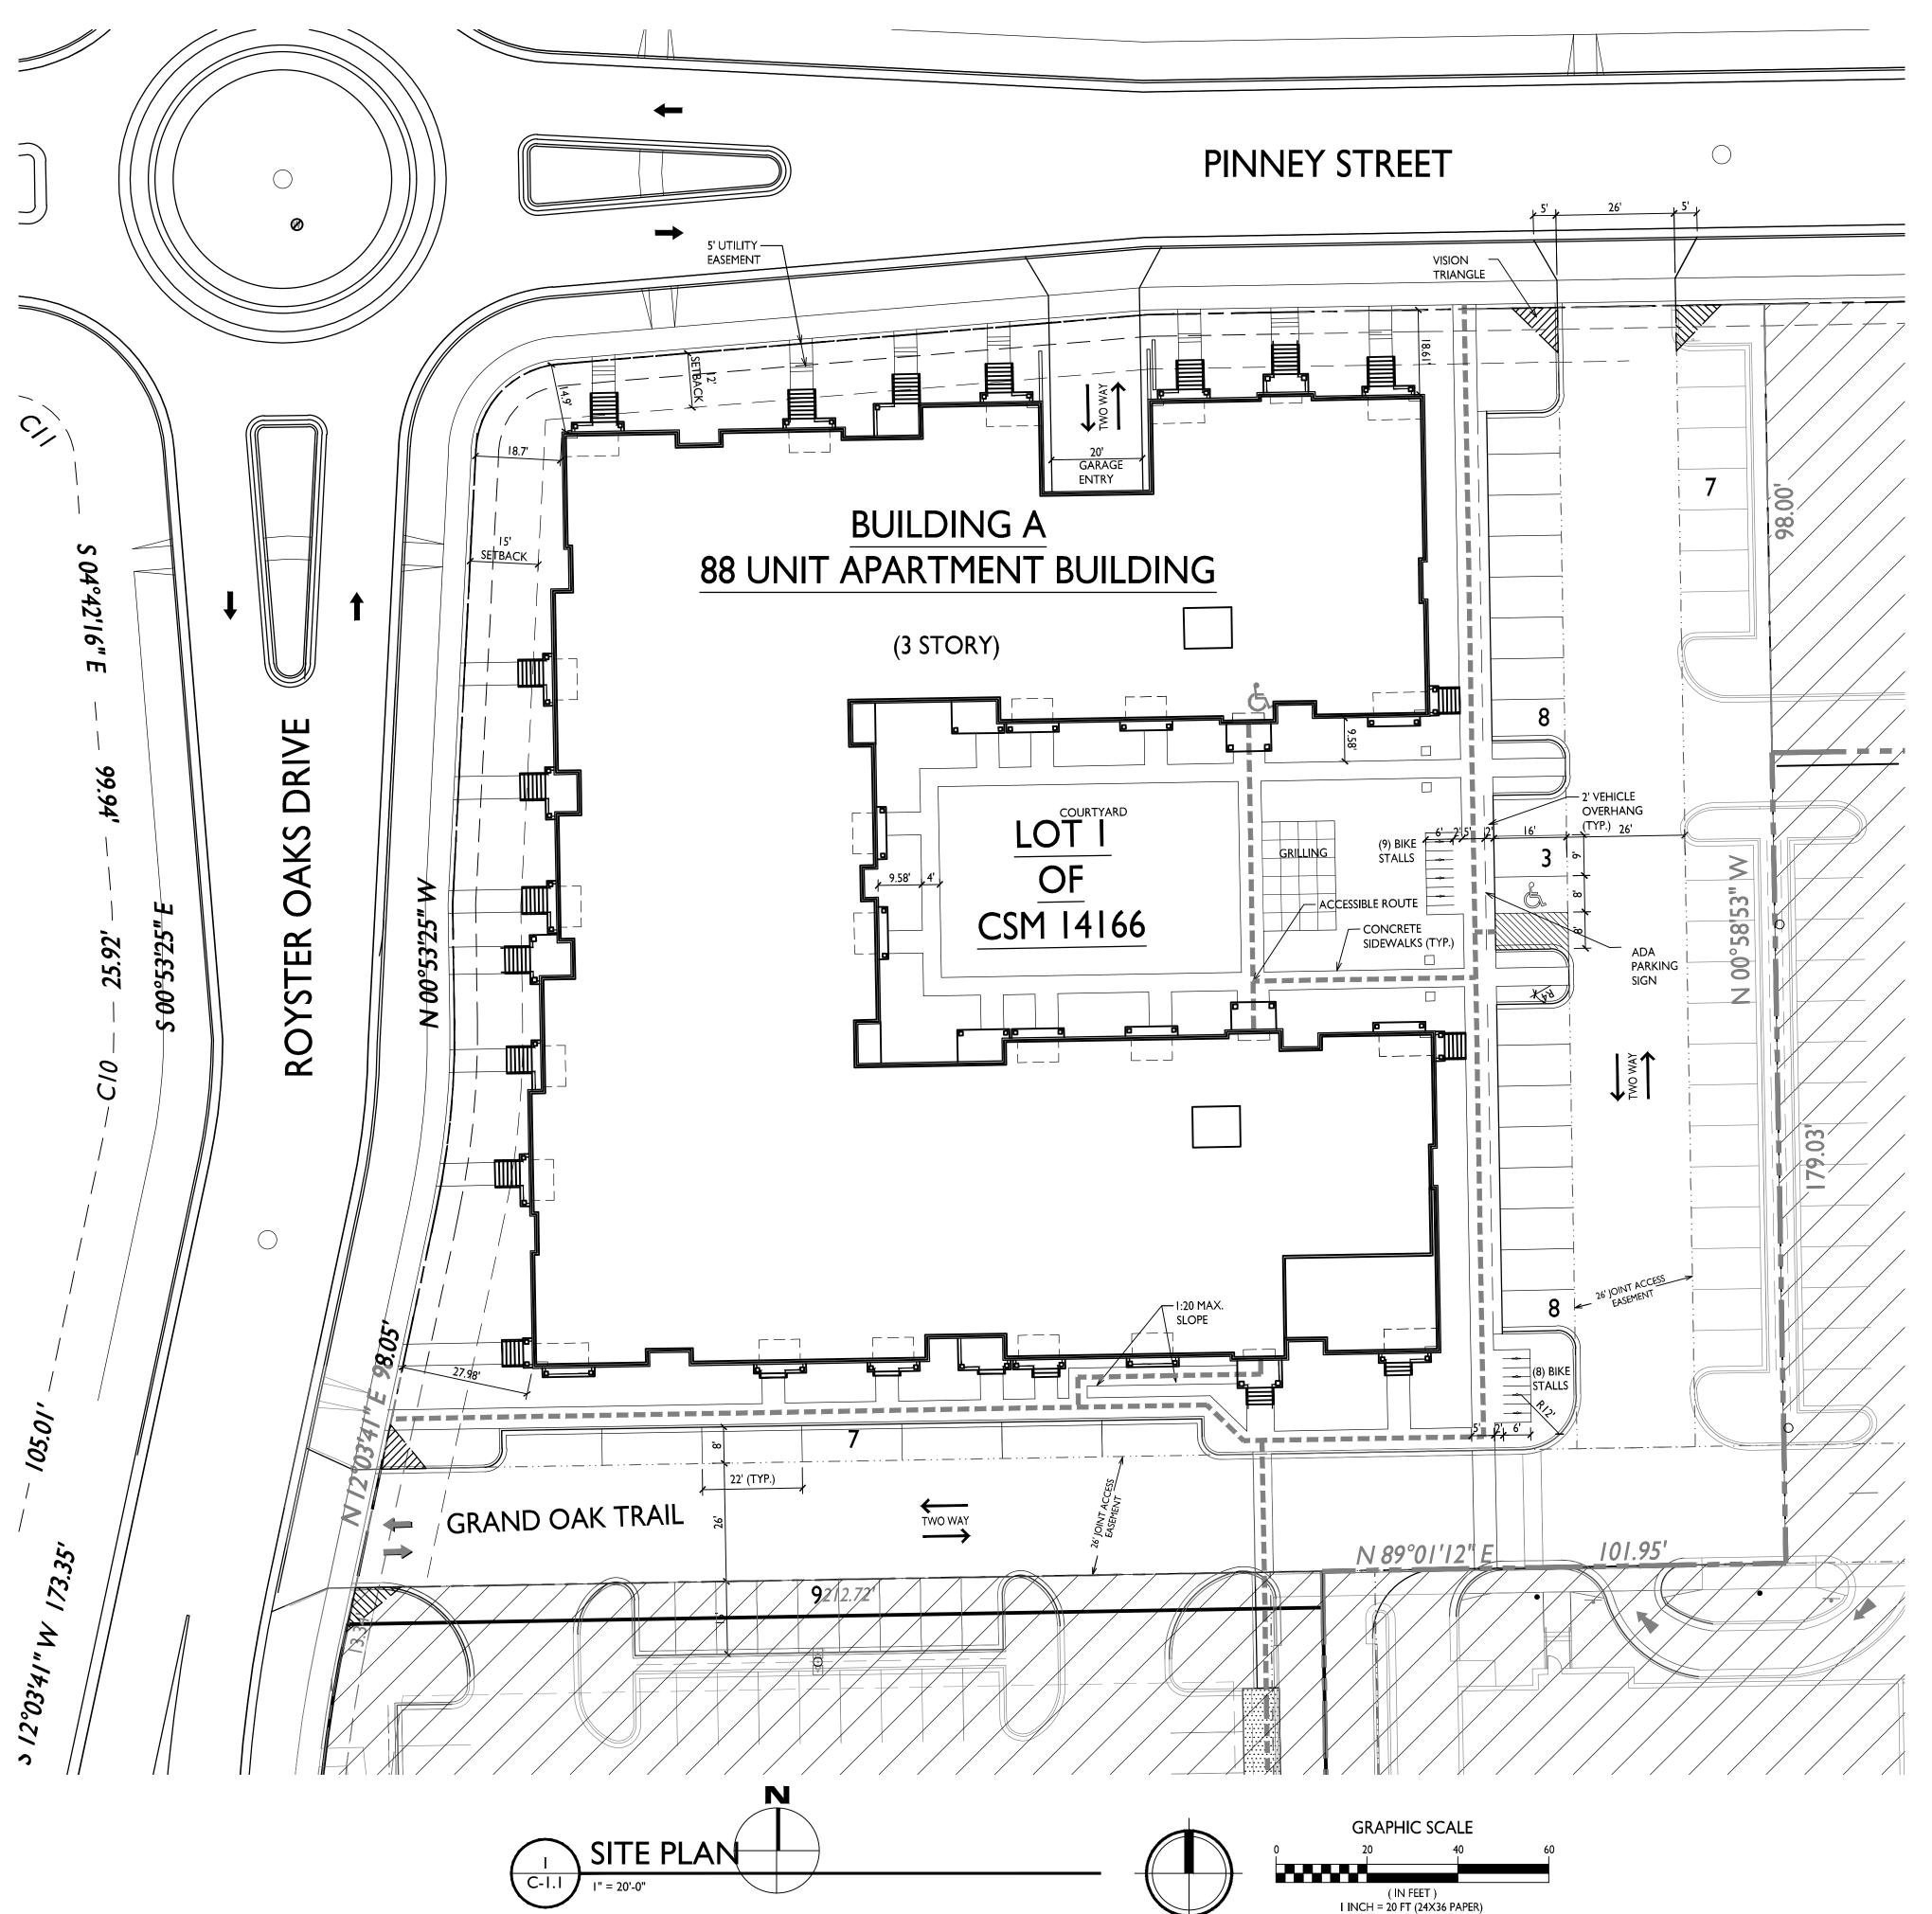

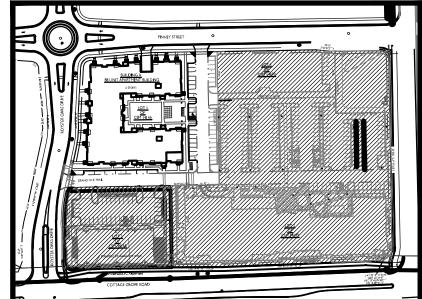SITE LOCATOR MAP



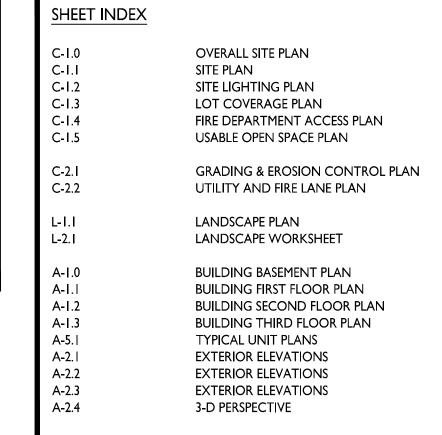



```
SITE DEVELOPMENT STATISTICS - LOT 1 of CSM 14166
                    80,462 S.F./I.84 ACRES
                   88 D.U.
DWELLING UNITS
LOT AREA/ D.U.
                   914 S.F./D.U.
                    47.8 UNITS/ACRE
DENSITY
BUILDING HEIGHT
                   3 STORIES
GROSS FLOOR AREA 88,606 SF
(excluding underground parking)
FLOOR AREA RATIO I.10
UNIT MIX
EFFICIENCY
 ONE BEDROOM
 ONE BEDROOM + DEN 6
 TWO BEDROOM 16
VEHICLE PARKING
SURFACE
 UNDERGROUND
BIKE PARKING
 SURFACE STALLS
  GUEST SURFACE STALLS
  BASEMENT FLOOR MOUNT STALLS
  BASEMENT WALL MOUNT STALLS
 USABLE OPEN SPACE (SHOWN ON C-1.3)
                                 13,762 S.F.
  GROUND LEVEL
  BALCONIES & PORCHES
                                 20,311 S.F. (230 S.F./ UNIT)
LOT COVERAGE:
                   57,561S.F. / 71.5%
```

## GENERAL NOTES:

- THE APPLICANT SHALL REPLACE ALL SIDEWALK AND CURB AND GUTTER WHICH ABUTS THE PROPERTY WHICH IS DAMAGED BY THE CONSTRUCTION OR ANY SIDEWALK AND CURB AND GUTTER WHICH THE CITY ENGINEER DETERMINES NEEDS TO BE REPLACED BECAUSE IT IS NOT AT A DESIRABLE GRADE REGARDLESS OF WHETHER THE CONDITION EXISTED PRIOR TO BEGINNING CONSTRUCTION.
- ALL WORK IN THE PUBLIC RIGHT-OF-WAY SHALL BE PERFORMED BY A CITY LICENSED CONTRACTOR.
- ALL DAMAGE TO THE PAVEMENT, ADJACENT TO THIS DEVELOPMENT SHALL BE RESTORED IN ACCORDANCE WITH THE CITY OF MADISON'S PAVEMENT PATCHING CRITERIA.
- APPROVAL OF PLANS FOR THIS PROJECT DOES NOT INCLUDE ANY APPROVAL TO PRUNE, REMOVE, OR PLANT TREES IN THE PUBLIC RIGHT-OF-WAY. PERMISSION FOR SUCH ACTIVITIES MUST BE OBTAINED FROM THE CITY FORESTER, 266-4816.
- EASEMENT LINES SHOWN ON THIS SHEET ARE FOR GENERAL REFERENCE ONLY - SEE CSM AND CIVIL SHEETS FOR ADDITIONAL AND MORE COMPLETE EASEMENT INFORMATION
- CONTRACTOR SHALL INSTALL TREE PROTECTION FENCING IN THE AREA BETWEEN THE CURB AND SIDEWALK AND EXTEND IT AT LEAST 5 FEET FROM BOTH SIDES OF THE TREE ALONG THE LENGTH OF THE TERRACE. NO EXCAVATION IS PERMITTED WITHIN 5 FEET OF THE OUTSIDE EDGE OF THE TREE TRUNK. IF EXCAVATION WITHIN 5 FEET OF ANY TREE IS NECESSARY, CONTRACTOR SHALL CONTACT CITY FORESTRY (266-4816) PRIOR TO EXCAVATION TO ASSESS THE IMPACT TO THE TREE AND ROOT SYSTEM. TREE PRUNING SHALL BE COORDINATED WITH CITY FORESTRY PRIOR TO THE START OF CONSTRUCTION. TREE PROTECTION SPECIFICATIONS CAN BE FOUND IN SECTION 107.13 OF CITY OF MADISON STANDARD SPECIFICATIONS FOR PUBLIC WORKS CONSTRUCTION. ANY TREE REMOVALS THAT ARE REQUIRED FOR CONSTRUCTION AFTER THE DEVELOPMENT PLAN IS APPROVED WILL REQUIRE AT LEAST A 72-HOUR WAIT PERIOD BEFORE A TREE REMOVAL PERMIT CAN BE ISSUED BY FORESTRY, TO NOTIFY
- THE ALDER OF THE CHANGE IN THE TREE PLAN. THE RIGHT-OF-WAY IS THE SOLE JURISDICTION OF THE CITY OF MADISON AND IS SUBJECT TO CHANGE AT ANY TIME PER THE RECOMMENDATION/PLAN OF TRAFFIC ENGINEERING AND CITY ENGINEERING DEPARTMENTS.

PROJECT TITLE Royster Crossing Lot I of CSM 14166

**ISSUED** 

Issued for Land Use - Sept. 19, 2018

**515** Pinney Street

SHEET TITLE Site Plan

SHEET NUMBER

© 2013 Knothe & Bruce Architects, LLC

**BIKE RACKS:** 




**EXTERIOR BIKE STALLS:** MADRAX POST AND RING



INTERIOR BIKE STALLS, FLOOR-MOUNT: MADRAX UX RACK



INTERIOR BIKE STALLS, WALL-MOUNT: MADRAX VERT. WALL MOUNT

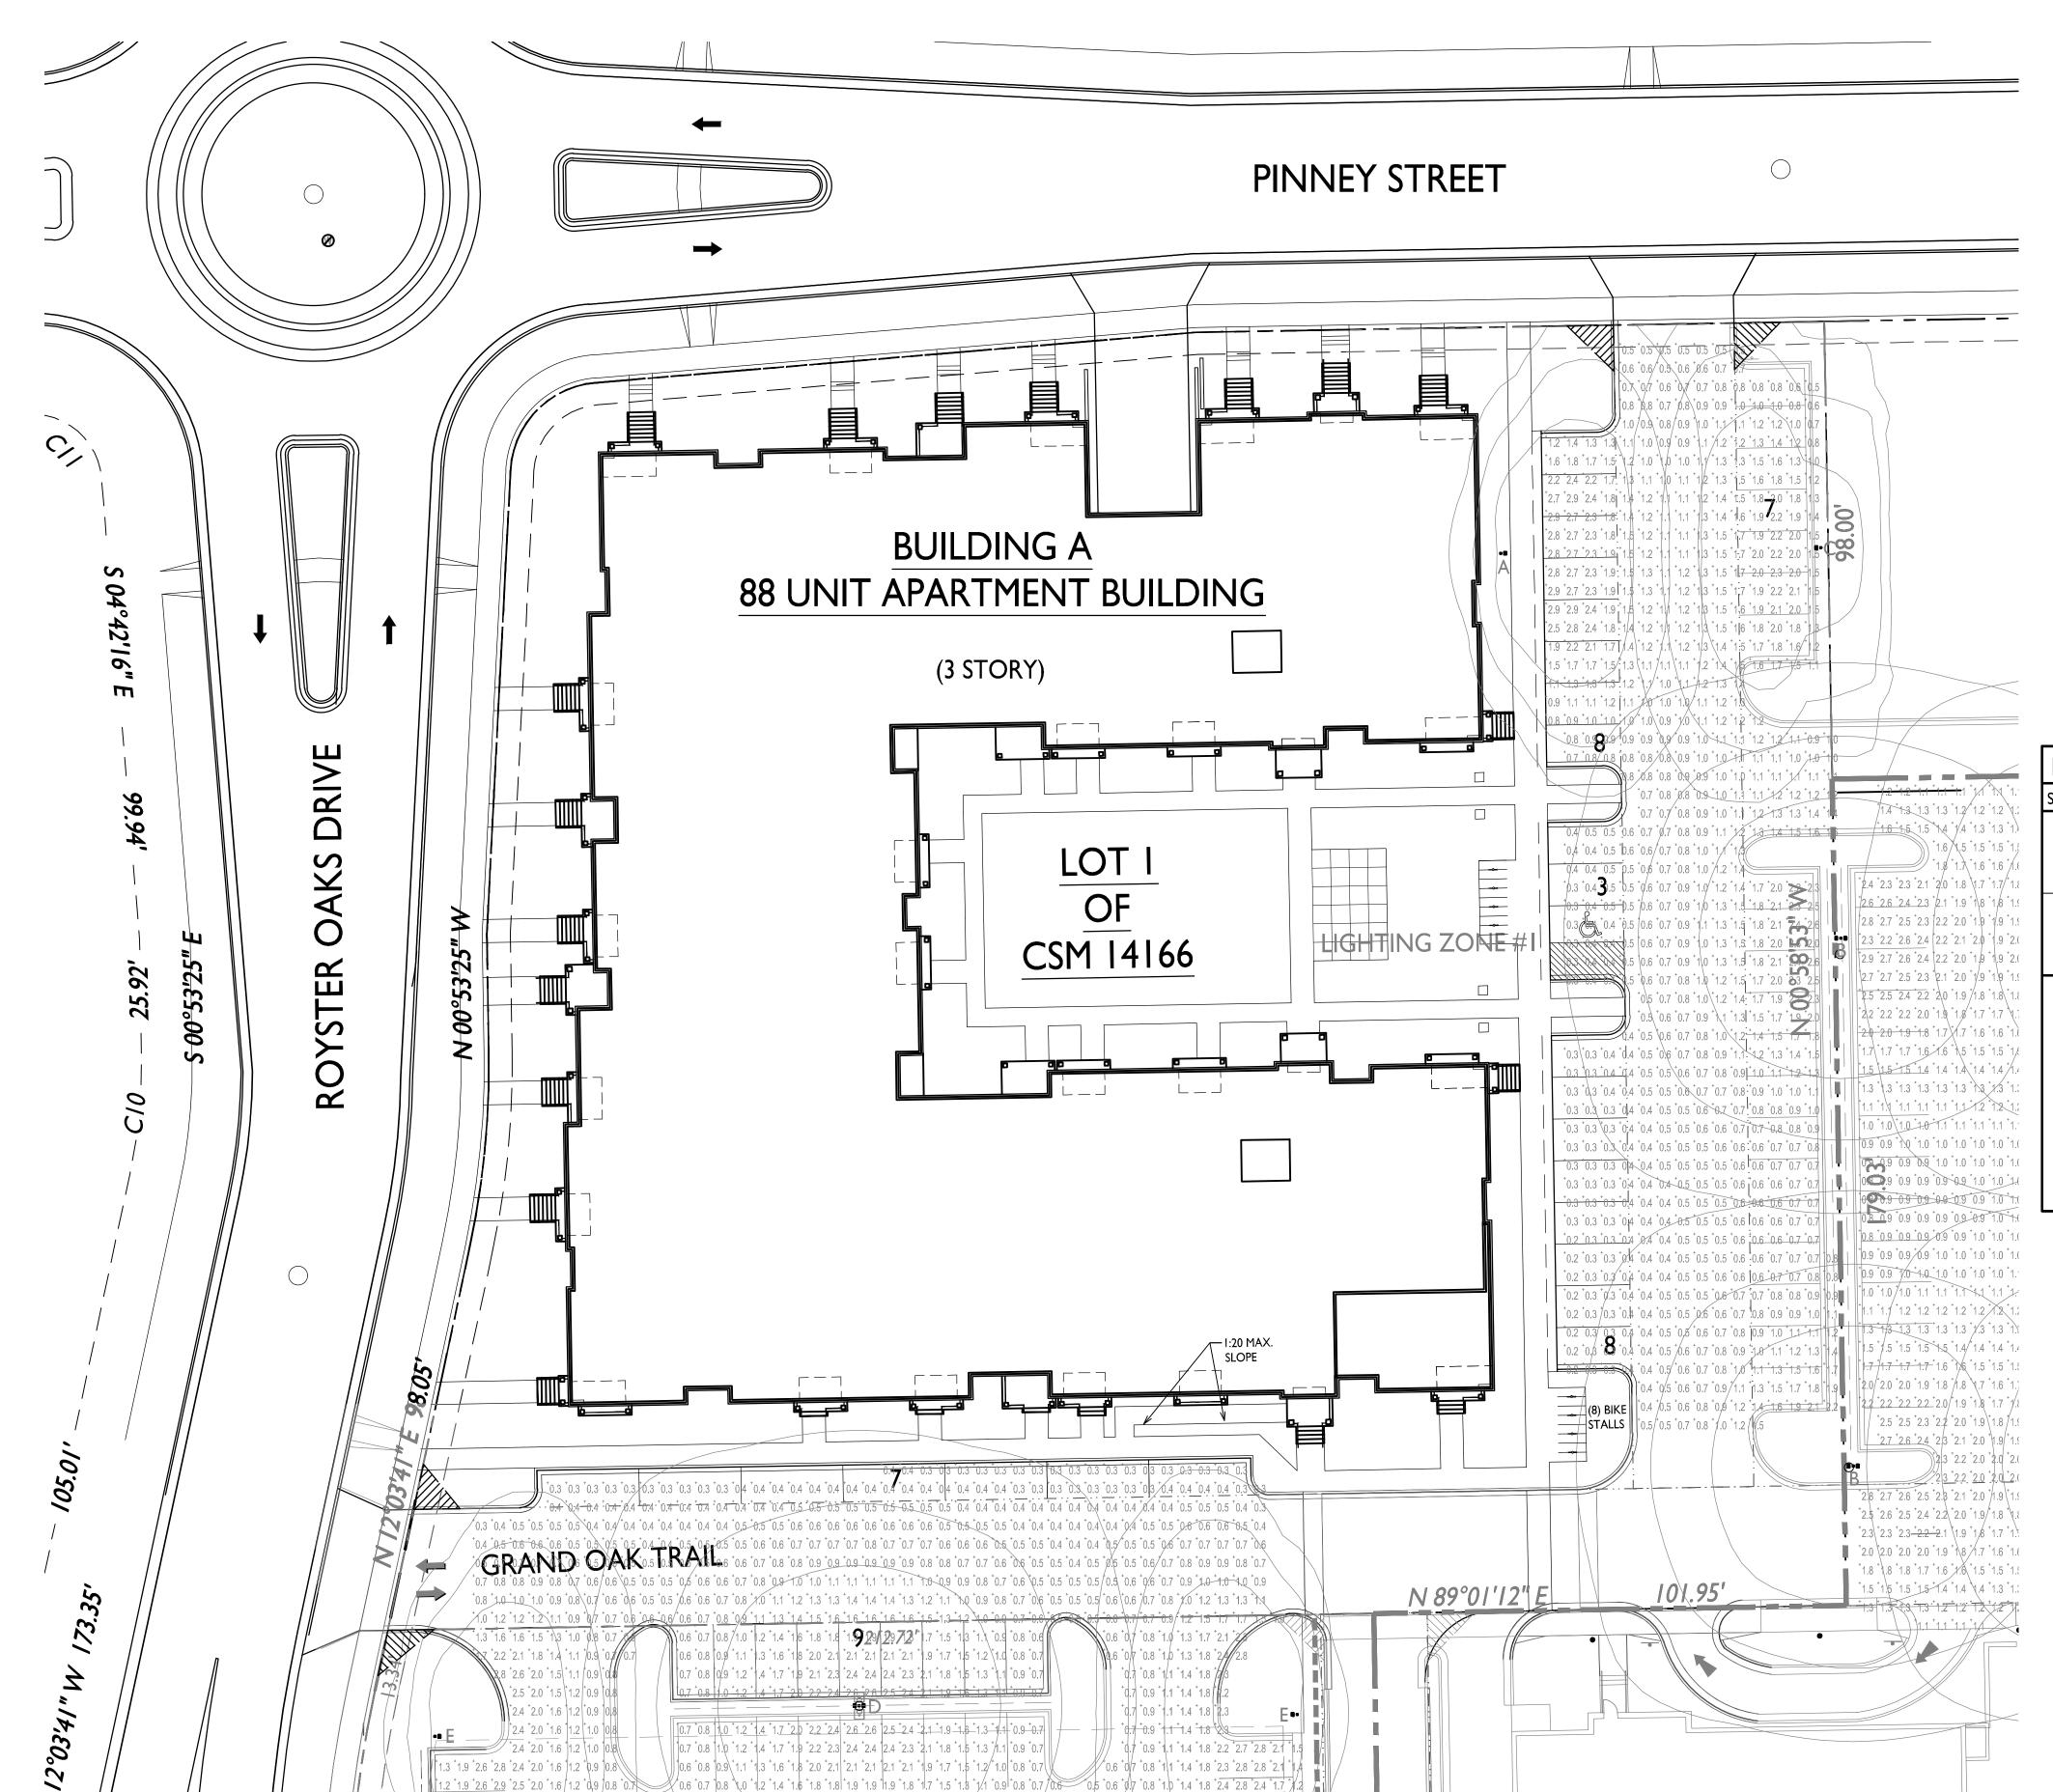



STATISTICS						
DESCRIPTION	SYMBOL	AVG.	MAX.	MIN.	MAX. / MIN.	AVG. / MIN.
East Parking Area Lighting	+	I.5 fc	3.2 fc	0.4 fc	8.0:I	3.8:I
South Parking Area Lighting	+	I.I fc	3.1 fc	0.3 fc	10.3:1	3.7:1

LUMII	VAIR	E SC	CHEDULE							
SYMBOL	LABEL	QTY.	MANUF.	CATALOG	DESCRIPTION	FILE	MOUNTING			
	Α	6	VISIONAIRE LIGHTING, LLC	VSX-I-T3-I6LC-I0-4K-UNV_CLS	23" L x I2.5" W x 8" H	VSX-I_T3_I6LC_I0 _4K_UNV_CLS.ies	20'-0" POLE ON FLUSH CONC. BASE			
	В	2	VISIONAIRE LIGHTING, LLC	VSX-1-T3-16LC-10-4K-UNV_CLS	23" L x 12.5" W x 8" H	VSX-I_T3_I6LC_I0 _4K_UNV_CLS.ies	18'-0" POLE ON 2'-0" TALL CONC. BASE			
•	EVANABLE LIGHT EIV/THEE DICTRIBUTION I									

# ISOLUX CONTOUR = 0.25 FC ISOLUX CONTOUR = 0.5 FC ISOLUX CONTOUR = 1.0 FC LIGHT FIXTURE

PROJECT TITLE
Royster Crossing
Lot I of CSM
14166

**515** Pinney Street

SHEET TITLE

Site Lighting Plan


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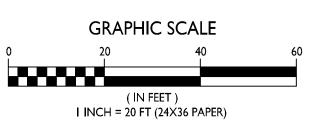
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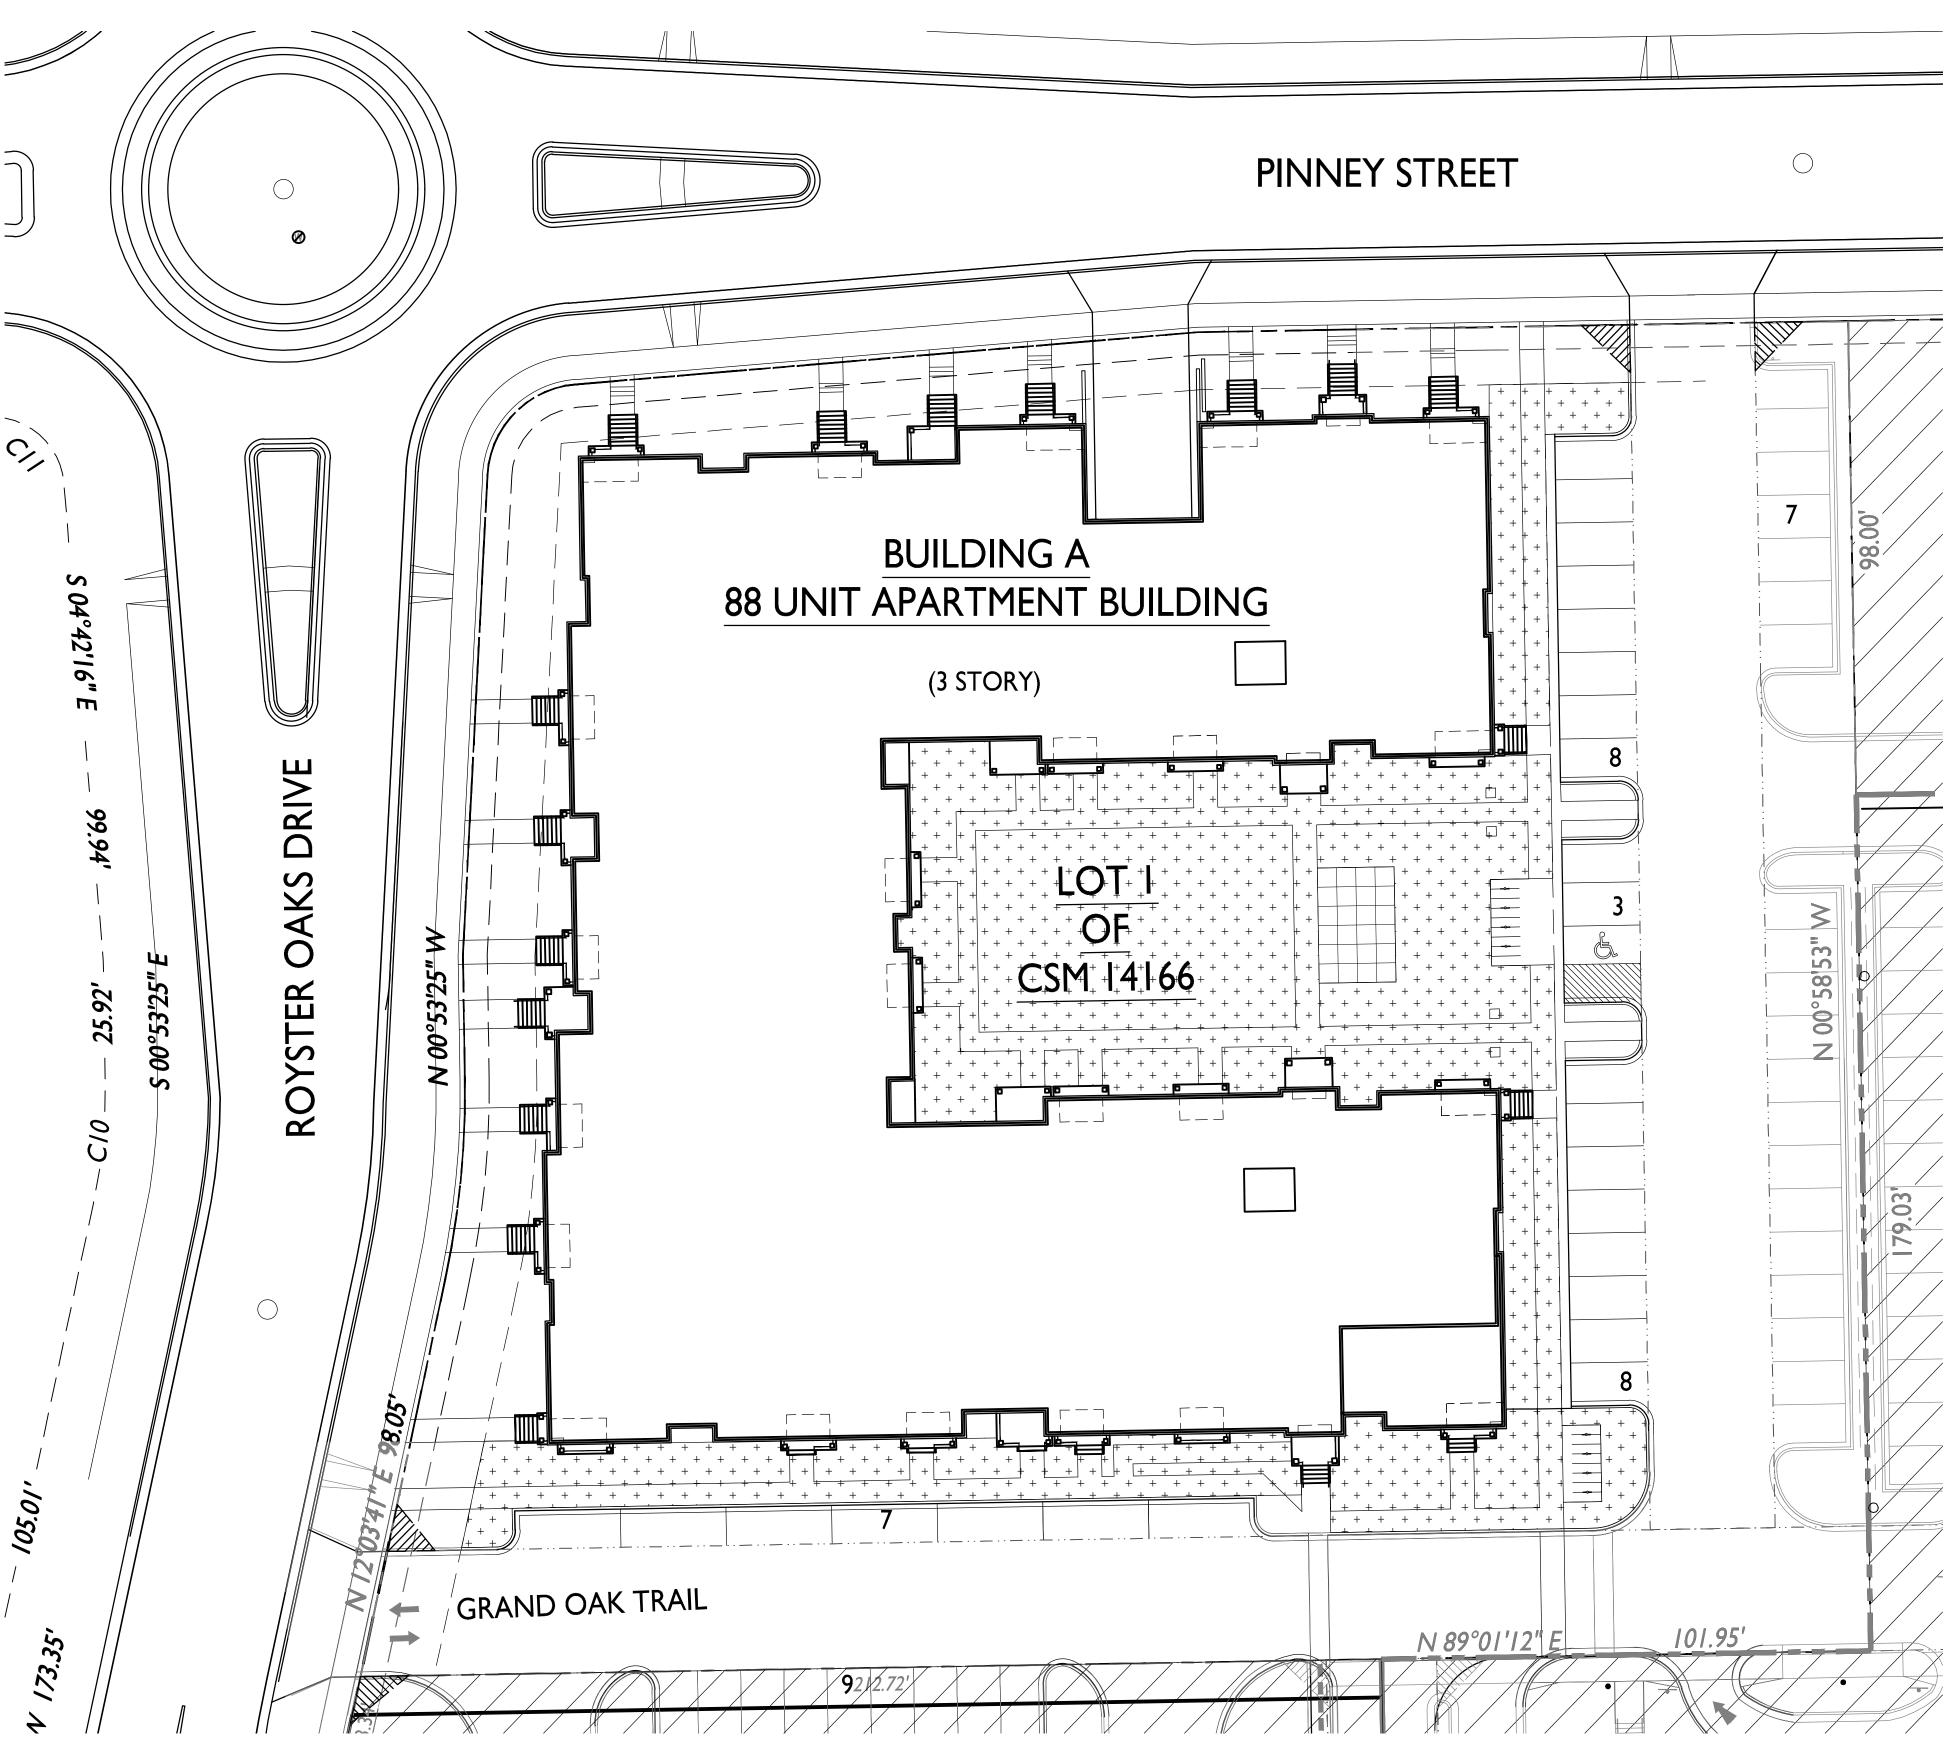
PROJECT NO.

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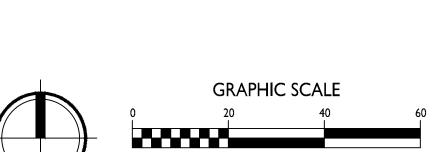







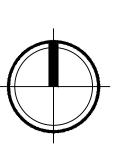

SITE PLAN - USABLE OPEN SPACE PLAN



( IN FEET ) I INCH = 20 FT (24X36 PAPER)

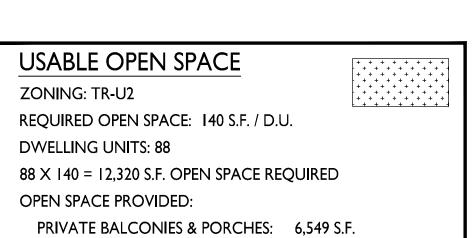

SURFACE:

TOTAL:

13,762 S.F.

20,311 S.F.

Knothe bruce
ARCHITEGTS

Phone: 7601 University Ave, Ste 201
608.836.3690 Middleton, WI 53562

ISSUED
Issued for Land Use - Sept. 19, 2018

Royster Crossing
Lot I of CSM
14166

**515** Pinney Street


SHEET TITLE
Usable Open
Space Plan


SHEET NUMBER

C-1.3

PROJECT NO. 185

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Royster Crossing
Lot I of CSM
14166

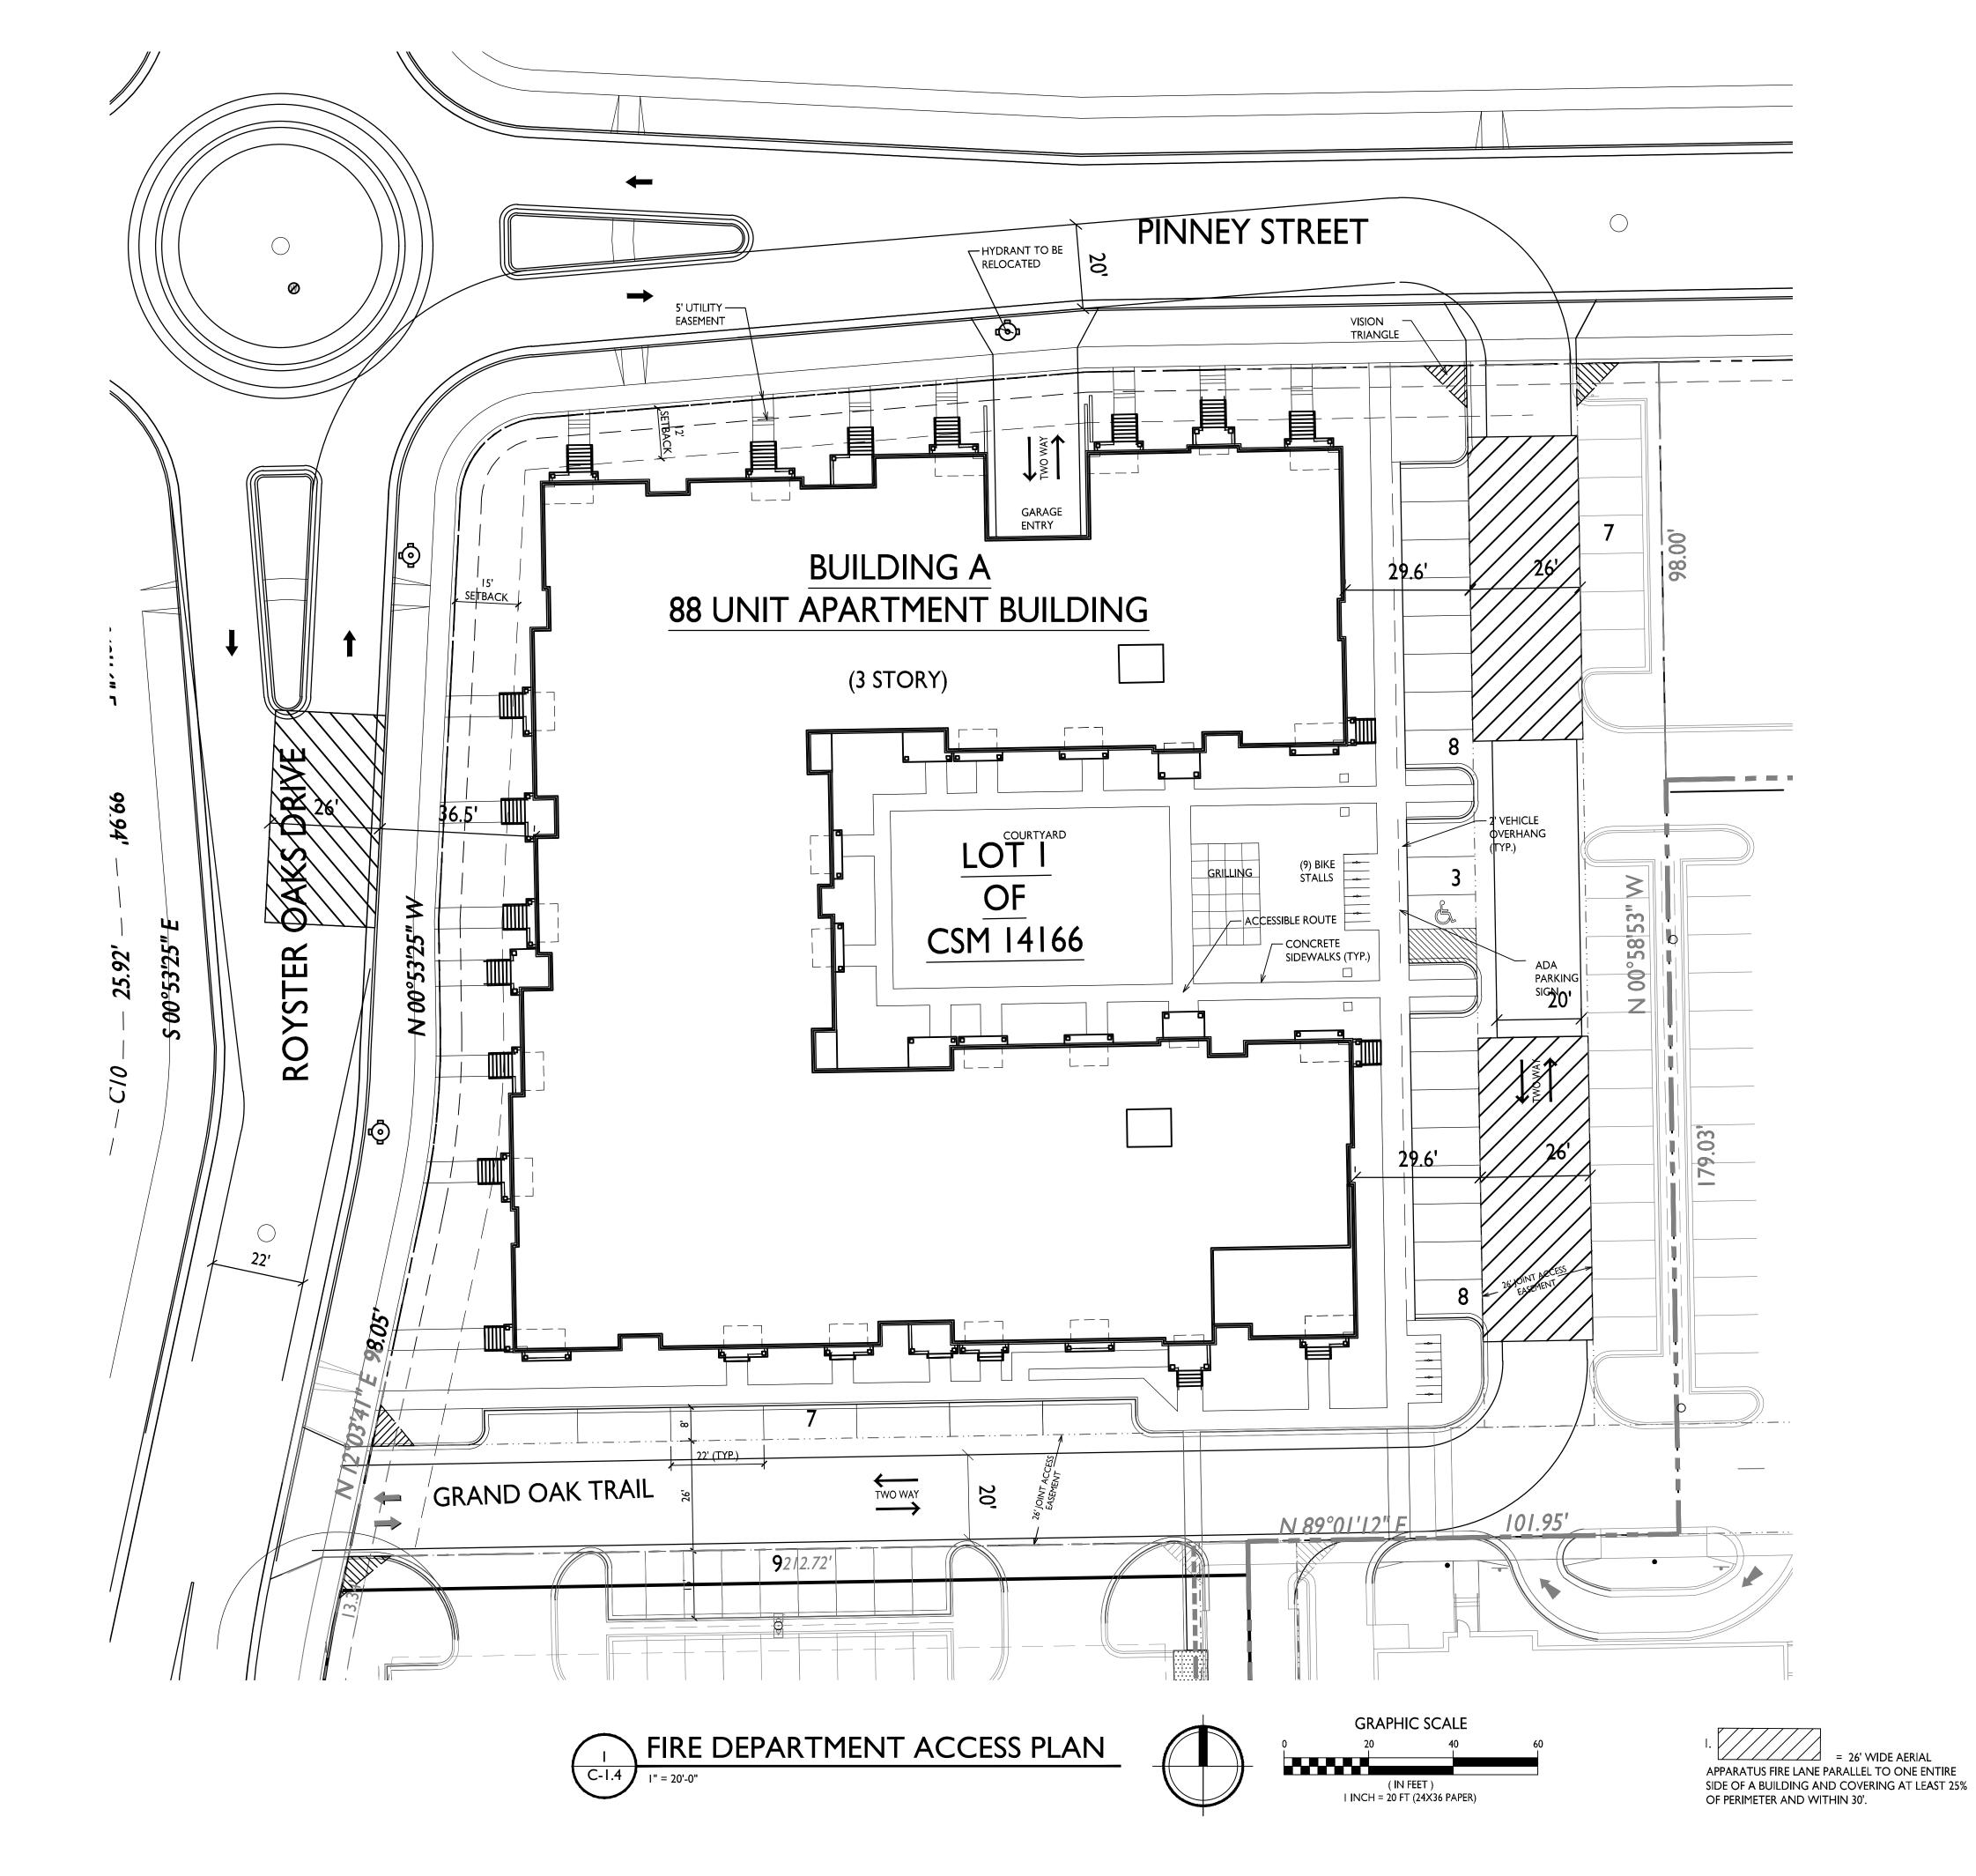515 Pinney Street

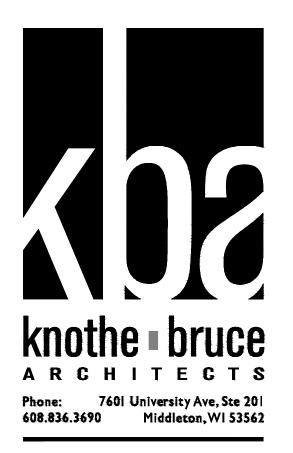
Fire Department
Access Plan


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C-1.4

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PROJECT NO.



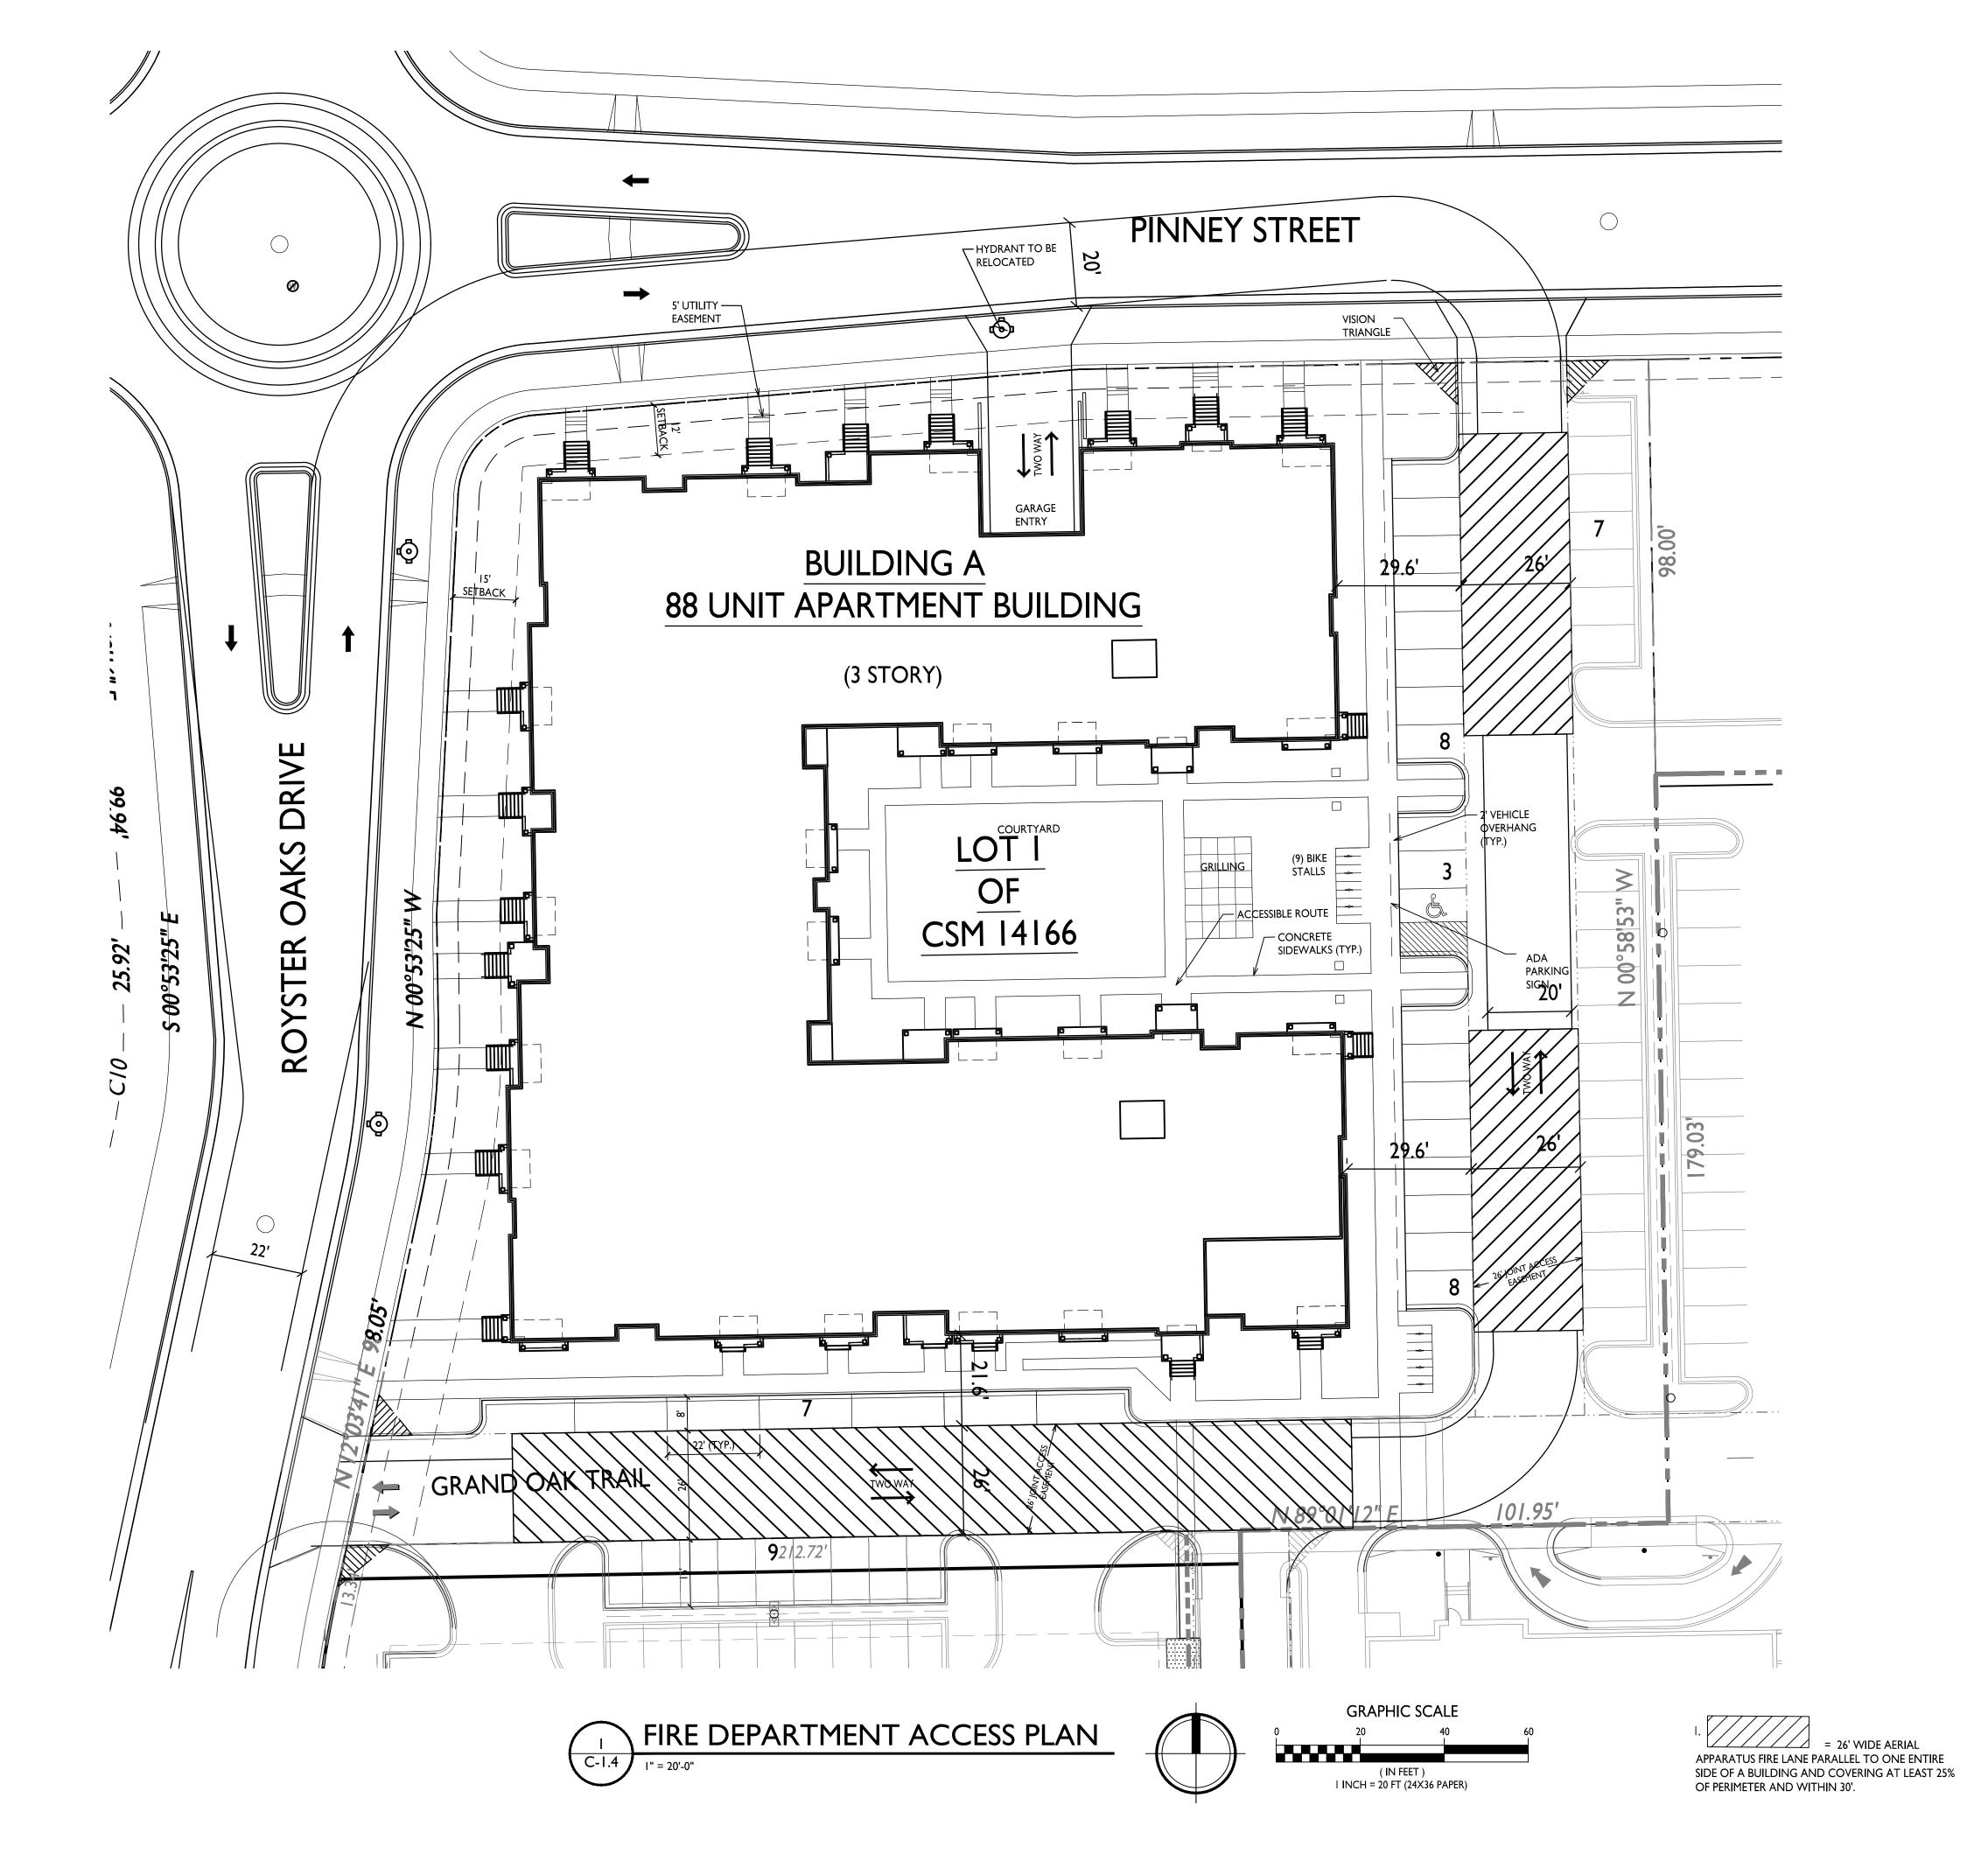

Royster Crossing
Lot 1 of CSM
14166

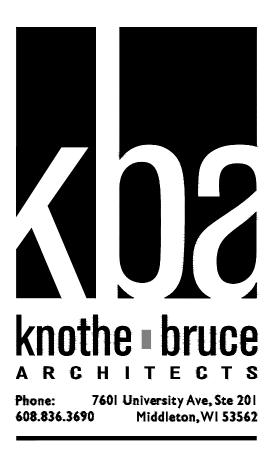515 Pinney Street


Fire Department
Access Plan


SHEET NUMBER

C-1.4

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PROJECT NO.



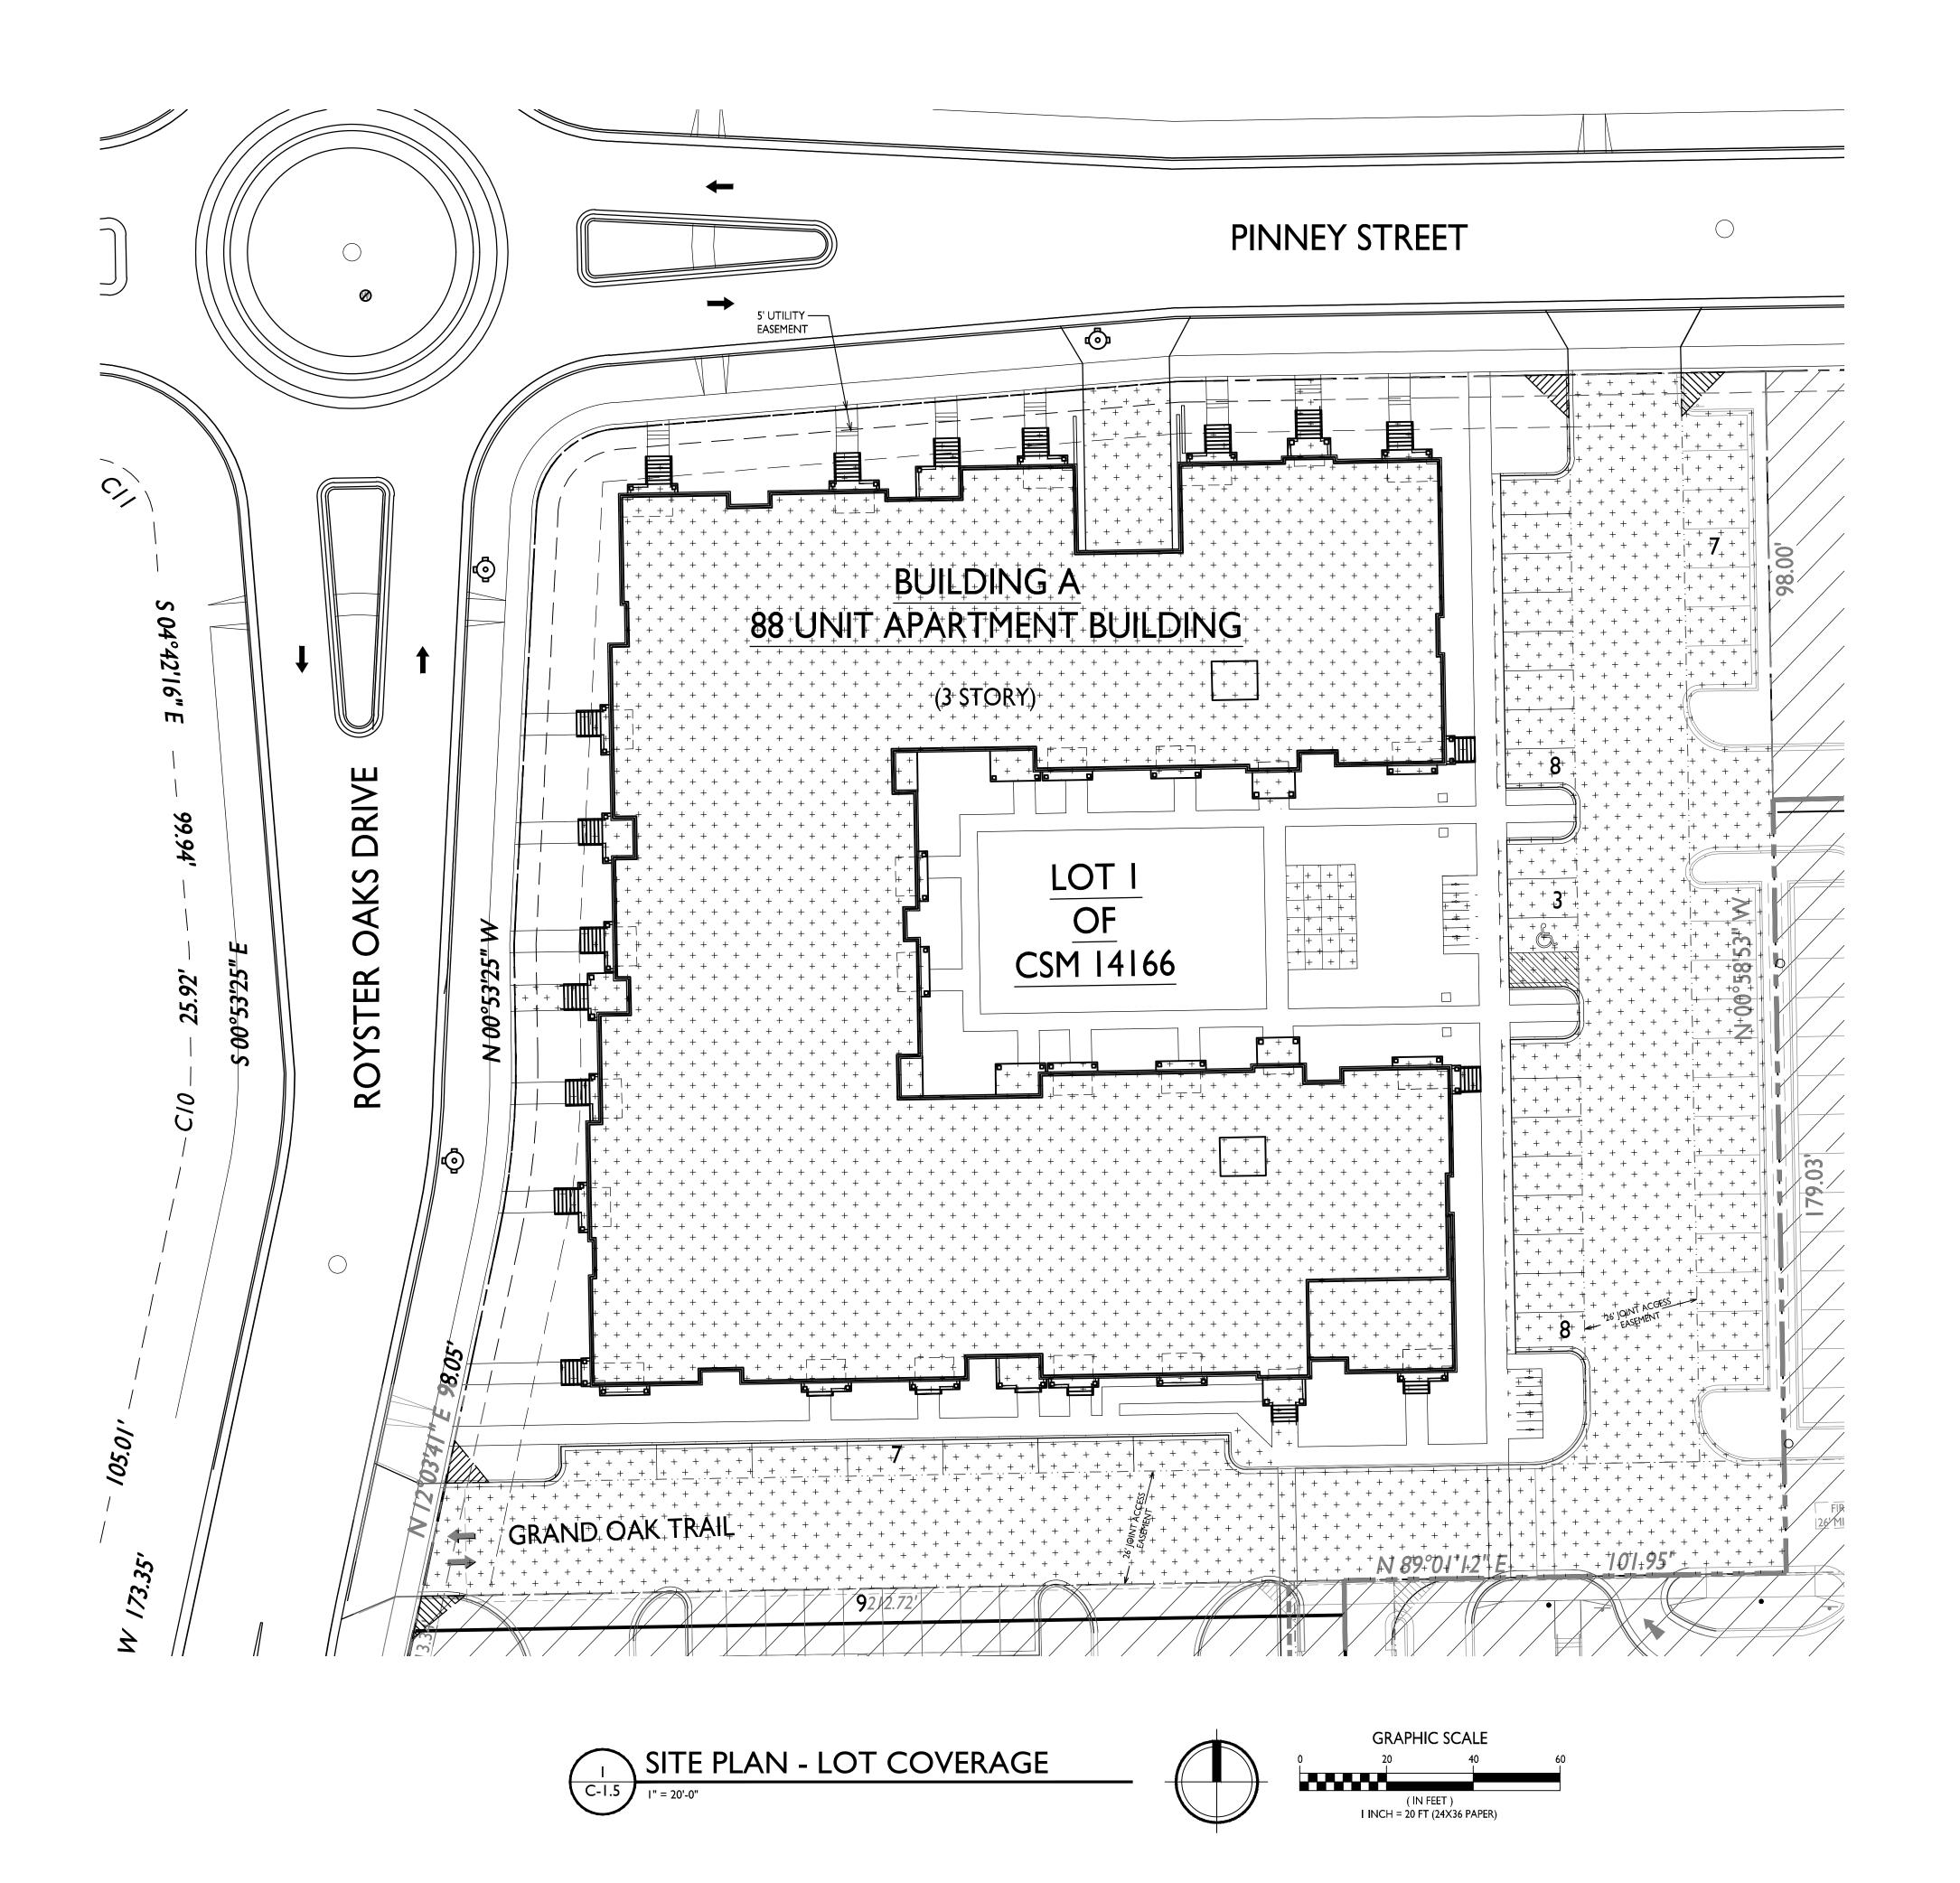

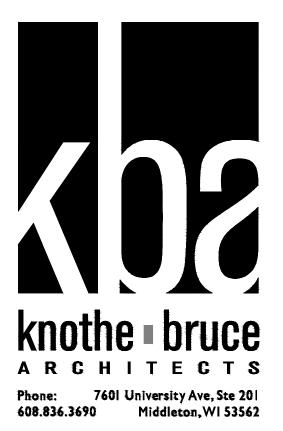LOT COVERAGE

ZONING: TR-U2 MAXIMUM LOT COVERAGE: 80% TOTAL LOT AREA: 80,462 S.F. ALLOWED COVERAGE: 64,369 S.F. PROPOSED COVERAGE: 57,561 S.F. / 71.5%

Issued for Land Use - Sept. 19, 2018

PROJECT TITLE Royster Crossing Lot I of CSM 14166

515 Pinney Street


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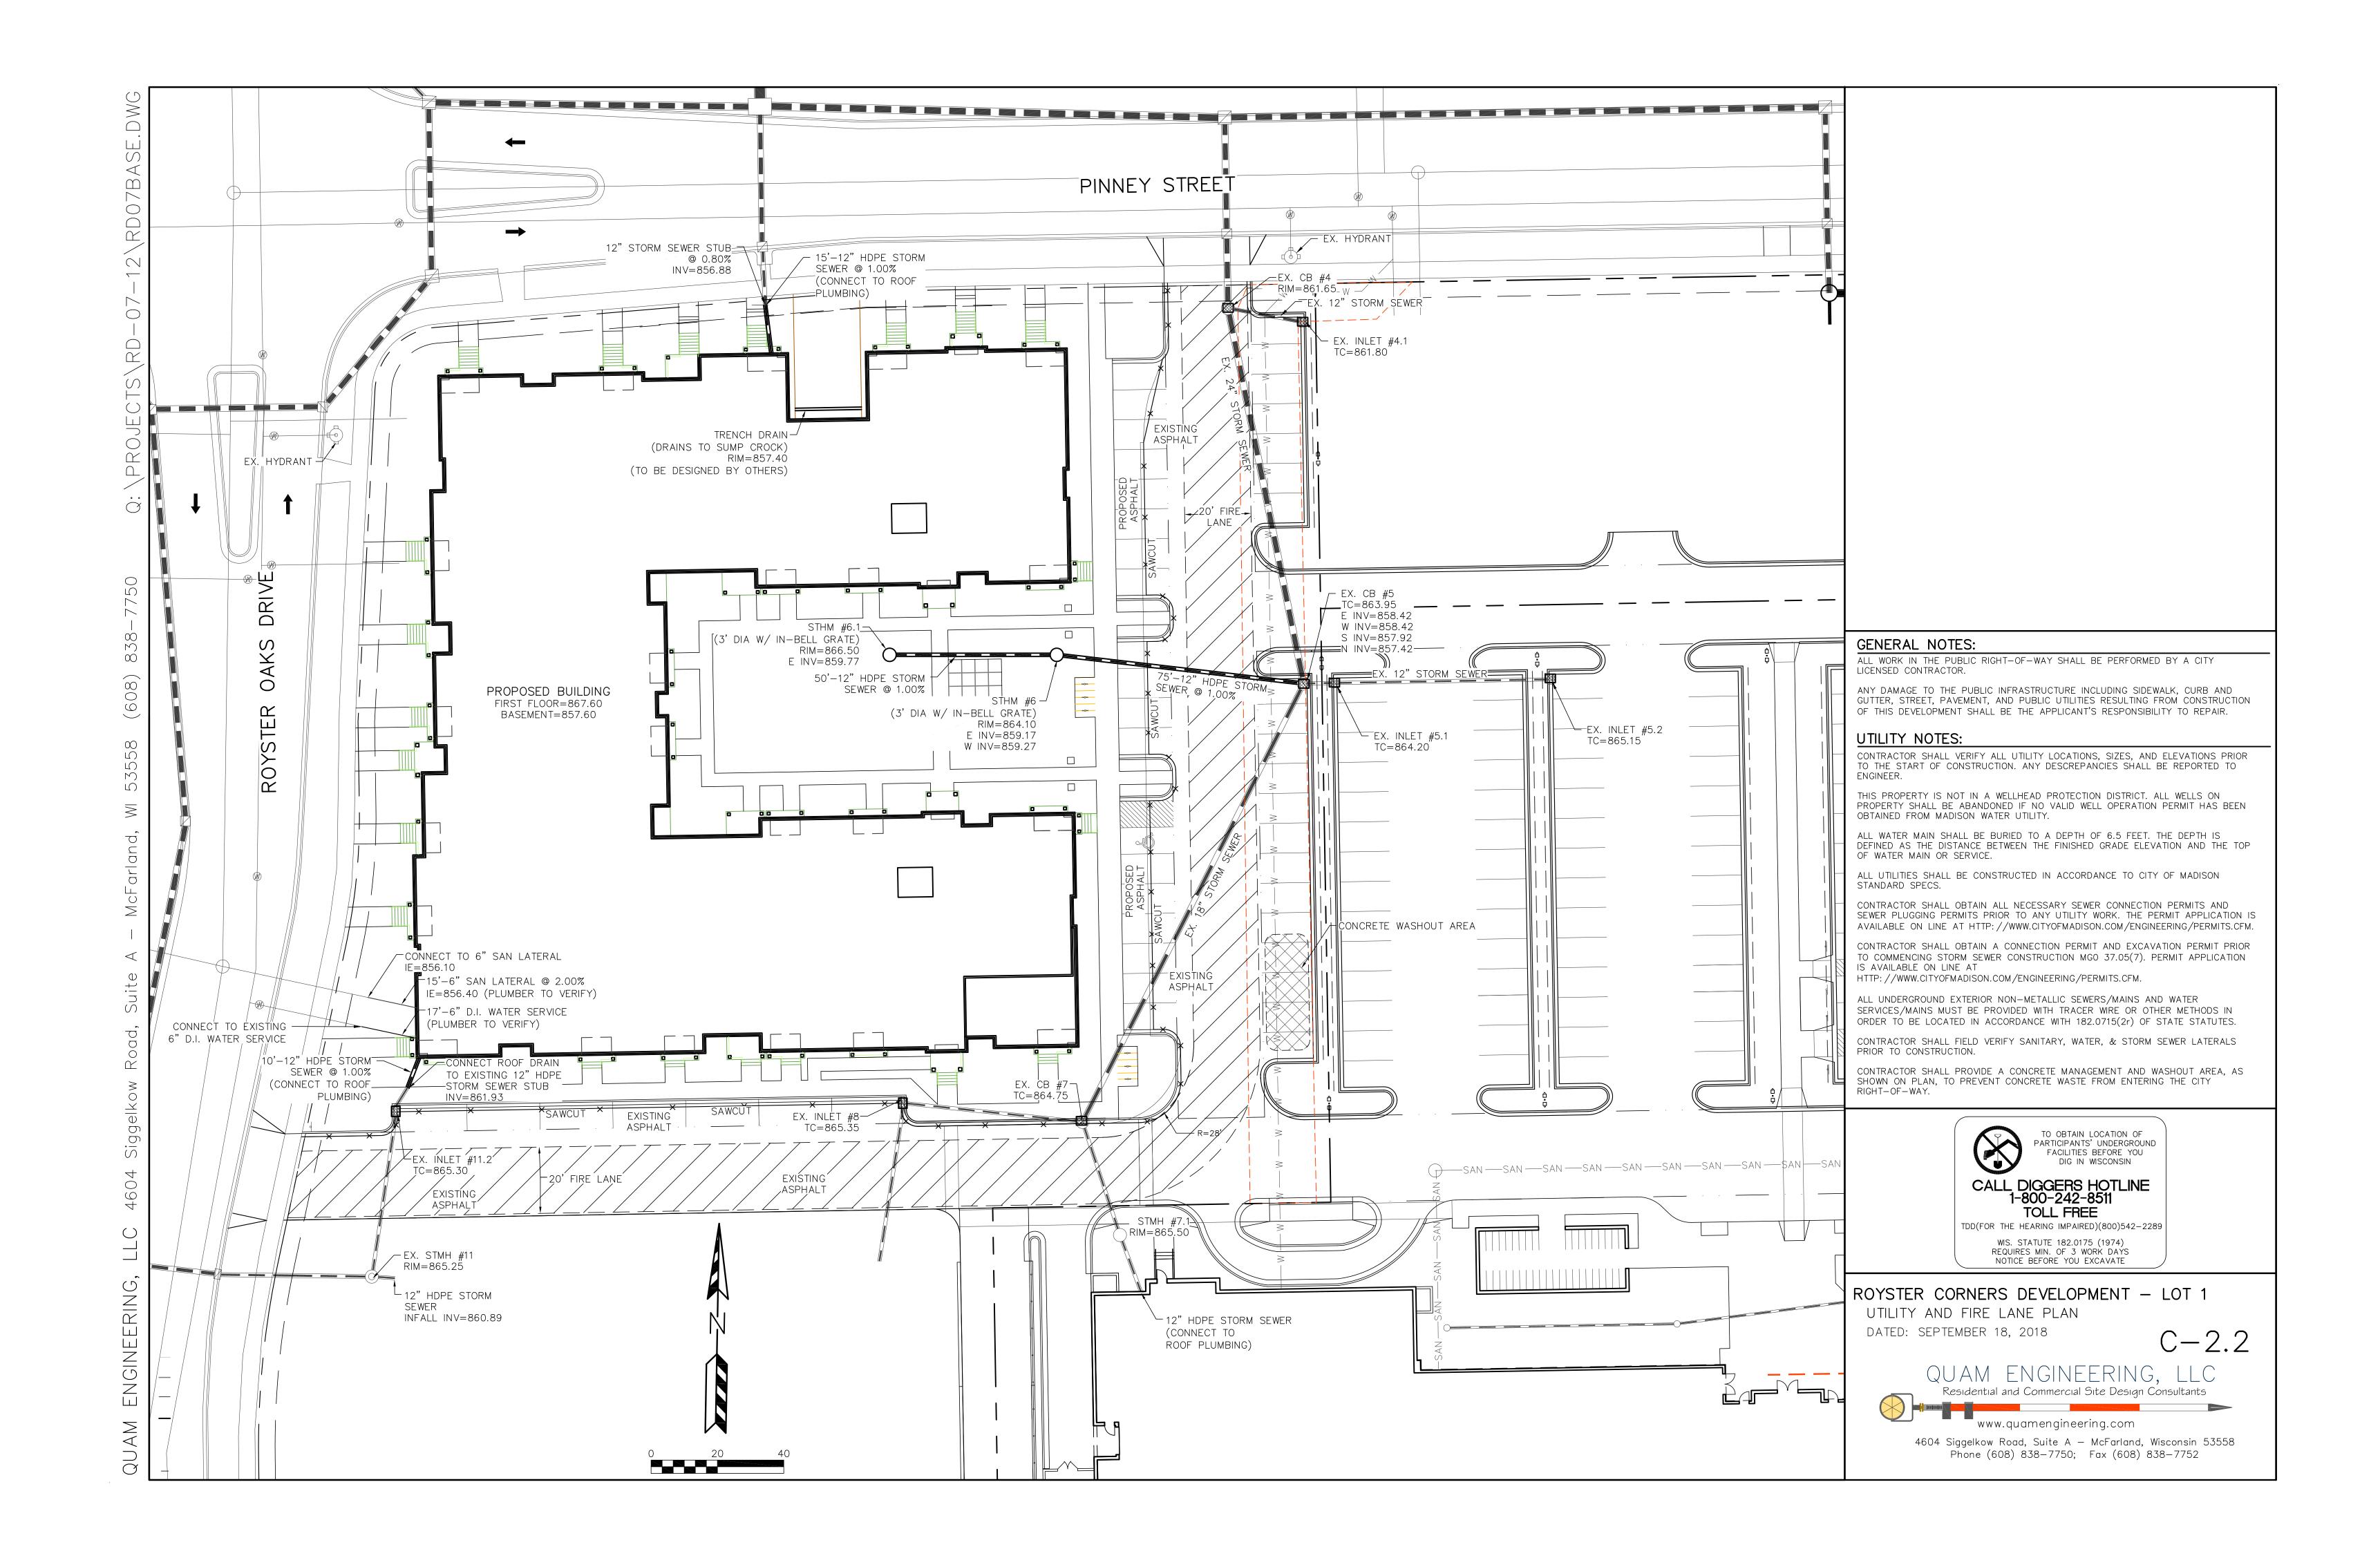
Lot Coverage Plan

SHEET NUMBER

C-1.5

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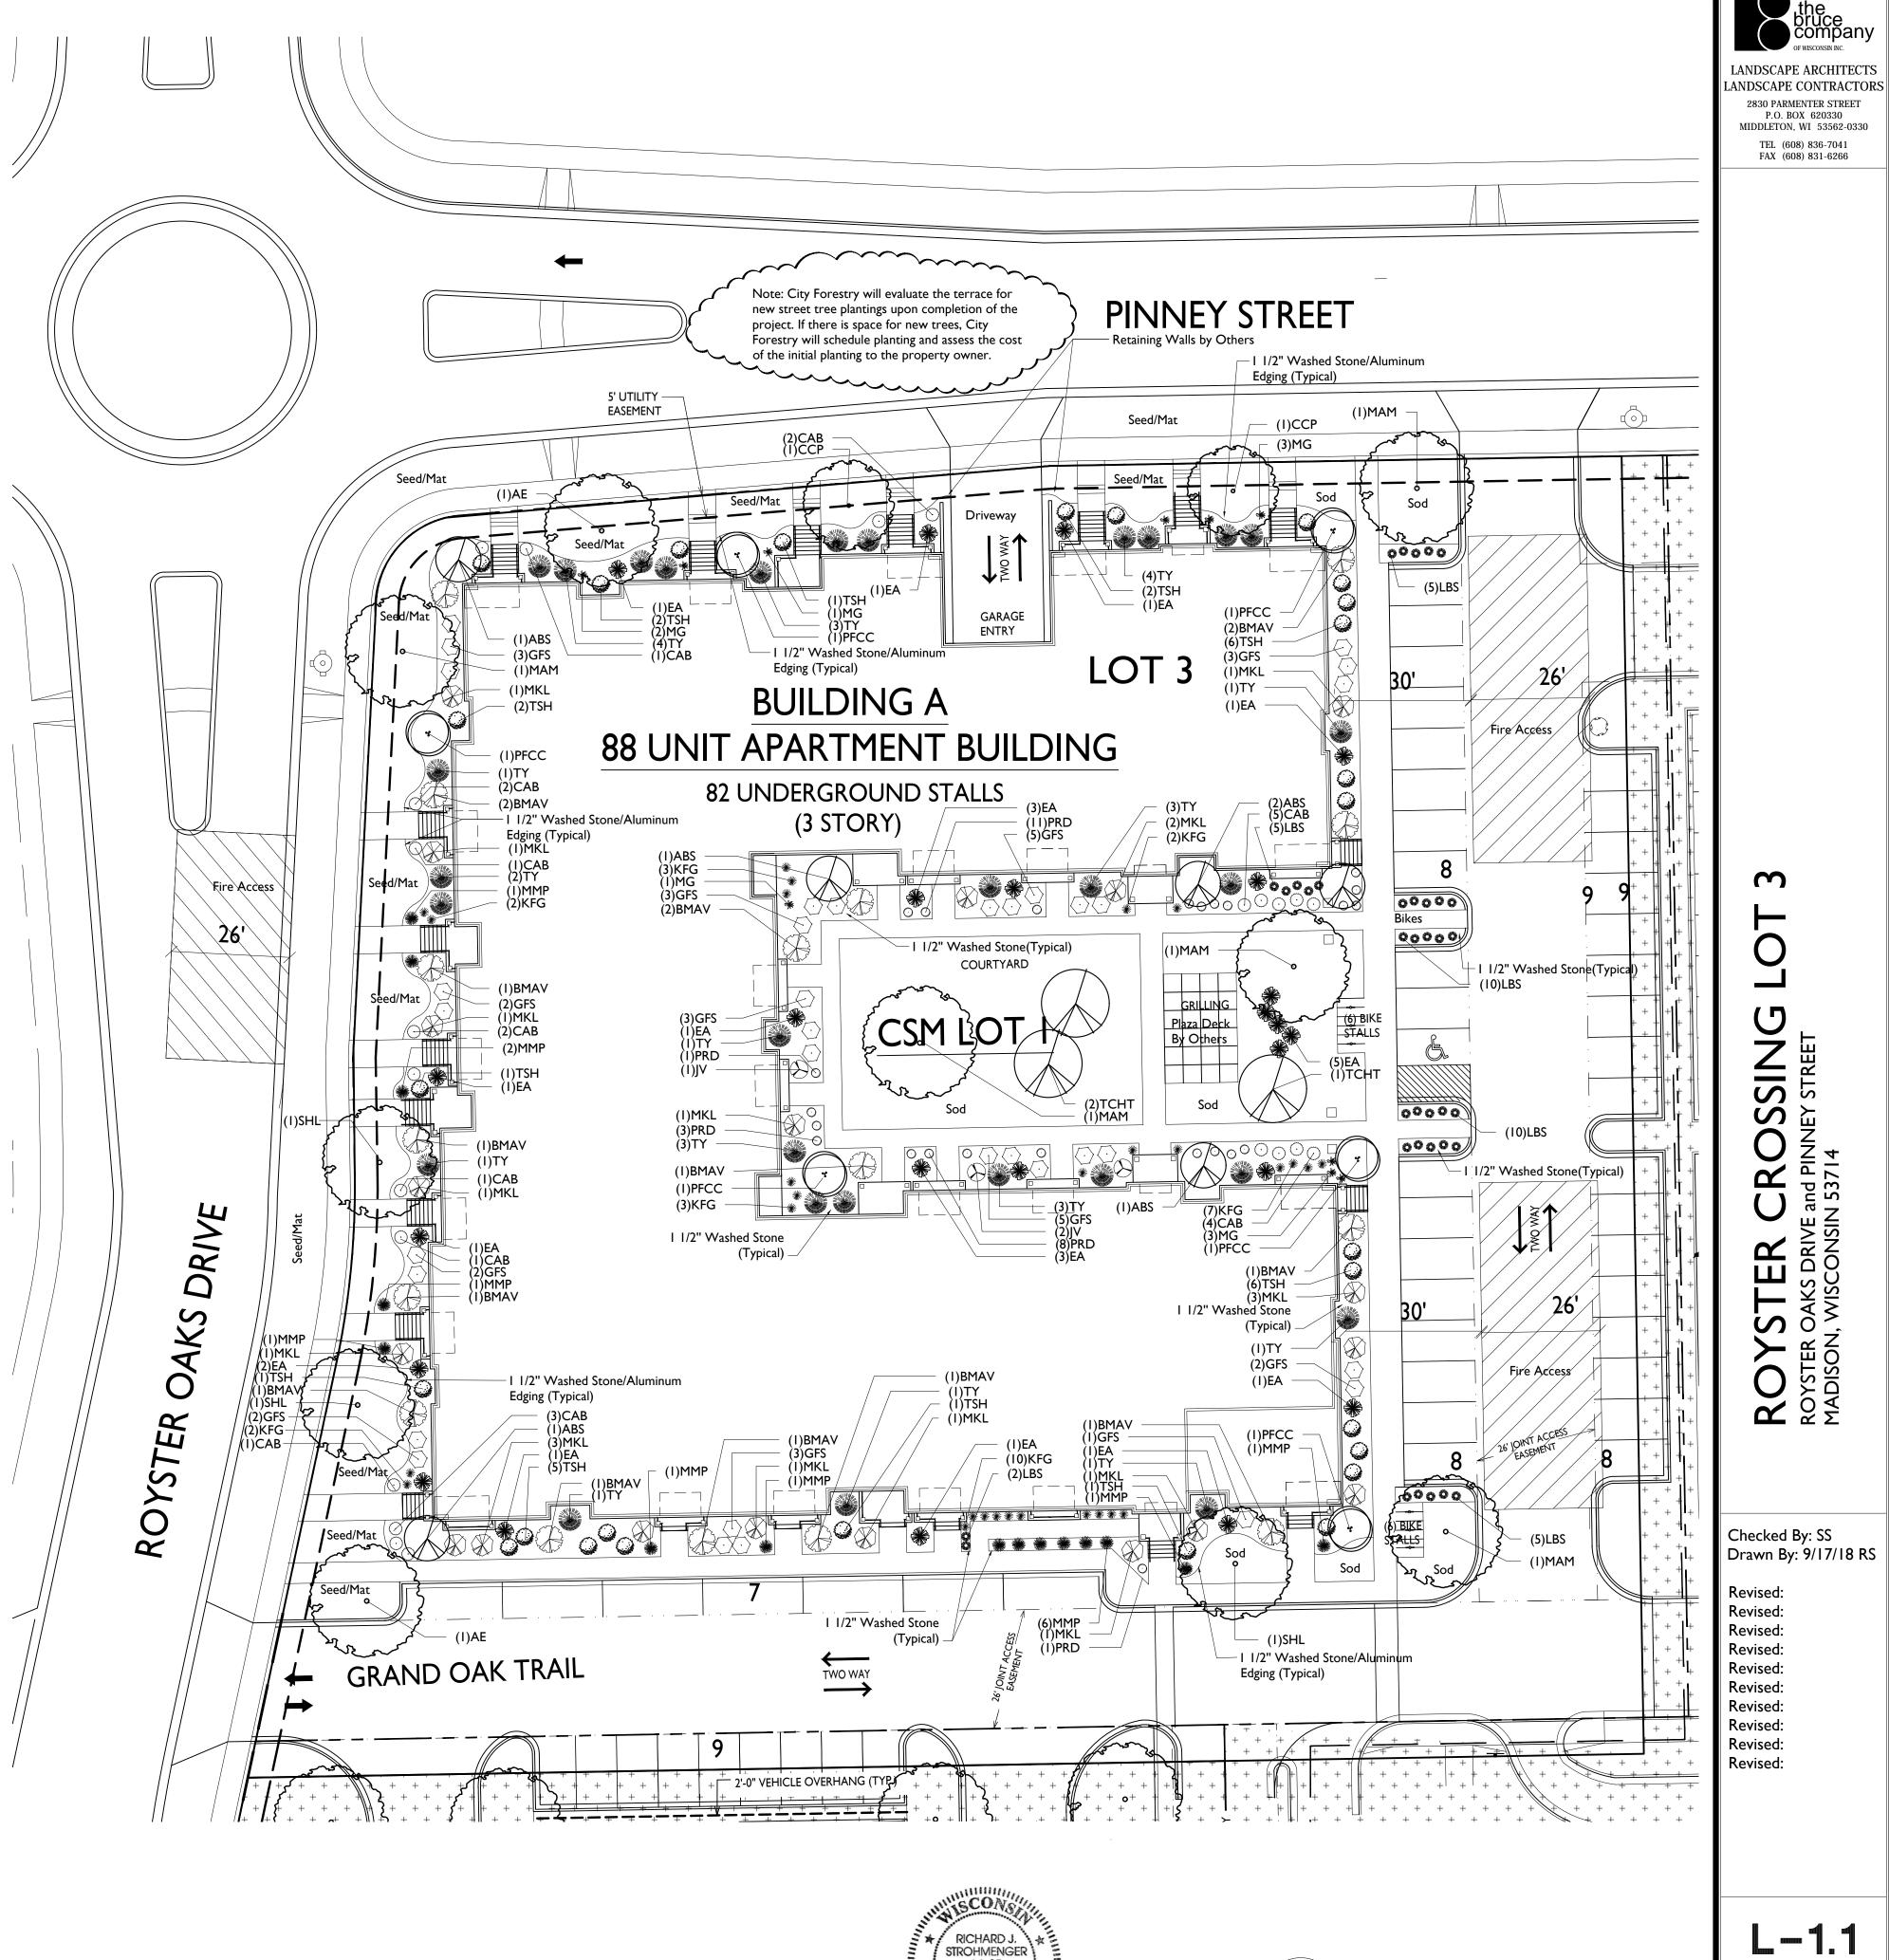


# Plant Material List

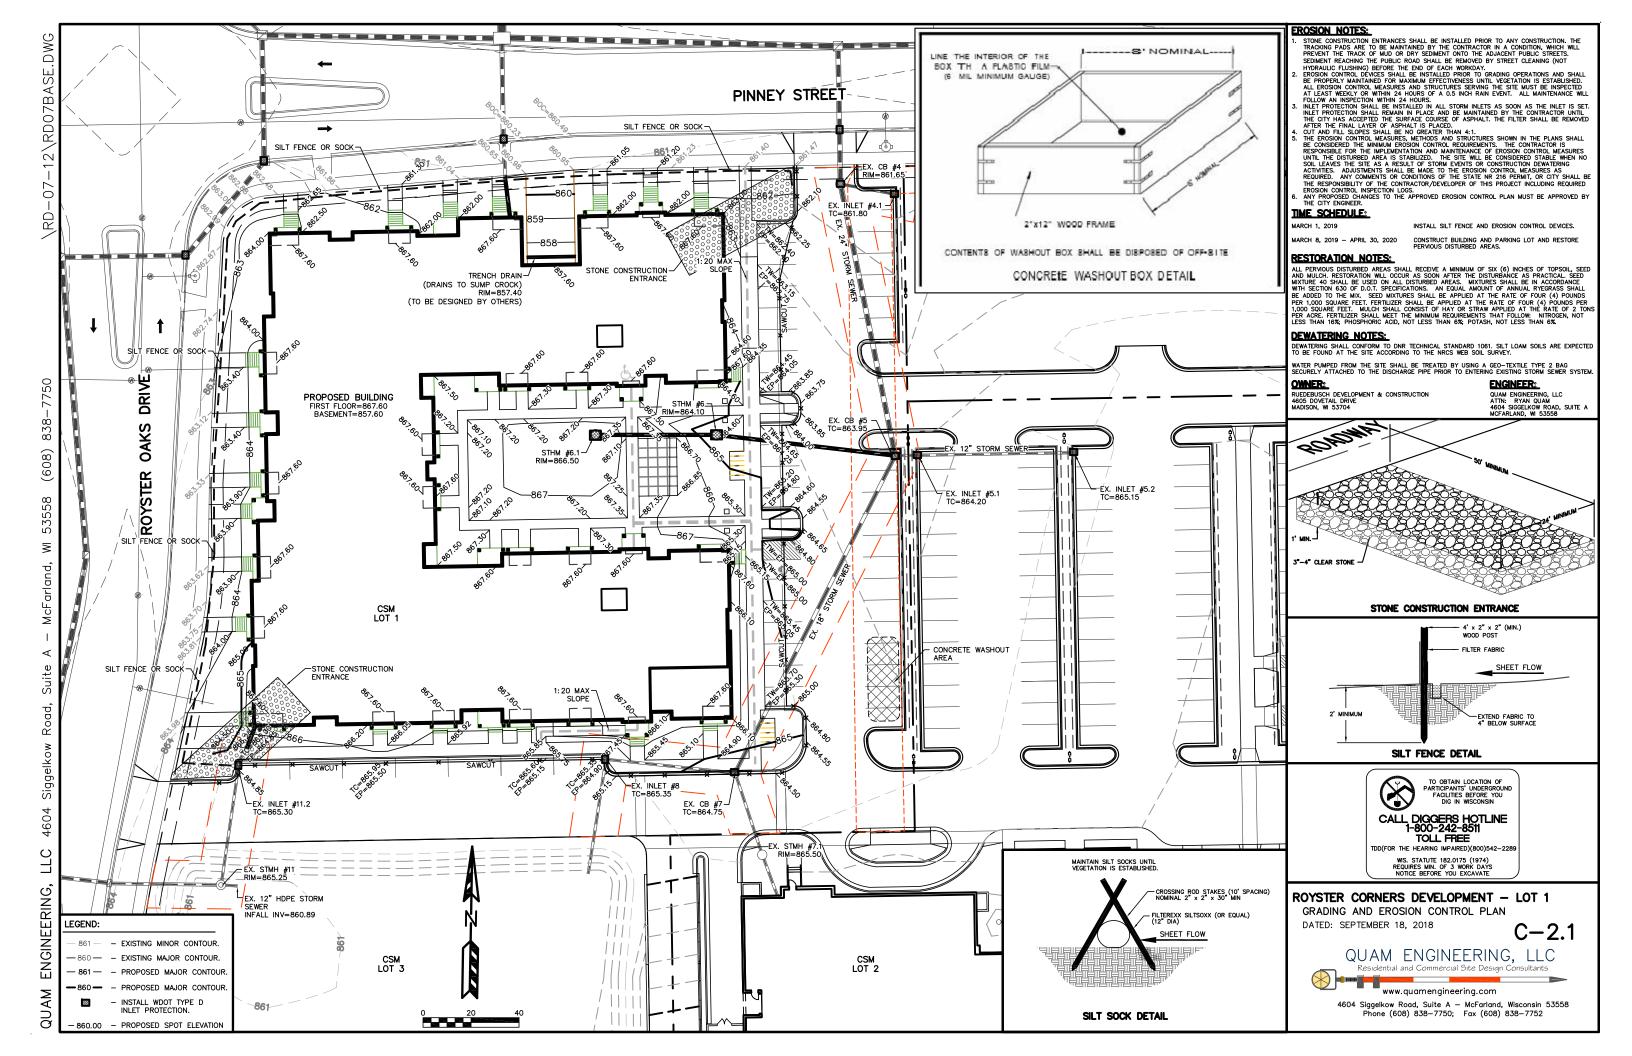Broadleaf De	ciduous				
Quantity	Code Name	Common Name	Scientific Name	Planting Size	
5	MAM	Marmo Maple	Acer X Freemanii 'marmo'	2 I/2" B&B	
6	ABS	Autumn Brill Serviceberry	Amelanchier X Grand 'autumn Brill'	6' B&B	
3	TCHT	Thnls Cockspur Hawthorn (tf)	Crataegus Crus-Galli Var Iner (tf)	2" B&B	
3	SHL	Skyline Thnls Honeylocust	Gleditsia Triacan Iner 'skycole'	2 I/2" B&B	
6	PFCC	Prairifire Crabapple (clp)	Malus 'prairifire' (clp)	6' B&B	
2	CCP	Chanticleer Callery Pear	Pyrus Calleryana 'chanticleer'	2" B&B	
2	AE	Accolade Elm	Ulmus Japonica X Wilsoniana 'morton'	2 I/2" B&B	
Conifer Everg	green				
Quantity	Code Name	Common Name	Scientific Name	Planting Size	
15	MMP	Mops Mugo Pine	Pinus Mugo 'mops'	#3 CONT.	
30	TY	Taunton Yew	Taxus X Media 'tauntonii'	18" B&B	
24	EA	Emerald Arborvitae	Thuja Occidentalis 'smaragd'	4' B&B	
Perennial					
Quantity	Code Name	Common Name	Scientific Name	Planting Size	
29	KFG	Karl Foerster's Feather Reed Grass	Calamagrostis Acutiflora 'karl Foerster'	#I CONT.	
10	MG	Maiden Grass	Miscanthus Sinensis 'gracillimus'	#I CONT.	
37	LBS	Little Bluestem	Schizachyrium Scoparium	#I CONT.	
24	PRD	Prairie Dropseed	Sporobolus Heterolepis	#I CONT.	
Shrub					
Quantity	Code Name	Common Name	Scientific Name	Planting Size	
23	CAB	Cabernet Barberry	Berberis Thunb Atrop 'moretti Select'	#2 CONT.	
28	TSH	Twist-N-Shout Hydrangea	Hydrangea Macro 'piihm-I'	#5 CONT.	
34	GFS	Goldflame Spirea	Spiraea Japonica 'goldflame'	#3 CONT.	
19	MKL	Miss Kim Lilac	Syringa Pubescens Subsp. Patula 'miss Kim'	3' B&B	
16	BMAV	Blue Muffin Arwd Viburnum	Viburnum Dentatum 'christom'	#5 CONT.	
3	JV	Judd Viburnum	Viburnum X Juddii	24" B&B	

# **GENERAL NOTES**

- A) Individual trees (and shrub groupings) found along perimeter of property as well as those found within lawn areas to receive wood mulch rings (and wood mulch beds) consisting of a mixture of recycled wood mulch, colored brown, spread to a minimum 3" depth (3' wide beds for shrub groupings).
- B) "Aluminum Edging" to be Curv-rite aluminum edging colored black or equivalent.
- C) Areas labeled "washed stone" to receive I-I/2" washed stone spread to a 3" depth over fabric weed barrier.
- D) "Seed" areas shall be finish-graded and seeded at a rate of 4 lbs. per 1,000 sq. ft.
- E) Seed shall consist of the following mixture:
  - 10% Palmer IV Perennial Ryegrass
  - 20% Dragon Kentucky Bluegrass
  - 20% Diva Kentucky Bluegrass
  - 20% Foxy II Creeping Red Fescue 15% Vail II Perennial Ryegrass
  - 15% Ginney Kentucky Bluegrass
- F) Areas labeled "Seed/Mat" shall be seeded with the above-noted premium lawn seed mixture and overlaid with DS75 straw erosion control netting that is then pegged into the soil with metal staples.
- G) Areas labeled "Sod" shall receive only No. I grade nursery-grown bluegrass sod.
- H) Plant beds adjacent to building foundation to be mulched with I-I/2" diameter washed stone mulch spread to a 3" depth over fabric weed barrier.
- I) There are no existing street trees at this time. City Forestry will evaluate for new street trees upon completion of the project. If there is space for new trees, City Forestry will schedule and assess the cost of the initial planting to the property owner.
- J) Contractor shall contact City Forestry (608)266-4816 at least one week prior to installing street trees to schedule inspecting the nursery stock and reviewing landscaping specifications with the landscaper.



OREGON,

P.O. BOX 620330

TEL (608) 836-7041 FAX (608) 831-6266

OS INNET

STE OAKS I

L-1.1

This plan made exclusively for the party named in the title block. It remains the property of **The Bruce** 

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SCALE: I"=20'-0"

#### MADISON LANDSCAPE WORKSHEET

Zoning district is CC-T Total square footage of developed area43,368 SF Total square footage of first 5 acres of developed area ÷ 300 square feet =145 Landscape Units Total square footage of 0 additional acres of developed area ÷ 100 square feet =0 Landscape Units
NUMBER OF LANDSCAPE POINT REQUIRED  145 Landscape Units x 5 landscape points for first 5 acres

	Point	NI	EW	EXIS	TING			
PLANT TYPE or ELEMENT	Value	Qty.	Points Achieved	Qty.	Points Achieved			
Overstory Deciduous Tree : 2-1/2" (dbh)	35	12	420					
Tall Evergreen Tree : 5-6 feet tall	35							
Ornamental Tree : I-I/2" Caliper (dbh)	15	15	225					
Upright Evergreen Shrub : 3-4 feet tall	10	24	240					
Shrub, deciduous : 3 gallon / 12"-24"	3	123	369					
Shrub, evergreen : 3 gallon / 12"-24"	4	45	180					
Ornamental grass/perennial : Igallon / 8"-18"	2	100	200					
Ornamental / Decorative fencing or wall	4 per 10 l.f.							
Existing significant specimen tree	I4 per Cal. In.					TOTAL		
Landscape furniture for public seating and /or transit connections	5 per 'seat'					POINTS PROVIDED		
	Sub	Totals	1,634	+		= 1,634		

Street Frontage Landscape Required	
Street Frontage = <u>562</u> LF  Canopy Trees Required: I per 30 LF Frontage =	19
Shrubs Required : 5 per 30 LF Frontage =	
Street Frontage Landscape Supplied	
Proposed Canopy Trees	19.5
Proposed Shrubs =	168





### LANDSCAPE ARCHITECTS LANDSCAPE CONTRACTORS

2830 PARMENTER STREET P.O. BOX 620330 MIDDLETON, WI 53562-0330

TEL (608) 836-7041 FAX (608) 831-6266

# ROYSTER CROSSING LOT ROYSTER OAKS DRIVE and PINNEY STREET MADISON, WISCONSIN 53714

Checked By: SS Drawn By: 9/17/18 RS

Revised: Revised: Revised: Revised: Revised:

Revised: Revised: Revised:


Revised: Revised: Revised:

Revised: Revised:

L-2.1

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VE SHORTIROYSTER LOT 3/ROYSTER LOT 3 18CLIDWG Created: 8/27/2018, Saved: 9/17/2018, Printed: 9/17/2018



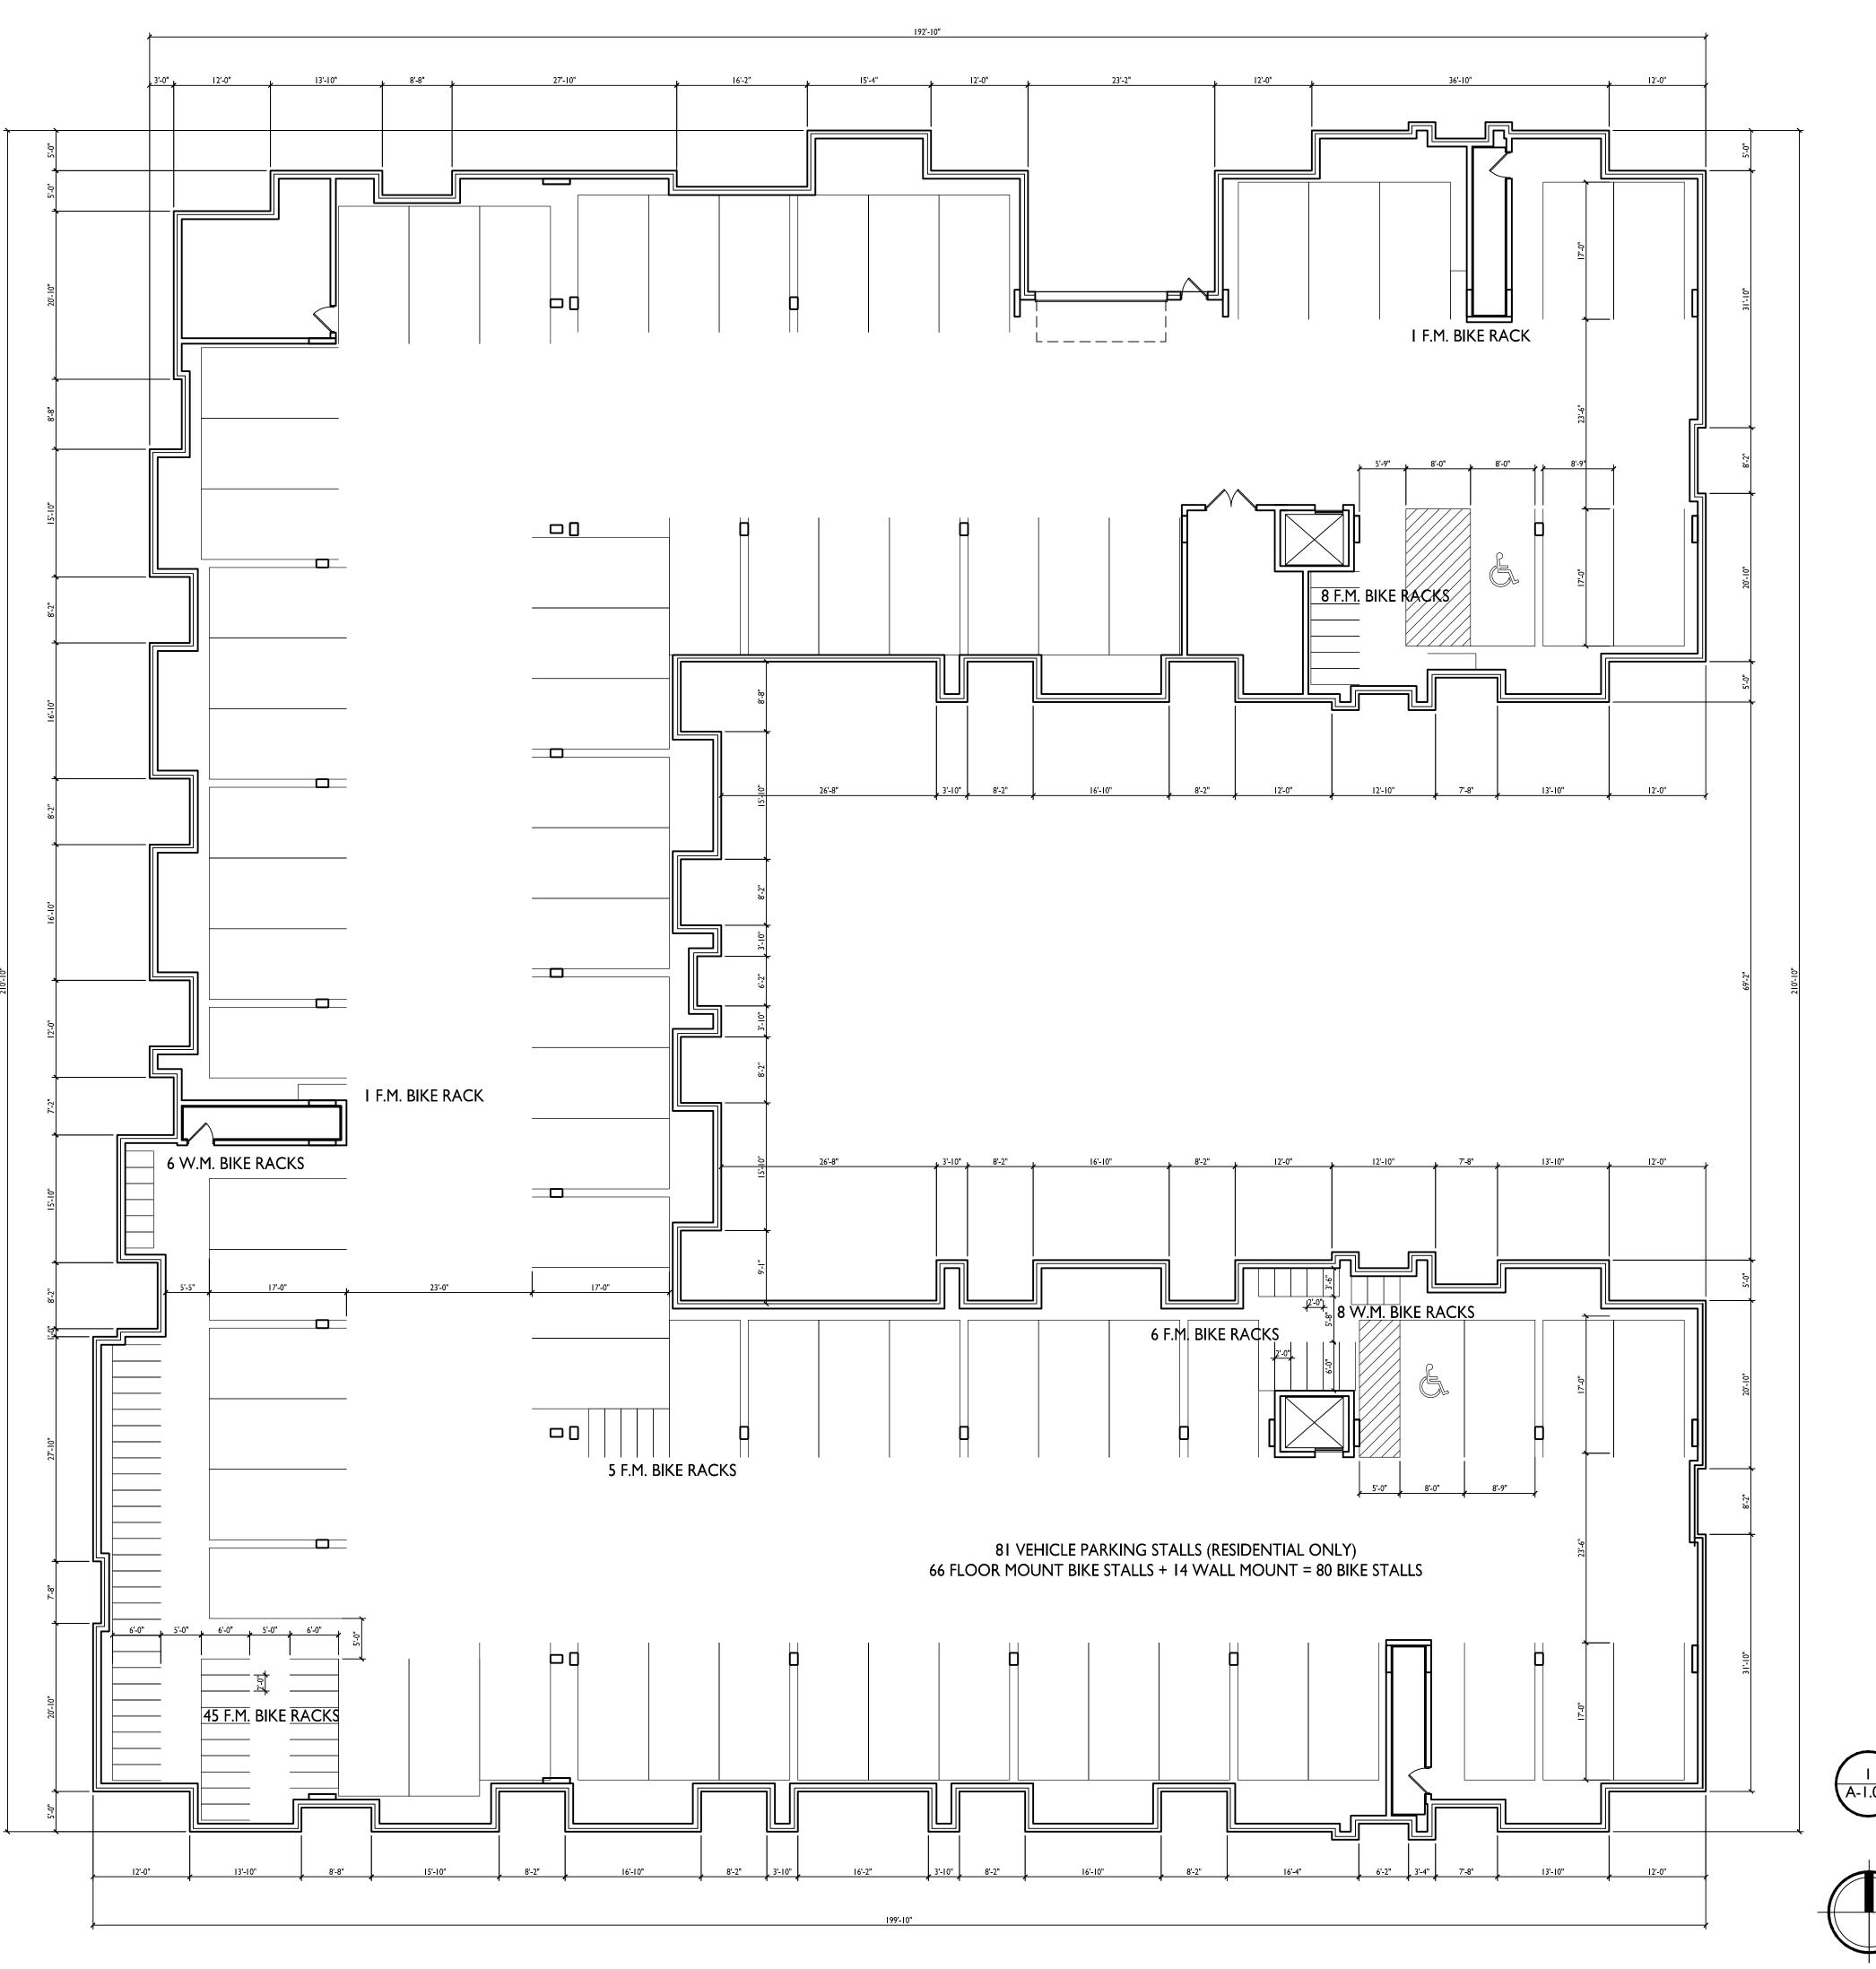

ISSUED

Issued for Land Use - Sept. 19, 2018

Royster Crossing
Lot I of CSM
14166

515 Pinney Street

SHEET TITLE

Basement Floor Plan


BASEMENT FLOOR PLAN


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A-1.0


PROJECT NO.


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Royster Crossing Lot 1 of CSM



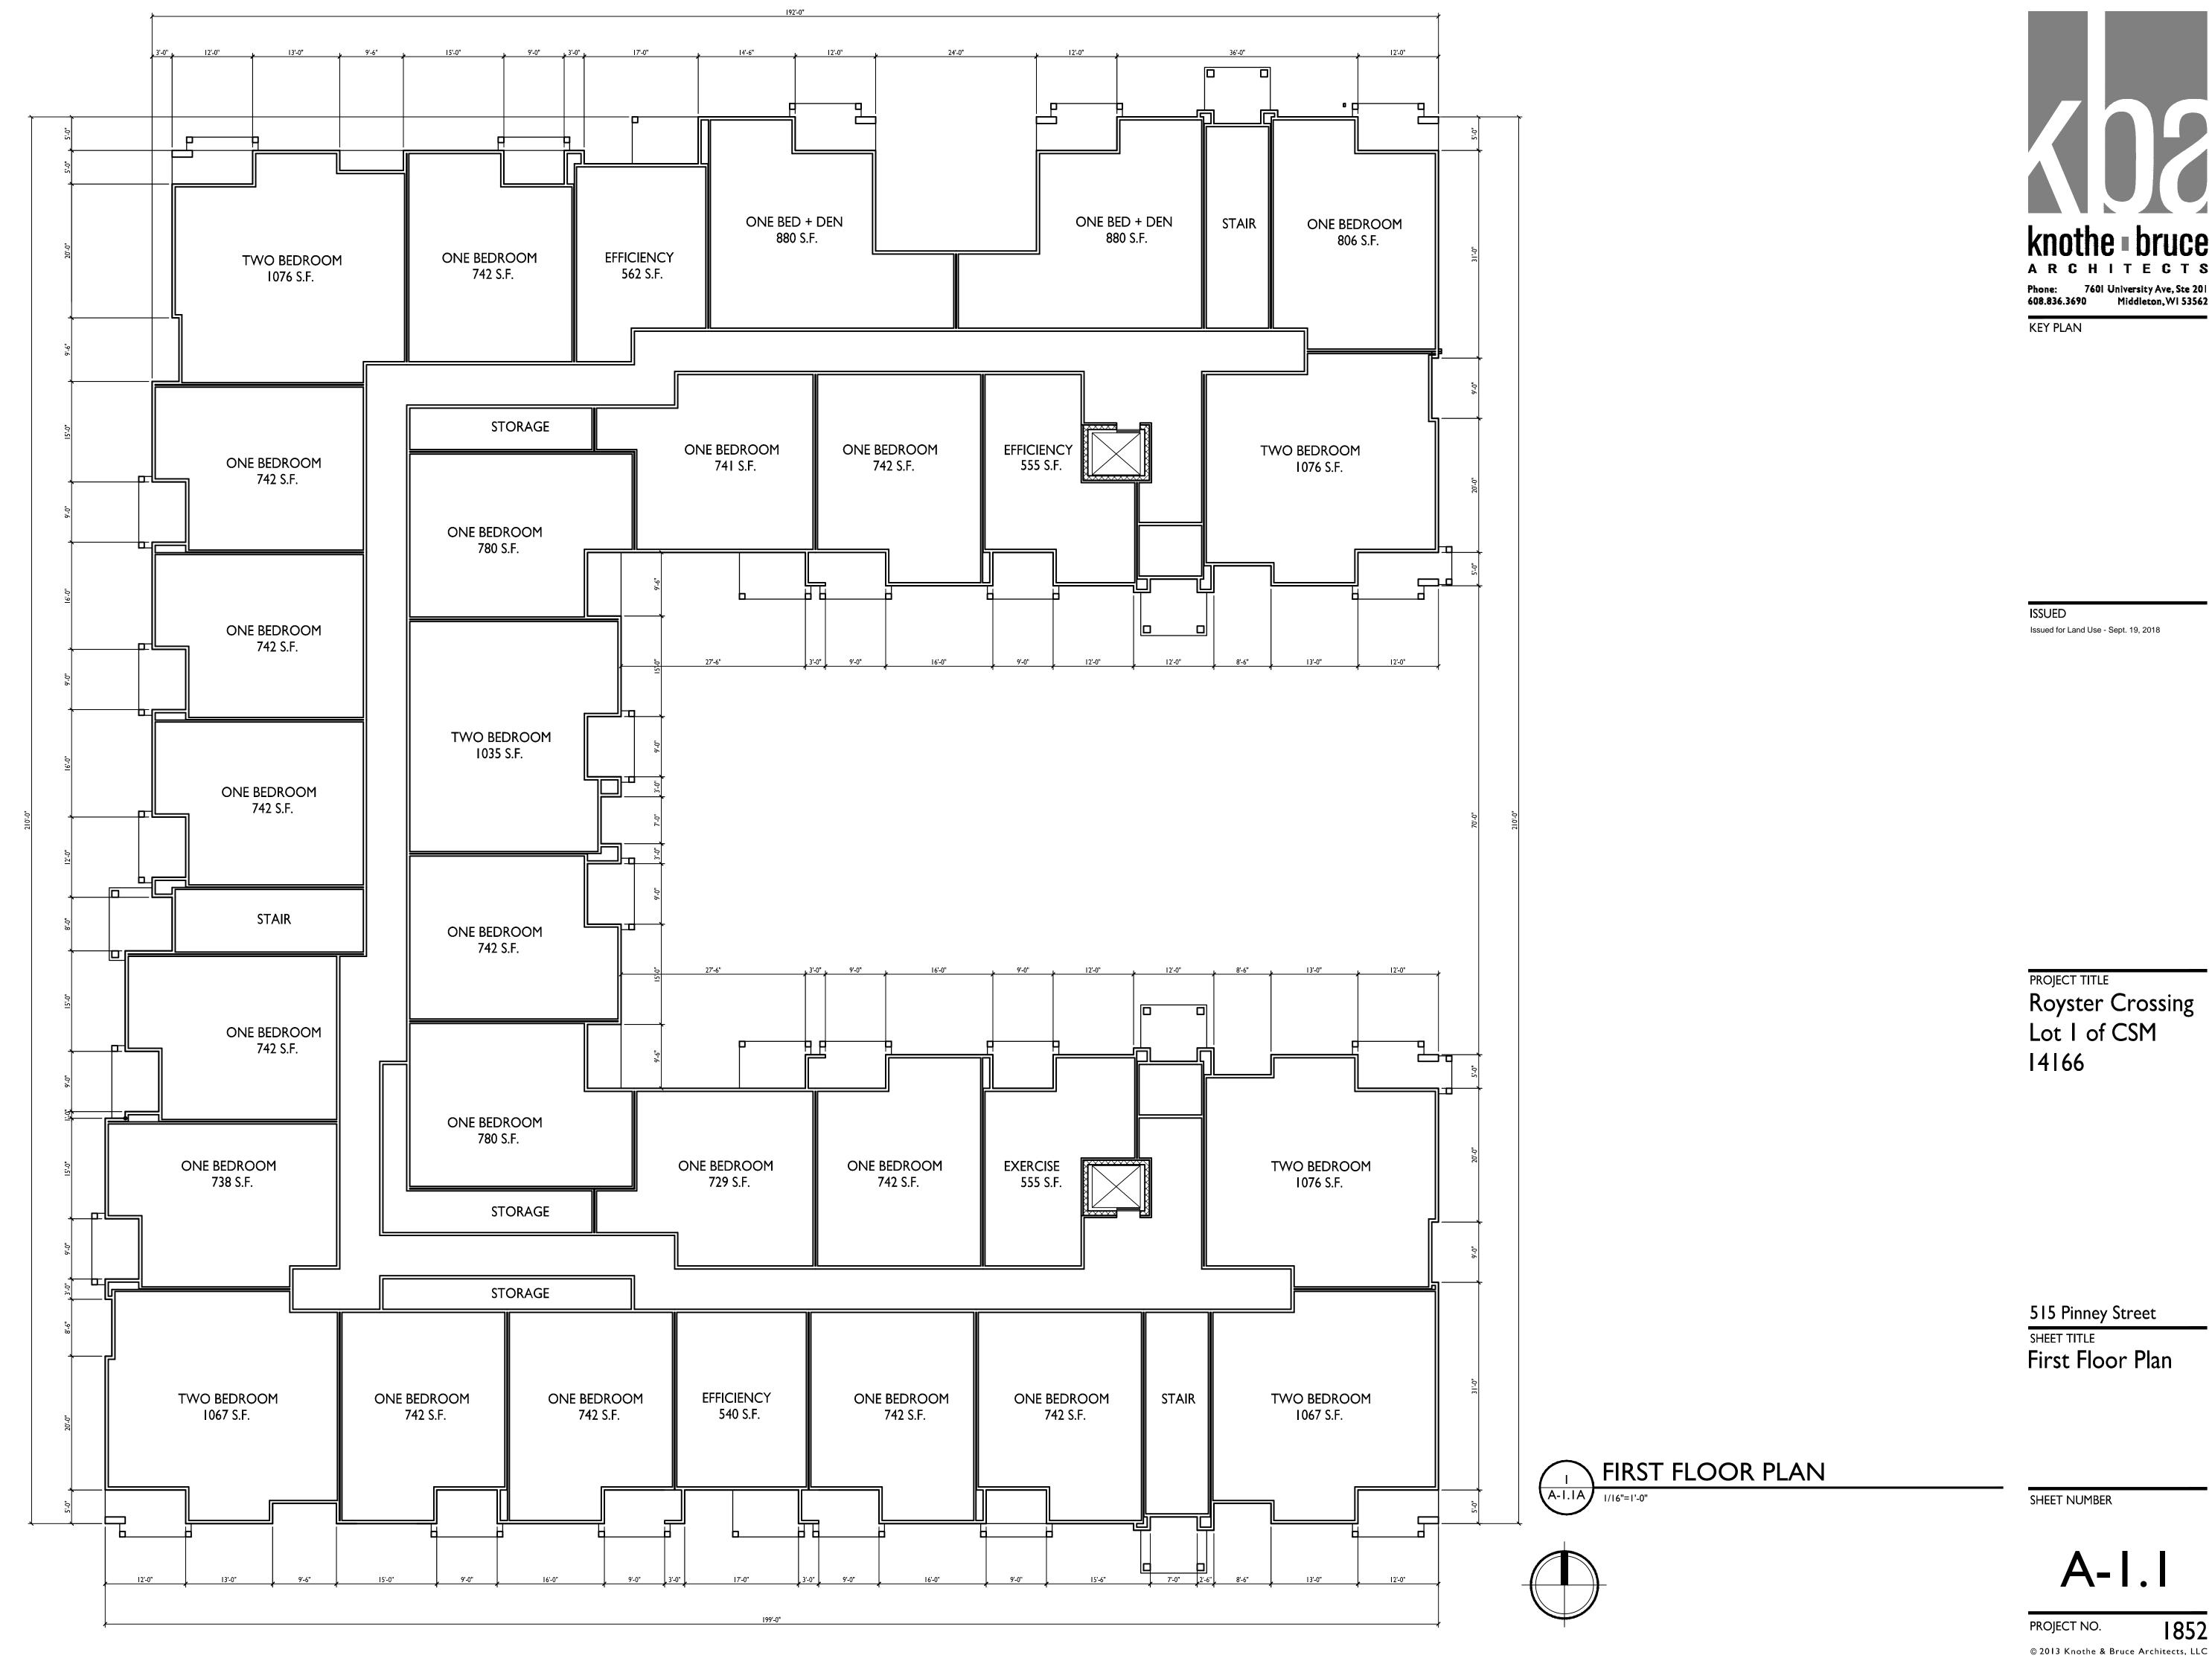
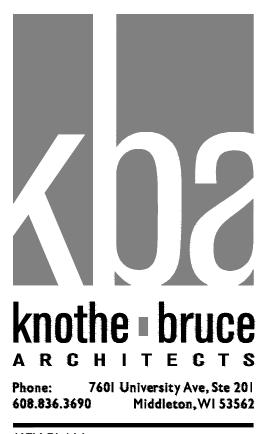
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Royster Crossing
Lot 1 of CSM
14166

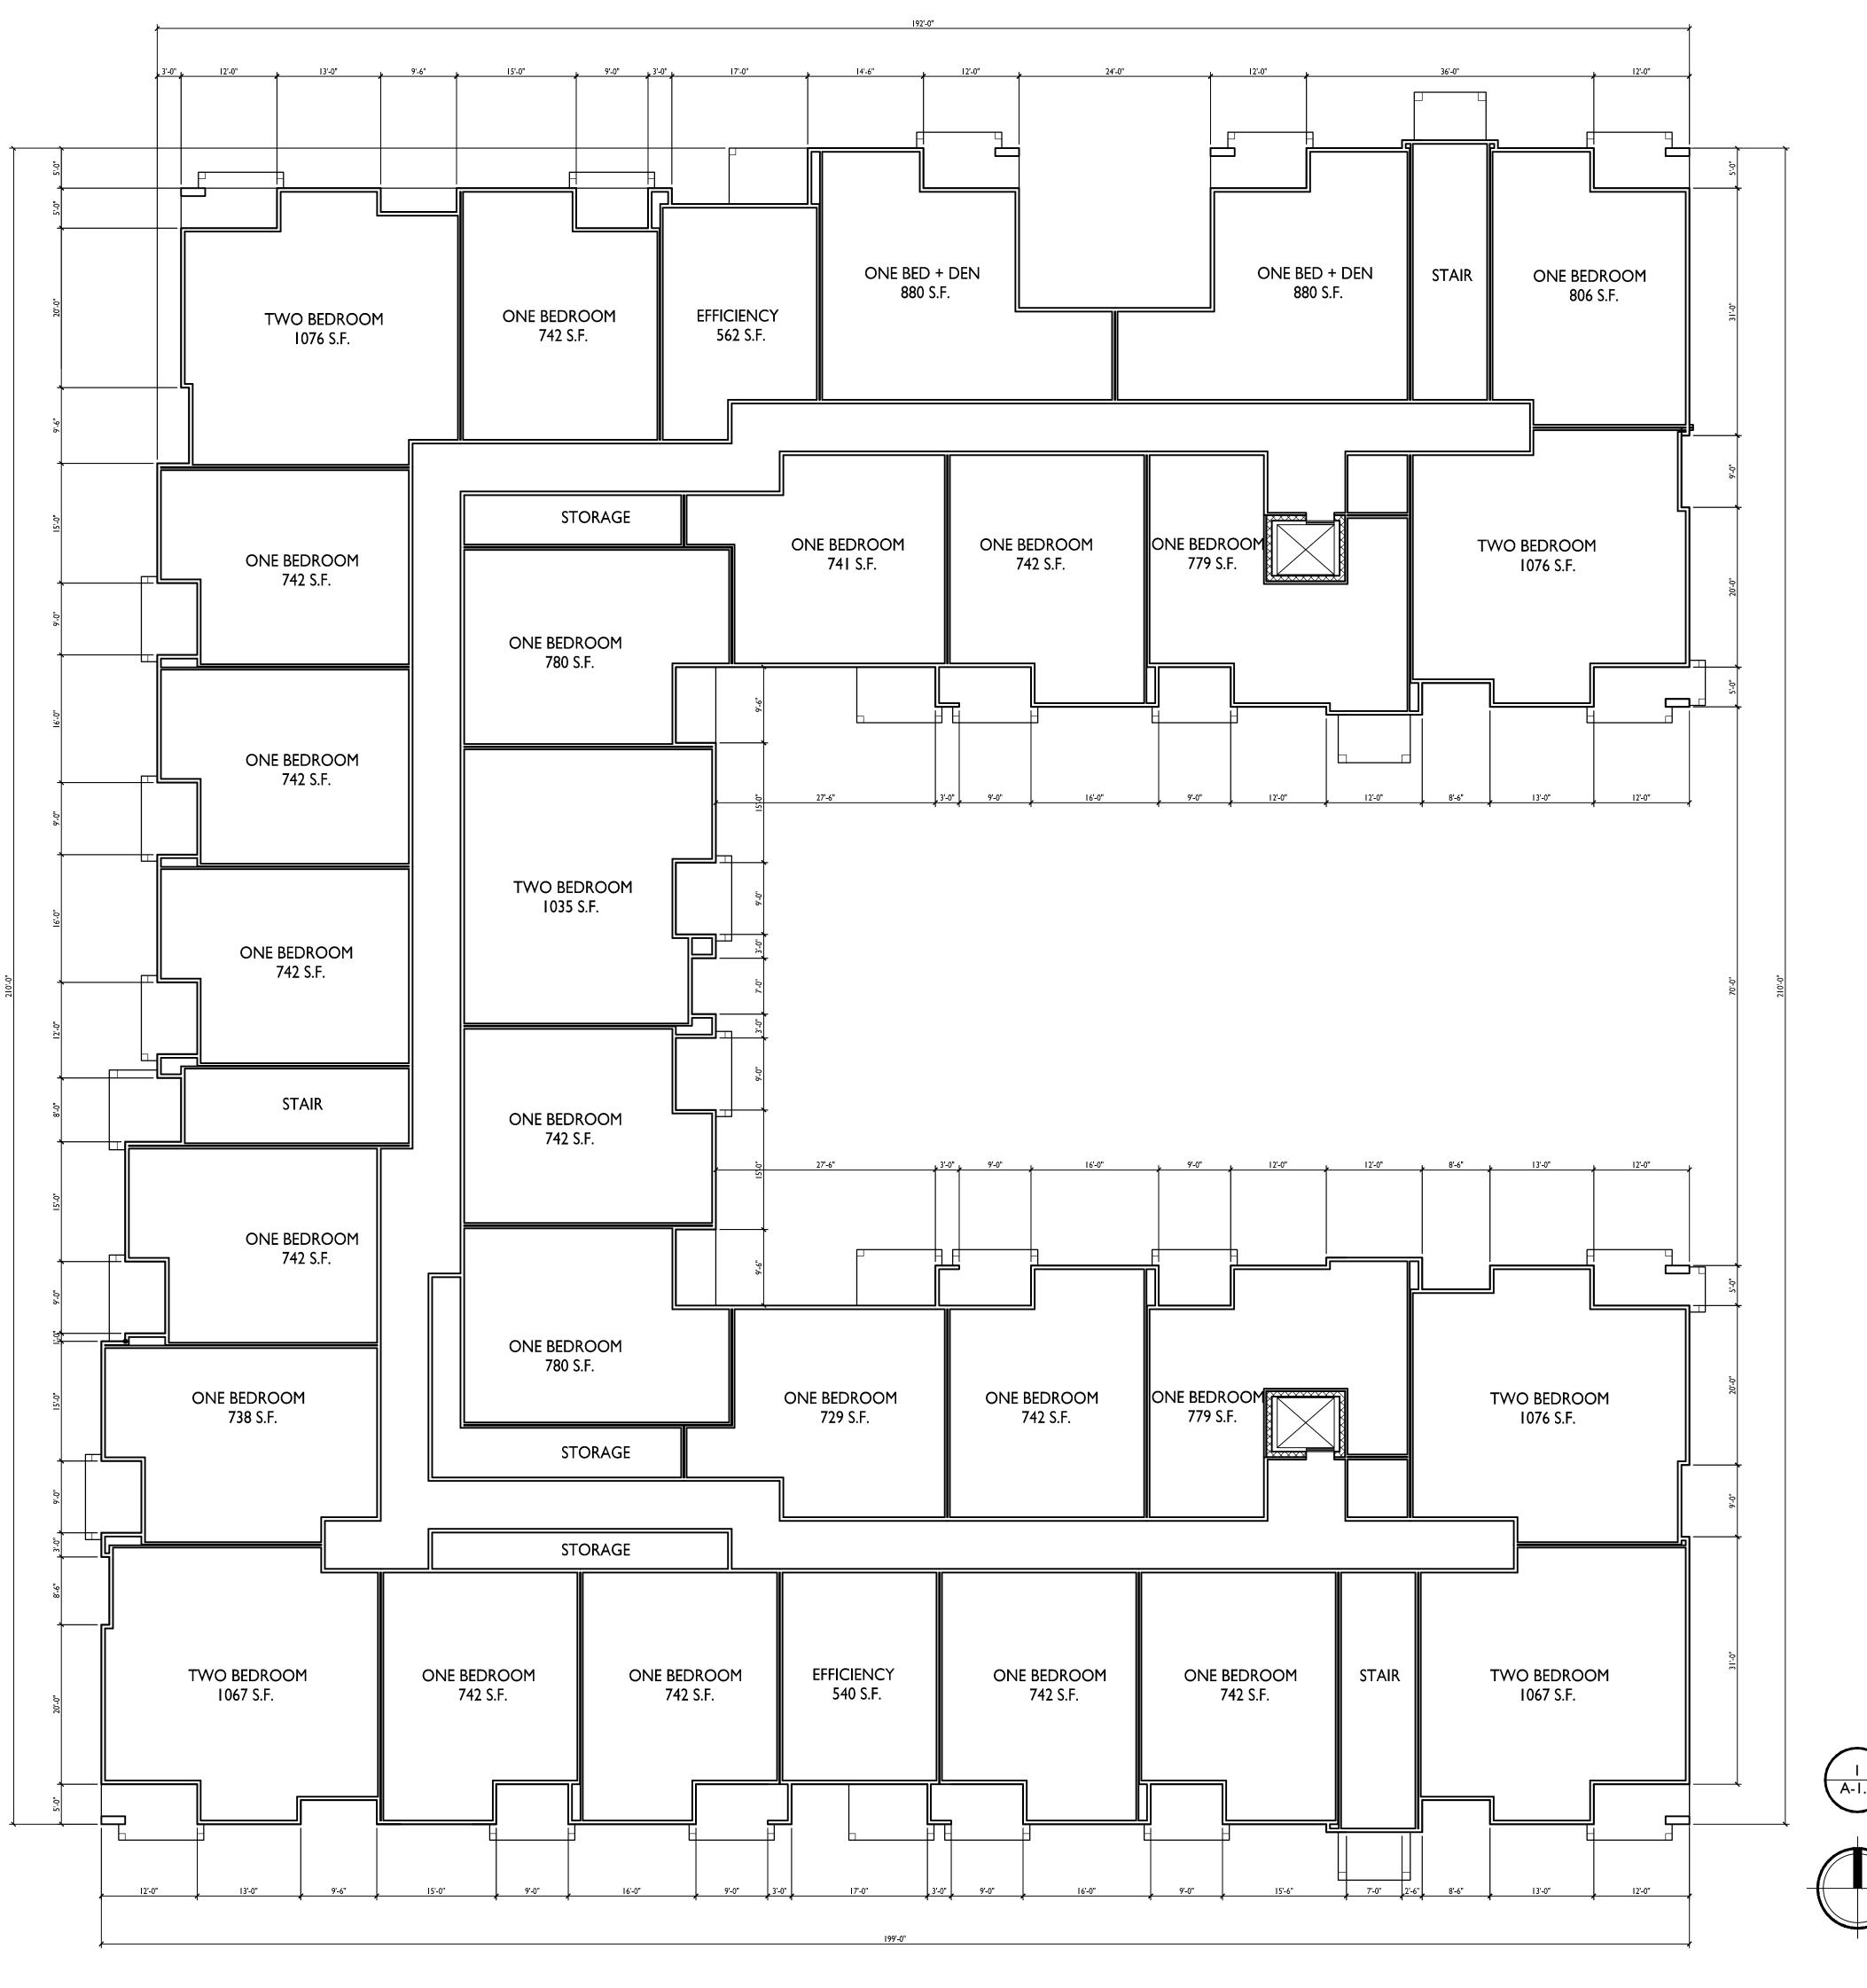515 Pinney Street

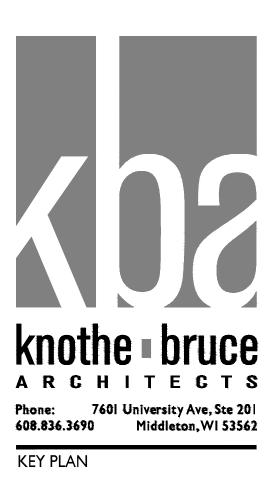SHEET TITLE

Second Floor Plan


SECOND FLOOR PLAN

SHEET NUMBER

A-1.2

PROJECT NO.

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SOUTH ELEVATION

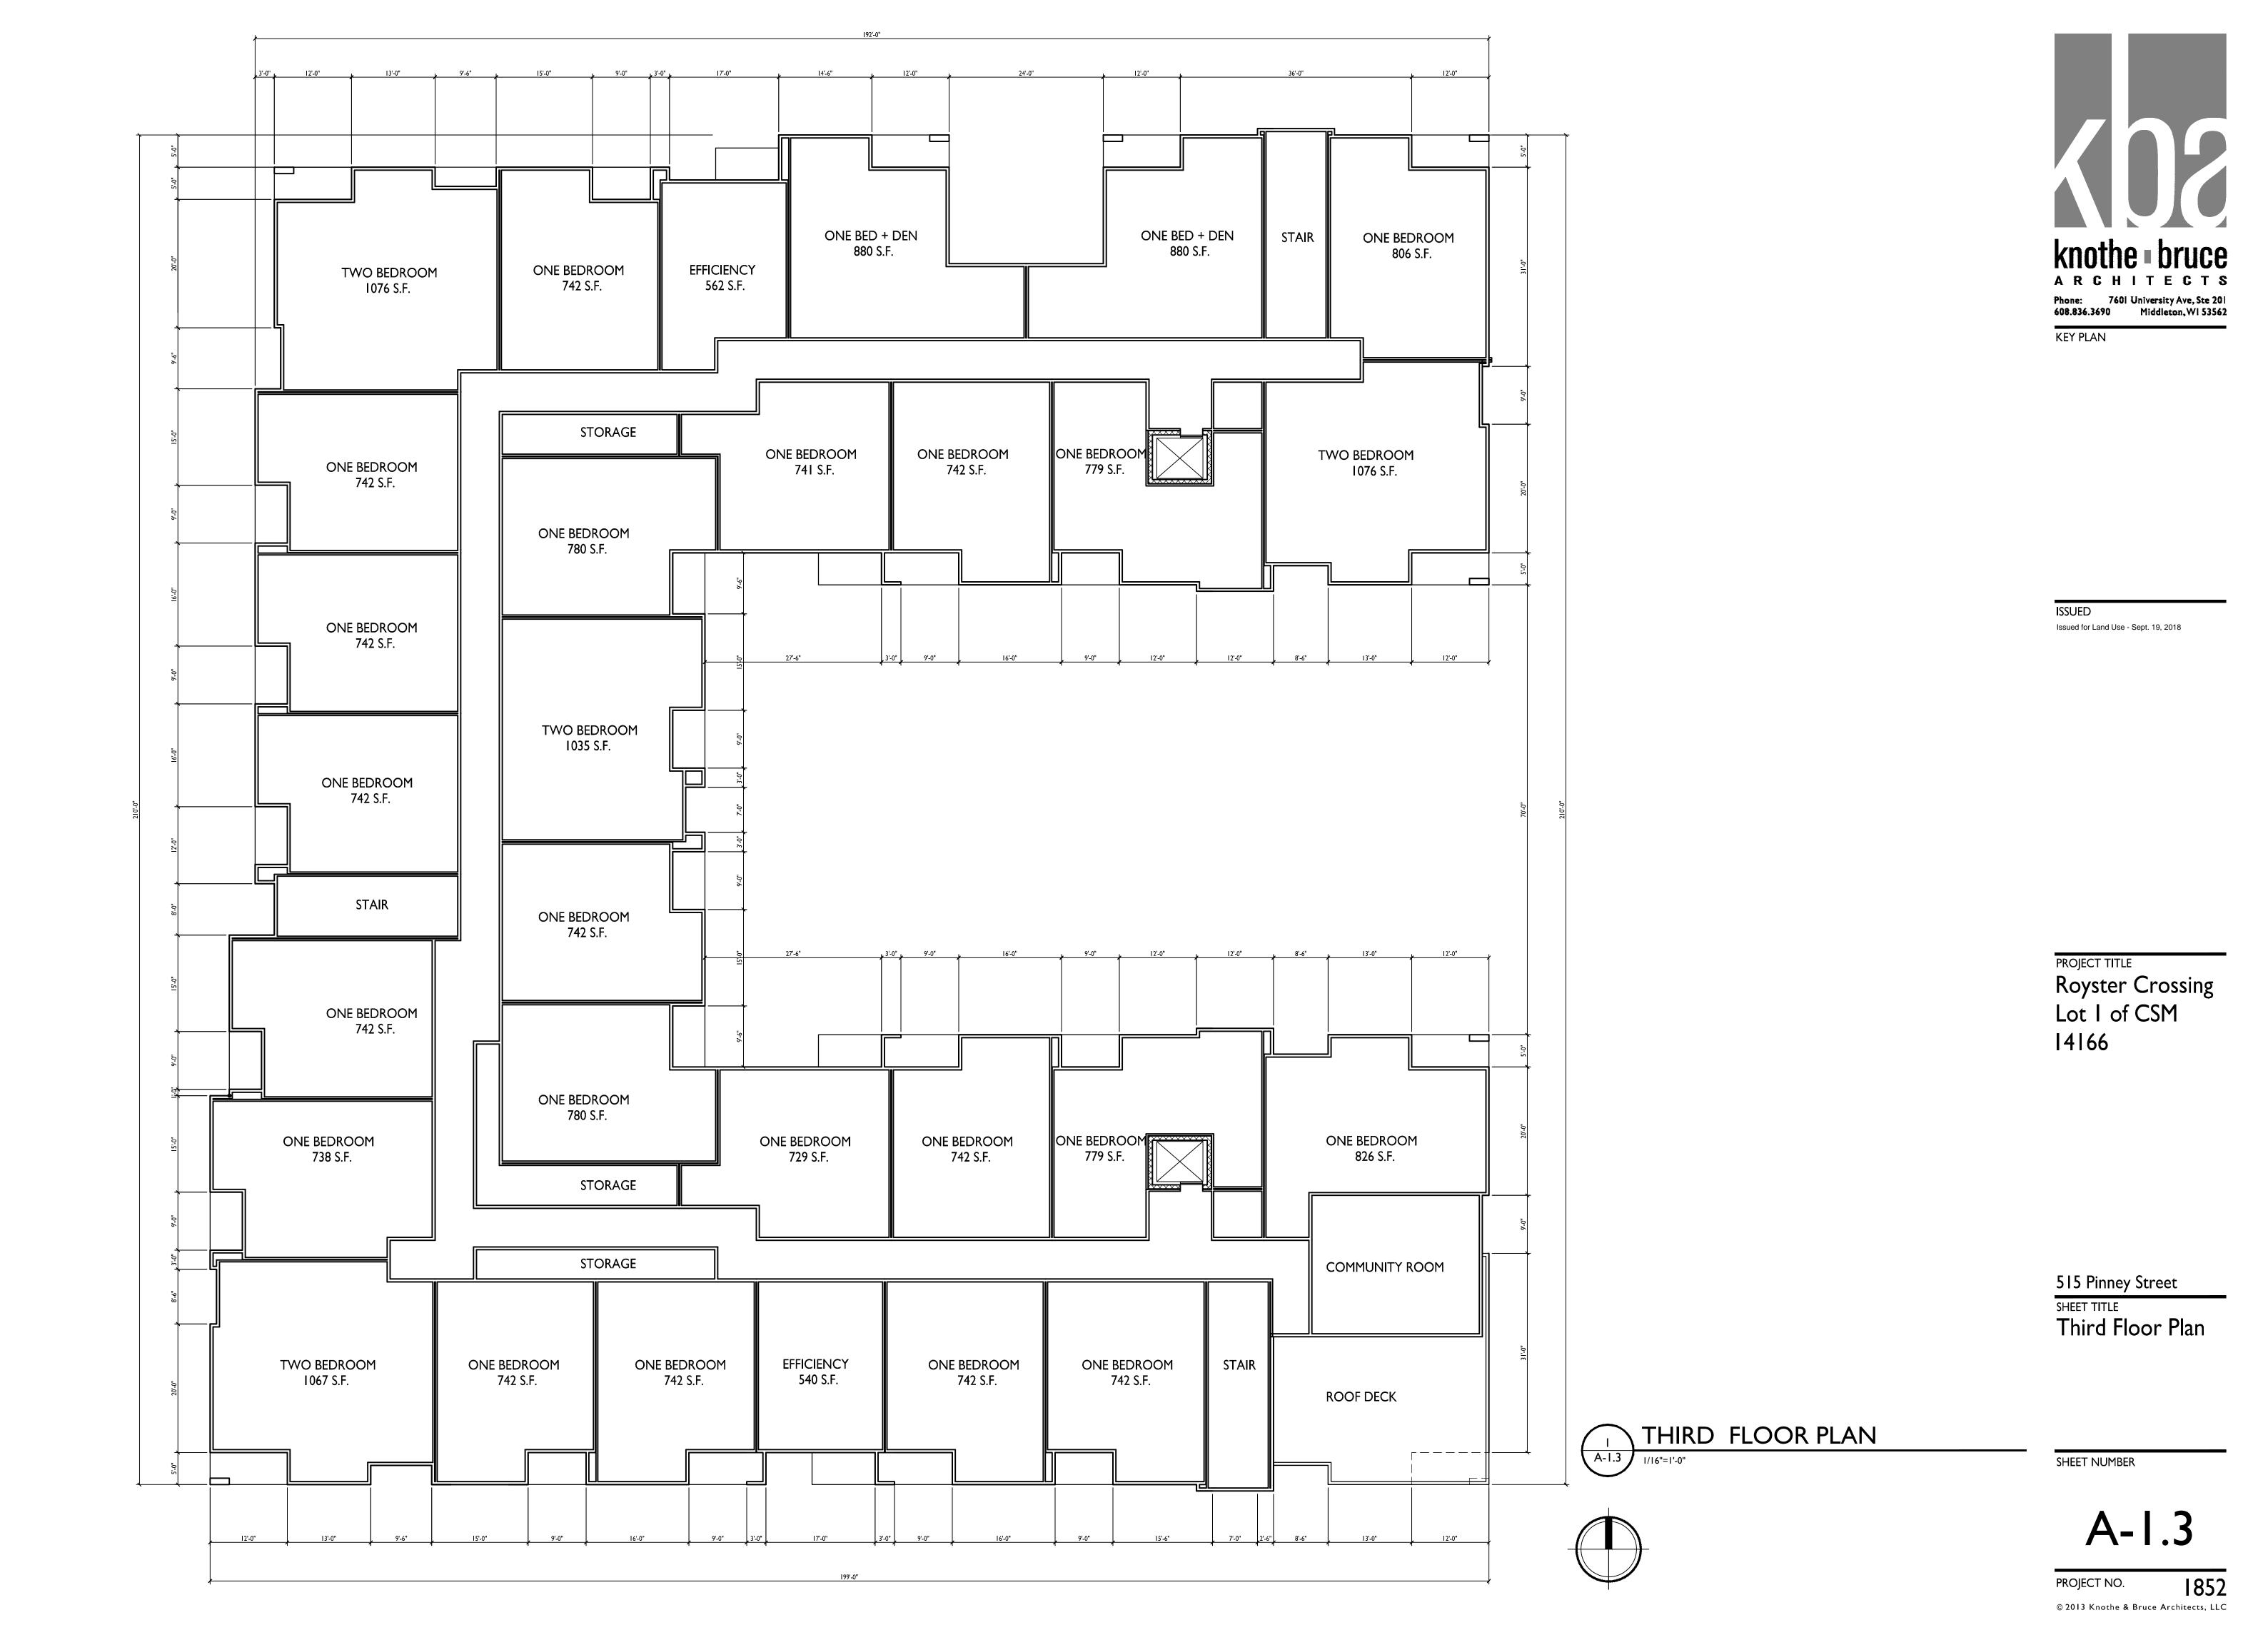I/8"=1'-0"



PROJECT TITLE
Royster Crossing
Lot I of CSM
14166

515 Pinney Street

SHEET TITLE

Elevations

SHEET NUMBER

A-2.1

PROJECT NO. 185

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WEST ELEVATION

EXTERIOR MATERIAL SCHEDULE									
BUILDING MATERIAL	MANUFACTURER	COLOR							
COMPOSITE SIDING & TRIM - A	HARDIE	SW 6123 BAGUETTE							
COMPOSITE TRIM - B	HARDIE	COBBLESTONE							
COMPOSITE TRIM - C	HARDIE	PAINT TO MATCH CORRUGATED METAL							
CORRUGATED METAL SIDING	FLYNN	PREWEATHERED GALVALUME 24 GA.							
RAILING	ALUMINUM	BLACK							
WINDOWS	VINYL	TAN							
BRICK VENEER	BORAL	CAGLES MILL KING							
PRECAST	ROCKCAST	WHEATSTONE							





Royster Crossing

PROJECT TITLE Lot I of CSM 14166



EXTERIOR MATERIAL SCHEDULE										
BUILDING MATERIAL	MANUFACTURER	COLOR								
COMPOSITE SIDING & TRIM - A	HARDIE	SW 6123 BAGUETTE								
COMPOSITE TRIM - B	HARDIE	COBBLESTONE								
COMPOSITE TRIM - C	HARDIE	PAINT TO MATCH CORRUGATED METAL								
CORRUGATED METAL SIDING	FLYNN	PREWEATHERED GALVALUME 24 GA.								
RAILING	ALUMINUM	BLACK								
WINDOWS	VINYL	TAN								
BRICK VENEER	BORAL	CAGLES MILL KING								
PRECAST	ROCKCAST	WHEATSTONE								

TYPICAL MATERIALS

----COMPOSITE TRIM - C

—COMPOSITE SIDING & TRIM - A

—COMPOSITE WRAPPED COLUMNS AND TRIM - B

515 Pinney Street

SHEET TITLE **Elevations** 

SHEET NUMBER

A-2.2

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Royster Crossing
Lot 1 of CSM
14166

# COURTYARD ELEVATION - SOUTH



COURTYARD ELEVATION- NORTH

| 1/8"=1'-0"

EXTERIO	EXTERIOR MATERIAL SCHEDULE		
BUILDING MATERIAL	MANUFACTURER	COLOR	
COMPOSITE SIDING & TRIM - A	HARDIE	SW 6123 BAGUETTE	
COMPOSITE TRIM - B	HARDIE	COBBLESTONE	
COMPOSITE TRIM - C	HARDIE	PAINT TO MATCH CORRUGATED METAL	
CORRUGATED METAL SIDING	FLYNN	PREWEATHERED GALVALUME 24 GA.	
RAILING	ALUMINUM	BLACK	
WINDOWS	VINYL	TAN	
BRICK VENEER	BORAL	CAGLES MILL KING	
PRECAST	ROCKCAST	WHEATSTONE	

515 Pinney Street


SHEET TITLE
Elevations

SHEET NUMBER


A-2.3

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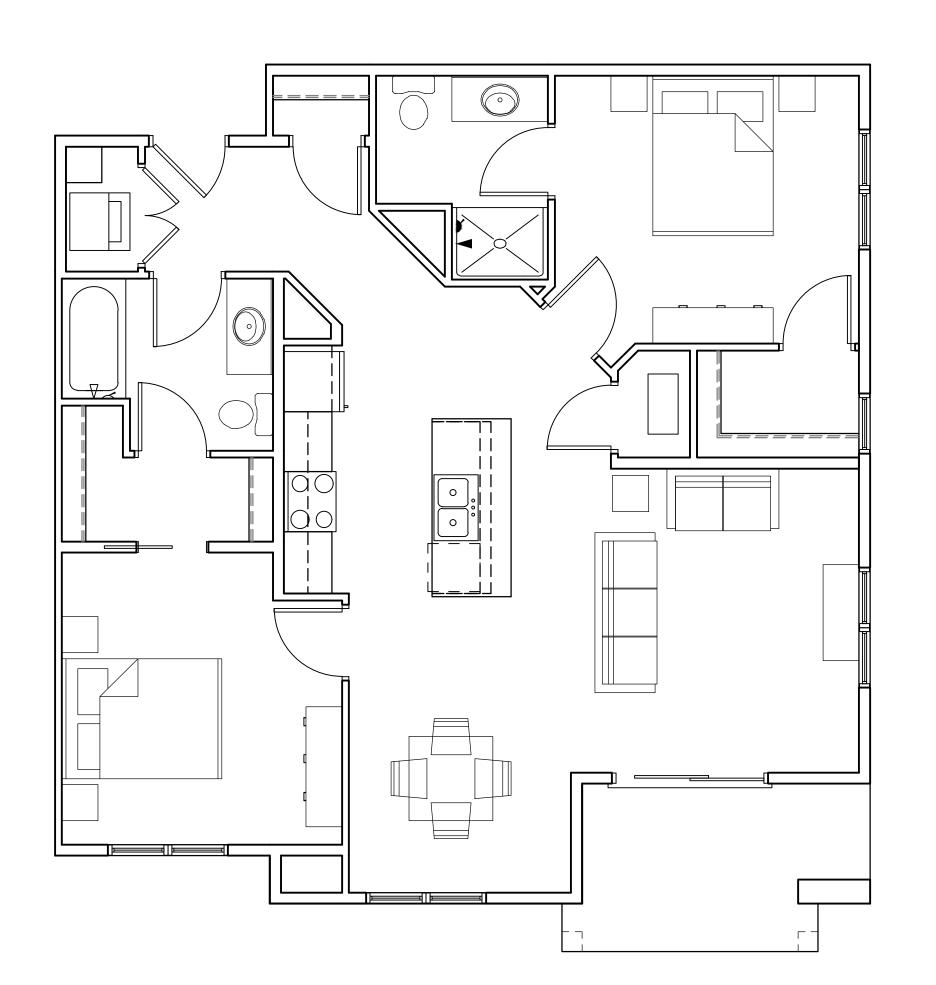




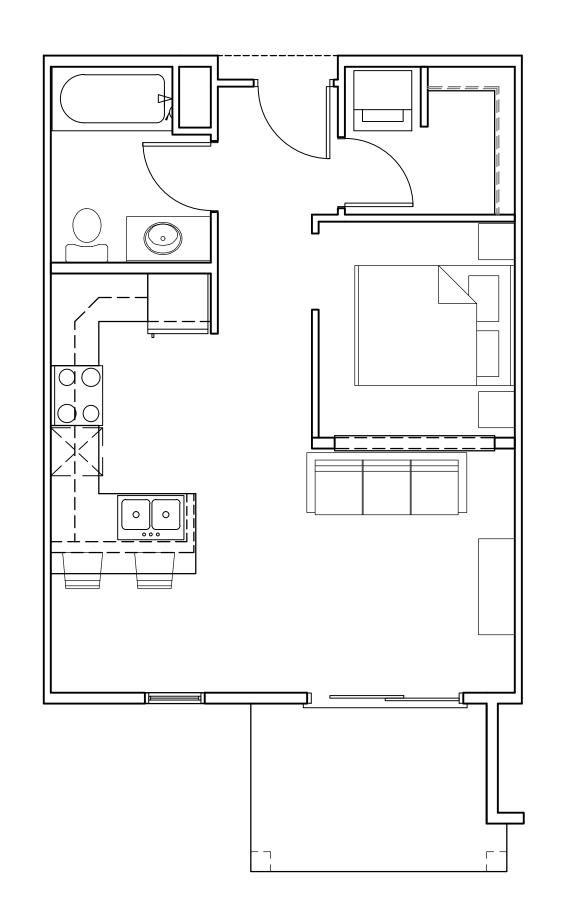

TYPICAL ONE BEDROOM

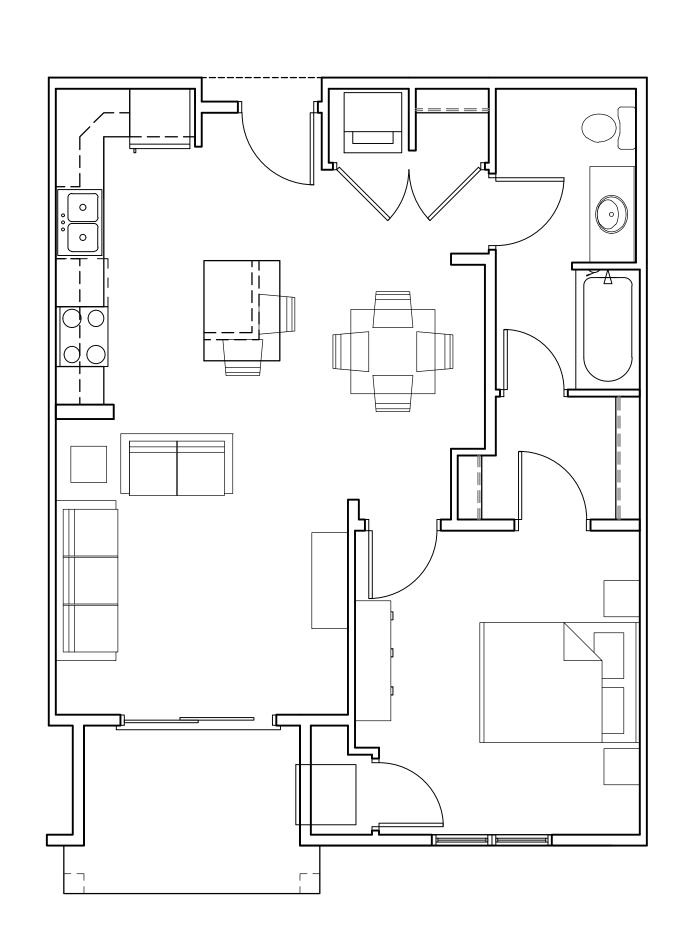A-5.1 1/4"=1'-0"



3 TYPICAL TWO BEDROOM

A-5.1 1/4"=1'-0"

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PROJECT TITLE Royster Crossing
Lot I of CSM 14166

515 Pinney Street

SHEET TITLE
Typical Unit Plans

SHEET NUMBER

A-5.1

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KEY PLAN

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Royster
Crossing Lot 1
of CSM 14166

515 Pinney Street

SHEET TITLE
Render

SHEET NUMBER

A-2.4

PROJECT NUMBER 1852
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NORTH ELEVATION

I/8"=1'-0"



EAST ELEVATION

1/8"=1'-0"

EXTERIOR MATERIAL SCHEDULE			
BUILDING MATERIAL	MANUFACTURER	COLOR	
COMPOSITE SIDING & TRIM - A	HARDIE	SW 6123 BAGUETTE	
COMPOSITE TRIM - B	HARDIE	COBBLESTONE	
COMPOSITE TRIM - C	HARDIE	PAINT TO MATCH CORRUGATED METAL	
CORRUGATED METAL SIDING	FLYNN	PREWEATHERED GALVALUME 24 GA.	
RAILING	ALUMINUM	BLACK	
WINDOWS	VINYL	TAN	
BRICK VENEER	BORAL	CAGLES MILL KING	
PRECAST	ROCKCAST	WHEATSTONE	

Knothe bruce
ARCHITECTS

Phone: 7601 University Ave, Ste 201
608.836.3690 Middleton, WI 53562

KEY PLAN

ISSUED Issued for Land Use - September 19, 2018

Royster Crossing
Lot 1 of CSM
14166

515 Pinney Street

Elevations
Rendered

SHEET NUMBER

A-2.5

PROJECT NO. 8

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