# **URBAN DESIGN COMMISSION APPLICATION**



City of Madison Planning Division 126 S. Hamilton St. P.O. Box 2985 Madison, WI 53701-2985



FOR OFFICE USE ONL	Y:
Paid	Receipt #
Date received	
Received by	
Aldermanic District	
Zoning District	
Urban Design District	
Submittal reviewed by	<i></i>

	the desired meeting of the desired an interpreted	of this application, including date and the action requested.  It, translator, materials in alternate modations to access these forms, ander above immediately.	Received by  Aldermanic District  Zoning District  Urban Design District  Submittal reviewed by
1	Project Information		
	•	Washington Avenue	
2.	Application Type (ch UDC meeting date red ☑ New developmen ☐ Informational		or previously-approved development  IX Final approval
3.	Project Type		
	Mixed-Use District  Project in the Sub Campus Institution District (EC)  Planned Developm General Developm Specific Impl Planned Multi-Us	wntown Core District (DC), Urban (UMX), or Mixed-Use Center District (MXC) urban Employment Center District (SEC), anal District (CI), or Employment Campus ment (PD) elopment Plan (GDP) ementation Plan (SIP) e Site or Residential Building Complex	Signage  ☐ Comprehensive Design Review (CDR)  ☐ Signage Variance (i.e. modification of signage height, area, and setback)  Other  ☐ Please specify  ———————————————————————————————————
4.	Applicant, Agent, an	d Property Owner Information	
	Applicant name Street address Telephone Project contact perso Street address Telephone	Brendan Baxter 2303 W. Beltline Hwy 608-276-0244  m Kevin Burow 7601 University Ave. Ste 201 608-836-3690	Company PJB-II Inc.  City/State/Zip Madison, WI 53713  Email baxter.bt@gmail.com  Company Knothe and Bruce Architects  City/State/Zip Middleton, WI 53562  Email kburow@knothebruce.com
		ot applicant)	
	Street address Telephone		_City/State/Zip _Email

must

(14)

submittal

11" x 17" collated paper

copies. Landscape and Lighting plans (if required)

must be full-sized. Please refrain from using plastic

covers or spiral binding.

include fourteen

Each

#### 5. Required Submittal Materials

- ☑ Application Form
- ☑ Letter of Intent
  - If the project is within an Urban Design District, a summary of how the development proposal addresses the district criteria is required
  - For signage applications, a summary of how the proposed signage is consistent with the applicable CDR or Signage Variance review criteria is required.
- Development plans (Refer to checklist provided below for plan details)
- ☐ Filing fee
- ☑ Electronic Submittal\*

Both the paper copies and electronic copies <u>must</u> be submitted prior to the application deadline before an application will be scheduled for a UDC meeting. Late materials will not be accepted. A completed application form is required for each UDC appearance.

For projects also requiring Plan Commission approval, applicants must also have submitted an accepted application for Plan Commission consideration prior to obtaining any formal action (initial or final approval) from the UDC. All plans must be legible when reduced.

\*Electronic copies of all items submitted in hard copy are required. Individual PDF files of each item submitted should be compiled on a CD or flash drive, or submitted via email to <a href="mailto:udcapplications@cityofmadison.com">udcapplications@cityofmadison.com</a>. The email must include the project address, project name, and applicant name. Electronic submittals via file hosting services (such as Dropbox.com) are not allowed. Applicants who are unable to provide the materials electronically should contact the Planning Division at (608) 266-4635 for assistance.

#### 6. Applicant Declarations

- Prior to submitting this application, the applicant is required to discuss the proposed project with Urban Design Commission staff. This application was discussed with <u>Heather Stauder, Kevin Firchow, Bill Freuling</u> on February 12, 2018
- The applicant attests that all required materials are included in this submittal and understands that if any required information is not provided by the application deadline, the application will not be placed on an Urban Design Commission agenda for consideration.

Applicant name Brendan Baxter	Relationship to property	Owner	
Authorized signature of Property Owner	Short	Date 10/3/2018	

#### 7. Application Filing Fees

Fees are required to be paid with the first application for either initial or final approval of a project, unless the project is part of the combined application process involving the Urban Design Commission in conjunction with Plan Commission and/or Common Council consideration. Make checks payable to City Treasurer. Credit cards may be used for application fees of less than \$1,000.

Please consult the schedule below for the appropriate fee for your request:

Urban Design Districts: \$350 (per §35.24(6) MGO).
Minor Alteration in the Downtown Core District (DC) or Urban Mixed-Use District (UMX): \$150 (per §33.24(6)(b) MGO)
Comprehensive Design Review: \$500 (per §31.041(3)(d)(1)(a) MGO)
Minor Alteration to a Comprehensive Sign Plan: \$100 (per §31.041(3)(d)(1)(c) MGO)
All other sign requests to the Urban Design Commission, including, but not limited to: appeals

from the decisions of the Zoning Administrator,

code approvals: \$300 (per §31.041(3)(d)(2) MGO)

requests for signage variances (i.e. modifications of

signage height, area, and setback), and additional sign

A filing fee is not required for the following project applications if part of the combined application process involving both Urban Design Commission and Plan Commission:

- Project in the Downtown Core District (DC), Urban
   Mixed-Use District (UMX), or Mixed-Use Center District (MXC)
- Project in the Suburban Employment Center District (SEC), Campus Institutional District (CI), or Employment Campus District (EC)
- Planned Development (PD): General Development
   Plan (GDP) and/or Specific Implementation Plan (SIP)
- Planned Multi-Use Site or Residential Building Complex

### **URBAN DESIGN COMMISSION APPROVAL PROCESS**



#### Introduction

The City of Madison's Urban Design Commission (UDC) has been created to:

- Encourage and promote high quality in the design of new buildings, developments, remodeling, and additions so as to maintain and improve the established standards of property values within the City.
- Foster civic pride in the beauty and nobler assets of the City, and in all other ways possible assure a functionally efficient and visually attractive City in the future.

#### **Types of Approvals**

There are three types of requests considered by the UDC:

- <u>Informational Presentation</u>. Applicants may, at their discretion, request to make an Informational Presentation to the UDC prior to seeking any approvals to obtain early feedback and direction before undertaking detailed design. Applicants should provide details on the context of the site, design concept, site and building plans, and other relevant information to help the UDC understand the proposal and provide feedback. (Does not apply to CDR's or Signage Variance requests)
- <u>Initial Approval</u>. Applicants may, at their discretion, request initial approval of a proposal by presenting preliminary design information. As part of their review, the Commission will provide feedback on the design information what should be addressed at Final Approval stage.
- <u>Final Approval</u>. Applicants may request Final Approval of a proposal by presenting all final project details. Recommendations or concerns expressed by the UDC in the initial approval must be addressed at this time.

#### **Presentations to the Commission**

Primarily, the UDC is interested in the appearance and design quality of projects. Emphasis should be given to the site plan, landscape plan, lighting plan, building elevations, exterior building materials, color scheme, and graphics.

When presenting projects to the UDC, applicants must fill out a registration slip provided in the meeting room and present it to the Secretary. Presentations should generally be limited to 5 minutes or as extended by motion by consent of the Commission. The Commission will withhold questions until the end of the presentation.

Applicants are encouraged to consider the use of various graphic presentation material including a locator map, photographs, renderings/model, scale drawings of the proposal in context with adjacent buildings/uses/signs, etc., as may be deemed appropriate to describe the project and its surroundings. Graphics should be mounted on rigid boards so that they may be easily displayed. Applicants/presenters are responsible for all presentation materials, AV equipment and easels.

### **URBAN DESIGN DEVELOPMENT PLANS CHECKLIST**



The items listed below are minimal application requirements for the type of approval indicated. Please note that the UDC and/or staff may require additional information in order to have a complete understanding of the project.

#### 1. Informational Presentation

- Locator Map
- Contextual site information, including photographs and layout of adjacent buildings/structures
- Two-dimensional (2D) images of proposed buildings or structures.

Providing additional information beyond these minimums may generate a greater level of feedback from the Commission.

#### **Requirements for All Plan Sheets**

- 1. Title block
- 2. Sheet number
- 3. North arrow
- 4. Scale, both written and graphic
- 5. Date
- 6. Fully dimensioned plans, scaled at 1"= 40' or larger

\*\* All plans must be legible, including the full-sized landscape and lighting plans (if required)

#### 2. Initial Approval

- Locator Map
- Letter of Intent (If the project is within a Urban Design District, a summary of <a href="https://how.ncbi.nlm.
- ☐ Contextual site information, including photographs and layout of adjacent buildings/structures
- Site Plan showing location of existing and proposed buildings, walks, drives, bike lanes, bike parking, and existing trees over 18" diameter
- Landscape Plan and Plant List (must be legible)
- Building Elevations in both black & white and color for all building sides (include material callouts)
- PD text and Letter of Intent (if applicable)

Providing additional information beyond these minimums may generate a greater level of feedback from the Commission.

#### 3. Final Approval

Αl	l	the re	quireme	ents of	the	Initial	App	oroval	(see a	bove	), p	lus:
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- ☑ Grading Plan
- ☐ Proposed Signage (if applicable)
- N/A Lighting Plan, including fixture cut sheets and photometrics plan (must be legible)
  - ☑ Utility/HVAC equipment location and screening details (with a rooftop plan if roof-mounted)
  - PD text and Letter of Intent (if applicable)
  - Samples of the exterior building materials (presented at the UDC meeting)

#### 4. Comprehensive Design Review (CDR) and Variance Requests (Signage applications only)


•	• • • • • • • • • • • • • • • • • • • •
	Locator Map
	Letter of Intent (a summary of <u>how</u> the proposed signage is consistent with the CDR or Signage Variance criteria is required)
	Contextual site information, including photographs of existing signage both on site and within proximity to the project site
	Site Plan showing the location of existing signage and proposed signage, dimensioned signage setbacks, sidewalks, driveways, and right-of-ways
	Proposed signage graphics (fully dimensioned, scaled drawings, including materials and colors, and night view)
	Perspective renderings (emphasis on pedestrian/automobile scale viewsheds)
	Graphic of the proposed signage as it relates to what the Ch. 31, MGO would permit

#### October 5, 2018

Ms. Janine Glaeser Urban Design Committee City of Madison 126 S. Hamilton Street PO Box 2985 Madison, Wisconsin 53701

Re: 555 W. Washington Ave.

Ms. Janine Glaeser:

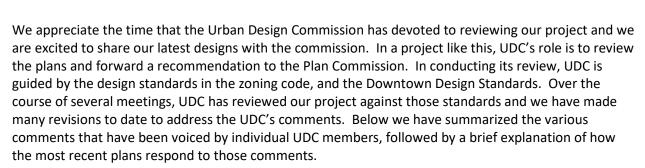

#### **UDC** comments from 8/8/18: (responses noted below each point)

- W Washing Elevation Stone façade: Overhang needs detailing.
  - o This has been modified to a brick façade with a traditional parapet edge.
- W Washing Elevation Stone façade: The second band on the bays needs more definition of a sill.
  - Additional bands have been added to the bays to provide definition for all of the sills.
- The scale doesn't match the surrounding residential. This is not a brownstone as it does not create an edge or complete the corner. Exceptional design benefits from single architectural style or expression. I have objections to the height.
  - The updated design does not focus on a brownstone look and has the brick façade from the sides of the building carried around to the front such that we have a cohesive design with a single style of architecture.
- The two architectural styles are very jarring.
  - The W Washington Elevation has been revised to be predominantly brick to match the rest of the project and the bay elements are cast stone, to match the cast stone base. This has made a much more cohesive building.
- The design is improved from the last one but it doesn't honor the other ones. If you had showed the other side relating to the warehouses that would have strengthened your argument.
  - The overall design is now in line with The Depot project which is located across the street.
- The rhythm is solved but I have a problem with the articulated bays and stone.
  - o The amount of stone has been greatly reduced in order to tie the two sides together.



- The entrances are competing with each other.
  - The main entry has been widened while the unit entries on either side have been revised by eliminating the columns that surround them and thus minimizing their presence on that façade.
- The terrace on West Washington is not a garden space. I question if it's appropriate to that level.
  - The amount of landscaping has been reduced in this area.
- Part of our decision is approving the height, depending on the design quality.
- There's a lot of good elements, but we're not sure it's what we would make judgment on.
- It's tempting to read as two separate buildings, it is one building, but it's a stretch. I like the stone material but it doesn't read successfully as two separate buildings.
  - o The building has been redesigned to remove a majority of the cast stone and incorporate the brick on all sides of the building with cohesive accent bands and details.
- The style does not work, it's not common to Madison. It's a revival style and I don't know why you'd go with that in that location.
  - The new design has created a more cohesive building and utilizes brick as the main element which ties in well with the surrounding buildings.
- The juxtaposition of what's on top and behind doesn't relate. Taken out of context it is a nice
  design. Looking at it along the Bedford Street side you can really see that it should be two
  different buildings.
  - o The new design has these merged into one cohesive building.
- I like the height of 3 stories on West Washington, but it's only in height that it relates to anything in the area.
  - The updated design that is predominantly brick now ties in with the buildings that are also located on the other corners of this intersection with West Washington and Bedford Streets.

We appreciate the UDC's input on our project, which has resulted in significant and valuable design changes, making it an exceptional project. We respectfully request the UDC make a positive recommendation to the Plan Commission, and identify any specific elements that may remain of concern so that we may address those concerns when we proceed to Plan Commission on November 5, 2018 for consideration of our zoning application.

Sincerely,

Kevin Burow, AIA

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July 2, 2018

Ms. Janine Glaeser Urban Design Committee City of Madison 146 S. Hamilton Street PO Box 2985 Madison, Wisconsin 53701

Re: Letter of Intent 555 W. Washington Ave. KBA Project #1713

Ms. Janine Glaeser:


The exterior lighting will be a combination of wall sconces and downlights. We are required to provide illumination at each exit door to light the exit pathway. The main entry will have a recessed downlight and each balcony/patio will have a wall sconce light fixture. The exact light fixtures are yet to be determined.

Sincerely,

Kevin Burow, AIA






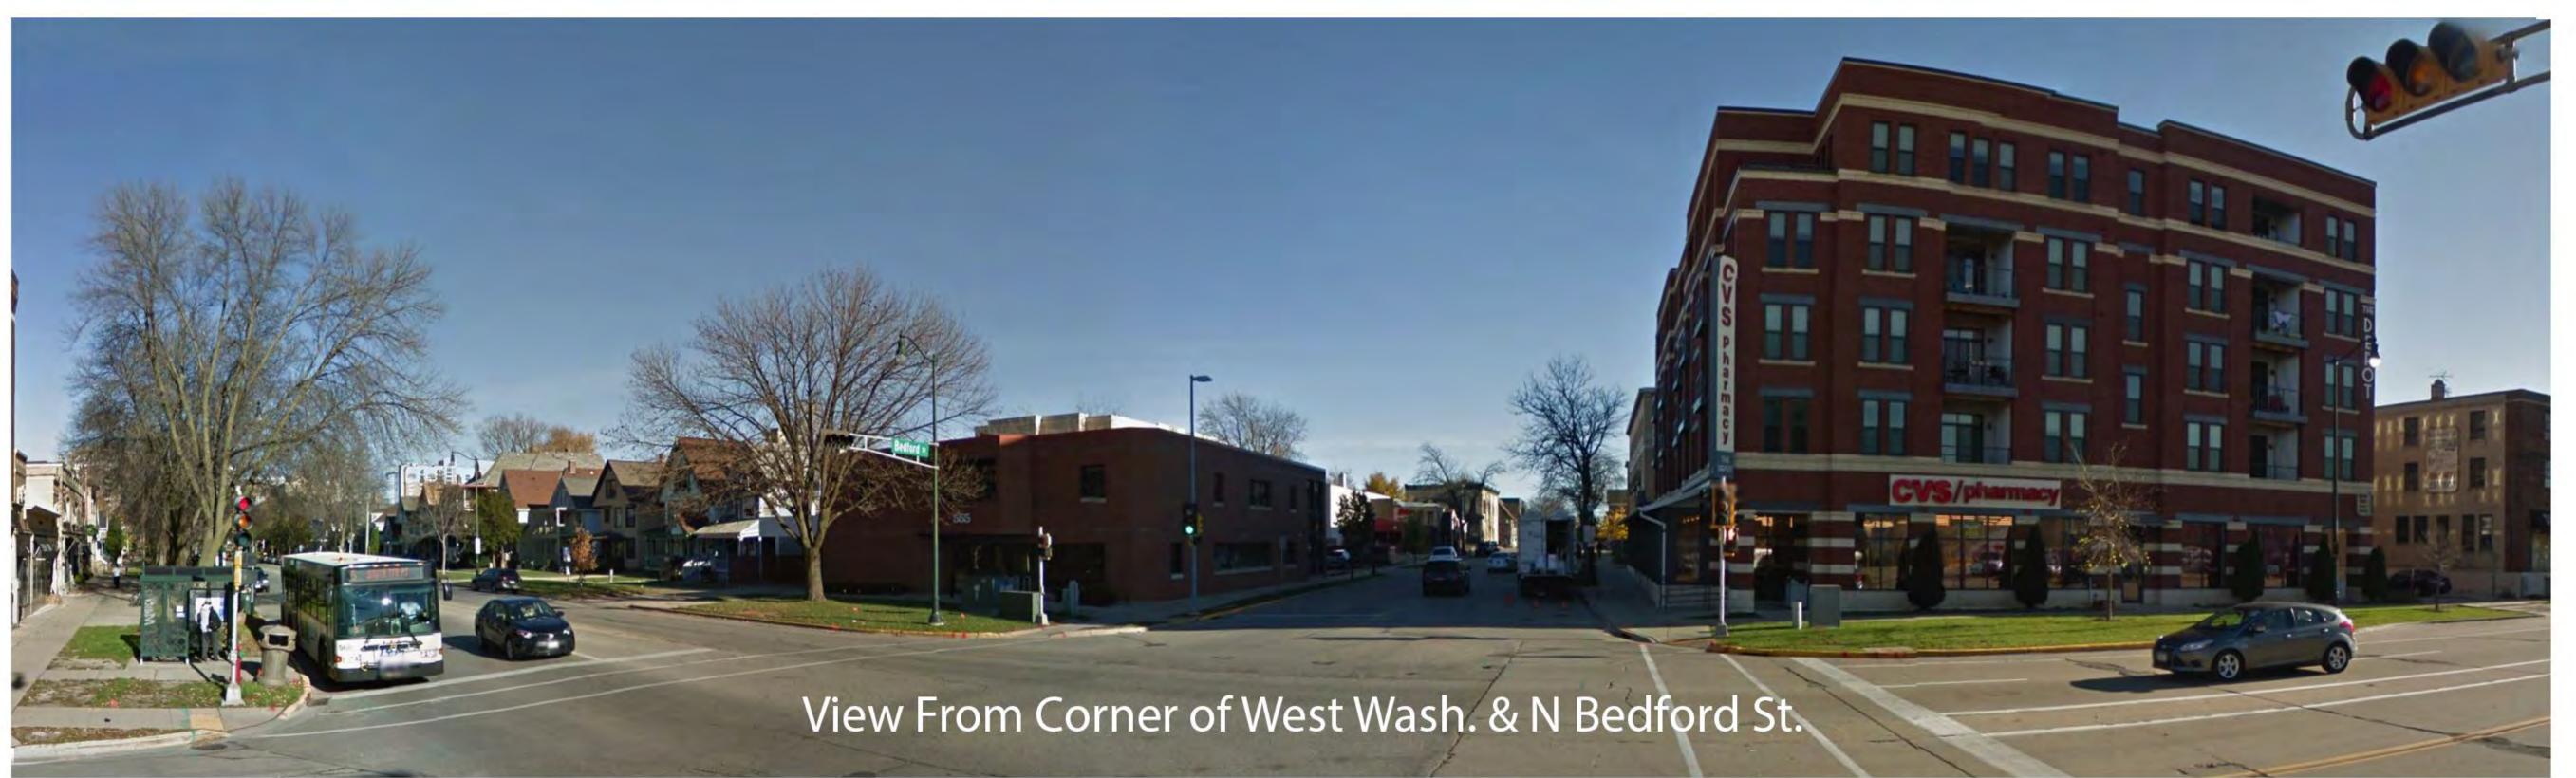









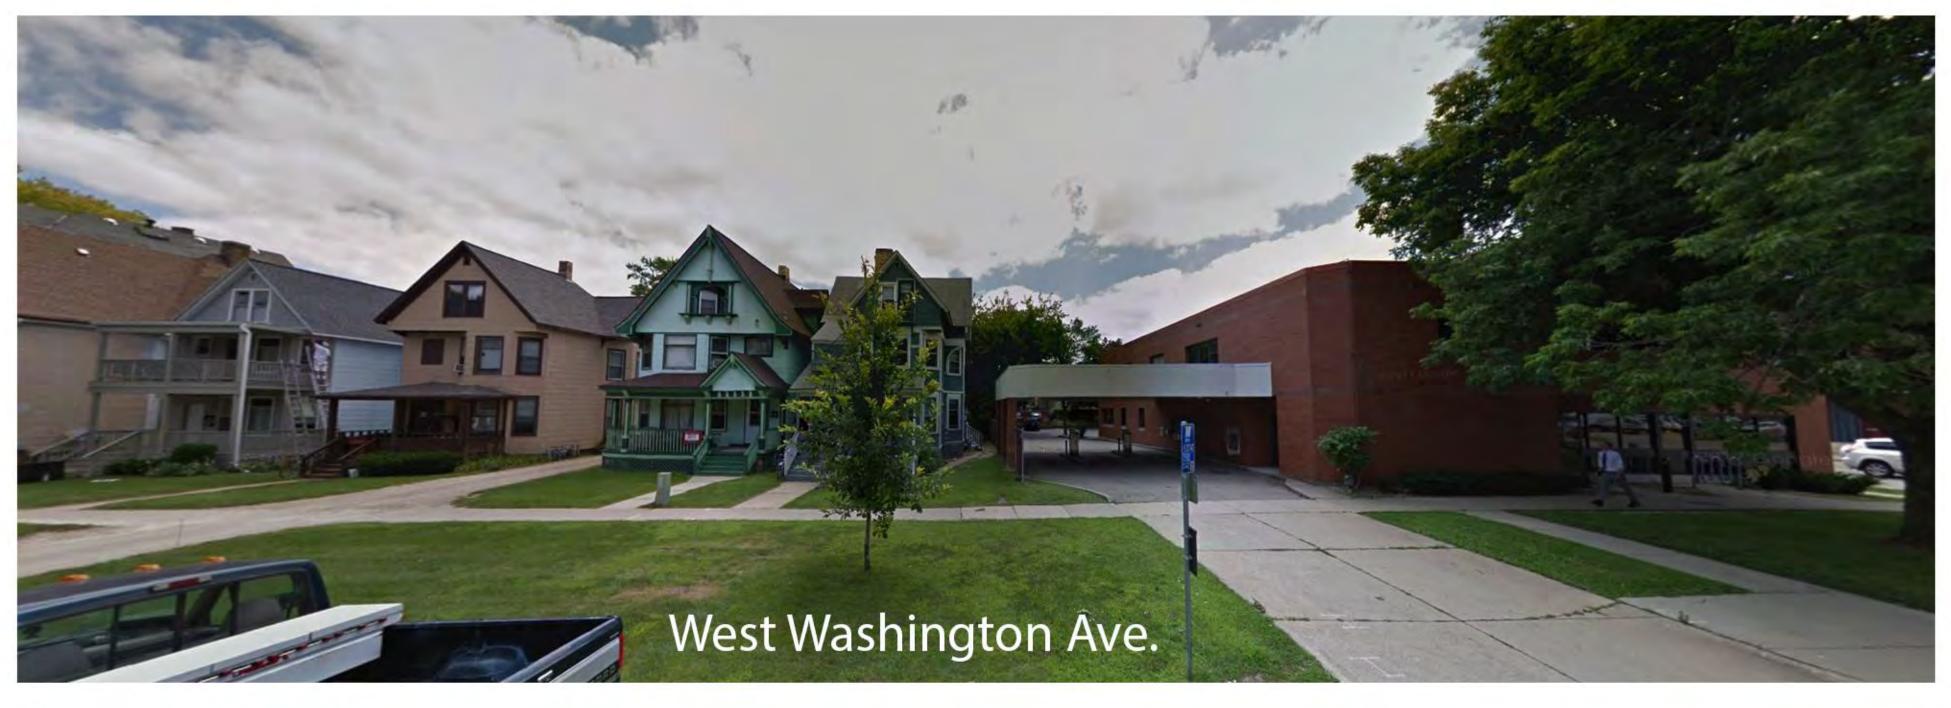

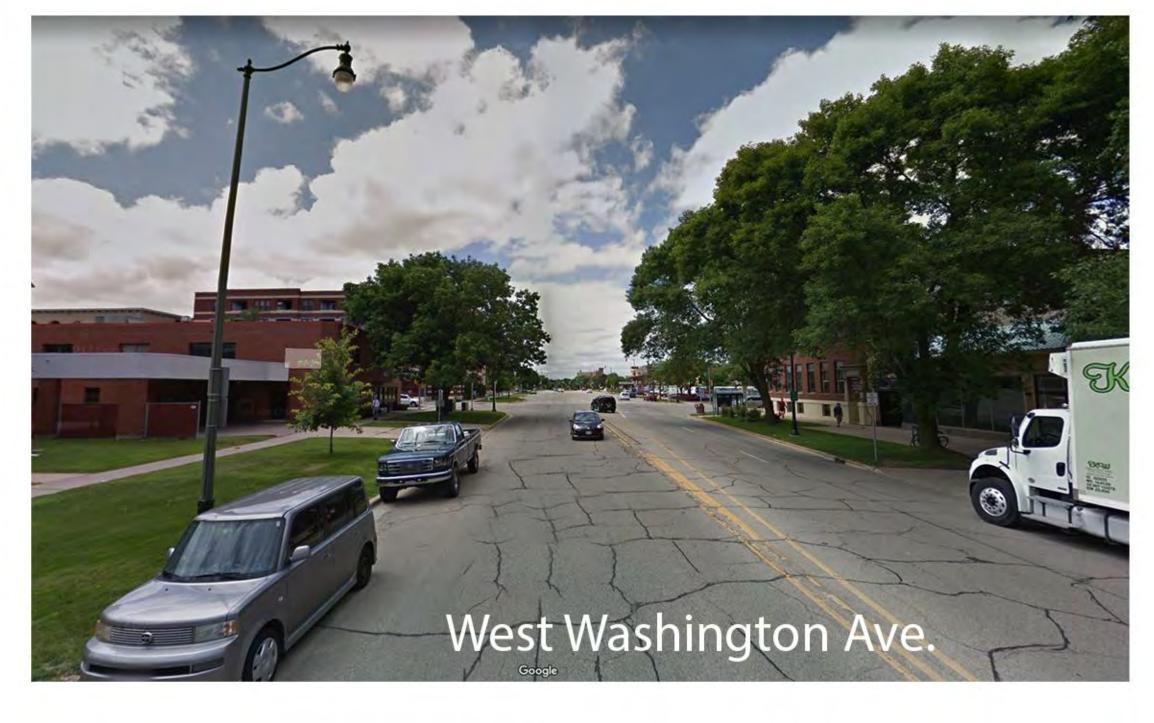

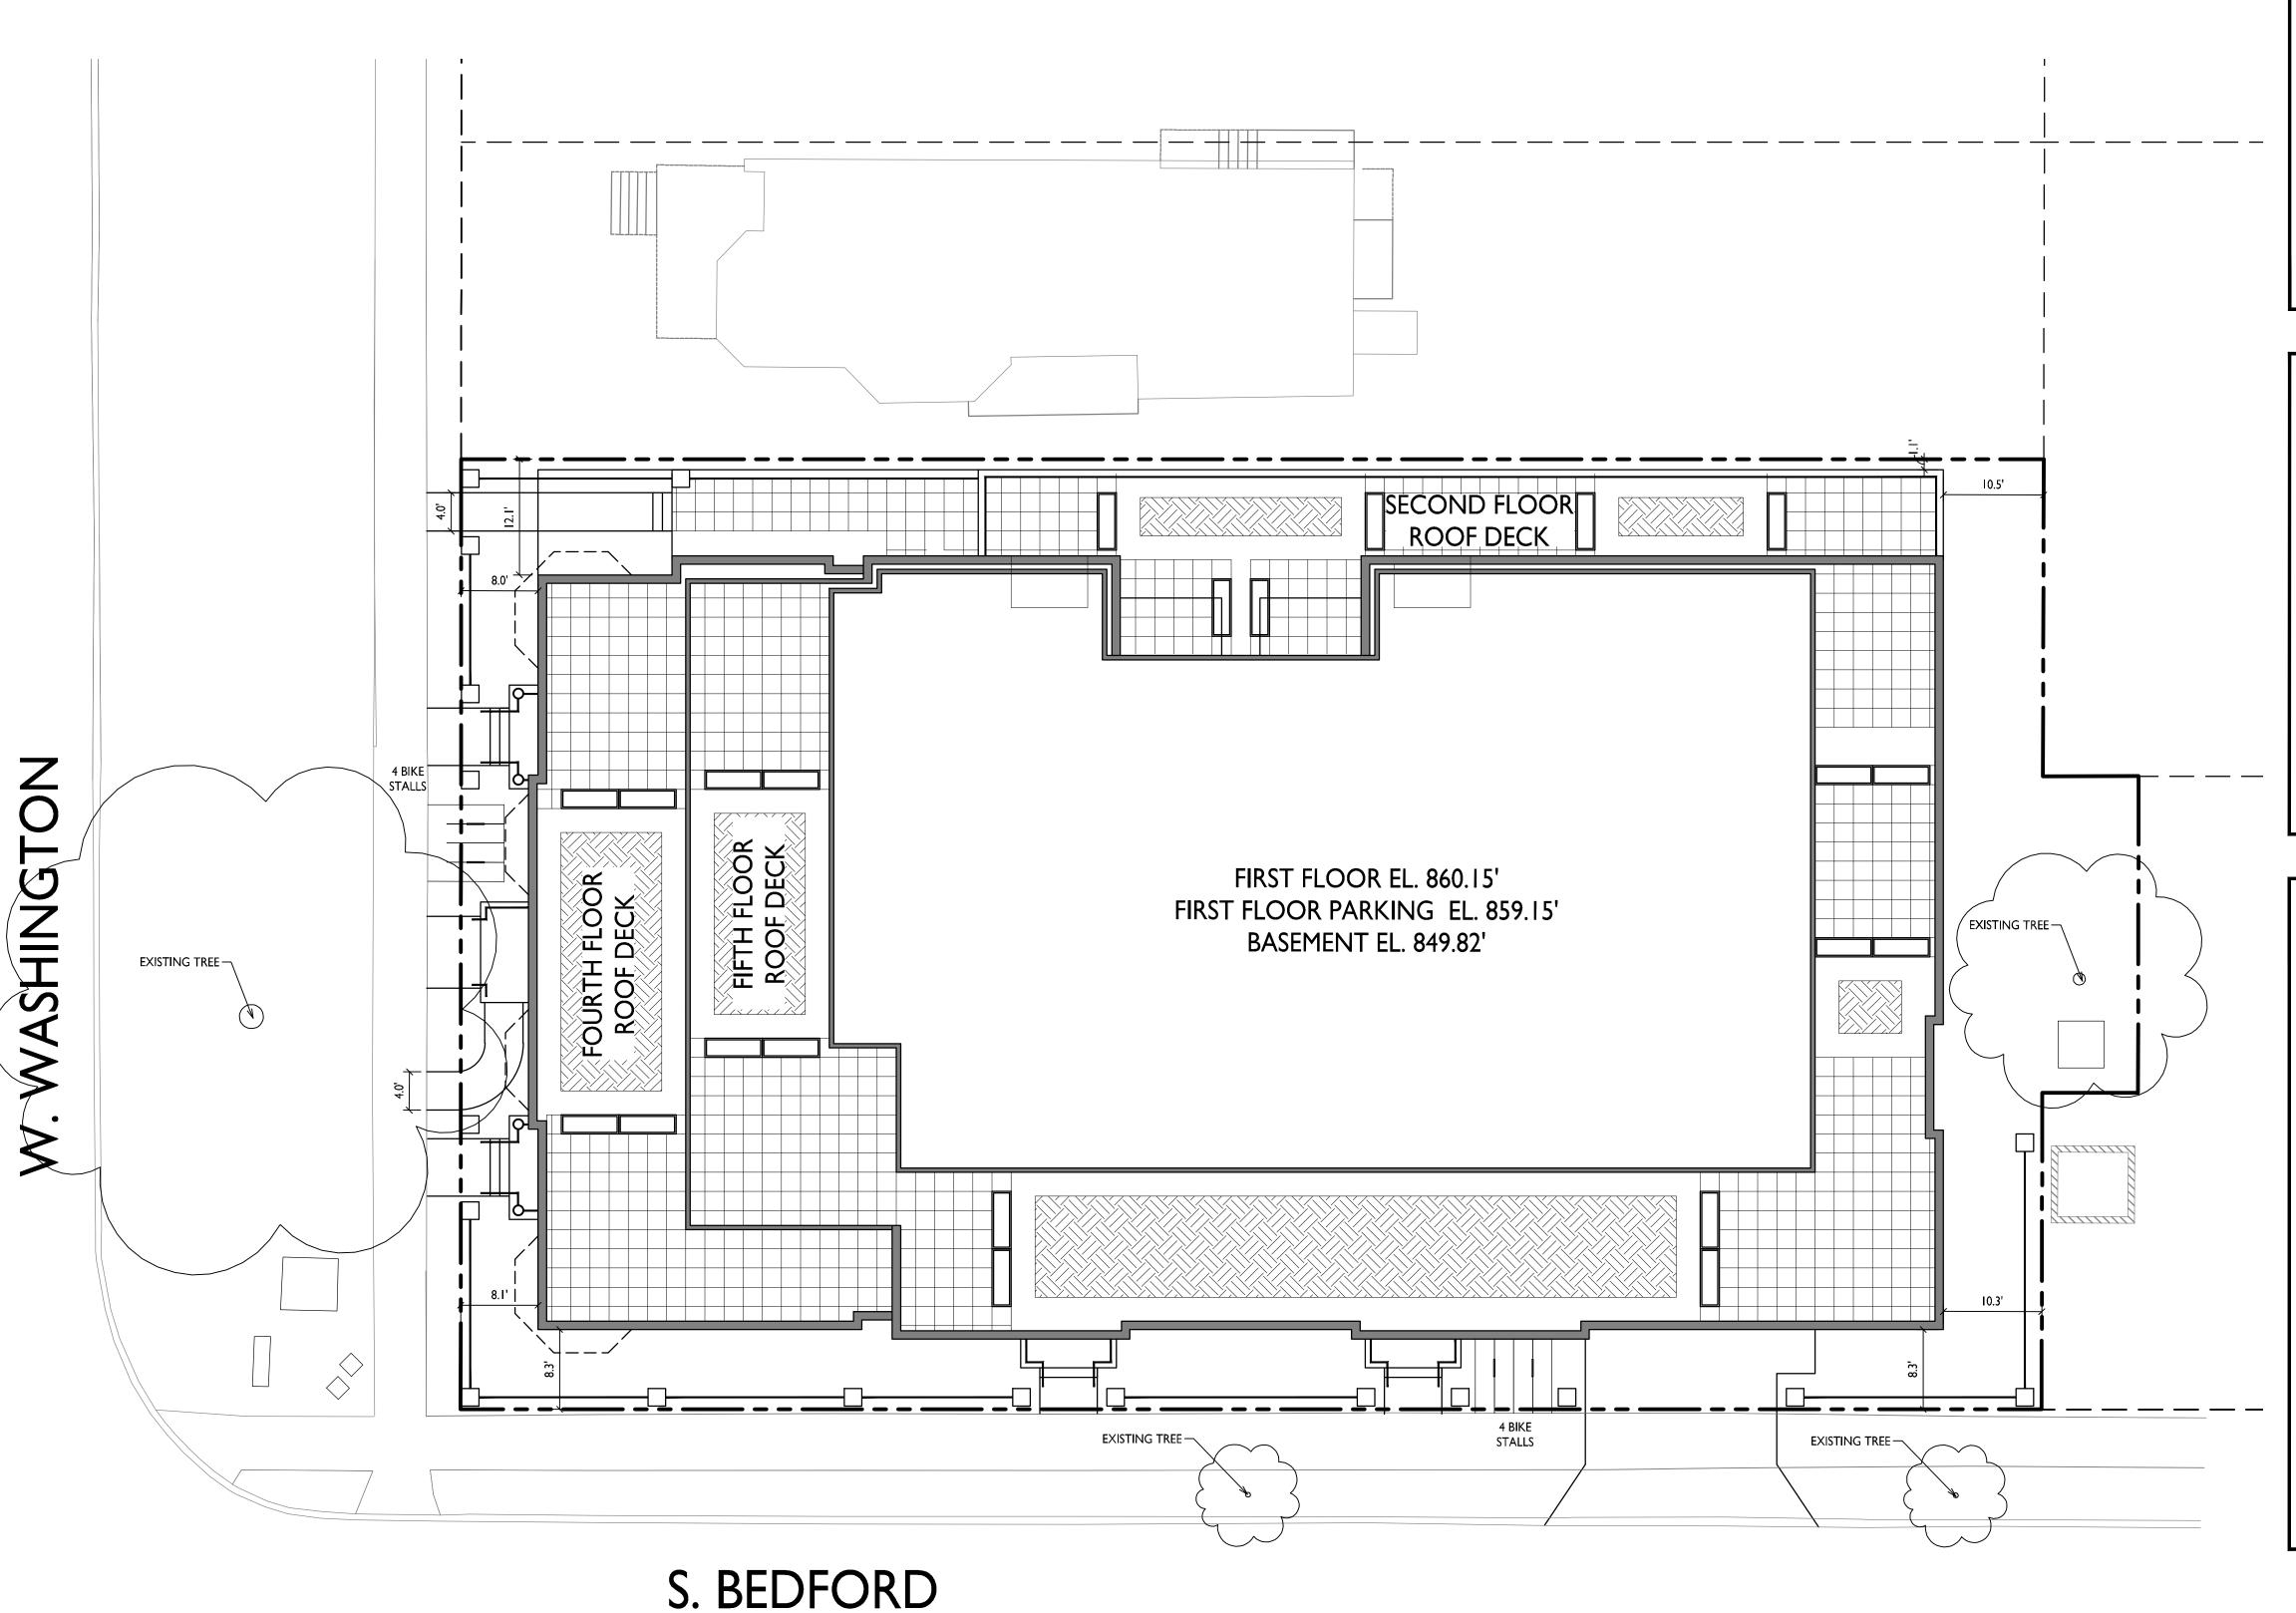

SHEET INDEX SITE PLAN FIRE DEPARTMENT ACCESS PLAN C-1.2 LOT COVERAGE C-1.3 C-1.4 **USABLE OPEN SPACE** EXISTING CONDITIONS C-2.0 C-3.0 DEMOLITION PLAN GRADING & EROSION CONTROL PLAN C-4.0 UTILITY PLAN LANDSCAPE PLAN L-101 ROOF TERRACE LANDSCAPE PLAN L-200 SITE PLAN IMAGE BOARD L-201 ROOF TERRACE IMAGE BOARD ARCHITECTURAL **BASEMENT PLAN** A-1.0 FIRST FLOOR PLAN A-I.I A-1.2 SECOND FLOOR PLAN THIRD FLOOR PLAN FOURTH FLOOR PLAN FIFTH FLOOR PLAN A-1.6 **ROOF PLAN** EXTERIOR ELEVATIONS A-2.2 **EXTERIOR ELEVATIONS** A-5.1 TYPICAL UNIT PLANS TYPICAL UNIT PLANS

RENDERINGS

SITE DEVELOPMENT DATA DENSITIES: LOT AREA 16,735 SF / .38 ACRES **DWELLING UNITS** LOT AREA / D.U. 372 SF / UNIT DENSITY 128 UNITS/ACRE **BUILDING HEIGHT** 3-5 STORIES LOT COVERAGE 13,747 S.F. = 82% (90% MAX.) **USABLE OPEN SPACE** 6,348 S.F. ( 570 S.F. REQ'D) DWELLING UNIT MIX EFFICIENCY ONE BEDROOM TWO BEDROOM
TOTAL DWELLING UNITS VEHICLE PARKING: FIRST FLOOR GARAGE **12 STALLS** UNDERGROUND TOTAL 33 STALLS 45 STALLS BICYCLE PARKING: SURFACE 8 STALLS 6 STALLS FIRST FLOOR GARAGE 39 STALLS (STD. 2'X6') 53 STALLS UNDERGROUND GARAGE

### GENERAL NOTES:

- THE APPLICANT SHALL REPLACE ALL SIDEWALK AND CURB AND GUTTER WHICH ABUTS THE PROPERTY WHICH IS DAMAGED BY THE CONSTRUCTION OR ANY SIDEWALK AND CURB AND GUTTER WHICH THE CITY ENGINEER DETERMINES NEEDS TO BE REPLACED BECAUSE IT IS NOT AT A DESIRABLE GRADE REGARDLESS OF WHETHER THE CONDITION EXISTED PRIOR TO BEGINNING CONSTRUCTION.
- 2. ALL WORK IN THE PUBLIC RIGHT-OF-WAY SHALL BE PERFORMED BY A CITY LICENSED CONTRACTOR.
- 3. ALL DAMAGE TO THE PAVEMENT, ADJACENT TO THIS DEVELOPMENT SHALL BE RESTORED IN ACCORDANCE WITH THE CITY OF MADISON'S PAVEMENT PATCHING CRITERIA.
- EASEMENT LINES SHOWN ON THIS SHEET ARE FOR GENERAL REFERENCE ONLY SEE CSM AND CIVIL SHEETS FOR ADDITIONAL AND MORE COMPLETE EASEMENT INFORMATION.
- 5. THE RIGHT-OF-WAY IS THE SOLE JURISDICTION OF THE CITY OF MADISON AND IS SUBJECT TO CHANGE AT ANY TIME PER THE RECOMMENDATION OF TRAFFIC ENGINEERING AND CITY ENGINEERING DEPARTMENTS.
- 6. CONTRACTOR SHALL INSTALL TREE PROTECTION FENCING IN THE AREA BETWEEN THE CURB AND SIDEWALK AND EXTEND IT AT LEAST 5 FEET FROM BOTH SIDES OF THE TREE ALONG THE LENGTH OF THE TERRACE. IF EXCAVATION WITHIN 5 FEET OF ANY TREE IS NECESSARY, CONTRACTOR SHALL CONTACT CITY FORESTRY (266-4816) PRIOR TO EXCAVATION TO ASSESS THE IMPACT TO THE TREE AND ROOT SYSTEM. TREE PRUNING SHALL BE COORDINATED WITH CITY FORESTRY PRIOR TO THE START OF CONSTRUCTION. TREE PROTECTION SPECIFICATIONS CAN BE FOUND IN SECTION 107.13 OF THE CITY OF MADISON STANDARD SPECIFICATIONS FOR PUBLIC WORKS CONSTRUCTION. ANY TREE REMOVALS THAT ARE REQUIRED FOR CONSTRUCTION AFTER THE DEVELOPMENT PLAN IS APPROVED WILL REQUIRE AT LEAST A 72 HOUR WAIT PERIOD BEFORE TREE REMOVAL PERMIT CAN BE ISSUED BY FORESTRY, TO NOTIFY THE ALDER OF THE CHANGE IN THE TREE PLAN.

555 W Washington Ave.

SHEET TITLE

SHEET TITLE

Site Plan


SHEET NUMBER

C-I.I

PROJECT NO.

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SITE PLAN

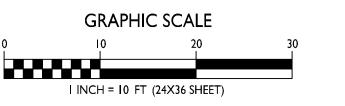


608.836.3690 Middleton, WI 53562

ARCHITECTS

Phone: 7601 University Ave, Ste 201

ISSUED
Issued for Land Use - June 20, 2018
Reissued to Plan Com & UDC - October 8,2018

PROJECT TITLE

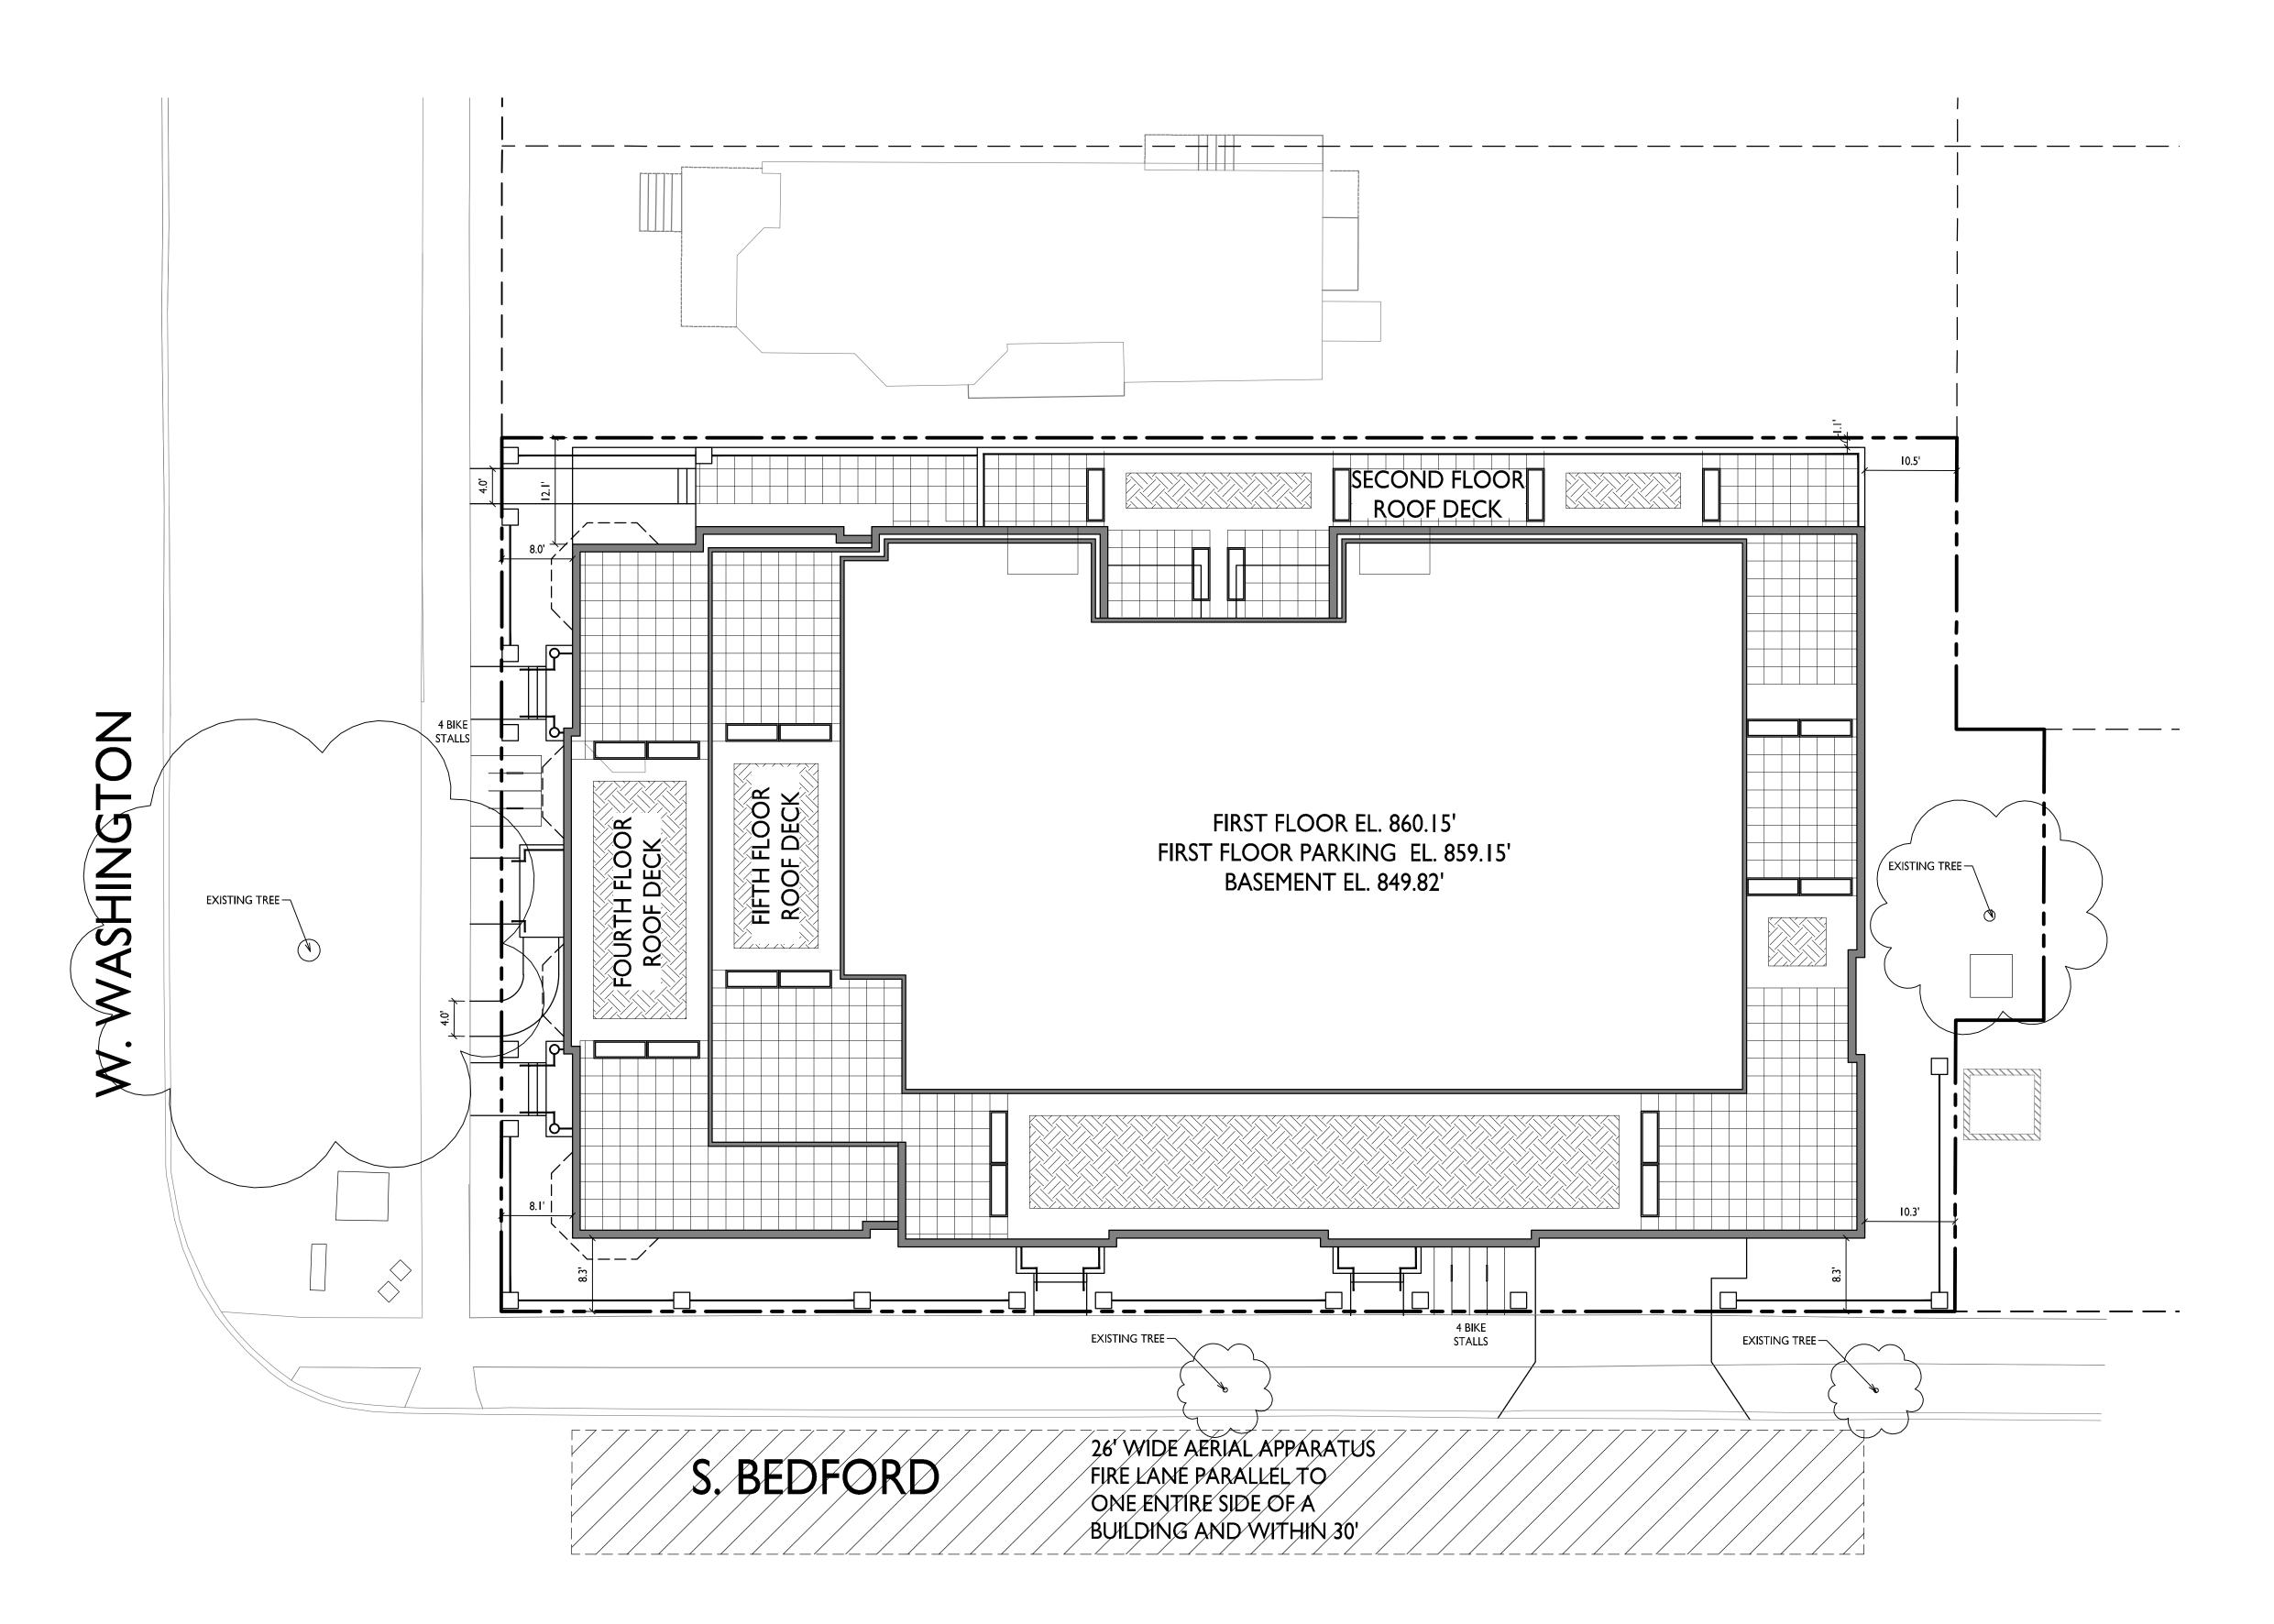



ISSUED

Issued for Land Use - June 20, 2018

Reissued to Plan Com & UDC - October 8,2018

PROJECT TITLE

555 W Washington Ave.

SHEET TITLE

Fire Department
Access Plan


SHEET NUMBER

C-1.2


PROJECT NO.

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**USABLE OPEN SPACE** 

**ZONING: UMX** 

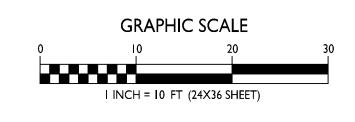REQUIRED OPEN SPACE: 10 S.F. / BEDROOM

DWELLING UNITS: 45

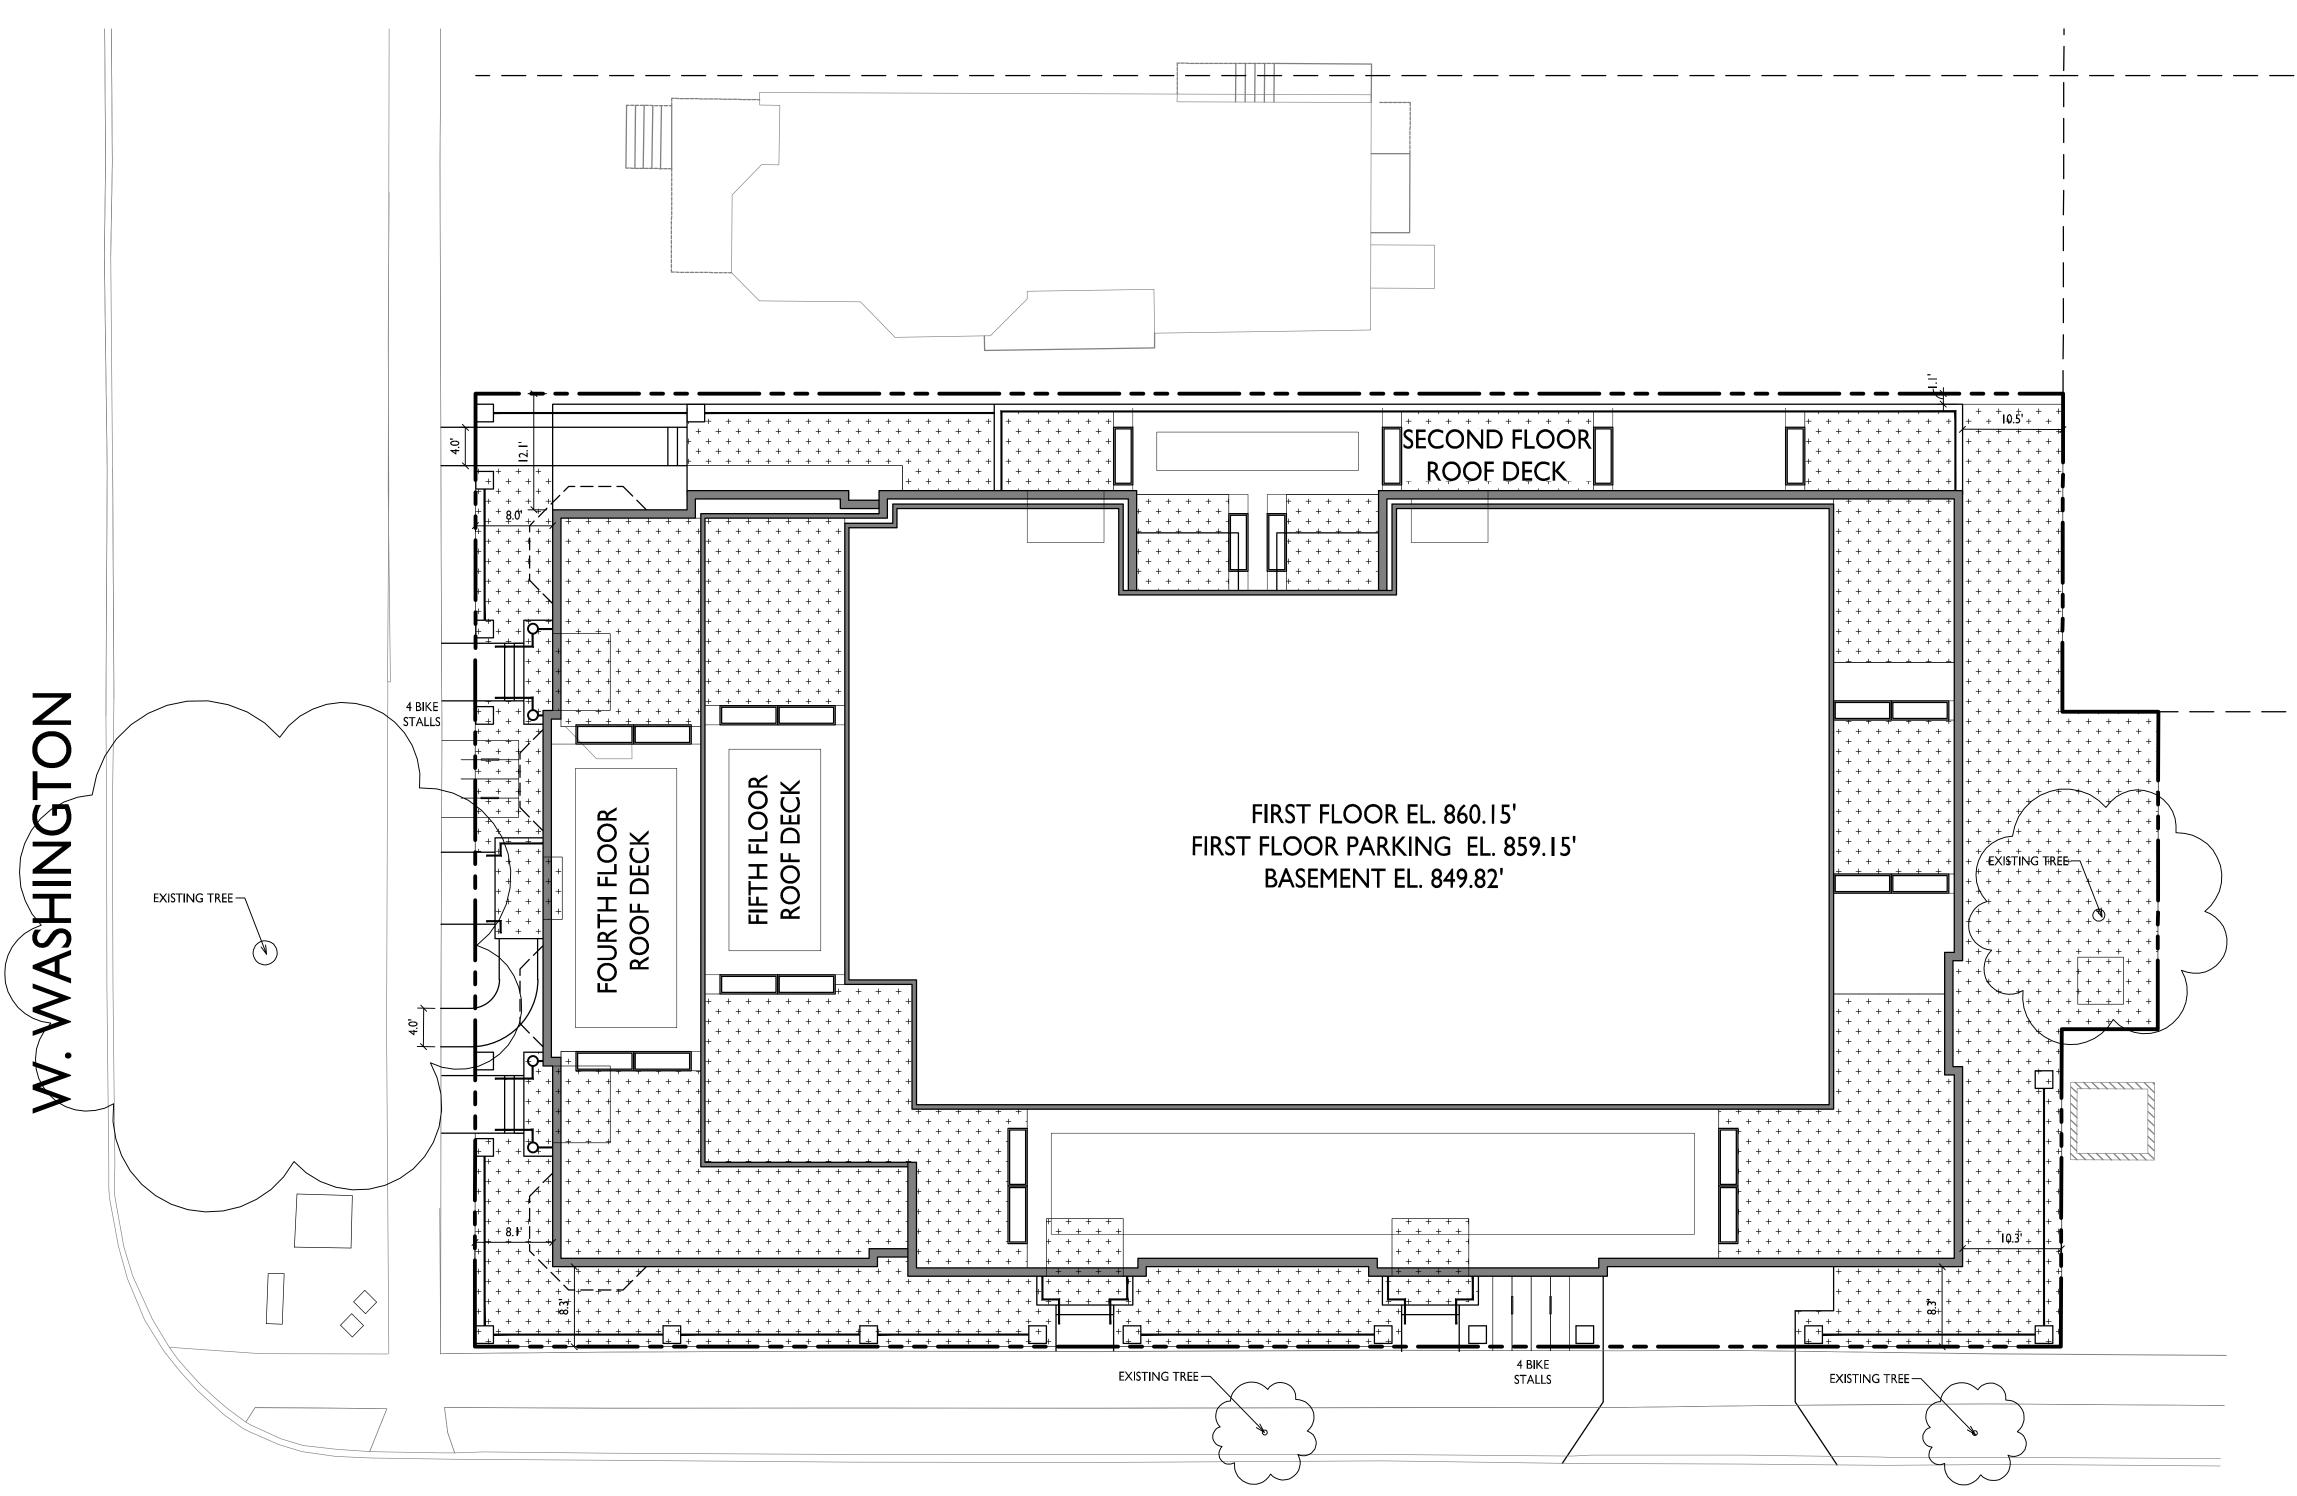BEDROOMS: 57

10 X 57 = 570 S.F. OPEN SPACE REQUIRED

OPEN SPACE PROVIDED:

BALCONIES/ROOF TERRACES: 3,719 S.F.
SURFACE: 2,629 S.F.
TOTAL: 6,348 S.F.

ISSUED

Issued for Land Use - June 20, 2018 Reissued to Plan Com & UDC - October 8,2018

PROJECT TITLE

555 W Washington Ave.

SHEET TITLE
Usable Open
Space


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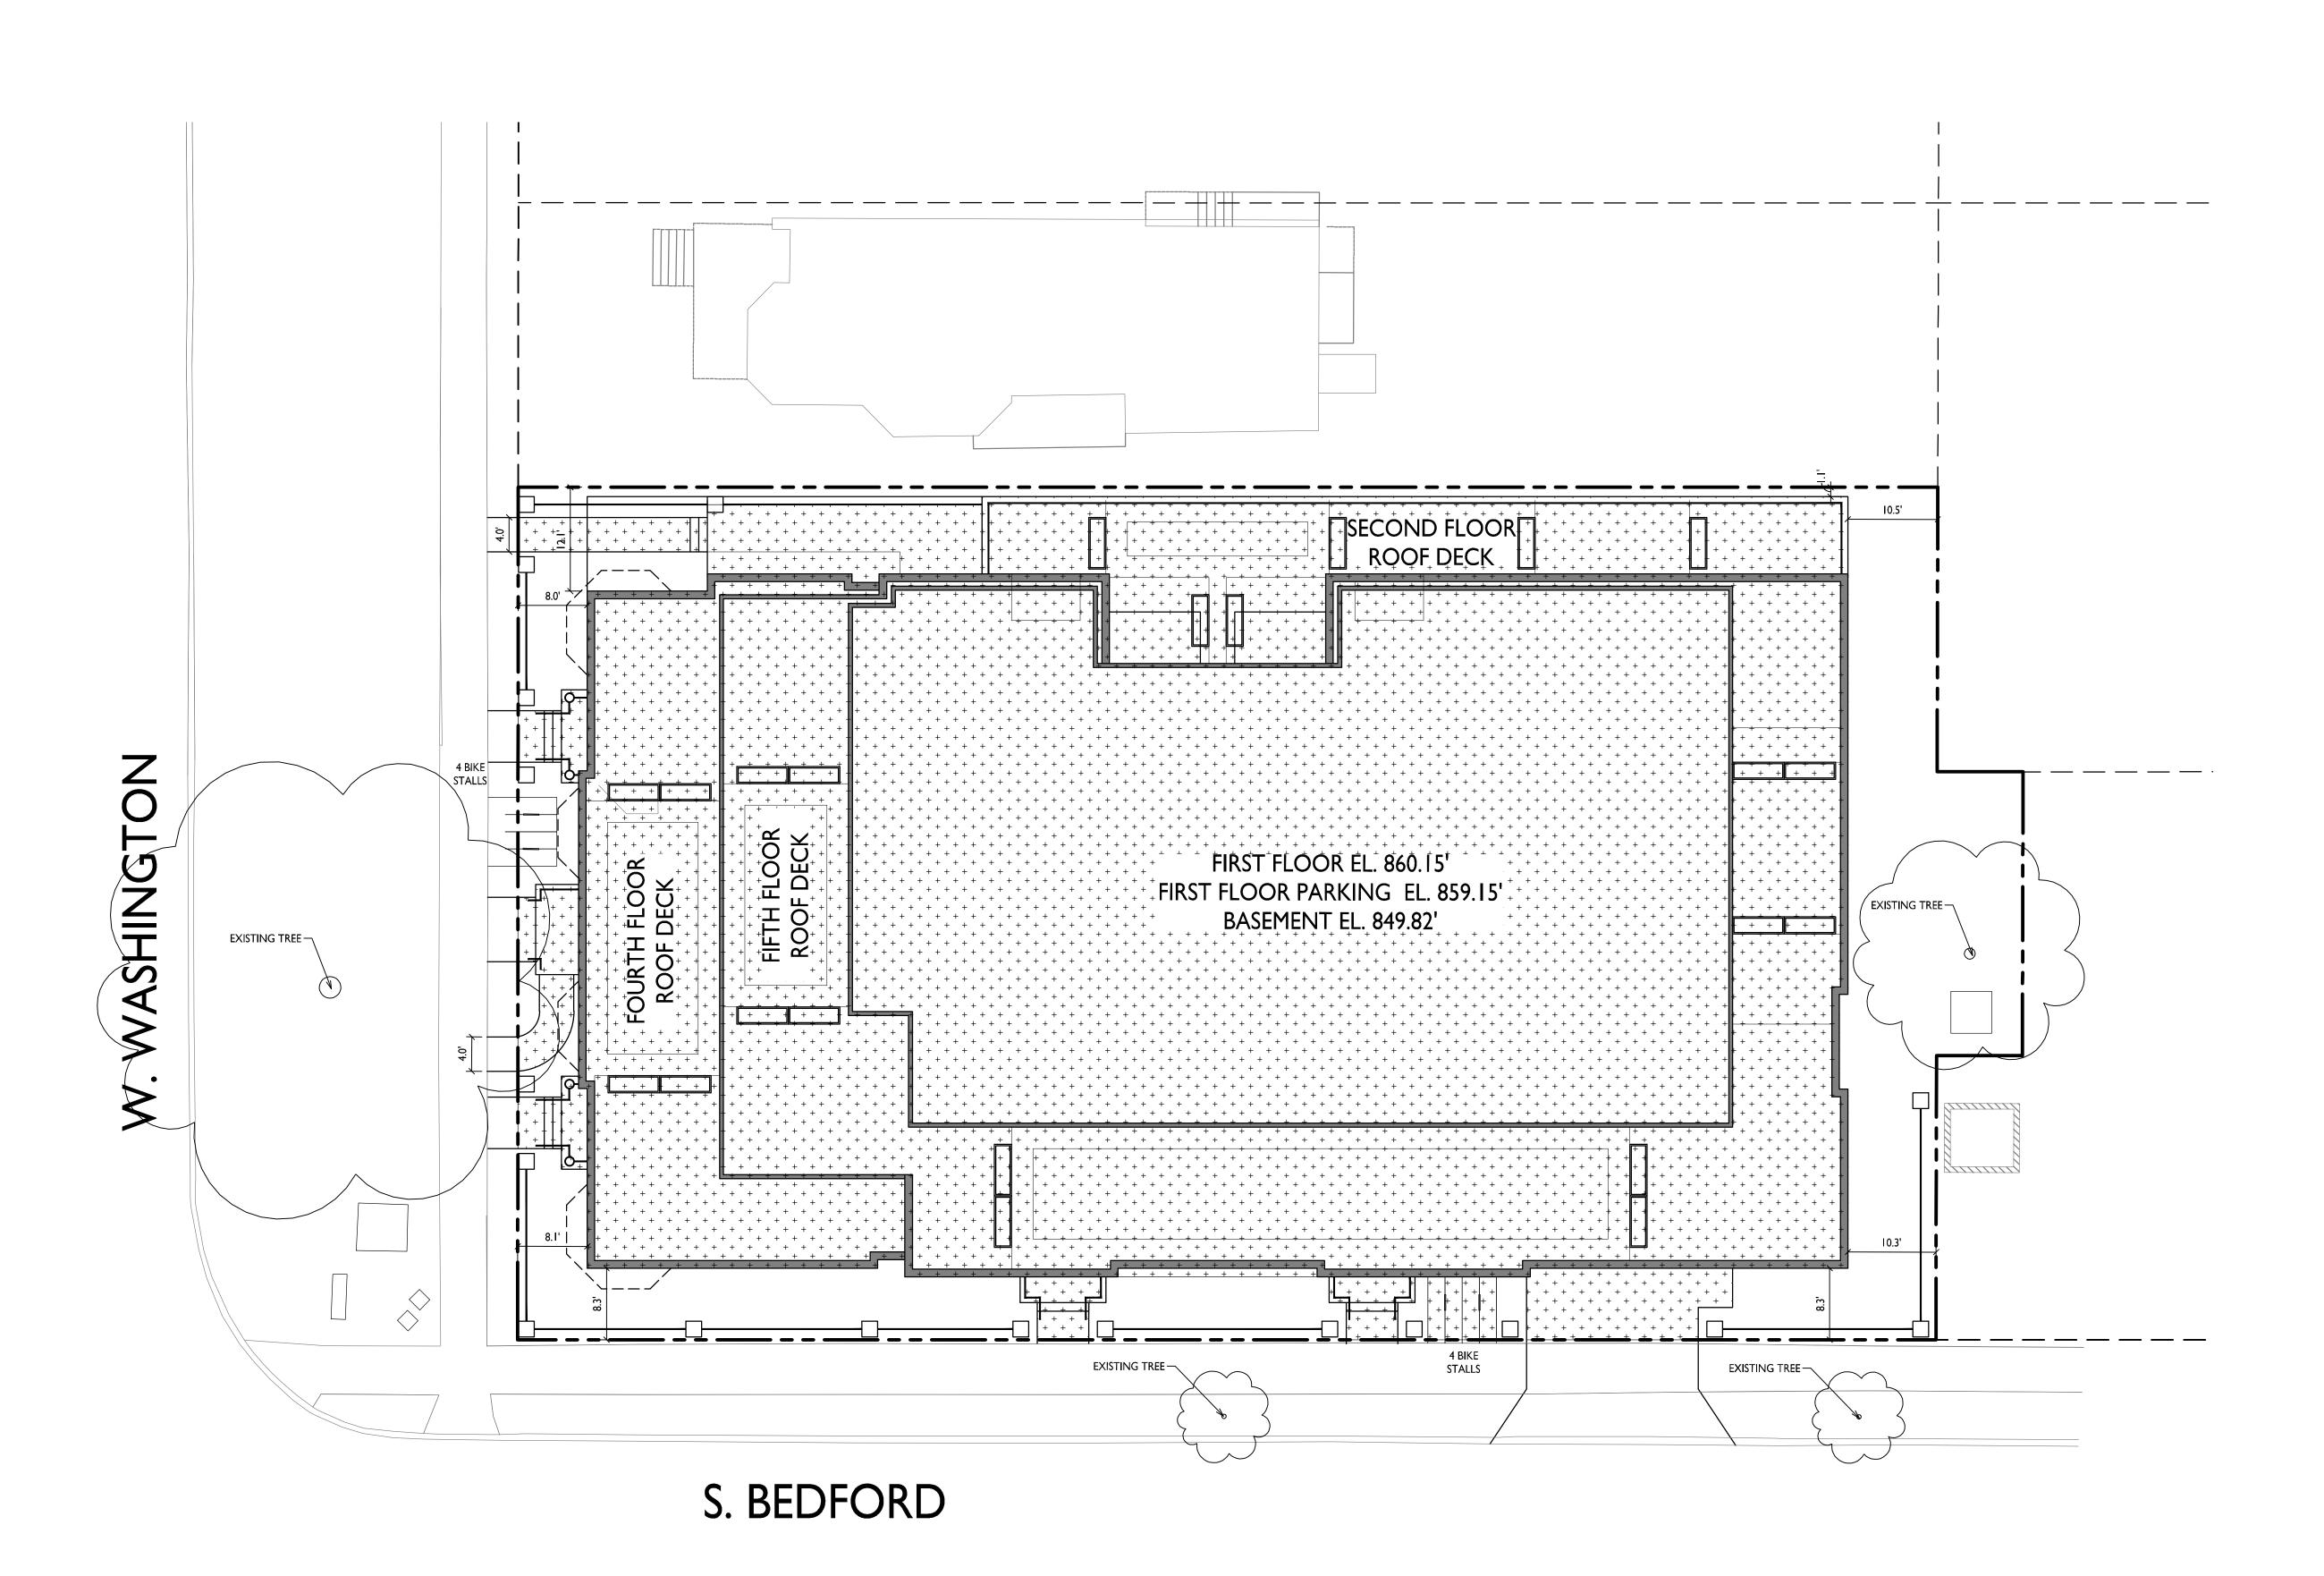
C-1.3

PROJECT NO. | 7

S. BEDFORD






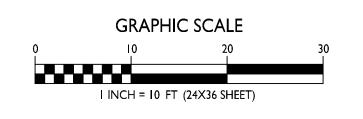

LOT COVERAGE

| INCH = 10 FT (24X36 SHEET)

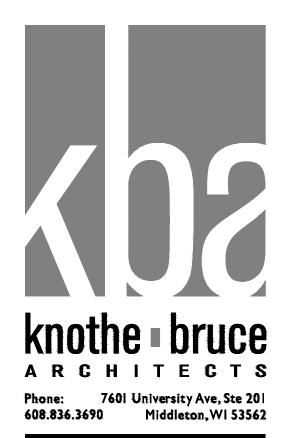

ISSUED

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Reissued to Plan Com & UDC - October 8,2018

PROJECT TITLE

SHEET TITLE


Lot Coverage


SHEET NUMBER


C-1.4

PROJECT NO.

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GRAPHIC SCALE FEET

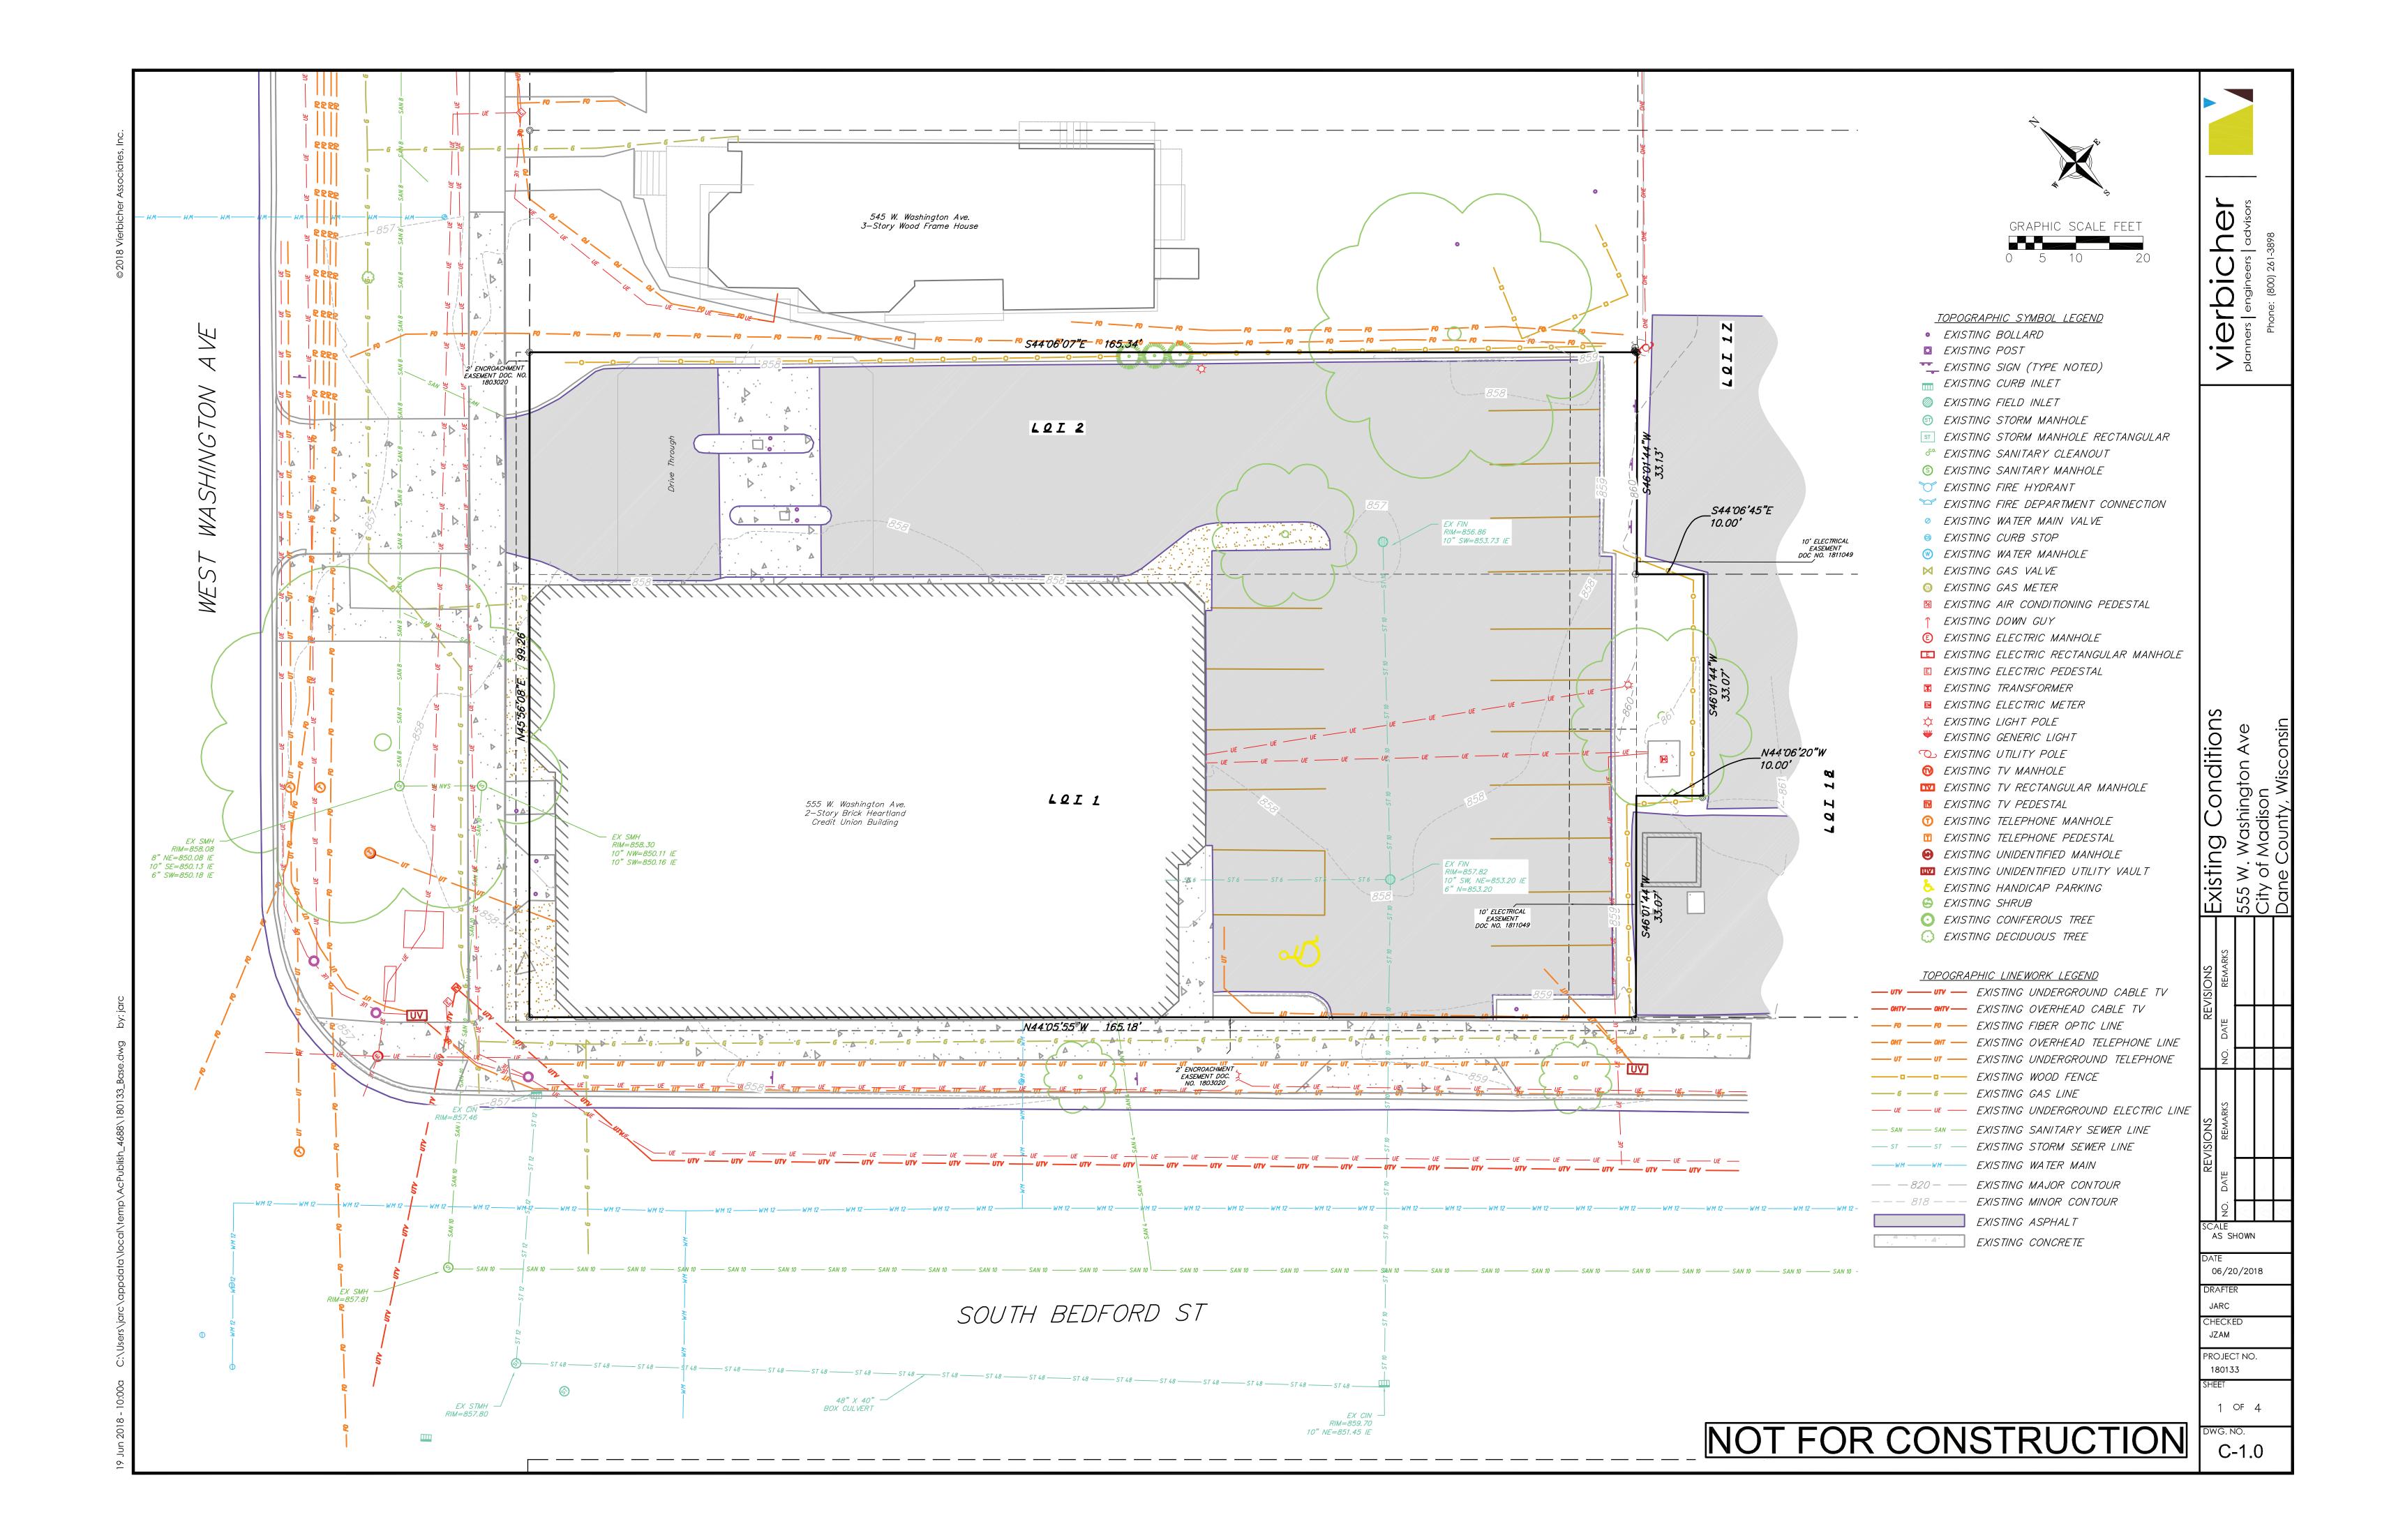GRADING AND EROSION CONTROL LEGEND --820-- EXISTING MAJOR CONTOURS EXISTING MINOR CONTOURS

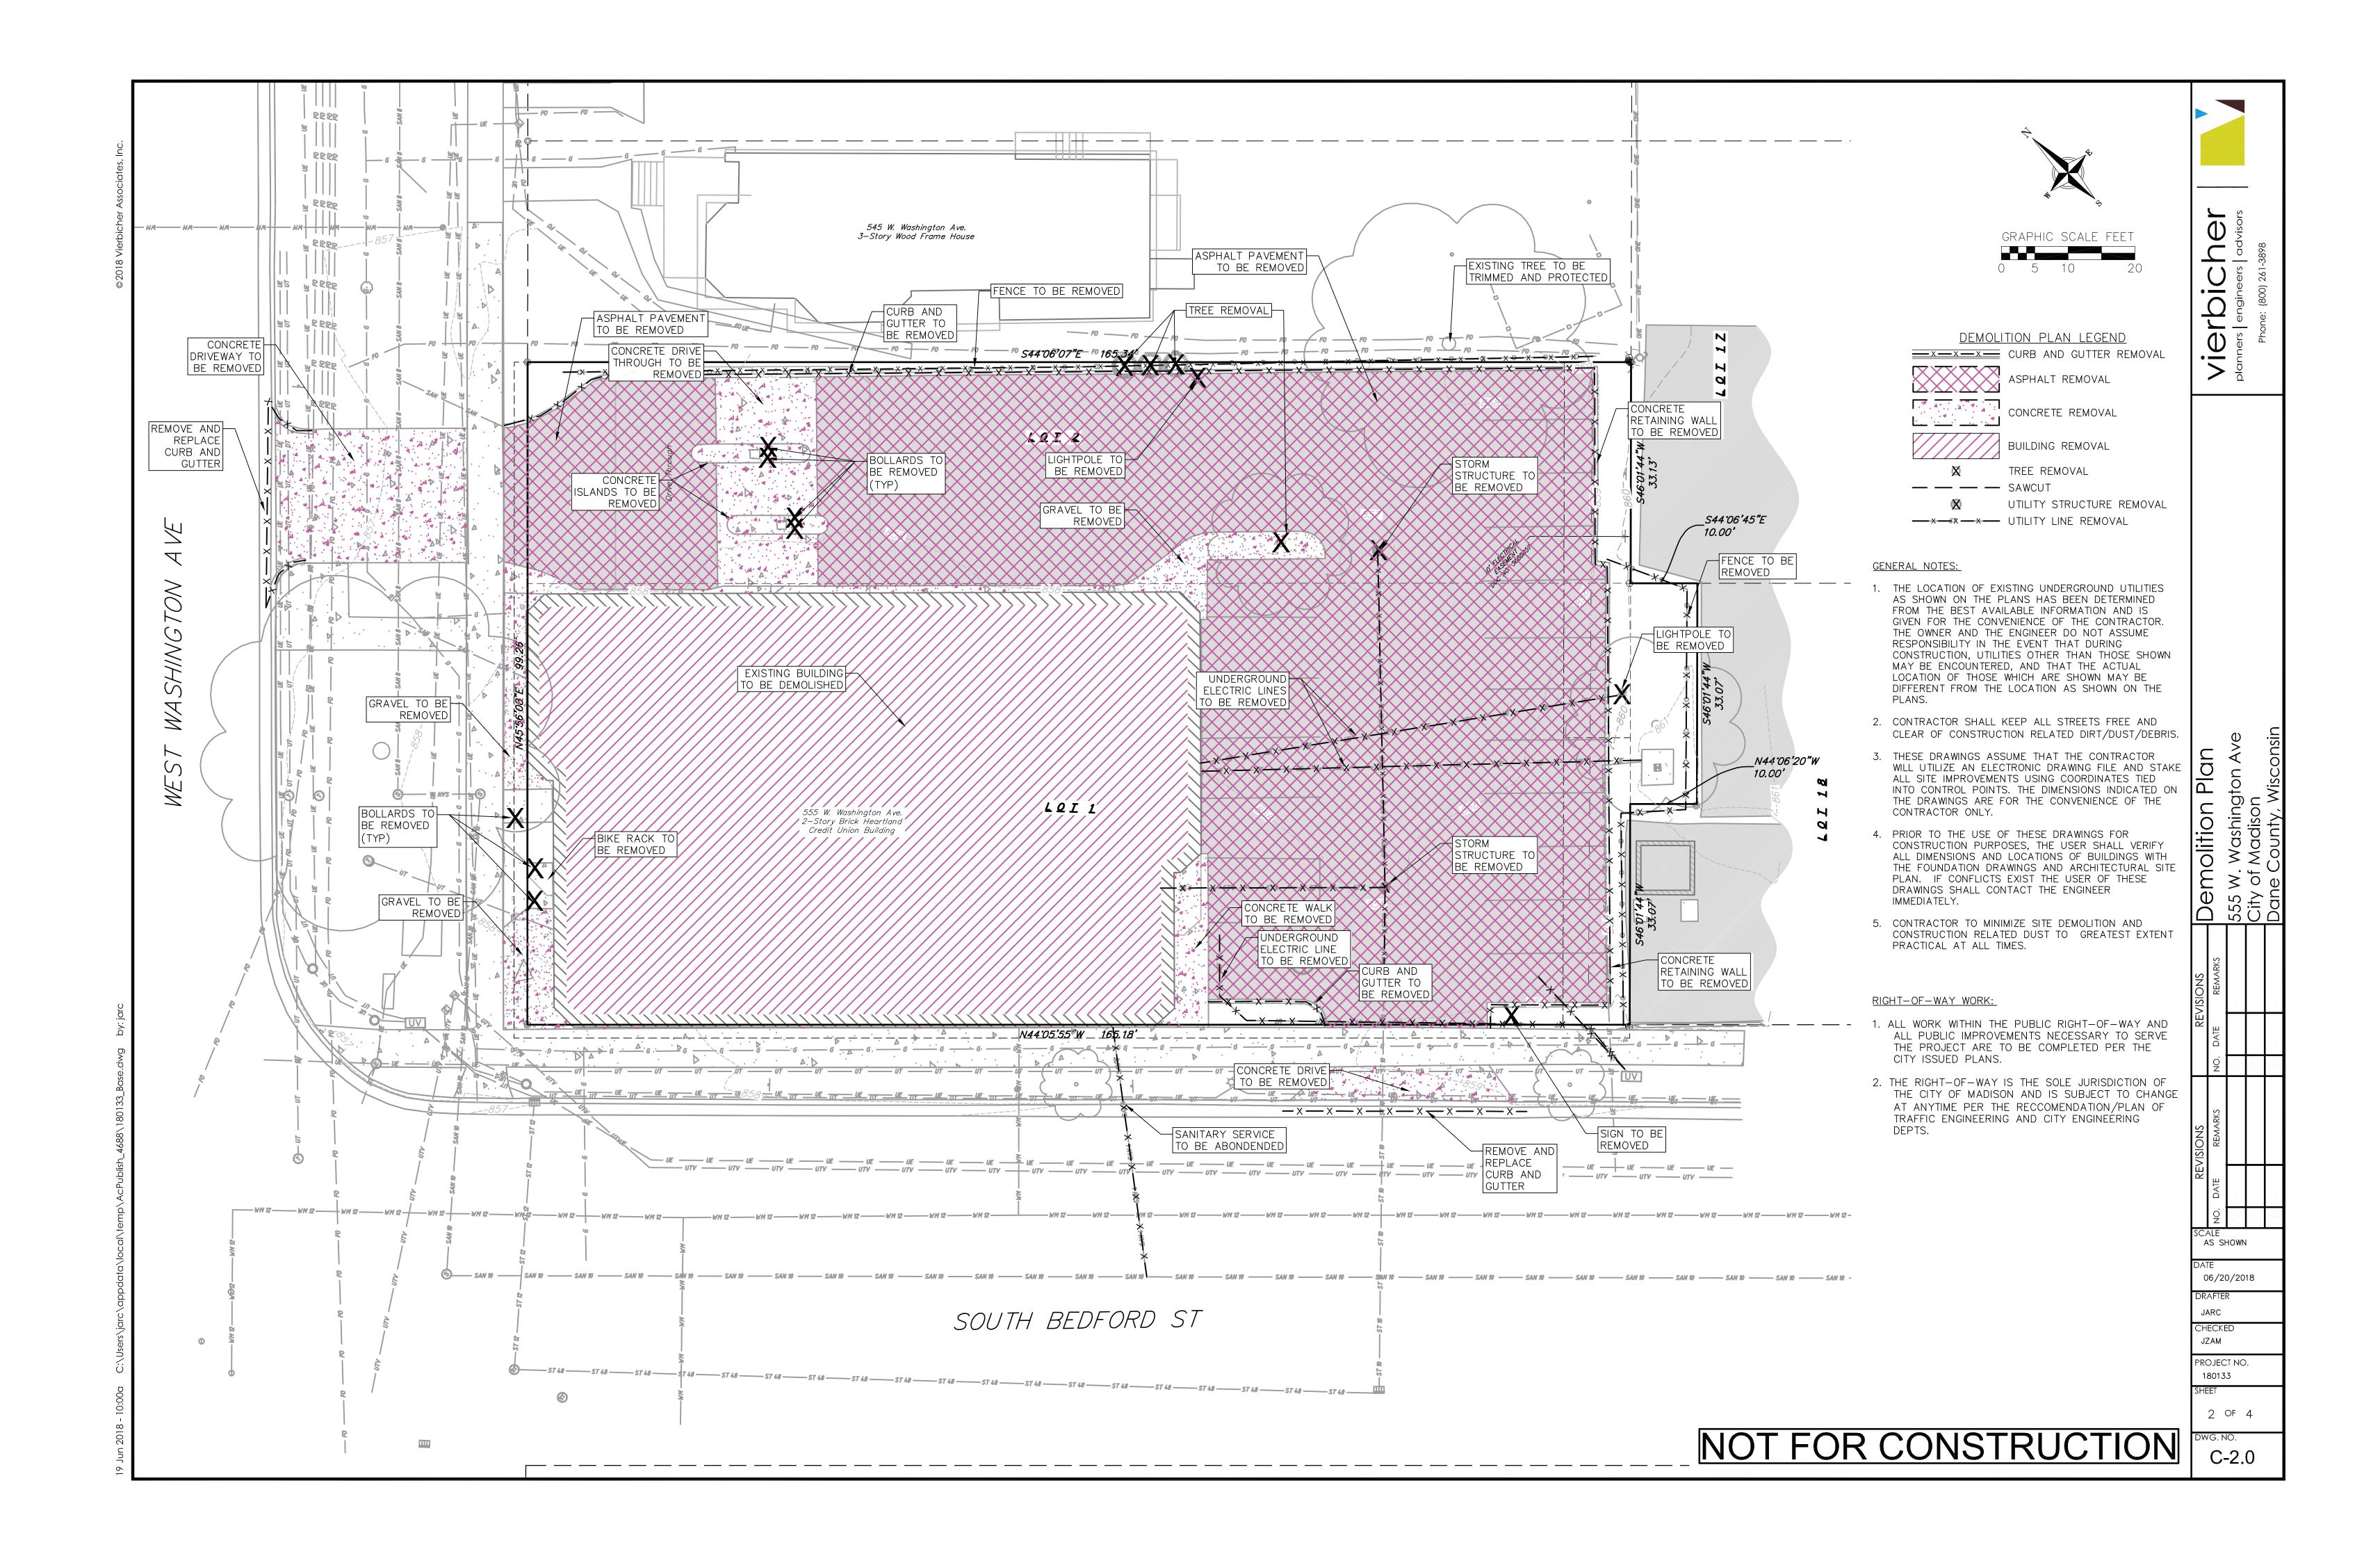 DITCH CENTERLINE - SILT FENCE/SILT SOCK DISTURBED LIMITS - ADA ACCESSIBLE ROUTE DRAINAGE DIRECTION

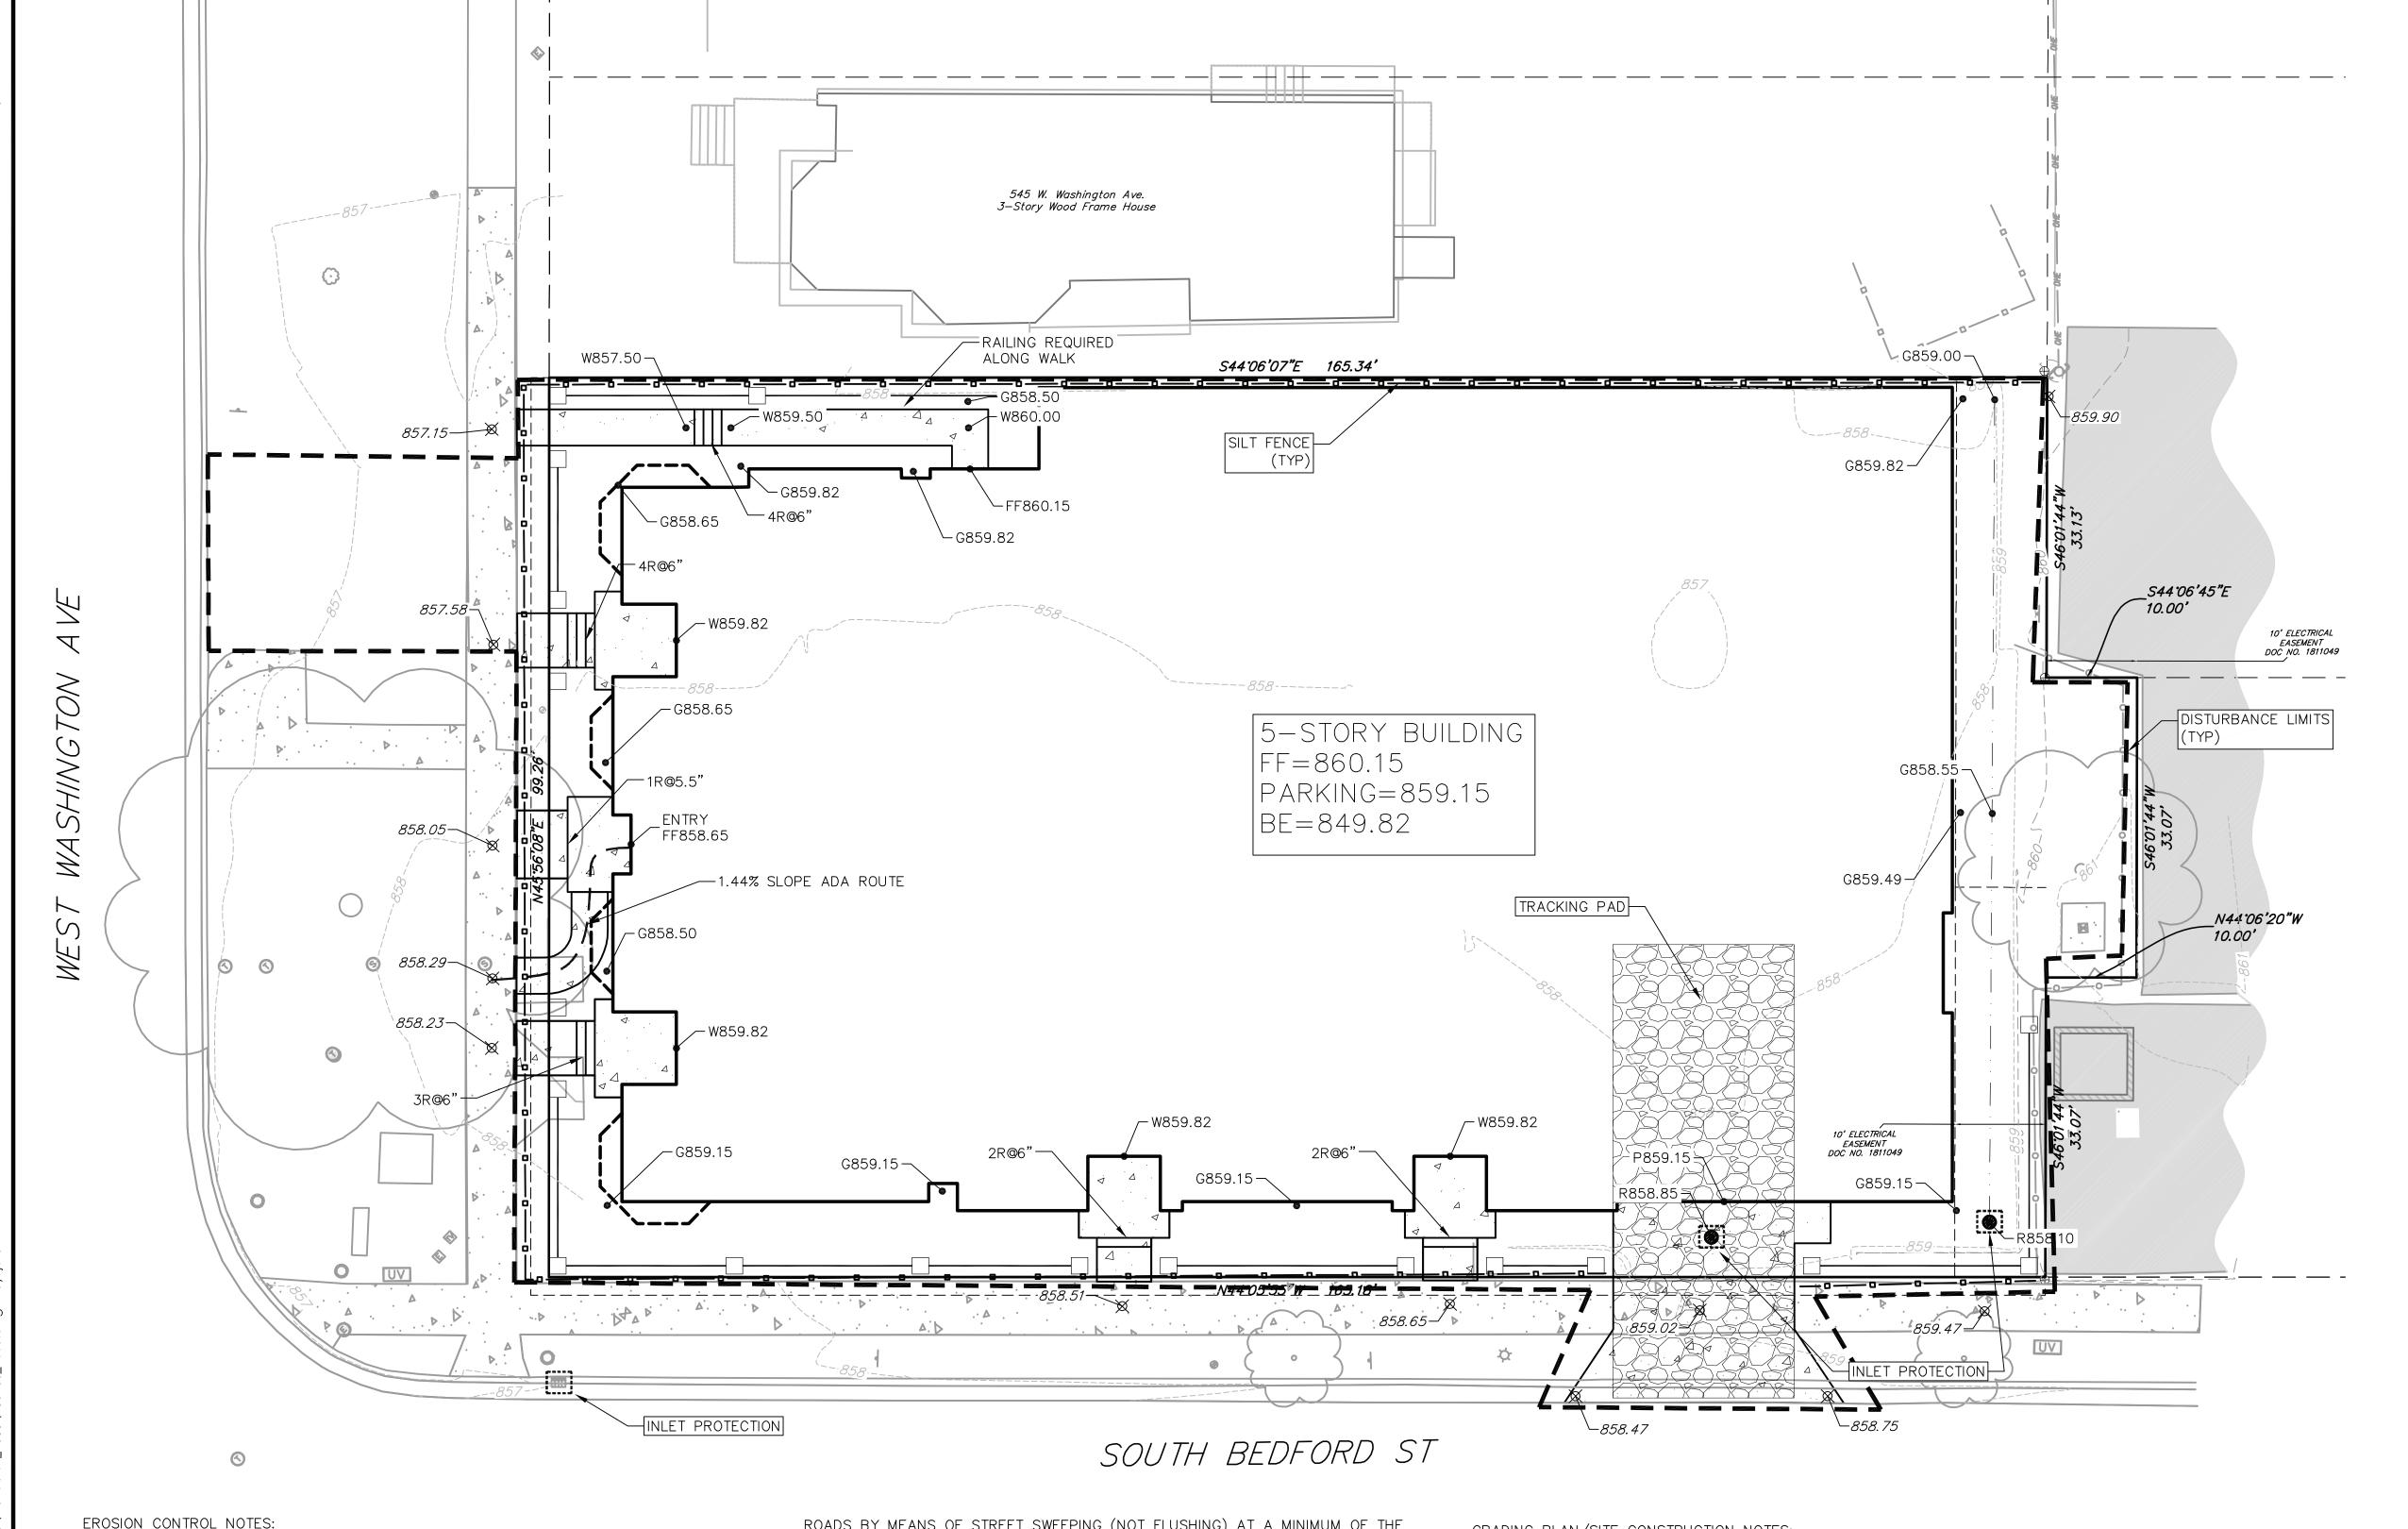2.92% PROPOSED SLOPE ARROWS EXISTING SPOT ELEVATIONS PROPOSED SPOT ELEVATIONS

INLET PROTECTION TRACKING PAD

<u>ABBREVIATIONS</u> TC - TOP OF CURB

P - PAVEMENT
W - TOP OF WALK
R - RISER
FF - FINISHED FLOOR G — GROUND FF - FINISHED FLOOR
BE - BASEMENT ELEVATION
R - RIM

**EROSION CONTROL NOTES:** 

- 1. CONTRACTOR SHALL KEEP ALL CITY STREETS FREE AND CLEAR OF CONSTRUCTION RELATED DIRT/DUST/DEBRIS.
- 2. INSTALL A 50'L X 20'W X 1.5'D TRACKING PAD AT THE SITE ENTRANCE. THE TRACKING PAD SHALL BE MAINTAINED/REPAIRED AS NECESSARY TO ACCOMMODATE CONSTRUCTION.
- 3. THE CONTRACTOR IS REQUIRED TO MAKE EROSION CONTROL INSPECTIONS AT THE END OF EACH WEEK AND WHEN 0.5 INCHES OF RAIN FALLS WITHIN 24 HOURS. INSPECTION REPORTS SHALL BE PREPARED AND FILED AS REQUIRED BY THE DNR. ALL MAINTENANCE/REPAIR WILL FOLLOW AN INSPECTION WITHIN 24 HOURS.
- 4. INSTALL WISDOT TYPE D INLET PROTECTION IN EXISTING CURB INLETS AND WISDOT TYPE A IN FIELD INLETS.
- 5. ANY DAMAGE TO THE CITY PAVEMENT, INCLUDING DAMAGE RESULTING FROM CURB REPLACEMENT, WILL REQUIRE RESTORATION IN ACCORDANCE WITH THE CITY
- 6. THE CONTRACTOR SHALL REMOVE ANY SEDIMENT TRACKED ONTO ADJACENT

ROADS BY MEANS OF STREET SWEEPING (NOT FLUSHING) AT A MINIMUM OF THE END OF EACH WORK DAY OR MORE AS NEEDED.

7. SEE DETAIL SHEETS FOR ADDITIONAL EROSION CONTROL NOTES.

### RIGHT-OF-WAY WORK:

- 1. ALL WORK WITHIN THE PUBLIC RIGHT-OF-WAY AND ALL PUBLIC IMPROVEMENTS NECESSARY TO SERVE THE PROJECT ARE TO BE COMPLETED PER THE CITY ISSUED PLANS.
- 2. THE RIGHT-OF-WAY IS THE SOLE JURISDICTION OF THE CITY OF MADISON AND IS SUBJECT TO CHANGE AT ANYTIME PER THE RECCOMENDATION/PLAN OF TRAFFIC ENGINEERING AND CITY ENGINEERING DEPTS.

## GRADING PLAN/SITE CONSTRUCTION NOTES:

- 1. CONCRETE SIDEWALK TO BE 5" THICK, CONSTRUCTED ON A BASE OF 4" COMPACTED SAND OR CRUSHED STONE.
- 2. CONTRACTOR TO OBTAIN ANY NECESSARY UTILITY CONNECTION, DEMOLITION, DRIVEWAY CONNECTION, RIGHT-OF-WAY AND EXCAVATION PERMITS PRIOR TO CONSTRUCTION.
- 3. ANY SIDEWALK AND CURB & GUTTER ABUTTING THE PROPERTY SHALL BE REPLACED IF IT IS DAMAGED DURING CONSTRUCTION OR IF THE CITY ENGINEERING DEPARTMENT DETERMINES THAT IT IS NOT AT A DESIRABLE GRADE, REGARDLESS OF WHETHER THE CONDITION EXISTED PRIOR TO BEGINNING CONSTRUCTION.
- 4. TYPICAL SIDEWALK CROSS SECTION IS 1.5% SLOPE. THIS APPLIES TO ALL WALKWAYS IN THIS PLAN UNLESS OTHERWISE NOTED.

NOT FOR CONSTRUCTION

vierbicher

Erosion


SCALE AS SHOWN

06/20/2018 JARC

CHECKED JZAM PROJECT NO. 180133

3 OF 4


C-3.0

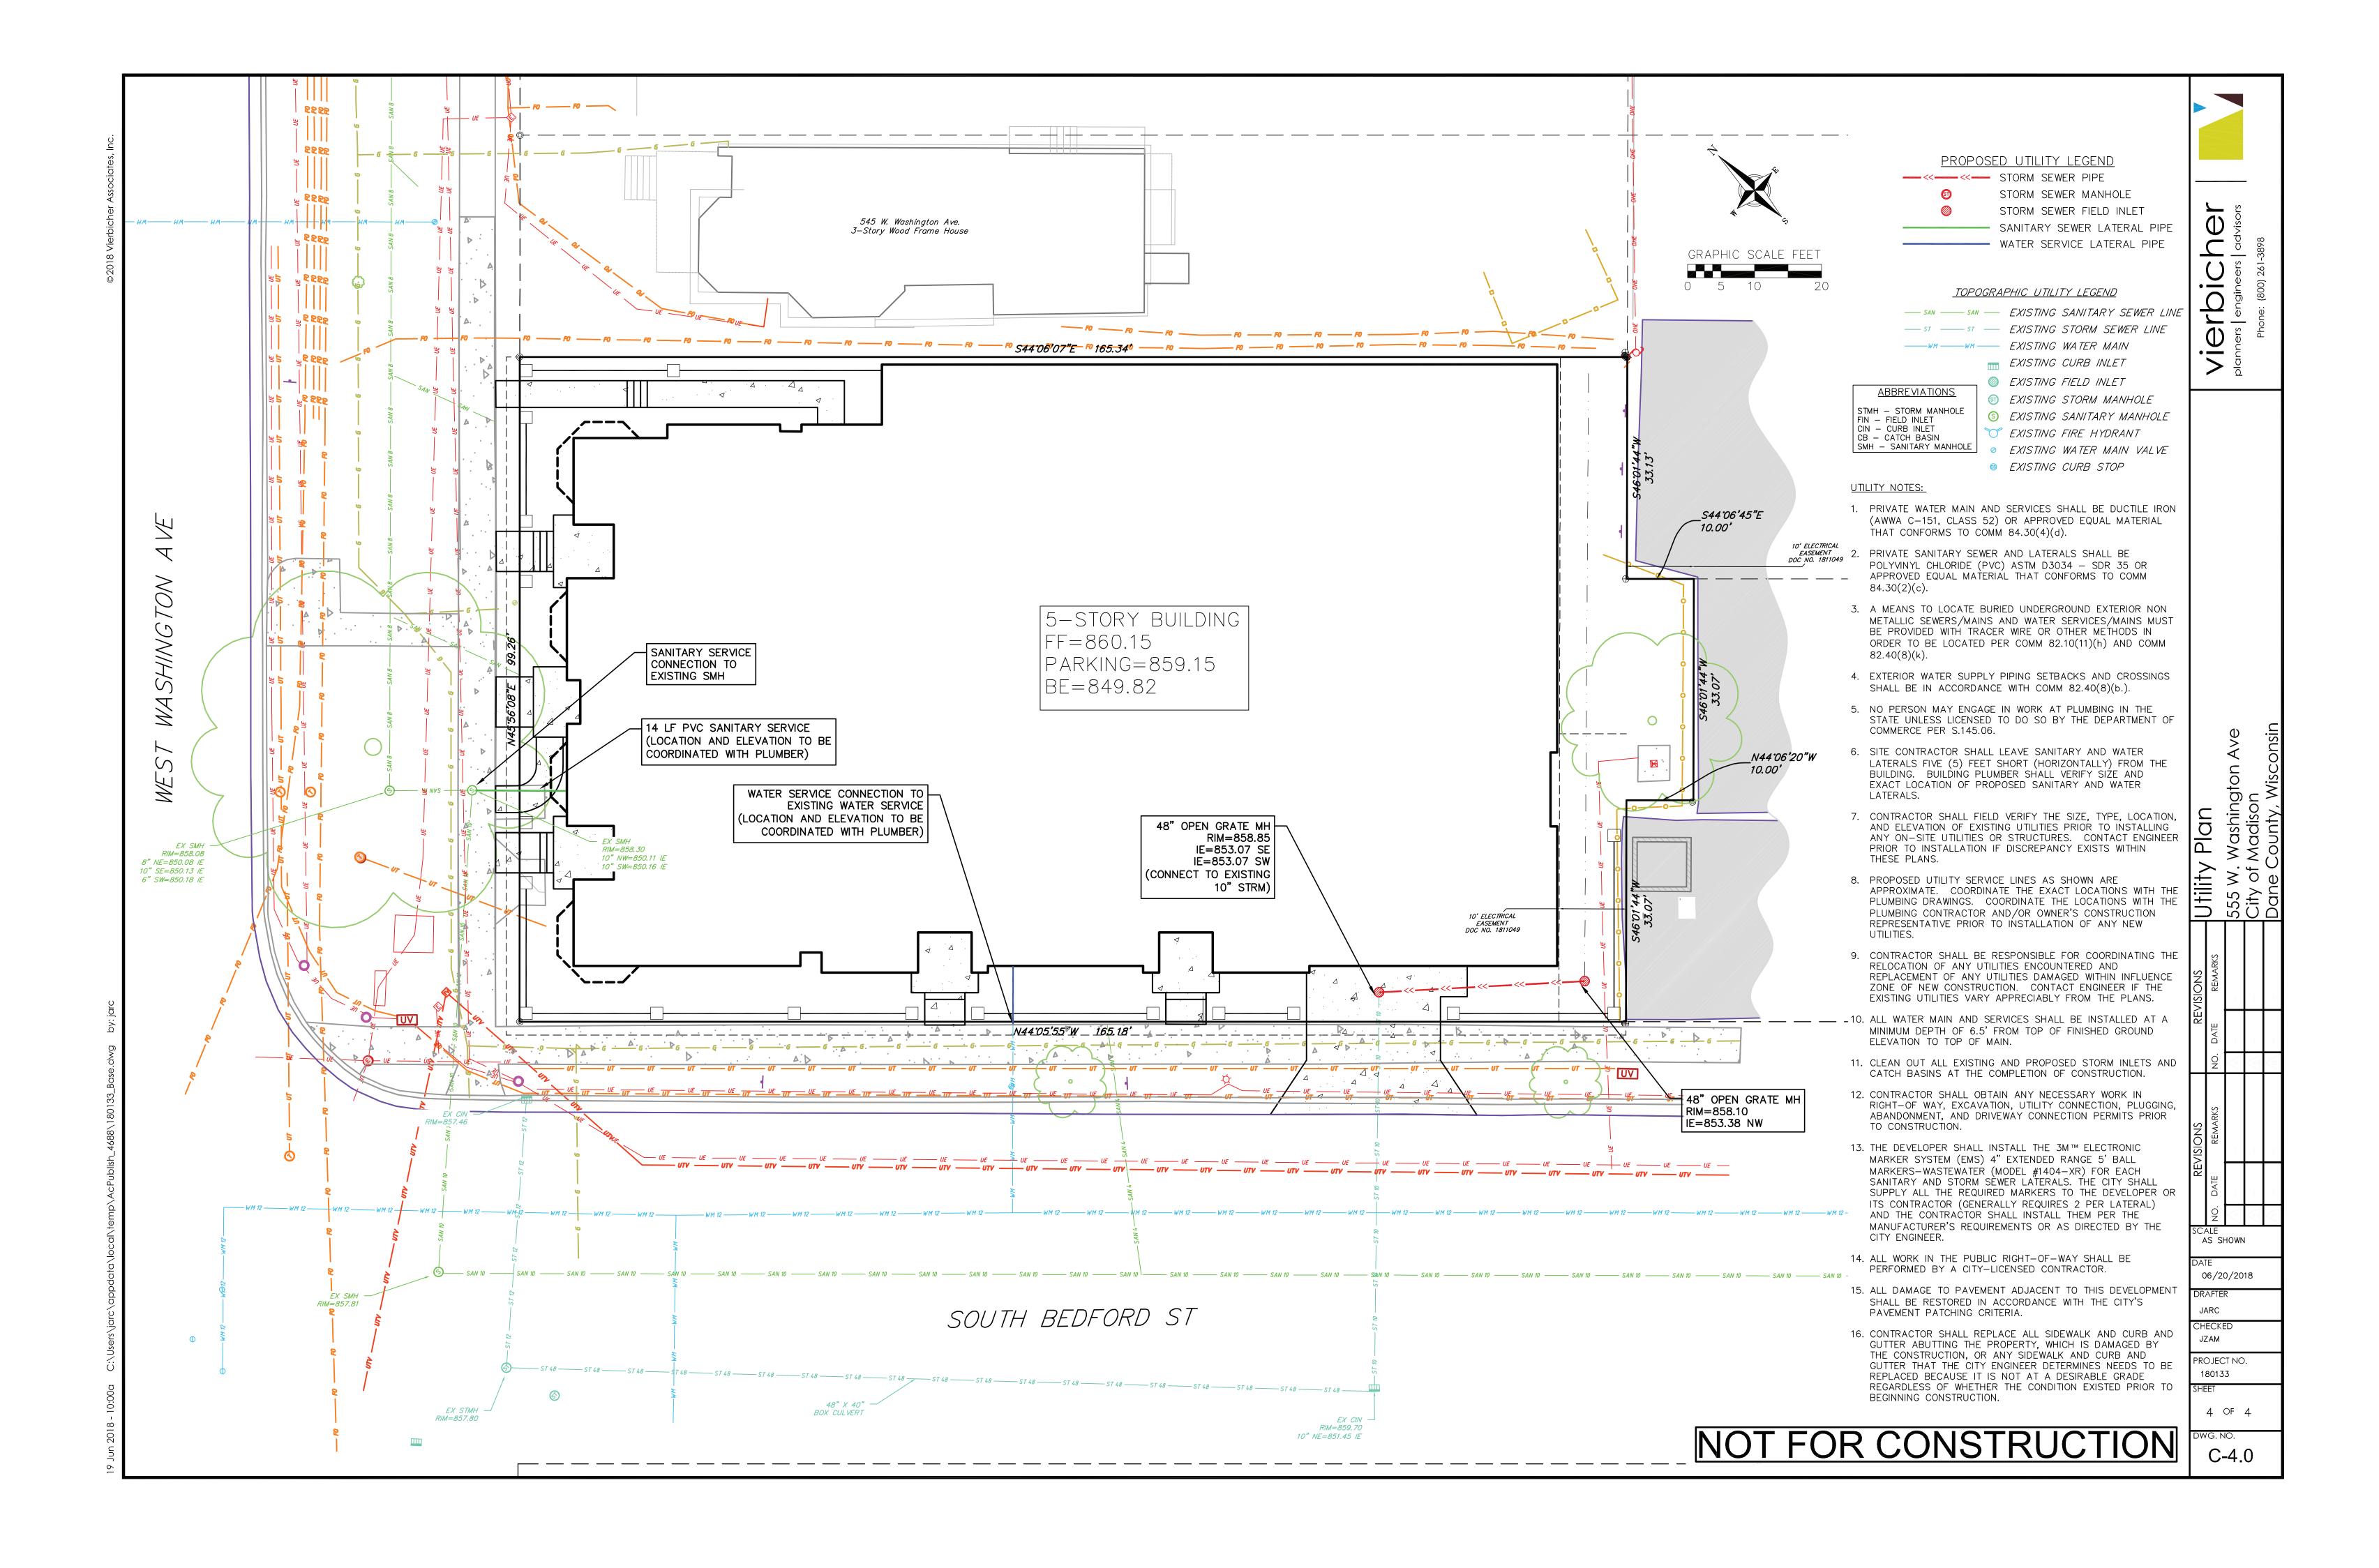

## NOTES 1. IT IS THE CONTRACTOR'S RESPONSIBILITY TO FIELD VERIFY SURVEY INFORMATION AND SITE CONDITIONS PRIOR TO START OF CONSTRUCTION AND REPORT ANY DISCREPANCIES. CONTRACTOR SHALL CONTACT DIGGER'S HOTLINE TO LOCATE ALL PUBLIC AND PRIVATE UTILITIES PRIOR TO START OF CONSTRUCTION. ANY DAMAGE CAUSED TO EXISTING UTILITIES, EITHER SHOWN OR NOT, SHALL BE REPAIRED AND PAID FOR AT THE CONTRACTOR'S EXPENSE. 2. CONTRACTOR SHALL PROTECT BENCHMARKS. 3. ALL TREES SHOWN TO BE RETAINED WITHIN THE PUBLIC RIGHT-OF-WAY SHALL BE PROTECTED DURING CONSTRUCTION WITH TREE PROTECTION FENCING. ALL TREE PROTECTION FENCING SHALL BE IN PLACE PRIOR TO ANY SITE WORK, PERFORM ALL WORK IN THE RIGHT-OF-WAY IN ACCORDANCE WITH CITY OF MADISON STANDARD 107.13 "TREE PROTECTION SPECIFICATION". 4. ALL EXISTING PLANT MATERIAL IS SHOWN AT EXISTING, APPROXIMATED SIZE PER CITY OF MADISON STANDARDS. 5. ALL WRAPPINGS, WIRE BASKETS, BURLAP, AND OTHER MISCELLANEOUS MATERIAL SHALL BE COMPLETELY REMOVED FROM ALL SHRUB AND TREE ROOT BALLS PRIOR TO INSTALLATION. 6. ALL LAWN AREAS DISTURBED BY CONSTRUCTION ACTIVITIES SHALL BE RE-SEEDED AT NO COST TO OWNER. 7. CONTRACTOR IS RESPONSIBLE FOR WATERING AND MAINTENANCE OF PLANT MATERIAL. 8. ALL WORK IN THE PUBLIC RIGHT-OF-WAY SHALL BE PERFORMED BY A CITY LICENSED CONTRACTOR PER CITY STANDARD SPECIFICATIONS. 9. CONTRACTOR SHALL OBTAIN PERMIT TO EXCAVATE IN THE PUBLIC RIGHT-OF-WAY. 10. CONTRACTOR SHALL INSTALL TREE PROTECTION FENCING IN THE AREA BETWEEN THE CURB AND SIDEWALK AND EXTEND IT AT LEAST 5-FEET FROM BOTH SIDES OF THE TREE ALONG THE LENGTH OF THE TERRACE. NO EXCAVATION IS PERMITTED WITHIN 5-FEET OF THE PROPOSED 6' HT. OUTSIDE EDGE OF A TREE TRUNK. IF EXCAVATION WITHIN PRIVACY FENCE 5-FEET OF ANY TREE IS NECESSARY, CONTRACTOR SHALL CONTACT CITY FORESTRY (BRAD HOFMANN, 266-4816) PRIOR TO EXCAVATION TO ASSESS THE IMPACT TO THE TREE AND ROOT SYSTEM. TREE PRUNING SHALL BE COORDINATED WITH CITY FORESTRY PRIOR TO THE START OF CONSTRUCTION. TREE PROTECTION SPECIFICATIONS CAN BE FOUND IN SECTION 107.13 OF CITY OF MADISON STANDARD SPECIFICATIONS FOR PUBLIC WORKS CCF CONSTRUCTION. ANY TREE REMOVALS THAT ARE REQUIRED FOR CONSTRUCTION AFTER THE DEVELOPMENT PLAN IS APPROVED WILL REQUIRE AT LEAST 72-HOUR WAIT PERIOD BEFORE A TREE REMOVAL PERMIT CAN BE ISSUED BY FORESTRY, TO NOTIFY THE ALDER OF THE CHANGE IN Tmt THE TREE PLAN. 11. CONTRACTOR SHALL CONTACT CITY FORESTRY (BRAD gck HOFMANN, 266-4816) AT LEAST ONE WEEK PRIOR TO PLANTING ANY NEW TREES WITHIN THE PUBLIC RIGHT-OF-WAY TO SCHEDULE INSPECTING THE NURSERY STOCK, REVIEW PLANTING SPECIFICATIONS AND INDICATE Hq PLANTING LOCATIONS WITH THE LANDSCAPE CONTRACTOR. \*\*\* PROPOSED-PYLON & ORNAMENTAL FENCING PROPOSED -BIKE PARKING WEST WASHINGTON AVENUE

EX. 28" ASH

asb 33

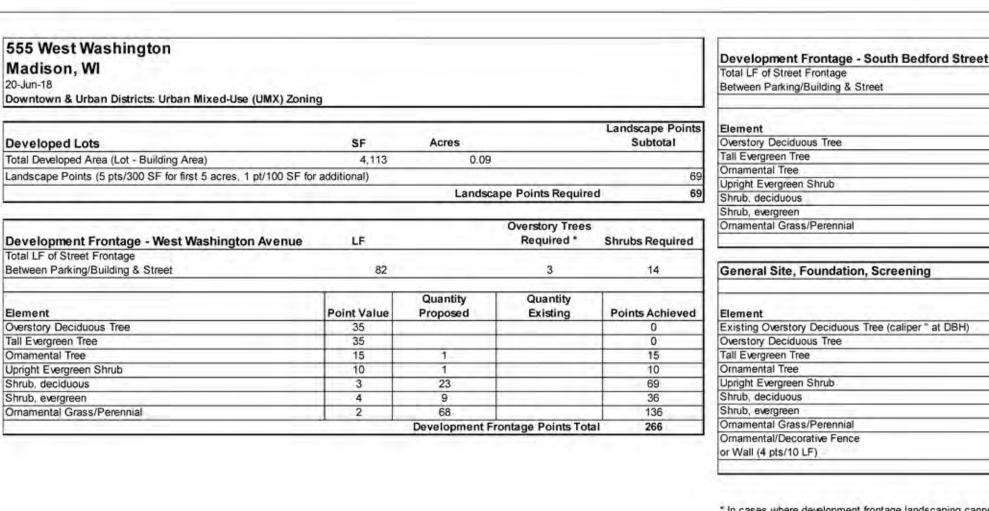

PROPOSED -

**PLANTERS** 

00000 00000 00000

RAISED

EXISTING

UTILITY CABINETS Pesosoooooo

PROTECT -EX. 6" PEAR

PROPOSED — PYLON & ORNAMENTAL

FENCING

SOUTH BEDFORD STREET

Element	Point Value	Quantity Proposed	Quantity Existing	Points Achieve
Overstory Deciduous Tree	35			0
Tall Evergreen Tree	35			0
Ornamental Tree	15	2		30
Jpright Evergreen Shrub	10	4		40
Shrub, deciduous	3	27		81
Shrub, evergreen	4	22		88
Ornamental Grass/Perennial	2	230		460
		Development Fr	ontage Points Tot	tal 699
General Site, Foundation, Screening				
Element	Point Value	Quantity Proposed	Quantity Existing	Points Achieved
Existing Overstory Deciduous Tree (caliper " at DBH)		Troposcu	Landing	14
existing Overstory Deciduous Tree (caliber at DBH)	14			14
	35		4	140
Overstory Deciduous Tree  [Fall Evergreen Tree]			4	
Overstory Deciduous Tree	35		4	140
Overstory Deciduous Tree Trail Evergreen Tree Ornamental Tree	35 35		4	140
Overstory Deciduous Tree Fall Evergreen Tree	35 35 15	21	4	140 0 0
Overstory Deciduous Tree Fall Evergreen Tree Ornamental Tree Upright Evergreen Shrub	35 35 15 10	21 16	4	140 0 0
Overstory Deciduous Tree Fall Evergreen Tree Ornamental Tree Upright Evergreen Shrub Shrub, deciduous	35 35 15 10 3		4	140 0 0 0 0 0
Overstory Deciduous Tree Fall Evergreen Tree Ornamental Tree Upright Evergreen Shrub Shrub, deciduous Shrub, evergreen	35 35 15 10 3 4	16	4	140 0 0 0 0 0 63 64
Overstory Deciduous Tree Tall Evergreen Tree Ornamental Tree Upright Evergreen Shrub Shrub, deciduous Shrub, evergreen Ornamental Grass/Perennial	35 35 15 10 3 4	16	4	140 0 0 0 0 0 63 64
Overstory Deciduous Tree Fall Evergreen Tree Ornamental Tree Upright Evergreen Shrub Shrub, deciduous Shrub, evergreen Ornamental Grass/Perennial Ornamental/Decorative Fence	35 35 15 10 3 4 2	16 72 20.5	tion Plantings Tot	140 0 0 0 0 63 64 144

Overstory Trees

Required \*

PROPOSED BIKE

PARKING (4)

for the required landscaping.

PLANT LIST Key Botanical Name Common Name Quantity Size Spec Comments Mature Size Deciduous Trees ARH | Amelanchier x grandiflora 'Robin Hill' Robin Hill Serviceberry 2 2" Cal. B&B Upright multi-stem CF Carpinus caroliniana 'J.N. Upright' Firespire Musclewood 1 2" Cal. B&B Upright multi-stem 20' ht x 8-10' sp Crimson Spire English Oak C Quercus robur 'Crimschmidt' 4 2" Cal. B&B Single, straight leader 45' ht x 15' sp Evergreen Trees Juniperus chinensis 'Trautman' 5 5' Ht. B&B Trautman Juniper 12' ht x 4' sp Deciduous Shrubs Aml Aronia melanocarpa Low Scape Mound Low Scape Mound Aronia 20 2 Gal. Cont. Space 2'-0" σ.c. 1-2' ht x 2-3' sp lq Hydrangea quercifolia 'Pee Wee' Oakleaf Hydrangea 13 2 Gal. Cont. Space 2.5'-0" o.c 2-4' ht x 2-3' sp dm Physocarpus opulifolius 'Donna May Little Devil Ninebark 2 Gal. Cont. Space 2.5'-0" o.c 3-4' ht x 3-4' sp 22 2 Gal. Cont. Space 2'-0" o.c. 2-3' ht x 2-3' sp bt Spiraea betulifolia 'Tor' Birchleaf Spirea Evergreen Shrubs Jpk Juniperus chinensis 'Pfitzeriana Kallay' Kallays Compact Pfitzer Juniper 25 2 Gal. Cont. Space 3.5'-0" o.c. 3' ht x 6-8' sp 8 2 Gal. Cont. Space 4'-0" o.c. Juniperus sabina 'Buffalo' Buffalo Juniper 1' ht x 4-6' sp Tauton Yew 21 2 Gal. Cont. Space 4'-0" o.c. 3-5' ht x 6-8' sp Tmt Taxus x media 'Tauntonii' Perennials/Grasses/Groundcovers Summer Beauty Allium 171 4-Inch Pot Space 1'-0" o.c. 1-1.5' ht x 1.5-2' sp asb Allium tanguticum 'Summer Beauty' Blue Ice Blue Star 11 4-Inch Pot Space 1.5'-0" o.c. 1-1.5' ht x 1.5-2' sp bi Amsonia tabernaemontana 'Blue Ice' 6 2 Gal. Cont. Space 3'-0" o.c. acs Aralia cordata 'Sun King' Sun King Aralia 3-4' ht x 3-4' sp expm Echinacea x 'Pixie Meadowbrite' Pixie Meadowbrite Purple Coneflower 59 4-Inch Pot Space 1.5'-0" o.c. 1.5-2' ht x 1.5-2' sp .5-1' ht x .5-1' sp Biokovo Cranesbill 45 4-Inch Pot Space 1.5'-0" o.c. gck Geranium x cantabrigiense 'Karmina 1-2' ht x 1-1.5' sp 9 4-Inch Pot Space 1'-0" o.c. hmr Heuchera x 'Midnight Rose' Coral Bells 1' ht x 2-3' sp bc Hosta x 'Blue Cadet' 23 4-Inch Pot Space 1.5'-0" o.c. Plantain Lify hgs Hosta x 'Gold Standard' Gold Standard Plantain Lil 26 4-Inch Pot Space 2'-0" o.c. 2-3' ht x 2' sp 28 4-Inch Pot Space 1'-0" o.c. Kobold Spike Gayfeathe 1.5-3' ht x 1.5-2' sp sk Liatris spicata 'Kobold' k Nepeta x faassenii 'Kit Kat' 11 4-Inch Pot Space 2'-0" o.c. Kit Kat Catmint 1' ht x 2' sp 14 4-Inch Pot Space 1.5'-0" o.c. pdd Penstemon digitalis 'Dark Towers' Beard-tongue 3-4' ht x 1.5-2' sp v Rudbeckia fulgida speciosa 'Viette's Little Suzy' Black-Eyed Susan 24 4-Inch Pot Space 1'-0" o.c. 2-3' ht x 1.5-2' sp 18 4-Inch Pot Space 1.5'-0" o.c. 2-2.5' ht x 1.5' sp snc Salvia nemorosa 'Caradonna' Cardonna Sage 8-12" ht x 1.5' sp snm | Salvia nemorosa 'Marcus' 9 4-Inch Pot Space 1.5'-0" o.c. Woodland Sage 31 1 Gal. Cont. Space 1'-0" o.c. Sesleria autumnalis Autumn Moor Grass

ARCHITECTS Phone: 7601 University Ave. Ste 201 608.836.3690 Middleton, WI 53562



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PROJECT TITLE BAXTER West Washington Development


555 W Washington Ave.


SHEET TITLE Landscape Plan


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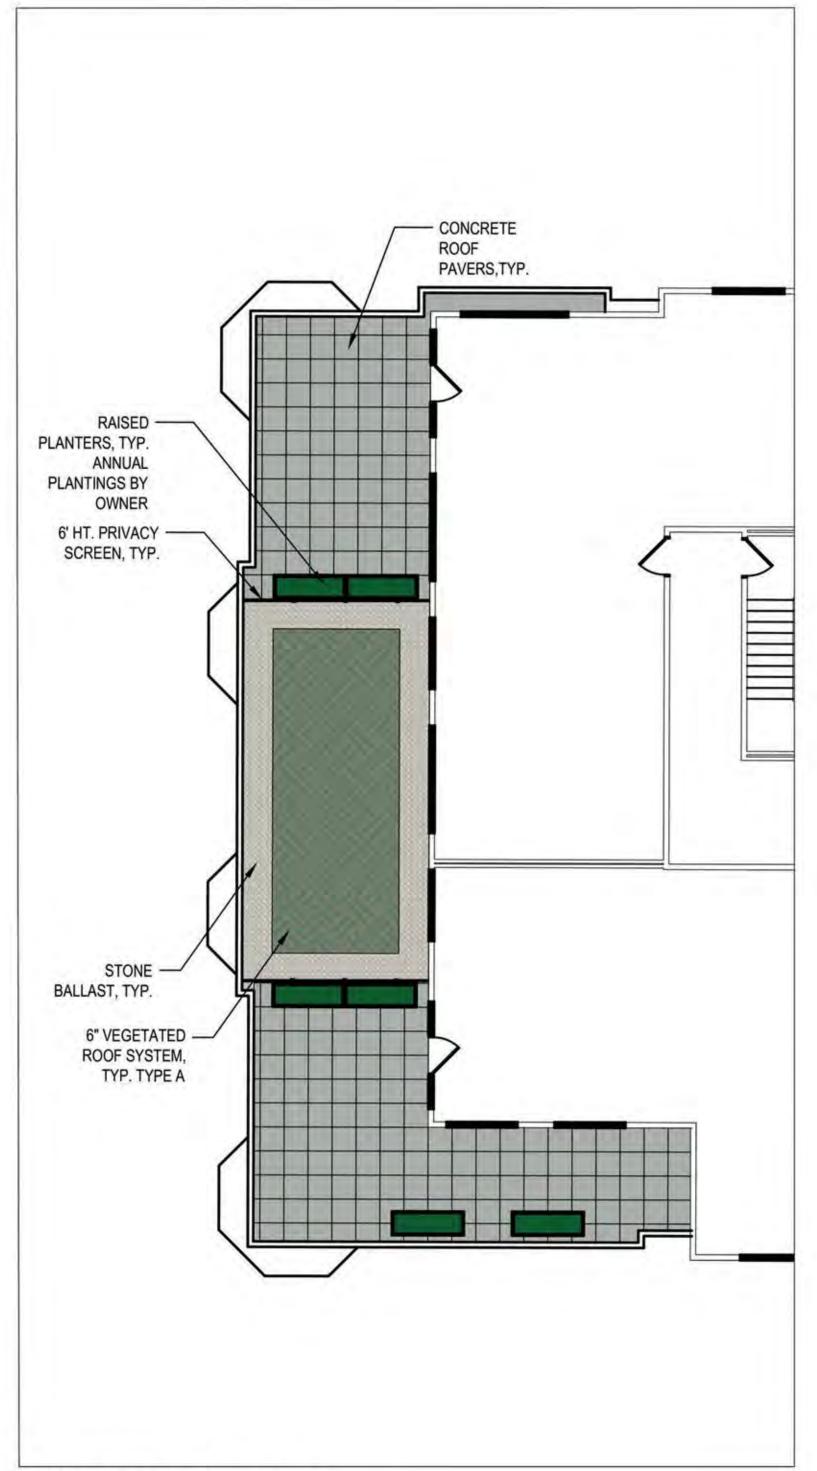
PROJECT NO.

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## FOURTH FLOOR TERRACE

Type A:	1
Propogated Sedum Tray 'Tough Extreme Mix'	
by Liveroof or approved equal. Interplant with	
2.5" perennial plugs.	
Perennial Plugs	
Allium tanguticum 'Summer Beauty'	Summer Beauty Allium
Calamintha nepeta 'Montrose White'	Montrose White Calamint
Sedum kamtschaticum 'Takahira Dake'	Takahira Dake Stonecrop
Sedum spectabilie 'Neon'	Neon Stonecrop
Sesleria autumnalis	Autumn Moor Grass
Type B:	
Propogated Sedum Tray 'Shade Serene Mix'	
by Liveroof or approved equal. Interplant with	L
2.5" perennial plugs.	
Perennial Plugs	1 11 11 11 11 11
Geranium maculatum	Wild Geranium
Heuchera villosa var. atropurpurea	Maple-leaved Alum Root
Smilacina racemosa	False Solomon's Seal
Dryopteris marginalis	Leatherleaf Woodfern
Tiarella cordifolia	Foamflower

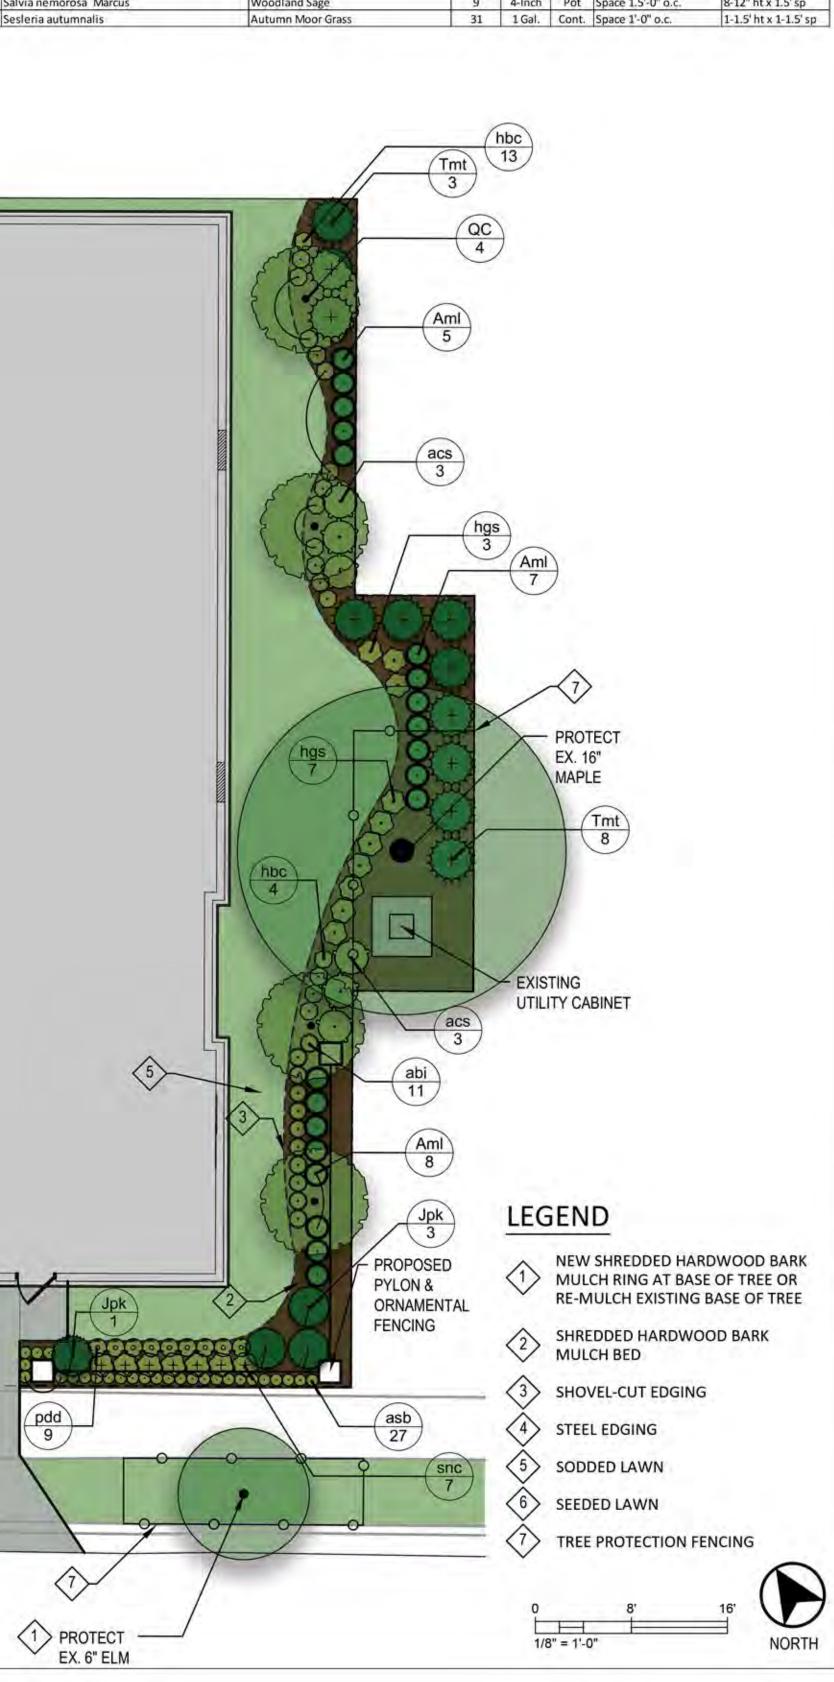

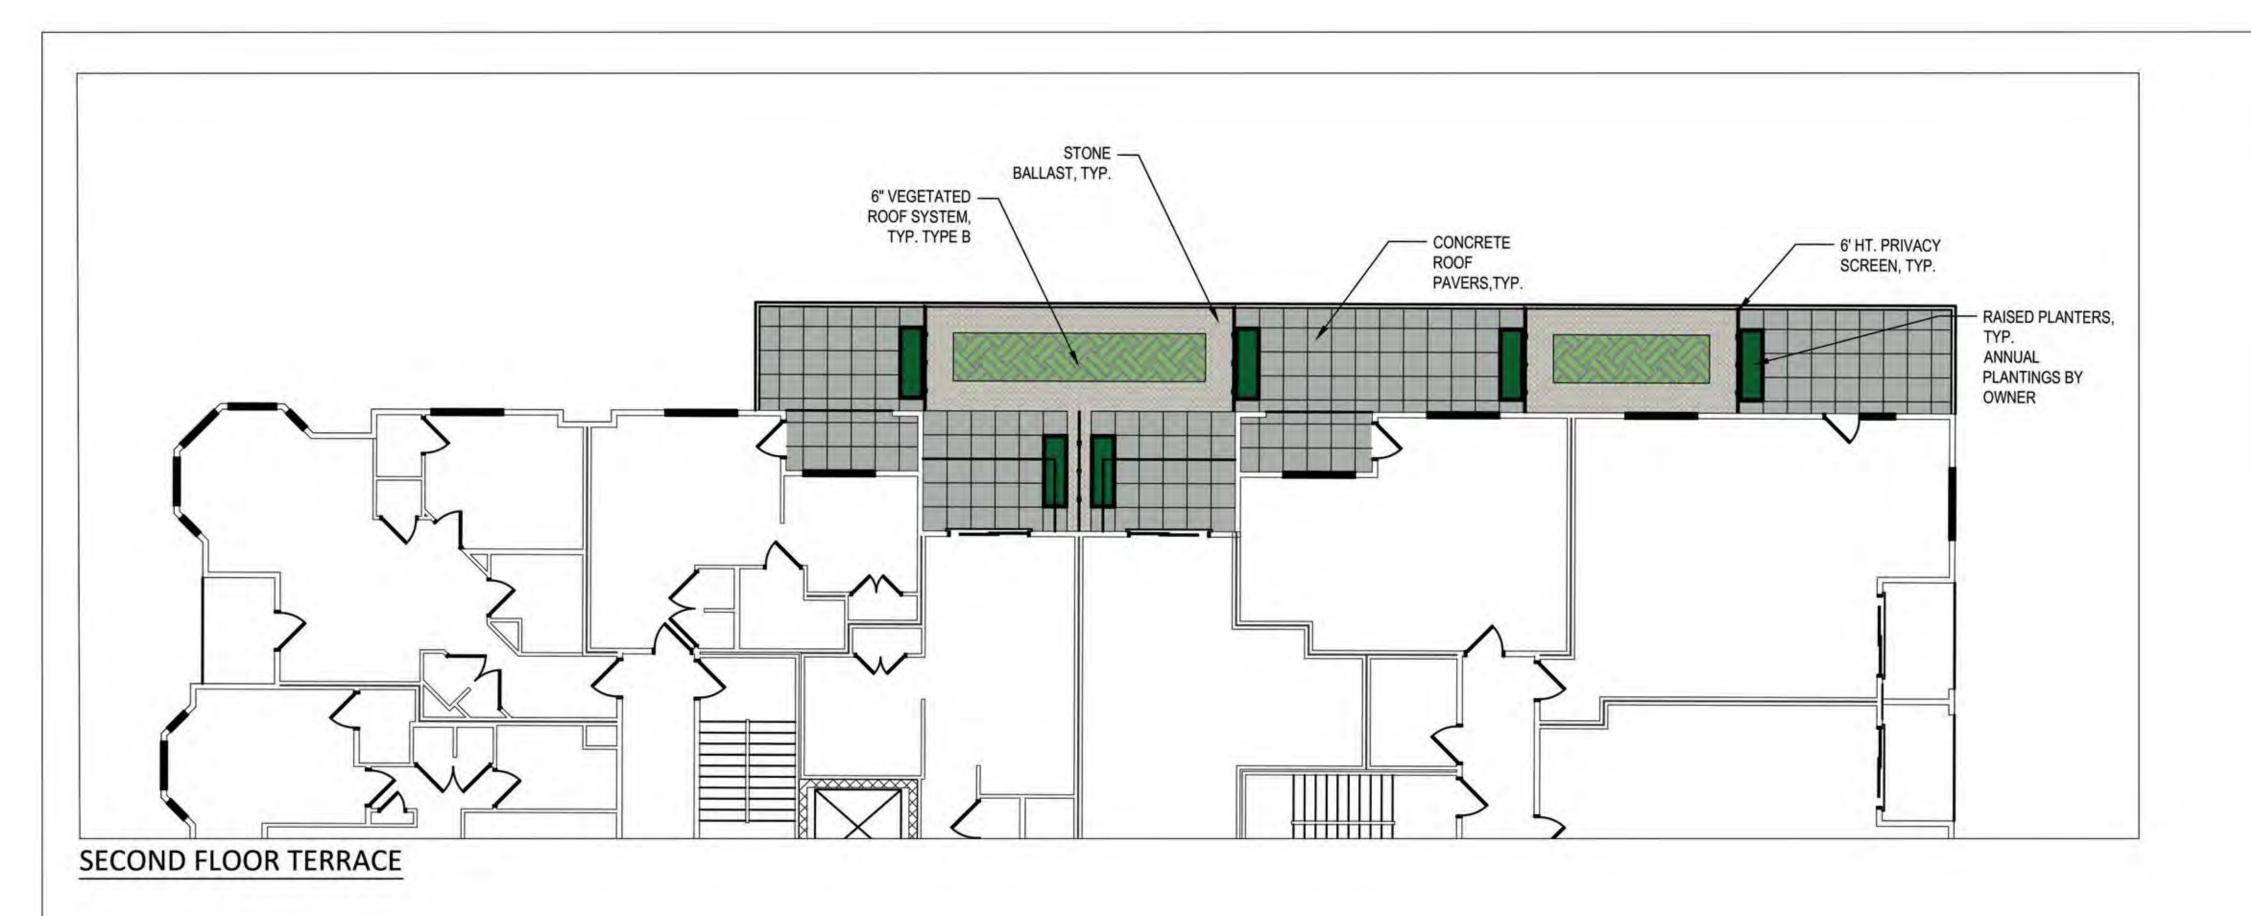
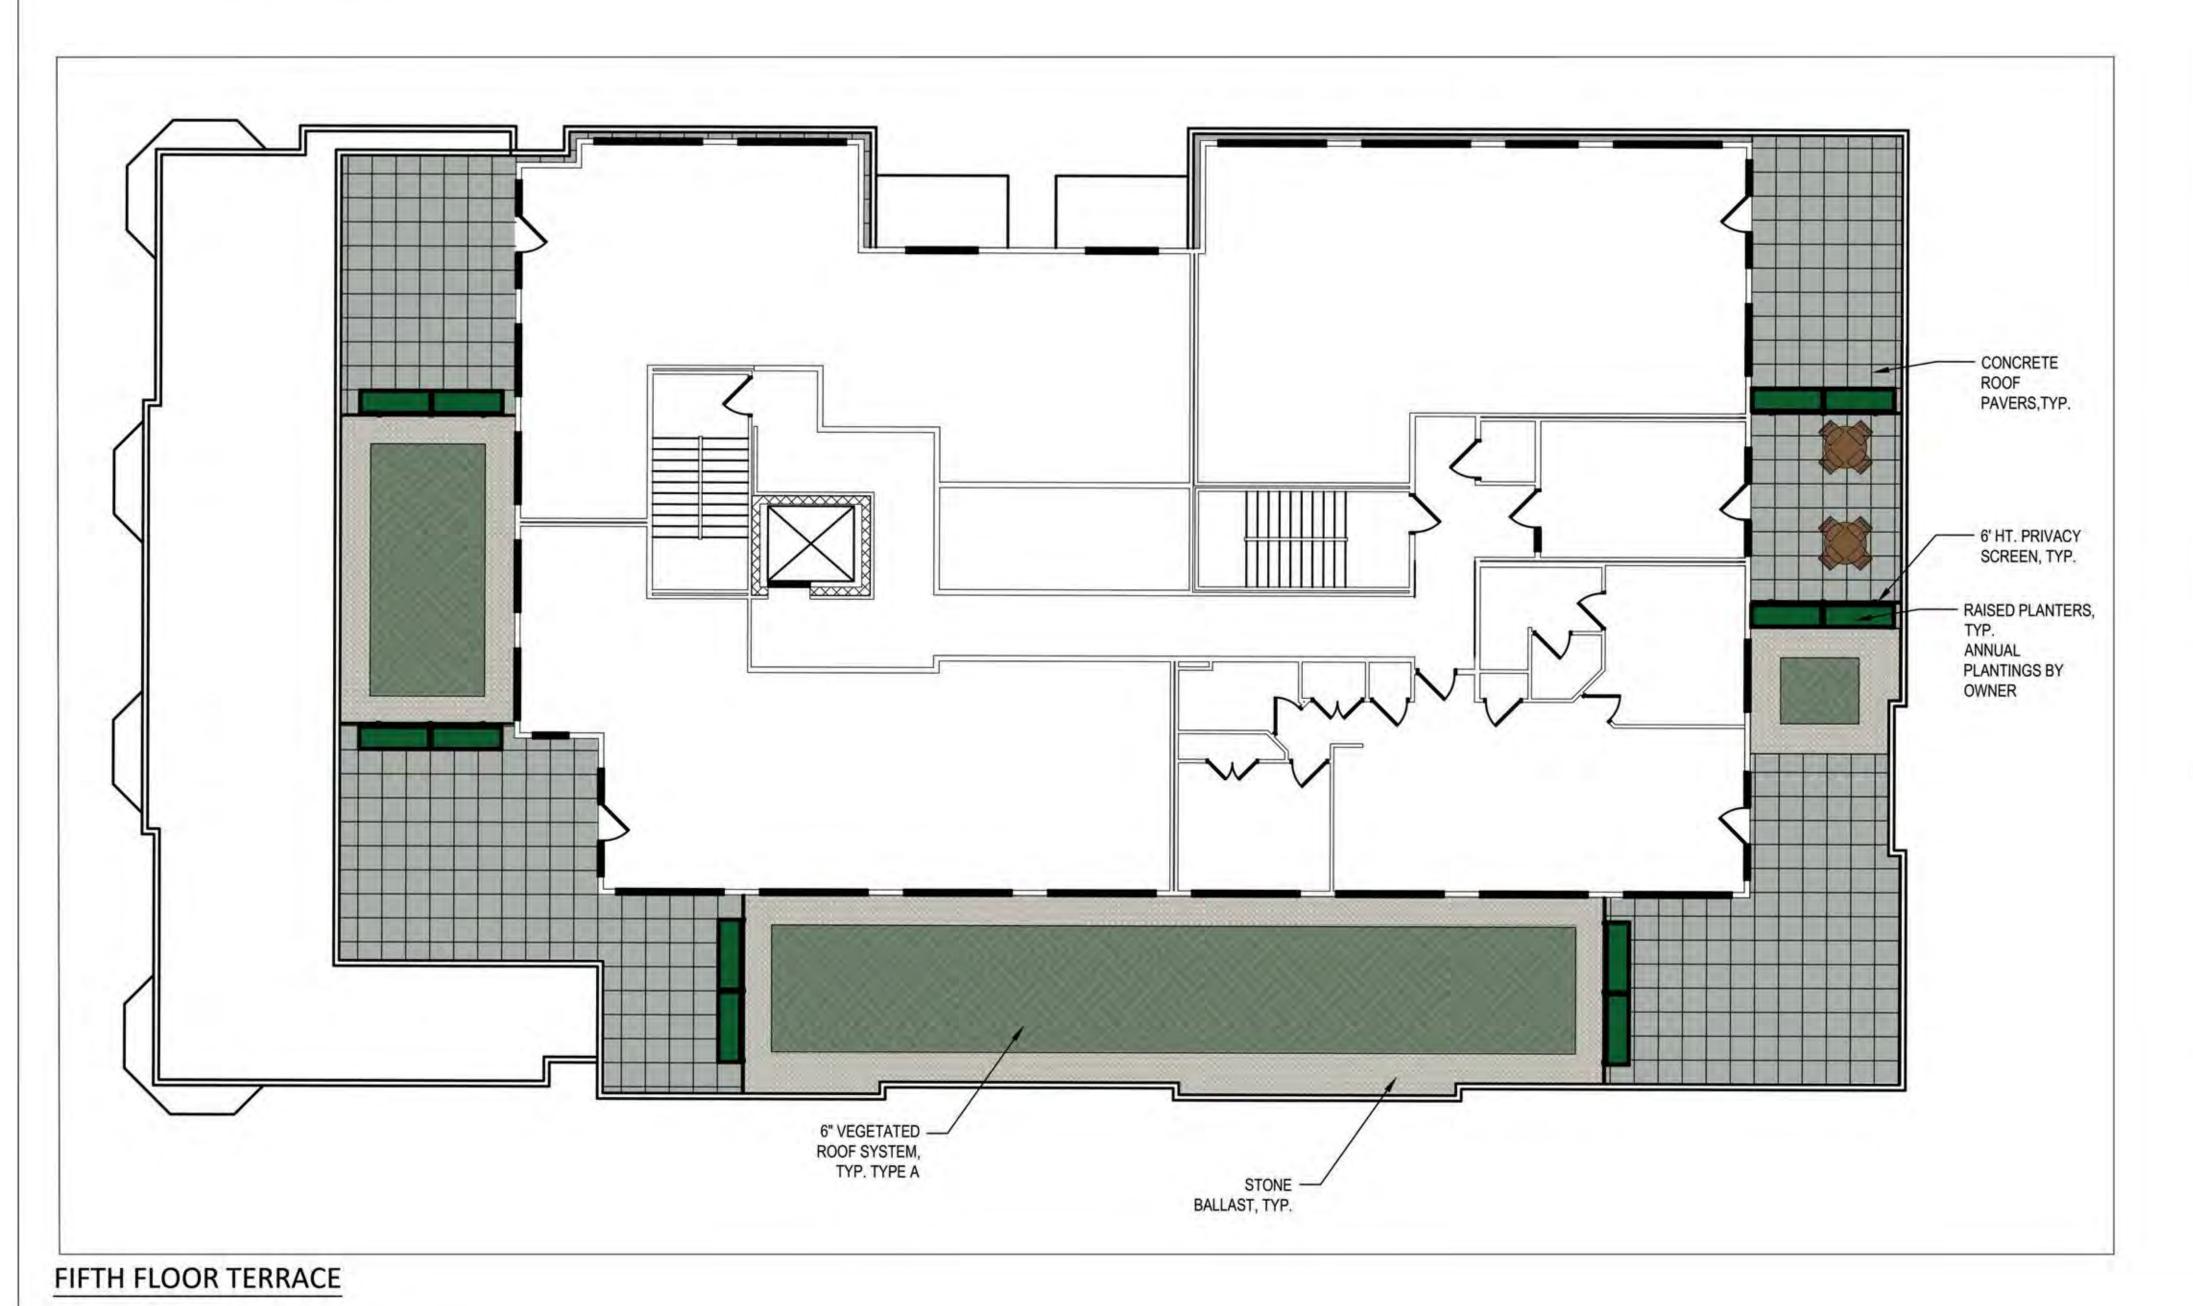
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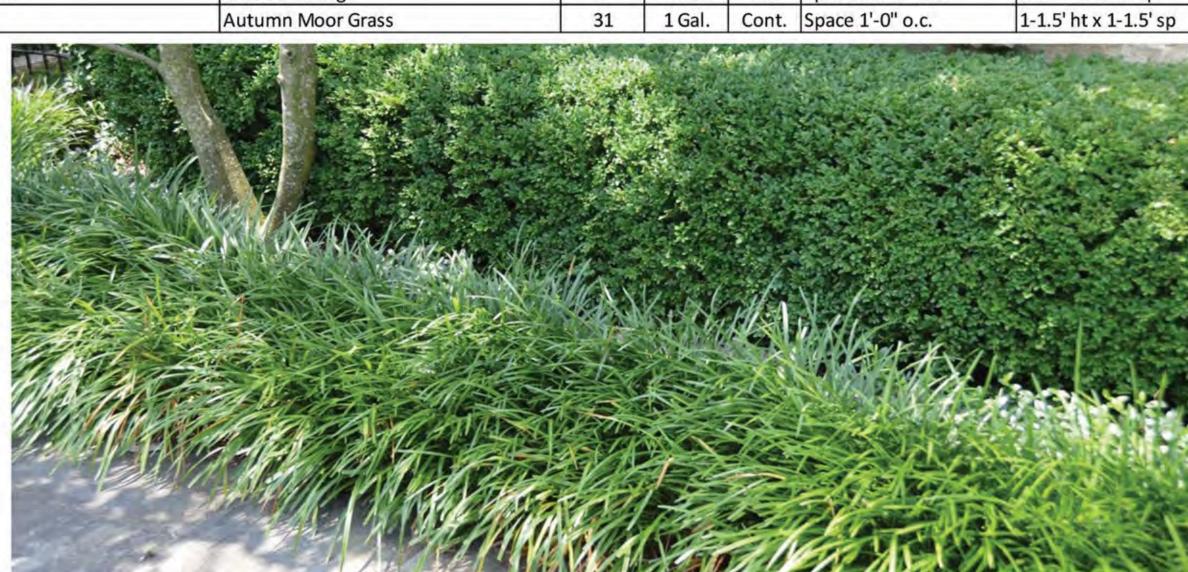
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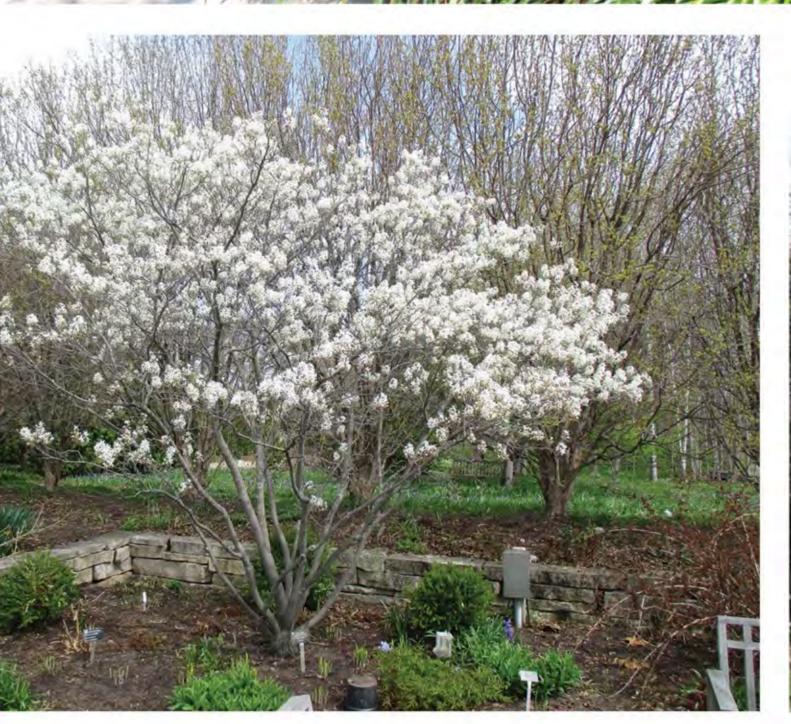
555 W Washington Ave. SHEET TITLE
Roof Terrace Landscape Plan

SHEET NUMBER

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	PLANT LIST						
Key	Botanical Name	Common Name	Quantity	Size	Spec	Comments	Mature Size
	Deciduous Trees						
ARH	Amelanchier x grandiflora `Robin Hill`	Robin Hill Serviceberry	2	2" Cal.	B&B	Upright multi-stem	20-25' ht x 12-15' sp
CCF	Carpinus caroliniana `J.N. Upright`	Firespire Musclewood	1	2" Cal.	B&B	Upright multi-stem	20' ht x 8-10' sp
QC	Quercus robur `Crimschmidt`	Crimson Spire English Oak	4	2" Cal.	B&B	Single, straight leader	45' ht x 15' sp
	Evergreen Trees						
JT	Juniperus chinensis 'Trautman'	Trautman Juniper	5	5' Ht.	B&B		12' ht x 4' sp
	Deciduous Shrubs						
Aml	Aronia melanocarpa Low Scape Mound	Low Scape Mound Aronia	20	2 Gal.	Cont.	Space 2'-0" o.c.	1-2' ht x 2-3' sp
Hq	Hydrangea quercifolia 'Pee Wee'	Oakleaf Hydrangea	13	2 Gal.	Cont.	Space 2.5'-0" o.c	2-4' ht x 2-3' sp
	Physocarpus opulifolius 'Donna May'	Little Devil Ninebark	12	2 Gal.	Cont.	Space 2.5'-0" o.c	3-4' ht x 3-4' sp
Sbt	Spiraea betulifolia 'Tor'	Birchleaf Spirea	22	2 Gal.	Cont.	Space 2'-0" o.c.	2-3' ht x 2-3' sp
	Evergreen Shrubs						
Jpk	Juniperus chinensis 'Pfitzeriana Kallay'	Kallays Compact Pfitzer Juniper	25	2 Gal.	Cont.	Space 3.5'-0" o.c.	3' ht x 6-8' sp
Js	Juniperus sabina `Buffalo`	Buffalo Juniper	8	2 Gal.	Cont.	Space 4'-0" o.c.	1' ht x 4-6' sp
Tmt	Taxus x media `Tauntonii`	Tauton Yew	21	2 Gal.	Cont.	Space 4'-0" o.c.	3-5' ht x 6-8' sp
	Perennials/Grasses/Groundcovers				41.00		
asb	Allium tanguticum 'Summer Beauty'	Summer Beauty Allium	171	4-Inch	Pot	Space 1'-0" o.c.	1-1.5' ht x 1.5-2' sp
abi	Amsonia tabernaemontana `Blue Ice`	Blue Ice Blue Star	11	4-Inch	Pot	Space 1.5'-0" o.c.	1-1.5' ht x 1.5-2' sp
acs	Aralia cordata 'Sun King'	Sun King Aralia	6	2 Gal.		Space 3'-0" o.c.	3-4' ht x 3-4' sp
expm	Echinacea x 'Pixie Meadowbrite'	Pixie Meadowbrite Purple Coneflower	59	4-Inch	Pot	Space 1.5'-0" o.c.	1.5-2' ht x 1.5-2' sp
	Geranium x cantabrigiense `Karmina`	Biokovo Cranesbill	45	4-Inch	Pot	Space 1.5'-0" o.c.	.5-1' ht x .5-1' sp
	Heuchera x `Midnight Rose`	Coral Bells	9	4-Inch	Pot	Space 1'-0" o.c.	1-2' ht x 1-1.5' sp
hbc	Hosta x `Blue Cadet`	Plantain Lily	23	4-Inch	Pot	Space 1.5'-0" o.c.	1' ht x 2-3' sp
hgs	Hosta x `Gold Standard`	Gold Standard Plantain Lily	26	4-Inch	Pot	Space 2'-0" o.c.	2-3' ht x 2' sp
lsk	Liatris spicata `Kobold`	Kobold Spike Gayfeather	28	4-Inch	Pot	Space 1'-0" o.c.	1.5-3' ht x 1.5-2' sp
nk	Nepeta x faassenii 'Kit Kat'	Kit Kat Catmint	11	4-Inch	Pot	Space 2'-0" o.c.	1' ht x 2' sp
pdd	Penstemon digitalis 'Dark Towers'	Beard-tongue	14	4-Inch	Pot	Space 1.5'-0" o.c.	3-4' ht x 1.5-2' sp
		Black-Eyed Susan	24	4-Inch	Pot	Space 1'-0" o.c.	2-3' ht x 1.5-2' sp
snc	Salvia nemorosa `Caradonna`	Cardonna Sage	18	4-Inch	Pot	Space 1.5'-0" o.c.	2-2.5' ht x 1.5' sp
snm	Salvia nemorosa `Marcus`	Woodland Sage	9	4-Inch	Pot	Space 1.5'-0" o.c.	8-12" ht x 1.5' sp
sa	Sesleria autumnalis	Autumn Moor Grass	31	1 Gal.		Space 1'-0" o.c.	1-1.5' ht x 1-1.5' sp

























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PROJECT TITLE
BAXTER West Washington Development


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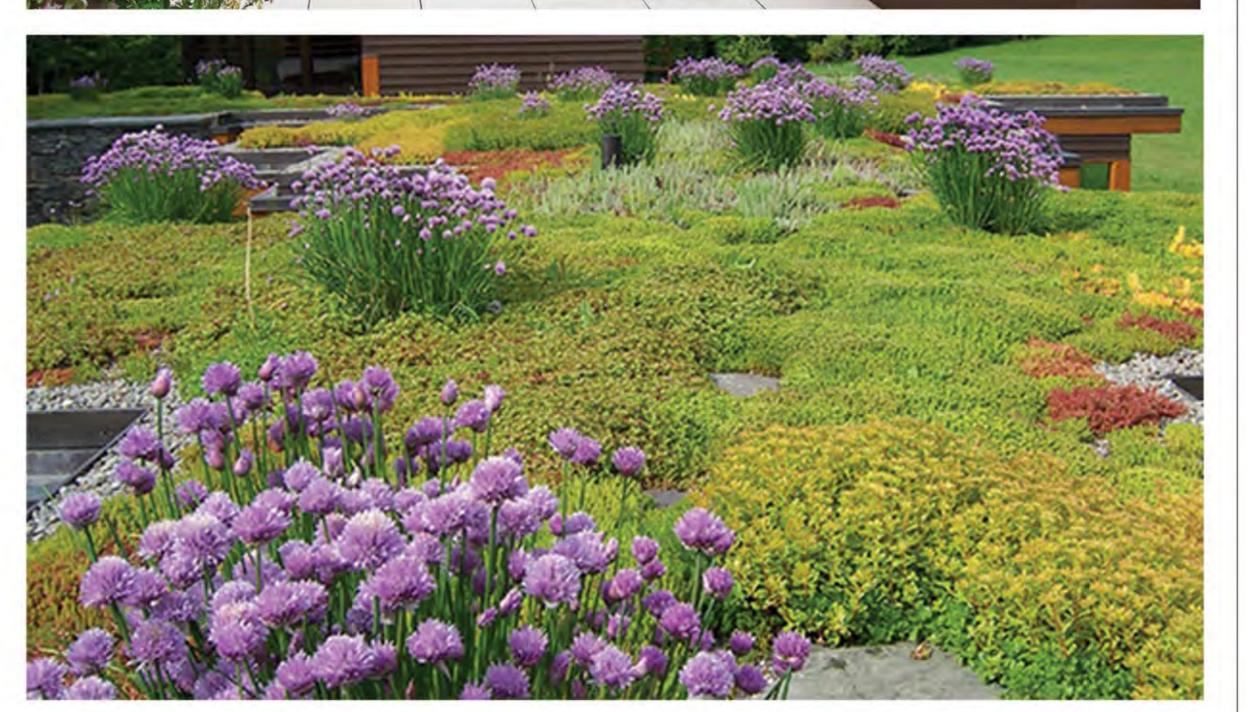
Type A:	
Propogated Sedum Tray 'Tough Extreme Mix'	
by Liveroof or approved equal. Interplant with 2.5"	
perennial plugs.	
Perennial Plugs	
Allium tanguticum 'Summer Beauty'	Summer Beauty Allium
Calamintha nepeta 'Montrose White'	Montrose White Calamint
Sedum kamtschaticum 'Takahira Dake'	Takahira Dake Stonecrop
Sedum spectabilie 'Neon'	Neon Stonecrop
Sesleria autumnalis	Autumn Moor Grass
Type B:	
Propogated Sedum Tray 'Shade Serene Mix'	
by Liveroof or approved equal. Interplant with 2.5"	
perennial plugs.	
Perennial Plugs	
Geranium maculatum	Wild Geranium
Heuchera villosa var. atropurpurea	Maple-leaved Alum Root
Smilacina racemosa	False Solomon's Seal
Dryopteris marginalis	Leatherleaf Woodfern
Tiarella cordifolia	Foamflower









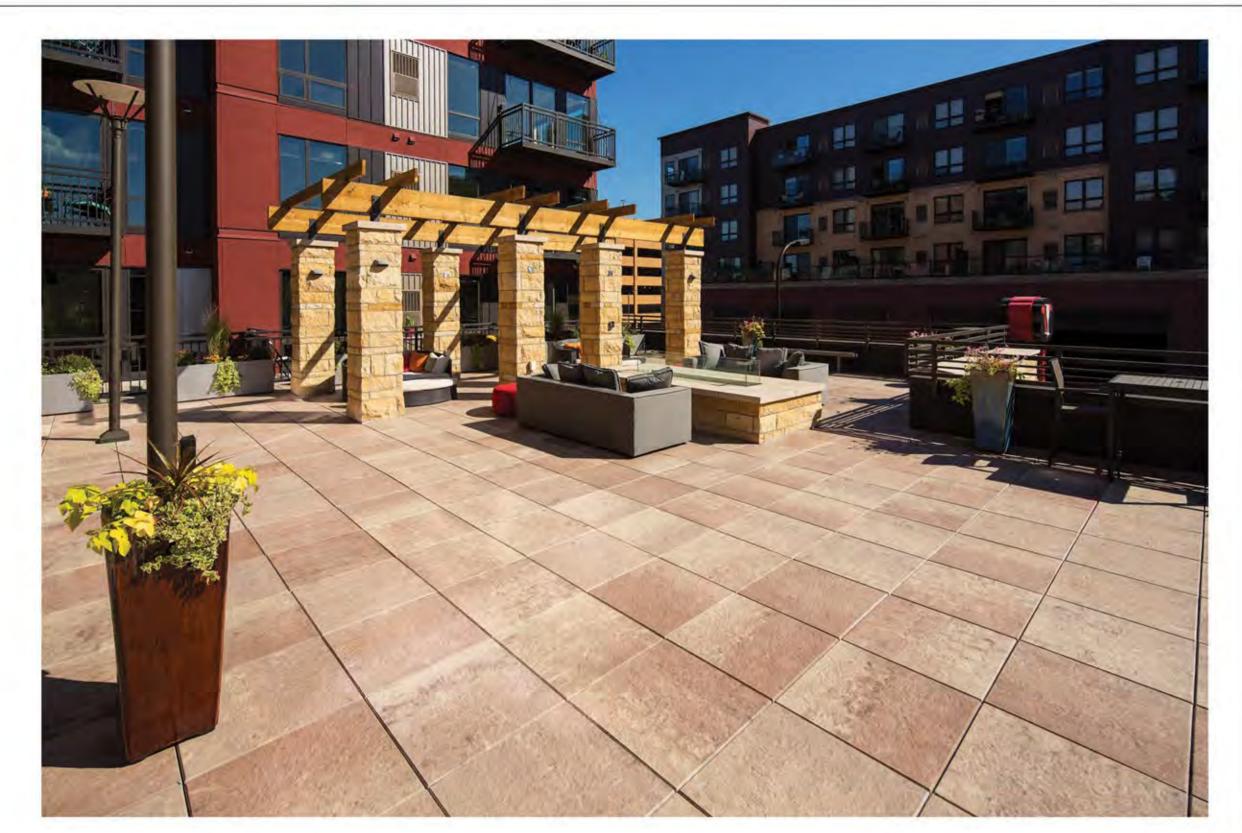





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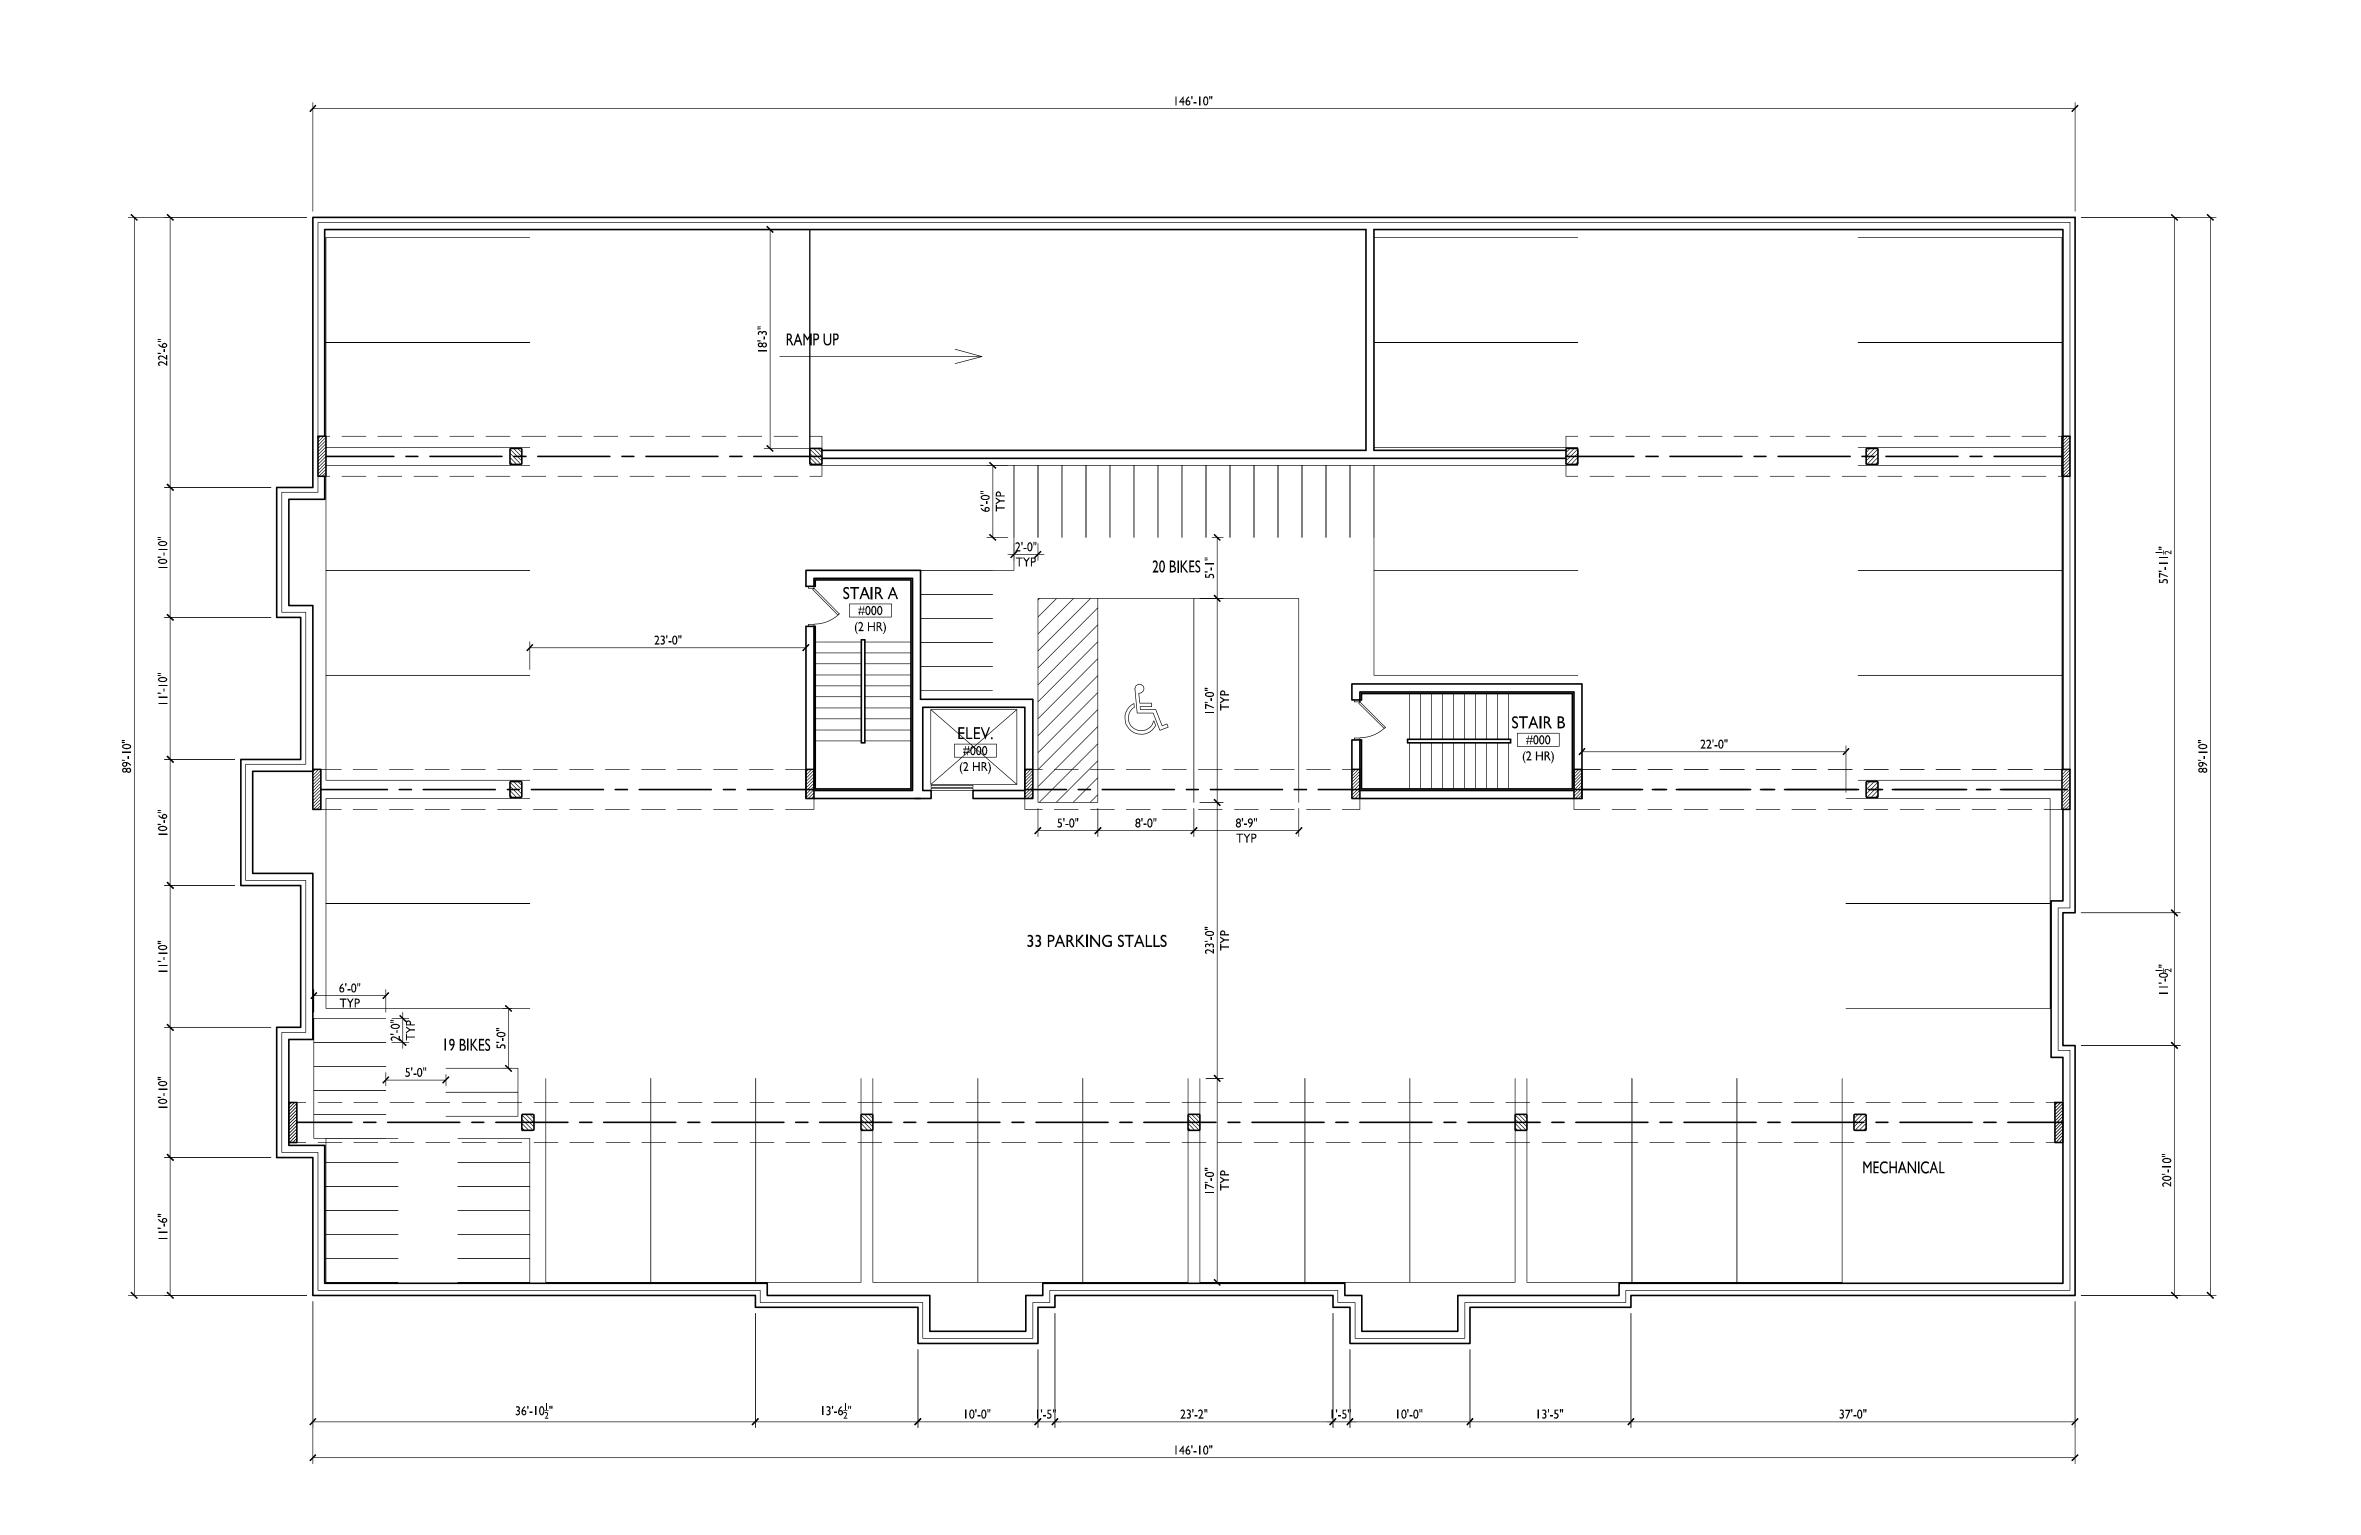
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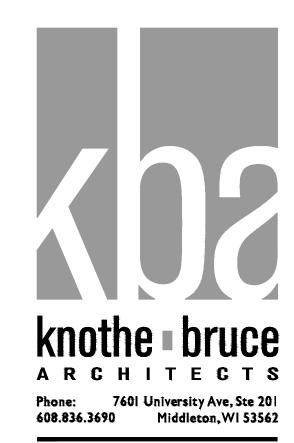
555 W Washington Ave. SHEET TITLE
Roof Terrace
Image Board

SHEET NUMBER

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PROJECT TITLE
BAXTER
West Washington
Development

555 W Washington Ave.

SHEET TITLE

Basement Plan

SHEET NUMBER

A-1.0

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PROJECT NO.





S. BEDFORD



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PROJECT TITLE

BAXTER West Washington Development

555 W Washington Ave.

SHEET TITLE
First Floor Plan


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PROJECT TITLE
BAXTER
West Washington
Development

555 W Washington Ave.

SHEET TITLE

Second Floor Plan

SHEET NUMBER

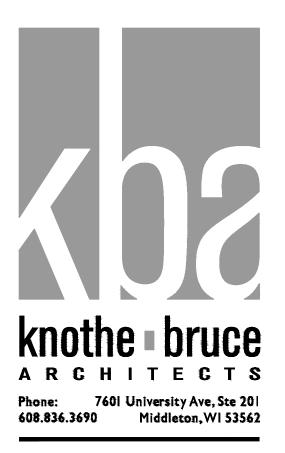A-1.2

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PROJECT NO.


SECOND FLOOR PLAN

A-1.2

1/8"=1'-0"





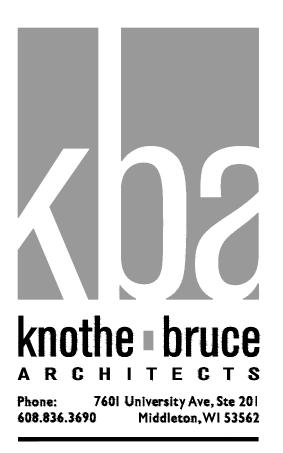

Issued for Land Use - June 20, 2018

PROJECT TITLE

BAXTER West Washington Development

555 W Washington Ave.

SHEET TITLE
Third Floor Plan

SHEET NUMBER


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PROJECT TITLE

BAXTER West Washington Development

555 W Washington Ave.

SHEET TITLE

Fourth Floor Plan

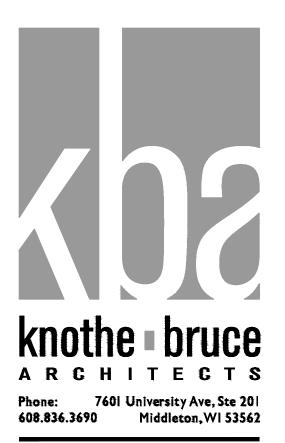
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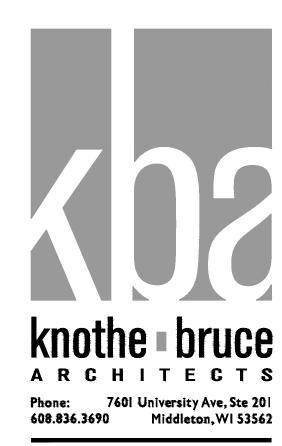


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PROJECT NO.





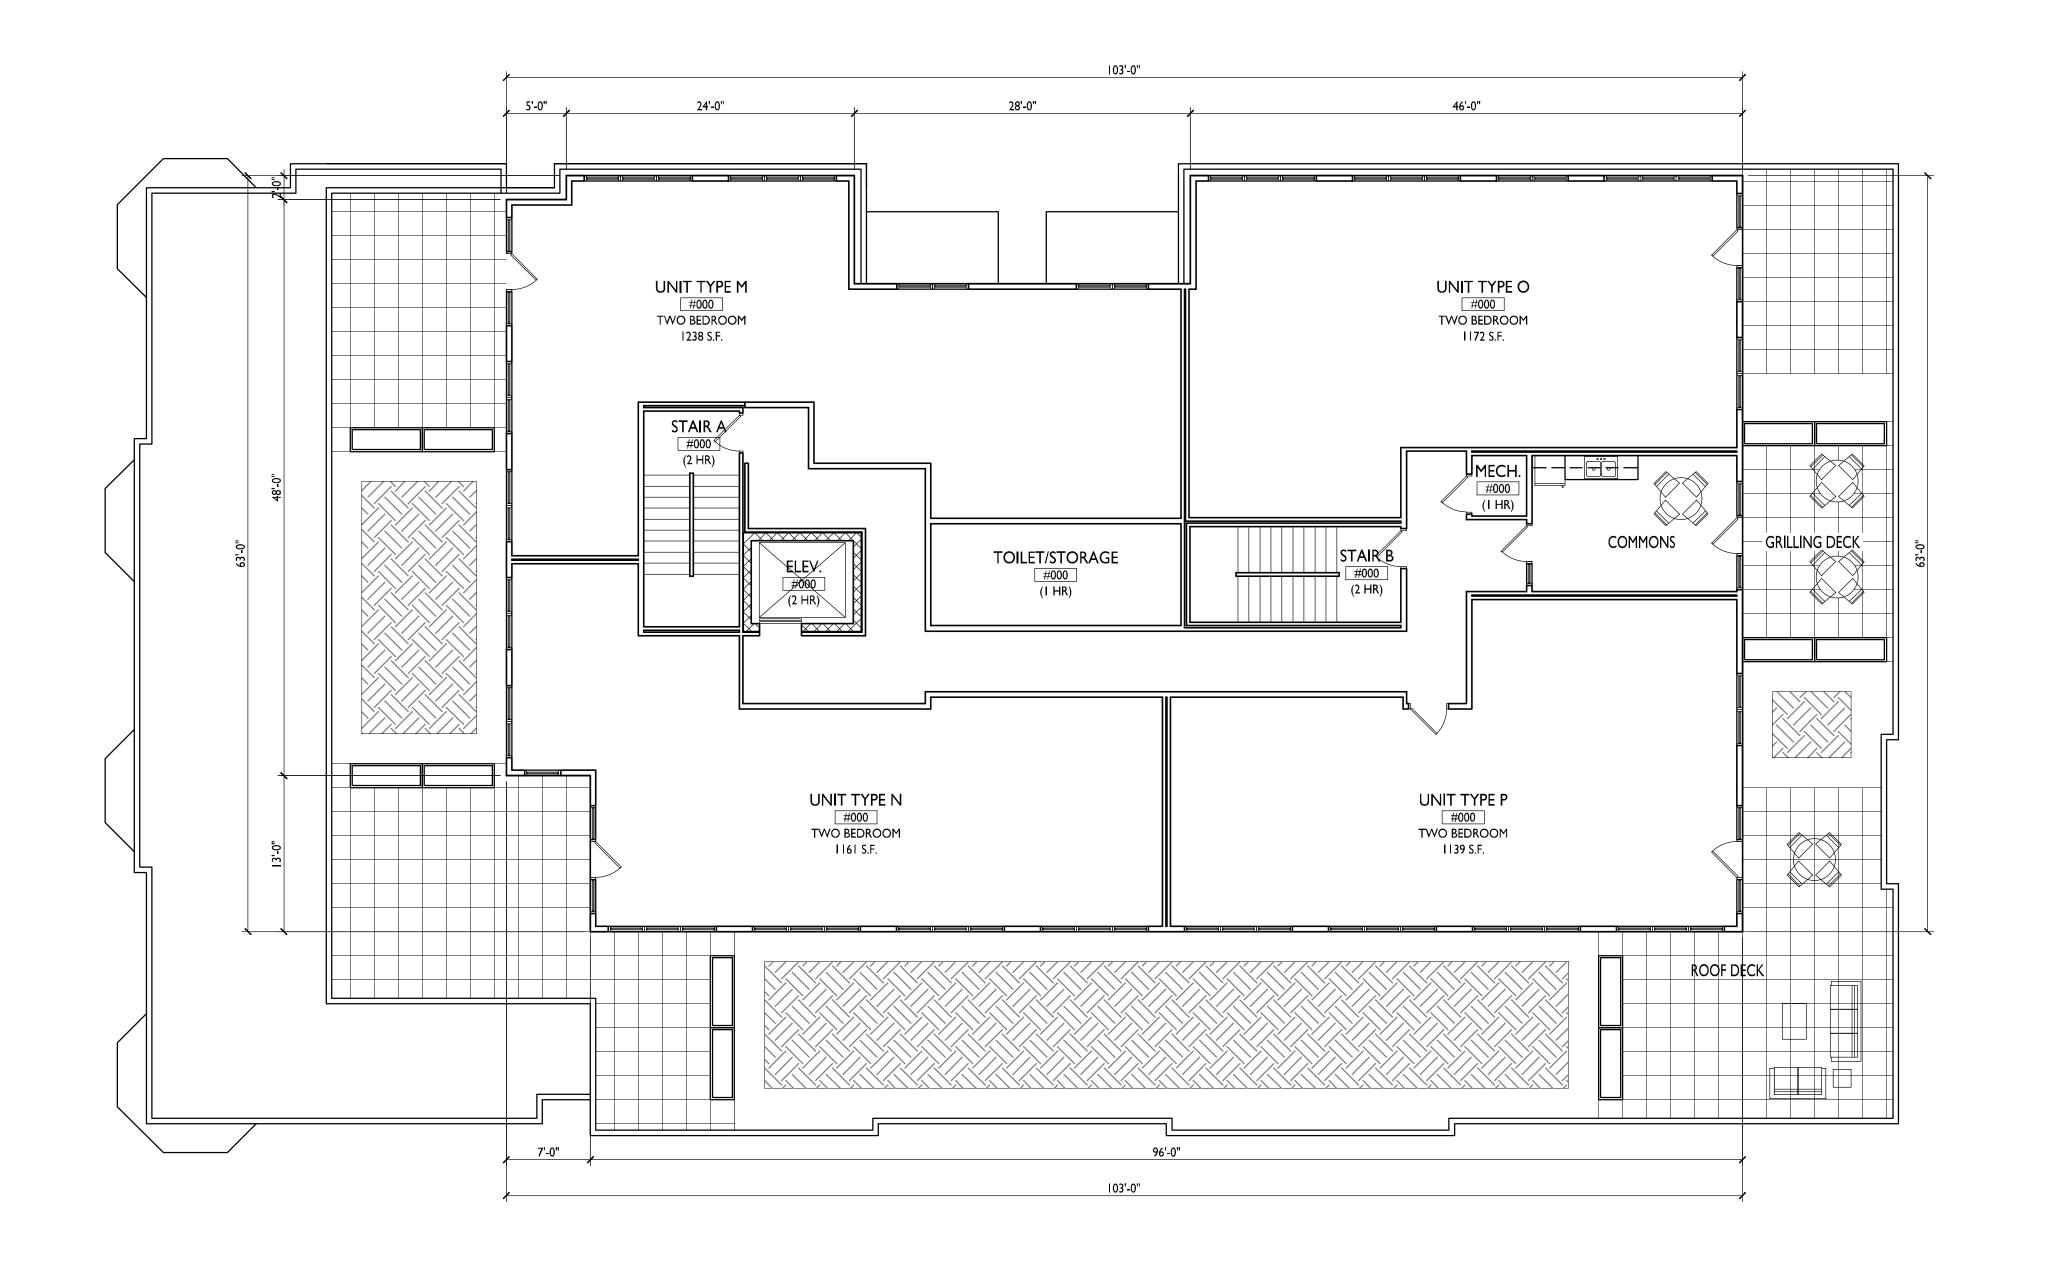

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PROJECT TITLE

BAXTER West Washington Development

555 W Washington Ave.

SHEET TITLE
Fifth Floor Plan

SHEET NUMBER


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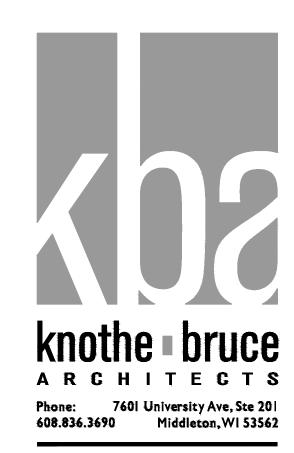
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PROJECT NO.







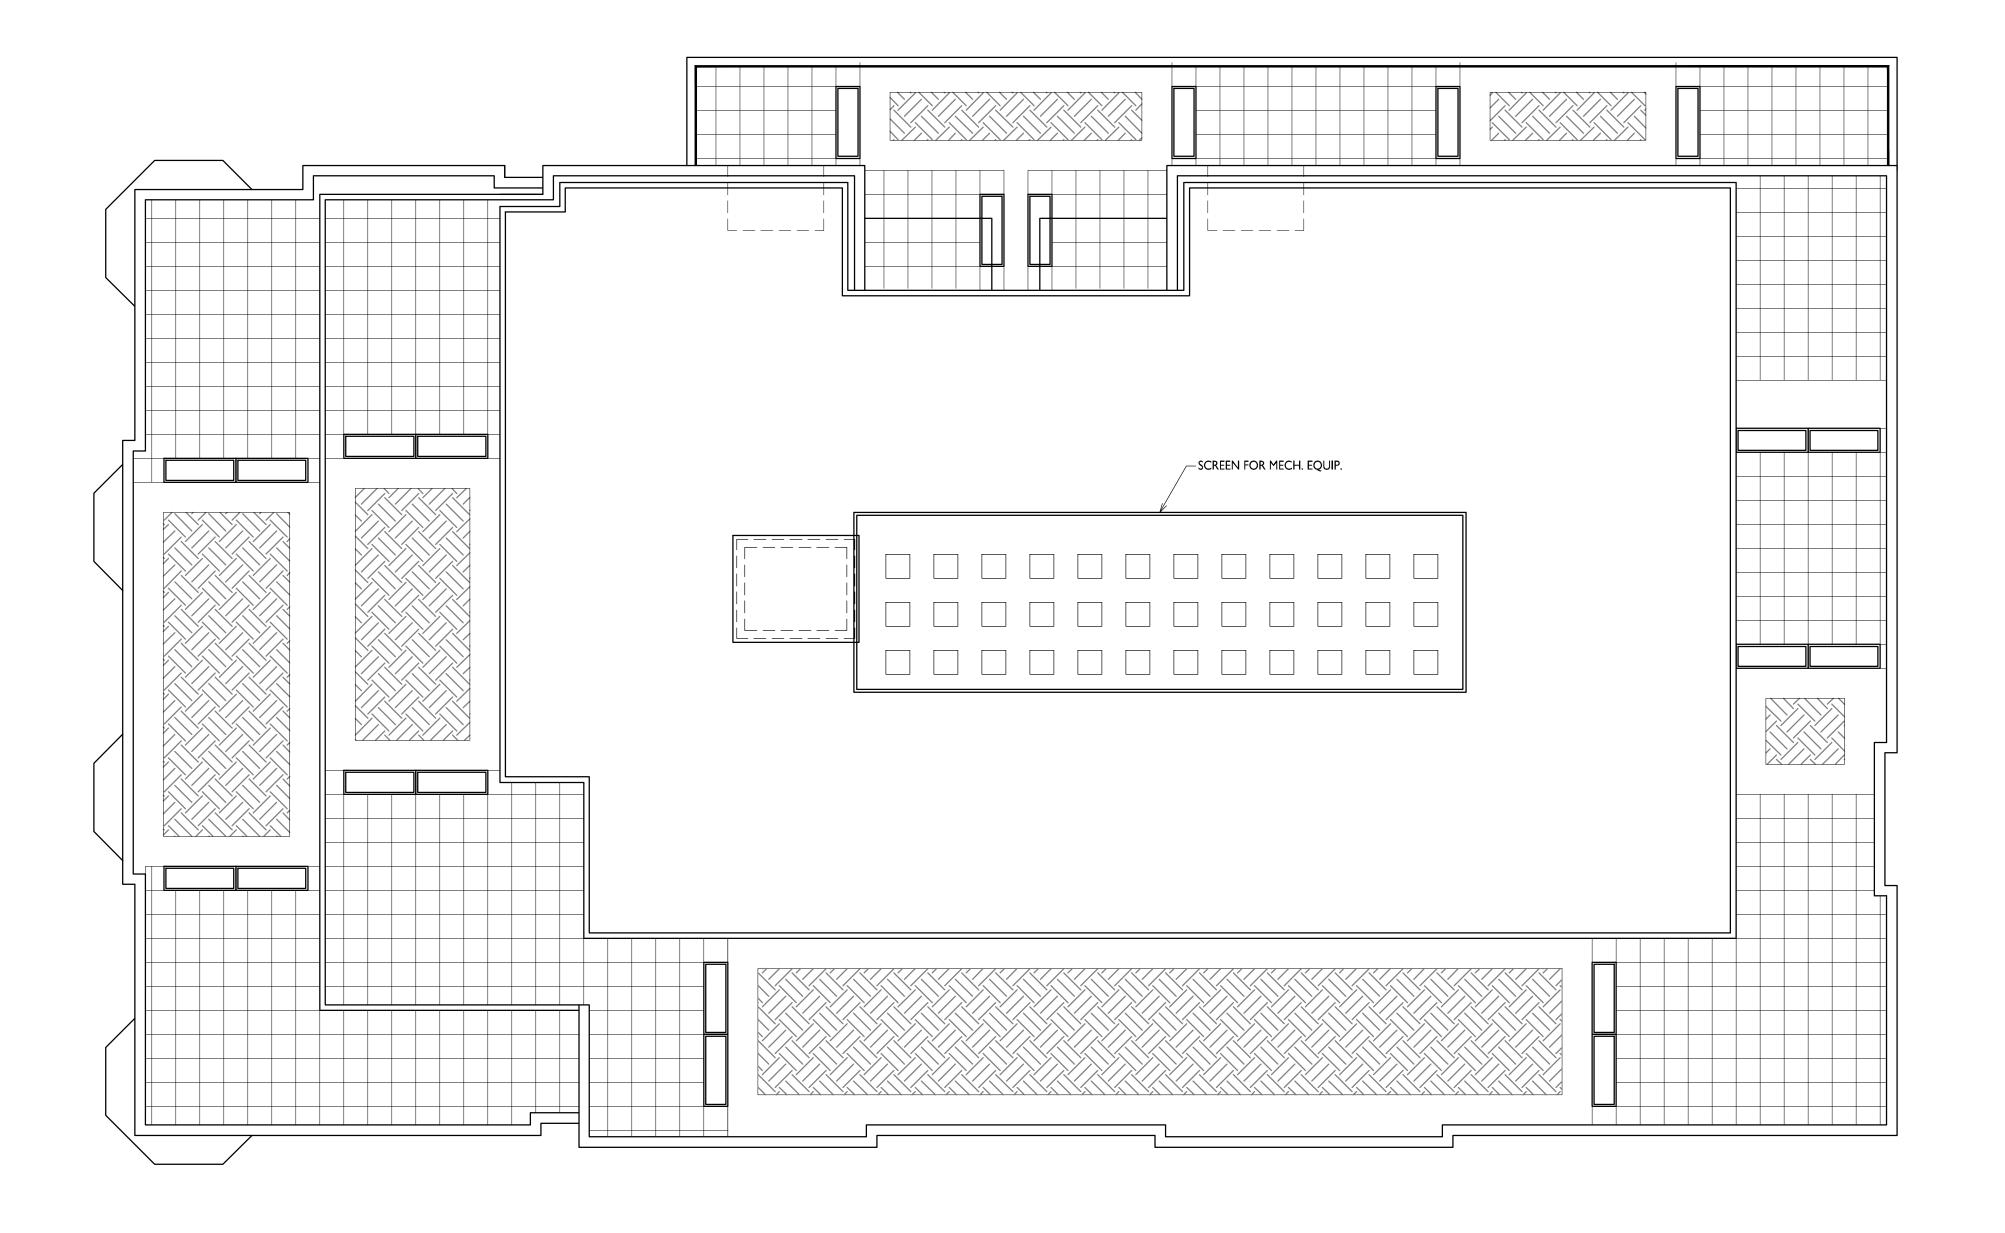

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PROJECT TITLE
BAXTER
West Washington
Development

555 W Washington Ave.

sheet title Roof Plan


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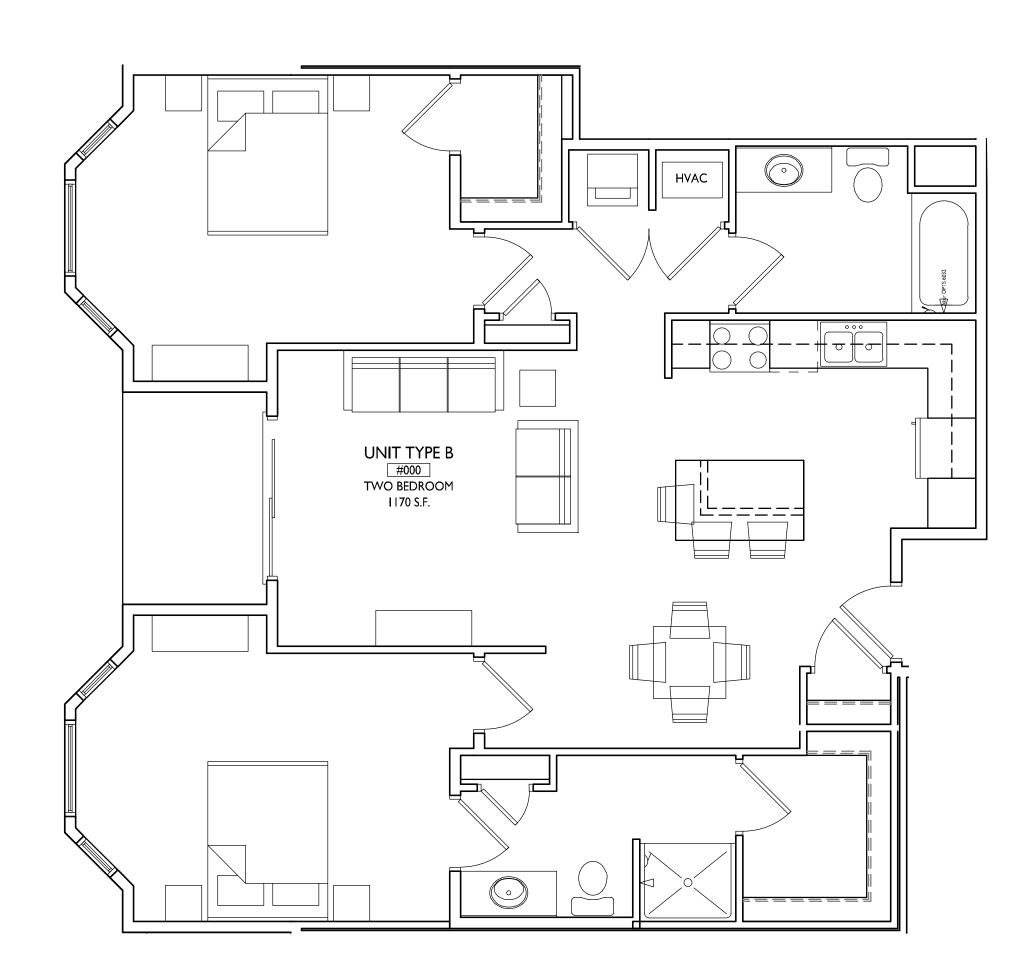
PROJECT NO. 1713
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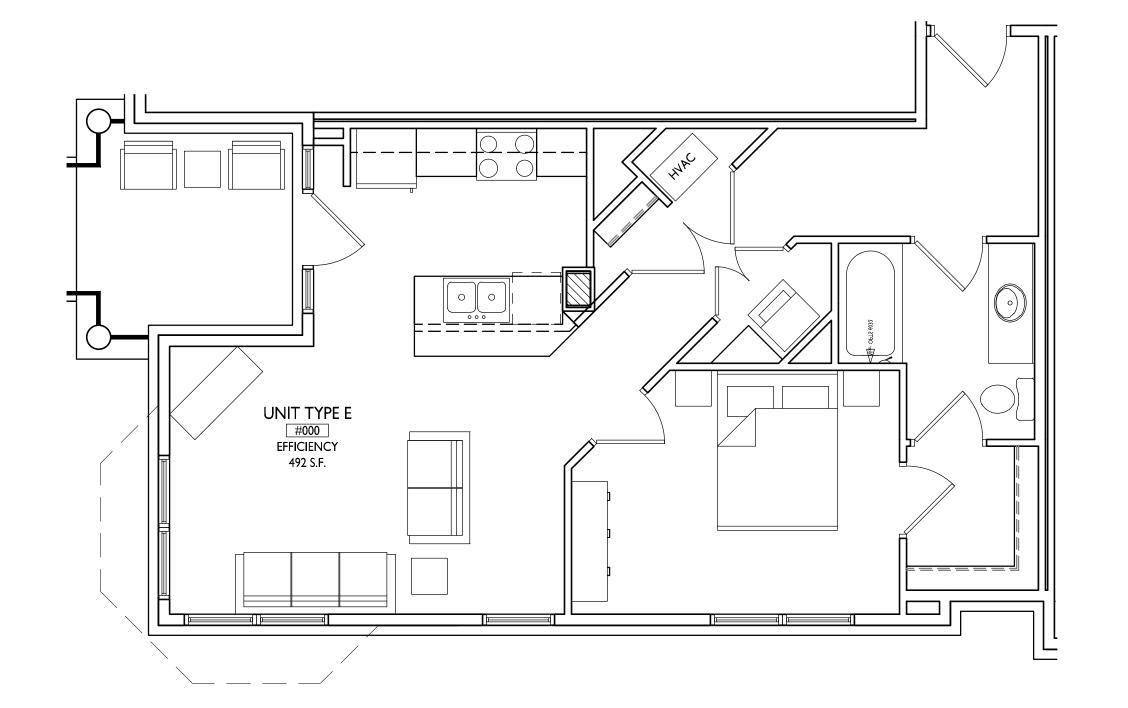









UNIT TYPE B

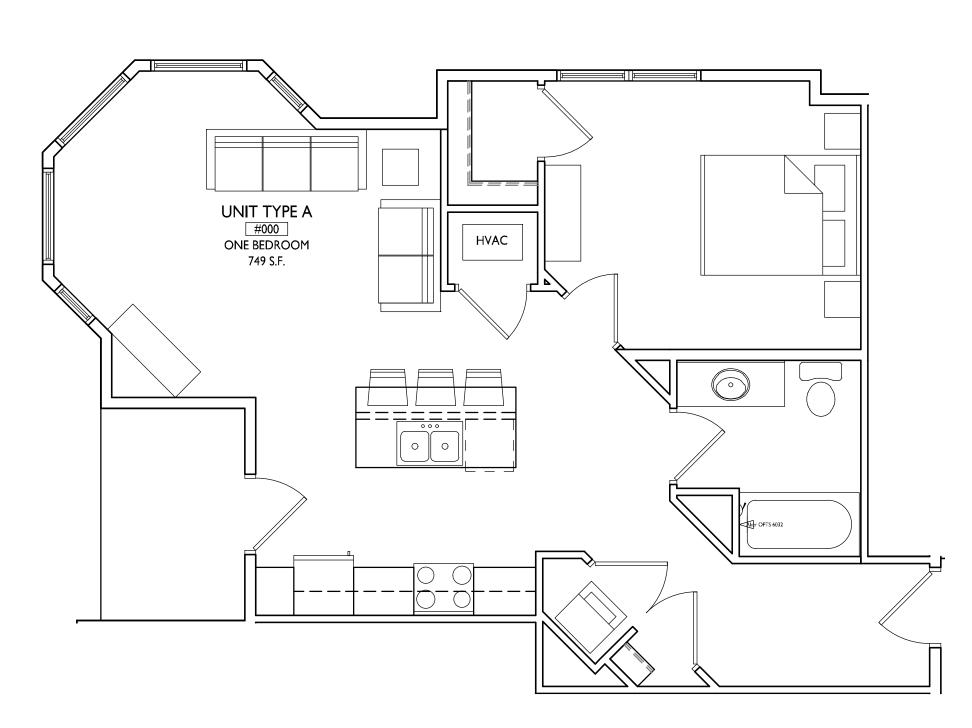

3 UNIT TYPE E

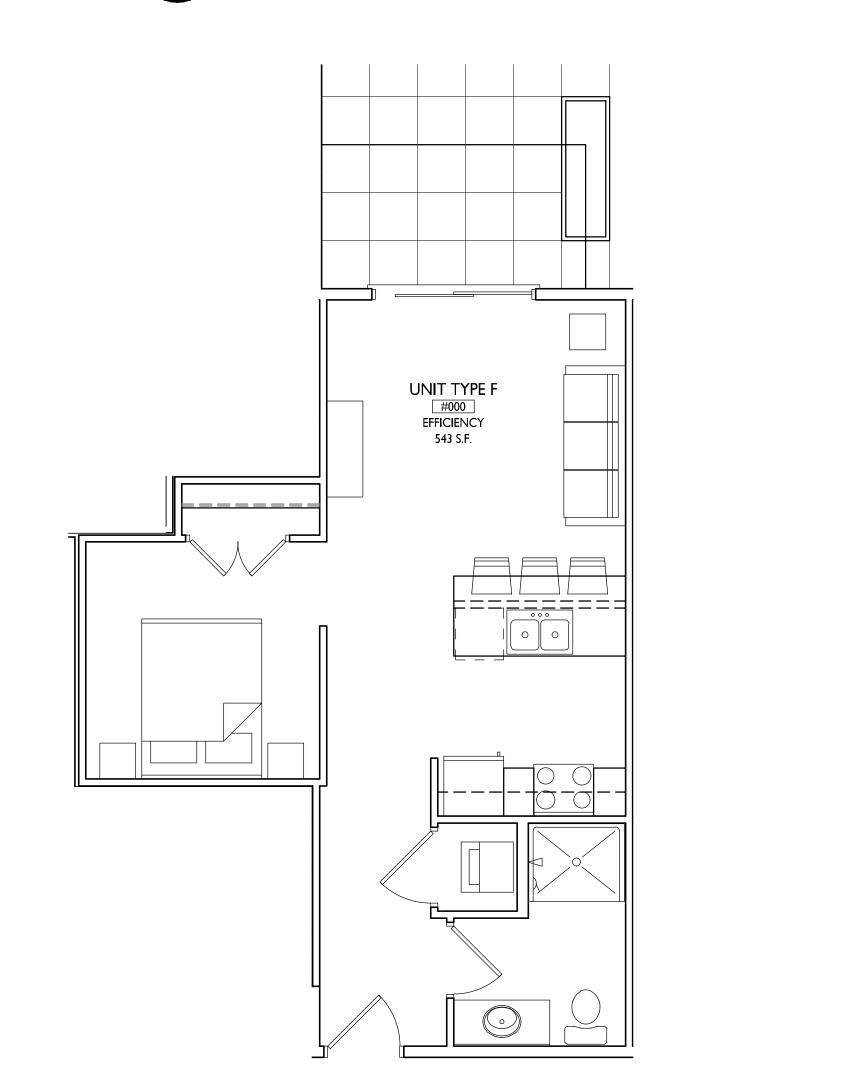

UNIT TYPE F



ISSUED

Issued for Land Use - June 20, 2018

PROJECT TITLE

BAXTER West Washington Development

555 W Washington Ave.

SHEET TITLE
Typical Unit Plans


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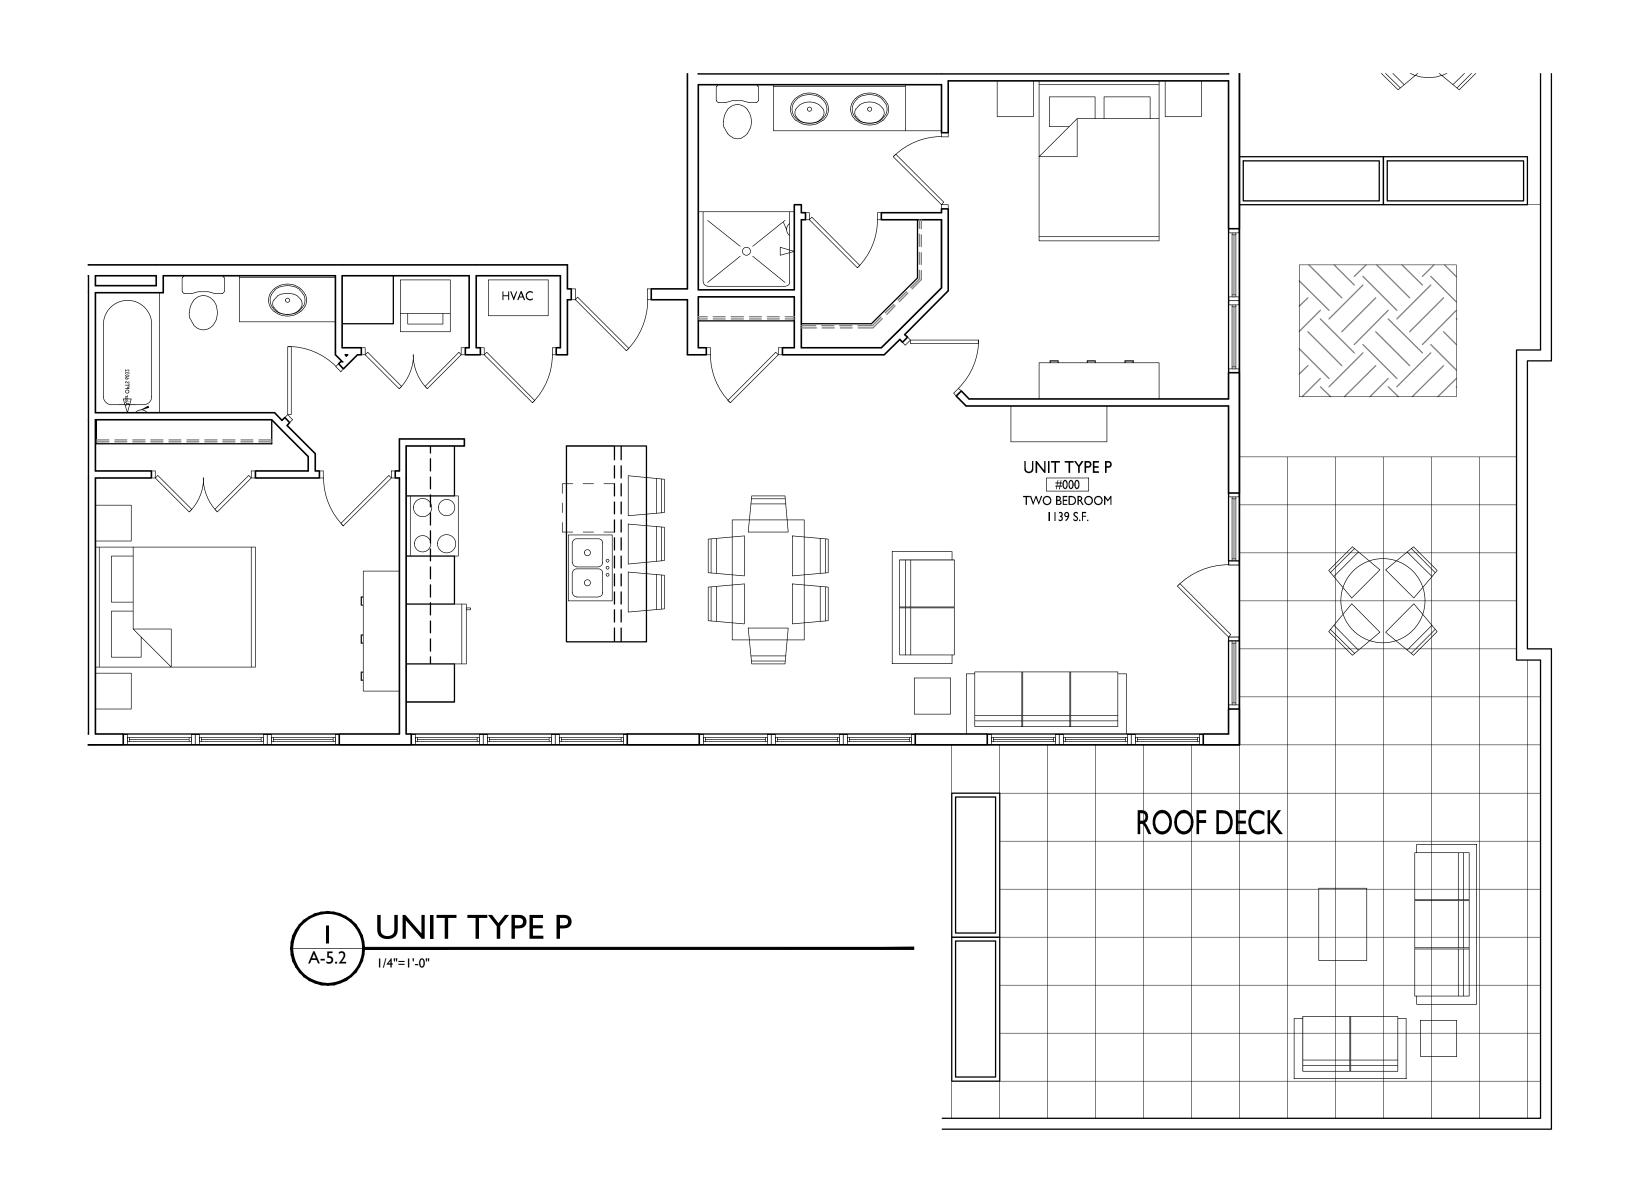
A-5.1

PROJECT NO.

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PROJECT TITLE
BAXTER West Washington Development

555 W Washington Ave.

SHEET TITLE

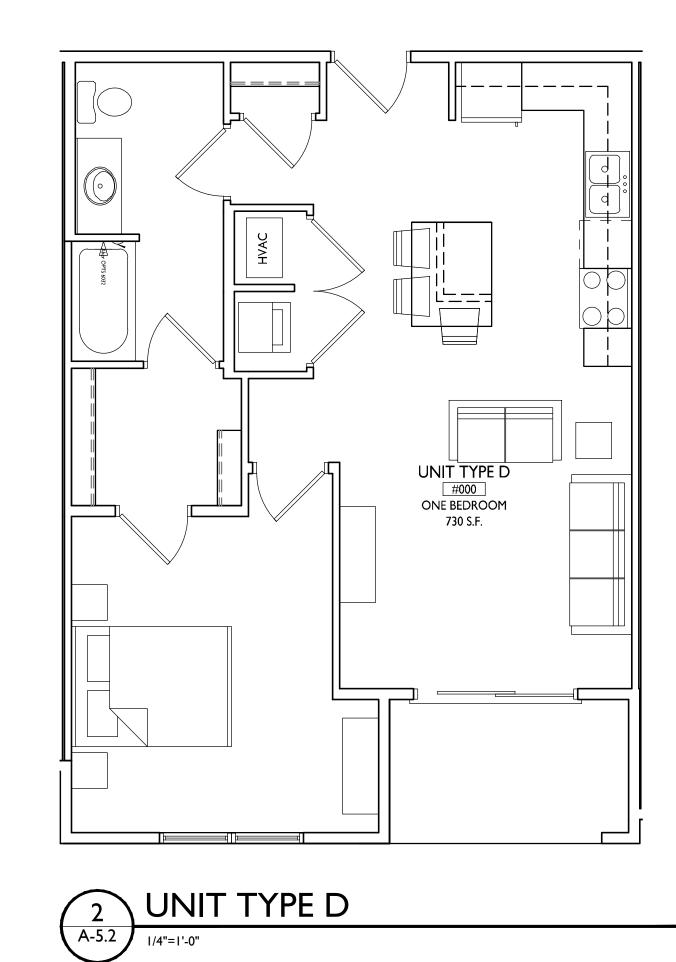Typical Unit Plans

SHEET NUMBER

A-5.2

PROJECT NO.

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PROJECT TITLE

1 NorthEast A-2.1 1/16" = 1'-0"



2 NorthWest A-2.1 1/16" = 1'-0" 555 WEST WASHINGTON

EXTERIOR MATERIAL SCHEDULE

CORDOVA - BUFF

RAILING

FIBREX - DARK BRONZE

ALUMINUM - DARK BRONZE

ALUMINUM - MATCH TRIM

BRAMPTON - MORGAN - QUEEN SIZE

COMPOSITE SIDING - DARK BRONZE

SHEET TITLE

AVE.

Exterior Elevations

SHEET NUMBER

A-2.1

PROJECT NUMBER 1713
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PROJECT TITLE

555 WEST WASHINGTON

SHEET TITLE

AVE.

Exterior Elevations

SHEET NUMBER

1 SouthEast A-2.2 1/16" = 1'-0"

2 SouthWest A-2.2 1/16" = 1'-0"

EXTERIOR MATERIAL SCHEDULE				
BRICK	BRAMPTON - MORGAN - QUEEN SIZE			
STONE MASONRY	CORDOVA - BUFF			
PANELS & TRIM	COMPOSITE SIDING - DARK BRONZE			
WINDOWS	FIBREX - DARK BRONZE			
RAILING	ALUMINUM - DARK BRONZE			
FACIA	ALUMINUM - MATCH TRIM			

A-2.2

PROJECT NUMBER 1713
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EXTERIOR MATERIAL SCHEDULE	
BRICK	BRAMPTON - MORGAN - QUEEN SIZE
STONE MASONRY	CORDOVA - BUFF
PANELS & TRIM	COMPOSITE SIDING - DARK BRONZE
WINDOWS	FIBREX - DARK BRONZE
RAILING	ALUMINUM - DARK BRONZE
FACIA	ALUMINUM - MATCH TRIM



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7601 University Ave. • Suite 201 • Middleton, WI 53562

ISSUED

PROJECT TITLE

555 WEST WASHINGTON

SHEET TITLE

AVE.


Colored Exterior Elevations

SHEET NUMBER

A-2.3

PROJECT NUMBER 1713
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1 NorthEast - Color
A-2.3 1/16" = 1'-0"

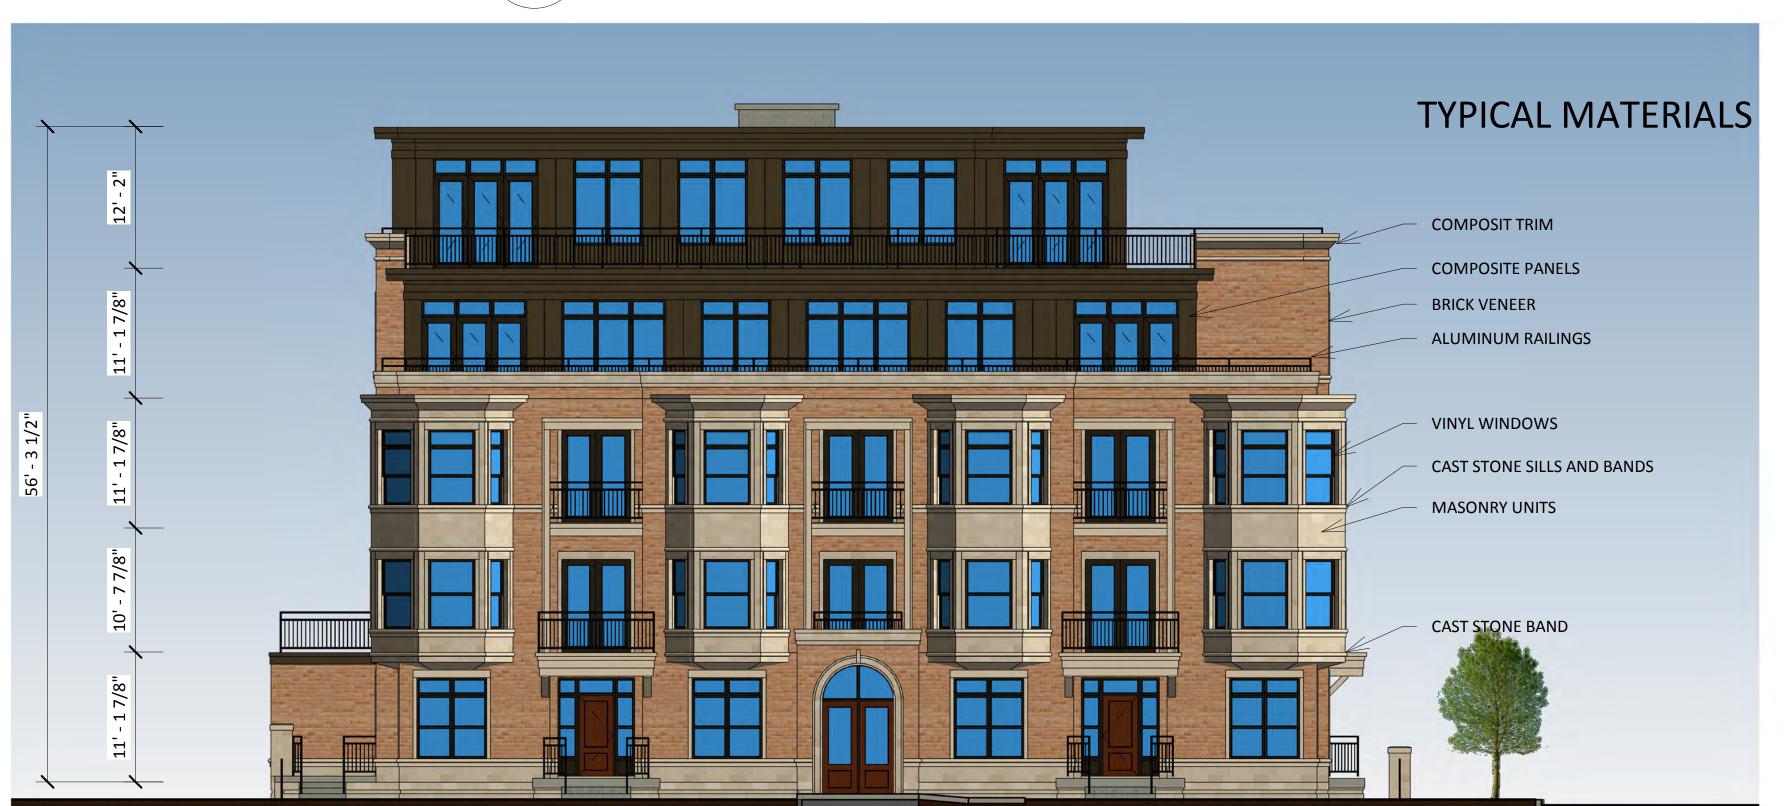

NorthWest - Color
A-2.3 1/16" = 1'-0"



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PROJECT TITLE

555 WEST WASHINGTON AVE.

SHEET TITLE

Colored Exterior Elevations

SHEET NUMBER

A-2.4 1/16" = 1'-0"

EXTERIOR MATERIAL SCHEDULE	
BRICK	BRAMPTON - MORGAN - QUEEN SIZE
STONE MASONRY	CORDOVA - BUFF
PANELS & TRIM	COMPOSITE SIDING - DARK BRONZE
WINDOWS	FIBREX - DARK BRONZE
RAILING	ALUMINUM - DARK BRONZE
FACIA	ALUMINUM - MATCH TRIM

A-2.4

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SouthEast - Color A-2.4 1/16" = 1'-0"



























