URBAN DESIGN COMMISSION APPLICATION



City of Madison Planning Division 126 S. Hamilton St. P.O. Box 2985



LOW OLLICE DZE OME	r:
Paid	Receipt #
Date received	
Received by	
Aldermanic District	
Zoning District	
Urban Design District	
Submittal reviewed by	

	Madison, W (608) 266-46	5 53701-2985 335	MECONSTH	Date received Received by Aldermanic District					
Complete all sections of this application, including the desired meeting date and the action requested. If you need an interpreter, translator, materials in alternate formats or other accommodations to access these forms, please call the phone number above immediately.				Zoning District Urban Design District Submittal reviewed by					
1.	Project Information Address: Title:	*	ghway, Madison, WI 5371. oof						
2.	UDC meeting	date requested 0	pply) and Requested Da 9-26-18 Alteration to an existing a Initial approval	previously-approved develo Final approval	pment				
	Project in Mixed-Use Project in Campus Ir District (Ed	Project in an Urban Design District Project in the Downtown Core District (DC), Urban Mixed-Use District (UMX), or Mixed-Use Center District (MXC) Project in the Suburban Employment Center District (SEC) Campus Institutional District (CI), or Employment Campus District (EC) Planned Development (PD) □ General Development Plan (GDP) □ Specific Implementation Plan (SIP)		Signage Variance (i.e. rarea, and setback) Other Please specify					
:	Applicant nam Street address Telephone Project contact Street address Telephone	901 Deming Wa (608) 664-3500 t person Alan Theob 901 Deming Wa (608) 664-3500 or (if not applicant) G	ald ald sy sary Steinhafel	ompany Iconica ity/State/Zip Madison, WI 5 mail atheobald@iconicacrea ompany Iconica ty/State/Zip Madison, WI 5 mail atheobald@iconicacrea	tes.com				
	Street address Telephone	W231 N1013 Co (262) 436-4600		ty/State/Zip <u>Waukesha, W</u> nail garys@steinhafels.com					

5. Required Submittal Materials

- Application Form
- Letter of Intent
 - If the project is within an Urban Design District, a summary of how the development proposal addresses the district criteria is required
 - For signage applications, a summary of how the proposed signage is consistent with the applicable CDR or Signage Variance review criteria is required.
- Development plans (Refer to checklist provided below for plan details)
- Filing fee
- Electronic Submittal*

include fourteen (14) 11" x 17" collated paper copies. Landscape and Lighting plans (if required) must be full-sized. Please refrain from using plastic covers or spiral binding.

Each submittal must

Both the paper copies and electronic copies <u>must</u> be submitted prior to the application deadline before an application will be scheduled for a UDC meeting. Late materials will not be accepted. A completed application form is required for each UDC appearance.

For projects also requiring Plan Commission approval, applicants must also have submitted an accepted application for Plan Commission consideration prior to obtaining any formal action (initial or final approval) from the UDC. All plans must be legible when reduced.

*Electronic copies of all items submitted in hard copy are required. Individual PDF files of each item submitted should be compiled on a CD or flash drive, or submitted via email to <u>udcapplications@cityofmadison.com</u>. The email must include the project address, project name, and applicant name. Electronic submittals via file hosting services (such as Dropbox.com) are not allowed. Applicants who are unable to provide the materials electronically should contact the Planning Division at (608) 266-4635 for assistance.

6. Applicant Declarations

1.	Prior to submitting this Commission staff. This	application,	the was	applicant discussed	is I w	required vith JAN	to IN E	discuss	the	proposed R そく h	project RISTIN	with A	Urban THIEL	Desi	gn on
	7/31/18														

The applicant attests that all required materials are included in this submittal and understands that if any required information is not provided by the application deadline, the application will not be placed on an Urban Design Commission agenda for consideration.

Applicant name ALAN	THEOBALD >	α	Relationship to propert	y AR	CHITECT
Authorized signature of Property C	wner		alel.	Date	8-6-18
Notificial and an arrangement of a second		GARY	STEINHAFEL)		

7. Application Filing Fees

Fees are required to be paid with the first application for either initial or final approval of a project, unless the project is part of the combined application process involving the Urban Design Commission in conjunction with Plan Commission and/or Common Council consideration. Make checks payable to City Treasurer. Credit cards may be used for application fees of less than \$1,000.

Please consult the schedule below for the appropriate fee for your request:

Urban Design Districts: \$350 (per §35.24(6) MGO).
Minor Alteration in the Downtown Core District (DC) or Urban Mixed-Use District (UMX): \$150 (per §33.24(6)(b) MGO)
Comprehensive Design Review: \$500 (per §31.041(3)(d)(1)(a) MGO)
Minor Alteration to a Comprehensive Sign Plan: \$100

(per §31.041(3)(d)(1)(c) MGO)

☐ All other sign requests to the Urban Design Commission, including, but not limited to: appeals from the decisions of the Zoning Administrator, requests for signage variances (i.e. modifications of signage height, area, and setback), and additional sign code approvals: \$300 (per §31.041(3)(d)(2) MGO)

A filing fee is not required for the following project applications if part of the combined application process involving both Urban Design Commission and Plan Commission:

- Project in the Downtown Core District (DC), Urban Mixed-Use District (UMX), or Mixed-Use Center District (MXC)
- Project in the Suburban Employment Center
 District (SEC), Campus Institutional District (CI), or
 Employment Campus District (EC)
- Planned Development (PD): General Development
 Plan (GDP) and/or Specific Implementation Plan (SIP)
- Planned Multi-Use Site or Residential Building Complex



STEINHAFELS FURNITURE

2164 WEST BELTLINE HIGHWAY MADISON, WI 53713

LETTER OF INTENT:

The Steinhafels Furniture at 2164 West Beltline Highway was built in 1995. The roof over the main entrance is failing and is in need of replacement. As part of the required repair, Steinhafels would like to upgrade the old façade over the main entrance to match their brand, which has been established at their other Retail store locations, as well as fix the sight lines to their main sign which is currently obscured by the lower transluscent panels.

The existing store exterior is a mix of scored c.m.u., brick, precast concrete, and EIFS, with a large transluscent panel façade over the main entry. The renovation will be limited to the façade area over the main entrance, so most of the existing store exterior will remain as is.

New work will include adding a new roof element and façade at the main entrance. We are proposing a new EIFS skin to replace the aging transluscent panels, which have reached the end of their expected life. The panels look old and faded and do not blend well with the rest of the facades in this retail center. Upgrading the facade will also allow the roof replacement solution to be more effectively tied into the existing building exterior. The proposed façade will more closely resemble the adjacent facades as is evident in the attached photos.

The Existing EIFS on the South elevation will remain as is, with the exception of a new coat of paint to match the new EIFS on the facade. The new paint will be a lighter shade of the existing color, which will match the previously painted pylon sign.

The existing building signage at the main entrance will be removed during the renovation. The main sign ("Steinhafels") will be re-installed on the new façade, while the secondary sign ("Furniture Superstore") will be replaced with a new sign of similar design. Both signs will remain internally lit box letters.

The two existing signs ("Steinhafels" and "Furniture Superstore") are a combined 321 s.f. The new signage will be slightly smaller in size, however as they will be pushed together are considered as a single sign, the new 360 s.f. size includes the void space between the two signs.

To help the new façade tie in with the overall look of the Center, the new height will be 2'-0" shorter than the existing façade. At 240' wide, Steinhafels is the largest store in the Center and the gradual stepping of the facades helps draw you to the main entrance. Also, the new signage will be 4'-3" lower than the existing signage. The resulting façade is a better fit to the rest of the Center in both material and "look".





Gotham Architectural Downlighting LED Downlights





6" Evo®
Downlight

Solid-State Lighting





SHOWN: 4500LM (LEFT), 17,500LM (RIGHT)

FEATURES OPTICAL SYSTEM

Patented Bounding Ray[™] optical design (U.S. Patent No. 5,800,050)

- 45° cutoff to source and source image
- Top-down flash characteristic
- · Polycarbonate lens integral to light engine

MECHANICAL SYSTEM

- 16-gauge galvanized steel construction; maximum 1-1/2" ceiling thickness
- Telescopic mounting bars maximum of 32", preinstalled, 4" vertical adjustment
- Toolless adjustments post installation
- Junction box capacity: 8 (4 in, 4 out) 12AWG rated for 90°C
- Light engine and driver accessible through aperture

ELECTRICAL SYSTEM

- Fully serviceable and upgradeable lensed LED light engine
- 70% lumen maintenance at 60,000 hours
- Tested according to LM-79 and LM-80 standards
- · Overload and short circuit protected
- 2.5 SDCM; 85 CRI typical, 90+ CRI optional

LISTINGS

 Fixtures are CSA certified to meet US and Canadian standards; wet location, covered ceiling. ENERGY STAR® certified product.

WARRANTY

5-year limited warranty. Complete warranty terms located at: www.acuitybrands.com/CustomerResources/Terms and conditions.aspx

Note:

Actual performance may differ as a result of end user environment and application.

All values are design or typical values, measured under laboratory conditions at 25 $^{\circ}\text{C}.$

	WATTAGE CONSUMPTION MATRIX								
NOMINAL LUMENS	DELIVERED LUMENS*	WATTAGE	LUMENS per WATT						
1000	1074	11.8	91.4						
1500	1595	18.5	86.2						
2000	2064	23.2	89.2						
2500	2660	29.5	90.2						
3000	3077	36.6	84.1						
3500	3665	42.1	87.1						
4000	4050	48.1	84.2						
4500	4623	46.9	98.6						
5000	5256.3	48.66	108.0						
6000	6371.4	57.61	110.6						
8000	8246.7	74.89	110.1						
10000	10636.5	97.13	109.5						
12000	12332	115.0	107.2						
15000	15776	150.9	104.5						
17500	17801	175.3	101.5						

*Lumen Output for CRI80 - 3500K - MWD - Clear LS Reflector

****** Capable Luminaire

This item is an A+ capable luminaire, which has been designed and tested to provide consistent color appearance and out-of-the-box control compatibility with simple commissioning.

- All configurations of this luminaire meet the Acuity Brands' specification for chromatic consistency
- This luminaire is part of an A+ Certified solution for nLight® control networks when ordered with drivers marked by a shaded background*
- This luminaire is part of an A+ Certified solution for nLight® control networks, providing advanced control
 functionality at the luminaire level, when selection includes driver and control options marked by a shaded
 background*

To learn more about A+, visit www.acuitybrands.com/aplus.

*See ordering tree for details





ORDERING INFORMATION





Design2Ship Quick Ship Program: Options in green text qualify for Design2Ship — 5 business days from order entry to ship. Refer to Design2Ship Brochure for complete program details. Maximum Order Quantity: 100 units; 50 for Chicago Plenum.

EXAMPLE: EVO 35/150 GAR MWD LSS MVOLT EZ1

Series	Color ten	nperature	Nomi	nal lumen value:	S		Reflector	/Flange color	Trim St	yle	Distr	bution
EVO	30/ 30 35/ 33 40/ 4	700 K 000 K 500 K 000 K 000 K	10 15 20 25 30 35 40 45	1000 lumens 1500 lumens 2000 lumens 2500 lumens 3000 lumens 3500 lumens 4000 lumens 4500 lumens	50 60 80 100 120 150	5000 lumens 6000 lumens 8000 lumens 10000 lumens 12000 lumens 15000 lumens 17500 lumens	GAR GPR GWTR GGR GWR' GBR' GWRAMF'	Clear Pewter Wheat Gold White Black White anti- microbial	(biank) FL	Self-flanged Flangeless	ND MD MWD	Very narrow (0.5 s/mh) Narrow (0.7 s/mh) Medium (0.9 s/mh) Medium wide (1.0 s/mh) Wide (1.2 s/mh)
Finish		Voltage	Drive	3								
LD M	e <mark>mi-specular</mark> atte-diffuse pecular	MVOLT 120 277 347 ²	GZ10 GZ1 (EZ10) EZ1 EZB EDAB ⁴	0-10V driver dims 0-10V eldoLED dr free deep dimmin 0-10V eldoLED dr free deep dimmin 0-10V eldoLED dr free deep dimmin DALI eldoLED driv	0-10V driver dims to 10% 0-10V driver dims to 1% 0-10V eldoLED driver with smooth and flicker- free deep dimming performance down to 10% 0-10V eldoLED driver with smooth and flicker- free deep dimming performance down to 1% 0-10V eldoLED driver with smooth and flicker- free deep dimming performance to dark DALI eldoLED driver with smooth and flicker- free deep dimming performance to dark			flicker-free deep of XPoint Wireless, (dimming perform XPoint Wireless, (dimming perform Lutron® Hi-Lume	dimming per 0-10V eldoLE ance down t 0-10V eldoLE ance to darl [®] 2-wire for	rformance to dark ED driver with sm to 1% ED driver with sm k ward-phase drive	c. Refer to ooth and ooth and ooth and or. Minim	flicker-free deep

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SF	Single fuse. Specify 120V or 277V.	NPS80EZ ¹⁰	nLight® dimming pack controls 0-10V eldoLED drivers.
TRW ⁷	White painted flange	NPS80EZER ¹⁰	nLight® dimming pack controls 0-10V eldoLED drivers. ER controls
TRBL ⁸	Black painted flange		fixtures on emergency circuit.
EL ⁹	Emergency battery pack with integral test switch	N80 ¹⁰	nLight® Lumen Compensation
ELR ⁹	Emergency battery pack with remote test switch	BGTD	Bodine generator transfer device. Specify 120V or 277V.
ELSD	Emergency battery pack with self-diagnostics, integral test switch	CRI90	High CRI (90+)
ELRSD	Emergency battery pack with self-diagnostics, remote test switch	CP ¹²	Chicago plenum. Specify 120V or 277V.
E10WCP	Emergency battery pack, 10W Constant Power, CA Title 20 compliant	RRL	RELOC®-ready luminaire connectors enable a simple and consistent
NPP16D ¹⁰	nLight® network power/relay pack with 0-10V dimming for		factory installed option across all ABL luminaire brands. Refer to <u>RRL</u> for
	non-eldoLED drivers (GZ10, GZ1).		complete nomenclature.
NPP16DER ¹⁰	nLight® network power/relay pack with 0-10V dimming for	HAO ¹³	HAO High ambient option (40C)
	non-eldoLED drivers (GZ10, GZ1). ER controls fixtures on emergency circuit.	NLTAIR214	nLight® Air enabled

ACCESSORIES order as separate catalog numbers (shipped separately)

SCA6 Sloped ceiling adapter. Degree of slope must be specified (5D, 10D, 15D, 20D, 25D, 30D). Ex: SCA6 10D. Refer to TECH-190.

CTA4-8 YKH Ceiling thickness adapter for 10,000lm and above (extends mounting frame to accommodate ceiling thickness up to 5"). Adds ~4" to fixture height.

CTA4-8 YK
Ceiling thickness adapter for 8,000lm and below (extends mounting frame to accommodate ceiling thickness up to 5"). Adds ~4" to fixture height.

GVRT Vandal-resistant trim accessory. Refer to <u>TECH-200</u>.

ISD BC 0-10V wallbox dimmer. Refer to ISD-BC.

ORDERING NOTES

- Not available with finishes.
- Not available with emergency batterypack options.
- 3. Refer to <u>TECH-240</u> for compatible dimmers.
- 4. Not available with nLight® and Xpoint options.
- 5. Not available 17,500lm.
- 6. Specify voltage 120V or 277V.
- 7. Not applicable with WR or FL option.
- 8. Not applicable with BR or FL option.
- P. For dimensional changes, refer to <u>TECH-140</u>.


- Specify voltage. ER for use with generator supply power. Will require an emergency hot feed and normal hot feed.
- Fixture begins at 80% light level. Must be specified with NPS80EZ or NPS80EZ ER.
 Only available with EZ10 and EZ1 drivers.
- 12,000Im max with EL or nLight[®] options. 5,000Im max with Lutron drivers combined with EL. Not available with ELR, HAO, EXA1, or EXAB options.
- 13. Only available 5000lm -15,000lm with eldoLED drivers.
- Not available DALI or DMX drivers. Not available with CP, NPS80EZ, NPS80EZER, NPP16D, NPP16DER or N80 options.






DIMENSIONAL DATA


All dimensions are inches unless otherwise noted.

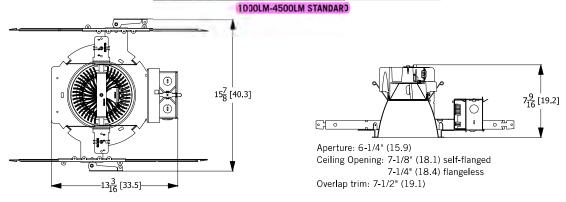


1000LM-4500LM BATTERYPACK

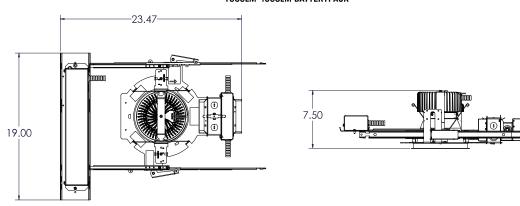


5000LM-8000LM STANDARD

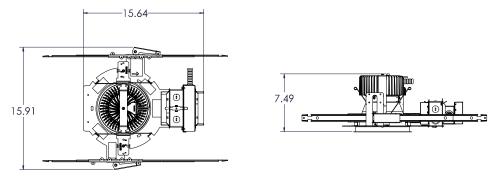

5000LM-8000LM BATTERYPACK

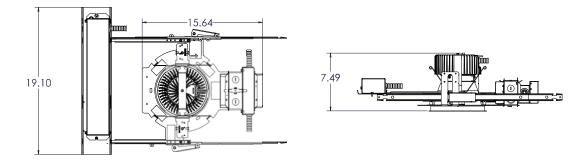

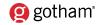





08/09/18 STEINHAFELS BELTLINE ROOF 2164 W. BELTLINE HWY MADISON, WI 53713 MATTRESS EXPRESS CENTER Steinhafels FURNITURE SUPERSTORE








08/09/18 STEINHAFELS BELTLINE ROOF 2164 W. BELTLINE HWY MADISON, WI 53713 Steinhafels FURNITURE SUPERSTORE MATTRESS EXPRESS CLEARANCE





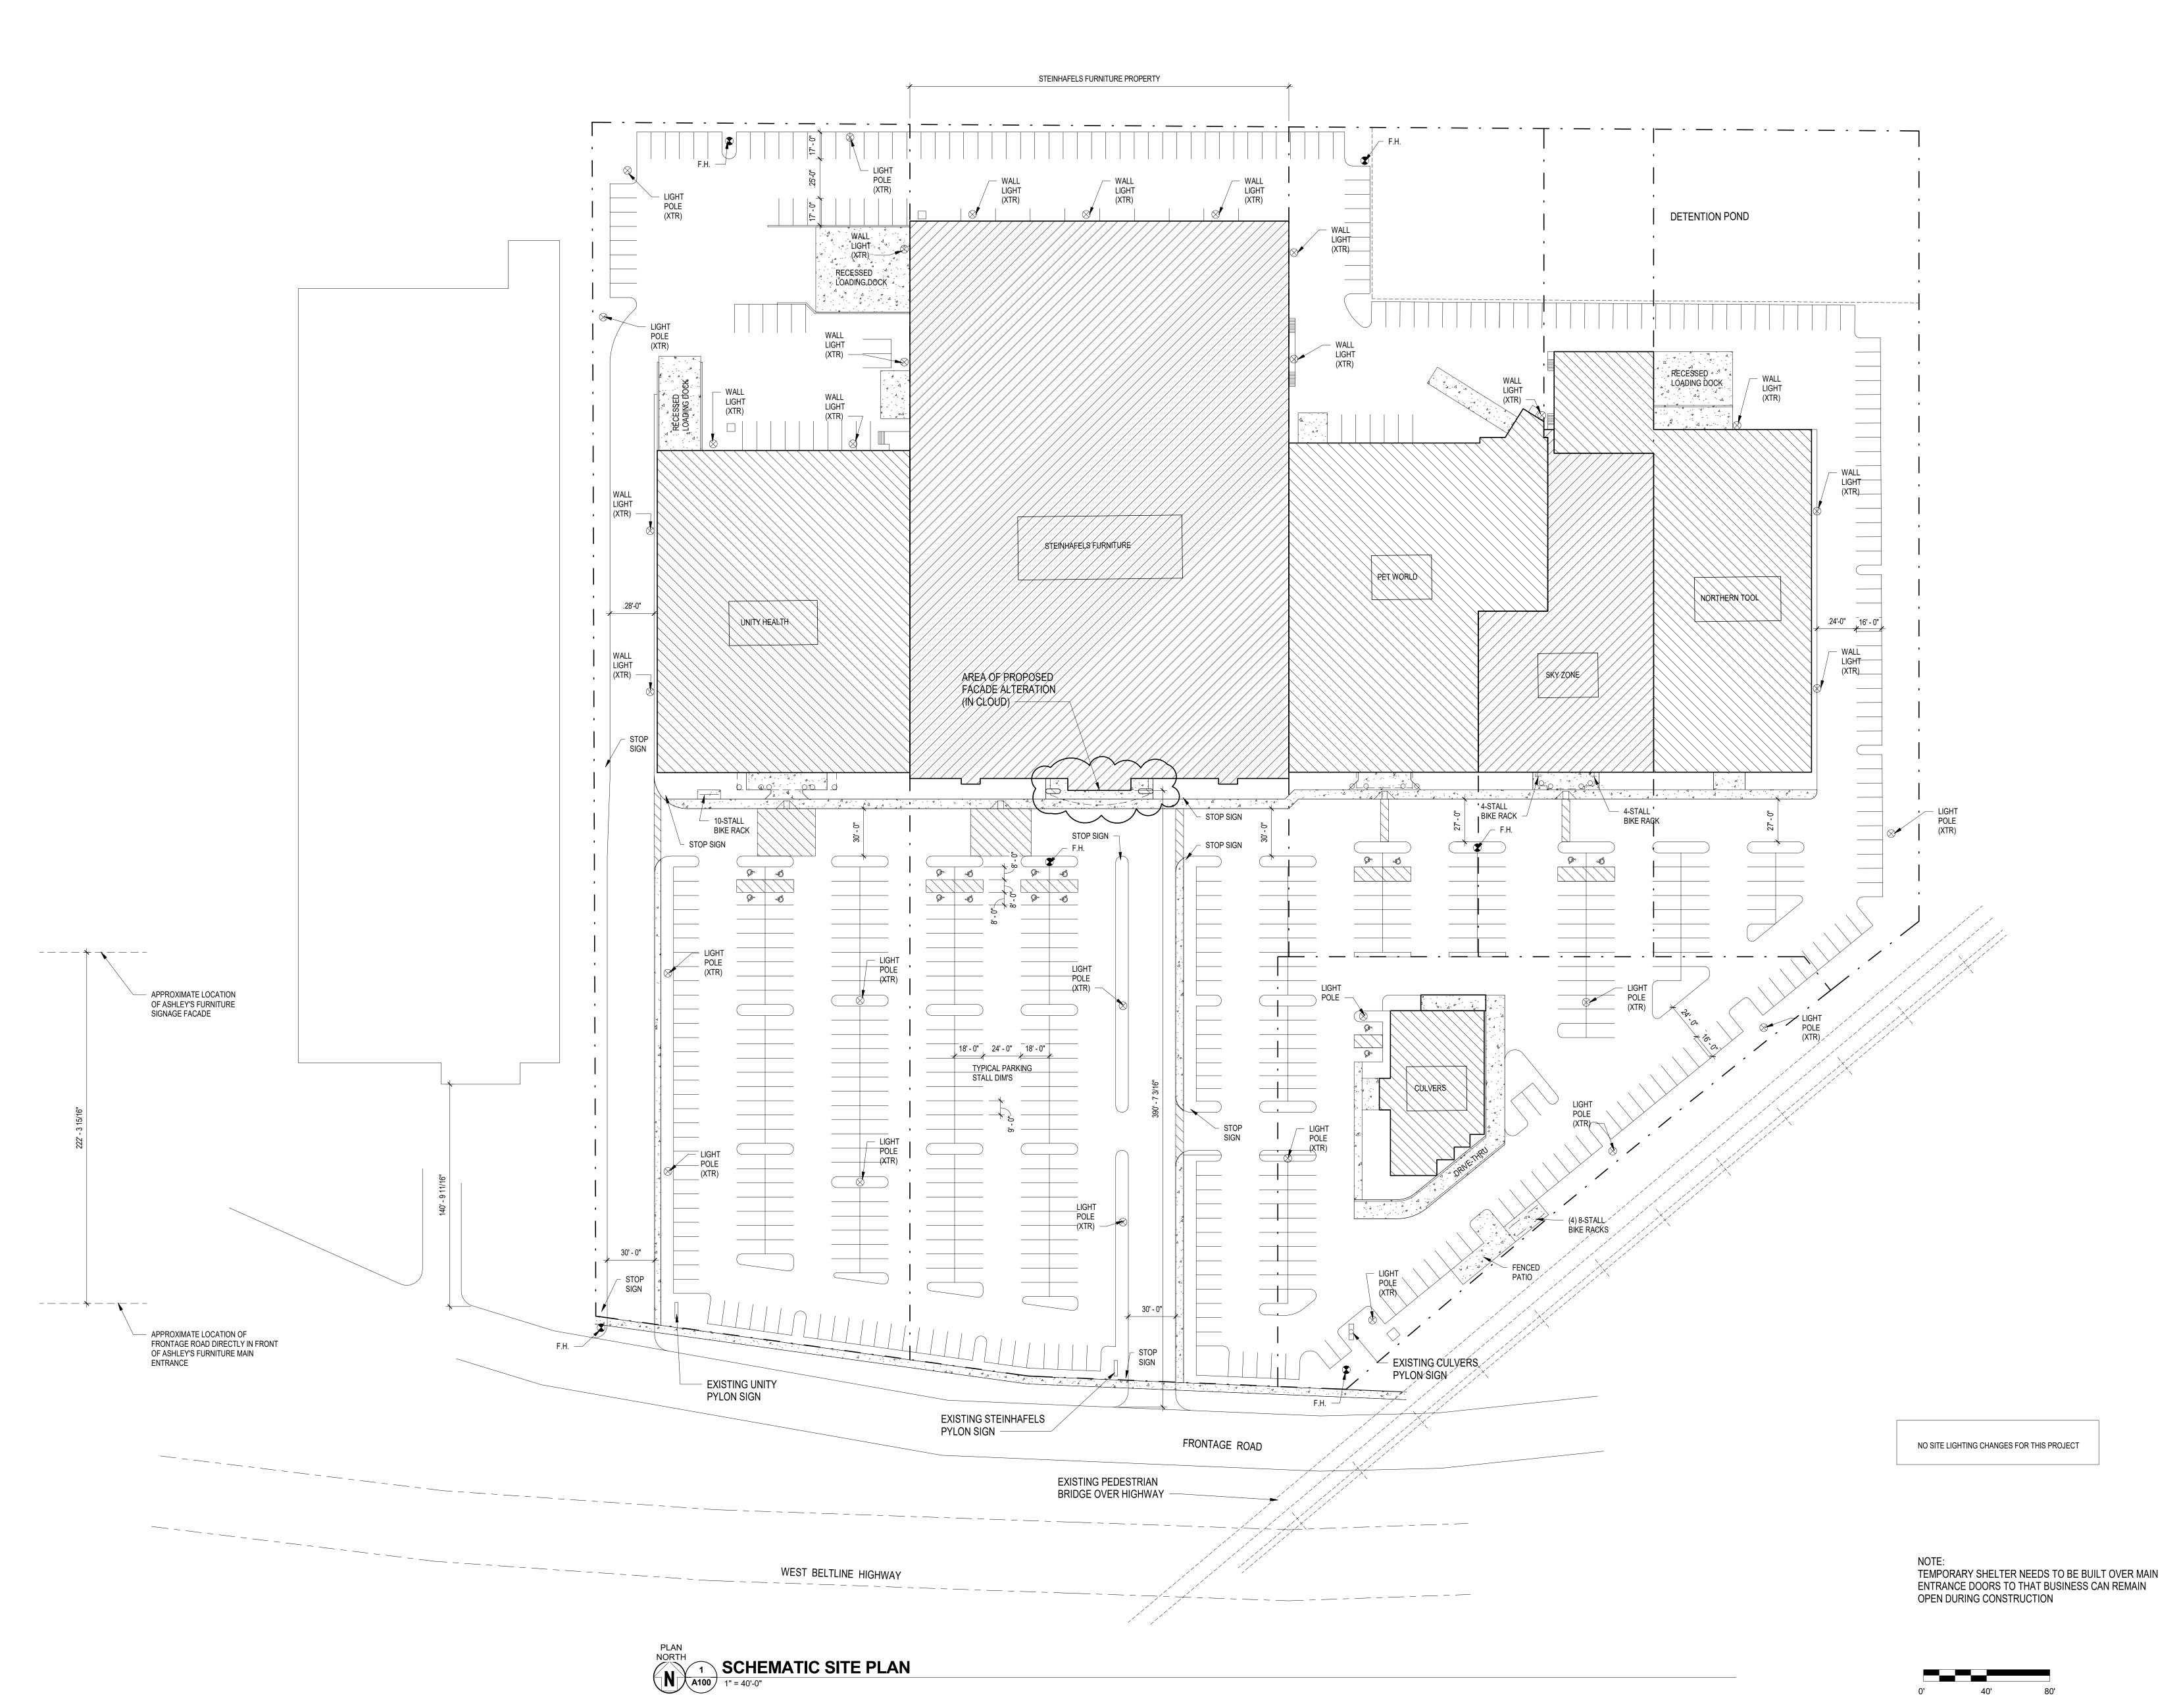

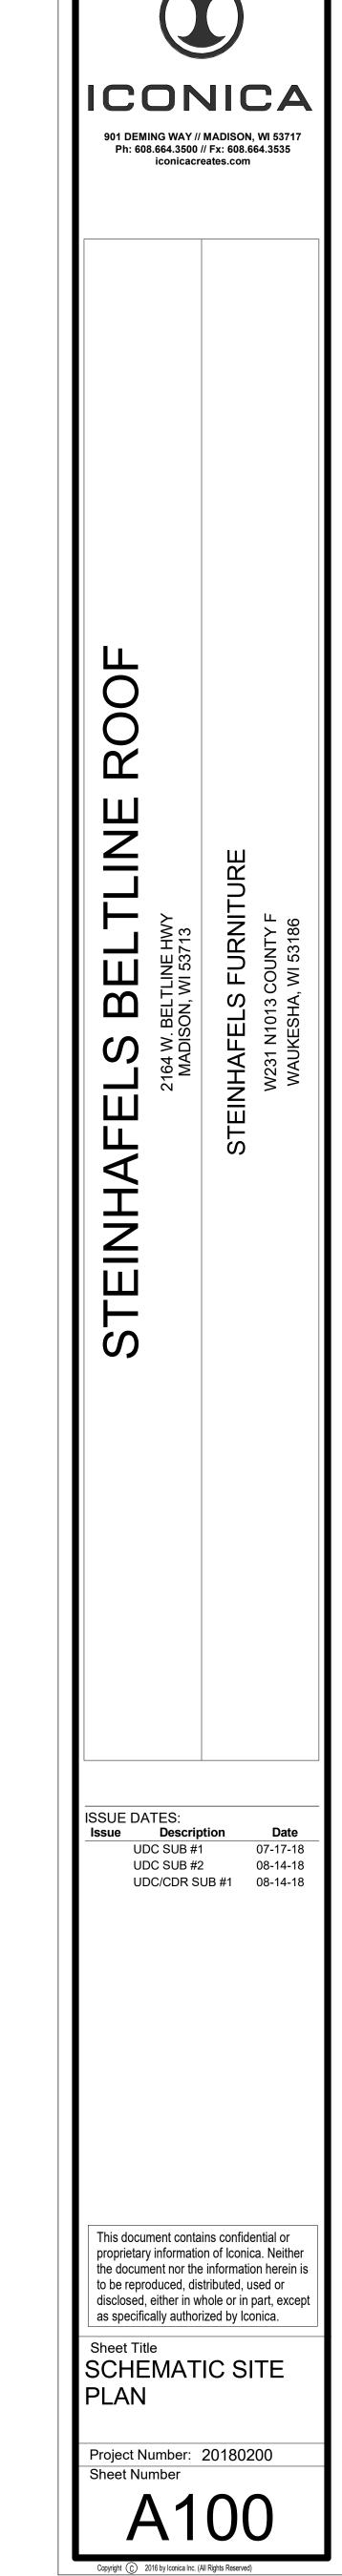

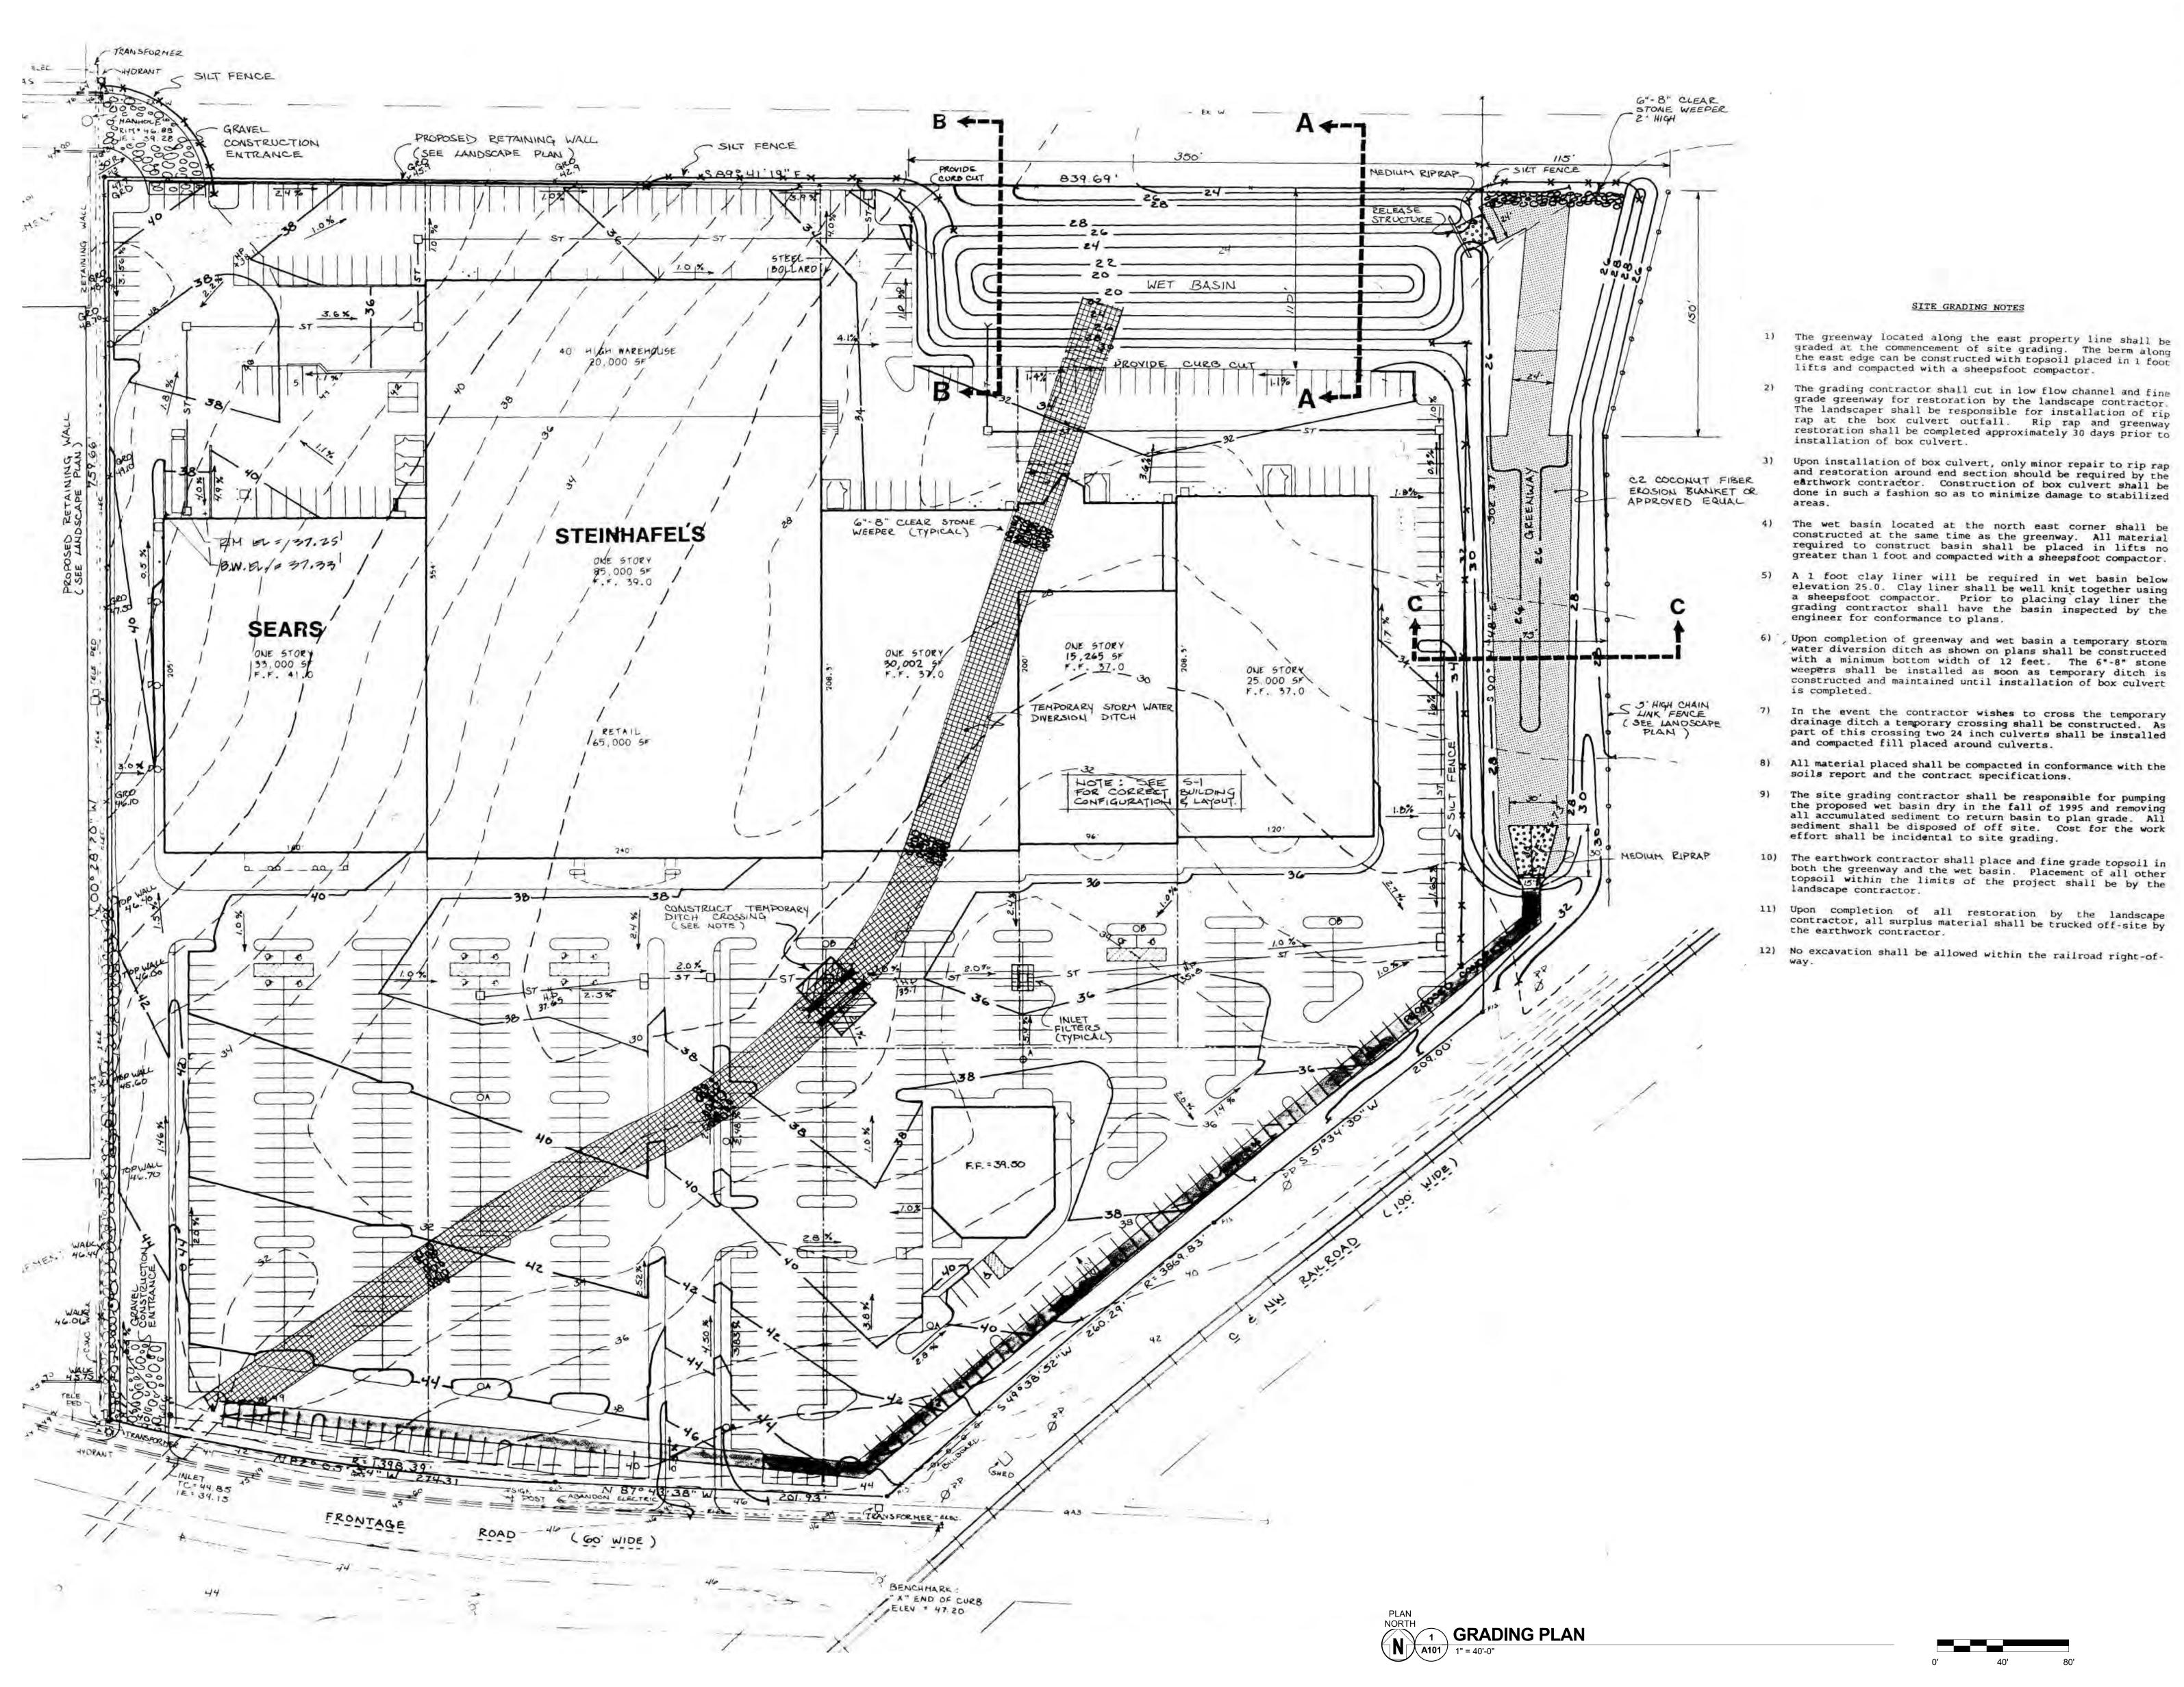



The landscaper shall be responsible for installation of rip rap at the box culvert outfall. Rip rap and greenway restoration shall be completed approximately 30 days prior to installation of box culvert.

done in such a fashion so as to minimize damage to stabilized

with a minimum bottom width of 12 feet. The 6"-8" stone weepers shall be installed as soon as temporary ditch is constructed and maintained until installation of box culvert


ISSUE DATES: Description


UDC SUB #2 UDC/CDR SUB #1 08-14-18

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as specifically authorized by Iconica. Sheet Title **GRADING PLAN**

Project Number: 20180200 Sheet Number



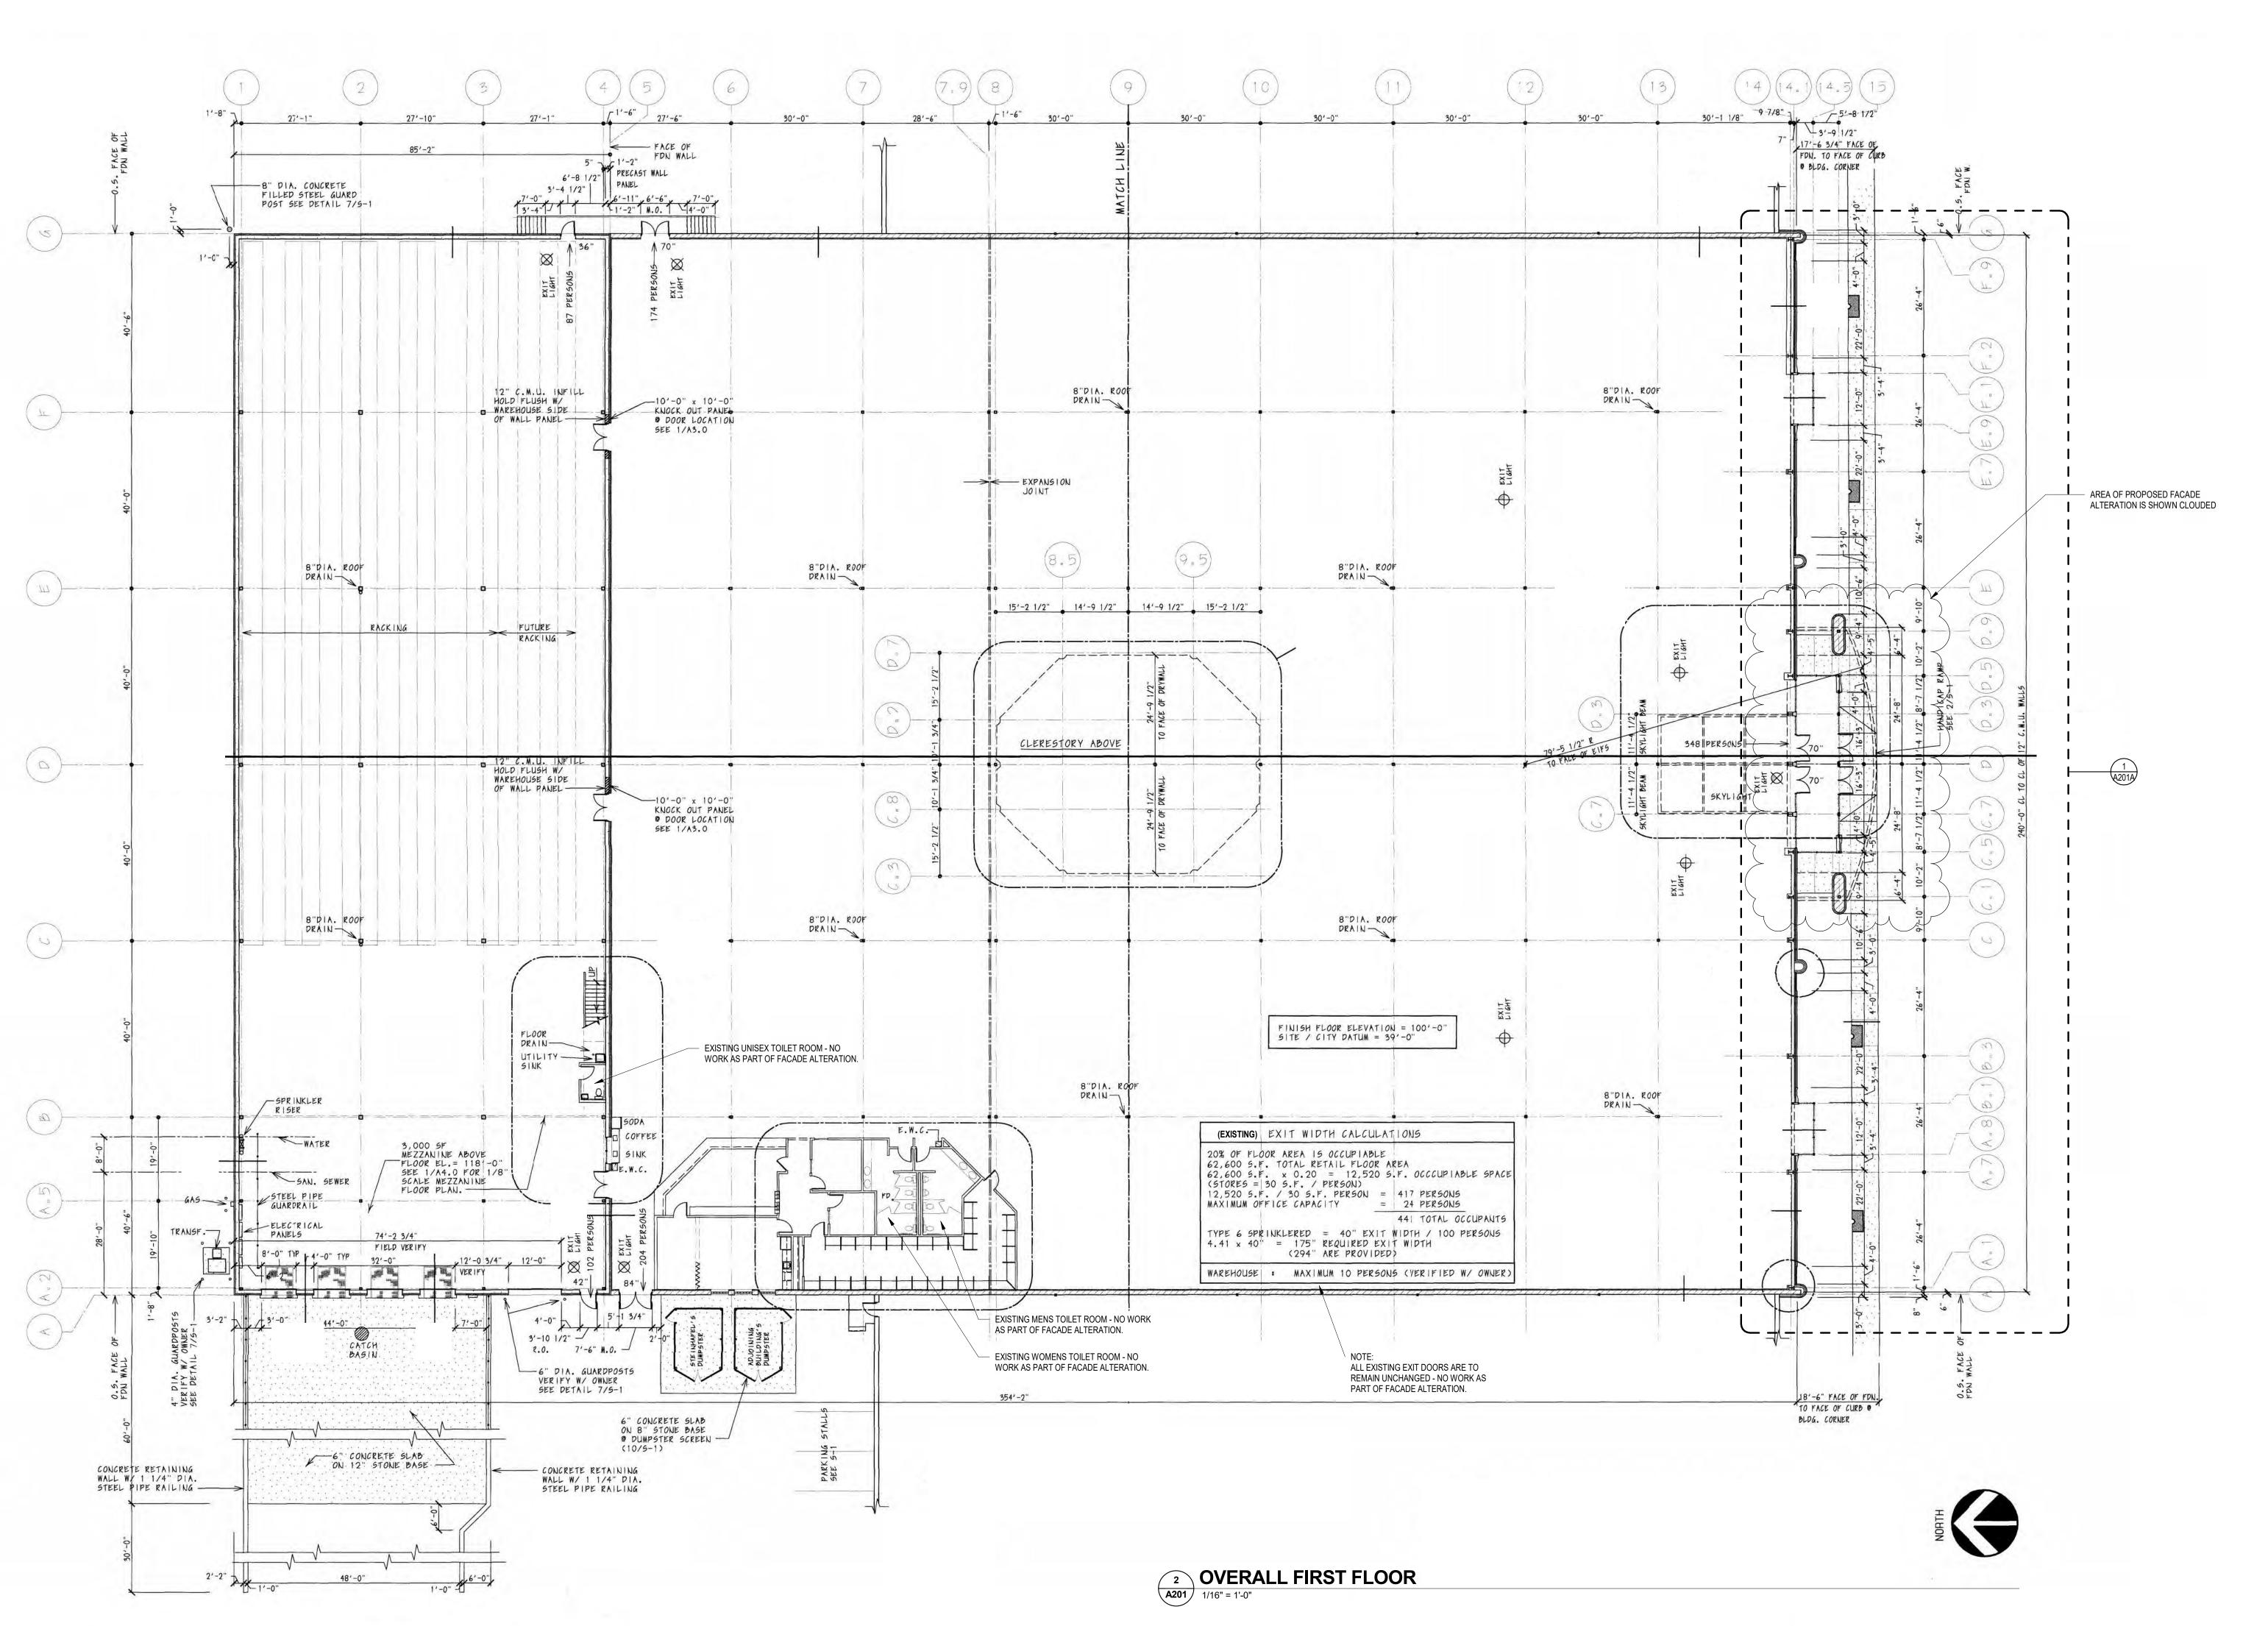

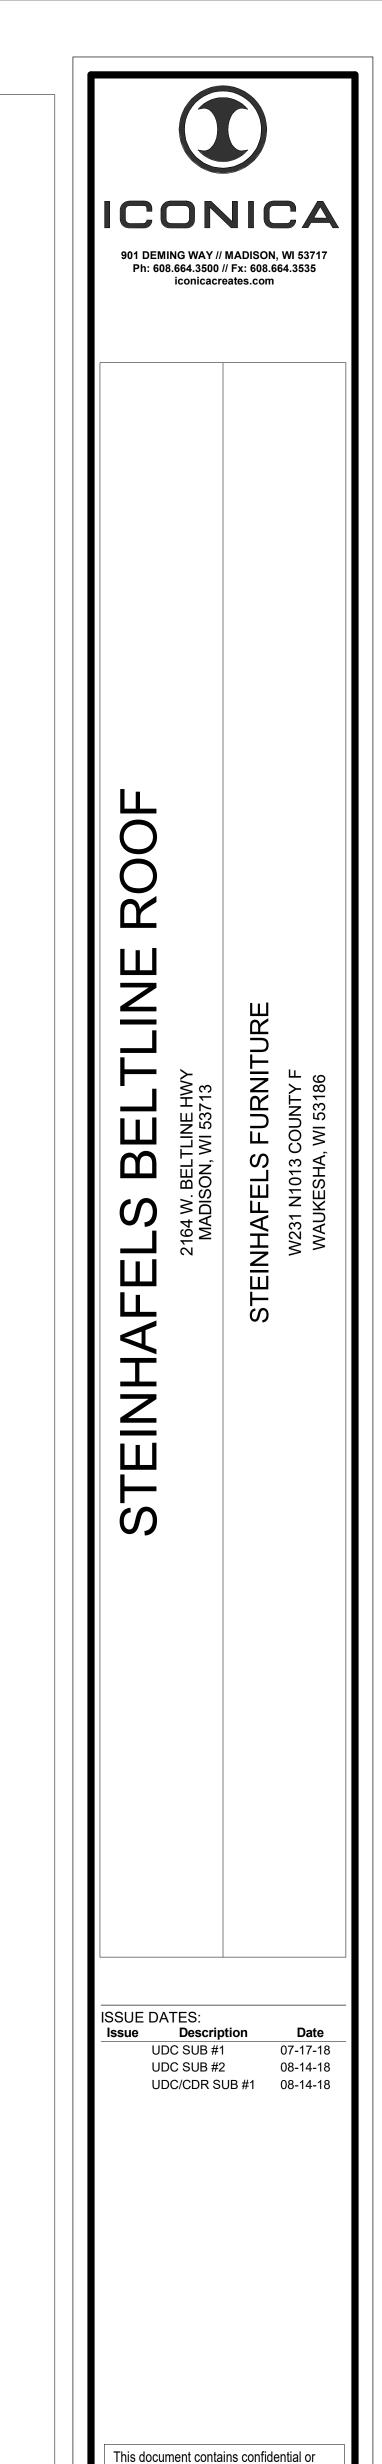
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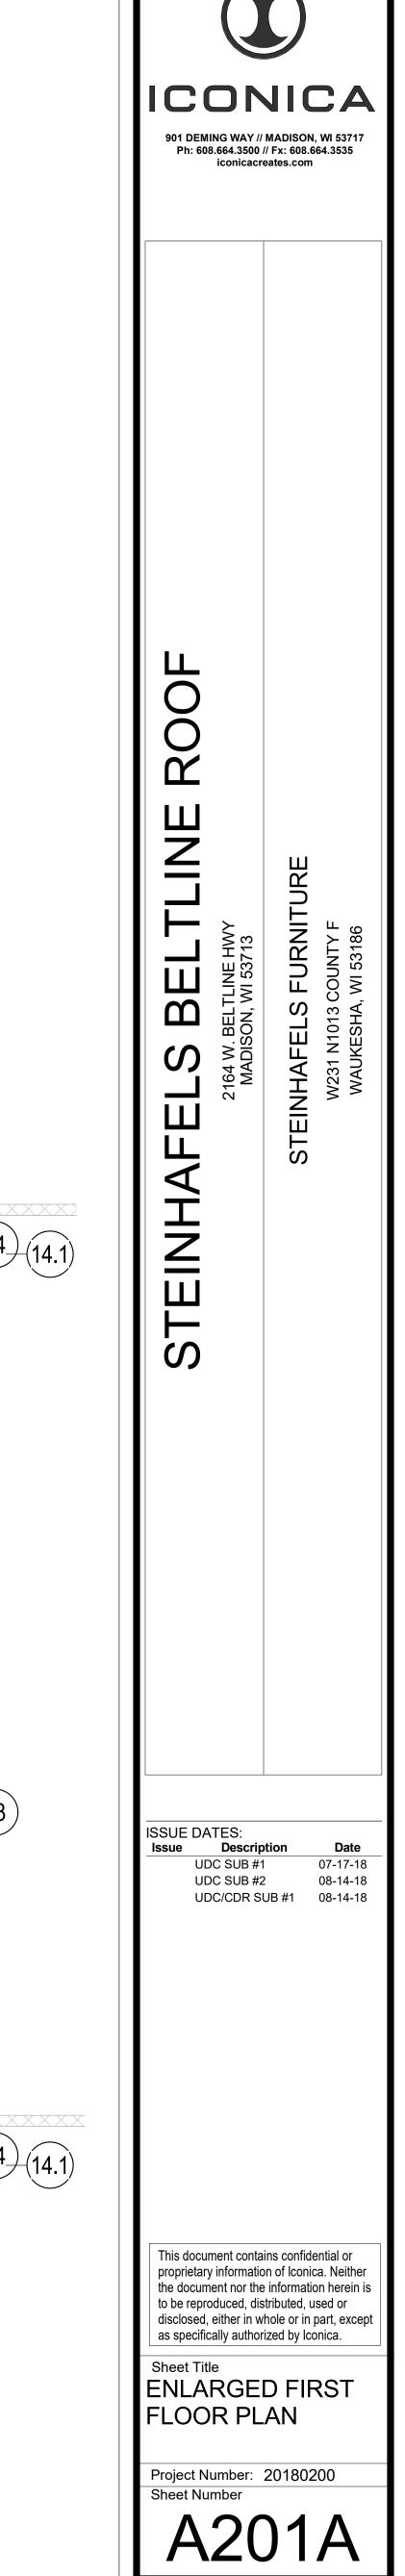
Sheet Title
OVERALL FIRST
FLOOR PLAN


Project Number: 20180200
Sheet Number

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STEINHAFELS E

2164 W. BE
MADISON

STEINHAFE W231 N'

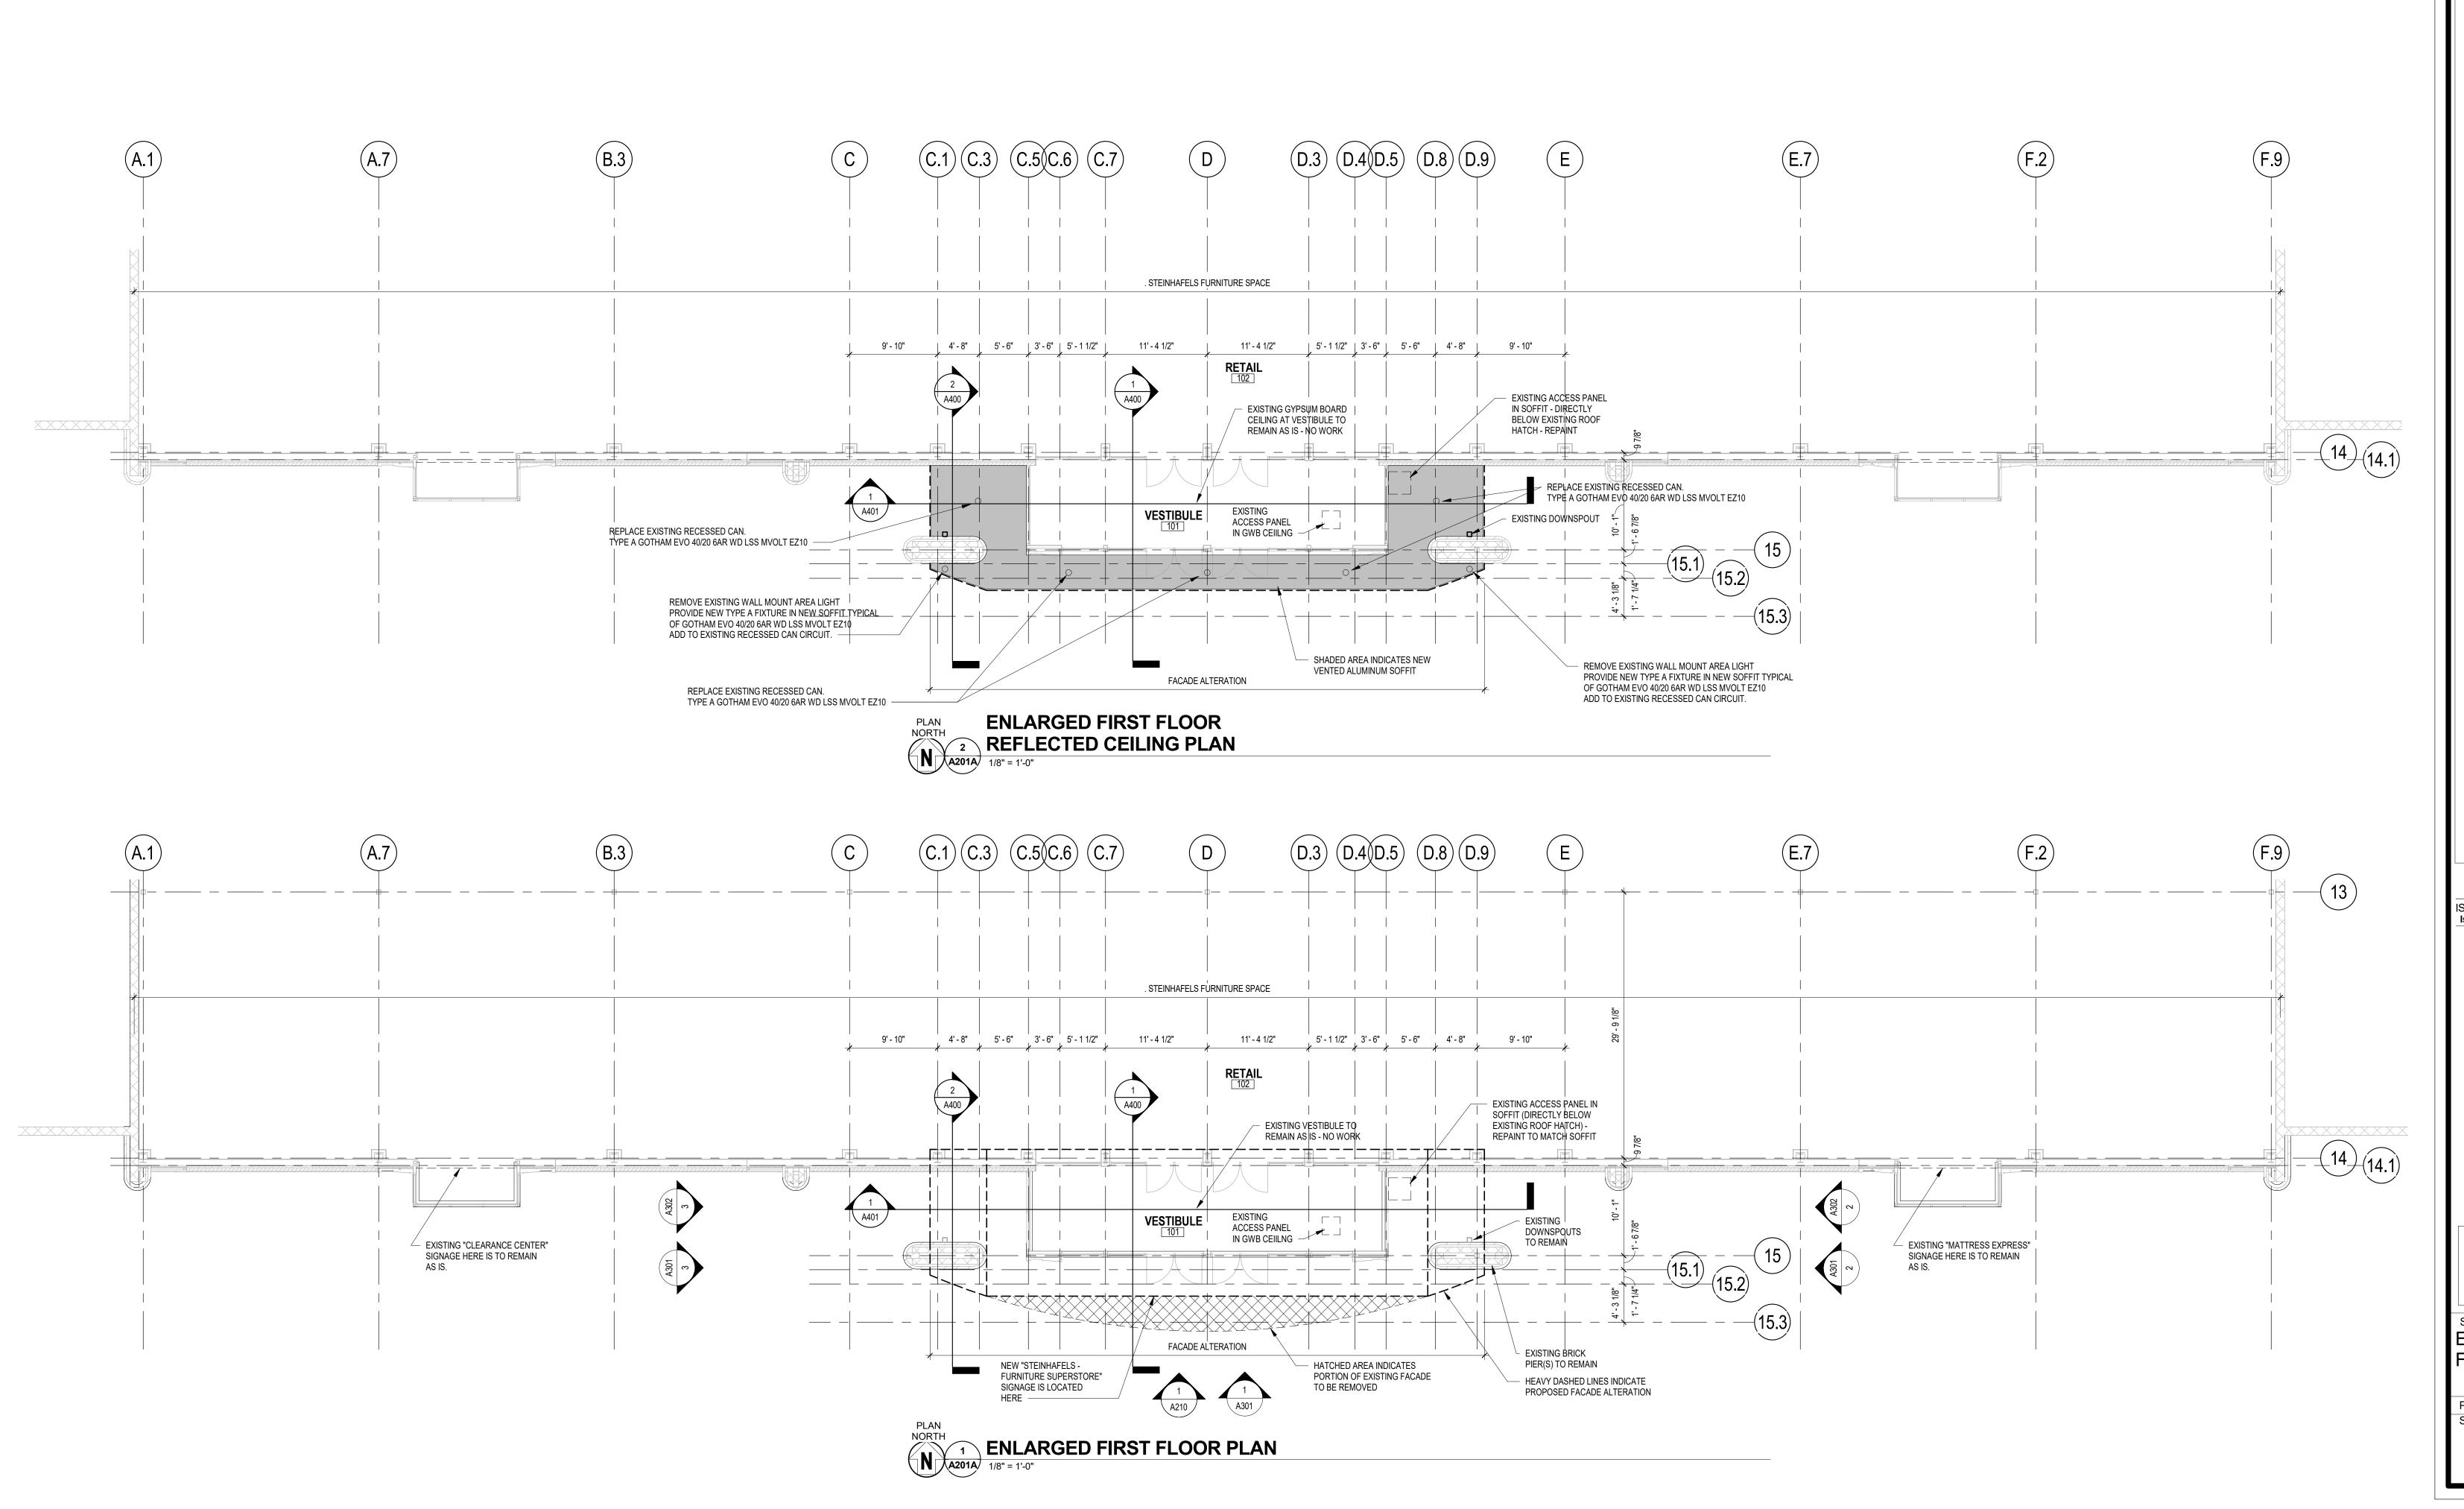
ISSUE DATES:
Issue Descri Description
UDC SUB #2 **Date** 08-14-18

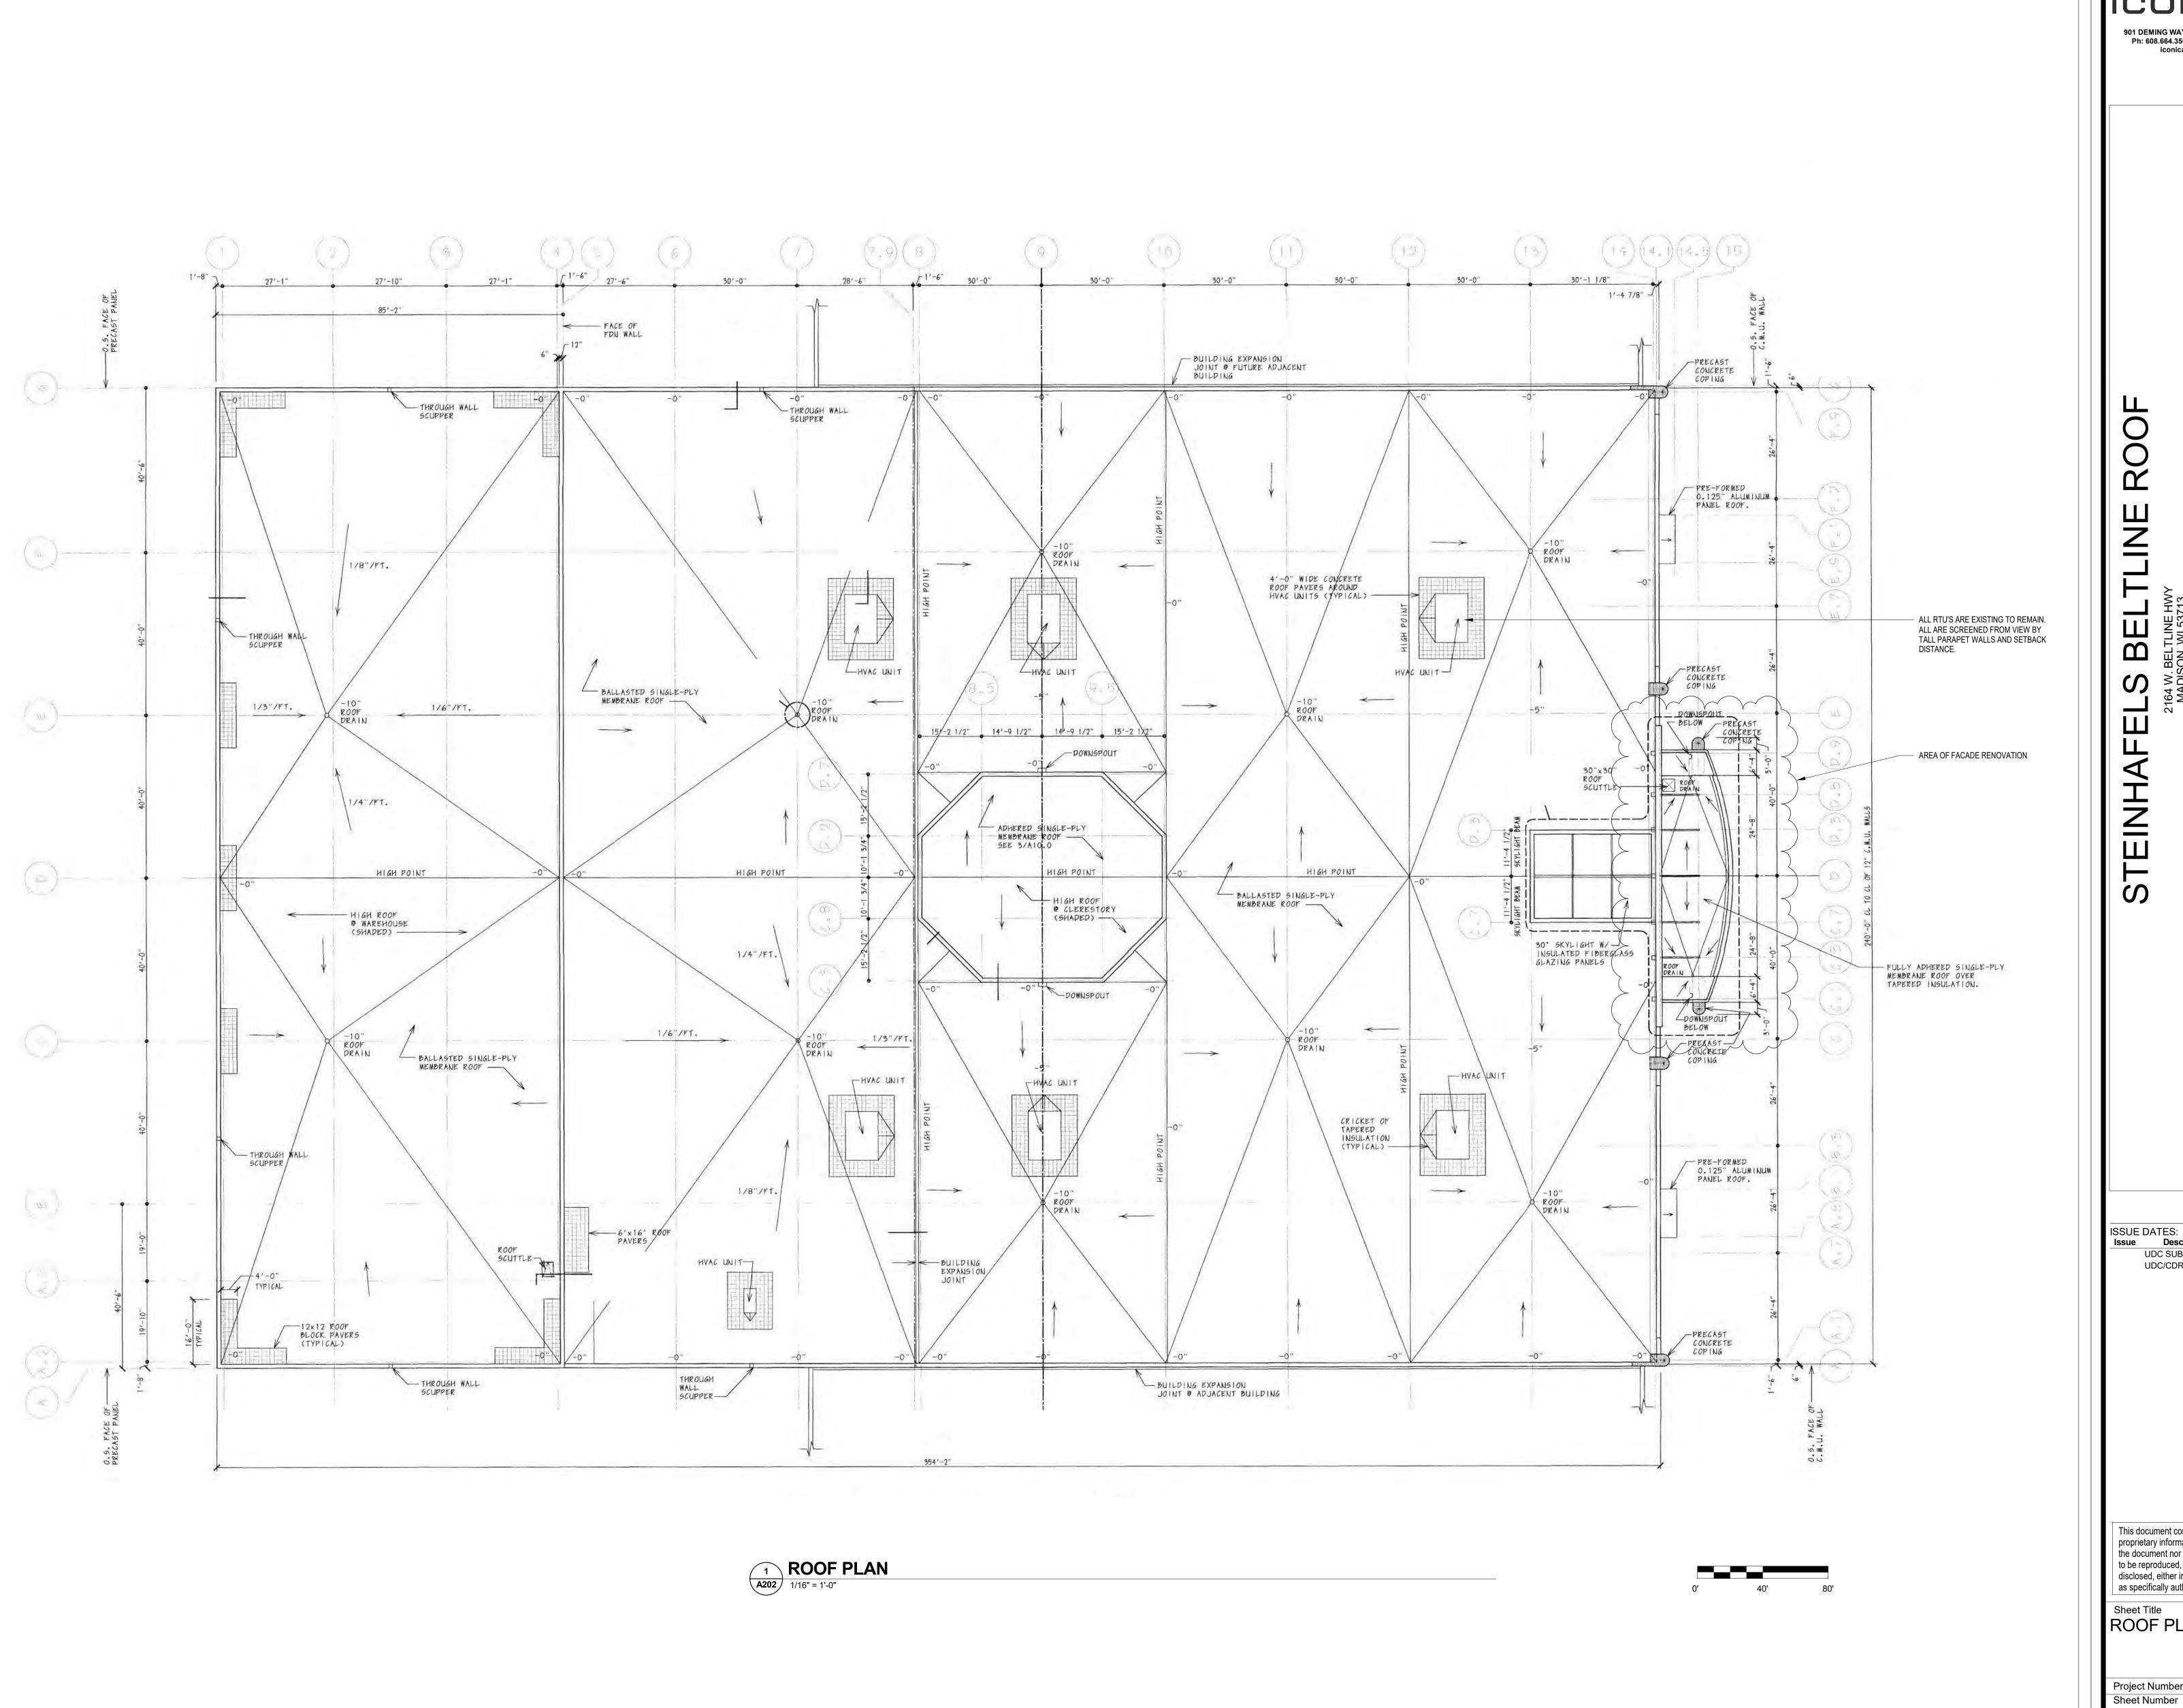
UDC/CDR SUB #1 08-14-18


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Sheet Title **ROOF PLAN**


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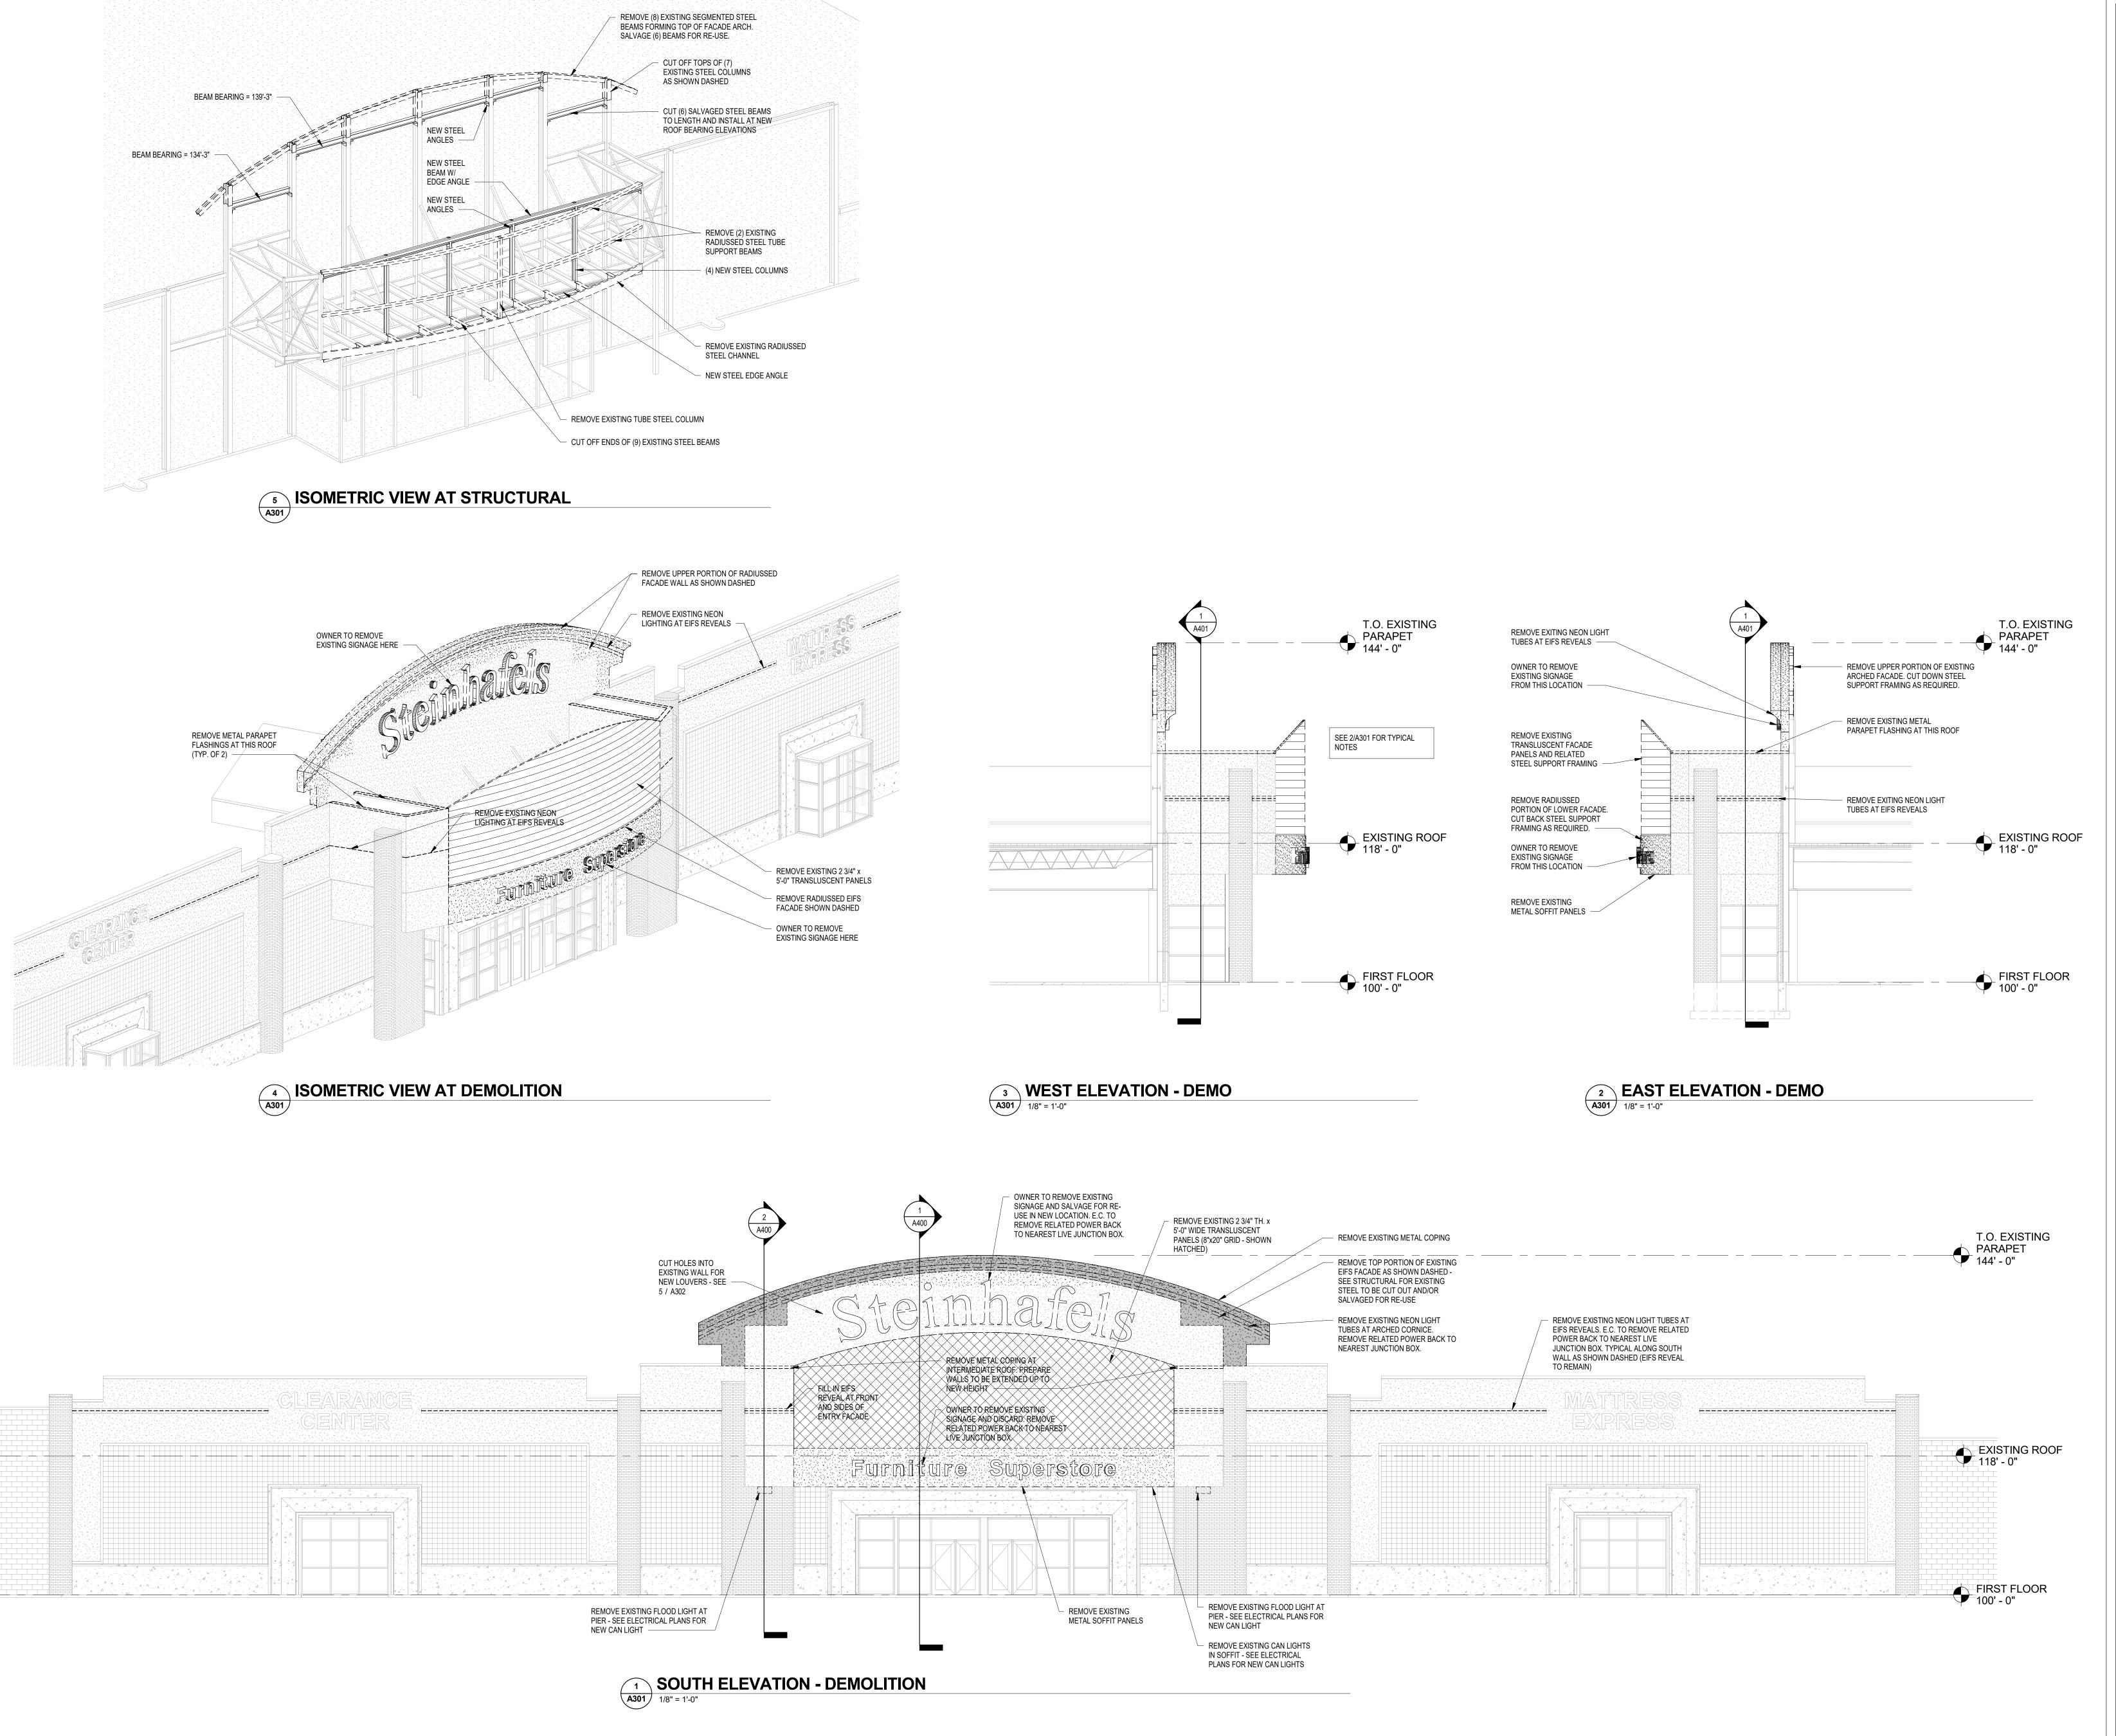




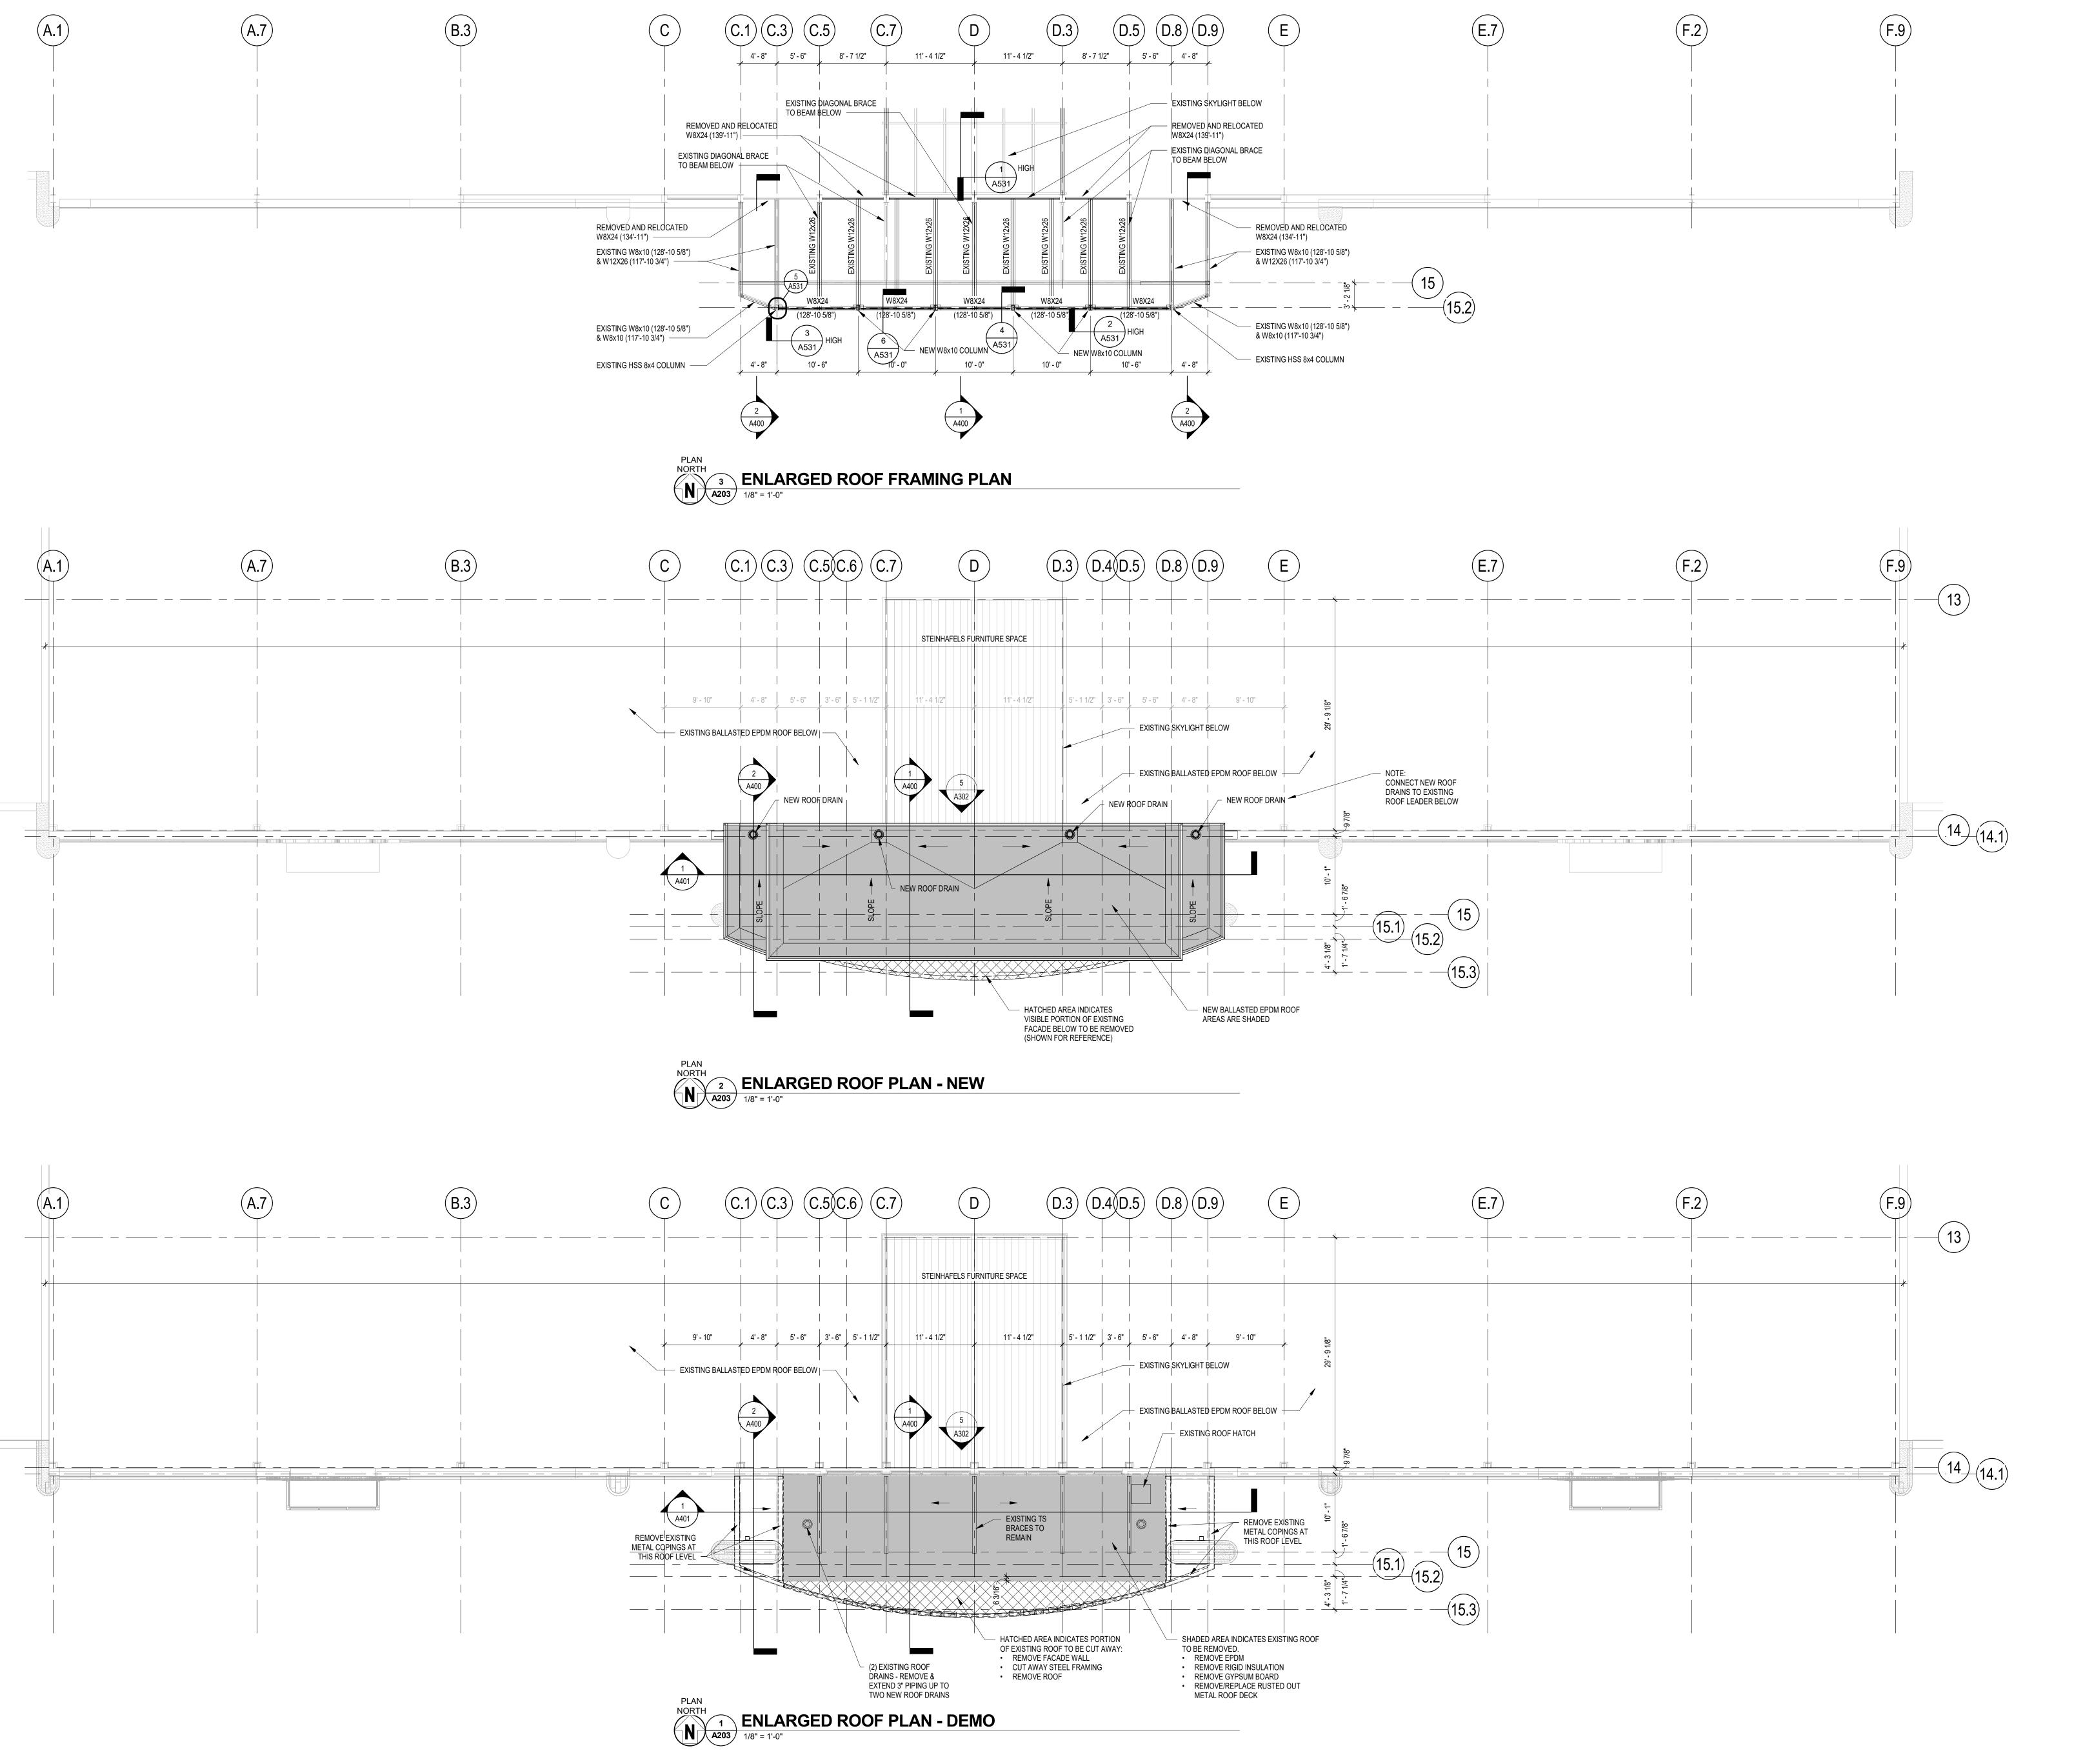


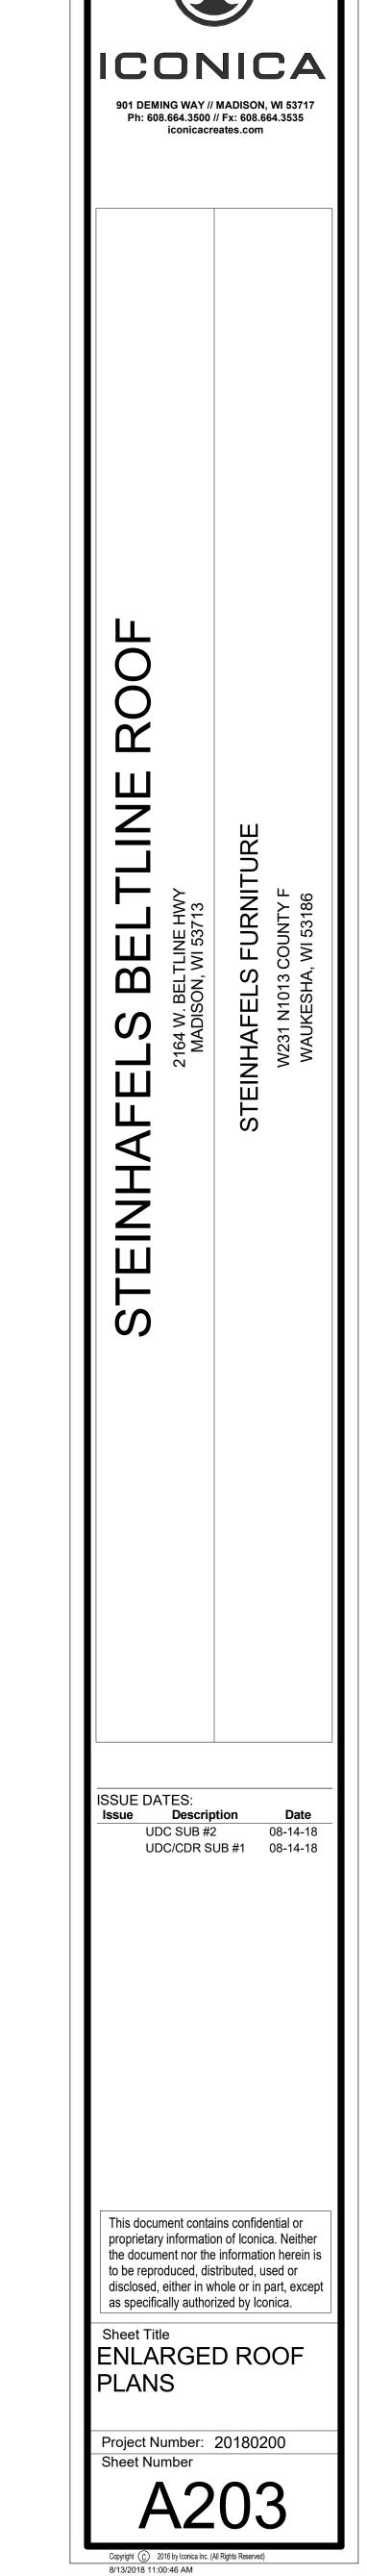A210 1/8" = 1'-0"

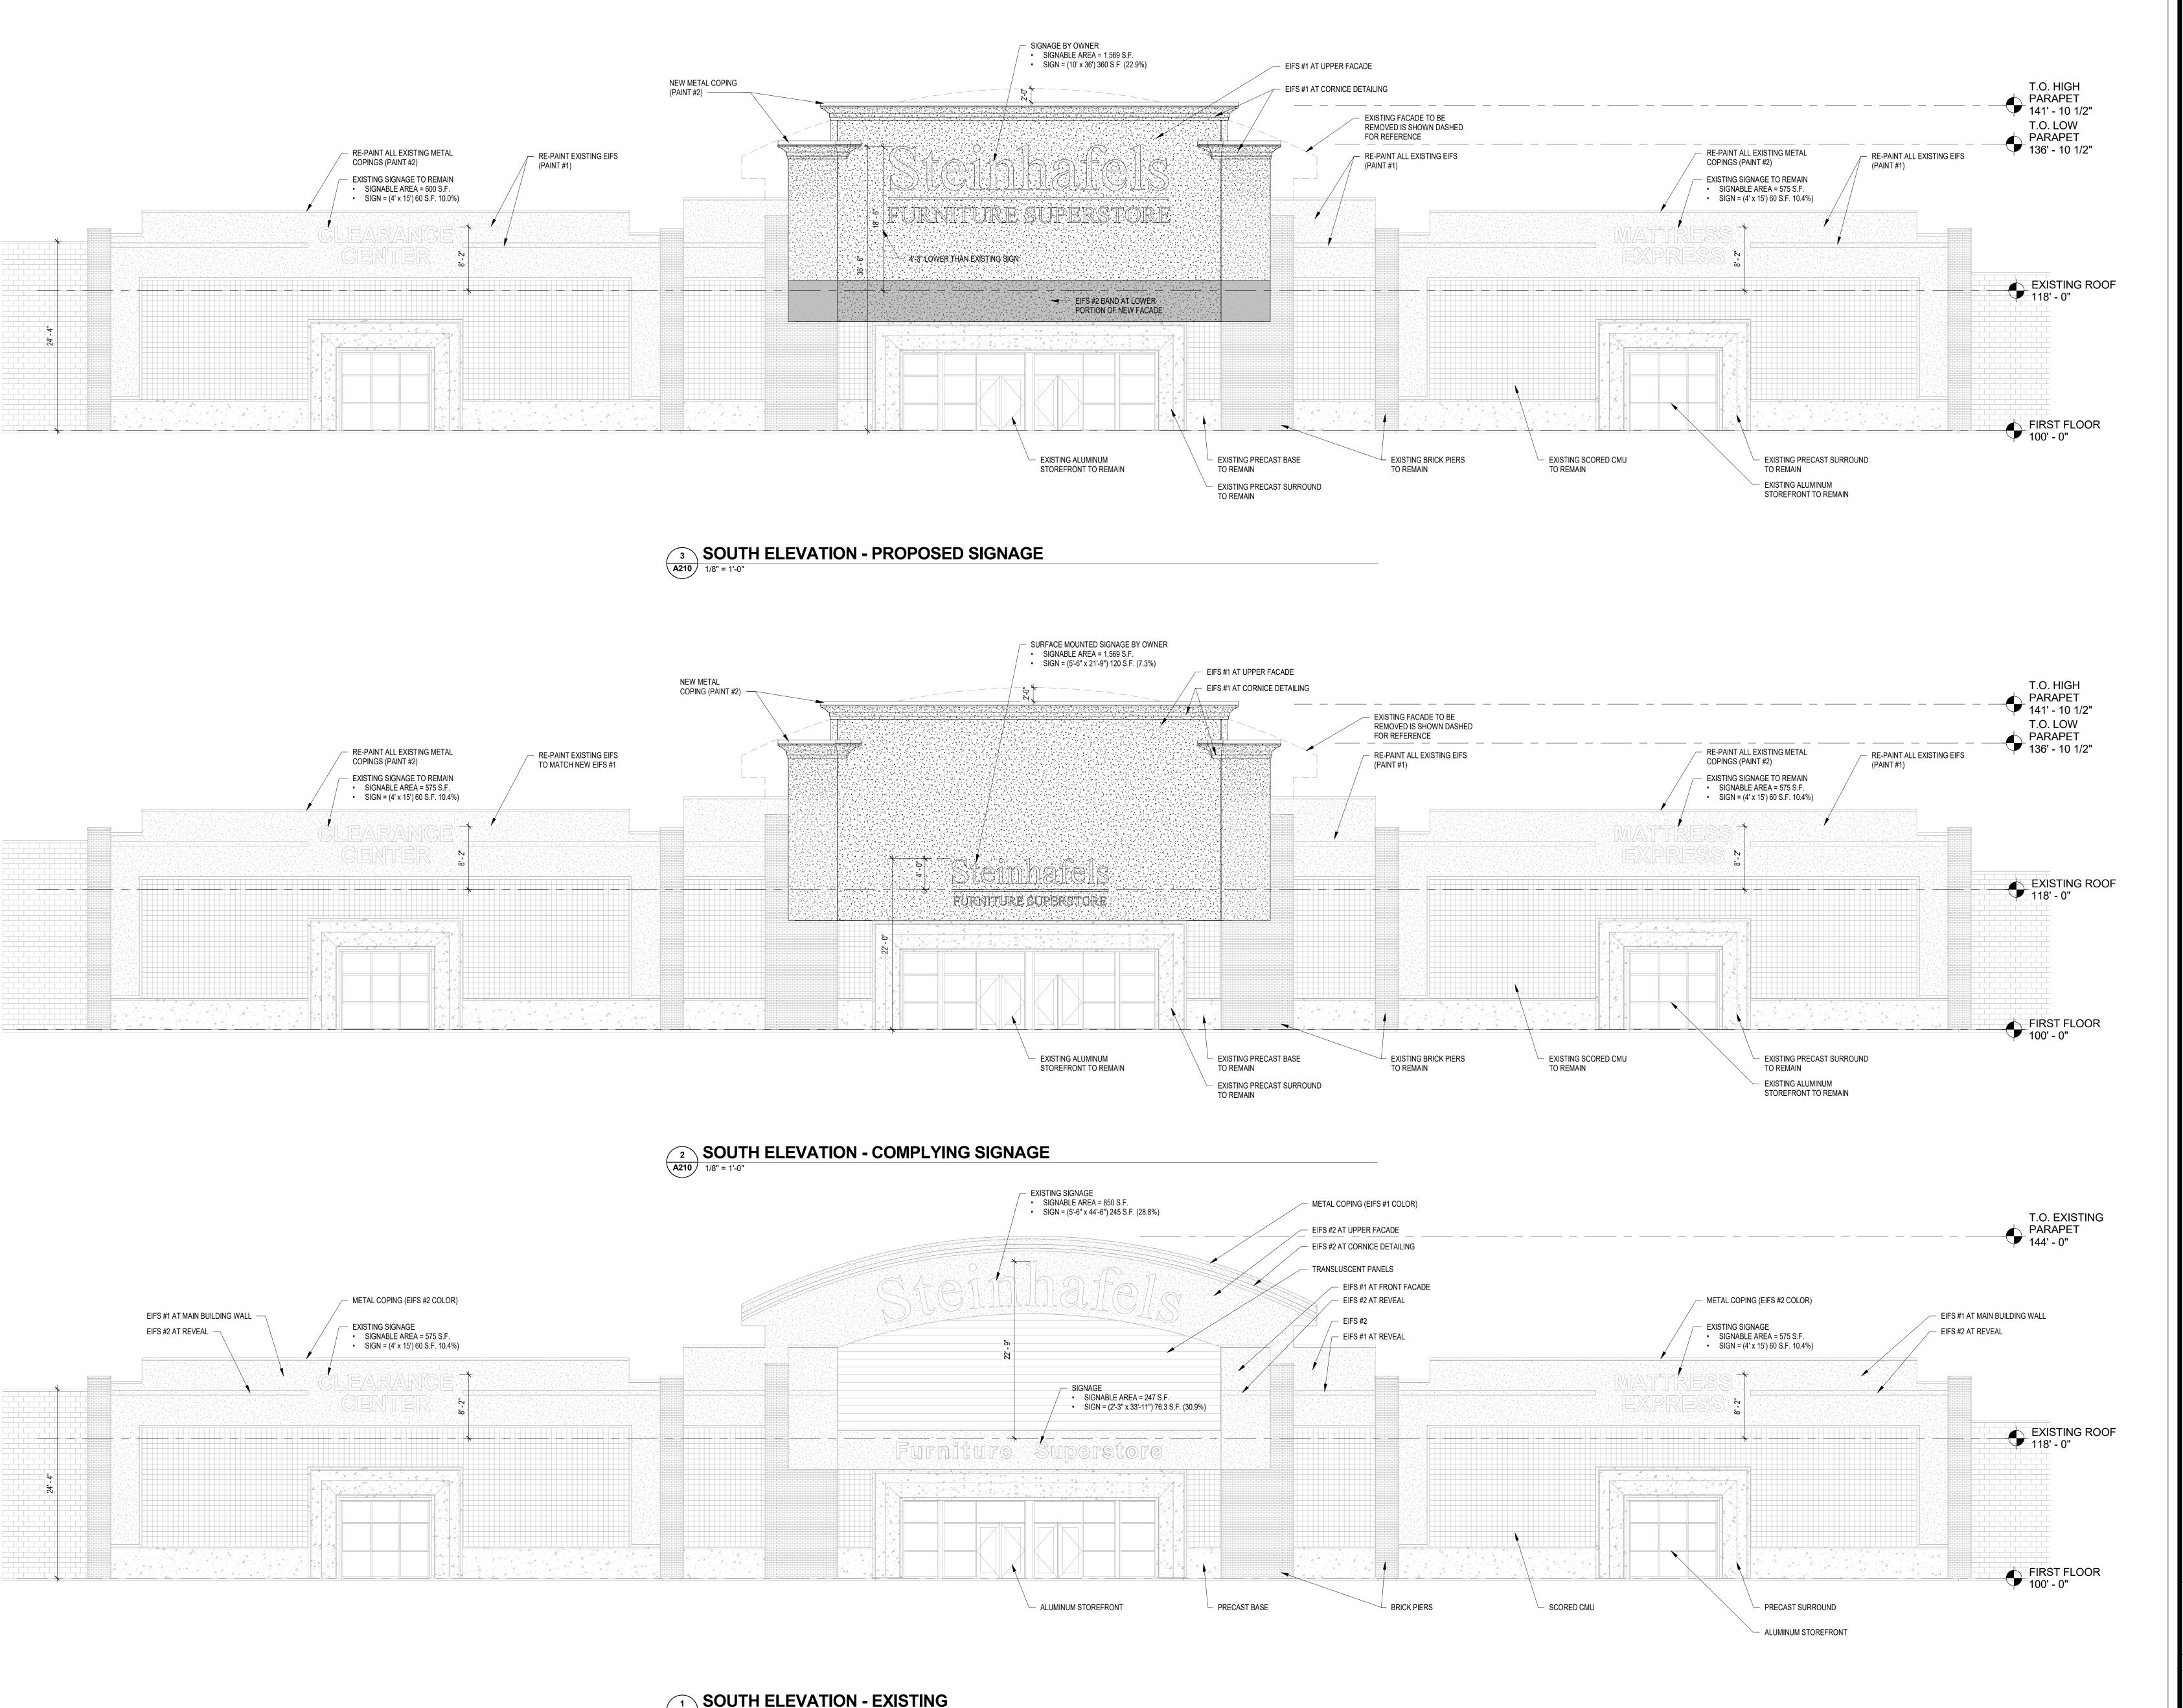

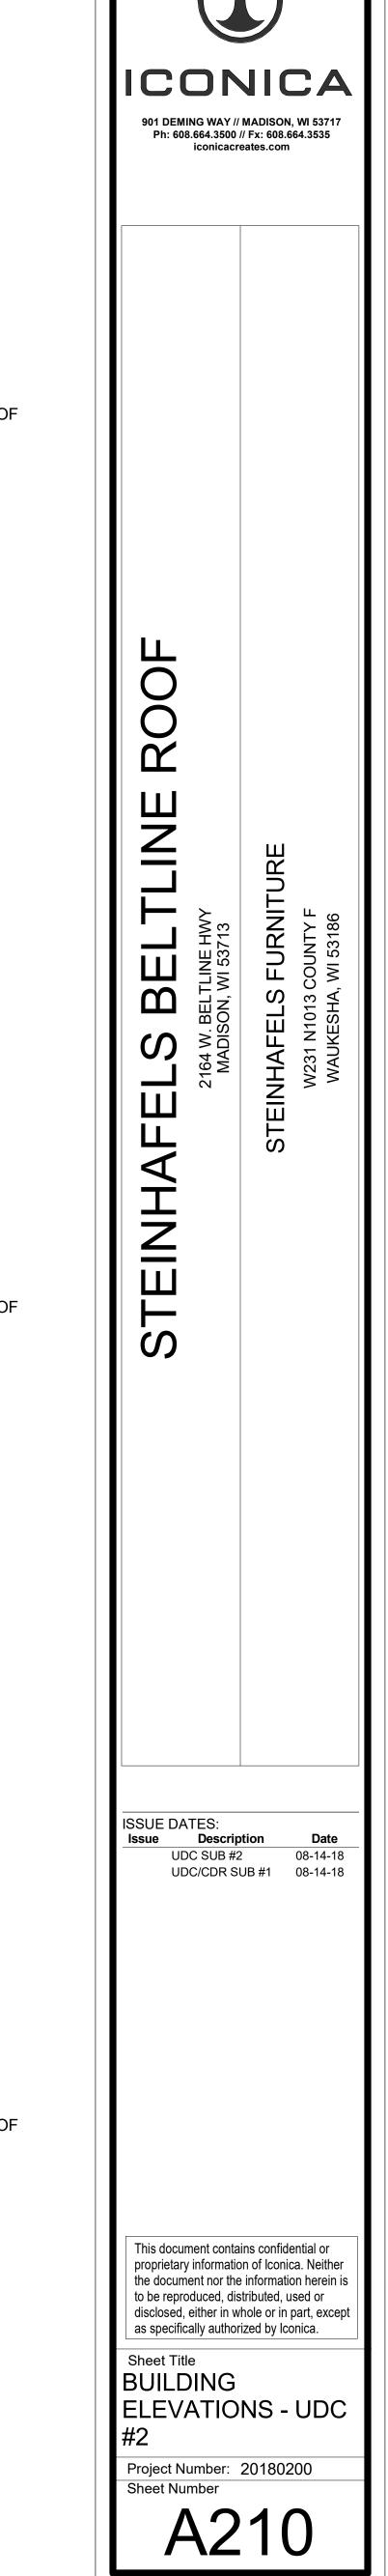

901 DEMING WAY // MADISON, WI 53717 Ph: 608.664.3500 // Fx: 608.664.3535 iconicacreates.com ISSUE DATES:
Issue Desc Description 08-14-18 UDC SUB #2 UDC/CDR SUB #1 08-14-18 This document contains confidential or proprietary information of Iconica. Neither the document nor the information herein is to be reproduced, distributed, used or disclosed, either in whole or in part, except as specifically authorized by Iconica. Sheet Title BUILDING **ELEVATIONS -**DEMO Project Number: 20180200 Sheet Number

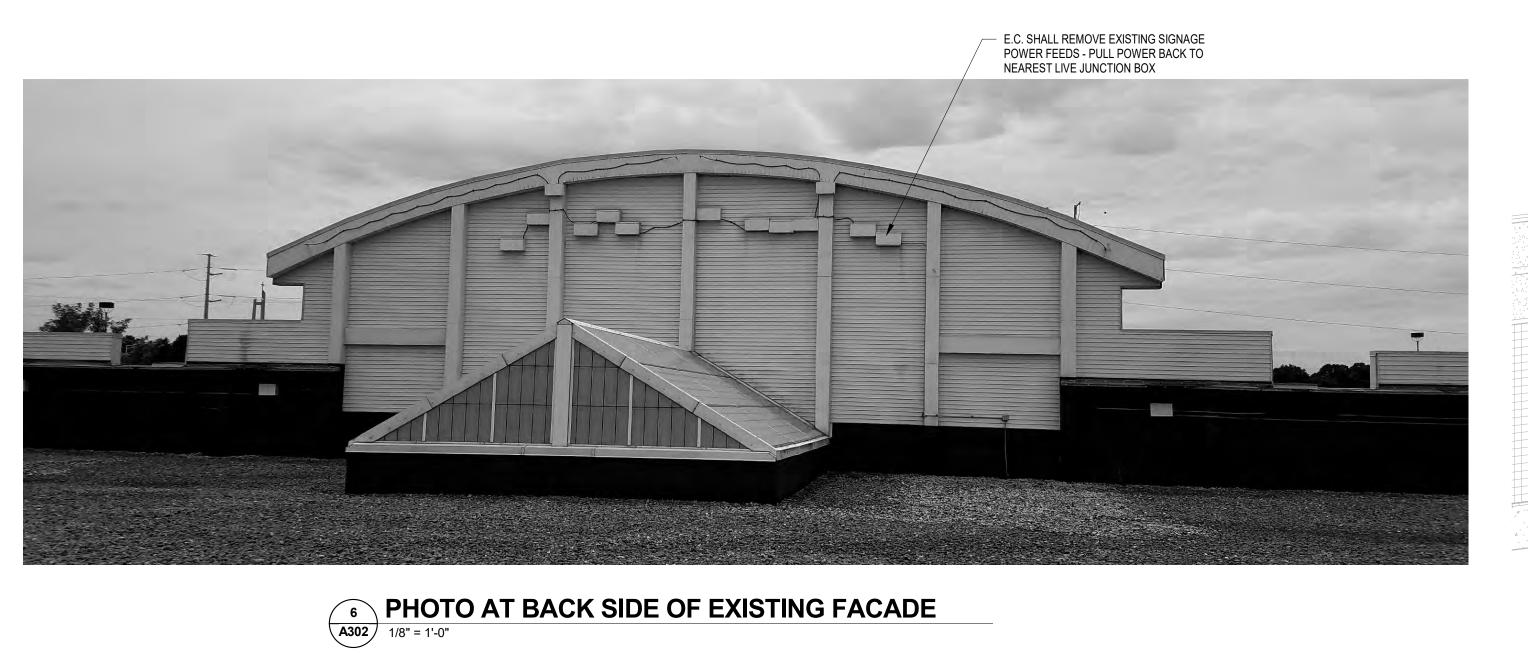




EXTERIOR MATERIALS KEY								
	EIFS #1 PAINT #1	COLOR: SW6105 DIVINE WHITE TEXTURE: FINE SAND FINISH	NEW EIFS, AND RE-PAINT EXISTING EIFS AND EIFS REVEALS					
	EIFS #2 PAINT #2	COLOR: SW6107 NOMADIC DESERT TEXTURE: FINE SAND FINISH	ACCENT BAND AT LOWER PORTION OF NEW FACADE					
	PRECAST CONCRETE (EXISTING)	COLOR: EDWARDS TAN DC-25 TEXTURE: SMOOTH	EXISTING AT BASE, MAIN ENTR' SURROUND, BAY WINDOW SURROUNDS, PIER CAPS					
	BRICK (EXISTING)	COLOR: GLEN GARY, OXFORD IRON SIZE: UTILITY	EXISTING TO REMAIN AT PIERS					
	SCORED C.M.U. (EXISTING)	COLOR: GLEN GARY, OXFORD IRON SIZE: 8" x 8" SCORE	EXISTING TO REMAIN AT BUILDING WALLS					
	METAL COPINGS (EXISTING)	COLOR: PREVIOUSLY PAINTED SW 6107 NOMADIC DESERT	REPAINT PAINT #2 - SW 6107 NOMADIC DESERT					
	METAL COPINGS (NEW)	COLOR: SW 6107 NOMADIC DESERT	PAINT GRIP METAL - PAINT IN SHOP					
	METAL SOFFIT (NEW)	COLOR: ALMOND	VENTED ALUMINUM SOFFIT PANELS					
	ALUMINUM STOREFRONT (EXISTING)	COLOR: MEDIUM BRONZE	EXISTING TO REMAIN					

EXTERIOR MATERIAL NOTES:

1. SEALANT COLOR TO MATCH DARKER OF TWO ADJACENT MATERIALS

2. AESTHETIC "V" JOINT IS REQUIRED IN EIFS AT COLOR/TEXTURE TRANSITIONS

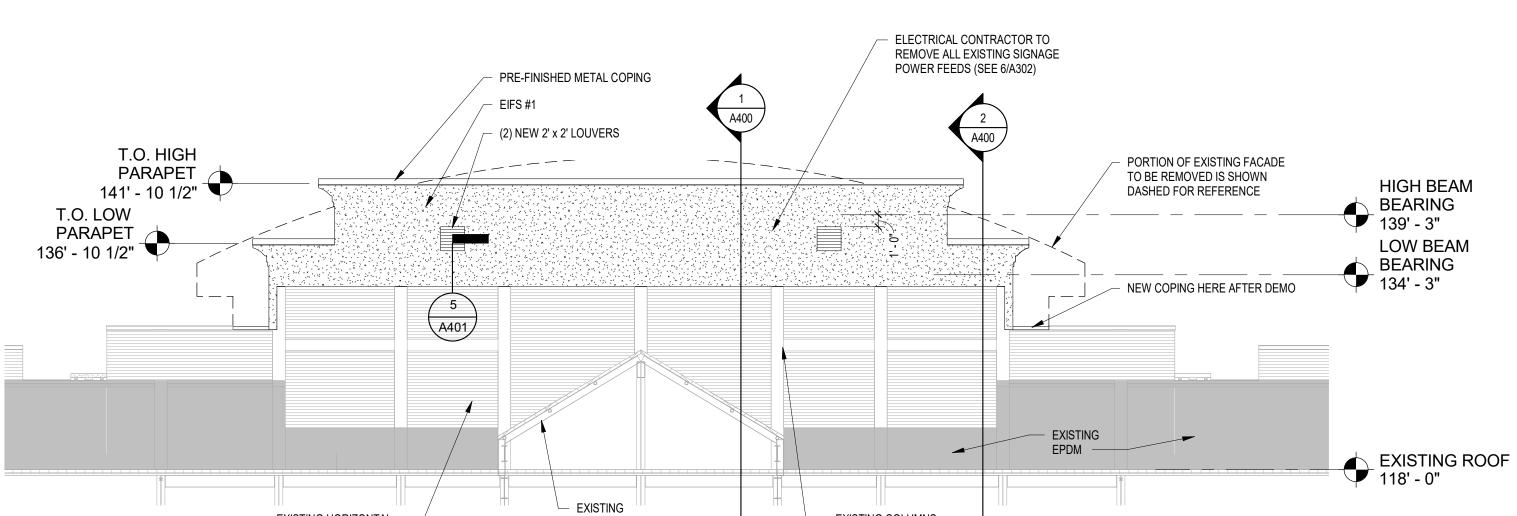


EXISTING COLUMNS


ARE BOXED OUT W/
METAL FLASHING




SKYLIGHT

EXISTING HORIZONTAL ALUMINUM SIDING

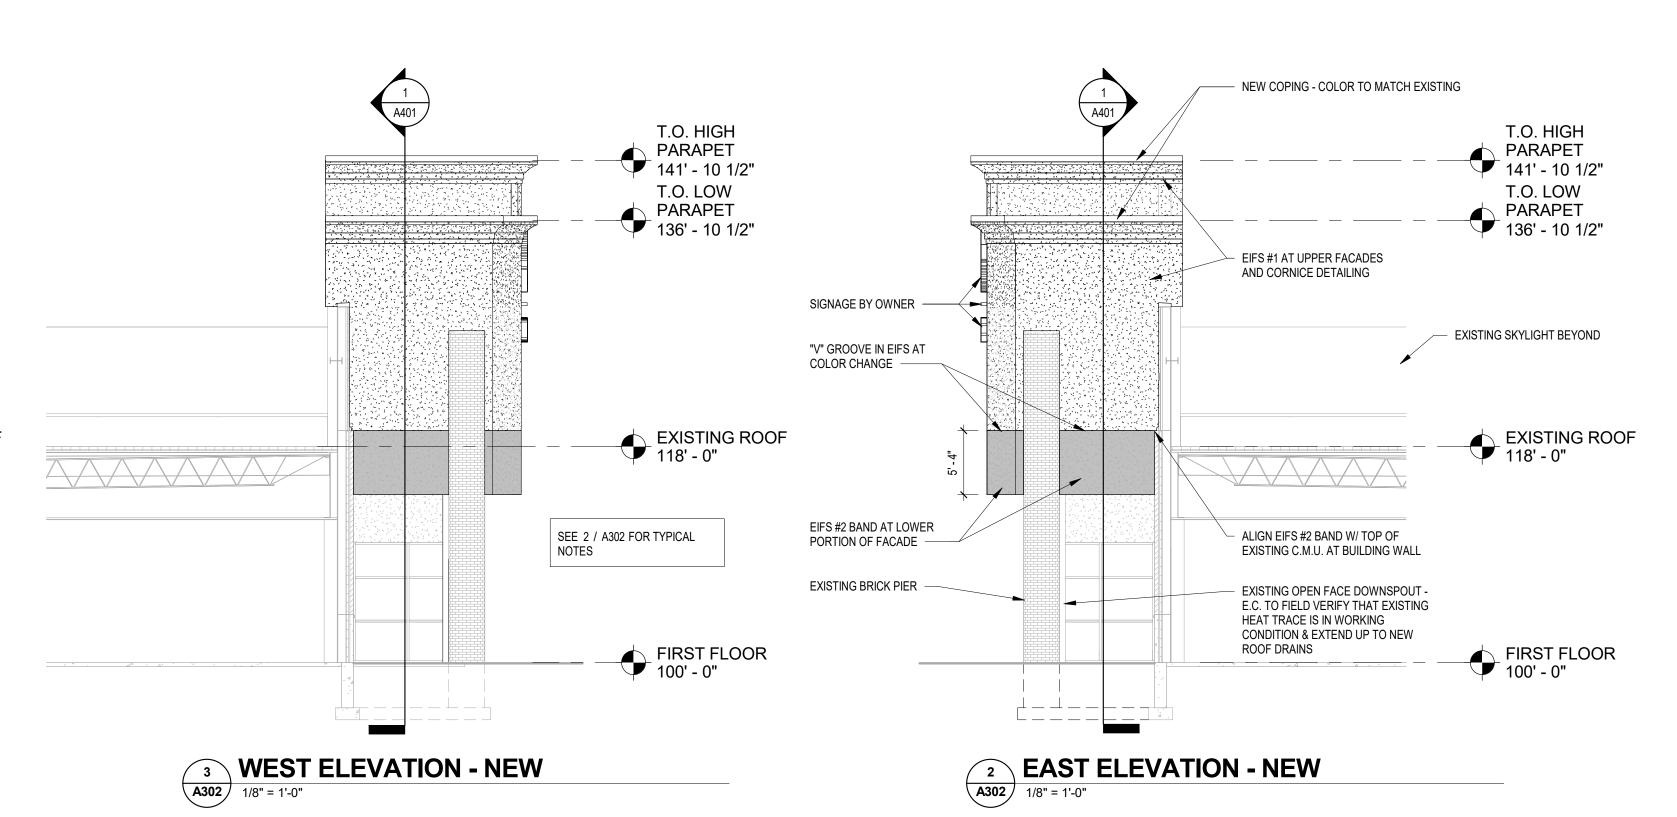


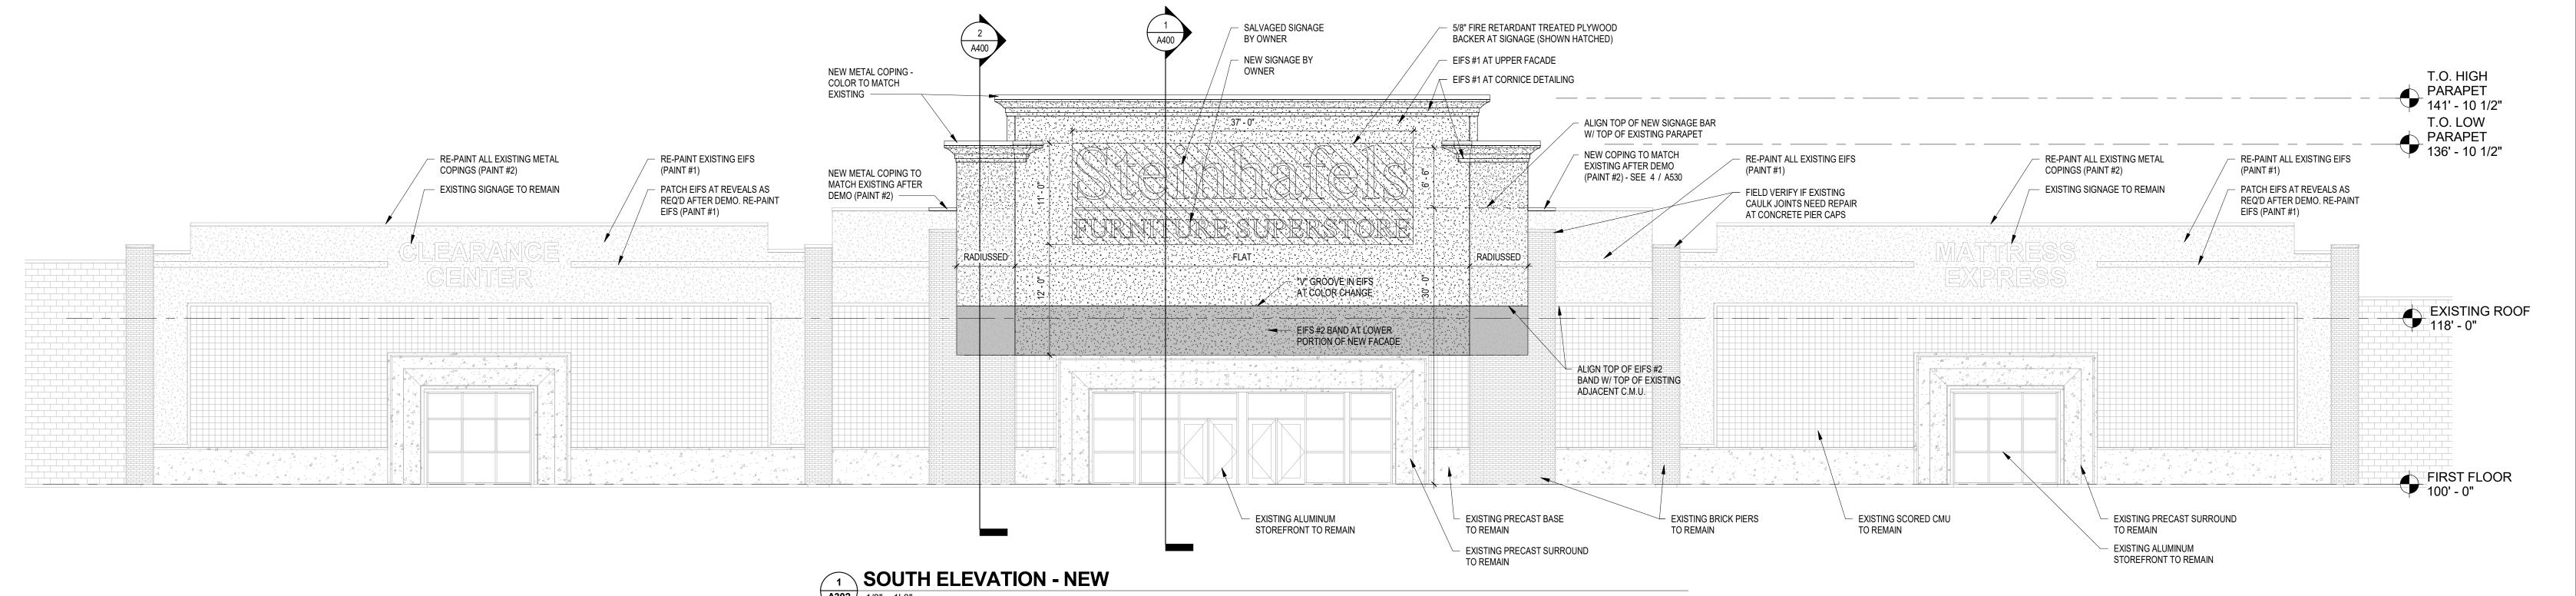


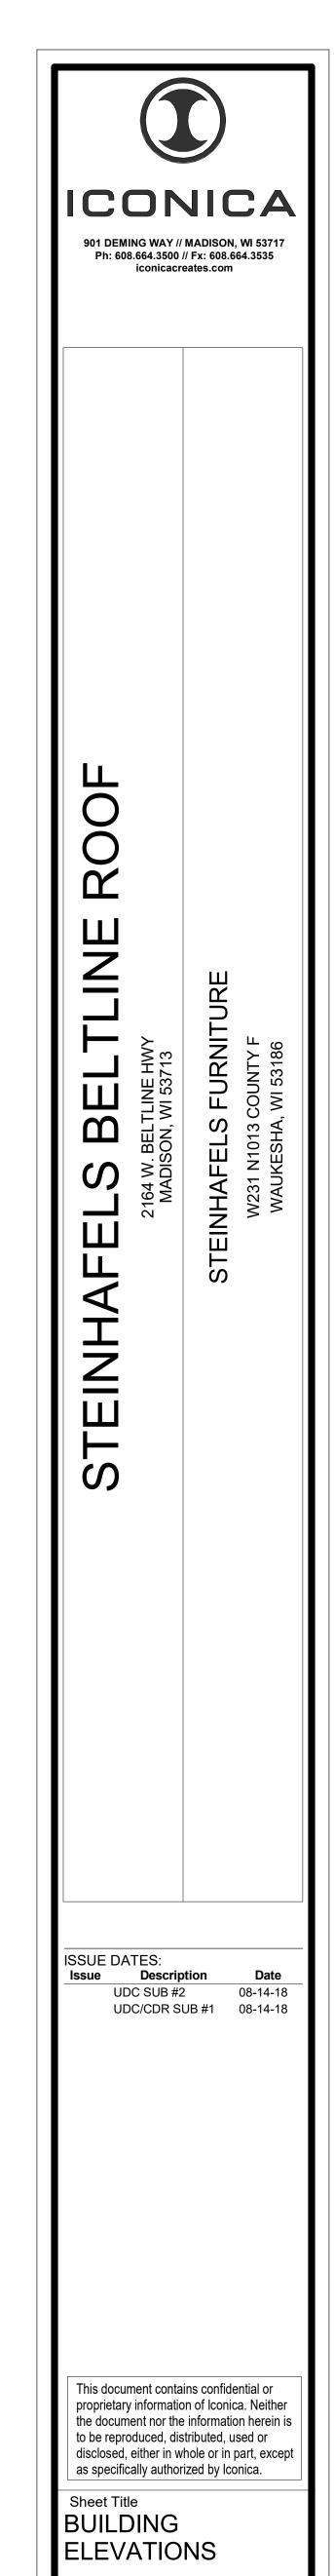



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Sheet Number


A302

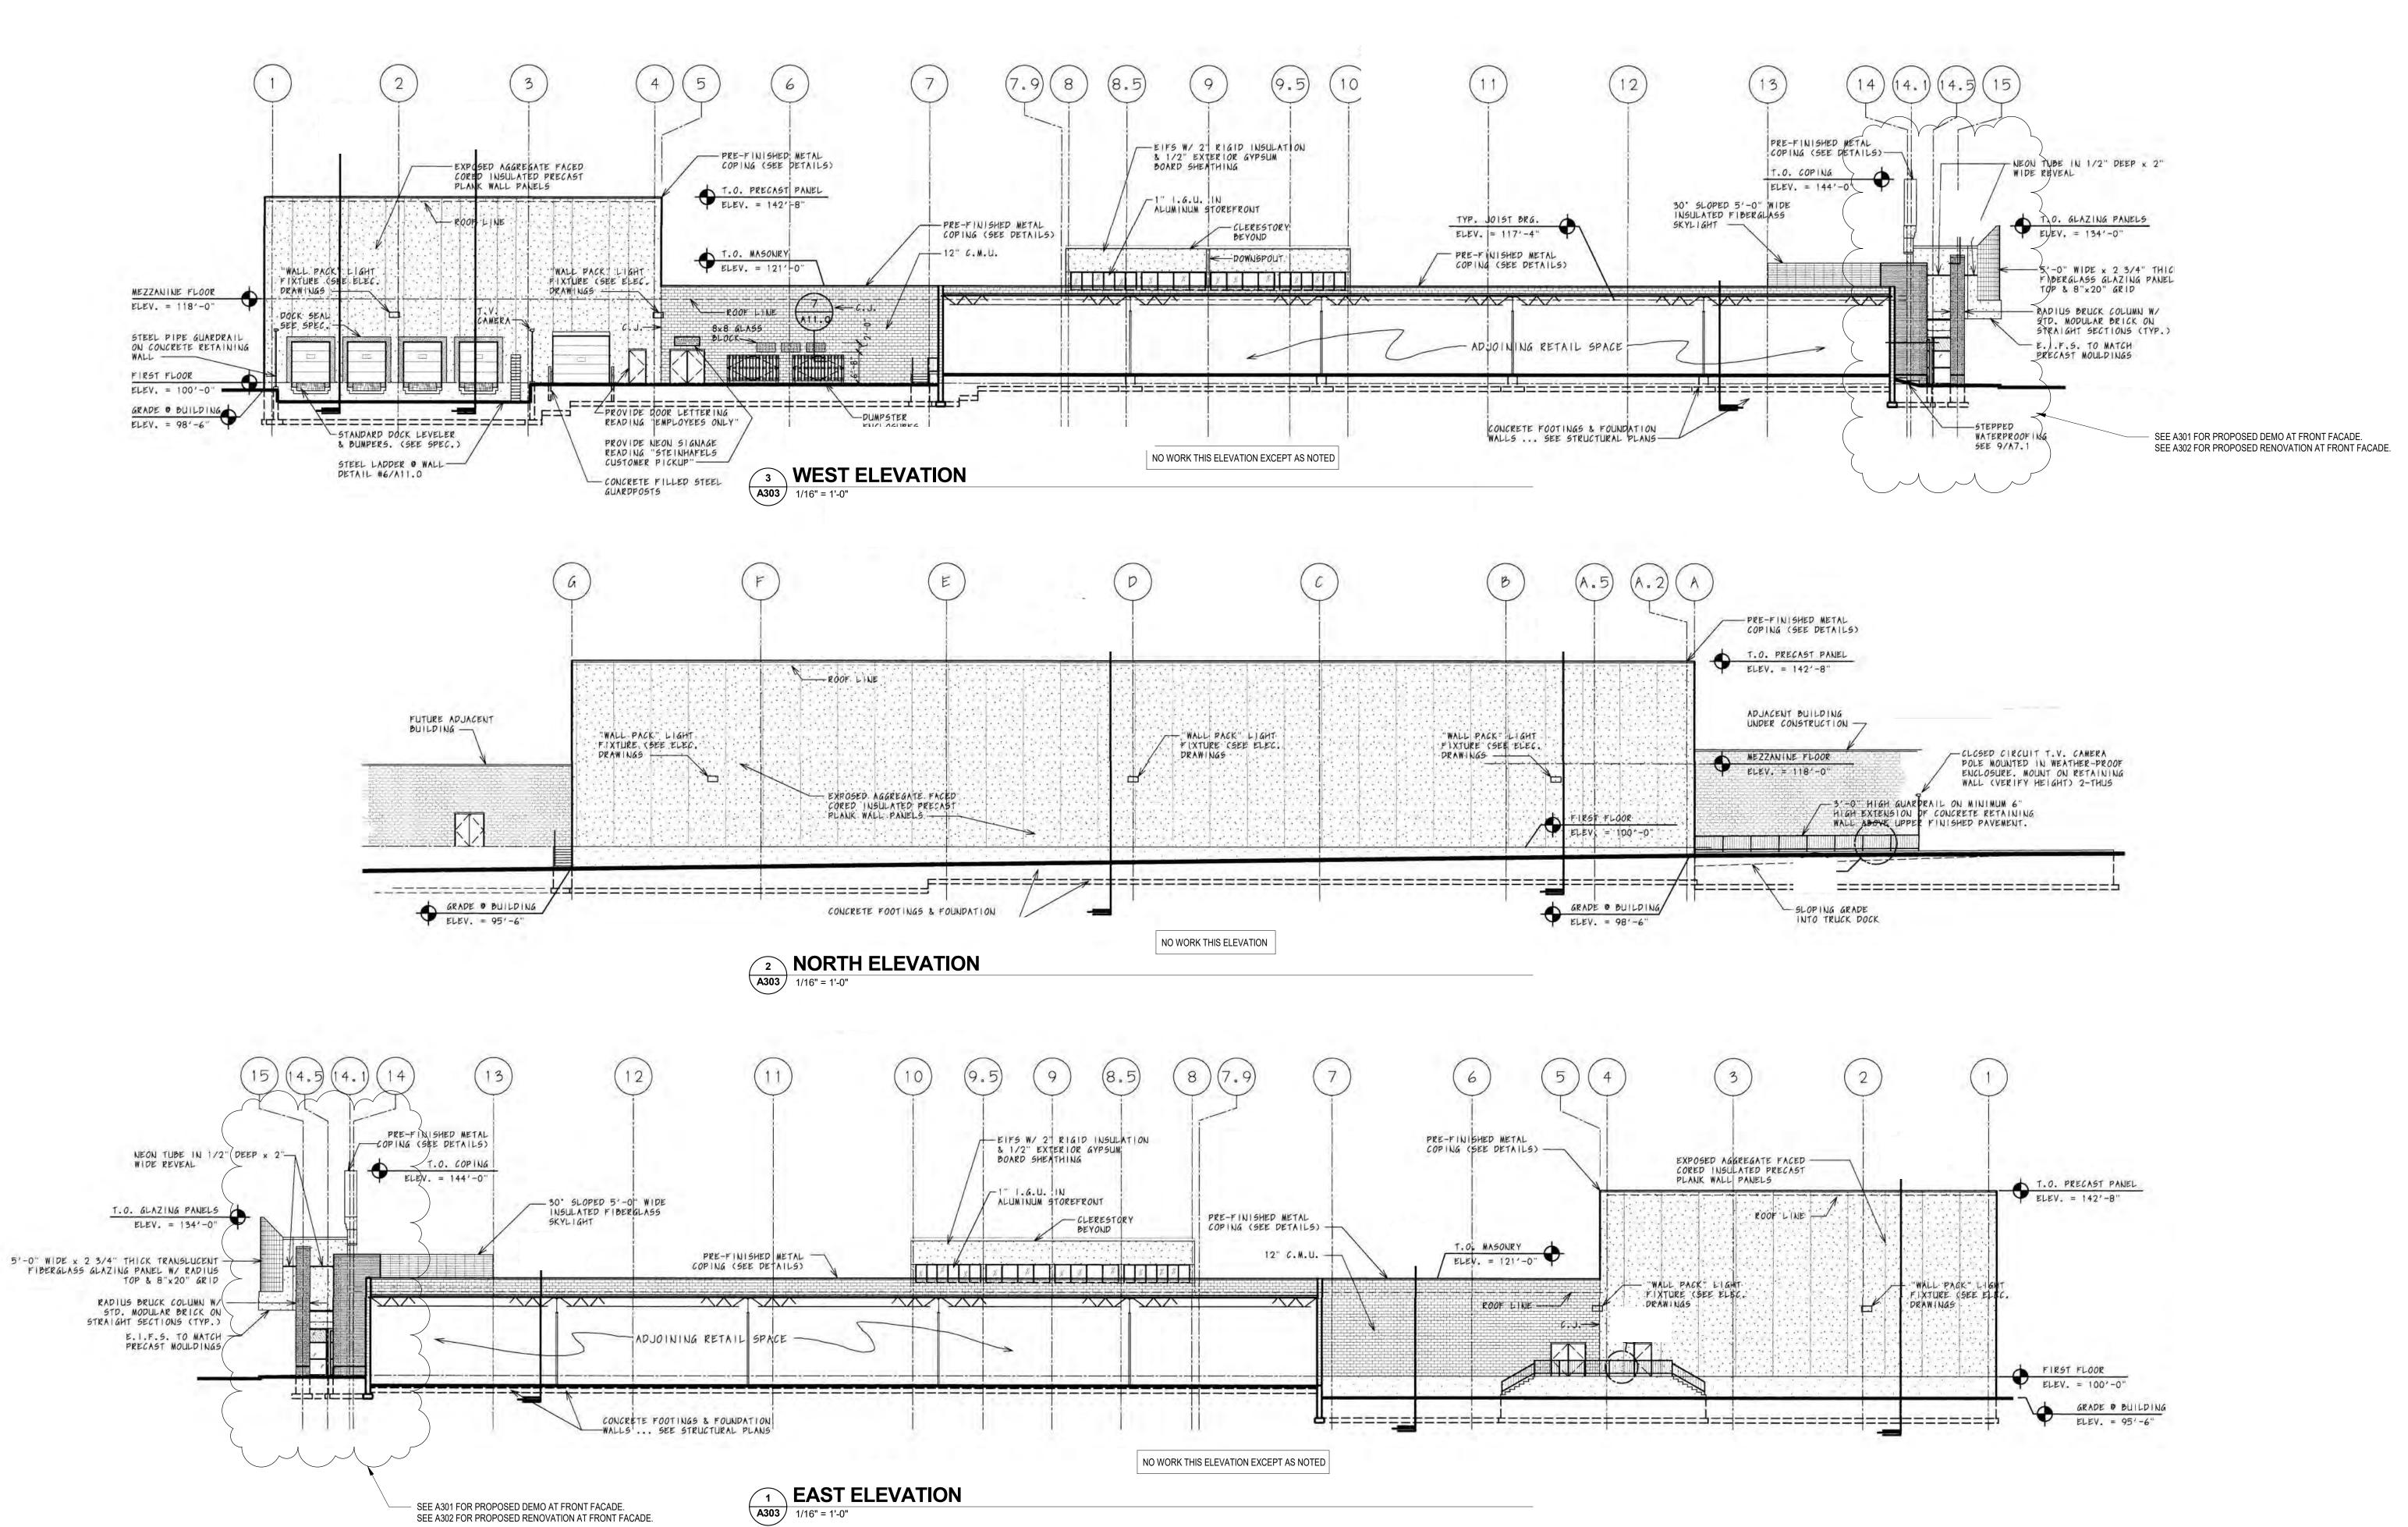


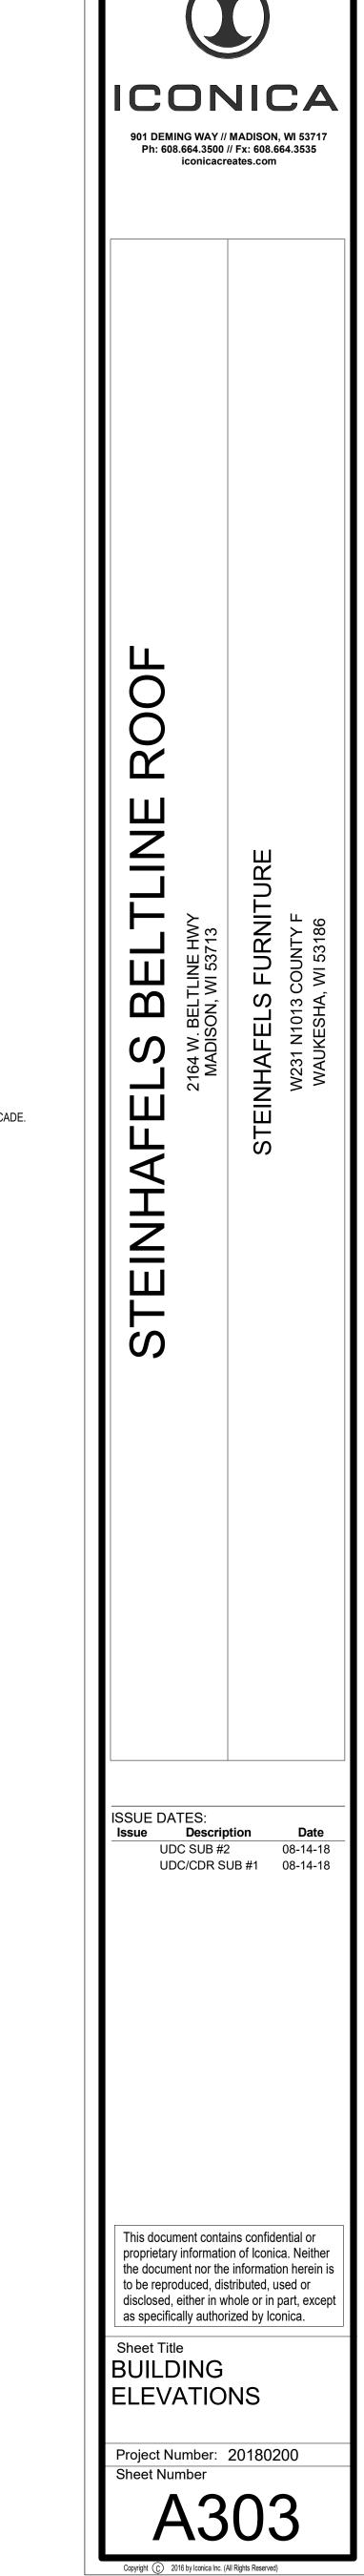

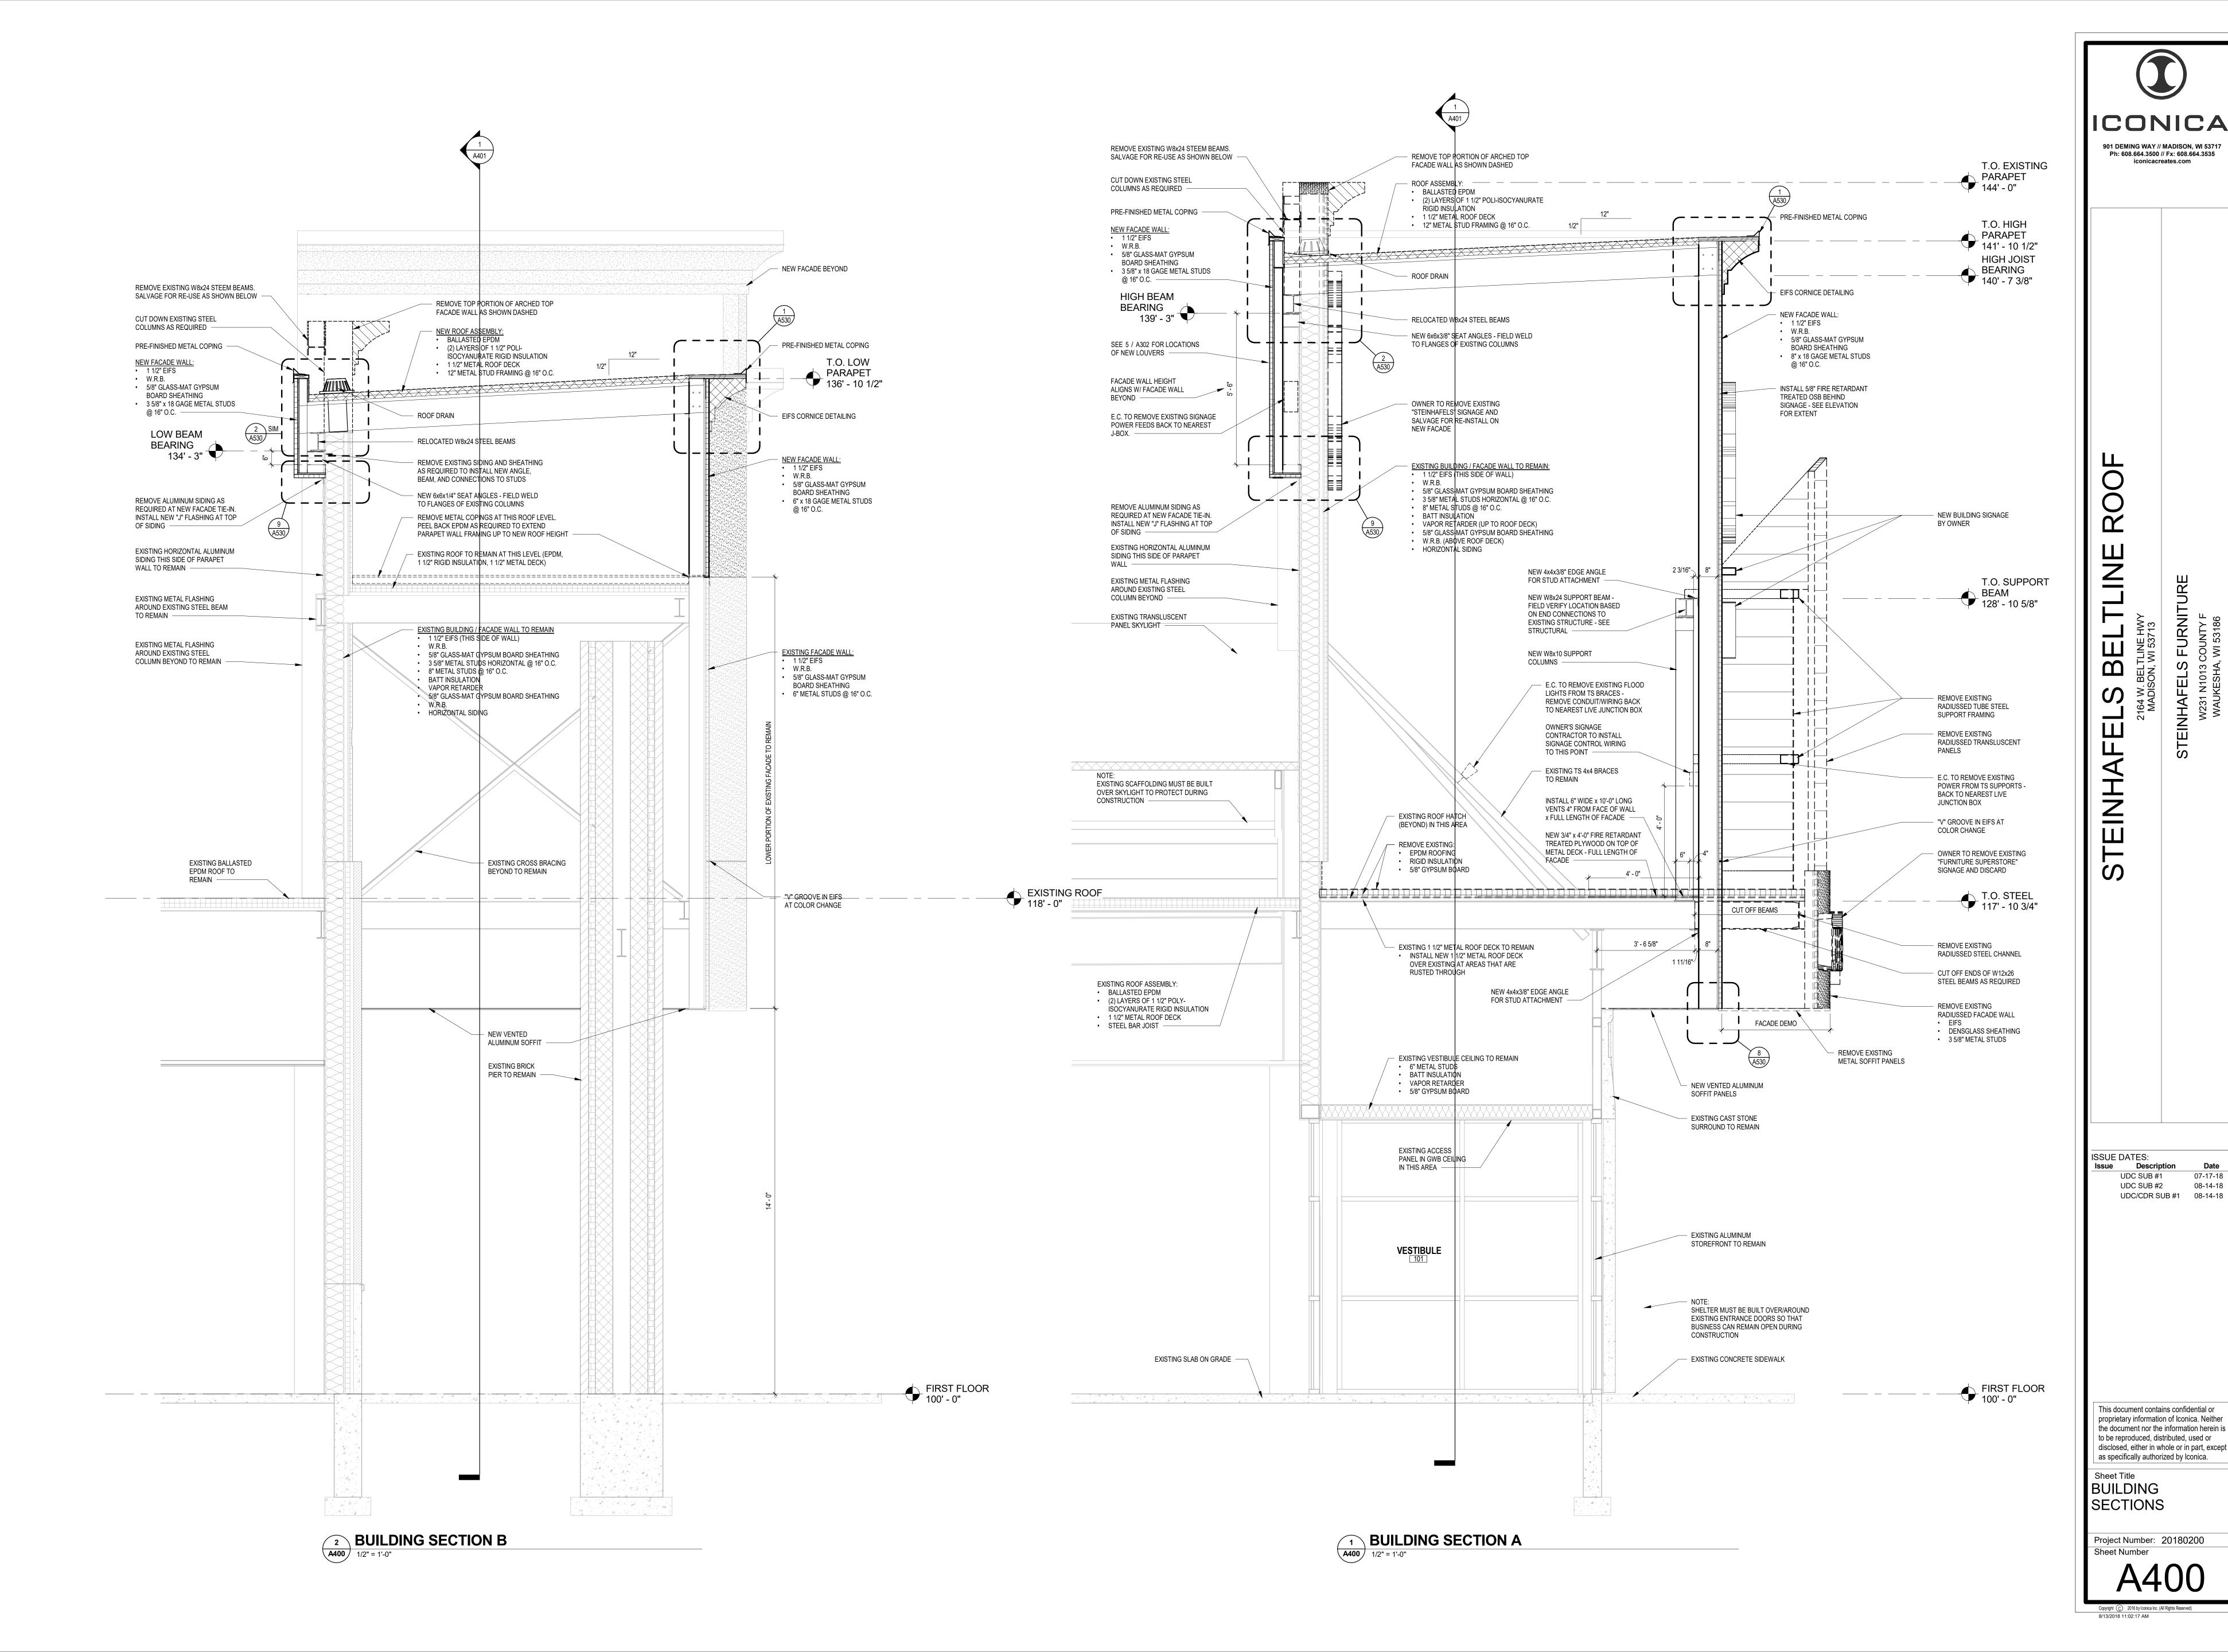

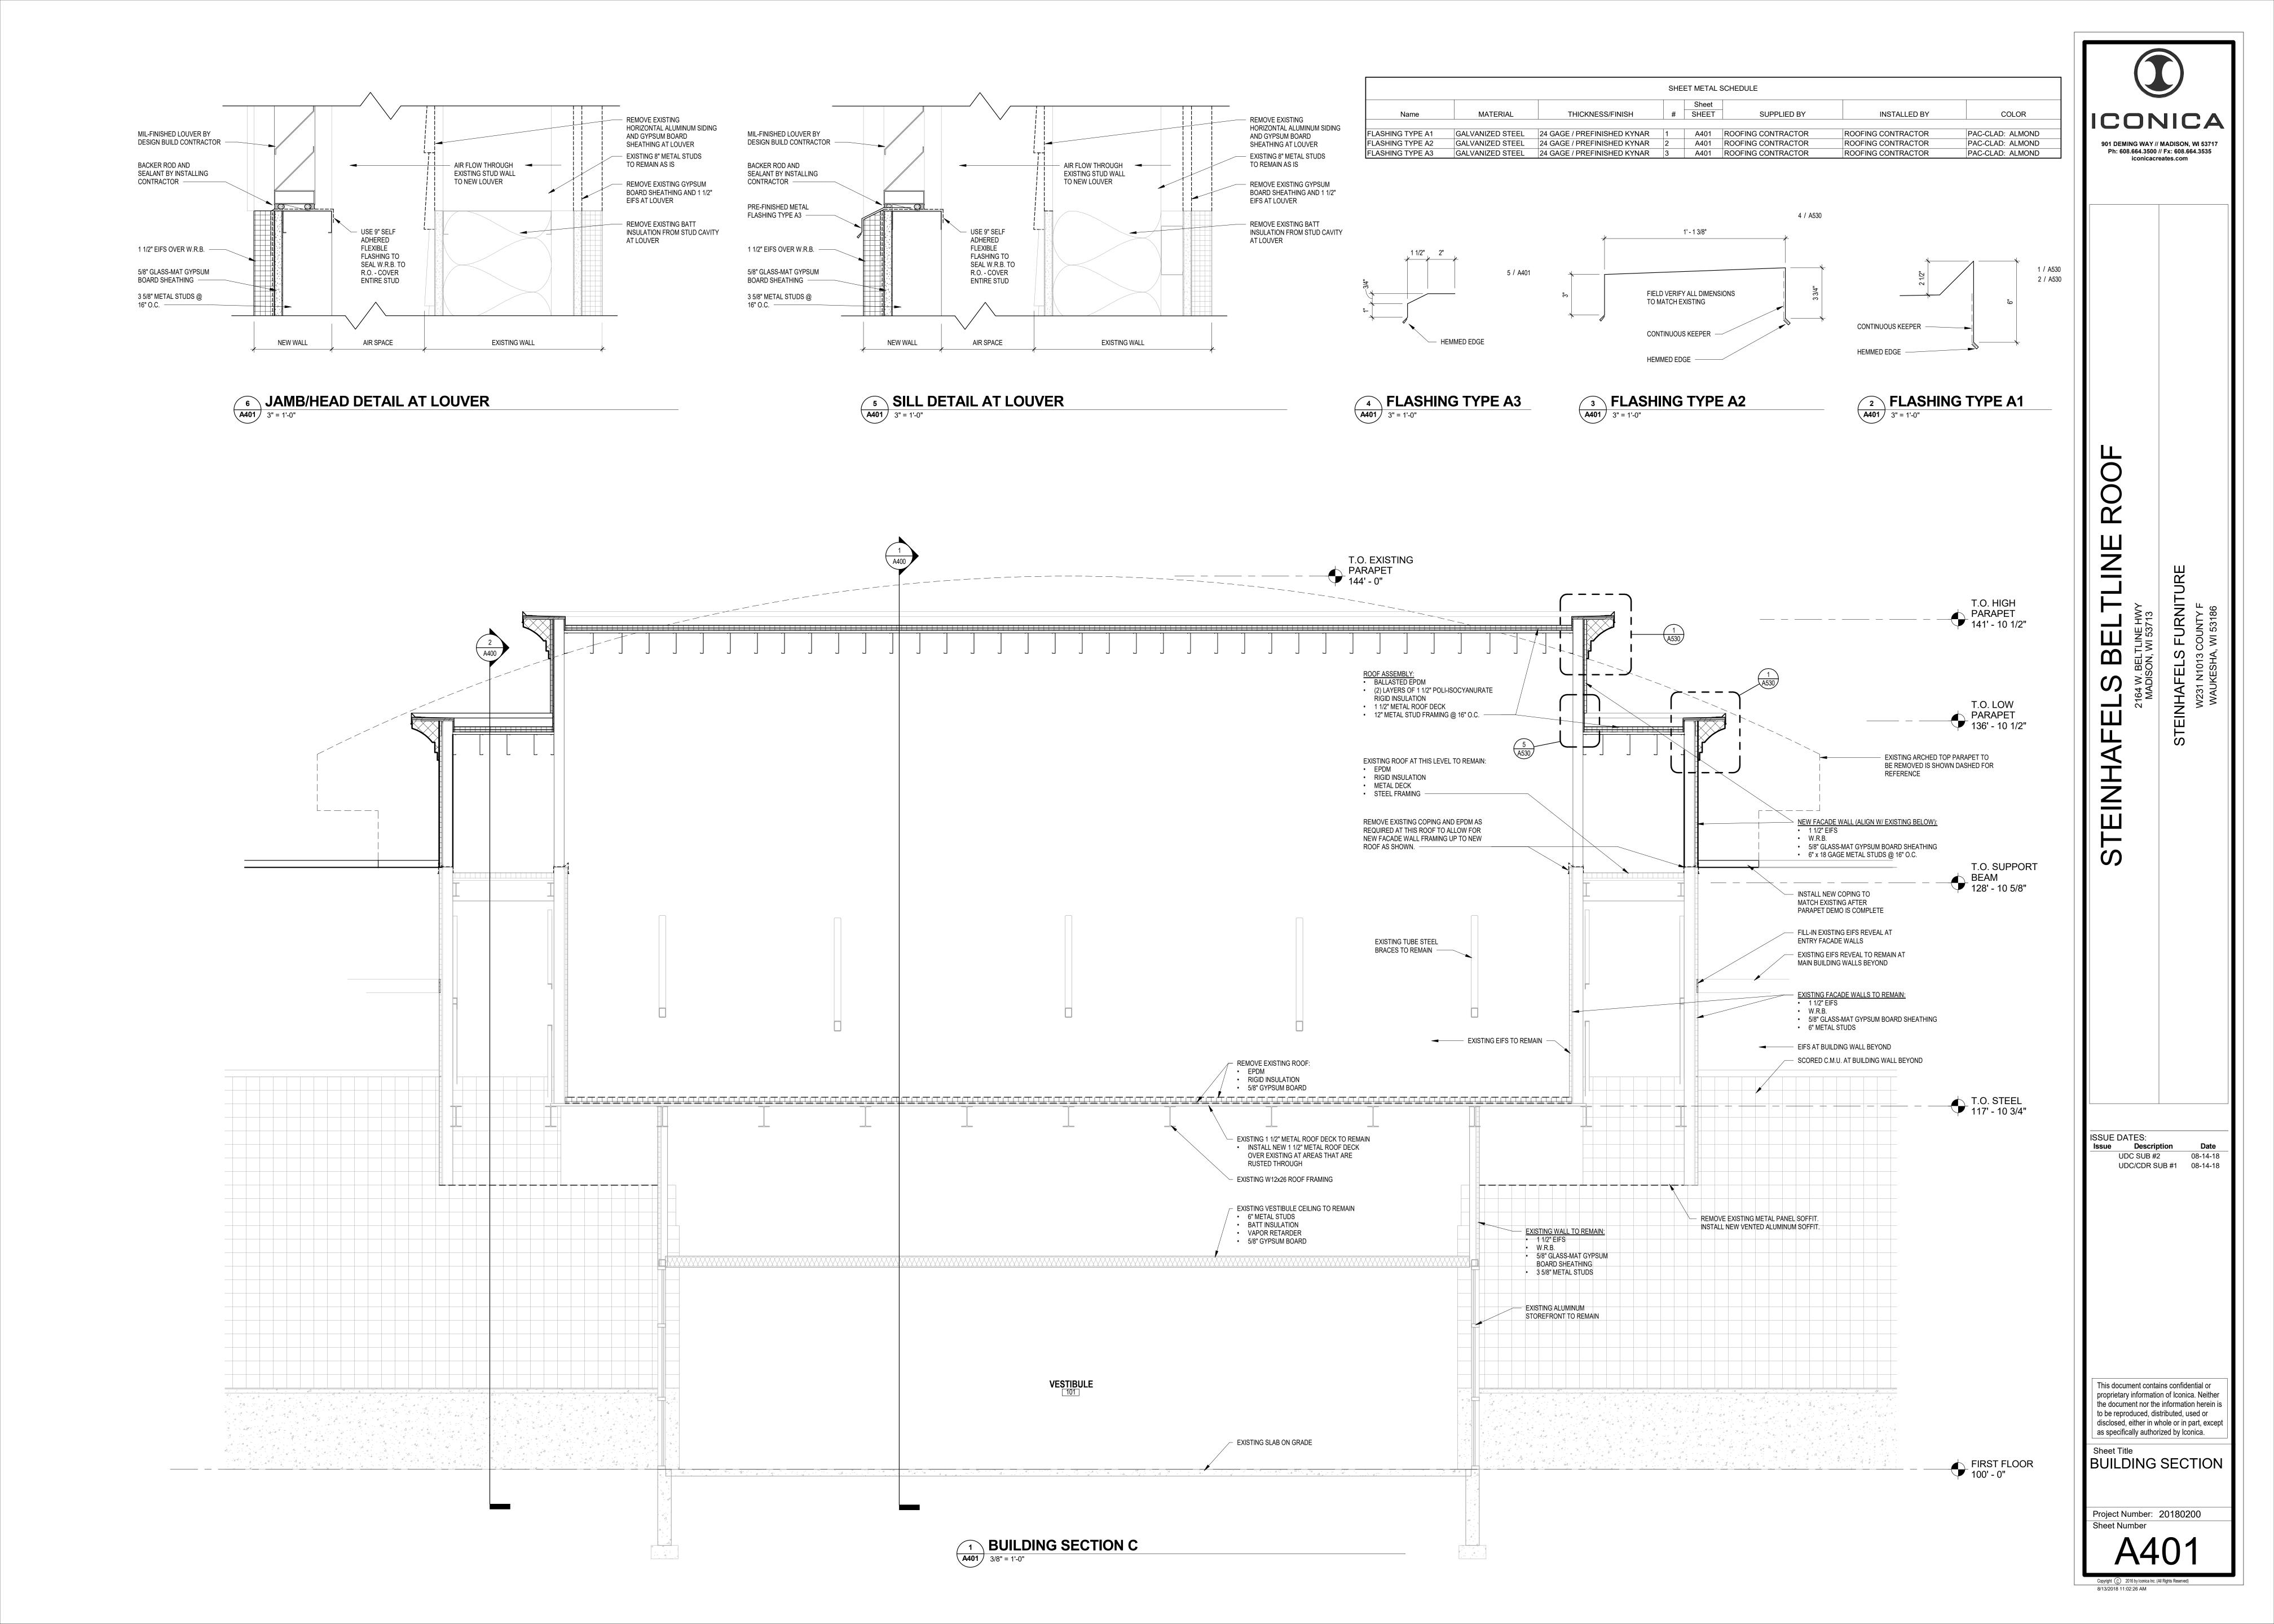

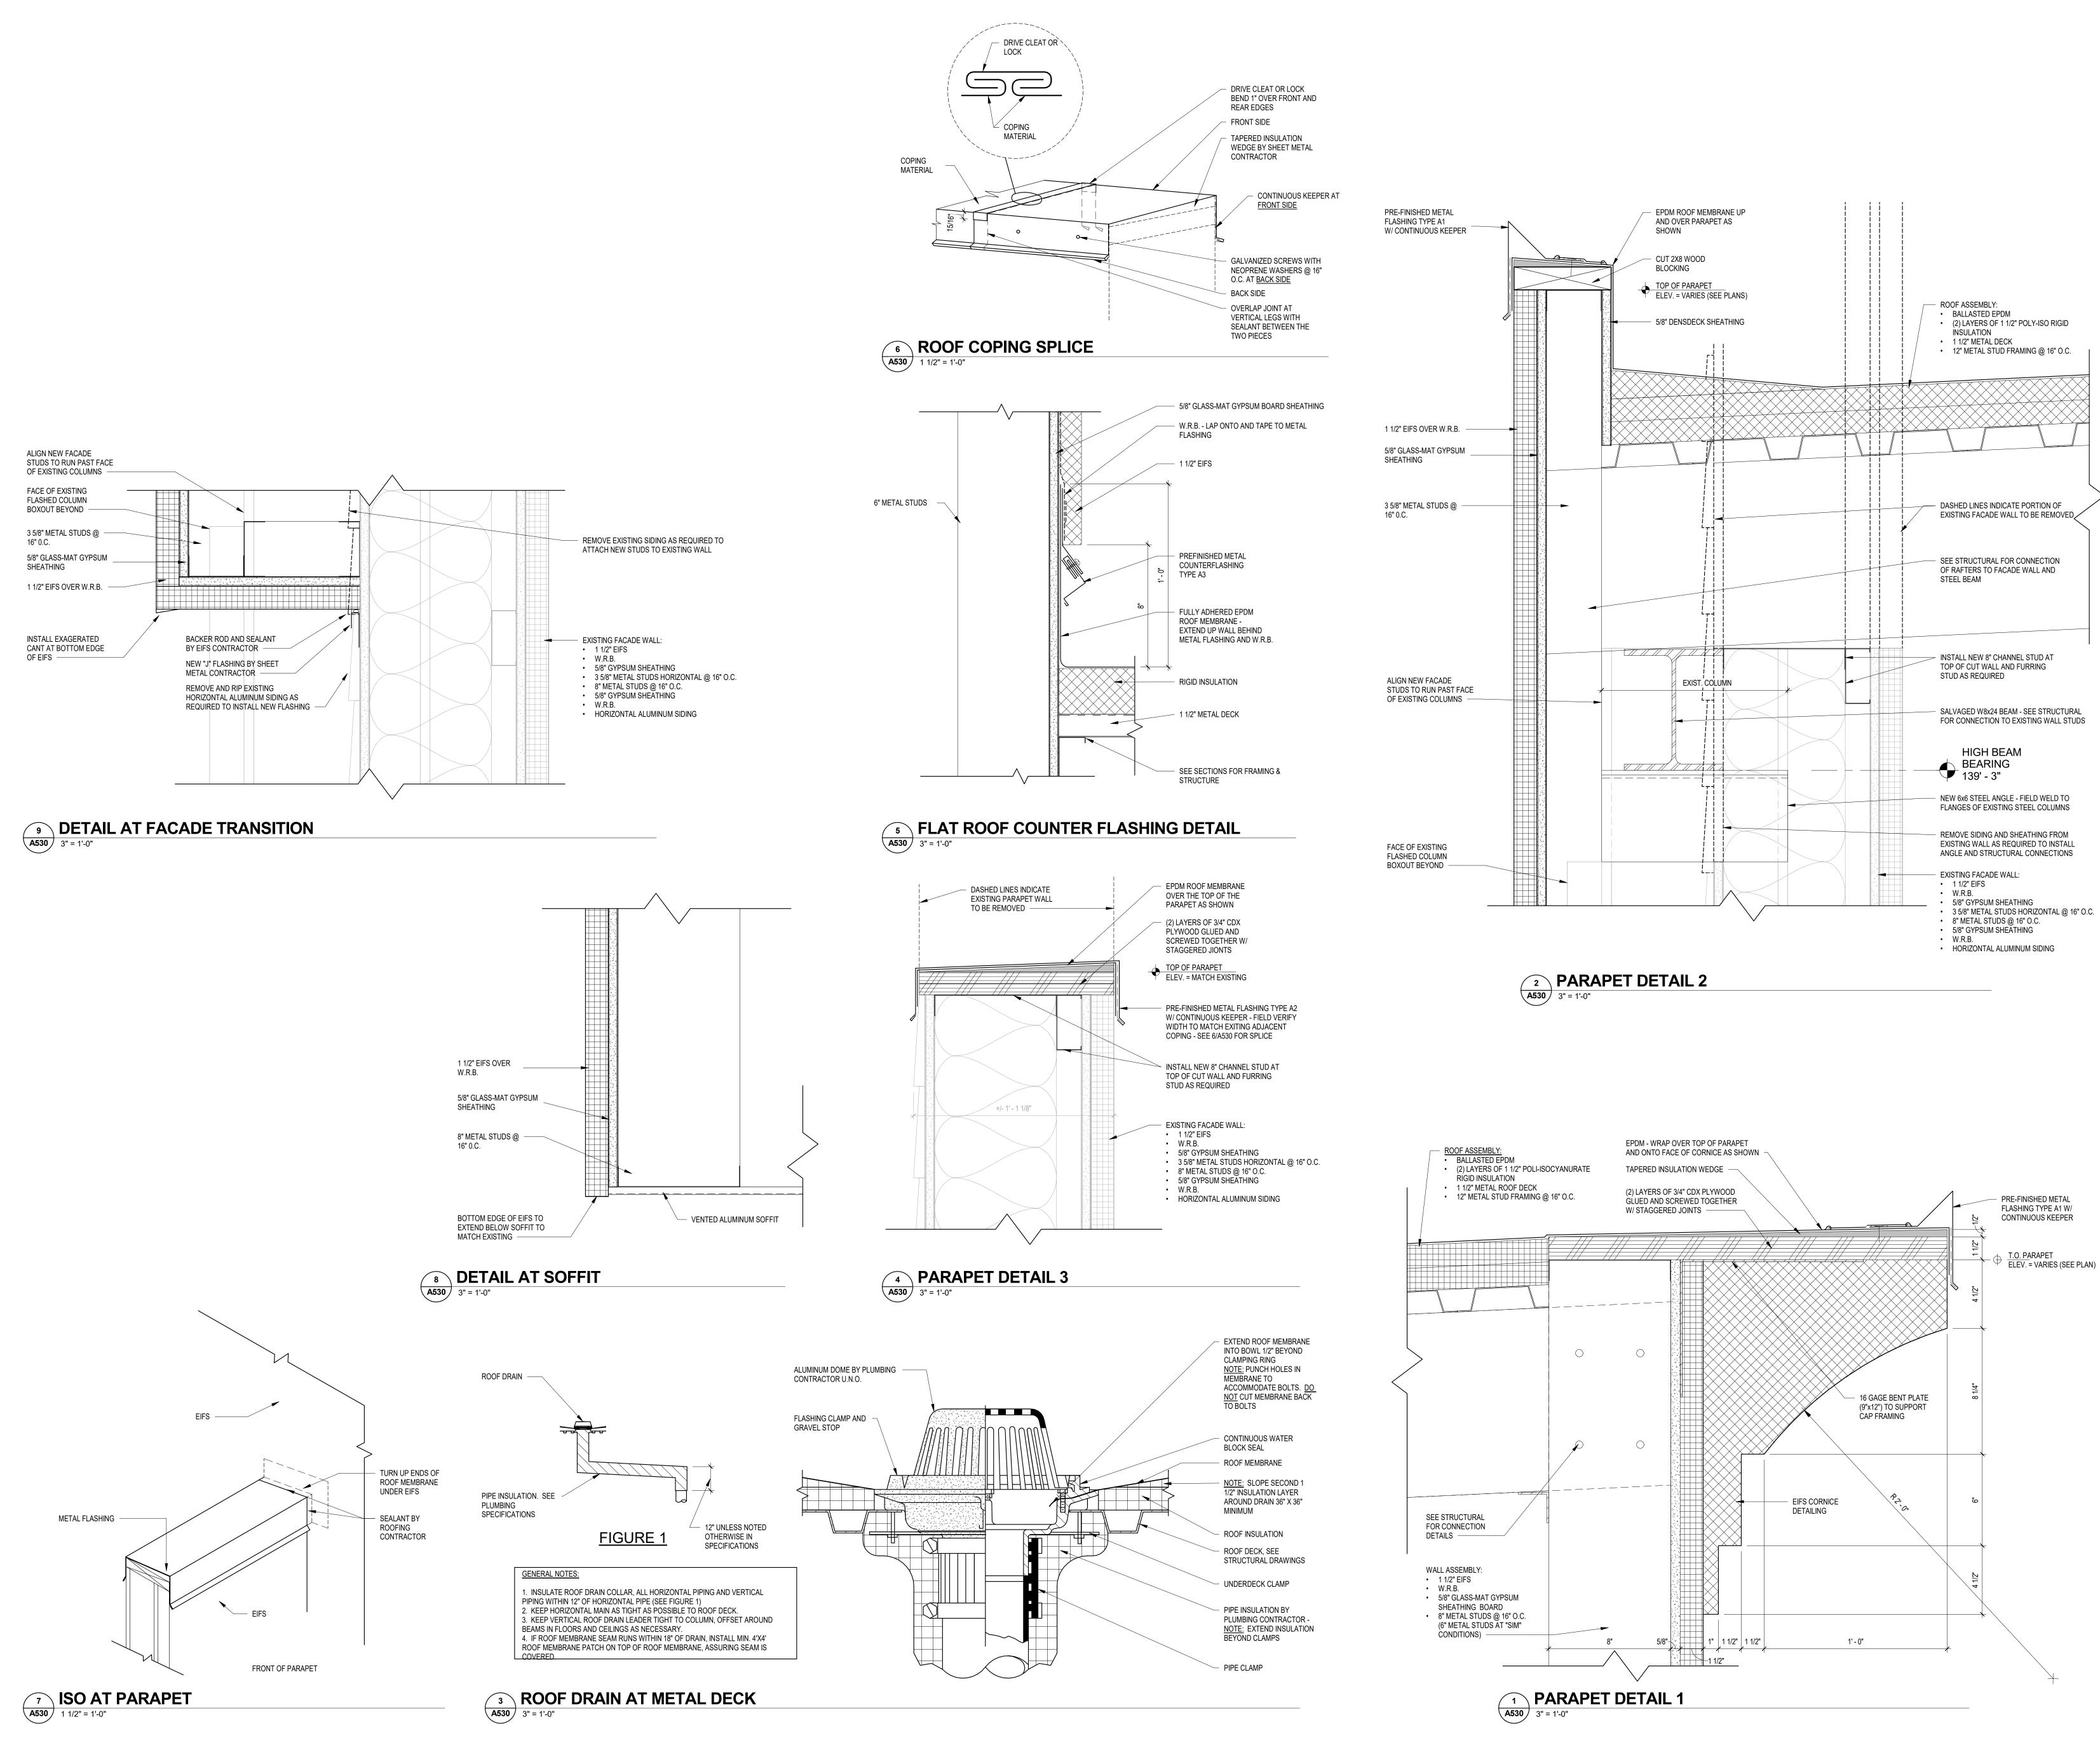

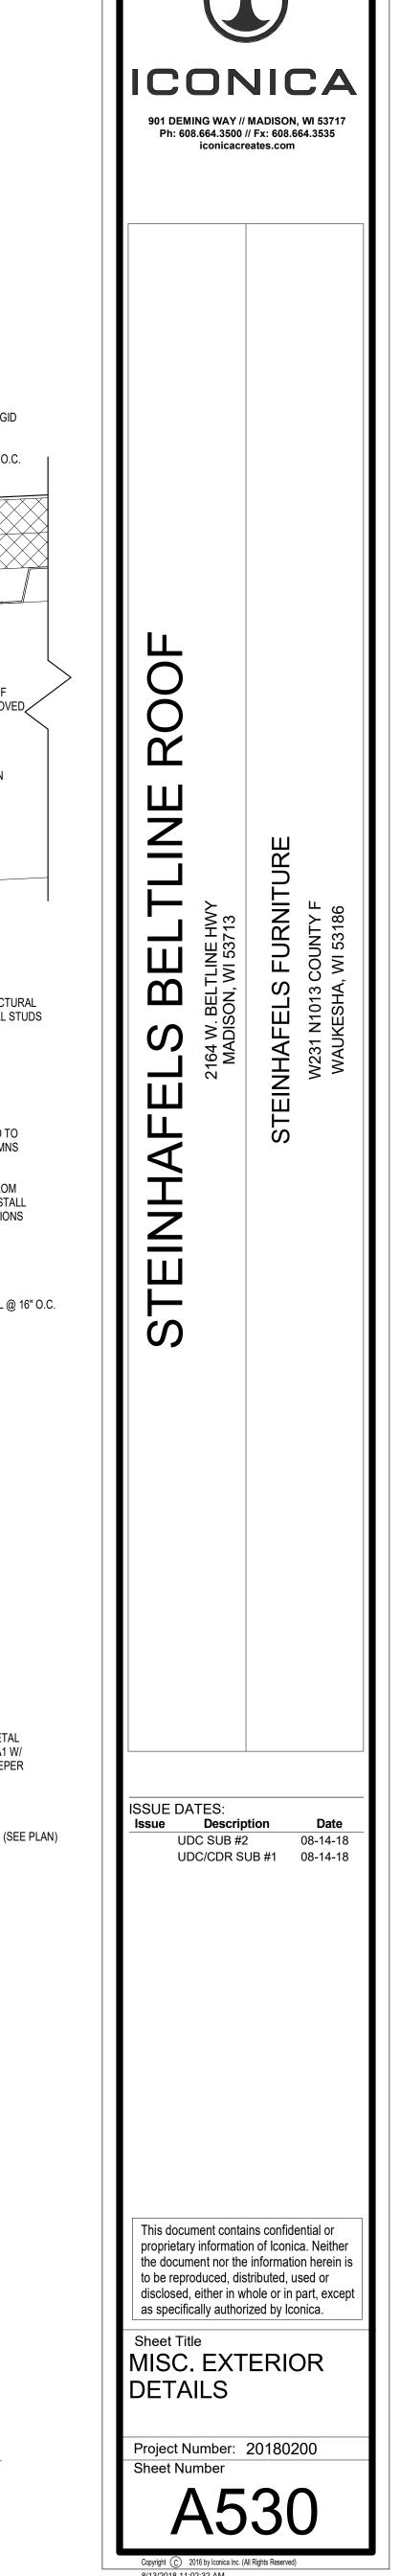

BUILDING EXTERIOR ENTRY...

Calculation Points Name Average Maximum Minimum Average / Minimum Minimum

FRONT ENTRY 5 fc 14 fc 0 fc 78.0 226.

VESTIBULE O L _ 0 0 0 3 9 10 15 (151) 00 01 01 02 02 02 03 01 02 03 02 02 03 0 0 00 00 ElumTools PLAN EXTERIOR BUILDING PHOTOMETRIC

N E100P 1/8" = 1'-0"

901 DEMING WAY // MADISON, WI 53717 Ph: 608.664.3500 // Fx: 608.664.3535 iconicacreates.com UDC SUB #2 08-14-18 UDC/CDR SUB #1 08-14-18 This document contains confidential or proprietary information of Iconica. Neither the document nor the information herein is to be reproduced, distributed, used or disclosed, either in whole or in part, except as specifically authorized by Iconica. Sheet Title SITE PHOTOMETRIC PLAN Project Number: 20180200 Sheet Number

SITE LOCATION MAP



2164 W. BELTLINE HWY MADISON, WI 53713

PROJECT DIRECTORY

FAX: (608) 664-3535

W231 N1013 COUNTY F WAUKESHA, WI 53186

STEINHAFELS BELTLINE ROOF



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BID PACKAGE #1: 08-14-18 UDC/CDR SUB#1 08-14-18	UDC SUB #2 08-14-18	UDC SUB #1: 07-17-18	SHEET#	SHEET TITLE

	•			G001	ICONICA BUILDING COVER SHEET
Architectur	al				
•				A001	ABBREVIATIONS, SYMBOLS AND NOTES
•	•	•	•	A100	SCHEMATIC SITE PLAN
		•		A101	GRADING PLAN
•			•	A201	OVERALL FIRST FLOOR PLAN
•	•	•	•	A201A	ENLARGED FIRST FLOOR PLAN
•				A202	ROOF PLAN
•		•		A203	ENLARGED ROOF PLANS
	•	•		A210	BUILDING ELEVATIONS - UDC #2
			•	A300	BUILDING ELEVATIONS - UDC #1
•		•		A301	BUILDING ELEVATIONS - DEMO
•	•			A302	BUILDING ELEVATIONS
•	•			A303	BUILDING ELEVATIONS
	•	•		A304	SOUTH ELEVATION - EXISTING
				A305	PERSPECTIVE AT EXISTING
	•			A306	SOUTH ELEVATION - ALT SIGNAGE
				A307	PERSPECTIVE AT ALT SIGNAGE
				A308	SOUTH ELEVATION - PROPOSED
				A309	PERSPECTIVE AT PROPOSED SOUTH ELEVATION
•			•	A400	BUILDING SECTIONS
•				A401	BUILDING SECTION
•	•			A530	MISC. EXTERIOR DETAILS
•				A531	FRAMING DETAILS
				E100P	PHOTOMETRIC PLAN AT ENTRY
				L100	LANDSCAPE PLAN

BUILDING CODE

Bui	ilding Design:	2015 International Existing Building Code, with WI amendments (ALTERATION LEVEL 2) 2015 International Building Code, with WI amendments			
1.	Building Use / Occupancy	V: Non-Separated Occupancies: Mercantile (M) Storage moderate hazard (S-1)			
2.	Construction Classification	Type IIB			
3.	Area and Stories:	Per Table 503: Mercantile - 50,000 gsf and 3 stories; S-1 - 70,000 gsf and 2 stories			
4.	Unlimited Area Building:	One Story fully sprinklered building surrounded w/ 60' public ways (507). Reduced open space per (507.2.1) shall not be allowed more than 75% of the building perimeter. Exterior walls facing the reduced width shall be 3-hour fire rated (Existing walls and openings meet this protection requirement).			
5.	Occupancy Separation:	Not required for occupancy separation per Table 508.4			
6.	Fire Protection System:	Fully Sprinklered per NFPA 13 (Existing)			
7.	Mezzanine:	Open to first floor - occupancy is < 10 % of first floor area			
8.	Non-Separated Areas: Mercantile 1st floor: 65,000 gsf S-1 1st floor: 20,000 gsf S-1 mezzanine: 3,000 gsf (not included in Total for code purposes) Total: 1st floor 85,000 gsf				
9.	Minimum Number of Exits	2 minimum (Table 1006.3.1)			
10.	Occupant load per code:	Mercantile First Floor: 442 S-1 1st floor: 10 S-1 Mezzanine: 6 Total: 458 occupants			
11.	Exit Access Travel Distan	ice: 250' Mercantile / Storage S-1 (Table 1017.2)			
12.		Width - 0.2 inches per person for exits (0.3 at stairways, min 36" clear) 92" exit width are required, 358" exit width is existing			
13.		Note: toilet rooms are existing and are to remain as is - No Work Existing Toilet Facilities Provided: WC - Women, 4 existing are provided WC - Men, 2 existing are provided plus 2 urinals WC - Unisex, 1 existing is provided LAV - Women, 2 existing are provided LAV - Men, 2 existing are provided LAV Unisex, 1 existing is provided DF - 2 existing hi/lo provided SS - 1 existing provided			
14.	·	Type: 2A Distance to Extinguisher: 75' Floor Area / Extinguisher: 11,250 sq. ft. Minimum Rating: Class B			
15.		As determined by tabular values (Tables 601 & 602) (Group M / Type IIB) Structural frame 0 hr Ext. bearing wall 0 hr Int. bearing walls 0 hr Ext. non-bearing walls 0 hr where X > 10' (4-hr fire walls exist at party walls) Int. non-bearing walls0 hr			

BID PACKAGES

Existing parking stalls (standard and accessible) to remain.

BID PACKAGE #1

DEMOLITION, STEEL FABRICATION, ROUGH CARPENTRY MATERIALS, ROUGH CARPENTRY LABOR, ROOFING, EIFS, INSULATION, SHEET METAL, CAULKING, DRYWALL, PAINTING, PLUMBING, ELECTRICAL

901 DEMING WAY // MADISON, WI 53717 Ph: 608.664.3500 // Fx: 608.664.3535

ISSUE DATES: Issue Description UDC SUB #1 07-17-18 UDC SUB #2 08-14-18

UDC/CDR SUB #1 08-14-18

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ICONICA BUILDING **COVER SHEET** Project Number: 20180200

Sheet Number




		EXI	STING PLANT LIST			
KEY	SIZE	QUANTITY	COMMON NAME	ROOT	UNIT POINTS	TOTAL
SHADE AND OF	RNAMENTAL	TREES			•	
APA	2 ½"	8	AUTUMN PURPLE ASH	-	35	280
SGA	2 ½"	4	SUMMIT GREEN ASH	_	35	140
RJC	1 1/4"	5	RED JEWEL CRAB	_	15	75
RSPC	1 1/4"	0	RED SPLENDOR CRAB	_	15	60
SHL	2 ½"	9	SKYLINE HONEY LOCUST	-	35	315
ABS	2 ½"	12	AUTUMN BRILLIANCE SER∨ICEBERRY	-	15	180
DECIDUOUS SH	IRUBS					
RR	-	15	RUGOSA ROSE	_	3	45
FS	-	23	FROEBEL SPIREA	_	3	69
GFS	_	12	GOLDFLAME SPIREA	-	3	36
GMS	_	25	GOLDMOUND SPIREA	-	3	75
EVERGREEN T	REES AND	SHRUBS				
GPB	_	5	GREEN MOUNTAIN PYRAMIDAL BOXWOOD	-	4	20
BY	-		BERRYHILL YEW	_	4	
TA	_	3	TECHNY ARBORVITAE	_	4	12
LAM	-	22	MINI ARCADE JUNIPER	-	4	88
ORNAMENTAL (GRASSES /	PERENNIA	_S			
BES	_	43	BLACK-EYED SUSAN	-	2	86
KFF	-	103	KARL FOERESTER FEATHER REED GRASS	-	2	206
PDR	-	34	PRAIRIE DROPSEED	_	2	68
RSC	_	34	RUBY STAR CONEFLOWER	_	2	68
RRD	-	62	ROSY RETURNS DAYLILLY	-	2	124
RUS	-	21	RUSSIAN SAGE	_	2	42
BOULDER RETA	AINING WAL	L WITH SI	PLITRAIL FENCE ABOVE			
240 LIN. FT.	-	_	RETAINING WALLS	-	4/10LF	96
TOTAL EXISTI	NG POINTS					2021
NDTES:						
SITE = 187,56	38 SF					
BUILDING = 8						
DEVELOPED A	REA = 102,	568 S.F.				
	ADE DELLE	C DEQUIDE	ID (102,568 / 300 * 5)			1710









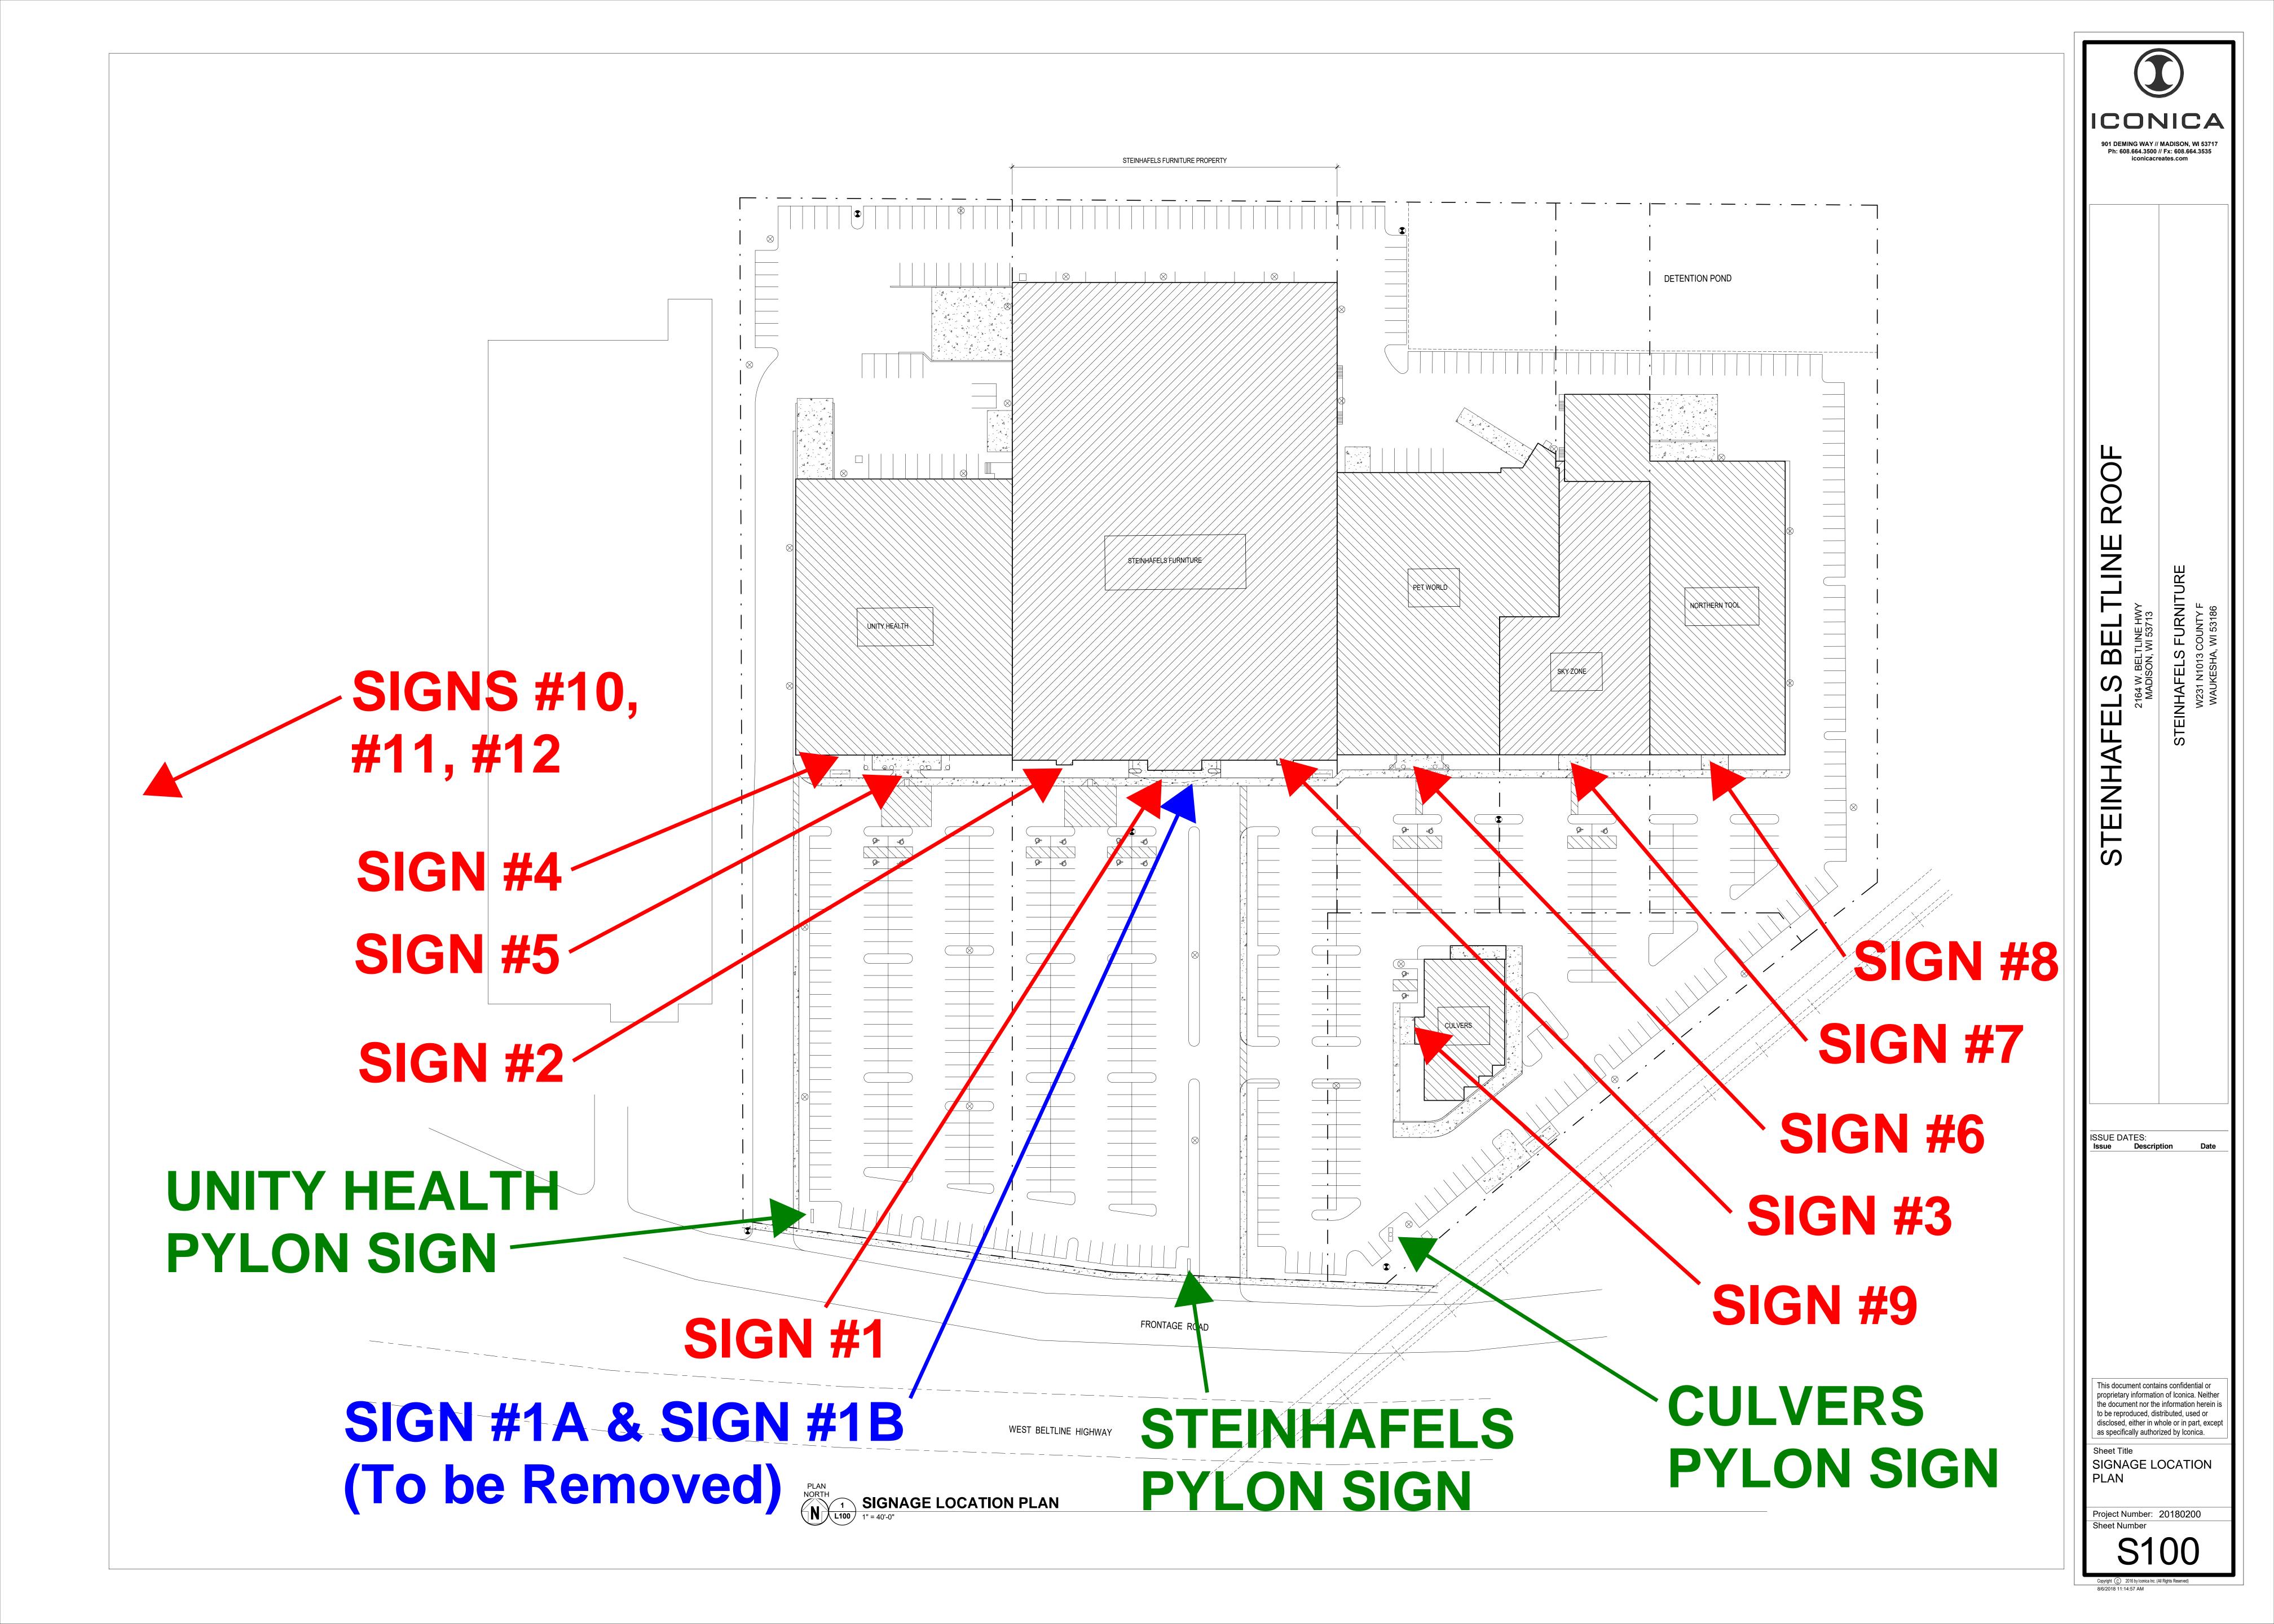












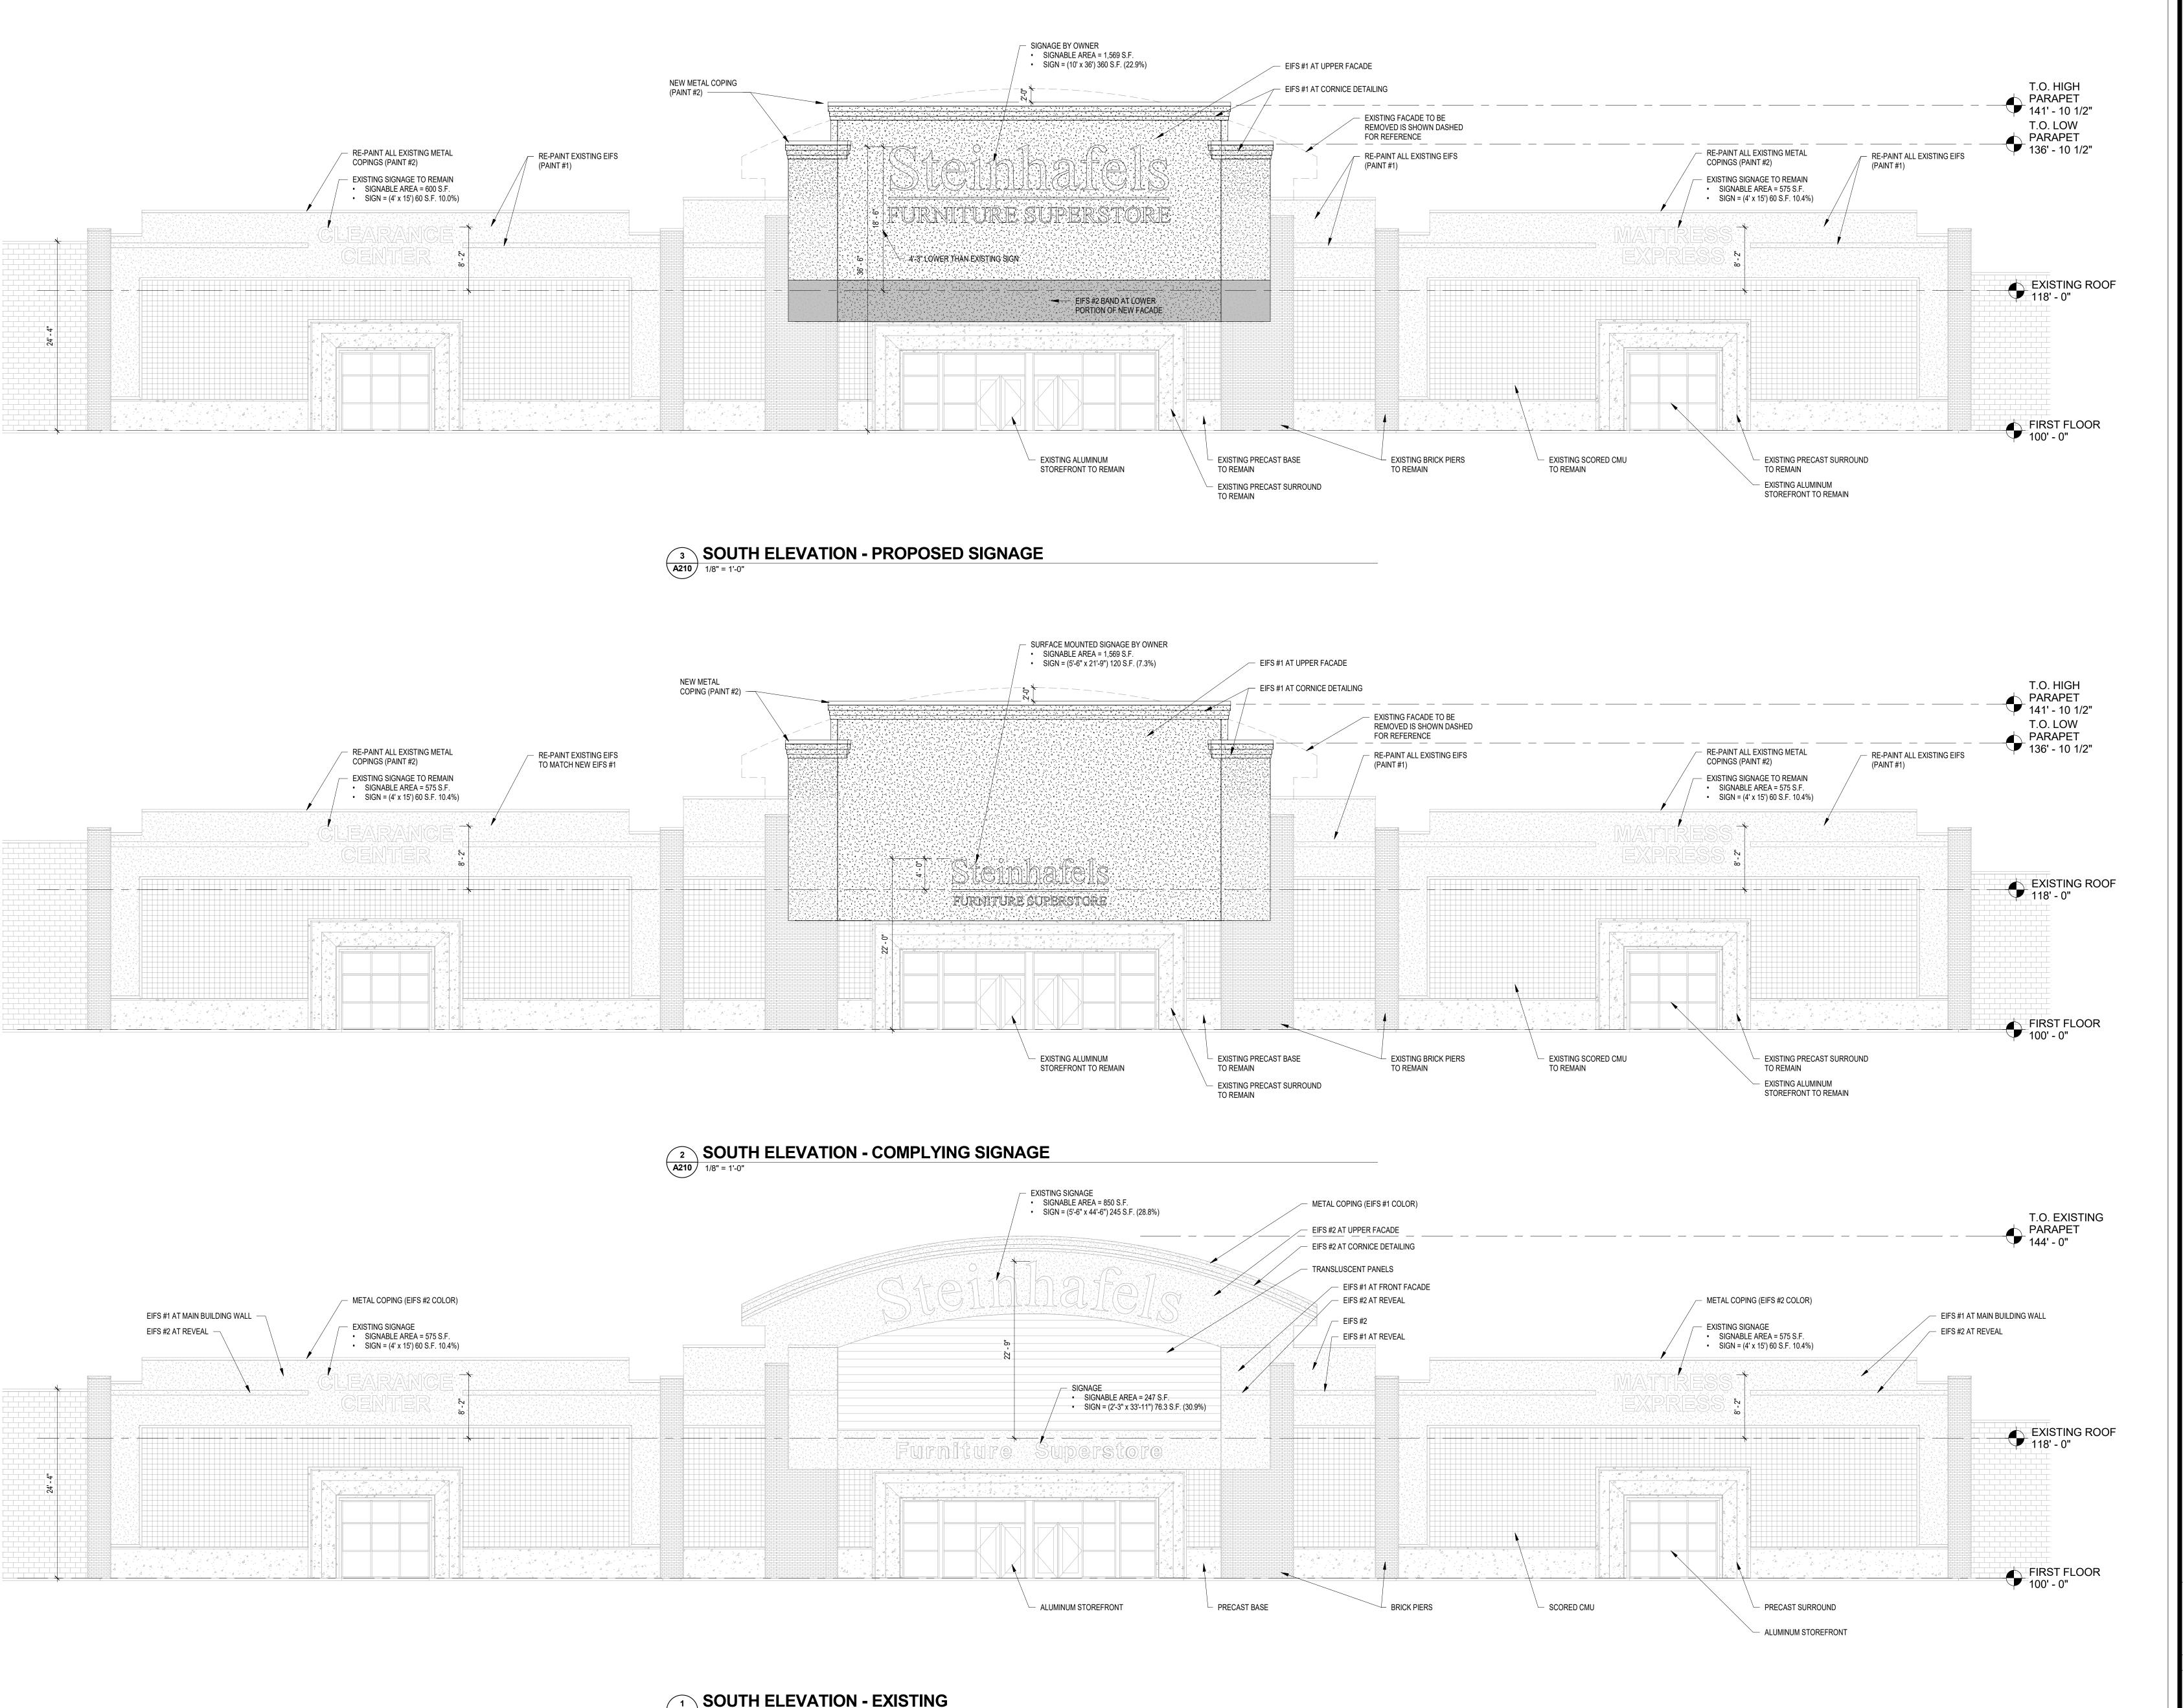

A210 1/8" = 1'-0"

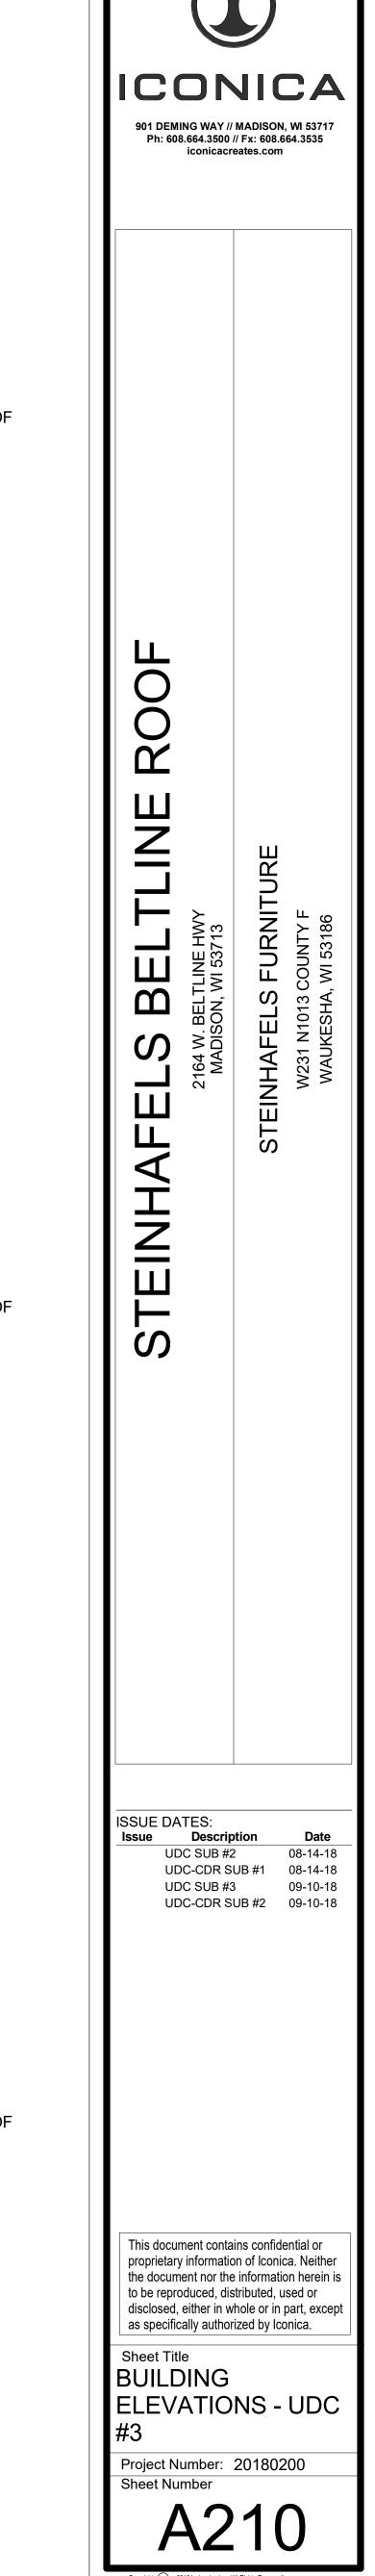

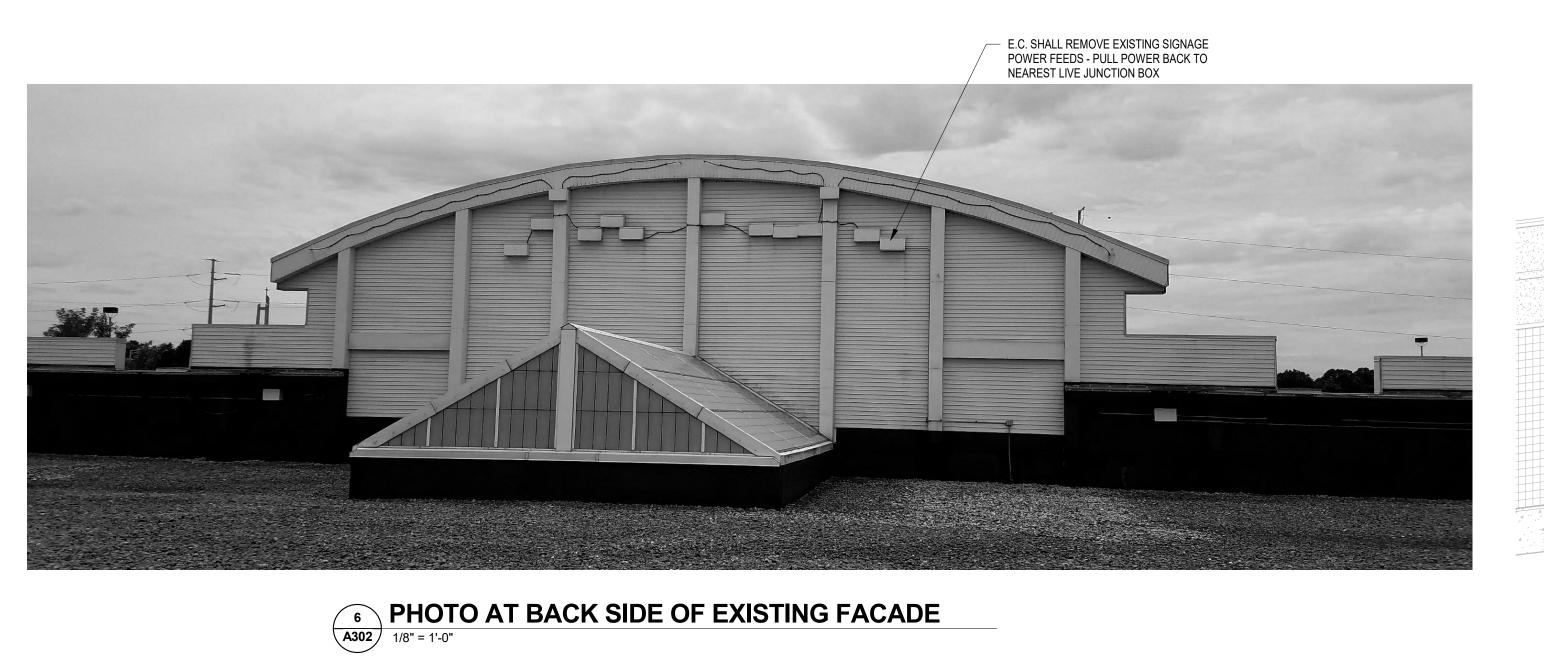





V.6	EXTERIOR MATERIALS KEY				
	EIFS #1 PAINT #1	COLOR: SW6105 DIVINE WHITE TEXTURE: FINE SAND FINISH	NEW EIFS, AND RE-PAINT EXISTING EIFS AND EIFS REVEALS		
	EIFS #2 PAINT #2	COLOR: SW6107 NOMADIC DESERT TEXTURE: FINE SAND FINISH	ACCENT BAND AT LOWER PORTION OF NEW FACADE		
	PRECAST CONCRETE (EXISTING)	COLOR: EDWARDS TAN DC-25 TEXTURE: SMOOTH	EXISTING AT BASE, MAIN ENTRY SURROUND, BAY WINDOW SURROUNDS, PIER CAPS		
	BRICK (EXISTING)	COLOR: GLEN GARY, OXFORD IRON SIZE: UTILITY	EXISTING TO REMAIN AT PIERS		
	SCORED C.M.U. (EXISTING)	COLOR: GLEN GARY, OXFORD IRON SIZE: 8" x 8" SCORE	EXISTING TO REMAIN AT BUILDING WALLS		
	METAL COPINGS (EXISTING)	COLOR: PREVIOUSLY PAINTED SW 6107 NOMADIC DESERT	REPAINT PAINT #2 - SW 6107 NOMADIC DESERT		
	METAL COPINGS (NEW)	COLOR: SW 6107 NOMADIC DESERT	PAINT GRIP METAL - PAINT IN SHOP		
	METAL SOFFIT (NEW)	COLOR: ALMOND	VENTED ALUMINUM SOFFIT PANELS		
	ALUMINUM STOREFRONT (EXISTING)	COLOR: MEDIUM BRONZE	EXISTING TO REMAIN		


EXTERIOR MATERIAL NOTES:

1. SEALANT COLOR TO MATCH DARKER OF TWO ADJACENT MATERIALS 2. AESTHETIC "V" JOINT IS REQUIRED IN EIFS AT COLOR/TEXTURE TRANSITIONS


T.O. HIGH

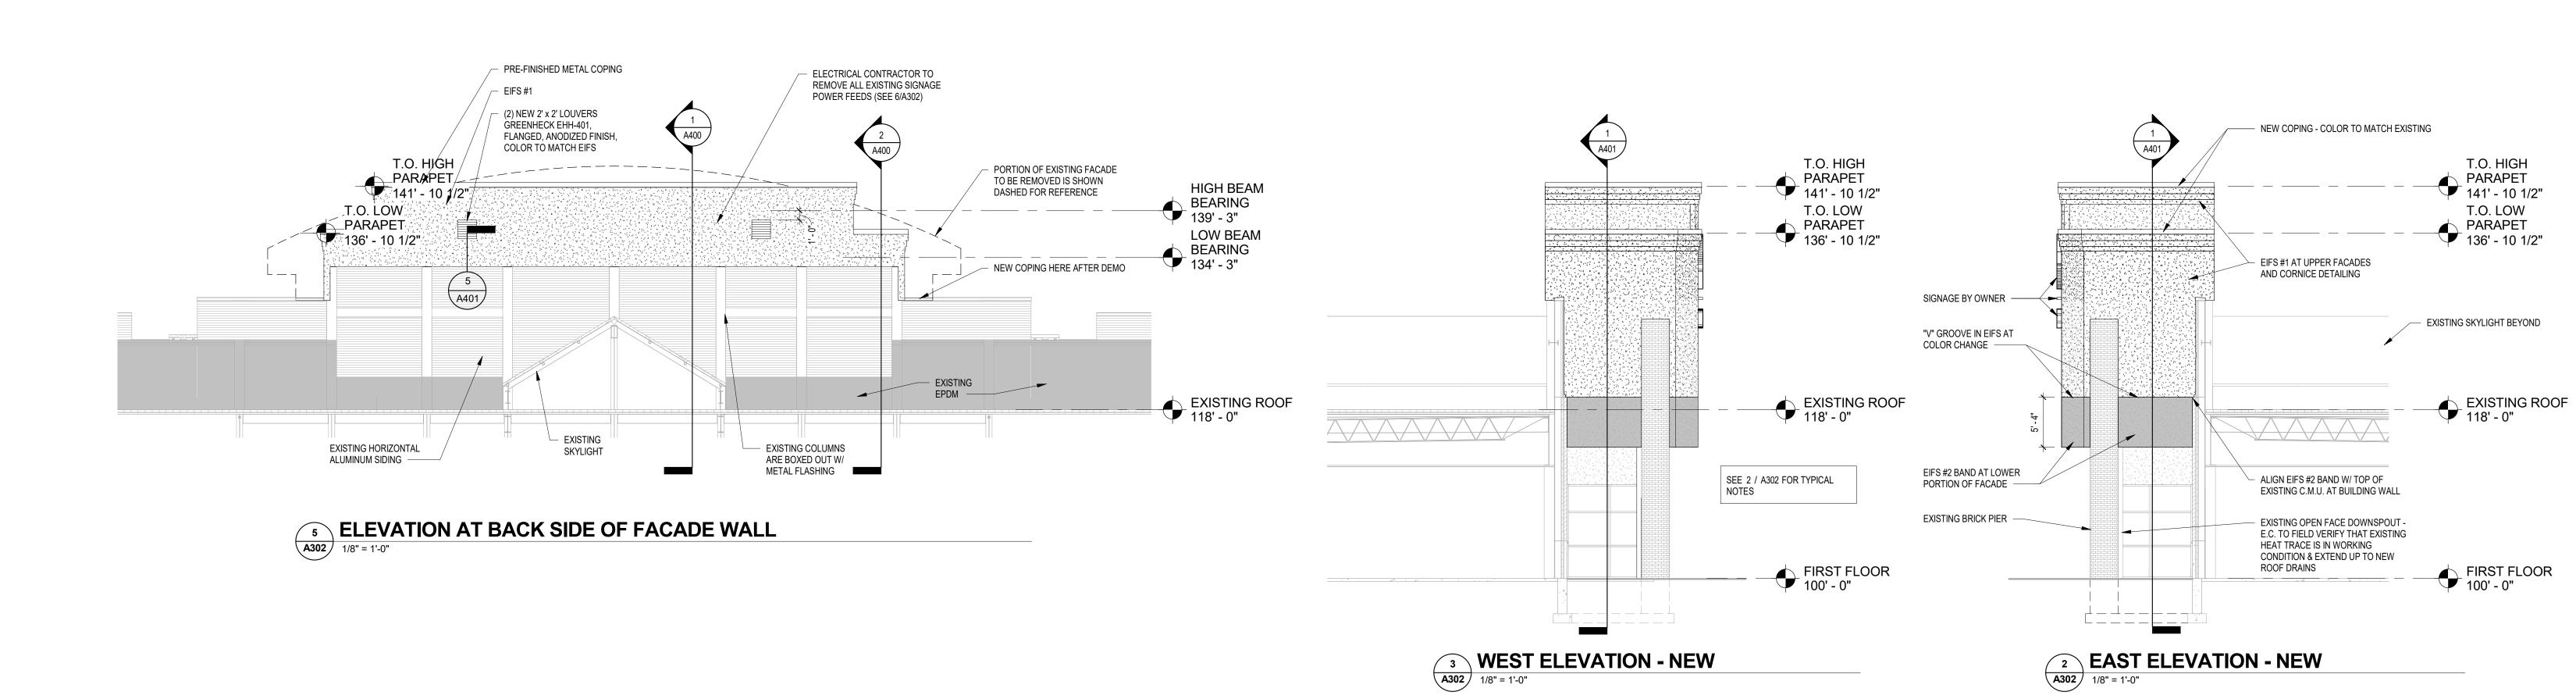


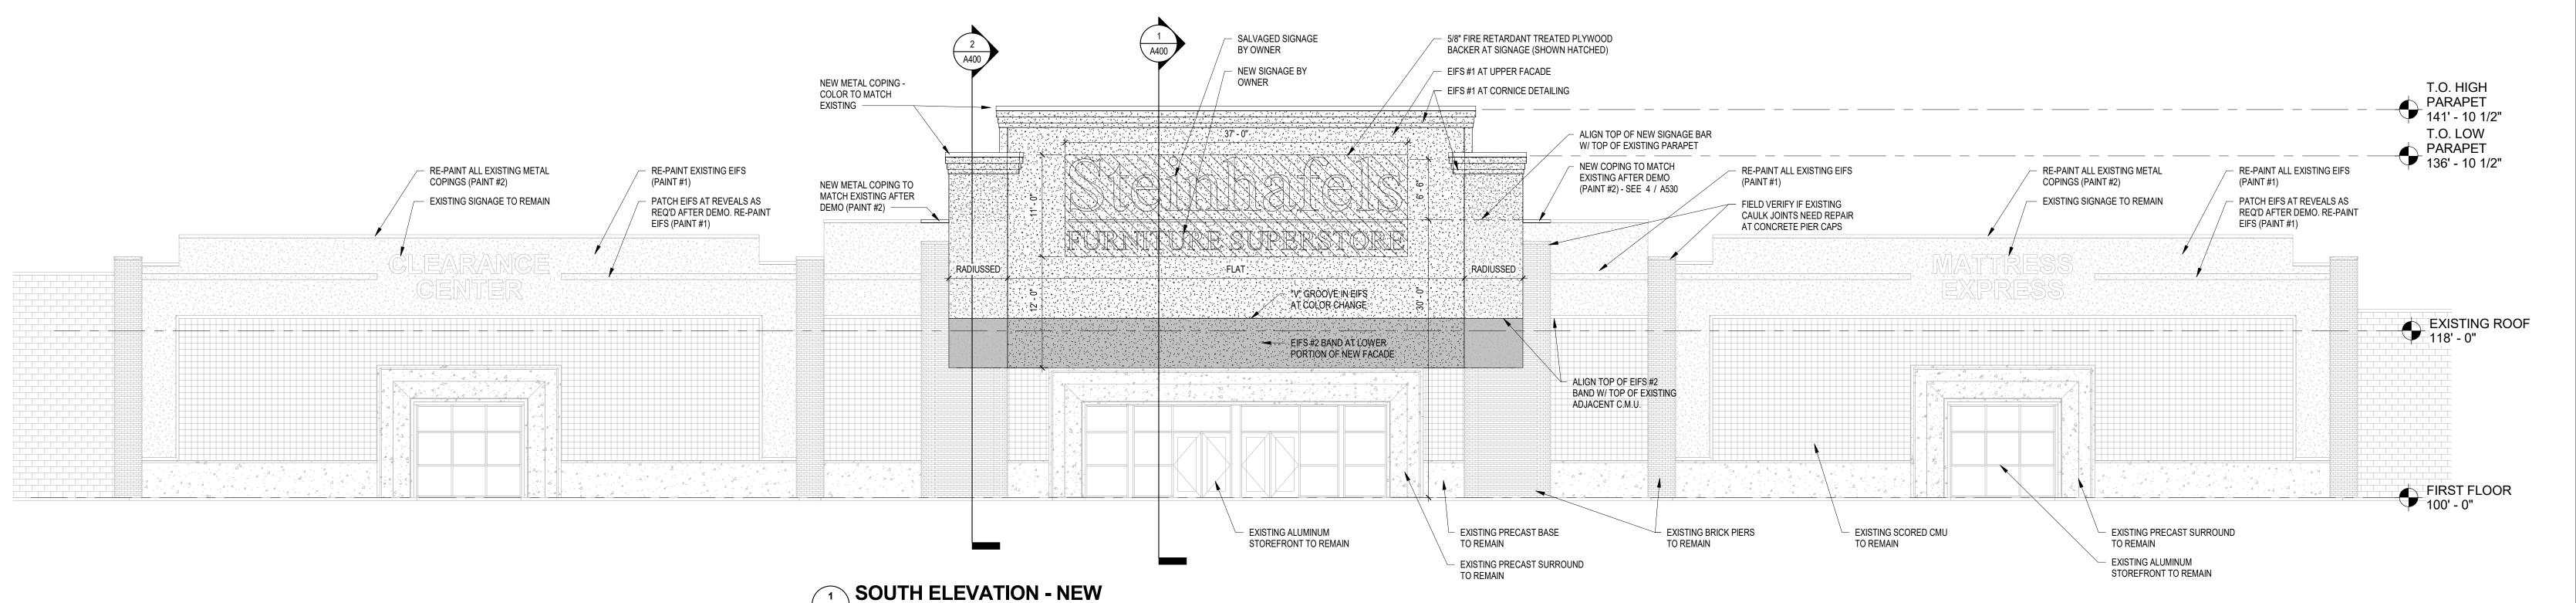


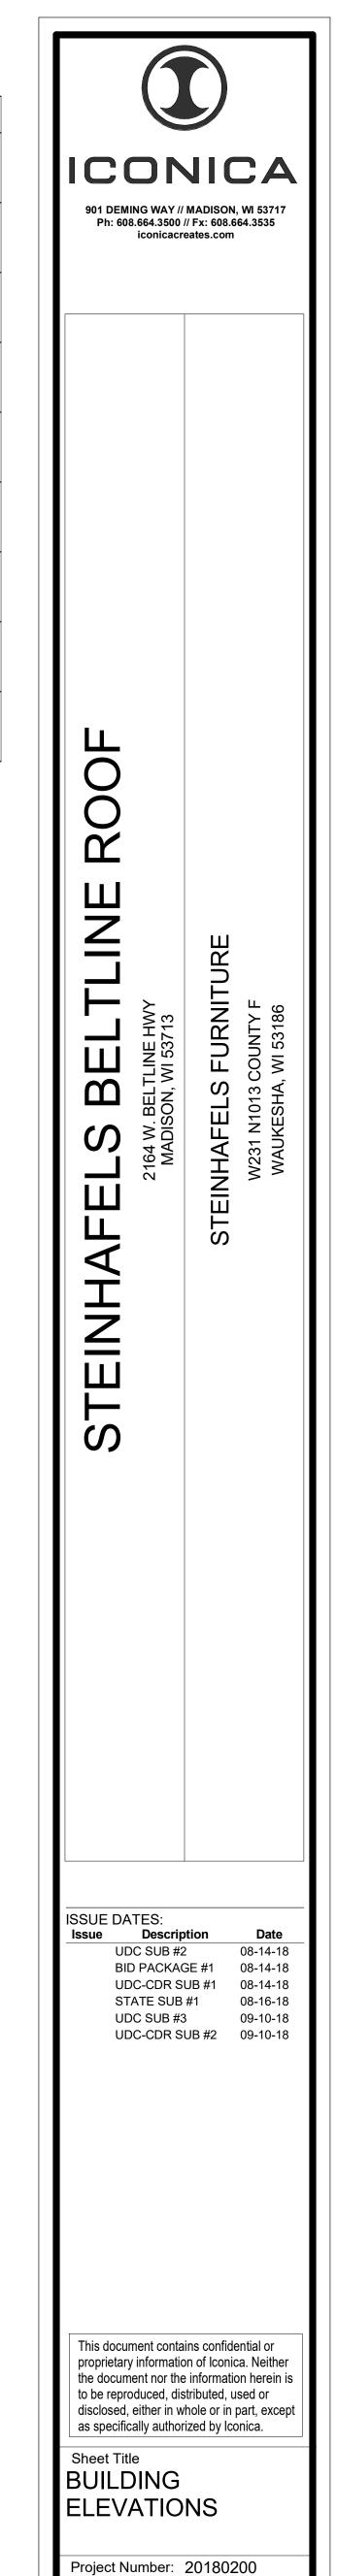


Sheet Number

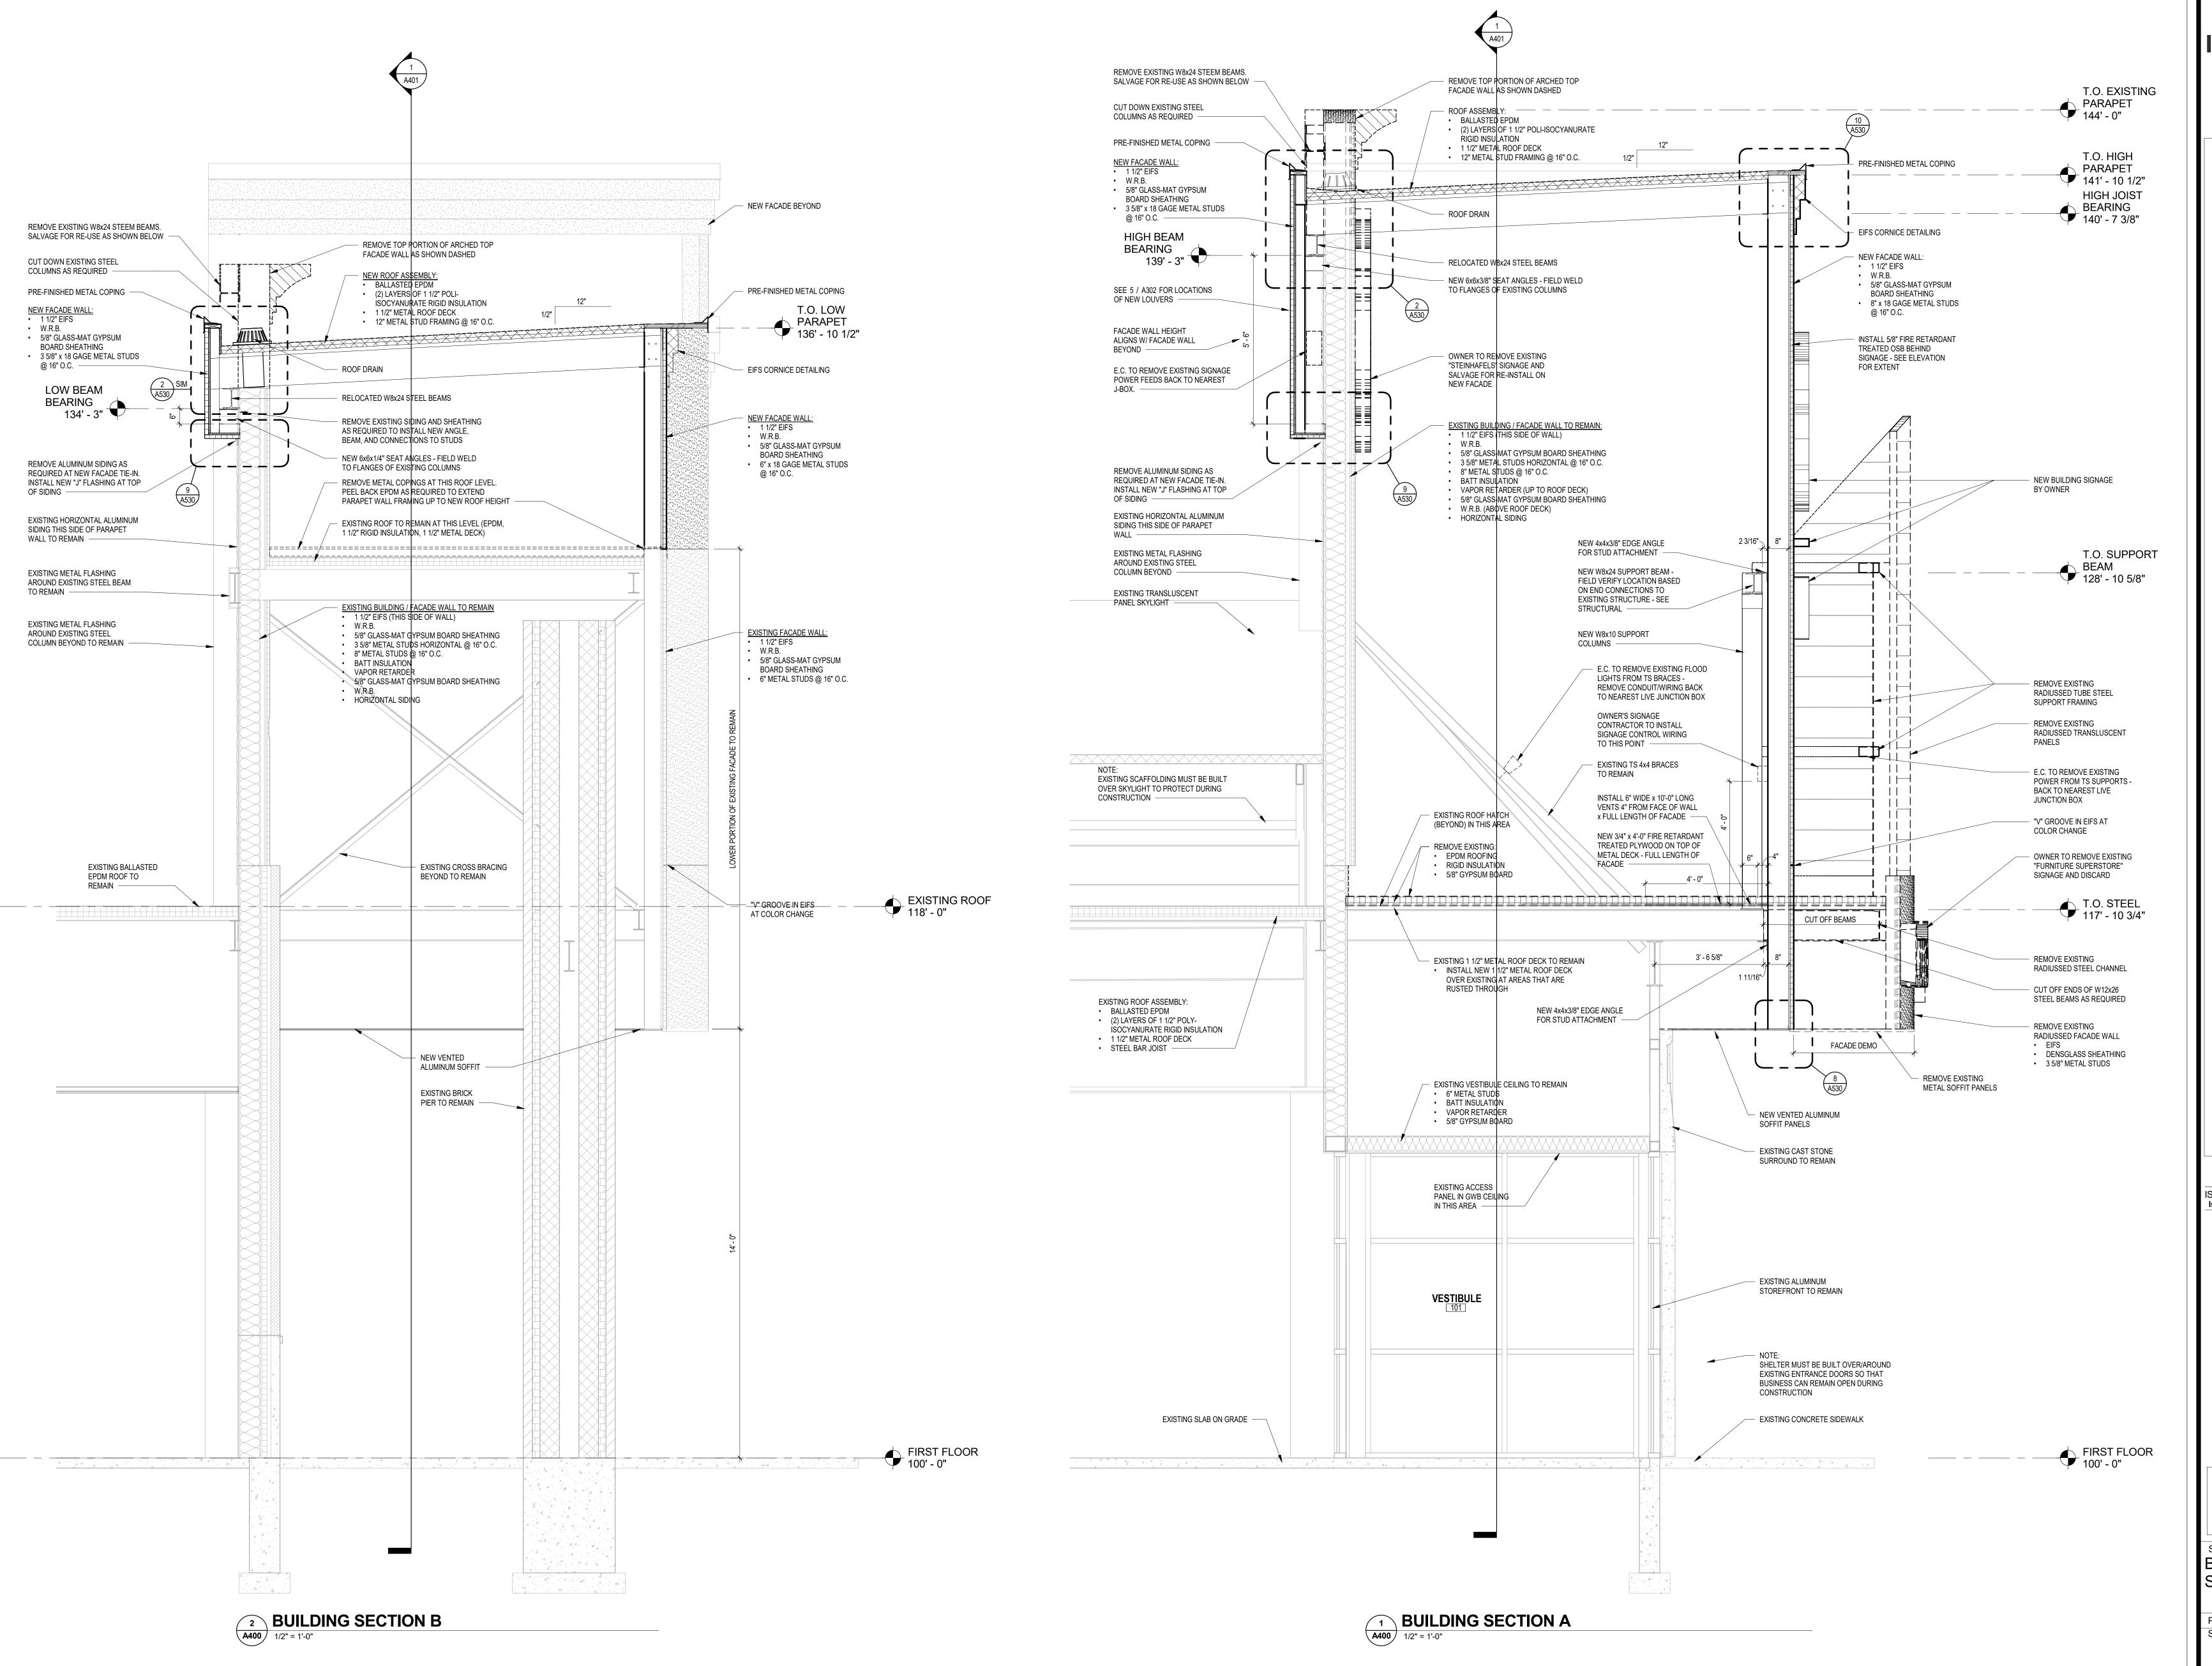


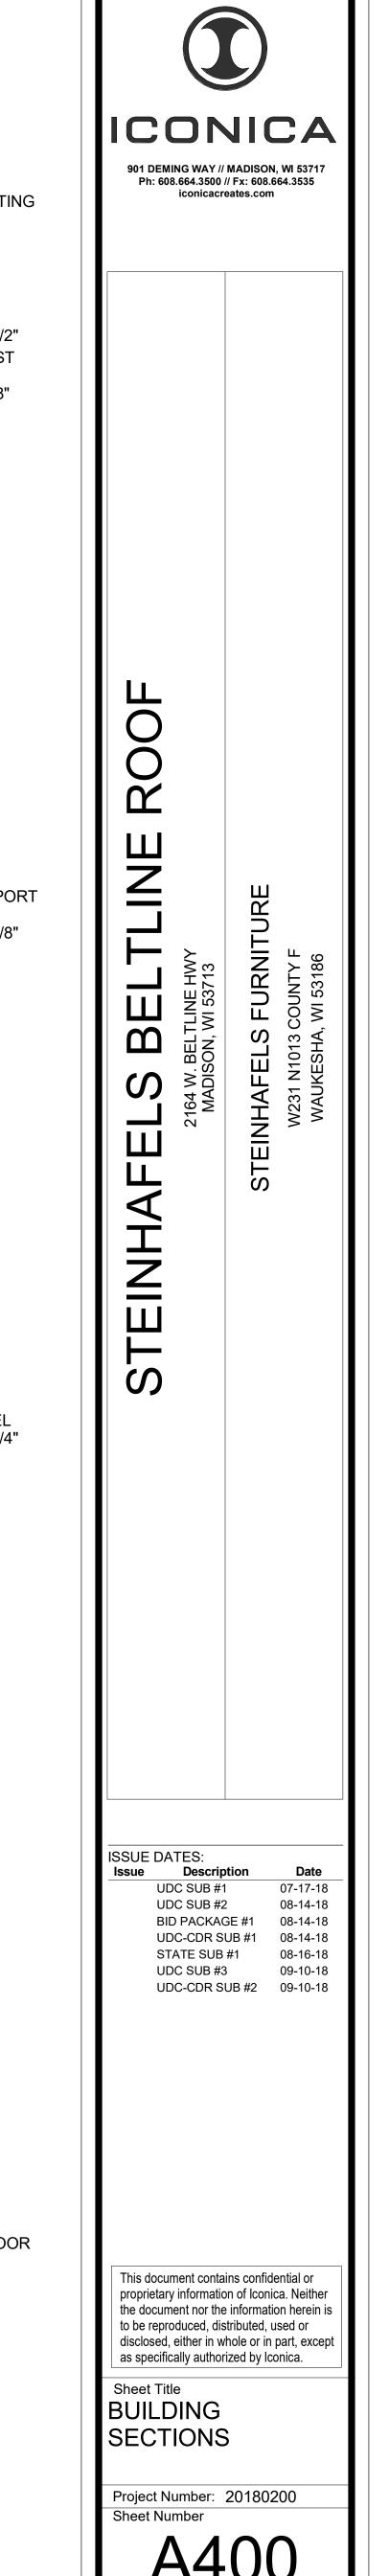

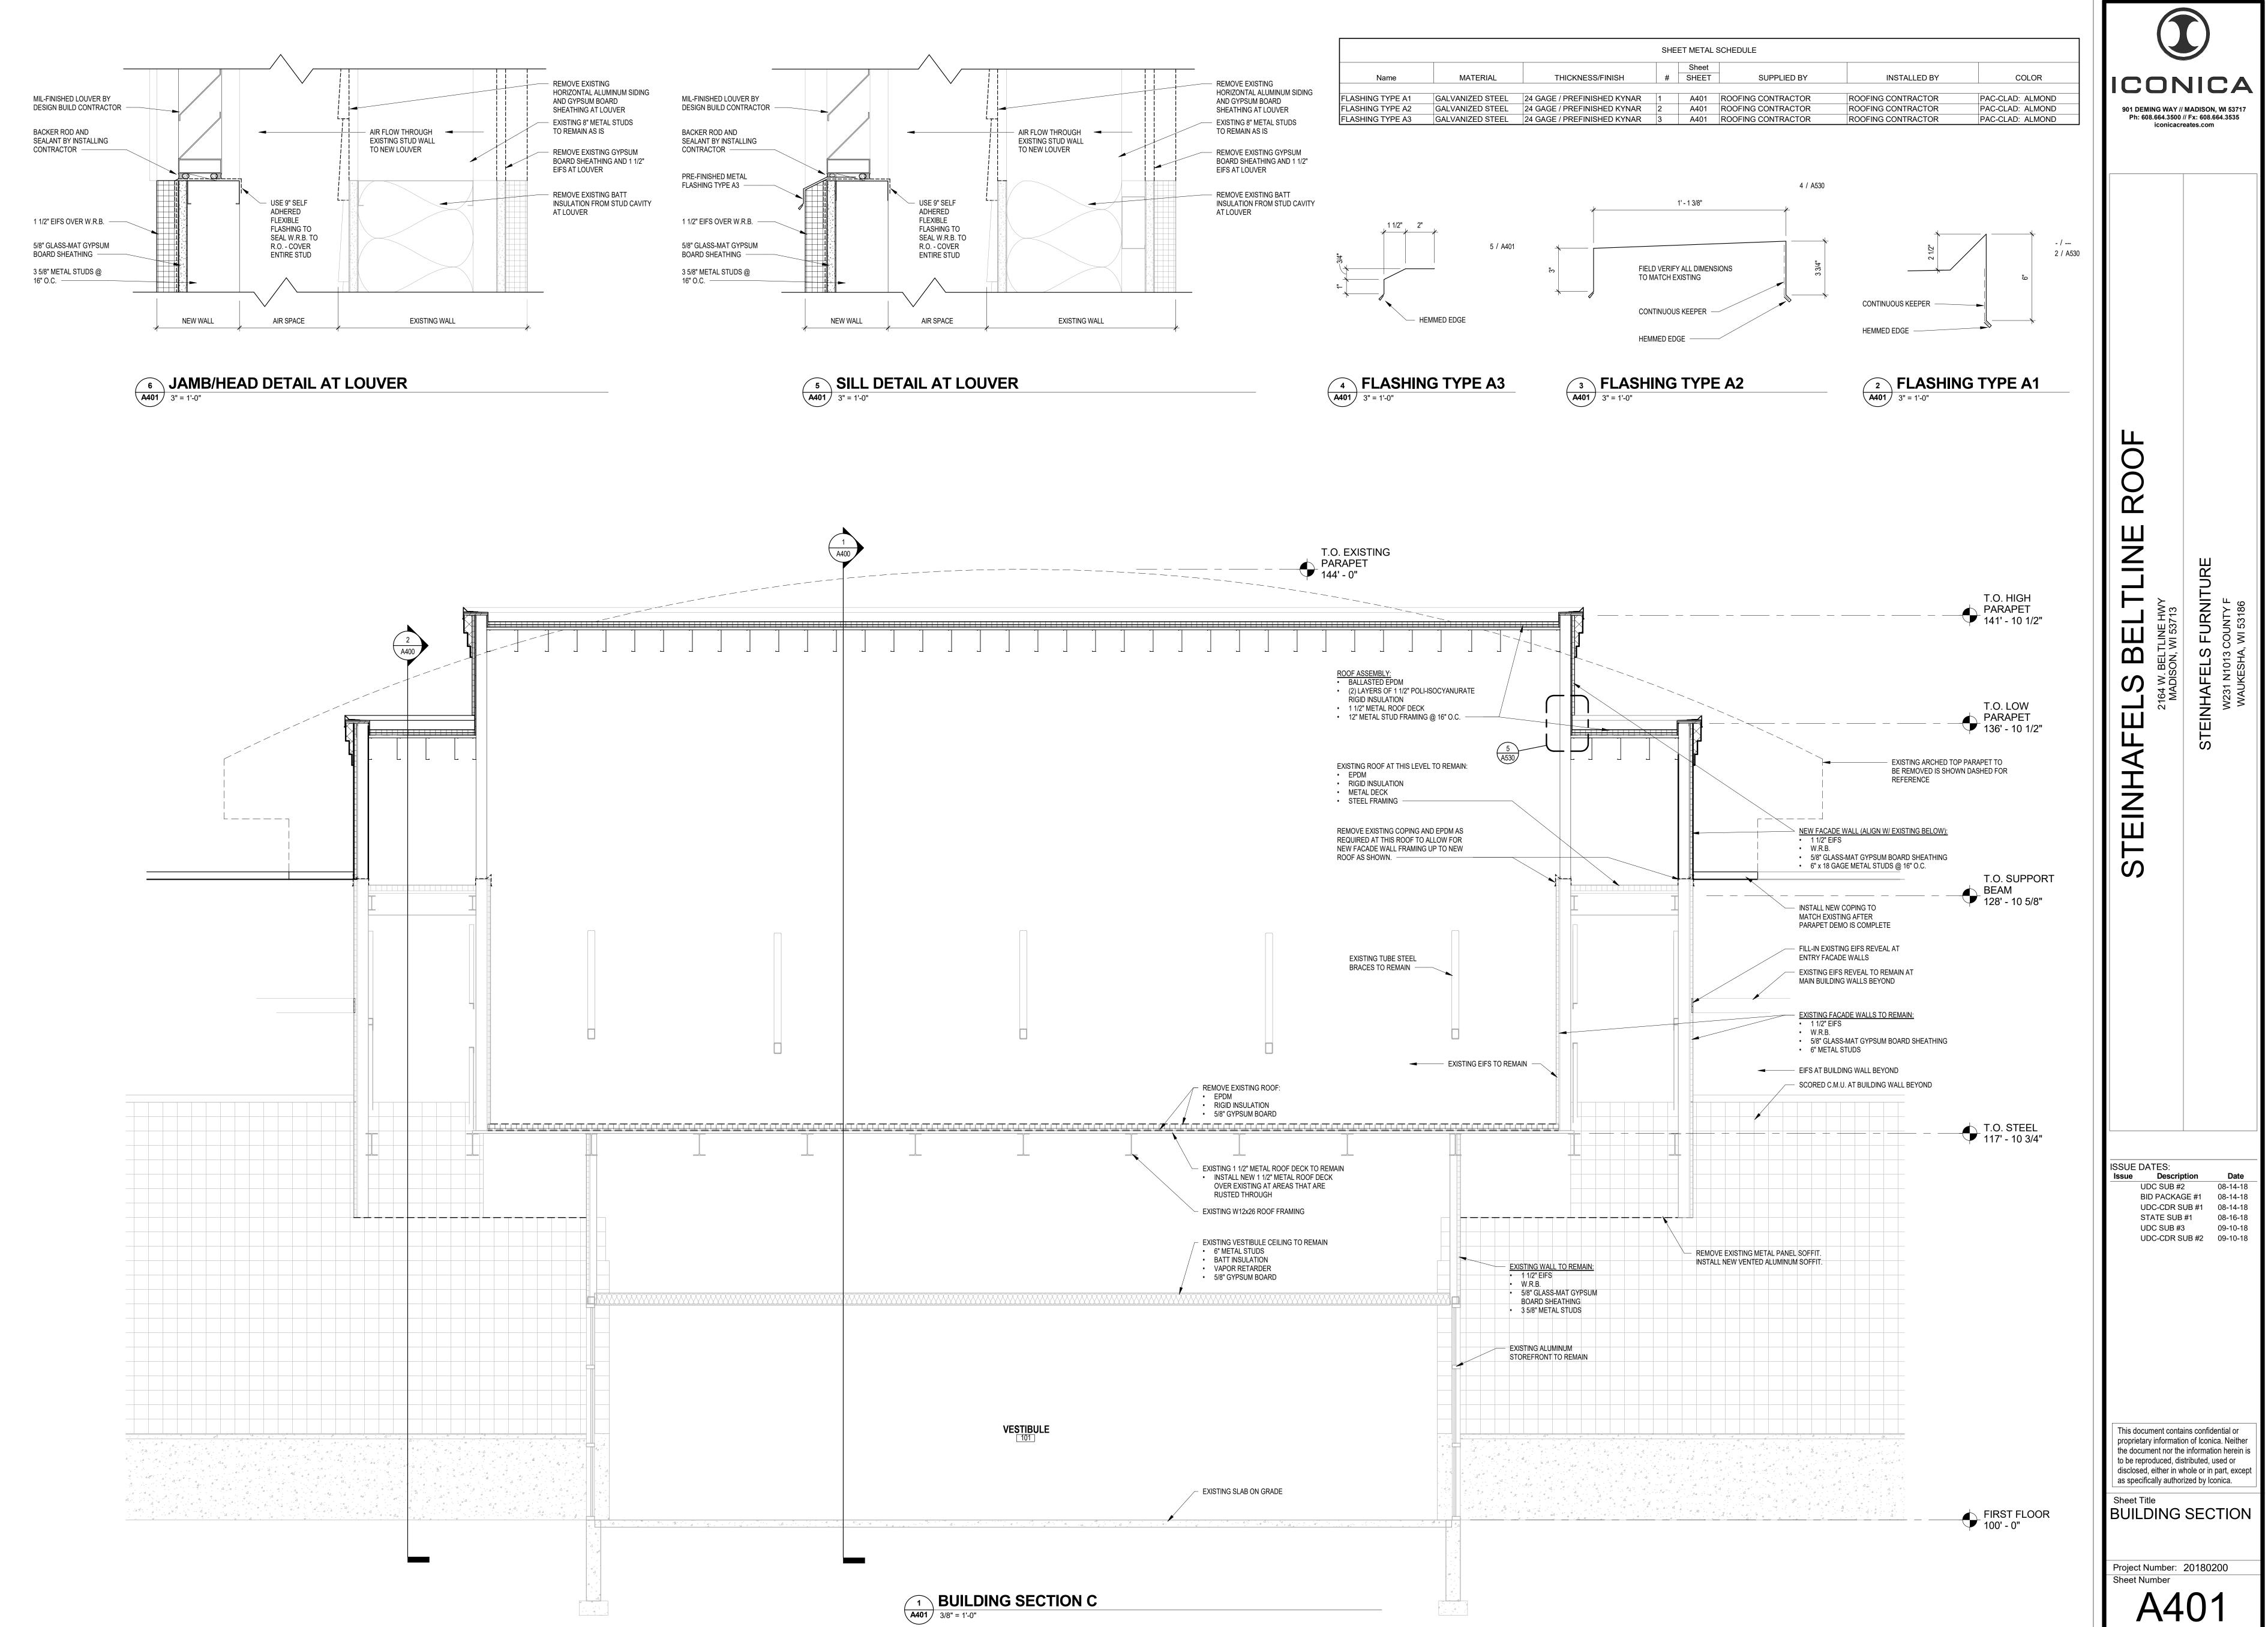



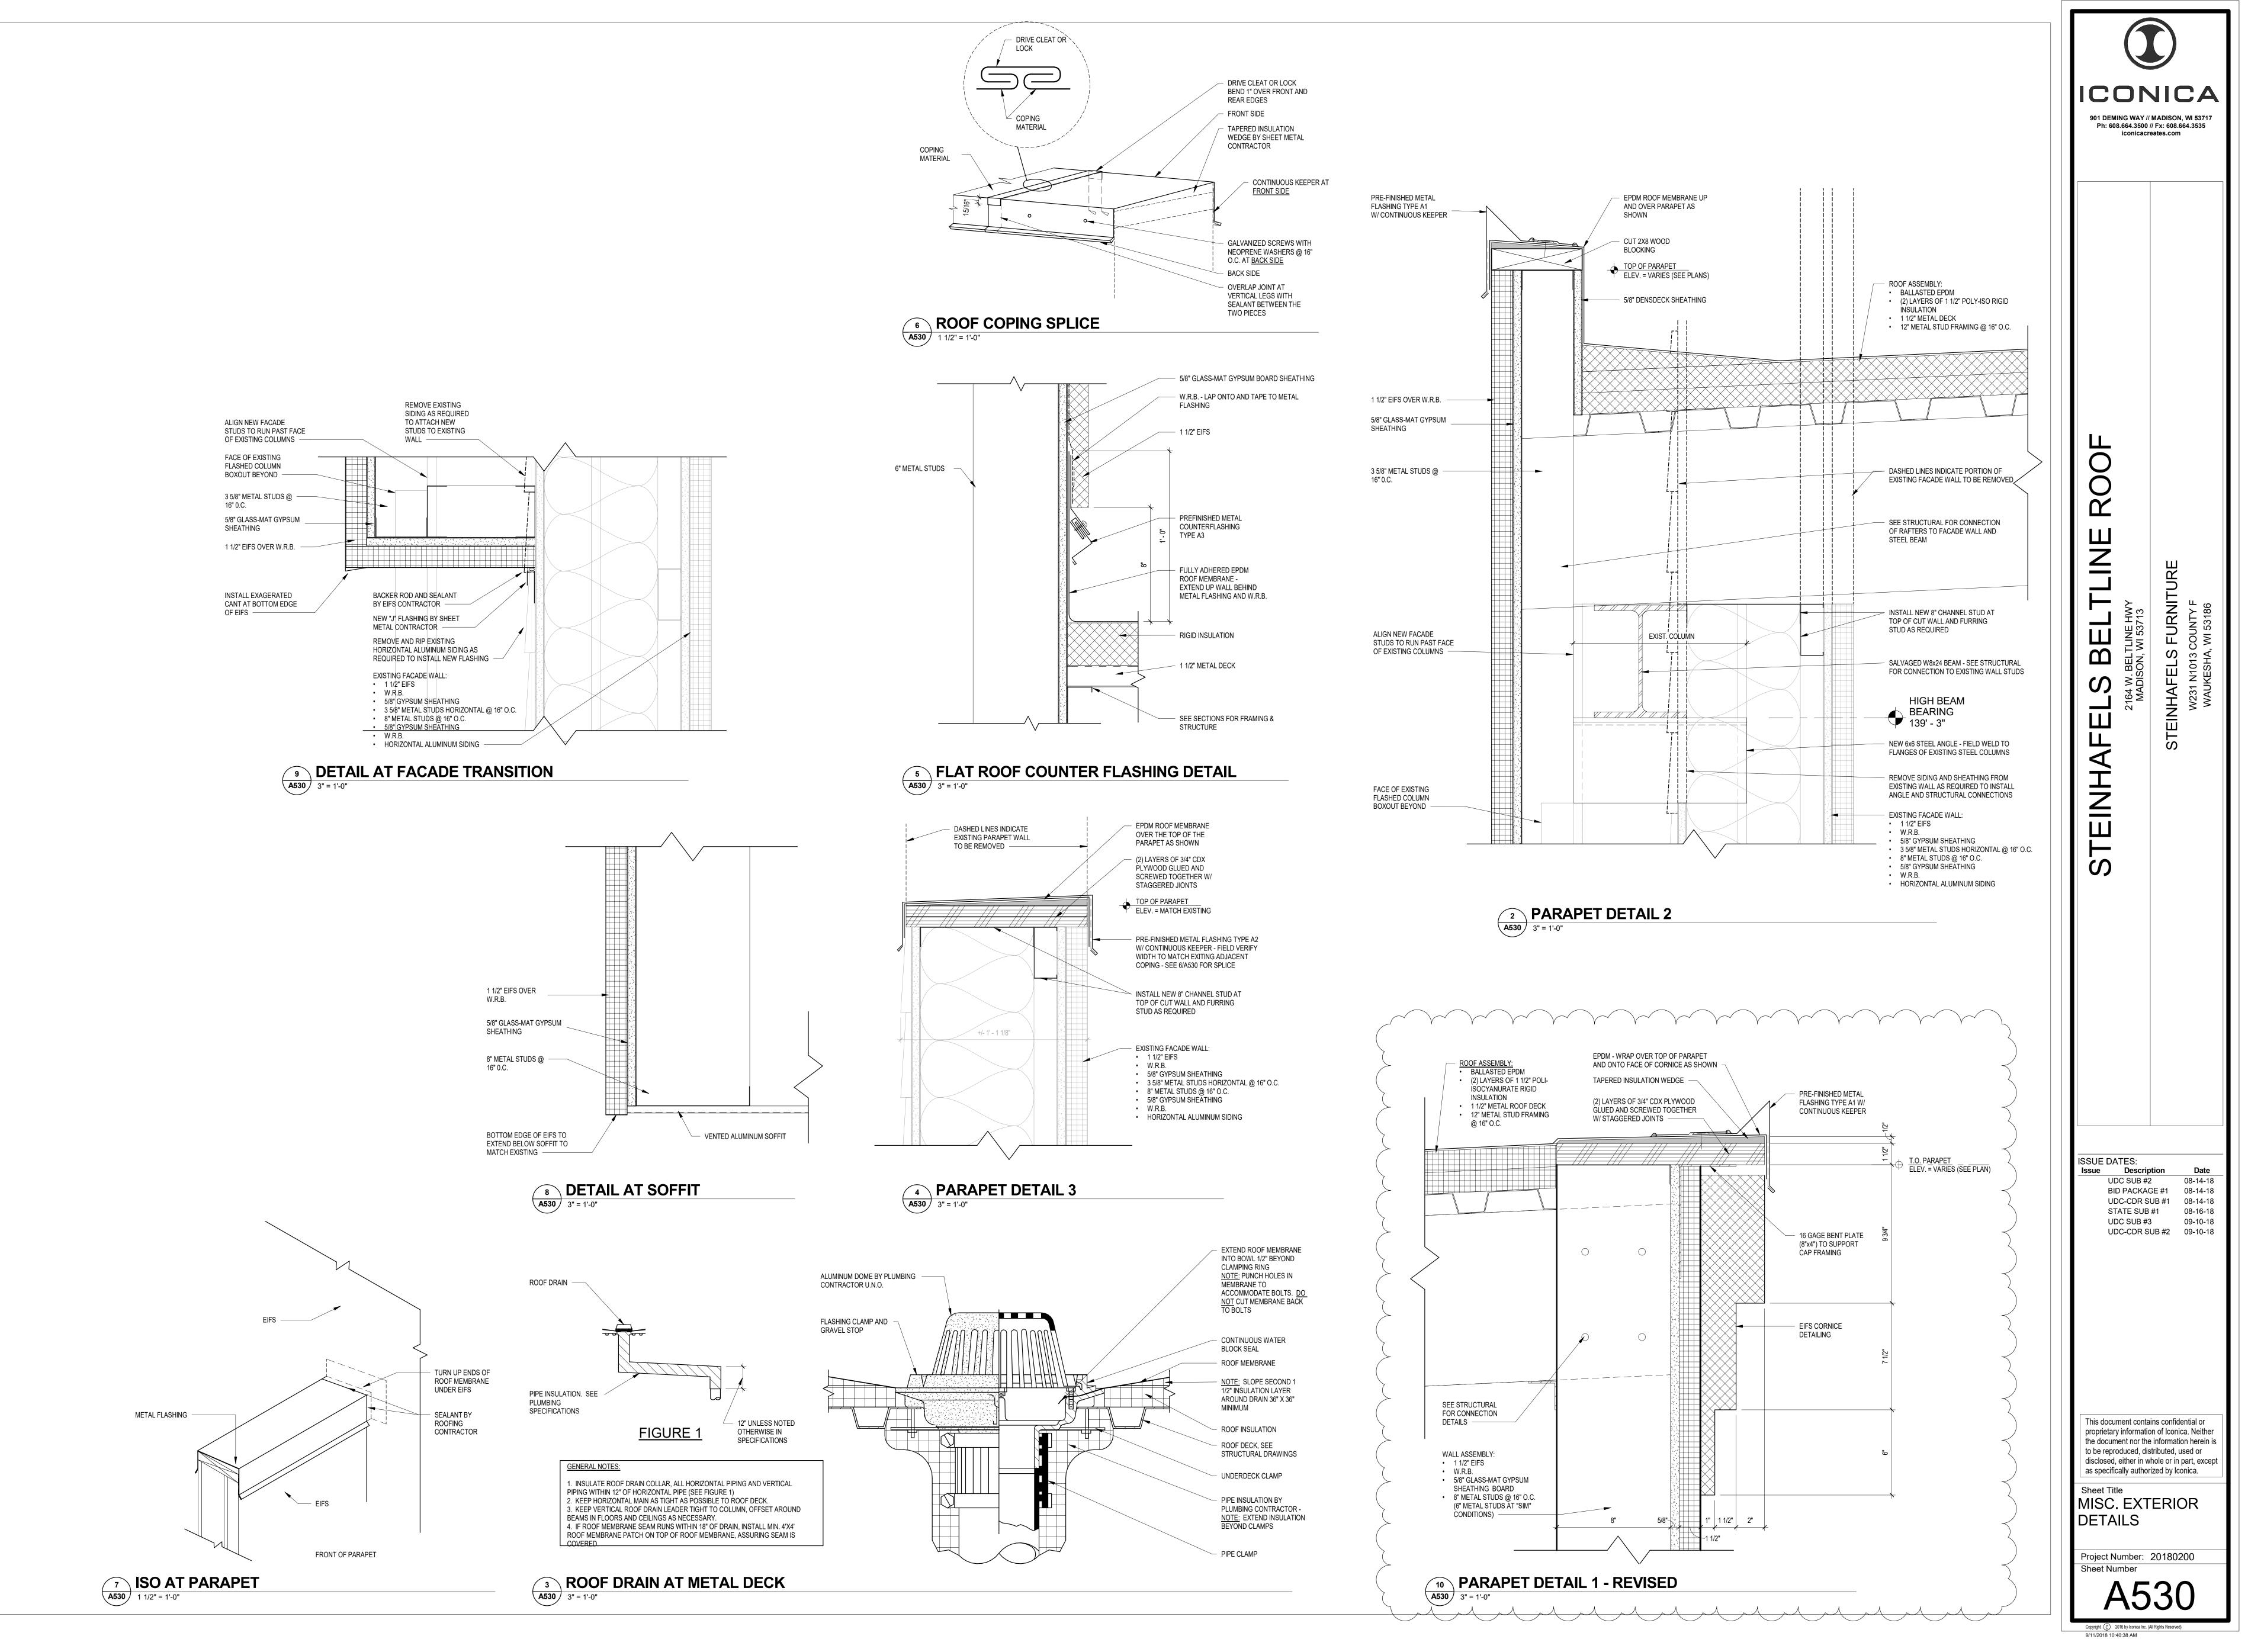

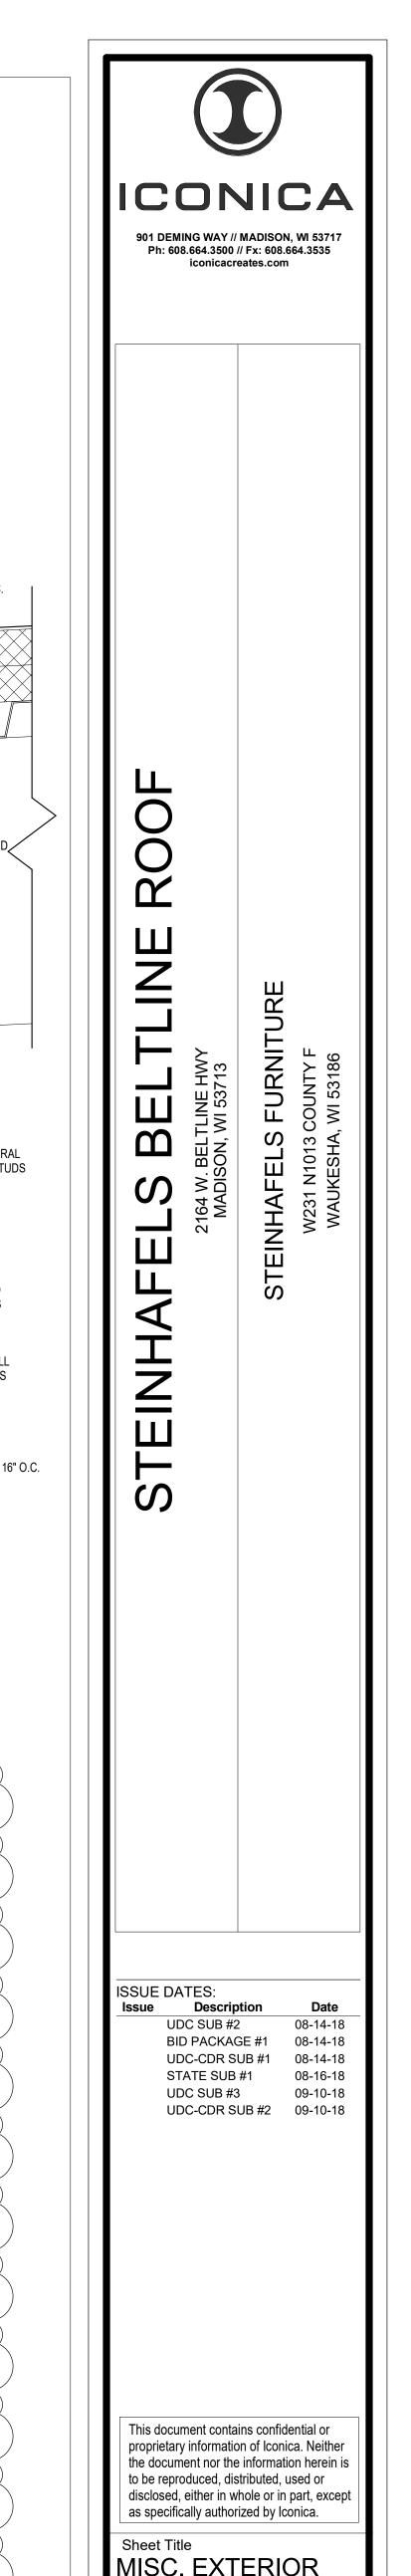

SITE LOCATION MAP



2164 W. BELTLINE HWY MADISON, WI 53713

PROJECT DIRECTORY

DESIGN-BUILDER
ICONICA, INC.
901 DEMING WAY
MADISON, WISCONSIN 53717
PHONE: (608) 664-3500
FAX: (608) 664-3535

OWNER STEINHAFELS FURNITURE W231 N1013 COUNTY F WAUKESHA, WI 53186

STEINHAFELS BELTLINE ROOF



G - SHEET INDEX					
UDC SUB #3 09-10-18	STATE SUB #1 08-16-18	BID PACKAGE #1: 08-14-18	SHEET#	SHEET TITLE	
General					
_			1		
and the set	-1		G001	ICONICA BUILDING COVER SHEET	
Architectur	al				
Architectur	al =	•	A001	ABBREVIATIONS, SYMBOLS AND NOTES	
Architectur	al •		A001 A100	ABBREVIATIONS, SYMBOLS AND NOTES SCHEMATIC SITE PLAN	
Architectur	= = = = = = = = = = = = = = = = = = =	- -	A001 A100 A101	ABBREVIATIONS, SYMBOLS AND NOTES SCHEMATIC SITE PLAN GRADING PLAN	
Architectur	= = = = = = = = = = = = = = = = = = =	-	A001 A100 A101 A201	ABBREVIATIONS, SYMBOLS AND NOTES SCHEMATIC SITE PLAN GRADING PLAN OVERALL FIRST FLOOR PLAN	
Architectur	al	1	A001 A100 A101 A201 A201A	ABBREVIATIONS, SYMBOLS AND NOTES SCHEMATIC SITE PLAN GRADING PLAN OVERALL FIRST FLOOR PLAN ENLARGED FIRST FLOOR PLAN	
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Architectur		- - - - - - -	A001 A100 A101 A201 A201A	ABBREVIATIONS, SYMBOLS AND NOTES SCHEMATIC SITE PLAN GRADING PLAN OVERALL FIRST FLOOR PLAN ENLARGED FIRST FLOOR PLAN	

L100 LANDSCAPE PLAN

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BID PACKAGE #1

DEMOLITION, STEEL FABRICATION, ROUGH CARPENTRY MATERIALS, ROUGH CARPENTRY LABOR, ROOFING, EIFS, INSULATION, SHEET METAL, CAULKING, DRYWALL, PAINTING, PLUMBING, ELECTRICAL

Policial Property of the Control of

TLINE ROOF

Ĭ Z 2164 W. BELTLINE HWY
MADISON, WI 53713
STEINHAFFI S FIIRNITH

UDC-CDR SUB #2 09-10-18

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ICONICA
BUILDING
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