

City of Madison Fire Department

30 West Mifflin Street, 8th & 9th Floors, Madison, WI 53703-2579 Phone: 608-266-4420 • Fax: 608-267-1100 • E-mail: fire@cityofmadison.com

Project Address: 555 Wes	t Washington Avenue
Contact Name & Phone #:	Kevin Burow 608-836-3690

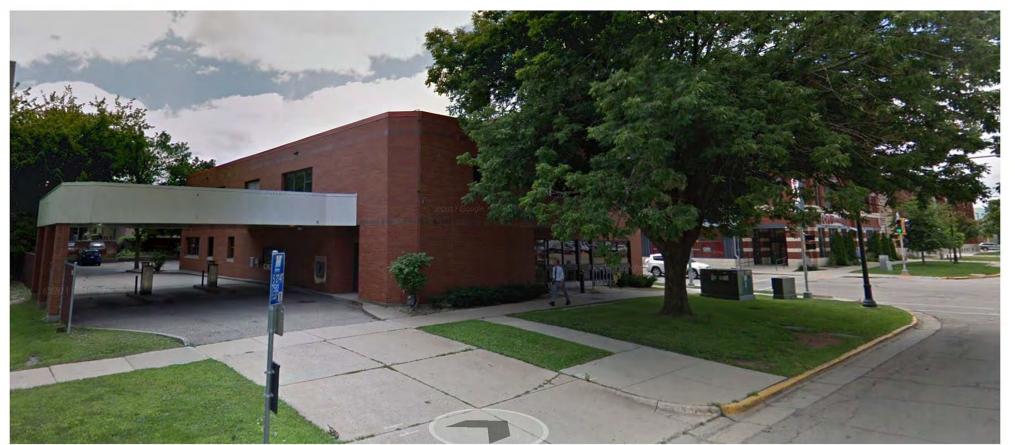
FIRE APPARATUS ACCESS AND FIRE HYDRANT WORKSHEET

1. Is the building completely protected by an NFPA 13 or 13R automatic fire sprinkler system? If non-sprinklered, fire lanes extend to within 150-feet of all portions of the exterior wall? If sprinklered, fire lanes are within 250-feet of all portions of the exterior wall?	X Yes Yes X Yes	☐ No ☐ No ☐ No	 N/A N/A N/A N/A
 2. Is the fire lane constructed of concrete or asphalt, designed to support a minimum load of 85,000 lbs? a) Is the fire lane a minimum unobstructed width of at least 20-feet? b) Is the fire lane unobstructed with a vertical clearance of at least 13½-feet? c) Is the minimum inside turning radius of the fire lane at least 28-feet? d) Is the grade of the fire lane not more than a slope of 8%? e) Is the fire lane posted as fire lane? (Provide detail of signage.) f) Is a roll-able curb used as part of the fire lane? (Provide detail of curb.) g) Is part of a sidewalk used as part of the required fire lane? (Must support +85,000 lbs.) 	X Yes	No No No No No No No No	 N/A N/A N/A N/A N/A N/A N/A N/A N/A
3. Is the fire lane obstructed by security gates or barricades? If yes:a) Is the gate a minimum of 20-feet clear opening?b) Is an approved means of emergency operations installed, key vault, padlock or key switch?	Yes Yes Yes	X No No No	 N/A N/A N/A
4. Is the Fire lane dead-ended with a length greater than 150-feet? If yes, does the area for turning around fire apparatus comply with IFC D103?	Yes Yes	X No No	□ N/A □ N/A
5. Is any portion of the building to be used for high-piled storage in accordance with IFC Chapter 3206.6 If yes, see IFC 3206.6 for further requirements.	Yes	X No	□ N/A
6. Is any part of the building greater than 30-feet above the grade plane?	X Yes	☐ No	N/A
If yes, answer the following questions: a) Is the aerial apparatus fire lane parallel to one entire side of the building and covering at least 25% of the perimeter? b) Is the near edge of the aerial apparatus fire lane between 15' and 30' from the building? c) Are there any overhead power or utility lines located across the aerial apparatus fire lane?	X Yes X Yes Yes	☐ No ☐ No ☒ No	N/AN/AN/A
d) Are there any tree canopies expected to grow across the aerial fire lane? (Based on mature canopy width of tree species)e) Does the aerial apparatus fire lane have a minimum unobstructed width of 26-feet?f) Is the space between the aerial lane and the building free of trees exceeding 20' in heights?	Yes Yes Yes Yes Yes	X No No No No	N/AN/AN/AN/A

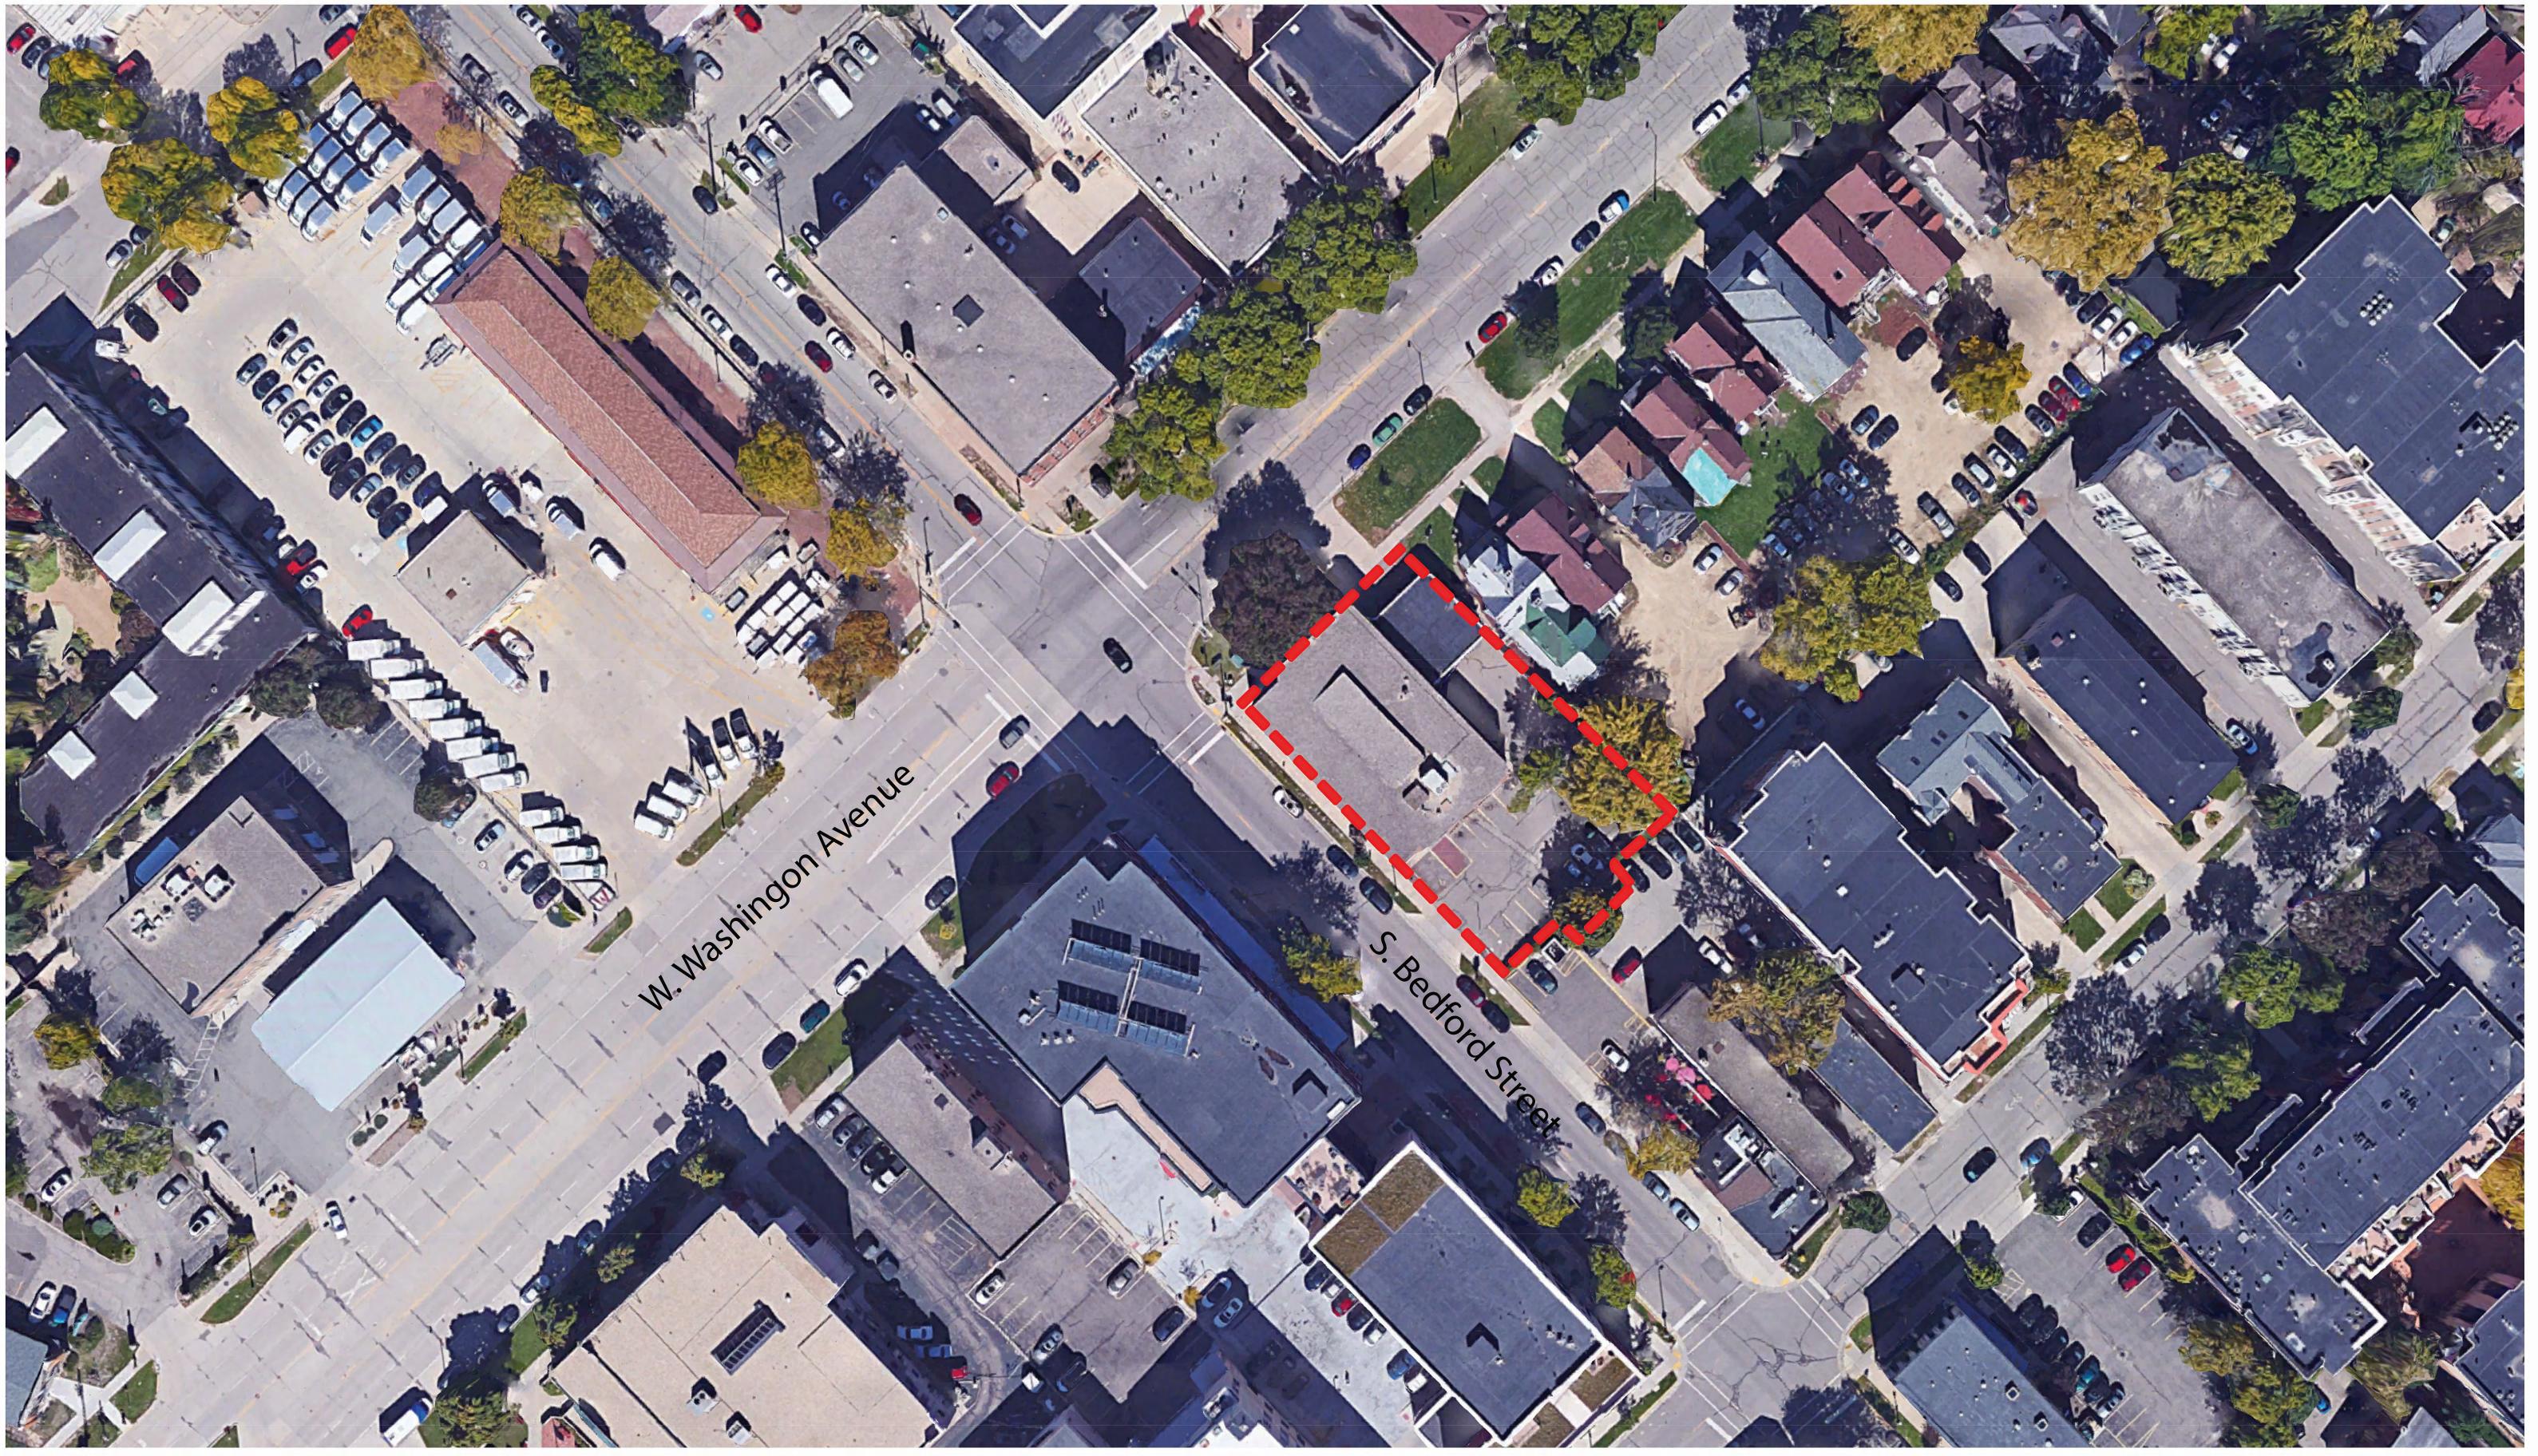
Attach an additional sheet if further explanation is required for any answers.

This worksheet is based on MGO 34.503 and IFC 2012 Edition Chapter 5 and Appendix D; please see the codes for further information.

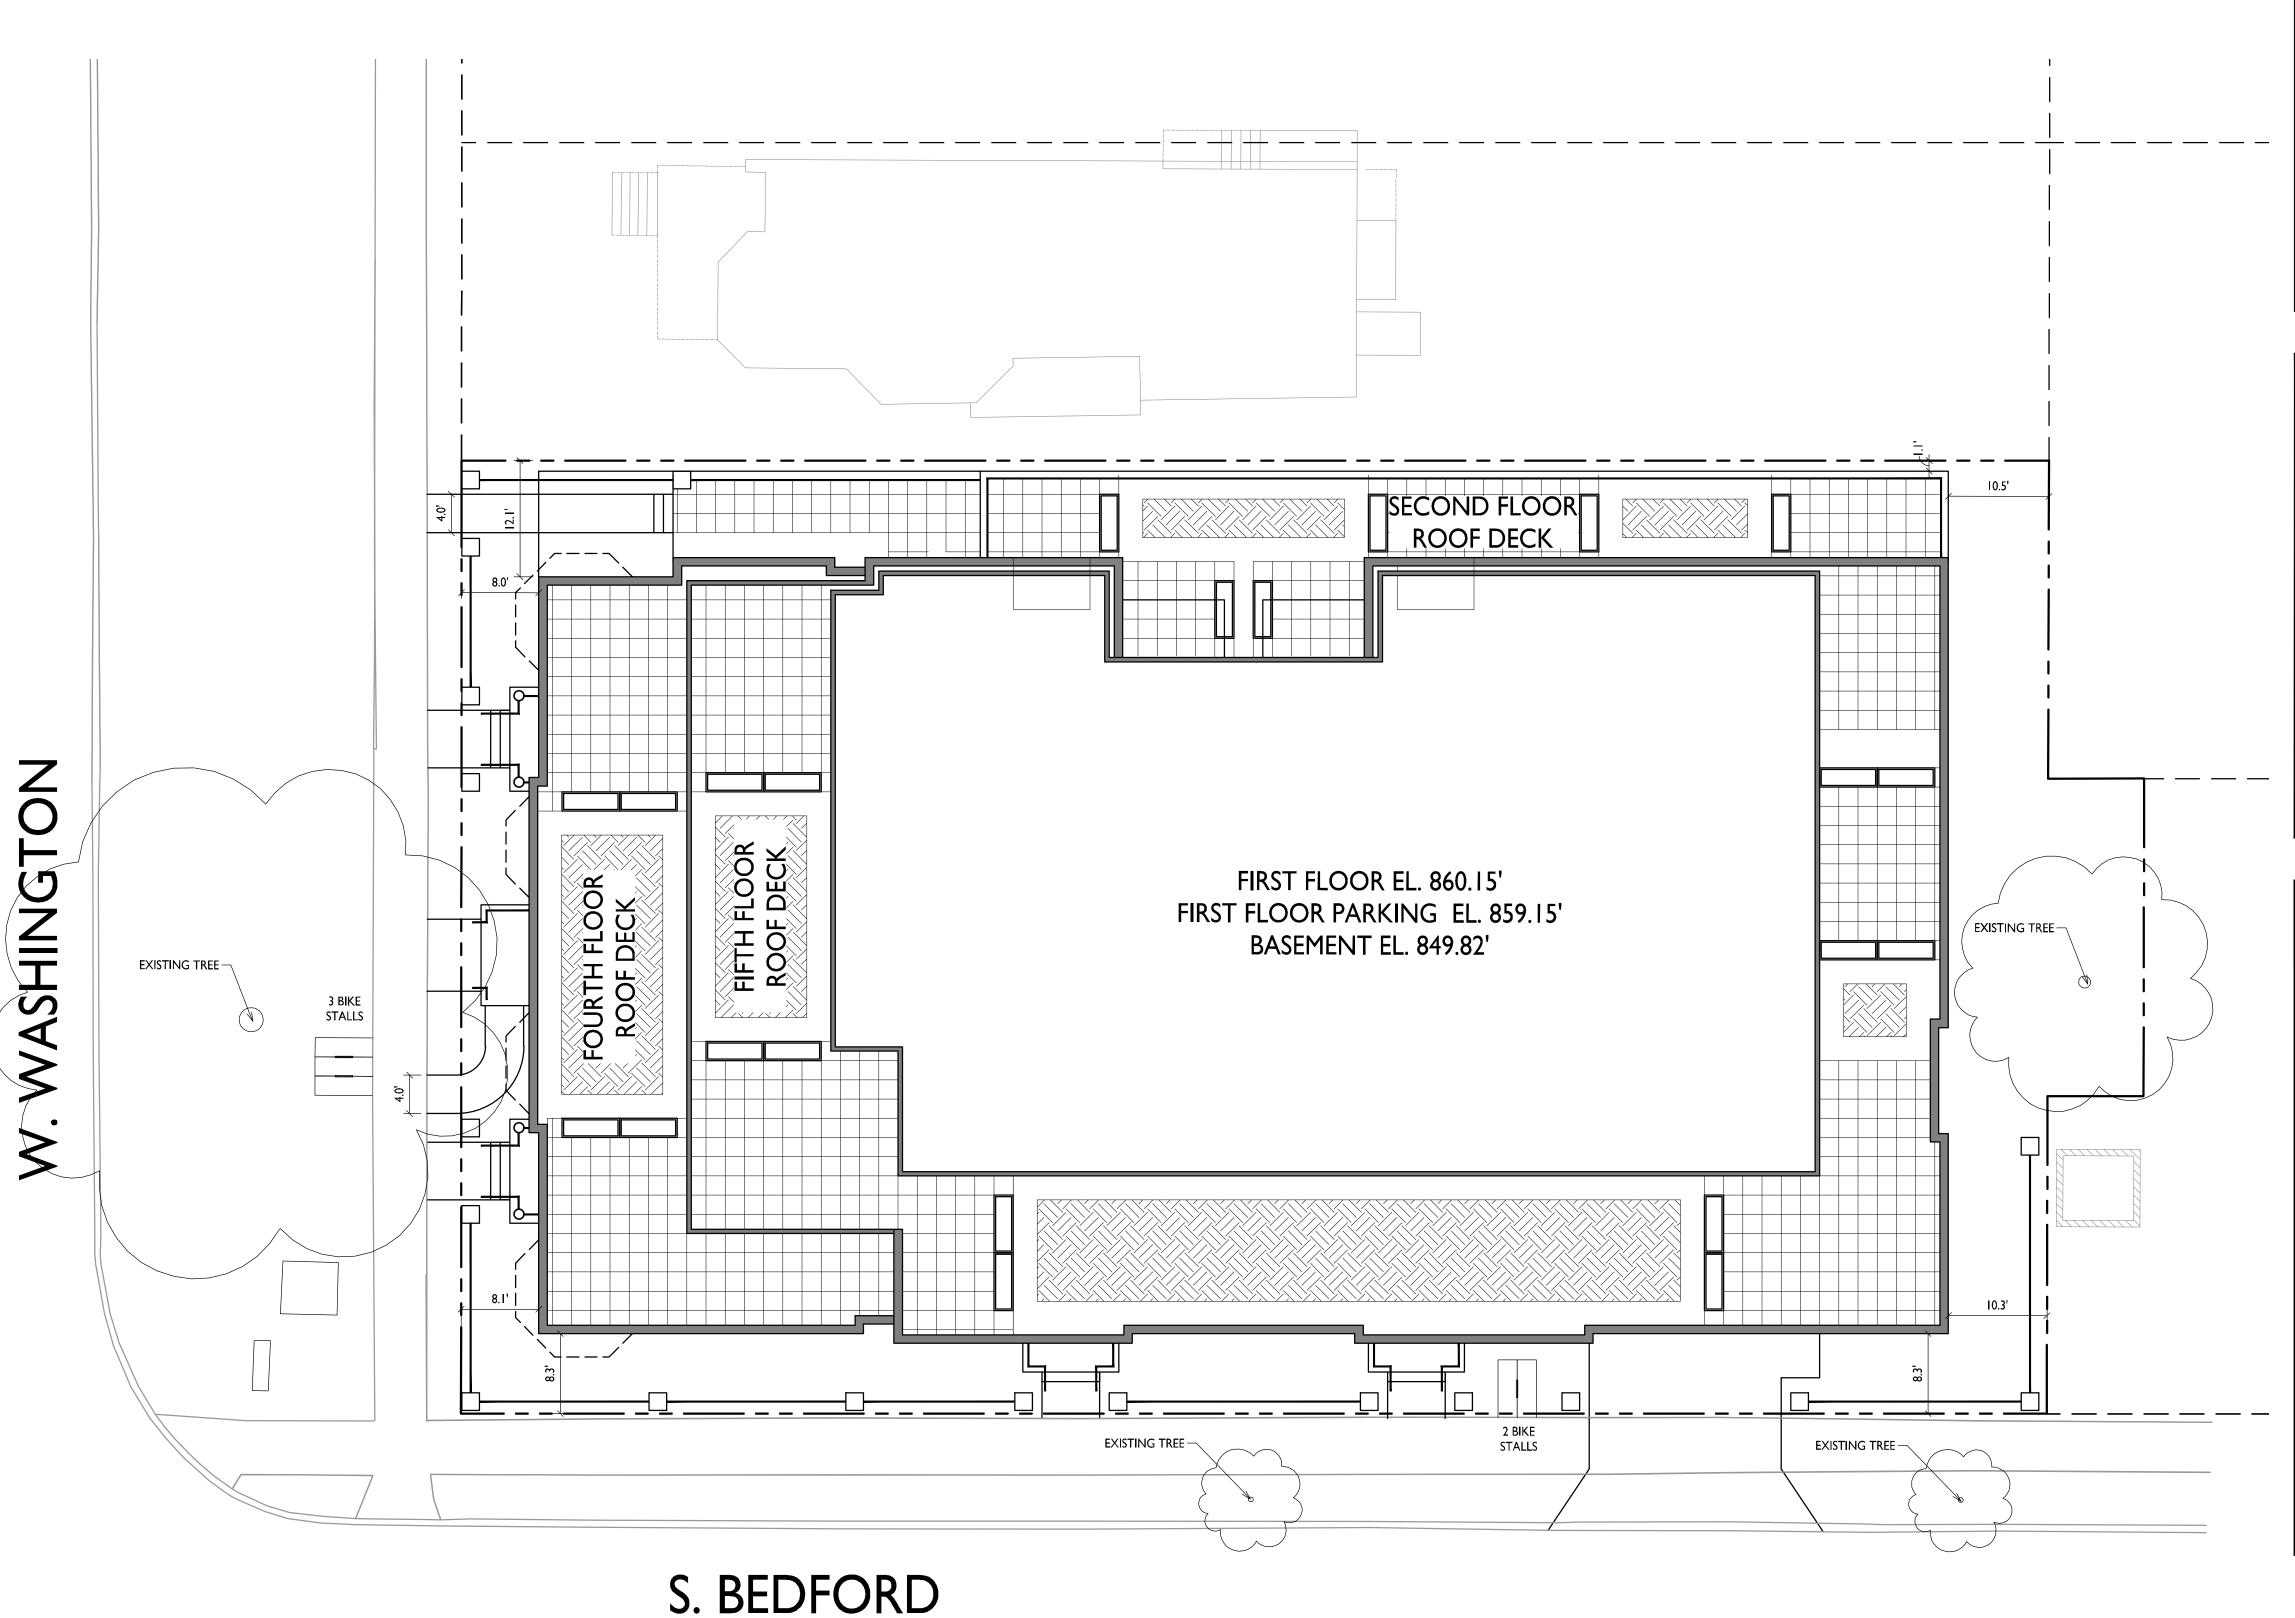


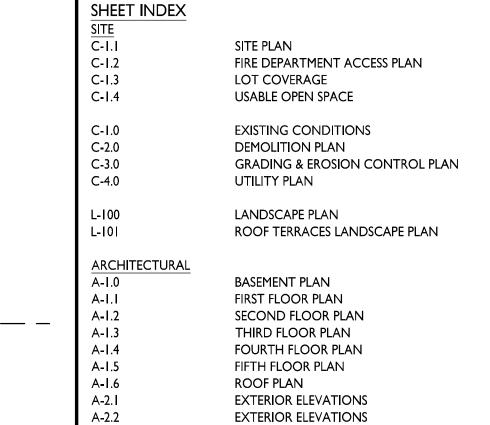












SITE DEVELOPMENT DATA DENSITIES: LOT AREA 16,735 SF / .38 ACRES **DWELLING UNITS** 372 SF / UNIT LOT AREA / D.U. DENSITY 128 UNITS/ACRE **BUILDING HEIGHT** 3-5 STORIES 13,747 S.F. = 82% (90% MAX.) LOT COVERAGE **USABLE OPEN SPACE** 6,348 S.F. (570 S.F. REQ'D) DWELLING UNIT MIX EFFICIENCY ONE BEDROOM TWO BEDROOM TOTAL DWELLING UNITS VEHICLE PARKING: FIRST FLOOR GARAGE **12 STALLS** 33 STALLS 45 STALLS UNDERGROUND **BICYCLE PARKING:** 5 STALLS SURFACE 6 STALLS FIRST FLOOR GARAGE 39 STALLS (STD. 2'X6') 50 STALLS UNDERGROUND GARAGE

TYPICAL UNIT PLANS

TYPICAL UNIT PLANS

GENERAL NOTES:

A-5.1

A-5.2

- THE APPLICANT SHALL REPLACE ALL SIDEWALK AND CURB AND GUTTER WHICH ABUTS THE PROPERTY WHICH IS DAMAGED BY THE CONSTRUCTION OR ANY SIDEWALK AND CURB AND GUTTER WHICH THE CITY ENGINEER DETERMINES NEEDS TO BE REPLACED BECAUSE IT IS NOT AT A DESIRABLE GRADE REGARDLESS OF WHETHER THE CONDITION EXISTED PRIOR TO BEGINNING CONSTRUCTION.
- 2. ALL WORK IN THE PUBLIC RIGHT-OF-WAY SHALL BE PERFORMED BY A CITY LICENSED CONTRACTOR.
- 3. ALL DAMAGE TO THE PAVEMENT, ADJACENT TO THIS DEVELOPMENT SHALL BE RESTORED IN ACCORDANCE WITH THE CITY OF MADISON'S PAVEMENT PATCHING CRITERIA.
- EASEMENT LINES SHOWN ON THIS SHEET ARE FOR GENERAL REFERENCE ONLY SEE CSM AND CIVIL SHEETS FOR ADDITIONAL AND MORE COMPLETE EASEMENT INFORMATION.
- 5. THE RIGHT-OF-WAY IS THE SOLE JURISDICTION OF THE CITY OF MADISON AND IS SUBJECT TO CHANGE AT ANY TIME PER THE RECOMMENDATION OF TRAFFIC ENGINEERING AND CITY ENGINEERING DEPARTMENTS.
- CONTRACTOR SHALL INSTALL TREE PROTECTION FENCING IN THE AREA BETWEEN THE CURB AND SIDEWALK AND EXTEND IT AT LEAST 5 FEET FROM BOTH SIDES OF THE TREE ALONG THE LENGTH OF THE TERRACE. IF EXCAVATION WITHIN 5 FEET OF ANY TREE IS NECESSARY, CONTRACTOR SHALL CONTACT CITY FORESTRY (266-4816) PRIOR TO EXCAVATION TO ASSESS THE IMPACT TO THE TREE AND ROOT SYSTEM. TREE PRUNING SHALL BE COORDINATED WITH CITY FORESTRY PRIOR TO THE START OF CONSTRUCTION. TREE PROTECTION SPECIFICATIONS CAN BE FOUND IN SECTION 107.13 OF THE CITY OF MADISON STANDARD SPECIFICATIONS FOR PUBLIC WORKS CONSTRUCTION. ANY TREE REMOVALS THAT ARE REQUIRED FOR CONSTRUCTION AFTER THE DEVELOPMENT PLAN IS APPROVED WILL REQUIRE AT LEAST A 72 HOUR WAIT PERIOD BEFORE TREE REMOVAL PERMIT CAN BE ISSUED BY FORESTRY, TO NOTIFY THE ALDER OF THE CHANGE IN THE TREE PLAN.

555 W Washington Ave.

ARCHITECTS

Phone: 7601 University Ave, Ste 201

608.836.3690 Middleton, WI 53562

ISSUED

Issued for Land Use - June 20, 2018

SHEET TITLE
Site Plan

PROJECT TITLE

BAXTER

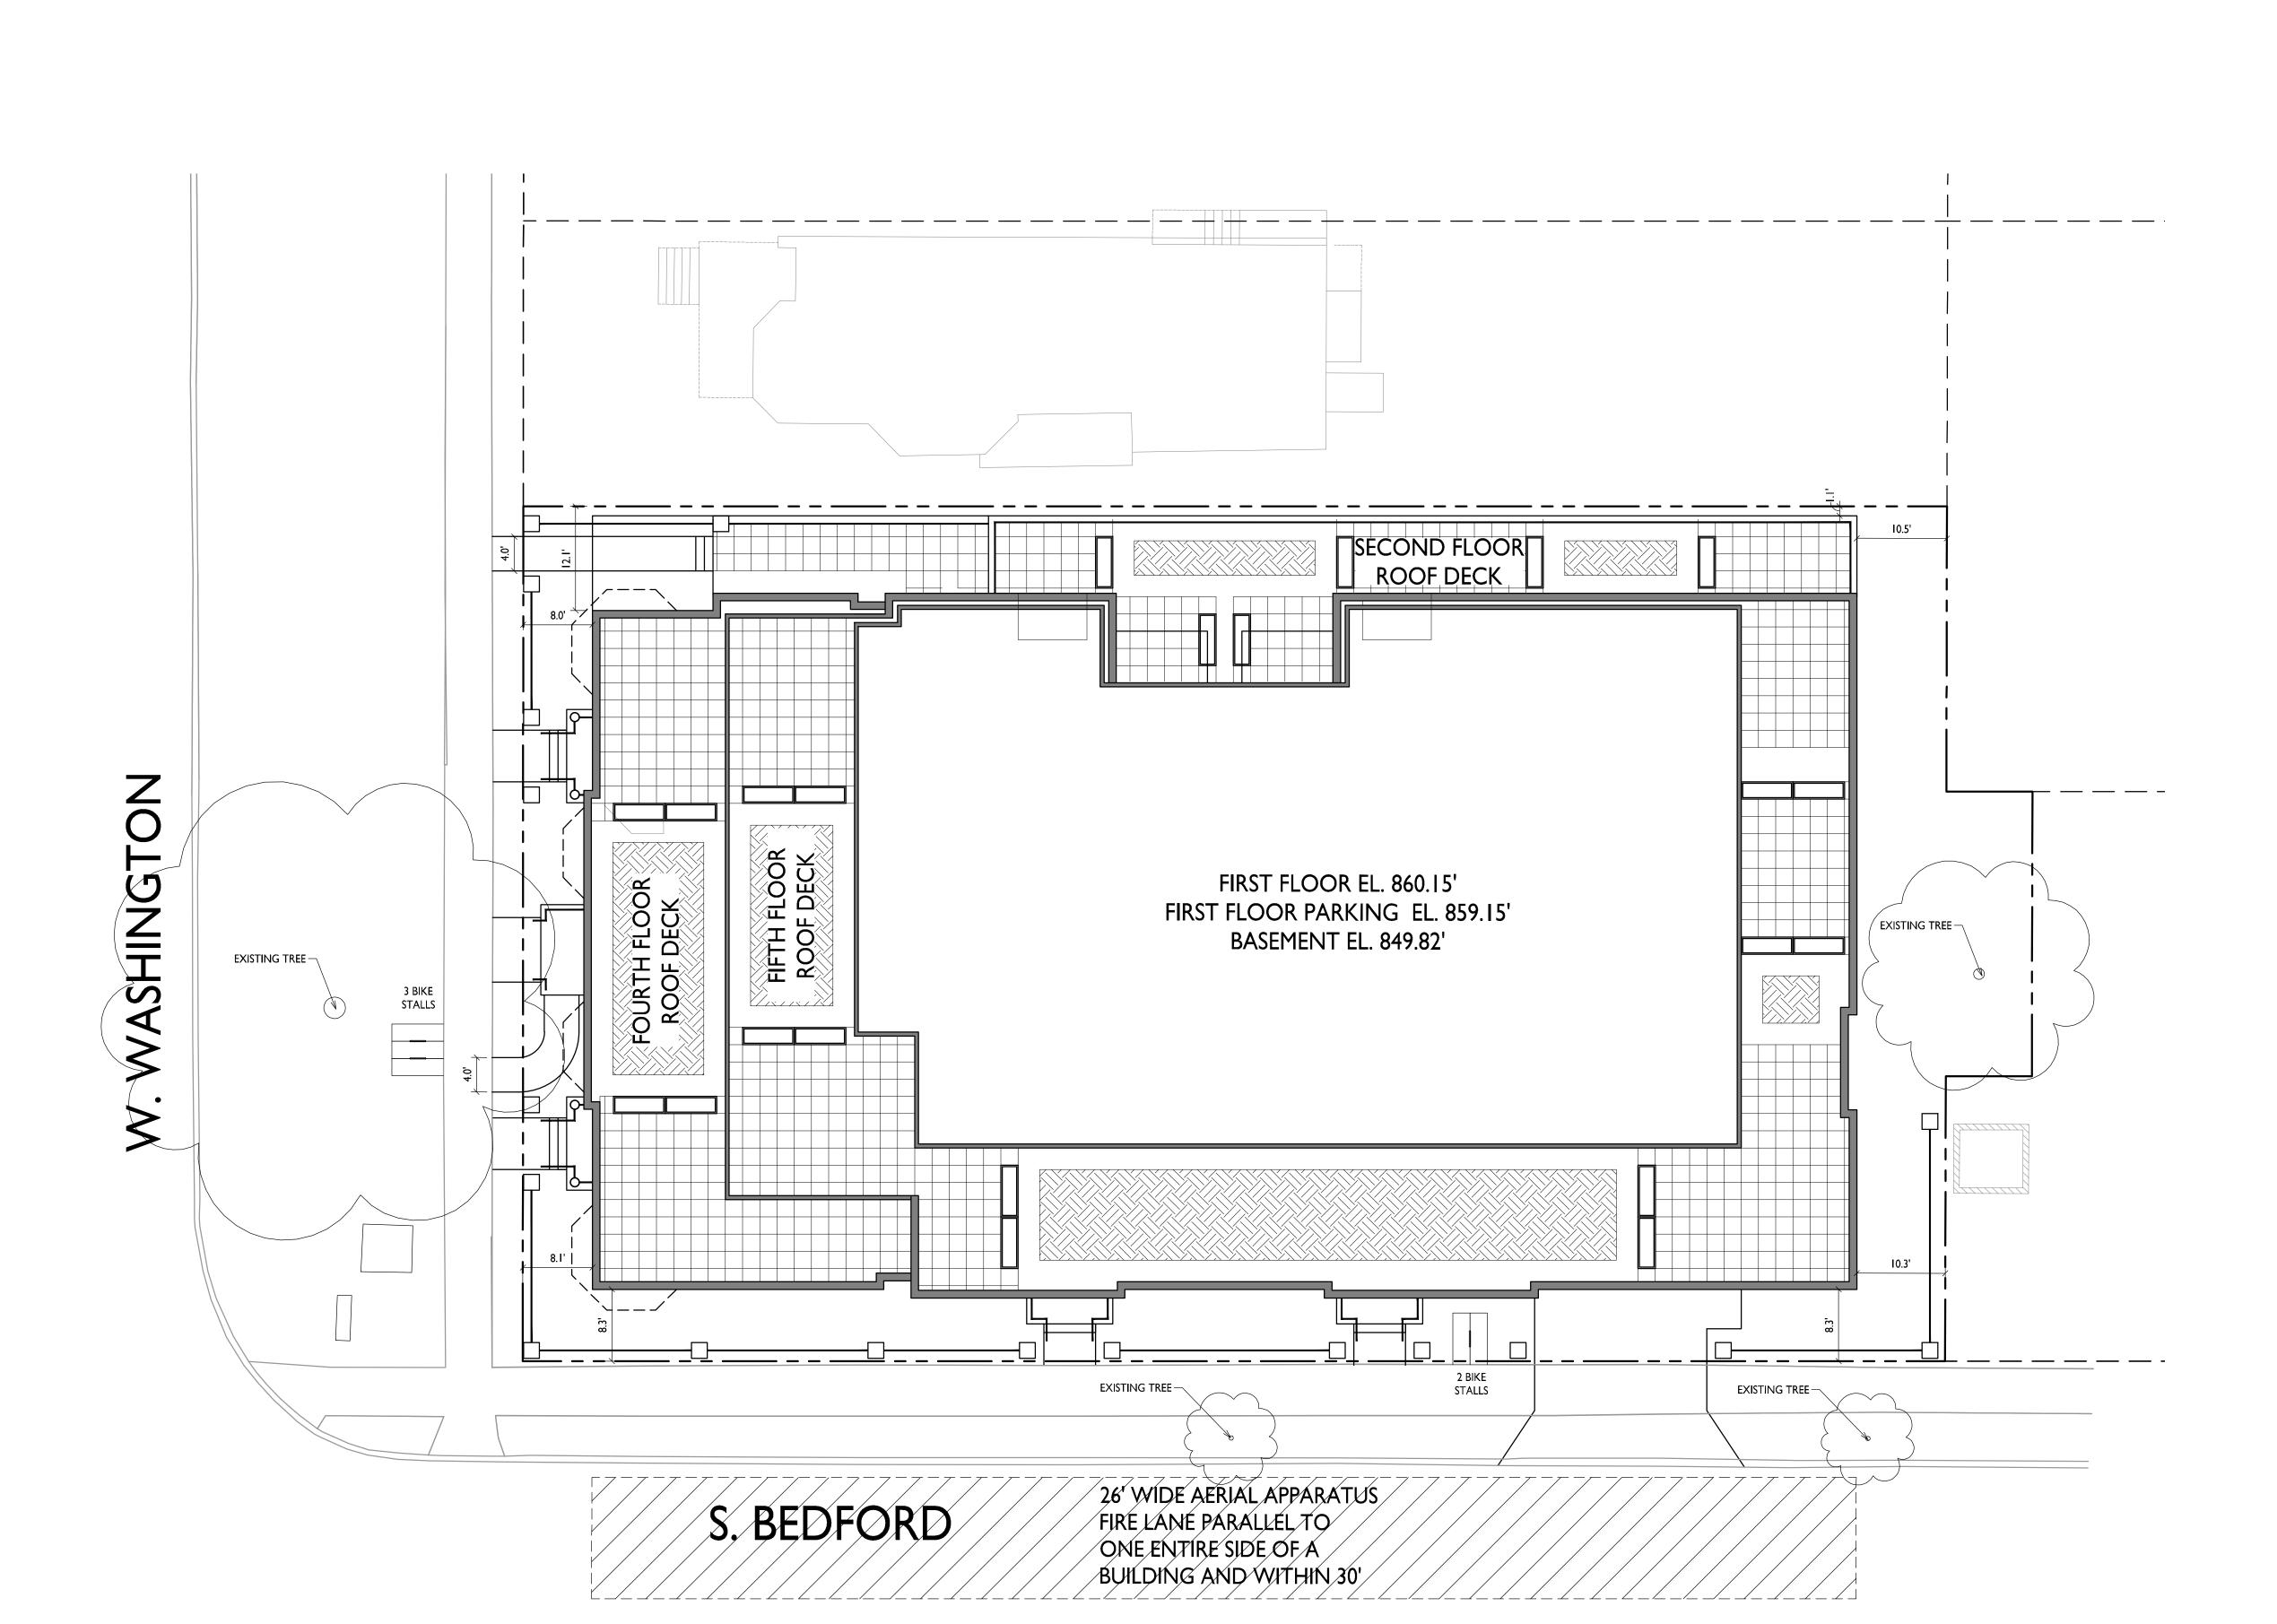
West Washington Development

SHEET NUMBER

C-I.I

PROJECT NO.

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PROJECT TITLE
BAXTER
West Washington
Development

555 W Washington Ave.

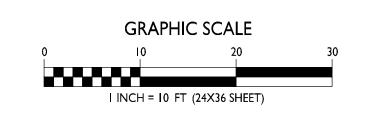
SHEET TITLE
Fire Department
Access Plan

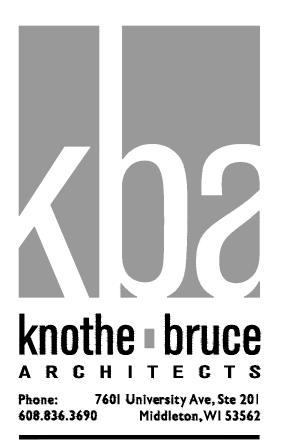
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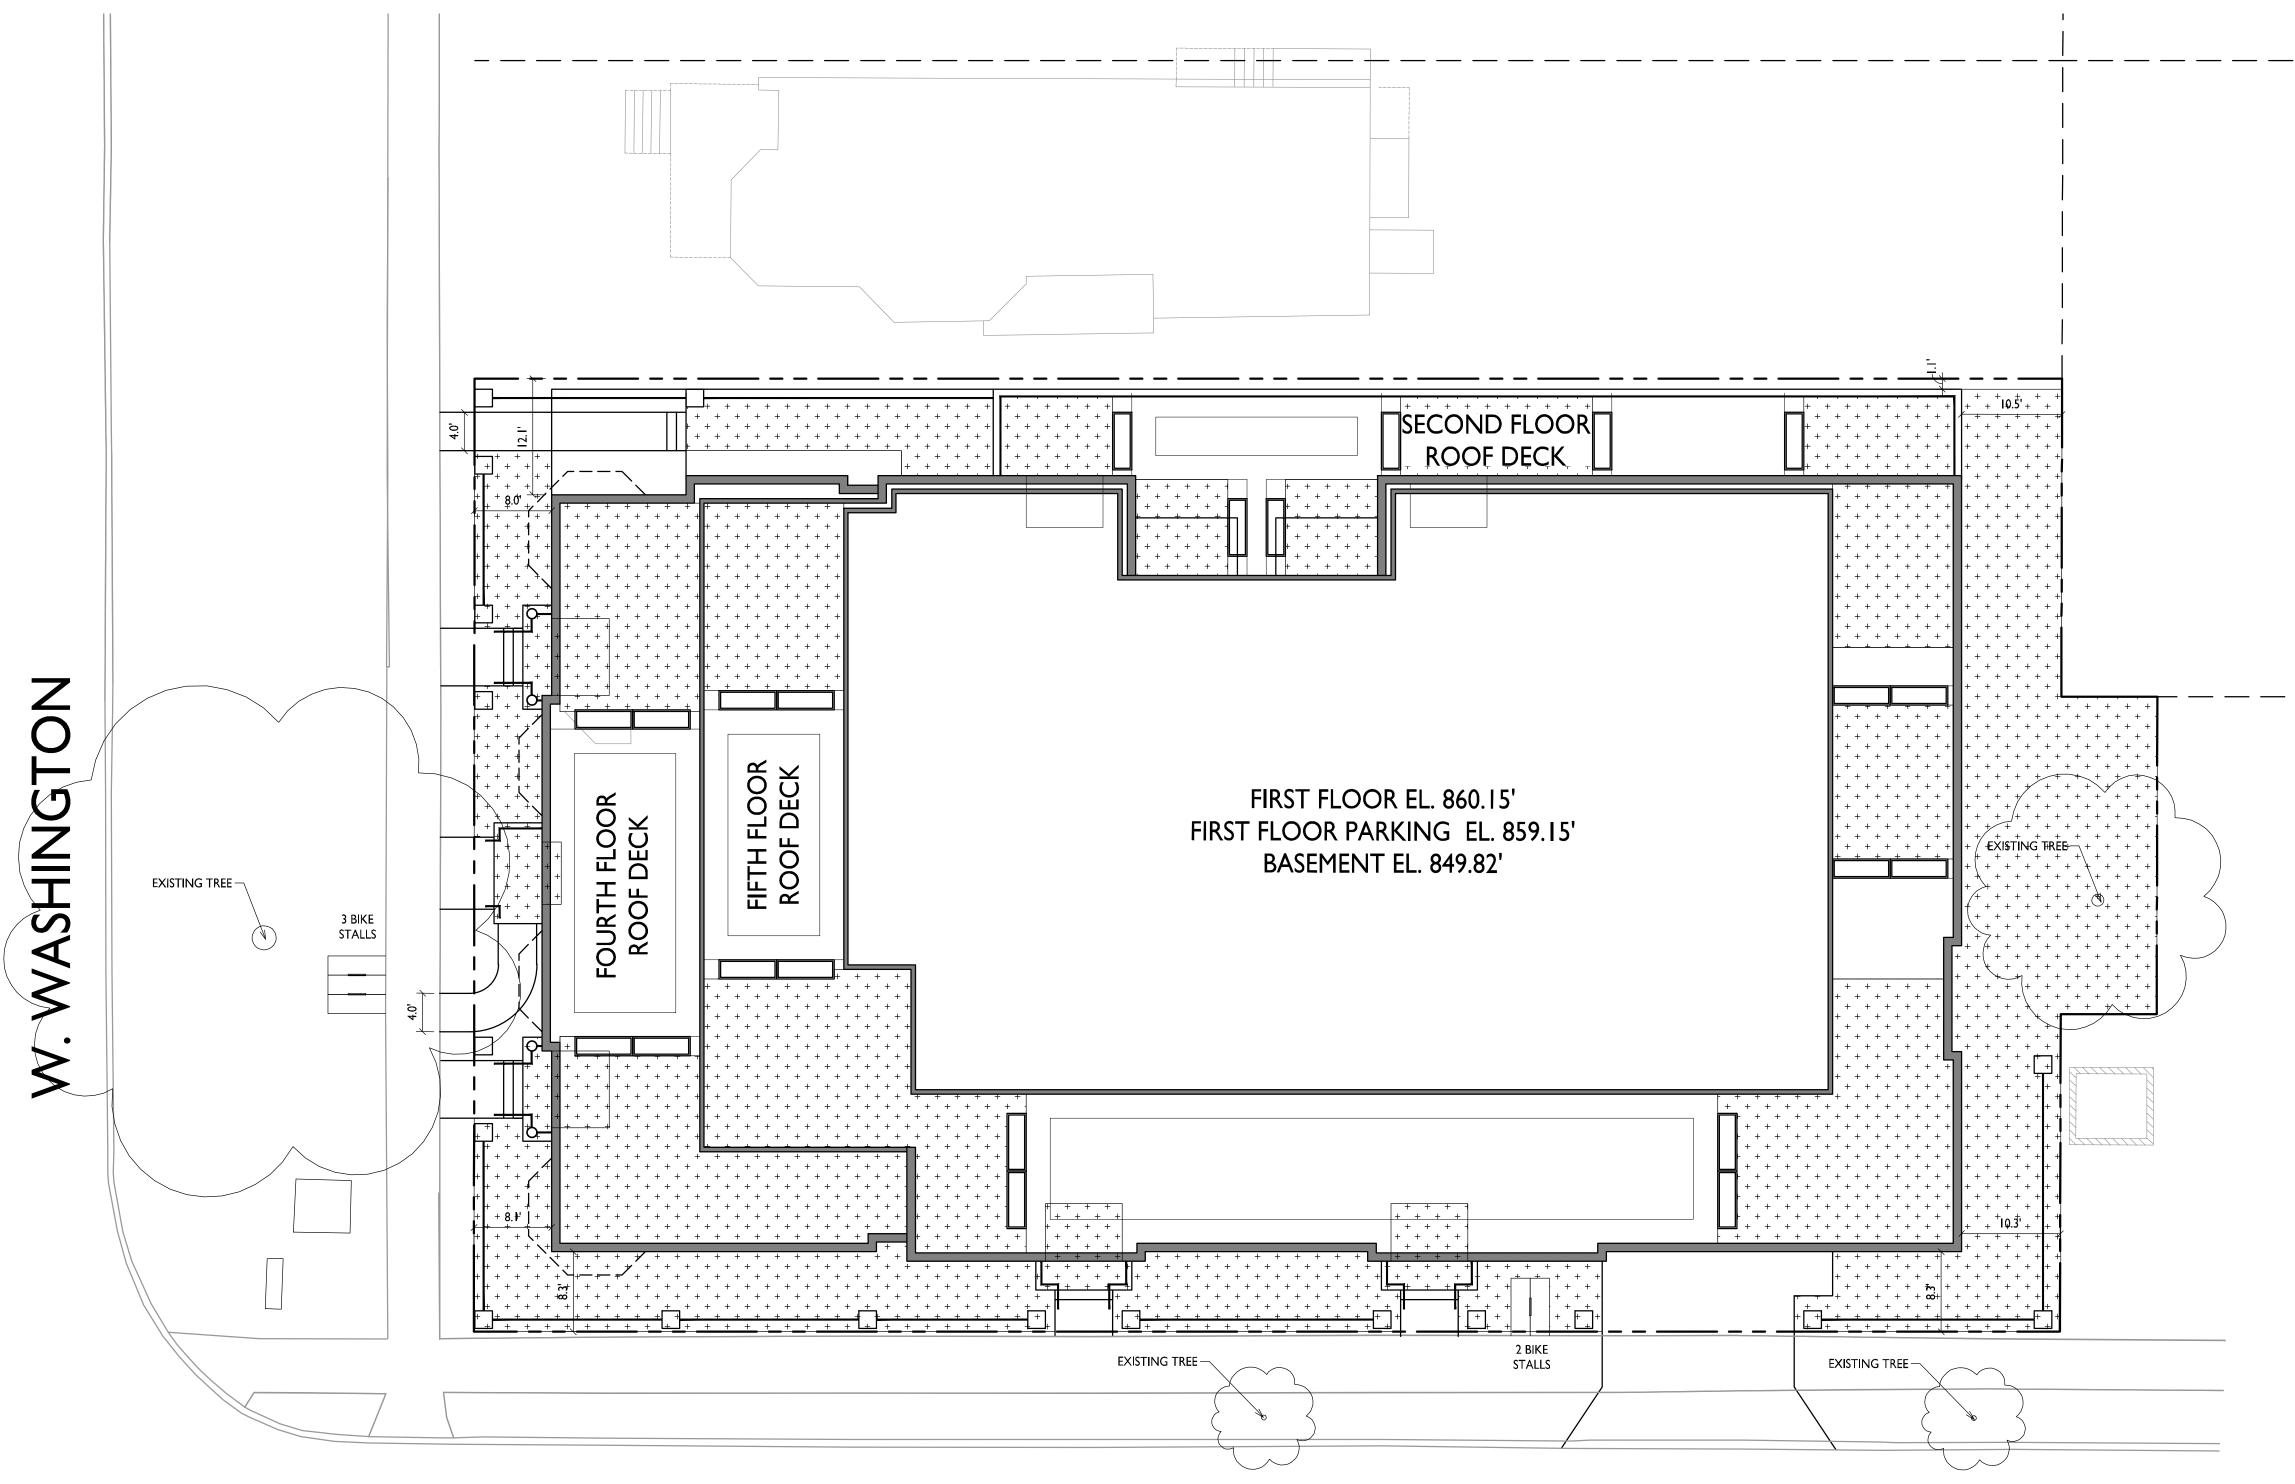
C-1.2

PROJECT NO. | 7 |
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USABLE OPEN SPACE

ZONING: UMX

REQUIRED OPEN SPACE: 10 S.F. / BEDROOM

DWELLING UNITS: 45 BEDROOMS: 57

10 X 57 = 570 S.F. OPEN SPACE REQUIRED

OPEN SPACE PROVIDED:

BALCONIES/ROOF TERRACES: 3,719 S.F.
SURFACE: 2,629 S.F.
TOTAL: 6,348 S.F.

ISSUED Issued for Land Use - June 20, 2018

PROJECT TITLE
BAXTER
West Washington
Development

555 W Washington Ave.

SHEET TITLE

Usable Open

SHEET NUMBER

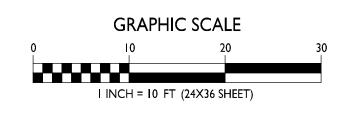
Space

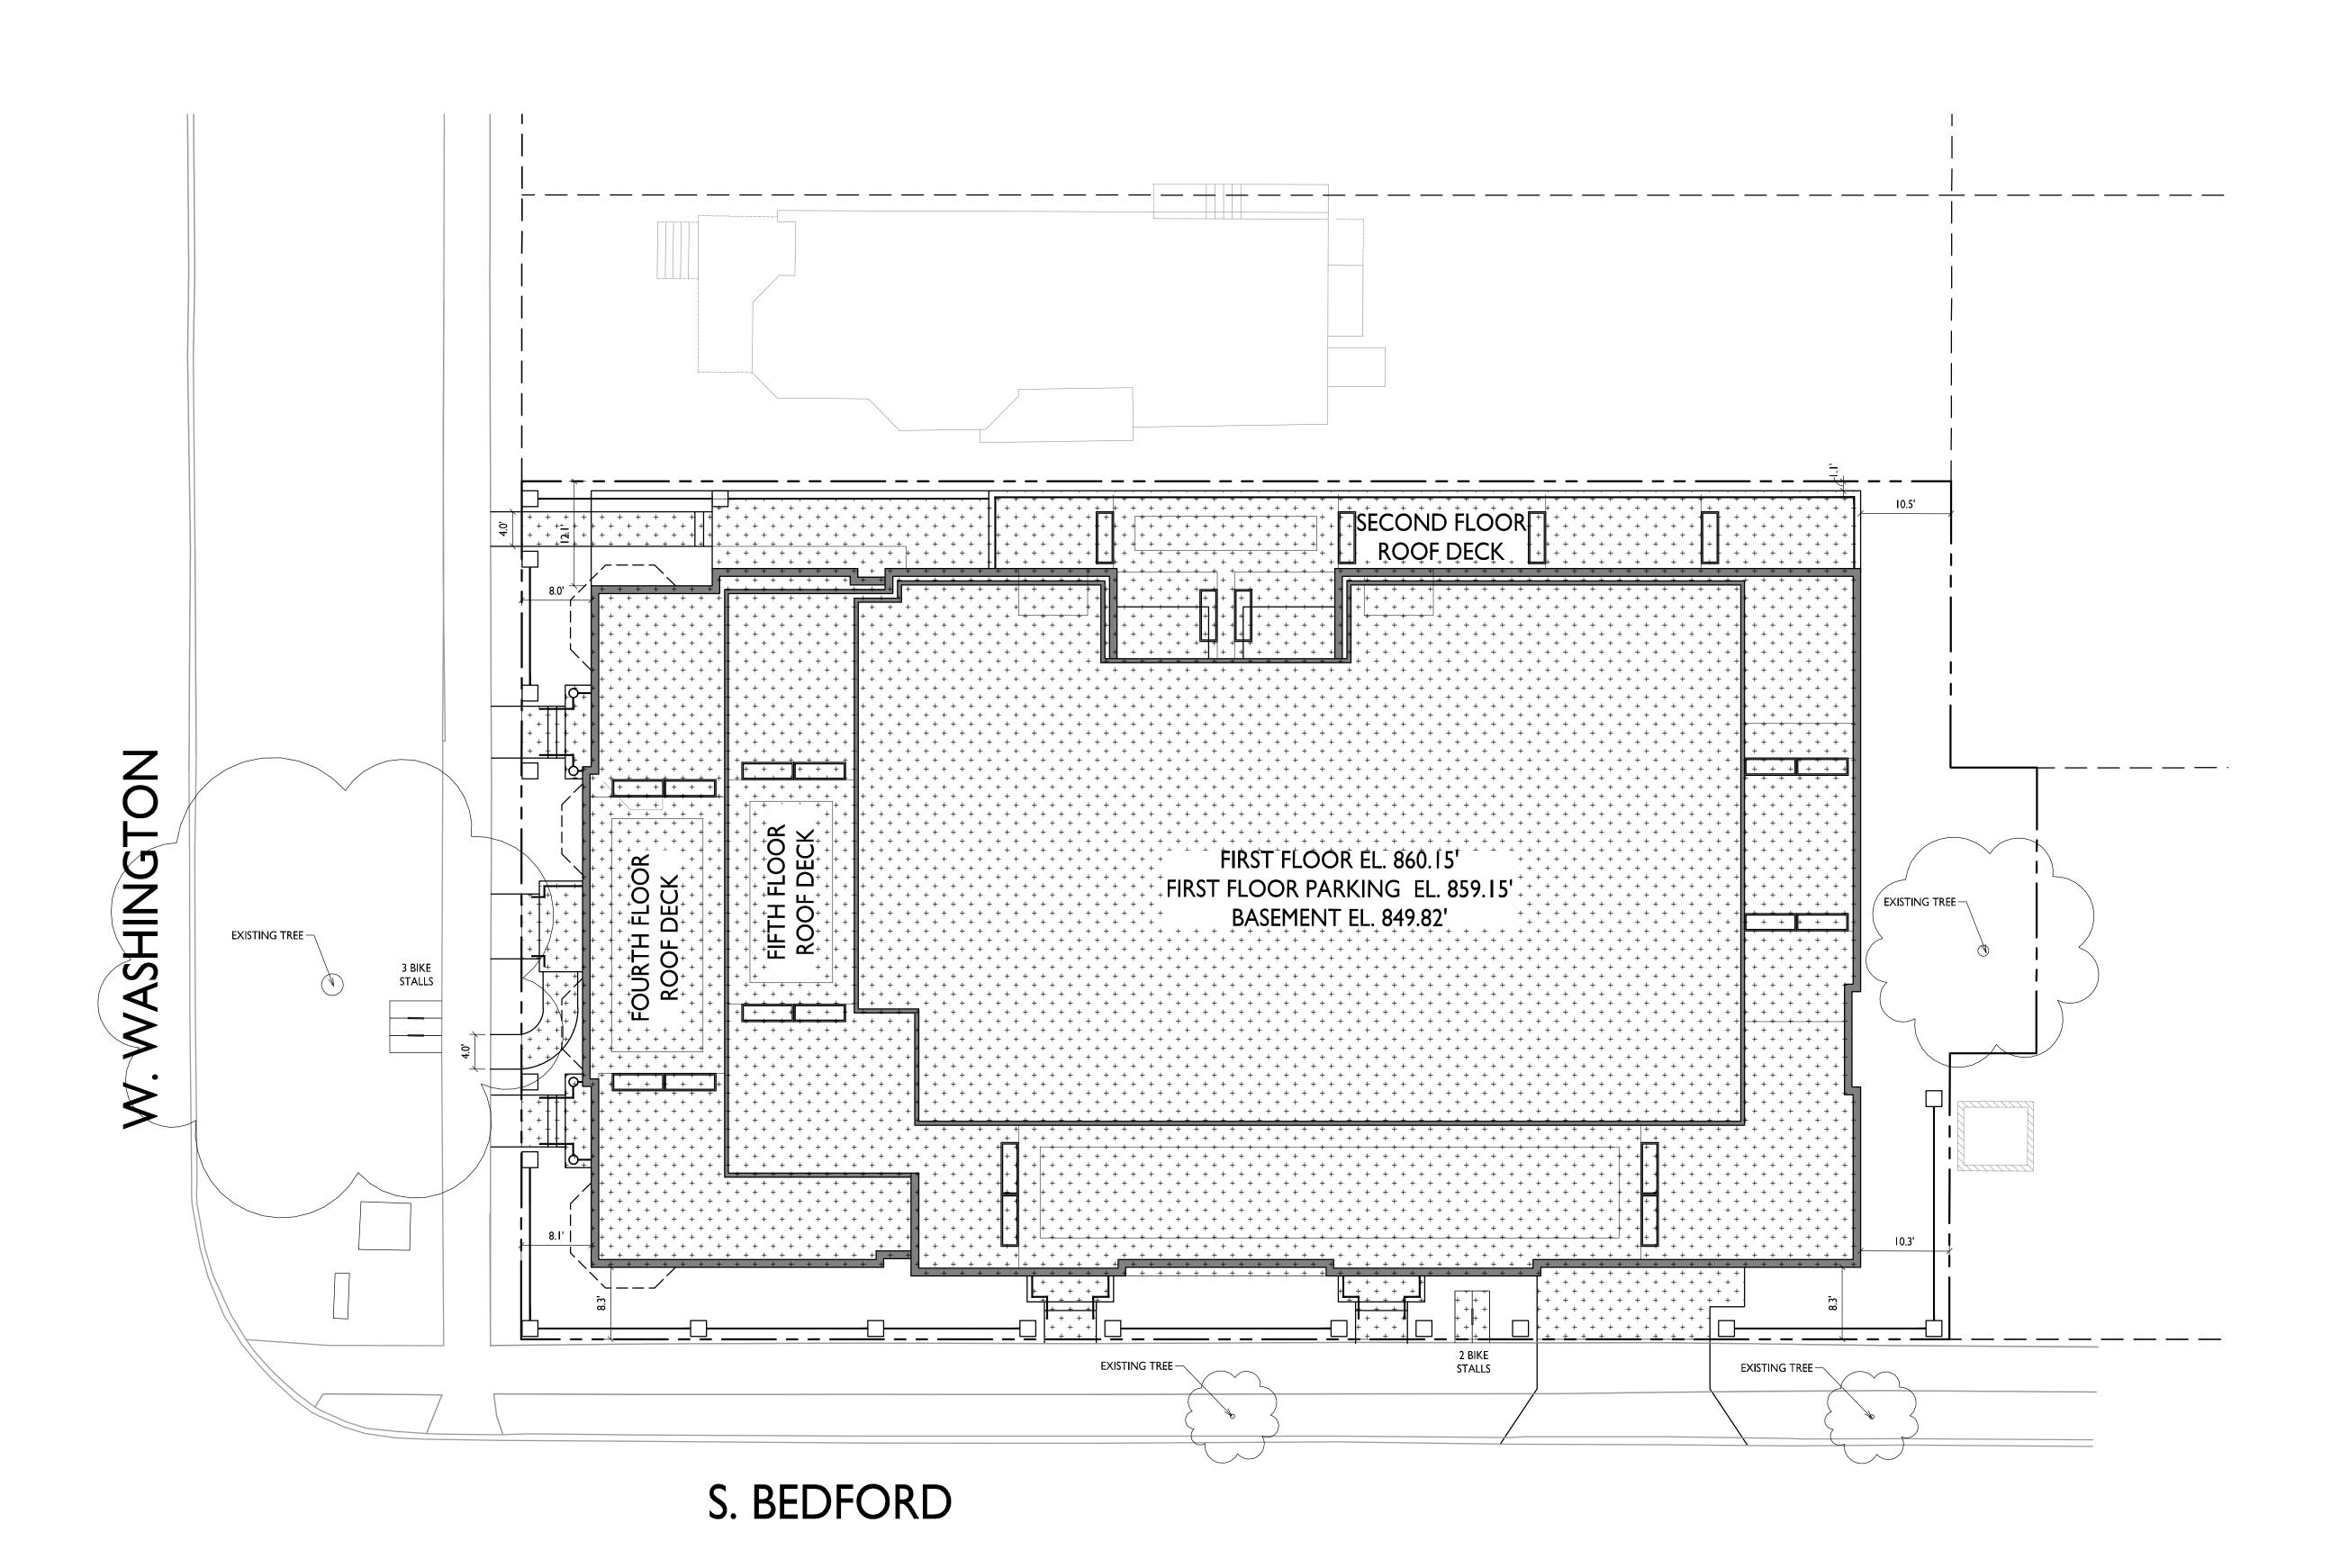
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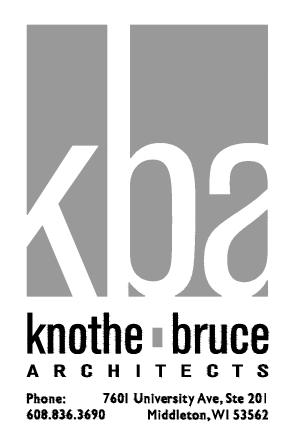
PROJECT NO. 7

S. BEDFORD









PROJECT TITLE

SHEET TITLE

Lot Coverage

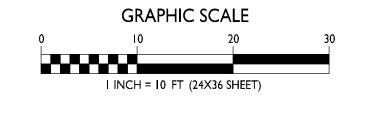
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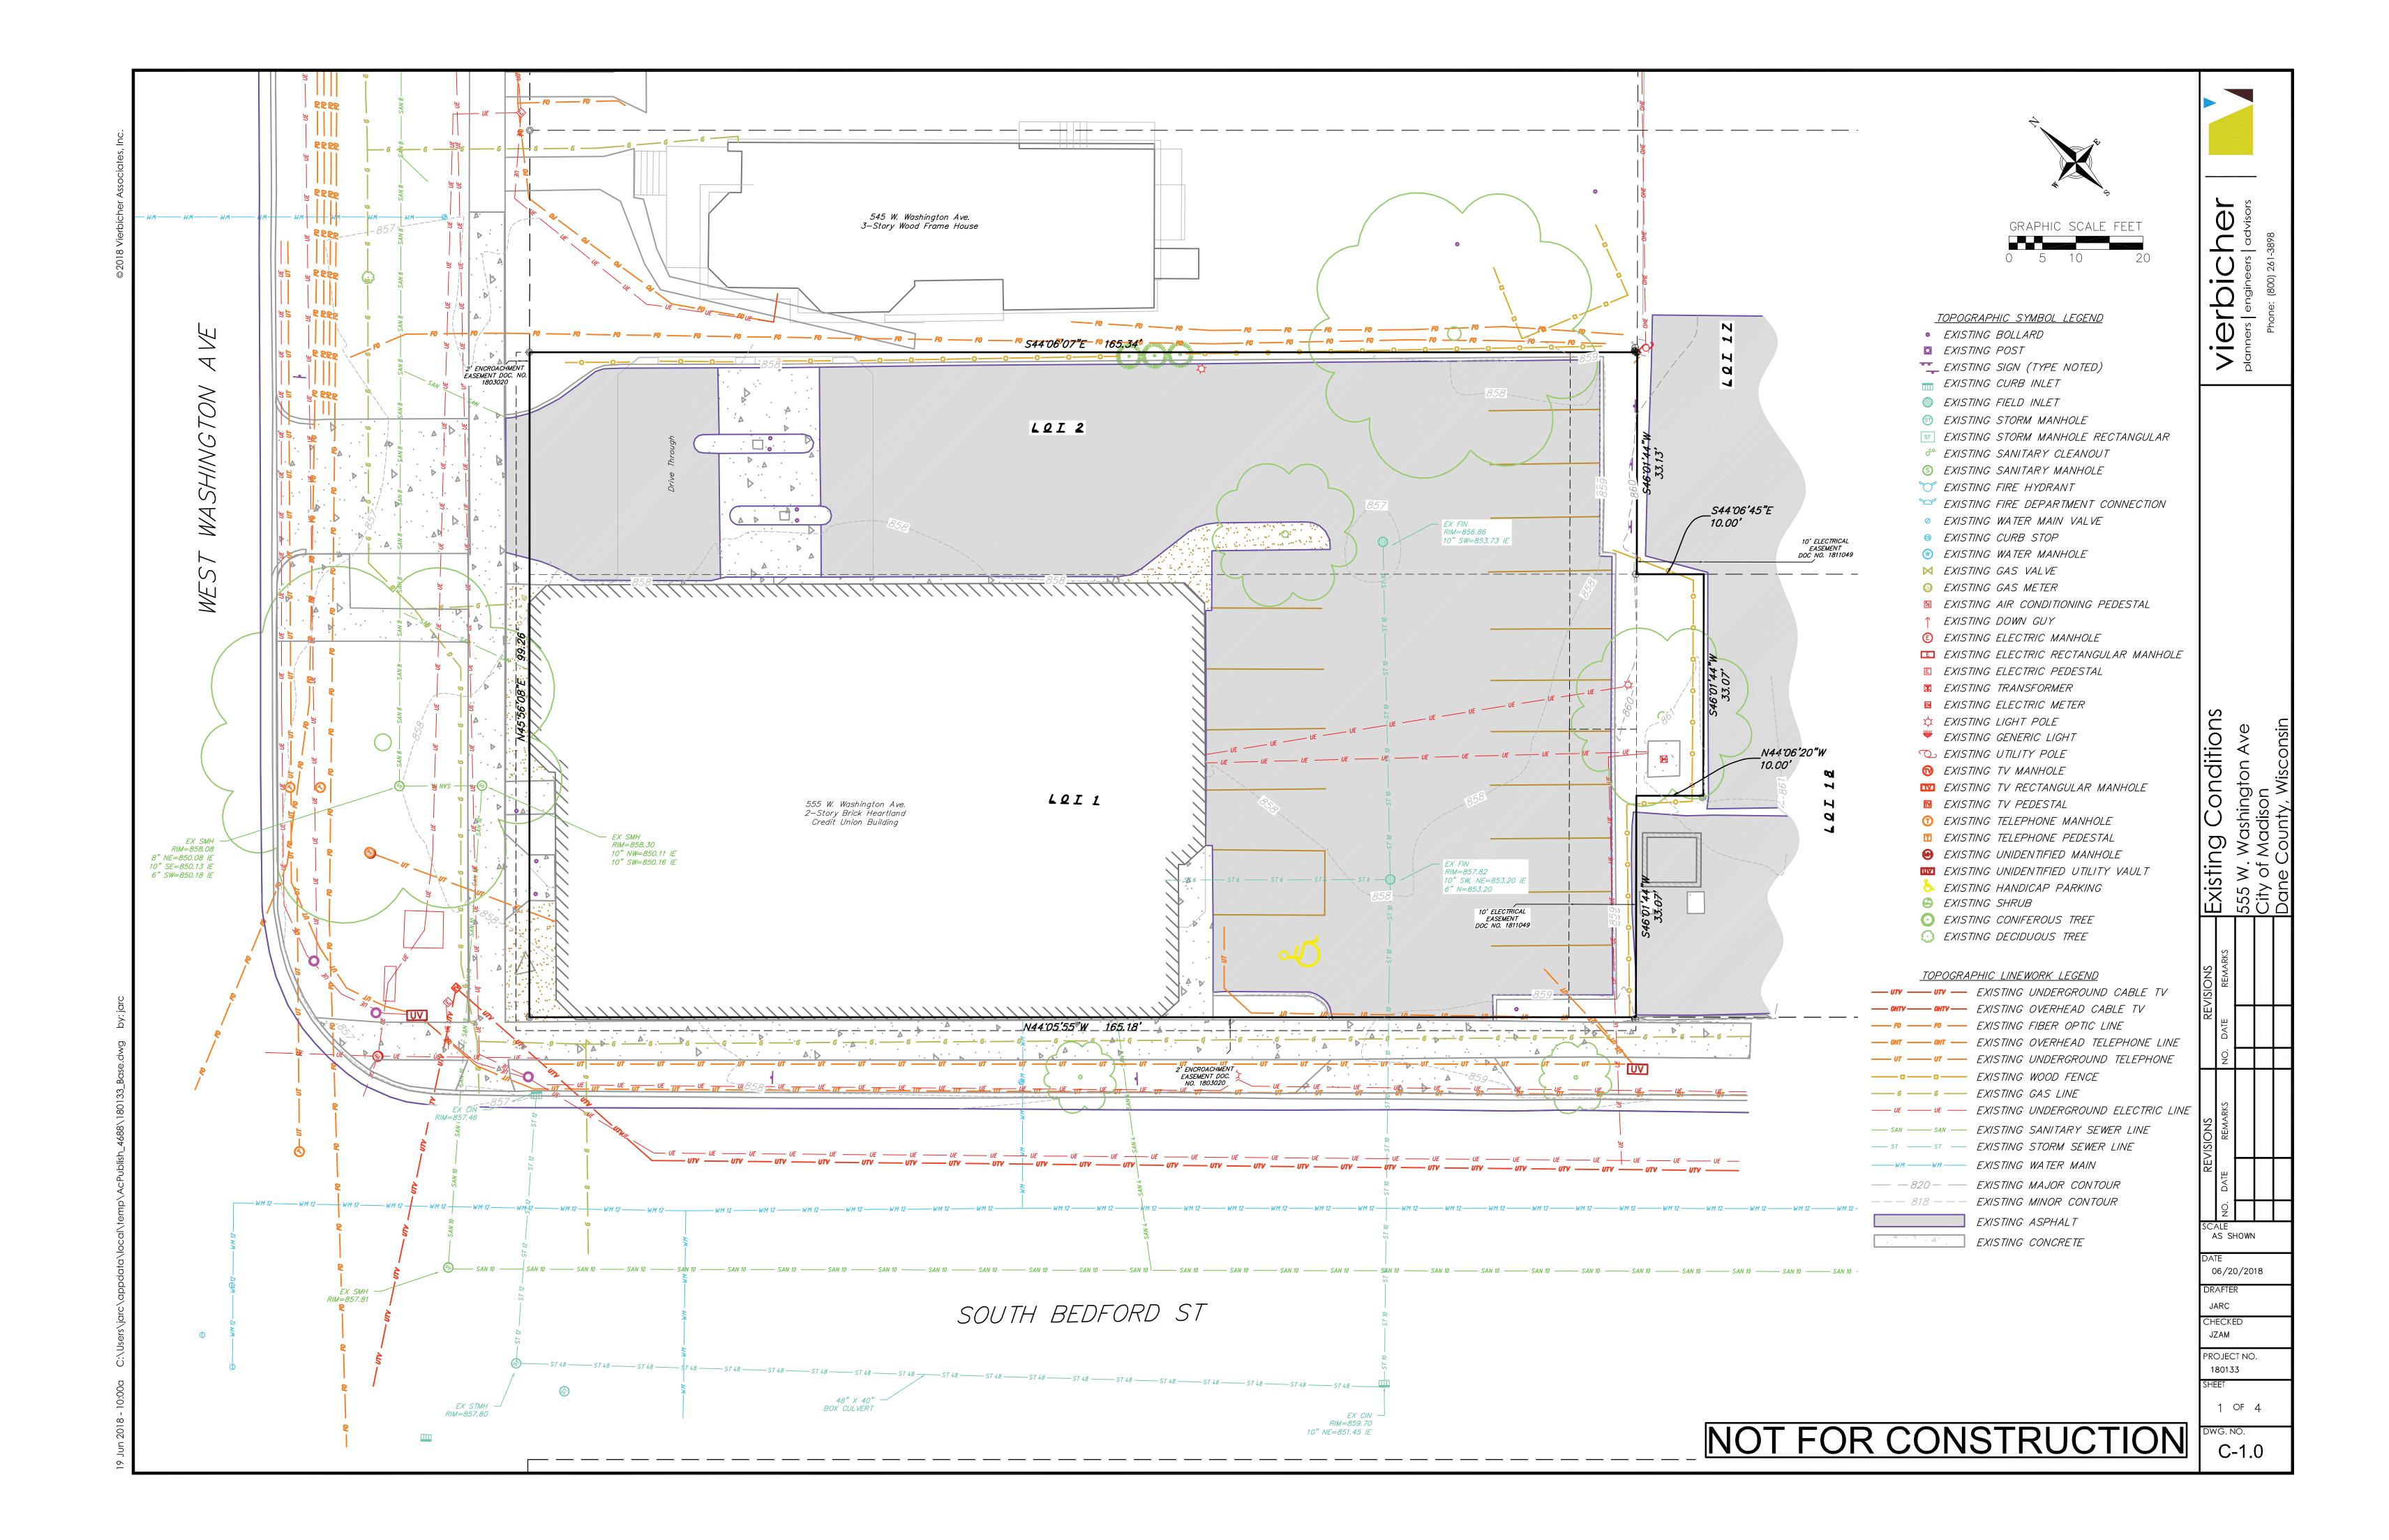
C-1.4

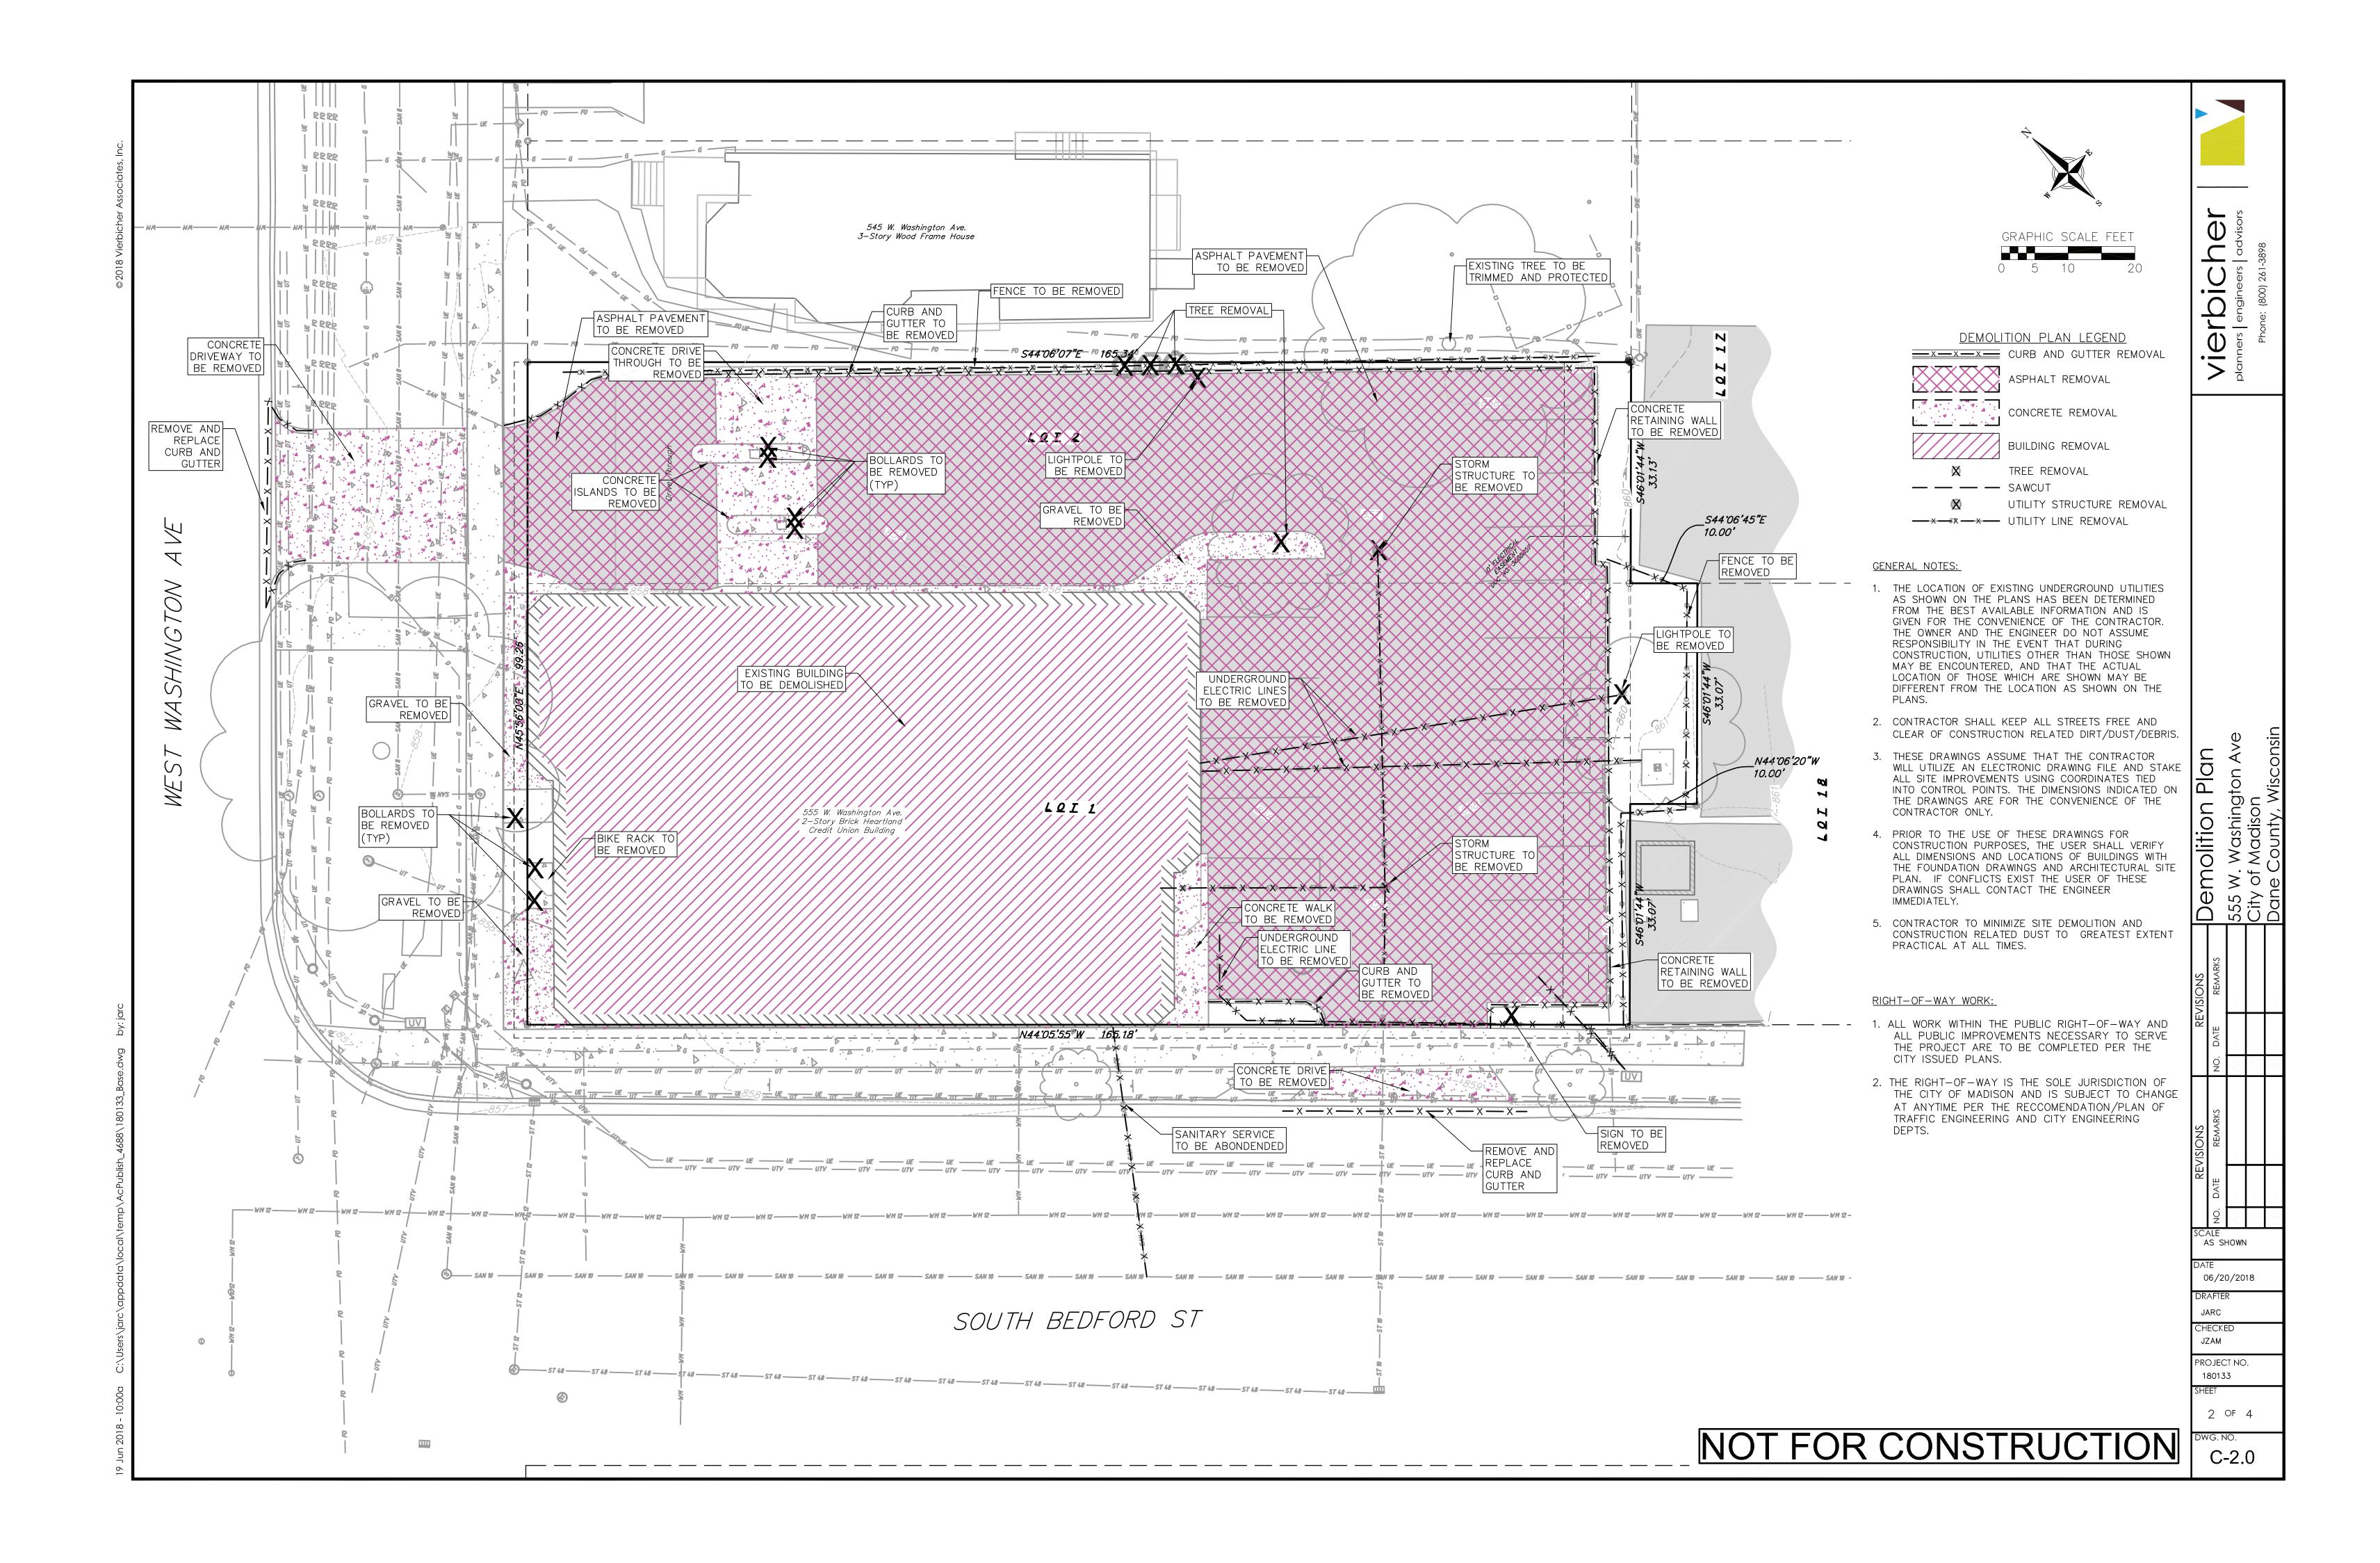
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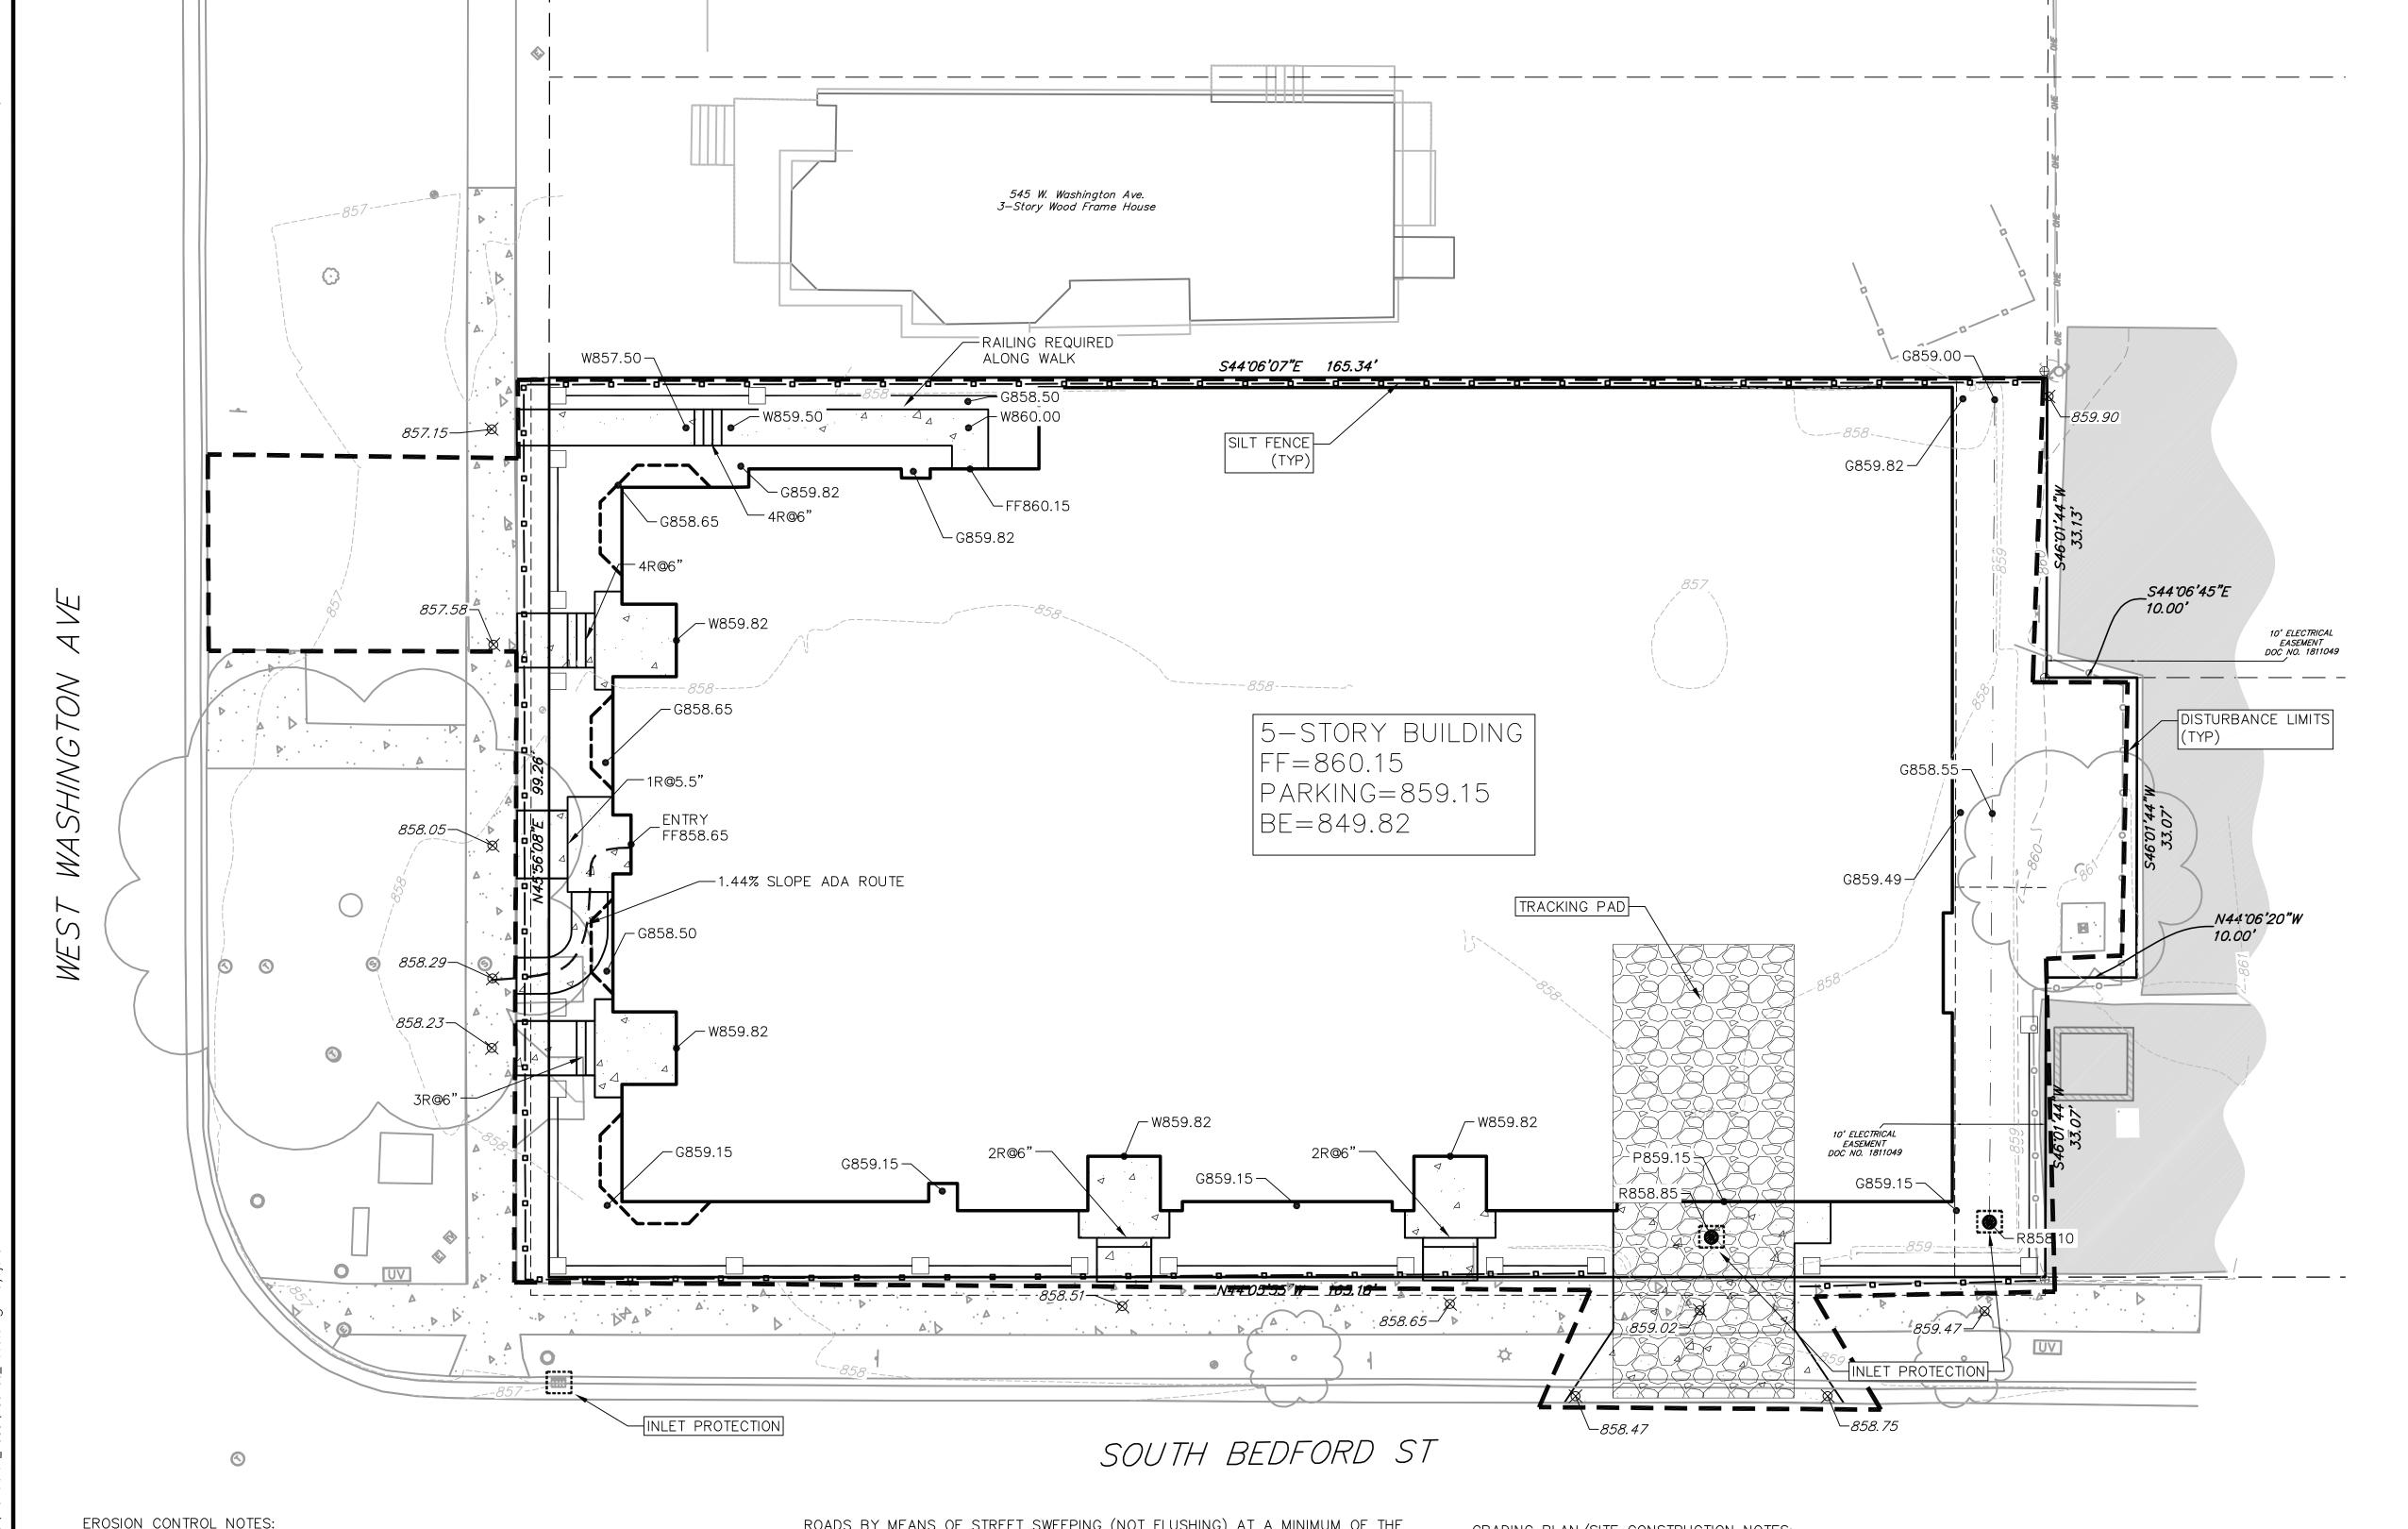
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GRAPHIC SCALE FEET

GRADING AND EROSION CONTROL LEGEND --820-- EXISTING MAJOR CONTOURS EXISTING MINOR CONTOURS

 DITCH CENTERLINE - SILT FENCE/SILT SOCK DISTURBED LIMITS - ADA ACCESSIBLE ROUTE DRAINAGE DIRECTION

2.92% PROPOSED SLOPE ARROWS EXISTING SPOT ELEVATIONS PROPOSED SPOT ELEVATIONS

INLET PROTECTION TRACKING PAD

<u>ABBREVIATIONS</u> TC - TOP OF CURB

P - PAVEMENT
W - TOP OF WALK
R - RISER
FF - FINISHED FLOOR G — GROUND FF - FINISHED FLOOR
BE - BASEMENT ELEVATION
R - RIM

EROSION CONTROL NOTES:

- 1. CONTRACTOR SHALL KEEP ALL CITY STREETS FREE AND CLEAR OF CONSTRUCTION RELATED DIRT/DUST/DEBRIS.
- 2. INSTALL A 50'L X 20'W X 1.5'D TRACKING PAD AT THE SITE ENTRANCE. THE TRACKING PAD SHALL BE MAINTAINED/REPAIRED AS NECESSARY TO ACCOMMODATE CONSTRUCTION.
- 3. THE CONTRACTOR IS REQUIRED TO MAKE EROSION CONTROL INSPECTIONS AT THE END OF EACH WEEK AND WHEN 0.5 INCHES OF RAIN FALLS WITHIN 24 HOURS. INSPECTION REPORTS SHALL BE PREPARED AND FILED AS REQUIRED BY THE DNR. ALL MAINTENANCE/REPAIR WILL FOLLOW AN INSPECTION WITHIN 24 HOURS.
- 4. INSTALL WISDOT TYPE D INLET PROTECTION IN EXISTING CURB INLETS AND WISDOT TYPE A IN FIELD INLETS.
- 5. ANY DAMAGE TO THE CITY PAVEMENT, INCLUDING DAMAGE RESULTING FROM CURB REPLACEMENT, WILL REQUIRE RESTORATION IN ACCORDANCE WITH THE CITY
- 6. THE CONTRACTOR SHALL REMOVE ANY SEDIMENT TRACKED ONTO ADJACENT

ROADS BY MEANS OF STREET SWEEPING (NOT FLUSHING) AT A MINIMUM OF THE END OF EACH WORK DAY OR MORE AS NEEDED.

7. SEE DETAIL SHEETS FOR ADDITIONAL EROSION CONTROL NOTES.

RIGHT-OF-WAY WORK:

- 1. ALL WORK WITHIN THE PUBLIC RIGHT-OF-WAY AND ALL PUBLIC IMPROVEMENTS NECESSARY TO SERVE THE PROJECT ARE TO BE COMPLETED PER THE CITY ISSUED PLANS.
- 2. THE RIGHT-OF-WAY IS THE SOLE JURISDICTION OF THE CITY OF MADISON AND IS SUBJECT TO CHANGE AT ANYTIME PER THE RECCOMENDATION/PLAN OF TRAFFIC ENGINEERING AND CITY ENGINEERING DEPTS.

GRADING PLAN/SITE CONSTRUCTION NOTES:

- 1. CONCRETE SIDEWALK TO BE 5" THICK, CONSTRUCTED ON A BASE OF 4" COMPACTED SAND OR CRUSHED STONE.
- 2. CONTRACTOR TO OBTAIN ANY NECESSARY UTILITY CONNECTION, DEMOLITION, DRIVEWAY CONNECTION, RIGHT-OF-WAY AND EXCAVATION PERMITS PRIOR TO CONSTRUCTION.
- 3. ANY SIDEWALK AND CURB & GUTTER ABUTTING THE PROPERTY SHALL BE REPLACED IF IT IS DAMAGED DURING CONSTRUCTION OR IF THE CITY ENGINEERING DEPARTMENT DETERMINES THAT IT IS NOT AT A DESIRABLE GRADE, REGARDLESS OF WHETHER THE CONDITION EXISTED PRIOR TO BEGINNING CONSTRUCTION.
- 4. TYPICAL SIDEWALK CROSS SECTION IS 1.5% SLOPE. THIS APPLIES TO ALL WALKWAYS IN THIS PLAN UNLESS OTHERWISE NOTED.

NOT FOR CONSTRUCTION

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Erosion

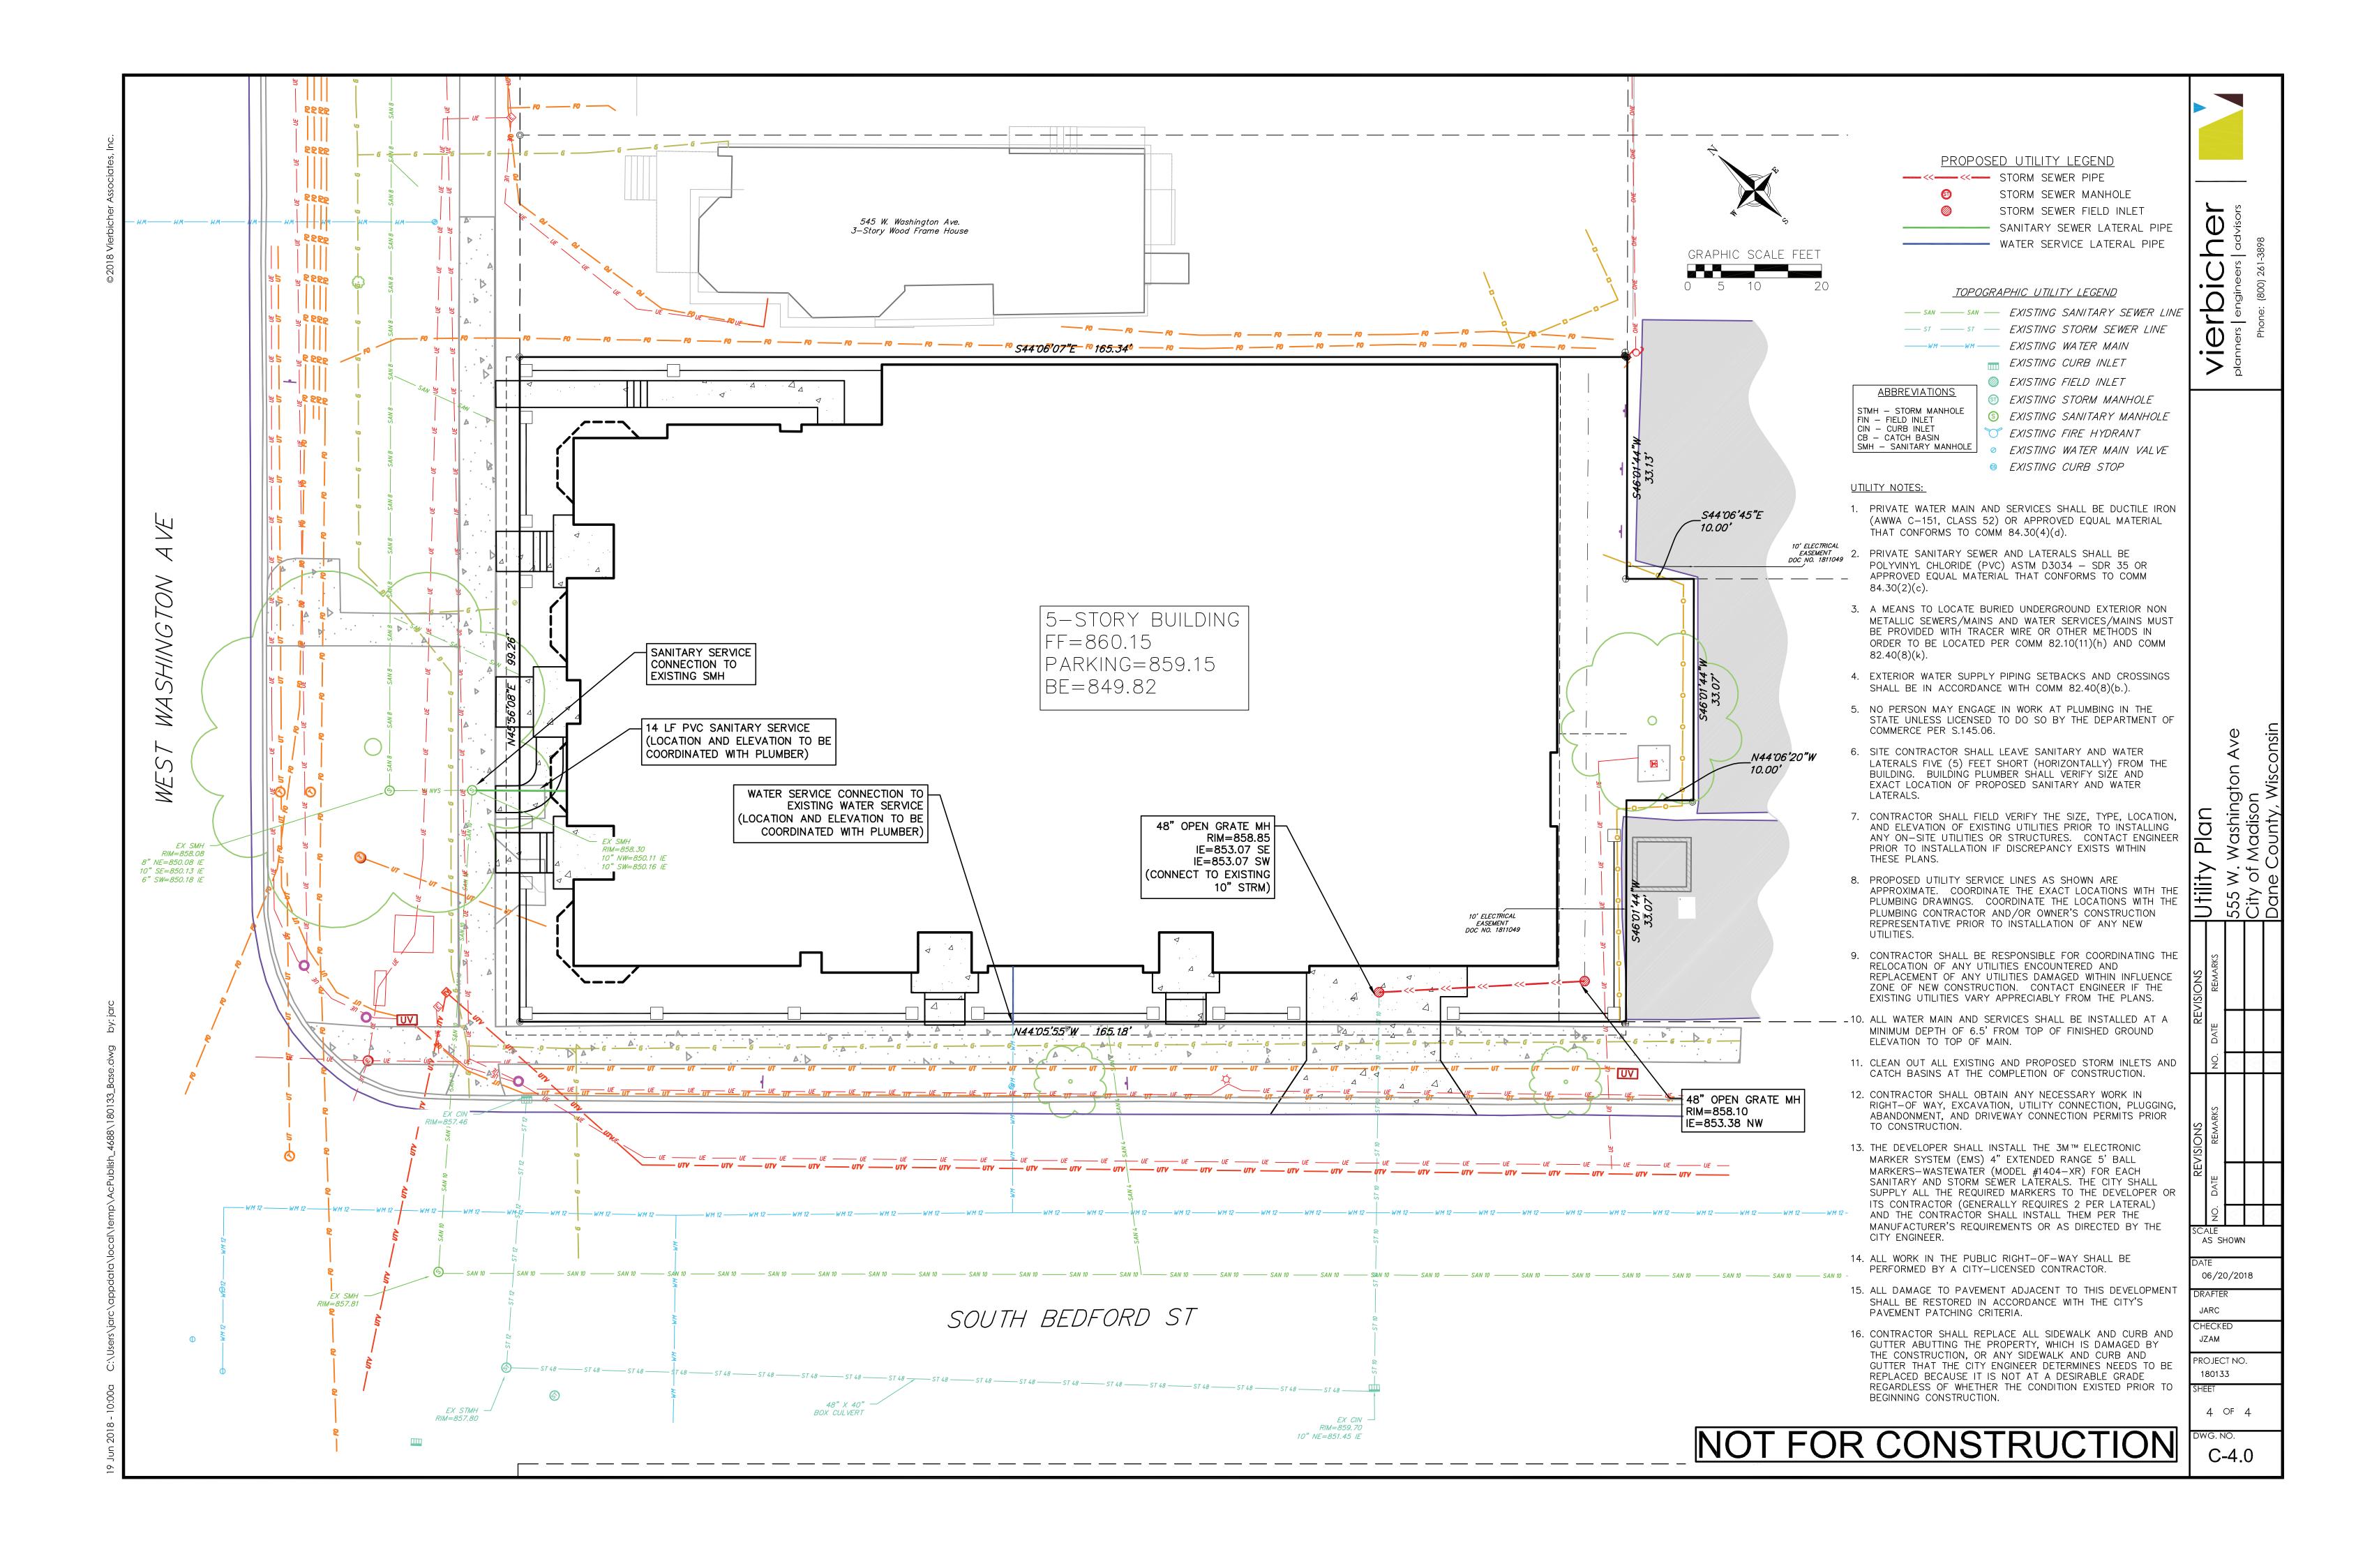
SCALE AS SHOWN

06/20/2018 JARC

CHECKED JZAM PROJECT NO. 180133

3 OF 4

C-3.0



NOTES 1. IT IS THE CONTRACTOR'S RESPONSIBILITY TO FIELD VERIFY SURVEY INFORMATION AND SITE CONDITIONS PRIOR TO START OF CONSTRUCTION AND REPORT ANY DISCREPANCIES. CONTRACTOR SHALL CONTACT DIGGER'S HOTLINE TO LOCATE ALL PUBLIC AND PRIVATE UTILITIES PRIOR TO START OF CONSTRUCTION. ANY DAMAGE CAUSED TO EXISTING UTILITIES, EITHER SHOWN OR NOT, SHALL BE REPAIRED AND PAID FOR AT THE CONTRACTOR'S EXPENSE. 2. CONTRACTOR SHALL PROTECT BENCHMARKS. 3. ALL TREES SHOWN TO BE RETAINED WITHIN THE PUBLIC RIGHT-OF-WAY SHALL BE PROTECTED DURING CONSTRUCTION WITH TREE PROTECTION FENCING. ALL TREE PROTECTION FENCING SHALL BE IN PLACE PRIOR TO ANY SITE WORK. PERFORM ALL WORK IN THE RIGHT-OF-WAY IN ACCORDANCE WITH CITY OF MADISON STANDARD 107.13 "TREE PROTECTION SPECIFICATION". 4. ALL EXISTING PLANT MATERIAL IS SHOWN AT EXISTING, APPROXIMATED SIZE PER CITY OF MADISON STANDARDS. 5. ALL WRAPPINGS, WIRE BASKETS, BURLAP, AND OTHER MISCELLANEOUS MATERIAL SHALL BE COMPLETELY REMOVED FROM ALL SHRUB AND TREE ROOT BALLS PRIOR TO INSTALLATION. 6. ALL LAWN AREAS DISTURBED BY CONSTRUCTION ACTIVITIES SHALL BE RE-SEEDED AT NO COST TO OWNER. 7. CONTRACTOR IS RESPONSIBLE FOR WATERING AND MAINTENANCE OF PLANT MATERIAL.

CONTRACTOR PER CITY STANDARD SPECIFICATIONS.

EXCAVATION IS PERMITTED WITHIN 5-FEET OF THE

10. CONTRACTOR SHALL INSTALL TREE PROTECTION FENCING IN THE AREA BETWEEN THE CURB AND SIDEWALK AND EXTEND IT AT LEAST 5-FEET FROM BOTH SIDES OF THE TREE ALONG THE LENGTH OF THE TERRACE. NO

OUTSIDE EDGE OF A TREE TRUNK. IF EXCAVATION WITHIN

5-FEET OF ANY TREE IS NECESSARY, CONTRACTOR SHALL CONTACT CITY FORESTRY (BRAD HOFMANN, 266-4816)

PRIOR TO EXCAVATION TO ASSESS THE IMPACT TO THE TREE AND ROOT SYSTEM. TREE PRUNING SHALL BE

COORDINATED WITH CITY FORESTRY PRIOR TO THE START

OF CONSTRUCTION. TREE PROTECTION SPECIFICATIONS

CAN BE FOUND IN SECTION 107.13 OF CITY OF MADISON

REQUIRED FOR CONSTRUCTION AFTER THE DEVELOPMENT

STANDARD SPECIFICATIONS FOR PUBLIC WORKS CONSTRUCTION. ANY TREE REMOVALS THAT ARE

8. ALL WORK IN THE PUBLIC RIGHT-OF-WAY SHALL BE PERFORMED BY A CITY LICENSED

9. CONTRACTOR SHALL OBTAIN PERMIT TO EXCAVATE IN THE PUBLIC RIGHT-OF-WAY.

555 West Washington					
Madison, WI					Development Frontage - South Bedford Street
20-Jun-18					Total LF of Street Frontage
Downtown & Urban Districts: Urban Mixed-Use (UMX) Zoni	ng				Between Parking/Building & Street
, , , , , , , , , , , , , , , , , , ,					
				Landscape Points	Element
Developed Lots	SF	Acres		Subtotal	Overstory Deciduous Tree
Total Developed Area (Lot - Building Area)	4,113	0.09			Tall Evergreen Tree
Landscape Points (5 pts/300 SF for first 5 acres, 1 pt/100 SF fo	or additional)			69	Ornamental Tree
zarradospo i emite (e pierede el ilei met e sense, i period el ile	, manufication,	Landeer	pe Points Requir		Upright Evergreen Shrub
		Landsca	pe roms requir	eu vs	Shrub, deciduous
				-	Shrub, evergreen
			Overstory Trees		Ornamental Grass/Perennial
Development Frontage - West Washington Avenue	LF		Required *	Shrubs Required	
Total LF of Street Frontage					
Between Parking/Building & Street	82		3	14	General Site, Foundation, Screening
		Quantity	Quantity		
Element	Point Value	Proposed	Existing	Points Achieved	Element
Overstory Deciduous Tree	35			0	Existing Overstory Deciduous Tree (caliper " at DBH)
Tall Evergreen Tree	35			0	Overstory Deciduous Tree
Ornamental Tree	15	1		15	Tall Evergreen Tree
Upright Evergreen Shrub	10	1		10	Ornamental Tree
Shrub, deciduous	3	23		69	Upright Evergreen Shrub
Shrub, evergreen	4	6		36	Shrub, deciduous
Ornamental Grass/Perennial	2	68		136	Shrub, evergreen
		Development Fr	ontage Points To	tal 266	Ornamental Grass/Perennial
					Ornamental/Decorative Fence
					or Wall (4 pts/10 LF)

PROPOSED -

RAISED

PLANTERS

PROPOSED 6' HT. _

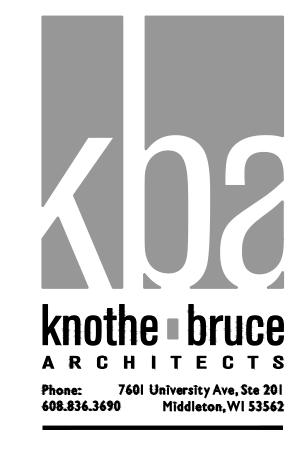
PRIVACY FENCE

|boo|booooo|

ent	Point Value	Proposed	Existing	Points Achieved	CCF	Carpinus caroliniana J.N. Upright	Fires
tory Deciduous Tree	35	. 10p000u	Lixioung	0	QC	Quercus robur 'Crimschmidt'	Crims
vergreen Tree	35			0		Evergreen Trees	
nental Tree	15	2		30	JT	Juniperus chinensis 'Trautman'	Traut
nt Evergreen Shrub	10	4		40		Deciduous Shrubs	111200
, deciduous	3	27		81	Aml	Aronia melanocarpa Low Scape Mound	Low S
, evergreen	4	22		88			+
nental Grass/Perennial	2	230		460	Hq	Hydrangea quercifolia 'Pee Wee'	Oakle
		Development Fr	rontage Points Total	699	Pdm	Physocarpus opulifolius 'Donna May'	Little
					Sbt	Spiraea betulifolia 'Tor'	Birchl
eral Site, Foundation, Screening						Evergreen Shrubs	
_					Jpk	Juniperus chinensis 'Pfitzeriana Kallay'	Kallay
		Quantity	Quantity		Js	Juniperus sabina `Buffalo`	Buffal
ent	Point Value	Proposed	Existing	Points Achieved	Tmt	Taxus x media `Tauntonii`	Tauto
ng Overstory Deciduous Tree (caliper " at DBH)	14		1	14	11112	Perennials/Grasses/Groundcovers	Tauto
tory Deciduous Tree	35		4	140	1-		-
vergreen Tree	35			0	asb	Allium tanguticum `Summer Beauty`	Summ
nental Tree	15			0	abi	Amsonia tabernaemontana `Blue Ice`	Blue
nt Evergreen Shrub	10			0	acs	Aralia cordata `Sun King`	Sun Ki
, deciduous	3	21		63	expm	Echinacea x 'Pixie Meadowbrite'	Pixie
, evergreen	4	16		64	gck	Geranium x cantabrigiense `Karmina`	Bioko
nental Grass/Perennial	2	72		144	hmr	Heuchera x `Midnight Rose`	Coral
nental/Decorative Fence ill (4 pts/10 LF)	4	20.5		82	hbc	Hosta x `Blue Cadet`	Planta
iii (4 pts/10 Li)	4		│ ation Plantings Total		hgs	Hosta x `Gold Standard`	Gold S
		1 Odilde	adon riantings rotal	301	-		
	Г	TOTALI	ANDSCAPE POINTS	1472	Isk	Liatris spicata `Kobold`	Kobol
	L	TOTAL L	ANDSCAPE POINTS	1472	nk	Nepeta x faassenii `Kit Kat`	Kit Ka
ases where development frontage landscaping cannot b					pdd	Penstemon digitalis 'Dark Towers'	Beard
ed due to site constraints, the zoning administrator ma the requirement or substitute alternative screening me	*				rfv	Rudbeckia fulgida speciosa 'Viette's Little Suzy'	` Black-
the requirement or substitute alternative screening me	mous					Caluia namanasa 'Caradanas'	Canda

* In d	ases where development frontage landscaping cannot be
	ded due to site constraints, the zoning administrator may
waive	the requirement or substitute alternative screening method
for th	e required landscaping.

Kev	PLANT LIST Botanical Name	Common Name	Quantity	Size	Spec	Comments	Mature Size
,	Deciduous Trees	- Commonwant	Quarterty	0.20	Opec	Comments	Triduic Size
ARH	Amelanchier x grandiflora 'Robin Hill'	Robin Hill Serviceberry	2	2" Cal.	B&B	Upright multi-stem	20-25' ht x 12-15' sp
CCF	Carpinus caroliniana 'J.N. Upright'	Firespire Musclewood	1	2" Cal.	B&B	Upright multi-stem	20' ht x 8-10' sp
QC	Quercus robur 'Crimschmidt'	Crimson Spire English Oak	4	2" Cal.	B&B	Single, straight leader	45' ht x 15' sp
	Evergreen Trees	*					
IT	Juniperus chinensis 'Trautman'	Trautman Juniper	5	5' Ht.	в&в		12' ht x 4' sp
	Deciduous Shrubs						
4ml	Aronia melanocarpa Low Scape Mound	Low Scape Mound Aronia	20	2 Gal.	Cont.	Space 2'-0" o.c.	1-2' ht x 2-3' sp
Hq	Hydrangea quercifolia 'Pee Wee'	Oakleaf Hydrangea	24	2 Gal.	Cont.	Space 2.5'-0" o.c	2-4' ht x 2-3' sp
Pdm	Physocarpus opulifolius 'Donna May'	Little Devil Ninebark	12	2 Gal.	Cont.	Space 2.5'-0" o.c	3-4' ht x 3-4' sp
Sbt	Spiraea betulifolia 'Tor'	Birchleaf Spirea	22	2 Gal.	Cont.	Space 2'-0" o.c.	2-3' ht x 2-3' sp
	Evergreen Shrubs						
lpk	Juniperus chinensis 'Pfitzeriana Kallay'	Kallays Compact Pfitzer Juniper	25	2 Gal.	Cont.	Space 3.5'-0" o.c.	3' ht x 6-8' sp
ls	Juniperus sabina `Buffalo`	Buffalo Juniper	5	2 Gal.	Cont.	Space 4'-0" o.c.	1' ht x 4-6' sp
Tmt	Taxus x media `Tauntonii`	Tauton Yew	28	2 Gal.	Cont.	Space 4'-0" o.c.	3-5' ht x 6-8' sp
	Perennials/Grasses/Groundcovers						
asb	Allium tanguticum 'Summer Beauty'	Summer Beauty Allium	185	4-Inch	Pot	Space 1'-0" o.c.	1-1.5' ht x 1.5-2' sp
abi	Amsonia tabernaemontana 'Blue Ice'	Blue Ice Blue Star	11	4-Inch	Pot	Space 1.5'-0" o.c.	1-1.5' ht x 1.5-2' sp
acs	Aralia cordata 'Sun King'	Sun King Aralia	6	2 Gal.	Cont.	Space 3'-0" o.c.	3-4' ht x 3-4' sp
expm	Echinacea x 'Pixie Meadowbrite'	Pixie Meadowbrite Purple Coneflower	74	4-Inch	Pot	Space 1.5'-0" o.c.	1.5-2' ht x 1.5-2' sp
zck	Geranium x cantabrigiense 'Karmina'	Biokovo Cranesbíll	40	4-Inch	Pot	Space 1.5'-0" o.c.	.5-1' ht × .5-1' sp
hmr	Heuchera x `Midnight Rose`	Coral Bells	9	4-Inch	Pot	Space 1'-0" o.c.	1-2' ht x 1-1.5' sp
hbc	Hosta x `Blue Cadet`	Plantain Lily	23	4-Inch	Pot	Space 1.5'-0" o.c.	1' ht x 2-3' sp
hgs	Hosta x `Gold Standard`	Gold Standard Plantain Lily	20	4-Inch	Pot	Space 2'-0" o.c.	2-3' ht x 2' sp
lsk	Liatris spicata 'Kobold'	Kobold Spike Gayfeather	28	4-Inch	Pot	Space 1'-0" o.c.	1.5-3' ht x 1.5-2' sp
nk	Nepeta x faassenii `Kit Kat`	Kit Kat Catmint	18	4-Inch	Pot	Space 2'-0" o.c.	1' ht x 2' sp
bbc	Penstemon digitalis 'Dark Towers'	Beard-tongue	14	4-Inch	Pot	Space 1.5'-0" o.c.	3-4' ht x 1.5-2' sp
f∨	Rudbeckía fulgida speciosa 'Víette's Little Suzy'	Black-Eyed Susan	24	4-Inch	Pot	Space 1'-0" o.c.	2-3' ht x 1.5-2' sp
snc	Salvia nemorosa 'Caradonna'	Cardonna Sage	18	4-Inch	Pot	Space 1.5'-0" o.c.	2-2.5' ht x 1.5' sp
nm	Salvia nemorosa 'Marcus'	Woodland Sage	8	4-Inch	Pot	Space 1.5'-0" o.c.	8-12" ht x 1.5' sp
sa	Sesleria autumnalis	Autumn Moor Grass	31	1 Gal.	Cont.	Space 1'-0" o.c.	1-1.5' ht x 1-1.5' sp





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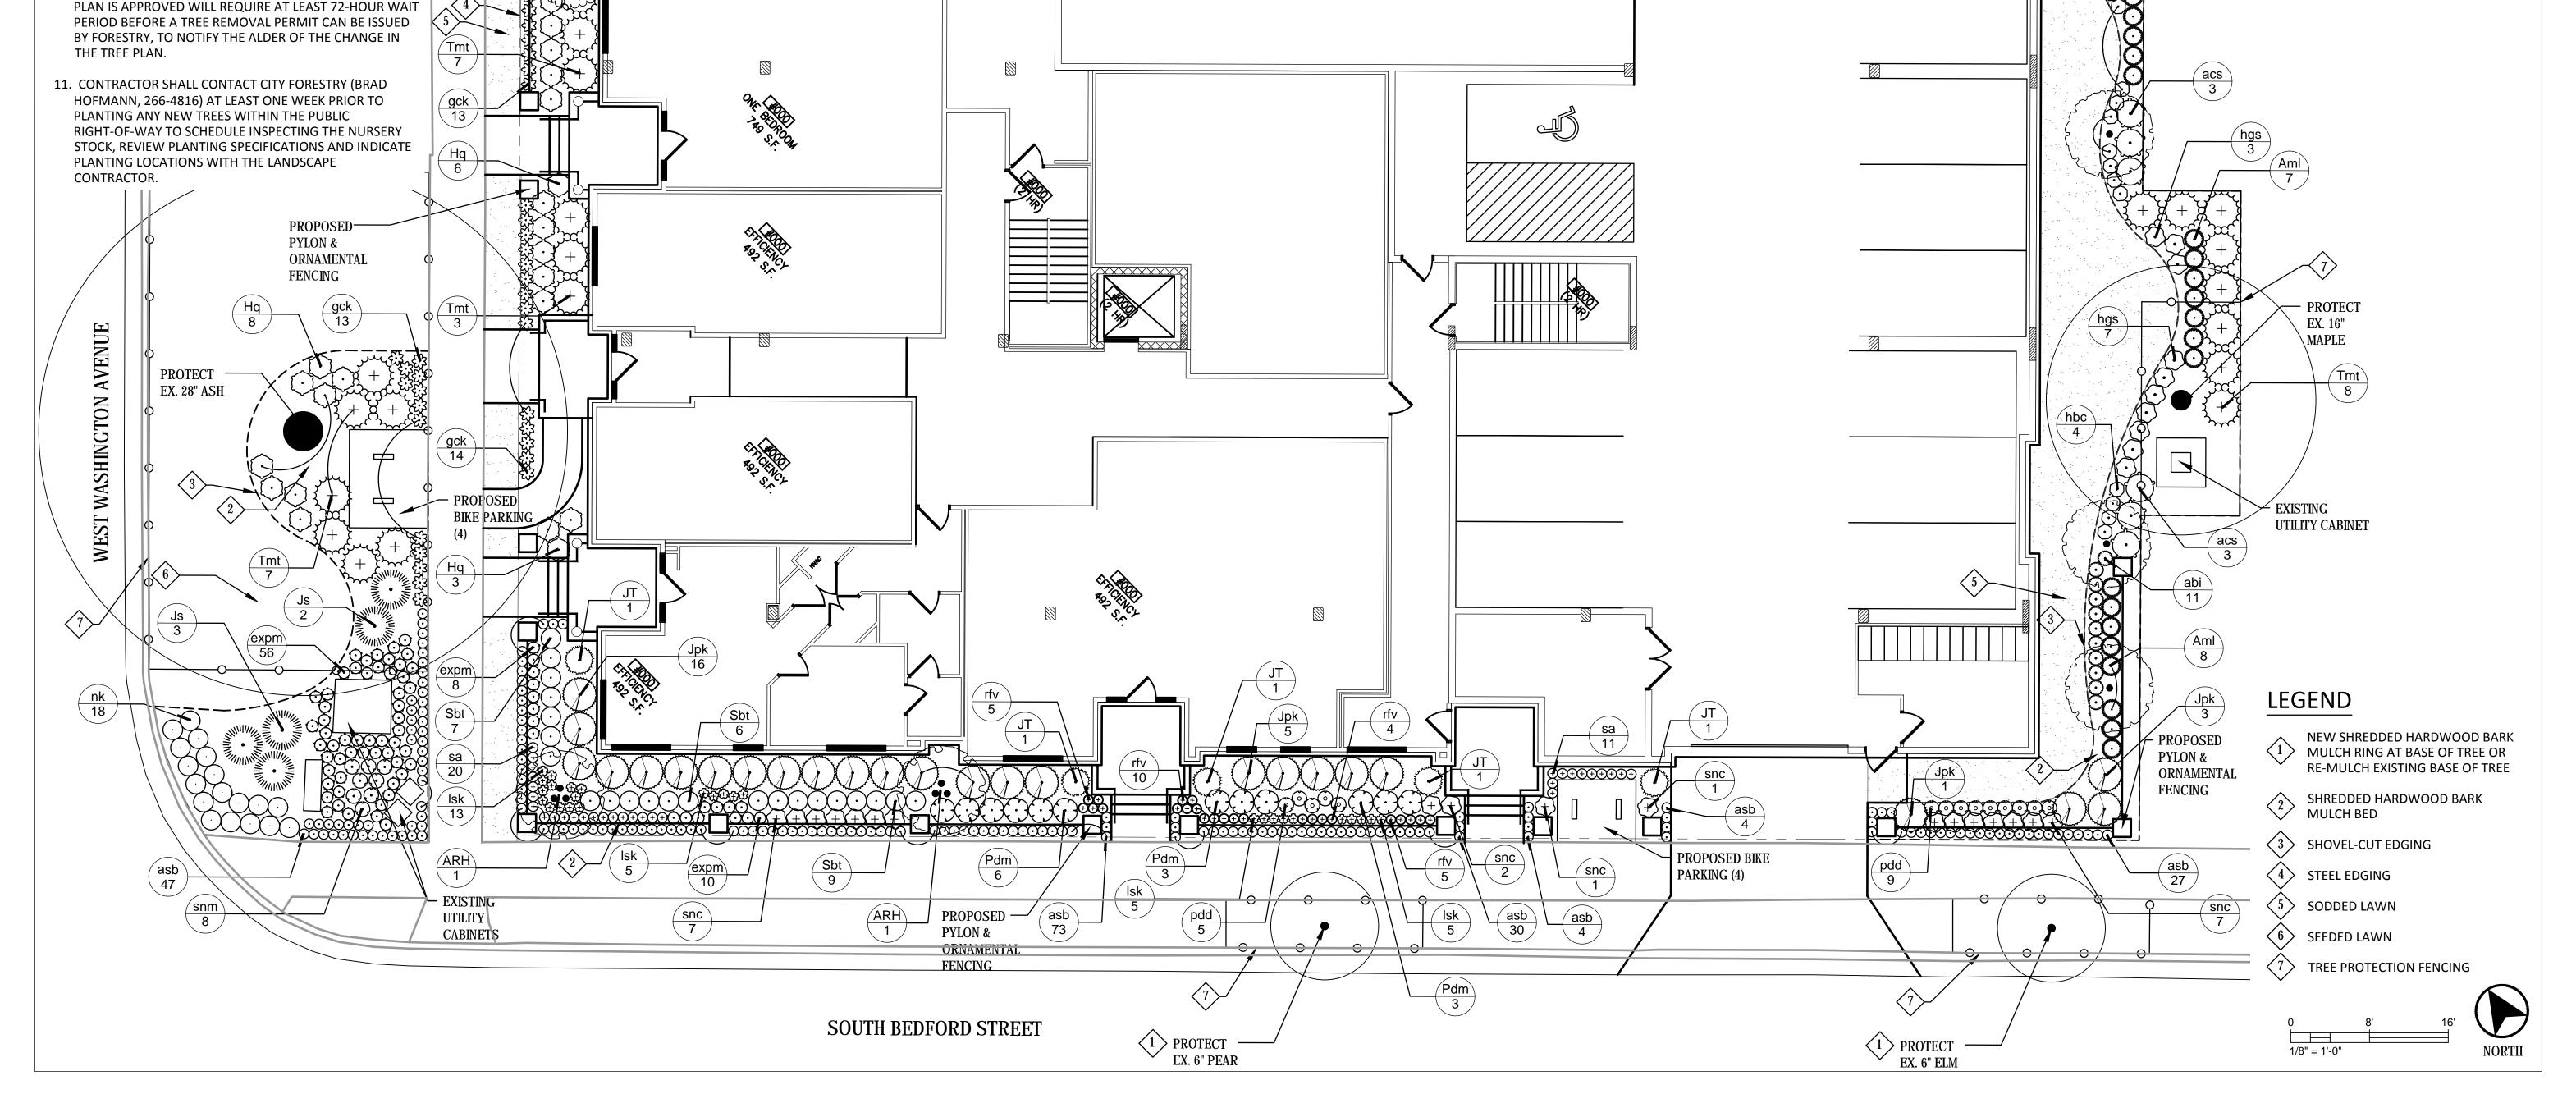


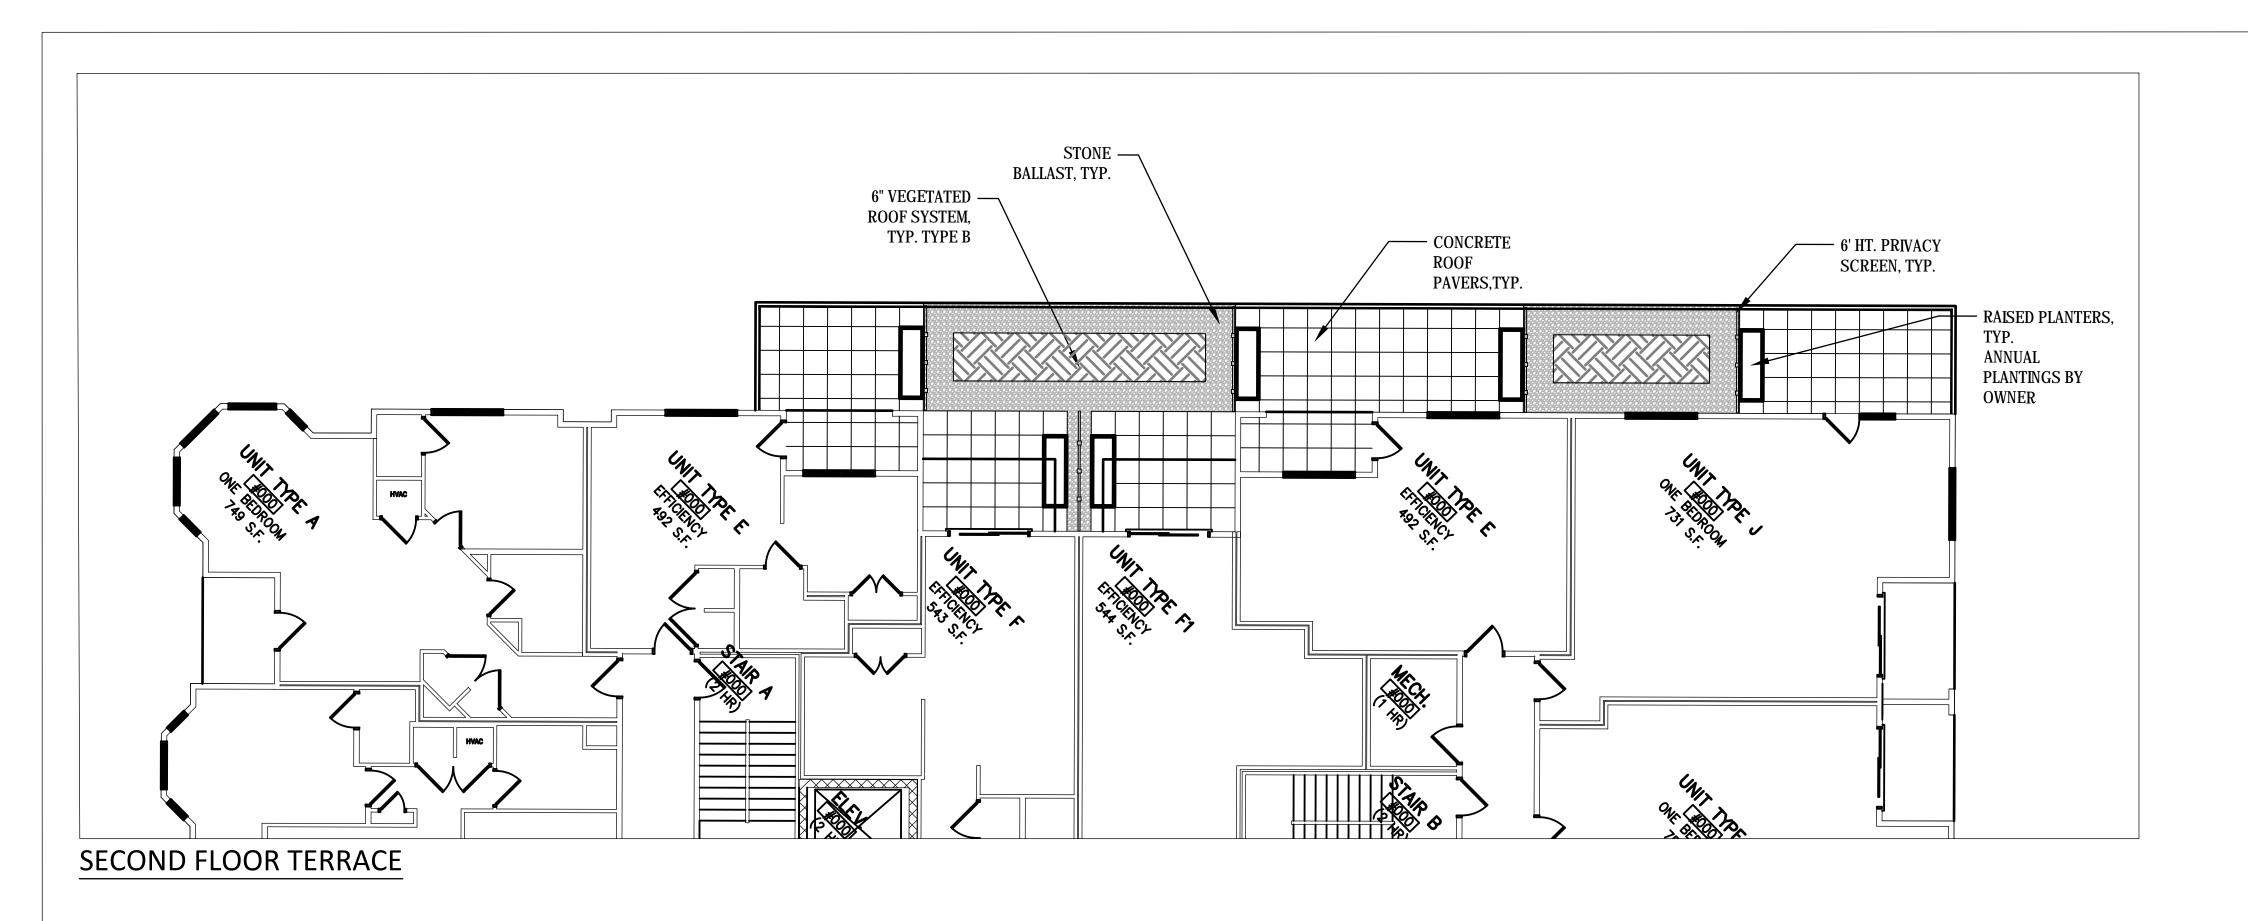
PROJECT TITLE BAXTER West Washington Development

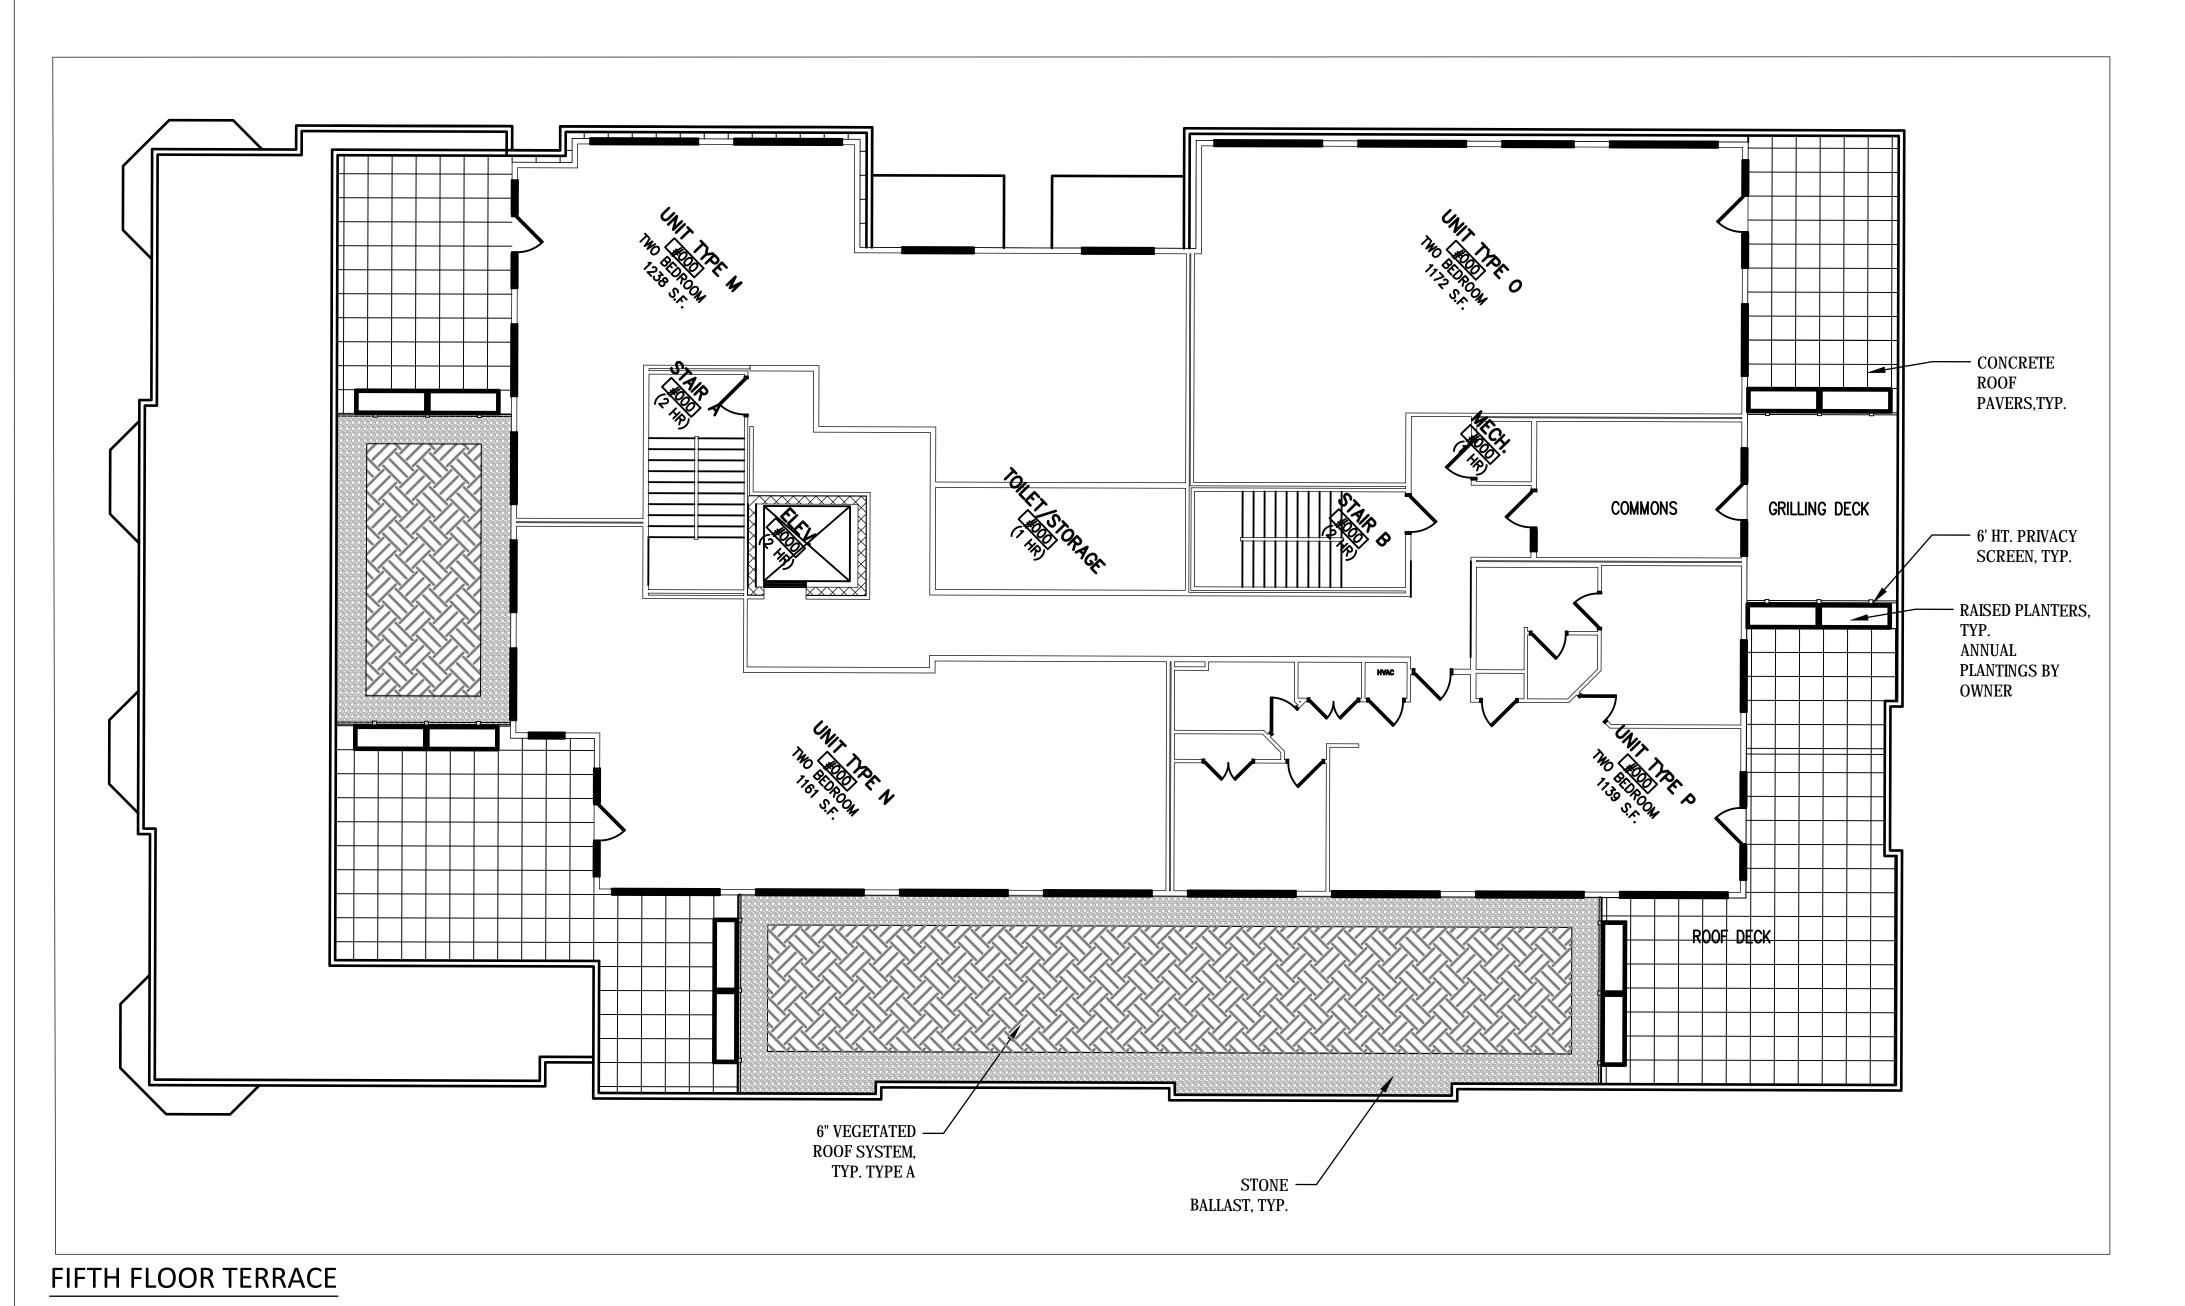
555 W Washington Ave. SHEET TITLE Landscape Plan

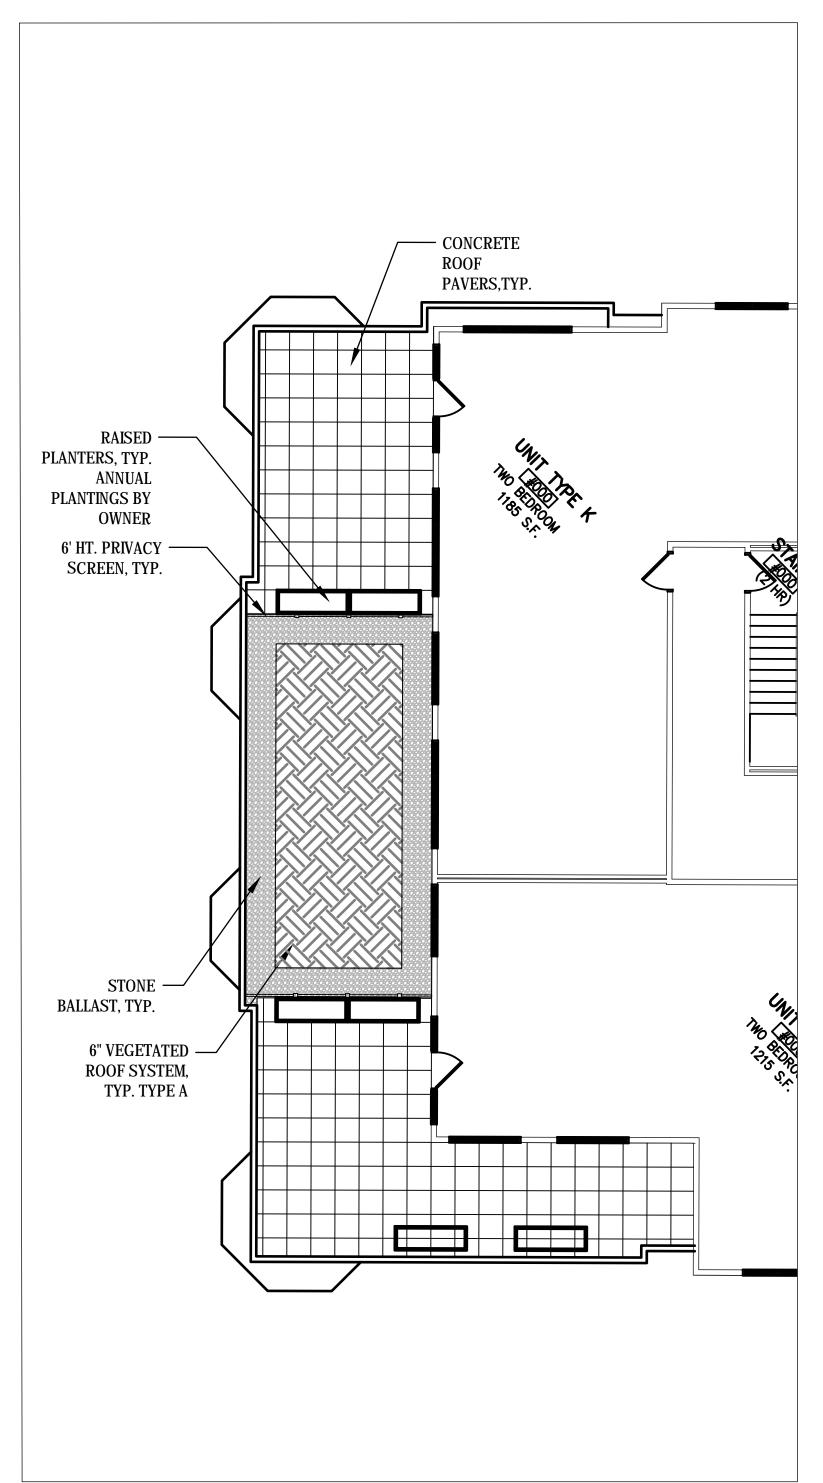
SHEET NUMBER

PROJECT NO. © 2013 Knothe & Bruce Architects, LLC









FOURTH FLOOR TERRACE

Type A:	
Propogated Sedum Tray 'Tough Extreme Mix'	
by Liveroof or approved equal. Interplant with	
2.5" perennial plugs.	
Perennial Plugs	
Allium tanguticum 'Summer Beauty'	Summer Beauty Allium
Calamintha nepeta 'Montrose White'	Montrose White Calamint
Sedum kamtschaticum 'Takahira Dake'	Takahira Dake Stonecrop
Sedum spectabilie 'Neon'	Neon Stonecrop
Sesleria autumnalis	Autumn Moor Grass
Type B:	
Propogated Sedum Tray 'Shade Serene Mix'	
by Liveroof or approved equal. Interplant with	
2.5" perennial plugs.	
Perennial Plugs	
Geranium maculatum	Wild Geranium
Heuchera villosa var. atropurpurea	Maple-leaved Alum Root
Smilacina racemosa	False Solomon's Seal
Dryopteris marginalis	Leatherleaf Woodfern
Tiarella cordifolia	Foamflower





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PROJECT TITLE
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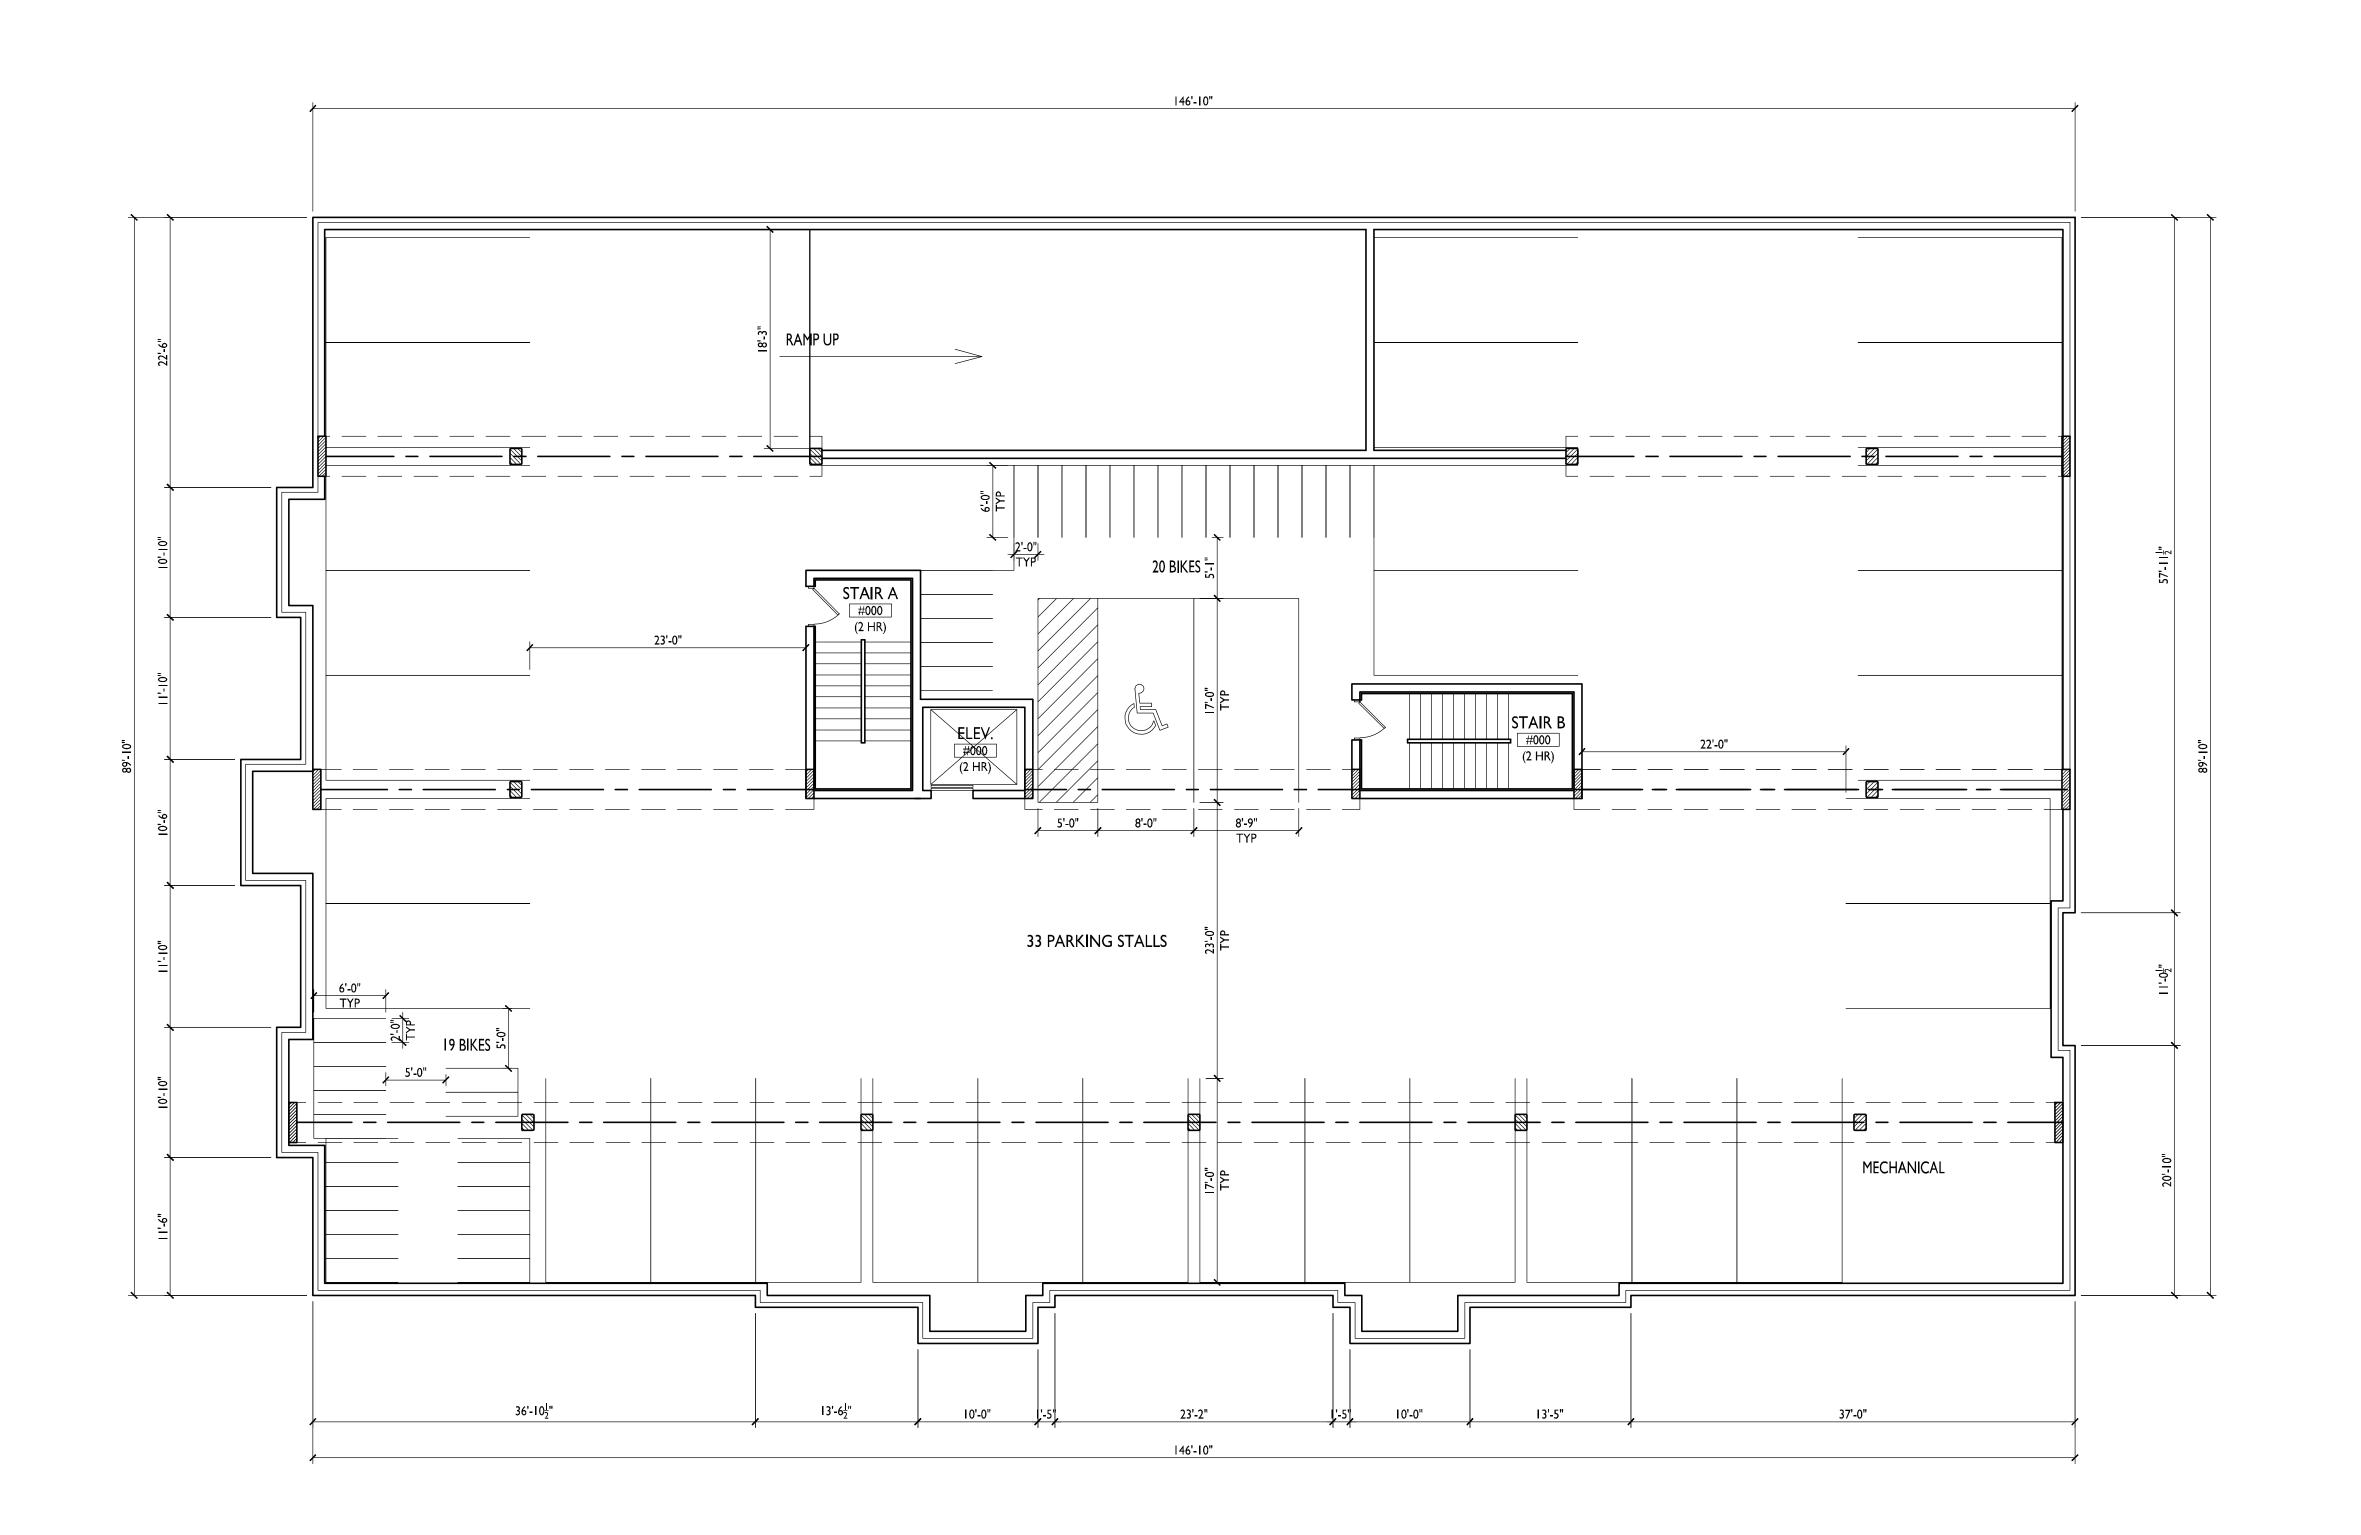
SHEET TITLE
Roof Terrace
Landscape
Plan

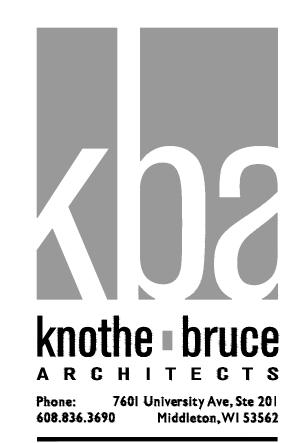
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PROJECT NO.

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PROJECT TITLE
BAXTER
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Development

555 W Washington Ave.

SHEET TITLE

Basement Plan

SHEET NUMBER

A-1.0

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PROJECT NO.





S. BEDFORD



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PROJECT TITLE

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555 W Washington Ave.

SHEET TITLE
First Floor Plan

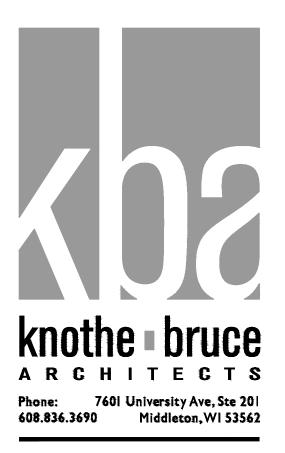
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PROJECT TITLE
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555 W Washington Ave.

SHEET TITLE

Second Floor Plan

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A-1.2

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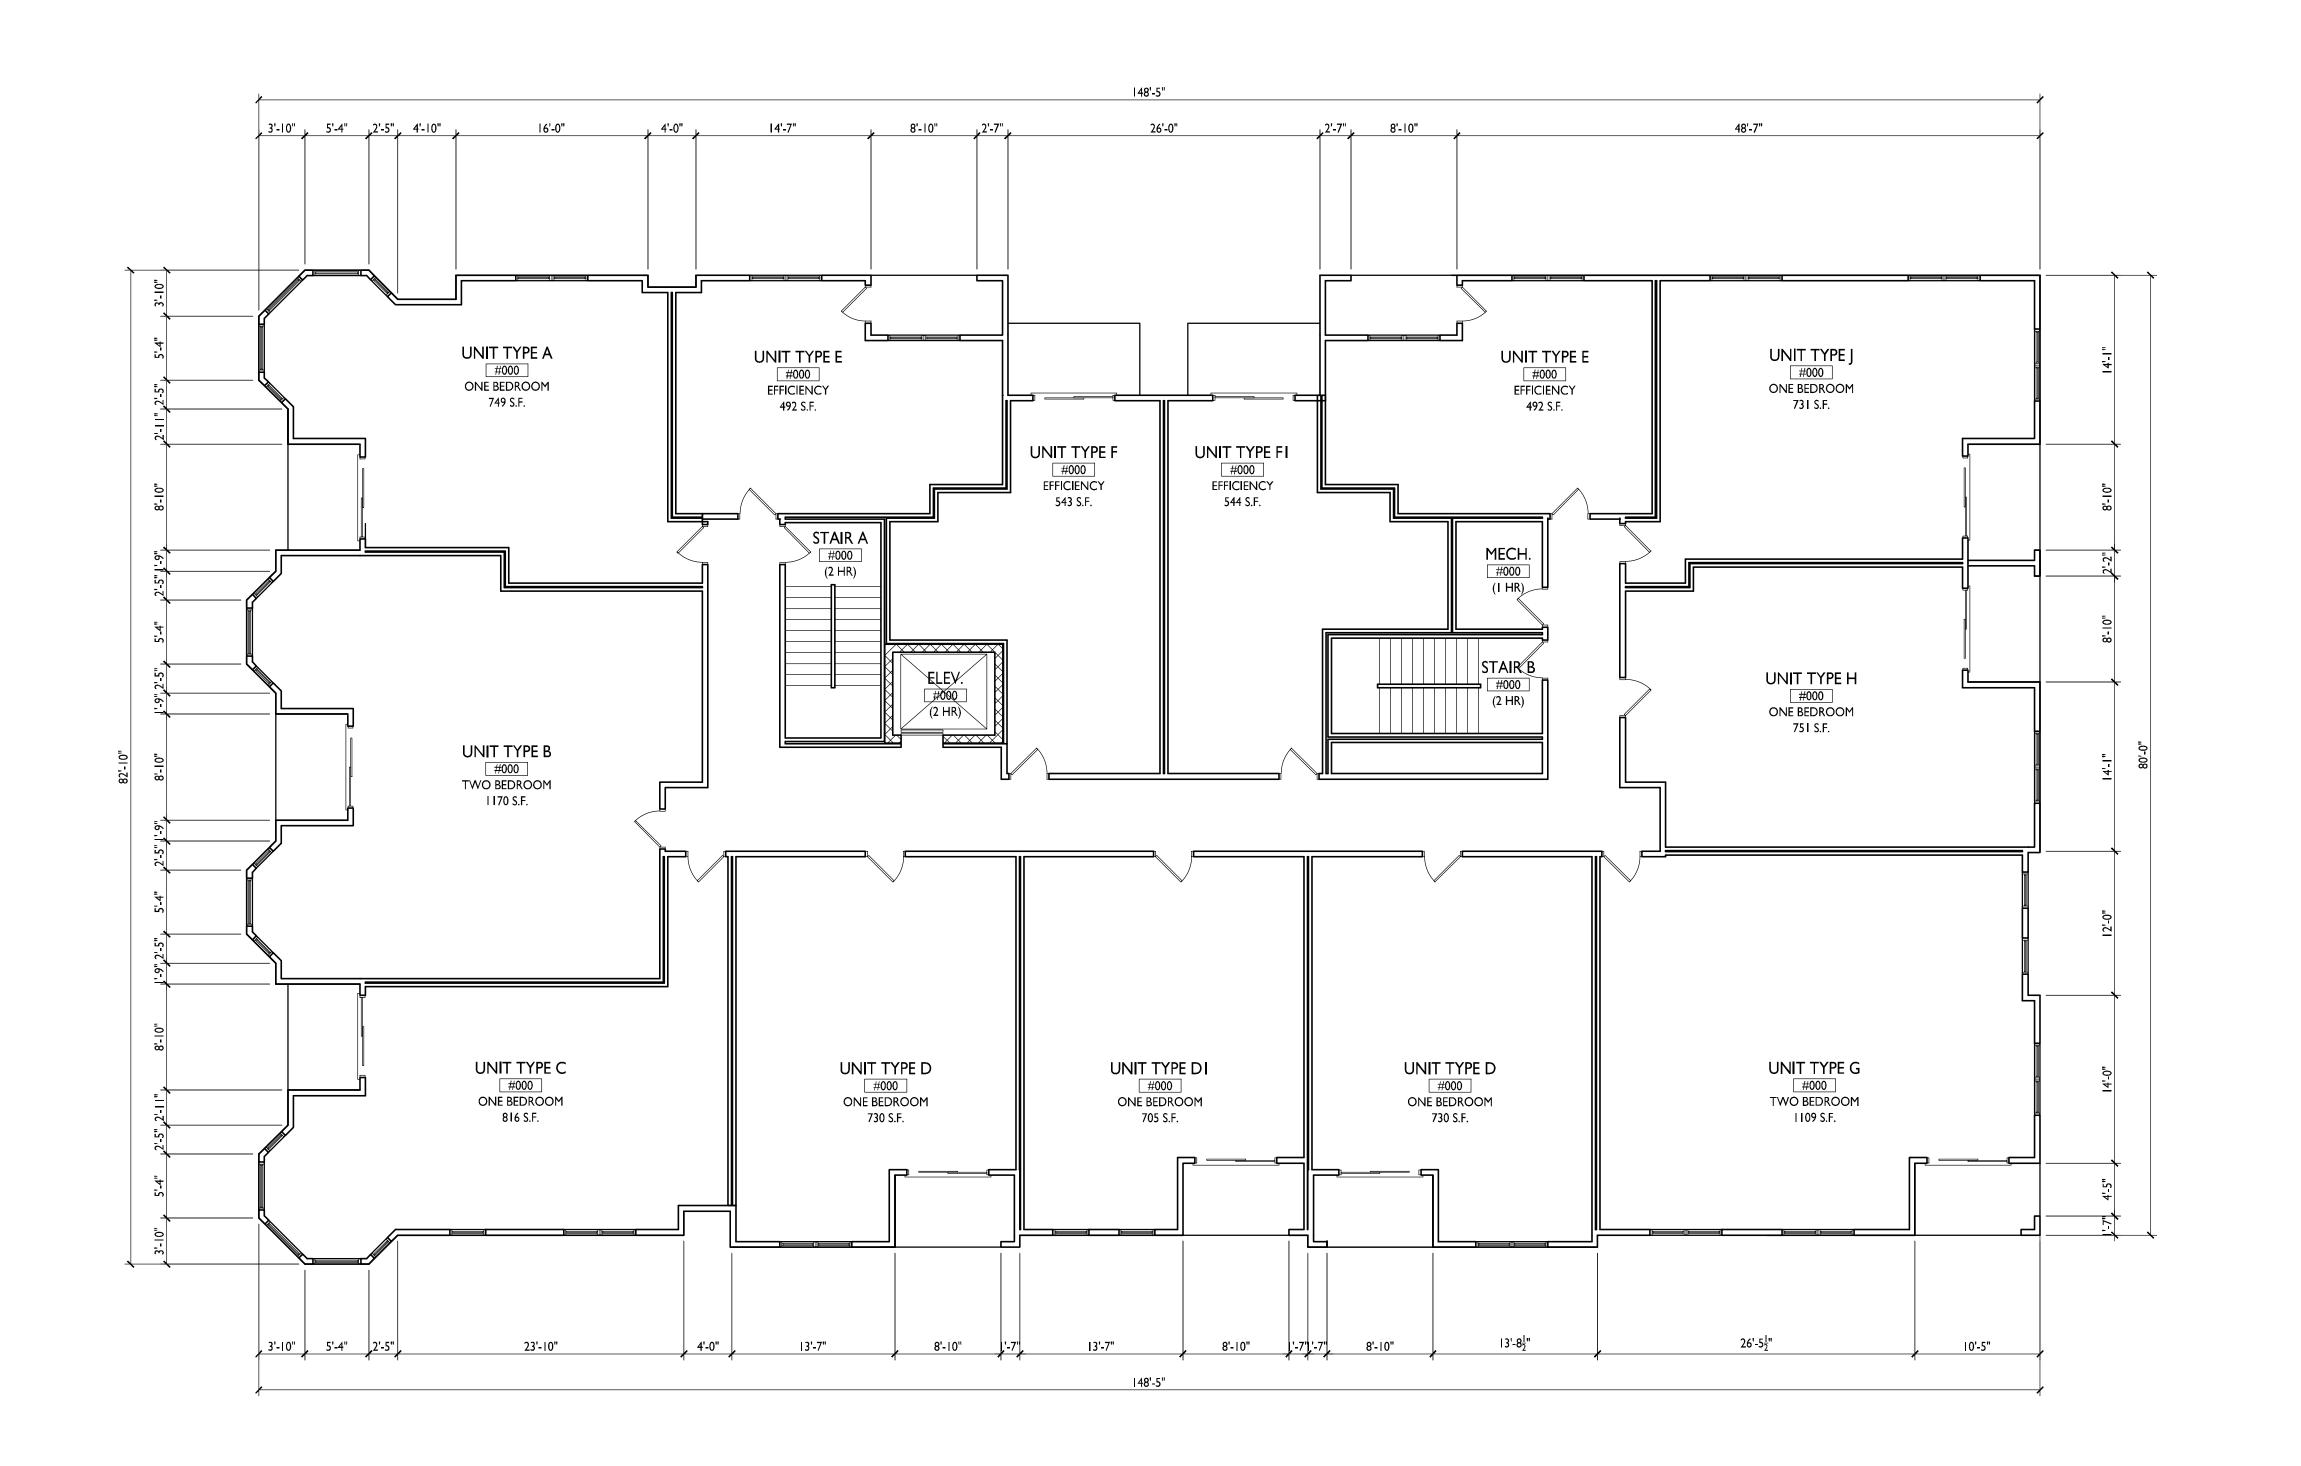
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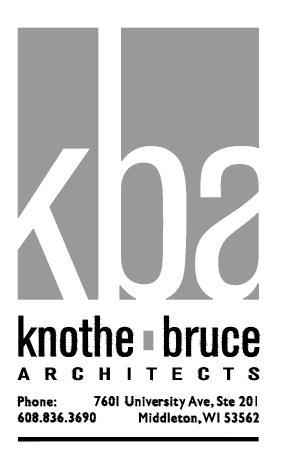
SECOND FLOOR PLAN

A-1.2

1/8"=1'-0"







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PROJECT TITLE

BAXTER West Washington Development

555 W Washington Ave.

SHEET TITLE
Third Floor Plan

SHEET NUMBER

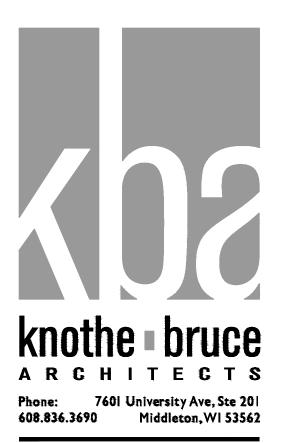
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PROJECT TITLE

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555 W Washington Ave.

SHEET TITLE

Fourth Floor Plan

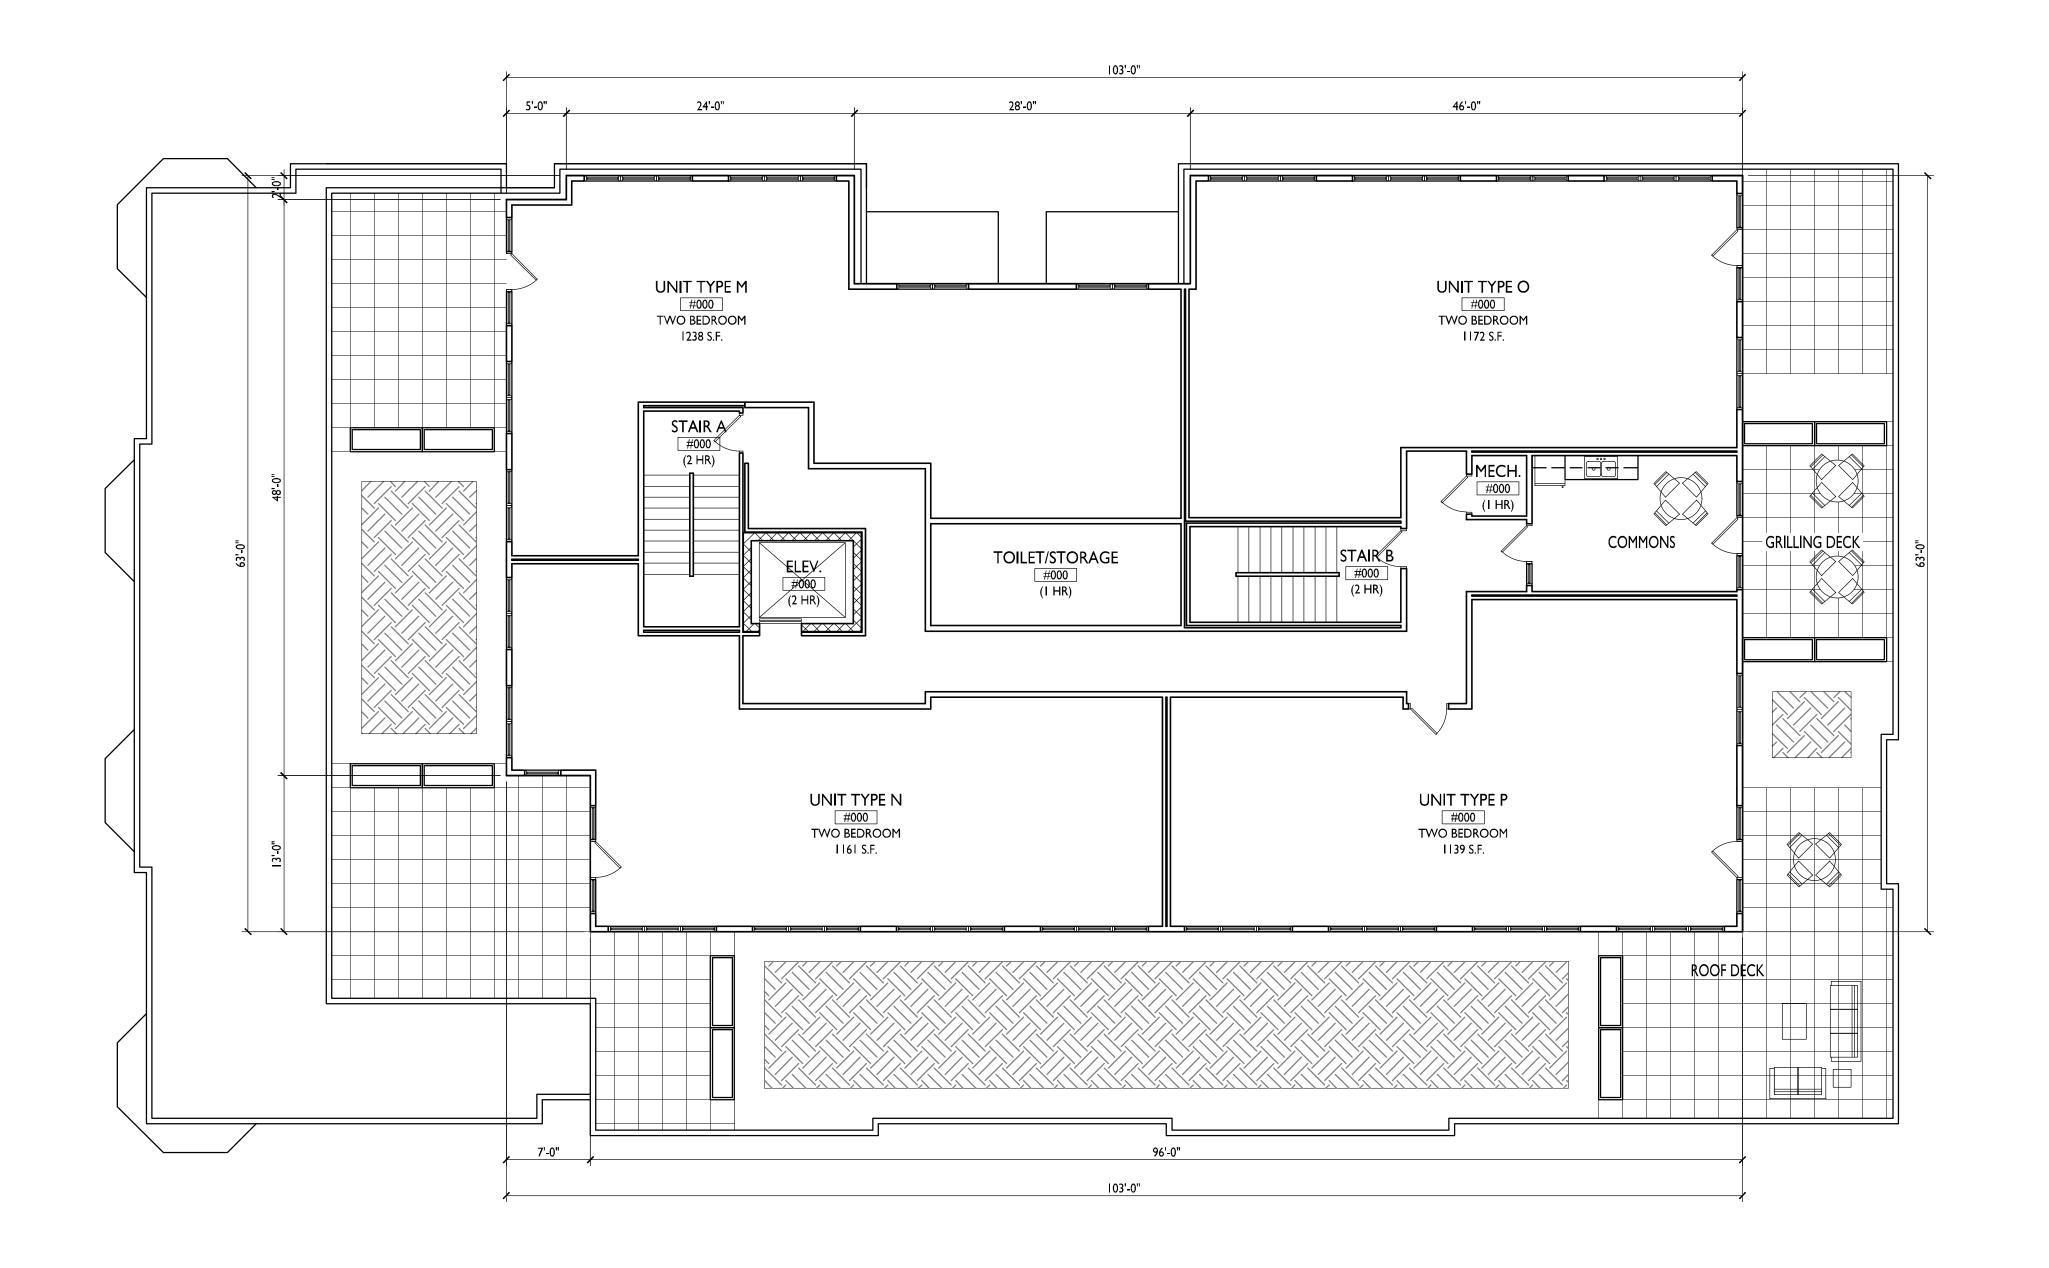
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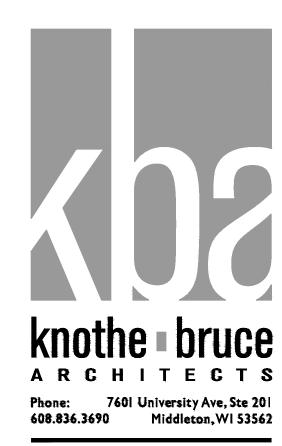


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SHEET TITLE
Fifth Floor Plan

SHEET NUMBER

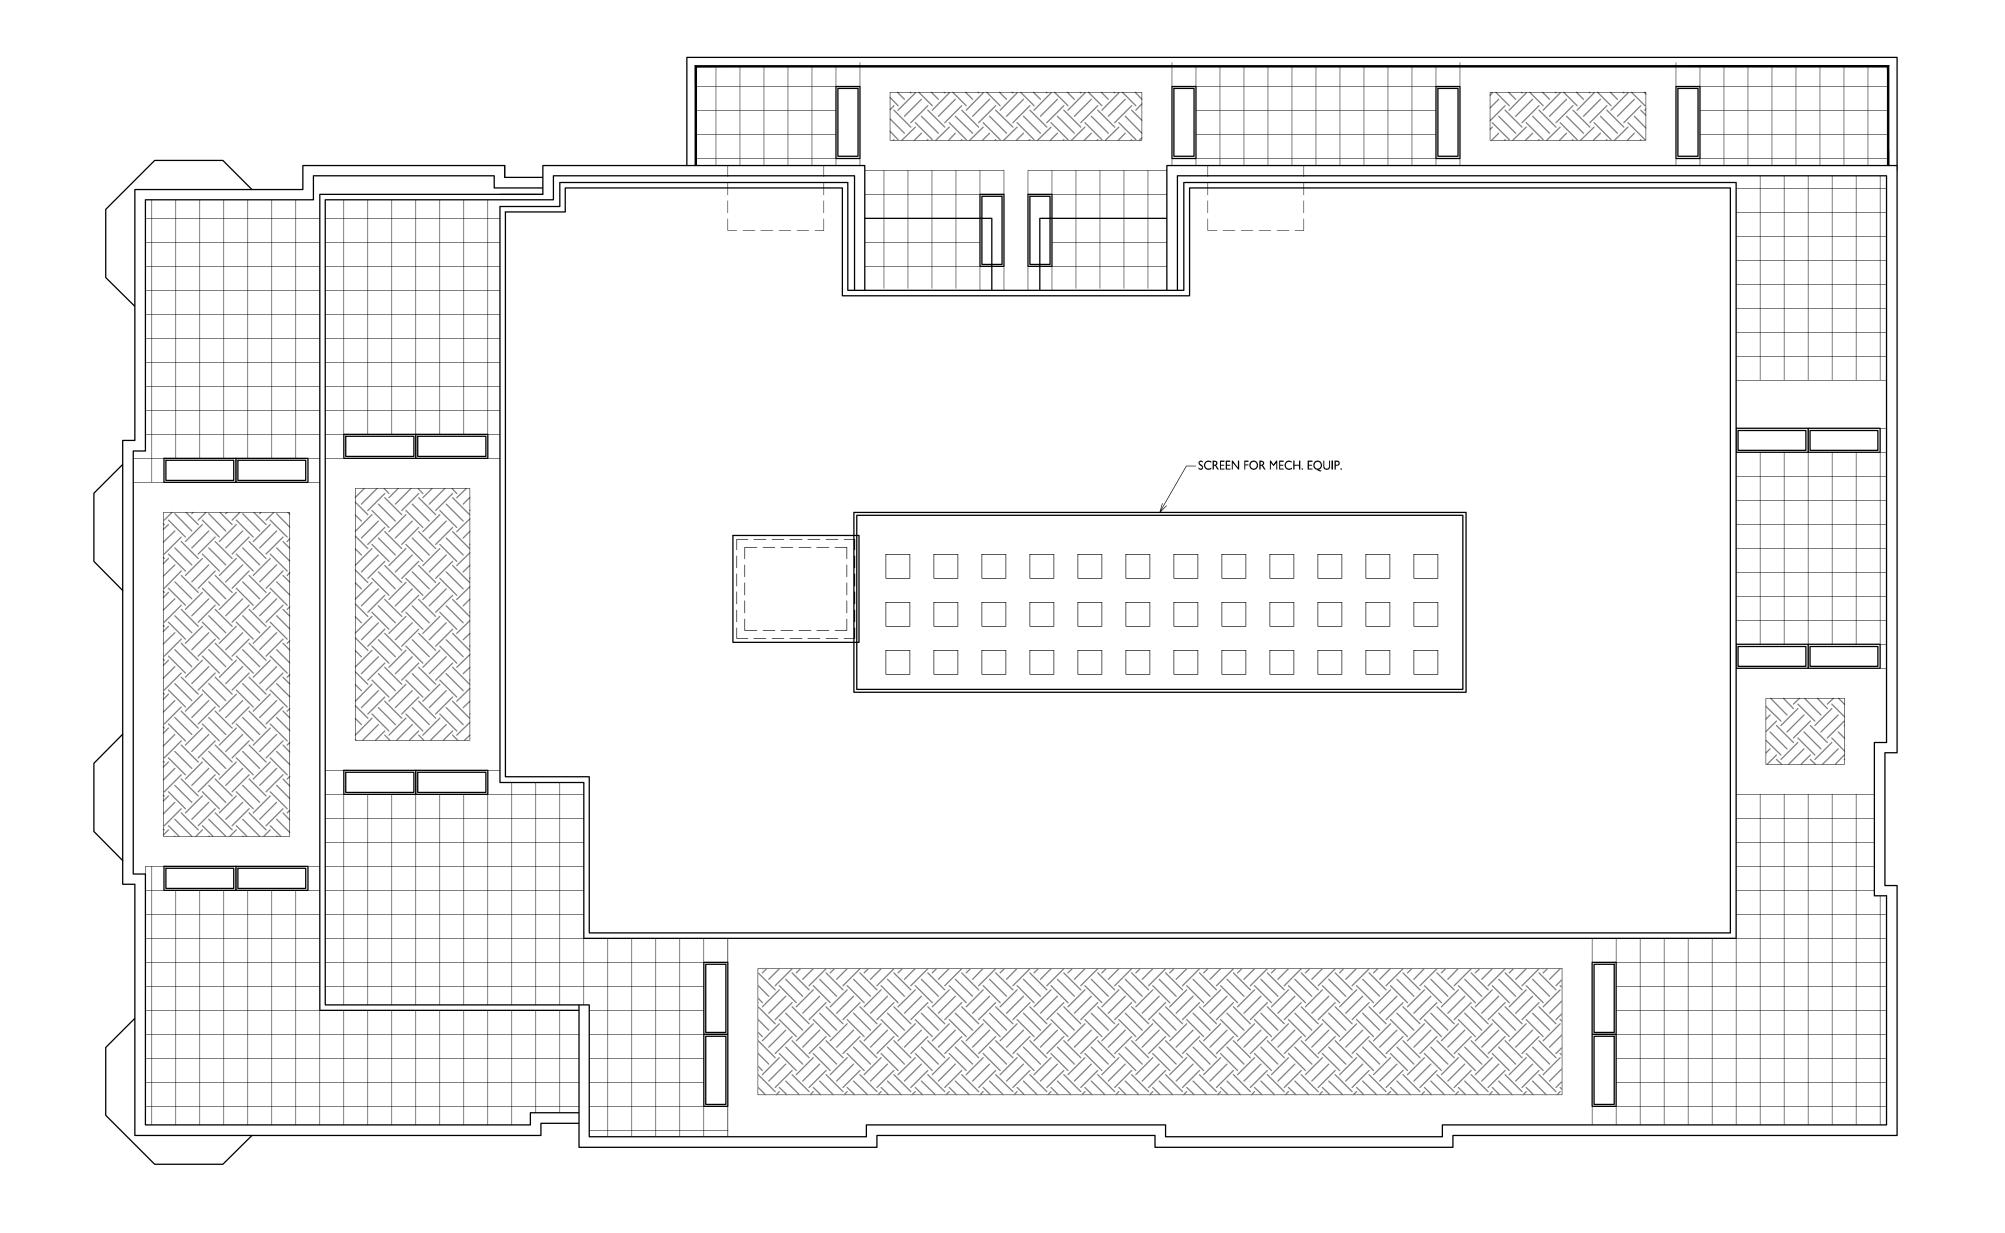
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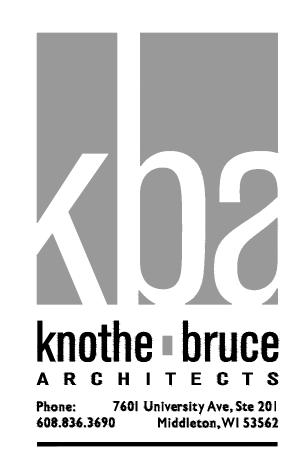
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sheet title Roof Plan

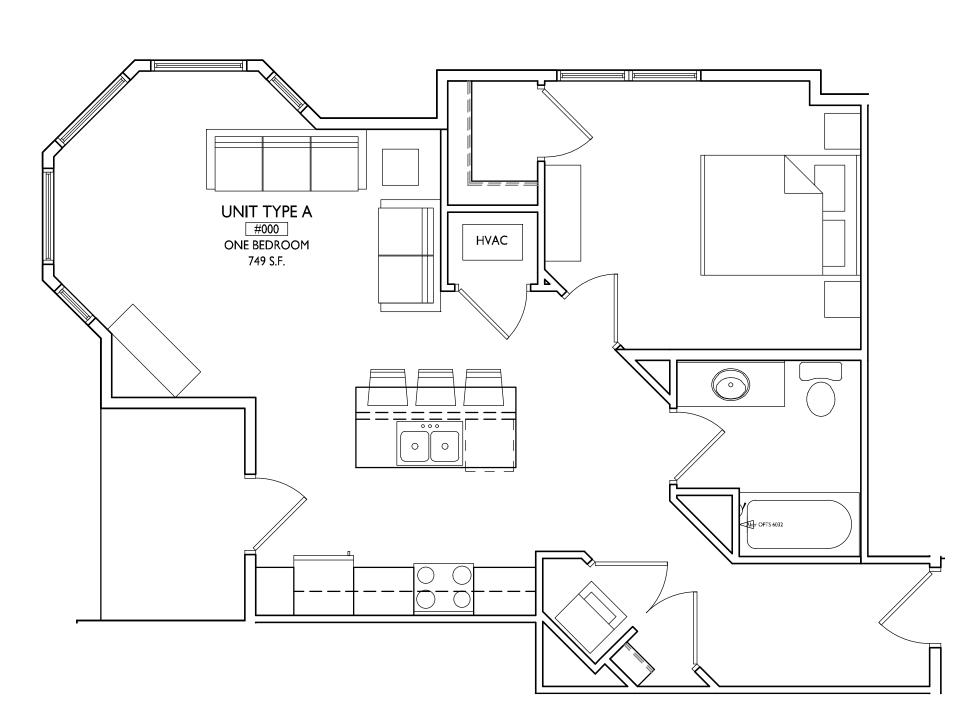
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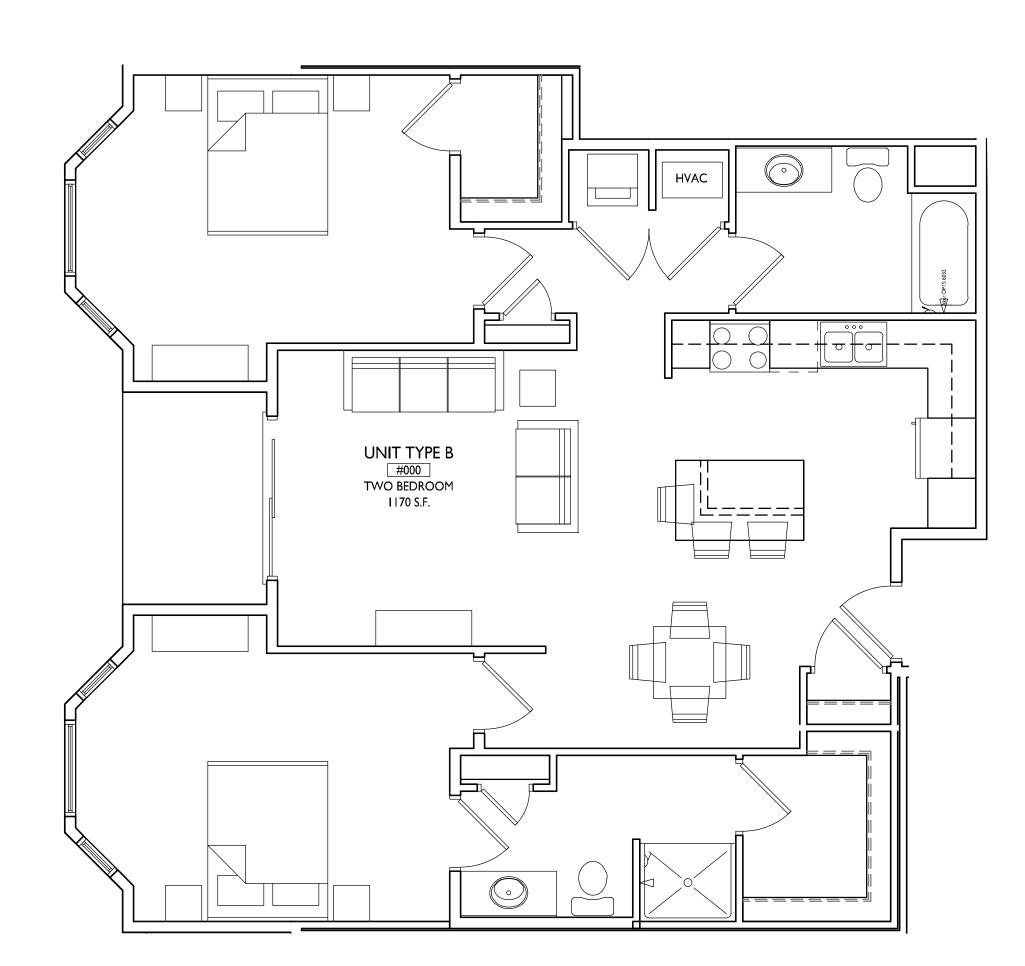
PROJECT NO. 1713
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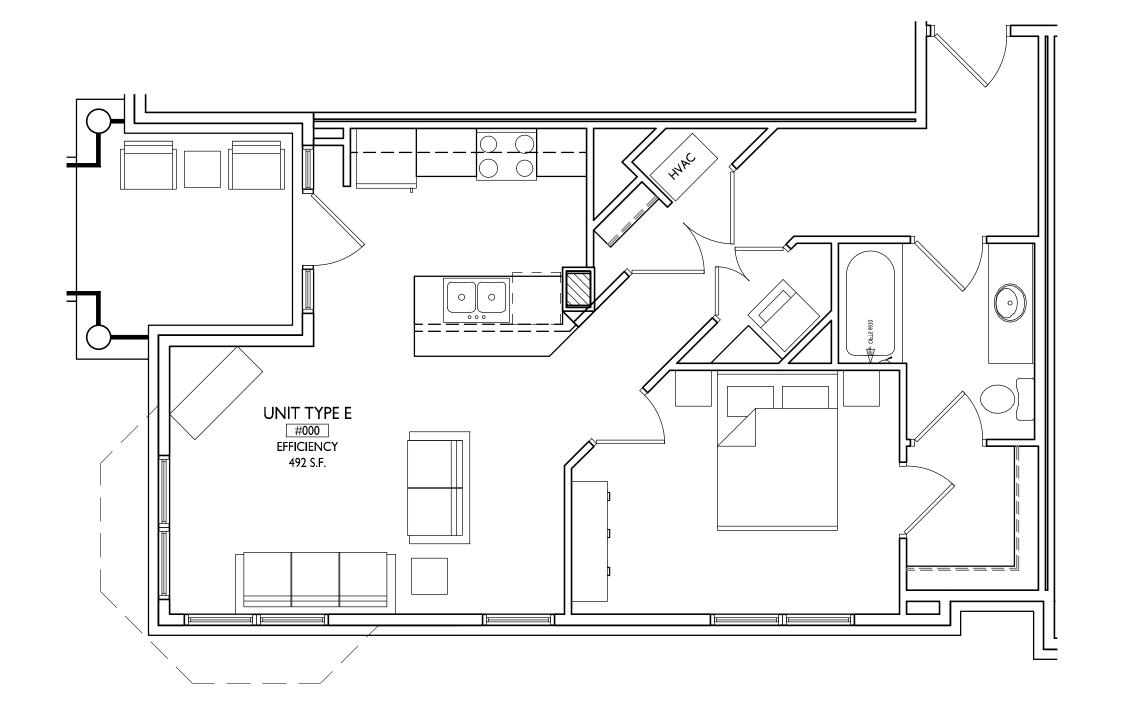




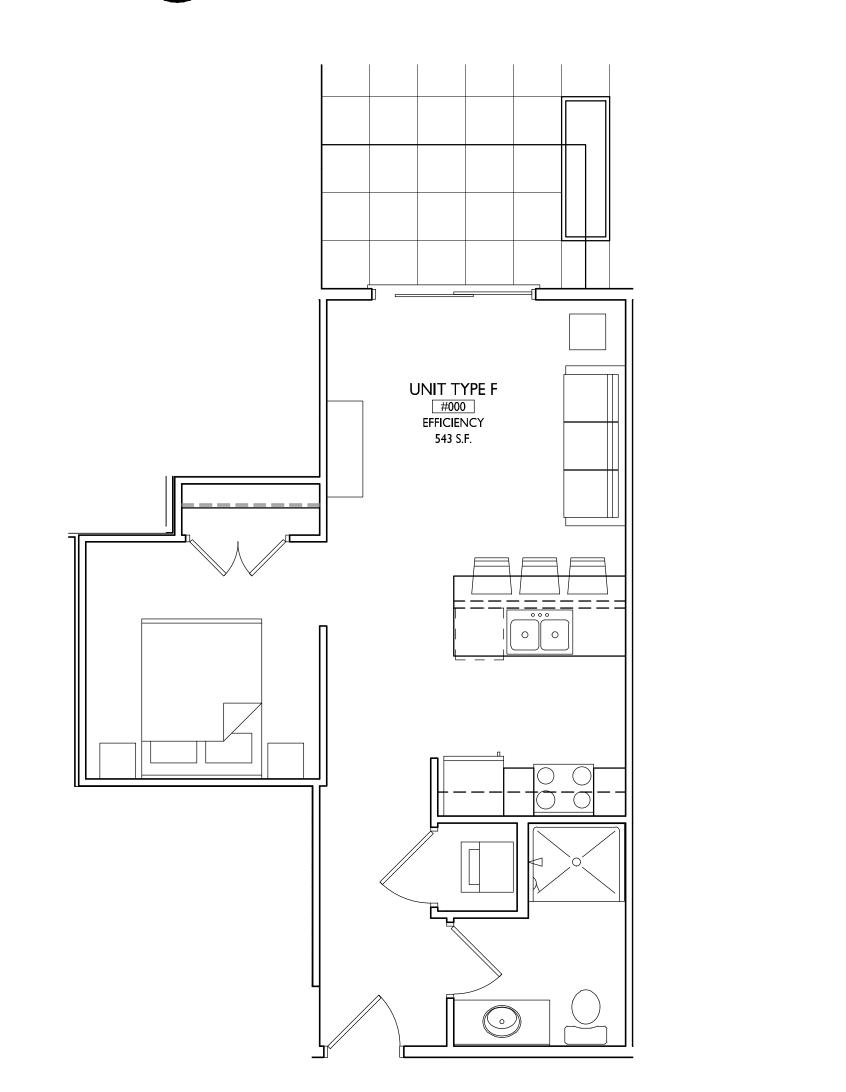




UNIT TYPE B



3 UNIT TYPE E



UNIT TYPE F



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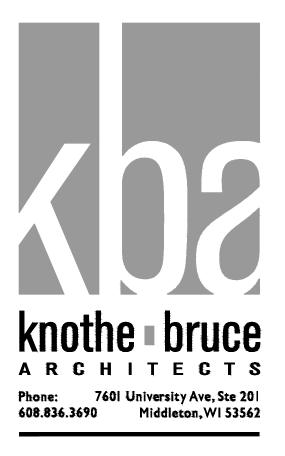
SHEET TITLE
Typical Unit Plans

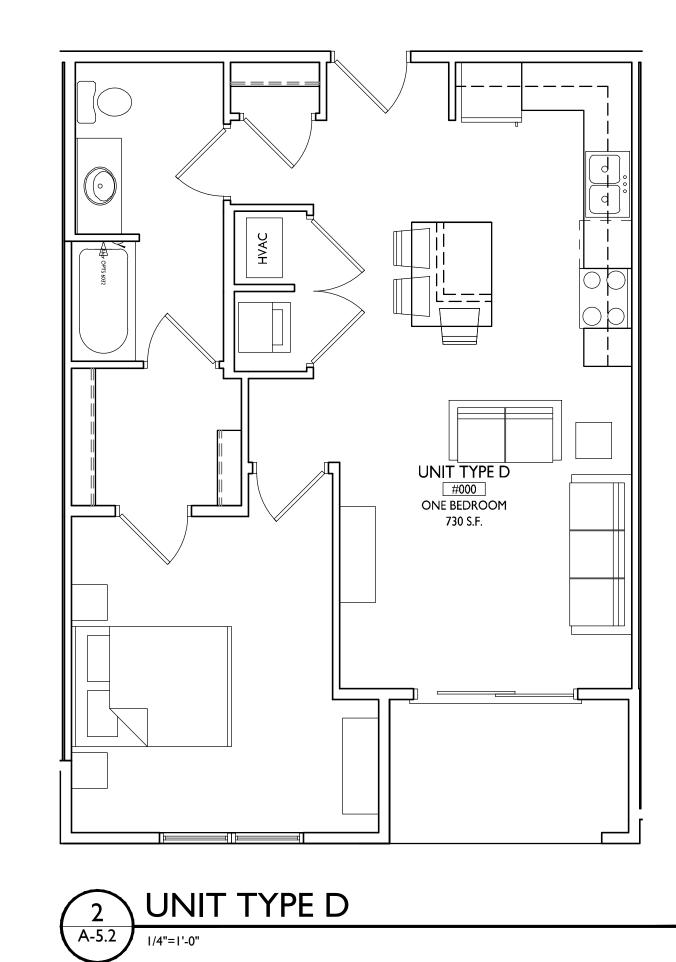
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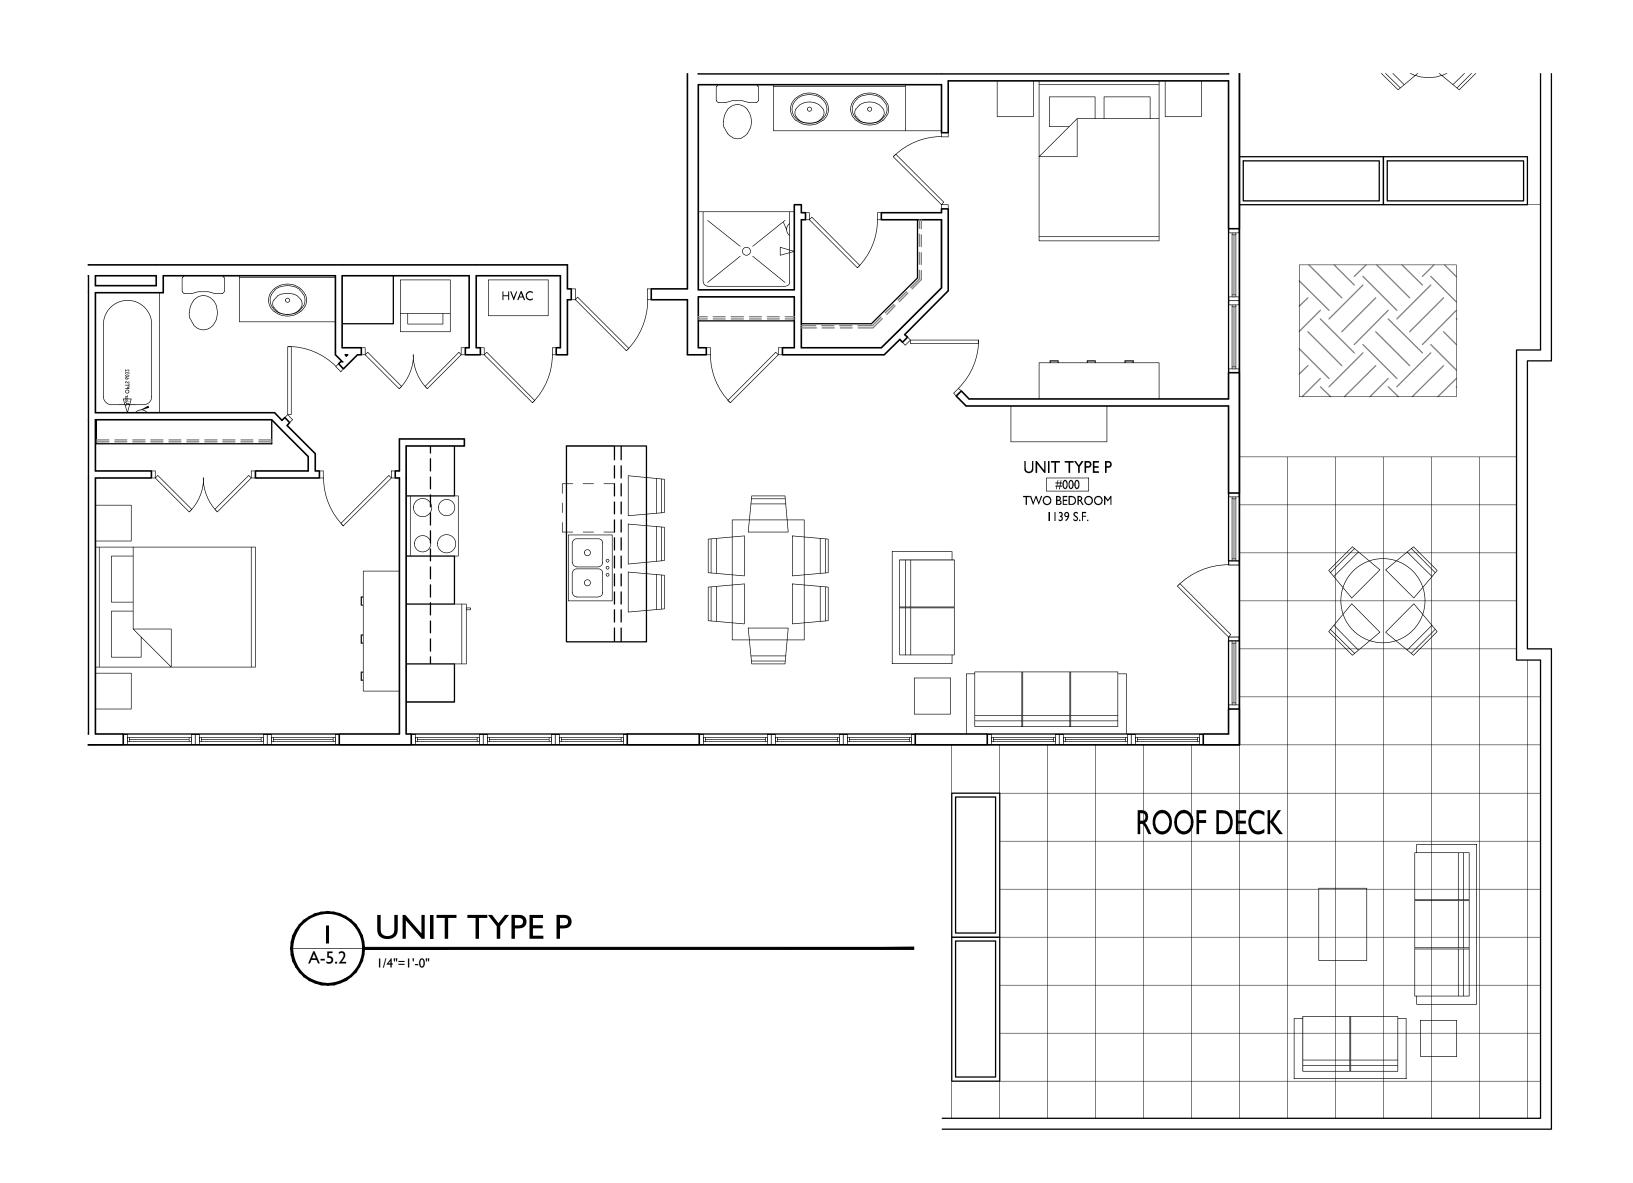
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PROJECT NO.

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PROJECT TITLE
BAXTER West Washington Development

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SHEET TITLE

Typical Unit Plans

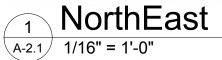
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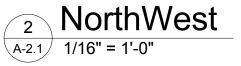
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PROJECT TITLE

SHEET TITLE

Exterior Elevations

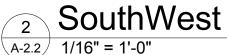
SHEET NUMBER

A-2.1

PROJECT NUMBER 1713

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SouthEast
A-2.2 1/16" = 1'-0"



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PROJECT TITLE

SHEET TITLE

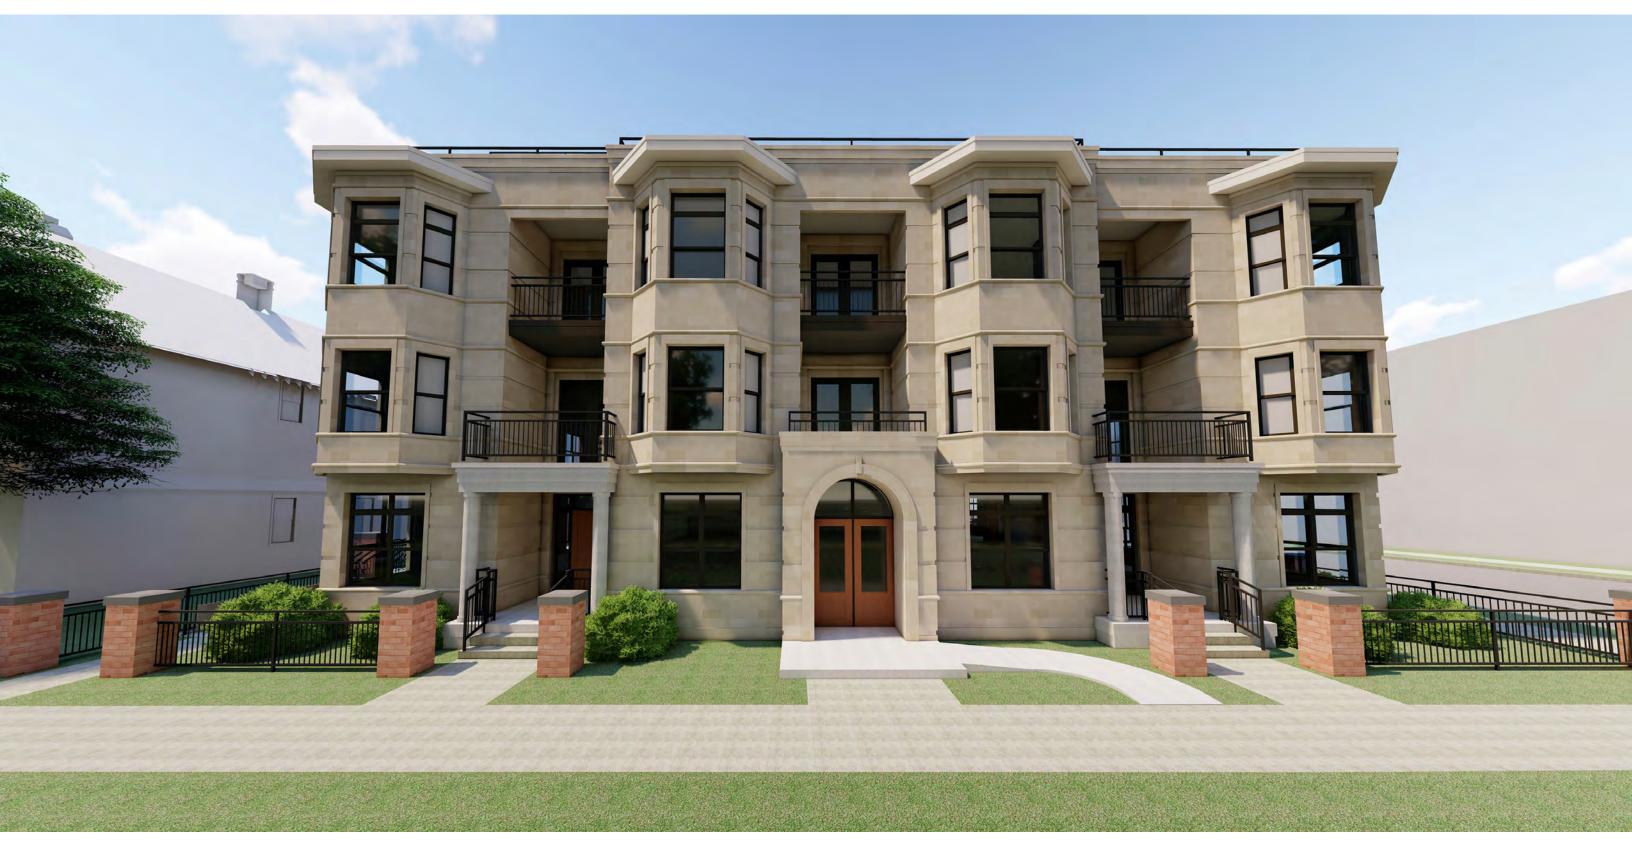
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PROJECT NUMBER 1713

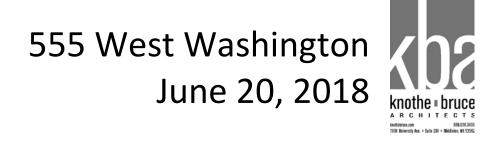
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555 West Washington June 20, 2018

