SITE LOCATION MAP



ADDRESS: 2430 frazier ave madison, wi 53713

PROJECT DIRECTORY

<u>DESIGN-BUILDER</u> ICONICA, INC. 901 DEMING WAY MADISON, WISCONSIN 53717 PHONE: (608) 664-3500 FAX : (608) 664-3535

STARION FINANCIAL

<u>CONSULTANT</u>

999 FOURIER DRIVE, SUITE 201 MADISON, WISCONSIN 53717 PHONE: (608) 826-0532 FAX: (608) 826-0530

<u>OWNER</u> 333 N 4TH STREET BISMARK, ND 58501

STARION - MADISON FRAZIER AVENUE





INDEX OF DRAWINGS										
EET TITLE	SHEET	TITLE	SHEET	TITLE	SHEET	TITLE	SHEET	TITLE	SHEET	TITLE
EET TITLE 01 COVER SHEET							1 1			
CIVIL AND LANDSCAPE OO EXISTING CONDITIONS PLAN OO DEMOLITION PLAN OO SITE PLAN OO GRADING & EROSION CONTROL PLAN OUTILITY PLAN OO CONSTRUCTION DETAILS - 1 O1 CONSTRUCTION DETAILS - 2 O2 CONSTRUCTION DETAILS - 3 O3 CONSTRUCTION DETAILS - 4 O4 CONSTRUCTION DETAILS - 5 OO LANDSCAPE PLAN	SITE	ARCHITECTURAL		ELECTRICAL						
00 EXISTING CONDITIONS PLAN	Δ201	FIRST FLOOR PLAN	E100	PHOTOMETRIC PLAN — BUSINESS PHOTOMETRIC PLAN — NIGHT						
DEMOLITION PLAN	A202	SECOND FLOOR PLAN	E101	PHOTOMETRIC PLAN — NIGHT						
00 SITE PLAN	A203	ROOF PLAN								
OO GRADING & EROSION CONTROL PLAN	A300 A301	ELEVATIONS — WEST AND NORTH								
00 UTILITY PLAN	A301	SECOND FLOOR PLAN ROOF PLAN ELEVATIONS — WEST AND NORTH ELEVATIONS — EAST AND SOUTH								
0 CONSTRUCTION DETAILS - 1										
1 CONSTRUCTION DETAILS - 2										
2 CONSTRUCTION DETAILS - 3										
CONSTRUCTION DETAILS - 4										
04 CONSTRUCTION DETAILS - 5										
0 LANDSCAPE PLAN										
ARCHITECTURAL SITI	E									
O SITE PLAN										
1 SITE DETAILS										
O SITE PLAN 1 SITE DETAILS 2 SITE DETAILS 3 FIRE ACCESS PLAN										
FIRE ACCESS PLAN										
			I							



901 Deming Way // Madison, WI 53717 Ph: 608.664.3500 // Fx: 608.664.3535 iconicacreates.com

ISSUE DATES: UDC INITIAL/FINAL: 05-16-18 CONDITIONAL USE: 05-16-18 **REZONING: 05-16-18**

RFI/SI DATE:


Schematic Design Phase:


This drawing indicates the scale and relationship of the project components. This drawing is **not for** construction.


This document contains confidential or proprietary information of Iconica. Neither the document nor the information herein is to be reproduced, distributed, used or disclosed, either in whole or in part, except as specifically authorized by Iconica.

PROJECT #: 20180130 SHEET NUMBER

A001

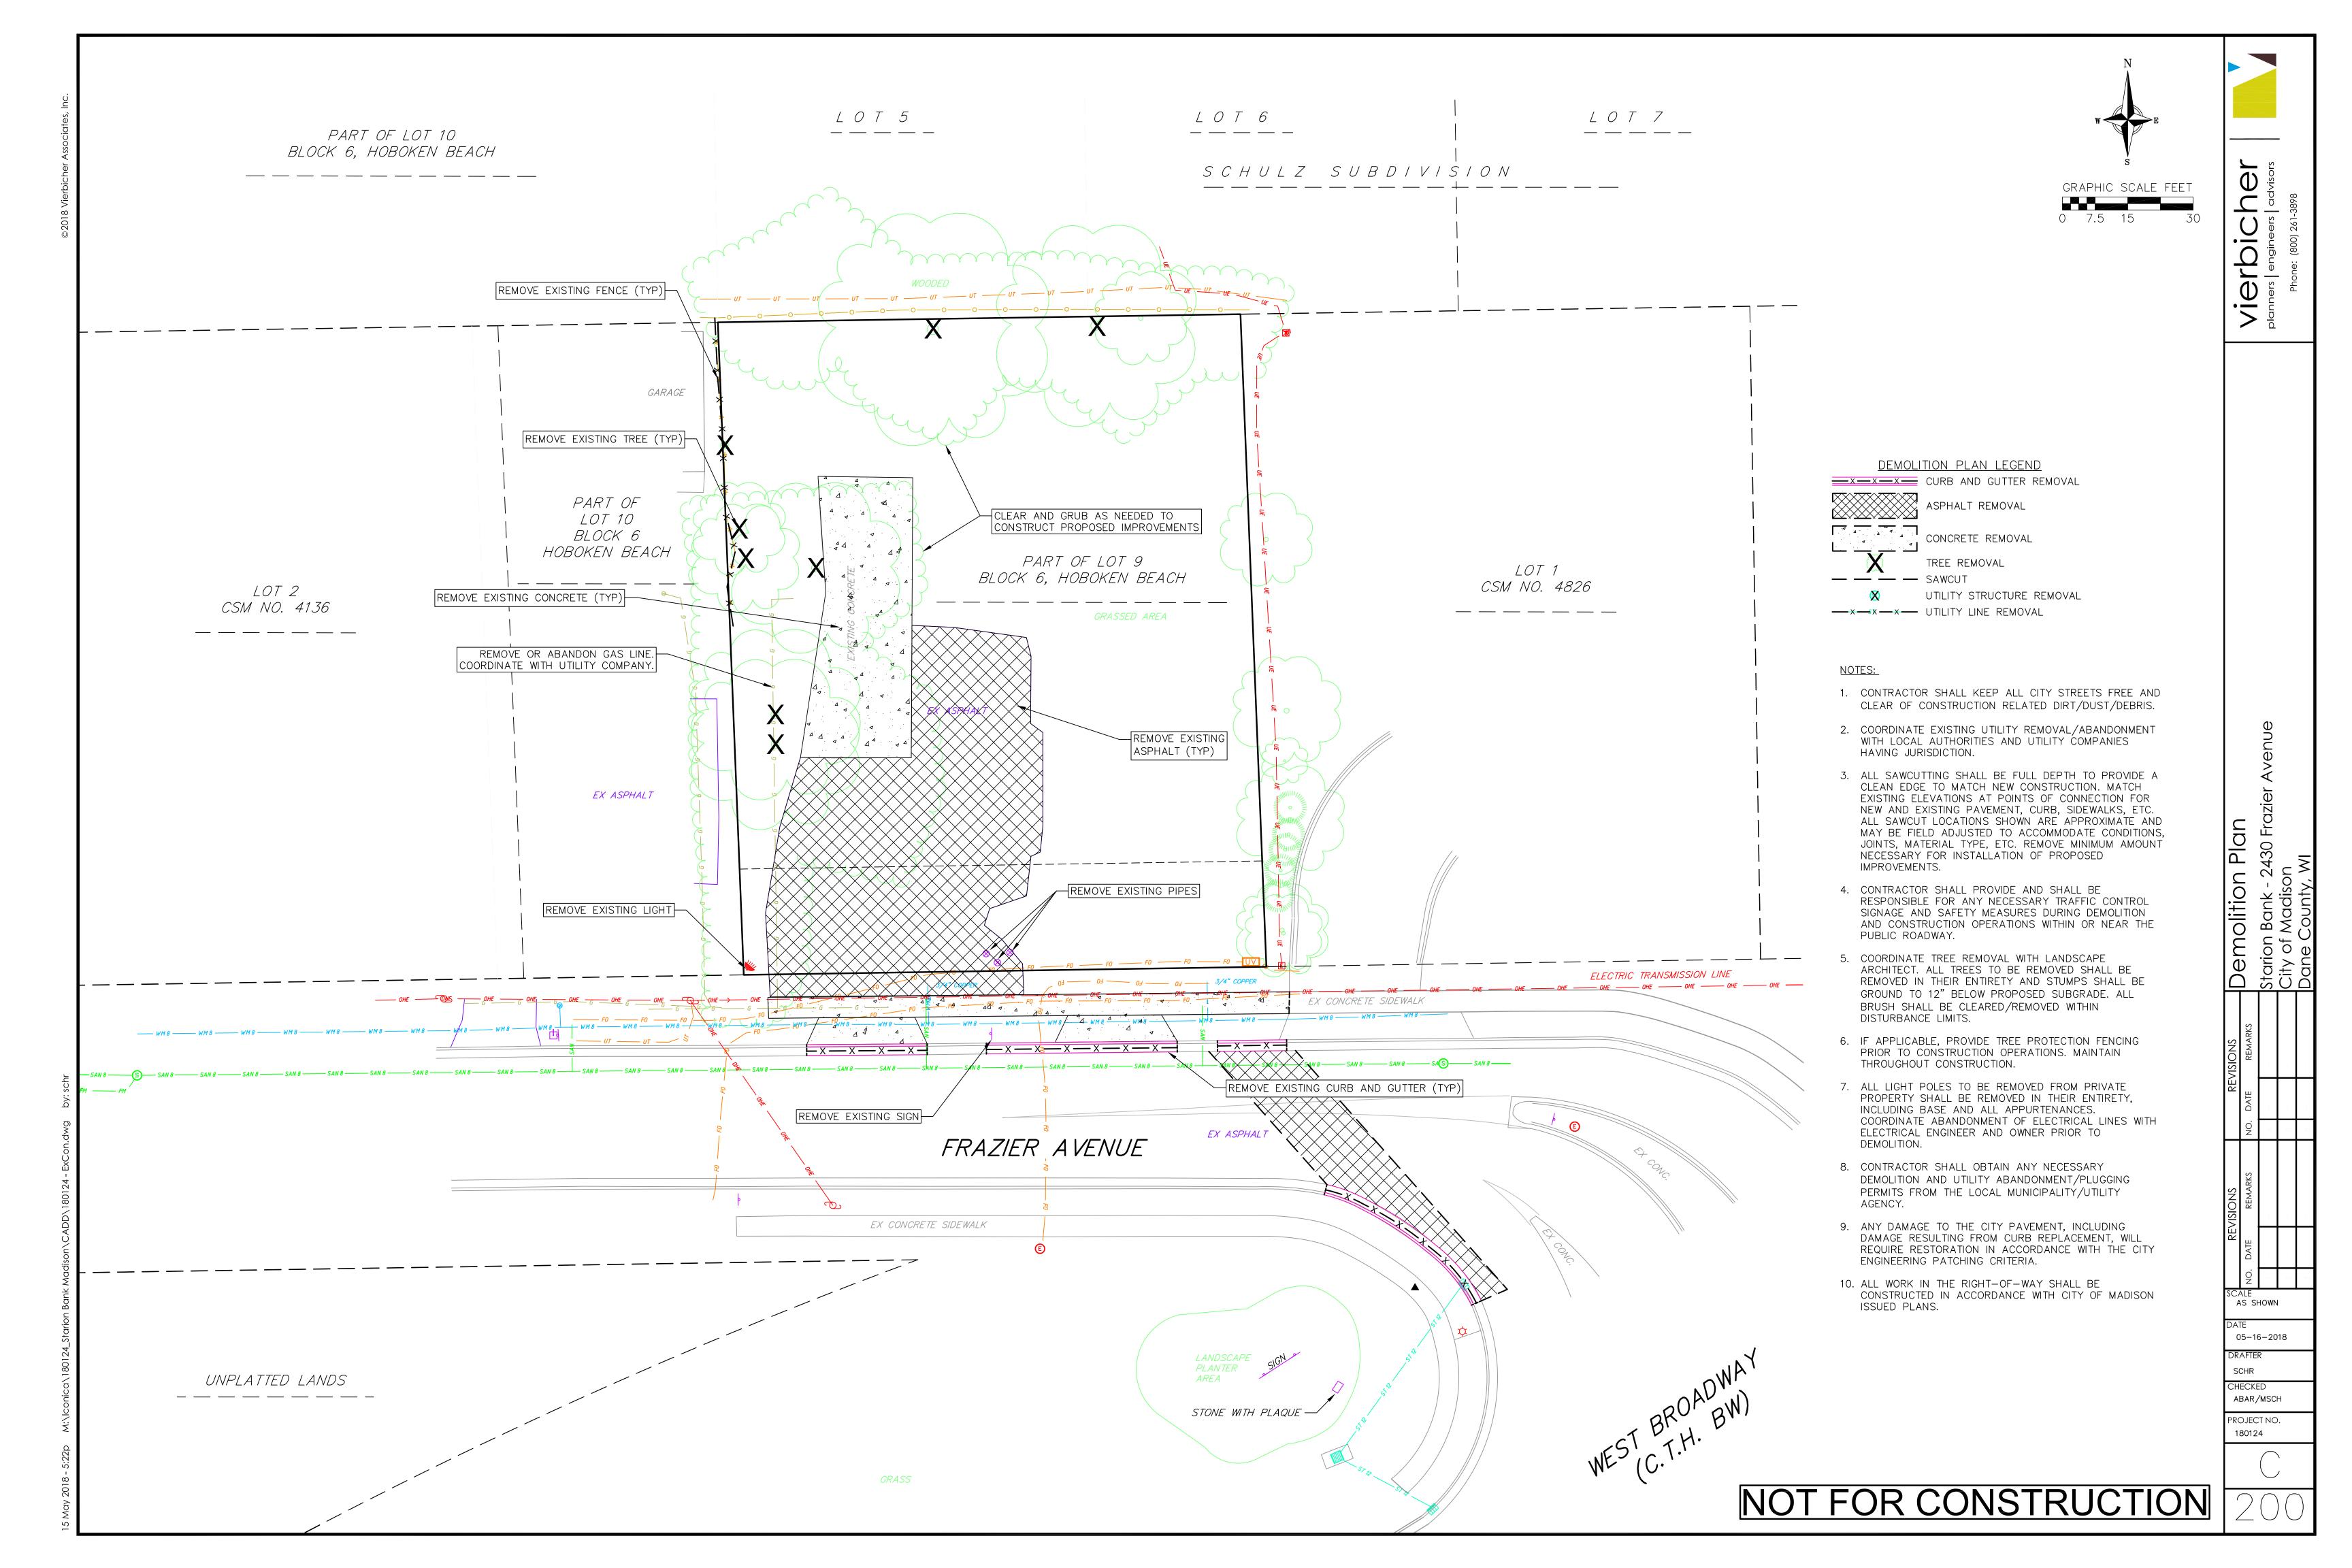

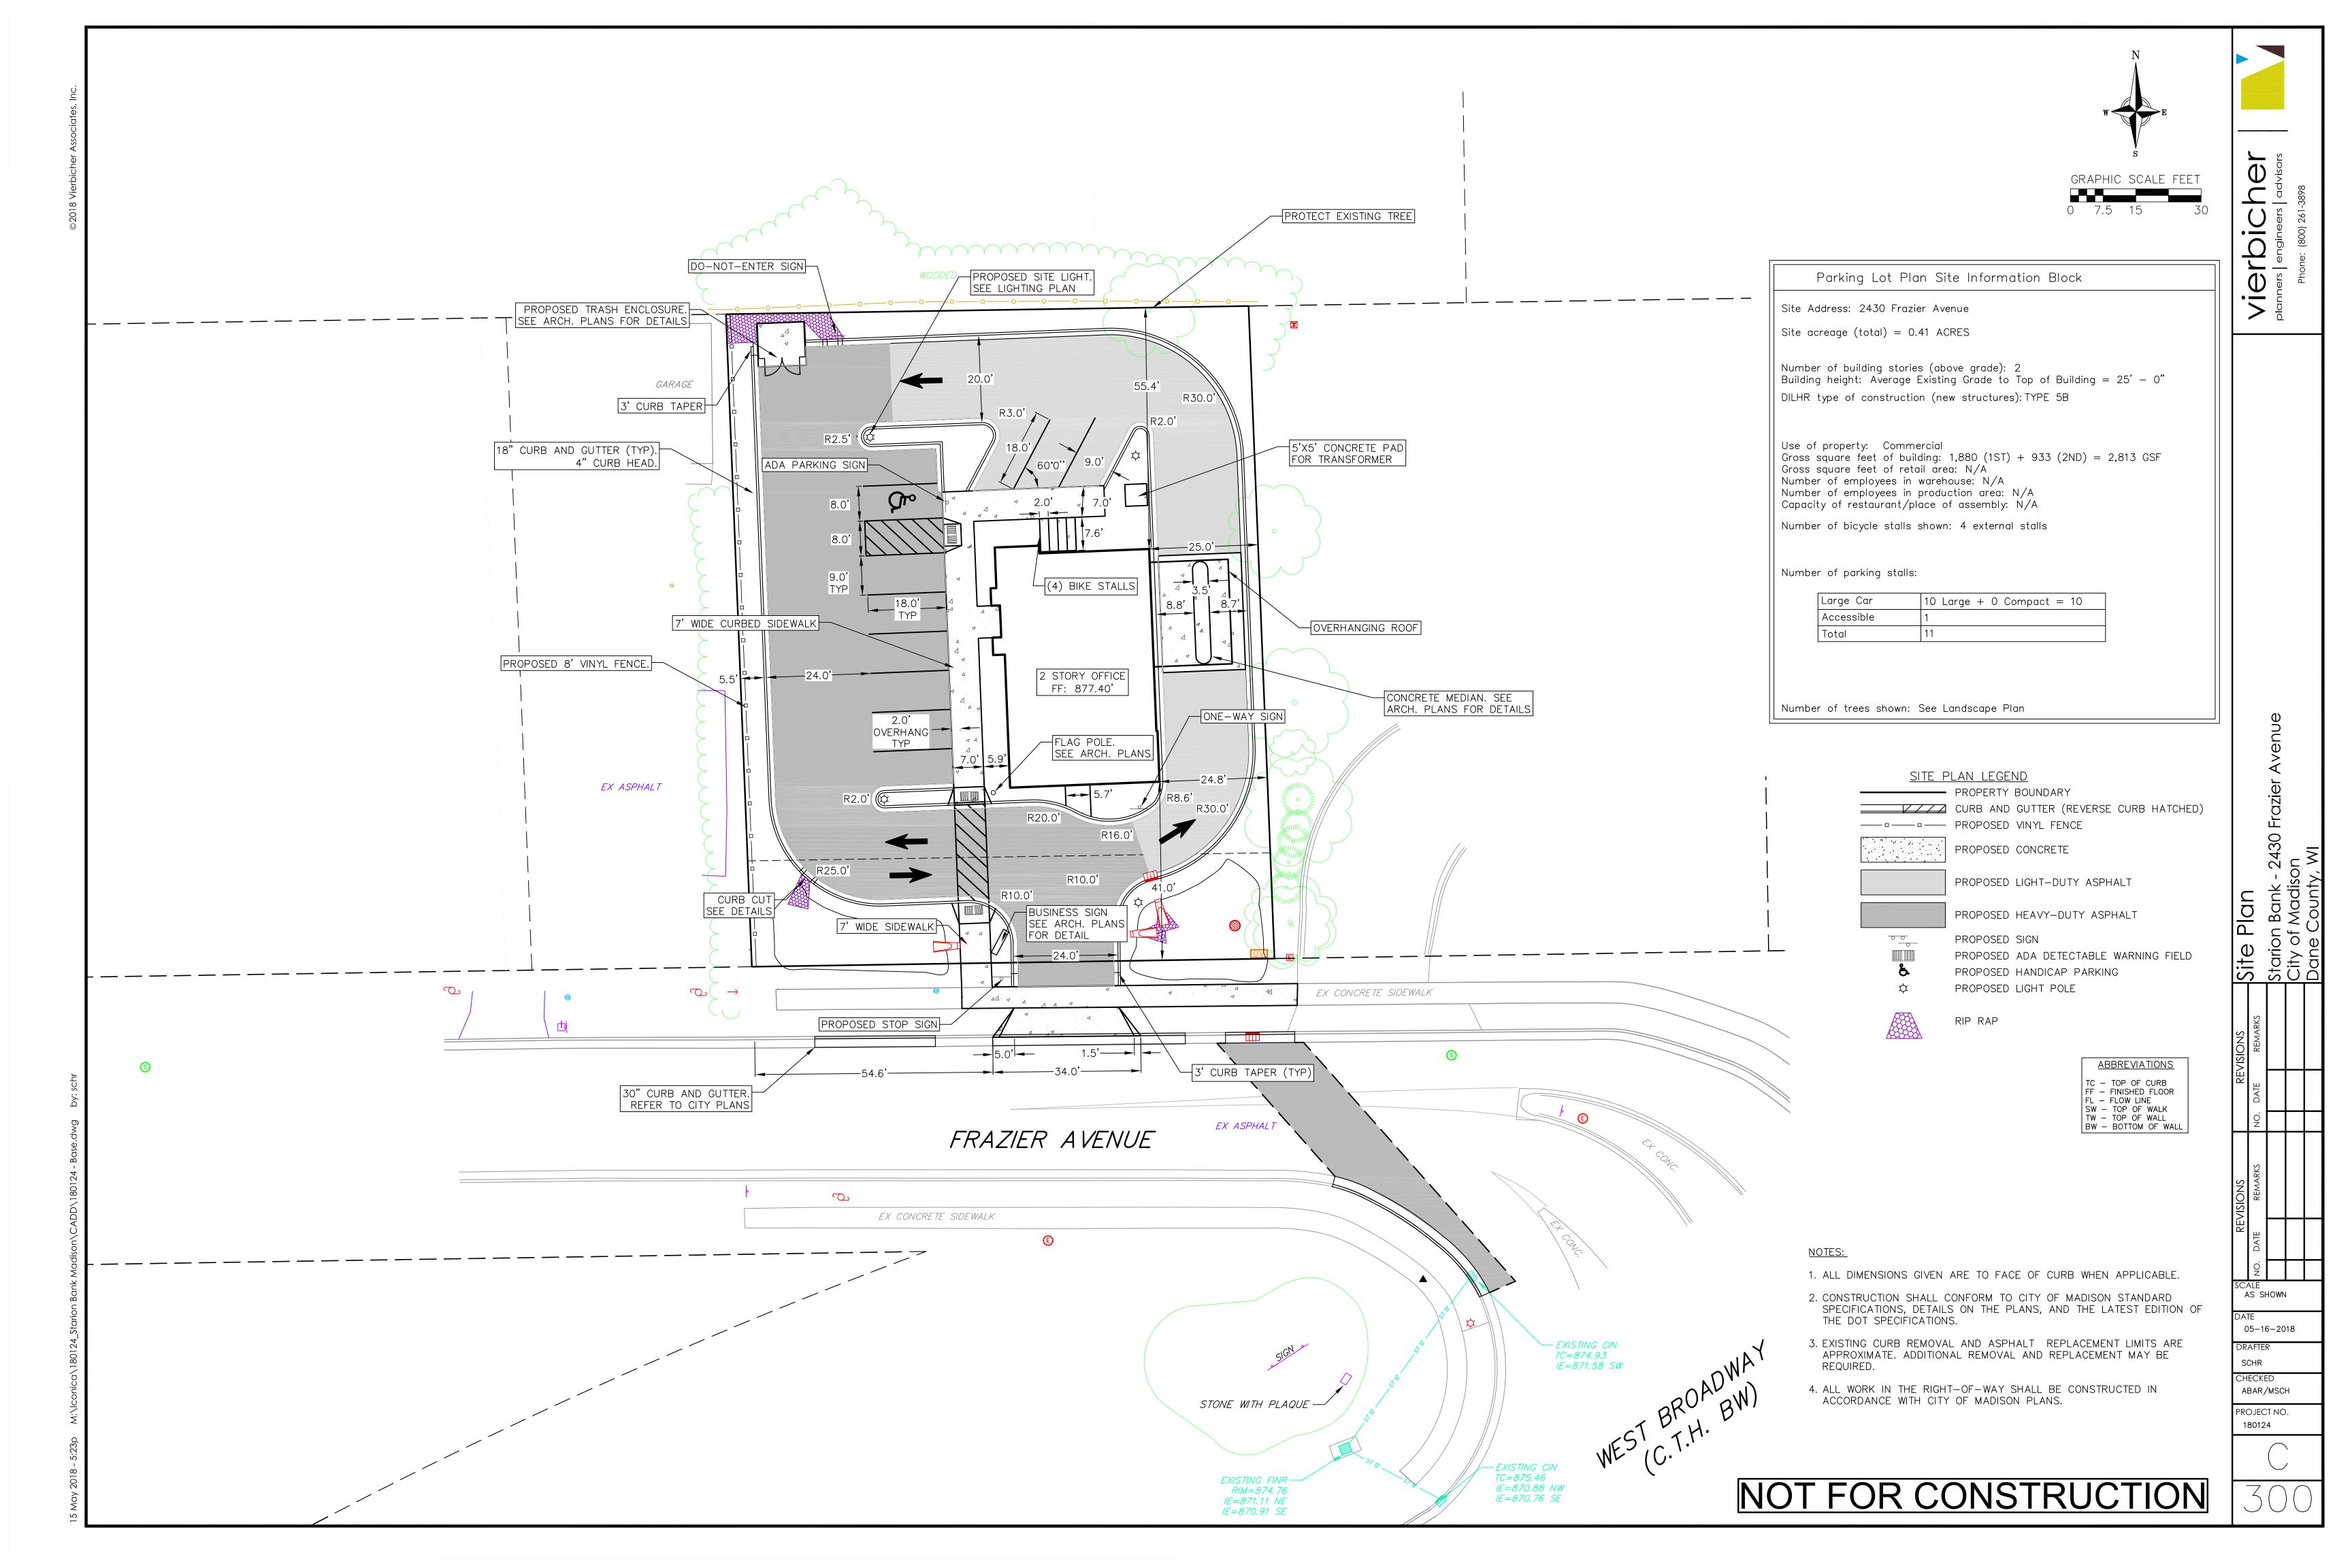

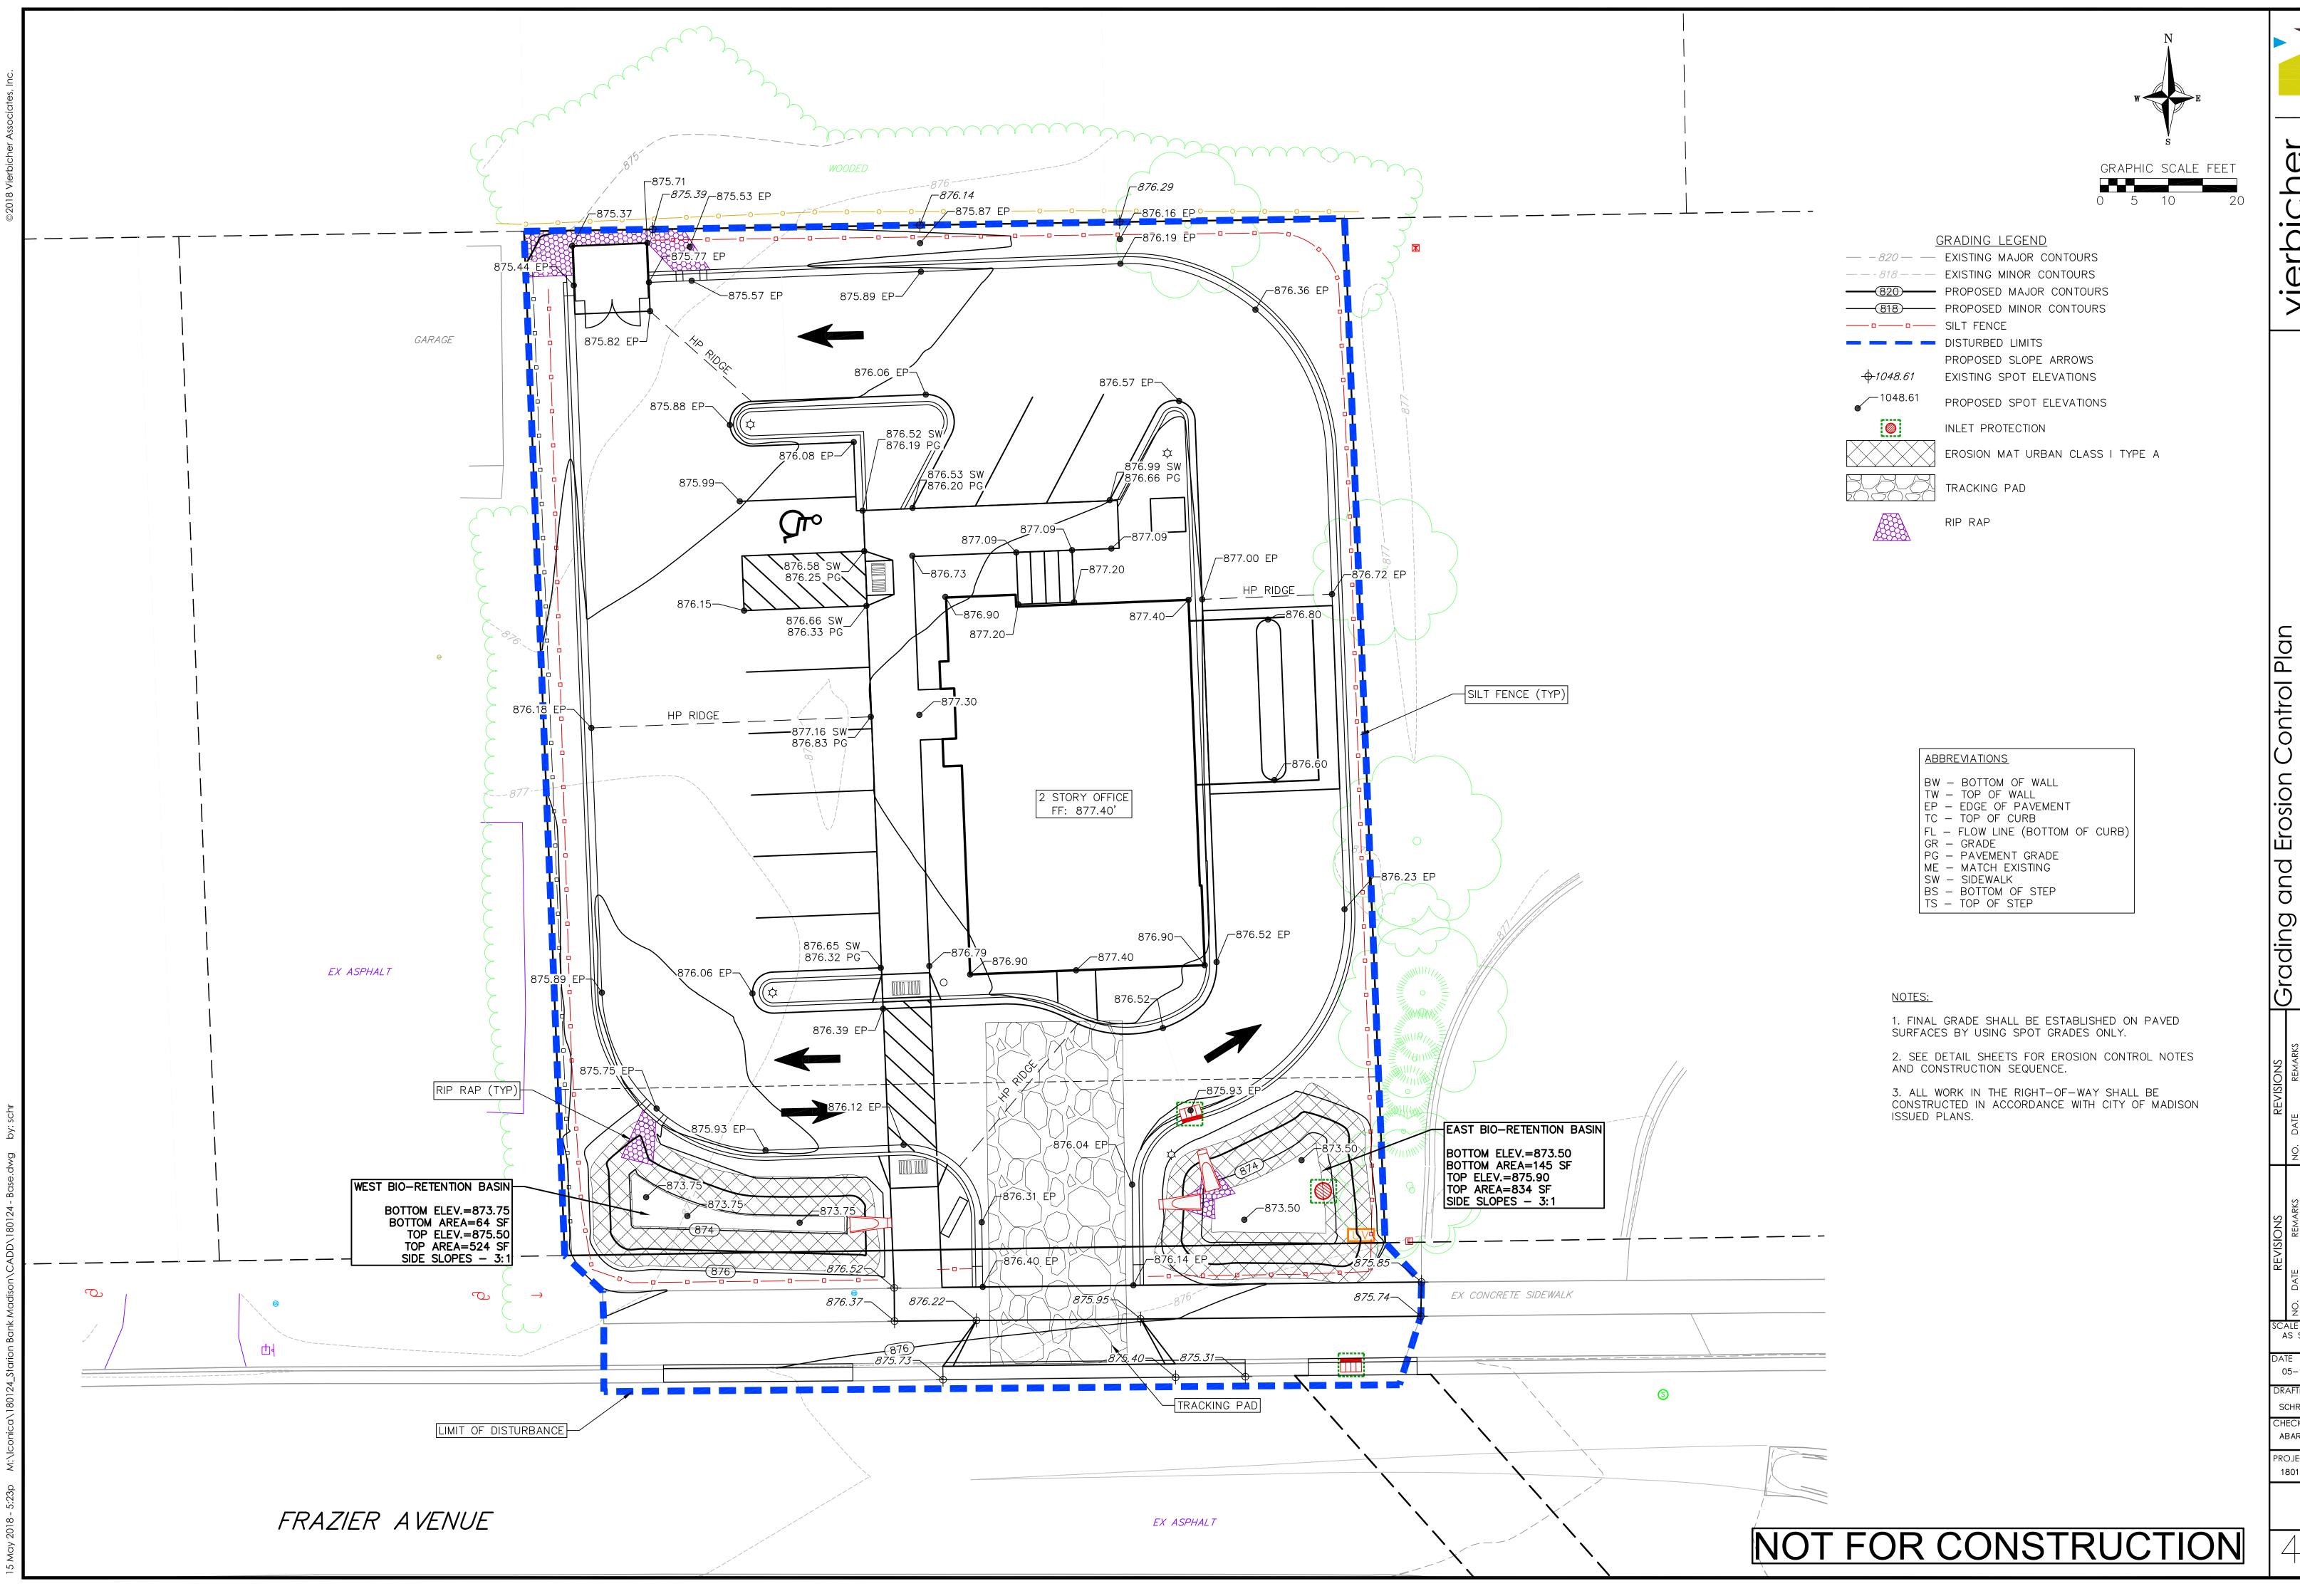

Vierbichers | advisor

> Ig

Grading and Erosion Control Plan
Starion Bank - 2430 Frazier Avenue
City of Madison

SCALE AS SHOWN


DATE 05–16–2018

DRAFTER
SCHR/IGRE
CHECKED

ABAR/MSCH
PROJECT NO.

180124

400

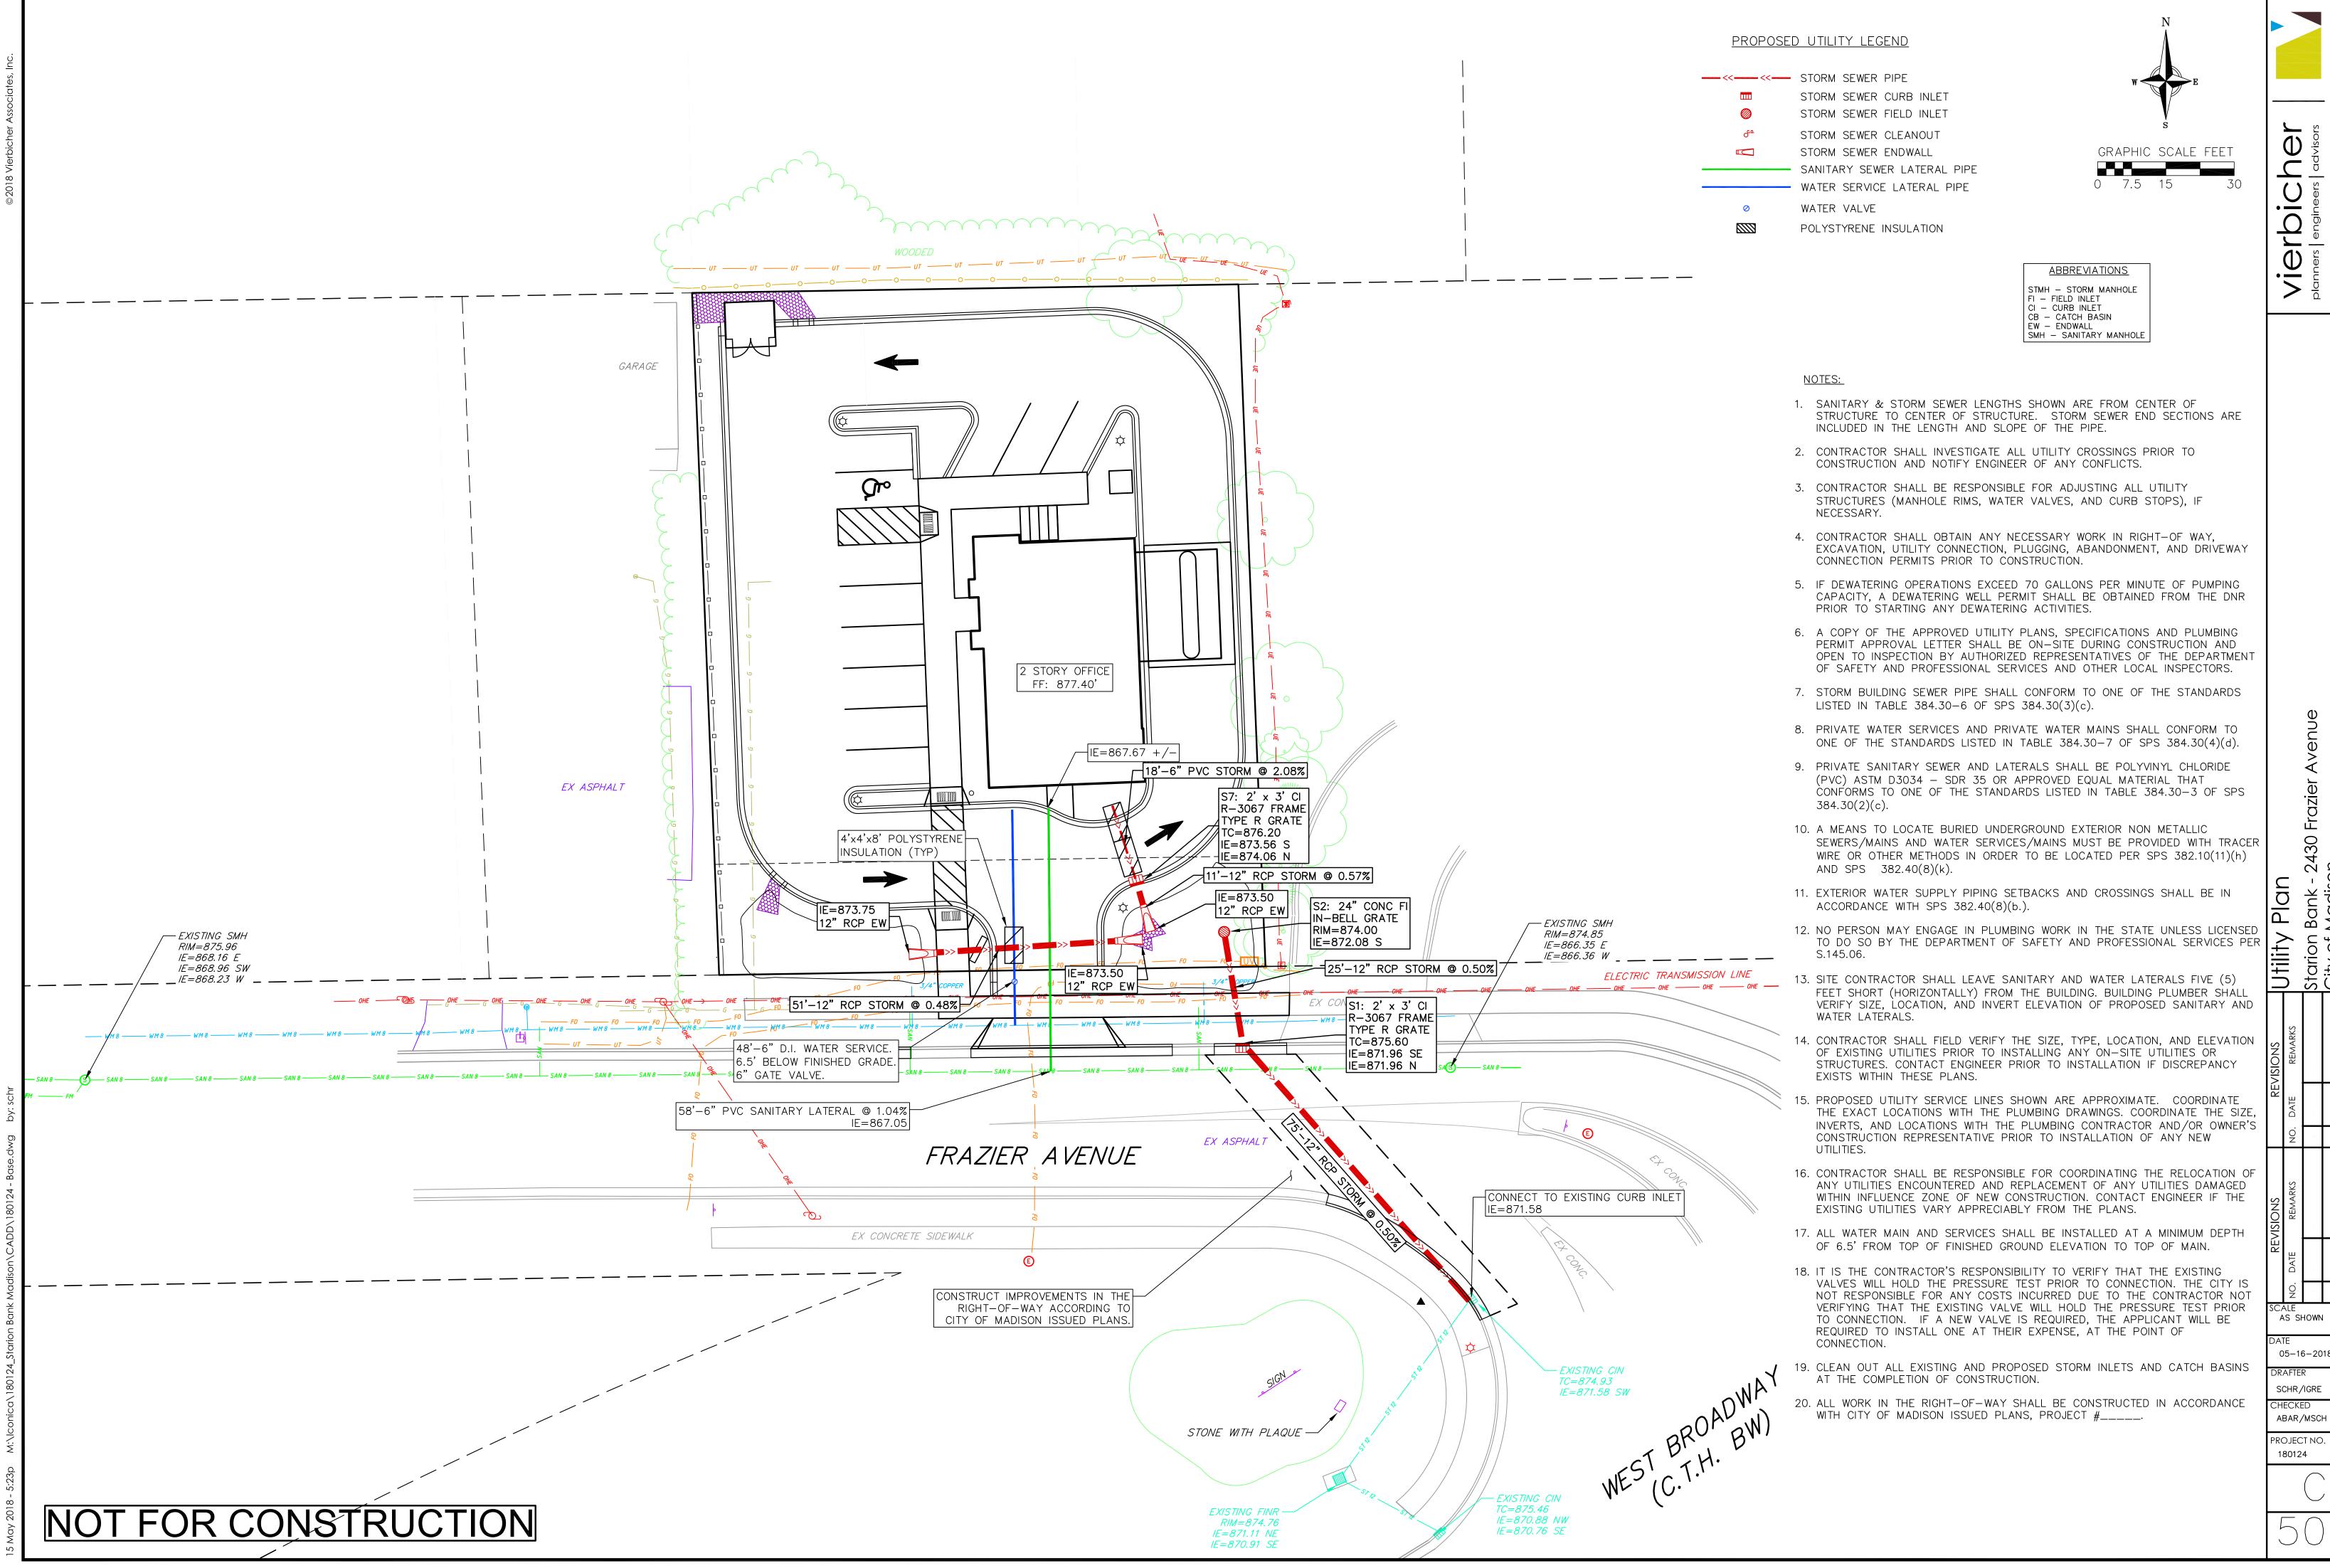

on of e (

05-16-2018

EROSION CONTROL MEASURES

- EROSION CONTROL SHALL BE IN ACCORDANCE WITH THE CITY OF MADISON EROSION CONTROL ORDINANCE AND CHAPTER NR 216 OF THE WISCONSIN ADMINISTRATIVE CODE.
- 2. CONSTRUCT AND MAINTAIN ALL EROSION AND SEDIMENT CONTROL MEASURES IN ACCORDANCE WITH WISCONSIN DNR TECHNICAL STANDARDS (http://dnr.wi.gov/runoff/stormwater/techstds.htm) AND WISCONSIN CONSTRUCTION SITE BEST MANAGEMENT PRACTICE HANDBOOK.
- INSTALL SEDIMENT CONTROL PRACTICES (TRACKING PAD, PERIMETER SILT FENCE, SEDIMENT BASINS, ETC.) PRIOR TO INITIATING OTHER LAND DISTURBING CONSTRUCTION ACTIVITIES.
- 4. THE CONTRACTOR IS REQUIRED TO MAKE EROSION CONTROL INSPECTIONS AT THE END OF EACH WEEK AND WHEN 0.5 INCHES OF RAIN FALLS WITHIN 24 HOURS. INSPECTION REPORTS SHALL BE PREPARED AND FILED AS REQUIRED BY THE DNR AND/OR CITY. ALL MAINTENANCE WILL FOLLOW AN INSPECTION WITHIN 24 HOURS.
- EROSION CONTROL IS THE RESPONSIBILITY OF THE CONTRACTOR UNTIL ACCEPTANCE OF THIS PROJECT. EROSION CONTROL MEASURES AS SHOWN SHALL BE THE MINIMUM PRECAUTIONS THAT WILL BE ALLOWED. ADDITIONAL EROSION CONTROL MEASURES, AS REQUESTED IN WRITING BY THE STATE OR LOCAL INSPECTORS, OR THE DEVELOPER'S ENGINEER, SHALL BE INSTALLED WITHIN 24 HOURS.
- 6. A 3" CLEAR STONE TRACKING PAD SHALL BE INSTALLED AT THE END OF ROAD CONSTRUCTION LIMITS TO PREVENT SEDIMENT FROM BEING TRACKED ONTO THE ADJACENT PAVED PUBLIC ROADWAY. SEDIMENT TRACKING PAD SHALL CONFORM TO WISDNR TECHNICAL STANDARD 1057. SEDIMENT REACHING THE PUBLIC ROAD SHALL BE REMOVED BY STREET CLEANING (NOT HYDRAULIC FLUSHING) BEFORE THE END OF EACH WORK DAY.
- 7. <u>CHANNELIZED RUNOFF:</u> FROM ADJACENT AREAS PASSING THROUGH THE SITE SHALL BE DIVERTED AROUND DISTURBED AREAS.
- STABILIZED DISTURBED GROUND: ANY SOIL OR DIRT PILES WHICH WILL REMAIN IN EXISTENCE FOR MORE THAN 7-CONSECUTIVE DAYS, WHETHER TO BE WORKED DURING THAT PERIOD OR NOT, SHALL NOT BE LOCATED WITHIN 25-FEET OF ANY ROADWAY, PARKING LOT, PAVED AREA, OR DRAINAGE STRUCTURE OR CHANNEL (UNLESS INTENDED TO BE USED AS PART OF THE EROSION CONTROL MEASURES). TEMPORARY STABILIZATION AND CONTROL MEASURES (SEEDING, MULCHING, TARPING, EROSION MATTING, BARRIER FENCING, ETC.) ARE REQUIRED FOR THE PROTECTION OF DISTURBED AREAS AND SOIL PILES, WHICH WILL REMAIN UN-WORKED FOR A PERIOD OF MORE THAN 14-CONSECUTIVE CALENDAR DAYS. THESE MEASURES SHALL REMAIN IN PLACE UNTIL SITE HAS STABILIZED.
- 9. SITE DE-WATERING: WATER PUMPED FROM THE SITE SHALL BE TREATED BY TEMPORARY SEDIMENTATION BASINS OR OTHER APPROPRIATE CONTROL MEASURES. SEDIMENTATION BASINS SHALL HAVE A DEPTH OF AT LEAST 3 FEET, BE SURROUNDED BY SNOWFENCE OR EQUIVALENT BARRIER AND HAVE SUFFICIENT SURFACE AREA TO PROVIDE A SURFACE SETTLING RATE OF NO MORE THAN 750 GALLONS PER SQUARE FOOT PER DAY AT THE HIGHEST DEWATERING PUMPING RATE. WATER MAY NOT BE DISCHARGED IN A MANNER THAT CAUSES EROSION OF THE SITE, A NEIGHBORING SITE, OR THE BED OR BANKS OF THE RECEIVING WATER. POLYMERS MAY BE USED AS DIRECTED BY DNR TECHNICAL STANDARD 1061 (DE-WATERING).
- 10. IN NO CASE WILL RIP-RAP BE SMALLER THAN 3" TO 6".
- 11. INLET FILTERS ARE TO BE PLACED IN STORMWATER INLET STRUCTURES AS SOON AS THEY ARE INSTALLED. ALL PROJECT AREA STORM INLETS NEED WISCONSIN D.O.T. TYPE D INLET PROTECTION. THE FILTERS SHALL BE MAINTAINED UNTIL DISTURBED AREAS ARE PAVED AND VEGETATIVE AREAS ARE 70% ESTABLISHED.
- 12. RESTORATION (SEED, FERTILIZE AND MULCH) SHALL BE PER SPECIFICATIONS ON THIS SHEET UNLESS SPECIAL RESTORATION IS CALLED FOR ON THE LANDSCAPE PLAN.
- 13. VEGETATIVE AREAS SHALL BE RESTORED WITH 6" TOPSOIL, PERMANENT SEED, FERTILIZER AND MULCH.
- 14. SEED, FERTILIZER AND MULCH SHALL BE APPLIED WITHIN 7 DAYS AFTER FINAL GRADE HAS BEEN ESTABLISHED. IF DISTURBED AREAS WILL NOT BE RESTORED IMMEDIATELY AFTER ROUGH GRADING, TEMPORARY SEED SHALL BE PLACED.
- 15. FOR THE FIRST SIX WEEKS AFTER RESTORATION (E.G. SEED & MULCH, EROSION MAT, SOD) OF A DISTURBED AREA, INCLUDE SUMMER WATERING PROVISIONS OF ALL NEWLY SEEDED AND MULCHED AREAS WHENEVER 7 DAYS ELAPSE WITHOUT A RAIN EVENT.
- 16. EROSION MAT (CLASS I, TYPE A URBAN PER WISCONSIN D.O.T. P.A.L.) SHALL BE INSTALLED ON ALL SLOPES 3:1 OR GREATER BUT LESS
- 17. SILT FENCE TO BE USED ACROSS AREAS OF THE LOT THAT SLOPE TOWARDS A PUBLIC STREET OR WATERWAY. SEE DETAILS.
- 18. SEDIMENT SHALL BE CLEANED FROM CURB AND GUTTER AFTER EACH RAINFALL AND PRIOR TO PROJECT ACCEPTANCE.
- 19. ACCUMULATED CONSTRUCTION SEDIMENT SHALL BE REMOVED FROM ALL PERMANENT BASINS TO THE ELEVATION SHOWN ON THE GRADING PLAN FOLLOWING THE STABILIZATION OF DRAINAGE AREAS.
- 20. ANY PROPOSED CHANGES TO THE EROSION CONTROL PLAN MUST BE SUBMITTED AND APPROVED BY THE CITY OF MADISON AND DNR.
- 21. THE CITY, OWNER AND/OR ENGINEER MAY REQUIRE ADDITIONAL EROSION CONTROL MEASURES AT ANY TIME DURING CONSTRUCTION.

SEEDING RATES:

<u>TEMPORARY:</u>

1. USE ANNUAL OATS AT 3.0 LB./1,000 S.F. FOR SPRING AND SUMMER PLANTINGS. 2. USE WINTER WHEAT OR RYE AT 3.0 LB./1,000 SF FOR FALL

PLANTINGS STARTED AFTER SEPTEMBER 15.

1. USE WISCONSIN D.O.T. SEED MIX #40 AT 2 LB./1,000 S.F.

FERTILIZING RATES:

TEMPORARY AND PERMANENT:

USE WISCONSIN D.O.T. TYPE A OR B AT 7 LB./1,000 S.F.


MULCHING RATES:

TEMPORARY AND PERMANENT:

USE $1 M M^{2}$ TO 1 $- M M M^{2}$ STRAW OR HAY MULCH, CRIMPED PER SECTION 607.3.2.3, OR OTHER RATE AND METHOD PER SECTION 627, WISCONSIN D.O.T. STANDARD SPECIFICATIONS FOR HIGHWAY AND STRUCTURE CONSTRUCTION

CONSTRUCTION SEQUENCE:

- 1. INSTALL EROSION CONTROL MEASURES
- 2. CONDUCT DEMOLITION
- 3. ROUGH GRADE BIORETENTION BASINS
- 4. STRIP TOPSOIL SITE
- 5. ROUGH GRADE SITE
- 6. CONSTRUCT UNDERGROUND UTILITIES
- 7. INSTALL INLET PROTECTION IN NEW INLETS
- 8. CONSTRUCT BUILDING
- 9. CONSTRUCT RETAINING WALL
- 10. CONSTRUCT PAVEMENT
- 11. FINAL GRADE AND RESTORE DISTURBED AREAS
- 12. FINAL GRADE BIORETENTION BASINS, REMOVE CONSTRUCTION SEDIMENT, PLACE ENGINEERED SOIL AND RESTORE PER PLAN.
- 13. REMOVE EROSION CONTROL MEASURES AFTER DISTURBED AREAS ARE PAVED AND VEGETATIVE AREAS ARE 70% RESTORED

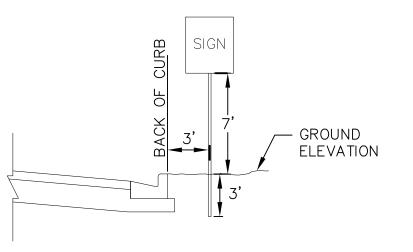

TOP OF CURB TAPER CURB HEAD FROM 6" TO 0" EDGE OF PAVEMENT

PROFILE VIEW


CURB & GUTTER TERMINATION NOT TO SCALE


SIGNAGE NOTES:

- 1. ALL SIGNS SHALL BE FABRICATED AND INSTALLED IN ACCORDANCE WITH THE MANUAL ON UNIFORM TRAFFIC CONTROL DEVICES.
- 2. SIGNS SHALL BE A DISTANCE OF 7' FROM GROUND LEVEL TO THE BOTTOM OF THE SIGN MOUNTED ON THE POST AND LOCATED 3' BEHIND THE BACK OF CURB.
- STREET NAME SIGNS SHALL HAVE WHITE LETTERS AND GREEN BACKGROUND.
- 4. SIGN POSTS SHALL BE 2-3/8" O.D., GALVANIZED 10 FT LONG, 13 GAUGE, AND 0.095 WALL THICKNESS. MOUNT SIGN AT TOP OF THE POST, AND INSTALL POSTS 3' DEEP AND MIX 1/2 BAG OF 80 LB SAKRETE CONCRETE, POURING IT AROUND THE POST BELOW THE GROUND BEFORE COVERING WITH 8" OF TOPSOIL
- 5. LOADING ZONE SIGNS SHALL BE 12"X9" R8-3qP.
- 6. ONE-WAY SIGNS SHALL BE 18"X24" R6-2.
- 7. DO NOT ENTER SIGN SHALL BE 30"X30" R5-1.

STANDARD SIGN


NOT TO SCALE

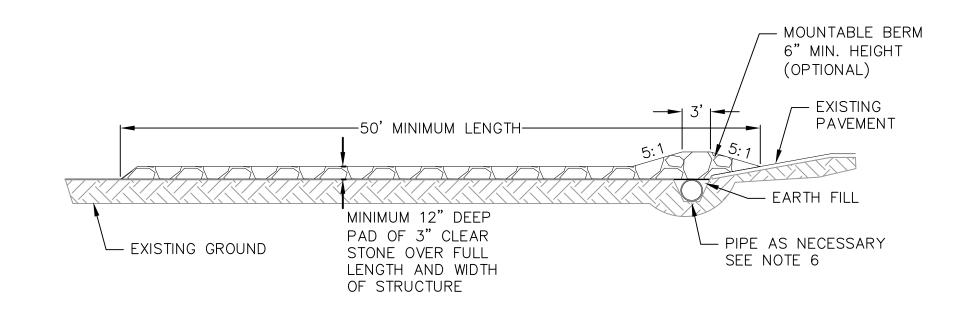

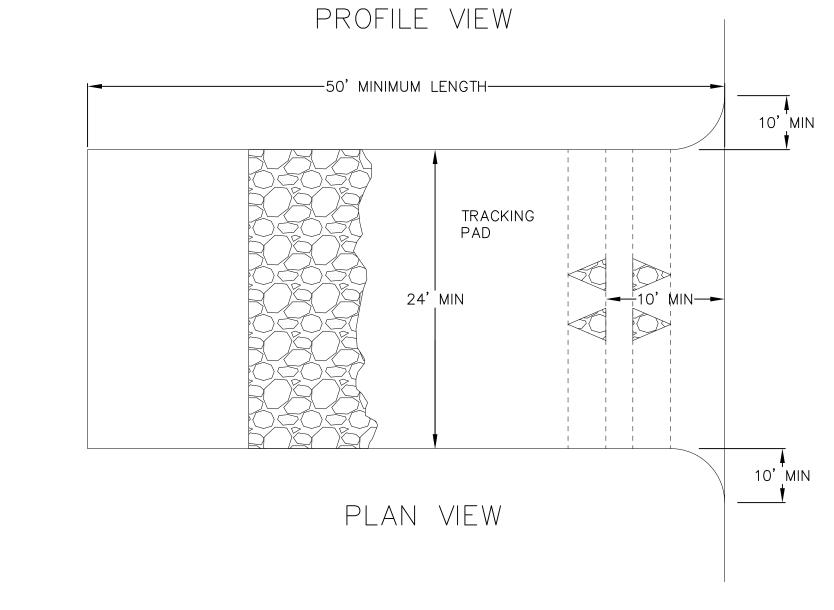

- 1. FOLLOW WISCONSIN DNR TECHNICAL STANDARD 1057 FOR FURTHER DETAILS AND INSTALLATION.
- 2. LENGTH MINIMUM OF 50'
- 3. WIDTH 24' MINIMUM, SHOULD BE FLARED AT THE EXISTING ROAD TO PROVIDE A TURNING RADIUS.
- 4. ON SITES WITH A HIGH GROUND WATER TABLE OR WHERE SATURATED CONDITIONS EXIST, GEOTEXTILE FABRIC SHALL BE PLACED OVER EXISTING GROUND PRIOR TO PLACING STONE. FABRIC SHALL BE WISDOT TYPE—HR GEOTEXTILE FABRIC.
- 5. STONE CRUSHED 3" CLEAR STONE SHALL BE PLACED AT LEAST 12" DEEP OVER THE ENTIRE LENGTH AND WIDTH OF ENTRANCE.
- 6. SURFACE WATER ALL SURFACE WATER FLOWING TO OR DIVERTED TOWARDS CONSTRUCTION ENTRANCES SHALL BE PIPED THROUGH THE ENTRANCE. MAINTAINING POSITIVE DRAINAGE. PIPE INSTALLED THROUGH THE STABILIZED CONSTRUCTION ENTRANCE SHALL BE PROTECTED WITH A MOUNTABLE BERM WITH 5:1 SLOPES AND MINIMIUM OF 6" STONE OVER THE PIPE. PIPE SHALL BE SIZED ACCORDING TO THE DRAINAGE REQUIREMENTS. WHEN THE ENTRANCE IS LOCATED AT A HIGH SPOT AND HAS NO DRAINAGE TO CONVEY A PIPE SHALL NOT BE NECESSARY. THE MINIMUM PIPE DIAMETER SHALL BE 6". CONTRACTOR SHALL BE RESPONSIBLE FOR THE MAINTENANCE OF SAID PIPE.
- 7. LOCATION A STABILIZED CONSTRUCTION ENTRANCE SHALL BE LOCATED WHERE CONSTRUCTION TRAFFIC ENTERS AND/OR LEAVES THE CONSTRUCTION SITE. VEHICLES LEAVING THE SITE MUST TRAVEL OVER THE ENTIRE LENGTH OF THE TRACKING PAD.



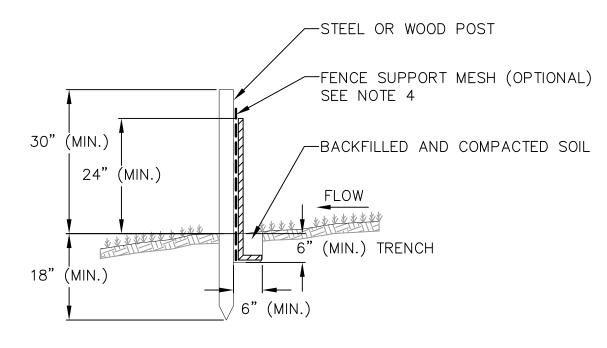


NOTES:

- 1. INSTALL SILT FENCE TO FOLLOW THE GROUND CONTOURS AS CLOSELY AS POSSIBLE.
- 2. CURVE THE SILT FENCE UP THE SLOPE TO PREVENT WATER FROM RUNNING AROUND THE
- 3. POST SPACING WITH FENCE SUPPORT MESH = 10 FT. (MAX.)
 - POST SPACING WITHOUT FENCE SUPPORT MESH = 6 FT. (MAX.)
- 4. SILT FENCE SUPPORT MESH CONSISTS OF 14-GAUGE STEEL WIRE WITH A MESH SPACING OF 6 IN. X 6 IN. OR PREFABRICATED POLYMERIC MESH OF EQUIVALENT STRENGTH



NOT FOR CONSTRUCTION

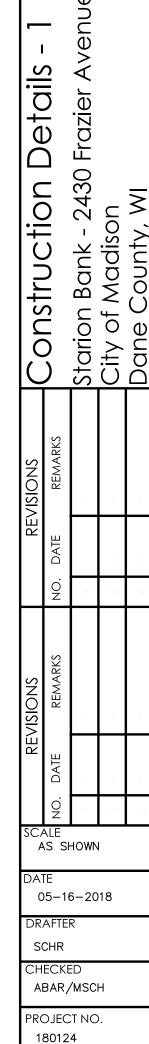

• —

5

0

·<u>></u>

05-16-2018

SCHR CHECKED

ABAR/MSCH PROJECT NO. 180124

BASIN FOR SOLIDS -IMPERMEABLE MEMBRANE THROUGHOUT - EVAPORATION BASIN FOR LIQUIDS IMPERMEABLE MEMBRANE — -SOIL OR STRAW BALE 3 FT TYP. SOLIDS LIQUIDS *`*^\`/\\`** -1:1 MAX SIDE SLOPE SECTION A-A TEMPORARY FORMING TO COLLECT SOLIDS. -REPLACE AS NECESSARY. PLAN

Vinyl Fence Products

CERTAINTEED CORPORATION FENCE. DECK & RAIL DIVISION 231 SHIP CANAL PARKWAY BUFFALO, NY 14218 TOLL FREE:1-800-333-0569 PHONE: (716) 823-3023 FAX: (716) 823-2843 www.certainteed.com

8'

7'

SELECT DESIRED COLOR

ARBOR BLEND ☐ ARCTIC BLEND


■ BRAZILIAN BLEND


☐ FRONTIER BLEND ☐ HONEY BLEND

■ NATURAL CLAY

☐ SIERRA BLEND

■ WEATHERED BLEND

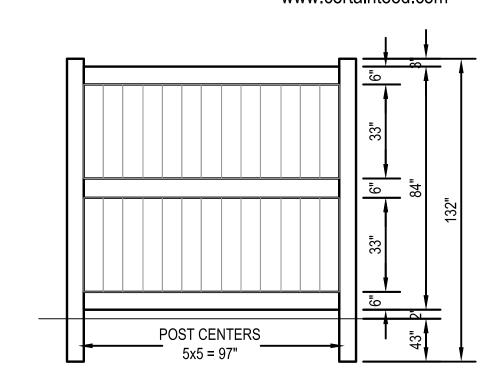

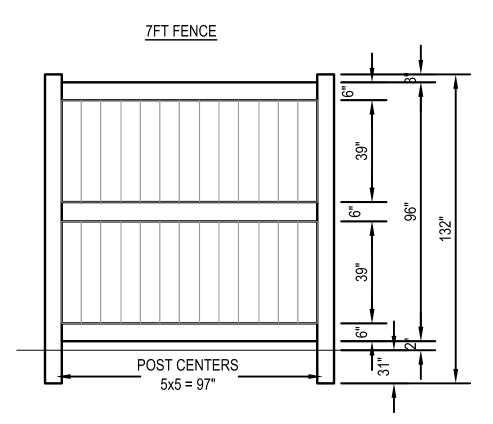

8FT FENCE

1. INSTALLATION TO BE COMPLETED IN ACCORDANCE WITH MANUFACTURER'S SPECIFICATIONS. 2. DO NOT SCALE DRAWINGS.

3. CONTRACTORS NOTE: FOR PRODUCT AND COMPANY INFORMATION VISIT www.CADdetails.com/info REFERENCE NUMBER 035-088.

PROTECTED BY COPYRIGHT ©2013 CADdetails.com LTD.

www CADdetails.com


VINYL FENCE NOT TO SCALE


1. LOCATE WASHOUT STRUCTURE A MINIMUM OF 50 FEET AWAY FROM OPEN CHANNELS, STORM DRAIN INLETS,

2.PREPARE SOIL BASE FREE OF ROCKS OR OTHER DEBRIS THAT MAY CAUSE TEARS OR HOLES IN THE LINER. FOR LINER, USE 10 MIL OR THICKER UV RESISTANT, IMPERMEABLE SHEETING, FREE OF HOLES AND TEARS OR

3.KEEP CONCRETE WASHOUT STRUCTURE WATER TIGHT. REPLACE IMPERMEABLE LINER IF DAMAGED (E.G., RIPPED OR PUNCTURED). EMPTY OR REPLACE WASHOUT STRUCTURE THAT IS 75 PERCENT FULL, AND DISPOSE OF ACCUMULATED MATERIAL PROPERLY. DO NOT REUSE PLASTIC LINER. WET-VACUUM STORED LIQUIDS THAT HAVE NOT EVAPORATED AND DISPOSE OF IN AN APPROVED MANNER. REMOVE HARDENED SOLIDS, WHOLE OR BROKEN UP, FOR DISPOSAL OR RECYCLING. MAINTAIN RUNOFF DIVERSION AROUND EXCAVATED WASHOUT STRUCTURE UNTIL STRUCTURE IS REMOVED.




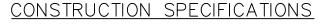

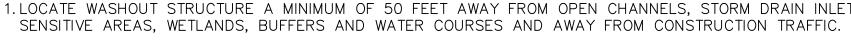

OTHER DEFECTS THAT COMPROMISE IMPERMEABILITY OF THE MATERIAL.

INLET PROTECTION TYPE D NOT TO SCALE

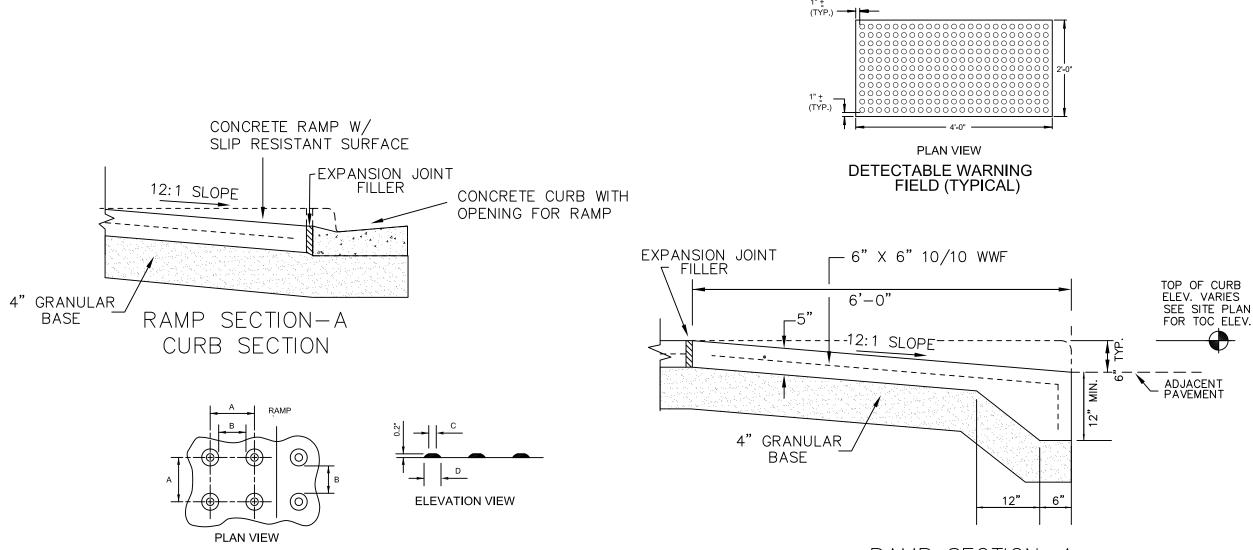


RAMP SECTION-A SIDEWALK / CURB COMBINATION TRUNCATED DOMES DETECTABLE WARNING PATTERN DETAIL

THE VILLAGE ENGINEER 2) COLOR SHALL BE A DISSIMILAR COLOR FROM THE ADJACENT PAVED SURFACE AND APPROVED BY THE OWNER AND

NOTE: 1) MATERIALS AND METHOD OF CONSTRUCTION FOR TRUNCATED

DOMES SHALL BE SPECIFIED IN SPECIAL PROVISIONS OR AS REQUIRED BY

CURB RAMP DETAIL

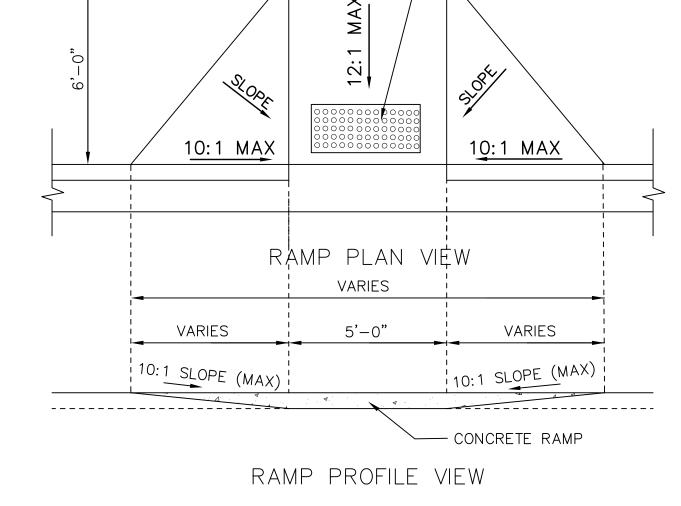

BAG TO BE CONSTRUCTED USING GEOTEXTILE FABRIC, WisDOT TYPE

DIMENSIONS OF TOP OPENING OF

FRONT, BACK AND BOTTOM PANEL TO BE MADE FROM SINGLE PIECE OF

CURB BOX OPENING.

TO WITHIN 3" OF THE GRATE.

- 4" x 6" OVAL HOLE CUT INTO ALL

FOUR SIDE PANELS. HOLES TO BE POSITIONED MIN. 8" BELOW INLET

PANELS AND AT FLAP POCKETS.

4" FROM BAG BOTTOM) TO ACHIEVE

INLET PROTECTION DEVICES SHALL BE

WHEN REMOVING OR MAINTAINING INLET PROTECTION, ANY TRAPPED MATERIAL THAT

FALLS INTO THE INLET SHALL BE

MAINTAINED OR REPLACED AT THE DIRECTION

IMMEDIATELY REMOVED BY THE CONTRACTOR.

2'x4' DETECTABLE WARNING FIELD

CLEARANCE.

IF INLET DEPTH FROM TOP OF

LESS THAN 30", CONTRACTOR

INLET PROTECTION.

GRATE TO BOTTOM OF INLET IS

SHALL SUBSTITUTE WisDOT TYPE C

OF THE ENGINEER.

CLEARANCE OF 3" FROM THE INLET WALLS, MEASURED AT THE HOLES. IF NECESSARY, CONTRACTOR SHALL CINCH THE BAG (MAX.

- BOTTOM DIMENSION = 12"

- FLAP POCKET TO BE FITTED WITH REBAR OR STEEL ROD FOR REMOVAL. IF USED


BAG TO MATCH INLET GRATE.

FABRIC (NO SEAMS).


GENERAL NOTES RAMPS SHALL BE BUILT AT 12:1 OR FLATTER WHEN NECESSARY, THE SIDEWALK ELEVATION MAY BE LOWERED TO MEET THE HIGH POINT ON THE RAMP.


NOT FOR CONSTRUCTION


NOT TO SCALE

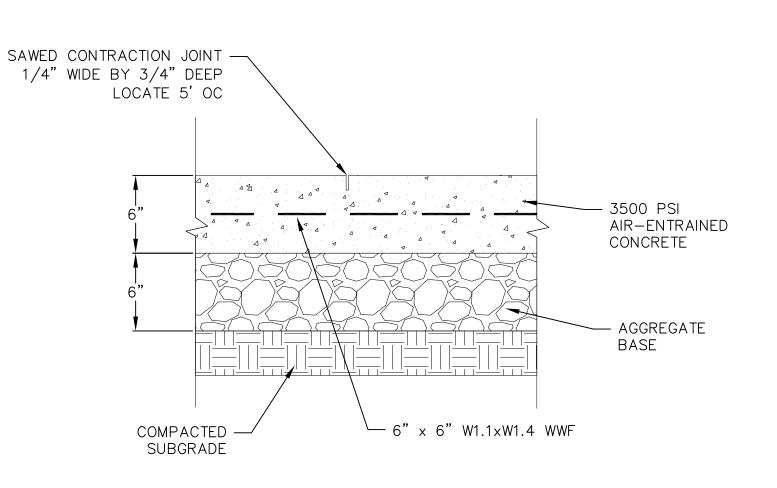

CONCRETE PAD NOT TO SCALE

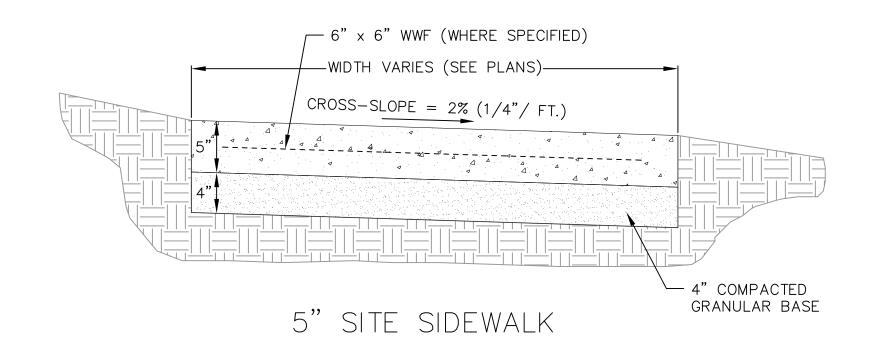


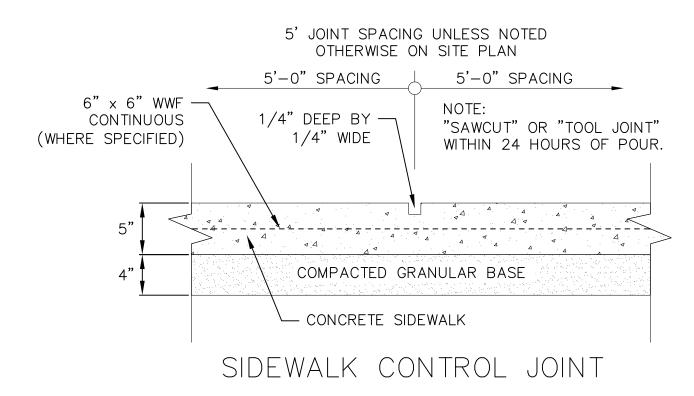

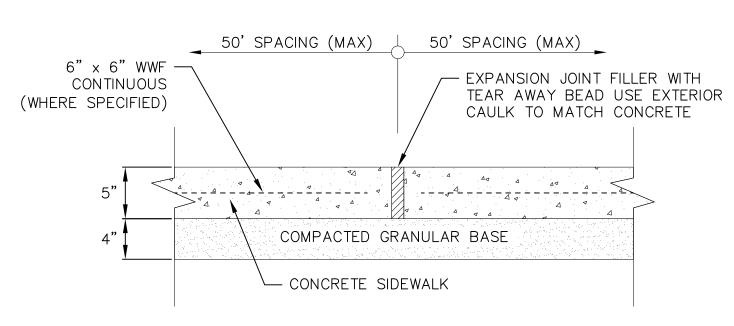

SIDEWALK EXPANSION JOINT



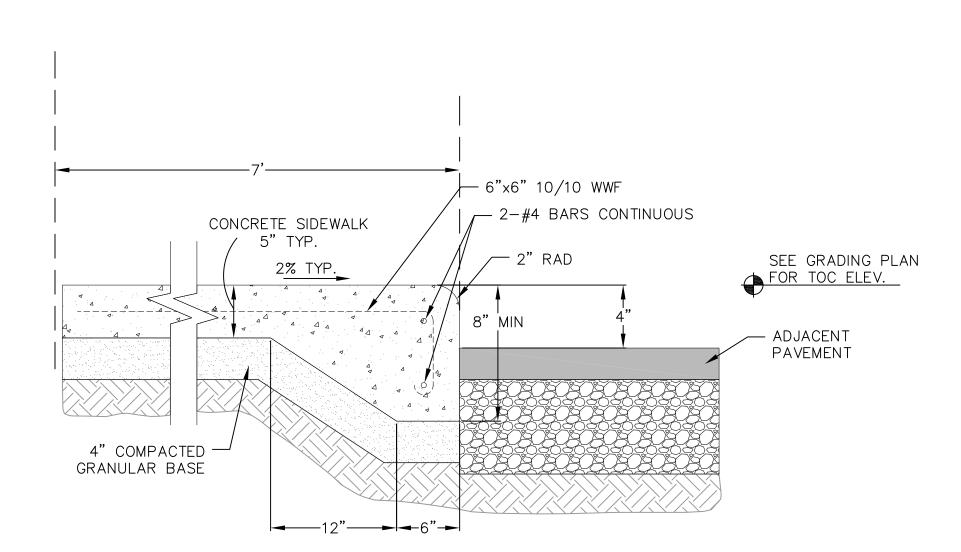

CURBED SIDEWALK DETAIL NOT TO SCALE

1.25" SURFACE COURSE

← 1.5" SURFACE

COURSE

8" CRUSHED AGGREGATE

BASE COURSE

COMPACTED SUBGRADE

10" CRUSHED AGGREGATE BASE COURSE


COMPACTED SUBGRADE

HEAVY-DUTY


BITUMINOUS PAVEMENT

LIGHT-DUTY


BITUMINOUS PAVEMENT

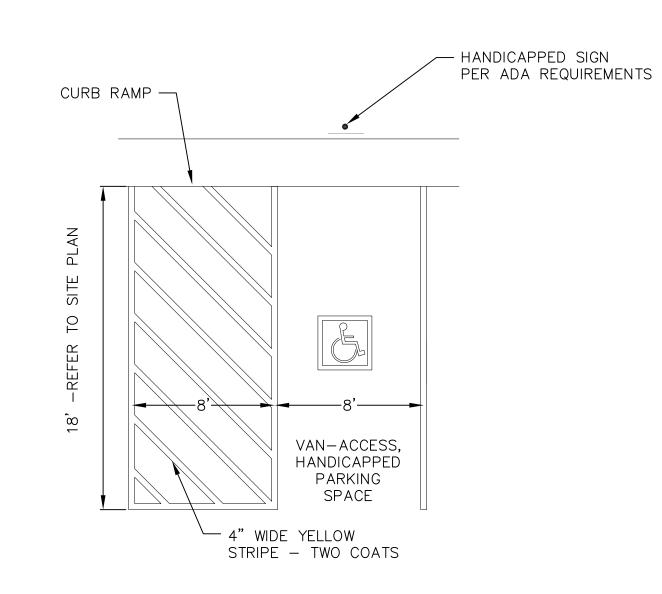


ADA STRIPING NOT TO SCALE

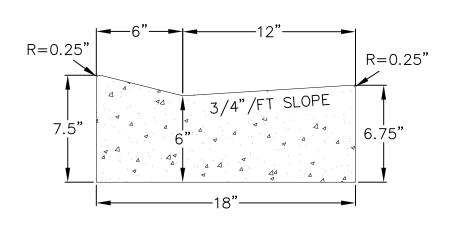


DRIVEWAY GUTTER CROSS SECTION

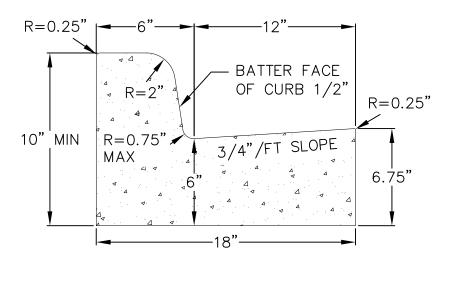


4" CURB AND GUTTER CROSS SECTION

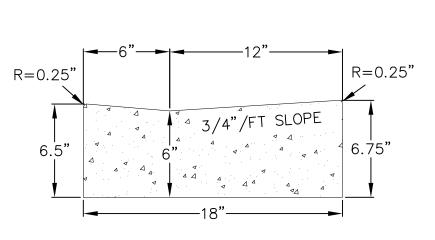

HANDICAP RAMP GUTTER CROSS SECTION

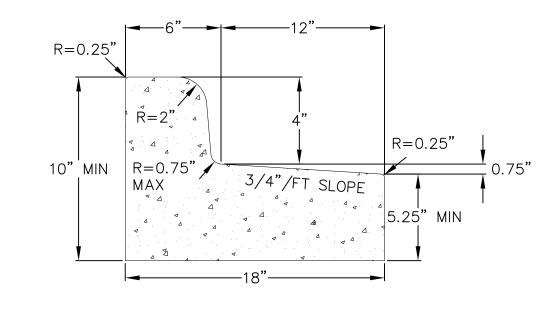

4" CURB AND GUTTER REJECT SECTION

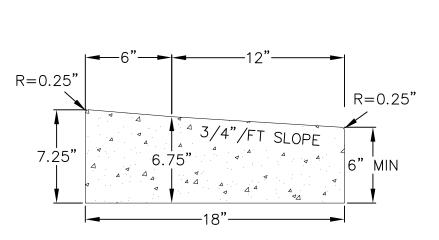

HANDICAP RAMP GUTTER REJECT SECTION




1.75" BINDER

2.5" BINDER

COURSE



NOT FOR CONSTRUCTION

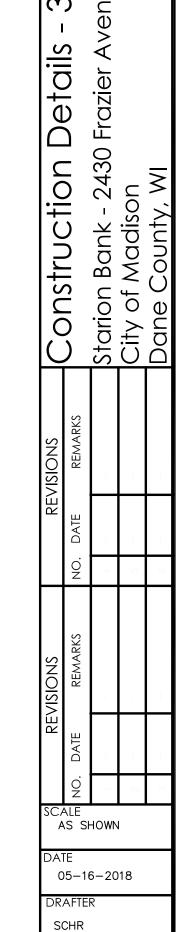



CHECKED ABAR/MSCH

PROJECT NO.

180124


vierbicher

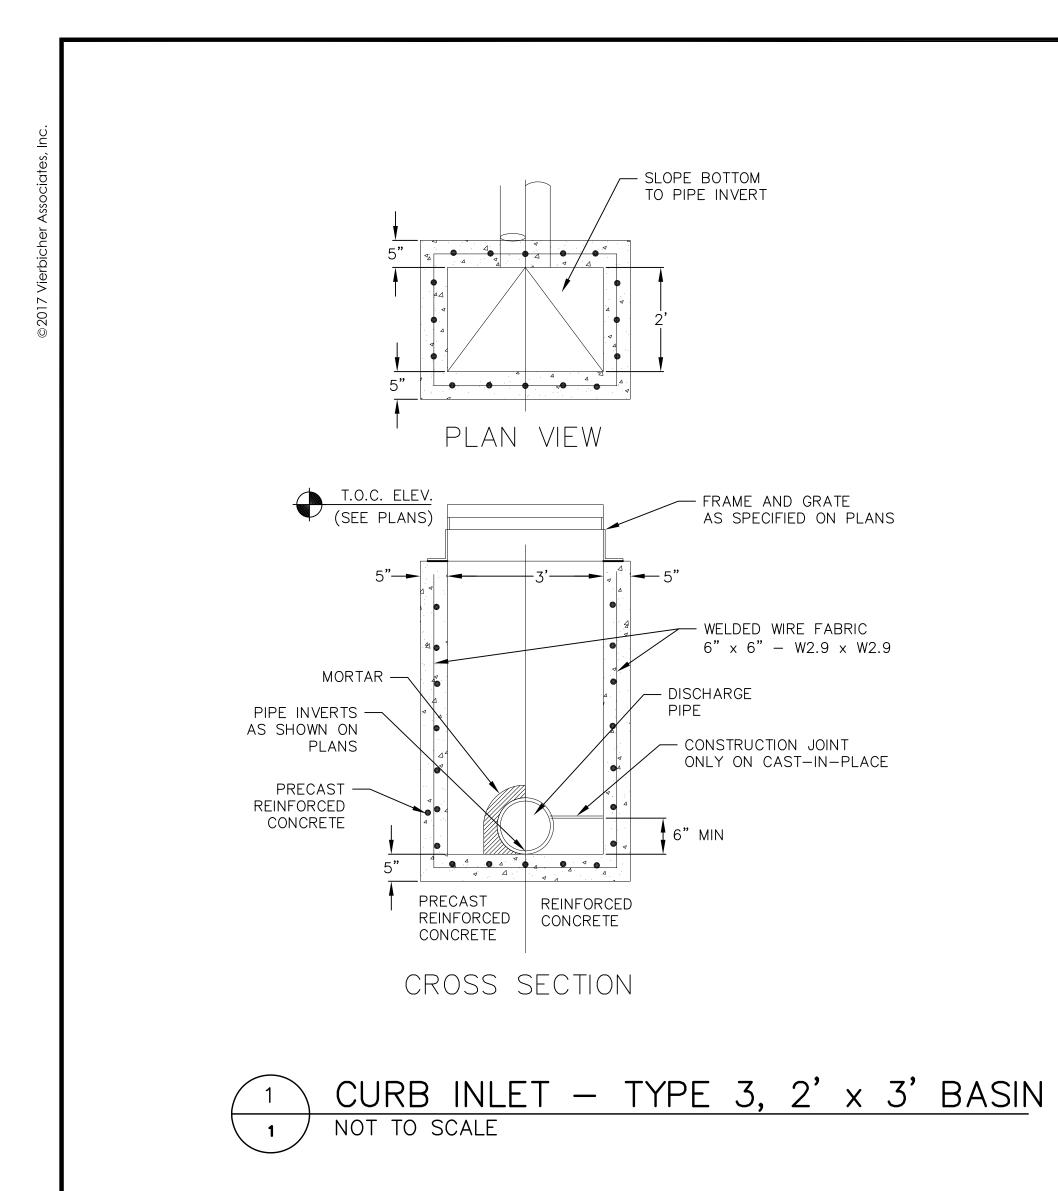

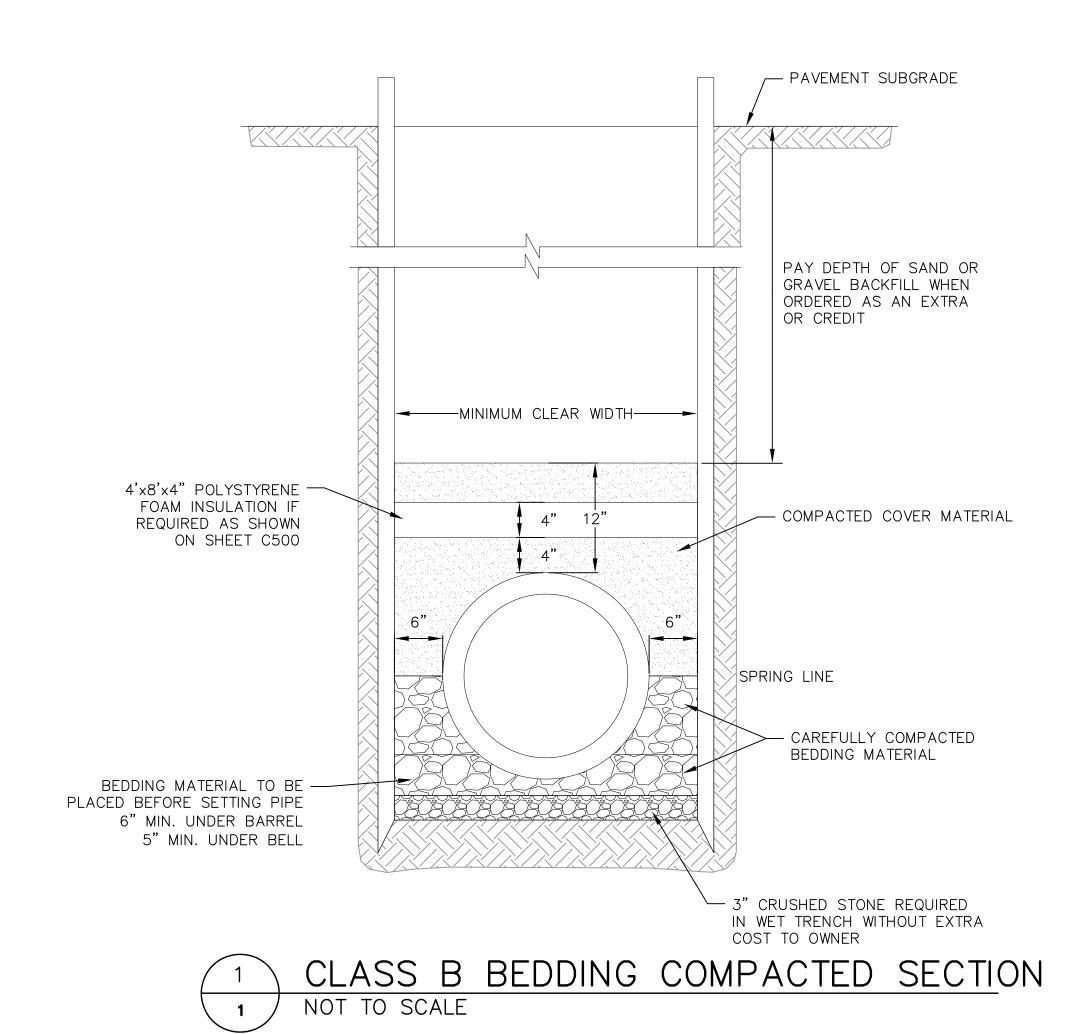

RIP-RAP OUTLET

NOT TO SCALE

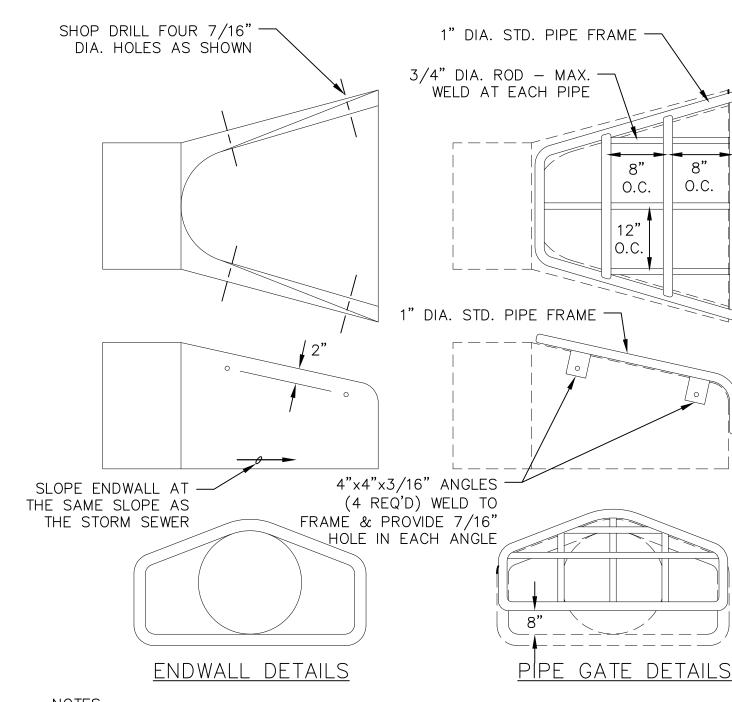

NOTES:


— THE CONTRACTOR SHALL BOLT THE PIPE GATE TO THE CONCRETE ENDWALL WITH FOUR 3/8"x6" MACHINE BOLTS WITH NUTS ON INSIDE WALL.

PAINTING SPECIFICATIONS:

— THE PIPE GATE SHALL RECEIVER THE FOLLOWING PREPARATION & PAINTING. THE FIRST COAT SHALL BE RUS-OLEUM X-60 RED BARE METAL PRIMER OR APPROVED EQUAL. THE SECOND COAT SHALL BE RUST-OLEUM 960 ZINC CHROMATE PRIMER OR APPROVED EQUAL. THE THIRD COAT SHALL BE RUS-OLEUM 1282 HIGH GLOSS METAL FINISH OR APPROVED EQUAL.


PREPARATION STEPS:

- 1. BARE METAL SURFACES TREAT WITH THE THREE—COAT PAINTING SYSTEM LISTED AFTER A THOROUGH SCRAPING, WIRE BRUSHING & CLEANING.
- 2. EACH COAT OF PAINT SHALL BE APPLIED OVER THE ENTIRE GATE SURFACE. 3. ALLOW 24-48 HOURS DRYING TIME AT 60° OR ABOVE BETWEEN COATS.

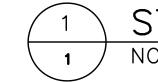

STANDARD ENDWALL

NOT TO SCALE

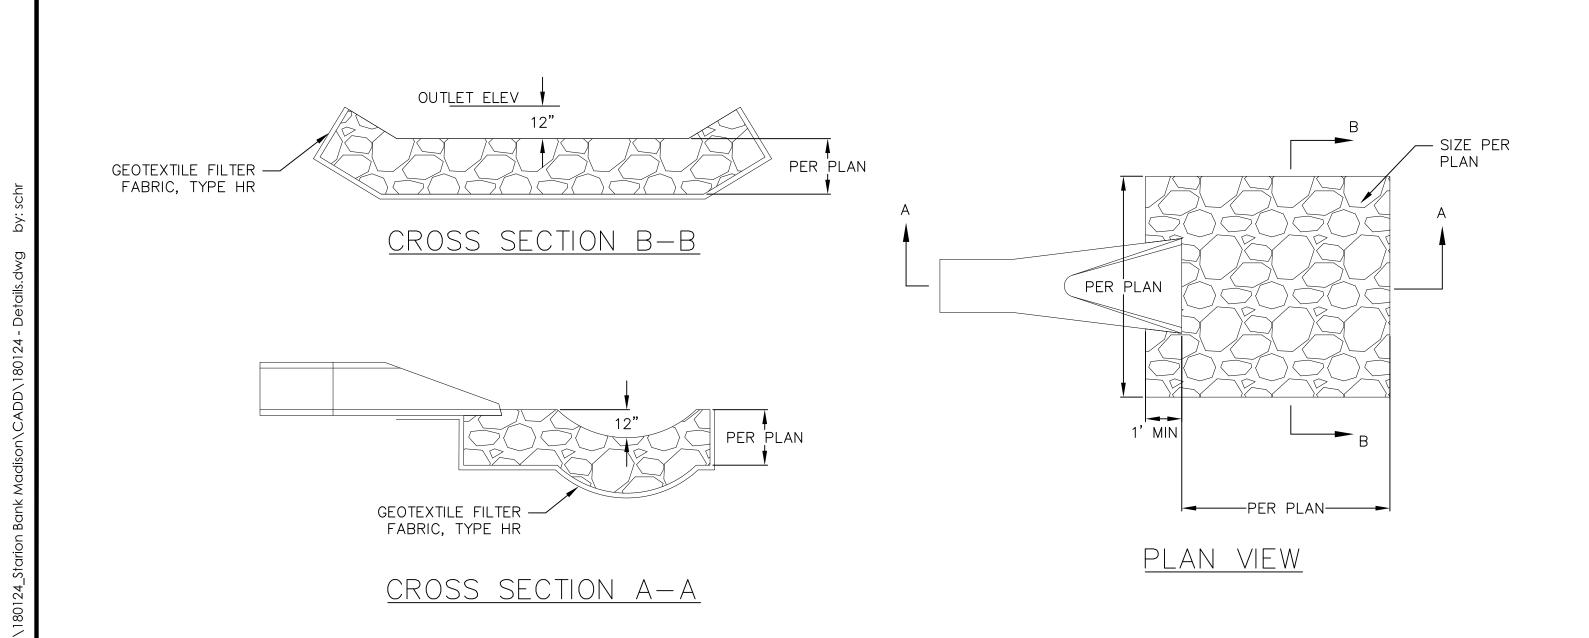

<u>APRON SIZING</u>

REVISIONS REVISIONS CONSTRUCTIC CONSTRUCTION BANK - 2 STATION BANK - 2 STA

etails

vierbicher


NOT FOR CONSTRUCTION

602


CHECKED ABAR/MSCH

PROJECT NO.


180124

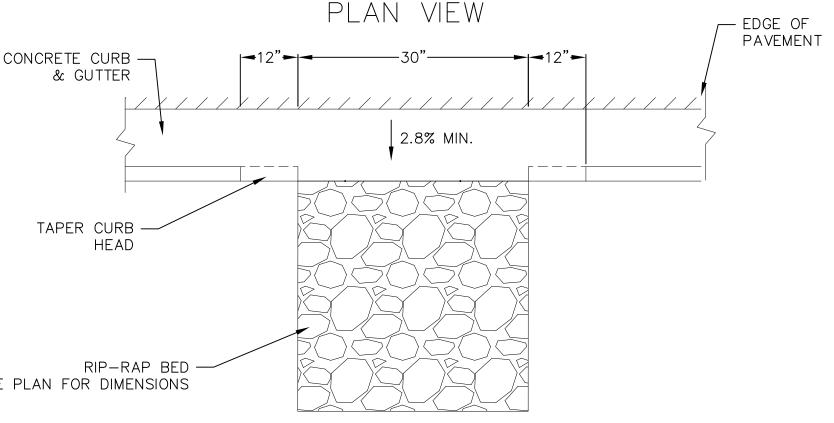

NOT TO SCALE

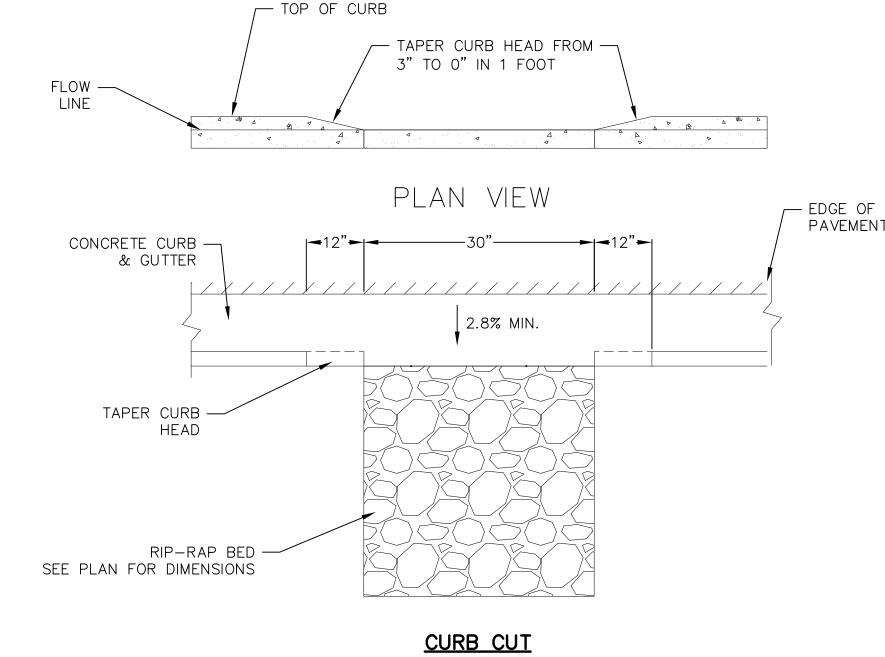

CURB CUT

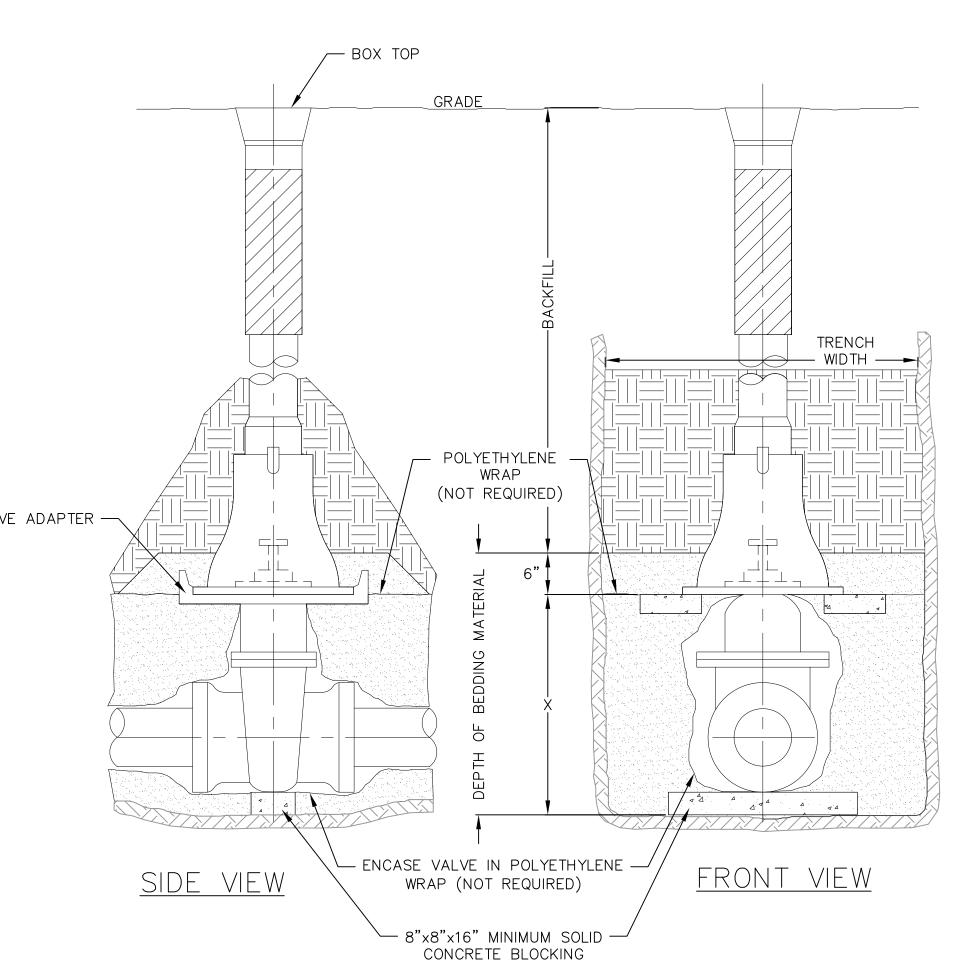

PIPE DIA. INCHES	X=SETTING INCHES
2	6
3	7
4	8
6	12
8	13
12	21
16	30

STANDARD GATE VALVE BOX SETTING NOT TO SCALE

NOT FOR CONSTRUCTION


vierbicher

etails

SCALE AS SHOWN 05-16-2018

SCHR CHECKED ABAR/MSCH

PROJECT NO. 180124

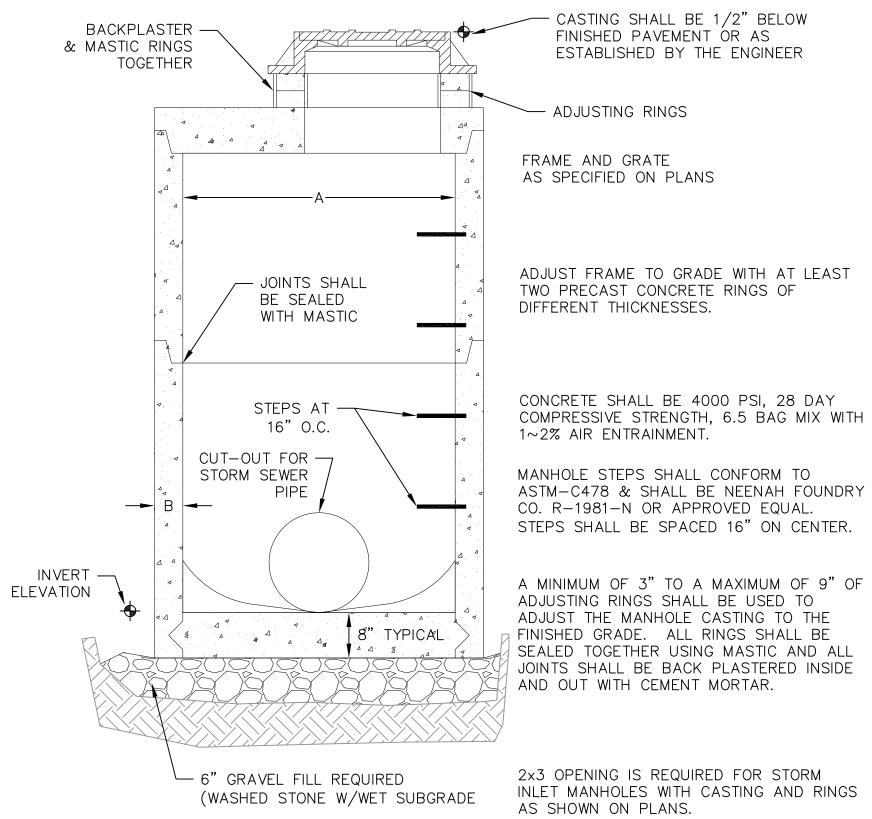

2x3 OPENING IS REQUIRED FOR STORM INLET MANHOLES WITH CASTING AND RINGS


STORM MANHOLE DIMENSIONS

MANHOLE	DIMENSION		
SIZE	Α	B (MIN.)	
48"	48"	5"	
60"	60"	6"	
72"	72"	7"	
84"	84"	7"	
96"	96"	9"	

STORM SEWER FIELD INLET NOT TO SCALE

SAWCUT AT R/W OR AS SHOWN ON PLANS 6" CONCRETE DRIVEWAY OR ASPHALT TO MATCH EXISTING 4" CONCRETE SIDEWALK 6" CONCRETE SIDEWALK 6" CONCRETE APRON A A A A A A A A A A A A A A A A A A A			GATE VALV
6" CONCRETE DRIVEWAY OR ASPHALT TO MATCH EXISTING 4" CONCRETE SIDEWALK 6" CONCRETE SIDEWALK 6" CONCRETE APRON VARIES VARIES		/ AS SHOWN ON PLANS	I
ASPHALT TO MATCH EXISTING 4" CONCRETE SIDEWALK 6" CONCRETE SIDEWALK 6" CONCRETE APRÔN VARIES	R/W		*
4" CONCRETE SIDEWALK 6" CONCRETE SIDEWALK 4 5' TYP. 4 6" CONCRETE APRON 4 A A A A A A A A A A A A A A A A A A			VARIES
6" CONCRETE APRÓN A A A A A A A A A A A A A	✓ .		< ✓ ✓
6" CONCRETE APRON A A A A A A A A A A A A A	4" CONCRETE SIDEWALK	6" CONCRETE SIDEWALK △	5' TYP.
6" CONCRETE APRÓN VARIES			
			VADIES
IIDD % CUTTED			VARIES
	CÚRB & GUTTER		
OND & GOTTEN	JOND & GOTTEN		

DRIVEWAY DETAIL NOT TO SCALE

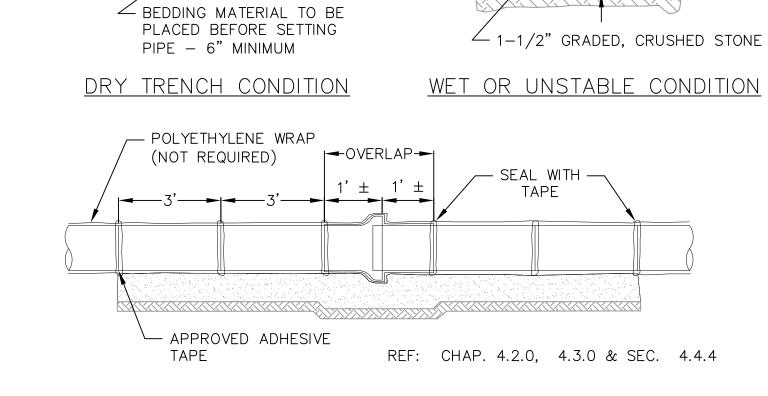

SHEATING WHEN__

REQUIRED


WRAP (NOT REQUIRED)

BEDDING

MATERIAL

6" MIN. 6"

STANDARD WATER MAIN TRENCH SECTION NOT TO SCALE

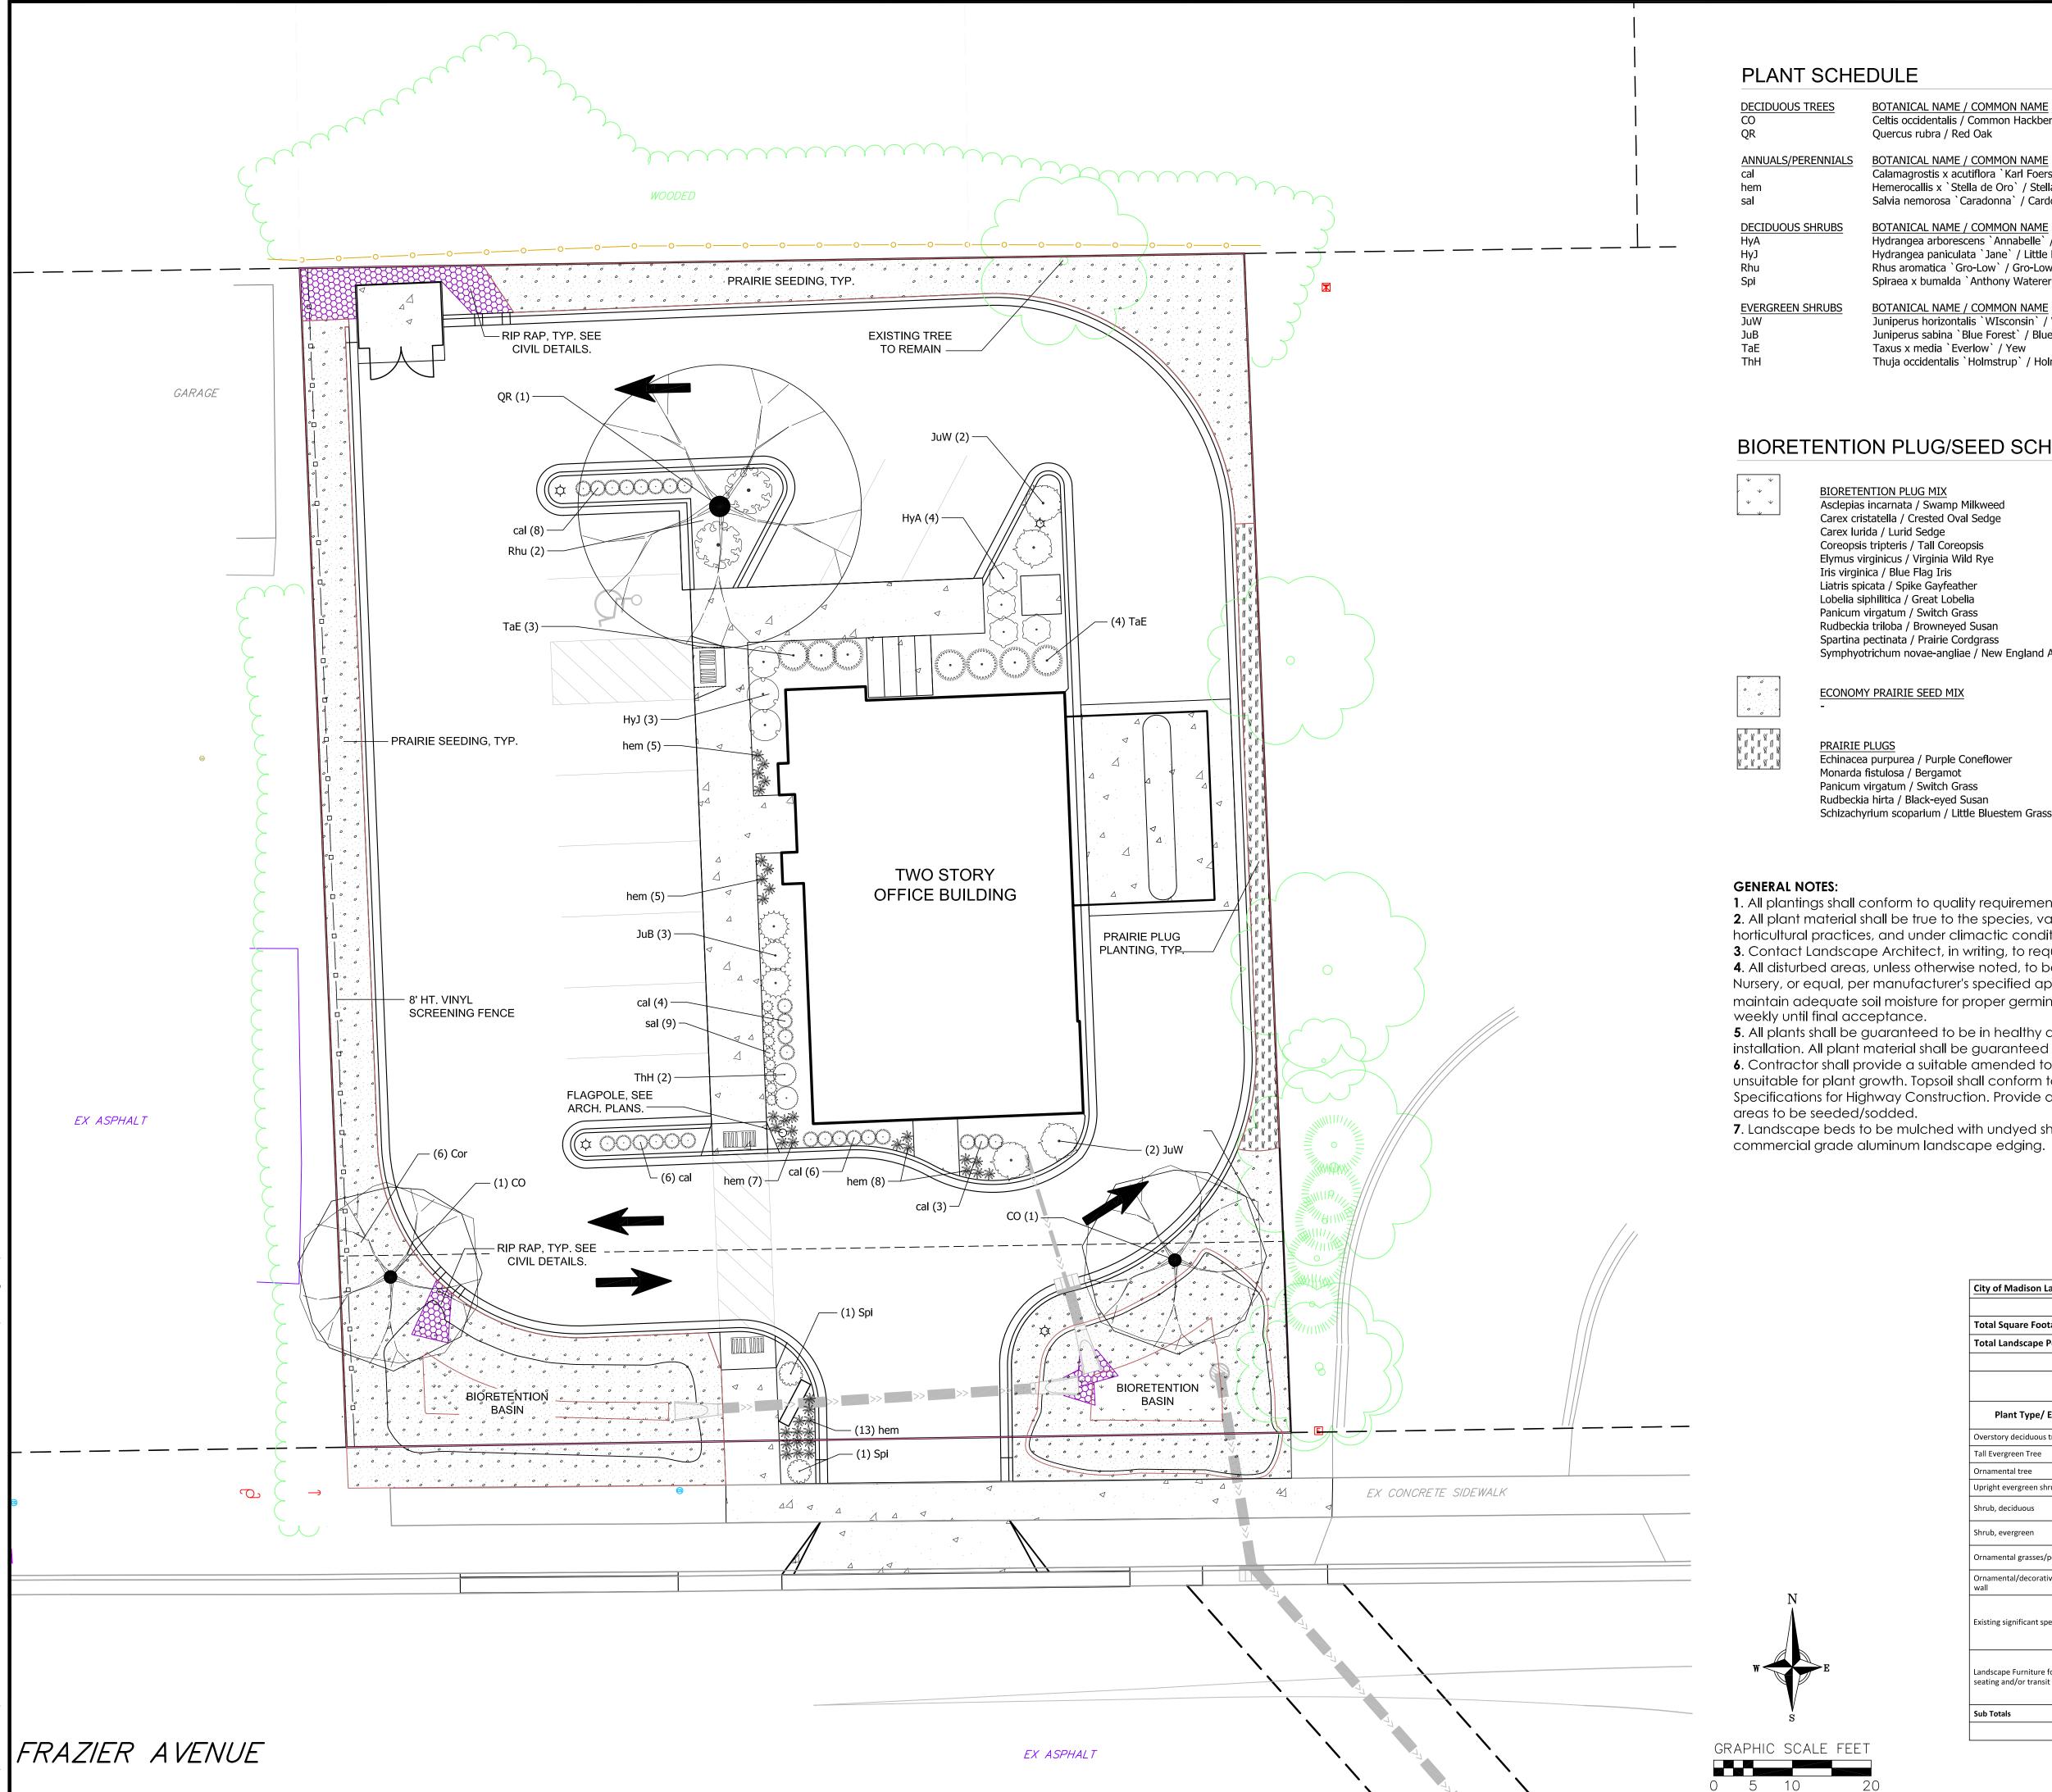


PLANT SCHEDULE

DECIDUOUS TREES	BOTANICAL NAME / COMMON NAME Celtis occidentalis / Common Hackberry Quercus rubra / Red Oak	CONT	<u>CAL</u>	QTY
CO		B & B	2.5"Cal	2
QR		B & B	2.5"Cal	1
ANNUALS/PERENN	IALS BOTANICAL NAME / COMMON NAME Calamagrostis x acutiflora `Karl Foerster` / Feather Reed Grass Hemerocallis x `Stella de Oro` / Stella de Oro Daylily Salvia nemorosa `Caradonna` / Cardonna Perennial Salvia	SIZE	FIELD2	<u>QTY</u>
cal		1 gal	Cont	27
hem		4" pot	Cont	38
sal		4" pot	Cont	9
<u>DECIDUOUS SHRUI</u>	BOTANICAL NAME / COMMON NAME Hydrangea arborescens `Annabelle` / Annabelle Smooth Hydrangea Hydrangea paniculata `Jane` / Little Lime Hydrangea Rhus aromatica `Gro-Low` / Gro-Low Fragrant Sumac Spiraea x bumalda `Anthony Waterer` / Anthony Waterer Spiraea	SIZE	FIELD2	<u>QTY</u>
HyA		5 gal	Cont	4
HyJ		5 gal	Cont	3
Rhu		5 gal	Cont	2
Spi		3 gal	Cont	2
<u>EVERGREEN SHRUI</u>	BOTANICAL NAME / COMMON NAME Juniperus horizontalis `WIsconsin` / Wisconsin Juniper Juniperus sabina `Blue Forest` / Blue Forest Juniper Taxus x media `Everlow` / Yew Thuja occidentalis `Holmstrup` / Holmstrup Cedar	SIZE	FIELD2	<u>QTY</u>
JuW		5 gal	Cont	4
JuB		5 gal	Cont	3
TaE		5 gal	Cont	7
ThH		10 gal	Cont	2

BIORETENTION PLUG/SEED SCHEDULE

₩		
	BIORETENTION PLUG MIX	245 st
Ψ	Asclepias incarnata / Swamp Milkweed	23
	Carex cristatella / Crested Oval Sedge	21
	Carex Iurida / Lurid Sedge	21
	Coreopsis tripteris / Tall Coreopsis	21
	Elymus virginicus / Virginia Wild Rye	21
	Iris virginica / Blue Flag Iris	23
	Liatris spicata / Spike Gayfeather	23
	Lobelia siphilitica / Great Lobelia	21
	Panicum virgatum / Switch Grass	21
	Rudbeckia triloba / Browneyed Susan	23
	Spartina pectinata / Prairie Cordgrass	21
	Symphyotrichum novae-angliae / New England Aster	21

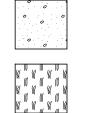

3,399 sf

PRAIRIE PLUGS	212
Echinacea purpurea / Purple Coneflower	38
Monarda fistulosa / Bergamot	38
Panicum virgatum / Switch Grass	56
Rudbeckia hirta / Black-eyed Susan	36
Schizachyrium scoparium / Little Bluestem Grass	56

GENERAL NOTES:

1. All plantings shall conform to quality requirements as per ANSI Z60.1.

2. All plant material shall be true to the species, variety and size specified, nursery grown in accordance with good horticultural practices, and under climactic conditions similar to those of the project site.

3. Contact Landscape Architect, in writing, to request and plant material substitutions due to availability issues.

4. All disturbed areas, unless otherwise noted, to be seeded with Economy Prairie Mix by Cardno Native Plant Nursery, or equal, per manufacturer's specified application rates. All seeded areas are to be watered daily to maintain adequate soil moisture for proper germination. After vigorous growth is established, apply $\frac{1}{2}$ " water twice weekly until final acceptance.

5. All plants shall be guaranteed to be in healthy and flourishing condition during the growing season following

installation. All plant material shall be guaranteed for one year from the time of installation. 6. Contractor shall provide a suitable amended topsoil blend for all planting areas where soil conditions are

unsuitable for plant growth. Topsoil shall conform to quality requirements as per Section 625.2(1) of the Standard Specifications for Highway Construction. Provide a minimum of 12" of topsoil in all planting areas and 6" of topsoil in areas to be seeded/sodded. 7. Landscape beds to be mulched with undyed shredded hardwood bark mulch to 3" depth min. and edged with

			Credi	ts/ Existing	Now/ Prov	sacad Landceanin
Total Landscape Points Require	d:	16,108	/ 300 =	54	x 5 =	268
Total Square Footage of Develo	ped Area:	16,108				
City of Madison Landscape Wo	ksheet					

			Credits/ Existing Landscaping		New/ Proposed Landscaping	
Plant Type/ Element	Min. Size at Installation	Points	Quantity	Points Achieved	Quantity	Points Achieved
Overstory deciduous tree	2.5" cal	35		0	3	105
Tall Evergreen Tree	5-6 feet tall	35		0		0
Ornamental tree	1.5" cal	15		0		0
Upright evergreen shrub	3-4 feet tall	10		0	2	20
Shrub, deciduous	#3 gallon container size, Min. 12-24"	3		0	11	33
Shrub, evergreen	#3 gallon container size, Min. 12-24"	4		0	14	56
Ornamental grasses/perennials	#1 gallon container size, Min. 8-18"	2		0	27	54
Ornamental/decorative fencing or wall	n/a	4 per 10 LF		0		0
Existing significant specimen tree	Min. Size 2.5" cal. Trees must be within developed area and cannot comprise more than 30% of total required points.	14 per caliper inch. Max. points per tree: 200		0		0
Landscape Furniture for public seating and/or transit connections	Furniture must be within developed area, publicly accessible, and cannot comprise more than 5% of total required points	5 points per "seat"		0		0
Sub Totals				0		268
		Total Points Provided			268	





Plan 130 Fra Landscape F Starion Bank - 243 City of Madison Dane County, WI AS SHOWN 05-16-2018


ABAR/MSCH

PROJECT NO.

DIGGERS HOTLINE

TOLL FREE 1-800-242-8511 MILWAUKEE AREA 414-259-1181 TDD 1-800-542-2289

STATE LAW REQUIRES YOU TO NOTIFY OWNERS AND OPERATORS OF TRANSMISSION FACILITIES AT LEAST THREE WORKING DAYS BEFORE YOU DIG

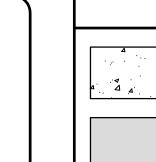

CONCRETE SIDEWALKS:

4" THICK SLAB W/ BROOM
FINISH OVER 4" THICK
COMPACTED SUBBASE.

STANDARD PAVEMENT: 3" BITUMINOUS PAVIN

HARD SURFACE LEGEND

STANDARD PAVEMENT: 3" BITUMINOUS PAVING (1½"


SURFACE COURSE AND 1½" BINDER COURSE) OVER AN 8"

THICK COMPACTED STONE BASE (±4" OF BREAKER RUN

STONE & ±4" OF ¾" COMPACTED STONE)


REPAVING AT EXISTING PARKING LOT: SEE CIVIL


REPAVING AT EXISTING PARKING LOT: SEE CIVIL DRAWINGS FOR AREA IDENTIFICATION. BASE BID TO INCLUDE SURFACE COURSE OF LISTED THICKNESS. ALTERNATE ADD TO INCLUDE STANDARD PAVEMENT DESIGN AS NOTED ABOVE.

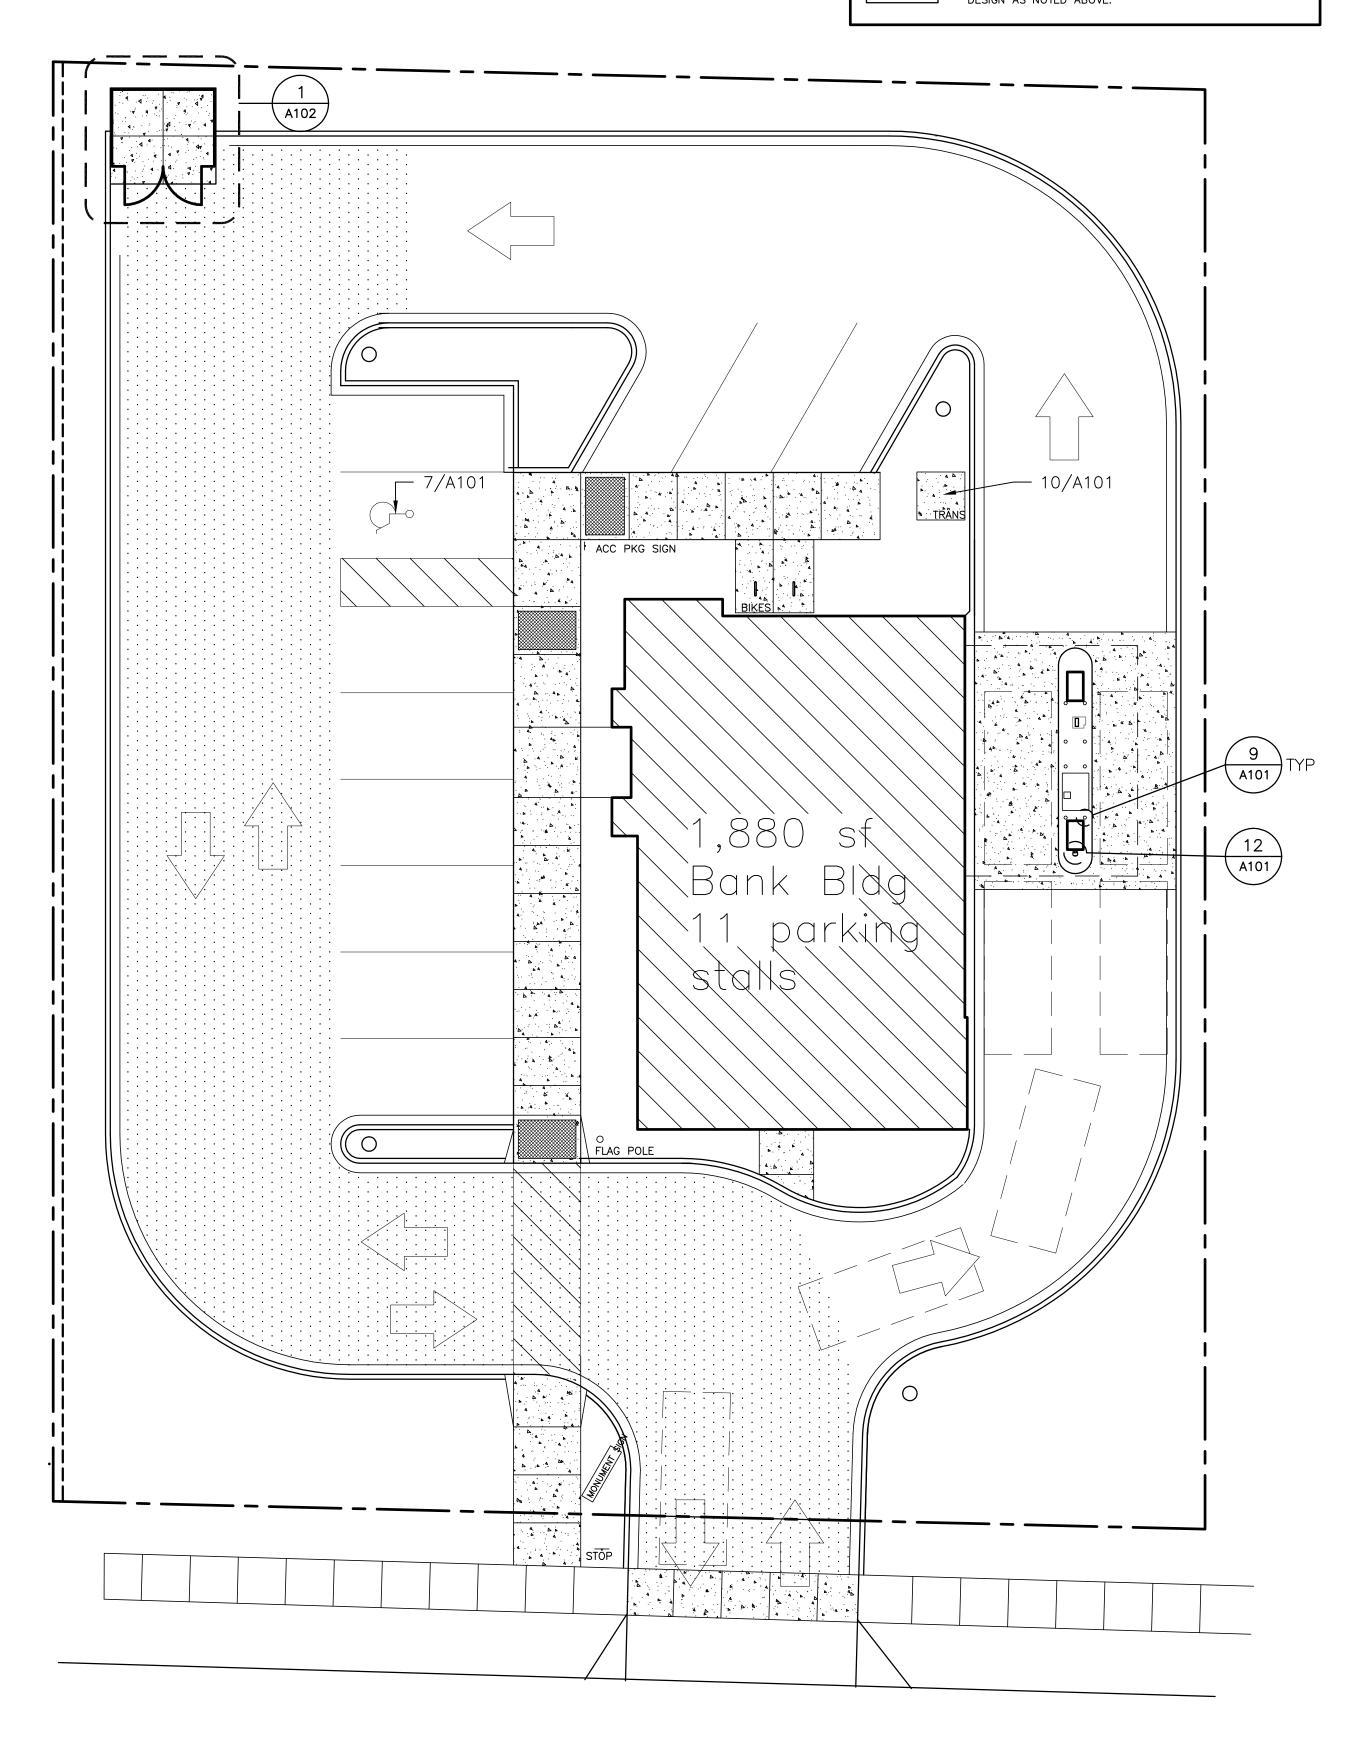





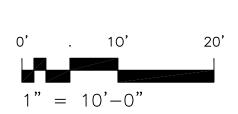

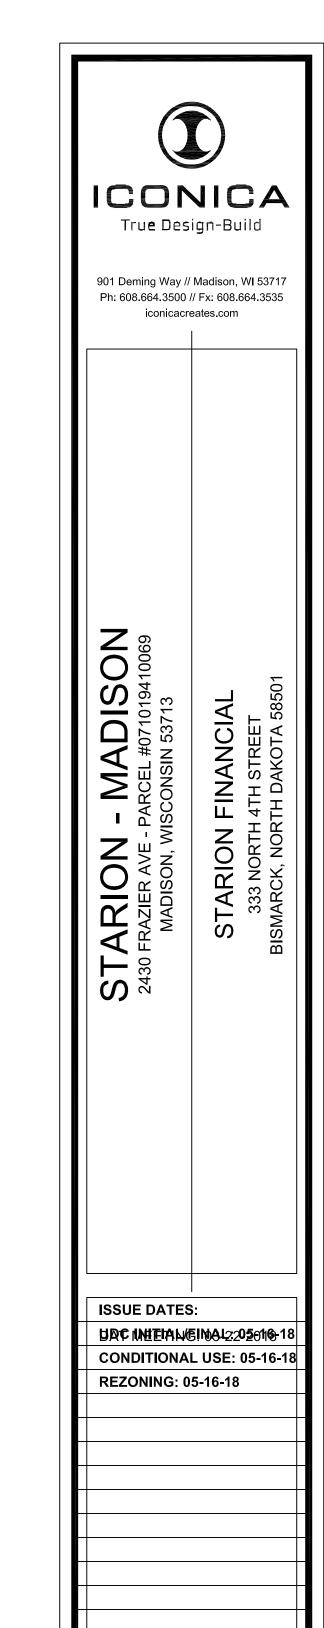

	T
RFI/SI DATE:	
	T
	-


This drawing indicates the scale and relationship of the project components.
This drawing is **not for construction.**

Schematic Design Phase:

This document contains confidential or proprietary information of Iconica. Neither the document nor the information herein is to be reproduced, distributed, used or disclosed, either in whole or in part, except as specifically authorized by Iconica.

PROJECT #: 20180130
SHEET NUMBER

A100

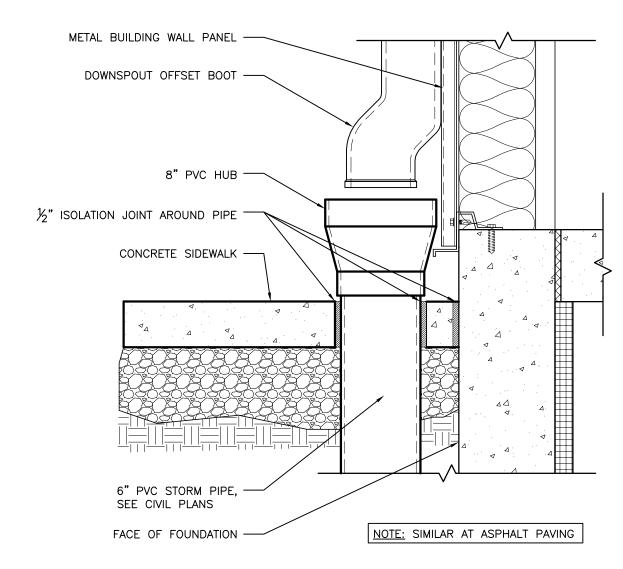

HUB DRAIN DETAIL @ SIDEWALK

-<u>RIGID CONDUIT (BY E.C.) FOR PRIMARY</u> TO BE INSTALLED AT EXTREME LEFT, TOP TO BE EVEN WITH PAD AND EXTENDING AT LEAST 36" HORIZONTALLY BEYOND AREAS 02751.00.00.101 THAT MAY BECOME INACCESSIBLE (i.e. BITUMINOUS DRIVEWAYS, PARKING LOTS) PLUG AND MARK ENDS OF CONDUIT w/ A STAKE MARKED "CONDUIT" CUSTOMER OWNED DUCTS (INSTALLED—BY E.C.) FOR SECONDARY CABLE TO BE INSTALLED AT EXTREME RIGHT EDGE OF PAD. DUCT MUST BE INSTALLED TO A LEVEL OF 1"-2" ABOVE TOP OF PAD. -8" CONCRETE PAD W/ #4'S @ 24" O.C. EACH WAY BY CONCRETE CONTRACTOR -¾" DIA. RADIUSED TÖOLED EDGE -#4 BAR AROUND ÖPENING LOCATION OF TRANSFORMER DOOR ±8'-0" (FRONT OF PAD) VERIFY W/ UTILITY CO.


GENERAL NOTES:

- ELECTRICAL CONTRACTOR TO CONFIRM EXACT DIMENSIONS & LOCATION WITH


- LOCAL UTILITY COMPANY - CONFIRM TRANSFORMER DOOR LOCATION WITH DESIGN-BUILDER'S ARCHITECT & ELECTRICAL ENGINEER PRIOR TO ROUGH IN OF ELECTRICAL DUCTS - DESIGN-BUILDER'S SUPERINTENDENT TO VERIFY ELEVATIONS OF PAD WITH RESPECT TO
- SURROUNDING GRADES & NOTIFY ARCHITECT OF POTENTIAL GRADING CONFLICTS PRIOR TO POURING SET PAD LEVEL - DESIGN-BUILDER'S SUPERINTENDENT TO VERIFY REQUIRED CLEARANCES WITH UTILITY COMPANY PRIOR TO SETTING PAD
- DESIGN-BUILDER AND ELECTRICAL CONTRACTOR TO VERIFY REQUIRED CLEARANCES TO BUILDING, WINDOWS, DOORS ETC. WITH LOCAL UTILITY COMPANY PRIOR TO SETTING PAD


TRANSFORMER PAD CONCEPT


02751.00.00.302

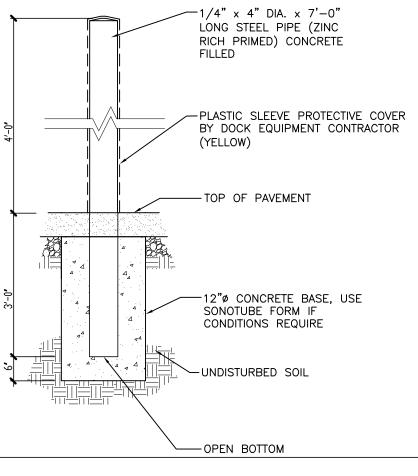

GENERAL NOTES:
-STEEL BOLLARD (Z.R.P.) BY STEEL FABRICATOR -CONCRETE CONTRACTOR TO EXCAVATE AND POUR BASE, SET PIPE BOLLARD, AND FILL BOLLARD WITH CONCRETE -CONCRETE CONTRACTOR TO WIPE DOWN STEEL BOLLARD CLEAN OF ALL CONCRETE RESIDUE @ TIME OF POURING

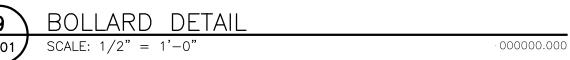

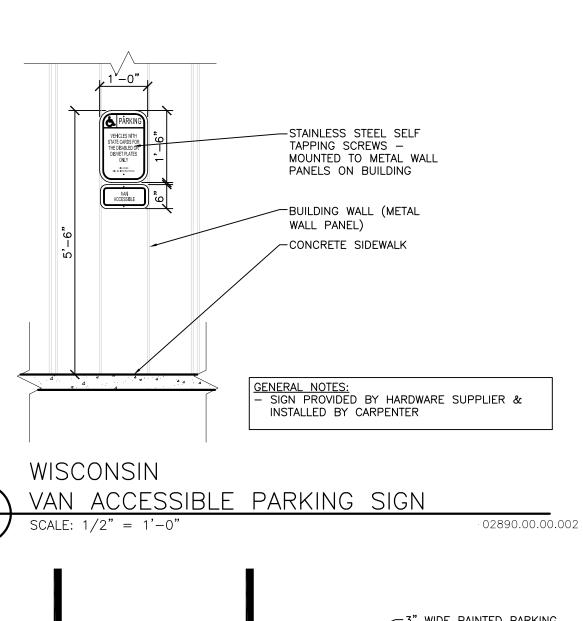

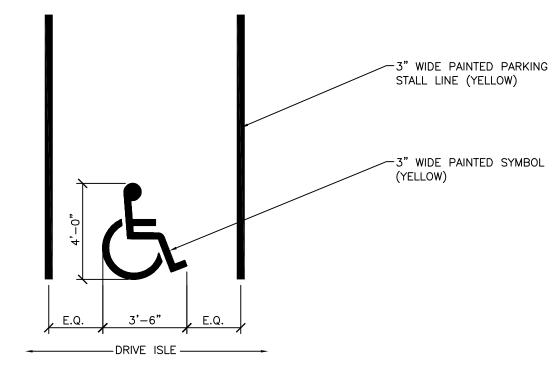




ICONICA Tru**e** Design-Build 901 Deming Way // Madison, WI 53717 Ph: 608.664.3500 // Fx: 608.664.3535 iconicacreates.com TARION

O FRAZIER AVE -**ISSUE DATES:** UDC INITIAL/FINAL: 05-16-18 CONDITIONAL USE: 05-16-18 **REZONING: 05-16-18** RFI/SI DATE: Schematic Design Phase: This drawing indicates the scale and relationship of the project components. This drawing is **not for** construction. This document contains confidential or proprietary information of Iconica. Neither the document nor the information herein is to be reproduced, distributed, used or disclosed, either in whole or in part, except as specifically authorized by Iconica.

STARION FINANCIAL
333 NORTH 4TH STREET
BISMARCK, NORTH DAKOTA 5850

PROJECT #: 20180130 SHEET NUMBER

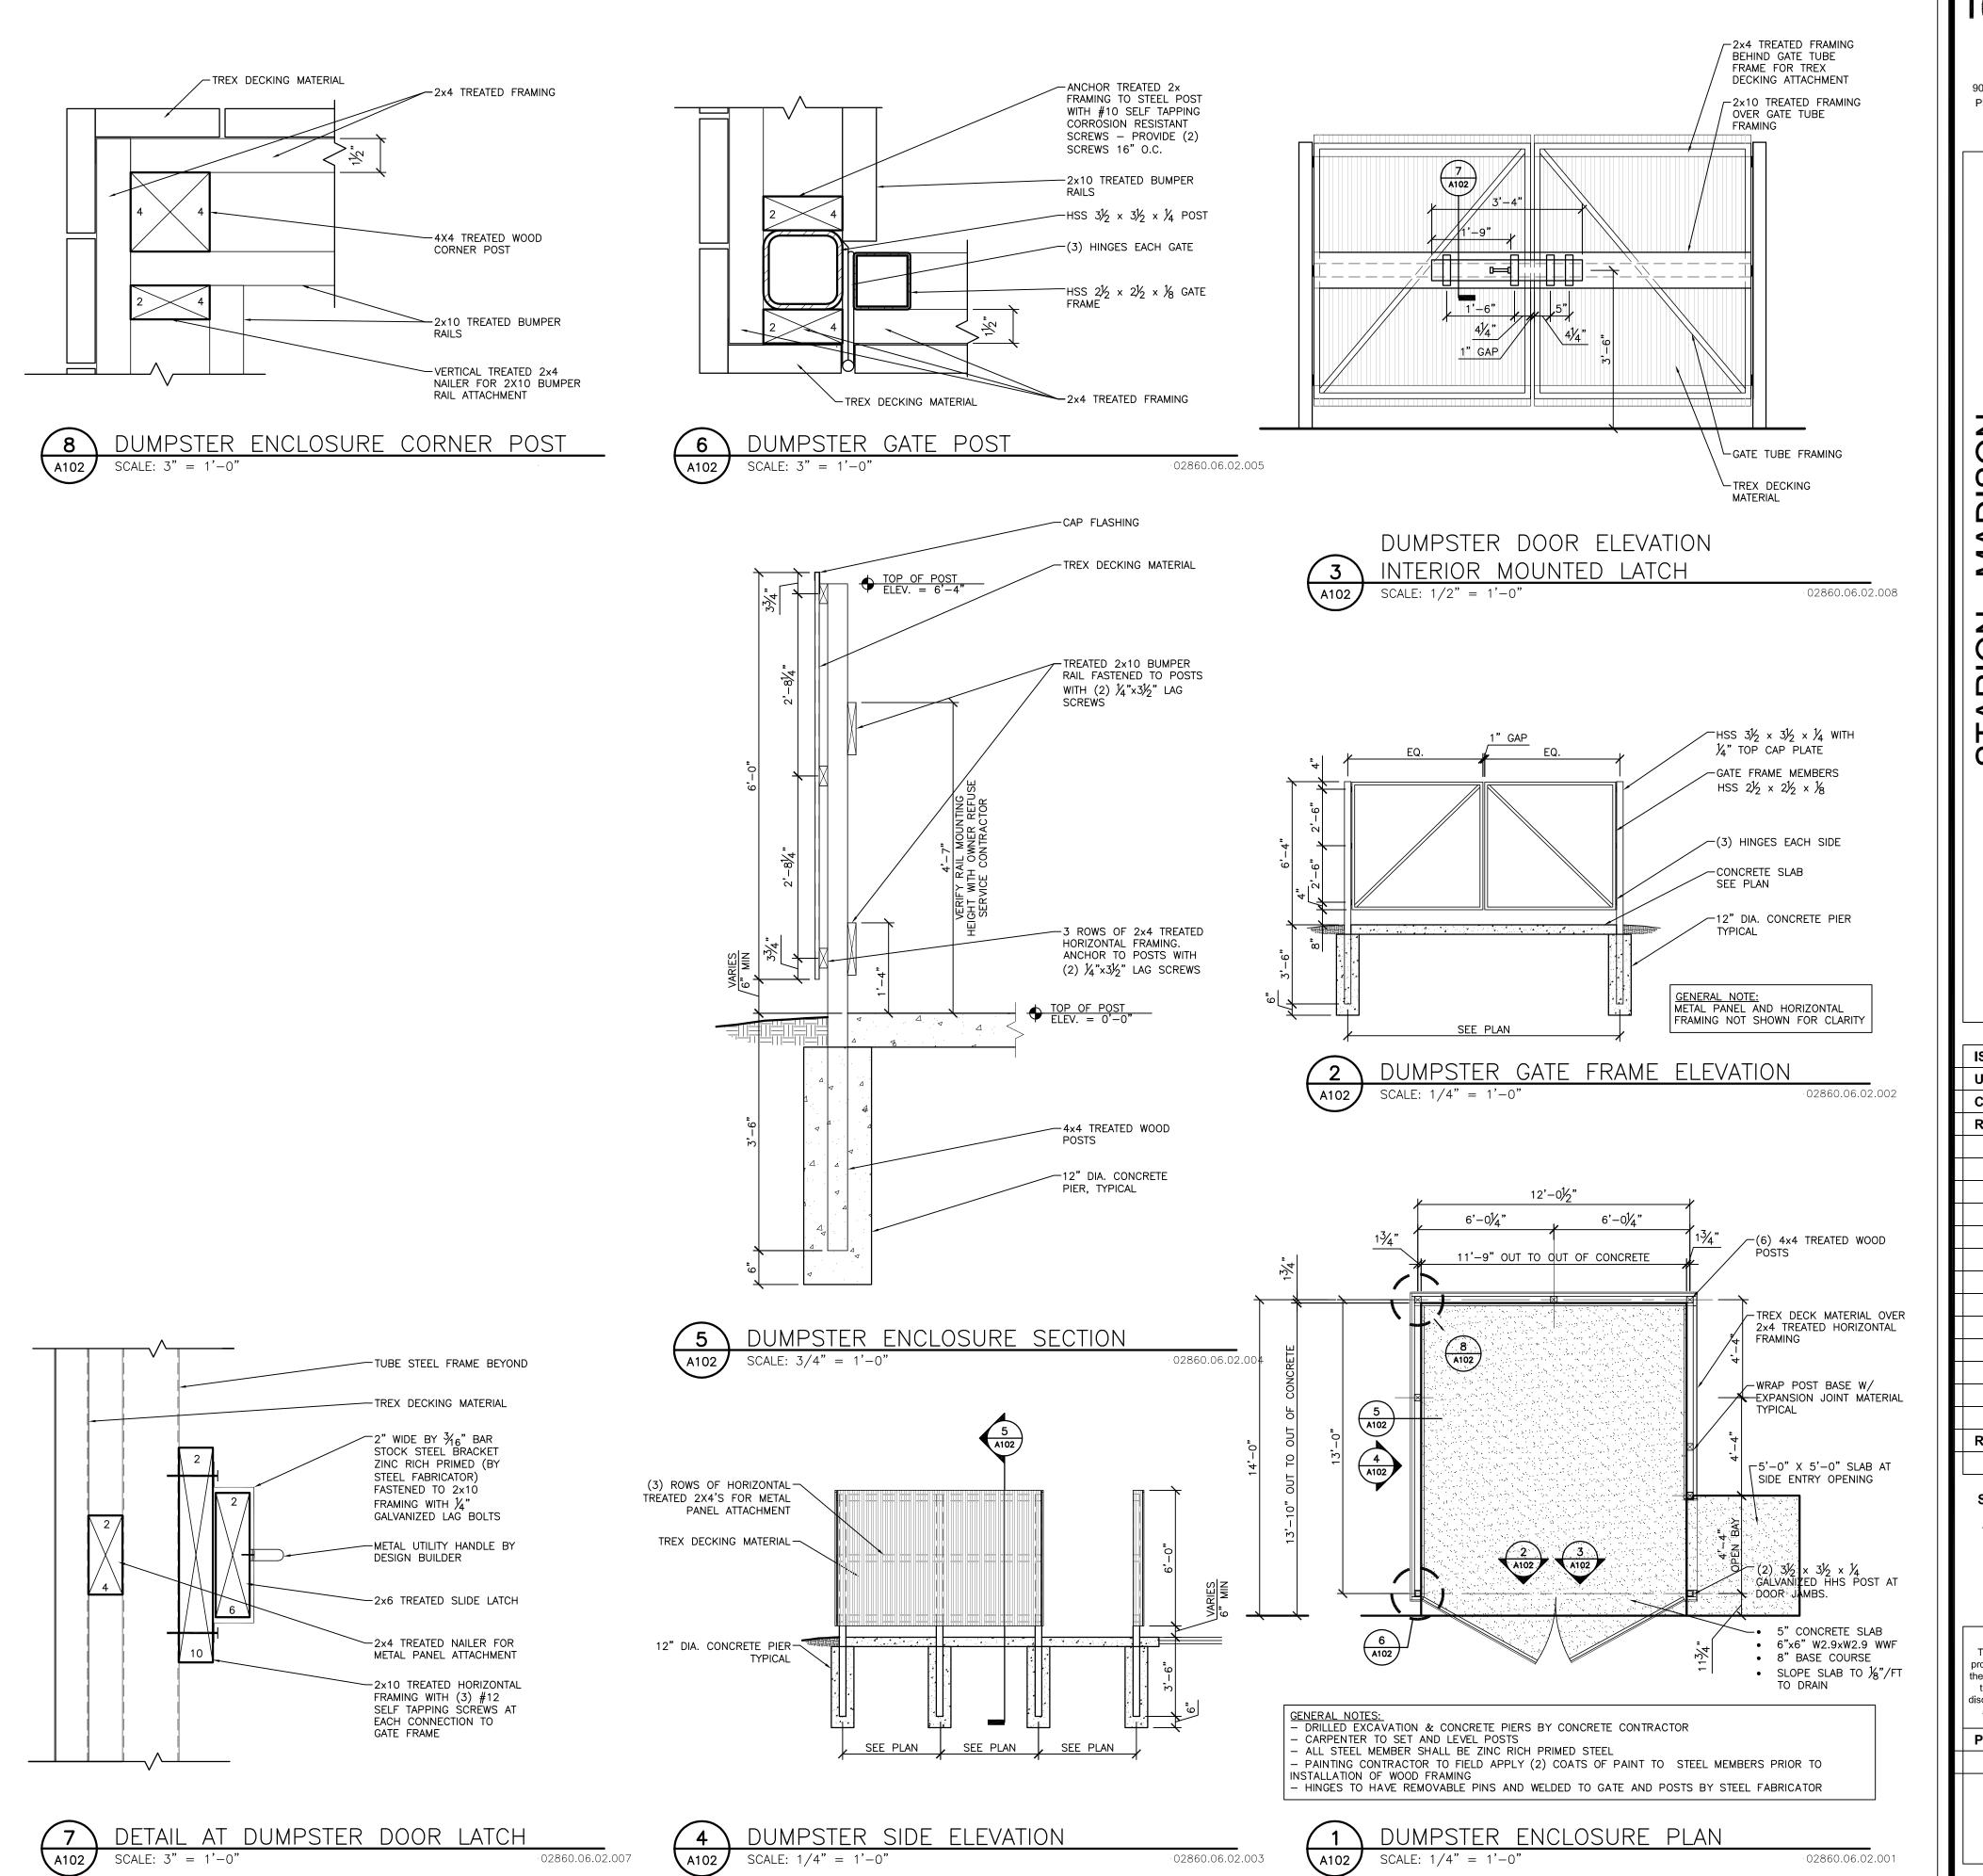


ICONICA Tru**e** Design-Build 901 Deming Way // Madison, WI 53717 Ph: 608.664.3500 // Fx: 608.664.3535 iconicacreates.com STARION FINANCIAL
333 NORTH 4TH STREET
BISMARCK, NORTH DAKOTA 5850 TARION


OF FRAZIER AVE -**ISSUE DATES:** UDC INITIAL/FINAL: 05-16-18 CONDITIONAL USE: 05-16-18 **REZONING: 05-16-18** RFI/SI DATE: Schematic Design Phase: This drawing indicates the scale and relationship of the project components. This drawing is **not for** construction. This document contains confidential or proprietary information of Iconica. Neither the document nor the information herein is to be reproduced, distributed, used or disclosed, either in whole or in part, except as specifically authorized by Iconica. **PROJECT #**: 20180130


SHEET NUMBER

A102

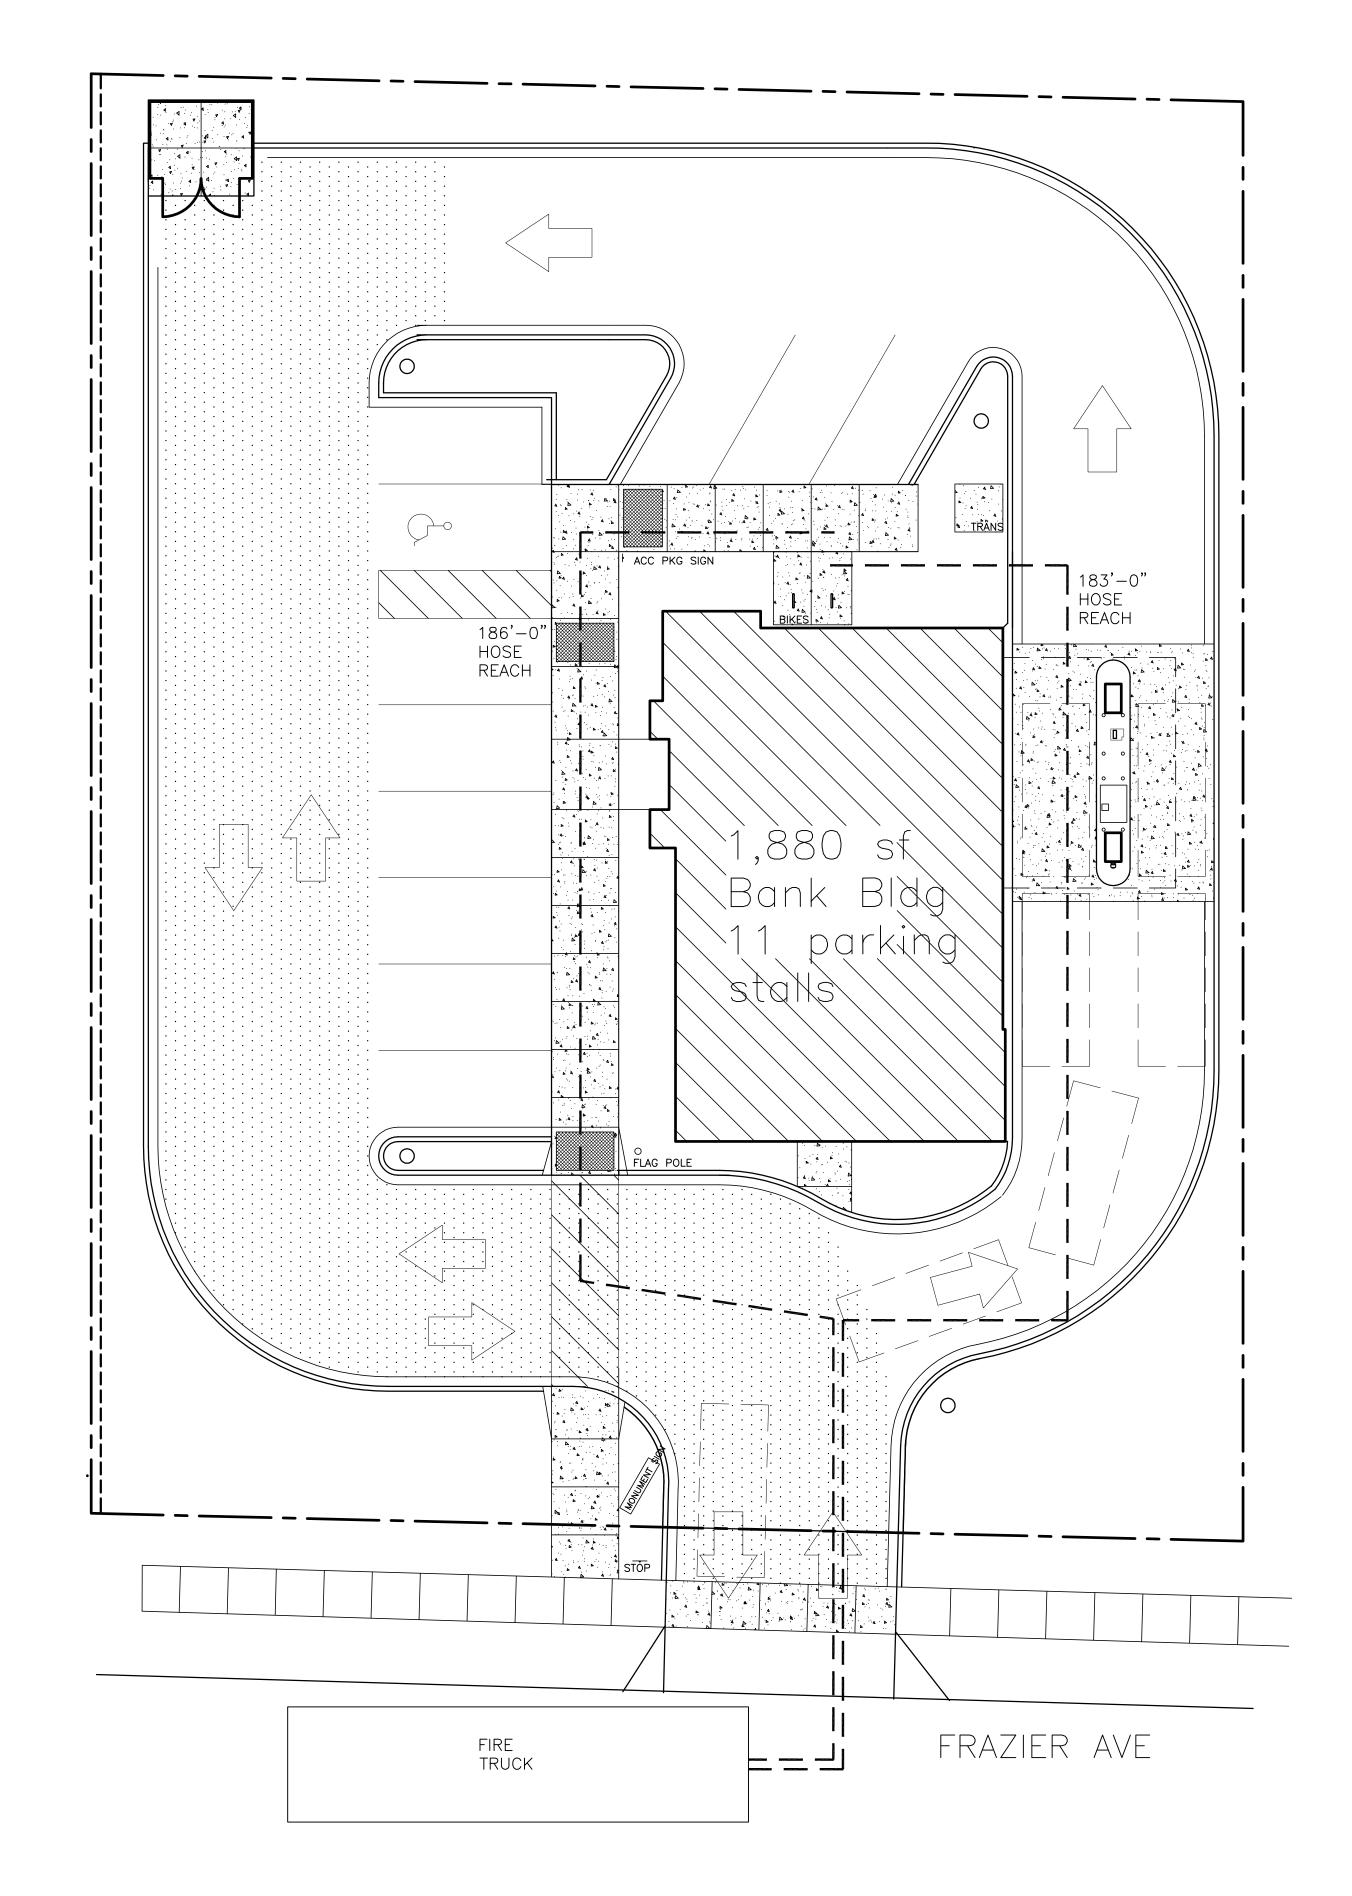



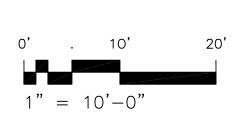

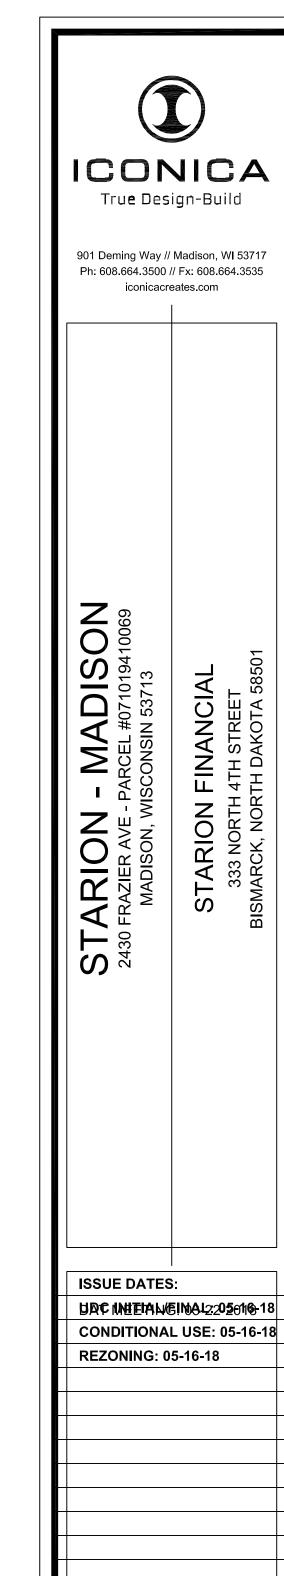

Schematic Design Phase:

RFI/SI DATE:


This drawing indicates the scale and relationship of the project components. This drawing is **not for** construction.

This document contains confidential or proprietary information of Iconica. Neither the document nor the information herein is to be reproduced, distributed, used or disclosed, either in whole or in part, except as specifically authorized by Iconica.

PROJECT #: 20180130 SHEET NUMBER


A103




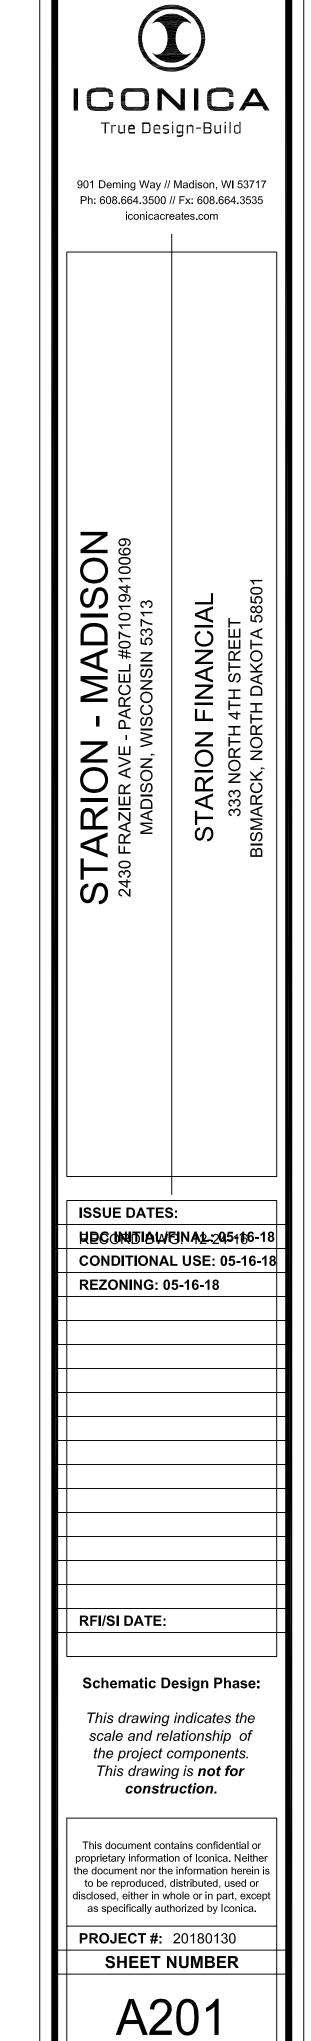






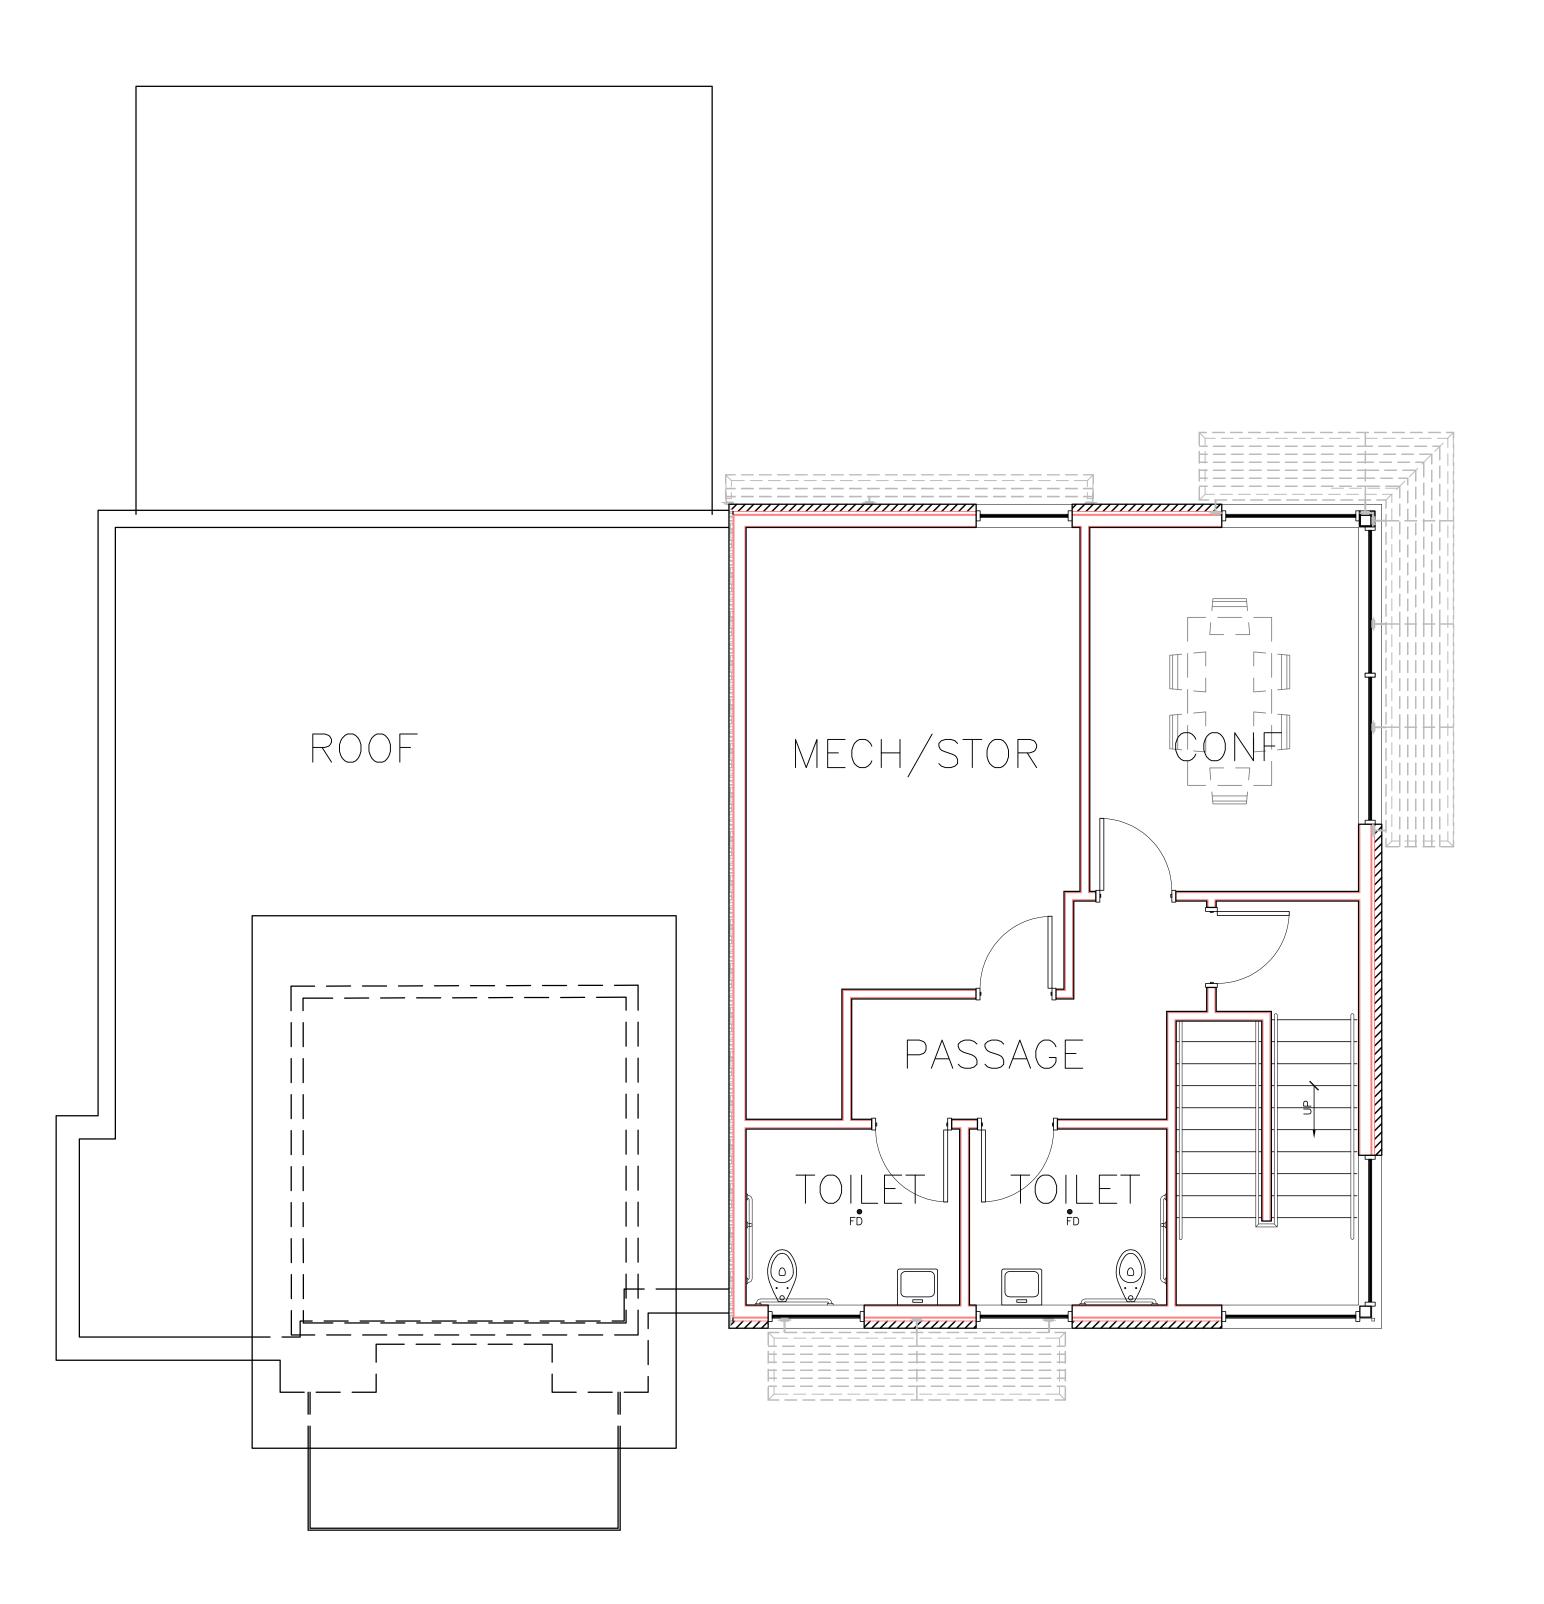


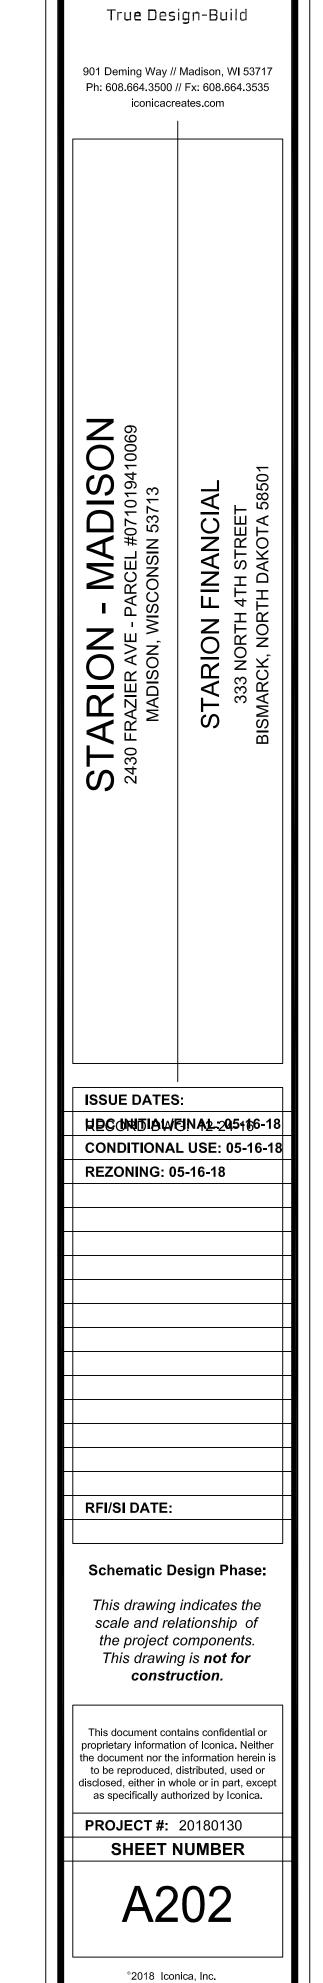

ICONICA

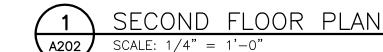



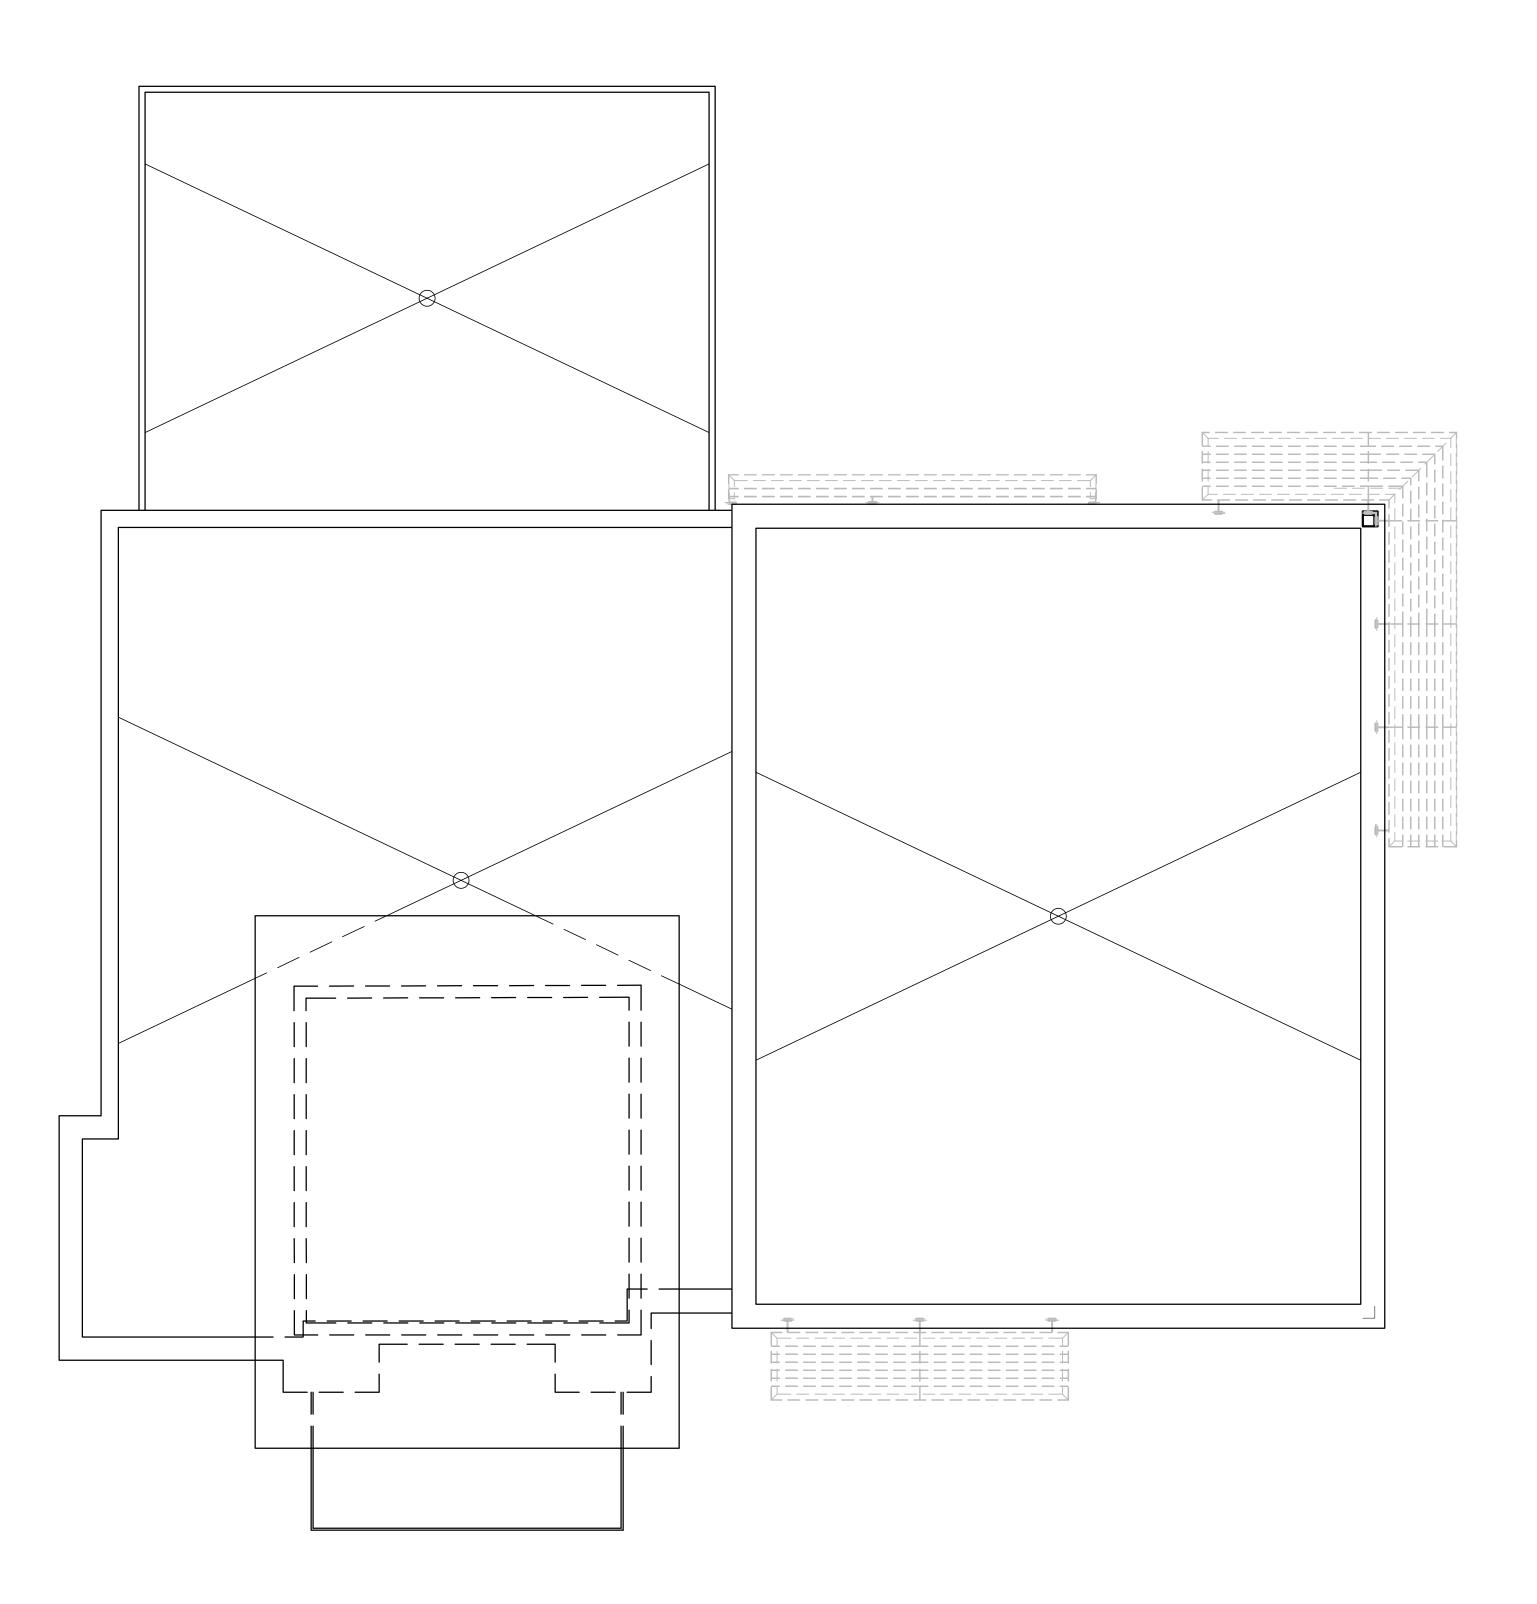

	STARION - MADISON 2430 FRAZIER AVE - PARCEL #071019410069 MADISON, WISCONSIN 53713	STARION FINANCIAL 333 NORTH 4TH STREET BISMARCK, NORTH DAKOTA 58501
		∄NA <u>12-2</u> 05+166-18 - USE: 05-16-18
	RFI/SI DATE:	
	Schematic Do This drawing scale and relative project of This drawing constru	indicates the ationship of omponents. g is not for
	This document cont proprietary information the document nor the to be reproduced, of disclosed, either in what as specifically authors. PROJECT #:	n of Iconica. Neither information herein is distributed, used or nole or in part, except torized by Iconica.
NORTH	SHEET N	
	°2018 Icon	ica, Inc.

ICONICA


Tru**e** Design-Build

901 Deming Way // Madison, WI 53717 Ph: 608.664.3500 // Fx: 608.664.3535 iconicacreates.com








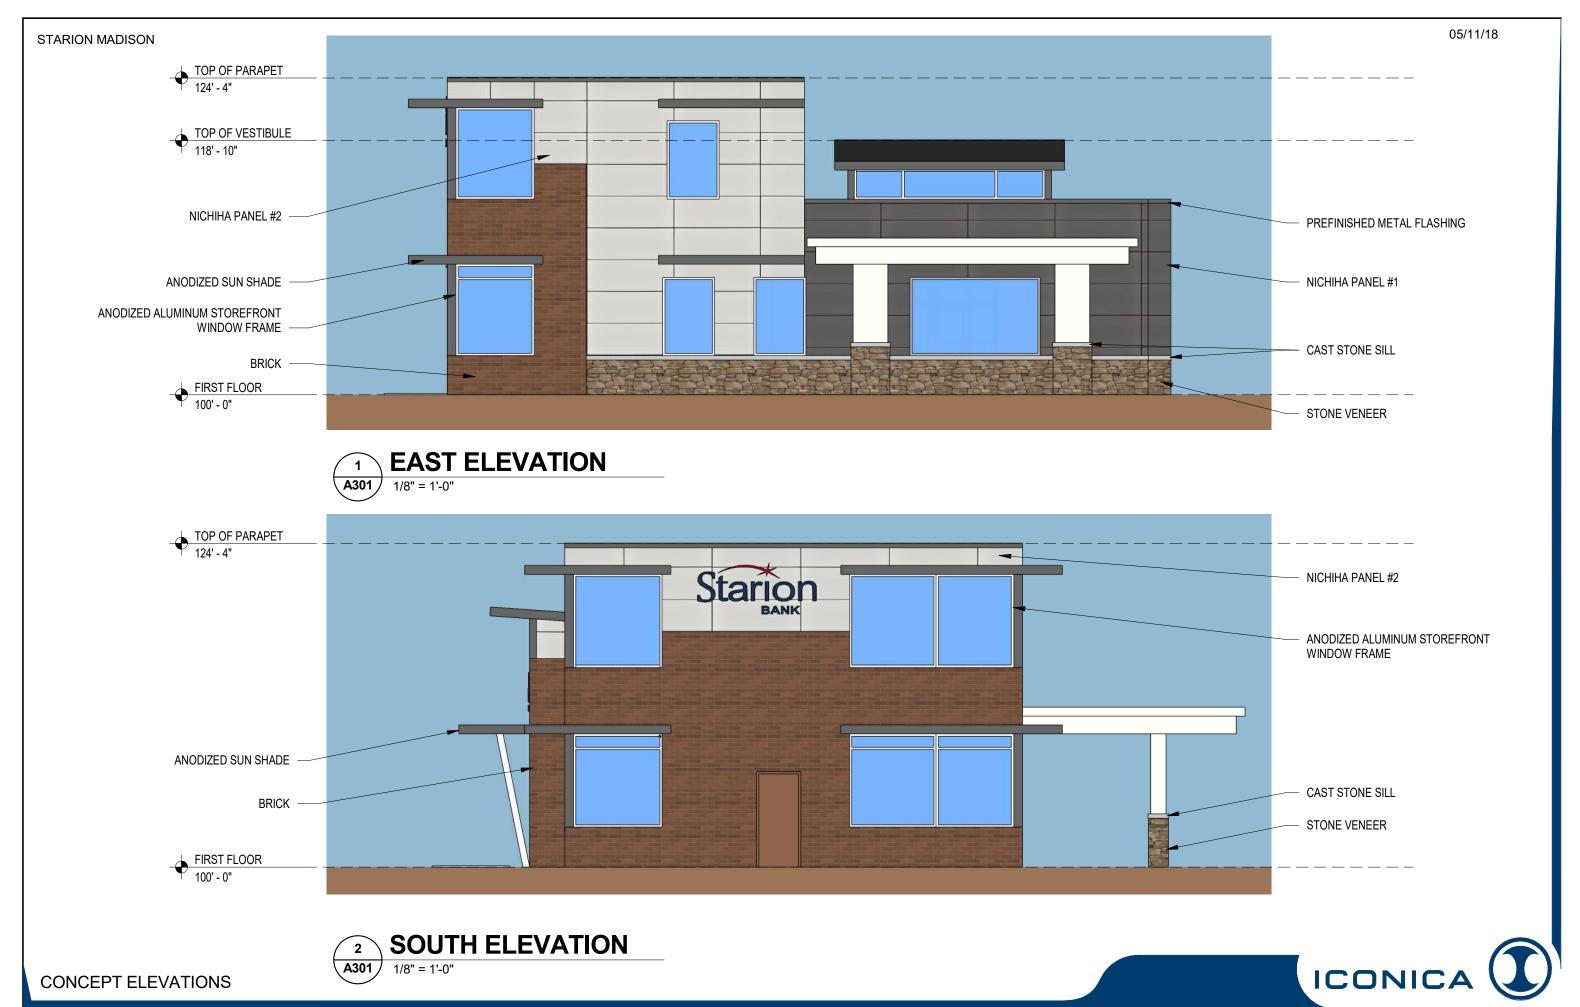






IĞONIĞA True Design-Build 901 Deming Way // Madison, WI53717 Ph: 608.664.3500 // Fx: 608.664.3535 iconicacreates.com N - MADISON /E - PARCEL #071019410069 I, WISCONSIN 53713 STARION FINANCIAL
333 NORTH 4TH STREET
BISMARCK, NORTH DAKOTA 58501 STARION - 2430 FRAZIER AVE - P ISSUE DATES: UDC INITIAL/FINAL: 05-16-18 CONDITIONAL USE: 05-16-18 REZONING: 05-16-18 STAFF COMMENTS 06-22-18 RFI/SI DATE: Schematic Design Phase This drawing indicates the scale and relationship of the project components. This drawing is not for construction. PROJECT #: 20180130

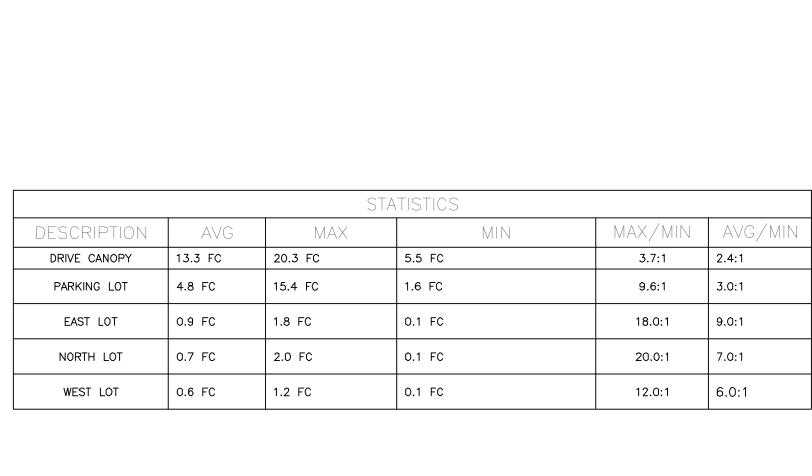

								£2 .	
								*0.3 *0.3 *0.2 *0.2 *0.2	
								i2 i2 p ⁺ pi	
	LIGHT FIXTURE SCHEDULE								
ID	Description	Manufacturer	Model #	Voltage	Lamps	Mounting	Remarks	6.2 6.2 6. 6.2 6.2 6.	
С	WALL MOUNTED EXTERIOR LIGHT	LITHONIA LIGHTING (ACUITY BRANDS)	DSXW1 LED 20C 700 40K T3S	MVOLT	LED (INCLUDED)	SURFACE		0,1 °C,1 °C,1 °C,1 °C,1 °C,1 °C,1 °C,1 °C	
D	RECESSED CAN LIGHT	GOTHAM LIGHTING (ACUITY BRANDS)	EVO 40/15 6AR MD LD	MVOLT	LED (INCLUDED)	RECESSED		0.1 c.1 c.1 c.1 c.1 c.1 c.1 c.1 c.1 c.1 c	
F	SITE POLE LIGHT 20'	LITHONIA LIGHTING (ACUITY BRANDS)	DSX2 LED P2 40K T3M	MVOLT	LED (INCLUDED)	RECESSED		6.1	
G	SITE POLE LIGHT 20'	LITHONIA LIGHTING (ACUITY BRANDS)	DSX2 LED P2 40K T5M	MVOLT	LED (INCLUDED)	RECESSED			

PHOTOMETRICS PLAN — BUSINESS

SCALE: 1" = 40'-0" 1" = 10'-0"

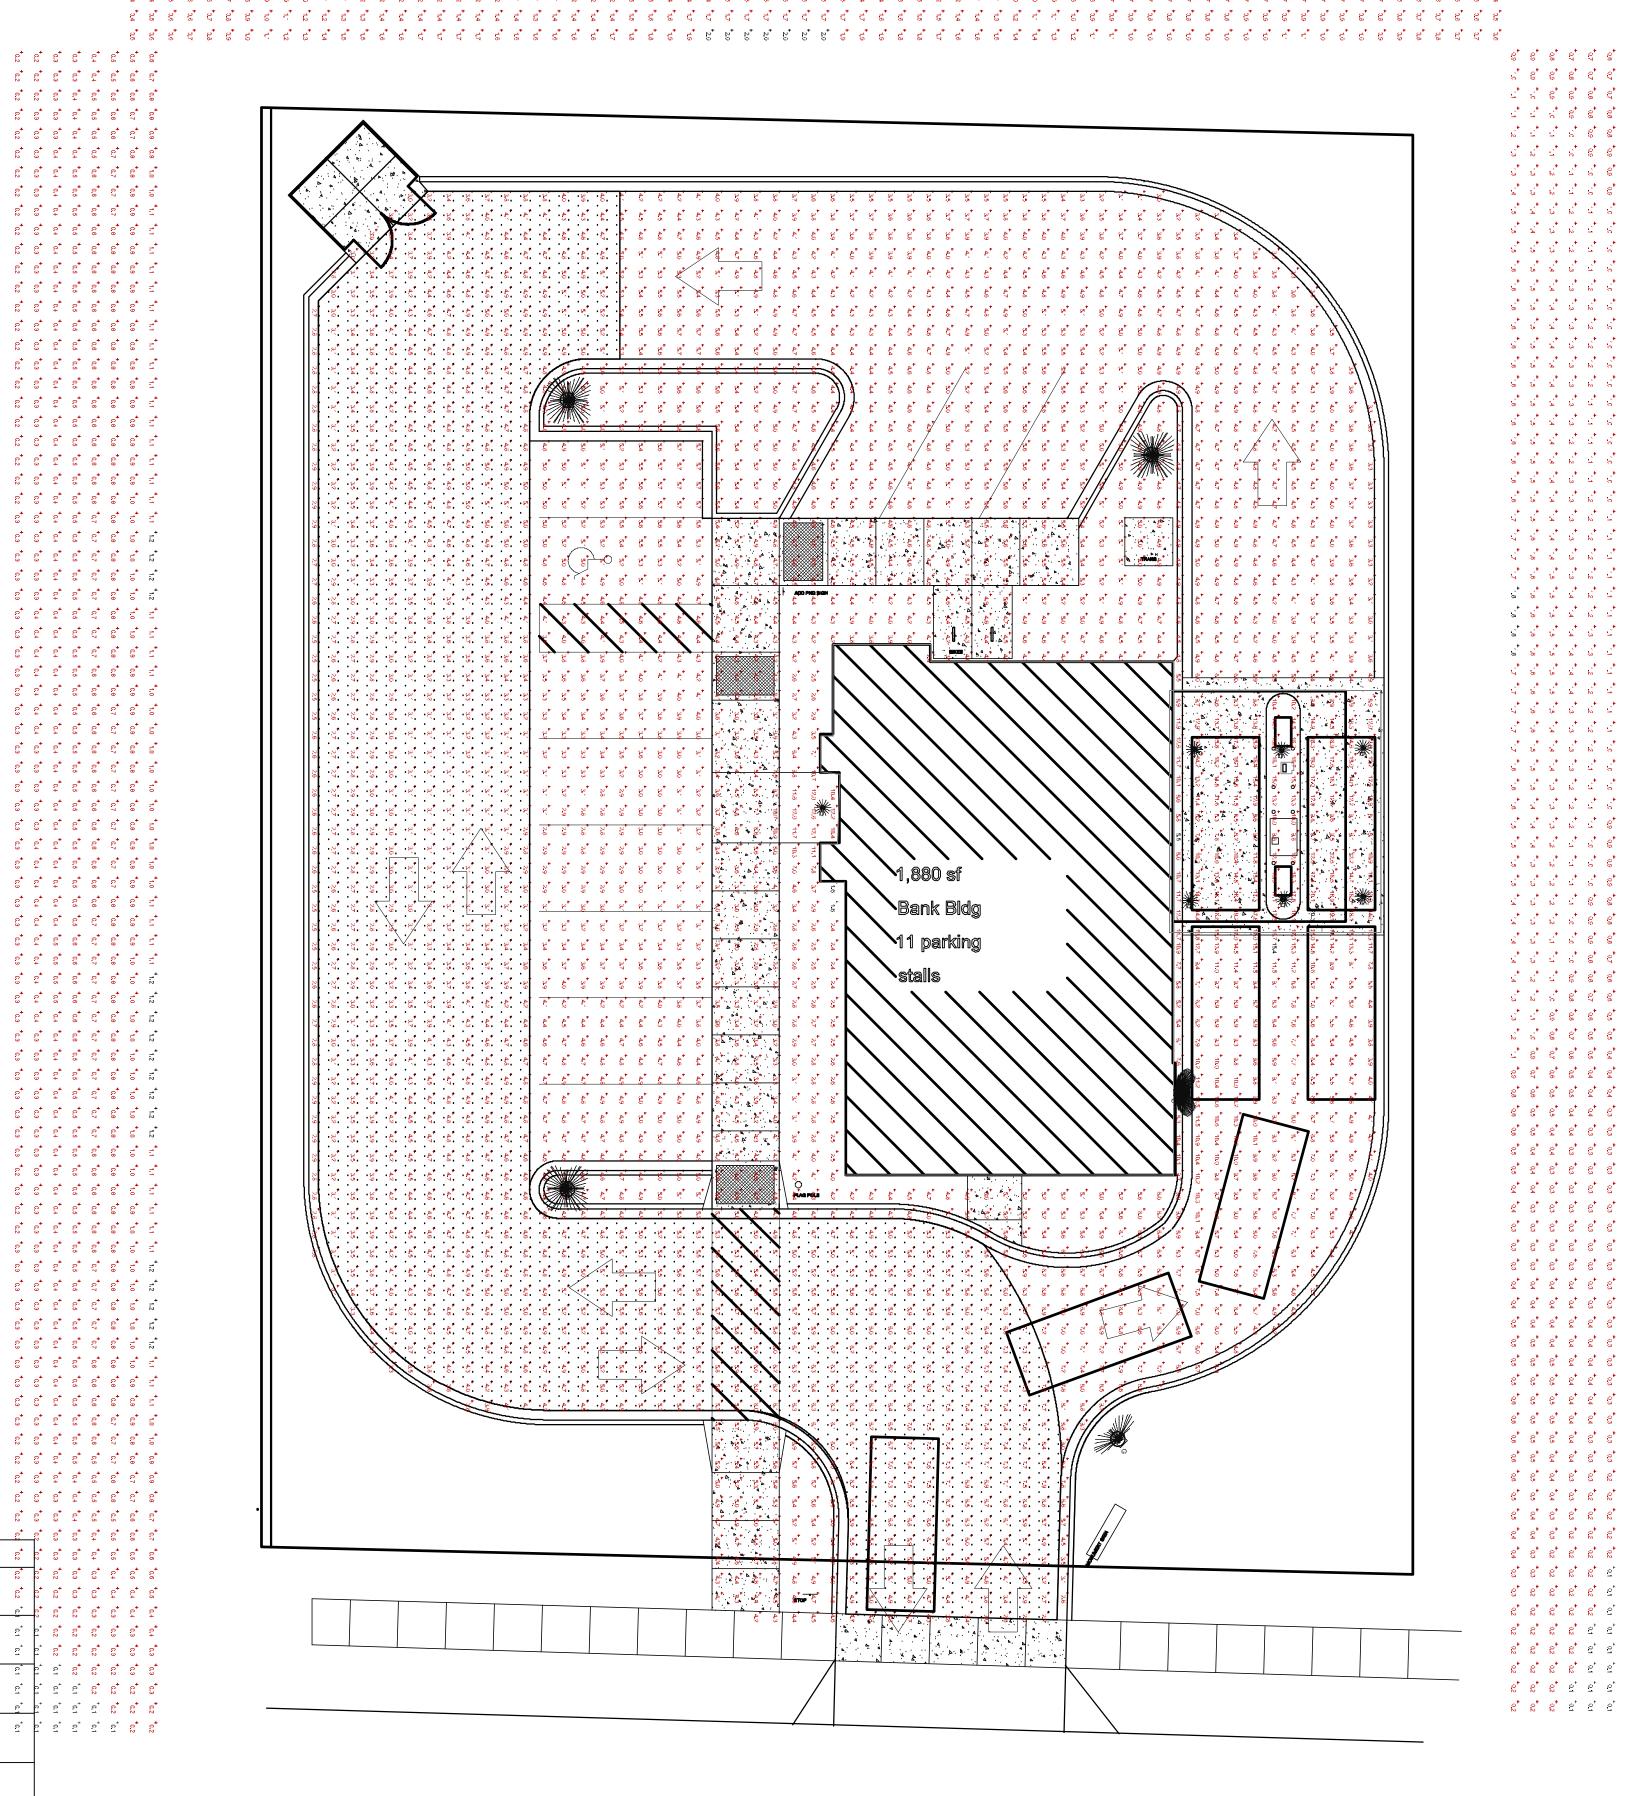

ICONICA
True Design-Build

901 Deming Way // Madison, WI 53717 Ph: 608.664.3500 // Fx: 608.664.3535 iconicacreates.com

> **1700** CEL #071019410069 NSIN 53713

MADISON, WISCONSIN 53713

STARION FINANCIAL
333 NORTH 4TH STREET
BISMARCK, NORTH DAKOTA 5850

ISSUE DATES:
UDC INITIAL/FINAL: 05-16-18
CONDITIONAL USE: 05-16-18
REZONING: 05-16-18

RFI/SI DATE:


Schematic Design Phase:

This drawing indicates the scale and relationship of the project components.
This drawing is **not for** construction.

This document contains confidential or proprletary Information of Iconica. Neither the document nor the information herein is to be reproduced, distributed, used or disclosed, either in whole or in part, except as specifically authorized by Iconica.

PROJECT #: 20180130
SHEET NUMBER

E100

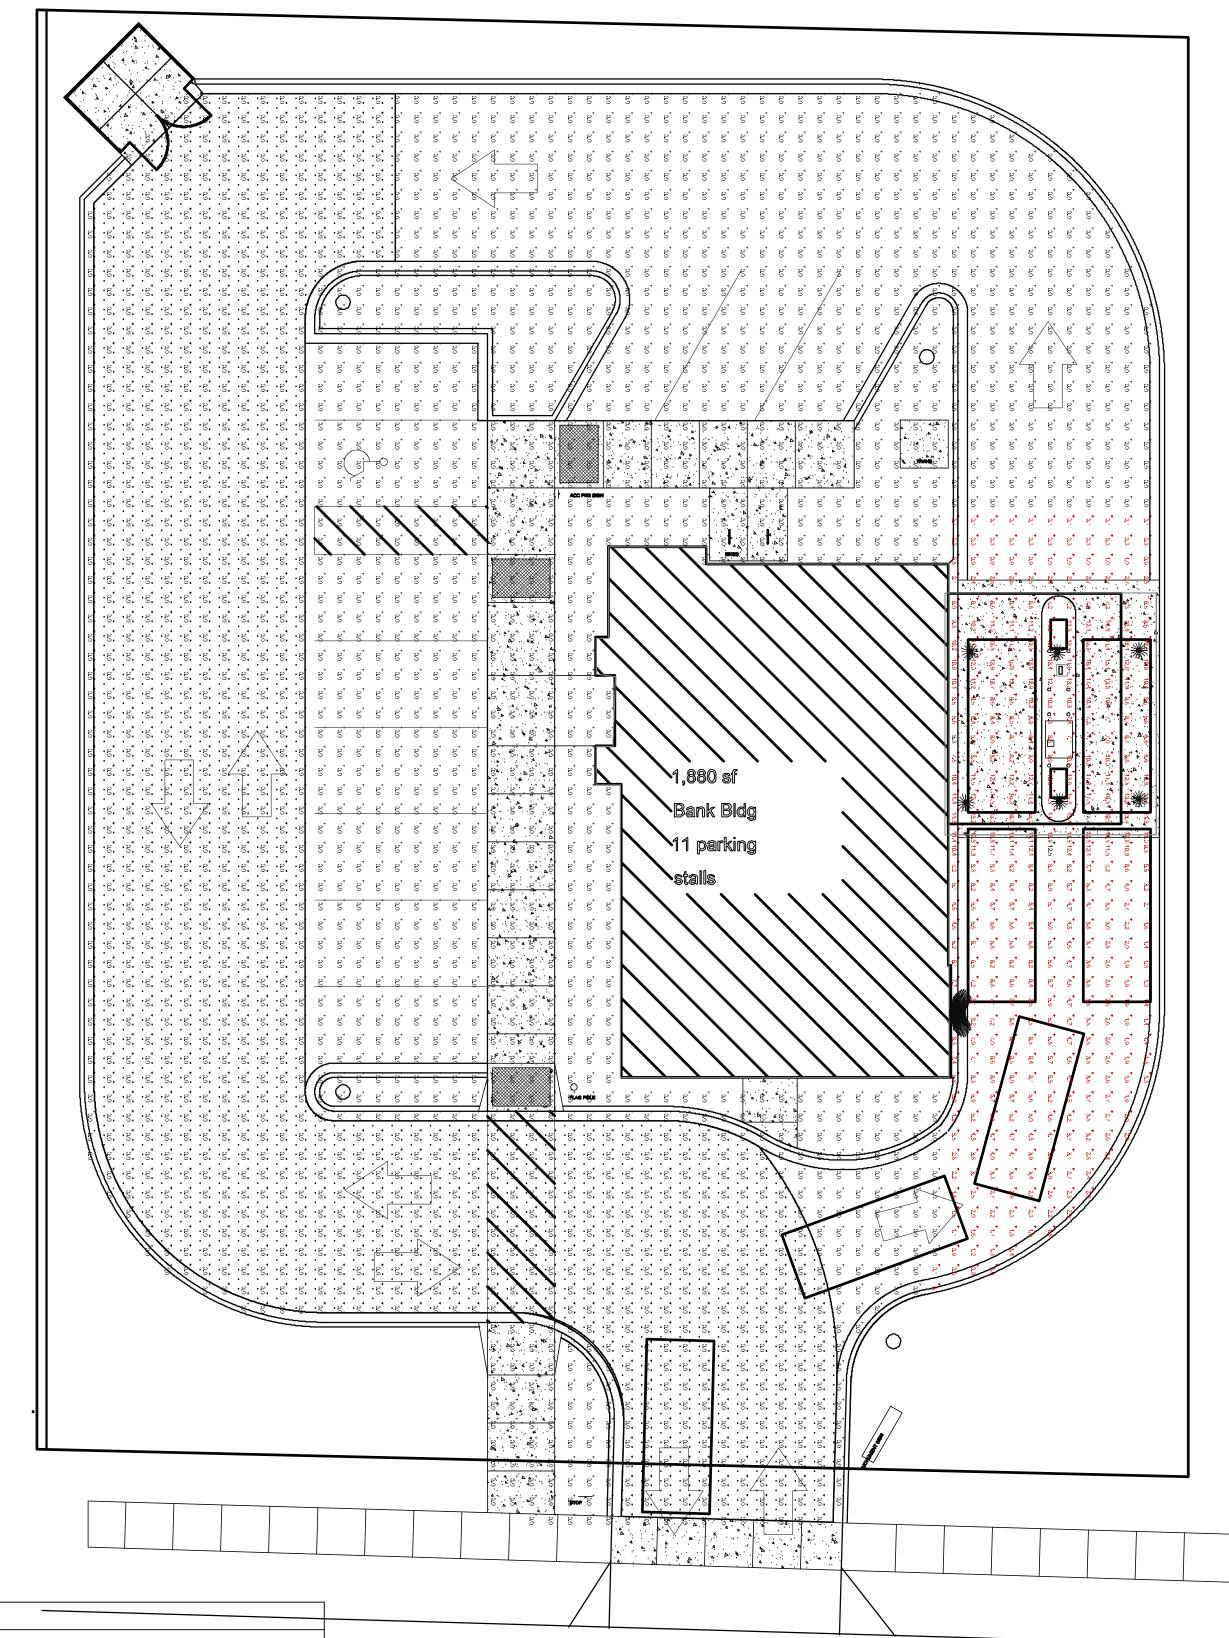

8 8 8 8 8

8 8 8 8 8


8 8 8 8 8 8


g' g' g' g' g' g'

STATISTICS								
DESCRIPTION	AVG	MAX	MIN	MAX/MIN	AVG/MIN			
DRIVE CANOPY	11.0 FC	17.7 FC	5.3 FC	3.3:1	2.1:1			
PARKING LOT	0.4 FC	12.5 FC	0.0 FC	N/A	N/A			
EAST LOT	0.0 FC	0.0 FC	0.0 FC	N/A	N/A			
NORTH LOT	0.0 FC	0.0 FC	0.0 FC	N/A	N/A			

	LIGHT FIXTURE SCHEDULE							
ID	Description	Manufacturer	Model #	Voltage	Lamps	Mounting	Remarks	
С	WALL MOUNTED EXTERIOR LIGHT	LITHONIA LIGHTING (ACUITY BRANDS)	DSXW1 LED 20C 700 40K T3S	MVOLT	LED (INCLUDED)	SURFACE		
D	RECESSED CAN LIGHT	GOTHAM LIGHTING (ACUITY BRANDS)	EVO 40/15 6AR MD LD	MVOLT	LED (INCLUDED)	RECESSED		



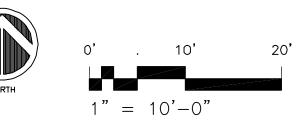

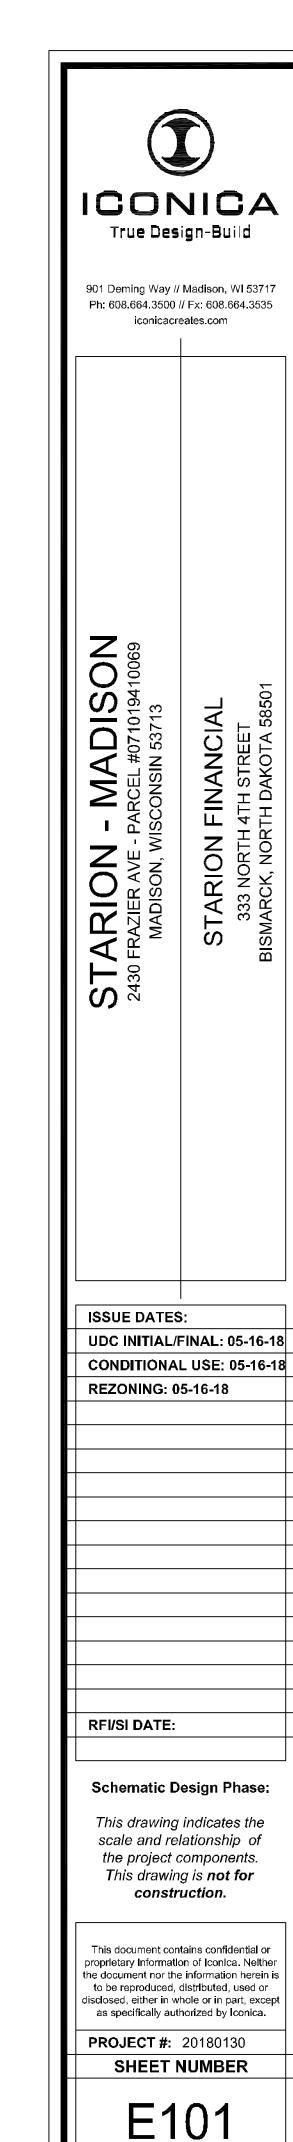



City of Madison Fire Department

314 W Dayton Street, Madison, WI 53703-2506

Phone: 608-266-4420 • Fax: 608-267-1100 • E-mail: fire@cityofmadison.com

Project Address:	2430 Frazier Ave, Madison, WI 53713
Contact Name &	Phone #: Bob Feller (608) 664-3591

FIRE APPARATUS ACCESS AND FIRE HYDRANT WORKSHEET

 Is the building completely protected by an NFPA 13 or 13R automatic fire sprinkler system? If non-sprinklered, fire lanes extend to within 150-feet of all portions of the exterior wall? If sprinklered, fire lanes are within 250-feet of all portions of the exterior wall? 	X Yes Yes X Yes	☐ No ☐ No ☐ No	N/AN/AN/A
2. Is the fire lane constructed of concrete or asphalt, designed to support a minimum load of 85,000 lbs? a) Is the fire lane a minimum unobstructed width of at least 20-feet? b) Is the fire lane unobstructed with a vertical clearance of at least 13½-feet? c) Is the minimum inside turning radius of the fire lane at least 28-feet? d) Is the grade of the fire lane not more than a slope of 8%? e) Is the fire lane posted as fire lane? (Provide detail of signage.) f) Is a roll-able curb used as part of the fire lane? (Provide detail of curb.) g) Is part of a sidewalk used as part of the required fire lane? (Must support +85,000 lbs.)	X Yes X Yes X Yes Yes Yes Yes Yes Yes Yes Yes Yes Yes	No No No No No No No No	 N/A N/A N/A N/A N/A N/A N/A N/A N/A
3. Is the fire lane obstructed by security gates or barricades? If yes:a) Is the gate a minimum of 20-feet clear opening?b) Is an approved means of emergency operations installed, key vault, padlock or key switch?	Yes Yes Yes	X No	N/A N/A N/A N/A
4. Is the Fire lane dead-ended with a length greater than 150-feet? If yes, does the area for turning around fire apparatus comply with IFC D103?	Yes Yes	X No No	N/A N/A
5. Is any portion of the building to be used for high-piled storage in accordance with IFC Chapter 3206.6 If yes, see IFC 3206.6 for further requirements.	Yes	X No	□ N/A
6. Is any part of the building greater than 30-feet above the grade plane?	Yes	X No	N/A
If yes, answer the following questions: a) Is the aerial apparatus fire lane parallel to one entire side of the building and covering at least 25% of the perimeter? b) Is the near edge of the aerial apparatus fire lane between 15' and 30' from the building? c) Are there any overhead power or utility lines located across the aerial apparatus fire lane? d) Are there any tree canopies expected to grow across the aerial fire lane? (Based on mature canopy width of tree species)	☐ Yes ☐ Yes ☐ Yes ☐ Yes	 No No No No	X N/A X N/A X N/A X N/A
e) Does the aerial apparatus fire lane have a minimum unobstructed width of 26-feet? f) Is the space between the aerial lane and the building free of trees exceeding 20' in heights?	☐ Yes☐ Yes	☐ No ☐ No	X N/A X N/A
7. Are all portions of the required fire lanes within 500-feet of at least (2) hydrants?	X Yes	□ No	N/A
 Note: Distances shall be measured along the path of the hose lay as it comes off the fire apparatus. a) Is the fire lane at least 26' wide for at least 20-feet on each side of the hydrants? b) Is there at least 40' between a hydrant and the building? c) Are the hydrant(s) setback no less than 5-feet nor more than 10-feet from the curb or edge of the street or fire lane? 	X Yes X Yes X Yes	☐ No ☐ No ☐ No	□ N/A □ N/A □ N/A
 d) Are hydrants located in parking lot islands a minimum of 3½-feet from the hydrant to the curb? e) Are there no obstructions, including but not limited to: power poles, trees, bushes, fences, posts 	Yes	□ No	X N/A

Attach an additional sheet if further explanation is required for any answers.

This worksheet is based on MGO 34.503 and IFC 2015 Edition Chapter 5 and Appendix D; please see the codes for further information.