

# CITY OF MADISON ZONING BOARD OF APPEALS

### VARIANCE APPLICATION

\$300 Filing Fee

Ensure all information is **typed** or legibly **printed** using blue or black ink.

Address of Subject Property: 116 E. Dayton Street	
Name of Owner: Dewey & Sandy Bredeson	
Address of Owner (if different than above): 6420 Clo	
Address of Switch (in different than above). 0420 Ok	TVEITIOUR ING. IVIII UNIE (OII, VVI 33302
Daytime Phone: 608 575-0990	Evening Phone: 608 575-0990
Email Address: baytree@chorus.net	
Zindii / Iddi essi.	
Name of Applicant (Owner's Representative):	
Address of Applicant:	
	Evening Phones
	Evening Phone:
Email Address:	
Description of Requested Variance: Side yard setback variance for a rear 2-story additionsecond floor bump-out location on an existing non-content.	
Amount Paid: Receipt: Filing Date: Received By: Parcel Number:	(See reverse side for more instructions)  E USE ONLY Hearing Date: Published Date: Appeal Number: GQ: Code Section(s):
Zoning District: USF	
AIGHT DISTRICT' - CHIT	

### **Standards for Variance**


The Zoning Board of Appeals shall not grant a variance unless it finds that the applicant has shown the following standards are met:

1.	There are conditions unique to the property of the applicant that do not apply generally to other properties in the district.		
	The lot and house are already non-conforming due to lot width		
2.	The variance is not contrary to the spirit, purpose, and intent of the regulations in the zoning district and is not contrary to the public interest.		
3.	For an area (setbacks, etc) variance, compliance with the strict letter of the ordinance would unreasonably prevent use of the property for a permitted purpose or would render compliance with the ordinance unnecessarily burdensome.		
	Moving the addition the northeast to comply with the side yard setback, results in the elimination of the garage access		
4.	The alleged difficulty or hardship is created by the terms of the ordinance rather than by a person who has a present interest in the property.		
	The lot and house are already non-conforming due to lot width		
5.	The proposed variance shall not create substantial detriment to adjacent property.		
	The addition will basically match with what is there currently except have finished space and not an open porch at the first floor level		
6.	The proposed variance shall be compatible with the character of the immediate neighborhood.		
	We are proposing to match characteristics of the gable end in order to keep the aesthetic character of the existing building		

### **Application Requirements**

**Please provide the following Information** (Please note any boxes left uncheck below could result in a processing delay or the Board's denial of your application):

	Pre-application meeting with staff: Prior to submittal of this application, the applicant is strongly encouraged to discuss the proposed project and submittal material with Zoning staff. Incomplete applications could result in referral or denial by the Zoning Board of Appeals.				
	Site plan, drawn to scale. A registered survey is recommended, but not required. Show the following on the site plan (Maximum size for all drawings is 11" x 17"):  Lot lines  Existing and proposed structures, with dimensions and setback distances to all property lines  Approximate location of structures on neighboring properties adjacent to variance  Major landscape elements, fencing, retaining walls or other relevant site features  Scale (1" = 20' or 1' = 30' preferred)  North arrow				
	<b>Elevations</b> from all relevant directions showing existing and proposed views, with notation showing the existing structure and proposed addition(s). (Maximum size for all drawings is 11" x 17")				
	Interior floor plan of existing and proposed structure, when relevant to the variance request and required by Zoning Staff (Most additions and expansions will require floor plans). (Maximum size for all drawings is 11" x 17")				
	<b>Front yard variance requests only.</b> Show the building location (front setback) of adjacent properties on each side of the subject property to determine front setback average.				
	<b>Lakefront setback variance requests only.</b> Provide a survey prepared by a registered land surveyor showing existing setbacks of buildings on adjacent lots, per MGO 28.138.				
	Variance requests specifically involving slope, grade, or trees. Approximate location and amount of slope, direction of drainage, location, species and size of trees.				
	CHECK HERE. I acknowledge any statements implied as fact require supporting evidence.				
	<b>CHECK HERE.</b> I have been given a copy of and have reviewed the standards that the Zoning Board of Appeals will use when reviewing applications for variances.				
Own	er's Signature: Dam Dan Dan Dan Date: 4-24-2018  (Do not write below this line/For Office Use Only)				
	DECISION  oard, in accordance with its findings of fact, hereby determines that the requested variance for  (is) (is not) in compliance with all of the standards for a variance.				
Furth	er findings of fact are stated in the minutes of this public hearing.				
The Z	Zoning Board of Appeals: Approved Denied Conditionally Approved				
700:-	ng Board of Appeals Chair:				
Date:					

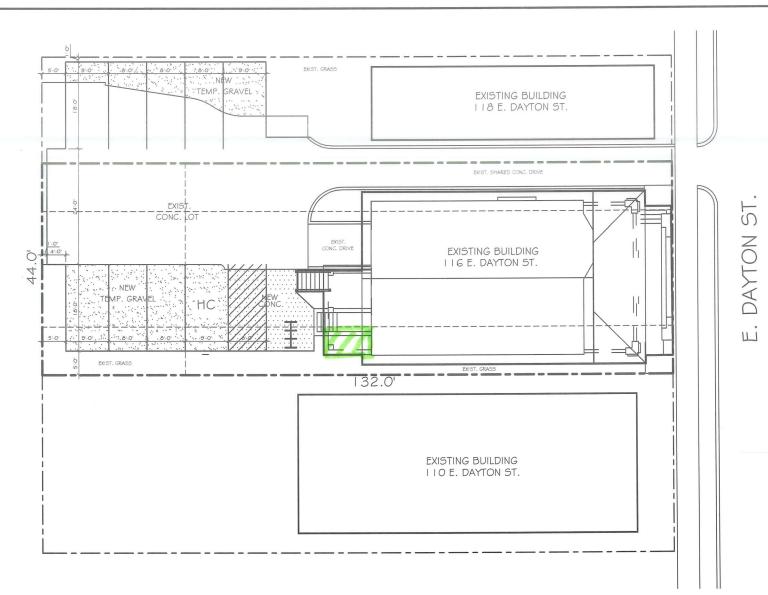



two-Story Four whit Read mut Building
Encose 1st Lond Paris At ramber Structure

Side Yard

10.0' Peyer red

Provided

Novim Ce

SITE INFORMATION BLOCK

PROJECT DESCRIPTION: A JOINT DRIVEWAY/ PARKING LOT EASEMENT AGREEMENT WILL BE PROVIDED FOR SITES 116 & 118 EAST DAYTON STREET. DUE TO THE DEMOLITION OF 118 IN THE NEAR FUTURE, THE PROPOSED PERVICUS PAVEMENT LOT WILL BE COMPLETED AFTER AT A LATER DATE A LATER DATE.

WORK FOR I I & EAST DAYTON STREET WILL BE SUBMITTED UNDER A SEPARATE COVER.

SITE ADDRESS: 116 EAST DAYTON STREET

SITE ACREAGE: (TOTAL) 0.13 ACRES

SITE ZONING: UOR - URBAN OFFICE-RESIDENTIAL DISTRICT

EXISTING NON-CONFORMING LOT (LOT WIDTH)

NUMBER OF BUILDING STORIES (ABOVE GRADE): 2 - EXISTING

BUILDING HEIGHT: EXISTING

DILHR TYPE OF CONSTRUCTION: TYPE IIIB EXISTING

TOTAL SQUARE FOOTAGE OF BUILDING: 3,996 SF.

USE OF PROPERTY: GROUP R-2 - 4-UNIT MULTI-FAMILY

IST FLR: I BEDROOM UNIT 2ND FLR: (2) | BEDROOM UNITS 2ND FLR: 2 BEDROOM UNIT

NUMBER OF BICYCLE STALLS SHOWN: 6 STALLS


NUMBER OF PARKING STALLS:

SMALL CARS	2	
LARGE CARS	1	
ACCESSIBLE	T	
TOTAL PROVIDED	4	

#### SITE AREA CALCS:

TOTAL LOT AREA: 5,808 SQ. FT. HOUSE FOOTPRINT AREA: 2,464 SQ. FT. EXISTING CONCRETE DRIVES: 553 SQ. FT. NEW CONCRETE ISLE/ WALKS: 282 SQ. FT. NEW PERVIOUS PAVEMENT LOT: 1,779 SQ. FT.

TOTAL LOT COVERAGE: 57%

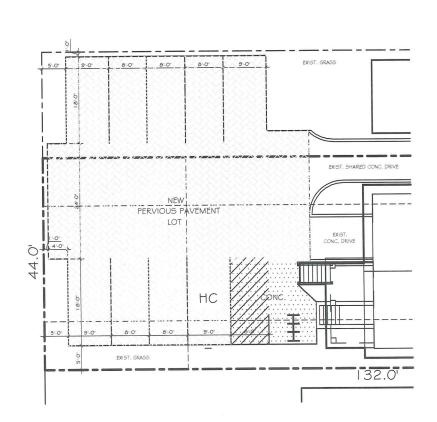



Submittal Zoning

Bouril Design Studio, uc


Dewey Bredeson nativet, Madison. WI 53703 Remodel for ₩ Sandy

REVISIONS DATE ISSUE

> PROJECT NO 18011

DRAWN BY

SW

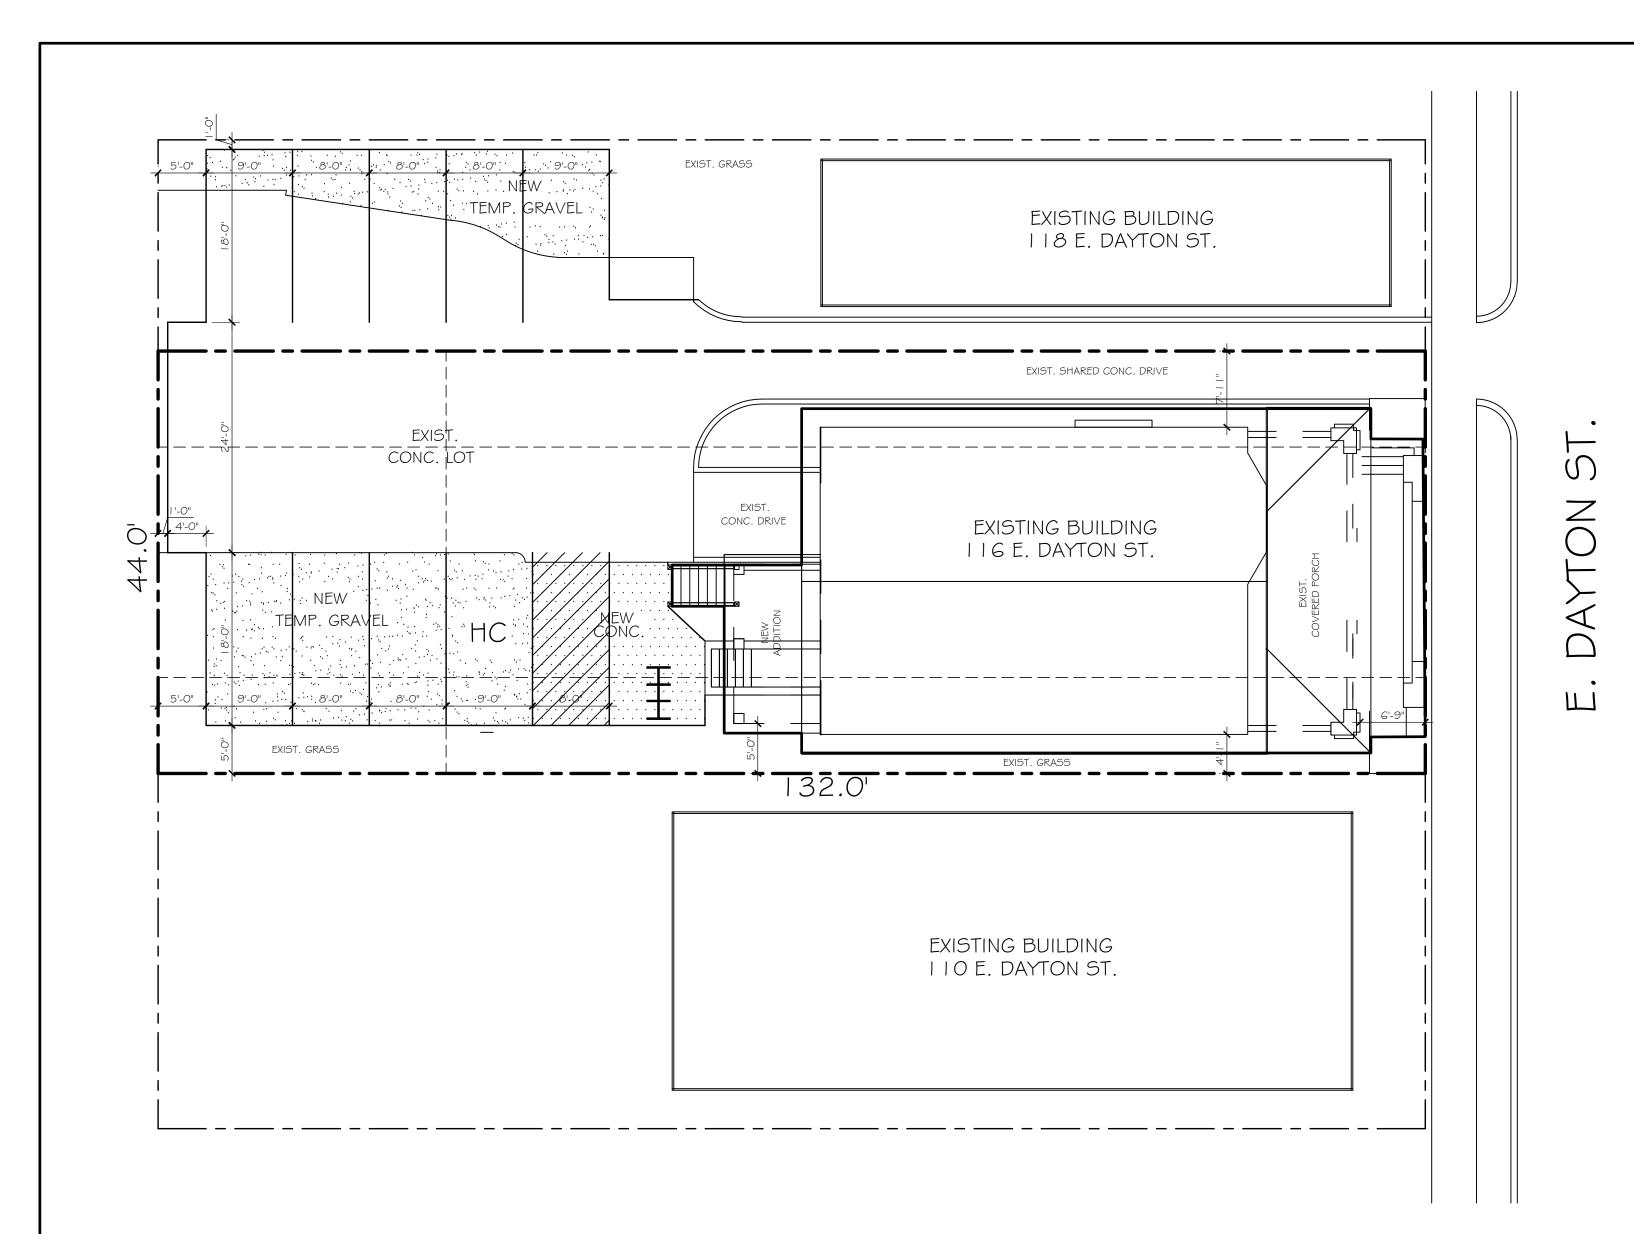



### SITE INFORMATION BLOCK

PROJECT DESCRIPTION: A JOINT DRIVEWAY/ PARKING LOT EASEMENT AGREEMENT WILL BE PROVIDED FOR SITES 116 \$ 118 EAST DAYTON STREET. DUE TO THE DEMOLITION OF 118 IN THE NEAR FUTURE, THE PROPOSED PERVIOUS PAVEMENT LOT WILL BE COMPLETED AFTER AT A LATER DATE.

WORK FOR 118 EAST DAYTON STREET WILL BE SUBMITTED UNDER A SEPARATE COVER.

SITE ADDRESS: 116 EAST DAYTON STREET

SITE ACREAGE: (TOTAL) 0.13 ACRES

SITE ZONING: UOR - URBAN OFFICE-RESIDENTIAL DISTRICT
EXISTING NON-CONFORMING LOT (LOT WIDTH)

NUMBER OF BUILDING STORIES (ABOVE GRADE): 2 - EXISTING

BUILDING HEIGHT: EXISTING

DILHR TYPE OF CONSTRUCTION: TYPE IIIB EXISTING

TOTAL SQUARE FOOTAGE OF BUILDING: 3,996 SF.

USE OF PROPERTY: GROUP R-2 - 4-UNIT MULTI-FAMILY

IST FLR: I BEDROOM UNIT

2ND FLR: (2) I BEDROOM UNITS

2ND FLR: 2 BEDROOM UNIT

NUMBER OF BICYCLE STALLS SHOWN: 6 STALLS

NUMBER OF PARKING STALLS:


SMALL CARS	2
LARGE CARS	
ACCESSIBLE	
TOTAL PROVIDED	4

## SITE AREA CALCS:

TOTAL LOT AREA: 5,808 SQ. FT.
HOUSE FOOTPRINT AREA: 2,464 SQ. FT.
EXISTING CONCRETE DRIVES: 553 SQ. FT.
NEW CONCRETE ISLE/ WALKS: 282 SQ. FT.

NEW PERVIOUS PAVEMENT LOT: 1,779 SQ. FT.

TOTAL LOT COVERAGE: 57%

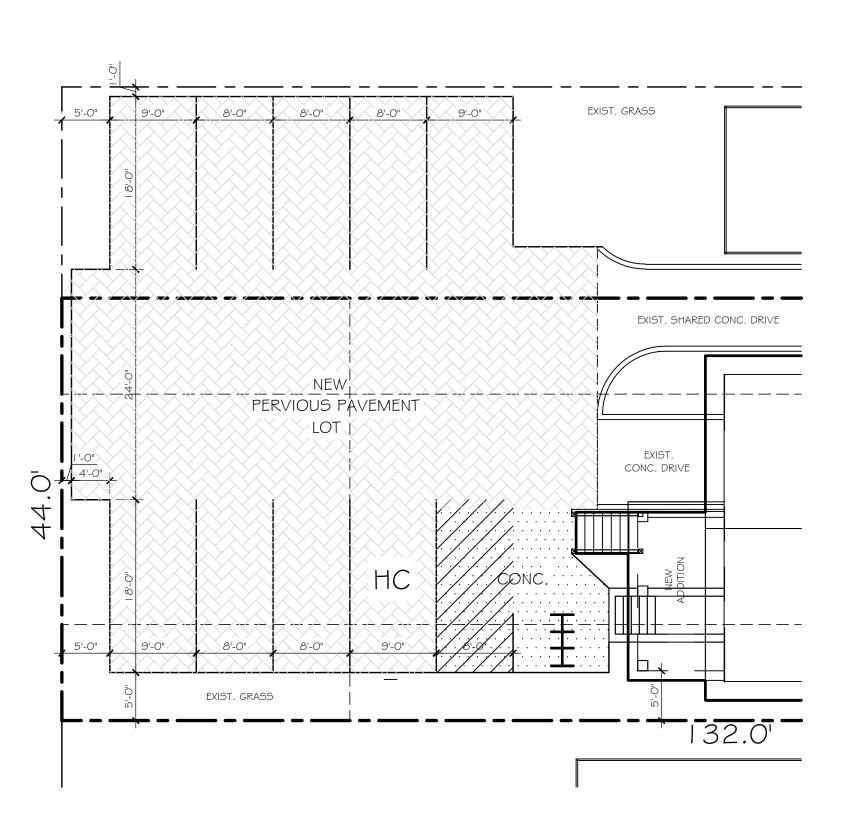



EDESIGN REPRESENTED BY THESE AWINGS IS THE PROPERTY OF BOURIL SIGN STUDIO, LLC. THESE DRAWINGS, ETHER PRINTED OR IN ELECTRONIC AWAT, MAY NOT BE COPIED OR PODUCED IN ANY FORM WITHOUT THE ITTEN CONSENT OF BOURIL DESIGN DIO. LLC OF MADISON. WISCONSIN.

DESIGN STUDIO, LI
WHETHER PRINTED
FORMAT, MAY NOT
REPRODUCED IN A
WRITTEN CONSENT
STILIDIO 11.C OF M

oning Submittal

N

Bouril Design Studio, LLC 6425 Odana Rd, Suite 2, Madison, WI 53719 Phone: (608) 833-3400

Bour e425 Oct

Remodel for Sandy & Dewey Bredeson 116 East Dayton Street, Madison, WI 53703

REVISIONS


A DATE ISSUE

PROJECT NO

PROJECT NO

5/8/2018 DRAWN BY

SWI

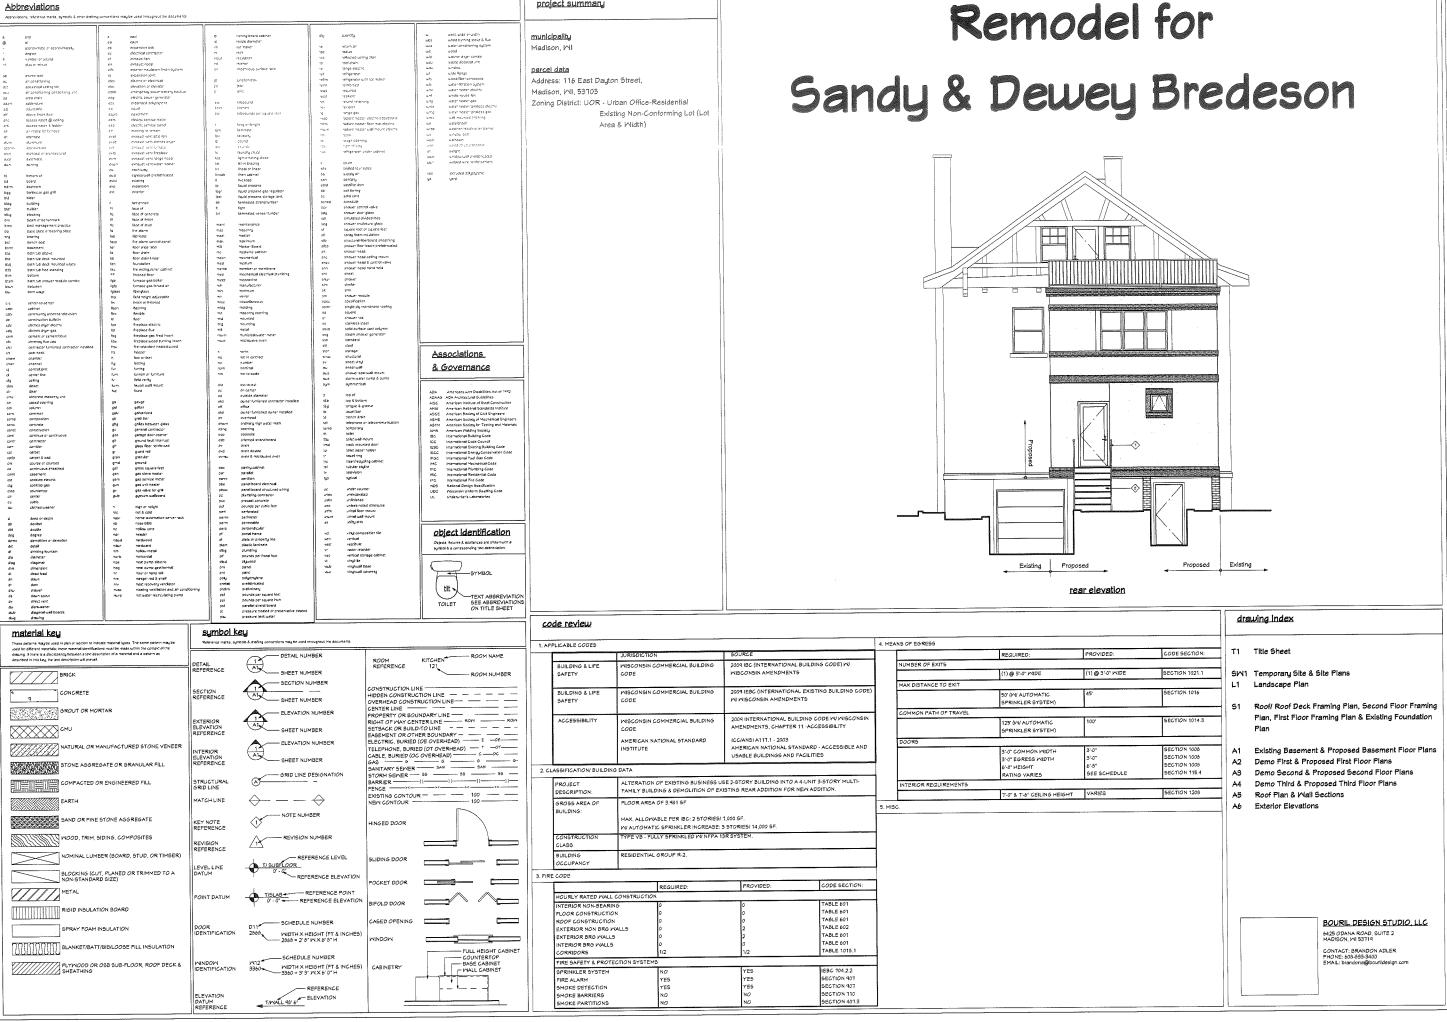

project summary

Abbreviations


Studio, LLC Bouril Design

Dewey Bredeson

ంద్ర Sandu L

project: 18011 date: 4/16/2018 drawn by: BB

- REFER TO CITY OF MADISON LANDSCAPE WORKSHEET FOR LANDSCAPE POINT TOTAL CONFORMANCE.
- PROVIDE EROSION CONTROL DEVICES AROUND PERIMETER OF CONSTRUCTION SITE DOWNHILL FROM EXCAVATIONS. EROSION CONTROL SHALL COMPLY WITH ALL APPLICABLE REGULATIONS.
- 3. CONTRACTOR TO REPAIR ALL DISTURBED AREAS WITH TOPSOIL TO FINISH GRADE, SEED & MULCH.

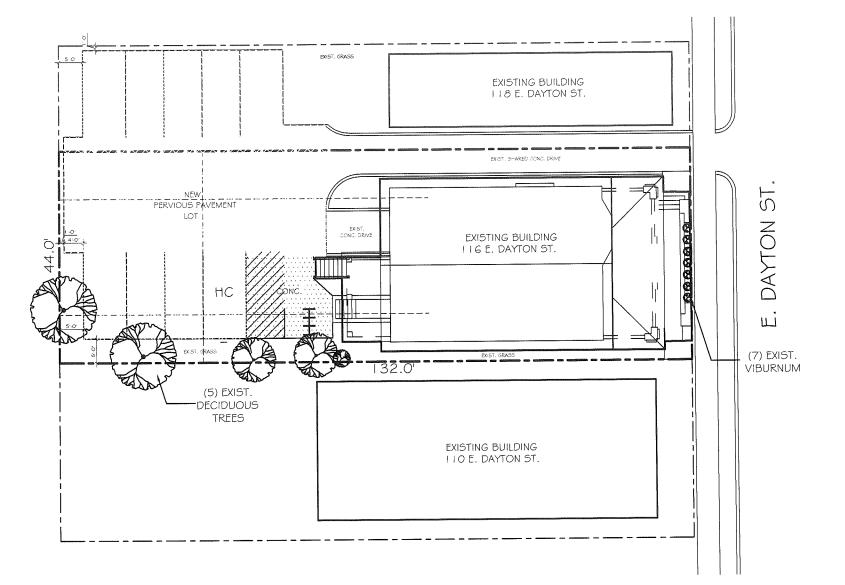

LANDSCAPE PLAN

DESIGN REPRESENTED BY THESE
WHIGS IS THE REOPERTY OF BOURN
SIGN STUDIO, LIC. THESE DRAWINGS
SIGN STUDIO, LIC. THESE DRAWINGS
NAM. MAY NOT BE COPED OR
REODUCED IN ANY FORM WITHOUT THE
PRODUCED OF BOURD OF THE OPENION
THE COPERITY OF BOURD OF THE DESIGN
THE COPERITY OF BOURD ON THE COPENION THE OPENION
THE COPERITY OF BOURD ON THE OPENION
THE COPERITY OF THE OPENION

WHETHER PRINTED O WHETHER PRINTED O FORMAT, MAY HOT E REPRODUCED IN AHY WRITTEN CONSENT O

Zoning Submittal

Bouril Design Studio, uc ozas coma ra samo 2 Mendenn. 141 62719

Remodel for Dewey Bredeson avon Street, Madson, WI 53703

REVISIONS

DATE ISSUE


Sandy


PROJECT NO

DATE 4/16/2018

DRAWN BY


Ll

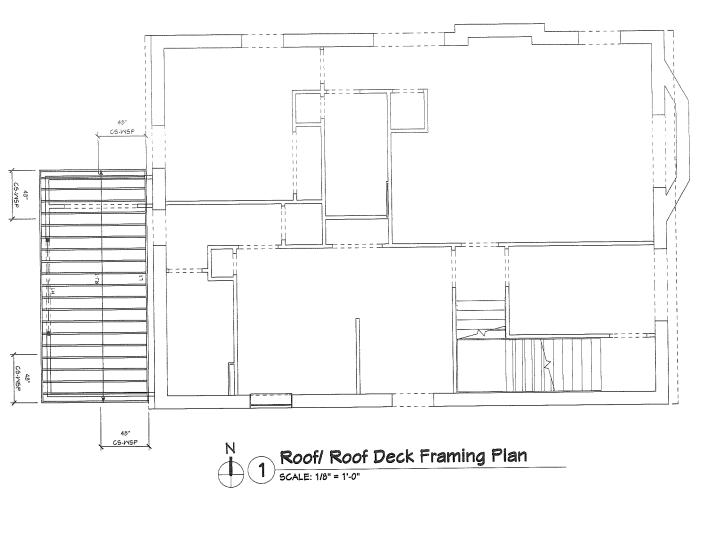

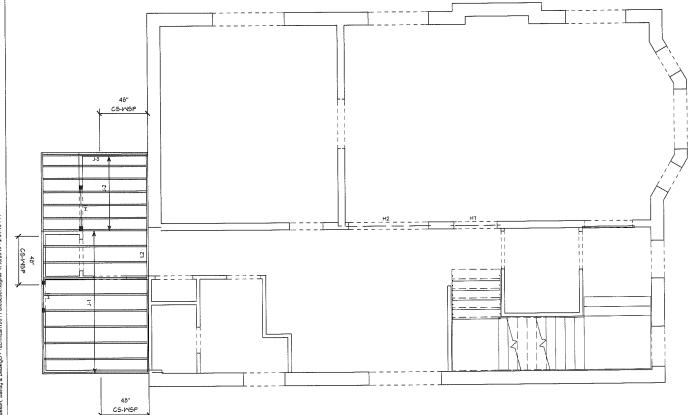

Second Floor Framing Plan

SCALE: 1/8" = 1'-0"

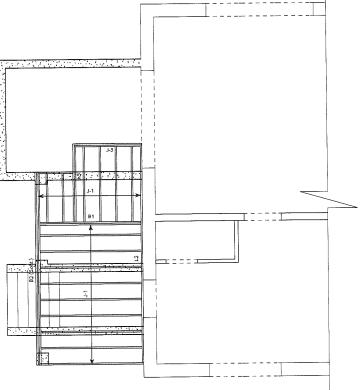

3 First Floor Framing Plan

SCALE: 1/8" = 1'-0"

Existing Foundation Plan SCALE: 1/8" = 1'-0"

Noning English

Studio,

Dewey Bredeson

Sandus

project: 18011 date: 4/16/2018 drawn by: BB

51

Existing Basement Floor Plan

SCALE: 1/8" = 1'-0"

Mech/ Storage 

Proposed Basement Floor Plan

SCALE: 1/8" = 1'-0"

General Notes - Basement Plan

Key Notes - Basement Plan 1 Masher/ dryer by owner at existing connections

1. Existing basement items are to remain as they are. Update MEP equipment as needed for new work on other floors

Sandy & Dewey Bredeson 116 East Dayton Street, Madison, WI, 53703

Zoning Submittal

Bouril Design Studio, L.c

- 1. The general contractor is responsible for determining the presence of asbestos-containing material and lead-based paint. These materials have the potential to advarsely affect human health and the environment. The abatement of these materials is regulated by federal, state, and local laws and regulations. Along with the appropriate industry
- these materials is regulated by federal, state, and local laws and regulations, along junt the appropriate invusary practices, these laws and requisitions must be followed during abatement and all phases of construction activity, including demolition and new construction.

  2. The general contractor and subcontractors shall thoroughly familiarize themselves with the existing building prior to the start of aemolition. All work coulded of the area of demolition shall be protected from incidental damage. Any damage shall be repaired as new to the councer's satisfaction prior to completion of new construction.
- statil for repairts as new to the currier's emistration prior to compression on mar consumerous.

  A. All existing shortcure to remain shall be brace, shored, and reinforced as required during the demolflon process. All bracing, shoring, and reinforcement shall remain in place during new construction as required or as deemed necessari by the general contractor.
- og the general commodor. 1. The disposition of all equipment, fixtures, doors, windows, hardware, etc slated for demofition shall be coording the owner. Items that are selected by the owner for salvage shall be carefully removed to avoid incidental damage. The the country literia that are selection up the function belongs, which is designed a lother salvages dems shall be lumed over to the country.

  5. Extent of demolition of openings must be coordinated with the new construction.

Key Notes - Demolition Plan (#)

1. Dashed line indicates the demolition of wall, stairs, post, door, window, stab, etc (typ)

#### General Notes - First Floor Plan

- 1. See Title Sheets for Abbreviations & Product & Material Specifications.
- All dimensions are to the face of dimensional members (stud, blocking, framing, board, etc). Dimensions do not
- All dimensions are to the face or aimensional mentions (study, obscalle, natural), reference sheathing, wall board or other finish litems unless noted otherwise.
   Provide solid wood blocking & bracing for all wall-mounted & celling mounted eq manufacturer's instructions or as required by the equipment supplier or installer.
- 4. All wood in contact with concrete shall be preservative treated
- National in Contact uncontract some of the Stand openings.

  5 Verify rough opening requirements for all framed openings.

  6 Position & layout of cabinarty, counterlops, appliances & lixtures are for general reference only. Installation & roughins shall be per counter approved shop drawings.

  1. Unless noted dytheruse, Linen, Partiny, Storage & Utility, Closets to receive five adjustable white low pressure.
- laminate shelves on pre-finished steel or aluminum shelf standards of sufficient strength to support loads. Shelf dep
- terninate she'ves on pre-finished steel or aluminum shelf elandards of sufficient strength to support loads. Shelf depth shall allow clearance for changing shelf heights.

  5. Master Closet to receive modular closet storage & hanging system as an allowance. Supplier to coordinate directly with Duner for design & finishes. All other Bedroom Closets, entry Coat Closets & Mudroom Closets to receive one white loup pressure laminate fixed shelf with pre-finished steel, aluminum or wood hanging rod. Shelf to be 1/2 the depth of the closet, mounted at 10° above the finished floor; not to be mounted at 66° above the finished floor & closets of the finished floor.
- depth of the closel, mounted at 10° above the finished floor; not to be mounted at 66° above the finished floor & centered in the closed depth.

  9. Bathrooms to receive an Energy Star rated venting fan with built-in adjustable delay timer & automatic backdraft damper. If installed within a shower enclosure, select a unit that is UL listed for this use & wire to a 6°Cf predected direxit. Exhancial receit is the exterior through a single 4° diameter in 28ga min smoth-bore rigid duct, minimum elbous, minimum run, terminating with a louvered wall cap or dampered & screened roof jack.

  10. Exhaust clothes diper directly to the exterior through a single 4° diameter min 28ga min smooth-bore rigid duct, minimum dibuss, minimum nut, terminating with a dampered wall cap or screened roof jack. If the vent is routed through a framed wall provide a recessed driger vent box or manifold. In all cases the vent must exhaust 3° (min) from the start of the control of the
- any other opening into the building into the building.

  1. Provide ducked range hood & vent fan uith automatic backdraft damper, Energy-Star rated. Exhaust directly to the exterior through a single 4" min, 28ga min, smooth-bore rigid duct, minimum elboux, minimum run, terminating with a screened & dampered wall cap or roof jack.

#### Partition Type Legend

Existing Exterior Mail:

Existing 2x Interior Mall:

New 2x4 Exterior Stud Wall w/ foam-in-place insulation

New 2x Interior Stud Wall w/ sound batt insulation:

#### 'Note - Provide plaster finish to match existing. Finish Info - First Floor Plan

Trim - Base & Casing: New base and casing is to match existing in material, profile & finish. Reuse existing where

Doors: New doors are to match existing in material, profile & finish. Reuse existing doors where possible.

Windows: New windows are to match existing in material, profile & finish. Re-glaze existing windows as required.

Cabinetry: New kitchen and bath cabinets are to match existing trim material & finish, verify door style. Countertops

Shower Doors & Mirrors: New swinging glass door @ shower & mirror @ vanity.

Appliances: Provide an allowance for appliances as shown

Elozing:

HDND ETR - Existing hardwood to remain, patch and refinish as required HDNO - New hardwood to match existing CPT - New carpet & pad


VNL PLANK - New vinyl plank flooring


VKL IT.AKK. - New Virigi juest Nooring
VKL IVP DECKTIKK - New Virigi waterproof decking
TILE - New Ulle & underlayment
MD COMP - New composite wood decking
\*\*Note - Provide soundproof floor underlayment @ all new flooring locations as required.
\*\*Note - Provide soundproof floor underlayment @ all new flooring locations as required.


Key Notes - First Floor Plan

2x infill @ existing pocket door location on front side, door is to remain on back side

New header @ existing load bearing wall New railing system

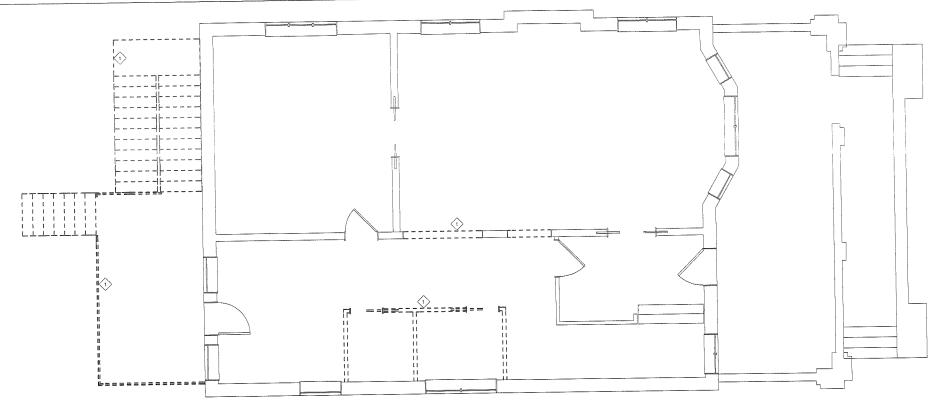

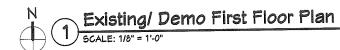

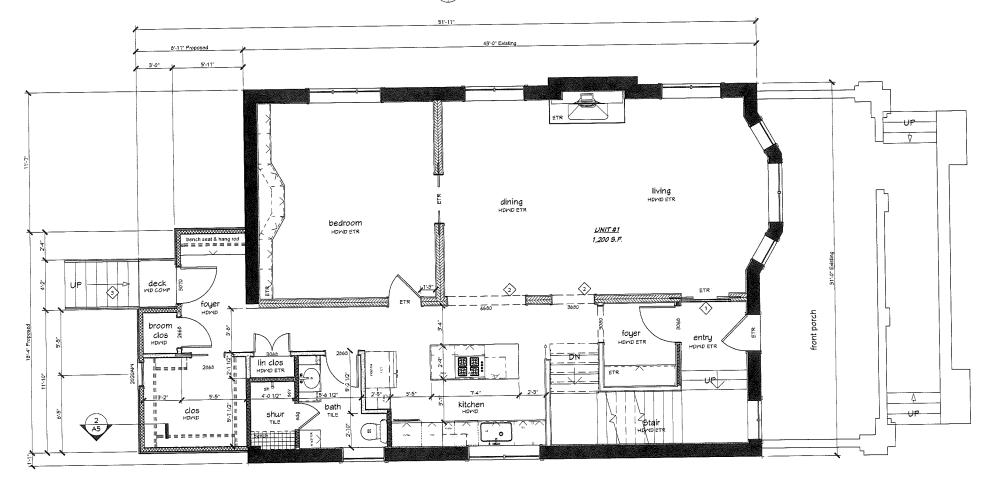



NON TO THE PORT OF THE PORT OF

Studio, Bouril Design

Bredeson lison, MI, Dewey

Remodel for ంర <u>0</u> <u>2</u> <u>2</u> S

project: 18011 date: 4/16/2018 drawn by: BB

- The general contractor is responsible for determining the presence of asbestos-containing material and lead-based
  paint. These materials have the potential to adversely affect human health and the environment. The abatement of these materials is regulated by federal, state, and local laws and regulations. Along with the appropriate industry practices, these laws and regulations must be followed during abatement and all phases of construction activity including demolition and new construction.
- The general contractor and subcontractors shall thoroughly familiarize themselves with the existing building prior to the start of demolition. All work outside of the area of demolition shall be protected from incidental damage. Any damage shall be repaired as new to the owner's satisfaction prior to completion of new construction.
- All distilling structure to remain shall be breads, shored, and reinforced as required during the demolition process. All brighting structure to remain shall be breads, shored, and reinforced as required during the demolition process. All brighting, shoring, and reinforcement shall remain in place during new construction as required or as deemed necessary. by the general contractor.
- The disposition of all equipment, fixtures, doors, windows, narquiste, atc stated for demolition shall be coordinated w the current items that are selected by the currer for salvage shall be carefully removed to avoid incidental damage. The general contractor is responsible for storing items designated for re-use, all other salvaged items shall be turned over
- 5. Extent of demolition of openings must be coordinated with the new construction

Key Notes - Demolition Plan 👍

1 Dashed line indicates the demolition of wall, stairs, post, door, window, slab, etc (tup)

#### General Notes - Second Floor Plan

- See Title Sheets for Abbreviations & Product & Material Specifications.
   All dimensions are to the face of dimensional members (stud, blocking, framing, board, etc.). Dimensions do not reference sheathing, util board or other finish items unless noted otherwise.
- 3. Provide solid wood blocking & bracing for all wall-mounted & ceiling mounted equipment according to the equipment
- 3. Hrowse solid wood blocking & brazing for all usali-mounted & ceiting mounted equipment seconding to the equipment supplier or installer.
  4. Verify rough opening requirements for all framed openings.
  5. Position & lagguot of existently countertops, spollances & fixtures are for general reference only. Installation & roughins shall be per owner approved shop drawings.
  6. Vinless noted otherwise, Linner, Parthy, Storage & Utility Closets to receive five adjustable white low pressure laminates shelves on pre-finished steel or duminium; shelf standards of sufficient strength to support loads. Shelf depth with the contractions of the pressure in the contraction of the contraction of the contraction of the contraction of the contraction. territines strettes on permission seed to administration stem standards of administration of the seed of the standard of administration of the standard of the
- with pre-finished steel, aluminum or wood hanging rod. Shelf to be 1/2 the depth of the closet, mounted at 10" above the finished floor; rod to be mounted at 66" above the finished floor & centered in the closet depth.
- The ministers notify, dut to be marined acroit across the ministers in the close of the close of
- elbows, minimum run, lerminating with a louvered wall cap or dampered & screened roof jack.

  9. Exhaust clothes driger directly to the extensi through a single 4" diameter min 29ga min smooth-bore rigid duct,
  minimum elbows, minimum run, terminating uith a dampered wall cap or screened roof jack. If the vent is routed
  through a framed wall provide a recessed driger vent box or manifold. In all cases the vent must exhaust 3" (min) fro
- any other opening into the building. ). Provide ducted range hood & vent fan with automatic backdraft damper, Energy-Star rated. Exhaust directly to the exterior through a single 4" min, 29ga min, smooth-bore rigid duct, minimum elbows, minimum run, terminating with a screened & dampered wall cap or roof jack.

#### Partition Type Legend

Existing Exterior Mail:

Existing Masonry Load Bearing Mall:

Existing 2x Interior Mall w/ sound batt insulation

New 2x Interior Stud Mall w/ sound batt insulation

#### Finish Info - Second Floor Plan

Trim - Base & Casing: New base and casing is to match existing in material, profile & finish. Reuse existing where

Doors: New doors are to match existing in material, profile & finish. Reuse existing doors where possible.

Mindows: New windows are to match existing in material, profile & finish. Re-finish painted windows as needed to match existing. Re-glaze existing windows as required

Shower Doors & Mirrors: New sliding glass door @ showers & mirrors @ vanities.

<u>Flooring:</u> HDMD ETR - Existing hardwood to remain, patch and refinish as required

Appliances: Provide an allowance for appliances as shown.


HDMD - New hardwood to match existing GPT - New carpet & pad

YNL PLANK - New vinul plank flooring

VIX. I/P DECKING. New vinit justerproof decking
TILE - New lile & underlagment
MD COMP - New composite wood decking
Note - Provide soundproof foor underlayment @ all new flooring locations as required.

=====

Existing/ Demo Second Floor Plan

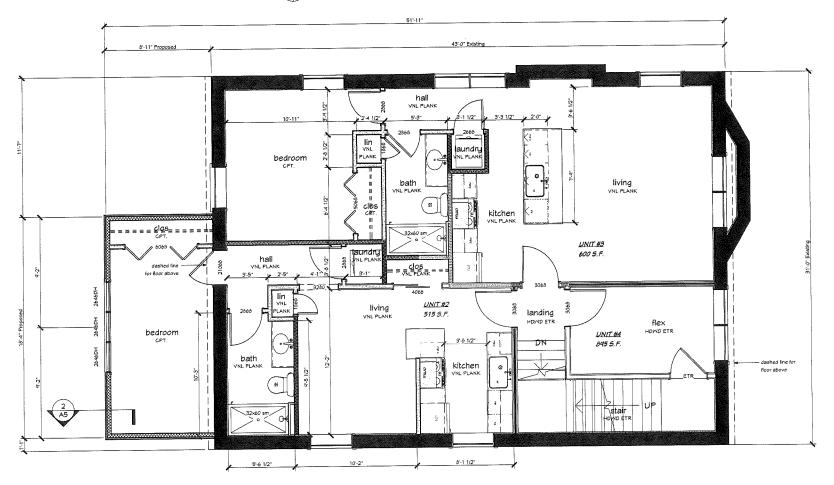



Koning English

Studio,



Bredeson Dewey

Remodel for ంద్ర <u>a</u> <u>2</u> S

revision index # date reference



- 1. The general contractor is responsible for determining the presence of asbestos-containing material and lead-based . In eigeness contractor is responsible for determining the presence or assessis-containing material and lead-based paint. These materials have the potential to adversely affect human health and the environment. The abstraent of these materials is regulated by federal, state, and local laws and regulations. Along with the appropriate industry practices, these laws and regulations must be followed during abatement and all phases of construction activity. including demolition and new construction.
- The general contractor and subcontractors shall thoroughly familiarize themselves with the existing building prior to the start of demolition. All work outside of the area of demolition shall be protected from incidental damage. Any damage shall be repaired as new to the owner's subflection prior to completion or new construction.
   All existing structure to remain shall be braced, shorted, and reinforced as required during the demolition process. All
- bracina, shorina, and reinforcement shall remain in place during new construction as required or as deemed necessary
- the owner, flome that are solected by the owner for salvage shall be carefully removed to avoid incidental damage. The general contractor is responsible for storing items designated for re-use; all other salvaged items shall be turned over
- to the owner.

  5. Extent of demolition of openings must be coordinated with the new construction.

#### Key Notes - Demolition Plan (#)

1. Dashed line indicates the demolition of wall, stairs, post, door, window, slab, etc (typ).

#### General Notes - Third Floor Plan

- See Title Sheets for Abbreviations & Product & Material Specifications.
- All dimensions are to the face of dimensional members (stud, blocking, framing, board, etc.). Dimensions do not reference sheathing, wall board or other finish items unless noted otherwise.
- Provide sold among user board or own maken many and the selfing mounted equipment according to the equipment manufacturer's instructions or as required by the equipment supplier or installer.

  4. Verify rough opening requirements for all framed openings.
- 5. Position & layout of cabinetry, countertops, appliances & fixtures are for general reference only. Installation & rough
- In shall be prounter approved shop drawings.

  6. Unless noted otherwise, Einen, Pentry, Storage & Utility. Closels to receive five adjustable white low pressure laminate shelves on pre-finished steel or aluminum shelf standards of sufficient strength to support loads. Shelf de
- shall allow clearance for changing shelf heights. . All Bedroom Closets, entry Coat Closets & Mudroom Closets to receive one white low pressure laminate fixed shelf with pre-finished steel, aluminum or used hanging rod. Shelf to be 1/2 the depth of the closet, mounted at 10° above the finished floor, rod to be mounted at 66° above the finished floor & certered in the closet depth.

  6. Baltrooms to receive an Energy Star rated venting fan with built-in adjustable delay timer & automatic backdraft
- damper. If installed within a shower enclosure, select a unit that is UL listed for this use & wire to a GFCI protected circuit. Exhaust directly to the exterior through a single 4" diameter min 28ga min smooth-bore rigid duct, minimum
- dibous, minimum run, terminating with a louvered wall cap or dampered & screened roof lack.

  9. Exhaust clothes dryer directly to the exterior through a single 4" diameter min 28ga min smooth bore rigid duct, minimum elbous, minimum run, terminating with a dampered wall cap or screened roof lack. If the vent is routed through a femed wall provide a recessed driger vent box or manifold. In all cases the vent must exhaust 3" (min) from
- any other opening into the building.

  Provide ducted range hood & vent fan uith automatic backdraft damper, Energy-Star rated. Exhaust directly to the exterior through a single 4" mil. Saga min, smooth-bore rigid duct, minimum etbows, minimum run, terminating uith screened & dampered wall cap or roof jack.

#### Partition Type Legend

Existing Exterior Mall:

Existing 2x Interior Mail:

Existing 2x Interior Mali w/ sound batt insulation

New 2x4 Exterior Stud Mall w/ foam-in-place insulation

New 2x Interior Stud Mall w/ sound batt insulation:

\*Note - Provide plaster finish to match existing.

#### Finish Info - Third Floor Plan

Trim - Base & Casing: New base and casing is to match existing in material, profile & finish. Reuse existing where

Doors: New doors are to match existing in material, profile & finish. Reuse existing doors where possible

Mindows: New windows are to match existing in material, profile & finish. Re-glaze existing windows as required

(#)


Shower Doors & Mirrors: New sliding glass door @ showers & mirrors @ vanities.

HDWD ETR - Existing hardwood to remain, patch and refinish as required


HD/ND ETR - Existing hardwood to remain, patch and refinish as required HD/ND - New hardwood to match existing CPT - New carpet & pad VNL PLANK - New Vinly plank floorling VNL PLANK - New Vinly plank floorling TNL - New Bits & underflayment WN COMP - New composite wood decking NO COMP - New composite wood decking 'Note - Provide soundproof floor underlayment @ all new floorling locations as required.

Key Notes - Third Floor Plan

1 New guardrail system

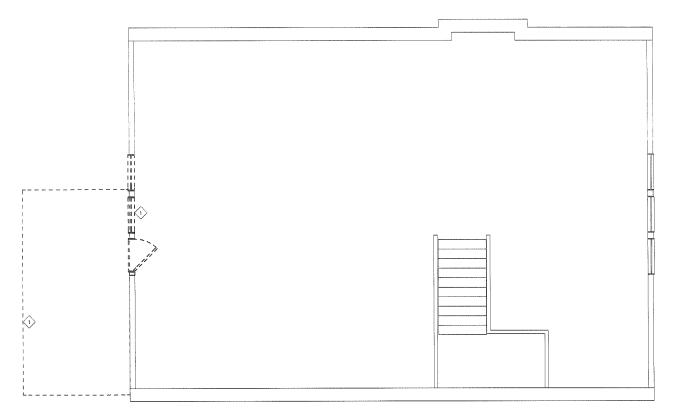

Existing/ Demo Third Floor Plan SCALE: 1/8" = 1'-0"

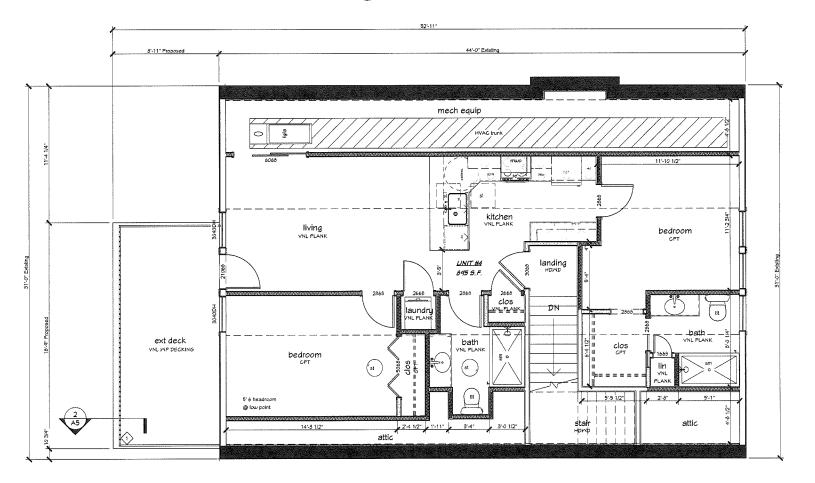



S Zoning

Studio,



Bredeson , WI, 53703

Dewey රේ 

S



#### General Notes - Roof Plan

- 1. All dimensions are to the face of dimensional members (stud, blocking, framing, board, etc). Dimensions ao not reference sheathing, until board, or other finish items unless noted otherwise.


  2. Verify rough opening requirements for all framed openings (skylights, solar tubes, chimneys, etc).

  3. Install unaterproof membrane as follows: at all vertical penetrations through the roof, including chimneys, verts & stacks; along the entire length of eaves to 12" inside the projected extenor until line; in 35" ude strips along the entire length of values, intersecting uslats, changes in note pitch & other varical surfaces; over the entire surface of any roof, crickets, or over-build with a slope 4:12 or less. All areas not covered by unterproof membrane will be covered with
- crickets, or over-bulld with a slope 4.12 or less. All areas not covered by waterproof membrane will be covered with 15th roofing feit applied horizontally from eave to ridge.

  4. Gutters, downspouts, and leaders shall be roll-formed from 0.032" aluminum coil stock in a color to match the eave feacie. Gutter lengths shall be seamless; K Style profile & shall provide 20sq in (min) of net cross-sectional area and shall have a depth to udith radio of not less than 125 (eg at "deepx 5" high U-shaped gutter satisfies this requirement). All gutters shall receive a fully covered leaf quard system. Downspouts & leaders shall be at 4"x3" rectangular profile. Downspouts which discharge to a leader at grade shall be provided with a decorative aggregate concrete spleah block at the leader termination. Downspouts which discharge to a drain receptor shall terminate into a 4x3x4 PVC offset downspout tile adoption mated to a burled 4" 5DR55 drain pipe receiver. Burled drain pipe shall object at 14.12 and drain to daylight; all pipe fittings shall be permanently weblad or use gassices; all bends shall be 45 degrees or less.

#### Key Notes - Roof Plan 👍

- New Velux F5-D26 Skylight
   New Yelux Pitched TMR 14" Dia. sun lunnel
   Duradek vinyl rooff deck membrane

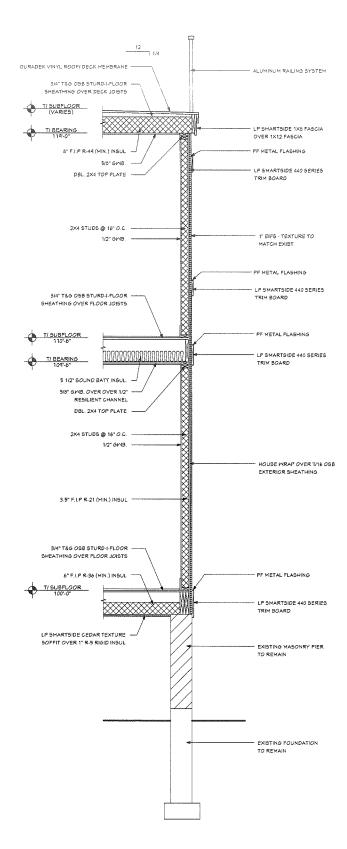




Bouril Design Studio, 1 e45 otans Road, Suite #2 (85) 833749 (85) 833340 vww.bunidesign.com

Dewey Bredeson ton Street, Madison, MI, 53703

revision index # date reference

project: 18011 date: 4/16/2018 drawn by: BB

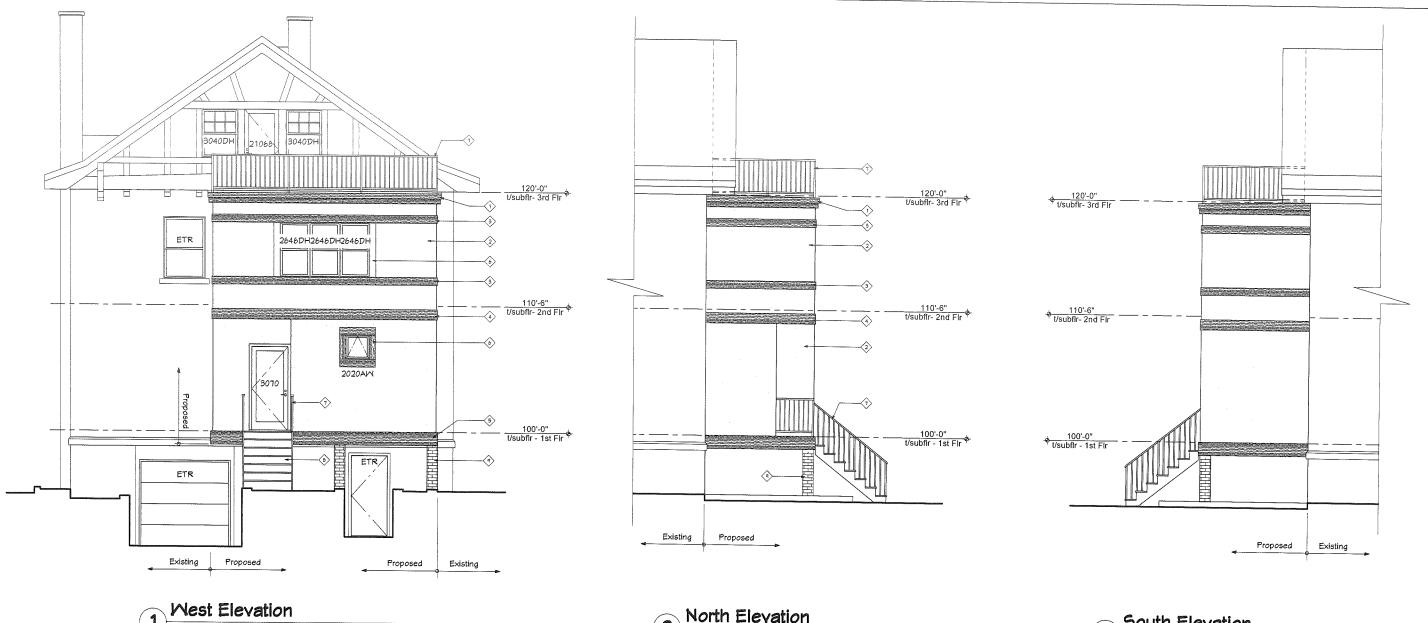

1 SCALE: 1/8" = 1'-0"

North Elevation SCALE: 1/8" = 1'-0"

South Elevation SCALE: 1/8" = 1'-0"

#### General Notes - Exterior Elevations

- 1. See Title Sheet for Abbreviations.
  2. See Typical Exterior Mell Sections for additional material information, sizes & dimensions.
  3. Provide physical samples of all exterior materials, colors & finishes for curver approval prior to installation.
  4. Typical exterior materials are noted on Front Elevation only. Only unique materials are noted on other Exterior Elevations.

### Key Notes - Exterior Elevations (#)

1. LP Smartside 1x6 fisacia over 1x12 fascia
2. EIFS - texture to match axissing
3. LP Smartside 440 series trim (1 1/4")
4. LP Smartside 440 series trim (1 1/4")
5. LP Smartside 440 series trim (13 1/2")
6. LP Smartside 440 series trim (15 1/2")
7. Aluminum railing system
8. Nood composite deckl stair system
9. Existing masonry pier to remain


Remodel for Sandy & Dewey Bredeson # date reference

116 East Dayton Street, Madison, MI, 53703

Zoning Submittal

Bouril Design Studio, L. eezs can act sure 2. Medico, NI S7719 18719 (1909 835 3400 new bounidesign.com



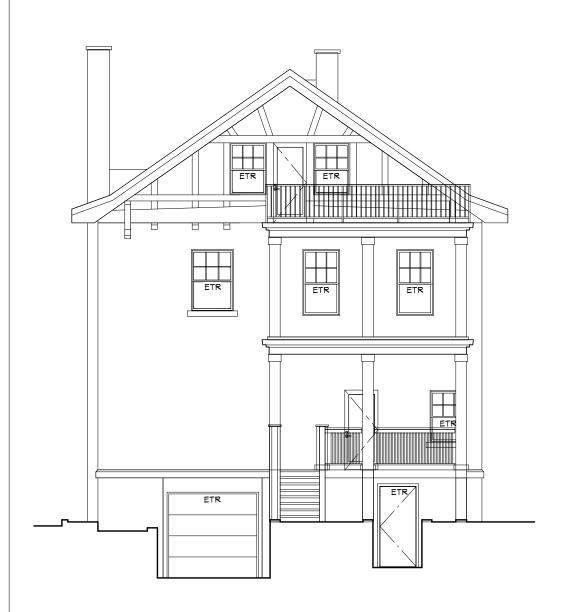



2 Existing East Elevation A





