### **URBAN DESIGN COMMISSION APPLICATION**

UDC

City of Madison **Planning Division** 126 S. Hamilton St. P.O. Box 2985 Madison, WI 53701-2985 (608) 266-4635



Complete all sections of this application, including the desired meeting date and the action requested.

If you need an interpreter, translator, materials in alternate formats or other accommodations to access these forms, please call the phone number above immediately.

FOR OFFICE USE ONLY:

Paid	Receipt #
Date received	
Received by	
Aldermanic District	
Zoning District	
Urban Design District	
Submittal reviewed by	

#### 1. Project Information

Addre	Address: 2507 WINNEBAGO STREET, MADISON, WI. DCI PARCEL# 071006134284				
Title:		UNION CORNERS	- GRANDFAMILY APARTMENTS		
		<b>e</b> (check all that te requested	at apply) and Requested Da JANUARY 24, 2018	te	
<b>X</b> 1	New develo	pment C	Alteration to an existing of Initial approval	or previously-approved development Final approval	
3. Proje	ect Type				
	Project in ar	n Urban Design D	istrict	Signage	
			e District (DC), Urban ⁄lixed-Use Center District (MXC)	<ul> <li>Comprehensive Design Review (CDR)</li> <li>Signage Variance (i.e. modification of signage height,</li> </ul>	
(		roject in the Suburban Employment Center District (SEC), ampus Institutional District (CI), or Employment Campus		area, and setback) Other	
<ul> <li>Planned Development (PD)</li> <li>General Development Plan (GDP)</li> <li>Specific Implementation Plan (SIP)</li> </ul>		n Plan (SIP)	Please specify		
			sidential Building Complex		
4. Appli	icant, Ager		y Owner Information		
Appli	icant name		RSHALL	_ CompanyGORMAN AND COMPANY	
Stree	t address	200 N. N	IAIN STREET	_City/State/ZipOREGON, WI. 53575	
Telep	hone	608) 835	-3900	_Emailbmarshall@gormanusa.com	
Project contact personMARK M. SMITH		M. SMITH	Company GORMAN AND COMPANY		
•	t address	200 N. MAI	N STREET		
Telep		608) 835	5-3900	Emailmarksmith@gormanusa.com	
Prope	erty owner	(if not applicar	t)UC Grandfamily, LLC		
	t address	200 N. MA		City/State/Zip OREGON, WI. 53575	
Telep		608) 835-	3900	_Email	

#### 5. Required Submittal Materials

#### **Application Form**

#### Letter of Intent

- If the project is within an Urban Design District, a summary of how the development proposal addresses the district criteria is required
- For signage applications, a summary of how the proposed signage is consistent with the applicable CDR or Signage Variance review criteria is required.

Development plans (Refer to checklist provided below for plan details)

#### **Filing fee**

#### Electronic Submittal\*

Both the paper copies and electronic copies <u>must</u> be submitted prior to the application deadline before an application will be scheduled for a UDC meeting. Late materials will not be accepted. A completed application form is required for each UDC appearance.

For projects also requiring Plan Commission approval, applicants must also have submitted an accepted application for Plan Commission consideration prior to obtaining any formal action (initial or final approval) from the UDC. All plans must be legible when reduced.

\*Electronic copies of all items submitted in hard copy are required. Individual PDF files of each item submitted should be compiled on a CD or flash drive, or submitted via email to <u>udcapplications@cityofmadison.com</u>. The email must include the project address, project name, and applicant name. Electronic submittals via file hosting services (such as Dropbox.com) are not allowed. Applicants who are unable to provide the materials electronically should contact the Planning Division at (608) 266-4635 for assistance.

#### 6. Applicant Declarations

- 2. The applicant attests that all required materials are included in this submittal and understands that if any required information is not provided by the application deadline, the application will not be placed on an Urban Design Commission agenda for consideration.

Applicant name	BEN MARSHALL	12		Relationship to property	OWNERS AGENT
Authorized signati	ure of OWNERS AGENT	Da	$W/N^{\circ}$	7	Date
			l		
	-				

#### 7. Application Filing Fees

Fees are required to be paid with the first application for either initial or final approval of a project, unless the project is part of the combined application process involving the Urban Design Commission in conjunction with Plan Commission and/or Common Council consideration. Make checks payable to City Treasurer. Credit cards may be used for application fees of less than \$1,000.

Please consult the schedule below for the appropriate fee for your request:

- Urban Design Districts: \$350 (per §35.24(6) MGO).
- Minor Alteration in the Downtown Core District (DC) or Urban Mixed-Use District (UMX) : \$150 (per \$33.24(6)(b) MGO)
- □ Comprehensive Design Review: \$500 (per §31.041(3)(d)(1)(a) MGO)
- Minor Alteration to a Comprehensive Sign Plan: \$100 (per §31.041(3)(d)(1)(c) MGO)
- □ All other sign requests to the Urban Design Commission, including, but not limited to: appeals from the decisions of the Zoning Administrator, requests for signage variances (i.e. modifications of signage height, area, and setback), and additional sign code approvals: \$300 (per §31.041(3)(d)(2) MGO)

A filing fee is not required for the following project applications if part of the combined application process involving both Urban Design Commission and Plan Commission:

- Project in the Downtown Core District (DC), Urban Mixed-Use District (UMX), or Mixed-Use Center District (MXC)
- Project in the Suburban Employment Center District (SEC), Campus Institutional District (CI), or Employment Campus District (EC)
- Planned Development (PD): General Development
   Plan (GDP) and/or Specific Implementation Plan (SIP)
- Planned Multi-Use Site or Residential Building Complex

Each submittal must include fourteen (14) 11" x 17" collated paper copies. Landscape and Lighting plans (if required) must be full-sized. Please refrain from using plastic covers or spiral binding. The City of Madison's Urban Design Commission (UDC) has been created to:

- Encourage and promote high quality in the design of new buildings, developments, remodeling, and additions so as to maintain and improve the established standards of property values within the City.
- Foster civic pride in the beauty and nobler assets of the City, and in all other ways possible assure a functionally efficient and visually attractive City in the future.

#### **Types of Approvals**

There are three types of requests considered by the UDC:

- <u>Informational Presentation</u>. Applicants may, at their discretion, request to make an Informational Presentation to the UDC prior to seeking any approvals to obtain early feedback and direction before undertaking detailed design. Applicants should provide details on the context of the site, design concept, site and building plans, and other relevant information to help the UDC understand the proposal and provide feedback. (Does not apply to CDR's or Signage Variance requests)
- <u>Initial Approval</u>. Applicants may, at their discretion, request initial approval of a proposal by presenting preliminary design information. As part of their review, the Commission will provide feedback on the design information what should be addressed at Final Approval stage.
- <u>Final Approval</u>. Applicants may request Final Approval of a proposal by presenting all final project details. Recommendations or concerns expressed by the UDC in the initial approval must be addressed at this time.

#### **Presentations to the Commission**

Primarily, the UDC is interested in the appearance and design quality of projects. Emphasis should be given to the site plan, landscape plan, lighting plan, building elevations, exterior building materials, color scheme, and graphics.

When presenting projects to the UDC, applicants must fill out a registration slip provided in the meeting room and present it to the Secretary. Presentations should generally be limited to 5 minutes or as extended by motion by consent of the Commission. The Commission will withhold questions until the end of the presentation.

Applicants are encouraged to consider the use of various graphic presentation material including a locator map, photographs, renderings/model, scale drawings of the proposal in context with adjacent buildings/uses/signs, etc., as may be deemed appropriate to describe the project and its surroundings. Graphics should be mounted on rigid boards so that they may be easily displayed. Applicants/presenters are responsible for all presentation materials, AV equipment and easels.

#### **URBAN DESIGN DEVELOPMENT PLANS CHECKLIST**

The items listed below are minimal application requirements for the type of approval indicated. Please note that the UDC and/ or staff may require additional information in order to have a complete understanding of the project.

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#### 1. Informational Presentation

	· · · · · · · · · · · · · · · · · · ·	<b>`</b>		nequileme	its for All Fian Sheets
	Locator Map			1. Title k	olock
	Letter of Intent (If the project is within a			2. Sheet	number
	Urban Design District, a summary of <u>how</u> the development proposal addresses the		Providing additional	3. North	arrow
	district criteria is required)		information beyond these	4. Scale,	, both written and graphic
	Contextual site information, including	> r	minimums may generate	5. Date	
	photographs and layout of adjacent buildings/structures		a greater level of feedback from the Commission.		dimensioned plans, scaled = 40' or larger
	Site Plan			•	s must be legible, including
	Two-dimensional (2D) images of proposed buildings or structures.	J		the full-size plans (if req	ed landscape and lighting uired)
2. Initial Ap	oproval				
N	Locator Map			٦	
¥	Letter of Intent (If the project is within a L how the development proposal addresses				
7	Contextual site information, including pho buildings/structures	otog	graphs and layout of adjace	nt	Providing additional information beyond these
*	Site Plan showing location of existing and lanes, bike parking, and existing trees ove			ves, bike	minimums may generate a greater level of feedback
X	Landscape Plan and Plant List (must be leg	gible	e)		from the Commission.
×	Building Elevations in both black & white a material callouts)	and :	l color for all building sides	(include	
¥	PD text and Letter of Intent (if applicable)	:)		J	
3. Final Ap	proval				
All the re	equirements of the Initial Approval (see abo	oove)	), <u>plus</u> :		
	Grading Plan				
	Proposed Signage (if applicable) NOT APP				
5	Lighting Plan, including fixture cut sheets		•	- ·	
	Utility/HVAC equipment location and scre		ing details (with a rooftop p	lan if roof-m	ounted) NOT APPLICABLE HVAC IN UNITS
_	PD text and Letter of Intent (if applicable)				(INTERIOR)
	Samples of the exterior building materials	ls (pr	resented at the UDC meetir	ng)	
4. Comprel	hensive Design Review (CDR) and Varian	nce l	Requests ( <u>Signage applica</u>	ations only)	
	Locator Map				
	Letter of Intent (a summary of <u>how</u> the pr is required)	oropo	osed signage is consistent w	vith the CDR	or Signage Variance criteria

- Contextual site information, including photographs of existing signage both on site and within proximity to the project site
- Site Plan showing the location of existing signage and proposed signage, dimensioned signage setbacks, sidewalks, driveways, and right-of-ways
- Proposed signage graphics (fully dimensioned, scaled drawings, including materials and colors, and night view)
- Perspective renderings (emphasis on pedestrian/automobile scale viewsheds)
- Graphic of the proposed signage as it relates to what the Ch. 31, MGO would permit



December 6th, 2014

Mr. Tim Parks Urban Design Commission 215 Martin Luther King Jr. Blvd P.O. Box 2985 Madison, Wi 53701

Re: Letter of Intent PD-SIP Re Zoning 2507 Winnebago Street Madison, Wi 53704

Dear Mr. Parks:

The following is submitted together with the plans, and application for staff approval.

#### **Project Organizational Structure:**

Owner: Gorman & Company, Inc. 200 N. Main Street Oregon, WI 53575 414-617-9997 Contact: Edward Matkom tmatkom@gormanusa.com

Civil: JSD Professional Services, Inc. Engineer 161 Horizon Dr, Suite 101 Madison, WI 53593 608-848-5060 Contact: Hans Justeson hans.justeson@jsdinc.com

P: (608) 835-3900 F: (608) 835-3922 www.GormanUSA.com

#### **REAL ESTATE DEVELOPMENT**

MILWAUKEE MIAMI PHOENIX CHICAGO DENVER

Architect: Gorman & Company, Inc. 200 N. Main Street Oregon, WI 53575 608-835-3900 Contact: Mark M. Smith marksmith@gormanusa.com

Landscape: JSD Professional Services, Inc. Design 7402 Stone Ridge Dr, Suite 4 Weston, WI 54476 715-298-6330 Contact: Justin Frahm justin.frahm@jsdinc.com

#### Introduction:

The site property is located on the east side of Madison, on Winnebago Street just off of East Washington Boulevard. The property is within the Union corners General Plan Development. The site is currently vacant.

#### Zoning:

The site is currently within the Union Corners General Plan Development.

#### **Project Description:**

The Project consists of two three story buildings with basement parking. The ground floor contains building common areas/ amenity spaces rental apartments, and lobbies. The upper two floors are rental apartments. The project includes improvements to Winnebago street outside of the property line of this phase, including new sidewalks, and angled street parking. Additionally, the project constructs a new serpentine pedestrian pathway and stormwater management swales.

#### Project Development Data:

Site Density:	
Lot area:	138,085 s.f. (3.05 acres)
<b>Dwelling Units:</b>	60 Units
Lot Area / D.U.	2301 s.f / d.u.
Density	19.68 d.u. / acre

#### Site Coverage:

<b>Building Footprints:</b>	28,676 s.f. ( 24 %)
Sidewalks / Terrace:	17,486 s.f. ( 13 %)
Pavement:	11,530 s.f. ( 9%)
Pervious Surface:	75,166 s.f. (54%)

#### **Building Ratio:**

Social Services:	2,859 s.f. (2.6 %)
Apartments & Amenities	68,320 s.f. (64.0 %)
Underground Parking:	22,983 s.f. (21.65%)
Misc (corridor, mech, stairs):	<u>12,546 s.f. (11.75 %)</u>
	106,708 s.f. Total Building Area

Dwelling Unit Mix		Bike Parking:	
Two Bedroom	37	Enclosed:	62
Three Bedroom	23	Surface <u>:</u>	30
	60 Total		92 Total
Vehicular Parking:			
Enclosed	75		

Enclosed	75
Surface	43 ( <u>33 In City R.O.W.)</u>
	118 Total

#### Schedule:

The development schedule calls for construction to start September of 2018, with a scheduled completion in November 2019.

#### Social & Economic Impacts:

This development will have a positive social and economic impact on the surrounding community. The redevelopment of this property will provide high quality affordable housing and social support services.

Thank you for your time in reviewing our proposal.

Sincerely,

Edward B. Matter

Edward Matkom President – Wisconsin Market Gorman & Company, Inc.

#### **Zoning Text**

Rezoning PD-GDP to PD-SIP Union Corners – Bldg. 6 & 7 2507 Winnebago Road Parcel #071006134284 Lot 1 of Union Corners December 6, 2017

Legal Description: Parcel #071006134284 or Lot 1 of Union Corners

- A. **Statement of Purpose:** Re-zoning of Lot 1 from PD-GDP PD-SIP to allow for the construction of two three story buildings with a total of 60 dwelling units. Buildings will consist of community, social service space and dwelling units on the ground floor, with dwelling units on the upper two floors. Tenant parking will be provided on site and in underground parking beneath the buildings.
- B. Permitted Uses: Uses as shown on Exhibit A, attached hereto
- C. Lot Area: Lot 1 138,085 s.f. (3.05 acres)
- D. Floor Area Ratio: 0.61
- E. Yard Requirements: As shown on the attached plans
- F. Landscaping: Site landscaping provided as shown on the attached landscape plan.
- G. Accessory Off-Site Parking: Off-street and surface parking shall be provided as shown the attached plans.
- H. **Lighting:** Site lighting will be provided along pedestrian path, plaza, and building façade and meeting MGO requirements. Exhibit to follow.
- **I. Signage:** Tenant, and apartment signage will be located on building façade, and meet MGO requirements. See attached plans. Signage approval will made in a separate submittal.
- J. Alterations and Revisions: No alteration or revision of the planned unit development shall be permitted unless approved by the City Plan Commission, however, the Zoning Administration may issue permits for minor alterations or additions which are approved by the Director of Planning and Development and the alderperson of the district and are compatible with the concept approved by the City Plan Commission.

#### **Exhibit A - Permitted Uses**

#### **Residential – Family Living**

- Live/work unit
- Multi-family dwelling (>8 dwelling units)

#### **Residential - Group Living**

- Adult family home
- Cohousing community
- Community living arrangement (> 15 residents)
- Housing cooperative

#### **Civic and Institutional Uses**

- Counseling, community services organization
- Community center
- Day care center
- Library, museum
- Recreational, community, and neighborhood centers

#### Agriculture and Resource Uses

- Community garden
- Market garden

#### **Accessory Uses and Structures**

- Management office and recreation facilities within multi-family building
- Non-accessory temporary outdoor events
- On-site agricultural retail, farm stand
- Outdoor display
- Outdoor eating area
- Outdoor sales event
- Temporary outdoor events

#### **Offices**

- Insurance office, real estate office, sales office
- General office
- Professional office

#### **Medical Facilities**

• Physical, occupational or message therapy

#### **Retail Sales and Services**

- Artisan workshop
- Business sales and services
- Farmers' market
- Food and related goods sales
- Furniture and household goods sales
- Health/sports club
- Home occupation
- Indoor recreation
- Printing and publishing
- Post office
- Real estate sales office
- Secondhand goods sales
- Service business
- Telecommunications center


#### Food and Beverage

- Catering
- Coffee shop, tea house

### **GRAND FAMILY HOUSING**

Union Corners Grand family project is a new construction development consisting of a mix of affordable and market-rate units for families. Specifically, this development will be targeting grand families (grandparents raising grandchildren) and kinship families (family members raising other family members' children). The project will include 59 units total between two buildings, both three stories in height. The buildings will have access to underground parking with apartments and community space above. The project will also include the following interior amenities: community room, supportive service office, business center, and fitness center. In addition, additional community space is anticipated to serve a mix of residents ranging from children to seniors. Outdoor space will include a playground and community gardens. The project is the third piece of a master development on this site by Gorman & Company, Inc. who acquired a 5 acre parcel from the City of Madison in exchange for implementing the master development. Previous phases include the UW Health Clinic and a 90-unit, multi-family, mixed-income development.

The Grand family project includes a partnership with Lutheran Social Services (LSS) to provide supportive services. Space on the first floor has been designed to accommodate these services on-site.

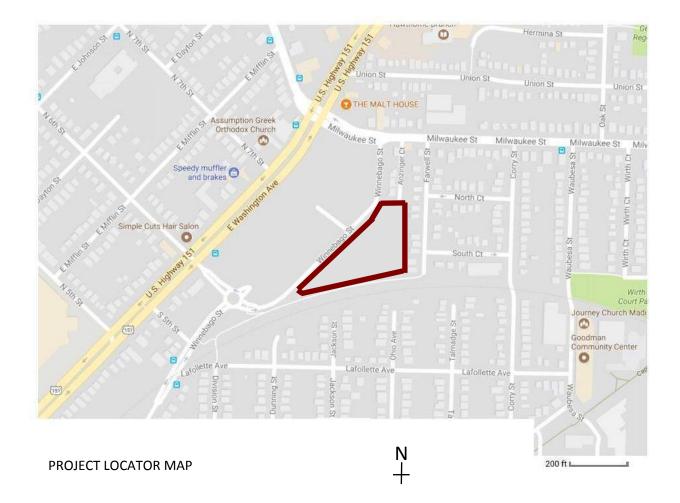


SCALE:	GRAND FAMILY HOUSING	NAMAN
Sheet Name		& COMPANY, INC.
	UNION CORNERS - MADISON WI.	REAL ESTATE DEVELOPMENT AND MANGEMENT 200 N. MAIN STREET
JULY 19, 2017	A Gorman & Company Neighborhood	OREGON, WI 53575



COMMUNITY GARDEN LOCATION - NORTH EAST CORNER OF SITE



BIKE PATH LOOKING WEST - MIDDLE OF SITE

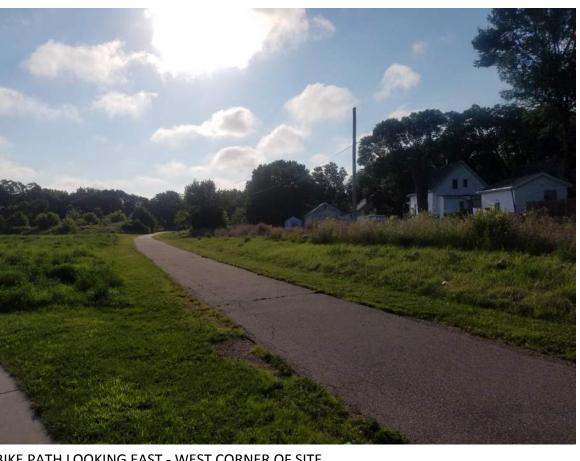


BIKE PATH LOOKING EAST - WEST CORNER OF SITE



BIKE PATH LOOKING WEST - EAST CORNER OF SITE

SITE CONTEXT

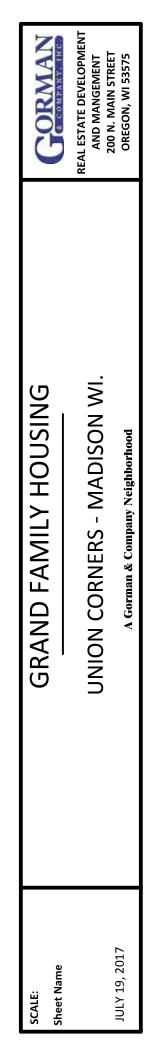



SIMPLE TWO STORY MASONRY BUILDING CORNER OF WINNEBAGO AND MILWAUKEE



NEWLY BUILT APARTMENTS ACROSS WINNEBAGO FROM SITE LOOKING EAST




METAL QUONSET HUT TYPICAL EAST SIDE ECLECTIC AESTHETIC



NEWLY BUILT APARTMENTS ACROSS WINNEBAGO FROM SITE LOOKING WEST

### ADJACENT BUILDING CONTEXT

SCALE: Sheet Name	GRAND FAMILY HOUSING	GORMAN CORMAN
	UNION CORNERS - MADISON WI.	REAL ESTATE DEVELOPMENT AND MANGEMENT 200 N. MAIN STREET
JULY 19, 2017	A Gorman & Company Neighborhood	OREGON, WI 53575

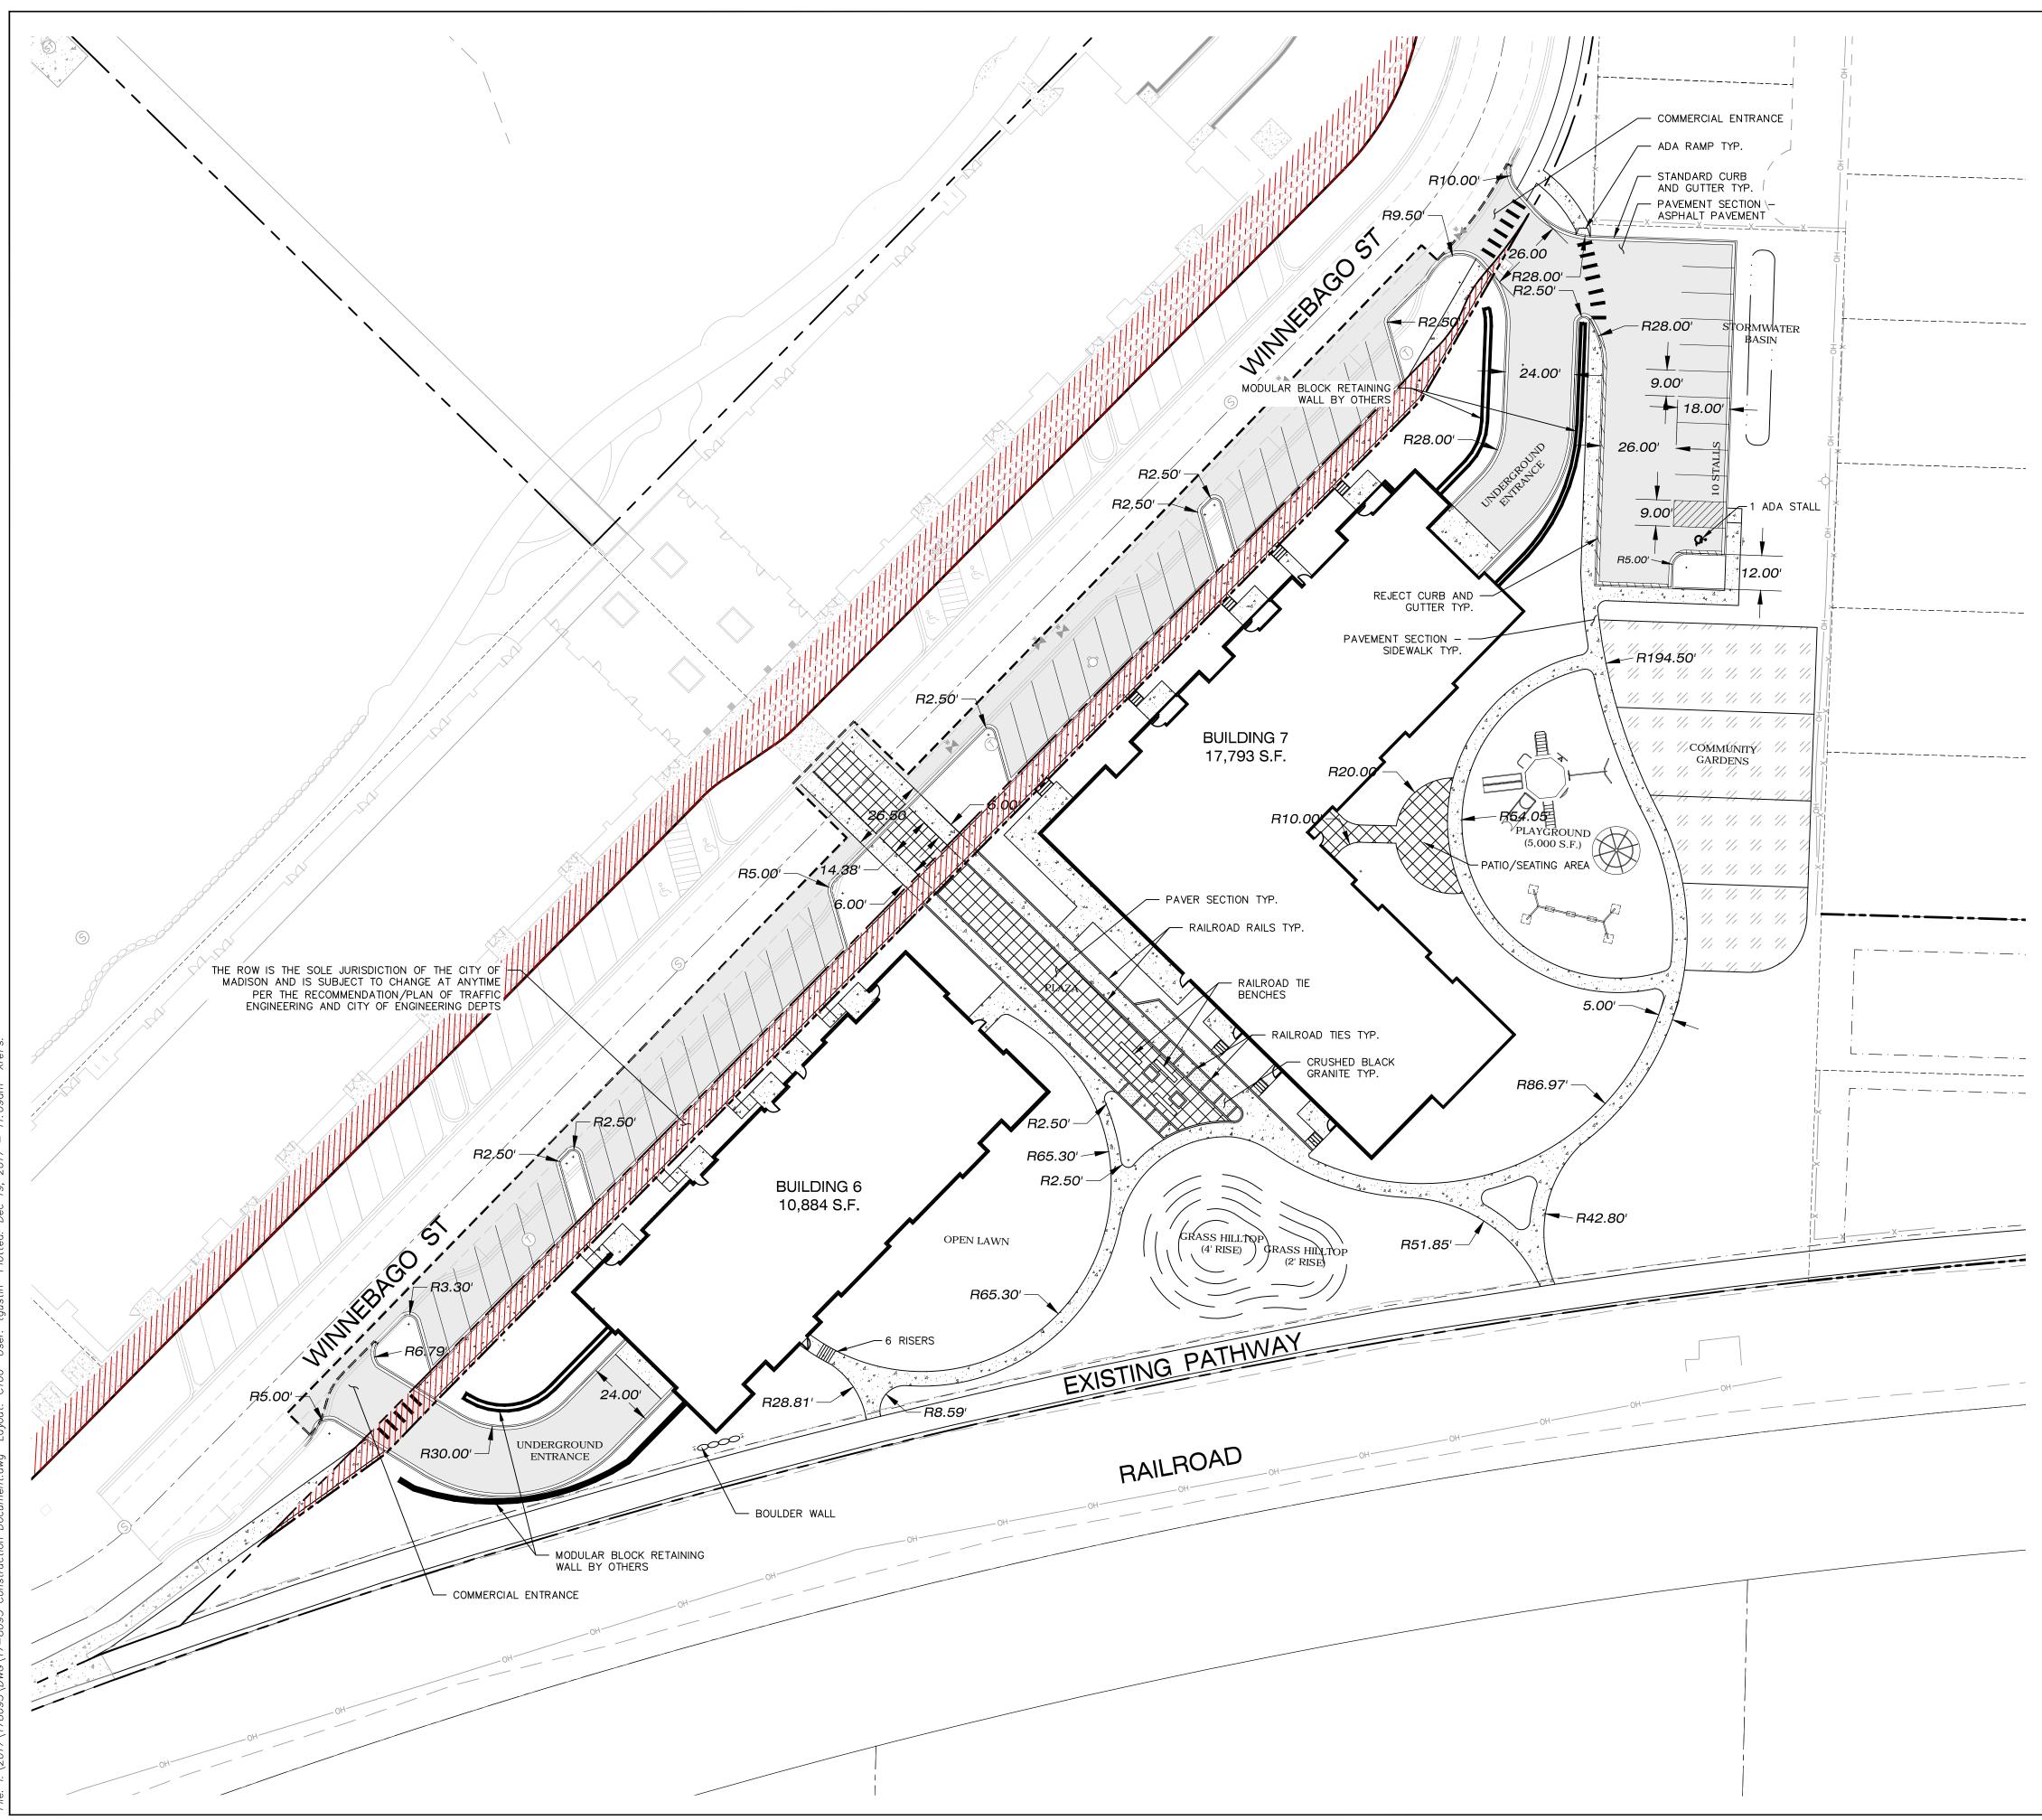

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#### LEGEND (SITE PLAN)

	PROPERTY LINE
	RIGHT-OF-WAY
· · ·	EASEMENT LINE
	BUILDING SETBACK LINE
	PAVEMENT SETBACK LINE
	BUILDING OUTLINE
	EDGE OF PAVEMENT
	STANDARD CURB AND GUTTER
	REJECT CURB AND GUTTER
	MOUNTABLE CURB
	ASPHALT PAVEMENT
	HEAVY DUTY ASPHALT PAVEMENT
<u>ک</u> ۲	CONCRETE PAVEMENT
$\begin{array}{c} * & * & * & * & * & * & * & * & * & * $	HEAVY DUTY CONCRETE PAVEMENT
	SAWCUT EXISTING PAVEMENT
· · · ·	STORMWATER MANAGEMENT AREA
	BOULDER RETAINING WALL
	MODULAR BLOCK RETAINING WALL
⊶⊡	LIGHT POLE (REFER TO PHOTOMETRIC PLAN)
	ADA PARKING BOLLARDS/SIGNS


#### GENERAL NOTES:

- 1. REFER TO THE EXISTING CONDITIONS SURVEY FOR EXISTING CONDITIONS NOTES AND LEGENDS.
- ALL WORK IN THE ROW AND/OR PUBLIC EASEMENTS SHALL BE IN ACCORDANCE WITH THE STANDARD SPECIFICATIONS FOR SEWER & WATER CONSTRUCTION IN WISCONSIN AND THE MUNICIPAL REQUIREMENTS.
- 3. EXISTING GRADE SPOT ELEVATIONS SHOWN FOR INFORMATIONAL PURPOSES. DURING CONSTRUCTION MATCH EXISTING GRADES AT CONSTRUCTION LIMITS.
- 4. NO SITE GRADING OUTSIDE OR DOWNSLOPE OF PROPOSED SILT FENCE LOCATION. NO LAND DISTURBANCE BEYOND PROPERTY LINES.
- 5. JSD SHALL BE HELD HARMLESS AND DOES NOT WARRANT ANY DEVIATIONS BY THE OWNER/CONTRACTOR FROM THE APPROVED CONSTRUCTION PLANS THAT MAY RESULT IN DISCIPLINARY ACTIONS BY ANY OR ALL REGULATORY AGENCIES.

#### SITE PLAN NOTES


- 1. ALL DIMENSIONS TO FACE OF CURB AND/OR EDGING OF CONCRETE UNLESS OTHERWISE NOTED.
- 2. ALL RADII TO FACE OF CURB AND/OR EDGING OF CONCRETE UNLESS OTHERWISE NOTED.
- 3. ANY REQUIRED REPLACEMENT OF PUBLIC CURB AND GUTTER SHALL MATCH EXISTING AND MEET THE REQUIREMENTS OF THE CITY OF MADISON.
- 4. CONTRACTOR SHALL PROVIDE CONTROL JOINTS AND CONSTRUCTION JOINTS OF ONE-QUARTER CONCRETE THICKNESS AT AN EQUAL RATIO OF LENGTH TO WIDTH WHEREVER POSSIBLE WITH A MAXIMUM LENGTH BETWEEN JOINTS OF 8' ON CENTER
- 5. CONTRACTOR SHALL PROVIDE EXPANSION JOINTS IN SIDEWALKS AT A MAXIMUM 24' ON CENTER
- 6. EXTERIOR CONCRETE SURFACES SHALL BE BROOM FINISHED.
- 7. ALL CONCRETE SURFACES TO BE SEALED WITH TYPE TK-26UV CONCRETE SEALANT.
- 8. MARK AND STRIPE ADA PARKING SPACES APPROPRIATELY.
- 9. 2' × 4' TRUNCATED DOME WARNING DETECTION FIELD SHALL BE PLACED AT ALL ADA RAMPS.
- 10. ALL PAVEMENT MARKINGS INCLUDING: STOP BARS, CROSSWALKS, DIRECTIONAL ARROWS, PARKING STALL LINES, ADA STALL MARKINGS, NO PARKING ZONES, DROP-OFF/PICK-UP ZONES SHALL BE PAINTED WITH HIGH VISIBILITY YELLOW LATEX PAINT PER SPECIFICATIONS.

SITE INFORMATION BLOCK	
Site Address	WINNEBAGO ST
Existing Site Acreage (total)	3.17
Proposed Site Acreage (total)	3.05
Number of Building Stories	4
(above grade)	
Total Building Square Footage	28,676 SF
Use of property	MULTI-FAMILY
Number of parking stalls:	
Surface	
Large Stall	9
Accessible	1
Total Surface	10
Existing vs. Proposed Site Coverage:	
Existing Impervious Surface Area	5,428 S.F.
Existing Pervious Surface Area	132,657 S.F.
Proposed Impervious Surface Area	57,964 S.F.
Proposed Pervious Surface Area	74,894 S.F.
Proposed Impervious Surface Area Ratio *calculated with proposed site acreage 3.05	.44

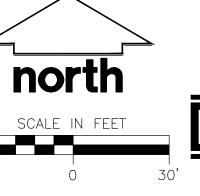

30'




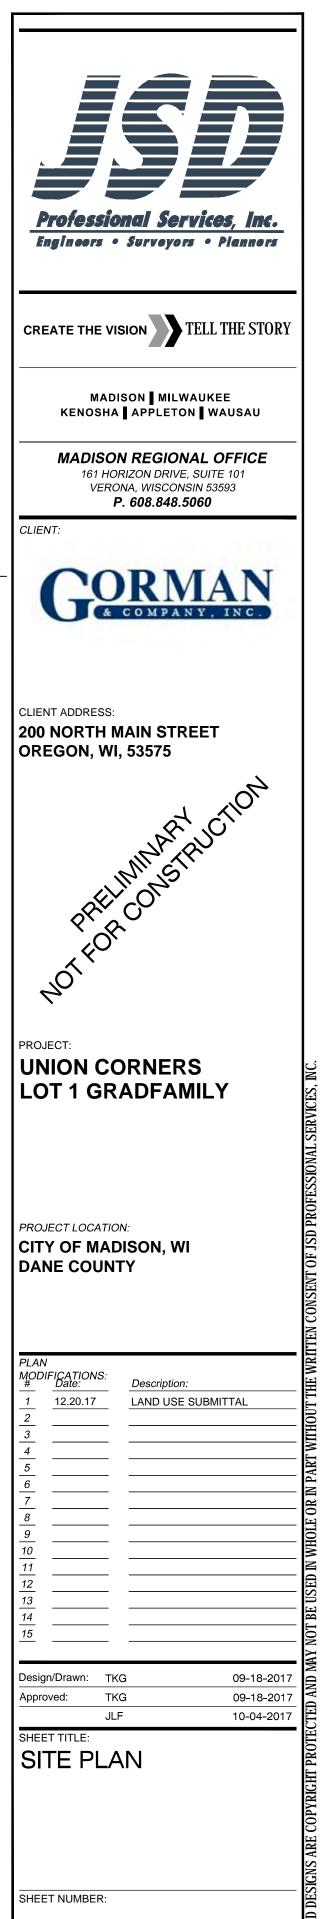

C100

17-8095

JSD PROJECT NO:

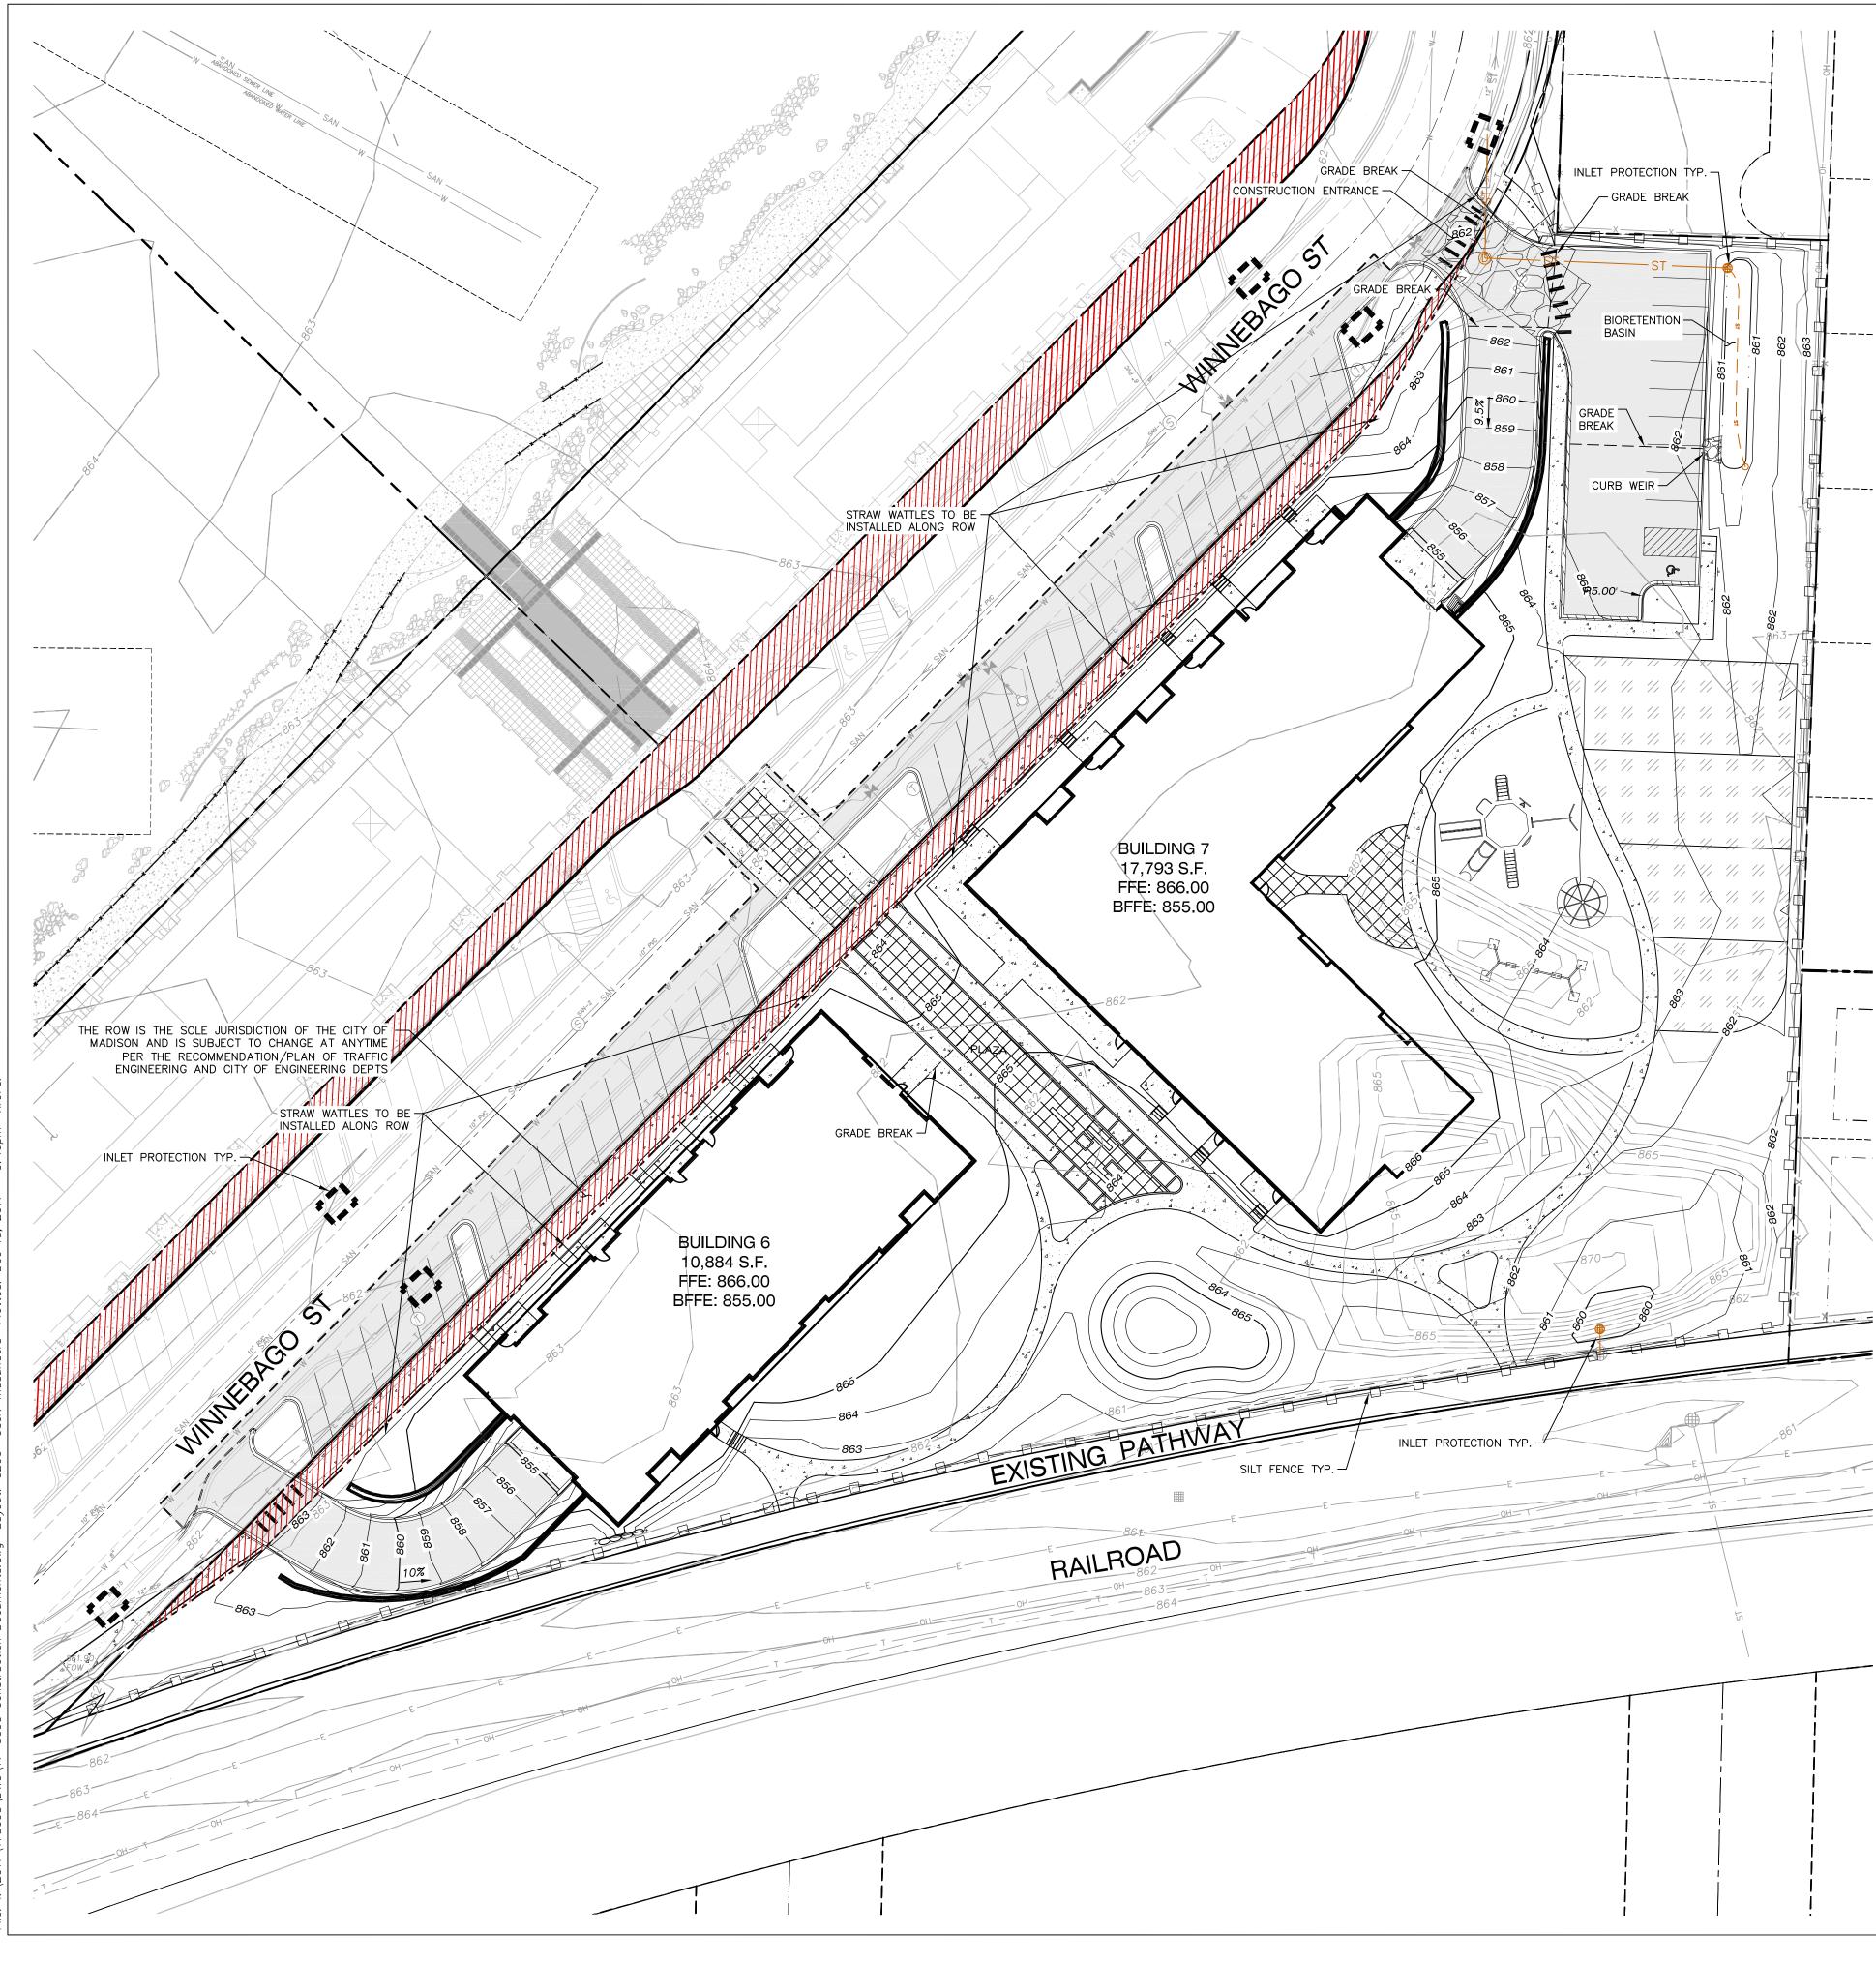

#### LEGEND (GRADING & EROSION CONT

	PROPERTY LINE
	RIGHT-OF-WAY
· · · ·	EASEMENT LINE
	BUILDING OUTLINE
	EDGE OF PAVEMENT
	STANDARD CURB AND GU
	REJECT CURB AND GUTTE
	MOUNTABLE CURB
	ASPHALT PAVEMENT
	HEAVY DUTY ASPHALT PA
	CONCRETE PAVEMENT
* * * * * * * * * * * * * * * * * * *	HEAVY DUTY CONCRETE F
· · ·	STORMWATER MANAGEMEN
	BOULDER RETAINING WALL
	MODULAR BLOCK RETAININ
0-□	LIGHT POLE (REFER TO F

#### CONSTRUCTION SITE EROSION CONTR

\_\_\_\_

- 1. ALL EROSION AND SEDIMENT CONTROL PRACTICES DEPARTMENT OF NATURAL RESOURCES EROSION http://www.dnr.state.wi.us/runoff/stormwater/tec
- 2. INSTALL EROSION CONTROL MEASURES PRIOR TO MATERIALS AS SHOWN ON PLAN. MODIFICATIONS CONDITIONS IF MODIFICATIONS CONFORM TO WDNR
- 3. INSPECTIONS AND MAINTENANCE OF ALL EROSION PROPER FUNCTION OF EROSION CONTROLS AT ALL END OF EACH WORK DAY.
- 4. INSPECT EROSION CONTROL MEASURES AFTER EAC INSPECTION.
- 5. EROSION CONTROL MEASURES SHALL NOT BE REM BEEN COMPLETED AND THAT A UNIFORM PERENNIA OF THE COVER FOR THE UNPAVED AREAS AND AR PERMANENT STABILIZATION MEASURES.
- 6. INSTALL A TRACKING PAD, 50' LONG AND NO LES MAINTAINED BY THE CONTRACTOR IN A CONDITION ADJACENT PUBLIC STREETS AFTER EACH WORKING
- 7. INSTALL EROSION CONTROLS ON THE DOWNSTREAM
- EROSION CONTROL FOR UTILITY CONSTRUCTION (S
   A. PLACE EXCAVATED TRENCH MATERIAL ON TH
   B. BACKFILL, COMPACT, AND STABILIZE THE TH C. DISCHARGE TRENCH WATER INTO A SEDIMEI TECHNICAL STANDARD NO. 1061 PRIOR TO
- 9. ADDITIONAL EROSION CONTROL MEASURES, AS REQ INSTALLED WITHIN 24 HOURS OF REQUEST.
- 10. ALL SLOPES 4:1 OR GREATER SHALL BE STABILIZ STABILIZED WITH CLASS II, TYPE B EROSION MATT ALLOW. REFER BELOW TO NOTE NO. FIFTEEN (15)
- 11. CONTRACTOR/OWNER SHALL FILE A NOTICE OF TE ACCORDANCE WITH WDNR REQUIREMENTS.
- □ 12. CONTRACTOR SHALL TAKE ALL NECESSARY STEPS TECHNICAL STANDARD 1068.
  - 13. STABILIZATION PRACTICES:

13.1.	* STABILIZATION MEASURES SHALL BE INIT CONSTRUCTION ACTIVITIES HAVE TEMPORAR AFTER THE CONSTRUCTION ACTIVITY IN THA
13.2.	* THE INITIATION STABILIZATION MEASURES PRECLUDED BY SNOW COVER. IN THAT EVI
13.3.	* CONSTRUCTION ACTIVITY WILL RESUME O
	CEASED, (I.E. THE TOTAL TIME PERIOD THA FOURTEEN (14) DAYS. IN THAT EVENT, STA SITE BY THE SEVENTH (7) DAY AFTER COI
13.4.	* STABILIZATION MEASURES SHALL BE DET HAS CEASED, INCLUDING BUT NOT LIMITED THE FOLLOWING ARE ACCEPTABLE STABILIZ
	* PERMANENT SEEDING; IN ACCORDANCE
	* TEMPORARY SEEDING; MAY CONSIST C
	* HYDRO-MULCHING WITH A TACKIFIER

### \* GEOTEXTILE EROSION MATTING \* SODDING **GRADING AND SEEDING NOTES**

- . ALL DISTURBED AREAS SHALL BE SODDED AND/ MIX TO BE IN ACCORDANCE WITH LANDSCAPE PI
- ALL PROPOSED GRADES SHOWN ARE FINISHED ( PROPERLY AND SHALL REPORT ANY DISCREPANO
- 3. CONTRACTOR SHALL PROTECT ADJACENT PROPER COMPLETED AND NOTICE OF TERMINATION FILED.
- 4. CONTRACTOR SHALL CHISEL-PLOW OR DEEP TILL SODDING AND/OR SEEDING AND MULCHING TO F
- . CONTRACTOR SHALL WATER ALL NEWLY SODDED/S LAPSE WITH NO SIGNIFICANT RAINFALL.
- 6. CONTRACTOR TO DEEP TILL ALL COMPACTED PER'
- 7. THE CONTRACTOR SHALL NOTIFY THE CITY OF M
- 8. IF GRADING ACTIVITIES STOP ON ANY PORTION ( TEMPORARILY STABILIZED.
- 9. ALL SLOPES 20% OR GREATER SHALL BE TEMPC 2 WEEKS OF DISTURBANCE.


CONSTRUCTION SEQUENCING 1. INSTALL EROSION CONTROL MEASURES PRIOR TO 2. STRIP TOPSOIL.

- 3. INSTALL ALL SWALES AND TEMP SEED BASIN
- 4. EXCAVATE BUILDING FOUNDATIONS.
- 5. COMPLETE ALL OTHER GRADING.
- 6. INSTALL STORM SEWER & INLET PROTECTION MEA
- 7. INSTALL AGGREGATE BASE COURSE AND PAVING
- 8. STABILIZE NEWLY GRADED SOILS.
- 9. COMPLETE EXTERIOR BUILDING WORK AND DOWNS
- 10. REGRADE & STABILIZE TEMPORARY SEDIMENT BASIN.

& EROSION CONTROL PLAN)			
PROPERTY LINE RIGHT–OF–WAY EASEMENT LINE	864 865	PROPOSED 1 FOOT CONTOUR PROPOSED 1 FOOT CONTOUR DRAINAGE DIRECTION	
BUILDING OUTLINE	ST	STORM SEWER	
EDGE OF PAVEMENT STANDARD CURB AND GUTTER	— — ST — — 	UNDERDRAIN SILT FENCE	
REJECT CURB AND GUTTER	571	INLET PROTECTION, TYPE D	Professional Services, Inc.
MOUNTABLE CURB ASPHALT PAVEMENT	1-2	SPOT ELEVATION	Engineers • Surveyors • Planners
HEAVY DUTY ASPHALT PAVEMENT	→934.20 FG	EP – EDGE OF PAVEMENT FG – FINISH GRADE EC – EDGE OF CONCRETE	
CONCRETE PAVEMENT HEAVY DUTY CONCRETE PAVEMENT		TS – TOP OF STEP TS – BOTTOM OF STEP RIM – RIM ELEVATION	
STORMWATER MANAGEMENT AREA		GRADE BREAK	CREATE THE VISION
BOULDER RETAINING WALL			
MODULAR BLOCK RETAINING WALL LIGHT POLE (REFER TO PHOTOMETRIC PLAN)			MADISON MILWAUKEE KENOSHA APPLETON WAUSAU
ADA PARKING BOLLARDS/SIGNS			MADISON REGIONAL OFFICE
E EROSION CONTROL REQUIREME	NTS (CSECR) NOTE	:S:	161 HORIZON REGIONAL OFFICE 161 HORIZON DRIVE, SUITE 101 VERONA, WISCONSIN 53593
MENT CONTROL PRACTICES SHALL BE DESIGNED AL RESOURCES EROSION AND SEDIMENT CONTRO us/runoff/stormwater/techstds.htm			<b>P. 608.848.5060</b> CLIENT:
ROL MEASURES PRIOR TO ANY SITE WORK, INCL ON PLAN. MODIFICATIONS TO SEDIMENT CONTRO ATIONS CONFORM TO WDNR TECHNICAL STANDAR	DL DESIGN MAY BE CONDUC DS.	TED TO MEET UNFORESEEN FIELD	CORMAN
ENANCE OF ALL EROSION CONTROL MEASURES EROSION CONTROLS AT ALL TIMES. EROSION C AY.	ONTROL MEASURES ARE TO	BE IN WORKING ORDER AT THE	& COMPANY, INC.
ROL MEASURES AFTER EACH 1/2" OR GREATER	D DISTURBING CONSTRUCTIO	ON ACTIVITY AT THE SITE HAS	
THAT A UNIFORM PERENNIAL VEGETATIVE COVER E UNPAVED AREAS AND AREAS NOT COVERED B DN MEASURES. D, 50' LONG AND NO LESS THAN 12" THICK B'	BY PERMANENT STRUCTURES	OR THAT EMPLOY EQUIVALENT	CLIENT ADDRESS: 200 NORTH MAIN STREET OREGON, WI, 53575
NTRACTOR IN A CONDITION WHICH WILL PREVENT ETS AFTER EACH WORKING DAY OR MORE FREQ ROLS ON THE DOWNSTREAM SIDE OF STOCKPILE	T THE TRACKING OF MUD C UENTLY AS REQUIRED.		OREGON, WI, 53575
UTILITY CONSTRUCTION (STORM SEWER, SANITAR	RY SEWER, WATER MAIN, ET	C.):	JATAU
) TRENCH MATERIAL ON THE HIGH SIDE OF THE CT, AND STABILIZE THE TRENCH IMMEDIATELY AF CH WATER INTO A SEDIMENTATION BASIN OR FIL DARD NO. 1061 PRIOR TO RELEASE INTO THE S	TER PIPE CONSTRUCTION. TERING TANK IN ACCORDAN		SEL MILSTI
ONTROL MEASURES, AS REQUESTED BY STATE IN OURS OF REQUEST.	SPECTORS, LOCAL INSPECT	ORS, AND/OR ENGINEER SHALL BE	2× A
REATER SHALL BE STABILIZED WITH CLASS I, TYP II, TYPE B EROSION MATTING, WITHIN 7 DAYS ( TO NOTE NO. FIFTEEN (15) FOR STABILIZATION I	OF REACHING FINAL GRADE	AND/OR AS SOON AS CONDITIONS	NOTES
HALL FILE A NOTICE OF TERMINATION UPON VEG R REQUIREMENTS.	ETATIVE STABILIZATION AND,	OR PROPERTY SALE IN	
KE ALL NECESSARY STEPS TO CONTROL DUST A	RISING FROM CONSTRUCTIO	N OPERATIONS. REFER TO WDNR	PROJECT: UNION CORNERS
<u>S</u> :			LOT 1 GRADFAMILY
N MEASURES SHALL BE INITIATED AS SOON AS ACTIVITIES HAVE TEMPORARILY OR PERMANENTL NSTRUCTION ACTIVITY IN THAT PORTION OF THE ON STABILIZATION MEASURES BY THE SEVENTH ( 'SNOW COVER. IN THAT EVENT, STABILIZATION SO ON ACTIVITY WILL RESUME ON A PORTION OF THE THE TOTAL TIME PERIOD THAT THE CONSTRUCTION ) DAYS. IN THAT EVENT, STABILIZATION MEASURE SEVENTH (7) DAY AFTER CONSTRUCTION ACTIVITY N MEASURES SHALL BE DETERMINED BASED ON NCLUDING BUT NOT LIMITED TO WEATHER COND G ARE ACCEPTABLE STABILIZATION MEASURES: IT SEEDING; IN ACCORDANCE WITH APPROVED C PY SEEDING; MAY CONSIST OF SPRING OATS(100 ULCHING WITH A TACKIFIER E EROSION MATTING	Y CEASED. NO MORE THAN SITE HAS CEASED UNLESS 7) DAY AFTER CONSTRUCTIO SHALL BE INITIATED AS SOC HE SITE WITHIN FOURTEEN ( ON ACTIVITY IS TEMPORARILY ES DO NOT HAVE TO BE IN 7 HAS TEMPORARILY CEASED SITE CONDITIONS AT THE ITIONS AND LENGTH OF TIM	SEVEN (7) DAYS SHALL PASS N ACTIVITY HAS CEASED IS N AS PRACTICABLE. (14) DAYS FROM WHEN ACTIVITY CEASED IS LESS THAN ITIATED ON THAT PORTION OF THE N. TIME OF CONSTRUCTION ACTIVITY E MEASURE MUST BE EFFECTIVE.	PROJECT LOCATION: CITY OF MADISON, WI DANE COUNTY
DING NOTES			PLAN
SHALL BE SODDED AND/OR SEEDED AND MUL DANCE WITH LANDSCAPE PLAN.	CHED IMMEDIATELY FOLLOWI	NG GRADING ACTIVITIES. SOD/SEED	MODIFICATIONS:     Description:       1     12.20.17     LAND USE SUBMITTAL
S SHOWN ARE FINISHED GRADES. CONTRACTOR REPORT ANY DISCREPANCIES TO THE ENGINEER			<u>2</u> <u>3</u>
ROTECT ADJACENT PROPERTIES WITH SILT FENCI CE OF TERMINATION FILED.	NG FOR EROSION CONTROL	UNTIL CONSTRUCTION IS	$\frac{4}{5}$
HISEL-PLOW OR DEEP TILL WITH DOUBLE TINES DING AND MULCHING TO PROMOTE INFILTRATION		MENT FACILITIES JUST PRIOR TO	
ATER ALL NEWLY SODDED/SEEDED AREAS DURIN		HENEVER THERE IS A 7 DAY	
TICANT RAINFALL.	IOR TO SODDING AND/OR S	FEDING AND MULCHING	$\begin{array}{c c} \frac{10}{11} & \underline{\qquad} \\ \hline \end{array}$
LL NOTIFY THE CITY OF MADISON TWO (2) WOR STOP ON ANY PORTION OF LAND FOR 14 OR	KING DAYS IN ADVANCE OF	ANY SOIL DISTURBING ACTIVITY.	$ \begin{array}{c ccccccccccccccccccccccccccccccccccc$
ED. GREATER SHALL BE TEMPORARY SEEDED, MULCI	HED, OR OTHER MEANS OF	COVER PLACED ON THEM WITHIN	Design/Drawn: MSS 12/13/2017
ANCE. EQUENCING		$\sim$	Design/Drawn.         MSS         12/13/2017           Approved:         MSS         12/13/2017
TROL MEASURES PRIOR TO ANY CONSTRUCTION	ACTIVITIES.		SHEET TITLE:
ND TEMP SEED BASIN		north	GRADING & EROSION
UNDATIONS.			CONTROL PLAN
GRADING.		SCALE IN FEET	
& INLET PROTECTION MEASURES.	30'	0 30'	
ED SOILS.	RIAAP		SHEET NUMBER:
UILDING WORK AND DOWNSPOUTS.		KS  ↓   KUIIINE	C200
TEMPORARY SEDIMENT BASIN.			

Toll Free (800) 242-8511

JSD PROJECT NO:

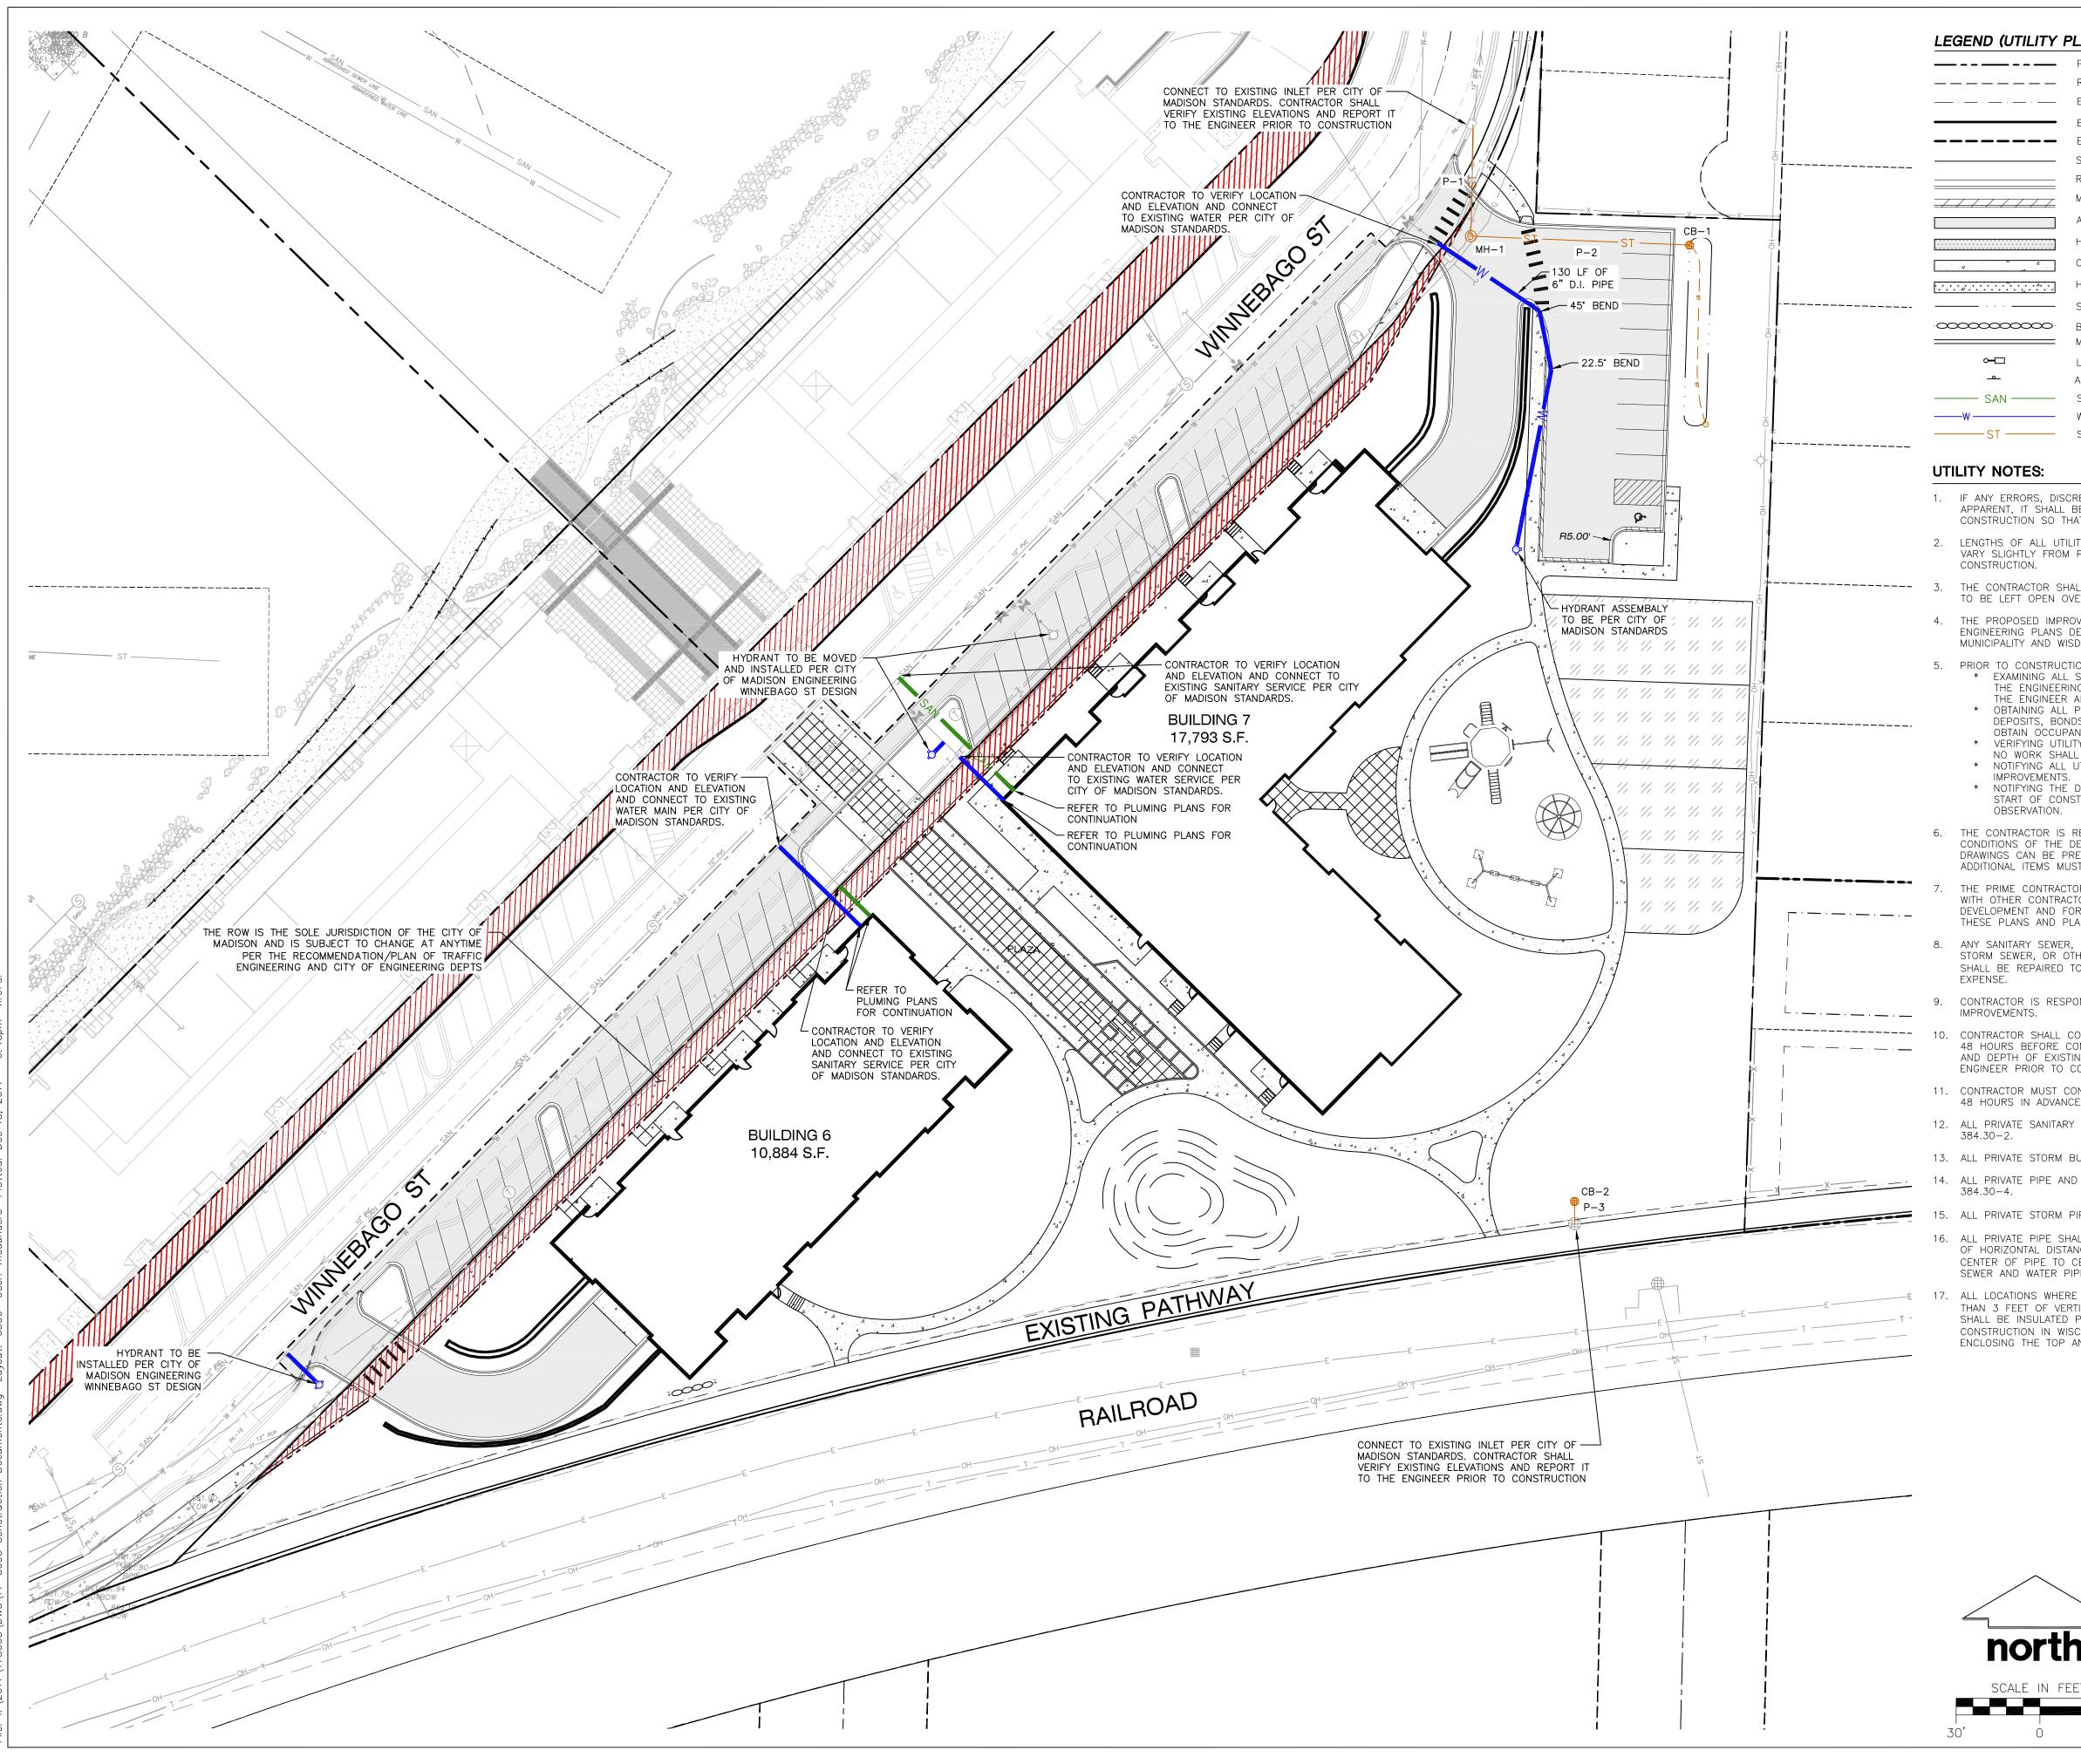

#### LEGEND (UTILITY PLAN)

	PROPERTY LINE
	RIGHT-OF-WAY
· ·	EASEMENT LINE
	BUILDING OUTLINE
	EDGE OF PAVEMENT
	STANDARD CURB AND GUTTER
	REJECT CURB AND GUTTER
	MOUNTABLE CURB
	ASPHALT PAVEMENT
	HEAVY DUTY ASPHALT PAVEMENT
<u> </u>	CONCRETE PAVEMENT
+ + + + + + + + + + + + + + + + + + +	HEAVY DUTY CONCRETE PAVEMENT
· ·	STORMWATER MANAGEMENT AREA
	BOULDER RETAINING WALL MODULAR BLOCK RETAINING WALL
-	LIGHT POLE (REFER TO PHOTOMETRIC PLAN)
٥	ADA PARKING BOLLARDS/SIGNS
SAN ———	SANITARY SEWER
	WATERMAIN
ST ———	STORM SEWER

1. IF ANY ERRORS, DISCREPANCIES, OR OMISSIONS WITHIN THE PLAN BECOME APPARENT, IT SHALL BE BROUGHT TO THE ATTENTION OF THE ENGINEER PRIOR TO CONSTRUCTION SO THAT CLARIFICATION OR REDESIGN MAY OCCUR.

2. LENGTHS OF ALL UTILITIES ARE TO CENTER OF STRUCTURES OR FITTINGS AND MAY VARY SLIGHTLY FROM PLAN. LENGTHS SHALL BE VERIFIED IN THE FIELD DURING CONSTRUCTION

THE CONTRACTOR SHALL INSTALL A PEDESTRIAN FENCE AROUND ALL EXCAVATIONS TO BE LEFT OPEN OVER NIGHT AS REQUIRED.

4. THE PROPOSED IMPROVEMENTS MUST BE CONSTRUCTED IN ACCORDANCE WITH ENGINEERING PLANS DESIGNED TO MEET ORDINANCES AND REQUIREMENTS OF THE MUNICIPALITY AND WISDOT, WDSPS, AND WDNR.

5. PRIOR TO CONSTRUCTION, THE CONTRACTOR IS RESPONSIBLE FOR: \* EXAMINING ALL SITE CONDITIONS RELATIVE TO THE CONDITIONS INDICATED ON THE ENGINEERING DRAWINGS. ANY DISCREPANCIES ARE TO BE REPORTED TO THE ENGINEER AND RESOLVED PRIOR TO THE START OF CONSTRUCTION. \* OBTAINING ALL PERMITS INCLUDING PERMIT COSTS, TAP FEES, METER DEPOSITS, BONDS, AND ALL OTHER FEES REQUIRED FOR PROPOSED WORK TO OBTAIN OCCUPANCY.

 VERIFYING UTILITY ELEVATIONS AND NOTIFYING ENGINEER OF ANY DISCREPANCY. NO WORK SHALL BE PERFORMED UNTIL THE DISCREPANCY IS RESOLVED.
 NOTIFYING ALL UTILITIES PRIOR TO THE INSTALLATION OF ANY UNDERGROUND IMPROVEMENTS. \* NOTIFYING THE DESIGN ENGINEER AND MUNICIPALITY 48 HOURS PRIOR TO THE

START OF CONSTRUCTION TO ARRANGE FOR APPROPRIATE CONSTRUCTION OBSERVATION.

6. THE CONTRACTOR IS RESPONSIBLE FOR PROVIDING THE ENGINEER WITH AS-BUILT CONDITIONS OF THE DESIGNATED IMPROVEMENTS IN ORDER THAT THE APPROPRIATE DRAWINGS CAN BE PREPARED, IF REQUIRED. ANY CHANGES TO THE DRAWINGS OR ADDITIONAL ITEMS MUST BE REPORTED TO THE ENGINEER AS WORK PROGRESSES.

THE PRIME CONTRACTOR IS RESPONSIBLE FOR COORDINATING ALL CONSTRUCTION WITH OTHER CONTRACTORS INVOLVED WITH CONSTRUCTION OF THE PROPOSED DEVELOPMENT AND FOR REPORTING ANY ERRORS OR DISCREPANCIES BETWEEN THESE PLANS AND PLANS PREPARED BY OTHERS.

ANY SANITARY SEWER, SANITARY SEWER SERVICES, WATER MAIN, WATER SERVICES, STORM SEWER, OR OTHER UTILITIES, WHICH ARE DAMAGED BY THE CONTRACTORS, SHALL BE REPAIRED TO THE OWNER'S SATISFACTION AT THE CONTRACTOR'S

9. CONTRACTOR IS RESPONSIBLE FOR SITE SAFETY DURING THE CONSTRUCTION OF IMPROVEMENTS.

10. CONTRACTOR SHALL CONTACT THE CITIES PUBLIC WORKS DEPARTMENT A MINIMUM OF 48 HOURS BEFORE CONNECTING TO PUBLIC UTILITIES. CONTRACTOR TO VERIFY SIZE AND DEPTH OF EXISTING UTILITY SERVICES AND REPORT ANY DISCREPANCIES TO THE ENGINEER PRIOR TO CONNECTING.

> 11. CONTRACTOR MUST CONTACT AND IS REQUIRED TO NOTIFY THE CITIES WATER UTILITY 48 HOURS IN ADVANCE OF CONNECTING TO THE PUBLIC UTILITY.

12. ALL PRIVATE SANITARY BUILDING PIPE AND TUBING SHALL CONFORM TO SPS

13. ALL PRIVATE STORM BUILDING PIPE AND TUBING SHALL CONFORM TO SPS 384.30-3. ALL PRIVATE PIPE AND TUBING FOR WATER SERVICE SHALL CONFORM TO SPS

ALL PRIVATE STORM PIPE SHALL CONFORM TO SPS 382.40(8)(B)4.A.

SCALE IN FEET

ALL PRIVATE PIPE SHALL BE INSTALLED PER SPS 382.40-8 INCLUDING AT LEAST 8' OF HORIZONTAL DISTANCE BETWEEN WATER PIPING AND SANITARY SEWER FROM CENTER OF PIPE TO CENTER OF PIPE AND 6' OF SEPARATION BETWEEN STORM SEWER AND WATER PIPING.

ALL LOCATIONS WHERE STORM SEWER AND WATER MAIN ARE CROSSING AND LESS THAN 3 FEET OF VERTICAL/HORIZONTAL SEPERATION IS PROVIDED, WATER MAIN SHALL BE INSULATED PER STANDARD SPECIFICATIONS FOR SEWER AND WATER CONSTRUCTION IN WISCONSIN LATEST EDITION. INSULATION SHALL CREATE A "BOX" ENCLOSING THE TOP AND SIDES OF WATER MAIN.








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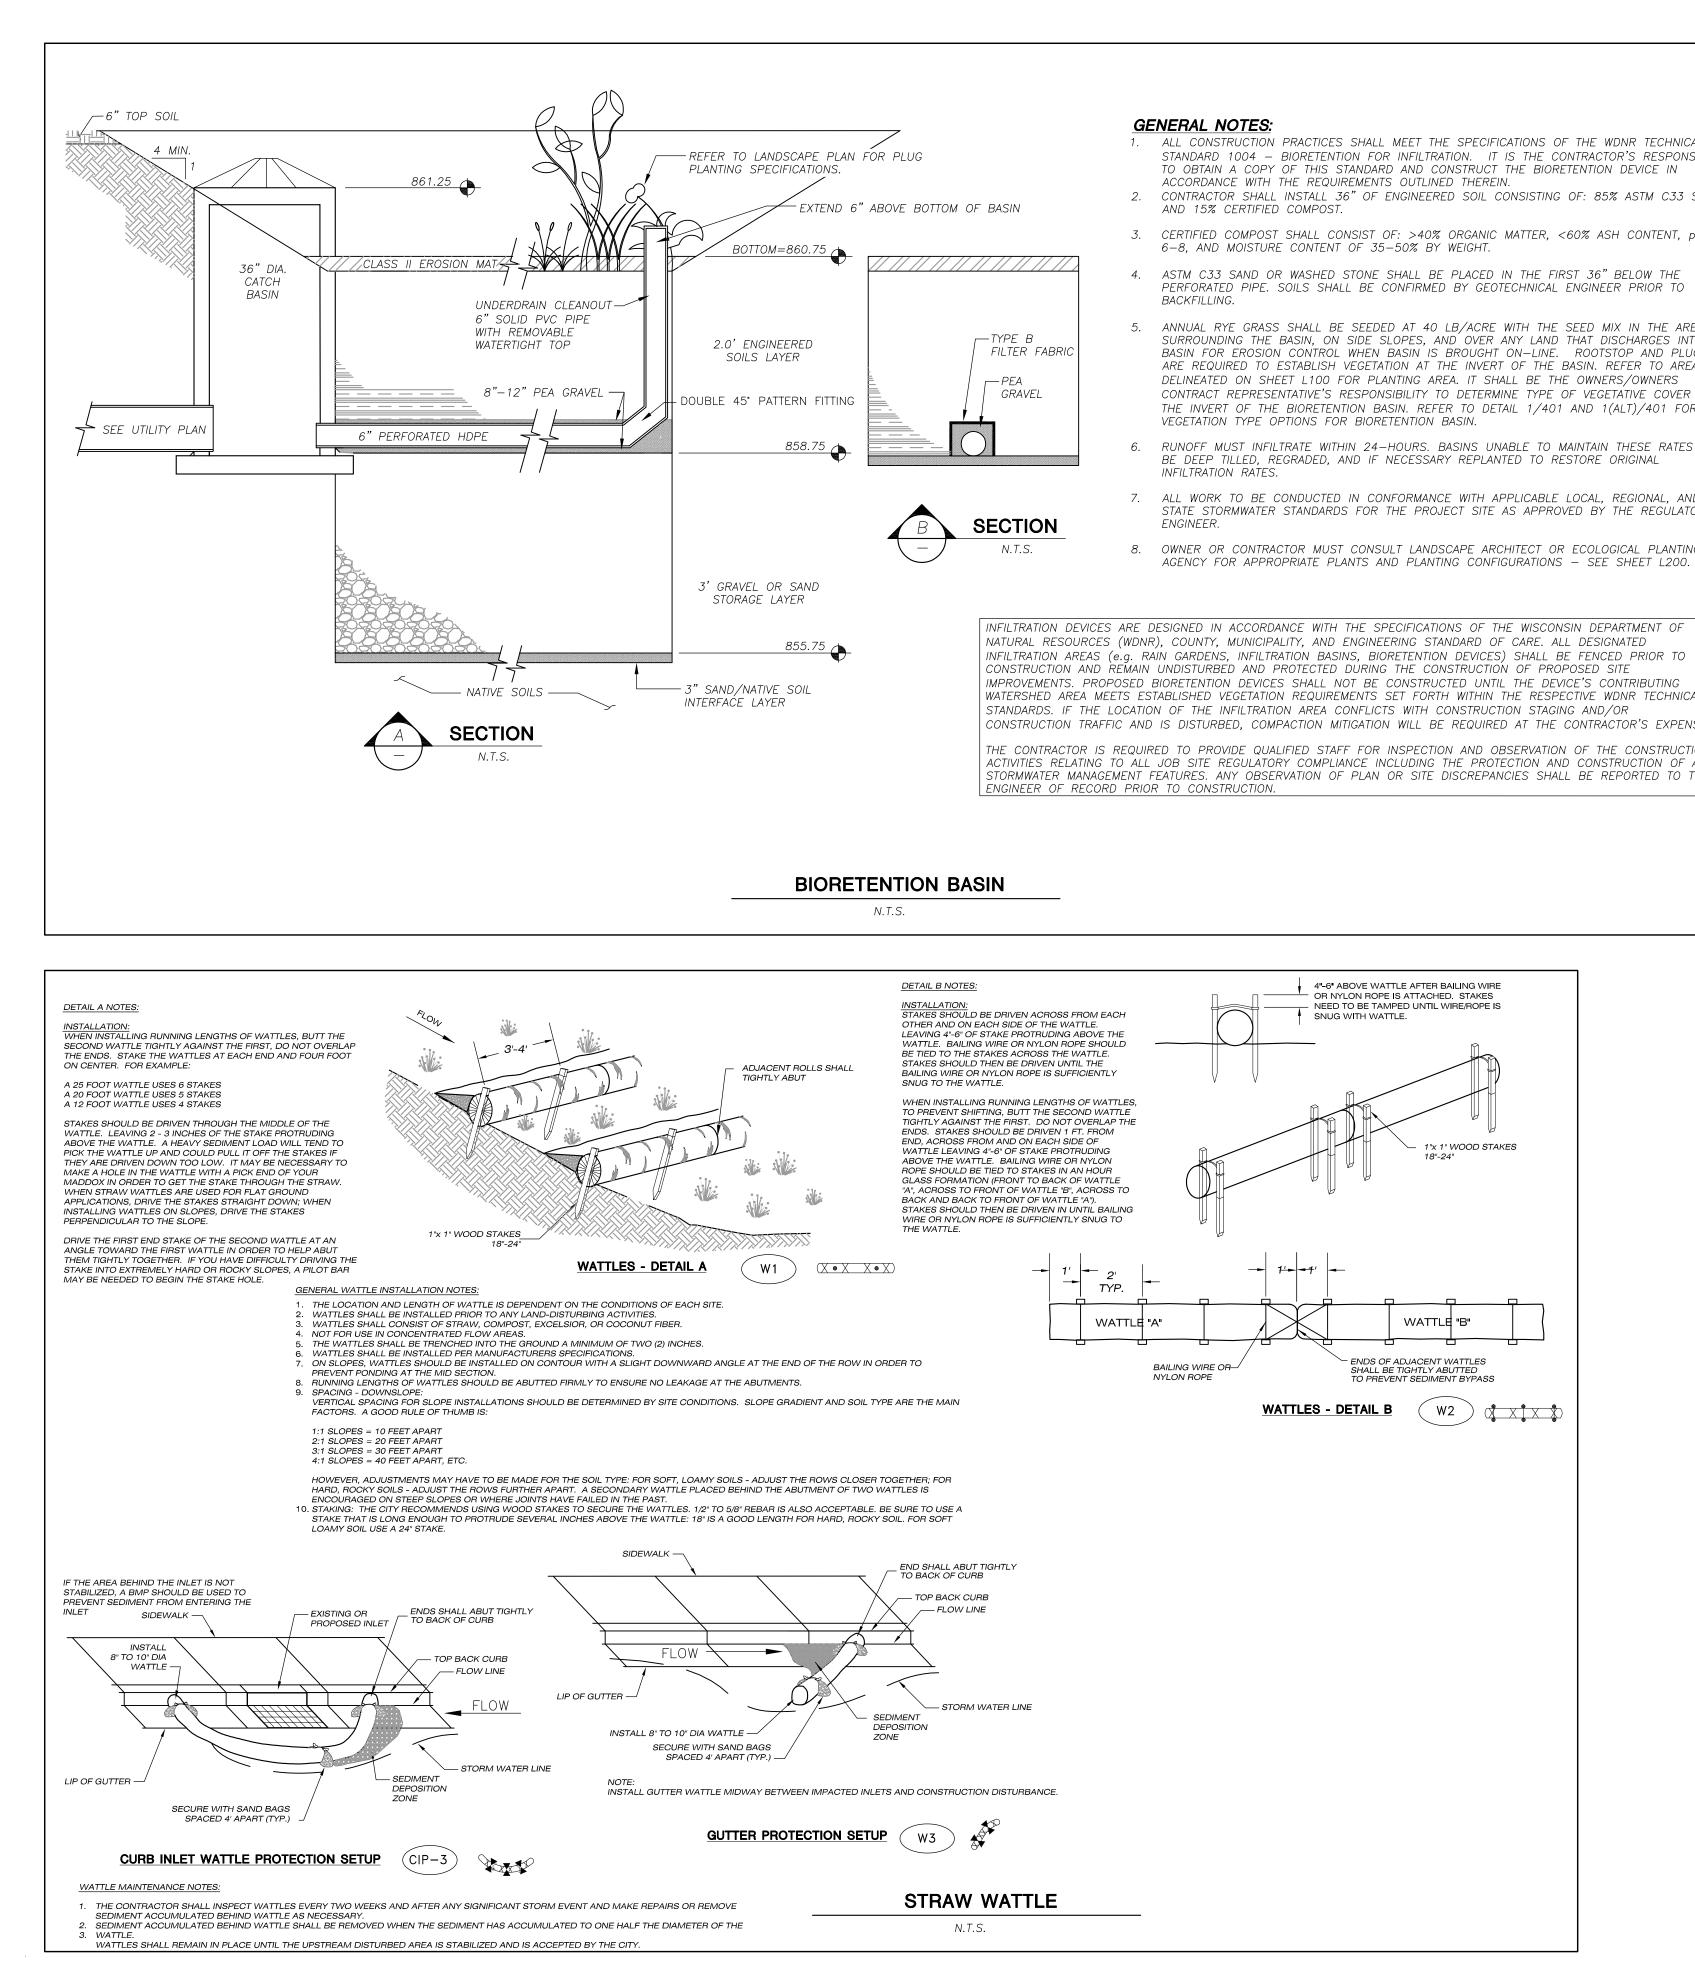
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	IN BELL GRATE IS CUSTOM MANU BY THE NEENAH FOUNDRY COMF MADISON CONCRETE PIPE SPECIF GRATE IS CAST GRAY IRON MANU	ANY TO TCATIONS	
	GRATE IS CAST GRAY IRON MANU TO MEET ASTM A-48 CLASS 35 AASHTO M105 SPECIFICATIONS - HYDRAULICS ARE AVAILABLE UPO	B AND GRATE	
	GRATES ARE AASHTO H20 LOAD GRATE SETS FLUSH WITH TOP O		
	BASIN BELL PRECAST REINFORCED CONCRETE BASIN IS MANUFACTURED TO ME. ASTM C-478 AND AASHTO M199 SPECIFICATIONS	ET	<b>Professional Services, Inc.</b> Engineers • Surveyors • Planners
	STANDARD CATCH BASIN BARREL 0'-6", 1'-0", 2'-0", 3'-0" AND STOCK 36" DIA. CATCH BASINS / WITH OR WITHOUT A 6" THICK IN BASE OR AS SPECIFIED	available	CREATE THE VISION TELL THE STORY
	CATCH BASIN JOINT MATERIAL: C CS–102 AND/OR CS–202 AS MANUFACTURED BY CONCRETE S INC., WHICH MEETS OR EXCEEDS REQUIREMENTS OF FEDERAL SPE	EALANTS CIFICATION	MADISON MILWAUKEE KENOSHA APPLETON WAUSAU MADISON REGIONAL OFFICE
TLET PIPE E PLAN FOR E AND I.E.	SS-S-210 (210A), AASHTO M-3 ASTM C-990 PIPE TO CATCH BASIN CONNECTO KOR-N-SEAL AS MANUFACTURED INC., WHICH MEETS OR EXCEEDS REQUIREMENTS OF ASTM C-923	DRS: DBY NPC	161 HORIZON DRIVE, SUITE 101 VERONA, WISCONSIN 53593 <b>P. 608.848.5060</b> CLIENT:
R.W.			GORMAN COMPANY, INC.
AMETER			
SIGNAGE – CO			CLIENT ADDRESS: 200 NORTH MAIN STREET OREGON, WI, 53575
	HANDICAPPED		at ction
REQUIRED @ ' STALL ONLY	VAN ACCESSIBLE		MNATAU
SQUARE STEL	PE SIGN POST		OREGON, WI, 53575
12 GA. GALVAI STEEL TUBE A SLEEVE (ONE THAN SIGN PC	NCHOR POST SIZE LARGER		PROJECT: UNION CORNERS LOT 1 GRADFAMILY
10" CONCRETE	FILLED POST HOLE		
BE UTILIZED II	'EN POST SYSTEM MAY N LIEU OF CONCRETE DE MIN. 3'-0" LONG " SLEEVE.		
<b>IG STALL</b> I.T.S.			PROJECT LOCATION: CITY OF MADISON, WI DANE COUNTY
			PLAN MODIFICATIONS: # Date: Description:
			1         12.20.17         LAND USE SUBMITTAL           2
			$\begin{array}{c c} \hline 4\\ \hline 5\\ \hline 6\\ \hline \end{array} \end{array} \qquad \boxed{} \qquad \boxed{} \qquad \phantom{aaaaaaaaaaaaaaaaaaaaaaaaaaaaaaaaaaa$
			$ \begin{array}{c c} \hline 7\\ \hline 8\\ \hline 9\\ \hline \\ \hline \\ 9\\ \hline \\ \hline $
			$ \begin{array}{c} \frac{10}{11} \\ \frac{12}{12} \\ \end{array} $
TTER			$ \begin{array}{c} \frac{13}{14} \\ \frac{15}{15} \end{array} $
			Design/Drawn: MSS 12-15-2017 Approved: MSS 12-15-2017
			Approved: MSS 12-15-2017 SHEET TITLE:
			DETAILS
			SHEET NUMBER:
	DIGG	<b>ERS HOTLINE</b> Free (800) 242–8511	C400
			JSD PROJECT NO: 17-8095

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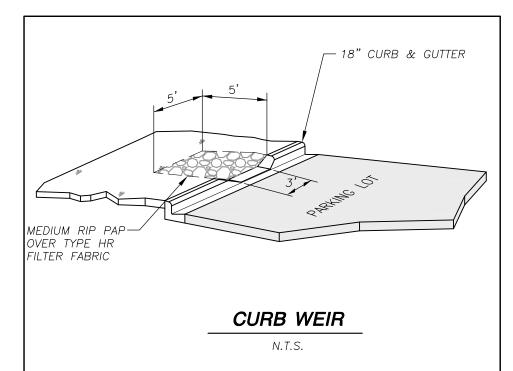

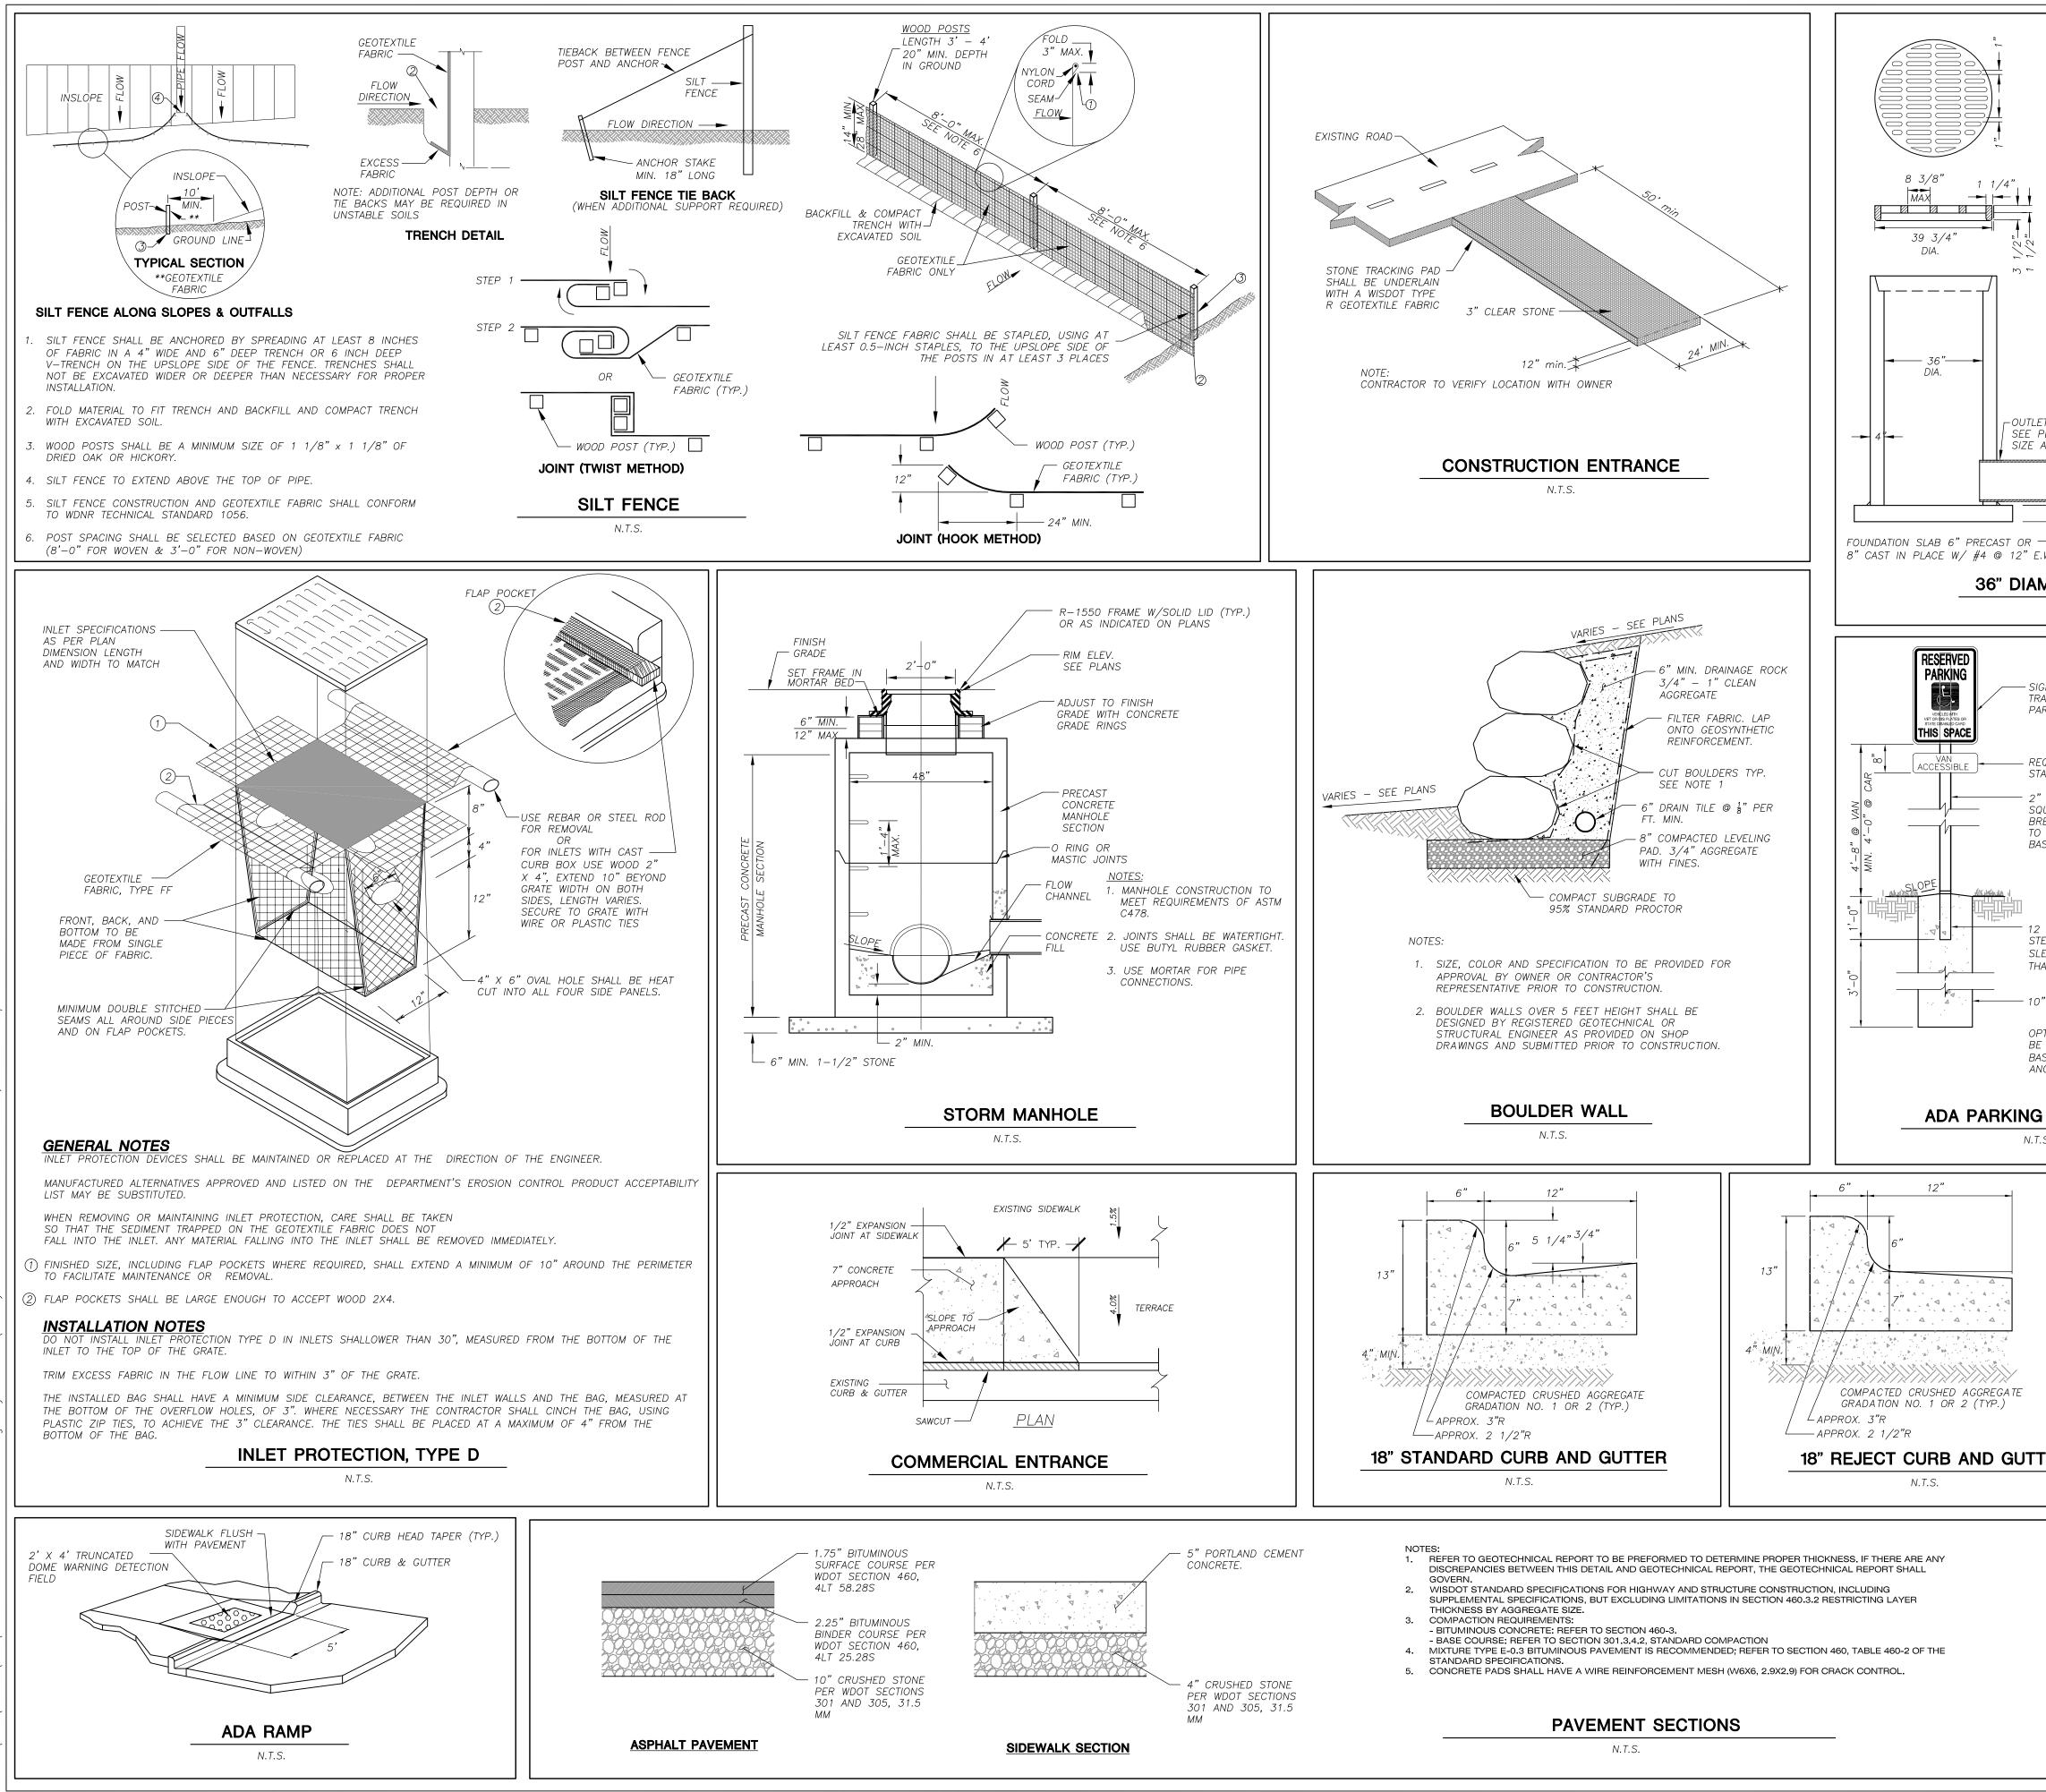
### 1. ALL CONSTRUCTION PRACTICES SHALL MEET THE SPECIFICATIONS OF THE WDNR TECHNICAL STANDARD 1004 - BIORETENTION FOR INFILTRATION. IT IS THE CONTRACTOR'S RESPONSIBILITY TO OBTAIN A COPY OF THIS STANDARD AND CONSTRUCT THE BIORETENTION DEVICE IN 2. CONTRACTOR SHALL INSTALL 36" OF ENGINEERED SOIL CONSISTING OF: 85% ASTM C33 SAND 3. CERTIFIED COMPOST SHALL CONSIST OF: >40% ORGANIC MATTER, <60% ASH CONTENT, pH OF ASTM C33 SAND OR WASHED STONE SHALL BE PLACED IN THE FIRST 36" BELOW THE PERFORATED PIPE. SOILS SHALL BE CONFIRMED BY GEOTECHNICAL ENGINEER PRIOR TO

- 5. ANNUAL RYE GRASS SHALL BE SEEDED AT 40 LB/ACRE WITH THE SEED MIX IN THE AREAS SURROUNDING THE BASIN, ON SIDE SLOPES, AND OVER ANY LAND THAT DISCHARGES INTO THE BASIN FOR EROSION CONTROL WHEN BASIN IS BROUGHT ON-LINE. ROOTSTOP AND PLUGS ARE REQUIRED TO ESTABLISH VEGETATION AT THE INVERT OF THE BASIN. REFER TO AREA DELINEATED ON SHEET L100 FOR PLANTING AREA. IT SHALL BE THE OWNERS/OWNERS CONTRACT REPRESENTATIVE'S RESPONSIBILITY TO DETERMINE TYPE OF VEGETATIVE COVER AT THE INVERT OF THE BIORETENTION BASIN. REFER TO DETAIL 1/401 AND 1(ALT)/401 FOR
- RUNOFF MUST INFILTRATE WITHIN 24-HOURS. BASINS UNABLE TO MAINTAIN THESE RATES MUST BE DEEP TILLED, REGRADED, AND IF NECESSARY REPLANTED TO RESTORE ORIGINAL
- 7. ALL WORK TO BE CONDUCTED IN CONFORMANCE WITH APPLICABLE LOCAL, REGIONAL, AND STATE STORMWATER STANDARDS FOR THE PROJECT SITE AS APPROVED BY THE REGULATORY
- 8. OWNER OR CONTRACTOR MUST CONSULT LANDSCAPE ARCHITECT OR ECOLOGICAL PLANTING AGENCY FOR APPROPRIATE PLANTS AND PLANTING CONFIGURATIONS - SEE SHEET L200.


NATURAL RESOURCES (WDNR), COUNTY, MUNICIPALITY, AND ENGINEERING STANDARD OF CARE. ALL DESIGNATED INFILTRATION AREAS (e.g. RAIN GARDENS, INFILTRATION BASINS, BIORETENTION DEVICES) SHALL BE FENCED PRIOR TO IMPROVEMENTS. PROPOSED BIORETENTION DEVICES SHALL NOT BE CONSTRUCTED UNTIL THE DEVICE'S CONTRIBUTING WATERSHED AREA MEETS ESTABLISHED VEGETATION REQUIREMENTS SET FORTH WITHIN THE RESPECTIVE WDNR TECHNICAL CONSTRUCTION TRAFFIC AND IS DISTURBED, COMPACTION MITIGATION WILL BE REQUIRED AT THE CONTRACTOR'S EXPENSE.

THE CONTRACTOR IS REQUIRED TO PROVIDE QUALIFIED STAFF FOR INSPECTION AND OBSERVATION OF THE CONSTRUCTION ACTIVITIES RELATING TO ALL JOB SITE REGULATORY COMPLIANCE INCLUDING THE PROTECTION AND CONSTRUCTION OF ALL STORMWATER MANAGEMENT FEATURES. ANY OBSERVATION OF PLAN OR SITE DISCREPANCIES SHALL BE REPORTED TO THE




	<b>nal Services, Inc.</b> Surveyors • Planners
CREATE THE VIS	SION TELL THE STORY
	SON MILWAUKEE
161 HOF VEROI	N REGIONAL OFFICE RIZON DRIVE, SUITE 101 NA, WISCONSIN 53593 . 608.848.5060
CLIENT:	
Ge	RMAN COMPANY, INC.
CLIENT ADDRESS: 200 NORTH M OREGON, WI,	
PROJECT: UNION CC	ORNERS ADFAMILY N: VISON, WI
PROJECT: UNION CC LOT 1 GRA PROJECT LOCATION CITY OF MAD	ORNERS ADFAMILY N: VISON, WI
PROJECT: UNION CC LOT 1 GRA PROJECT LOCATION CITY OF MAD DANE COUNT PLAN MODIFICATIONS: 1 12.20.17 2 3	DRNERS ADFAMILY
PROJECT:         UNION CC         LOT 1 GRA         PROJECT LOCATION         CITY OF MAD         DANE COUNT         PLAN         MODIFICATIONS:         #       Date:         1       12.20.17         2       3         4       5         6       7         8       9         10       11         12       10	DRNERS ADFAMILY
PROJECT: UNION CC LOT 1 GRA PROJECT LOCATION CITY OF MAD DANE COUNT PLAN MODIFICATIONS: # Date: 1 12.20.17 2 3 4 5 6 7 8 9 9 10 11	DRNERS ADFAMILY
PROJECT:         UNION CC         LOT 1 GRA         PROJECT LOCATION         CITY OF MAD         DANE COUNT         PLAN         MODIFICATIONS:         #         1         12.20.17         2         3         4         5         6         7         8         9         10         11         12         13         14	Description: LAND USE SUBMITTAL
PROJECT:         UNION CC         LOT 1 GRA         PROJECT LOCATION         CITY OF MAD         DANE COUNT         PLAN         MODIFICATIONS:         #         12.20.17         2         3         4         5         6         7         8         9         10         11         12         13         14         15	PRNERS ADFAMILY
PROJECT: UNION CC LOT 1 GRA PROJECT LOCATION CITY OF MAD DANE COUNT PLAN MODIFICATIONS: 1 12.20.17 2 3 4 5 6 7 8 9 10 11 12 13 14 15 Design/Drawn: MSS Approved: MSS SHEET TITLE: DETAILS	N: VISON, WI TY Description: LAND USE SUBMITTAL 



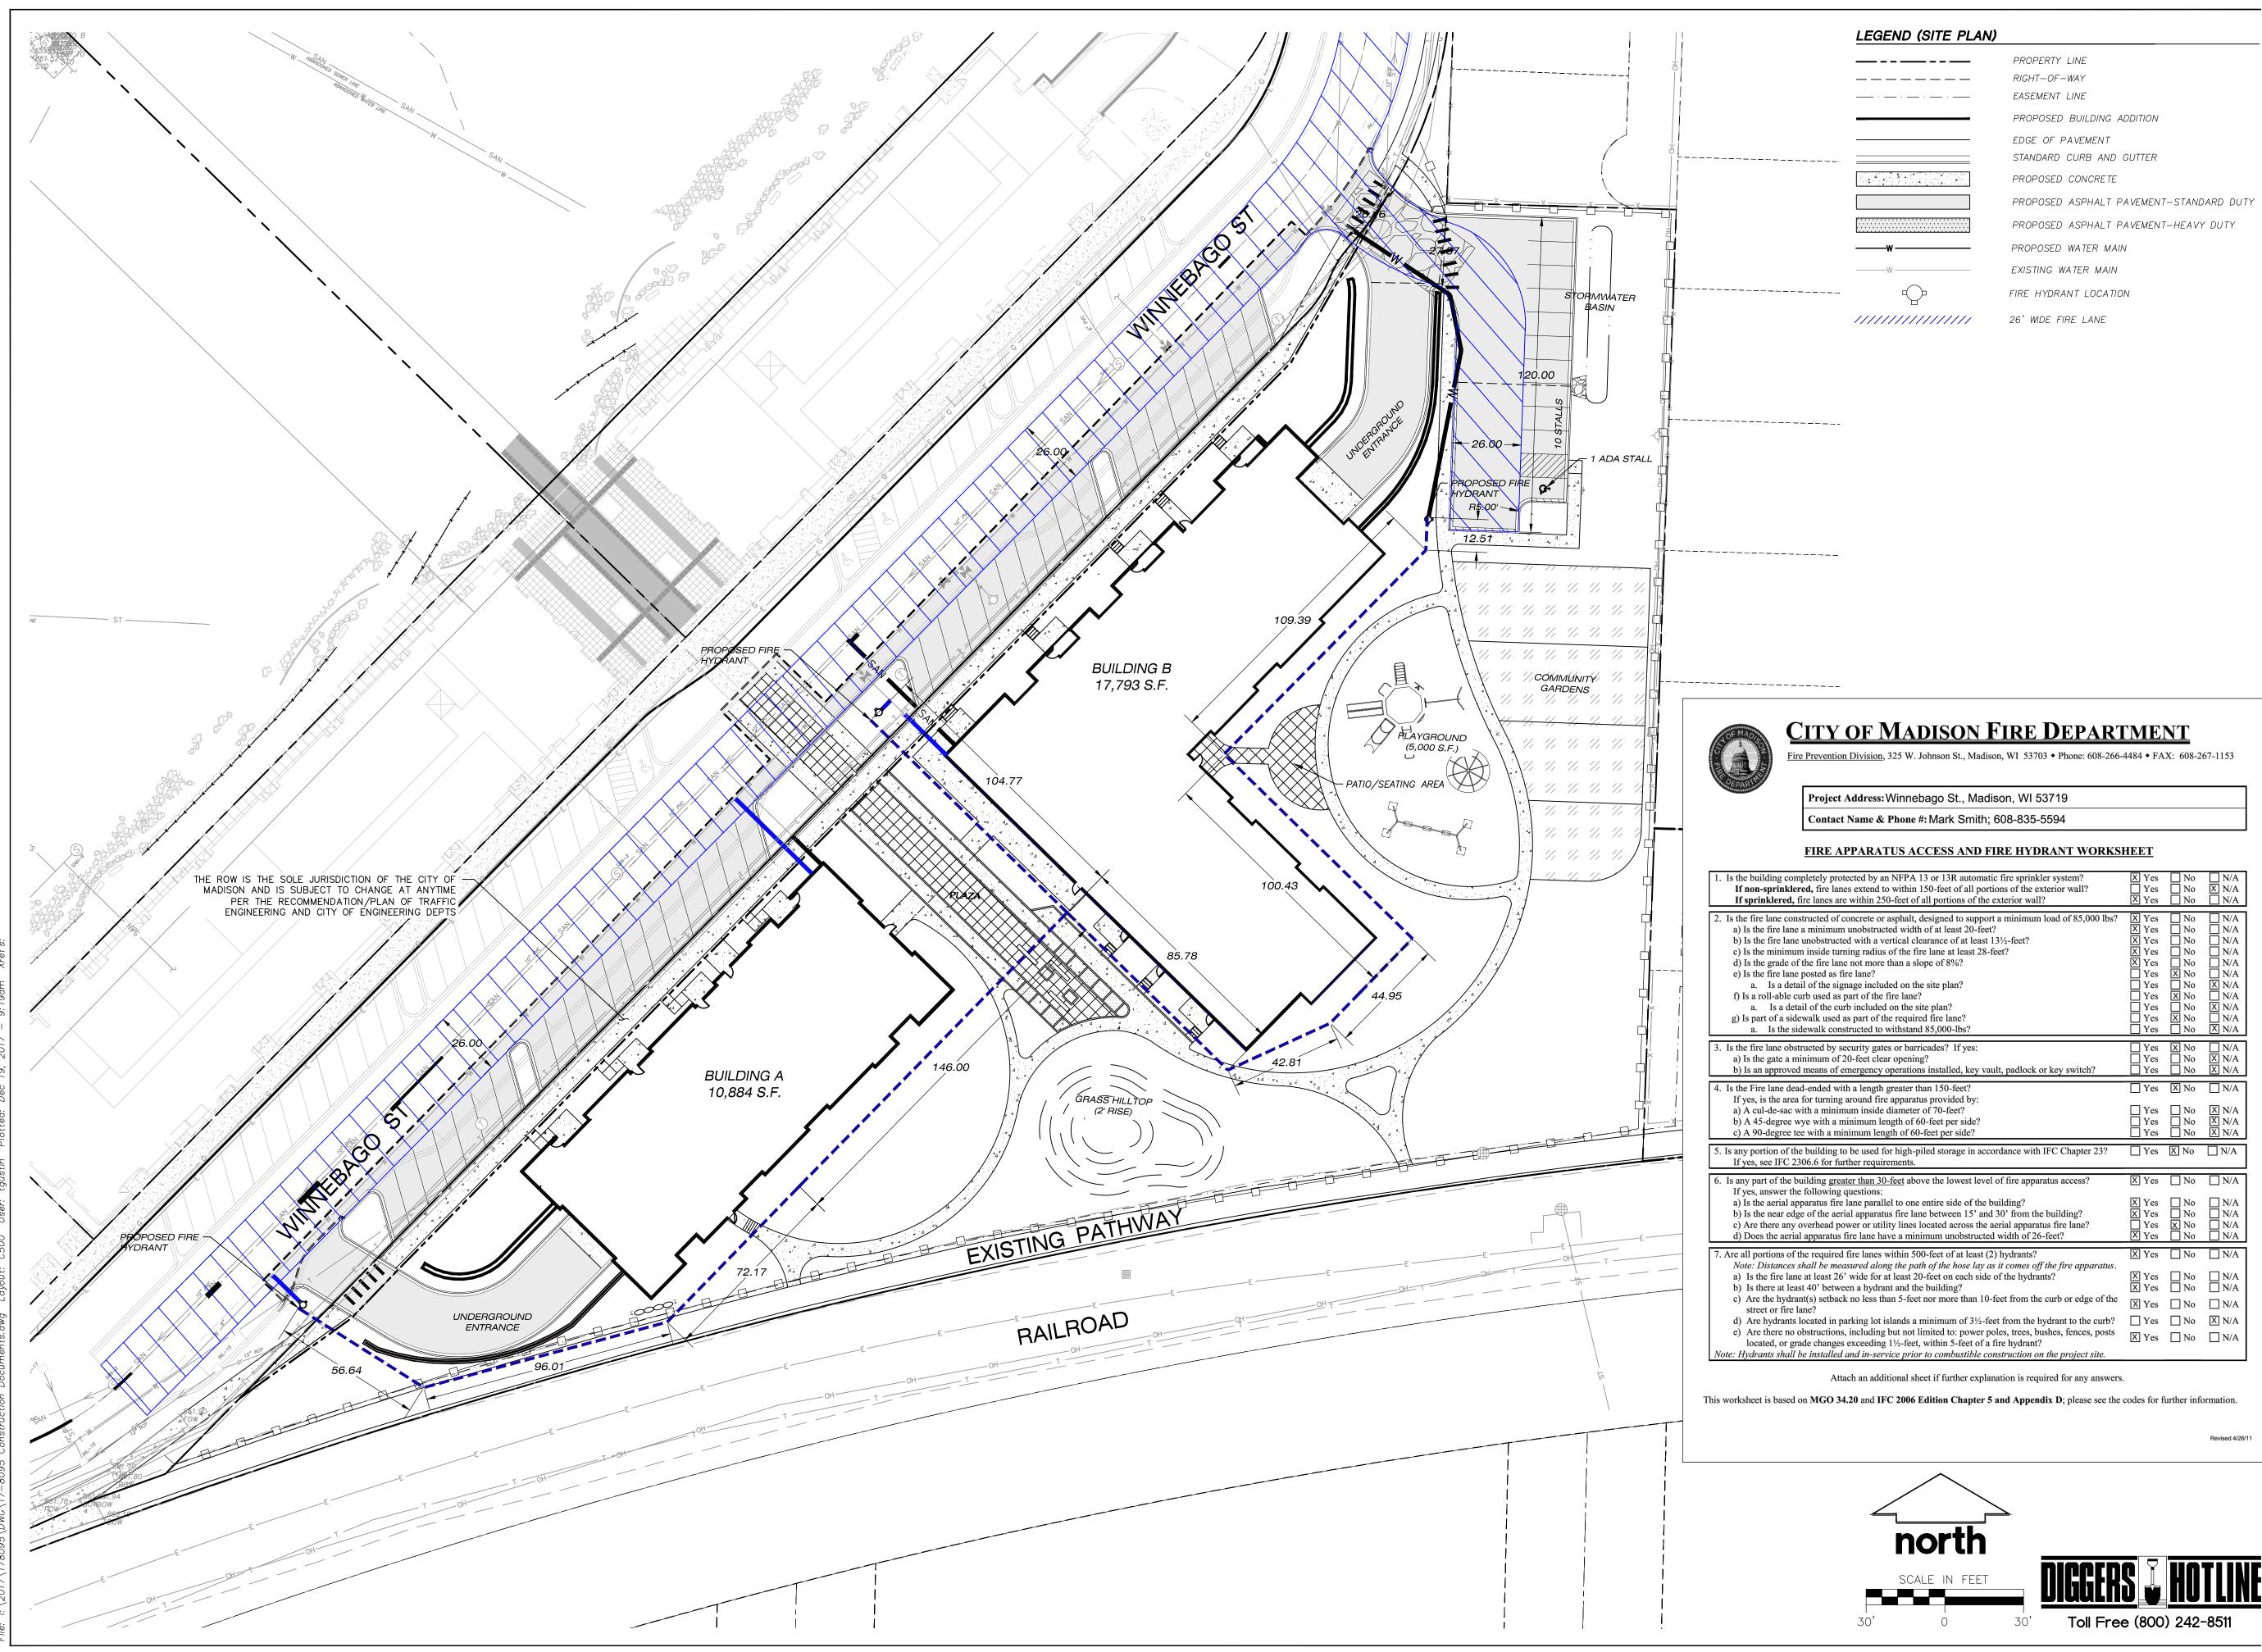

GEND	(SITE	PLAN)	
	•		

	PROPERTY LINE RIGHT-OF-WAY
	EASEMENT LINE
	PROPOSED BUILDING ADDITION
	EDGE OF PAVEMENT STANDARD CURB AND GUTTER
	PROPOSED CONCRETE
	PROPOSED ASPHALT PAVEMENT-STANDARD DUTY
	PROPOSED ASPHALT PAVEMENT-HEAVY DUTY
	PROPOSED WATER MAIN
	EXISTING WATER MAIN
ц Ср	FIRE HYDRANT LOCATION
///////////////////////////////////////	26' WIDE FIRE LANE

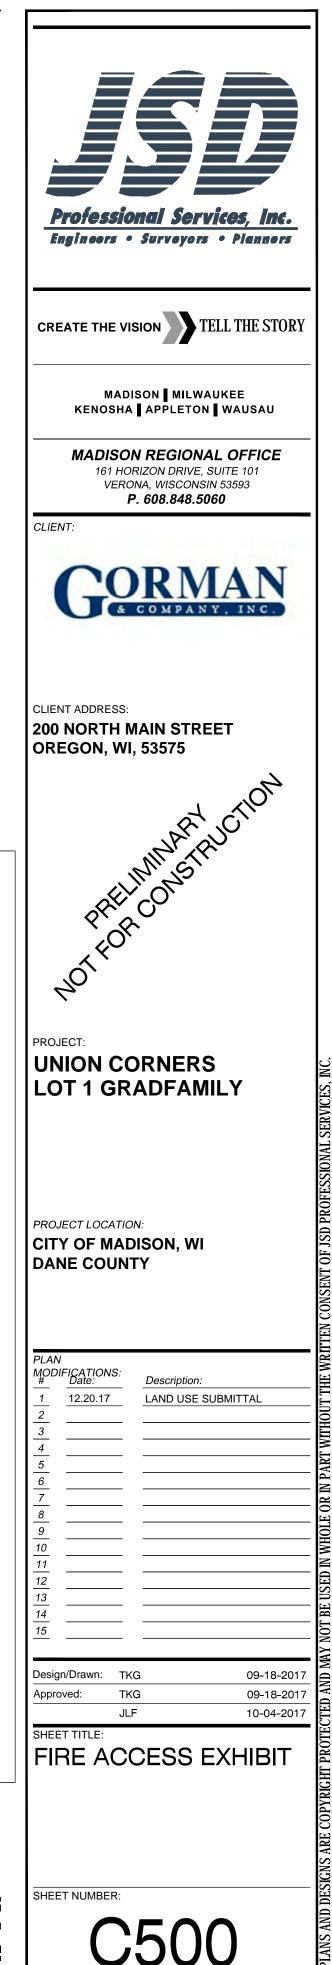


JSD PROJECT NO:

y an NFPA 13 or 13R automatic fire sprinkler system? nd to within 150-feet of all portions of the exterior wall? n 250-feet of all portions of the exterior wall?	X Yes Ves X Yes	☐ No ☐ No ☐ No	□ N/A ⊠ N/A □ N/A
e or asphalt, designed to support a minimum load of 85,000 lbs? tructed width of at least 20-feet? a vertical clearance of at least 13½-feet? dius of the fire lane at least 28-feet? ore than a slope of 8%? ? cluded on the site plan? the fire lane? ded on the site plan? of the required fire lane? t to withstand 85,000-lbs?	X Yes X Yes X Yes X Yes Yes Yes Yes Yes Yes Yes Yes Yes	<ul> <li>No</li> <li>No</li> <li>No</li> <li>No</li> <li>No</li> <li>Xo</li> <li>No</li> <li>Xo</li> <li>No</li> <li>Xo</li> <li>No</li> <li>Xo</li> <li>No</li> <li>Xo</li> <li>No</li> <li>No</li> <li>No</li> </ul>	<ul> <li>N/A</li> <li>X/A</li> </ul>
gates or barricades? If yes: clear opening? cy operations installed, key vault, padlock or key switch?	☐ Yes ☐ Yes ☐ Yes	X No No No	N/A N/A N/A
gth greater than 150-feet? fire apparatus provided by: ide diameter of 70-feet? n length of 60-feet per side? length of 60-feet per side?	Yes Yes Yes Yes	X No No No No No	N/A N/A N/A N/A N/A
ed for high-piled storage in accordance with IFC Chapter 23? quirements.	Yes	X No	N/A
<u>n 30-feet</u> above the lowest level of fire apparatus access? ns: urallel to one entire side of the building? uratus fire lane between 15' and 30' from the building? utility lines located across the aerial apparatus fire lane? e have a minimum unobstructed width of 26-feet?	X Yes X Yes X Yes Yes X Yes	□ No □ No □ No X No □ No	□ N/A □ N/A □ N/A □ N/A □ N/A
thes within 500-feet of at least (2) hydrants? along the path of the hose lay as it comes off the fire apparatus. for at least 20-feet on each side of the hydrants? rdrant and the building? as than 5-feet nor more than 10-feet from the curb or edge of the	X Yes X Yes X Yes X Yes	□ No □ No □ No □ No	□ N/A □ N/A □ N/A □ N/A
lot islands a minimum of 3 <sup>1</sup> / <sub>2</sub> -feet from the hydrant to the curb? ling but not limited to: power poles, trees, bushes, fences, posts ling 1 <sup>1</sup> / <sub>2</sub> -feet, within 5-feet of a fire hydrant? service prior to combustible construction on the project site.	☐ Yes X Yes	☐ No ☐ No	X N/A

$(\cdot)$	AG2	BOTANICAL NAME / COMMON NAME Amelanchier x grandiflora `Autumn Brilliance` / `Autumn Brilliance` Serviceberry	B & B	N SIZE AT PLANTING	QTY 12	1
<u> </u>	BL	Betula nigra `Little King` TM / Fox Valley Birch	B & B	1.5"Cal	3	-
	SF	Sorbus aucuparia `Fastigiata` / Oakleaf Mountain Ash	B & B	1.5"Cal	1	-
RSTORY DECIDUOUS TREE	CODE	BOTANICAL NAME / COMMON NAME	ROOT CONDITIO	N SIZE AT PLANTING	QTY	
	AA	Acer x freemanii `Jeffsred` / Autumn Blaze Maple	B & B	2.5"Cal	3	
	CA2	Carpinus caroliniana / American Hornbeam	B & B	1.5"Cal	3	-
	QB	Quercus bicolor / Swamp White Oak	B & B	2.5"Cal	5	
$\overline{\bigcirc}$	QM		B & B	2.5"Cal	2	
	QM	Quercus macrocarpa / Burr Oak	B&B	2.5 Cai	2	
$\left( \cdot \right)$	QM2	Quercus muehlenbergii / Chinkapin Oak	B & B	2.5"Cal	3	
IDUOUS SHRUBS	CODE CH	BOTANICAL NAME / COMMON NAME Clethra alnifolia 'Hummingbird' / Summersweet	CONT 3 gal	SIZE AT PLANTING Min. 18"-24"	QTY 13	
···· ····	СВ	Cornus baileyi / Bailey`s Red-twig Dogwood	3 gal	Min. 18"-24"	14	
	SA	Spiraea albiflora / Japanese White Spirea	3 gal	Min. 18"-24"	10	
RGREEN SHRUBS	CODE JS	BOTANICAL NAME / COMMON NAME Juniperus x pfitzeriana `Sea Green` / Sea Green Juniper	CONT 5 gal	SIZE AT PLANTING	QTY 12	
•		Pinus mugo mugo / Dwarf Mugo Pine	5 gal	Min. 18"-24"	4	
And the second s	TT	Taxus x media `Tauntonii` / Tauton Yew	5 gal	Min. 18"-24"	4	
O		BOTANICAL NAME / COMMON NAME	CONT	SIZE AT PLANTING		
N.S.	AT	Allium tanguticum `Summer Beauty` / Summer Beauty Globe Lily	1 Gal	10-12" Ht. 10-12" Ht.	21	$\bigcup  \bigcup  \bigcup  \bigcup  \bigcup  \bigcup  \bigcup  \bigcup  \bigcup  \bigcup $
	СК	Calamagrostis x acutiflora `Karl Foerster` / Feather Reed Grass Hemerocallis x `Happy Returns` / Happy Returns Daylily	1 Gal	10-12" Ht.	41	
·	НВ	Heuchera x `Berry Smoothie` / Berry Smoothie Coral Bells	1 Gal	10-12" Ht.	8	
(+) 	PP	Panicum virgatum `Praire Fire` / Red Switch Grass	1 Gal	10-12" Ht.	49	
⊕ ∰	PH	Pennisetum alopecuroides `Hameln` / Hameln Dwarf Fountain Grass	1 Gal	10-12" Ht.	10	
$\overline{\mathbf{\cdot}}$	PL	Perovskia atriplicifolia `Little Spire` TM / Little Spire Russian Sage	1 Gal	10-12" Ht.	9	
+	PG	Potentilla fruticosa `Gold Star` / Gold Star Potentilla	1 Gal	10-12" Ht.	18	
*	RG2	Rudbeckia fulgida sullivantii `Goldsturm` / Black-eyed Susan	1 Gal	10-12" Ht.	15	
$\overline{ullet}$	SM	Salvia nemorosa `Mainacht` / Maynight Salvia	1 Gal	10-12" Ht.	30	
×	SS	Solidago speciosa / Showy Goldenrod	1 Gal	10-12" Ht.	61	
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SOLE JURISDICTION OF CITY OF MADISON AN SUBJECT TO CHANGE ANYTIME PER THE RECOMMENDATION/ TRAFFIC ENGINEERING D CITY ENGINEERING D	OF THE ND IS E AT DEAN OF IG AND DEPTS			UNDER	MULCH RGROU RANCE	ND SEED, FERTILIZER

: \2017\178095\DWG\17-8095 Landscape Plan.dwg Layout: L100 (22X34) User: tqustin Plotted: Dec 19, 2017 – 12:41pm Xref's: 17–8095 Union Corners

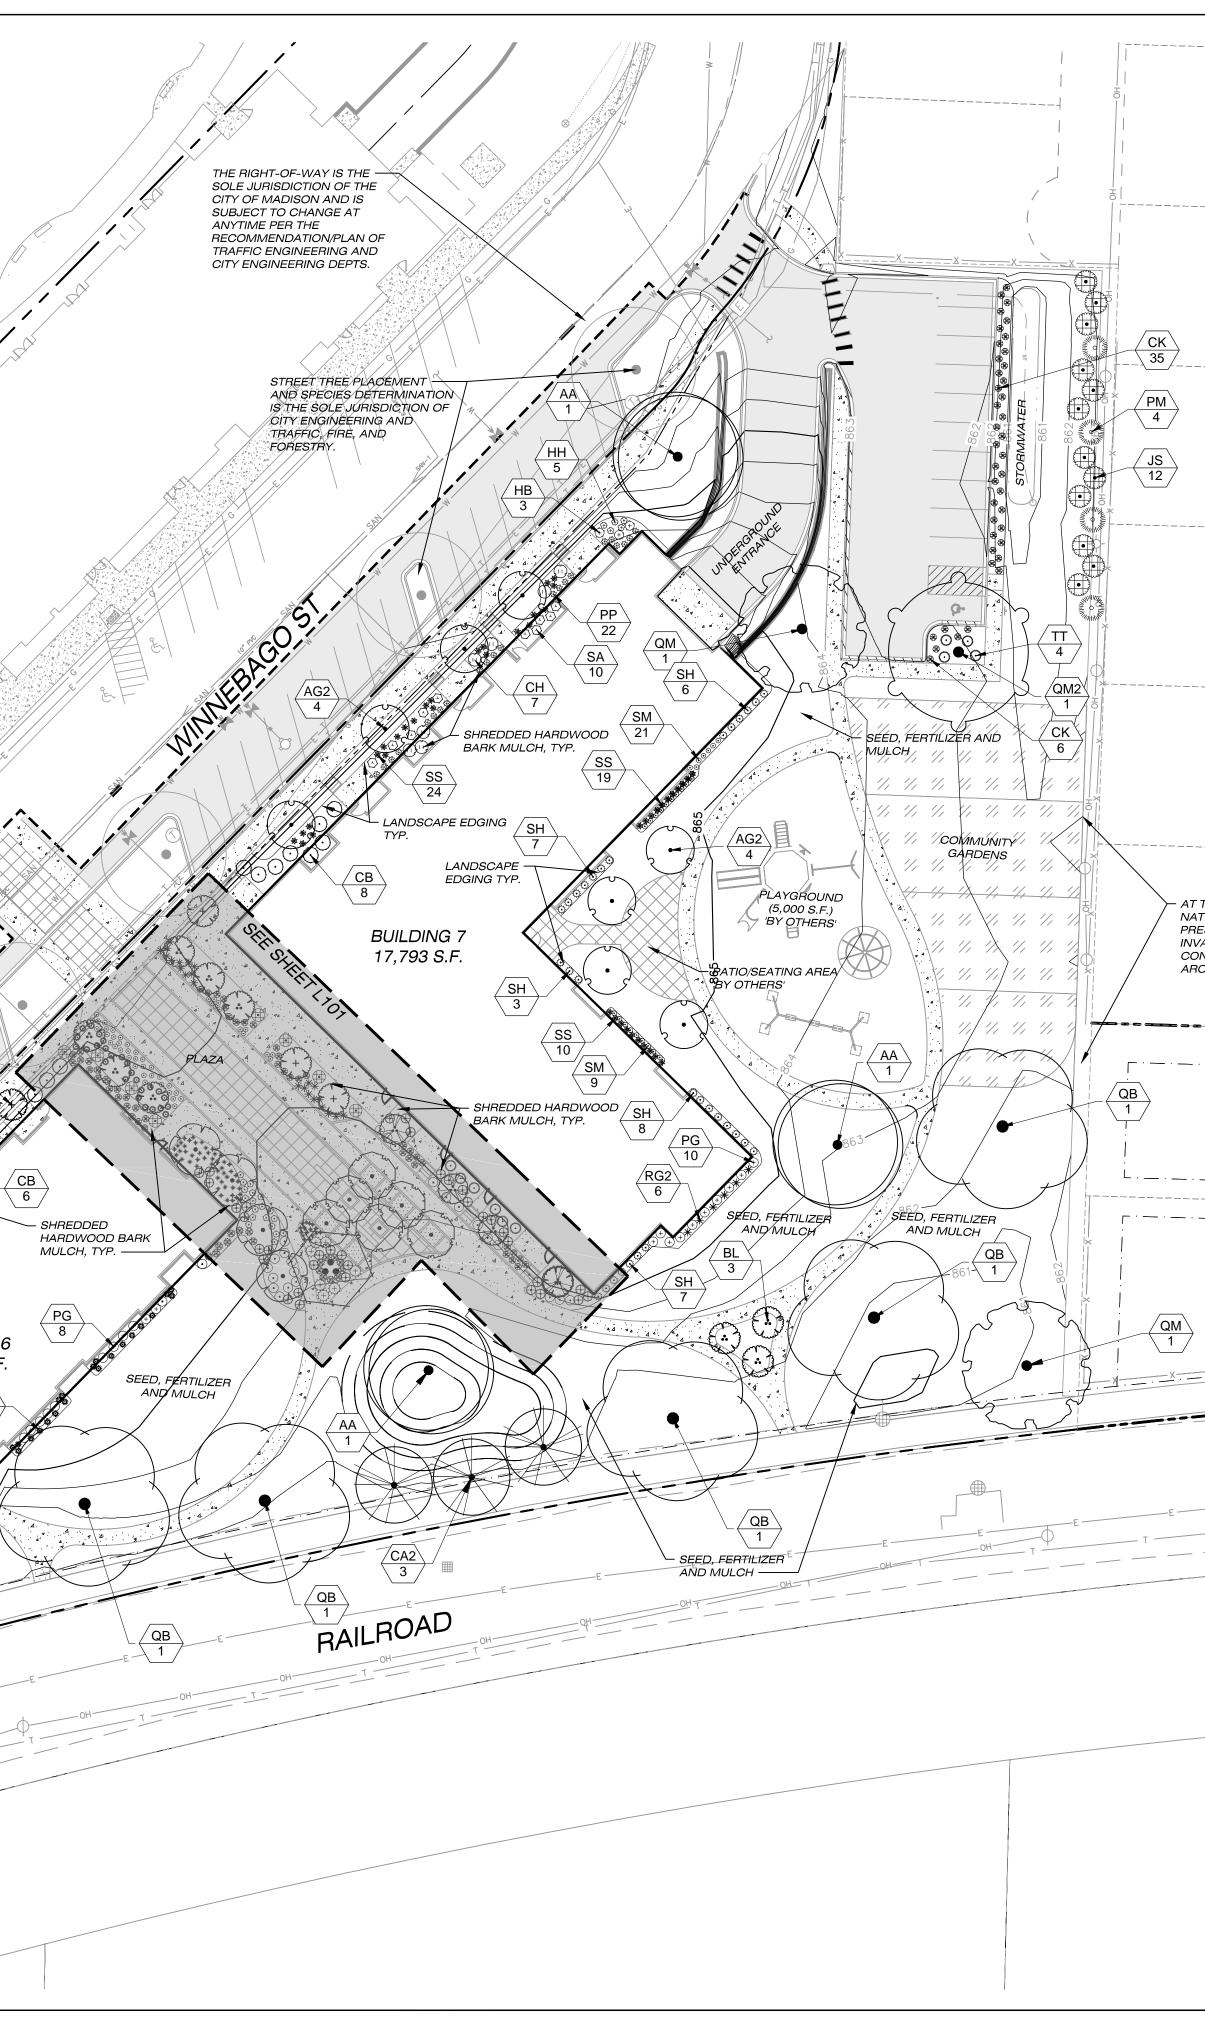

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PROPERTY LINE RIGHT-OF-WAY BUILDING OUTLINE EDGE OF PAVEMENT STANDARD CURB AND GUTTER REJECT CURB AND GUTTER MOUNTABLE CURB ASPHALT PAVEMENT CONCRETE PAVEMENT HEAVY DUTY CONCRETE PAVEMENT HEAVY DUTY CONCRETE PAVEMENT STORMWATER MANAGEMENT AREA MODULAR BLOCK RETAINING WALL LIGHT POLE (REFER TO PHOTOMETRIC PLAN)


#### GENERAL NOTES:


- 1. REFER TO THE EXISTING CONDITIONS SURVEY FOR EXISTING CONDITIONS NOTES AND LEGEND.
- 2. ALL WORK IN THE ROW SHALL BE IN ACCORDANCE WITH THE MUNICIPAL STANDARD SPECIFICATIONS FOR PUBLIC WORKS CONSTRUCTION.
- 3. JSD SHALL BE HELD HARMLESS AND DOES NOT WARRANT ANY DEVIATIONS BY THE OWNER/CONTRACTOR FROM THE APPROVED CONSTRUCTION PLANS THAT MAY RESULT IN DISCIPLINARY ACTIONS BY ANY OR ALL REGULATORY AGENCIES.
- 4. DRAWING FOR REVIEW NOT FOR CONSTRUCTION UNLESS OTHERWISE NOTED IN THE TITLE BLOCK.
- 5. THE LANDSCAPE CONTRACTOR SHALL COORDINATE ALL FINE GRADING AND TOPSOILING WITH GENERAL CONTRACTOR
- 6. REFER TO SHEET L200 FOR ADDITIONAL DETAILS, NOTES AND SPECIFICATION INFORMATION INCLUDING MATERIALS, GUARANTEE AND EXECUTION RELATED TO LANDSCAPE PLAN

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JSD PROJECT NO:



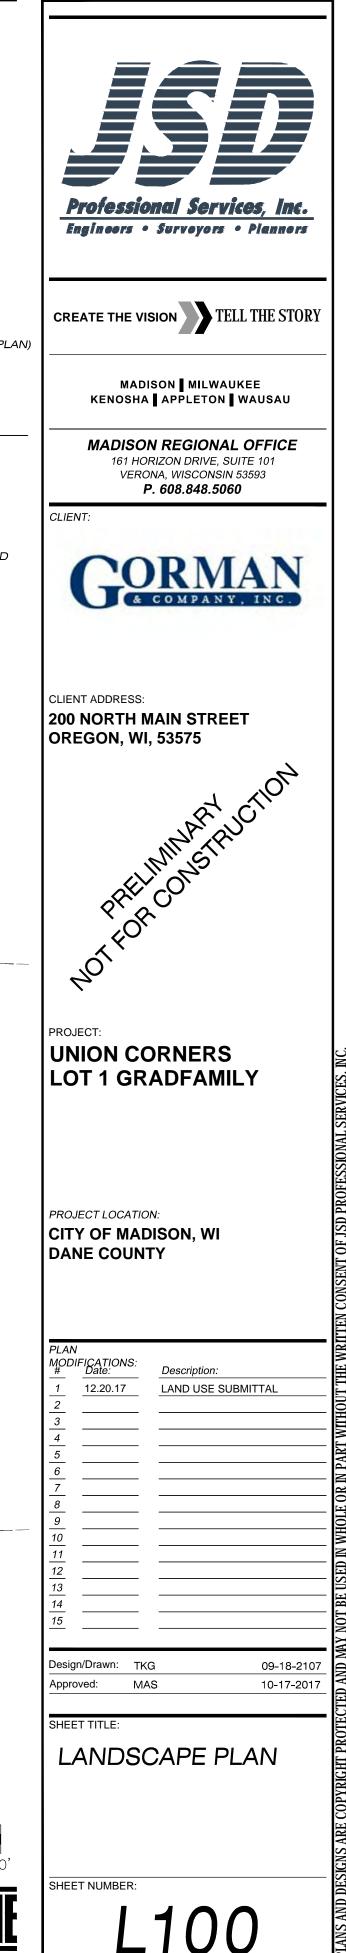

#### LEGEND (SITE PLAN)
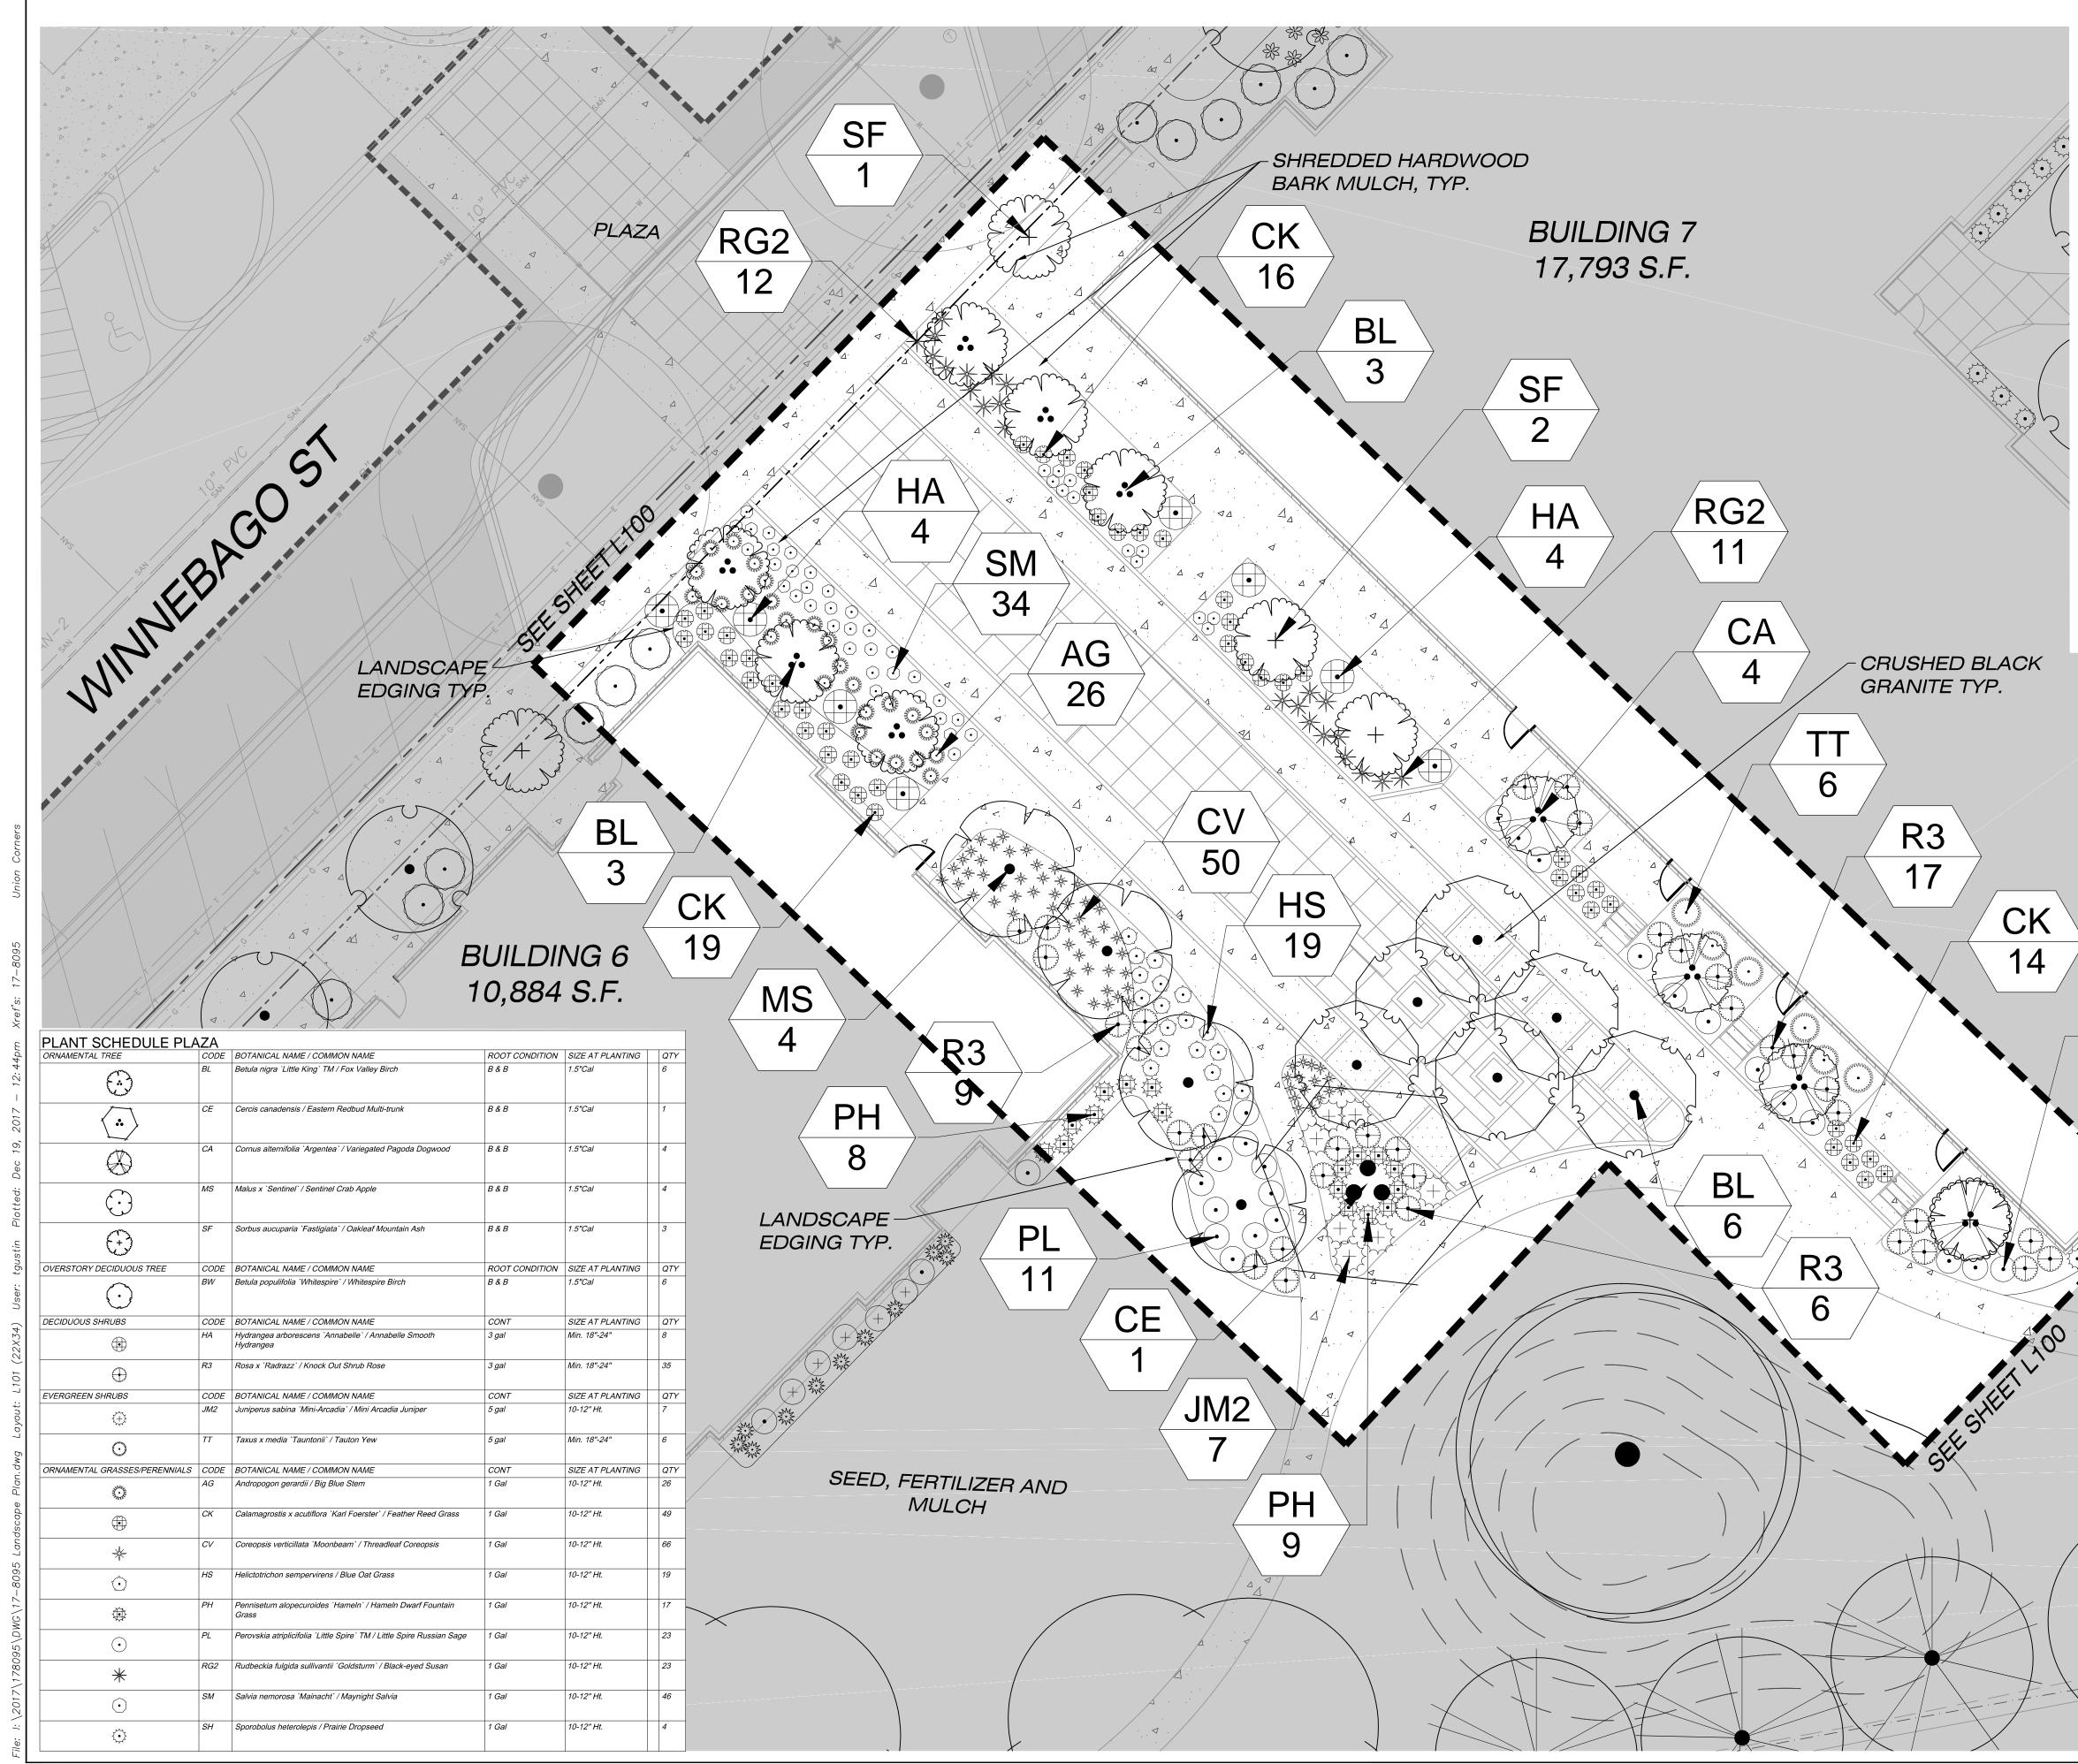
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PROPERTY LINE RIGHT-OF-WAY BUILDING OUTLINE EDGE OF PAVEMENT STANDARD CURB AND GUTTER REJECT CURB AND GUTTER MOUNTABLE CURB ASPHALT PAVEMENT CONCRETE PAVEMENT HEAVY DUTY CONCRETE PAVEMENT CRUSHED BLACK GRANITE STORMWATER MANAGEMENT AREA MODULAR BLOCK RETAINING WALL LIGHT POLE (REFER TO PHOTOMETRIC PLAN) ADA PARKING BOLLARDS/SIGNS

#### GENERAL NOTES:

- REFER TO THE EXISTING CONDITIONS SURVEY FOR EXISTING CONDITIONS NOTES AND LEGEND.
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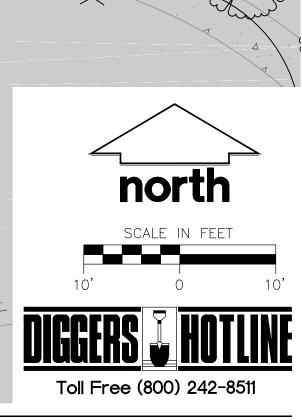
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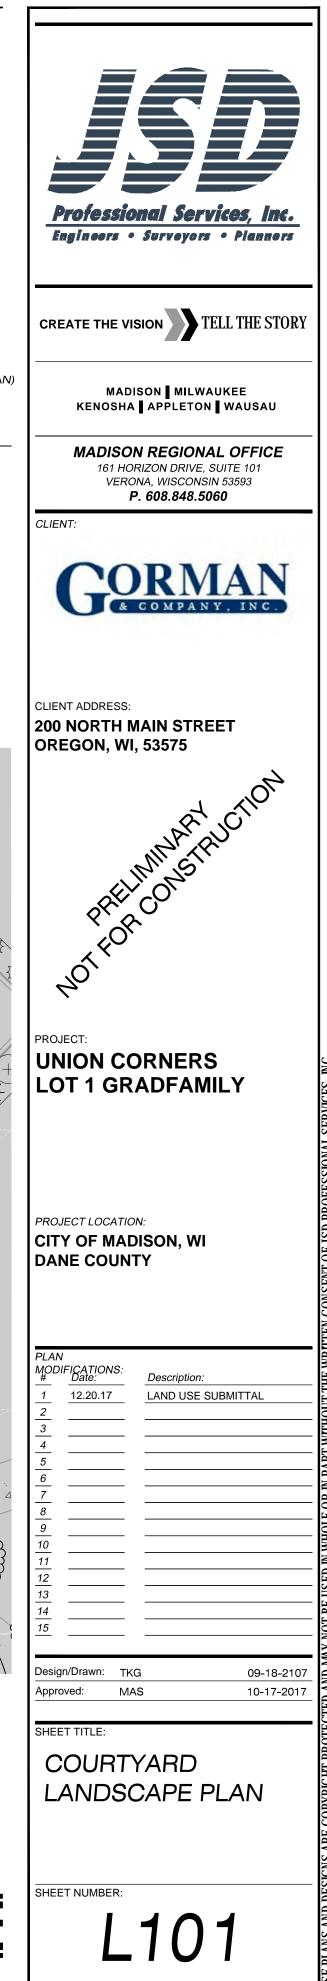
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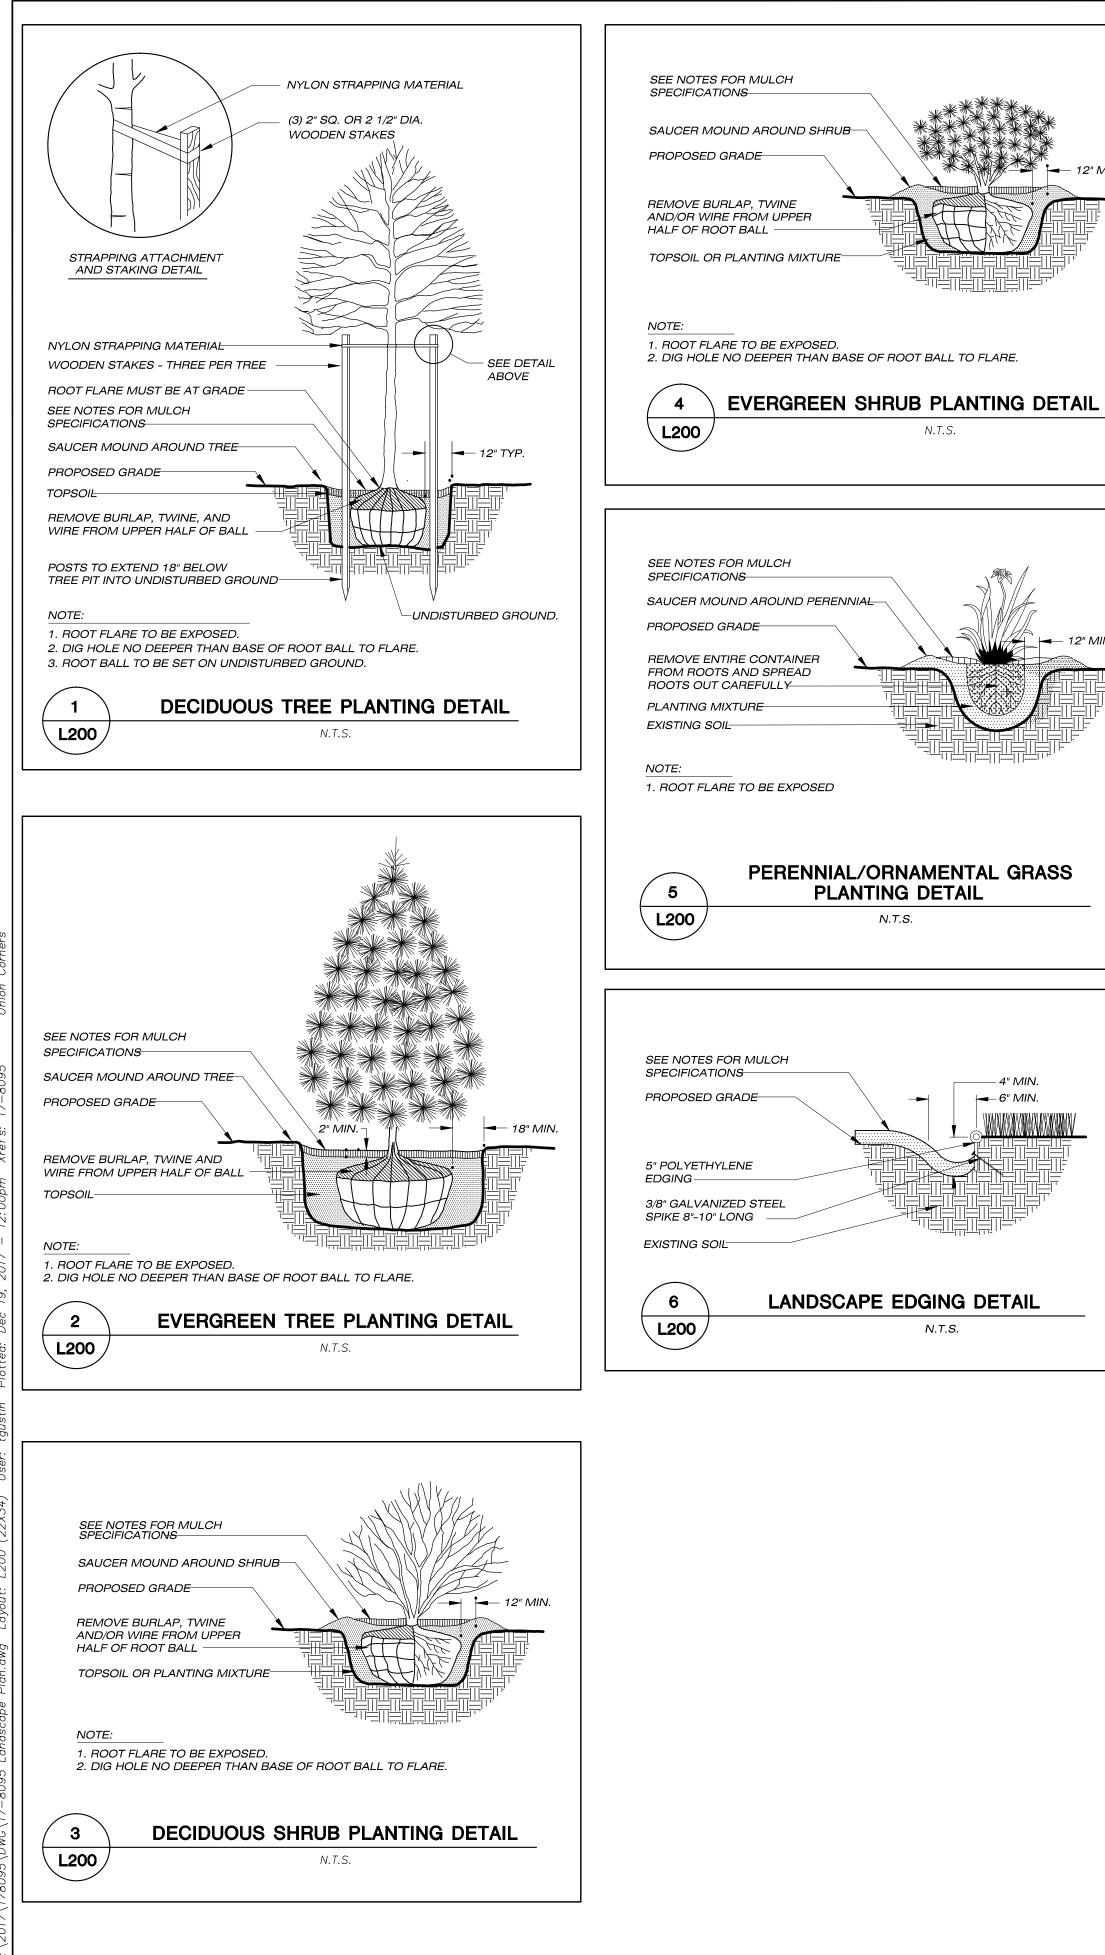
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JSD PROJECT NO:

PL 12







			GEN
	-	CITY OF MADISON LANDSCAPE WORKSHEET	1. G S C C N C R
Madison	5	Section 28,142 Madison General Ordinance	2. D A
	A Day of		
	Address UNION CORNERS, M		
	GORMAN -GRAND FAMILY DE	EVELOMENT	
Owner / Contact			
Contact Phone	(608) 848-5060	Contact Email JUSTIN.FRAHM@JSDINC.COM	
		eater than ten thousand (10,000) square feet in size a registered landscape architect. **	3. N S U D
Applicability		at a such dissection control in the disc of the constant of the fatter	Т
buildings, structur their accessory stru	es and parking lots, except the con actures. The entire development site	ction and development activity, including the expansion of existing istruction of detached single-family and two-family dwellings and must be brought up to compliance with this section unless <b>all</b> of the sected areas need to be brought up to compliance:	B H P S
(a) The ar	ea of site disturbance is less than te	n percent (10%) of the entire development site during any ten-(10)	
year p	eriod.		4. P
(b) Gross	floor area is only increased by ten pe	ercent (10%) during any ten-(10) year period.	s
(c) No den	nolition of a principal building is inv	volved.	
	and the second	be replaced on the site and shown on a revised landscaping plan.	
Required landscap defined as that an docking/loading fa such as athletic fi	rea within a single contiguous bor cilities, but excluding the area of a	upon the total developed area of the property. Developed area is undary which is made up of structures, parking, driveways and ny building footprint at grade, land designated for open space uses on the same zoning lot. There are three methods for calculating Zoning District.	5. C M T C U
	l lots except those described in (b) a nundred (300) square feet of develop	and (c) below, five (5) landscape points shall be provided for each	LAN
Te	stal square footage of developed area	29.288	1. N
		489	
10	otal landscape points required		2. P
		s shall be provided at five (5) points per three hundred (300) square and one (1) point per one hundred (100) square feet for all additional	L. L A F
Tc	otal square footage of developed area	1	3. N
	ve (5) acres = $217,800$ square feet		S A C
Fi	rst five (5) developed acres = $3,630$	points	
Re	mainder of developed area		3. N
Te	otal landscape points required		E A

(c) For the Industrial - Limited (IL) and Industrial - General (IG) districts, one (1) point shall be provided per one hundred (100) square feet of developed area.

Total square footage of developed area Total landscape points required

#### 10/2013

#### **Tabulation of Points and Credits**

Use the table to indicate the quantity and points for all existing and proposed landscape elements.

	Minimum Size at			Existing caping		roposed caping
Plant Type/ Element	Installation	Points	Quantity	Points Achieved	Quantity	Points Achieved
Overstory deciduous tree	2 <sup>1</sup> / <sub>2</sub> inch caliper measured diameter at breast height (dbh)	35			22	770
Tall evergreen tree (i.e. pine, spruce)	5-6 feet tall	35				
Ornamental tree	1 1/2 inch caliper	15			35	525
Upright evergreen shrub (i.e. arborvitae)	3-4 feet tall	10				
Shrub, deciduous	#3 gallon container size, Min. 12"-24"	3			80	240
Shrub, evergreen	#3 gallon container size, Min. 12"-24"	4			33	132
Ornamental grasses/ perennials	#1 gallon container size, Min. 8"-18"	2			575	1150
Ornamental/ decorative fencing or wall	n/a	4 per 10 lineal ft.				
Existing significant specimen tree	Minimum size: 2 ½ inch caliper dbh. *Trees must be within developed area and cannot comprise more than 30% of total required points.	14 per caliper inch dbh. Maximum points per tree: 200				
Landscape furniture for public seating and/or transit connections	* Furniture must be within developed area, publically accessible, and cannot comprise more than 5% of total required points.	5 points per "seat"				
Sub Totals						2,817

Total Number of Points Provided 2,817

\* As determined by ANSI, ANLA- American standards for nursery stock. For each size, minimum plant sizes shall conform to the specifications as stated in the current American Standard for Nursery Stock.

#### AL NOTES

- L BE HELD HARMLESS AND DOES NOT WARRANT ANY DEVIATIONS BY THE OWNER/CONTRACTOR FROM THE APPROVED. STRUCTION PLANS THAT MAY RESULT IN DISCIPLINARY ACTIONS BY ANY OR ALL REGULATORY AGENCIES. LOCATE ALL UTILITIES R TO CONSTRUCTION. THE CONTRACTOR IS RESPONSIBLE FOR REPAIRING ANY DAMAGE DONE TO UTILITIES. CONTRACTOR MUST . 1-800-382-5544 FOR UTILITY LOCATIONS AT LEAST THREE DAYS PRIOR TO DIGGING. HAND DIG AND INSTALL ALL PLANTS THAT ARE R EXISTING UTILITIES. PROTECT PREVIOUSLY INSTALLED WORK OF OTHER TRADES. CONTRACTOR IS RESPONSIBLE FOR STAKING THE NT MATERIALS FOR REVIEW BY OWNER PRIOR TO DIGGING AND PLACEMENT AND SHALL COORDINATE ALL FINE GRADING AND TORATION WITH THE GRADING CONTRACTOR.
- VERY AND HANDLING: DO NOT DELIVER MORE PLANT MATERIALS THAN CAN BE PLANTED IN ONE DAY, UNLESS ADEQUATE, ROPRIATE AND SECURE STORAGE IS PROVIDED AND APPROVED BY OWNER'S REPRESENTATIVE. AT ALL TIMES, PROTECT ALL PLANT FRIALS FROM WIND AND DIRECT SUN. DELIVER PLANTS WITH LEGIBLE IDENTIFICATION LABELS. PROTECT PLANTS DURING DELIVERY DO NOT PRUNE PRIOR TO DELIVERY. ALL TREES AND SHRUBS SHALL BE PLANTED ON THE DAY OF DELIVERY; IF THIS IS NOT SIBLE, PROTECT THE PLANT MATERIALS NOT PLANTED BY STORING THEM IN A SHADED, SECURE AREA, PROTECTING THE ROOT MASS WET SOIL, MULCH, HAY OR OTHER SUITABLE MEDIUM. CONTRACTOR TO KEEP ALL PLANT MATERIALS ADEQUATELY WATERED TO /ENT ROOT DESICCATION. DO NOT REMOVE CONTAINER GROWN STOCK FROM CONTAINERS BEFORE TIME OF PLANTING. DO NOT UP CONTAINER OR BALLED PLANTS BY STEM OR ROOTS. ALL PLANTS SHALL BE LIFTED AND HANDLED FROM THE BOTTOM OF THE TAINER OR BALL. PERFORM ACTUAL PLANTING ONLY WHEN WEATHER AND SOIL CONDITIONS ARE SUITABLE IN ACCORDANCE WITH ALLY ACCEPTED BEST HORTICULTURAL PRACTICES.
- FRIALS PLANTS: ALL PLANTS SHALL CONFORM TO THE AMERICAN STANDARD FOR NURSERY STOCK ANSI Z60.1-2004. PLANTS LL BE TRUE TO SPECIES AND VARIETY SPECIFIED AND NURSERY GROWN IN ACCORDANCE WITH GOOD HORTICULTURAL PRACTICES ER CLIMATIC CONDITIONS SIMILAR TO THOSE IN THE LOCALITY OF THE PROJECT FOR AT LEAST 2 YEARS. PLANTS SHALL BE FRESHLY (DURING THE MOST RECENT FAVORABLE HARVEST SEASON). PLANTS SHALL BE SO TRAINED IN DEVELOPMENT AND APPEARANCE AS E UNQUESTIONABLY SUPERIOR IN FORM, COMPACTNESS, AND SYMMETRY. PLANTS SHALL BE SOUND, HEALTHY, VIGOROUS, WELL ICHED AND DENSELY FOLIATED WHEN IN LEAF, AND FREE OF DISEASE AND INSECTS (ADULT EGGS, PUPAE OR LARVAE). THEY SHALL HEALTHY, WELL-DEVELOPED ROOT SYSTEMS AND SHALL BE FREE FROM PHYSICAL DAMAGE OR OTHER CONDITIONS THAT WOULD /ENT THRIVING GROWTH. PLANTS SHALL BE OF THE HIGHEST QUALITY, POSSESS TYPICAL GROWTH HABITS AND FORM FOR THEIR CIES AND BE FREE OF INJURY. PARKWAY TREES AND PARKING LOT TREES SHALL HAVE A MINIMUM BRANCHING HEIGHT OF SIX (6) ABOVE THE GROUND TO ALLOW ADEQUATE VISUAL AND PHYSICAL CLEARANCE.
- NING: THE CONTRACTOR SHALL PRUNE ALL TREES AND REPAIR ANY INJURIES THAT OCCURRED DURING THE PLANTING PROCESS. BLE LEADERS, DEAD BRANCHES, AND LIMBS DAMAGED OR BROKEN DURING THE PLANTING PROCESS SHALL BE PRUNED. THIS LL BE THE ONLY PRUNING ALLOWED AT PLANTING. PRUNING SHALL CONFORM TO AMERICAN STANDARD FOR TREE CARE RATIONS, ANSI A300. PRUNE TREES IN ACCORDANCE WITH NAA GUIDELINES. DO NOT TOP TREES. PRUNE SHRUBS ACCORDING TO NDARD HORTICULTURAL PRACTICES. ON CUTS OVER 3/4" IN DIAMETER AND BRUISES OR SCARS ON BARK, TRACE THE INJURED BIUM LAYER BACK TO LIVING TISSUE AND REMOVE. SMOOTH AND SHAPE WOUNDS SO AS NOT TO RETAIN WATER. TREAT THE AREA AN APPROVED INCONSPICUOUS LATEX BASED ANTISEPTIC TREE PAINT, IF PRUNING OCCURS "IN SEASON". DO NOT PRUNE ANY OAK ES DURING THE MONTHS FROM APRIL TO OCTOBER.
- ANUP: DISPOSED OF EXCESS SOIL. REMOVE ALL CUTTINGS AND WASTE MATERIALS. SOIL, BRANCHES, BINDING AND WRAPPING ERIALS, REJECTED PLANTS, OR OTHER DEBRIS RESULTING FROM ANY PLANTING SHALL BE PROMPTLY CLEANED UP AND REMOVED. WORK AREA SHALL BE KEPT SAFE AND NEAT AT ALL TIMES. UNDER NO CONDITION SHALL THE ACCUMULATION OF SOIL, BRANCHES THER DEBRIS BE ALLOWED UPON A PUBLIC PROPERTY IN SUCH A MANNER AS TO RESULT IN A PUBLIC SAFETY HAZARD. LIKEWISE, ER NO CIRCUMSTANCES SHALL ANY DEBRIS OR INCIDENTAL MATERIALS BE ALLOWED UPON ADJACENT PRIVATE PROPERTY.

#### CAPE MATERIAL NOTES

- ERIALS SOIL: PLANTING SOIL SHALL MEET THESE REQUIREMENTS: A. PLANTING AREAS = 24" B. TREE PITS = SEE DETAILS
- ITING SOIL TO BE A MINIMUM 24" DEPTH, UNLESS OTHERWISE SPECIFIED AS ABOVE OR ON DETAILS. TOPSOIL TO BE CLEAN, FRIABLE M FROM A LOCAL SOURCE, FREE FROM STONES OR DEBRIS OVER 3/4" IN DIAMETER, AND FREE FROM TOXINS. TOPSOIL SHALL HAVE VALUE BETWEEN 6 AND 7. TOPSOIL AND PLANTING SOIL SHALL BE TESTED TO CONFORM TO THESE SPECIFICATIONS AND SHALL BE NDED TO MEET THESE SPECIFICATIONS. PROVIDE TEST RESULTS TO OWNER'S REPRESENTATIVE PRIOR TO PLACEMENTDO NOT PLACE ZEN OR MUDDY TOPSOIL. APPLY SOIL AMENDMENTS TO ALL LANDSCAPE AREAS PER SOIL TEST.
- FRIALS SHREDDED HARDWOOD BARK MULCH: ALL PLANTING AREAS LABELED ON PLAN SHALL RECEIVE CERTIFIED WEED FREE EDDED HARDWOOD BARK MULCH OVER ALL PLANTING AREAS. SHREDDED HARDWOOD BARK MULCH SIZE & COLOR TO BE ROVED BY OWNER'S REPRESENTATIVE PRIOR TO INSTALLATION. FERTILIZER SHALL BE IN ACCORDANCE WITH APPLICABLE LOCAL, NTY AND STATE OF WISCONSIN REQUIREMENTS. SHREDDED HARDWOOD BARK MULCH AREAS SHALL NOT RECEIVE WOVEN WEED RIER FABRIC.
- CK GRANITE. SIZE & COLOR TO BE APPROVED BY OWNER'S REPRESENTATIVE PRIOR TO INSTALLATION. CRUSHED BLACK GRANITE AS SHALL RECEIVE WOVEN WEED BARRIER FABRIC.
- 4. MATERIALS TREE & SHRUB RINGS: ALL TREES AND/OR SHRUBS PLANTED IN SEEDED LAWN AREAS TO BE INSTALLED WITH A MINIMUM 5' DIAMETER SHREDDED HARDWOOD BARK MULCH TREE RING SPREAD TO A CONSISTENT DEPTH OF 4 INCHES. ALL TREE RINGS SHOULD BE INSTALLED WITH A 5" DEPTH SHOVEL CUT EDGE, ANGLED 45 DEGREES INTO SOIL AT A 5' DIAMETER ABOUT THE CENTER OF THE TREE PLANTING. A PRE-EMERGENT GRANULAR HERBICIDE WEED-PREVENTER SHOULD BE MIXED WITH MULCH USED TO INSTALL TREE RING AS WELL AS TOPICALLY APPLIED TO FINISHED INSTALLATION OF TREE RING.
- 5. MATERIALS EDGING: EDGING SHALL BE 5" DEEP, POLYETHYLENE EDGING. OWNER'S REPRESENTATIVE SHALL APPROVE PRODUCT SPECIFICATION PROVIDED BY LANDSCAPE CONTRACTOR.
- 6. MATERIALS SEED: DISTURBED LAWN AREAS LABELED ON PLAN AS SUCH, SHALL BE SPREAD BY HAND BROADCAST METHOD OR APPROPRIATE SPREADER EQUIPMENT WITH EARTH CARPET'S 'MADISON PARKS' OR EQUIVALENT AS APPROVED BY THE OWNER'S REPRESENTATIVE, INSTALLED PER MANUFACTURER'S RECOMMENDATIONS. IN ADDITION TO LAWN SEED, ANNUAL RYE SHALL BE APPLIED TO ALL DISTURBED AREAS AT A RATE OF 1 1/2 LBS PER 1000 SQUARE FEET. FERTILIZE AND MULCH PER MANUFACTURER'S RECOMMENDATIONS
- MATERIALS BIORETENTION BASIN/PRAIRIE SEED MIX: AREAS SPECIFIED ON PLAN TO BE BROADCAST SEEDED WITH "DIVERSE PRAIRIE FOR MEDIUM SOILS" SEED MIX, AS PROVIDED BY PRAIRIE NURSERY, P.O. BOX 306, WESTFIELD, WISCONSIN, 53964, TEL. 608-296-3679 (OR APPROVED EQUIVALENT). INSTALL SEED WITH SUPPLEMENTAL MATERIALS AND AMENDMENTS AS RECOMMENDED BY SEED SUPPLIER AND AT RATES AND OPTIMUM TIMES OF THE YEAR AS RECOMMENDED BY THE SEED SUPPLIER TO ENSURE SUCCESSFUL GERMINATION AND SEED/ROOT ZONE GROWTH DEVELOPMENT. REFER TO PRODUCT SPECIFICATIONS AND MANUFACTURERS RECOMMENDATIONS FOR INSTALLATION.


#### CONTRACTOR AND OWNER RESPONSIBILITY NOTES

- GUARANTEE: THE CONTRACTOR SHALL GUARANTEE ALL PLANTS THROUGH ONE (1) YEAR AFTER ACCEPTANCE BY THE OWNER'S REPRESENTATIVE. PLANTS SHALL BE ALIVE AND IN HEALTHY AND FLOURISHING CONDITION AT THE END OF THE GUARANTEE PERIOD. THE CONTRACTOR SHALL REPLACE (AT NO COST TO OWNER) ANY PLANTS THAT ARE DEAD OR NOT IN A VIGOROUS THRIVING CONDITION. REPLACEMENT PLANTS SHALL BE OF THE SAME KIND AND SIZE AS ORIGINALLY SPECIFIED UNLESS OTHERWISE DIRECTED BY OWNER'S REPRESENTATIVE. RESTORE BEDS AS NECESSARY FOLLOWING PLANT REPLACEMENT, INCLUDING BUT NOT LIMITED TO BEDDING, EDGING, MULCH, ETC. REPLACE PLANTS DAMAGED AT TIME OF PLANTING. REPAIR AREAS DISTURBED IN ANY WAY DURING PLANT REPLACEMENT AT NO COST TO OWNER. CONTRACTOR SHALL PROVIDE A TWO (2)-YEAR STRAIGHTENING GUARANTEE FOR ALL TREES.
- CONTRACTOR IS RESPONSIBLE FOR STAKING THE PLANT MATERIALS FOR REVIEW BY OWNER'S REPRESENTATIVE PRIOR TO DIGGING AND PLACEMENT AND SHALL COORDINATE ALL FINE GRADING AND RESTORATION WITH THE GRADING CONTRACTOR.
- MAINTENANCE: (CONTRACTOR) FOR ALL PLANTINGS, SEEDED LAWN AREAS: THE CONTRACTOR SHALL MAINTAIN ALL PLANTINGS AND LAWN AREAS FOR A MINIMUM TIME PERIOD OF 60 DAYS, UNTIL FINAL ACCEPTANCE BY OWNER'S REPRESENTATIVE. THE CONTRACTOR IS RESPONSIBLE FOR ADEQUATELY WATERING PLANTS AND LAWN/TURFGRASS DURING THIS 60 DAY ESTABLISHMENT PERIOD. CONTRACTOR IS RESPONSIBLE FOR THE ESTABLISHMENT OF HEALTHY VIGOROUS PLANT MATERIALS AND LAWN/TURFGRASS GROWTH. CONTRACTOR IS ALSO RESPONSIBLE FOR ANY PRUNING OF PLANT MATERIALS, AND SHAPING AND/OR REPLACEMENT OR SUPPLEMENT OF DEFICIENT SHREDDED HARDWOOD BARK MULCH DURING THIS PERIOD. LONG TERM PLANT MATERIALS AND LAWN/TURFGRASS MAINTENANCE AND ANY PROGRAM FOR SUCH IS THE RESPONSIBILITY OF THE OWNER. ALL PLANTINGS AND LAWN/TURFGRASS AREAS SHALL BE MAINTAINED IN A MANICURED CONDITION UNTIL THE TIME WHEN THE OWNER'S ACCEPTANCE IS GIVEN.
- MAINTENANCE: (OWNER) THE OWNER IS RESPONSIBLE FOR THE CONTINUED MAINTENANCE, REPAIR AND REPLACEMENT OF ALL

ERAL: ALL WORK IN THE R-O-W AND PUBLIC EASEMENTS SHALL BE IN ACCORDANCE WITH LOCAL MUNICIPAL REQUIREMENTS. JSD

ERIALS - CRUSHED BLACK GRANITE: ALL PLANTING AREAS LABELED ON PLAN IN PLAZA AREA SHALL RECEIVE 2" DEPTH OF CRUSHED

LANDSCAPING MATERIALS AND WEED BARRIER FABRIC AS NECESSARY FOLLOWING THE ONE (1) YEAR CONTRACTOR GUARANTEE PERIOD.

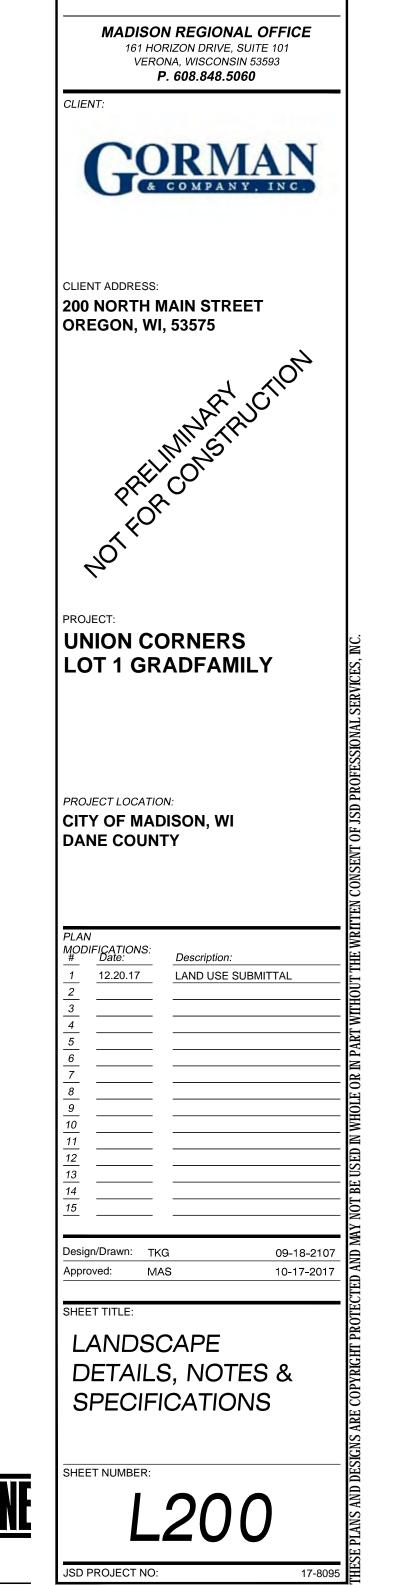

Professional Services, Inc.

Engineers • Surveyors • Planners


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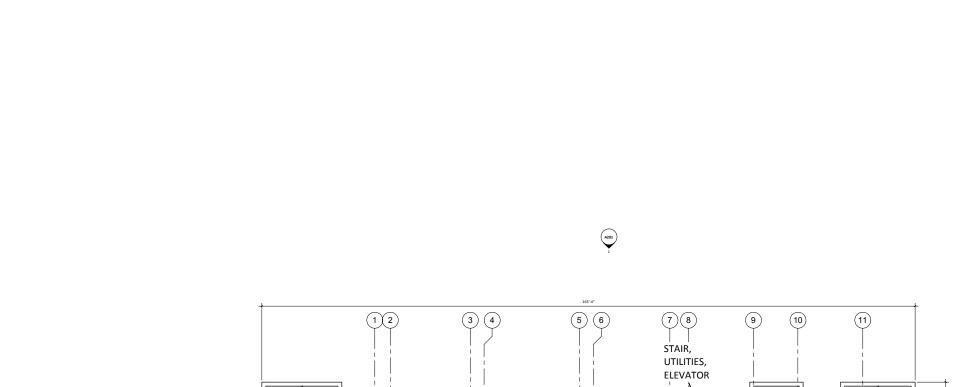
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AREA TABLE         PARCEL       SQUARE FEET       ACRES         A       248,815       5.712         B       3,360       0.077         C       57,203       1.313         D       22,826       0.524         E       27,018       0.620         F       5,455       0.125         G       137,970       3.167         H       12,027       0.276	$\begin{array}{c c c c c c c c c c c c c c c c c c c $	TABLEELTACHORDCHORD BEARING'22'11"1033.48'S'5'28"100.55'S84'39'53"W06'43"934.95'S72'58'48"W34'54"102.57'N80'58'31"E'57'10"131.04'N86'17'23"E'41'03"16.32'N33'10'30"E'52'38"105.71'N21'34'58"E'52'22"69.44'S23'04'50"W07'31"9.69'S50'04'47"W25'03"35.31'S55'13'33"W'44'46"26.26'S80'18'28"W
$ \begin{array}{ c c c c c c c c c c c c c c c c c c c$	$\begin{array}{c ccccccccccccccccccccccccccccccccccc$	$44 + 60$ $20.20$ $3 - 80 + 18 + 28$ $W$ $551'18''$ $40.77'$ $N - 78^{\circ}23'30''$ $W$ $51'18''$ $6.47'$ $N - 38^{\circ}50'02''$ $W$ $42'09''$ $30.49'$ $N - 19'08'51'' E$ $T7'21''$ $62.12'$ $S - 84^{\circ}36'04''$ $W$ $34'29'''$ $75.33'$ $N - 32^{\circ}25'30'' E$ $27'35'''$ $69.63'$ $S - 78^{\circ}41'48'' E$ $27'35'''$ $69.63'$ $S - 78^{\circ}41'48'' E$ $25'54''''$ $19.40'$ $S - 48'07'53'' E$ $256'17''''$ $30.91''$ $S - 64' 39'52'' E$ $103'47'''$ $99.90'$ $S - 74'23'39'' E$ $103'47''''$ $99.90''$ $S - 74'23''39'' E$ $11'43''''''''''''''''''''''''''''''''''$
$ \begin{array}{ c c c c c c c c c c c c c c c c c c c$	RCP         STORM         SEWER           RCP         STRUCT. ID         RIM ELEVATION         INVERT           RCP         STM-1         861.82         S           RCP         STM-1         861.82         S           RCP         STM-1         861.82         S           RCP         STM-2         862.01         SE           HDPE         STM-2         862.01         SE           RCP         STM-3         861.54         SE           RCP         STM-3         861.54         SE           RCP         STM-4         861.40         SW           RCP         STM-4         861.43         S           RCP         STM-5         861.43         SE	MANHOLES         ELEVATION PIPE SIZE PIPE TYPE         853.02       18"       RCP         853.47       18"       RCP         853.57       18"       RCP         856.91       12"       RCP         856.51       15"       RCP         853.46       18"       RCP         853.46       18"       RCP         854.34       15"       RCP         853.74       18"       RCP         857.90       15"       RCP         857.70       18"       RCP         856.53       18"       RCP         850.54       16"       860.8
INL-23       859.23       SW       857.18       12"         INL-24       859.28       NE       857.18       12"         INL-25       860.14       SW       858.44       8"         INL-26       860.01       SW       858.11       6"         INL-27       860.20       NW       855.80       24"         INL-27       860.20       NW       855.80       24"         INL-28       861.58       NW       858.13       12"         INL-29       860.63       NE       **       **         SW       ***       **       **         SW       ***       **       **	RCP         NE           RCP         STM-6         860.43         BOTTOM           PVC         STM-7         860.50         SE           HDPE         NW         NW           RCP         STM-7         860.50         SE           HDPE         NW         NW         NW           RCP         STM-8         859.96         SE           RCP         STM-8         859.96         SE           RCP         STM-9         861.40         S           RCP         STM-9         861.40         S           ***         UNABLE TO SEE PIPES         NW	856.68       18"       RCP         856.38       18"       RCP         855.30       18"       RCP         **       -       -         855.36       18"       RCP         **       **       -         855.36       **       RCP         855.36       **       RCP         855.36       **       RCP         856.96       12"       RCP         856.71       12"       RCP         855.36       **       RCP         856.00       24"       RCP         857.20       12"       RCP         856.00       24"       RCP         856.00       24"       RCP         856.00       24"       RCP



LOT 1 LOT 3

PREPARED FOR: GORMAN & COMPANY

SU F.E	PR	BOUNDARY. TOPOGRAPHIC AND UTILITY SURVEY	DRAWN BY JK	DATE 11-25-2013			
B. N		I DTS 1 AND 2 CERTIFIED SURVEY MAP No. 11774 RECORDED IN VOLLIME 72 DAGES 134-130 AS DOCUMENT No. 4106068 LOTS 1					
NO:_ EYED NO/F T NC	E E Professional Services, Inc.	AND 2. CERTIFIED SURVEY MAP No. 11835. RECORDED IN VOLUME 72. PAGES 247–251. AS DOCUMENT No. 4206575. LOTS 1 AND 2.	CHECKED BY	DATE			
PG: _	· Fanînaars • Survavars • Dinnars	CERTIFIED SURVEY MAP No. 12130, AS RECORDED IN VOLUME 74, PAGES 389–391, ÁS DOCUMENT No. 4301167, ALL OF VACATED	AL I	11-2/-2013			
4		FLORENCE STREET, ALL OF VACATED SULLIVAN STREET, THAT PART OF WINNEBAGO STREET VACATED PER CITY OF MADISON	APPROVED BY	DATE			
	G 161 HORIZON DRIVE, SUITE 101	ENACTMENT No. RES-06-00599, AND THAT PART OF MILWAUKEE STREET VACATED PER CITY OF MADISON ENACTMENT No.	ГdH	11-27-2013			
2 76 6	C VERONA, WISCONSIN 53593 PHONE: (608)848–5060	RES-06-00854, LOCATED IN THE SOUTHEAST QUARTER OF THE NORTHEAST QUARTER, THE SOUTHWEST QUARTER OF THE NORTHEAST	DWGNAME				
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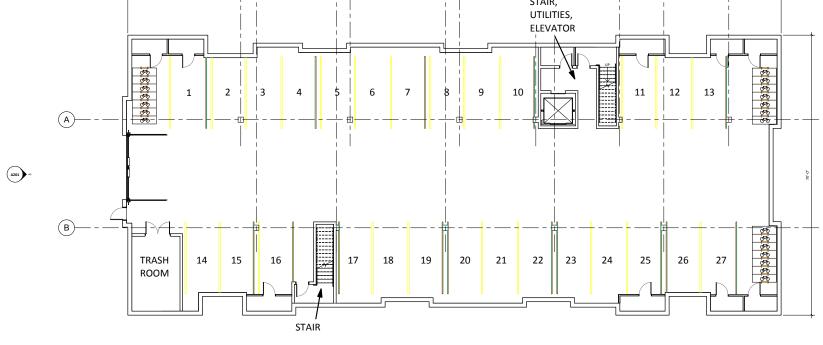
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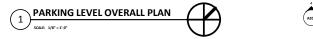
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REAL ESTATE DEVELOPMENT & MANAGEMENT 200 N. MAIN STREET OREGON, WI 53575
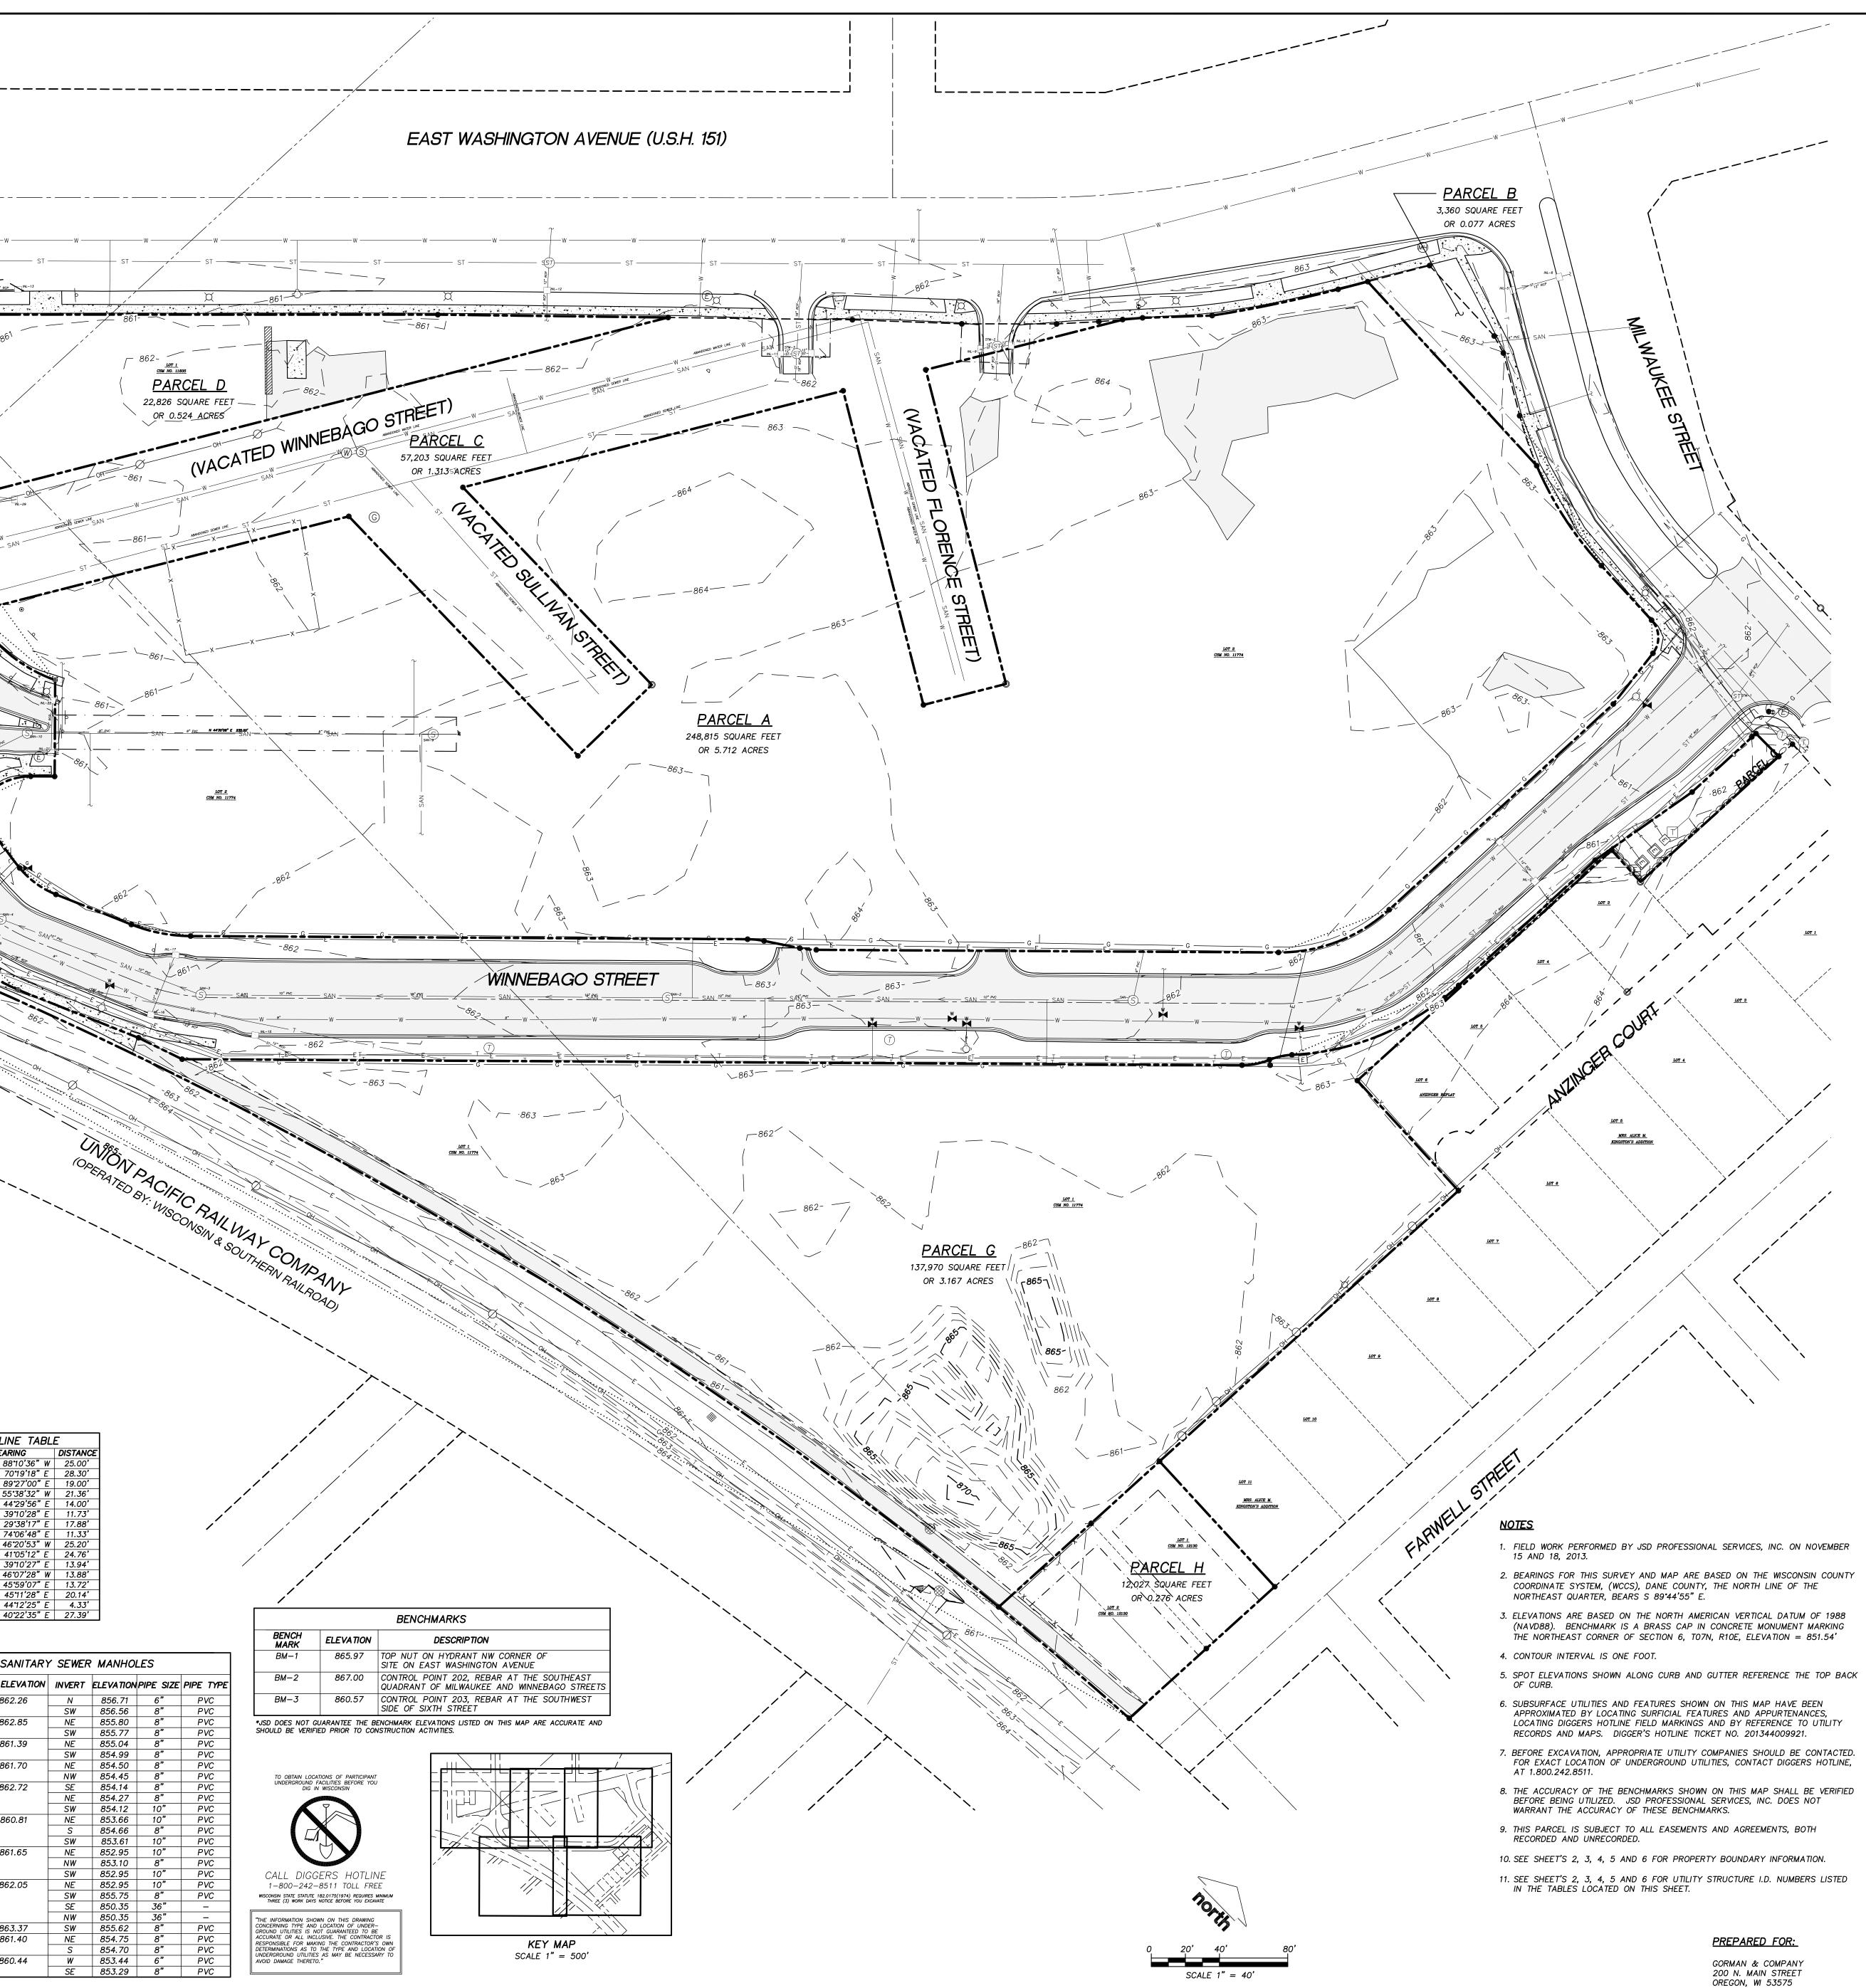
# GRAND FAMILY - BUILDING #6 at UNION CORNERS WINNEBAGO STREET MADISION, WI 53704

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Issue Description

Sheet Title PARKING LEVEL PLAN -OVERALL





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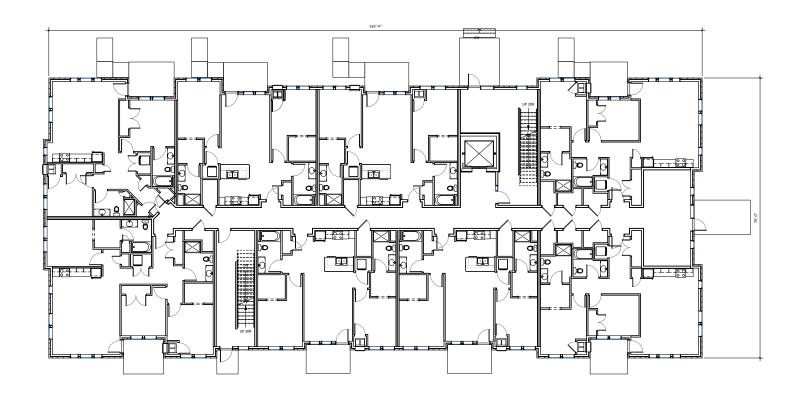
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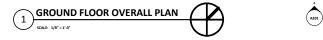
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REAL ESTATE DEVELOPMENT & MANAGEMENT 200 N. MAIN STREET OREGON, WI 53575

# GRAND FAMILY - BUILDING #6 at UNION CORNERS WINNEBAGO STREET MADISION, WI 53704

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Issue Description

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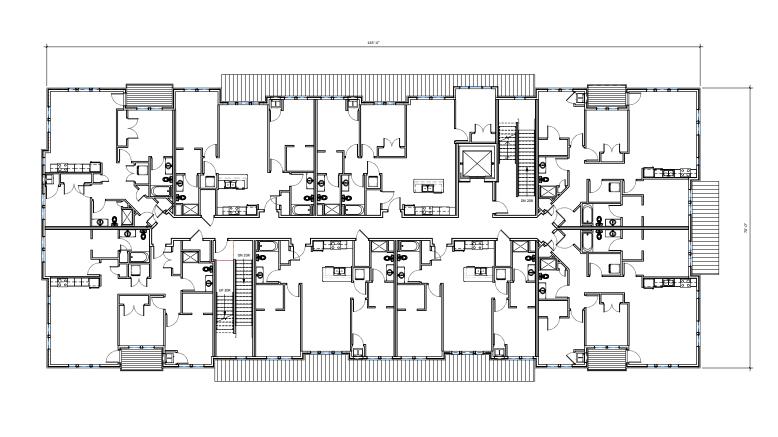
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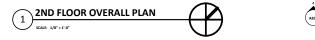
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# GRAND FAMILY - BUILDING #6 at UNION CORNERS WINNEBAGO STREET MADISION, WI 53704

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Plot Date:	12/20/2017 9:31:35 AM
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Issue Description

Sheet Title 2ND FLOOR PLAN -OVERALL



SCALE: 1/8" = 1'-0"







SOUTH ELEVATION  $\left(\begin{array}{c}4\end{array}\right)$ SCALE: 1/8" = 1'-0"



REAL ESTATE DEVELOPMENT & MANAGEMENT 200 N. MAIN STREET OREGON, WI 53575



# GRAND FAMILY - BUILDING #6 at UNION CORNERS WINNEBAGO STREET MADISION, WI 53704

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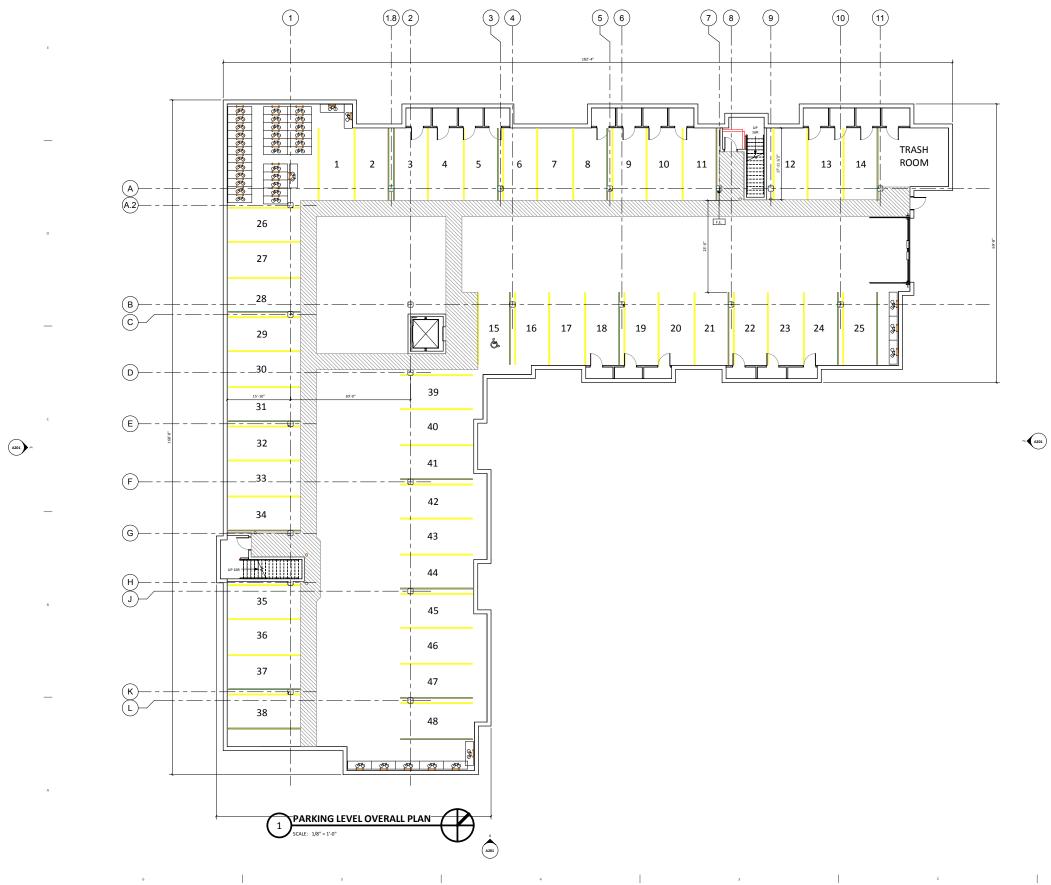
#### Sheet Title EXTERIOR BUILDING

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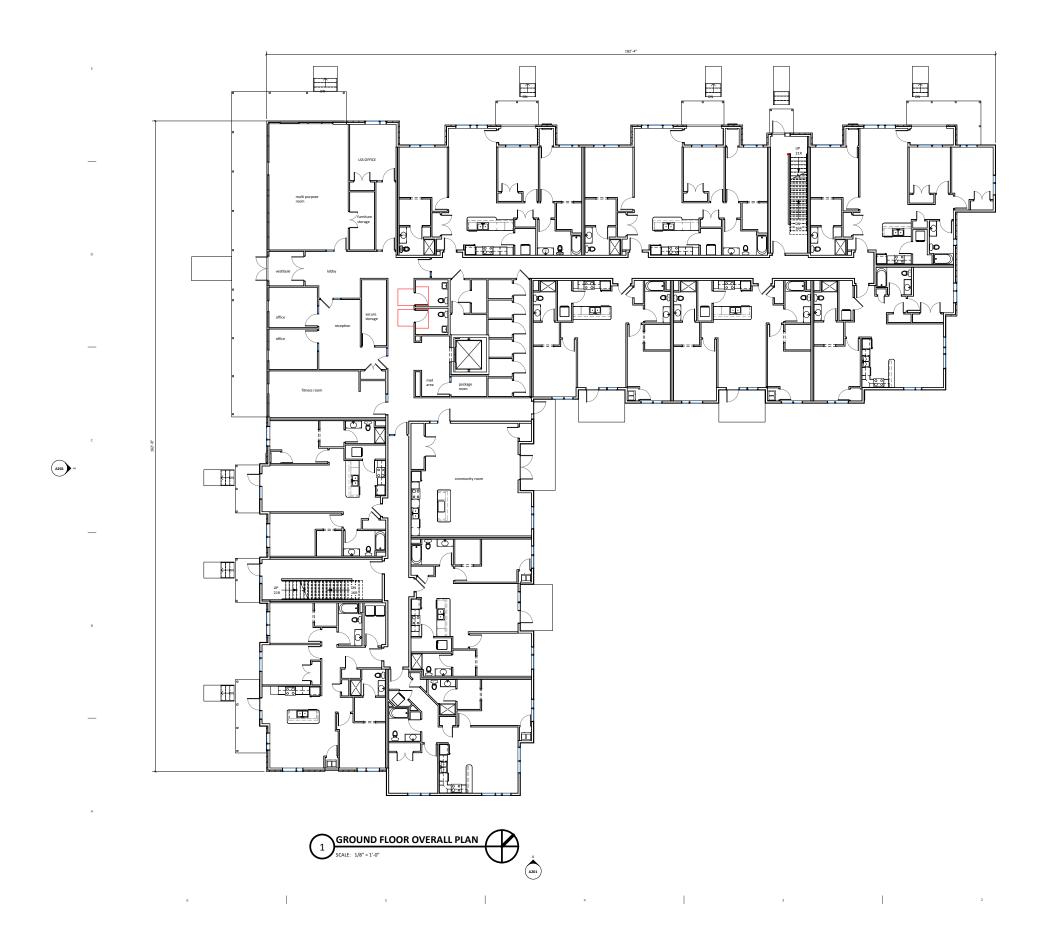
# GRAND FAMILY - BUILDING #7 at UNION CORNERS WINNEBAGO STREET MADISON, WI 53704

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Sheet Title PARKING LEVEL PLAN -OVERALL

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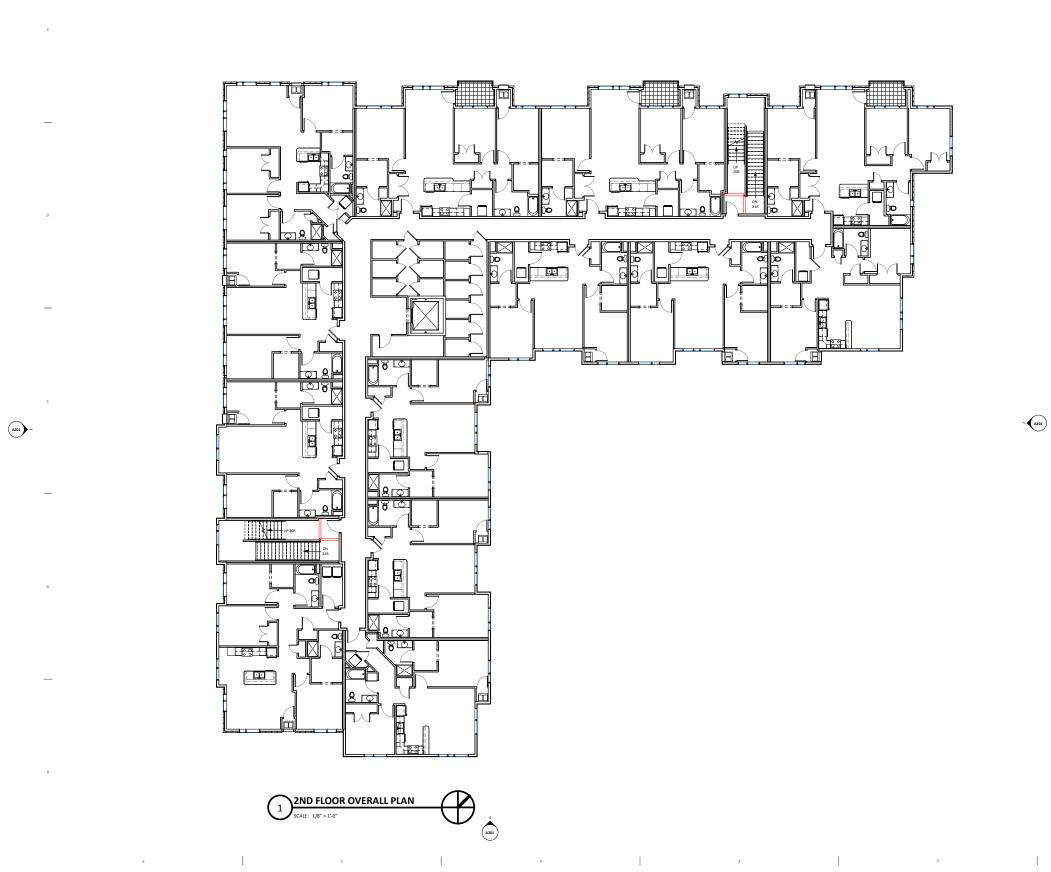
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## GRAND FAMILY - BUILDING #7 at UNION CORNERS WINNEBAGO STREET MADISON, WI 53704

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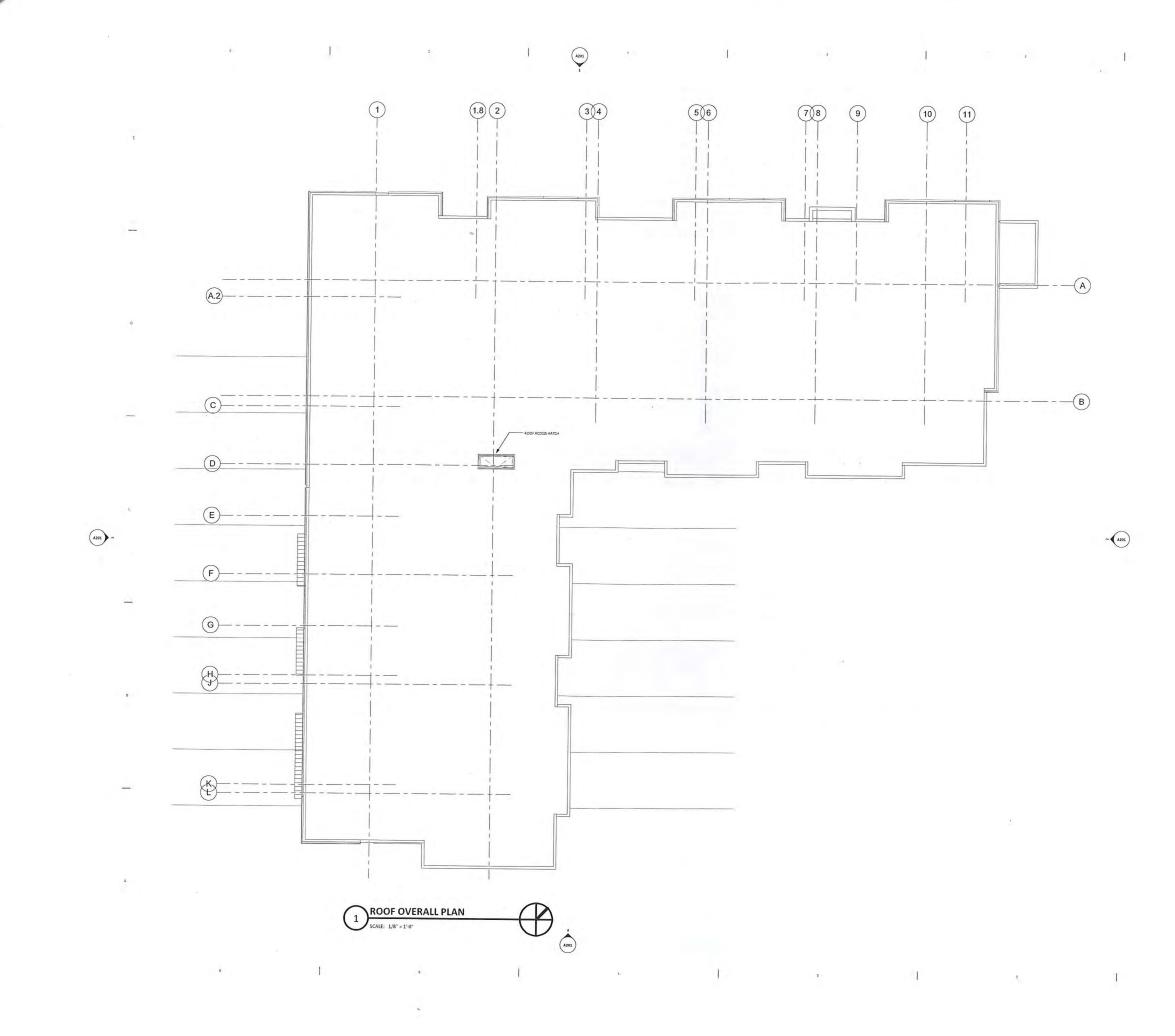
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# GRAND FAMILY - BUILDING #7 at UNION CORNERS WINNEBAGO STREET MADISON, WI 53704

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Sheet Title 2ND FLOOR PLAN -OVERALL





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GRAND FAMILY - BUILDING #7 at UNION CORNERS WINNEBAGO STREET MADISON, WI 53704

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ROOF PLAN - OVERALL


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Sheet Title EXTERIOR BUILDING ELEVATIONS



NORTH ELEVATION

SCALE: 1/8" = 1'-0"

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4 SOUTH ELEVATION SCALE: 1/8" = 1'-0"

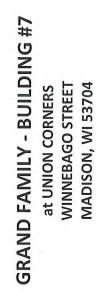

REAL ESTATE DEVELOPMENT ( MANAGEMENT 200 N. MAIN STREET OREGON, WI 53575



### GRAND FAMILY - BUILDING #6 at UNION CORNERS WINNEBAGO STREET MADISION, WI 53704

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REAL ESTATE DEVELOPMENT & MANAGEMENT 200 N. MAIN STREET OREGON, WI 53575

## GRAND FAMILY - BUILDING #7 at UNION CORNERS WINNEBAGO STREET MADISON, WI 53704

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