SCHEMATIC DESIGN 827 E GORHAM ST

827 E GORHAM ST MADISON WI 53703

KAHLER SLATER PROJECT: 217014.00 01/31/18

GENER	AL SHEET INDEX
Sheet Number	Sheet Name
G000	COVER SHEET
CIVIL S	HEET INDEX
Sheet Number	Sheet Name
C-1.0	EXISTING CONDITIONS
C-2.0	DEMOLITION PLAN
C-3.0	SITE PLAN
C-4.0	GRADING PLAN
C-5.0	UTILITY PLAN
	CAPE SHEET INDEX
Sheet Number	Sheet Name
Sheet Number L-1.0	Sheet Name
Sheet Number L-1.0 ELECTI Sheet Number	Sheet Name LANDSCAPE PLAN
Sheet Number L-1.0 ELECTI	Sheet Name LANDSCAPE PLAN RICAL SHEET INDEX
Sheet Number L-1.0 ELECTI Sheet Number E-1.0	Sheet Name LANDSCAPE PLAN RICAL SHEET INDEX Sheet Name
Sheet Number L-1.0 ELECTI Sheet Number E-1.0	Sheet Name LANDSCAPE PLAN RICAL SHEET INDEX Sheet Name LIGHTING PLAN FECTURAL SHEET INDEX
Sheet Number L-1.0 ELECTI Sheet Number E-1.0 ARCHIT	Sheet Name LANDSCAPE PLAN RICAL SHEET INDEX Sheet Name LIGHTING PLAN FECTURAL SHEET INDEX
Sheet Number L-1.0 ELECTI Sheet Number E-1.0 ARCHIT Sheet Number A101 A102	Sheet Name LANDSCAPE PLAN RICAL SHEET INDEX Sheet Name LIGHTING PLAN FECTURAL SHEET INDEX Sheet Name T25 E JOHNSON - FLOOR PLANS & PHOTOS 725 E JOHNSON - ELEVATIONS
Sheet Number L-1.0 ELECTI Sheet Number E-1.0 ARCHI Sheet Number A101	Sheet Name LANDSCAPE PLAN RICAL SHEET INDEX Sheet Name LIGHTING PLAN FECTURAL SHEET INDEX Sheet Name TECTURAL SHEET INDEX Sheet Name 725 E JOHNSON - FLOOR PLANS & PHOTOS



Copyright © 2018 Kahler Slater, Inc. All rights reserved. 111 West Wisconsin Avenue, Milwaukee, Wisconsin 53203 Telephone 414.272.2000 Fax 414.272.2001 44 East Mifflin Street, Suite 700, Madison, Wisconsin 53703 Telephone 608.283.6300 Fax 608.283.6317 Sheet No. GOOO

Project No. 700 EAST LLC 217014.00 Sheet Title COVER SHEET

827 E GORHAM ST MADISON WI 53703


827 E GORHAM ST

Drawing Date 01/31/2018

SCOPE DOCUMENTS

SCHEMATIC DESIGN



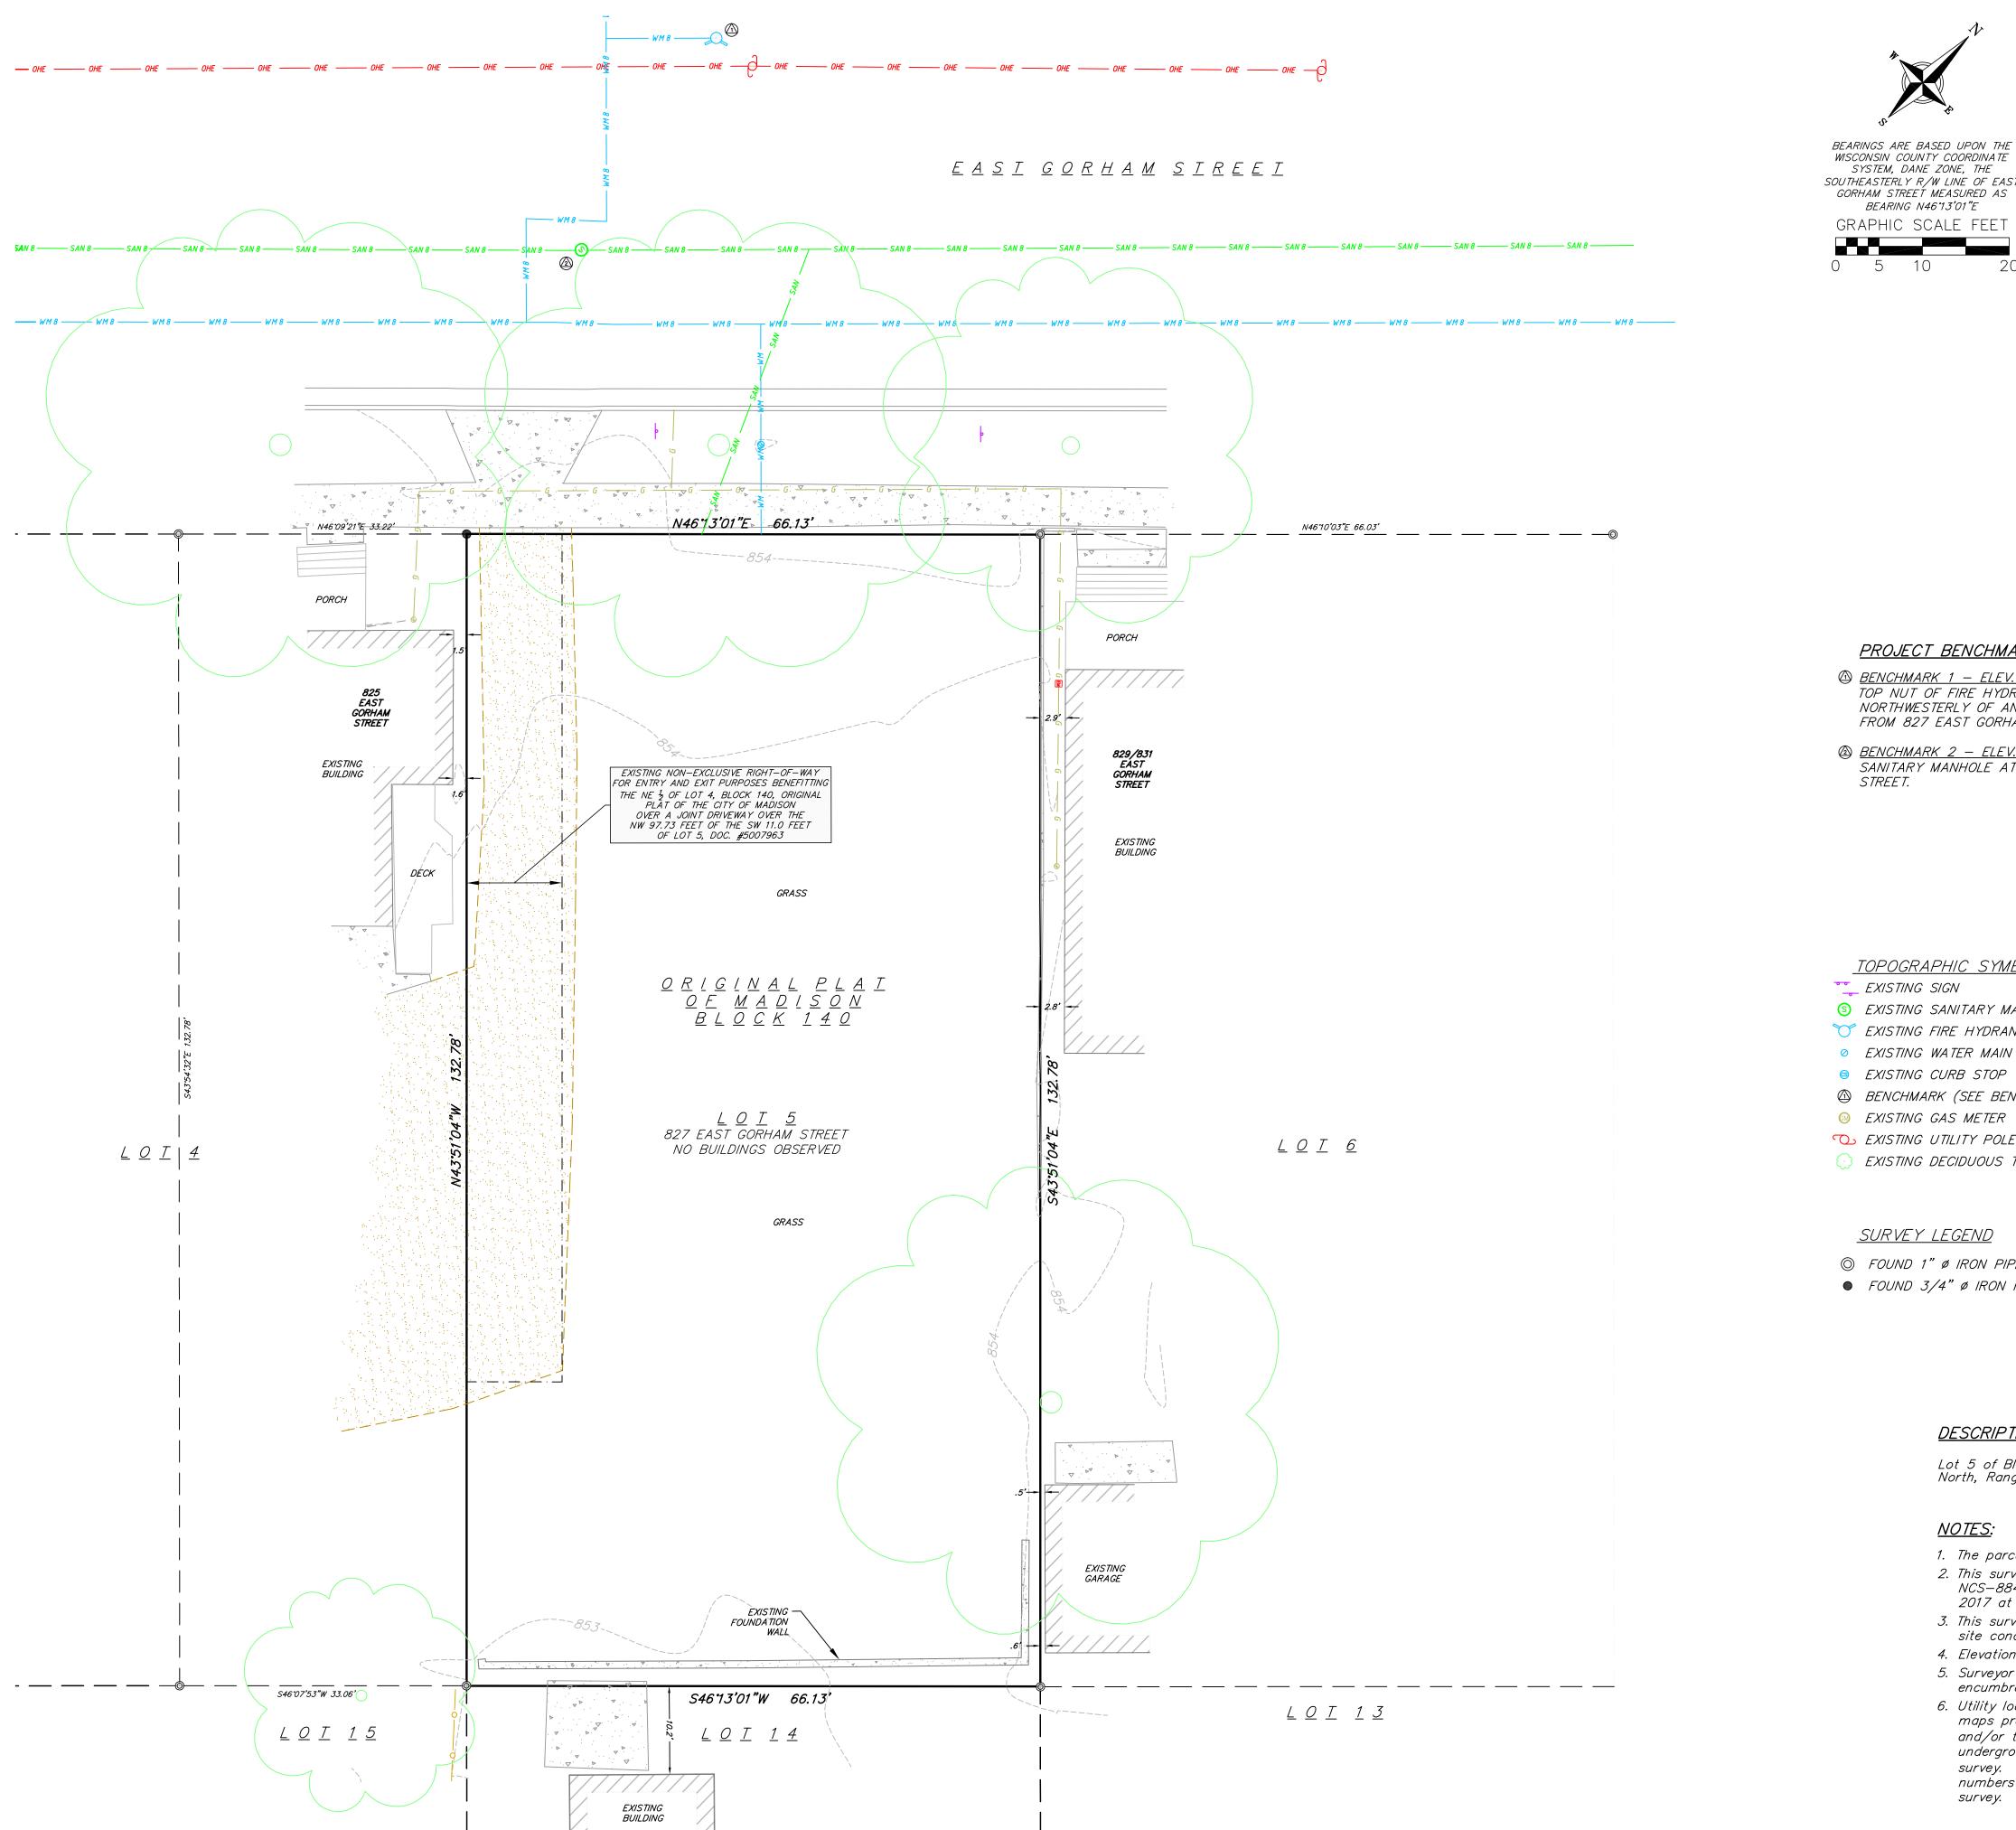

WISCONSIN COUNTY COORDINATE SYSTEM, DANE ZONE, THE SOUTHEASTERLY R/W LINE OF EAST GORHAM STREET MEASURED AS GRAPHIC SCALE FEET

PROJECT BENCHMARK:

- TOP NUT OF FIRE HYDRANT LOCATED NORTHWESTERLY OF AND ACROSS THE STREET FROM 827 EAST GORHAM STREET.
- BENCHMARK 2 ELEV. = 853.92': SANITARY MANHOLE AT 827 EAST GORHAM

TOPOGRAPHIC SYMBOL LEGEND

- S EXISTING SANITARY MANHOLE
- C EXISTING FIRE HYDRANT
- EXISTING WATER MAIN VALVE
- S EXISTING CURB STOP
- BENCHMARK (SEE BENCHMARK NOTES)
- In EXISTING GAS METER
- C EXISTING UTILITY POLE
- EXISTING DECIDUOUS TREE

SURVEY LEGEND

- ◎ FOUND 1" Ø IRON PIPE
- FOUND 3/4" Ø IRON ROD

DESCRIPTION:

<u>NOTES:</u>

- 2017 at 7:00 a.m

- survey.

Kahler Slater

vierbicher planners engineers advisors Phone: (800) 261-3898 Vierbicher Project No.: 107109





Dial i or (800) 242-8511

www.DiggersHotline.com

THE LOCATION OF EXISTING UTILITIES, BOTH UNDERGROUND AND OVERHEAD ARE APPROXIMATE ONLY AND HAVE NOT BEEN INDEPENDENTLY VERIFIED BY THE OWNER OR ITS REPRESENTATIVE. THE CONTRACTOR SHALL BE RESPONSIBLE FOR DETERMINING THE EXACT LOCATION OF ALL EXISTING UTILITIES WHETHER SHOWN ON THESE PLANS OR NOT, BEFORE COMMENCING WORK, AND SHALL BE FULLY RESPONSIBLE FOR ANY AND ALL DAMAGES WHICH MIGHT BE CAUSED BY THE CONTRACTOR'S FAILURE TO EXACTLY LOCATE AND PRESERVE ANY AND ALL UTILITIES.

> CALL DIGGER'S HOTLINE 1-800-242-8511

> > <u>SURVEYED FOR:</u> DCH PROPERTIES, LLC C/O SELECT PUBLISHING CHRIS HOUDEN 6417 NORMANDY LANE MADISON, WI 53719

<u>SURVEYED BY:</u> VIERBICHER ASSOCIATES, INC. BY: DAVID N. GULLICKSON 999 FOURIER DRIVE, SUITE 201 MADISON, WI 53717 (608)-821-3966

TOPOGRAPHIC LINEWORK LEGEND

_____ G _____ EXISTING GAS LINE — SAN 8 — SAN 8 — EXISTING 8" PVC SANITARY SEWER LINE ______WM _____ EXISTING 1" WATER SERVICE ----- OHE ----- EXISTING OVERHEAD ELECTRIC ---- 818 ---- EXISTING MINOR CONTOUR ——————— EXISTING PROPERTY LINE ----- PLAT BOUNDARY — — ADJOINER PROPERTY _____ ___ ___ ___ EXISTING ACCESS EASEMENT

TOPOGRAPHIC HATCHING LEGEND

CONCRETE PAVEMENT/SIDEWALK/PAD GRA VEL EXISTING BUILDING

Lot 5 of Block 140 of the Original Plat, located in the NE¼ of the SW¼ of Section 13, Township 07 North, Range 09 East, City of Madison, Dane County, Wisconsin.

1. The parcel surveyed contain 0.20 Acres or 8,781 sq. ft. more or less. 2. This survey was prepared based upon information provided in the Title Commitment No. NCS-884204-MAD from First American Title Insurance Company, Effective date, December 16,

3. This survey is based upon field survey work performed ON December 22, 2017. Any changes in site conditions after December 22, 2017 are not reflected by this survey.

4. Elevations depicted on this survey are based upon NAVD88 Datum.

5. Surveyor has made no investigation or independent search for easements of record, encumbrances, restrictive covenants, or ownership title evidence.

6. Utility locations were field located based upon substantial, visible, above ground structures, upon maps provided to the surveyor, or upon markings on the ground placed by utility companies and/or their agents. No warranty is given to the utility markings by others or that all underground utilities affecting this property were marked and subsequently located for this survey. A locate request was sent to Digger's Hotline per Digger's Hotline One-Call ticket numbers 20175201038. Location of buried private utilities are not within the scope of this

NOI. NOT FOR ONSTRUC \bigcirc

Revisions Date

Description

Schematic Design

SCOPE DOCUMENTS Drawing Date

827 E GORHAM ST

700 E JOHNSON ST **MADISON, WI 53703**

01/31/2018

Project No 700 EAST LLC 217014.00

Sheet Title

EXISTING CONDITIONS


Copyright © 2018 Kahler Slater, Inc. All rights reserved.


111 West Wisconsin Avenue, Milwaukee, Wisconsin 53203 Telephone 414.272.2000 Fax 414.272.2001 44 East Mifflin Street, Suite 700, Madison, Wisconsin 53703

Telephone 608.283.6300 Fax 608.283.6317

Sheet No. C-1.0

gul@vierbicher.com	

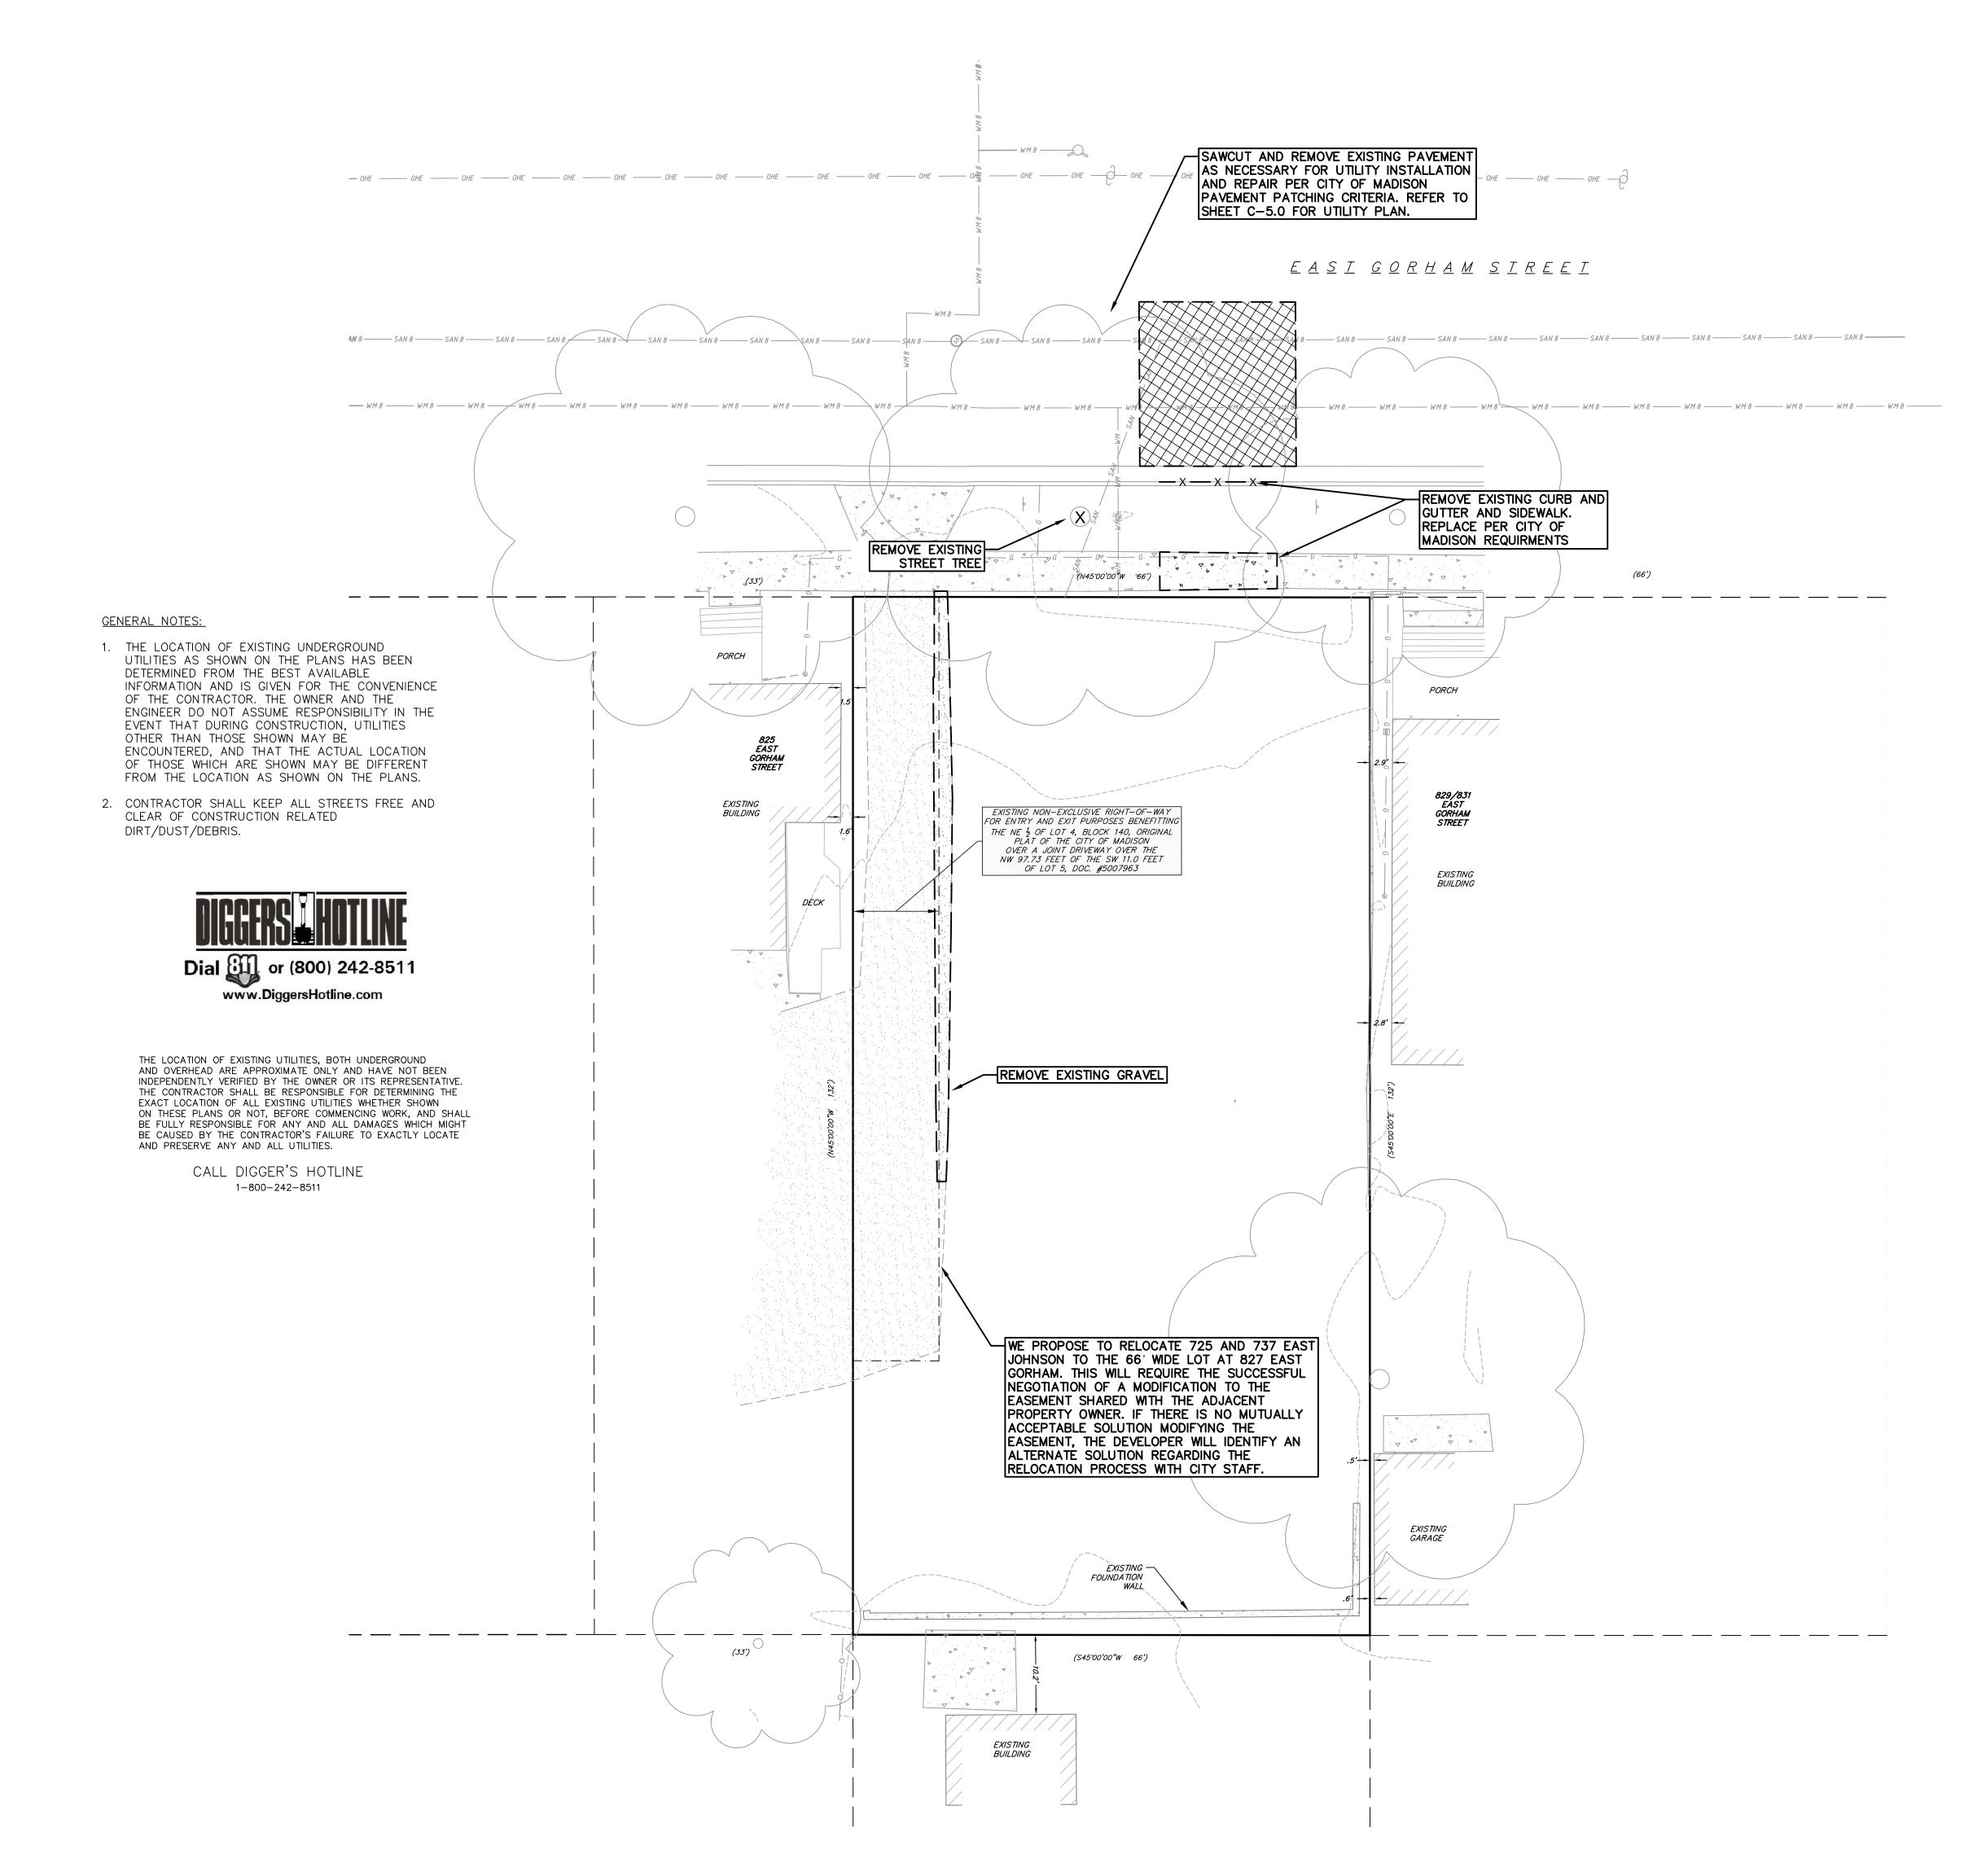

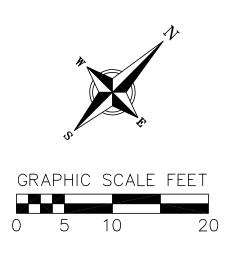

Kahler Slater experience desig

vierbicher planners engineers advisors Phone: (800) 261-3898 Vierbicher Project No.: 107109



DEMOLITION PLAN LEGEND



ASPHALT REMOVAL

CONCRETE REMOVAL

GRAVEL REMOVAL

— — — SAWCUT

TREE REMOVAL

TOPOGRAPHIC HATCHING LEGEND

CONCRETE PAVEMENT/SIDEWALK/PAD ASPHALT PAVEMENT GRA VEL EXISTING BUILDING

TOPOGRAPHIC LINEWORK LEGEND

101 0011	
——— FO ——— FO ———	EXISTING FIBER OPTIC LINE
G G	EXISTING GAS LINE
UE UE	EXISTING UNDERGROUND ELECTRIC LINE
OHE OHE	EXISTING OVERHEAD ELECTRIC
SAN 6 SAN 6	EXISTING 6" SANITARY SEWER LINE
SAN 10	EXISTING 10" SANITARY SEWER LINE
SAN 15	EXISTING 15" SANITARY SEWER LINE
ST 12 ST 12	EXISTING 12" STORM SEWER LINE
ST 18 ST 18	EXISTING 18" STORM SEWER LINE
ST 48 ST 48	EXISTING 48" STORM SEWER LINE
ST 54 ST 54	EXISTING 54" STORM SEWER LINE
WM 12 WM 12	EXISTING 12" D.I. WATER MAIN
WM 10 WM 10	EXISTING 10" D.I. WATER MAIN
	EXISTING 1" WATER SERVICE
— — <i>820</i> — —	EXISTING MAJOR CONTOUR
— — —	EXISTING MINOR CONTOUR
	EXISTING PROPERTY LINE
	PROPERTY BOUNDARY

---- ADJOINER PROPERTY

TOPOGRAPHIC SYMBOL LEGEND EXISTING SIGN

- EXISTING CURB INLET
- ST EXISTING FIELD INLET
- EXISTING STORM MANHOLE
- S EXISTING SANITARY MANHOLE
- *C EXISTING FIRE HYDRANT*
- EXISTING WATER MAIN VALVE
- 🔅 EXISTING LIGHT POLE
- EXISTING UNIDENTIFIED UTILITY VAULT
- EXISTING CURB STOP
- BENCHMARK (SEE BENCHMARK NOTES)
- EXISTING BOLLARD
- 🖂 EXISTING GAS VALVE
- EXISTING GAS METER
- EXISTING ELECTRIC METER
- C EXISTING UTILITY POLE
- EXISTING UNIDENTIFIED MANHOLE
- EXISTING POST
- EXISTING DECIDUOUS TREE



Revisions Date

Description

Schematic Design

SCOPE DOCUMENTS

Drawing Date 01/31/2018

827 E GORHAM ST

700 E JOHNSON ST MADISON, WI 53703

Project No 700 EAST LLC 217014.00

Sheet Title


DEMOLITION PLAN

Copyright © 2018 Kahler Slater, Inc. All rights reserved.

111 West Wisconsin Avenue, Milwaukee, Wisconsin 53203 Telephone 414.272.2000 Fax 414.272.2001


44 East Mifflin Street, Suite 700, Madison, Wisconsin 53703 Telephone 608.283.6300 Fax 608.283.6317

Sheet No. C-2.0

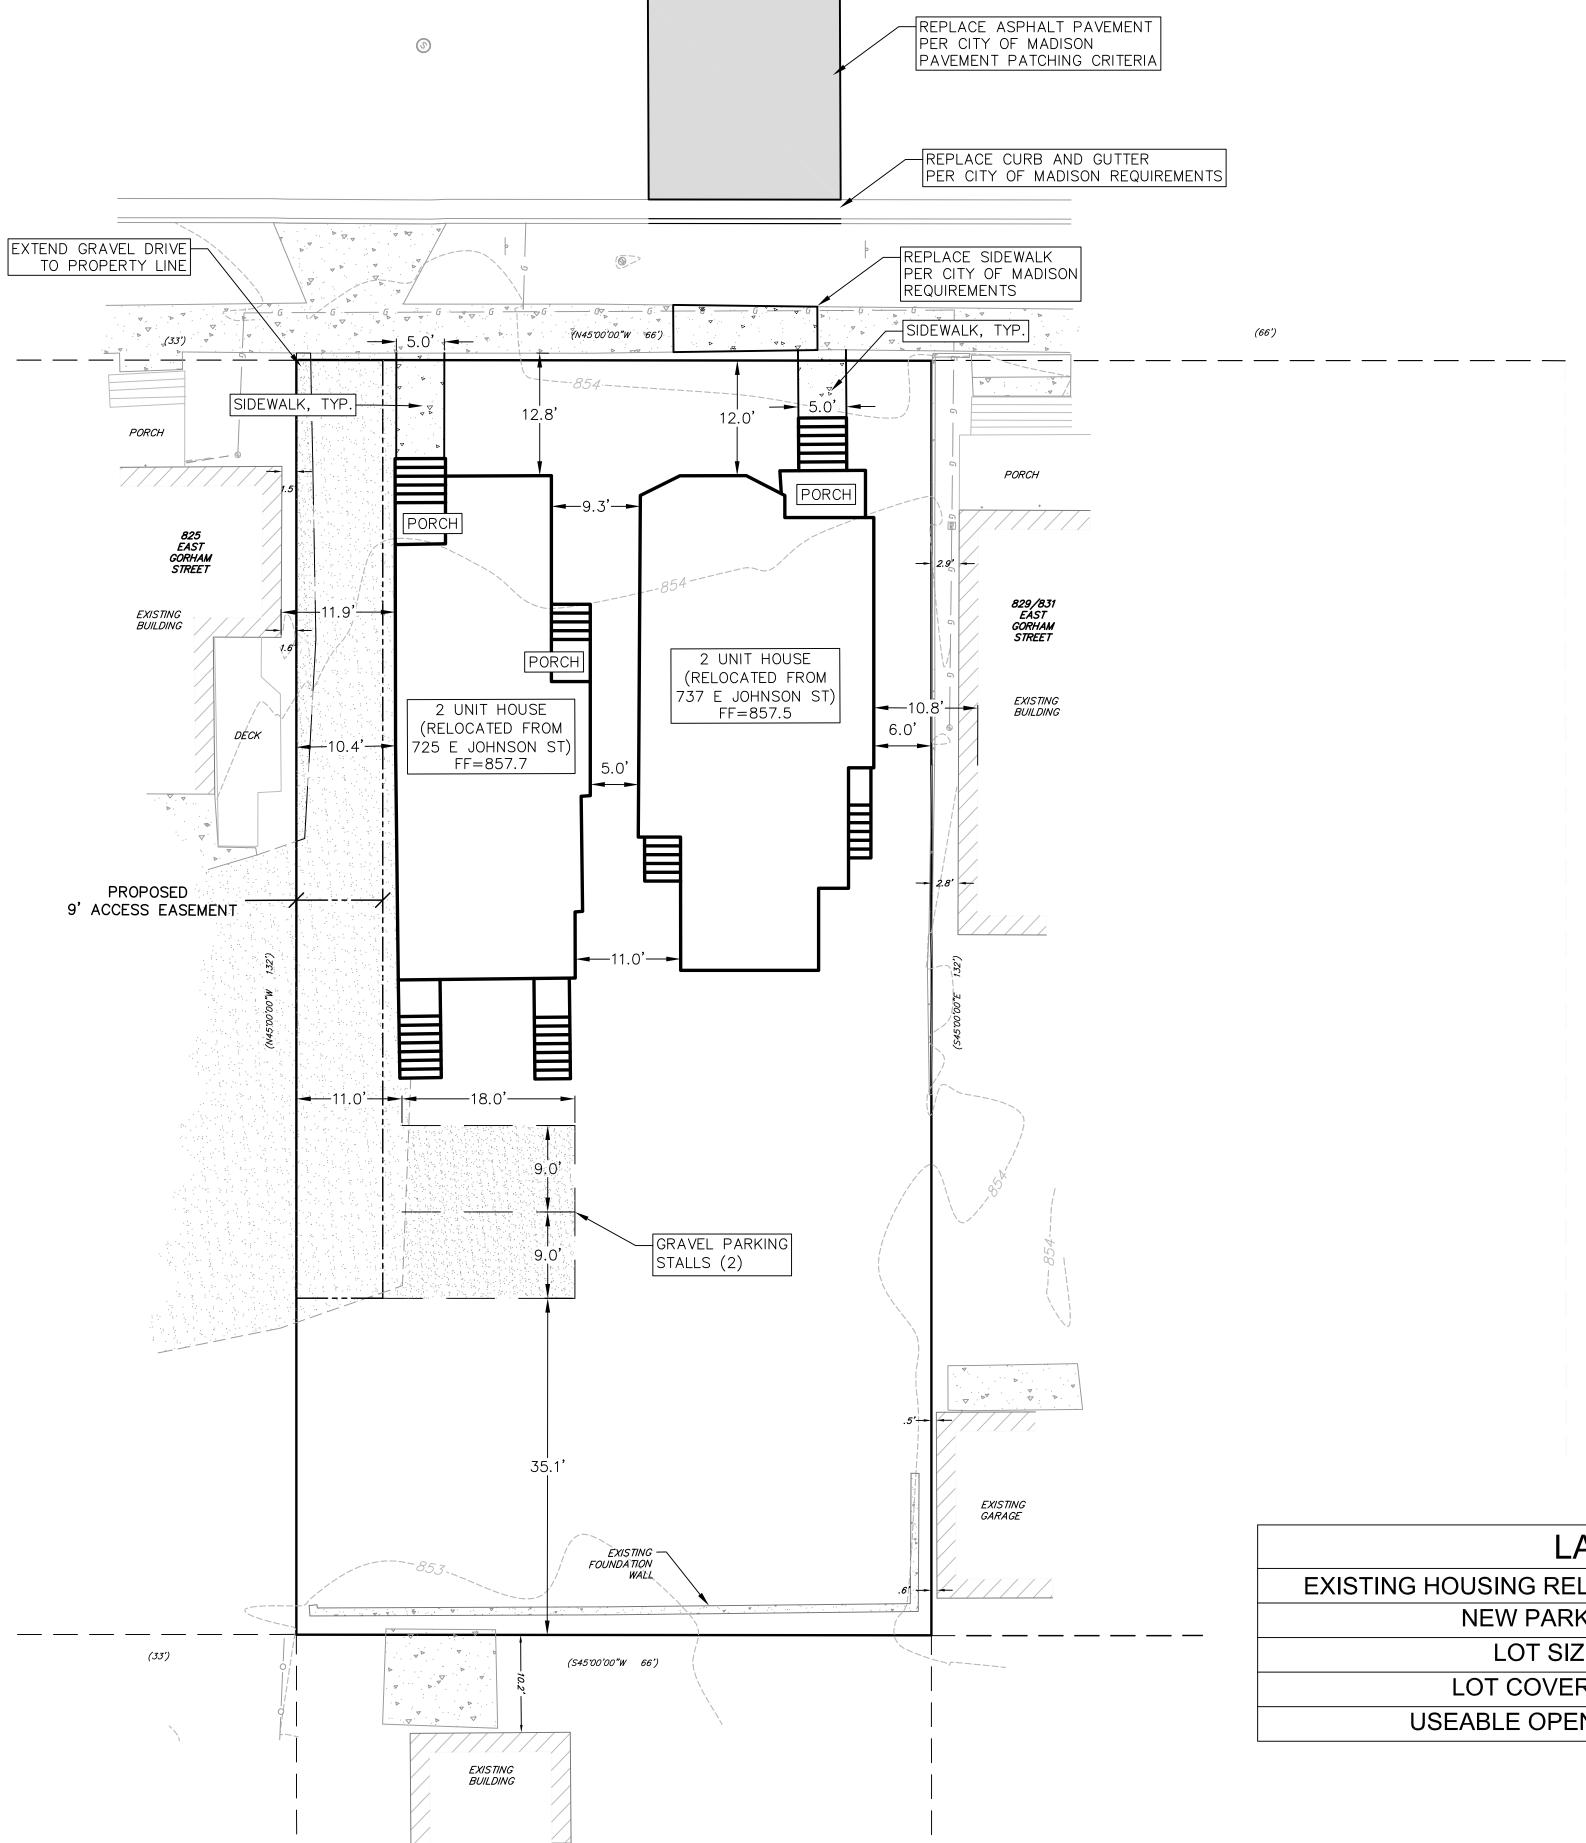



<u>EASI GORHAM SIREEI</u>

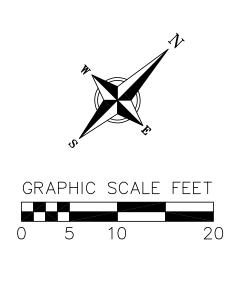



vierbicher planners | engineers | advisors Phone: (800) 261-3898 Vierbicher Project No.: 107109



 SITE PLAN LEGEND

 PROPERTY BOUNDARY

 CURB AND GUTTER

 ACCESSIBLE ROUTE

 PROPOSED CONCRETE SIDEWALK

 PROPOSED ASPHALT PAVEMENT

 PROPOSED GRAVEL

TOPOGRAPHIC SYMBOL LEGEND

- EXISTING SIGN
- EXISTING CURB INLET
- ST EXISTING FIELD INLET
- (I) EXISTING STORM MANHOLE
- EXISTING SANITARY MANHOLE
 EXISTING FIRE HYDRANT
- EXISTING WATER MAIN VALVE
- EXISTING LIGHT POLE
- IN EXISTING UNIDENTIFIED UTILITY VAULT
- S EXISTING CURB STOP
- BENCHMARK (SEE BENCHMARK NOTES)
- EXISTING BOLLARD
- 🖂 EXISTING GAS VALVE
- ₪ EXISTING GAS METER
- EXISTING ELECTRIC METER
- C EXISTING UTILITY POLE
- EXISTING UNIDENTIFIED MANHOLE
- EXISTING POST
- 💮 EXISTING DECIDUOUS TREE

SITE CONSTRUCTION NOTES:

- CONCRETE SIDEWALK TO BE 5" THICK, CONSTRUCTED ON A BASE OF 4" COMPACTED SAND OR CRUSHED STONE.
- 2. CONTRACTOR TO OBTAIN ANY NECESSARY UTILITY CONNECTION, DEMOLITION, OR RIGHT-OF-WAY PERMITS.
- CONTRACTOR SHALL OBTAIN ANY NECESSARY DRIVEWAY CONNECTION, WORK IN RIGHT-OF-WAY AND EXCAVATION PERMITS PRIOR TO CONSTRUCTION.
- 4. ANY SIDEWALK AND CURB & GUTTER ABUTTING THE PROPERTY SHALL BE REPLACED IF IT IS DAMAGED DURING CONSTRUCTION OR IF THE CITY ENGINEERING DEPARTMENT DETERMINES THAT IT IS NOT AT A DESIRABLE GRADE, REGARDLESS OF WHETHER THE CONDITION EXISTED PRIOR TO BEGINNING CONSTRUCTION.
- 5. ALL WORK IN THE PUBLIC RIGHT-OF-WAY SHALL BE PERFORMED BY A CITY-LICENSED CONTRACTOR.

RELOCATION NOTE:

WE PROPOSE TO RELOCATE 725 AND 737 EAST JOHNSON TO THE 66' WIDE LOT AT 827 EAST GORHAM. THIS WILL REQUIRE THE SUCCESSFUL NEGOTIATION OF A MODIFICATION TO THE EASEMENT SHARED WITH THE ADJACENT PROPERTY OWNER. IF THERE IS NO MUTUALLY ACCEPTABLE SOLUTION MODIFYING THE EASEMENT, THE DEVELOPER WILL IDENTIFY AN ALTERNATE SOLUTION REGARDING THE RELOCATION PROCESS WITH CITY STAFF.

LAND USE SUMMARY

LOCATED TO SITE	2 HOUSES, 4 UNITS
KING	324 GSF, 2 STALLS
ZE	0.20 ACRES
RAGE	3,604 SF
IN SPACE	4,371 SF



Revisions Date

Description

Schematic Design

SCOPE DOCUMENTS

Drawing Date 01/31/2018

827 E GORHAM ST

700 E JOHNSON ST MADISON, WI 53703

 Project No.
 700 EAST LLC

 217014.00

Sheet Title


SITE PLAN

Copyright © 2018 Kahler Slater, Inc. All rights reserved. 111 West Wisconsin Avenue, Milwaukee, Wisconsin 53203

Telephone 414.272.2000 Fax 414.272.2001

44 East Mifflin Street, Suite 700, Madison, Wisconsin 53703 Telephone 608.283.6300 Fax 608.283.6317

Sheet No.

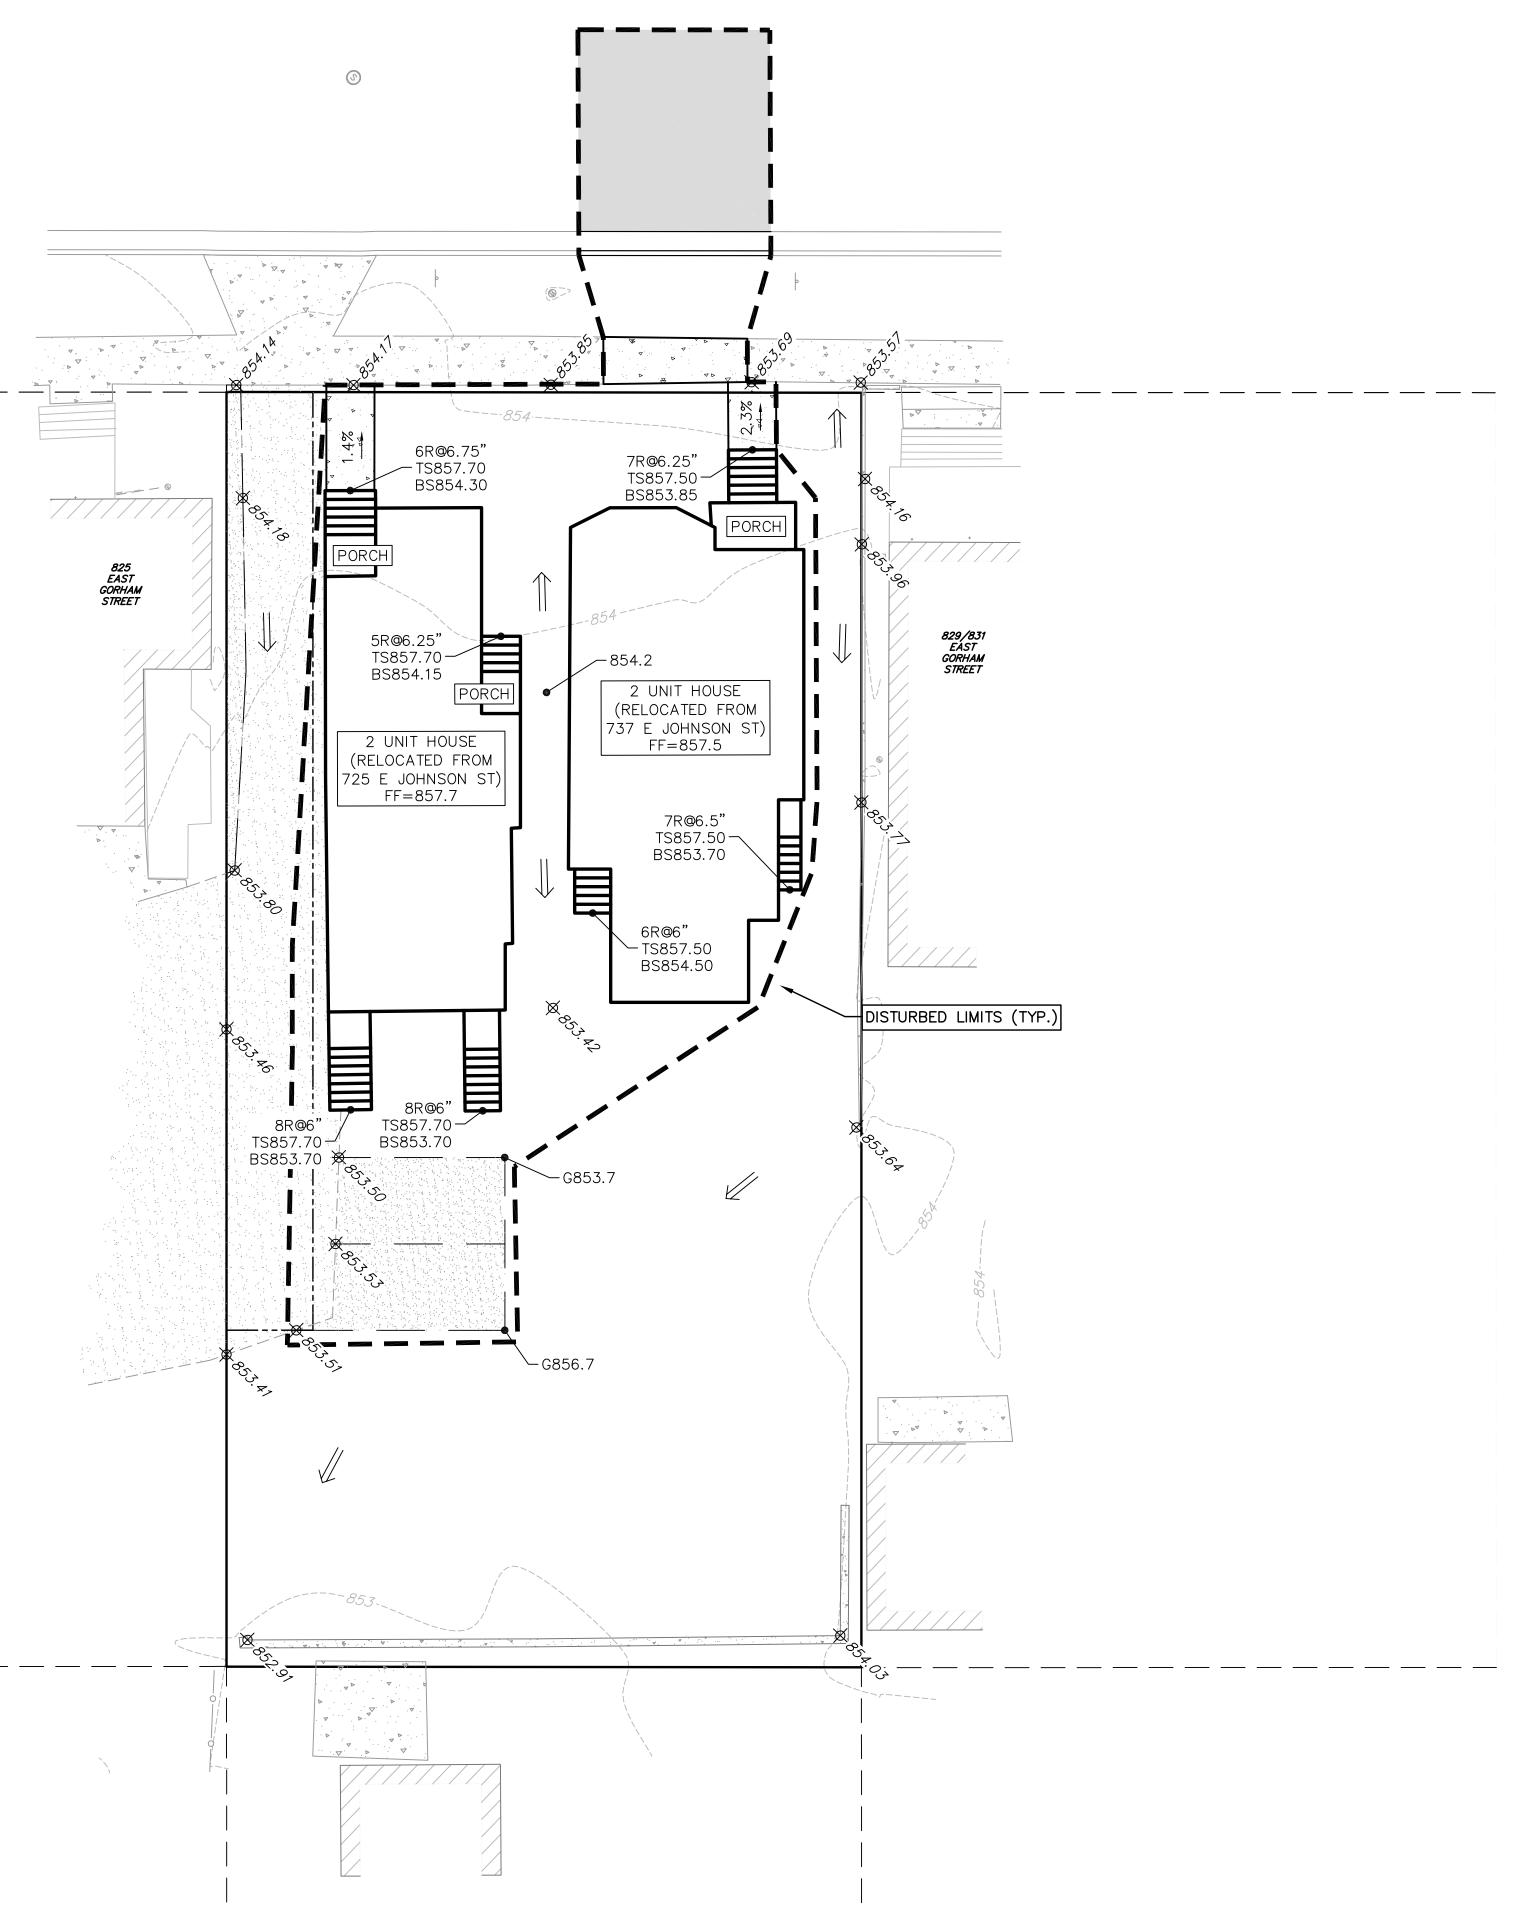




EASI GORHAM SIREEI



vierbicher planners engineers advisors Phone: (800) 261-3898 Vierbicher Project No.: 107109



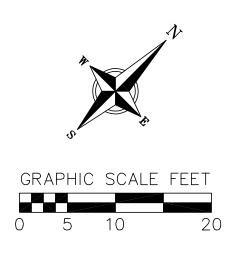

\implies 2.92% -**↓**-1048.61 -1048.61

<u>GRADING LEGEND</u> ---818--- EXISTING MINOR CONTOURS LIMITS OF DISTURBANCE DRAINAGE DIRECTION PROPOSED SLOPE ARROWS EXISTING SPOT ELEVATIONS PROPOSED SPOT ELEVATIONS

ABBREVIATIONS
FF – FINISHED FLOOR
FF – FINISHED FLOOR G – GRAVEL R – RISER TS – TOP OF STEP BS – BOTTOM OF STEP
BS - BOTTOM OF STEP

NOT FOR CONSTRUCTION

Revisions Date

Description

Schematic Design

SCOPE DOCUMENTS Drawing Date

01/31/2018

827 E GORHAM ST

700 E JOHNSON ST MADISON, WI 53703

700 EAST LLC Project No 217014.00


Sheet Title


GRADING PLAN

Copyright © 2018 Kahler Slater, Inc. All rights reserved. 111 West Wisconsin Avenue, Milwaukee, Wisconsin 53203 Telephone 414.272.2000 Fax 414.272.2001

44 East Mifflin Street, Suite 700, Madison, Wisconsin 53703 Telephone 608.283.6300 Fax 608.283.6317

Sheet No. C-4.0

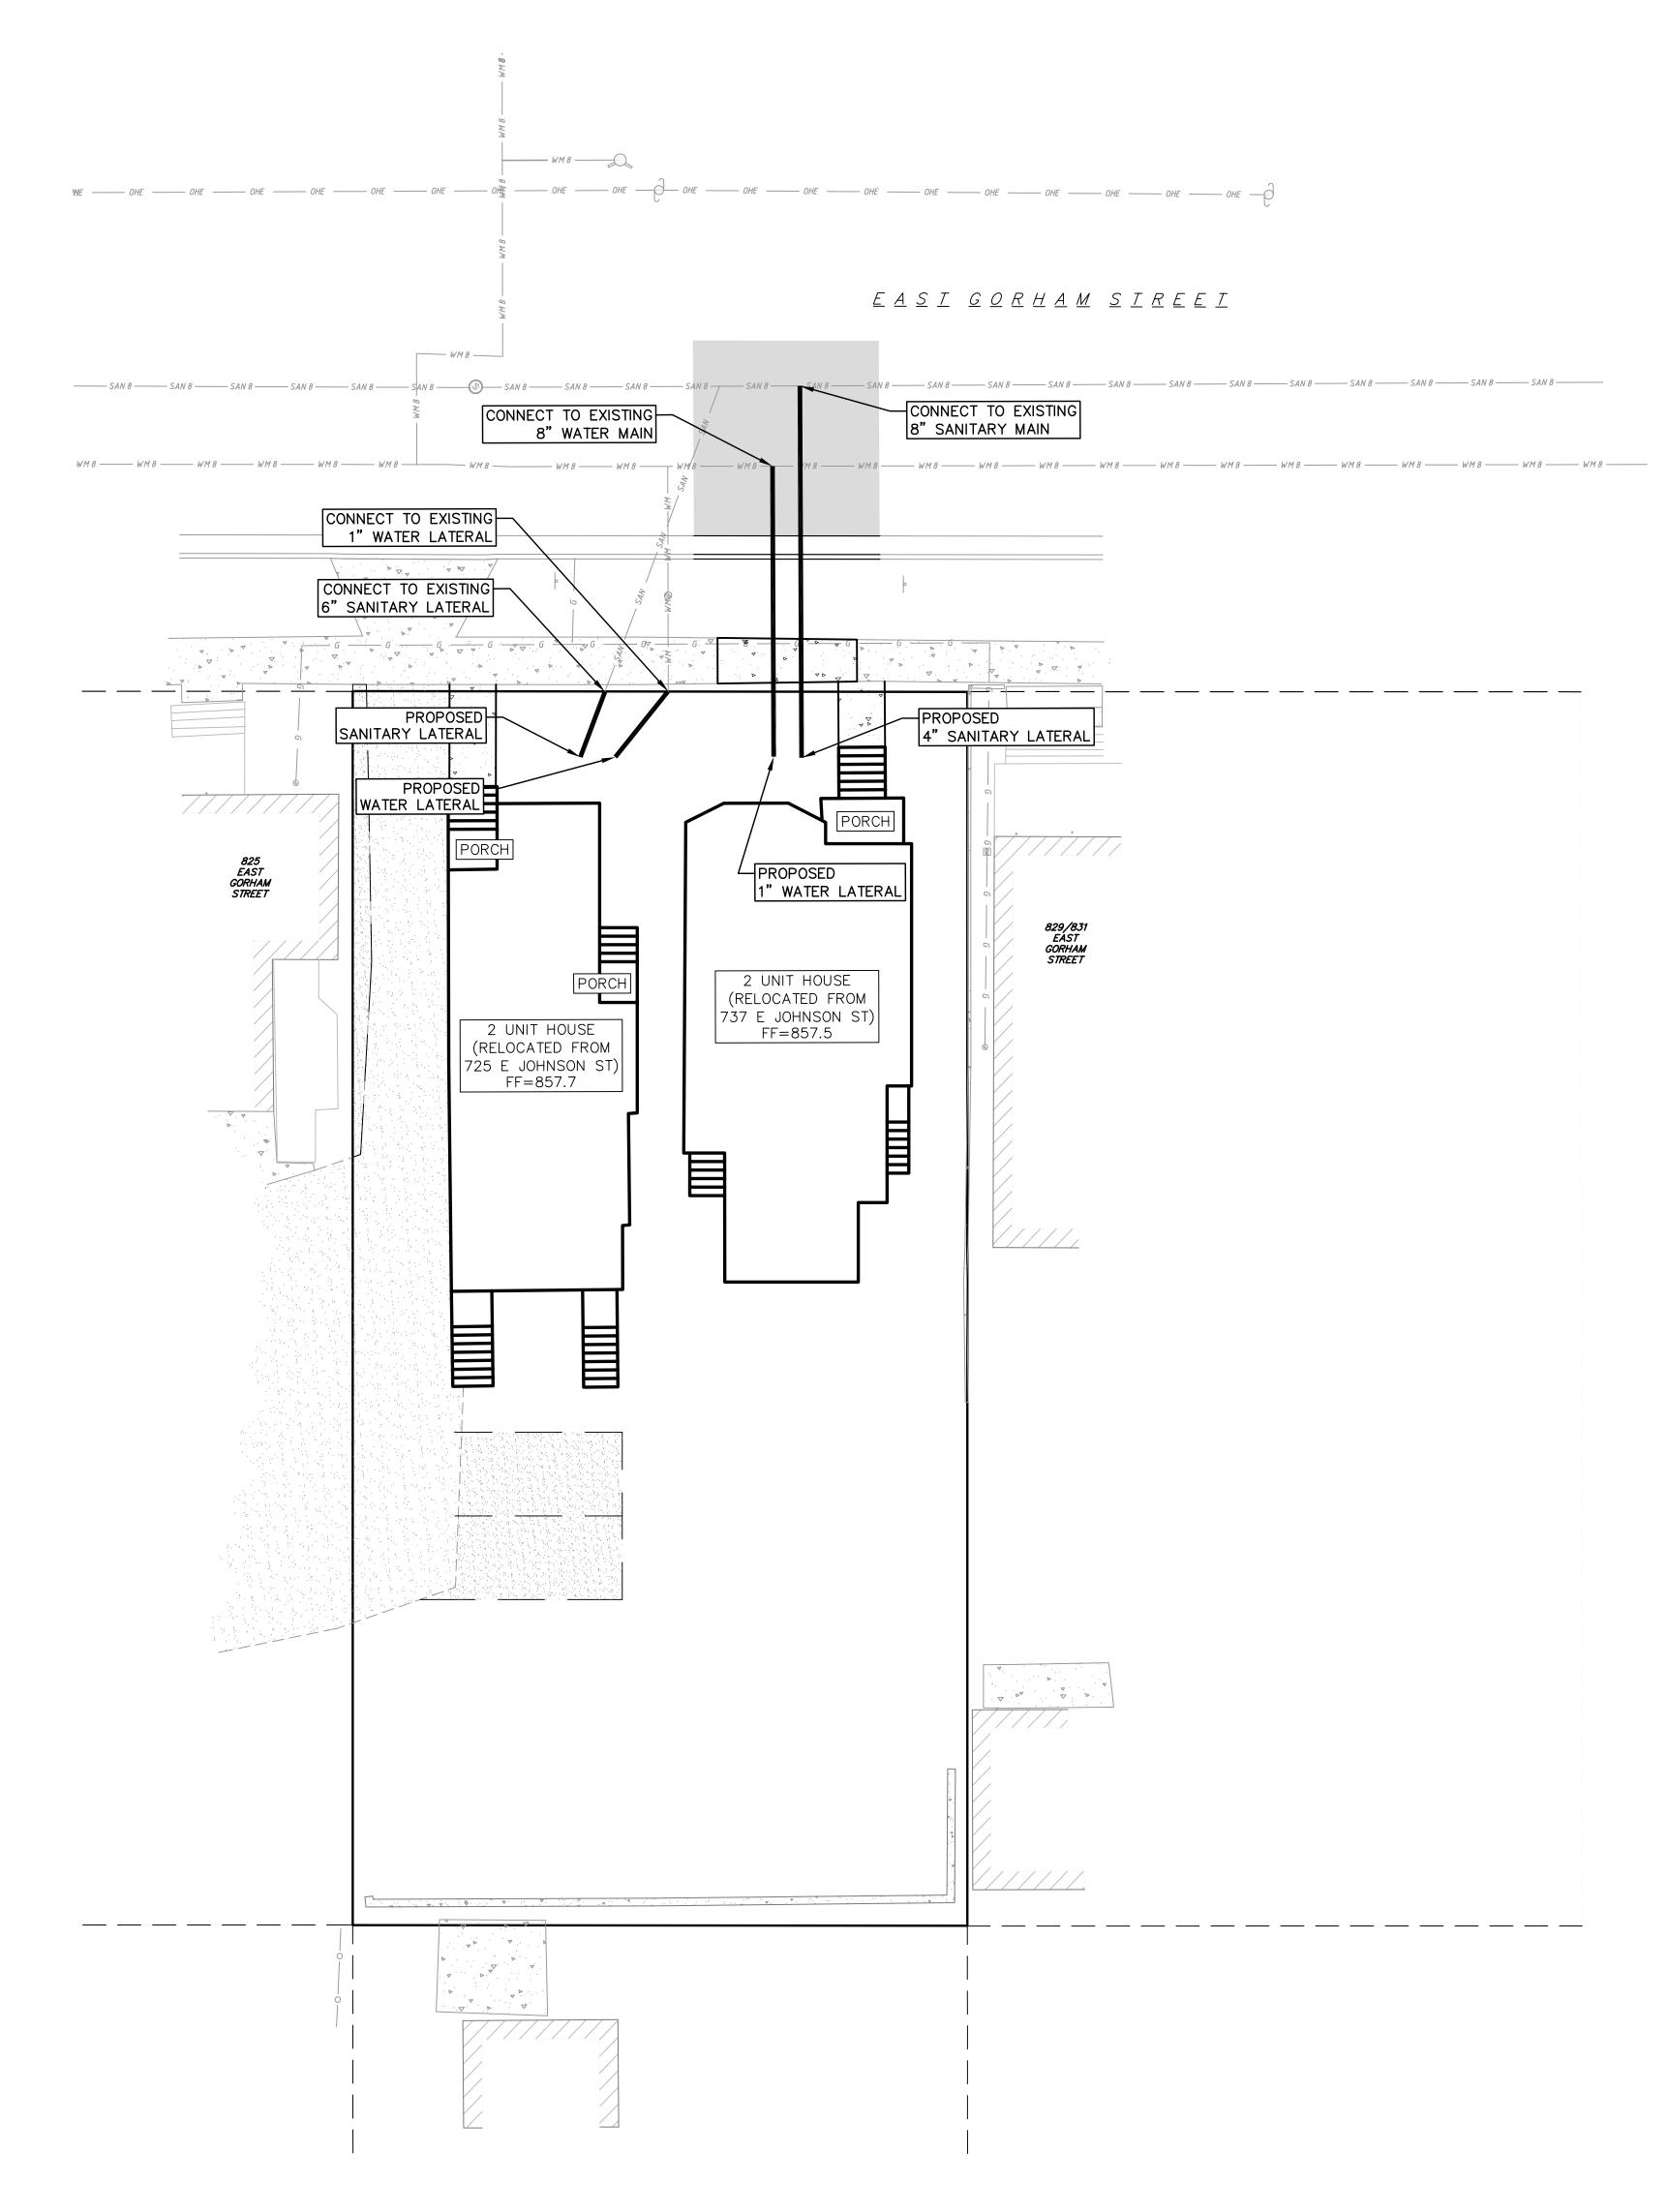

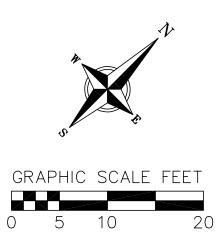



vierbicher planners | engineers | advisors Phone: (800) 261-3898 Vierbicher Project No.: 107109



PROPOSED UTILITY LEGEND

<< <<	
_ (((((
Ø	

STORM SEWER PIPE
 STORM SEWER ENDWALL
 SANITARY SEWER LATERAL PIPE
 WATER SERVICE LATERAL PIPE
 WATER VALVE

UTILITY NOTES:

- PRIVATE WATER MAIN AND SERVICES SHALL BE DUCTILE IRON (AWWA C-151, CLASS 52) OR APPROVED EQUAL MATERIAL THAT CONFORMS TO COMM 84.30(4)(d).
- 2. PRIVATE SANITARY SEWER AND LATERALS SHALL BE POLYVINYL CHLORIDE (PVC) ASTM D3034 - SDR 35 OR APPROVED EQUAL MATERIAL THAT CONFORMS TO COMM 84.30(2)(c).
- 3. A MEANS TO LOCATE BURIED UNDERGROUND EXTERIOR NON METALLIC SEWERS/MAINS AND WATER SERVICES/MAINS MUST BE PROVIDED WITH TRACER WIRE OR OTHER METHODS IN ORDER TO BE LOCATED PER COMM 82.10(11)(h) AND COMM 82.40(8)(k).
- 4. EXTERIOR WATER SUPPLY PIPING SETBACKS AND CROSSINGS SHALL BE IN ACCORDANCE WITH COMM 82.40(8)(b.).
- 5. NO PERSON MAY ENGAGE IN WORK AT PLUMBING IN THE STATE UNLESS LICENSED TO DO SO BY THE DEPARTMENT OF COMMERCE PER S.145.06.
- 6. SITE CONTRACTOR SHALL LEAVE SANITARY AND WATER LATERALS FIVE (5) FEET SHORT (HORIZONTALLY) FROM THE BUILDING. BUILDING PLUMBER SHALL VERIFY SIZE AND EXACT LOCATION OF PROPOSED SANITARY AND WATER LATERALS.
- 7. CONTRACTOR SHALL FIELD VERIFY THE SIZE, TYPE, LOCATION, AND ELEVATION OF EXISTING UTILITIES PRIOR TO INSTALLING ANY ON-SITE UTILITIES OR STRUCTURES. CONTACT ENGINEER PRIOR TO INSTALLATION IF DISCREPANCY EXISTS WITHIN THESE PLANS.
- 8. PROPOSED UTILITY SERVICE LINES AS SHOWN ARE APPROXIMATE. COORDINATE THE EXACT LOCATIONS WITH THE PLUMBING DRAWINGS. COORDINATE THE LOCATIONS WITH THE PLUMBING CONTRACTOR AND/OR OWNER'S CONSTRUCTION REPRESENTATIVE PRIOR TO INSTALLATION OF ANY NEW UTILITIES.
- 9. CONTRACTOR SHALL BE RESPONSIBLE FOR COORDINATING THE RELOCATION OF ANY UTILITIES ENCOUNTERED AND REPLACEMENT OF ANY UTILITIES DAMAGED WITHIN INFLUENCE ZONE OF NEW CONSTRUCTION. CONTACT ENGINEER IF THE EXISTING UTILITIES VARY APPRECIABLY FROM THE PLANS.
- 10. ALL WATER MAIN AND SERVICES SHALL BE INSTALLED AT A MINIMUM DEPTH OF 6.5' FROM TOP OF FINISHED GROUND ELEVATION TO TOP OF MAIN.
- 11. CLEAN OUT ALL EXISTING AND PROPOSED STORM INLETS AND CATCH BASINS AT THE COMPLETION OF CONSTRUCTION.
- 12. CONTRACTOR SHALL OBTAIN ANY NECESSARY WORK IN RIGHT-OF WAY, EXCAVATION, UTILITY CONNECTION, PLUGGING, ABANDONMENT, AND DRIVEWAY CONNECTION PERMITS PRIOR TO CONSTRUCTION.
- 13. THE DEVELOPER SHALL INSTALL THE 3M[™] ELECTRONIC MARKER SYSTEM (EMS) 4" EXTENDED RANGE 5' BALL MARKERS-WASTEWATER (MODEL #1404-XR) FOR EACH SANITARY AND STORM SEWER LATERALS. THE CITY SHALL SUPPLY ALL THE REQUIRED MARKERS TO THE DEVELOPER OR ITS CONTRACTOR (GENERALLY REQUIRES 2 PER LATERAL) AND THE CONTRACTOR SHALL INSTALL THEM PER THE MANUFACTURER'S REQUIREMENTS OR AS DIRECTED BY THE CITY ENGINEER.
- 14. ALL WORK IN THE PUBLIC RIGHT-OF-WAY SHALL BE PERFORMED BY A CITY-LICENSED CONTRACTOR.
- 15. ALL DAMAGE TO PAVEMENT ADJACENT TO THIS DEVELOPMENT SHALL BE RESTORED IN ACCORDANCE WITH THE CITY'S PAVEMENT PATCHING CRITERIA.
- 16. CONTRACTOR SHALL REPLACE ALL SIDEWALK AND CURB AND GUTTER ABUTTING THE PROPERTY, WHICH IS DAMAGED BY THE CONSTRUCTION, OR ANY SIDEWALK AND CURB AND GUTTER THAT THE CITY ENGINEER DETERMINES NEEDS TO BE REPLACED BECAUSE IT IS NOT AT A DESIRABLE GRADE REGARDLESS OF WHETHER THE CONDITION EXISTED PRIOR TO BEGINNING CONSTRUCTION.



Description

Revisions

Date

Schematic Design

SCOPE DOCUMENTS

Drawing Date 01/31/2018

827 E GORHAM ST

700 E JOHNSON ST MADISON, WI 53703

 Project No.
 700 EAST LLC

 217014.00

Sheet Title


UTILITY PLAN


Copyright © 2018 Kahler Slater, Inc. All rights reserved. 111 West Wisconsin Avenue, Milwaukee, Wisconsin 53203

Telephone 414.272.2000 Fax 414.272.2001 44 East Mifflin Street, Suite 700, Madison, Wisconsin 53703

Telephone 608.283.6300 Fax 608.283.6317

Sheet No.

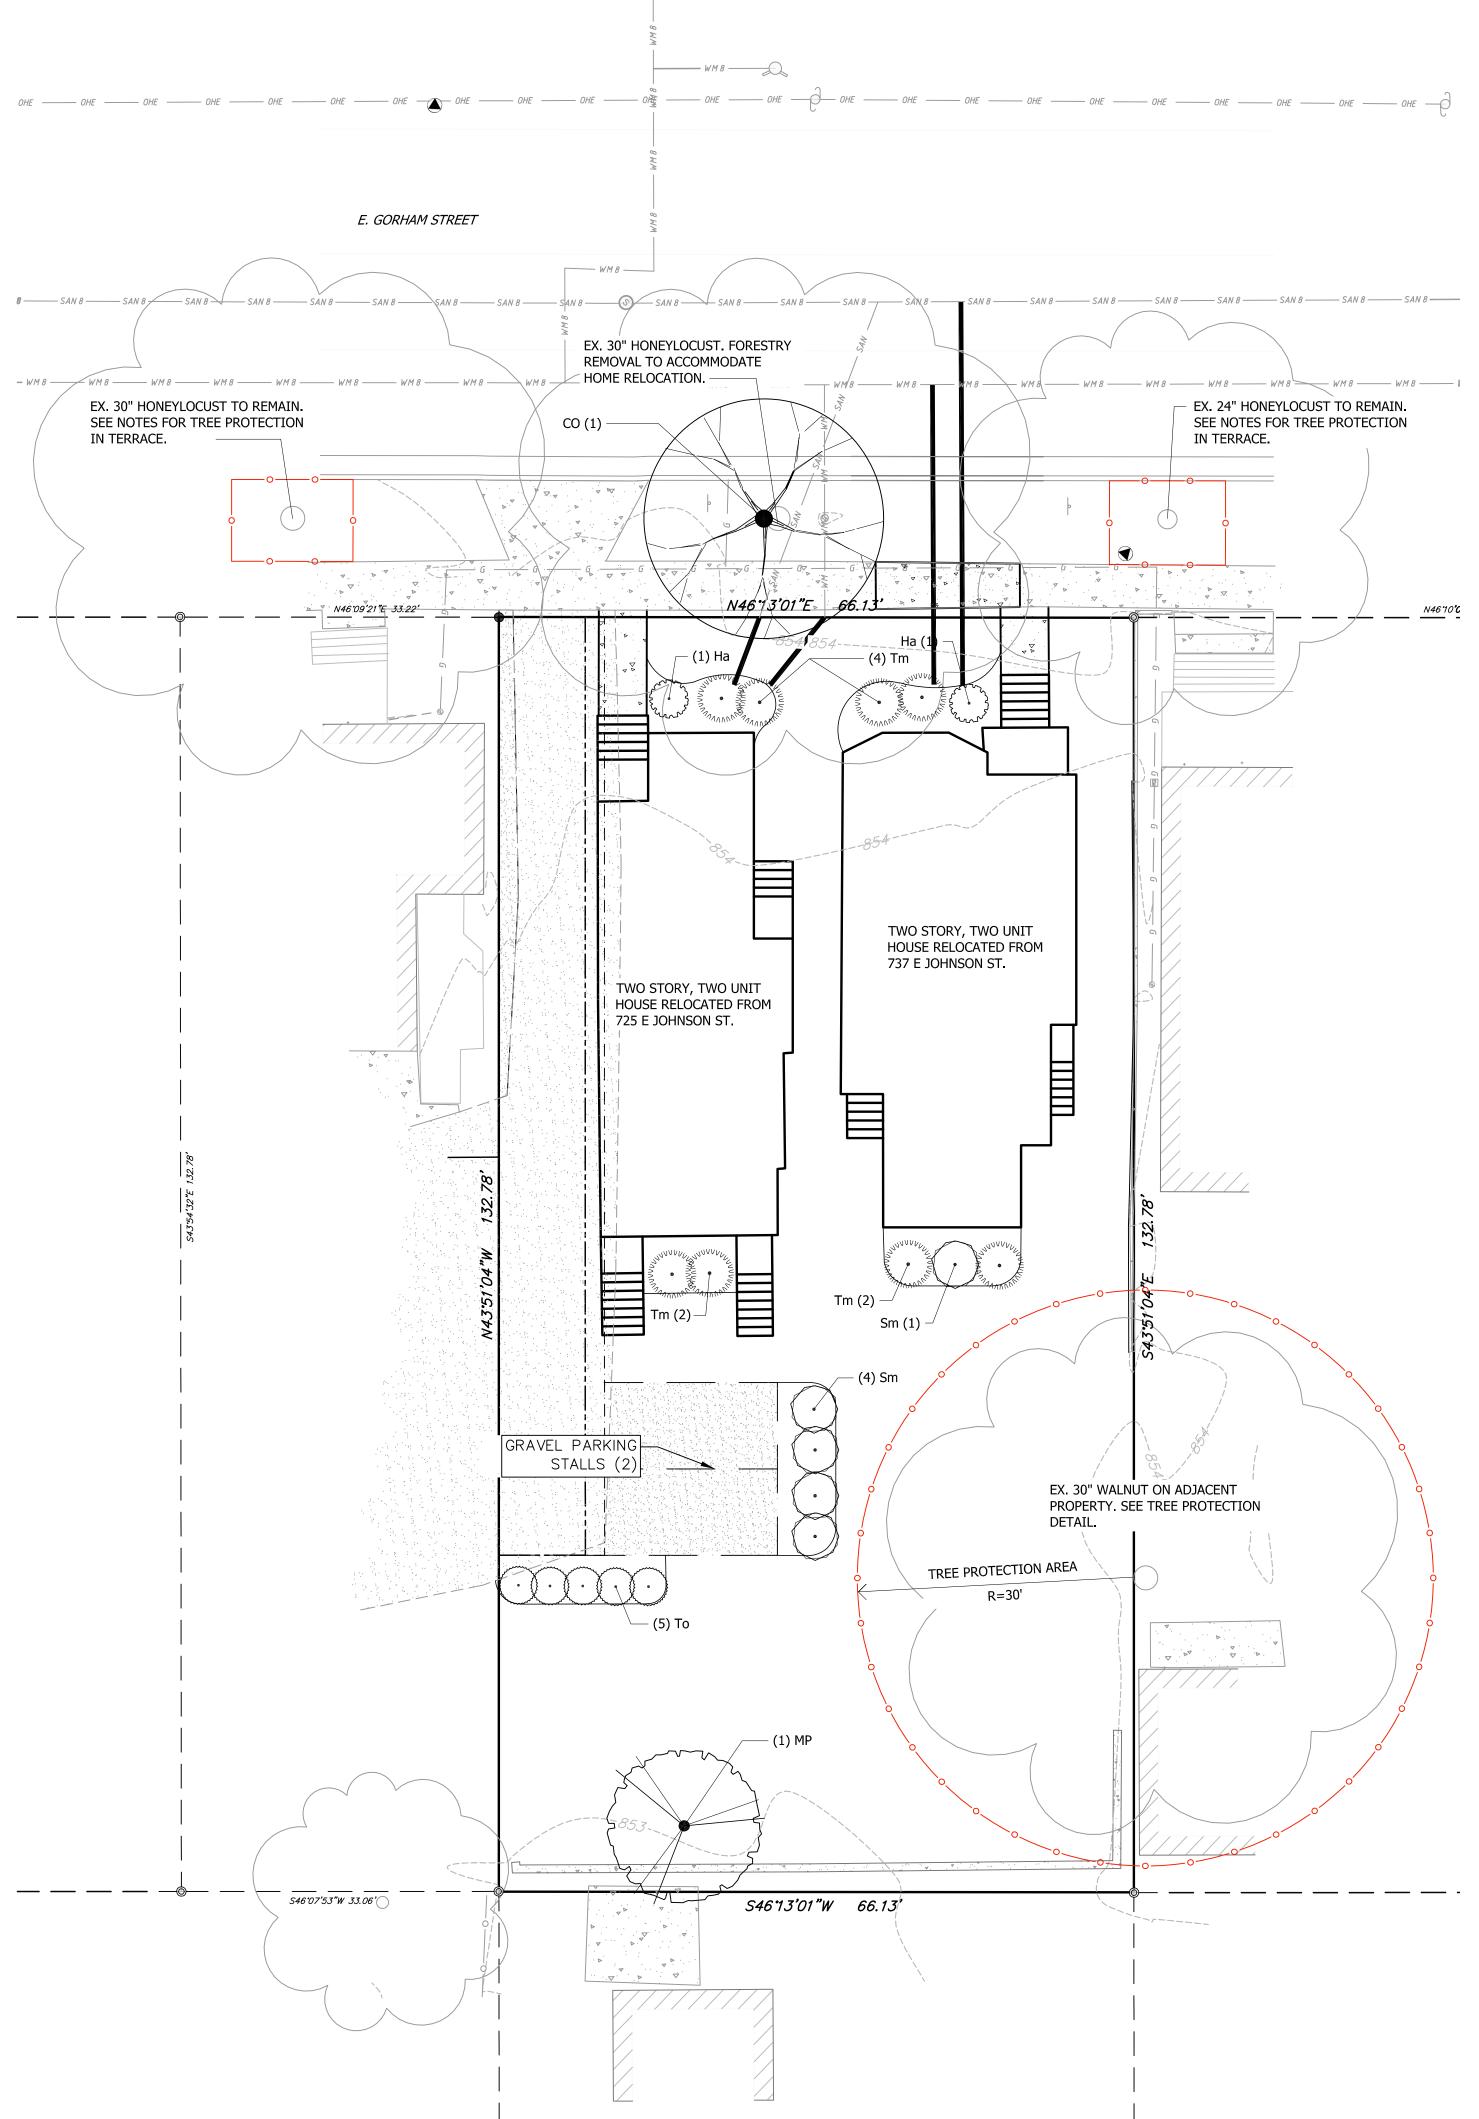

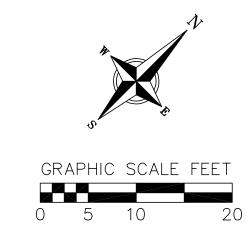

PLANT SCHEDULE

FLOWERING TREES	BOTANICAL NAME / COMMON NAM Malus x `Prairie Maid` / Prairie Ma
<u>STREET TREES</u>	BOTANICAL NAME / COMMON NAM
CO	Celtis occidentalis / Common Hack
<u>SHRUBS</u>	BOTANICAL NAME / COMMON NAM
Ha	Hydrangea arborescens `Annabelle
Sm	Syringa meyeri `Palibin` / Dwarf k
Tm	Taxus x media `Everlow` / Yew
To	Thuja occidentalis `Holmstrup` / H

NOTES:

1. All plantings shall conform to quality requirements as per ANSI Z60.1. 2. All plant material shall be true to the species, variety and size specified, nursery grown in accordance with good horticultural practices, and under climactic conditions similar to those of the project site. **3**. Contact Landscape Architect, in writing, to request and plant material substitutions due to availability issues. 4. All disturbed areas, unless otherwise noted, to be seeded with Madison Parks Mix by Olds Seed Company or equivalent, per manufacturer's specified application rates. All seeded areas are to be watered daily to maintain adequate soil moisture for proper germination. After vigorous growth is established, apply $\frac{1}{2}$ " water twice weekly until final acceptance.


5. All plants shall be guaranteed to be in healthy and flourishing condition during the growing season following installation. All plant material shall be guaranteed for one year from the time of installation. 6. Contractor shall provide a suitable amended topsoil blend for all planting areas where soil conditions are unsuitable for plant growth. Topsoil shall conform to quality requirements as per Section 625.2(1) of the Standard Specifications for Highway Construction. Provide a minimum of 12" of topsoil in all planting areas and 6" of topsoil in areas to be seeded/sodded. 7. Landscape beds to be mulched with undyed shredded hardwood bark mulch to 3" depth min. Edge beds with shovel cut trench edge.

8. Protection of Existing Street Trees: Contractor shall install tree protection fencing in the area between the curb and sidewalk and extend it at least 5 feet from both sides of the tree along the length of the terrace. No excavation is permitted within 5 feet of the outside edge of a tree trunk. If excavation within 5 feet of any street tree is necessary, contractor shall contact City Forestry (266.4816) prior to excavation to assess the impact to the tree and root system. Tree pruning/removal shall be coordinated with City Forestry prior to the start of construction. Tree protection specifications can be found in section 107.13 of City of Madison Standard Specifications for Public Works Construction: http://www.cityofmadison.com/business/pw/ documents/stdspecs/2013/partl.pdf. Any tree removals that are required for construction after the development plan is approved will require al least a 72 hour wait period before a tree removal permit can be issued by forestry, to notify the alder of the change in the tree plan.

TREE PROTECTION DETAIL

NOTES:

- CRITICAL ROOT RADIUS (IN FEET) = 1' x DBH EXAMPLE: 6" DBH TREE = 6' RADIUS
- REMOVAL.

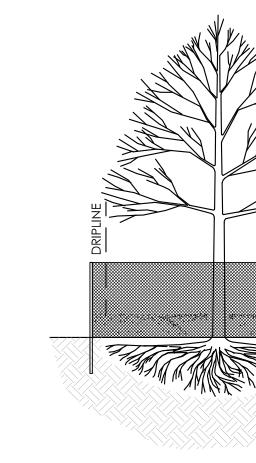




vierbicher planners engineers advisors Phone: (800) 261-3898 Vierbicher Project No.: 107109



<u>CAL</u> 1.5"Cal CONT B & B <u>QTY</u> laid Crabapple CAL <u>QTY</u> CONT Installed By MSN Forestry kberry FIELD2 24" ht. SIZE OT le` / Annabelle Smooth Hydrangea 5 gal 36" ht. Korean Lilac 5 gal 12" ht. 5 gal Holmstrup Cedar 7 gal 48" ht.

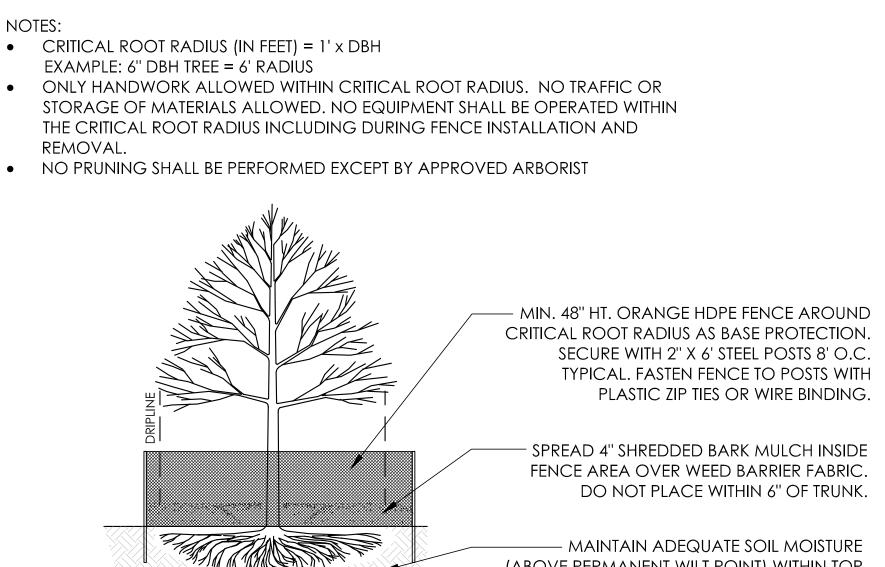

(ABOVE PERMANENT WILT POINT) WITHIN TOP 8" OF SOIL FOR THE DURATION OF CONSTRUCTION. APPLY ADDITIONAL WATER VIA HOSE, WATER TANK, OR TREE BAG DURING PERIODS OF DROUGHT OR EXTREME HEAT.



Revisions Date

Description

Schematic Design

SCOPE DOCUMENTS

Drawing Date 01/31/2018

827 E GORHAM ST

700 E JOHNSON ST MADISON, WI 53703

Project No 700 EAST LLC 217014.00

Sheet Title

LANDSCAPE PLAN


Copyright © 2018 Kahler Slater, Inc. All rights reserved. 111 West Wisconsin Avenue, Milwaukee, Wisconsin 53203 Telephone 414.272.2000 Fax 414.272.2001

44 East Mifflin Street, Suite 700, Madison, Wisconsin 53703 Telephone 608.283.6300 Fax 608.283.6317


Sheet No. L-1.0

	LED FIX		45 W MARCAN 7.4	FINAL MODEL #			
SPECIFICATION				PROJECT			
	MODEL # B	RA	ALNERAN 20	ТҮРЕ	AREA		
Athenican ocientific urginning				NOTES			
STANDARD FE	ATURES: SCC		-				
ixture thermally tested Naximum light distributi Iver current/voltage sho IL and/or CSA Compliant onstant Current Design	on throughout lens ort circuit protection t Listed			F			
FIXTUR	RE	LED ENGIN	JE				
BASE CR Steel Constru	Iction	.G/NICHIA/SAMSUNG	, LED CHIPS				
FINISH Satin Nickel		UMENS PER WATT AVO	G 100-120		1+7-1	//4"	
LENS Frosted Glass		@Module Efficacy					
LOCATION Damp		KELVIN 27K 30K 35K 40K					
COMPLIANT 📢 MAS		DRIVER 120 VOLTS 50/	60Hz				
LIFE HOURS 50,000		OWER FACTOR High			-	10"	
LIFE HOURS 50,000 WARRANTY Limited 5	Years	FOWER FACTOR High RIAC OR ELECTRONIC .ow Voltage Dimming Do Vall Box Dimmers				10"	
	Years L	RIAC OR ELECTRONIC	wn To 5% With				
WARRANTY Limited 5	Years L	RIAC OR ELECTRONIC ow Voltage Dimming Do Vall Box Dimmers	wn To 5% With	size: 5×2	W7 ^{1/4}		
WARRANTY Limited 5 LED LIGHT SOURCE OPTIONS*	Years	RIAC OR ELECTRONIC ow Voltage Dimming Do Vall Box Dimmers (ESTED LM80 and LM82	wn To 5% With	size: 5×2 Size:			
ED LIGHT	Years WATTAGE: 12	RIAC OR ELECTRONIC ow Voltage Dimming Do Vall Box Dimmers TESTED LM80 and LM82 KELVIN: 3000 KELVIN:	wn To 5% With				
WARRANTY Limited 5	Years	RIAC OR ELECTRONIC ow Voltage Dimming Do Vall Box Dimmers TESTED LM80 and LM82 KELVIN: 3000 KELVIN:	wn To 5% With EXAMPLE	SIZE: 4000K	W7 ^{1/4}	SIZE OPTIONS H10 D4	
ED LIGHT SOURCE OPTIONS* DRDERING INFORMATION:	Years	RIAC OR ELECTRONIC ow Voltage Dimming Do Vall Box Dimmers TESTED LM80 and LM82 KELVIN: 3000 KELVIN:	wn To 5% With EXAMPLE	SIZE: 4000K COOL WHITE	W7 ^{1/4}	SIZE OPTIONS H10 D4	
ED LIGHT SOURCE OPTIONS* DRDERING INFORMATION: SYSTEM WATTAGE	Years	RIAC OR ELECTRONIC ow Voltage Dimming Do Vall Box Dimmers TESTED LM80 and LM82 KELVIN: 3000 KELVIN: E 3000K SOFT WHITE 1000/1000	wn To 5% With EXAMPLE	SIZE: 4000K COOL WHITE 1000/1050	W7 ^{1/4}	SIZE OPTIONS H10 D4	
ED LIGHT SOURCE OPTIONS* RDERING INFORMATION: SYSTEM WATTAGE 10/12 DRIVERLESS 14/15 DRIVERLESS	Years	RIAC OR ELECTRONIC Low Voltage Dimming Do Vall Box Dimmers ESTED LM80 and LM82 KELVIN: 3000 KELVIN: 1000/1000 1350/1500	wn To 5% With EXAMPLE	SIZE: 4000K COOL WHITE 1000/1050 1400/1500	W7 ^{1/4}	SIZE OPTIONS H10 D4 LEGACY EQUIVALENT CFL 13 CFL 2 x 13	
ARRANTY Limited 5	Years	RIAC OR ELECTRONIC ow Voltage Dimming Do Vall Box Dimmers TESTED LM80 and LM82 KELVIN: 3000 KELVIN: E 3000K SOFT WHITE 1000/1000 1350/1500 1850/2400	WIN TO 5% With EXAMPLE K 3500K NEUTRAL	SIZE: 4000K COOL WHITE 1000/1050 1400/1500 1900/2500	W7 ^{1/4}	SIZE OPTIONS H10 D4 LEGACY EQUIVALENT CFL 13 CFL 2 x 13 CFL 3 x 13	
ARRANTY Limited 5	Years	RIAC OR ELECTRONIC ow Voltage Dimming Do Vall Box Dimmers TESTED LM80 and LM82 KELVIN: 3000K KELVIN: 1000/1000 1350/1500 1850/2400 1100	wn To 5% With EXAMPLE K 3500K NEUTRAL 1160	SIZE: 4000K COOL WHITE 1000/1050 1400/1500 1900/2500 1175	W7 ^{1/4}	SIZE OPTIONS H10 D4 LEGACY EQUIVALENT CFL 13 CFL 2 x 13 CFL 2 x 13 CFL 18	
WARRANTY Limited 5 LED LIGHT SOURCE OPTIONS* DRDERING INFORMATION: SYSTEM WATTAGE 10/12 DRIVERLESS 10/12 DRIVERLESS 10 12	Years	RIAC OR ELECTRONIC ow Voltage Dimming Do Vall Box Dimmers TESTED LM80 and LM82 KELVIN: 3000 KELVIN: 3000K sort WHITE 1000/1000 1350/1500 1850/2400 1100 1360	wn To 5% With EXAMPLE State St	SIZE: 4000K Cool WHITE 1000/1050 1400/1500 1900/2500 1175 1460	W7 ^{1/4} SOOOK DAYLIGHT 1250 1560	SIZE OPTIONS H10 D4 CFL 13 CFL 2 x 13 CFL 3 x 13 CFL 18 CFL 2 x 13	

driver: ÞVÞ	FINISH: FCU	LENS: LC	U ACCESSORIES: FUS	TECHNOLOGY: CT
DRIVER:	FINISH:	LENS:	ACCESSORIES:	TECHNOLOGY:
DRIVER	FINISH	LENS	ACCESSORIES	TECHNOLOGY
 DV 120/277 (Non Dimmable) DVD 120/277 (0-10v Dimmable) 	 FB Black FBR Bronzetone FCU Custom Any RAL Finish FSN Satin Nickel FW White 	□ LCU Custom	 BBX Back Box (Condult Holes Optional) FUS Fused IB Individually Boxed PCH Pull Chain PS Pin Switch SRP Surge Protector 	 CT LED Color Tuning EMG Emergency (Ary Lumens Package) EMGR Emergency Remote OS Occupancy Sensor On/Off OSCD Occupancy Sensor Step Dimming TP Tamper Proof Screws

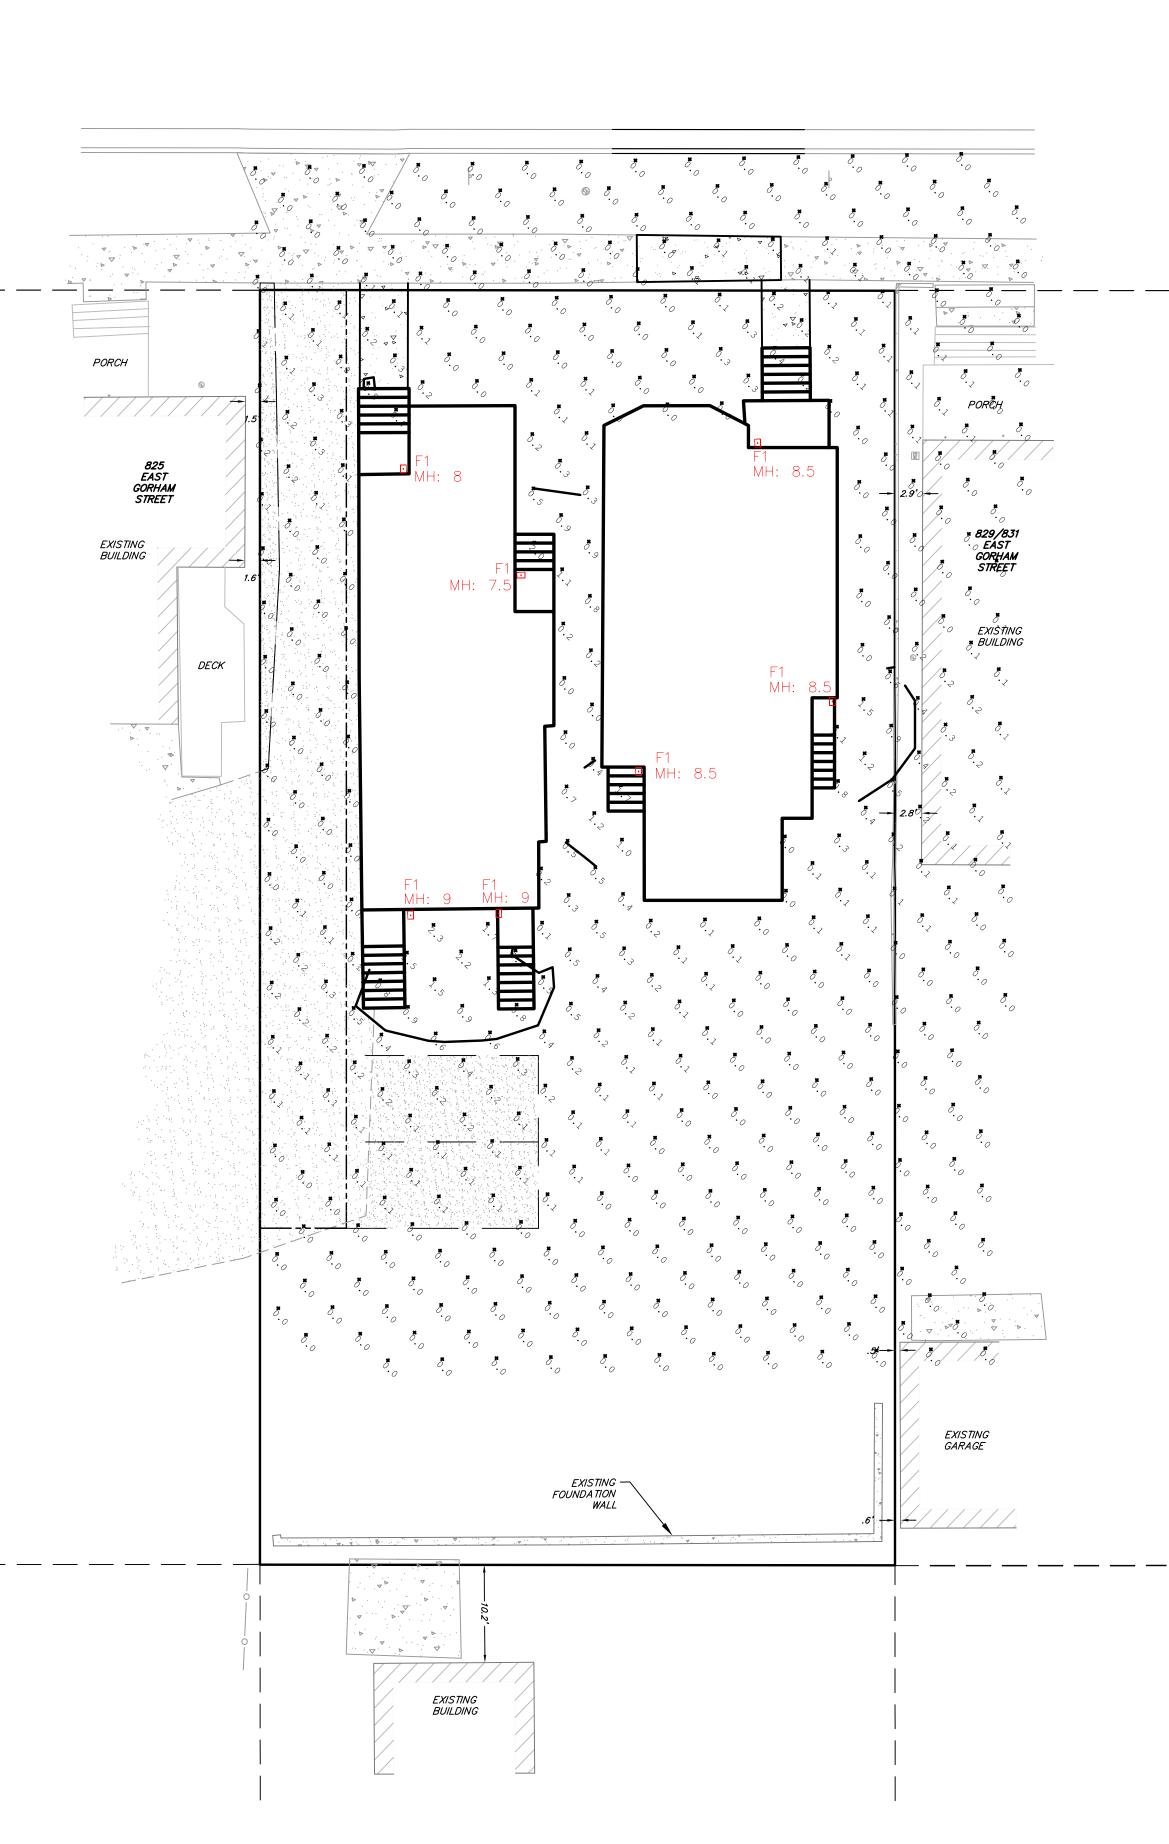

 \odot

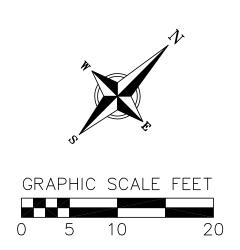



vierbicher planners engineers advisors Phone: (800) 261-3898 Vierbicher Project No.: 107109



NOT FOR CONSTRUCTION

Revisions Date

Description

Schematic Design

SCOPE DOCUMENTS Drawing Date 01/31/2018

827 E GORHAM ST

700 E JOHNSON ST MADISON, WI 53703

700 EAST LLC Project No. 217014.00

Sheet Title


LIGHTING PLAN

Copyright © 2018 Kahler Slater, Inc. All rights reserved. 111 West Wisconsin Avenue, Milwaukee, Wisconsin 53203 Telephone 414.272.2000 Fax 414.272.2001

44 East Mifflin Street, Suite 700, Madison, Wisconsin 53703 Telephone 608.283.6300 Fax 608.283.6317

Sheet No. E-1.0




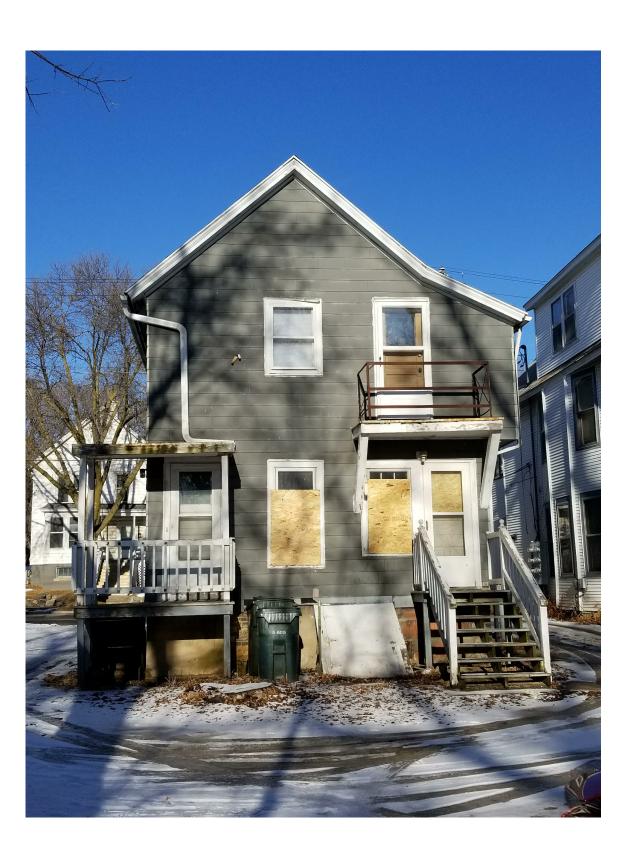


725 E JOHNSON






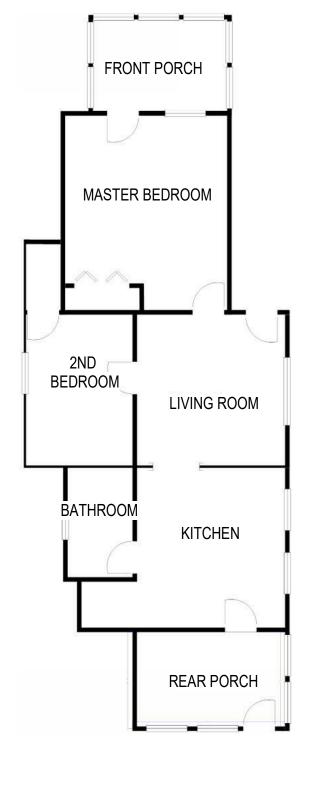

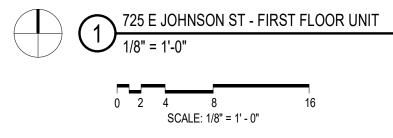



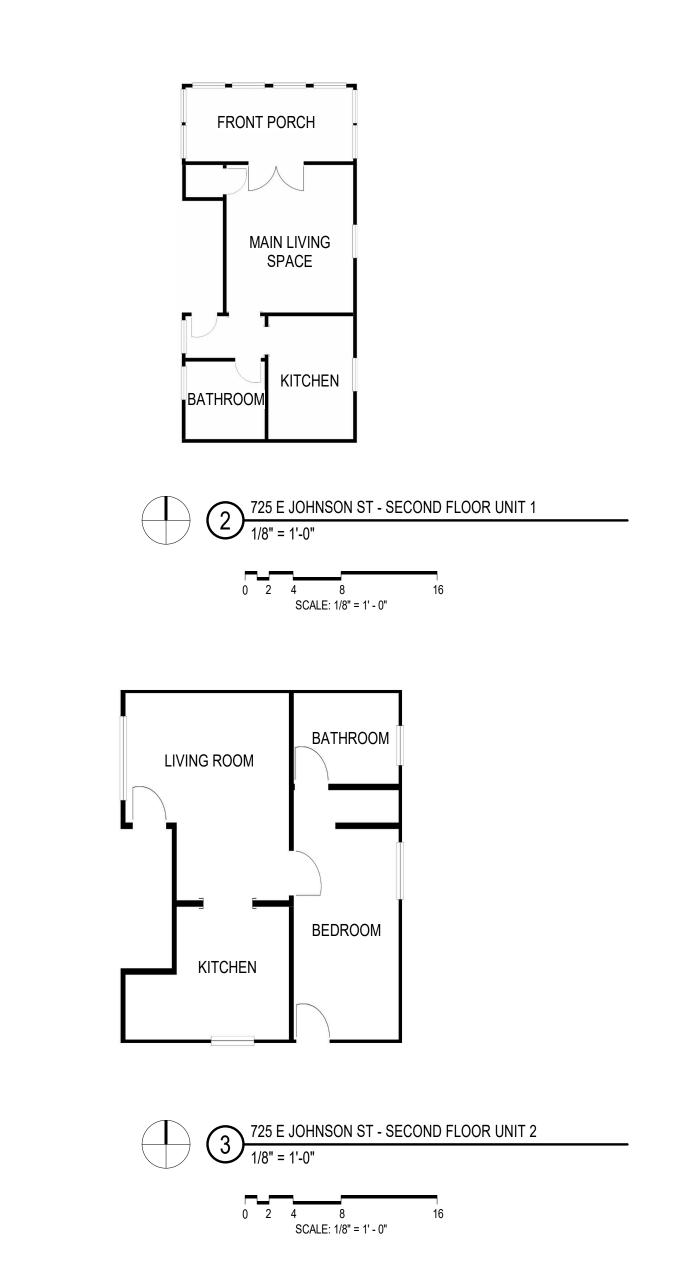

Sheet No. A101

Copyright © 2018 Kahler Slater, Inc. All rights reserved. 111 West Wisconsin Avenue, Milwaukee, Wisconsin 53203 Telephone 414.272.2000 Fax 414.272.2001 44 East Mifflin Street, Suite 700, Madison, Wisconsin 53703 Telephone 608.283.6300 Fax 608.283.6317

217014.00 Sheet Title 725 E JOHNSON - FLOOR PLANS & PHOTOS

700 EAST LLC

Project No.

827 E GORHAM ST MADISON WI 53703

827 E GORHAM ST

01/31/2018

SCOPE DOCUMENTS
Drawing Date

SCHEMATIC DESIGN





Sheet No. A102

Copyright © 2018 Kahler Slater, Inc. All rights reserved. 111 West Wisconsin Avenue, Milwaukee, Wisconsin 53203 Telephone 414.272.2000 Fax 414.272.2001 44 East Mifflin Street, Suite 700, Madison, Wisconsin 53703 Telephone 608.283.6300 Fax 608.283.6317

Sheet Title 725 E JOHNSON -ELEVATIONS

Project No. 700 EAST LLC 217014.00

827 E GORHAM ST MADISON WI 53703


827 E GORHAM ST

Drawing Date 01/31/2018

SCOPE DOCUMENTS


SCHEMATIC DESIGN



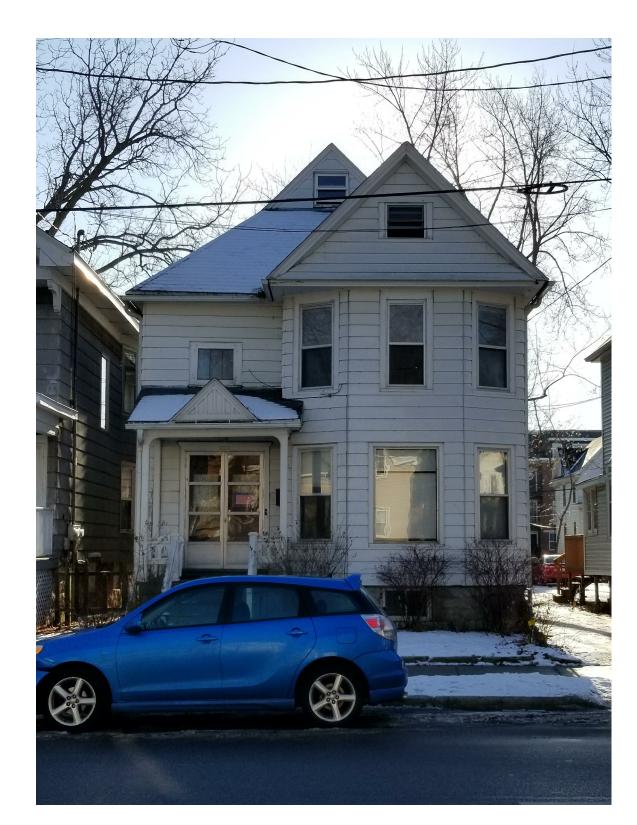



737 E JOHNSON




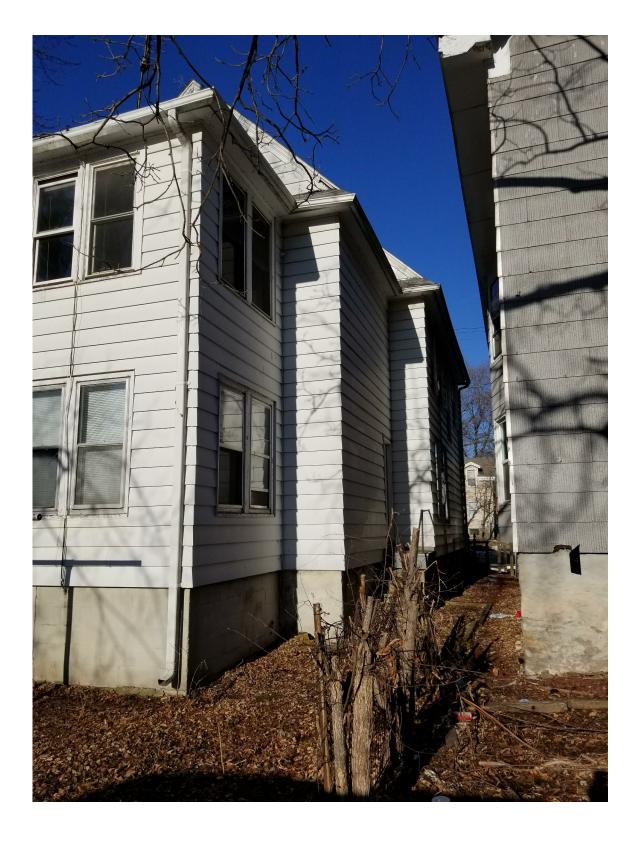



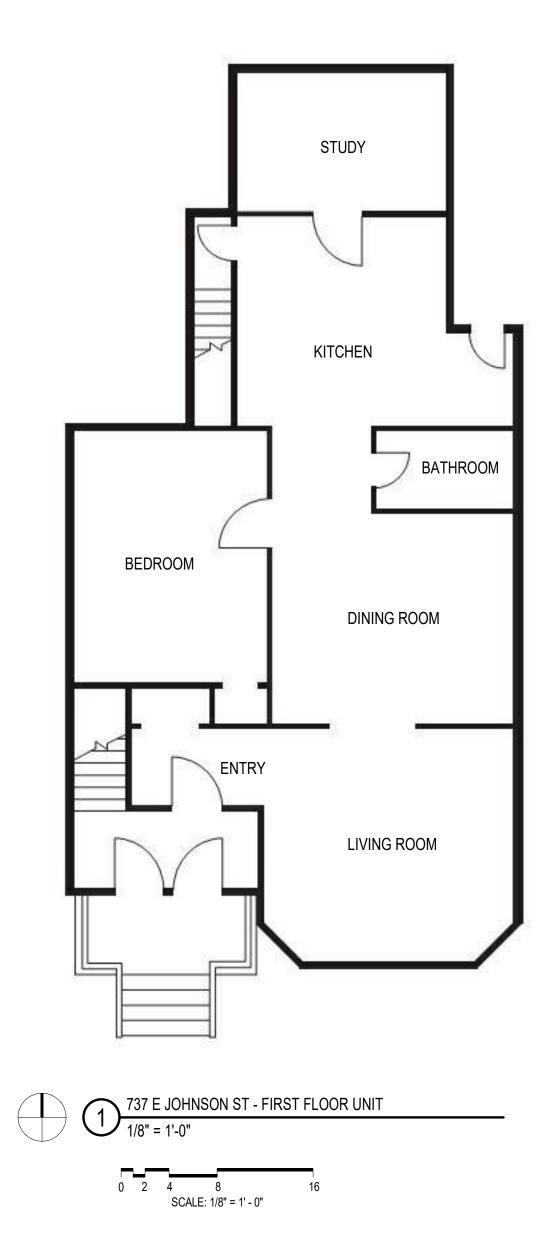

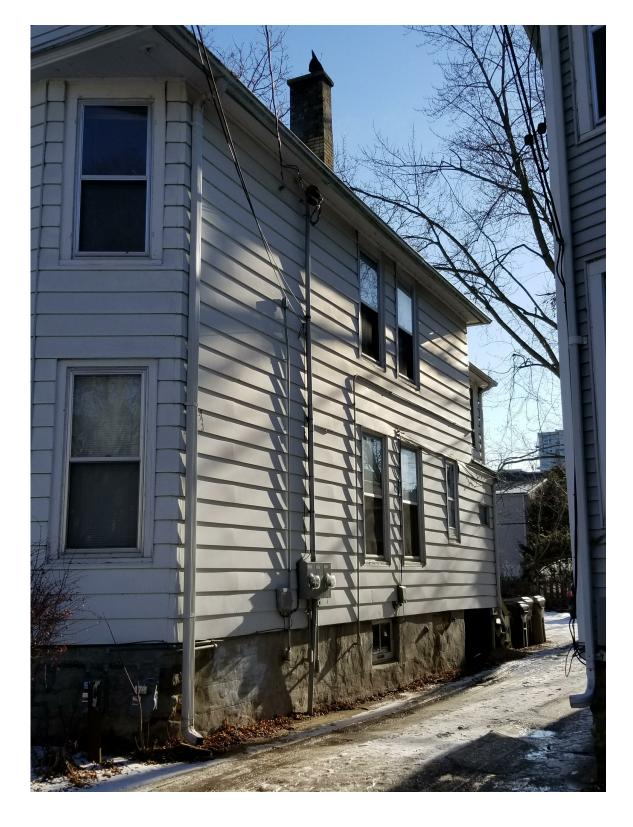

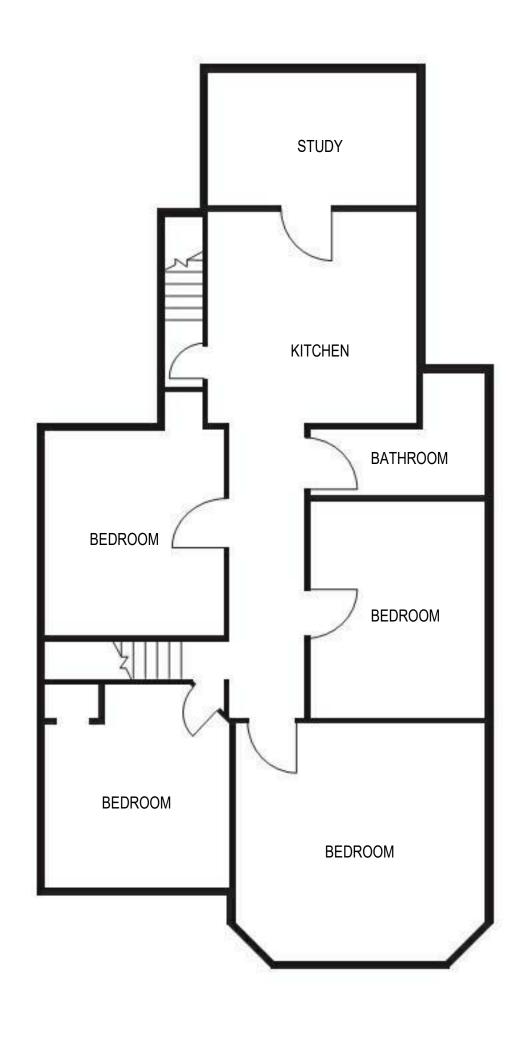

 $2 \frac{737 \text{ E JOHNSON ST - SECOND FLOOR UNIT}}{1/8" = 1'-0"}$

0 2 4 8 16 SCALE: 1/8" = 1' - 0"

Sheet No. A103

Copyright © 2018 Kahler Slater, Inc. All rights reserved. 111 West Wisconsin Avenue, Milwaukee, Wisconsin 53203 Telephone 414.272.2000 Fax 414.272.2001 44 East Mifflin Street, Suite 700, Madison, Wisconsin 53703 Telephone 608.283.6300 Fax 608.283.6317

700 EAST LLC 217014.00 Sheet Title 737 E JOHNSON - FLOOR PLANS & PHOTOS

Project No.

827 E GORHAM ST MADISON WI 53703

827 E GORHAM ST

01/31/2018

SCOPE DOCUMENTS
Drawing Date

SCHEMATIC DESIGN





Sheet No. A104

Copyright © 2018 Kahler Slater, Inc. All rights reserved. 111 West Wisconsin Avenue, Milwaukee, Wisconsin 53203 Telephone 414.272.2000 Fax 414.272.2001 44 East Mifflin Street, Suite 700, Madison, Wisconsin 53703 Telephone 608.283.6300 Fax 608.283.6317

Sheet Title 737 E JOHNSON -ELEVATIONS

Project No. 217014.00

700 EAST LLC

827 E GORHAM ST MADISON WI 53703

827 E GORHAM ST


01/31/2018

SCOPE DOCUMENTS
Drawing Date

SCHEMATIC DESIGN



Kahler Slater experience design

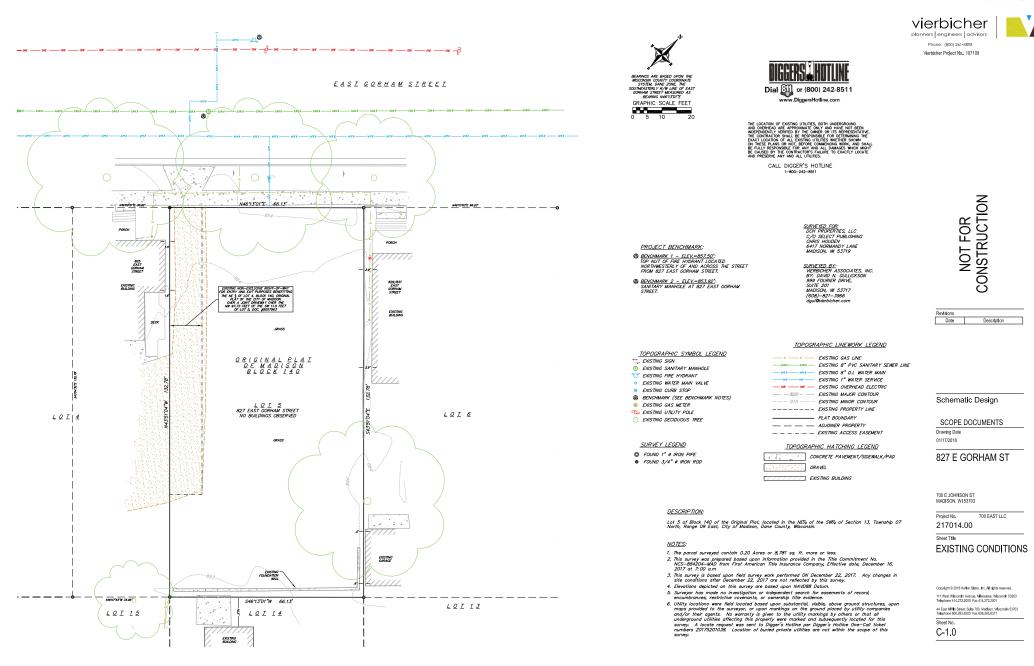



City of Madison Fire Department

30 West Mifflin Street, 8th & 9th Floors, Madison, WI 53703-2579 Phone: 608-266-4420 • Fax: 608-267-1100 • E-mail: fire@cityofmadison.com

Project Address: 827 East Gorham St, Madison, Wi

Contact Name & Phone #: Justin Zampardi 608-821-3970

FIRE APPARATUS ACCESS AND FIRE HYDRANT WORKSHEET

 Is the building completely protected by an NFPA 13 or 13R automatic fire sprinkler system? If non-sprinklered, fire lanes extend to within 150-feet of all portions of the exterior wall? If sprinklered, fire lanes are within 250-feet of all portions of the exterior wall? 	Yes X Yes Yes	× No No No	□ N/A □ N/A □ N/A
 2. Is the fire lane constructed of concrete or asphalt, designed to support a minimum load of 85,000 lbs? a) Is the fire lane a minimum unobstructed width of at least 20-feet? b) Is the fire lane unobstructed with a vertical clearance of at least 13¹/₂-feet? c) Is the minimum inside turning radius of the fire lane at least 28-feet? d) Is the grade of the fire lane not more than a slope of 8%? e) Is the fire lane posted as fire lane? (Provide detail of signage.) f) Is a roll-able curb used as part of the fire lane? (Provide detail of curb.) g) Is part of a sidewalk used as part of the required fire lane? (Must support +85,000 lbs.) 	 X Yes X Yes X Yes X Yes X Yes Yes Yes Yes Yes 	□ No □ No □ No □ No ○ No ○ No ○ No ○ No	□ N/A □ N/A □ N/A □ N/A □ N/A □ N/A □ N/A
3. Is the fire lane obstructed by security gates or barricades? If yes:a) Is the gate a minimum of 20-feet clear opening?b) Is an approved means of emergency operations installed, key vault, padlock or key switch?	☐ Yes ☐ Yes ☐ Yes	x No No No	□ N/A □ N/A □ N/A
4. Is the Fire lane dead-ended with a length greater than 150-feet? If yes, does the area for turning around fire apparatus comply with IFC D103?	Yes Yes	X No No	N/A N/A
5. Is any portion of the building to be used for high-piled storage in accordance with IFC Chapter 3206.6 If yes, see IFC 3206.6 for further requirements.	Yes	X No	N/A
6. Is any part of the building greater than 30-feet above the grade plane?	Yes	x No	N/A
 If yes, answer the following questions: a) Is the aerial apparatus fire lane parallel to one entire side of the building and covering at least 25% of the perimeter? b) Is the near edge of the aerial apparatus fire lane between 15' and 30' from the building? c) Are there any overhead power or utility lines located across the aerial apparatus fire lane? d) Are there any tree canopies expected to grow across the aerial fire lane? (Based on mature 	☐ Yes ☐ Yes ☐ Yes	□ No □ No □ No	□ N/A □ N/A □ N/A
 If yes, answer the following questions: a) Is the aerial apparatus fire lane parallel to one entire side of the building and covering at least 25% of the perimeter? b) Is the near edge of the aerial apparatus fire lane between 15' and 30' from the building? c) Are there any overhead power or utility lines located across the aerial apparatus fire lane? 	Yes	□ No □ No	N/A N/A
 If yes, answer the following questions: a) Is the aerial apparatus fire lane parallel to one entire side of the building and covering at least 25% of the perimeter? b) Is the near edge of the aerial apparatus fire lane between 15' and 30' from the building? c) Are there any overhead power or utility lines located across the aerial apparatus fire lane? d) Are there any tree canopies expected to grow across the aerial fire lane? (Based on mature canopy width of tree species) e) Does the aerial apparatus fire lane have a minimum unobstructed width of 26-feet? f) Is the space between the aerial lane and the building free of trees exceeding 20' in heights? 	☐ Yes ☐ Yes ☐ Yes ☐ Yes ☐ Yes ☐ Yes	□ No □ No □ No □ No □ No	 □ N/A □ N/A □ N/A □ N/A □ N/A
 If yes, answer the following questions: a) Is the aerial apparatus fire lane parallel to one entire side of the building and covering at least 25% of the perimeter? b) Is the near edge of the aerial apparatus fire lane between 15' and 30' from the building? c) Are there any overhead power or utility lines located across the aerial apparatus fire lane? d) Are there any tree canopies expected to grow across the aerial fire lane? (Based on mature canopy width of tree species) e) Does the aerial apparatus fire lane have a minimum unobstructed width of 26-feet? 	 ☐ Yes 	No No No No No No No No No	□ N/A □ N/A □ N/A □ N/A □ N/A □ N/A

Attach an additional sheet if further explanation is required for any answers.

This worksheet is based on MGO 34.503 and IFC 2012 Edition Chapter 5 and Appendix D; please see the codes for further information.



CITY OF MADISON LANDSCAPE WORKSHEET

Section 28.142 Madison General Ordinance

Project Location / Address 827 E Gorham St						
Name of Project	Relocation of 725 and 73	37 E Johnson				
Owner / Contact	Dwner / Contact Vierbicher, Attn. Justin Zampardi P.E.					
Contact Phone	608.821.3970	Contact Email	jzam@vierbicher.com			

** Landscape plans for zoning lots greater than ten thousand (10,000) square feet in size MUST be prepared by a registered landscape architect. **

Applicability

The following standards apply to all exterior construction and development activity, including the expansion of existing buildings, structures and parking lots, except the construction of detached single-family and two-family dwellings and their accessory structures. The entire development site must be brought up to compliance with this section unless **all** of the following conditions apply, in which case only the affected areas need to be brought up to compliance:

- (a) The area of site disturbance is less than ten percent (10%) of the entire development site during any ten-(10) year period.
- (b) Gross floor area is only increased by ten percent (10%) during any ten-(10) year period.
- (c) No demolition of a principal building is involved.
- (d) Any displaced landscaping elements must be replaced on the site and shown on a revised landscaping plan.

Landscape Calculations and Distribution

Required landscaped areas shall be calculated based upon the total developed area of the property. Developed area is defined as that area within a single contiguous boundary which is made up of structures, parking, driveways and docking/loading facilities, but excluding the area of any building footprint at grade, land designated for open space uses such as athletic fields, and undeveloped land area on the same zoning lot. There are three methods for calculating landscape points depending on the size of the lot and Zoning District.

(a) For all lots except those described in (b) and (c) below, five (5) landscape points shall be provided for each three hundred (300) square feet of developed area.

Total square footage of developed area ____6804 sf

Total landscape points required _____114

(b) For lots larger than five (5) acres, points shall be provided at five (5) points per three hundred (300) square feet for the first five (5) developed acres, and one (1) point per one hundred (100) square feet for all additional acres.

Total square footage of developed area _____

Five (5) acres = $\underline{217,800}$ square feet

First five (5) developed acres = 3,630 points

Remainder of developed area _____

Total landscape points required _____

(c) For the Industrial – Limited (IL) and Industrial – General (IG) districts, one (1) point shall be provided per one hundred (100) square feet of developed area.

Total square footage of developed area _____

Total landscape points required _____

Tabulation of Points and Credits

Use the table to indicate the quantity and points for all existing and proposed landscape elements.

Diout Truce/ Element	Minimum Size at	Points	Credits/ Existing Landscaping		New/ Proposed Landscaping	
Plant Type/ Element	Installation		Quantity	Points Achieved	Quantity	Points Achieved
Overstory deciduous tree	2 ¹ / ₂ inch caliper measured diameter at breast height (dbh)	35				
Tall evergreen tree (i.e. pine, spruce)	5-6 feet tall	35				
Ornamental tree	1 1/2 inch caliper	15			1	15
Upright evergreen shrub (i.e. arborvitae)	3-4 feet tall	10			5	50
Shrub, deciduous	#3 gallon container size, Min. 12"-24"	3			7	21
Shrub, evergreen	#3 gallon container size, Min. 12"-24"	4			8	32
Ornamental grasses/ perennials	#1 gallon container size, Min. 8"-18"	2				
Ornamental/ decorative fencing or wall	n/a	4 per 10 lineal ft.				
Existing significant specimen tree	Minimum size: 2 ¹ / ₂ inch caliper dbh. *Trees must be within developed area and cannot comprise more than 30% of total required points.	14 per caliper inch dbh. Maximum points per tree: 200				
Landscape furniture for public seating and/or transit connections	* Furniture must be within developed area, publically accessible, and cannot comprise more than 5% of total required points.	5 points per "seat"				
Sub Totals						118

Total Number of Points Provided 118

* As determined by ANSI, ANLA- American standards for nursery stock. For each size, minimum plant sizes shall conform to the specifications as stated in the current American Standard for Nursery Stock.

827 E Gorham St

LEGAL DESCRIPTION

Lot five (5), block one hundred forty (140), original plat of the City of Madison, in the City of Madison, Dane County, Wisconsin. Containing 8,779 square feet or 0.20 acres more or less.





VICINITY MAP