

City of Madison

Conditional Use

Location 135 East Towne Mall


Project Name Portillo's


Applicant J C Penney / Skip Alexander, CBL **Properties**

Existing Use Parking Lot

Proposed Use Construct restaurant with vehicle access sales and service window

Public Hearing Date Plan Commission 08 Janary 2018

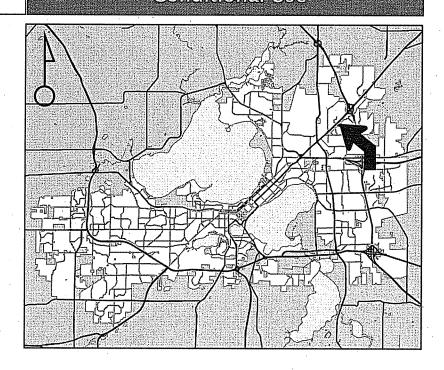

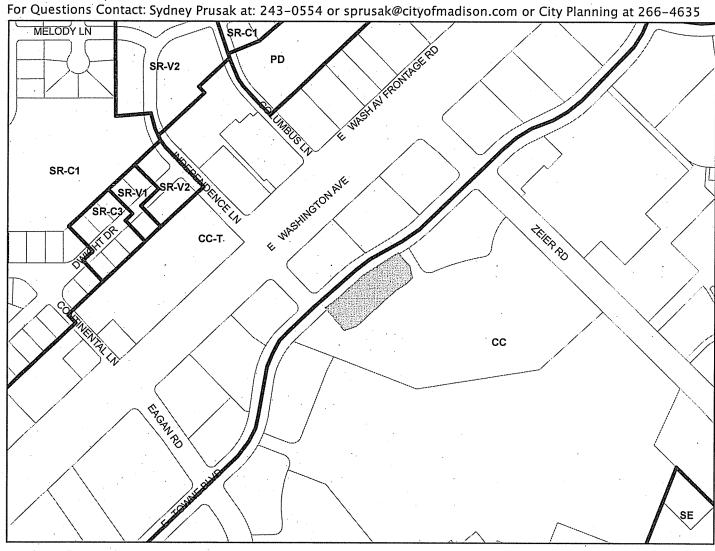


Scale: 1" = 400'

City of Madison, Planning Division: PPE: Date: 3 Jan 2018



City of Madison

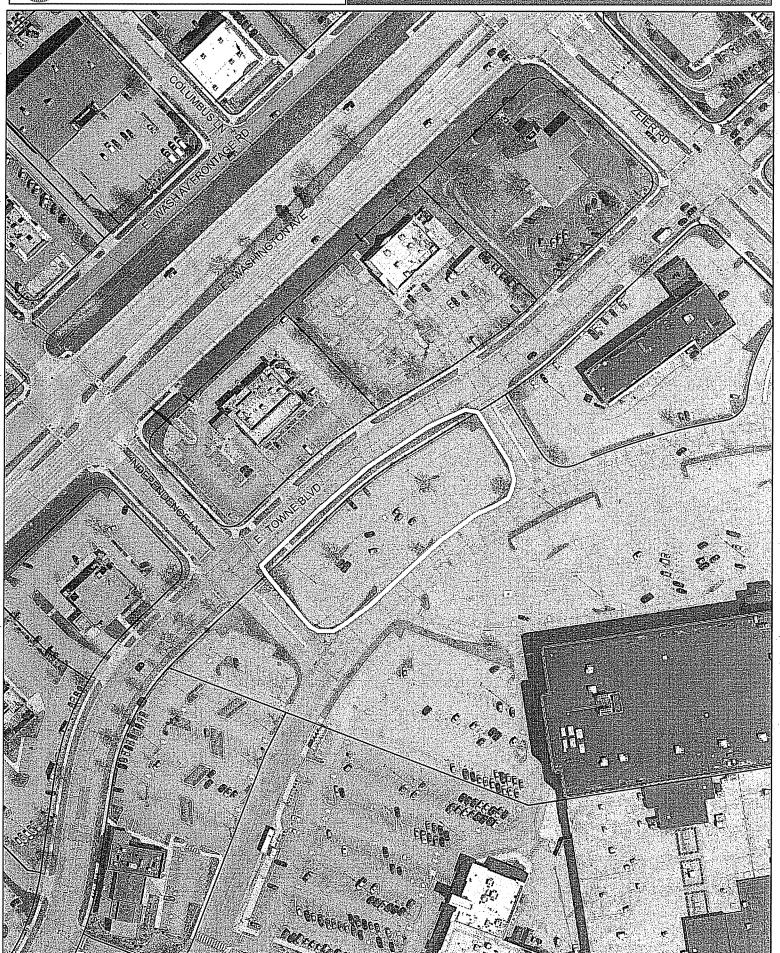

Date of Aerial Photography : Spring 2016 4



Zoning Office at the This completed for applications for Pla subdivisions or land	cations must be filed with the e above address. In is required for all in Commission review except divisions, which should be division Application found on	FOR OFFICE USE ONLY: Paid 76 C Receipt # 037134 - 0007 Date received 11 8 1 1 Received by 18 1 1 Parcel # 6816 - 273 - 0097 - 10 Aldermanic district 17 - BALDEH Zoning district C C Special requirements Review required by PC Common Council Other Reviewed By PC Rev
	·	·
1. Project Information	n .	
Address: Prop	oosed Address: 4505 East Tov	ne Blvd. Madison, WI 53704-3713
Title: Port	tillo's Restaurant East Towne N	/lall
a This is an amplication	f (-bbll sb-st-soub)	
	on for (check all that apply)	
- -	mendment (rezoning) from ·	ppment-General Development Plan (PD-GDP) Zoning
		opment-Specific Implementation Plan (PD-SIP)
	ration to Planned Development (PD)	
	e or Major Alteration to an Approve	
□ Demolition Pe	rmit	
☐ Other request:	S	
2 Bundianat America	nd Property Owner Information	
	Skip Alexander	CPI Proportion*
Applicant name Street address	2030 Hamilton Place Blvd.	Company CBL Properties* City/State/Zip Chattanooga, TN 37421-6000
Telephone	423.490.8822	Email skip.alexander@cblproperties.com
•	•	
Street address	rson Same as Above	City/State/7ip
Telephone	\$\tag{\text{\tince{\text{\texi{\text{\text{\text{\text{\text{\text{\text{\text{\text{\text{\tinit}\\ \text{\texi}\text{\text{\text{\text{\text{\text{\text{\text{\text{\text{\ti}\tint{\text{\text{\text{\text{\text{\tin}\tint{\text{\text{\text{\text{\text{\text{\text{\text{\text{\text{\text{\text{\text{\tin\tint{\text{\texi}\tint{\text{\texictex{\text{\texit{\text{\ti}\tint{\text{\texit{\text{\texi}\tint{\text{\tint}\text{\t	City/State/ZipEmail
•	not continued. IC Penney	
Street address	not applicant) JC Penney n/a	City/State/Zip n/a
Telephone	n/a	City/State/Zip <u>n/a</u> Email <u>n/a</u>
icichitotic		1.47 M

*CBL Properties, authorized entity by JC Penney (Underlying Land Owner)

(Fattg)	Use Application			LND-B
4. Pro	ject Description			
Pro	vide a brief description o	f the project and all proposed uses of the	site:	
P	ortillo's is proposing a	n approximate 9,075 SF restaurant	on lands currently	y owned by JC Penney
<u>vi</u> a	a a Conditional Use L	and Use Application and Certified S	Survey Map.	
Sch	eduled start date _April	2018 Planned completion	date <u>Fall 2018</u>	
5. Red	quired Submittal Materia	ıls		
Ref	er to the Land Use Applic	ation Checklist for detailed submittal requ	irements.	
X	Filing fee	☑ Pre-application notification	☑ Land Use Applica	tion Checklist (LND-C)
Ø	Land Use Application	☑ Vicinity map		quirements
X	Letter of intent	☑ Survey or existing conditions site plan	☑ Electronic Submi	ttal*
\boxtimes	Legal description	☑ Development plans		
or fi and	ash drive, or submitted via en applicant name. Electronic su	omitted in hard copy are required. Individual PDF j nail to pcapplications@cityofmadison.com. The en abmittals via file hosting services (such as Dropbo; lly should contact the Planning Division at (608) 2	mail must include the pro x.com) are not allowed. A	oject address, project name,
Foll sub	owing the pre-application mitted to the UDC Secreta	ons a separate pre-application meeting with meeting, a complete UDC Application form a ry. An electronic submittal, as noted above, it we, or sent via email to udcapplications@cityon.	and all other submittal s required. Electronic :	requirements must be
6. Ap	plicant Declarations			* .
Ø		g with staff. Prior to preparation of this ap the proposed development and review prodate.		
	Planning staff DAT Me	eetings	Date <u>(</u>	03.23.17 & 09.07.17
	Zoning staff DAT Me	etings	Date ()3.23.17 & 09.07.17
	Demolition Listserv			
	Public subsidy is being r	requested (indicate in letter of intent)		
X	nearby neighborhood a	ntion: The zoning code requires that the ap nd business associations in writing no late ighborhood association(s), business association	r than 30 days prior	to FILING this request.
	Email notification pr	rovided to District 17 Alder Samba E	<u> 3aldeh on 08.30.1</u>	7
	Notification acknow	ledged and Neighborhood Meeting	requested and so	heduled for 09.28.17
	requirement or waive the notification is required as	e Director of Planning & Community & Eco ne pre-application notification requiremen part of the application materials. A copy of ired as part of the application materials.	t altogether. Evidence	of the pre-application
The ap	pplicant attests that this	form is accurately completed and all requ	ired materials are su	bmitted:
Name	of applicant Skip Alexan		ionship to property	Authorized Entity by Property Owner
Author	izing signature of proper	ty owner <u>fli Alexane.</u>	Date	11.03.17.

|2|



Memorandum / Letter of Intent

www.jsdinc.com

To: City of Madison Plan Commission, Urban Design Commission & City Staff

From: Justin Frahm, JSD Professional Services, Inc.

Re: Portillo's Restaurant – East Towne Mall, 4505 East Towne Blvd. Madison, WI

JSD Project #: 16-7567

CC:

Date: November 8, 2017

Skip Alexander, CBL; Wendy Hunter, Hunter Development Group; Peggy Hart, Portillo's;

Walter Sydor, Portillo's; Jarrett Jensen, Jensen & Jensen

City of Madison Staff, Plan Commission & Urban Design Commission:

On behalf of CBL & Associates Properties, Inc, and Portillo's Hot Dogs, LLC, JSD is submitting and requesting an initial-final Urban Design Commission review and subsequent Plan Commission review and approval for the issuance of a Conditional Use Permit and construction of a Portillo's Hot Dogs restaurant at the East Town Mall, in Madison, WI.

CBL and Portillo's are proposing a 9,075 SF restaurant with a drive through vehicle service window to be constructed on an outlot to be subdivided via CSM on an underlying parcel owned by JC Penney northwest of East Towne Mall. The City anticipates the address of the restaurant outlot to be 4505 East Towne Blvd, Madison, WI 53704-3713.

The proposed Portillo's restaurant building will include 209 interior seats and 26 additional seats on the covered, outdoor patio. Hours of operation will typically be 10:30 AM to 11 PM.

Portillo's new freestanding building design will include an upgraded brick structure with accents of clear stainless steel, creating an Art Deco-based diner building. Access to the site will be limited to the interior mall ring road, with no vehicular access to adjacent public right-of-ways. The building entrance will face the parking lot, with drive through circulation circling the building. Parking is provided on site, along with bicycle parking and pedestrian sidewalks connecting to the public sidewalks along East Towne Blvd and existing bus stops, as well as the rear of the JCPenney facility for Mall access. An outdoor patio, accessible from the interior of the restaurant, will provide seasonal outdoor service. Site parking area, foundation and site landscaping will provide screening of the drive through lane, with foundation planting accenting the building design.

CBL and Portillo's have worked together with the City Staff, Development Assistance Team and UDC to review and inform plan development for the proposed site layout/circulation, building design, and sign package. Further, the project information has been presented to Alder Samba Baldeh at a public neighborhood meeting, with attendance of local constituents.

Construction is proposed to start in the spring of 2018, with an opening in fall 2018.

Enclosures

- Letter of Transmittal Land Use Application
- Letter of Transmittal Urban Design Commission Application (Initial & Final Combined Request)
- Land Use Application (Conditional Use Request Vehicular service window)
- Land Use Application Checklist

- Land Use Application Fee (\$700 for Conditional Use \$600 + \$100 for each addt'l acre 2-7)
- Urban Design Commission Application (Initial-Final Combined Request)
- Urban Design Commission Fee (\$300)
- Memorandum / Letter of Intent
- Legal Description of Proposed Parcel
- Pre-Application Notification to Alder
- Development Plans:
 - Ex. A Location Map
 - Ex. B Context Photos
 - C1.0 Title Sheet
 - C2.0 Existing Conditions Survey
 - C3.0 Demolition Plan
 - C4.0 Site Plan
 - C5.0 Grading and Erosion Control Plan
 - C6.0 Utility Plan
 - C7.0 Fire Access Exhibit
 - C8.0 Details
 - C8.1 Details
 - L1.0 Landscape Plan
 - L2.0 Landscape Details Notes and Specifications
 - Photometric Plan
 - Photometric Specifications (2 copies)
 - Architectural Plans
 - o Floor Plans
 - o Roof Plan
 - Line Elevations w/ Material Callouts
 - o Color Elevations w/ Material Callouts
 - o Material Board
 - o Renderings
 - Signage Plans
 - o Aerial Site Plan
 - o Proposed Site Plan / Locator Map
 - o Site Photographs
 - o Building Signage Elevation
 - Building Signage Details
 - o Site Signage Details
- Stormwater Management Memorandum (2 copies)

Additional requests for information and/or questions can be directed to JSD Professional Services, Inc.



Professional Services, Inc.

Engineers · Surveyors · Planners

CREATE THE VISION TELL THE STORY

MADISON REGIONAL OFFICE 161 HORIZON DRIVE, SUITE 101 VERONA, WISCONSIN 63593 P. 608.848.5060

CBL & ASSOCIATES
PROPERTIES

CLIENT ADDRESS: 2030 HAMILTON PLACE BLVD., STE. 500, CHATANOOGA, TN 34721

PROJECT:
PORTILLO'S, EAST
TOWNE MALL

PROJECT LOCATION: CITY OF MADISON, WI DANE COUNTY

Date: Description:
11-08-17 Land Use - UDC Initial/Final

LOCATION MAP

IMAGE 1: FROM SITE FACING NORTHEAST TOWARD OUTBACK STEAKHOUSE



IMAGE 4: FROM SITE FACING WEST TOWARD ASSOCIATED BANK LOT



IMAGE 7: FROM SITE FACING SOUTH TOWARD JC PENNY



IMAGE 2: FROM SITE FACING NORTH TOWARD RED LOBSTER



IMAGE 5: FROM SITE FACING EAST TOWARD FIRESTONE AUTO



IMAGE 8: FROM SITE FACING SOUTHWEST TOWARD MALL ENTRANCE



IMAGE 3: FROM SITE FACING NORTHWEST TOWARD ASSOCIATED BANK



IMAGE 6: FROM SITE FACING SOUTHEAST TOWARD JC PENNY LOT



IMAGE 9: FROM SITE FACING SOUTHWEST TOWARD INDEPENDENCE LANE





CREATE THE VISION TELL THE STORY

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CLIENT ADDRESS: 2030 HAMILTON PLACE BLVD., STE. 500, CHATANOOGA, TN 34721

PORTILLO'S, EAST
TOWNE MALL

PROJECT LOCATION: CITY OF MADISON, WI DANE COUNTY

Date:	Description:	
11-08-17	08-17 Land Use - UDC Initial/Fina	
	-	
	-	
/Drawn: JLF /	TKG 10-13-2017	
red: PMP	10-13-2017	
led:	10-13-2017	


PORTILLO'S EAST TOWNE MALL

CITY OF MADISON, WISCONSIN

NE 1/4, SE 1/4, SECTION 28, TOWNSHIP 08 NORTH, RANGE 10 EAST

DRAWING INDEX

C1.0	TITLE SHEET
C2.0	SURVEY
C3.0	DEMOLITION PLAN
C4.0	SITE PLAN
C5.0	EROSION CONTROL
C6.0	GRADING PLAN
C7.0	UTILITY PLAN
C8.0	DETAILS
C8.1	DETAILS
L1.0	LANDSCAPE PLAN
L2.0	LANDSCAPE DETAILS & NOTES

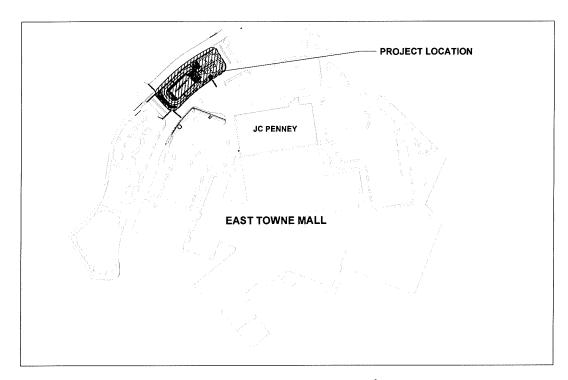

PROJECT AREA NOT TO SCALE



PROJECT INFORMATION

CBL Properties/Skip Alexander CBL Center, Suite 500, 2030 Hamilton Place Bivd. Chattanooga, TN 37421-6000 P: 423-855-0001

ARCHITECT / INTERIOR DESIGN Jensen & Jensen Architects/Jarrett Jensen Midwest Plaza Center, 2001 Midwest Road, Suite 301 P:630-573-1770



CIVIL CONSULTANT JSD Weston/Justin Frahm 7402 Stone Ridge Drive ,Suite 4

Weston, WI 54476 P: 715-298-6330 justin.frahm.@jsdinc.com



REATE THE VISION TELL THE STOR

MADISON REGIONAL OFFICE VERONA, WISCONSIN 63593 P. 608.848.5060

CBL & ASSOCIATES **PROPERTIES**

2030 HAMILTON PLACE BLVD., STE. 500, CHATANOOGA, TN 34721

PORTILLO'S, EAST TOWNE MALL

CITY OF MADISON, WI DANE COUNTY

LAN MODIFICATION	NS:
Date:	Description:
11-08-17	Land Use - UDC Initial/Final
11-08-17	
<u> </u>	

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1	
2	
:	
<u> </u>	
sign/Drawn: JLF/	TKG 10-13-2017
oproved: PMP	10-13-2017
bmitted:	10-13-2017
REET TITLE:	

TITLE SHEET

J.C. PENNY BUILDING

EXISTING CONDITIONS SURVEY

PART OF THE NORTHEAST QUARTER OF THE SOUTHEAST QUARTER SECTION 28, TOWNSHIP 08 NORTH, RANGE 10 EAST, CITY OF MADISON, DANE COUNTY, WISCONSIN.

COVERNMENT CORNER PHANAGE PROPAGATOR TOWN OF THE TOWN

1. FIELD WORK PERFORMED BY JSD PROFESSIONAL SERVICES, INC. ON AUGUST 28 AND 30, 2017.

- 2. BEARINGS FOR THIS SURVEY AND MAP ARE REFERENCED TO THE WISCONSHI COUNTY COORDINATE SYSTEM (DANE COUNTY). THE EAST LINE OF THE SOUTHEAST QUARTER OF SECTION 28, TOWN, RICE, BEARS SOOS4'38"W.
- 3. ELEVATIONS ARE BASED ON THE NORTH AMERICAN VERTICAL DATUM OF 1988 (NAVD88). BENCHMARK IS A BRASS CAP IN CONCRETE MARKING THE EAST QUARTER CORNER OF SECTION 28, TORN, RICE, ELEVATION = 879.55°. 4. CONTOUR INTERVAL IS ONE FOOT.
- 5. SPOT ELEVATIONS IN CURBED AREAS REFERENCE THE PAVEMENT EDGE ELEVATIONS.
- SUBSURFACE UTILITIES AND FEATURES SHOWN ON THIS WAP HAVE BEEN APPROXIMATED BY LOCATING SURFICIAL FEATURES AND APPURITENANCES, LOCATING DOCORS HOTILAE FELD MARKINGS AND BY REFERENCE TO UTILITY RECORDS AND WAPS. DIGGER'S HOTILAE TICKET NO. 2017.3313821 ANI 2017.3313829, WITH A CLEAR DATE OF AUGUST 21, 2017.
- 7. URLITY COMPANES CONTACTED THRU DIGGERS HOUNGE CITY OF MADISON DIGNERSHO MADISON DIGNERSHO MADISON DIGNERSHO AMBIGNAM TRANSASSION COMPANY ATTE DISTRIBUTION CONTRIVIANCE MADISON COMPANY ATTE DISTRIBUTION CONTRIVIANCE MADISON METERS DISTRICT

- 8. BEFORE EXCAVATION, APPROPRIATE UTILITY COMPANES SHOULD BE CONTACTED. FOR EXACT LOCATION OF UNDERGROUND UTILITIES, CONTACT DIGGERS HOULD, AT 1.800.242.8511.
- 9. JSD DOES NOT GUARANTEE THAT THE BENCHMARKS USTED ON THIS MAP HAVE NOT BEEN DISTURBED SINCE THE DATE OF THIS SURVEY AND SHOULD BE VENIFED PROPE TO CONSTRUCTION ACTIVITIES.

LEGAL DESCRIPTION

PART OF LOT 1, CERTIFIED SURVEY WAP NO. 13722, RECORDED IN VOLUME 90 OF DAME COUNTY CERTIFIED SURVEY WAPS ON PAGES 215-223 AS DOCUMENT NUMBER 5071049, CITY OF WADISON, DAME COUNTY, WISCONSIN WORE PARTICULARLY DESCRIBED AS FOLLOWS:

SAID PARCEL CONTAINS 53,380 SQUARE FEET OR 1.225 ACRES.

TAX KEY NO: 251/0810-273-0097-0

SURVEYOR'S CERTIFICATE

L JOHN KREBS, MISCONSIN PROFESSIONAL LAND SURVEYOR NO. S-1878, HEREBY CERTIFY THAT THIS EXISTING CONDITIONS SURVEY AND MAP IS CORRECT TO THE BEST OF MY KNOWLEDGE AND BELIEF IN ACCORDANCE WITH THE INFORMATION PROVIDED.

JOHN KREBS, S-1878 PROFESSIONAL LAND SURVEYOR

SANITARY SEWER MANHOLES | 187.65 | 18.5 | 18.7 | 18.7 
	STORM	SEWER	MANHOLE	S	
STRUCT. ID	RIM ELEVATION	INVERT	ELEVATION	PIPE SIZE	PIPE 1
CR-1	871.72	NE	865,75	30°	RC
	33773	SW	865,67	30"	RC
CB-2	871.46	NE	865.57	30"	RC
		SW	865.54	30"	RC
CB-3	871.23	NE	865,43	30"	RC
		SW	865,48	30"	RC
C8-4	870.53	NE	664.73	30"	RCI
		SW	864.66	30"	RCI
C8-6	869.39	CENTER	864.19	30"	RO
STM-1	878.78	NE	871.65	48"	RC
		E		12"	RC
		W		12"	RO
		SW	871.64	48"	RC
STM-2	876.50	NE	869.45	48"	RO
		SW	869.45	48"	RC
STM-3	874.38	NE		48"	RO
4.9	1000000	W	•	30°	RC
		SW		60°	RC

	STOR	M SEWE	R INLETS		
INLET ID	RIM ELEVATION	INVERT	ELEVATION	PIPE SIZE	PIPE TY
INL-1	877.83	W	875.76	12"	RCP
INL-2	877,84	E	875.79	12"	RCP
INL-3	873.65	NW	871.50	12"	RCP
INL-4	873.30	SW	871.30	12"	RCP
INL-5	872.90	N	870.90	12"	RCP
	-	NE	870,70	12"	RCP
		SW	870,45	12"	RCP
INL-6	872.97	SW	869.72	12"	RCP
		NE	869.67	18"	RCP
INL-7	872.65	E	870.65	12"	RCP

BENCHMARKS				
BENCH	ELEVATION	DESCRIPTION		
BM-1	879.55	CONCRETE MONUMENT AT THE EAST QUARTER CORNER OF SECTION 28-08-10		
BM-2	876.20	3/4" REBAR EAST OF SITE		

"AND DOES NOT CHARANTE THAT THE BENCHMARK DEPARTORS USED ON THIS MAP HAVE NOT BEEN DISTURBED SINCE THE DATE OF THIS SURVEY AND SHOULD BE VERFED PROR TO CONSTRUCTION ACTIVITIES.

C-1	65.30	40.50	92"22"40"	58.45'	S14'50'53'W
C-2	299.37	885.34"	19"22"26"	297.94	S51'21'00'W
C-3	68.30	40.50	96'37'26"	60.49*	S89'58'30"W
C-4	126.72	603.56	12'01'46"	126.49	N52"26"43"E



REATE THE VISION TELL THE STORY

MADISON MILWAUKEE KENOSHA APPLETON WAUSAU

MADISON REGIONAL OFFICE 161 HORIZON DRIVE, SUITE 101 VERONA, WISCONSIN 53393 P. 608.848.5060

CBL & ASSOCIATES PROPERTIES, INC

CLIENT ADDRESS: 2030 HAMILTON PLACE BLVD., STE. 500, CHATAGOONA, TN 34721

PORTILLO'S, EAST TOWNE MALL


PROJECT LOCATION.
CITY OF MADISON
DANE COUNTY, WISCONS



30'		30'
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N MCDIFICAT	IONS:	_
Date:	Description:	
Date: 09.07.17	Description: X	
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EXISTING CONDITIONS

1 OF 1

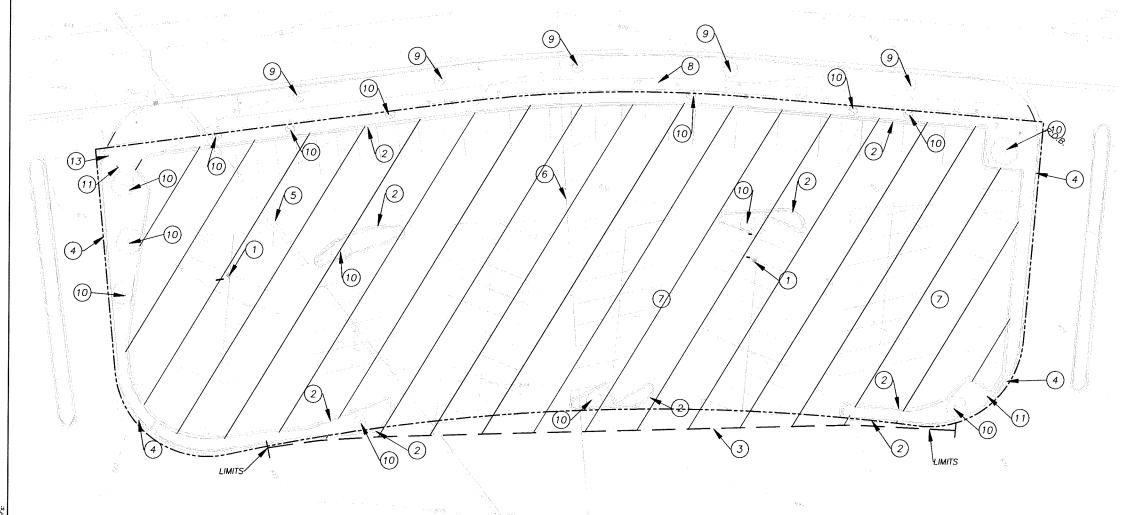

10)

(10)

LEGEND (GRADING & EROSION CONTROL)

--- SAN -----

SANITARY SEWER WATERMAIN STORM SEWER

CONCRETE PAVEMENT

STANDARD CURB AND GUTTER DEMOLITION KEY NOTE NUMBER

DEMOLITION KEY NOTES

4

- (2) REMOVE EXISTING CURB TO LIMITS SHOWN.
- (3) SAW CUT EXISTING ASPHALT PAVEMENT.
- (4) EXISTING CURB & GUTTER TO REMAIN. 5 EXISTING ELECTRIC SERVICE TO BE RELOCATED. COORDINATE WITH MG & E.
- 6 EXISTING GAS SERVICE TO BE RELOCATED. COORDINATE WITH MG & E.
- 7) REMOVE EXISTING ASPHALT PAVEMENT.
- EXISTING WALK TO REMAIN.
- 9 EXISITING TREES TO REMAIN.
- (1D) EXISTING TREE TO BE REMOVED.
- (11) EXISTING SIGN TO REMAIN.
- (12) EXISTING LIGHT POLE TO BE RELOCATED. (13) EXISTING SIGN TO BE RELOCATED.

Professional Services, Inc.

CREATE THE VISION TELL THE STORY

MADISON MILWAUKEE KENOSHA APPLETON WAUSAU

MADISON REGIONAL OFFICE JISON REGIONAL OFFI 161 HORIZON DRIVE, SUITE 101 VERONA, WISCONSIN 63593 P. 608.848.5060

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PORTILLO'S, EAST TOWNE MALL

PROJECT LOCATION CITY OF MADISON, WI DANE COUNTY

11-08-17 Land Use - UDC Initial/Final


Design/Drawn: JLF/TKG 10-13-2017 10-13-2017 10-13-2017


DEMOLITION PLAN

Toll Free (800) 242-8511

DEMOLITION NOTES

- THIS PLAN INDICATES ITEMS ON THE PROPERTY INTENDED FOR DEMOLITION BASED ON THE CURRENT SITE DESIGN THAT HAVE BEEN IDENTIFIED BY A REASONABLE OBSERVATION OF THE EXISTING CONDITIONS THROUGH FIELD SURVEY RECONNAISSANCE. "DIGGER'S HOTLINE" LOCATION, AND GENERAL "STANDARD OF CARE". THERE MAY BE ADDITIONAL ITEMS THAT CAN NOT BE IDENTIFIED BY A REASONABLE ABOVE GROUND OBSERVATION, OF WHICH THE ENGINEER WOULD HAVE NO KNOWLEDGE OR MAY BE A PART OF ANOTHER DESIGN DISCIPLINE. IT IS THE CONTRACTOR'S BUDGER'S RESPONSIBILITY TO REVIEW THE PLANS, INSPECT THE SITE AND PROVIDE HIS OWN DUE DILIGENCE TO INCLUDE IN HIS BID WHAT ADDITIONAL ITEMS, IN HIS OPINION, MAY BE NECESSARY FOR DEMOLITION, ANY ADDITIONAL ITEMS IDENTIFIED BY THE CONTRACTOR/BIDDER SHALL BE IDENTIFIED IN THE BID AND REPORTED TO THE ENGINEER OFECORD. JOS TAKES NO RESPONSIBILITY FOR ITEMS ON THE PROPERTY THAT COULD NOT BE LOCATED BY A REASONABLE OBSERVATION OF THE PROPERTY OR OF WHICH THEY WOULD HAVE NO KNOWLEDGE.
- ALL TREES WITHIN THE CONSTRUCTION LIMITS SHALL BE REVIOVED UNLESS SPECIFICALLY CALLED DUT FOR PROTECTION. ALL TREES TO BE REMOVED SHALL BE REMOVED IN THEIR ENTIRETY AND STUMPS SHALL BE GROUND TO PROPOSED SUBGRADE.
- PERFORM TREE PRUNING IN ALL LOCATIONS WHERE PROPOSED PAVEMENT AND/OR UTILITY INSTALLATION ENGROACH WITHIN THE EXISTING DRIP LINE OF THE TREES TO REMAIN, ALL TRENCHING WITHIN THE EXISTING DRIP LINE OF THE TREES TO REMAIN SHALL BE DONE RADIALLY AWAY FROM THE TRUNK IF ROOTS IN EXCESS OF 10 DIAMETER ARE EXPOSED. ROOTS MUST SHE CUIT BY REPUTABLE TREE PRUNING SERVICE PRIOR TO ANY TRANSVERSE TRENCHING.
- 5. ALL LIGHT POLES TO BE REMOVED SHALL BE REMOVED IN THEIR ENTIRETY, INCLUDING BASE AND ALL APPURTENANCES, SALVAGE FOR RELOCATION, COORDINATE RELOCATION AND/OR ABANDONMENT OF ALL ELECTRIC LINES WITH ELECTRICAL ENGINEER AND OWNER PRIOR TO DEMOLITION.
- ABANDONED/REMOVED ITEMS SHALL BE DISPOSED OF OFF SITE UNLESS OTHERWISE NOTED.
- THE CONTRACTOR SHALL INSTALL A PEDESTRIAN FENCE AROUND ALL EXCAVATIONS TO BE LEFT OPEN OVERNIGHT AS REQUIRED.
- CONTRACTOR TO REPLACE ALL SIDEWALK AND CURB AND GUTTER ABUTTING THE PROPERTIES, WHICH IS DAMAGED BY THE CONSTRUCTION.
- 9. GRANULAR BACKFILL MATERIALS ARE REQUIRED IN ALL UTILITY TRENCHES UNDER SIDEWALKS AND PROPOSED PAVED AREAS, ALL UTILITY TRENCH BACKFILL SHALL BE COMPACTED PER SPECIFICATIONS.
- PRIOR TO CONSTRUCTION, THE CONTRACTOR IS RESPONSBLE FOR:
 EXAMINIONG ALL SITE CONDITIONS RELATIVE TO THE CONDITIONS INDICATED ON THE ENGINEERING DRAWINGS. ANY DISCREPANCIES ARE TO BE REPORTED IMMEDIATELY TO THE ENGINEER AND RESOLVED PRIOR TO THE START OF CONSTRUCTION.
- 10.2. VERIFYING UTILITY ELEVATIONS AND NOTIFYING ENGINEER OF ANY DISCREPANCIES. NO WORK SHALL BE PERFORMED UNTIL THE DISCREPANCIES ARE RESOLVED.
- 10.3. NOTIFYING ALL UTILITIES PRIOR TO THE REMOVAL OF ANY UNDERGROUND UTILITIES.
- 10.4. NOTIFYING THE DESIGN ENGINEER AND LOCAL CONTROLLING MUNICIPALITY 48 HOURS PRIOR TO THE START OF CONSTRUCTION TO ARRANGE FOR APPROPRIATE CONSTRUCTION INSPECTION.
- 12. CONTRACTOR IS RESPONSIBLE FOR SITE SAFETY DURING THE CONSTRUCTION OF THESE IMPROVEMENTS.
- 14. ALL DEMOLITION SHALL BE IN ACCORDANCE WITH THE APPROVED CITY OF MADISON RECYCLING PLAN.
- 16. ALL EXISTING UTILITIES TO BE FIELD LOCATED AND FLAGGED BY CONTRACTOR.

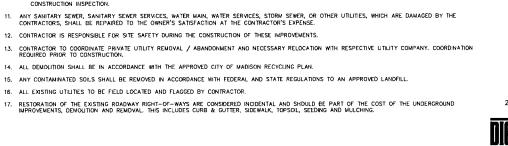

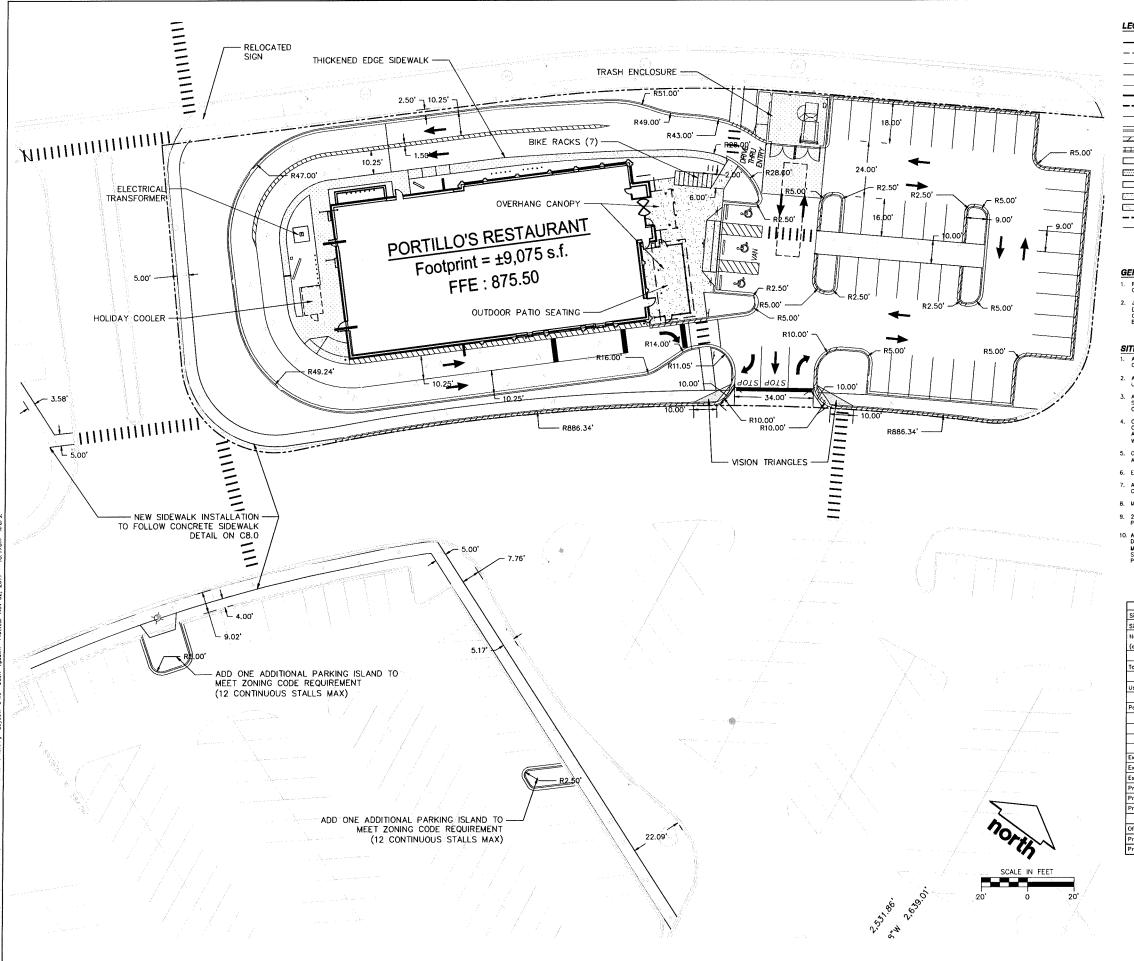

LEGEND (SITE PLAN)

RIGHT-OF-WAY EASEMENT LINE BUILDING SETBACK LINE PAVEMENT SETBACK LINE BUILDING OUTLINE BUILDING OVERHANG EDGE OF PAVEMENT STANDARD CURB AND GUTTER REJECT CURB AND GUTTER MOUNTABLE CURB ASPHALT PAVEMENT HEAVY DUTY ASPHALT PAVEMENT CONCRETE PAVEMENT CONCRETE PAVEMENT- DEEP CHARCOAL U49 CONCRETE PAVEMENT- SIENNA U37 SAWCUT EXISTING PAVEMENT STORMWATER MANAGEMENT AREA --LIGHT POLE (REFER TO PHOTOMETRIC PLAN) ADA PARKING BOLLARDS/SIGNS

GENERAL NOTES:

- REFER TO THE EXISTING CONDITIONS SURVEY FOR EXISTING CONDITIONS NOTES AND LEGENDS.
- 2. JSD SHALL BE HELD HARMLESS AND DOES NOT WARRANT ANY DEWATIONS BY THE OWNER/CONTRACTOR FROM THE APPROVED CONSTRUCTION PLANS THAT MAY RESULT IN DISCIPLINARY ACTIONS BY ANY OR ALL REGULATORY ACENCIES

SITE PLAN NOTES

- ALL DIMENSIONS TO FACE OF CURB AND/OR EDGING OF CONCRETE UNLESS OTHERWISE NOTED.
 - ALL RADII TO FACE OF CURB AND/OR EDGING OF CONCRETE UNLESS OTHERWISE NOTED.
 - ANY REQUIRED REPLACEMENT OF PUBLIC CURB AND GUTTER SHALL MATCH EXISTING AND WEET THE REQUIREMENTS OF THE CITY OF MADISON.
 - . CONTRACTOR SHALL PROVIDE CONTROL JOINTS AND CONSTRUCTION JOINTS OF ONE-QUARTER CONCRETE THICKNESS AT AN EQUAL RATIO OF LENGTH TO WIDTH WHEREVER POSSIBLE WITH A MAXIMUM LENGTH BETWEEN JOINTS OF 8' ON CENTER
- 6. EXTERIOR CONCRETE SURFACES SHALL BE BROOM FINISHED.
- ALL CONCRETE SURFACES TO BE SEALED WITH TYPE TK-26UV CONCRETE SEALANT.
- 8. MARK AND STRIPE ADA PARKING SPACES APPROPRIATELY.
- 2' x 4' TRUNCATED DOME WARNING DETECTION FIELD SHALL BE PLACED AT ALL ADA RAMPS.
- 10. ALL PAYEMENT MARKINGS INCLUDING: STOP BARS, CROSSWALKS, DIRECTIONAL ARROWS, PARKING STALL LINES, ADA STALL MARKINGS, NO PARKING ZONES, DROP—OFF,PICK-UP ZONES SHALL BE PAINTED WITH HIGH VISIBILITY YELLOW LATEX PAINT PER SPECIFICATIONS.

SITE INFORMAT	ION BL	.ock			
Site Address	EAST	TOWNE	MALL	MADISON	ł, W
Site Acreage (total)			1.22	(53,100	SF
Number of Building Stories					
(above grade)					
Total Building Square Footage				9,075	S SF
Use of property				COMMER	CIAL
Parking Stalls:					
Large Stall					38
Accessible					3
Total Stalls					4
Existing vs. Proposed Site Coverage	:				
Existing Impervious Surface Area				47,540	S.F
Existing Pervious Surface Area				5,560	S.F
Proposed Impervious Surface Area				43,710	S.F
Proposed Pervious Surface Area				9,390	S.F
Proposed Impervious Surface Area F	Ratio				4.66
Offsite Areas (Sidewalk & Terrace S	outh	of Main	Site)		
Proposed Offsite Impervious Surface	Area			2,160	S.F
Proposed Offsite Pervious Surface A	rea			390	S.F





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CBL & ASSOCIATES **PROPERTIES**

CLIENT ADDRESS: 2030 HAMILTON PLACE BLVD., STE. 500, CHATANOOGA, TN 34721


PORTILLO'S, EAST **TOWNE MALL**

PRO IECT I OCATION CITY OF MADISON, WI

PLW	4 MODIFICATI	ONS:	
	Date:	Description	c
1	11.08.17	Land Use -	UDC initial/Final
2			
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Donk	on/Drawn: JLF	/TKG	10-13-2017
Appr	oved: PM	P	10-13-2017
I			40 40 0047

SITE PLAN

C4.0

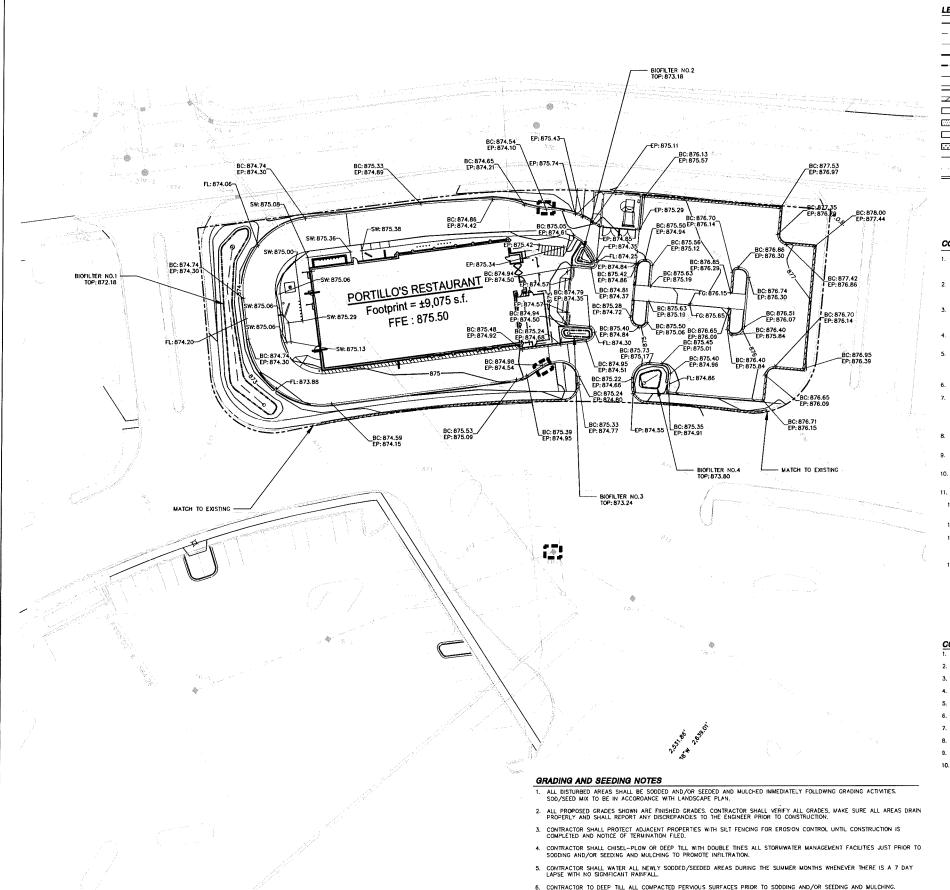

LEGEND (GRADING & EROSION CONTROL PLAN)

PROPERTY LINE --- 934 ----PROPOSED 1 FOOT CONTOUR RIGHT-OF-WAY --- 935 ---PROPOSED 1 FOOT CONTOUR EASEMENT LINE DRAWAGE DIRECTION BUILDING OUTLINE STORM SEWER BUILDING OVERHANG SILT FENCE CONSTRUCTION LIMITS STANDARD CURB AND GUTTER INLET PROTECTION, TYPE D REJECT CURB AND GUTTER SPOT ELEVATION

EP - EDGE OF PAVEMENT

FG - FINISH GRADE

EC - EDGE OF CONCRETE

TS - TOP OF STEP

TS - BOTTOM GF STEP

RIM - RIM ELEVATION ASPHALT PAVEMENT __934.20 FG CONCRETE PAVEMENT HEAVY DUTY CONCRETE PAVEMENT — — — — — GRADE BREAK STORMWATER MANAGEMENT AREA BOULDER RETAINING WALL MODULAR BLOCK RETAINING WALL -0 LIGHT POLE (REFER TO PHOTOMETRIC PLAN)

CONSTRUCTION SITE EROSION CONTROL REQUIREMENTS (CSECR) NOTES:

ADA PARKING BOLLARDS/SIGNS

- ALL EROSION AND SEDMENT CONTROL PRACTICES SHALL BE DESIGNED AND IMPLEMENTED IN ACCORDANCE WITH THE CURRENT DEPARTMENT OF NATURAL RESOURCES EROSION AND SEDIMENT CONTROL TECHNICAL STANDARDS WHICH ARE AVAILABLE AT: http://www.dnr.state.wi.us/runoff/stormwater/techstds.htm
- INSTALL EROSIDN CONTROL MEASURES PRIOR TO ANY SITE WORK, INCLUDING GRADING OR DISTURBANCE OF EXISTING SURFACE
 MATERIALS AS SHOWN ON PLAIN, MICDIFICATIONS TO SEDIMENT CONTROL DESIGN MAY BE CONDUCTED TO MEET UNFORESEEN FIELD
 CONDITIONS IF MODIFICATIONS CONFORM TO WORR TECHNICAL STANDARDS.
- INSPECTIONS AND MAINTENANCE OF ALL EROSION CONTROL MEASURES SHALL BE ROUTINE (ONCE PER WEEK MINIMUM) TO ENSUR PROPER FUNCTION OF EROSION CONTROLS AT ALL TIMES. EROSION CONTROL MEASURES ARE TO BE IN WORKING ORDER AT THE END OF EACH WORK DAY.
- INSPECT EROSION CONTROL MEASURES AFTER EACH 1/2" OR GREATER RAINFALL. REPAIR ANY DAMAGE OBSERVED DURING THE INSPECTION.
- 5. EROSION CONTROL MEASURES SHALL NOT BE REMOVED UNTIL ALL LAND DISTURBING CONSTRUCTION ACTIVITY AT THE SITE HAS BEEN COMPLETED AND THAT A UNIFORM PERENNIAL VEGETATIVE COVER HAS BEEN ESTABLISHED WITH A DENSITY OF AT LEAST 70% OF THE COVER FOR THE LUPPACED AREAS AND AREAS NOT COVERED BY PERMANENT STRUCTURES OR THAT EMPLOY EQUIVALENT PERMANENT STRUCTURES OR THAT EMPLOY
- 6. INSTALL EROSION CONTROLS ON THE DOWNSTREAM SIDE OF STOCKPILES.
- 7. EROSION CONTROL FOR UTILITY CONSTRUCTION (STORM SEWER, SANITARY SEWER, WATER MAIN, ETC.): A. PLACE EXCAVATED TRENCH MATERIAL ON THE HIGH SIDE OF THE TRENCH. B. BACKFILL, COMPACT, AND STABULZE THE TRENCH IMMEDIATELY AFTER PIPE CONSTRUCTION. C. DISCHARGE TRENCH WATER INTO A SCOMENTATION BASIN OR FILTERING TANK IN ACCORDANCE WITH THE DEWATERING TECHNICAL STANDARD NO. 1001 FRIOR TO RELEASE INTO THE STORM SEVER, RECEIVING STREAM, OR DRANNAGE DITCH.
- 8. ADDITIONAL EROSION CONTROL MEASURES, AS REQUESTED BY STATE INSPECTORS, LOCAL INSPECTORS, AND/OR ENGINEER SHALL BE INSTALLED WITHIN 24 HOURS OF REQUEST.
- CONTRACTOR/OWNER SHALL FILE A NOTICE OF TERMINATION UPON VEGETATIVE STABILIZATION AND/OR PROPERTY SALE IN ACCORDANCE WITH WONR REQUIREMENTS.
- CONTRACTOR SHALL TAKE ALL NECESSARY STEPS TO CONTROL DUST ARISING FROM CONSTRUCTION OFERATIONS. REFER TO WONR
 TECHNICAL STANDARD 1068.
- 11. STABILIZATION PRACTICES:

- LIZATION PRACTICES:

 * STABILIZATION MEASURES SHALL BE INITIATED AS SOON AS PRACTICABLE IN PORTIONS OF THE SITE WHERE CONSTRUCTION ACTIVITIES HAVE. TEMPORARILY OR PERMANENTLY CEASED. NO MORE THAN SEVEN (7) DAYS SHALL PASS AFTER THE CONSTRUCTION ACTIVITY IN THAT PORTION OF THE SITE HAS CEASED UNLESS:

 * THE INITIATION STABILIZATION MEASURES BY THE SEVENTH (7) DAY AFTER CONSTRUCTION ACTIVITY HAS CEASED IS PRECLUDED BY SNOW COVER. IN THAT EVENT, STABILIZATION SHALL BE INITIATED AS SOON AS PRACTICABLE.

 **CONSTRUCTION ACTIVITY WILL RESUME ON A PORTION OF THE SITE WITHIN FOURTER (14) DAYS FROM WHEN ACTIVITY CEASED, (I.E. THE TOTAL TIME PERIOD THAT THE CONSTRUCTION ACTIVITY IS TEMPORARILY CEASED IS LESS THAN FOURTER (14) DAYS. IN THAT EVENT, STABILIZATION MEASURES DO NOT HAVE TO BE INITIATED ON THAT PORTION OF THE SITE BY THE SEVENTH (7) DAY AFTER CONSTRUCTION ACTIVITY HAS TEMPORARILY CEASED.

 **STABILIZATION MEASURES SHALL BE DETERMINED BASED ON SITE CONDITIONS AT THE TIME OF CONSTRUCTION ACTIVITY HAS CEASED, INCLUDING BUT NOT LIMITED TO WEATHER CONDITIONS AND LENGTH OF TIME MEASURE MUST BE EFFECTIVE. THE FOLLOWING ARE ACCEPTABLE STABILIZATION MEASURES:

 **PERMANENT SECONG; IN ACCORDANCE WITH APPROVED CONSTRUCTION SPECIFICATION

 ** TEMPORARY SECONICS; MAY CONSISTOR OF SPRING OATS(100LBS/ACRE) AND/OR WHEAT OR CEREAL RYE (150LB/ACRE)

 ** HORDO-MULCHING WITH A TACKFIER

 ** GEDIER STAILE EROSION MATTHING

 ** SOCIONS


CONSTRUCTION SEQUENCING

- INSTALL EROSION CONTROL MEASURES PRIOR TO ANY CONSTRUCTION ACTIVITIES.
- 2. REMOVE EXISTING SURFACE MATERIALS PER DEMOLITION PLAN
- 4. COMPLETE ALL OTHER GRADING.
- 6. INSTALL STORM SEWER & INLET PROTECTION MEASURES.
- 7. INSTALL AGGREGATE BASE COURSE AND PAVINC IN PARKING AREAS.
- 8. STABILIZE NEWLY GRADED SOILS.

7. THE CONTRACTOR SHALL NOTIFY THE CITY OF MADISON TWO (2) WORKING DAYS IN ADVANCE OF ANY SOL DISTURBING ACTIVITY. 8. IF CRADING ACTIVITIES STOP ON ANY PORTION OF LAND FOR 14 OR MORE CALENDAR DAYS, THE AREA IN QUESTION MUST BE TEMPORARILY STABILIZED.

9. ALL SLOPES 20% OR GREATER SHALL BE TEMPORARY SEEDED, MULCHED, OR OTHER MEANS OF COVER PLACED ON THEM WITHIN 2 WEEKS OF DISTURBANCE.

- 9. COMPLETE EXTERIOR BUILDING WORK AND DOWNSPOUTS.
- 10. INSTALL BIO-FILTER MATERIAL.

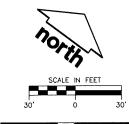

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CBL & ASSOCIATES PROPERTIES

2030 HAMILTON PLACE BLVD., STE. 500, CHATANOOGA, TN 34721

PORTILLO'S, EAST TOWNE MALL


CITY OF MADISON, WI DANE COUNTY

	Date:	Description:
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proved: PMP 10-13-2017

GRADING & EROSION CONTROL PLAN

C5.0

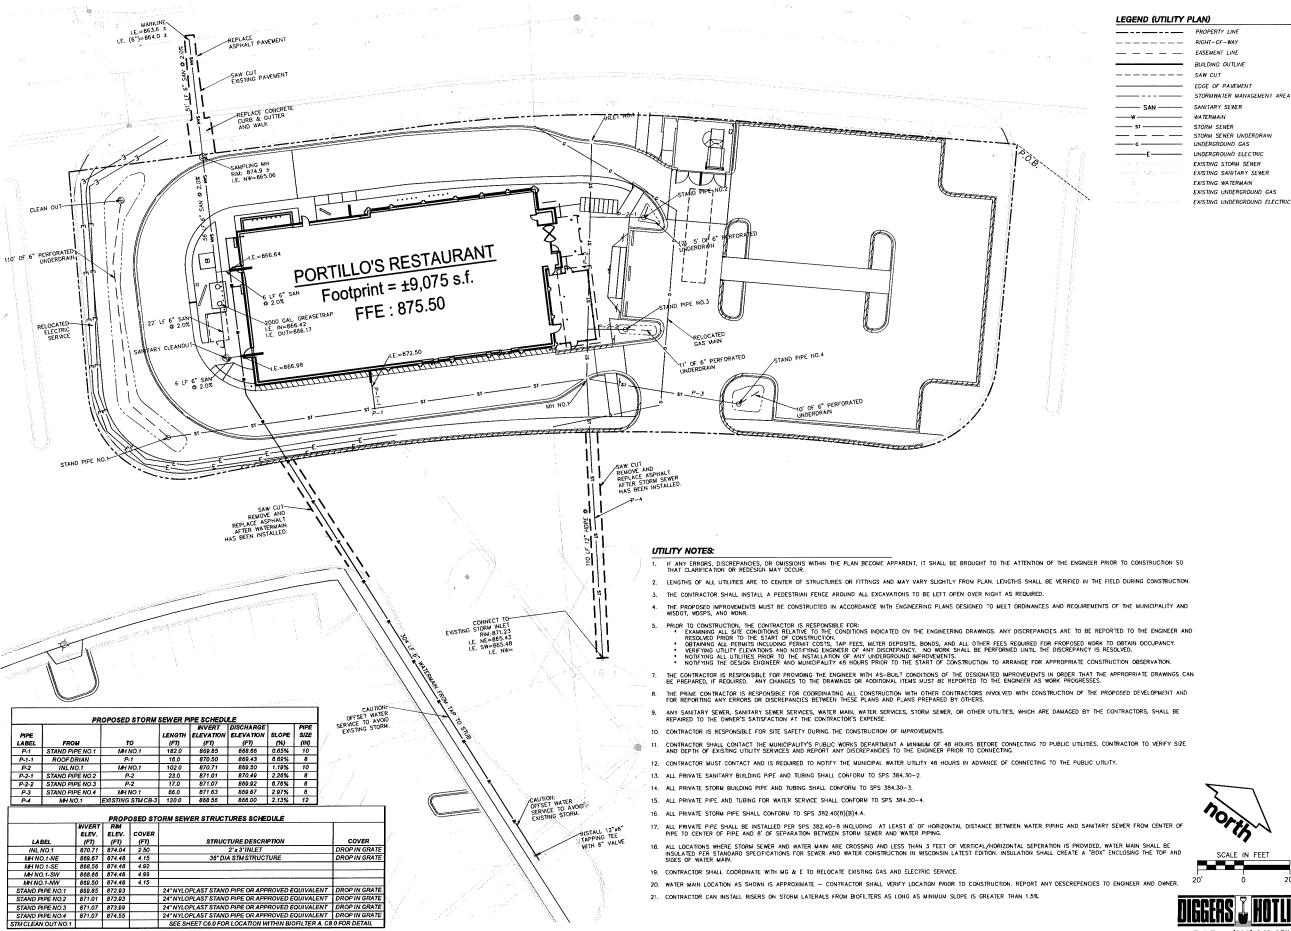

PROPERTY LINE ___ _ _ EASEMENT LINE EDGE OF PAVEMENT STORMWATER MANAGEMENT AREA STORM SEWER UNDERDRAIN UNDERGROUND GAS UNDERGROUND ELECTRIC EXISTING STORM SEWER EXISTING SANITARY SEWER EXISTING WATERMAIN EXISTING UNDERGROUND GAS



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CBL & ASSOCIATES **PROPERTIES**

2030 HAMILTON PLACE BLVD., STE. 500, CHATANOOGA, TN 34721

PORTILLO'S, EAST **TOWNE MALL**

ROJECT LOCATION: CITY OF MADISON, WI DANE COUNTY


Oato:	Description:
11-08-17	Land Use - UDC Initial/Final

Design/Drawn: JLF / TKG 10-13-2017 10-13-2017 proved: PMP 10-13-2017

UTILITY PLAN

C6.0

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500' RADIUS FROM HYDRAN EDGE OF PAVEMENT STANDARD CURB AND GUTTER REJECT CURB AND GUTTER

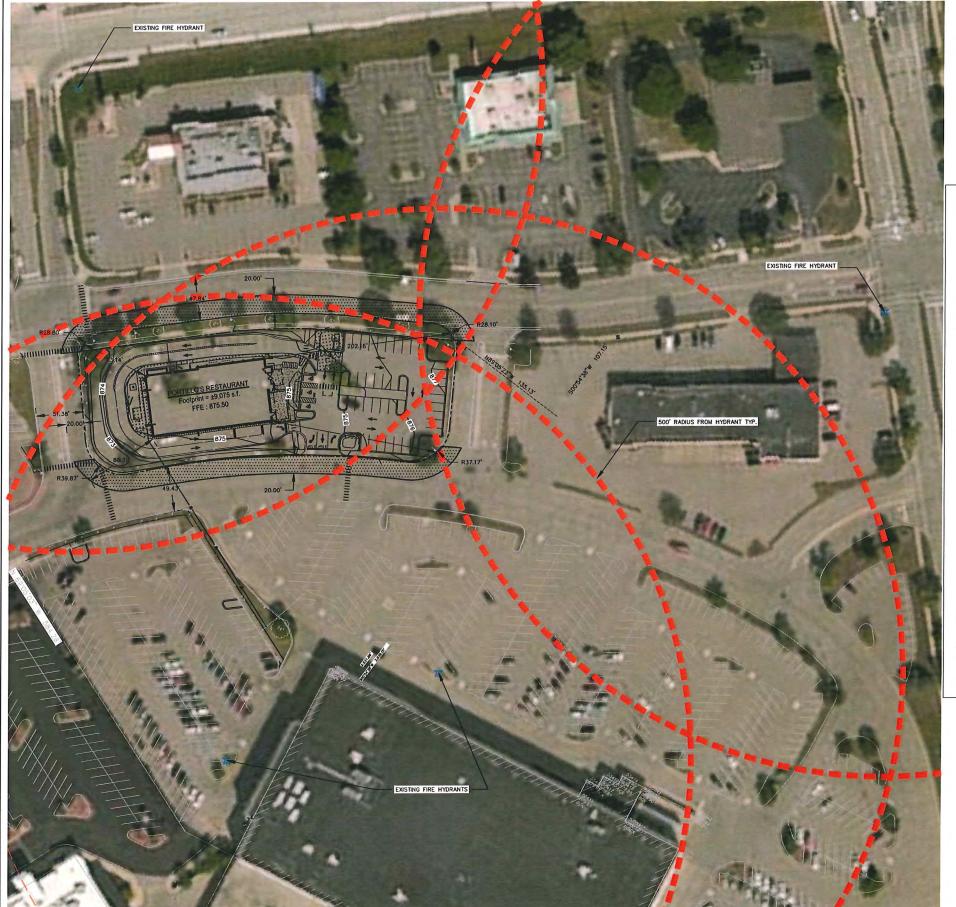

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CBL & ASSOCIATES
PROPERTIES

2030 HAMILTON PLACE BLVD., STE. 500, CHATANOOGA, TN 34721

PROJECT:
PORTILLO'S, EAST
TOWNE MALL

PROJECT LOCATION: CITY OF MADISON, WI DANE COUNTY

Date: Description:
11.08.17 Land Use - UDC Initial/Final

Design/Drawn: JLF / TKG	10-13-2017
Approved: PMP	10-13-2017
Submitted:	10-13-2017

FIRE ACCESS EXHIBIT





City of Madison Fire Department 314 W Dayton Street, Madison, WI 53703-2506 Phone: 608-266-4420 - Fax: 608-267-1100 - E-mail: fire@cityofmadison.com

Project Address: East Towne Mall, Madison, WI 53704 Contact Name & Phone #:


FIRE APPARATUS ACCESS AND FIRE HYDRANT WORKSHEET


 Is the building completely protected by an NFPA 13 or 13R automatic fire sprinkler system? If non-sprinklered, fire lanes extend to within 150-feet of all portions of the exterior wall? If sprinklered, fire lanes are within 250-feet of all portions of the exterior wall? 	X Yes ☐ Yes X Yes	No No	□ N/A □ N/A □ N/A
2. Is the fire lane constructed of concrete or asphalt, designed to support a minimum load of 85,000 lbs? a) Is the fire lane a minimum unobstructed width of at least 20-fect? b) Is the fire lane unobstructed with a vertical clearance of at least 13½-fect? c) Is the minimum inside turning radius of the fire lane at least 28-fect? d) Is the grade of the fire lane not more than a slope of 8½? c) Is the fire lane posted as fire lane? (Provide detail of signage.) f) Is a roll-able curb used as part of the fire lane? (Provide detail of curb.) g) Is part of a sidewalk used as part of the required fire lane? (Must support +85,000 lbs.)	X Yes	No	N/A
3. Is the fire lane obstructed by security gates or barricades? If yes: a) Is the gate a minimum of 20-feet clear opening? b) Is an approved means of emergency operations installed, key vault, padlock or key switch?	☐ Yes ☐ Yes ☐ Yes	No No	□ N/A ⊠ N/A ⊠ N/A
 Is the Fire lane dead-ended with a length greater than 150-feet? If yes, does the area for turning around fire apparatus comply with IFC D103? 	☐ Yes ☐ Yes	□ No	X N/A X N/A
 Is any portion of the building to be used for high-piled storage in accordance with IFC Chapter 3206.6 If yes, see IFC 3206.6 for further requirements. 	Yes	⊠ No	□ N/A
 Is any part of the building greater than 30-feet above the grade plane? If yes, answer the following questions: 	☐ Yes	No No	□ N/A
a) Is the aerial apparatus fire lane parallel to one entire side of the building and covering at least 25% of the perimeter?	☐ Yes	□ No	N/A
 b) Is the near edge of the aerial apparatus fire lane between 15' and 30' from the building? c) Are there any overhead power or utility lines located across the aerial apparatus fire lane? 	☐ Yes ☐ Yes	□ No	X N/A X N/A
d) Are there any tree canopies expected to grow across the aerial fire lane? (Based on mature canopy width of tree species)	☐ Yes	☐ No	X N/A
e) Does the aerial apparatus fire lane have a minimum unobstructed width of 26-feet? f) Is the space between the aerial lane and the building free of trees exceeding 20' in heights?	☐ Yes ☐ Yes	□ No	X N/A X N/A
7. Are all portions of the required fire lanes within 500-feet of at least (2) hydrants?	X Yes	□ No	□ N/A
Note: Distances shall be measured along the path of the hose lay as it comes off the fire apparatus. a) Is the fire lane at least 26' wide for at least 20-fect on each side of the hydrants?	X Yes	No No	□ N/A □ N/A
b) Is there at least 40° between a hydrant and the building?			
c) Are the hydrant(s) setback no less than 5-feet nor more than 10-feet from the curb or edge of the	Yes	No No	□ N/A
	☐ Yes☐ Yes☐ Yes☐ Yes☐ Yes☐ Yes☐ Yes☐ Yes	No No	□ N/A □ N/A □ N/A


Attach an additional sheet if further explanation is required for any answers.


This worksheet is based on MGO 34.503 and IFC 2015 Edition Chapter 5 and Appendix D; please see the codes for further information.


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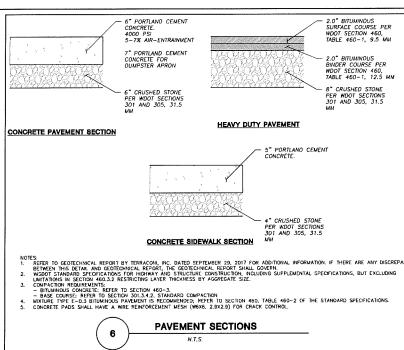


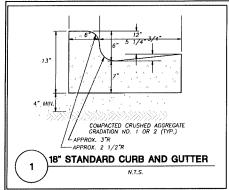


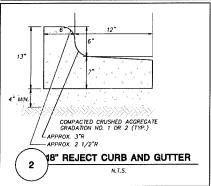

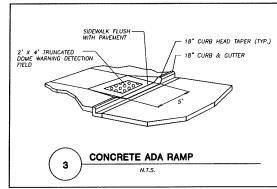

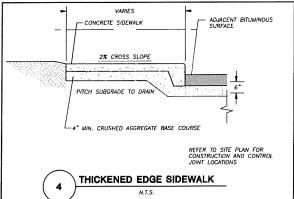

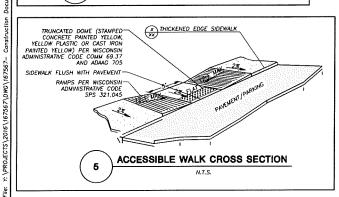

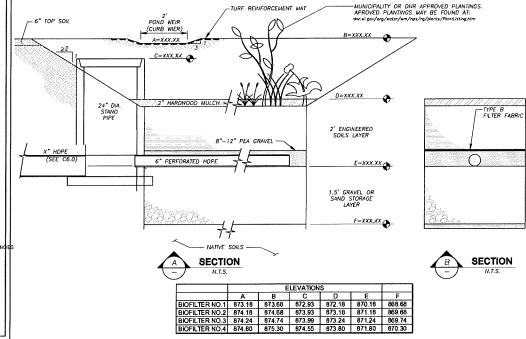



ALL CONSTRUCTION PRACTICES SHALL MEET THE SPECIFICATIONS OF THE WONR TECHNICAL STANDARD 1004 — BIORETENTION FCR INFILTRATION. IT IS THE CONTRACTOR'S RESPONSIBILITY 10 OBTAIN A COPY OF THIS STANDARD AND CONSTRUCT THE BIORETENTION DEVICE IN ACCORDANCE WITH THE REQUIREMENTS OUTLINED THEREIN.


- 2. CONTRACTOR SHALL INSTALL 24" DF ENGINEERED SOIL CONSISTING DF: 40% ASTM C33 SAND, 30% CERTIFIED COMPOST (SEE GENERAL NOTE 3), AND 30% TOPSOIL
- 3. CERTIFIED COMPOST SHALL CONSIST OF: >40% ORGANIC MATTER, <60% ASH CONTENT, pH OF 6-8, AND MOISTURE CONTENT OF 35-50% BY WEIGHT.
- 4. FILTER FABRIC SHALL BE PLACED ABOVE THE PERFORATEO PIPE, BETWEEN THE PEA GRAVEL AND THE ENGINEERED SOIL.
- 5. ANNUAL RYE GRASS SHALL BE SEEDED AT 40 LB/ACRE WITH THE SEED MIX IN THE AREAS SURROUNDING THE BASIN, ON SIDE SLOPES, AND OVER ANY LAND THAT DISCHARGES INTO THE BASIN FOR EROSION CONTROL WHEN BASIN IS BROUGHT ON—LINE. ROOTSTOP AND PLUGS ARE REQUIRED TO ESTABLISH VEGETATION AT THE INVERT OF THE BASIN.
- 6. RUNOFF MUST INFILTRATE WITHIN 48-HOURS. BASINS UNABLE TO MAINTAIN THESE RATES MUST BE DEEP TILLED, REGRADED, AND IF NECESSARY REPLANTED TO RESTORE ORIGINAL INFILTRATION RATES.
- 7. ALL WORK TO BE CONDUCTED IN CONFORMANCE WITH APPLICABLE LOCAL, REGIONAL, AND STATE STORMWATER STANDARDS FOR THE PROJECT SITE AS APPROVED BY THE REGULATORY ENGINEER.
- B. OWNER OR CONTRACTOR MUST CONSULT LANDSCAPE ARCHITECT OR ECOLOGICAL PLANTING AGENCY FOR APPROPRIATE PLANTS AND PLANTING CONFIGURATIONS

INFILTRATION DEVICES ARE DESIGNED IN ACCORDANCE WITH THE SPECIFICATIONS OF THE WISCONSIN DEPARTMENT OF NATURAL RESOURCES (WDNR), COUNTY, MUNICIPALITY, AND BIGINEERING STANDARD OF CAPE. ALL DESIGNATED INFILTRATION AREAS (e.g., RAIN GARDENS, INFILTRATION BASINS, BIDRETENTION DEVICES) SHALL BE FENCED PRIOR TO CONSTRUCTION AND REMAIN UNDISTURBED AND PROTECTED DURING THE CONSTRUCTION OF PROPOSED SITE IMPROVEMENTS. PROPOSED BIORITEMTON DEVICES SHALL NOT BE CONSTRUCTIOD UNTIL THE DEVICE'S CONTRIBUTING WATERSHED AFEA MEETS ESTABLISHED VEGETATION REQUIREMENTS SET FORTH WITHIN THE RESPECTIVE WORM TECHNICAL ISLANDARDS. IN THE LOCATION OF THE INFILTRATION AREA CORPLICTS WITH CONSTRUCTION STACING AND/OR CONSTRUCTION TRAFFIC AND IS DISTURBED, COMPACTION MITIGATION WILL BE REQUIRED AT THE CONTRACTOR'S EXPENSE.

THE CONTRACTOR IS REQUIRED TO PROVIDE QUALIFIED STAFF FOR INSPECTION AND OBSERVATION OF THE CONSTRUCTION ACTIVITIES RELATING TO ALL JOB SITE REGULATORY COMPUNICE INCLUDING THE PROTECTION AND CONSTRUCTION OF ALL STORMWATER MANAGEMENT FEATURES. ANY OBSERVATION OF PLAN OR SITE DISCREPANCES SHALL BE REPORTED TO THE ENGINEER OF RECORD PRIOR TO CONSTRUCTION.

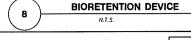

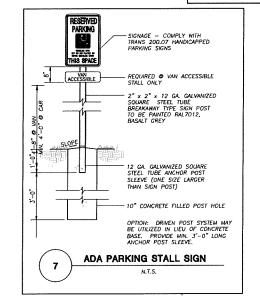

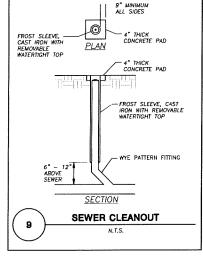





Engineers · Surveyors · Planners

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MADISON REGIONAL OFFICE 161 HORIZON DRIVE, SUITE 101 VERONA, WISCONSIN 63593 P. 608.848.5060

CBL & ASSOCIATES PROPERTIES


2030 HAMILTON PLACE BLVD., STE. 500, CHATANOOGA, TN 34721


PORTILLO'S, EAST TOWNE MALL


CITY OF MADISON, WI DANE COUNTY

Date:	Description	r .
11-08-17	Land Use	UDC initial/Final
	_	
Drawn: J	F/TKG	10-13-2017
ed: P	MP	10-13-2017
ed:		10-13-2017
TITLE:		
AILS	•	
MILS	•	

C8.0

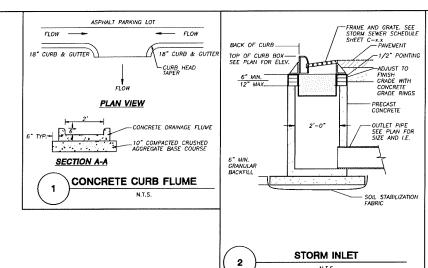

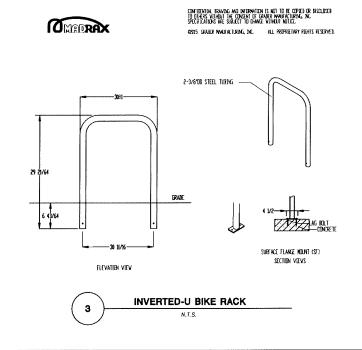

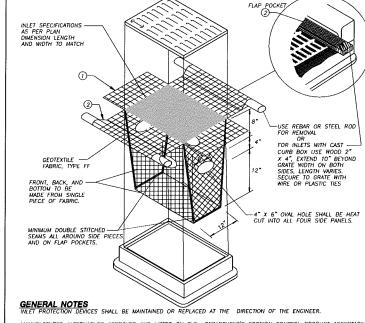

MANUFACTURED ALTERNATIVES APPROVED AND LISTED ON THE DEPARTMENT'S EROSION CONTROL PRODUCT ACCEPTABILITY LIST MAY BE SUBSTITUTED.

WHEN REMOVING OR MAINTAINING INLET PROTECTION, CARE SHALL BE TAKEN SO THAT THE SEDIMENT TRAFFED ON THE GEDTEXTILE FABRIC DOES NOT FALL INTO THE INLET. ANY MATERIAL FALLING INTO THE INLET. SHALL BE REMOVED IMMEDIATELY.

- (f) Finished Size, including flap pockets where required, shall extend a minimum of 10" around the perimeter to facilitate maintenance or "removal."
- ② FLAP POCKETS SHALL BE LARGE ENOUGH TO ACCEPT WOOD 274.

INSTALLATION NOTES
DO NOT INSTALL INLET PROTECTION TYPE D IN INLETS SHALLOWER THAN 30°, MEASURED FROM THE BOTTOM OF THE
MILET TO THE TOP OF THE GRATE.

TRIM EXCESS FABRIC IN THE FLOW LINE TO WITHIN 3" OF THE GRATE.

THE INSTALLED BAG SHALL HAVE A MINIMUM SIDE CLEARANCE, BETWEEN THE INLET WALLS AND THE BAG, WEASURED AT THE BOTTOM OF THE OVERFLOW HOLES, OF 3". WHERE NECESSARY THE CONTRACTOR SHALL CUICH THE BAG, USING PLASTIC 21P TIES, TO ACHIEVE THE 3" CLEARANCE. THE TIES SHALL BE PLACED AT A MAXIMUM OF 4" FROM THE BOTTOM OF THE BAG.



Professional Services, Inc.

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CBL & ASSOCIATES **PROPERTIES**

CLIENT ADDRESS:

2030 HAMILTON PLACE BLVD., STE. 500, CHATANOOGA, TN 34721

PORTILLO'S, EAST TOWNE MALL

CITY OF MADISON, WI DANE COUNTY

Date: Description:
11-08-17 Land Use - UDC Initial/Final Design/Drawn: JLF/TKG Approved: PMP 10-13-2017


10-13-2017


DETAILS


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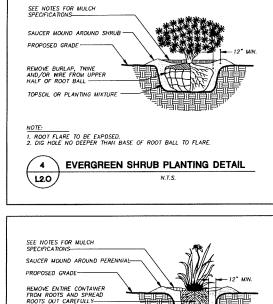
JSD PROJECT NO:

Toll Free (800) 242-8511



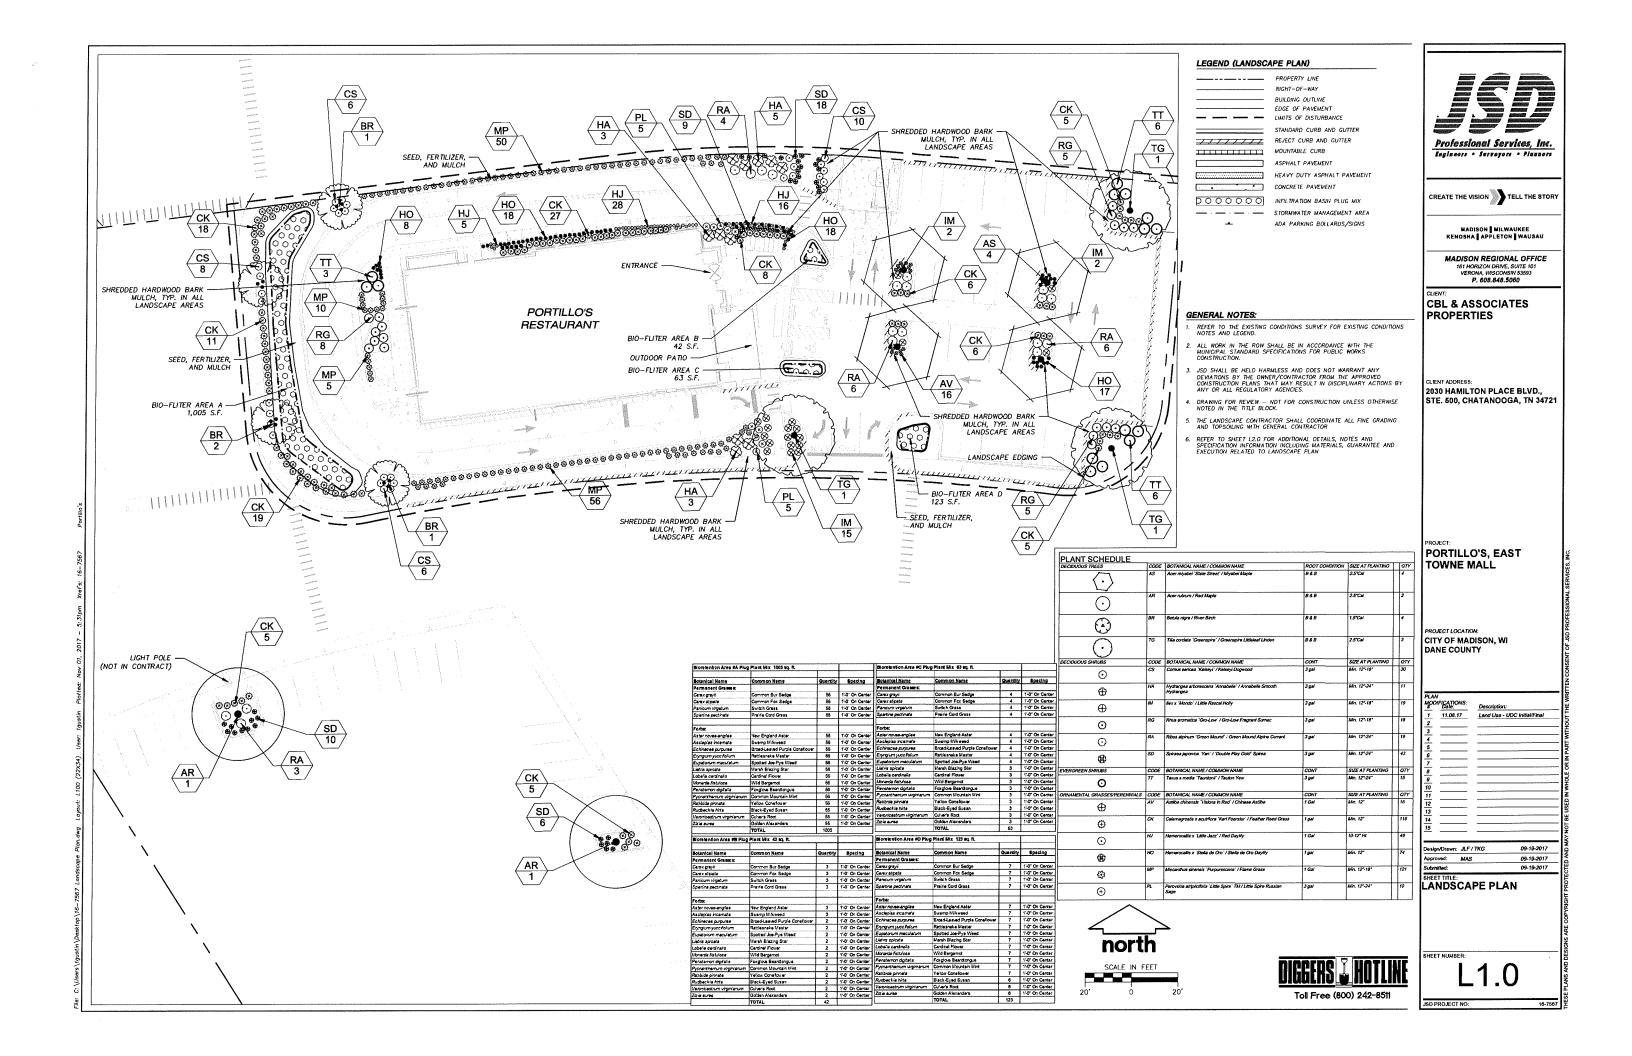

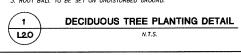


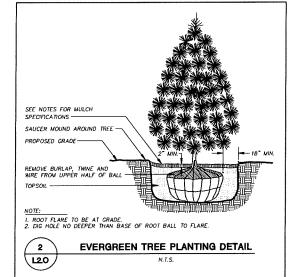

PLANTING MIXTURE-


120

1. ROOT FLARE TO BE EXPOSED

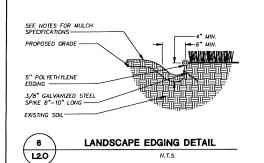

PERENNIAL/ORNAMENTAL GRASS

PLANTING DETAIL

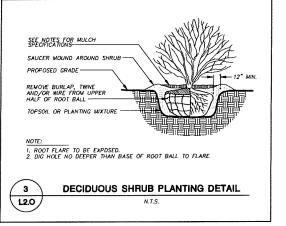



CITY OF MADISON LANDSCAPE WORKSHEET

Section 28.142 Madison General Ordinance

Project Location / Address EAST TOWNE MALL, MADISON, WI 53704 Name of Project PORTILLO'S - EAST TOWNE MALL Owner / Contact CBL & ASSOCIATES PROPERTIES, INC. - JUSTIN LONG Contact Email JUSTIN.FRAHM@JSDINC.COM

** Landscape plans for aoning lots greater than ten thousand (10,000) square feet in size
MUST be prepared by a registered landscape architect. **

The following standards apply to all exterior construction and development activity, including the expansion of existing buildings, structures and parking loss, except the construction of detached single-family and two-family dwellings and their accessory structures. The critic development site must be brought up to compliance with this service unless all of the following conditions apply, in which case only the affected areas need to be brought up to compliance:

- (a) The area of site disturbance is less than ten percent (10%) of the entire development site during any ten-(10) year period.
- b) Gross floor area is only increased by ten percent (10%) during any ten-(10) year peric (c) No demolition of a principal building is involved.
- (d) Any displaced landscaping elements must be replaced on the site and shown on a revised landscaping pla-

Landscape Calculations and Distribution Required landscaped areas shall be calculated based upon the total developed area of the property. Developed area is defined as that area within a single contiguous boundary which is made up of structures, parking, divieways and docking loading facilities, but excluding the area of any boilding foreprint at grade, hand designated for open space uses the as athletic fields, and underslepted land area on the same gening lot. There are there methods for calculating

(a) For all lots except those described in (b) and (c) below, five (5) landscape points shall be provided for each three hundred (300) square feet of developed area.

Total source footage of developed area 34,634 Total landscape points required 578

(b) For lots larger than five (5) acres, points shall be provided at five (5) points per three bundred (300) square feet for the first five (5) developed acres, and one (1) point per one hundred (100) square feet for all additional

Total square footage of developed area ____ Five (5) acres = 217 800 square feet First five (5) developed acres = 3,630 points Remainder of developed area Total landscape points required ____

(c) For the ladostrial - Limited (IL) and ladostrial - General (IG) districts, one (1) point shall be provided per one handred (III) upure feet of developed area.

Total square footage of developed area Total landscape points required

Tabulation of Points and Credits Use the table to indicate the quantity and points for all existing and proposed landscape elements

	Minimum Size at	Points		Existing caping		roposed caping
Plant Type/ Element	Installation	roints	Quantity	Points Achieved	Quantity	Paints Achieved
Overstory deciduous tree	2½ inch caliper measured diameter at breast height (dbh)	35			9	315
Tall evergreen tree (i.e. pine, spruce)	5-6 feet tall	35				
Omamental tree	1 1/2 inch caliper	15			4	60
Upright evergreen shrub (i.e. arborvitae)	3-4 feet tall	10				
Shrub, deciduous	#3 gallon container size, Min. 12"-24"	3			14D	42 0
Shrub, evergreen	#3 gallon container size, Min. 12"-24"	4			15	60
Ornamental grasses/ perennials	#1 gallon container size, Min. 8"-18"	2			386	772
Ornamental/ decorative fencing or wall	n/a	4 per 10 lineal ft.				
Existing significant specimen tree	Minimum size: 2 ½ inch caliper dbh. *Trees must be within developed area and cannot comprise more than 30% of total required points.	14 per caliper inch dbh. Maximum points per tree: 200				
Landscape furniture for public scating and/or transit connections	* Furniture must be within developed area, publically accessible, and cannot comprise more than 5% of total required points.	5 points per "seat"				
Sub Totals						1,627

Total Number of Points Provided 1,627

GENERAL NOTES

- GENERAL: ALL WORK IN THE R-O-W AND PUBLIC EASEMENTS SHALL BE IN ACCORDANCE WITH LOCAL MUNICIPAL REQUIREMENTS. JSD SHALL BE HELD HARMLESS AND ODES NOT WARRANT ANY DEVATIONS BY THE OWNER/CONTRACTOR FROM THE APPROVED CONSTRUCTION PLANS THAT MAY RESULT IN DISCIPLINARY ACTIONS BY ANY OR ALL REGULATORY ACENCES. LOCATE ALL UTUTIES PRIOR TO CONSTRUCTION. THE CONTRACTOR IS RESPONSIBLE FOR REPAIRING ANY DAMAGE DONE TO UTUTIES. CONTRACTOR IS RESPONSIBLE FOR REPAIRING ANY DAMAGE DONE TO UTUTIES. CONTRACTOR IS REPAIRING UTUTIES. PROTECT LOCATIONS AT LEAST THREE DAYS PRIOR TO DIGGING. HAND DIG AND INSTALL ALL PLANTS THAT ARE LEAST RESISTING UTUTIES. PROTECT PREVIOUSLY INSTALLED WORN OF OTHER TRADES. CONTRACTOR SEPONSIBLE FOR STAKING THE PLANT MATERIALS FOR RELIVE BY OWNER PRIOR TO DIGGING AND PLACEMENT AND SHALL COORDINATE ALL FINE GRADING AND RESTORATION WITH THE GRADING CONTRACTOR.
- PRIOR TO DIGGING AND POLEMENT AND STULL COORDINATE ALL TIME GROUND AND RESIDERATION WITH THE GROUND CONTROLLOR.

 DELINERY AND HANDLING: DO NOT DELIVER MORE PLANT MATERIALS THAN CAN BE PLATTED IN ONE DAY, UNLESS ADEQUATE, APPROPRIATE AND SECURE STORAGE IS PROVIDED AND APPROVED BY OWNER'S REPRESENTATIVE. AT ALL TIMES, PROTECT ALL PLANT MATERIALS FROM WIND AND DIRECT SUM. DELIVER PLANTS WITH LEGIBLE IDENTIFICATION LABELS. PROTECT PLANTS DURING DELIVERY AND DO NOT PRIVINE PRIOR TO DELIVERY. ALL TREES AND SHAUBS SHALL BE PLANTED ON THE DAY OF DEUVERY, IF THIS ROY POSSIBLE, PROTECT THE PLANT MATERIALS NOT PLANTED BY STORING THEM IN A SHADED, SECURE AREA, PROTECTING THE ROOT MASS WITH WET SOIL, MULCH, HAY OR OTHER SUITABLE MEDIUM, CONTRACTOR TO KEEP ALL PLANT MATERIALS ADEQUATELY WATERED TO PREVENT ROOT DESICCATION. DO NOT REMOVE CONTAINER GROWN STOKE FROM CONTAINERS BEFORE TIME OF PLANTING. DO NOT PICK UP CONTAINER OR BALLED PLANTS BY STEM OR ROOTS. ALL PLANTS SHALL BE LIFTED AND HANDLED FROM THE BOTTOM OF THE CONTAINER OR BALL PERFORM ACTUAL PLANTING ONLY WHEN WEATHER AND SOIL CONDITIONS ARE SUITABLE IN ACCORDANCE WITH LOCALLY ACCEPTED BEST HORTICULTURAL PRACTICES.
- MATERIUS PIANTS ALL PLANTS SHALL CONFORM TO THE AMERICAN STANDARD FOR NURSERY STOCK ANSI ZEO. 1-2004. PLANTS SHALL

 BE TRUE TO SPECIES AND VARIETY SPECIFIED AND NURSERY GROWN IN ACCORDANCE WITH GOOD HORTICULTURAL PRACTICES UNDER CLIMATIC
 CONDITIONS SIMILAR TO THOSE IN THE LOCALITY OF THE PROJECT FOR AT LEAST 2 YEARS. PLANTS SHALL BE FRESHLY DUG (DURING THE
 MOST RECENT FAVORABLE HARVEST SEASON). PLANTS SHALL BE SO TRAINED IN DEVELOPMENT AND APPEARANCE AS TO BE UNDUSTRIPHABLY
 SUPERIOR IN FORM, COMPACTIVESS, AND SYMMETRY. PLANTS SHALL BE SOUND, HEALTHY, VOOROUS, WELL BRANCHED AND DENSELY
 FOLIATED WHEN IN LEAF, AND FREE OF DISEASE AND INSECTS (ADULT EGGS, PUPPE OR LARVAE). THEY SHALL HAVE HEALTHY,
 WELL-DEVELOPED POOT SYSTEMS AND SHALL BE FREE FROM PHYSICAL DAVAGE OR DITHER CONDITIONS THAT WOULD PREVENT THRIMNG
 GROWTH, PLANTS SHALL BE OF THE HIGHEST QUALITY, POSSESS TYPICAL GROWTH HABITS AND FORM FOR THEIR SECRIES AND BE FREE OF
 INJURY. PARKINGY TREES AND PARKING LOT TREES SHALL HAVE A MINIMUM BRANCHING HEIGHT OF SIX (6) FEET ABOVE THE GROUND TO
 ALLOW ADDROLATE SMALL AND PHYSICAL CLERANCE. ALLOW ADEQUATE VISUAL AND PHYSICAL CLEARANCE.
- PRUNING: THE CONTRACTOR SHALL PRUNE ALL TREES AND REPAIR ANY INJURIES THAT OCCURRED DURING THE PLANTING PROCESS. DOUB LEADERS, DEAD BRANCHES, AND LIMBS DAMAGED OR BROKEN DURING THE PLANTING PROCESS SHALL BE THE ONLY PRUNING ALLORED AT PLANTING, PRUNING SHALL CONFORM TO AMERICAN STRANDARD FOR TREE CARE OFERTAINS, ANSI ADDO. PRUNE TREES IN ACCORDANCE WITH MAA GUIDELINES. DO NOT TOP TREES. PRUNE SHRUBS ACCORDING TO STANDARD HORTICULTURAL PRACTICES. DIN CUIS OVER 3/4" IN DUMETER AND BRUNESS OR SCARS ON BARK, TRACE THE NUIRED CAMBIUM ATTER BACK TO LIMME TISSUE AND REMOVES. SMOOTH AND SHAP MOUNTED SOA ON FOR THE METER. TRACE THE ARDA WITH AN APPROVED MOONSTICUOUS LATER DAGED ANTISEPTIC TREE PART, IF PRUNING OCCURS 'N SEASON'. DO NOT PURILE ANY ONX TREES DURING THE MONTHS FROM AN
- . CLEANUP: DISPOSED DF EXCESS SOIL. REMOVE ALL CUTTINGS AND WASTE MATERIALS. SDIL, BRANCHES, BINDING AND WRAPPING MATERIALS. REJECTED PLANTS, OR OTHER DEBRIS RESULTING FROM ANY PLANTING SHALL BE PROMPTLY CLEANED UP AND REMOVED. THE WORK AREA SHALL BE KEPT SAFE AND NEAT AT ALL TIMES. UNDER NO CONDITION SHALL THE ACCUMULATION OF SOIL, BRANCHES OR OTHER DEBRIS BE ALLOWED UPON A PUBLIC SAFETY HAZARD. LIKEWISE, UNDER NO CIRCUMSTANCES SHALL ANY DEBRIS OR INCIDENTAL MATERIALS BE ALLOWED UPON ADJACKENT PRAYER PROPERTY.

LANDSCAPE MATERIAL NOTES

- MATERIALS SOIL: PLAYTING SOIL SHALL MEET THESE REOUIREMENTS:
 A. PLANTING AREAS = 24"
 B. TREE PITS = SEE DETAILS
- 2. PLANTING SOIL TO BE A MINIMUM 24" DEPTH, UILLESS OTHERWISE SPECIFIED AS ABOVE OR ON DETAILS. TOPSOIL TO BE CLEAN, FRIABLE LOAM FROM A LOCAL SOURCE, FREE FROM STONES OR DEBRIS OVER 3/4" IN DIAMETER, AND FREE FROM TOXINS. TOPSOIL SHALL HAVE A PH VALUE BETWEEN 6 AND 7. TOPSOIL AND FLANDHRING SOIL SHALL BE TESTED TO CONFORM TO THES SPECIFICATIONS AND SHALL BE AWENDED TO CONFORM TO THE SECRETATIONS. AND SHALL BE AWENDED TO MILET THESE SPECIFICATIONS. PROVIDE TEST RESULTS TO OMNERS REPRESENTATIVE PRIOR TO PLACEMENTDO NOT PLACE FROZEN OR MUDOY TOPSOIL. APPLY SOIL AMENDMENTS TO ALL ANDISCAPE AREAS PER SOIL TEST.
- MATERIALS SHREDDED HARDWOOD BARK MULCH: ALL PLANTING AREAS LABELED ON PLAN SHALL RECEIVE CERTIFIED WEED FREE
 SHREDDED HARDWOOD BARK MULCH OVER ALL PLANTING AREAS. SHREDDED HARDWOOD BARK MULCH SIZE & COLOR TO BE APPROVED BY
 OWNER'S REPRESENTATIVE PRIOR TO INSTALLATION, FERTUZER SHALL BE IN ACCORDANCE WITH APPLICABLE LOCAL, COUNTY AND STATE OF
 WISCONSIN REQUIREMENTS. SHREDDED HARDWOOD BARK MULCH AREAS SHALL NOT RECEIVE WOVEN WEED BARRIER FABRIC.
- 4. MATERIALS TREE & SHRUB RINGS: ALL TREES AND/OR SHRUBS PLANTED IN SECDED LAWN AREAS TO BE INSTALLED WITH A MINIMUM 5'
 DIAMETER SHREDDED HARDWOOD BARK MULCH TREE RING SPREAD TO A CONSISTENT DEPTH OF 4 MICHES. ALL TREE PINGS SHOULD BE
 INSTALLED WITH A 5' DEPTH SHOWEL CUT EDGE, ANGLED 45 DEGREES INTO SOIL AT A 5' DIAMETER ABOUT THE CENTER OF THE TREE
 PLANTING. A PRE-EMERGENT GRANULAR HERBICIDE WEED—PREVENTER SHOULD BE MIXED WITH MULCH USED TO INSTALL TREE RING AS WELL
 AS TOPICALLY APPLIED TO FINISHED INSTALLATION OF TREE RING.
- MATERIALS SEED: DISTURBED LAWN AREAS LABELED ON PLAN AS SUCH, SHALL BE SPREAD BY HAND BROADCAST METHOD OR APPROPRIATE SPREADER EQUIPMENT WITH EARTH CARPET'S "MADISON PARKS" OR EQUIVALENT AS APPROVED BY THE OWIKER"S REPRESENTANTE, INSTALLED PER MAUFORDURER'S RECOMMENDATIONS. IN ADDITION TO LAWN SEED MINULA RYE SHALL BE APPLIED TO ALL DISTURBED AREAS AT A RATE OF 1 1/2 LBS PER 1000 SOUARE FEET. FERTILIZE AND MULCH PER MANUFACTURER'S RECOMMENDATIONS.
- MATERIALS BIORETENTION BASIN/PRAIRIE SEED MIX: AREAS SPECIFIED ON PLAN TO BE BROADCAST SEEDED WITH "DIVERSE PRAIRIE FOR SOILS" SEED MIX AS PROMOED BY PRAIRIE NURSERY P.O. BOX 306 WESTELED WISCONSIN 53964 TEL 608-296-3679 (OF MEDION SOILS SEED MIK, AS PROVIDED BY PHAINE HUMSERY, P.O. BOX 306, MESTHEDLY INSCRIPTION FILL 808-2981—369 (CM APPROVED EQUIVALENT), INSTALL SEED MITH SUPPLEMENTAL MATERIALS AND AMENDMENTS AS RECOMMENDED BY SEED SUPPUER AND RATES AND OPTIMUM TIMES OF THE YEAR AS RECOMMENDED BY THE SEED SUPPUER TO ENSURE SUCCESSIVE, GERMINATION AND SEED/ROOT ZONE GROWTH DEVELOPMENT, REFER TO PRODUCT SECURICATIONS AND MANUFACTURERS RECOMMENDATIONS FOR INSTALLATION.
- MATERIALS BIORETENTION BASIN PLUG PLANTINGS: PLUG PLANTINGS TO BE INSTALLED 1'-6" ON CENTER, MIXING SPECIES INTEGRALLY IN FLATS OF 2D AT A TIME. REFER TO WORN TECHNICAL STANDARDS FOR ROOTSTOCK AND PLUG PLANTINGS FOR BIORETENTION BASINS.

CONTRACTOR AND OWNER RESPONSIBILITY NOTES

- GURANTEE: THE CONTRACTOR SHALL GUARANTEE ALL PLANTS THROUGH DNE (1) YEAR AFTER ACCEPTANCE BY THE OWNER'S REPRESENTATIVE. PLANTS SHALL BE ALME AND IN HEALTHY AND FLOURISHING CONDITION AT THE END OF THE GUARANTEE PERIOD. THE CONTRACTOR SHALL REPLACE (AT NO COST TO OWNER) ANY PLANTS THAT ARE DEAD OR NOT IN A MOOROUS THRAWNIC CONDITION. REPLACEMENT PLANTS SHALL BE OF THE SAME KIND AND SIZE AS ORIGINALLY SPECIFIED UNLESS OTHERWISE DIRECTED BY OWNER'S REPRESENTATIVE. RESTORE BEDS AS NECESSAY FOLLOWING PLANT REPLACEMENT, INCLUDING BUT NOT LIMITED TO BEDDING, EDGING, MULCH, ETC. REPLACE PLANTS DAMAGED AT TIME OF PLANTING. REPAIR AREAS DISTURBED IN ANY WAY DURING PLANT REPLACEMENT AT NO COST TO OWNER. CONTRACTOR SHALL PROVIDE A TWO (2)—YEAR STRAGHTENING GUARANTEE FOR ALL TREES.
- CONTRACTOR IS RESPONSIBLE FOR STAKING THE PLANT MATERIALS FOR REVIEW BY OWNER'S REPRESENTATIVE PRIOR TO DIGGING AND PLACEMENT AND SMALL COORDINATE ALL FINE GRADING AND RESTORATION WITH THE GRADING CONTRACTOR.
- MUNITENANCE: (CONTRACTOR) FOR ALL PLANTINGS, AND SEEDED LAWN AREAS: THE CONTRACTOR SHALL MAINTAIN ALL PLANTINGS AND LAWN AREAS FOR A MINIMUM TIME PERIOD OF 60 DAYS, UNTIL FINAL ACCEPTANCE BY OWNER'S REPRESENTATIVE. THE CONTRACTOR IS RESPONSIBLE FOR ADEQUATELY WATERING PLANTS AND LAWN/TURFGRASS DURING HIS 60 DAY ESTABLISHMENT PERIOD. CONTRACTOR IS RESPONSIBLE FOR THE ESTABLISHMENT OF HEALTHY VICOROUS PLANT MATERIALS AND LAWN/TURFGRASS GROWTH. CONTRACTOR IS ALSO RESPONSIBLE FOR MAY PRINTING OF PLANT MATERIALS, AND SHAPING MAD/DAR REPLACEMENT OR SUPPLEMENT OF DEFICIENT SHREDDED HARDWOOD BARK MULCH DURING THIS PERIOD. LONG TERN PLANT MATERIALS AND LAWN/TURFGRASS MAINTENANCE AND ANY PROGRAM FOR SUCH IS THE RESPONSIBILITY OF THE OWNER. ALL PLANTINGS AND LAWN/TURFGRASS AREAS SHALL BE MAINTAINED IN A MANICURED CONDITION UNTIL THE TIME WHEN THE OWNER'S ACCEPTANCE IS GIVEN.
- MUNITENANCE: (OWNER) THE OWNER IS RESPONSIBLE FOR THE CONTINUED MAINTENANCE, REPAIR AND REPLACEMENT OF ALL LANDSCAPING MATERIALS AND WEED BARRIER FABRIC AS NECESSARY FOLLOWING THE ONE (1) YEAR CONTRACTOR GUARANTEE PERIOD.



CREATE THE VISION TELL THE STORY

MADISON REGIONAL OFFICE P. 608.848.5060

LIENT ADDRESS

CBL & ASSOCIATES PROPERTIES

2030 HAMILTON PLACE BLVD., STE, 500, CHATANOOGA, TN 34721

PORTILLO'S, EAST TOWNE MALL

CITY OF MADISON, WI DANE COUNTY

MODIFICATIONS:

Date.	Description:
11.08.17	Land Use - UDC Initial/Final

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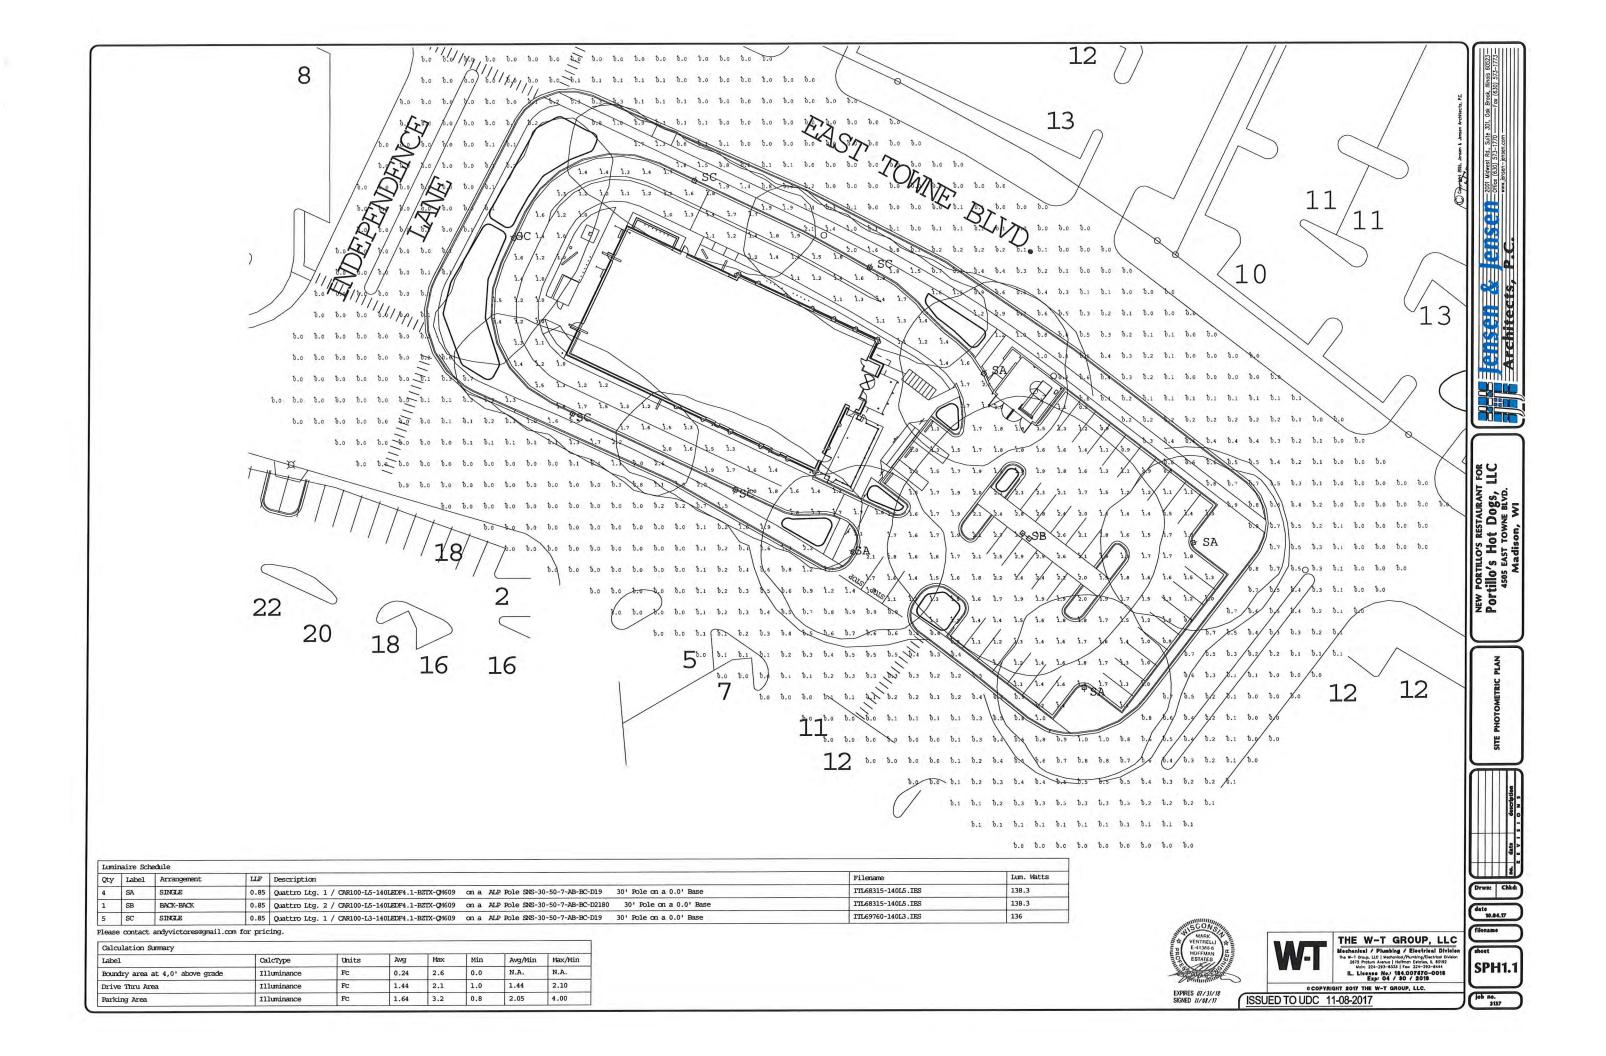
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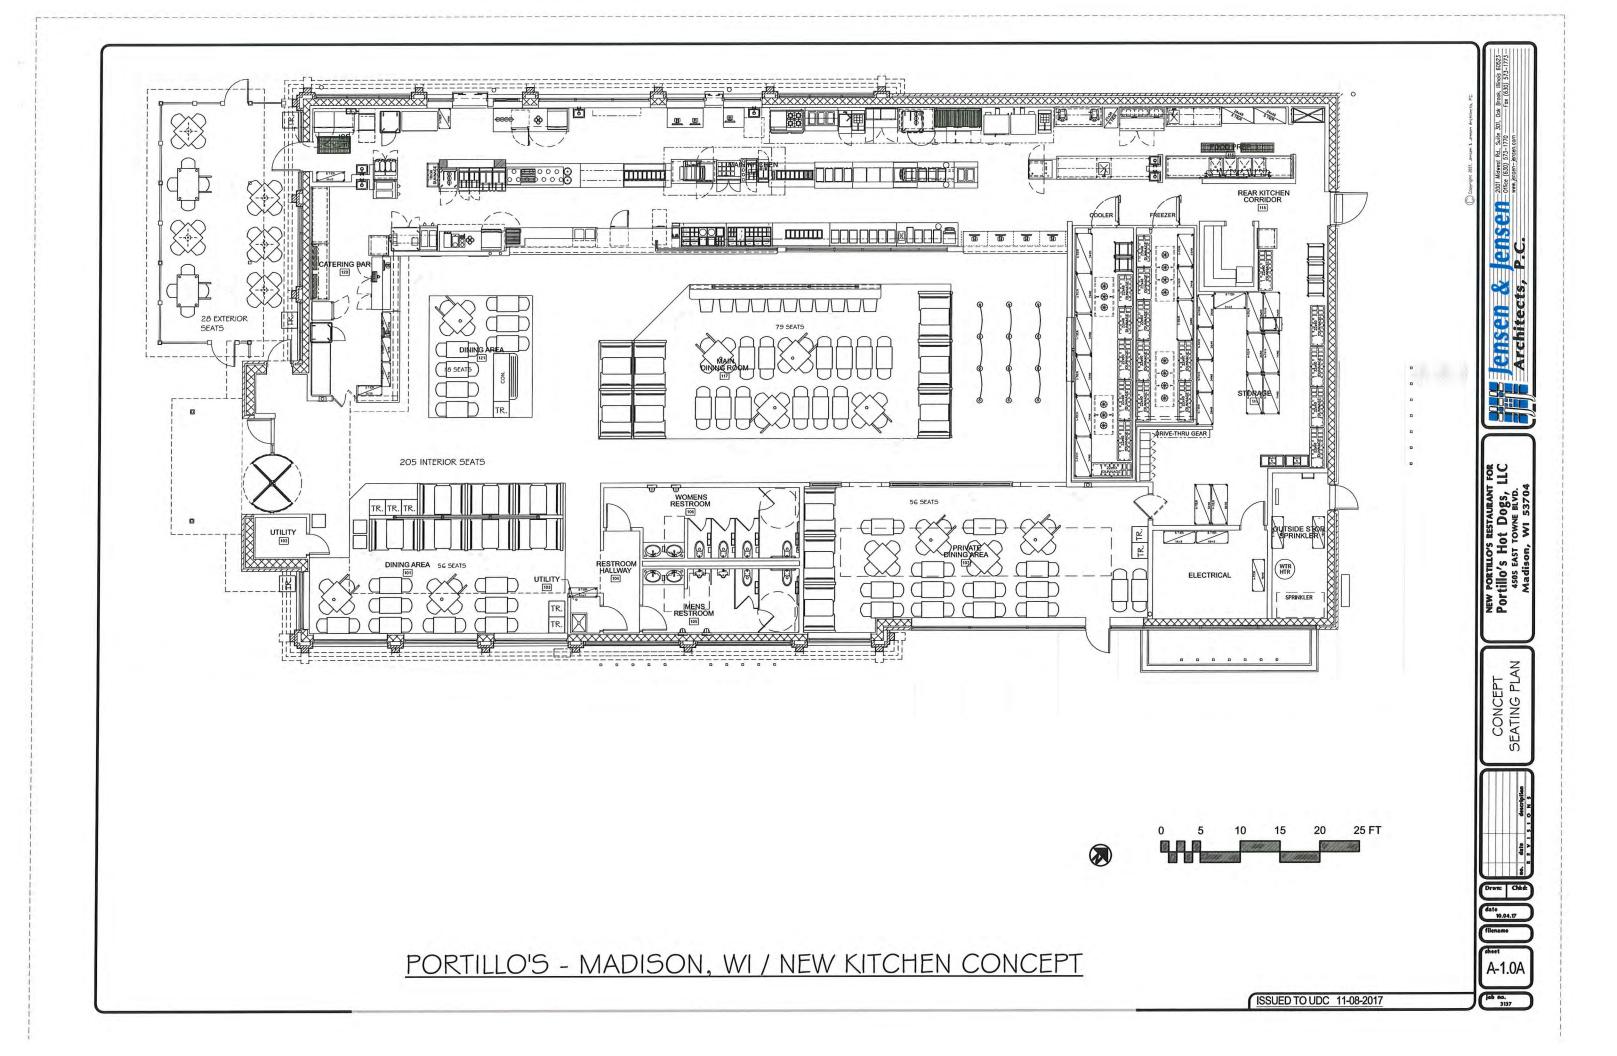
09-19-2017


LANDSCAPE DETAILS. **INOTES, AND** SPECIFICATIONS


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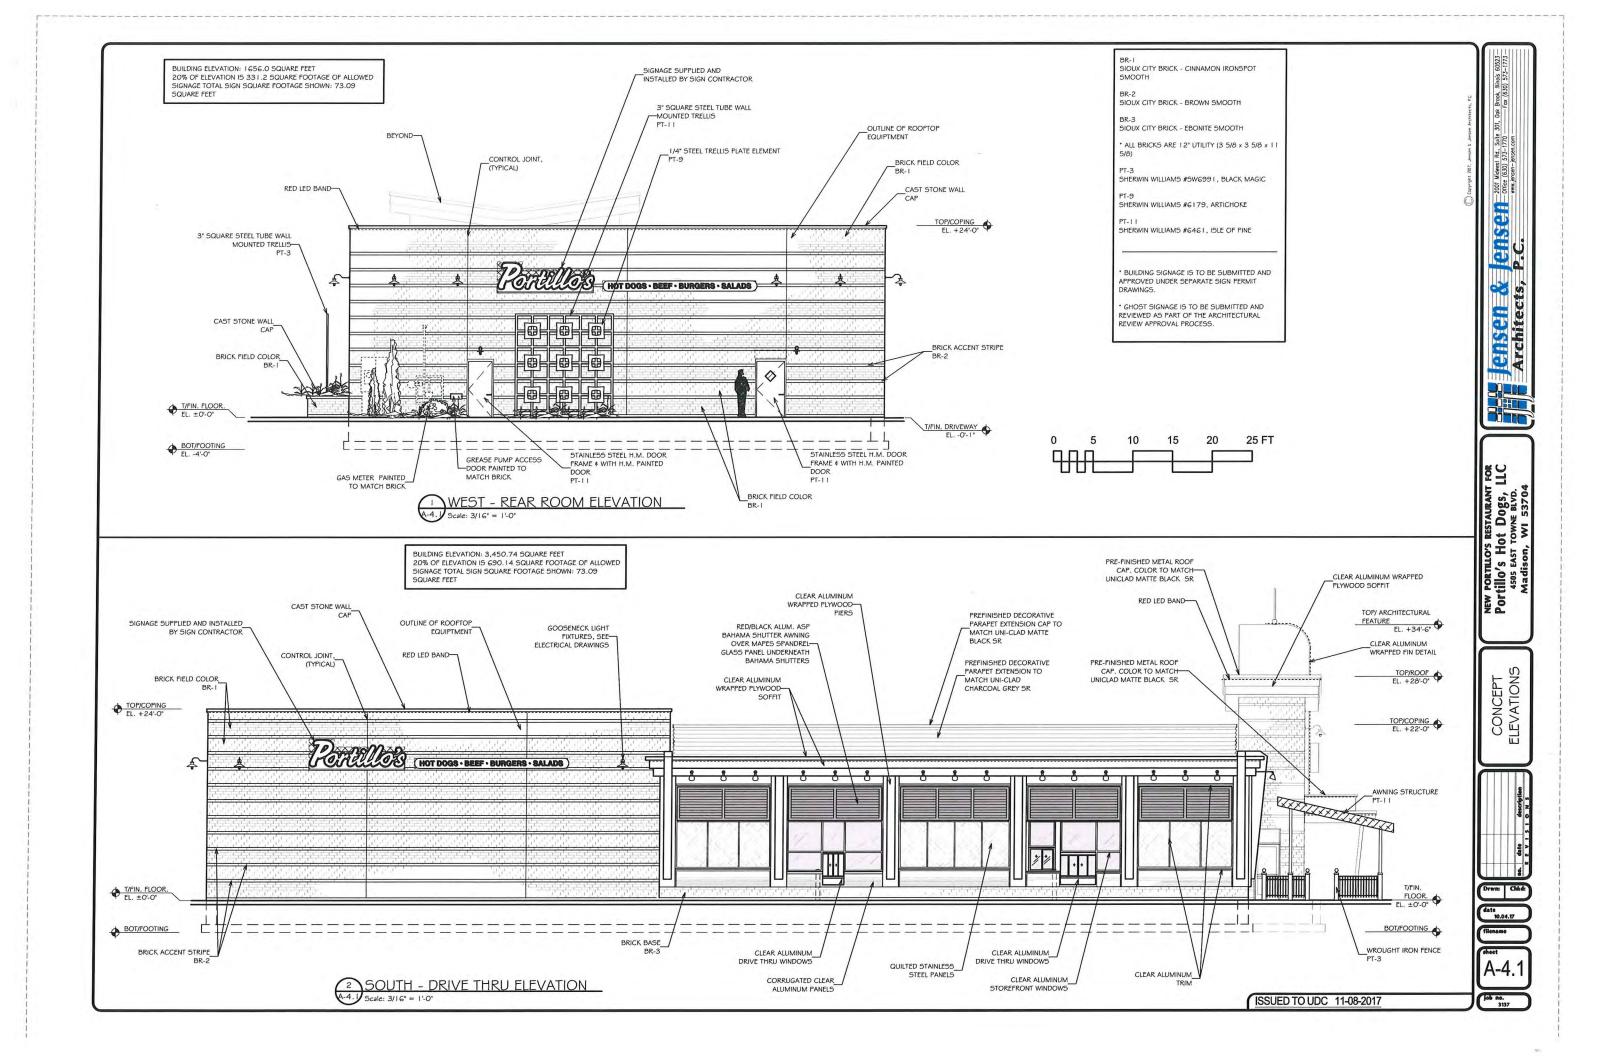
Toll Free (800) 242-8511









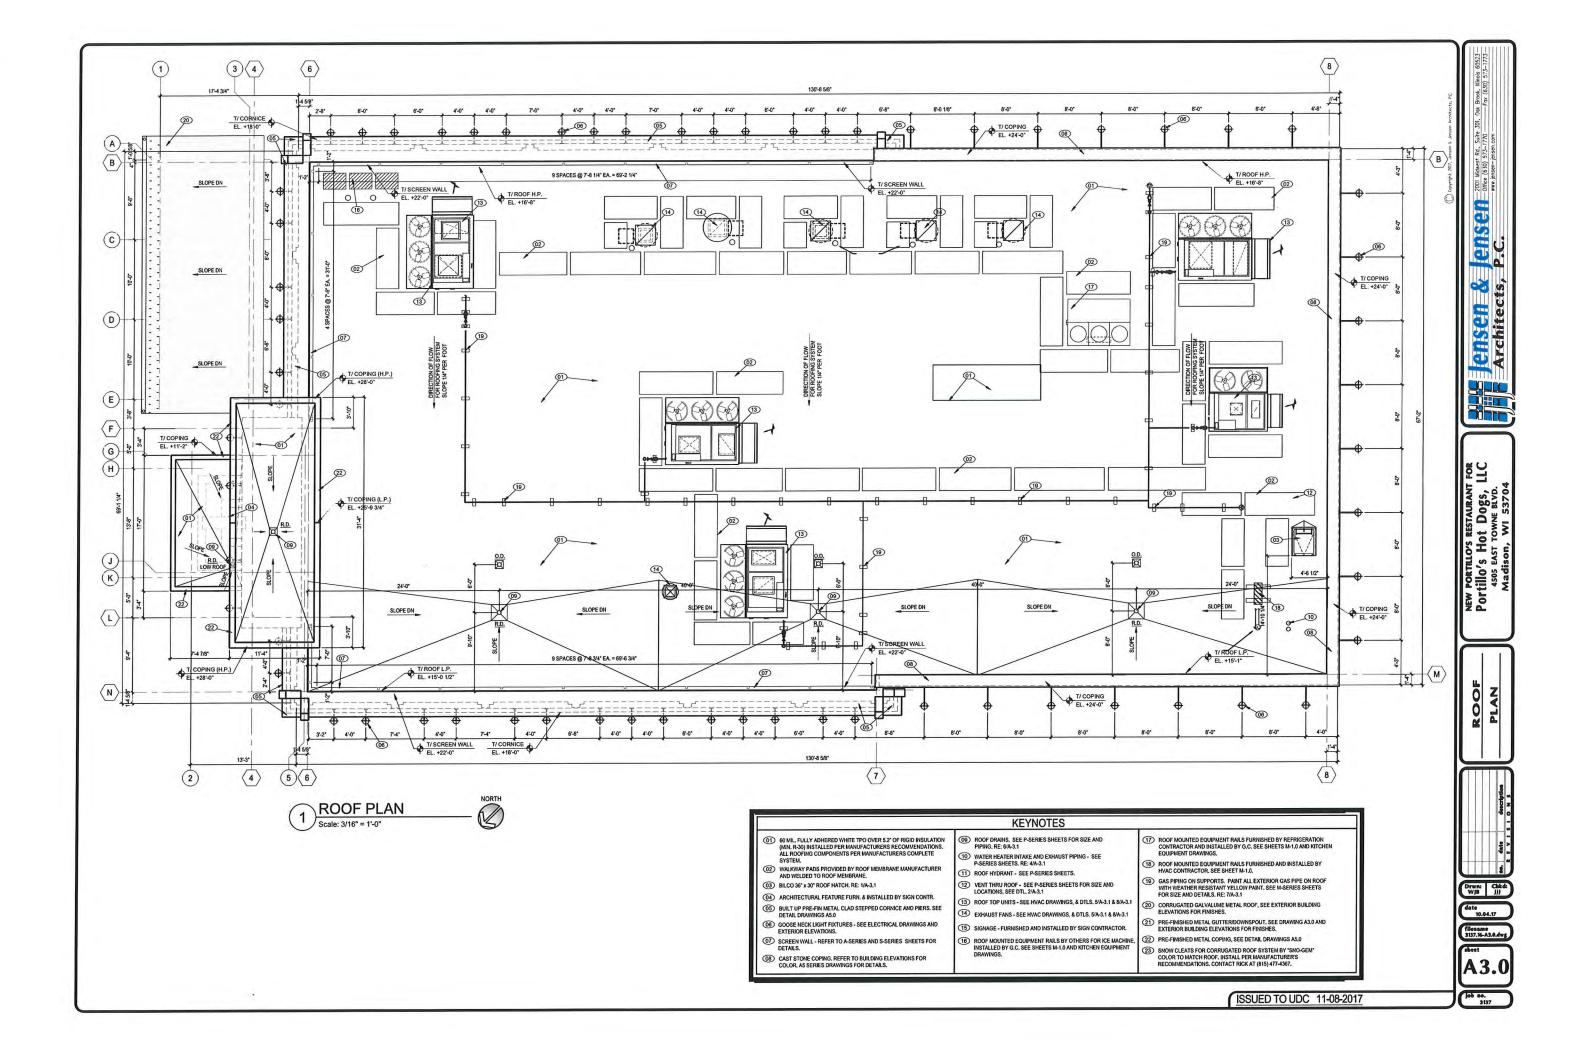

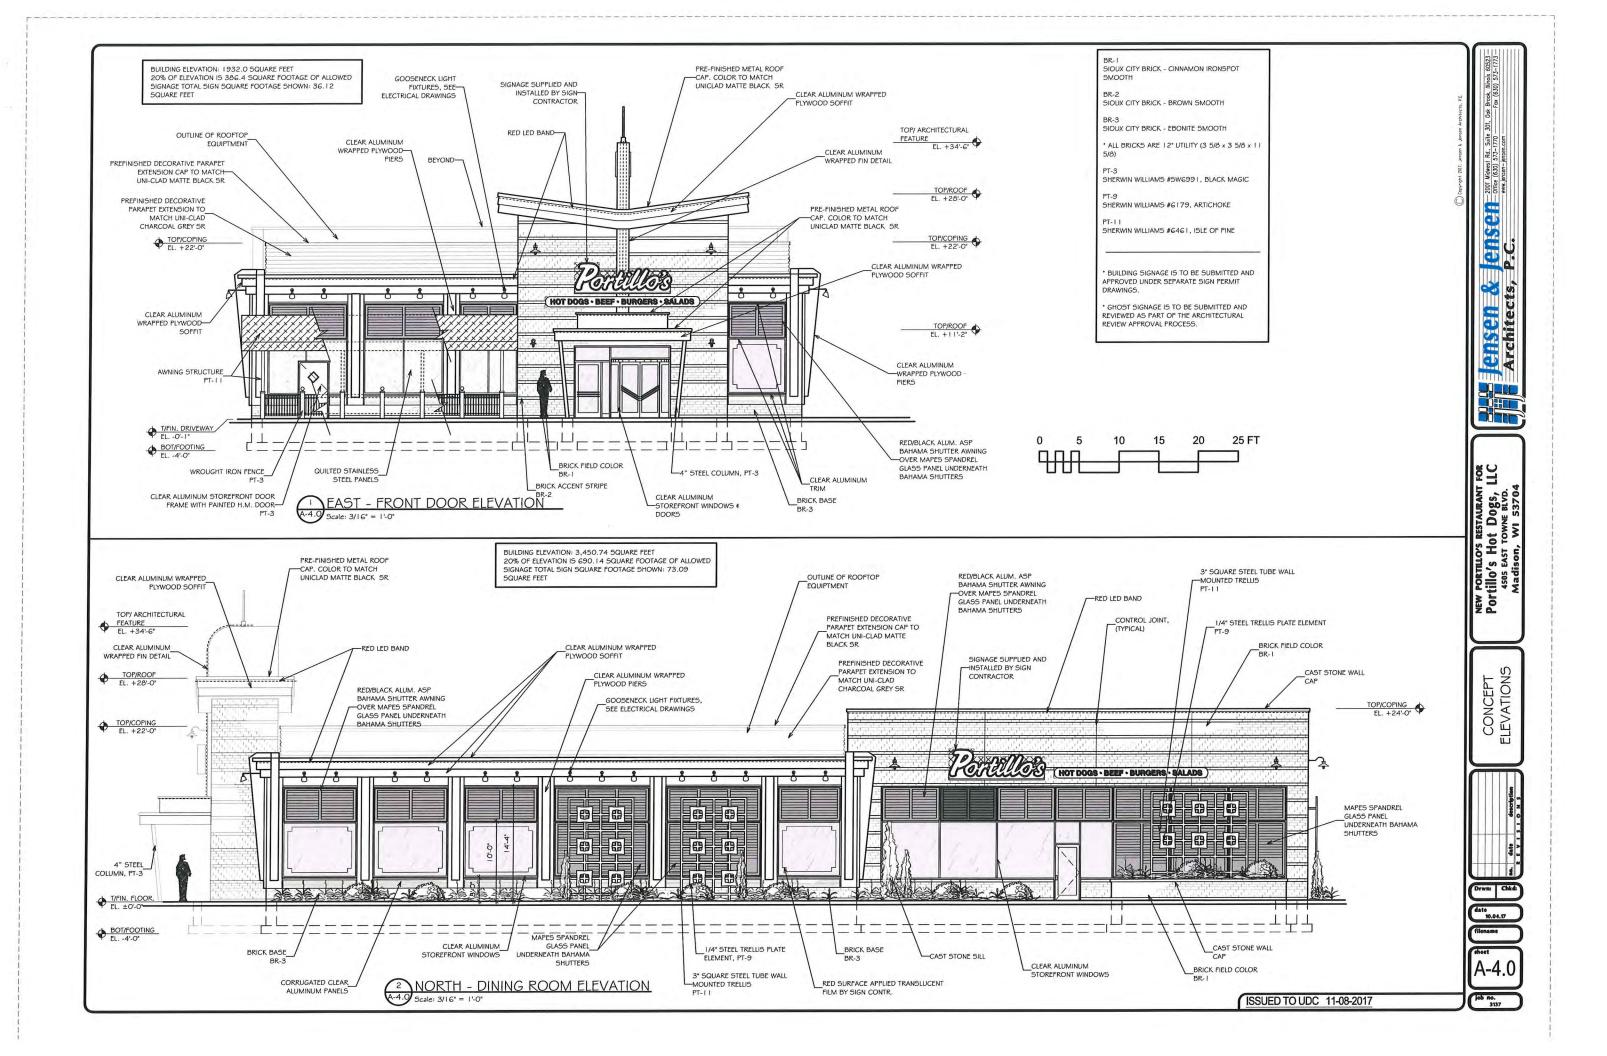

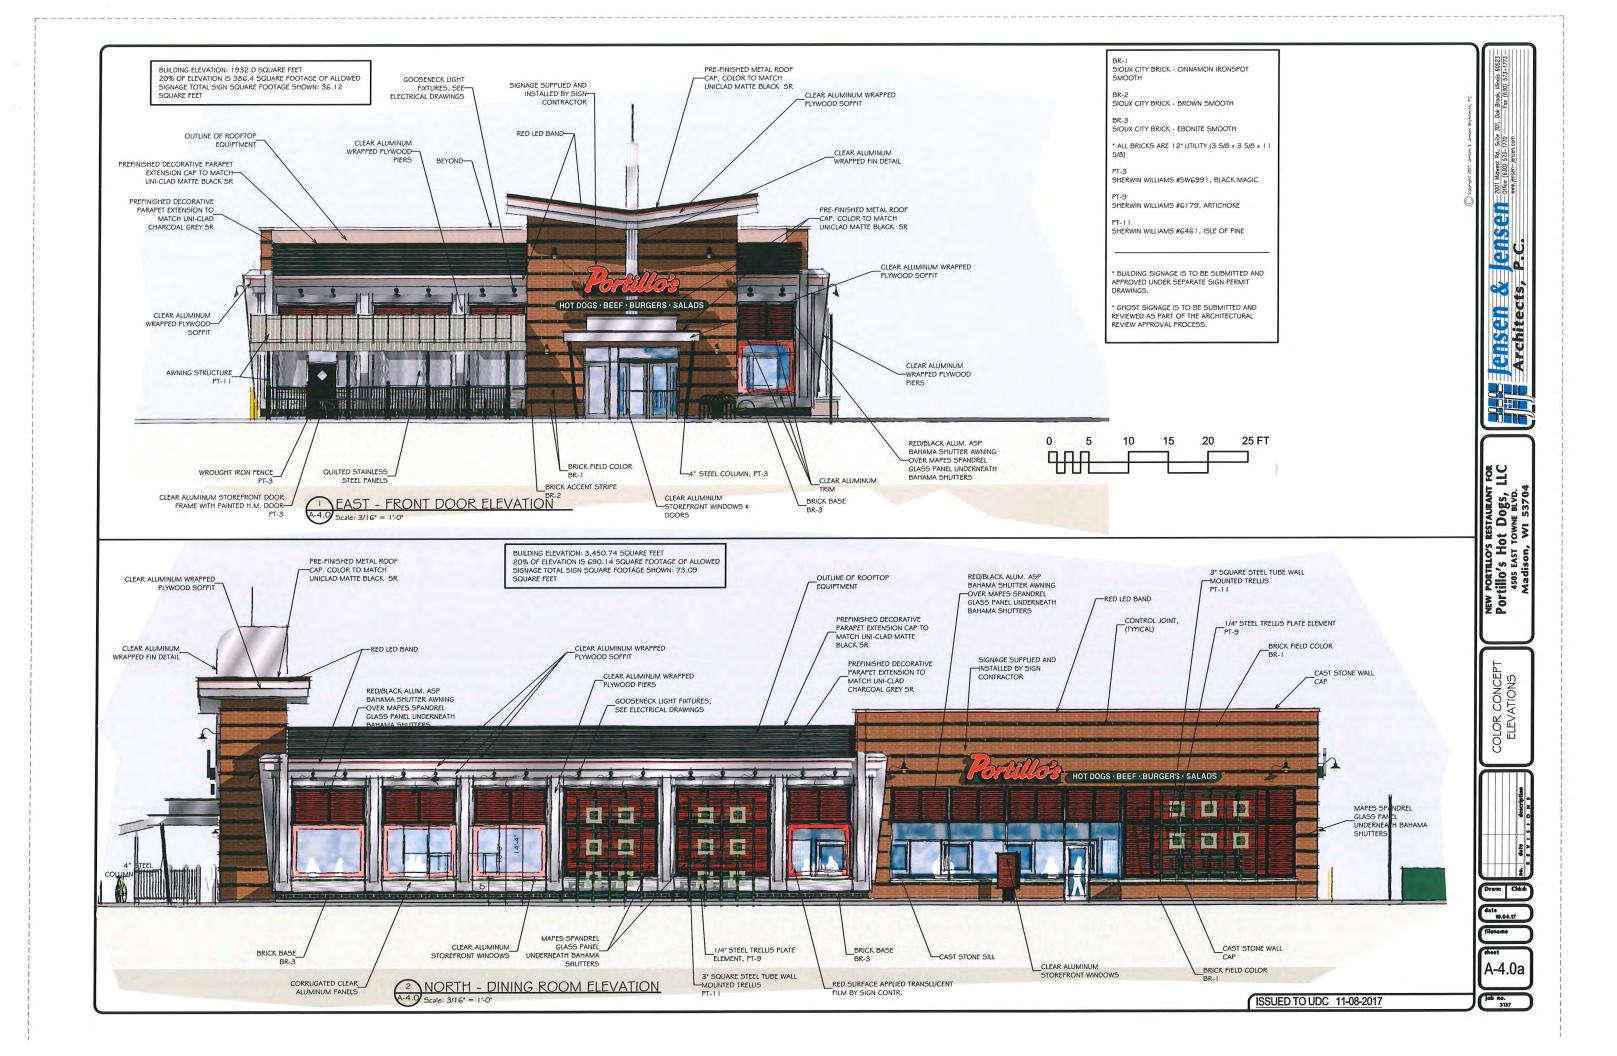

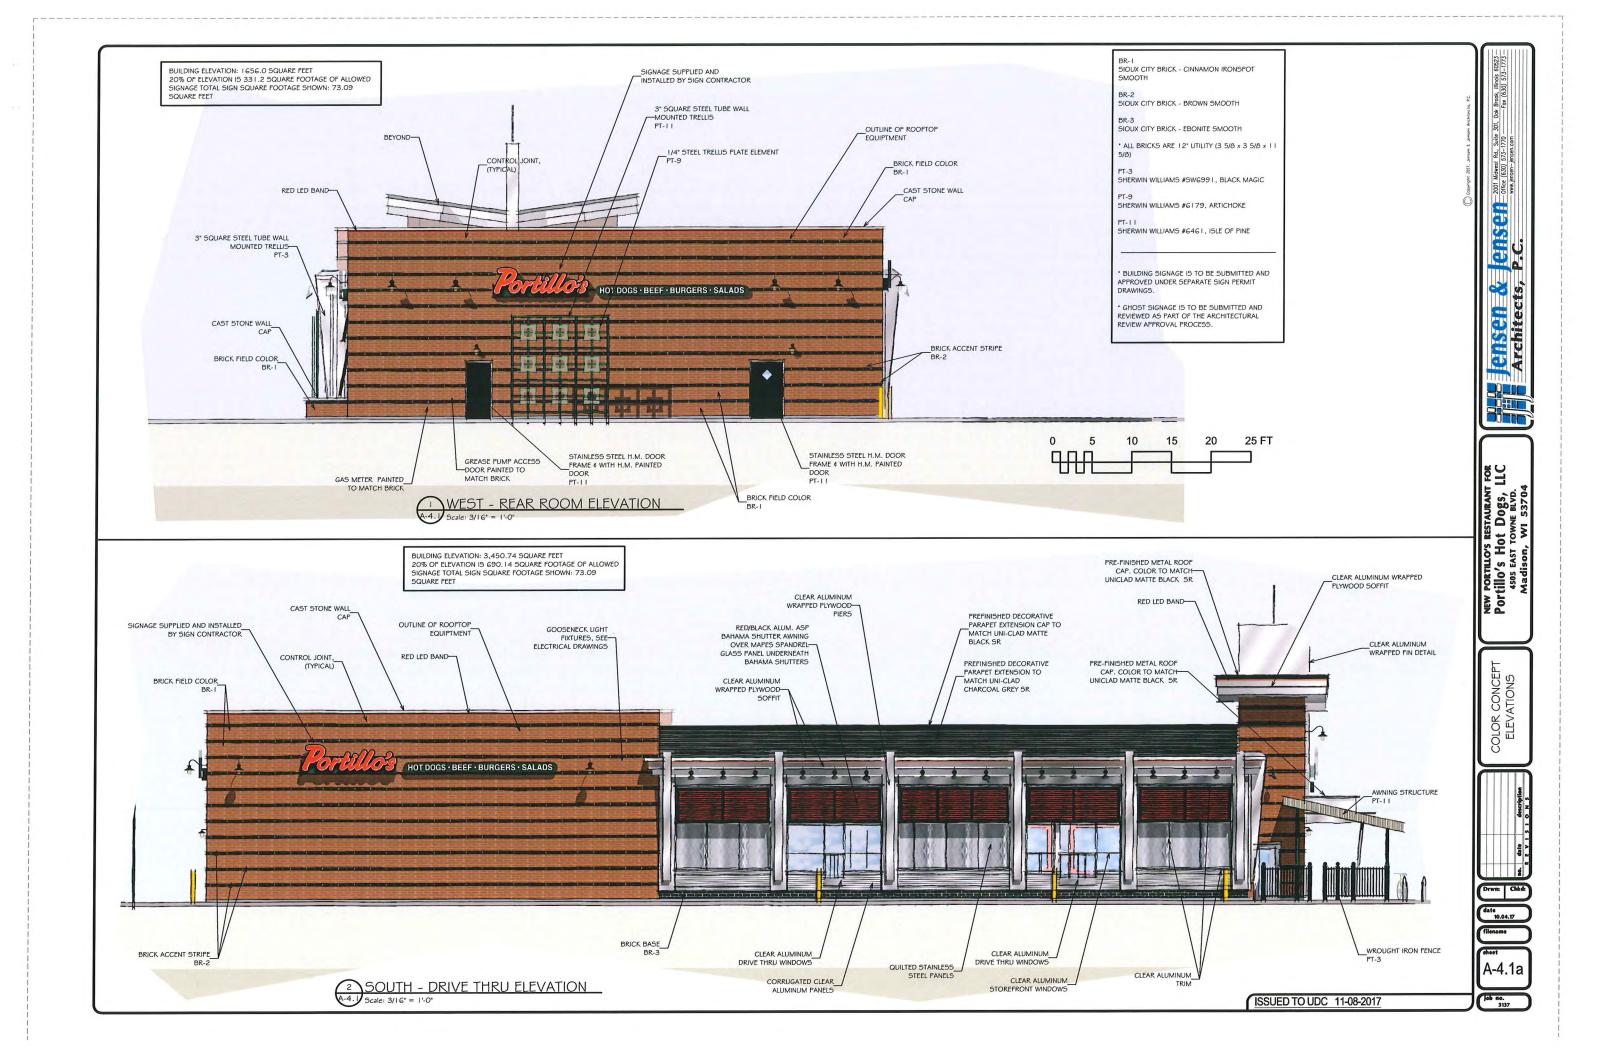



PAC-CLAD "CARDINAL RED"

METAL SHUTTER



(PT-3) SWG991 "BLACK MAGIC"

WROUGHT IRON



(PT-9) SW6979 "ARTICHOKE"


ACCENT PAINT



(PT-11) SW6979 "ARTICHOKE"

ACCENT PAINT



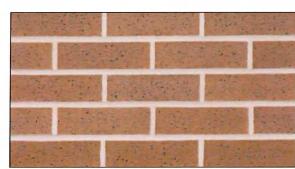

BR- I SIOUX CITY BRICK - CINNAMON IRONSPOT SMOOTH



MADISON, WI

EXTERIOR FINISHES



UNI-CLAD MATTE BLACK SR ALUM. BREAK METAL




UNI-CLAD CHARCOAL GREY SR ALUM. BREAK METAL



BR-2 SIOUX CITY BRICK - BROWN SMOOTH



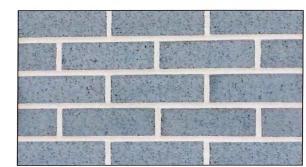

BR-3 SIOUX CITY BRICK - EBONITE SMOOTH



RESIN TABLE TOP



BLACK POWDER COATED BLACK ALUMINUM TABLE BASE




ALUMINUM FRAME WITH PVC WRAP CHAIR






MATERIAL BOARD

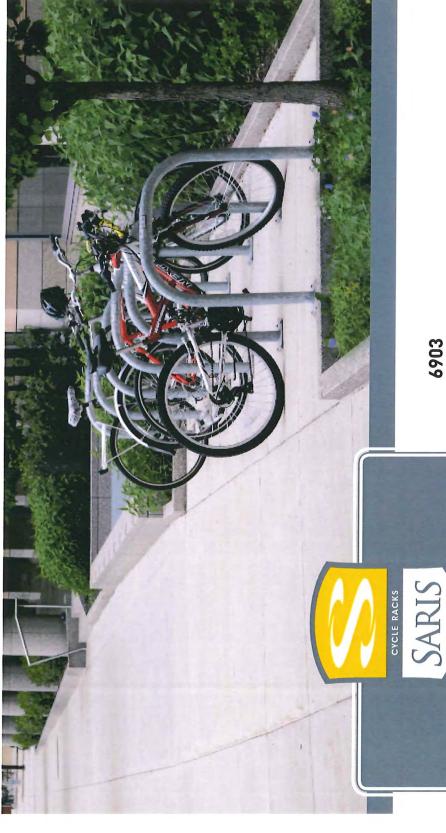

6903

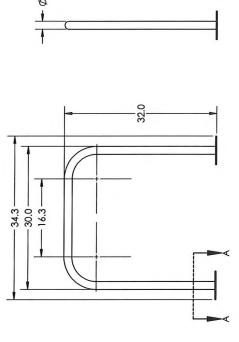

The bike dock is a simple and intuitive design that provides space efficient, high security bike parking. The bike dock accomodates two bikes, supporting them at two points and allowing for u-lock compatibility of both the wheel and bike frame.

 $\frac{\Delta}{\Delta}$


6903 Shown

Specifi	cations -	Specifications - 1.66" electrowelded steel tubing, 12 gauge	weldec	steel	tubing,	12 gar	age
Model #	# Bikes	Type of mount	weight	length	width	height	Space Requirem
6902	2	below grade	17 lbs.	30.	1.66"	32	.011×.199
6903	2	flange mount	19 lbs.	34.3"	.9	32"	.011×110"
Specifi	cations -	Specifications - 2 3/8" schedule 40 steel pipe, 9 gauge	dule 40	steel p	ipe, 9 g	gauge	
Model #	# Bikes	Type of mount	weight	length	width	height	Space Requirem
2112	2	below grade	31 lbs.	30	2.4"	32	.011 x 110"
2113	2	flange mount	30 lbs.	33.6"	9	32"	.011×.110
Specifi	cations -	Specifications - 2" X 2" X 3/16" square tubing, 7 gauge	enbs9	are tub	ing, 7 g	gange	
Model#	# Bikes	Type of mount	weight	length	width	height	Space Requirem
2212	2	below grade	38 lbs.	30	2	32	.011 x 110"
2213	2	flange mount	34 lbs.	34"	9	32	.110.

Note: Saris Parking Systems representatives can assist with custom layout and spacing to meet your room dimensions and desired bike capacity.

Bike Dock

Recommended Spacing

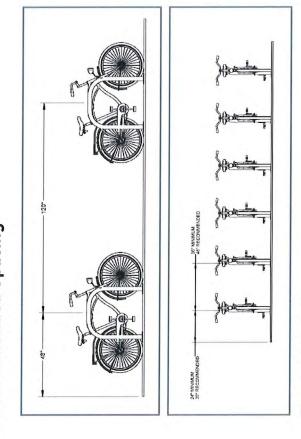


Product Details

- 1.66", 12 gauge schedule 40 pipe -- most affordable solution 2 3/8", 9 gauge schedule 40 pipe -- larger diameter pipe leaves less space between the lock and rack, which provides better security
 2" square, 7 gauge schedule 40 pipe -- square tubing resists efforts from thieves using pipe cutters
 Offers 2 points of contact for bike stability
 Meets APBP guidelines

Anchors must be purchased separately




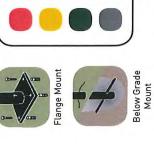



2113

2213

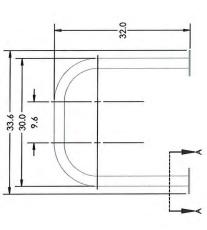

34.0 -

2213 Shown







Saris Bicycle Parking & Storage Solutions

800.783.7257

2113 Shown





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NEW PORTILLO'S RESTAURANT FOR PORTIBLO'S HOT DOGS, LLC 4505 EAST TOWNE BLVD.

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