URBAN DESIGN COMMISSION APPLICATION



City of Madison **Planning Division** 126 S. Hamilton St. P.O. Box 2985 Madison, WI 53701-2985 (608) 266-4635



FOR OFFICE USE ONL	Y:
Paid	Receipt #
Date received	
Received by	
Aldermanic District	
Zoning District	
Urban Design District	
Submittal reviewed by	·

	the of the of the office of th	desired me	eting of the second of the sec	date and r, transla nodations	d the tor, m	cation, including action requested aterials in alternate cess these forms, mediately.		Zoning Urban	nanic Distr District Design Di tal review	
1.	Proj	ect Inform	ation							
	Addı	ress: _	21	155 Rir	mroc	k Road				
	Title	: _	H	ome 2	Suit	es Hotel				
2.	Арр	lication Ty	pe (ch	eck all	that	apply) and Reque	ested Da	te		
	UDC	meeting d	ate red	quested	_	February 21, 2	2018			
	×	New devel	lopmer	nt		Alteration to an	existing o	r previ	ously-app	roved development
		Informatio	nal		Ø	Initial approval			Final app	proval
3.	Proj	ect Type								
		Project in a	an Urba	an Desig	n Dist	rict		Sigr	nage	
		•				District (DC), Urban			Comprel	nensive Design Review (CDR)
						ed-Use Center Distri	. ,			Variance (i.e. modification of signage height,
						ment Center Distr I), or Employment		O. I.	•	d setback)
		District (EC						Oth		and if
		Planned De	=			()			Please s	респу
				elopmer ementa		n (GDP) Plan (SIP)				
	×	•				dential Building Co	mnlev			
						_	•			
4.	App	licant, Age	ent, an	•	•	Owner Informati	on		0.5	DA Anabitantuna 8 Danima
		licant name	_	Josh				Comp	ully	BA Architecture & Design
		et address	-				uite 204		•	Middleton/WI 53562
		ohone	-	608-82				Email	josn.wi	lcox@garybrink.com
	Proje	ect contact	perso	n (sa	me a	s applicant)		Comp	any	
	Stree	et address	-					City/S	tate/Zip	
		ohone	-							
	Prop	erty owne	r (if no	t appli	cant)	Madison Rimi	ock Loc	dging I	nvestor	s I LLC (c/o North Central Group)
	Stree	et address					ite 200	City/S	tate/Zip	Middleton/WI 53562
	Telep	ohone	6	508-83	6-60	60		Email	ainma	n@ncghotels.com

5. Required Submittal Materials

- **Application Form**
- X Letter of Intent
 - If the project is within an Urban Design District, a summary of how the development proposal addresses the district criteria is required
 - For signage applications, a summary of how the proposed signage is consistent with the applicable CDR or Signage Variance review criteria is required.
- 図 **Development plans** (Refer to checklist provided below for plan details)
- 図 Filing fee
- 図 **Electronic Submittal***

Each submittal must include fourteen (14) 11" x 17" collated paper copies. Landscape and Lighting plans (if required) must be full-sized. Please refrain from using plastic covers or spiral binding.

Both the paper copies and electronic copies must be submitted prior to the application deadline before an application will be scheduled for a UDC meeting. Late materials will not be accepted. A completed application form is required for each UDC appearance.

For projects also requiring Plan Commission approval, applicants must also have submitted an accepted application for Plan Commission consideration prior to obtaining any formal action (initial or final approval) from the UDC. All plans must be legible when reduced.

*Electronic copies of all items submitted in hard copy are required. Individual PDF files of each item submitted should be compiled on a CD or flash drive, or submitted via email to <u>udcapplications@cityofmadison.com</u>. The email must include the project address, project name, and applicant name. Electronic submittals via file hosting services (such as Dropbox.com) are not allowed. Applicants who are unable to provide the materials electronically should contact the Planning Division at (608) 266-4635 for assistance.

6.	pplicant Declarations
	Prior to submitting this application, the applicant is required to discuss the proposed project with Urban Design Commission staff. This application was discussed with <u>Janine Glaeser</u> on November 22, 2017
	The applicant attests that all required materials are included in this submittal and understands that if any required information is not provided by the application deadline, the application will not be placed on an Urban Design Commission agenda for consideration.
	pplicant nameJosh WilcoxRelationship to propertyArchitect
	uthorized signature of <u>Property Owner</u> <u>Full Willia</u> Date 1-3-18
7.	oplication Filing Fees
	ees are required to be paid with the first application for either initial or final approval of a project, unless the project is part

combined application process involving the Urban Design Commission in conjunction with Plan Commission ar Common Council consideration. Make checks payable to City Treasurer. Credit cards may be used for application fees of less than \$1,000.

Please consult the schedule below for the appropriate fee for your request:

ш	Urban Design Districts: \$350 (per §35.24(6) MGO).
	Minor Alteration in the Downtown Core District (DC) or Urban Mixed-Use District (UMX): \$150 (per §33.24(6)(b) MGO)
	Comprehensive Design Review: \$500 (per §31.041(3)(d)(1)(a) MGO)
	Minor Alteration to a Comprehensive Sign Plan: \$100 (per §31.041(3)(d)(1)(c) MGO)
	All other sign requests to the Urban Design Commission, including, but not limited to: appeals from the decisions of the Zoning Administrator.

requests for signage variances (i.e. modifications of

code approvals: \$300 (per §31.041(3)(d)(2) MGO)

signage height, area, and setback), and additional sign

A filing fee is not required for the following project applications if part of the combined application process involving both Urban Design Commission and Plan Commission:

- Project in the Downtown Core District (DC), Urban Mixed-Use District (UMX), or Mixed-Use Center District (MXC)
- Project in the Suburban Employment Center District (SEC), Campus Institutional District (CI), or Employment Campus District (EC)
- Planned Development (PD): General Development Plan (GDP) and/or Specific Implementation Plan (SIP)
- Planned Multi-Use Site or Residential Building Complex

URBAN DESIGN COMMISSION APPROVAL PROCESS



Introduction

The City of Madison's Urban Design Commission (UDC) has been created to:

- Encourage and promote high quality in the design of new buildings, developments, remodeling, and additions so as to maintain and improve the established standards of property values within the City.
- Foster civic pride in the beauty and nobler assets of the City, and in all other ways possible assure a functionally efficient and visually attractive City in the future.

Types of Approvals

There are three types of requests considered by the UDC:

- <u>Informational Presentation</u>. Applicants may, at their discretion, request to make an Informational Presentation to the UDC prior to seeking any approvals to obtain early feedback and direction before undertaking detailed design. Applicants should provide details on the context of the site, design concept, site and building plans, and other relevant information to help the UDC understand the proposal and provide feedback. (Does not apply to CDR's or Signage Variance requests)
- <u>Initial Approval</u>. Applicants may, at their discretion, request initial approval of a proposal by presenting preliminary design information. As part of their review, the Commission will provide feedback on the design information what should be addressed at Final Approval stage.
- <u>Final Approval</u>. Applicants may request Final Approval of a proposal by presenting all final project details. Recommendations or concerns expressed by the UDC in the initial approval must be addressed at this time.

Presentations to the Commission

Primarily, the UDC is interested in the appearance and design quality of projects. Emphasis should be given to the site plan, landscape plan, lighting plan, building elevations, exterior building materials, color scheme, and graphics.

When presenting projects to the UDC, applicants must fill out a registration slip provided in the meeting room and present it to the Secretary. Presentations should generally be limited to 5 minutes or as extended by motion by consent of the Commission. The Commission will withhold questions until the end of the presentation.

Applicants are encouraged to consider the use of various graphic presentation material including a locator map, photographs, renderings/model, scale drawings of the proposal in context with adjacent buildings/uses/signs, etc., as may be deemed appropriate to describe the project and its surroundings. Graphics should be mounted on rigid boards so that they may be easily displayed. Applicants/presenters are responsible for all presentation materials, AV equipment and easels.

URBAN DESIGN DEVELOPMENT PLANS CHECKLIST



The items listed below are minimal application requirements for the type of approval indicated. Please note that the UDC and/or staff may require additional information in order to have a complete understanding of the project.

1. Informa	ational Presentation		Requirements for All Plan Sheets
	Locator Map		1. Title block
	Letter of Intent (If the project is within a		2. Sheet number
	Urban Design District, a summary of how the development proposal addresses the	D 112 1122 1	3. North arrow
	district criteria is required)	Providing additional information beyond these	4. Scale, both written and graphic
	Contextual site information, including	minimums may generate	5. Date
	photographs and layout of adjacent buildings/structures	a greater level of feedback from the Commission.	6. Fully dimensioned plans, scaled at 1"= 40' or larger
	Site Plan		** All plans must be legible, including
	Two-dimensional (2D) images of proposed buildings or structures.		the full-sized landscape and lighting plans (if required)
2. Initial A	pproval		
	Locator Map)
×	Letter of Intent (If the project is within a L how the development proposal addresses		
×	Contextual site information, including phobuildings/structures	otographs and layout of adjace	Providing additional information beyond these
×	Site Plan showing location of existing and lanes, bike parking, and existing trees over		
×	Landscape Plan and Plant List (must be leg	gible)	from the Commission.
⊠	Building Elevations in both black & white material callouts)	and color for all building sides	(include
	PD text and Letter of Intent (if applicable)		J
3. Final Ap	proval		
•	equirements of the Initial Approval (see abo	ove). plus :	
	Grading Plan		
	Proposed Signage (if applicable)		
	Lighting Plan, including fixture cut sheets	and photometrics plan (must	be legible)
	Utility/HVAC equipment location and scre	•	-
	PD text and Letter of Intent (if applicable)		,
	Samples of the exterior building materials	(presented at the UDC meeti	ng)
4. Compre	hensive Design Review (CDR) and Varian	ce Requests (Signage applic	ations only)
	Locator Map		-
	Letter of Intent (a summary of <u>how</u> the pris required)	roposed signage is consistent v	with the CDR or Signage Variance criteria
	Contextual site information, including pho project site	otographs of existing signage b	ooth on site and within proximity to the
	Site Plan showing the location of existing sidewalks, driveways, and right-of-ways	signage and proposed signage	, dimensioned signage setbacks,
	Proposed signage graphics (fully dimensic	oned, scaled drawings, includir	ng materials and colors, and night view)
	Perspective renderings (emphasis on ped	_	

☐ Graphic of the proposed signage as it relates to what the Ch. 31, MGO would permit



January 3, 2018

Matt Tucker Department of Planning & Development 126 S. Hamilton Street Madison, WI 53703

Re: Letter of Intent

2155 Rimrock Road - Conditional Use

Dear Matt:

This is our Letter of Intent (Conditional Use) for the property located at 2155 Rimrock Road. The owner, Madison Rimrock Lodging Investors I, LLC is planning to develop a new four-story, 85,319 sf, 143 guestroom hotel on Parcel 2. Parcel 1 will not include any structures as part of this proposal. The development shall include the demolition of the existing structures located at 2155, 2165, 2175 & 2201 Rimrock Road. The lot area is 194,510 sf (or 4.47 acres).

Total Parking/Bicycle Stalls will be as follows:

Parcel 1 (Retail Parcel along Rimrock Road)

Small Car Parking: 0 Large Car Parking: 0 Accessible Parking: 0

Bicycle Stall: 0 Total Parcel 1 Parking: 0

Parcel 2 (Hotel)

Small Car Parking: 28 Large Car Parking: 107 Accessible Parking: 5 Bicycle Stall: 16

Total Parcel 2 Parking: 140

Parcel 3 (DOR Overflow Lot)

Small Car Parking: 0 Large Car Parking: 24 Accessible Parking: 0 Bicycle Stall: 0

Total Parcel 3 Parking: 24

Total Site Parking

Small Car Parking: 28 Large Car Parking: 131 Accessible Parking: 5 Bicycle Stall: 16

Total Site Car Parking: 164

All maintenance, including trash and snow removal, will be provided by private contract.

The proposed hours of operation will 24 hours a day/365 days a year.

The number of construction jobs created as a result of this new development will be 30 and the number of full time equivalent jobs created is 30 FTE.

The current assessed value of the land is approximately \$2,000,000.

The proposed construction schedule is for construction to commence March of 2018 and construction completion to be April 2019.

The Development Team includes the following:

Developer/Owner: Madison Rimrock Lodging Investors I, LLC

c/o North Central Group

1600 Aspen Commons, Suite 200

Middleton, WI 53562 Phone: 608-836-6060 Fax: 608-836-6399

Principal Contact: Andy Inman

ainman@ncghotels.com

Architect: GBA

7780 Elmwood Avenue, Suite 204

Middleton, WI 53562 Phone: 608-829-1750 Fax: 608-829-3056

Principal Contact: Josh Wilcox josh.wilcox@garybrink.com

Civil/Landscape: Vierbicher

999 Fourier Drive #201 Madison, WI 53717 Phone: 608-826-0532

Principal Contact: Andrew Barnebey

abar@vierbicher.com

Please refer to the attached plans for additional information.

feel William

Sincerely,

Josh Wilcox VP/Partner




PROPOSED Home2 Suites

2155 Rimrock Road Madison, Wisconsin

UDC / PLANNING COMMISSION RE-SUBMITTAL JANUARY 3, 2018

PROJECT LOCATION MAP

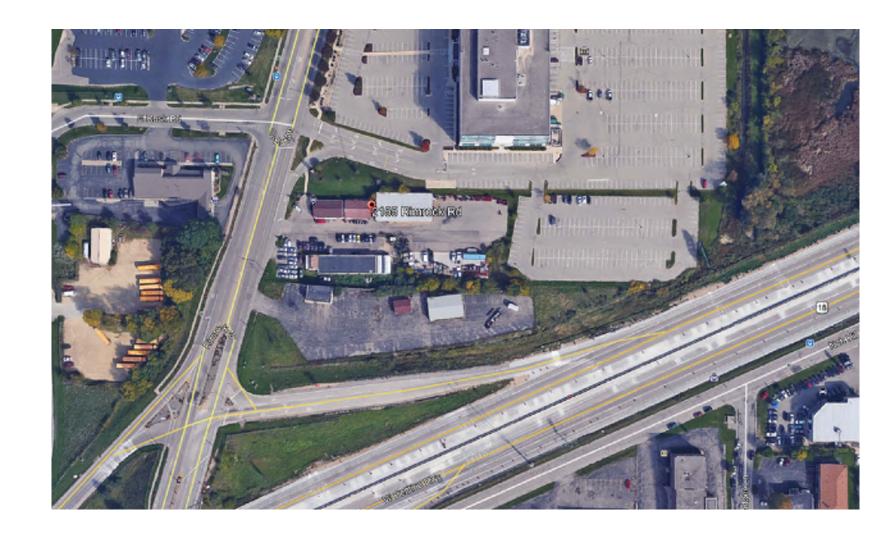

PROJECT ROOM & PARKING MATRIX

	D	ouble Queen	S		Kings		Total	Causes Costag	
Floor	Standard D/Q	ACC D/Q	1 Bedroom	Standard King	ACC KING	1 Bedroom	TOtal	SquareFootag	
1st	15	0	0	6	1	1	23	22,913	
2nd	14	1	0	21	1	3	40	20,802	
3rd	14	1	0	21	1	3	40	20,802	
4th	14	1	0	22	0	3	40	20,802	
	57	3	0	70	3	10	143		
Totals		60		83			143	85,319	
		42%			58%		100%		
				Parking Stalls					
ACC-P	arking Stalls	5	Non ACC-F	arking Stalls	135	Tota	<u> </u>	140	
***************************************	***************************************	***************************************	Site Info	ormation	***************************************	***************************************	***************************************	Area Total	
F	arcel 1	62,728	Par	cel 2	117,652	Parcel 3	12,359	192,739	

SHEET INDEX:

TITLE SHEET

EXISTING SITE CONDITIONS EXISTING SITE CONDITIONS

EXISTING SITE CONDITIONS

CIVIL DRAWINGS

ZONING PLAN

EXISTING CONDITIONS PLAN

DEMOLITION PLAN

SITE PLAN

GRADING & EROSION CONTROL PLAN

UTILITY PLAN

CONSTRUCTION DETAIL PLAN CONSTRUCTION DETAIL PLAN

CONSTRUCTION DETAIL PLAN CONSTRUCTION DETAIL PLAN CONSTRUCTION DETAIL PLAN

LANDSCAPE PLAN FIRE ACCESS PLAN

LIGHTING DRAWINGS

SITE LIGHTING PLAN

SITE LIGHTING PLAN

SITE LIGHTING LUMINAIRES

ARCHITECTURAL DRAWINGS

HOTEL FIRST FLOOR PLAN HOTEL SECOND FLOOR PLAN

HOTEL THIRD FLOOR PLAN HOTEL FOURTH FLOOR PLAN

HOTEL ROOF PLAN

HOTEL COLORED BUILDING ELEVATIONS

HOTEL COLORED BUILDING ELEVATIONS

HOTEL RENDERING

7780 ELMWOOD AVE. STE. 204 MIDDLETON, WI 53562 608-829-1750 608-829-3056 (FAX)





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PROJECT: DRAWN BY: TELAIA

DATE: SCALE:

AS NOTED LAND USE SUBMITTAL 11/20/2017

LAND USE RESUBMITTAL 1/03/2018

TITLE

BLOCK

DEVELOPER:

MADISON RIMROCK LODGING INVESTORS I, LLC. C/O NORTH CENTRAL GROUP

1600 ASPEN COMMONS, SUITE 200 MIDDLETON. WISCONSIN 53562 PHONE: (608) 662-3631

EMAIL: AINMAN@NCGHOTELS.COM

CONTACT: ANDY INMAN



STRUCTURAL ENGINEER:

STRATEGIC STRUCTURAL DESIGN, LLC.

725 HEARTLAND TRAIL SUITE 203 MADISON, WI 53711

PHONE: (608) 841-1850

CWHITTINGHILL@STRATEGICSTRUCTURAL.COM CONTACT: CHAD WHITTINGHILL, P.E., S.E., LEED AP



ARCHITECT:

GBA ARCHITECTURE & DESIGN

7780 ELMWOOD AVENUE, SUITE 204 MIDDLETON. WISCONSIN 53562 PHONE: (608) 829-1750

EMAIL: JOSH.WILCOX@GARYBRINK.COM

CONTACT: JOSH WILCOX


CIVIL ENGINEER / LANDSCAPE ARCHITECT

VIERBICHER


999 FOURIER DRIVE, SUITE 201 MADISON, WISCONSIN 53717 PHONE:

(608) 826-0532 ABAR@VIERBICHER.COM CONTACT: ANDREW BARNEBEY



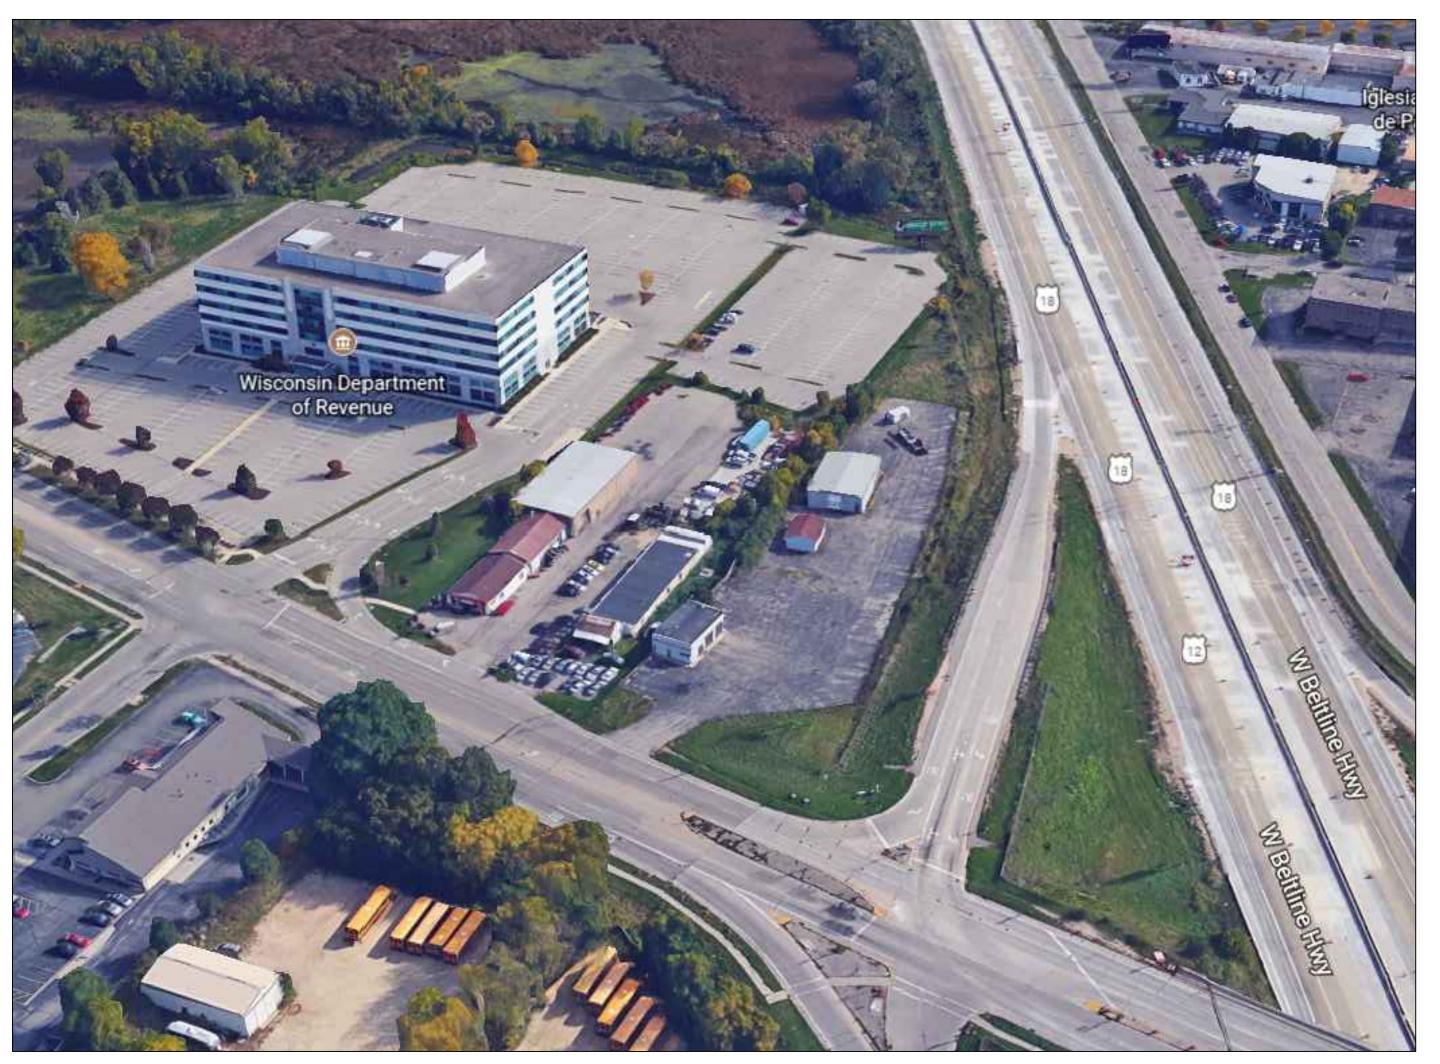


BIRD'S EYE LOOKING NORTHEAST

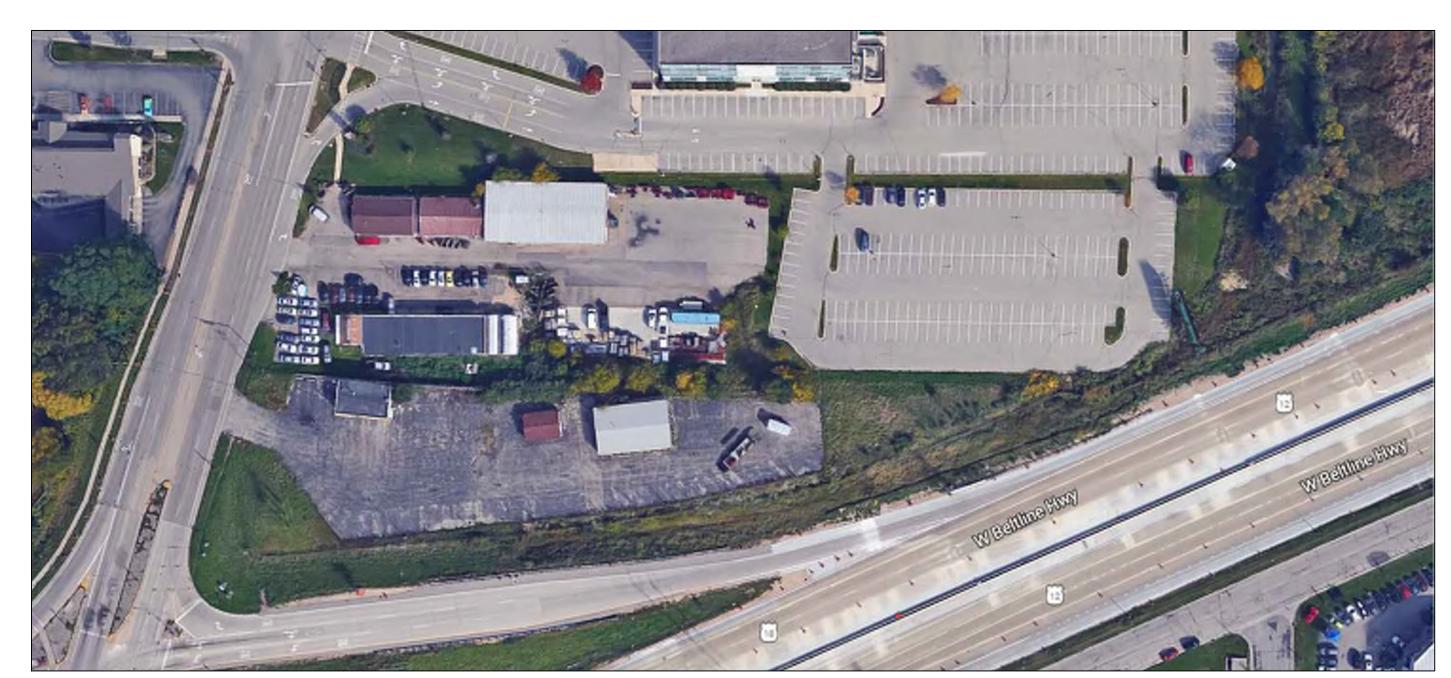


CLOSE AERIAL OF SITE



BIRD'S EYE LOOKING NORTHWEST

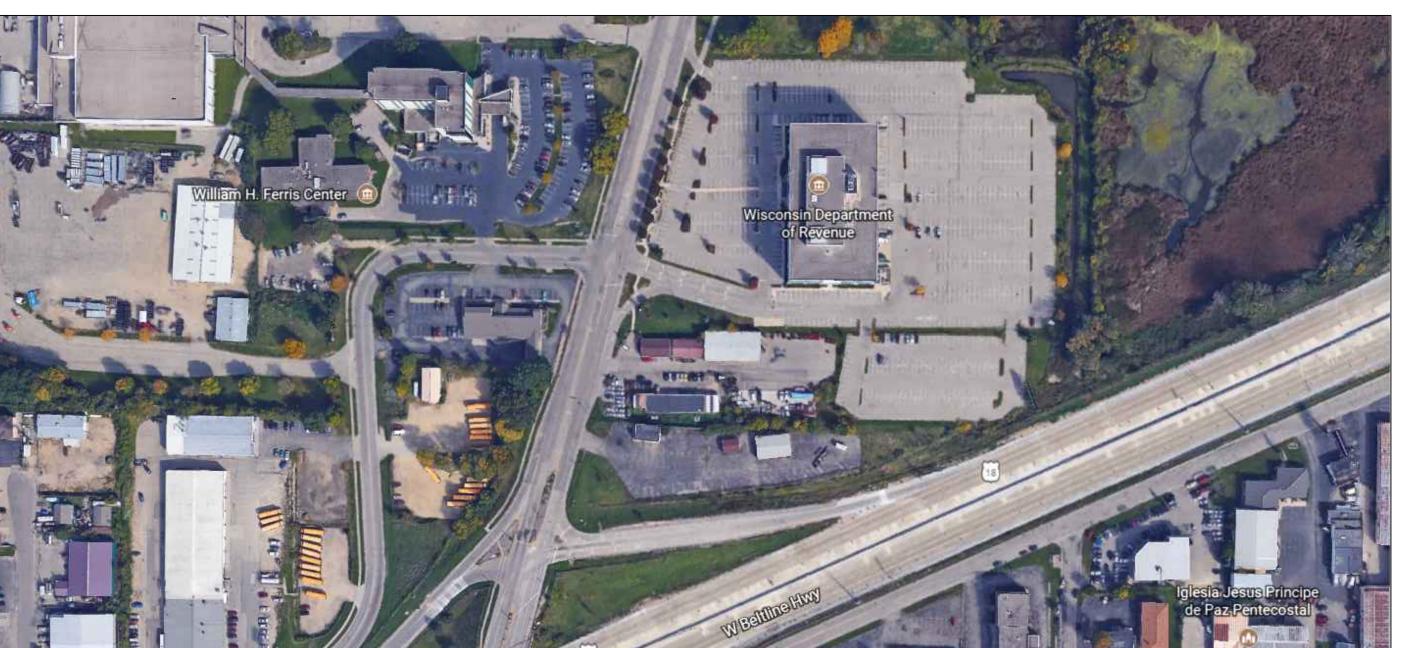

AERIAL OF CONTEXT

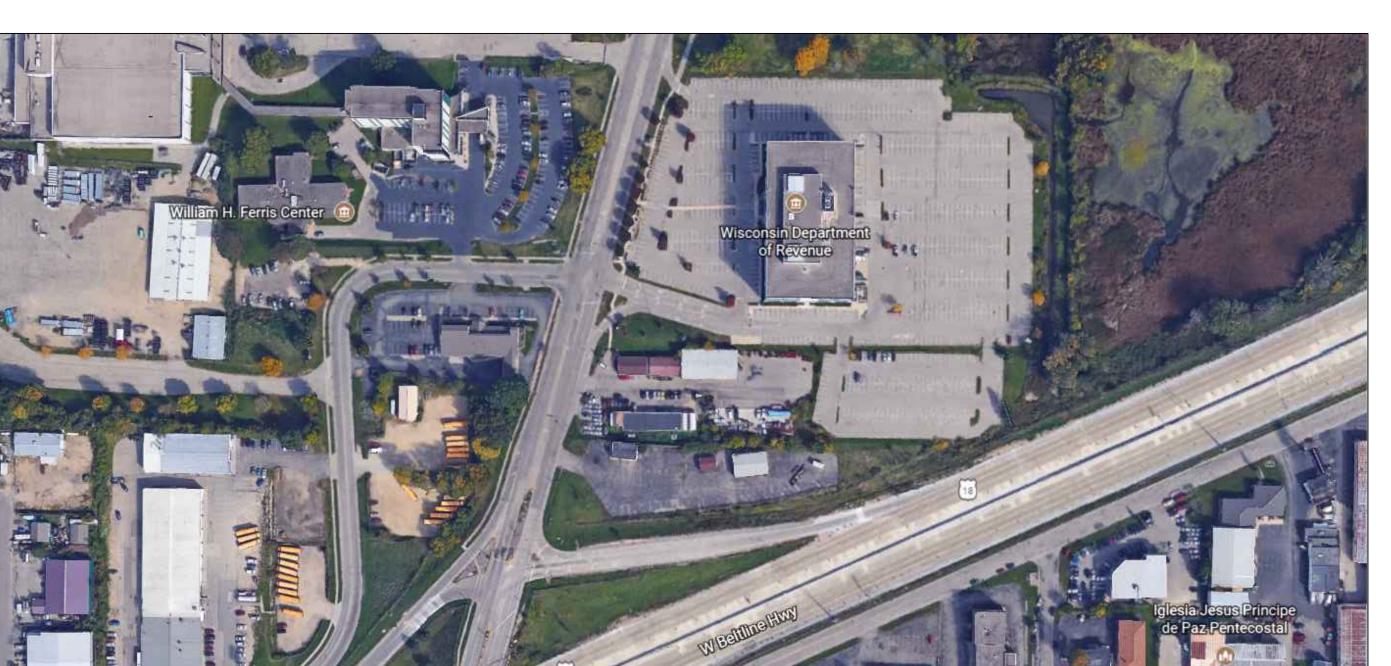

LAND USE SUBMITTAL 11/20/2017 LAND USE RESUBMITTAL 1/03/2018

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DRAWN BY: TELAIA

SCALE: AS NOTED

PROJECT:

DATE:

NORTHEAST CORNER LOOKING WEST



CENTER OF SITE ON NORTH SIDE LOOKING WEST



CENTER OF SITE LOOKING NORTHWEST



CENTER OF SITE LOOKING SOUTHWEST



CENTER OF SOUTH SIDE LOOKING WEST



NEAR SOUTHEAST CORNER OF SITE LOOKING EAST



CENTER OF SOUTH SIDE LOOKING NORTHEAST



SOUTHWEST CORNER LOOKING NORTHEAST



SOUTHWEST CORNER LOOKING NORTH



SOUTHWEST CORNER LOOKING NORTHEAST



CENTER OF WEST SIDE LOOKING SOUTHEAST



NEAR NORTHWEST CORNER LOOKING NORTHEAST



NEAR NORTHWEST CORNER LOOKING EAST



NORTHWEST CORNER LOOKING NORTH



NORTH OF NORTHWEST CORNER LOOKING SOUTH



NORTH OF NORTHWEST CORNER LOOKING EAST

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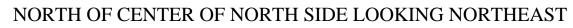
DATE: SCALE:

PROJECT:

DRAWN BY:

EXISTING SITE CONDITIONS







SOUTH SIDE OF SITE LOOKING EAST



NEAR CENTER OF SITE ON SOUTH SIDE LOOKING WEST



NEAR CENTER OF SITE ON SOUTH SIDE LOOKING NORTHEAST



PROJECT:
HOME 2 SUITES
2155 RIMROCK ROAD
MADISON, WISCONSIN 53713-1443
CLIENT:
MADISON RIMROCK LODGING IN
c/o NORTH CENTRAL GROUP
1600 ASPEN COMMONS, SUITE 200
MIDDLETON, WISCONSIN

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PROJECT: 201732 DRAWN BY: TELAIA DATE:

SCALE: AS NOTED LAND USE SUBMITTAL 11/20/2017

LAND USE RESUBMITTAL 12/01/2017 LAND USE RESUBMITTAL 1/03/2018


EXISTING SITE CONDITIONS



7780 ELMWOOD AVE. STE. 204 MIDDLETON, WI 53562 608-829-1750 608-829-3056 (FAX)





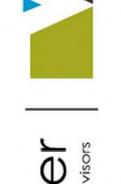

Vierbicher planners | engineers | advisors


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PROJECT: ABAR DRAWN BY: DATE:

SCALE: AS NOTED LAND USE SUBMITTAL 11/20/17

LAND USE RESUBMITTAL 1/3/18

ZONING PLAN

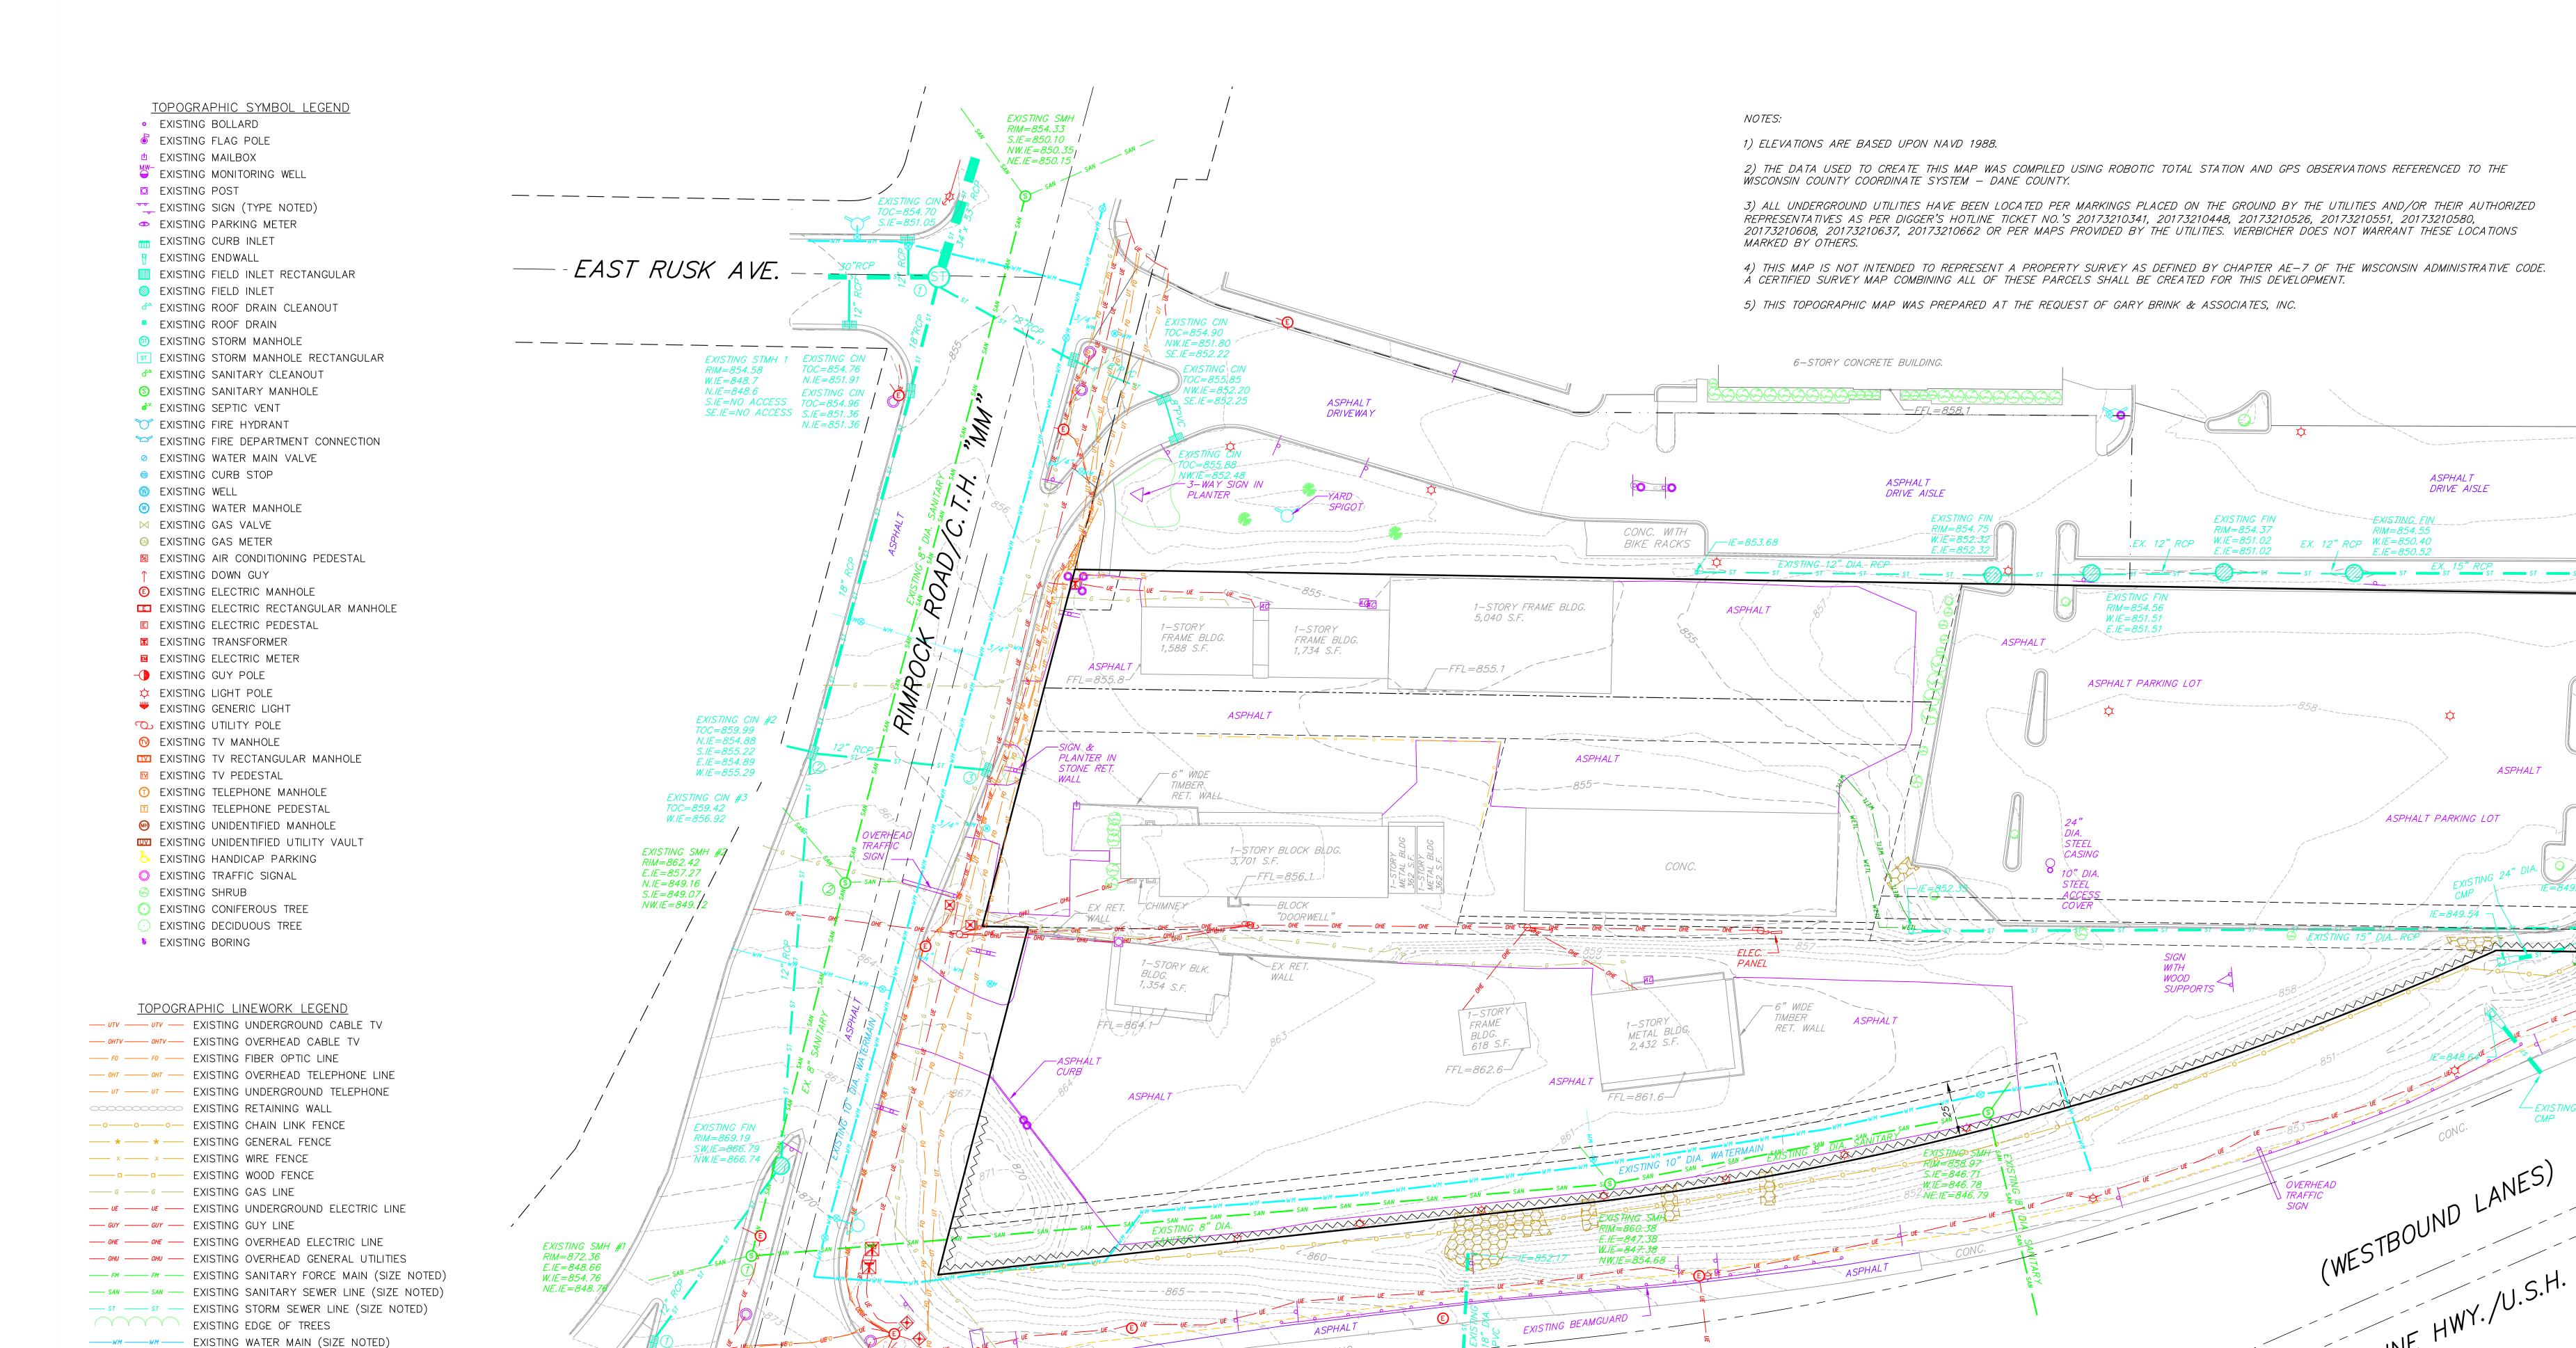

WEST BELTLINE HWY. RAMP

EXISTING MAJOR CONTOUR

EXISTING MINOR CONTOUR

EXISTING CIN # TOC=874.20 SW.IE=870.37 7780 ELMWOOD AVE. STE. 20
MIDDLETON, WI 53562
608-829-1750
608-829-1750





Vierbich planners | engineers | adv

HOME 2 SUITES
RIMROCK ROAD
MADISON, WISCONSIN
CLIENT:
NORTH CENTRAL GROUP
c/o XYZ
1600 ASPEN COMMONS, SUITE 200

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PROJECT: 201732

DRAWN BY: JGOL DATE:

SCALE: AS NOTED

LAND USE SUBMITTAL 11/20/17

LAND USE SUBMITTAL 11/20/17

LAND USE RESUBMITTAL 1/3/18

BATE-A

BATE

EXISTING CONDITIONS PLAN

-METAL STORAGE

DEMOLITION PLAN

DEMOLITION PLAN LEGEND

CONCRETE REMOVAL

BUILDING REMOVAL

UTILITY STRUCTURE REMOVAL

www.DiggersHotline.com

2. CLEAR AND GRUB EXISTING TREE/BRUSH. FILL WETLAND. CONFIRM WETLAND FILL PERMIT IS ÁPPROVED BEFORE

OVERHEAD POWER AND UTILITY LINES/POLES AND ELECTRIC

PANEL WITH MG&E, AT&T AND CHARTER COMMUNICATIONS.

4. REMOVE EXISTING CURB & GUTTER. REPLACE IF SHOWN

APPURTENANCES INCLUDING BUT NOT LIMITED TO BUILDINGS,

SLABS, PORCHES, DECKS AND LANDSCAPING (SEE DEMOLITION

7. ABANDON EXISTING GAS LINE/METER. COORDINATE WITH

9. REMOVE EXISTING PAVEMENT (SEE DEMOLITION LEGEND.)

11. REMOVE EXISTING STORM SEWER AND ENDWALLS.

10. REMOVE EXISTING SITE LIGHTING, CONCRETE BASES AND UNDERGROUND LINES. COORDINATE REMOVAL WITH MG&E,

8. REMOVE EXISTING PLANTER, FENCE, GUARD RAIL, RETAINING

3. COORDINATE THE REMOVAL/BURY OF THE EXISTING

5. REMOVE EXISTING CONCRETE SIDEWALK/PAD (SEE

6. REMOVE EXISTING BUILDINGS AND ALL THEIR

TREE REMOVAL

<u>x—x—x</u> curb and gutter removal

ASPHALT REMOVAL

— — — SAWCUT

DEMOLITION KEY:

BEGINNING WORK.

(SEE DEMOLITION LEGEND).

LOCAL GAS UTILITY COMPANY.

AT&T AND CHARTER COMMUNICATIONS

WALLS AND BOLLARDS.

DEMOLITION LEGEND).

LEGEND).

1. REMOVE EXISTING SIGNS AND BASES.

DEMOLITION/EROSION CONTROL NOTES:

1. ALL APPLICABLE EROSION CONTROL MEASEURES SHALL BE INSTALLED BEFORE BEGINNING DEMOLITION.

0' 15' 30' 60' 90

2. CONTRACTOR SHALL KEEP ALL CITY STREETS FREE AND CLEAR OF CONSTRUCTION RELATED DIRT/DUST/DEBRIS.



7780 ELMWOOD AVE. STE. 204 MIDDLETON, WI 53562 608-829-1750 608-829-3056 (FAX)



METAL STORAGE


NOT FOR CONSTRUCTION

RELOCATE SIGN (TYP.)

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DATE: SCALE: AS NOTED LAND USE SUBMITTAL 11/20/17 LAND USE RESUBMITTAL 1/3/18

DEMOLITION

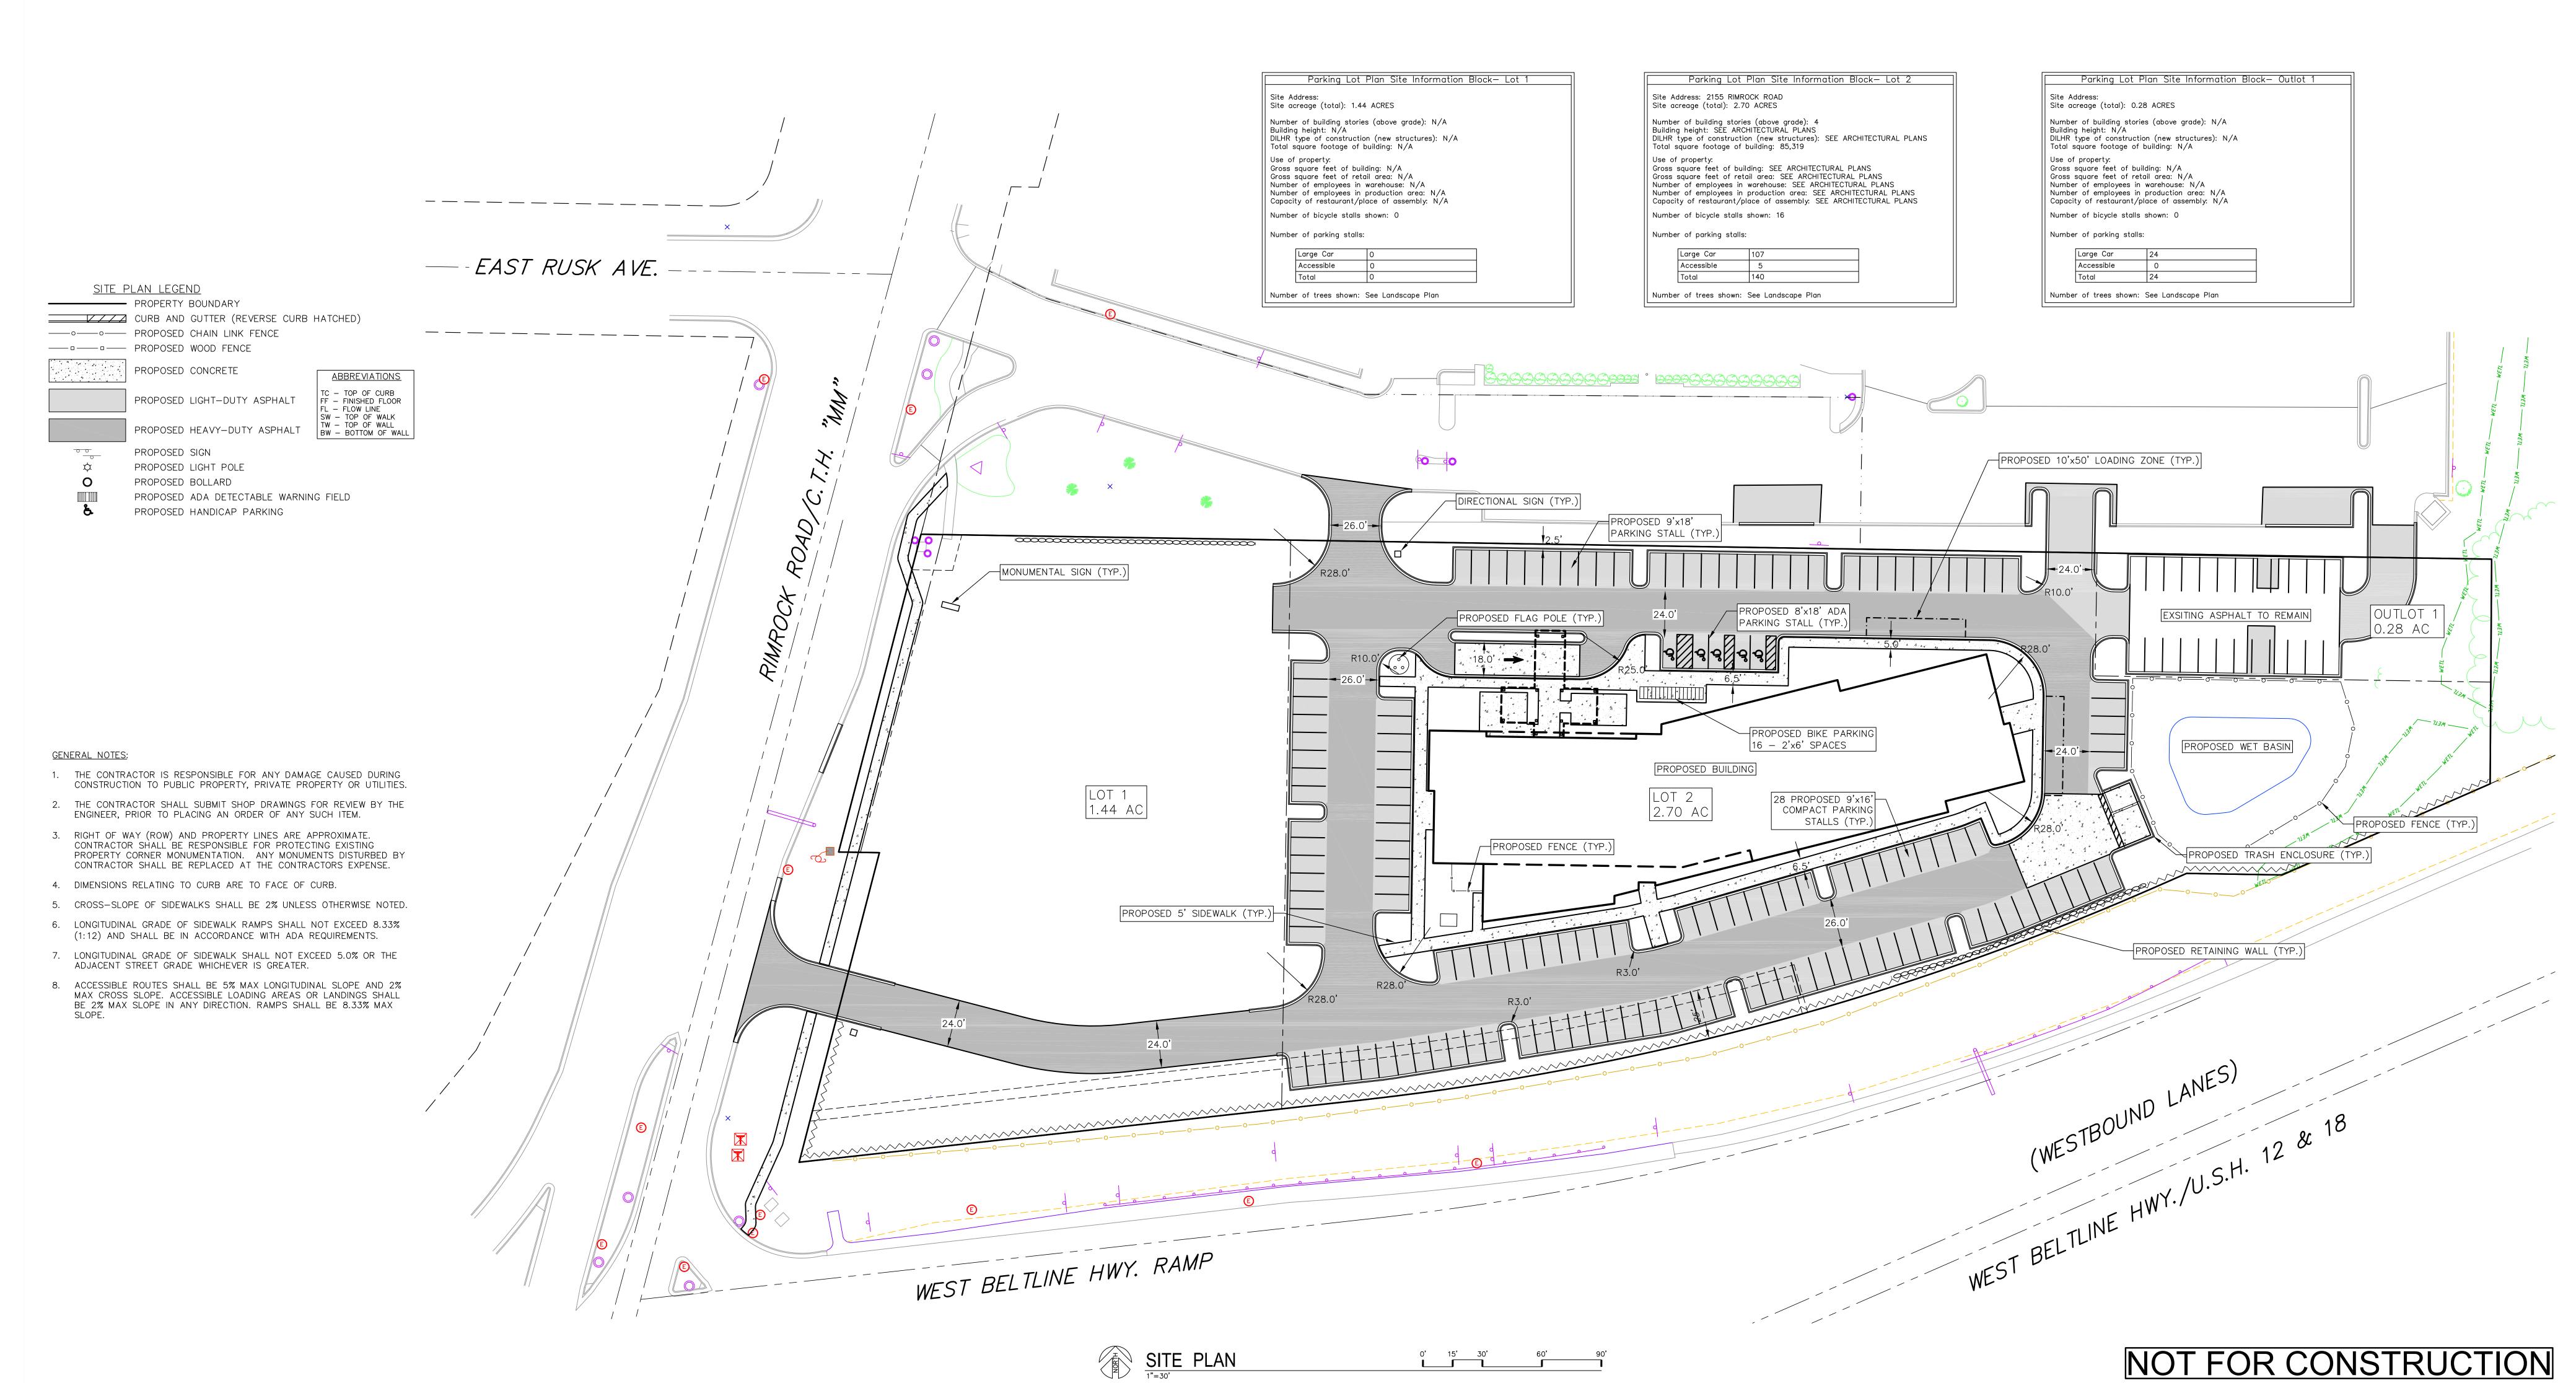

7780 ELMWOOD AVE. STE. 204


MIDDLETON, WI 53562 608-829-1750 608-829-3056 (FAX)



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PROJECT: DRAWN BY: SCALE: AS NOTED


LAND USE SUBMITTAL 11/20/17 LAND USE RESUBMITTAL 1/3/18

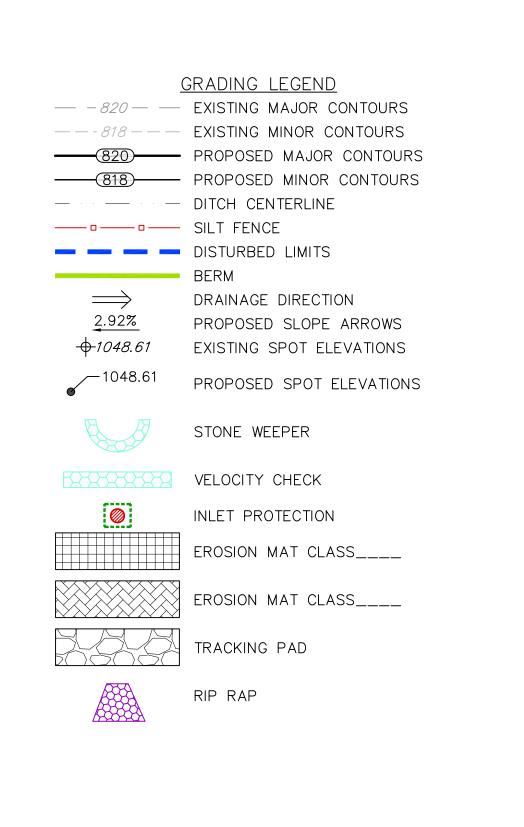

GRADING NOTES:

1. CONTOURS ARE SHOWN FOR PURPOSES OF INDICATING ROUGH GRADING. FINAL GRADE SHALL BE ESTABLISHED ON PAVED SURFACES BY USING SPOT GRADES ONLY.

2. SEE DETAIL SHEETS FOR EROSION CONTROL NOTES AND CONSTRUCTION SEQUENCE.

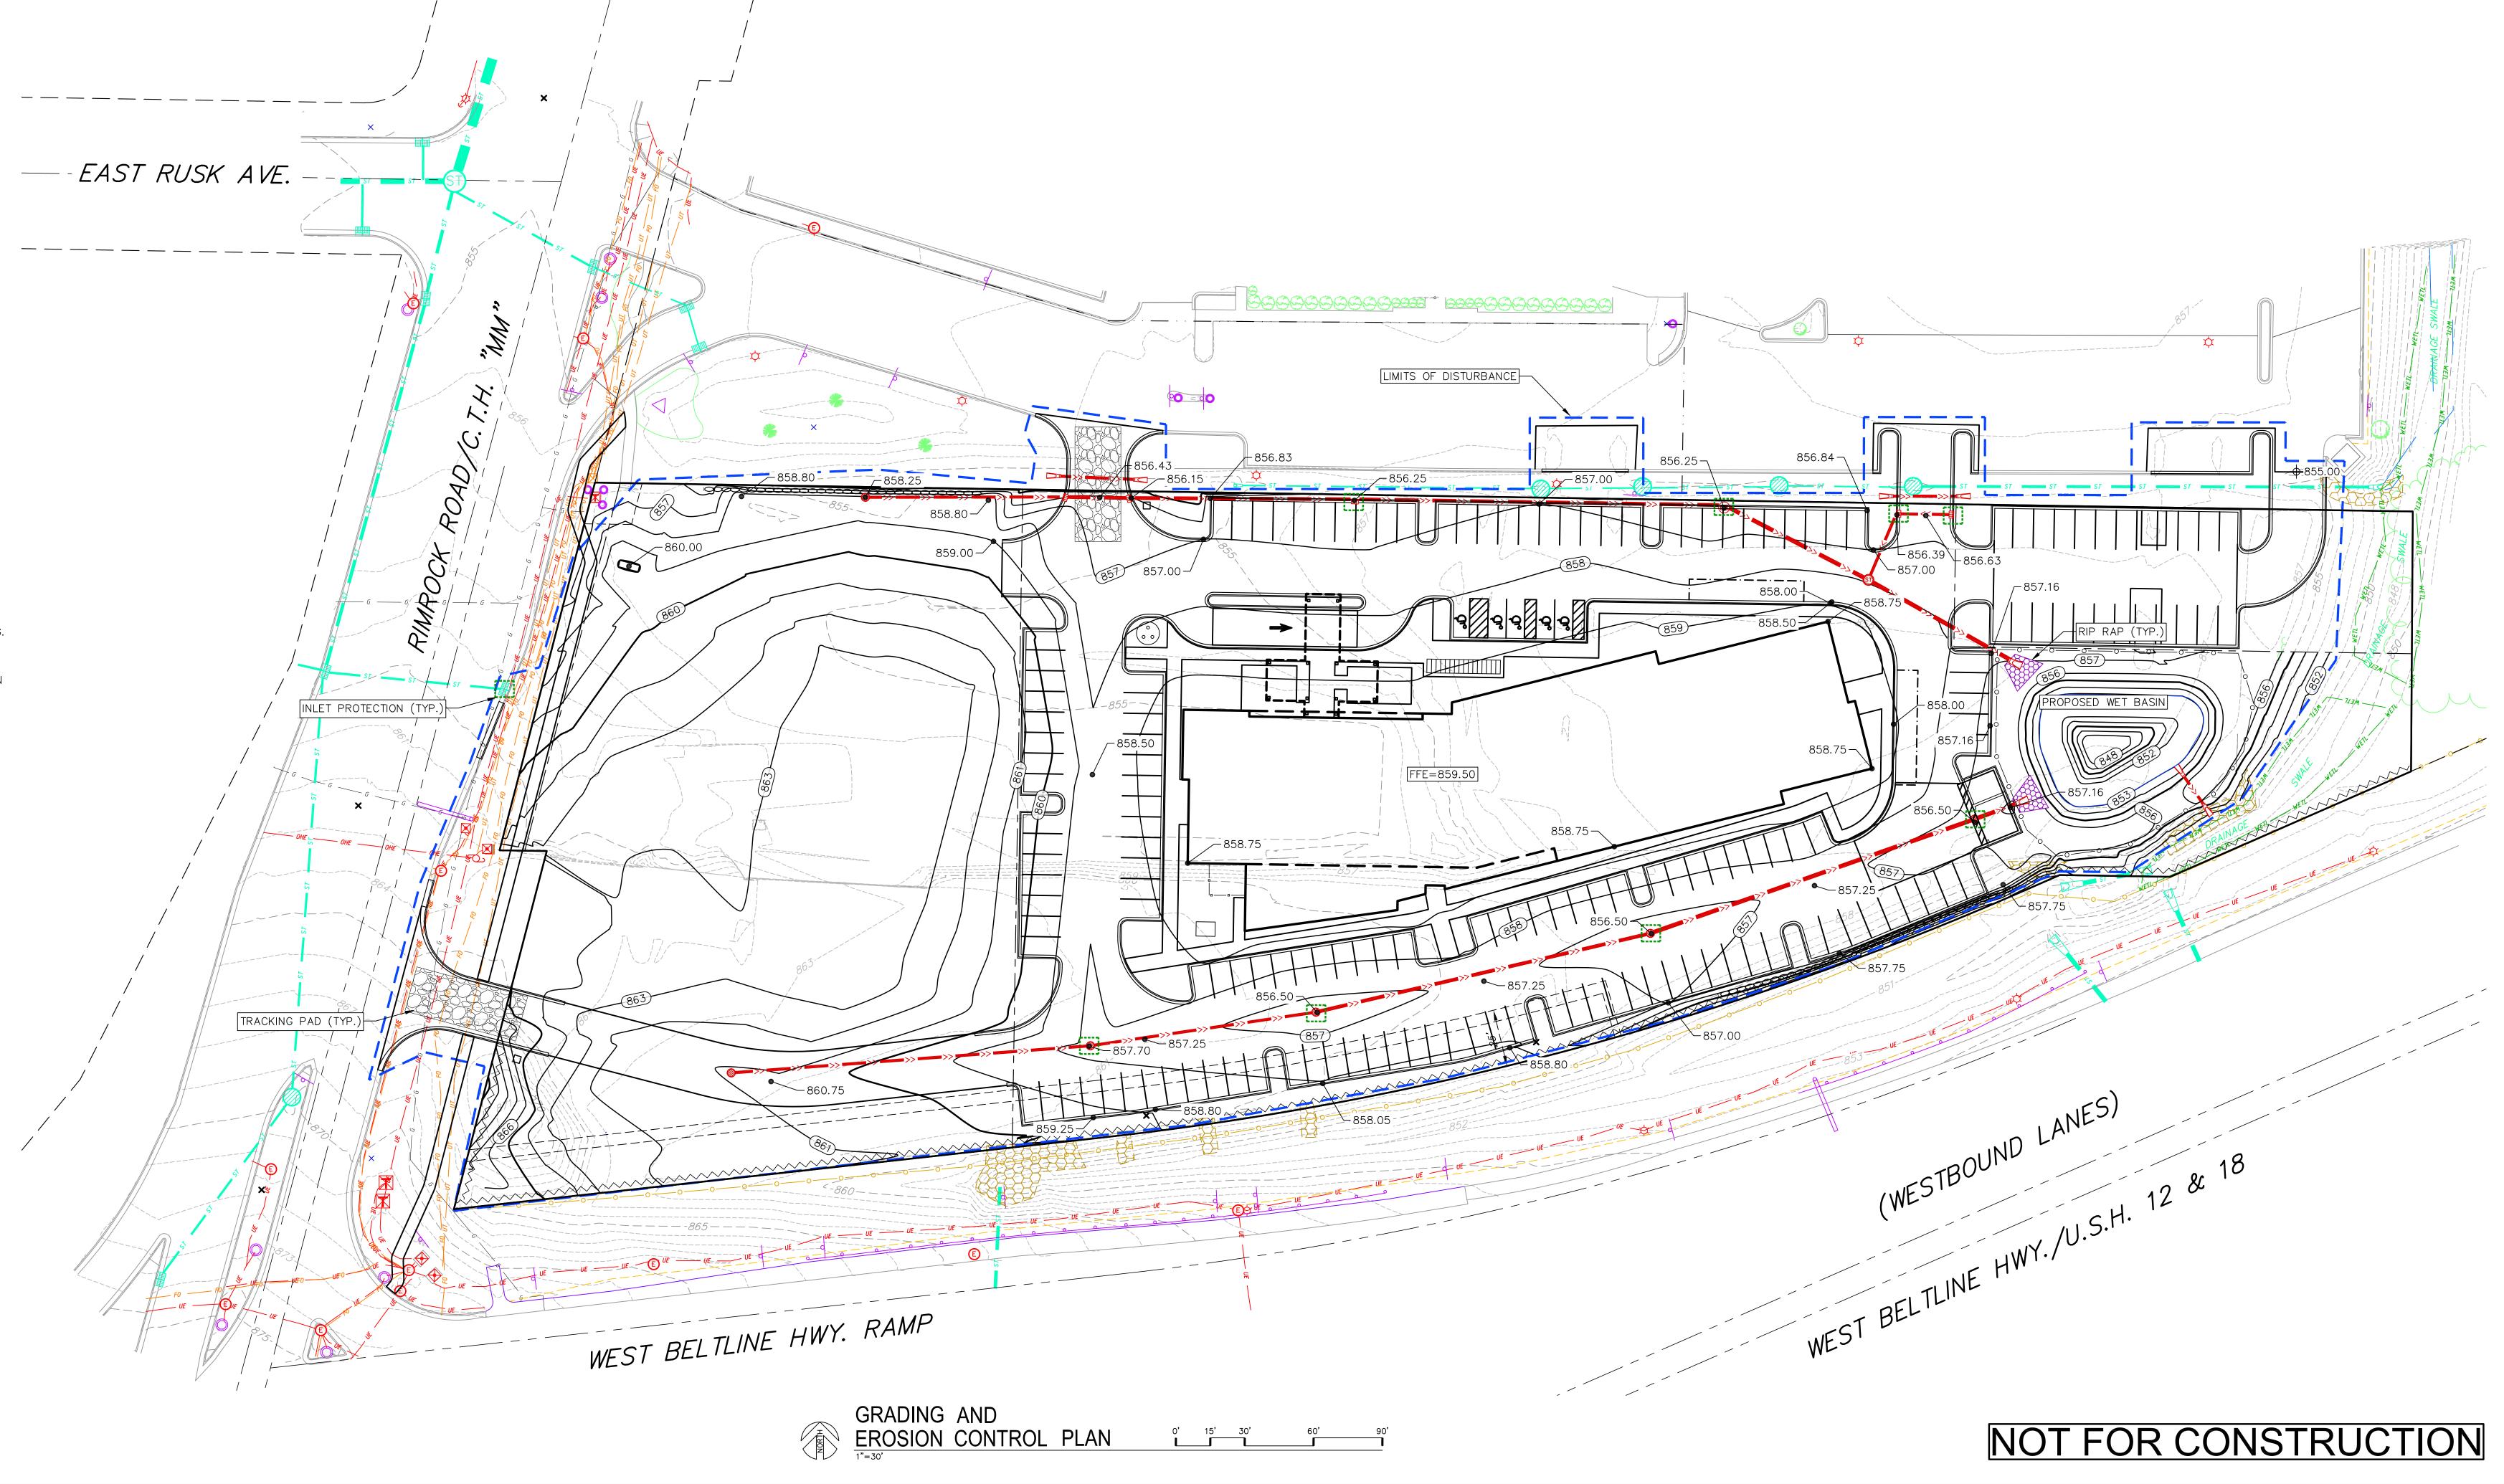





ierbichers | advisors

HOME 2 SUITES
RIMROCK ROAD
MADISON, WISCONSIN
CLIENT:
NORTH CENTRAL GROUP
C/O XYZ

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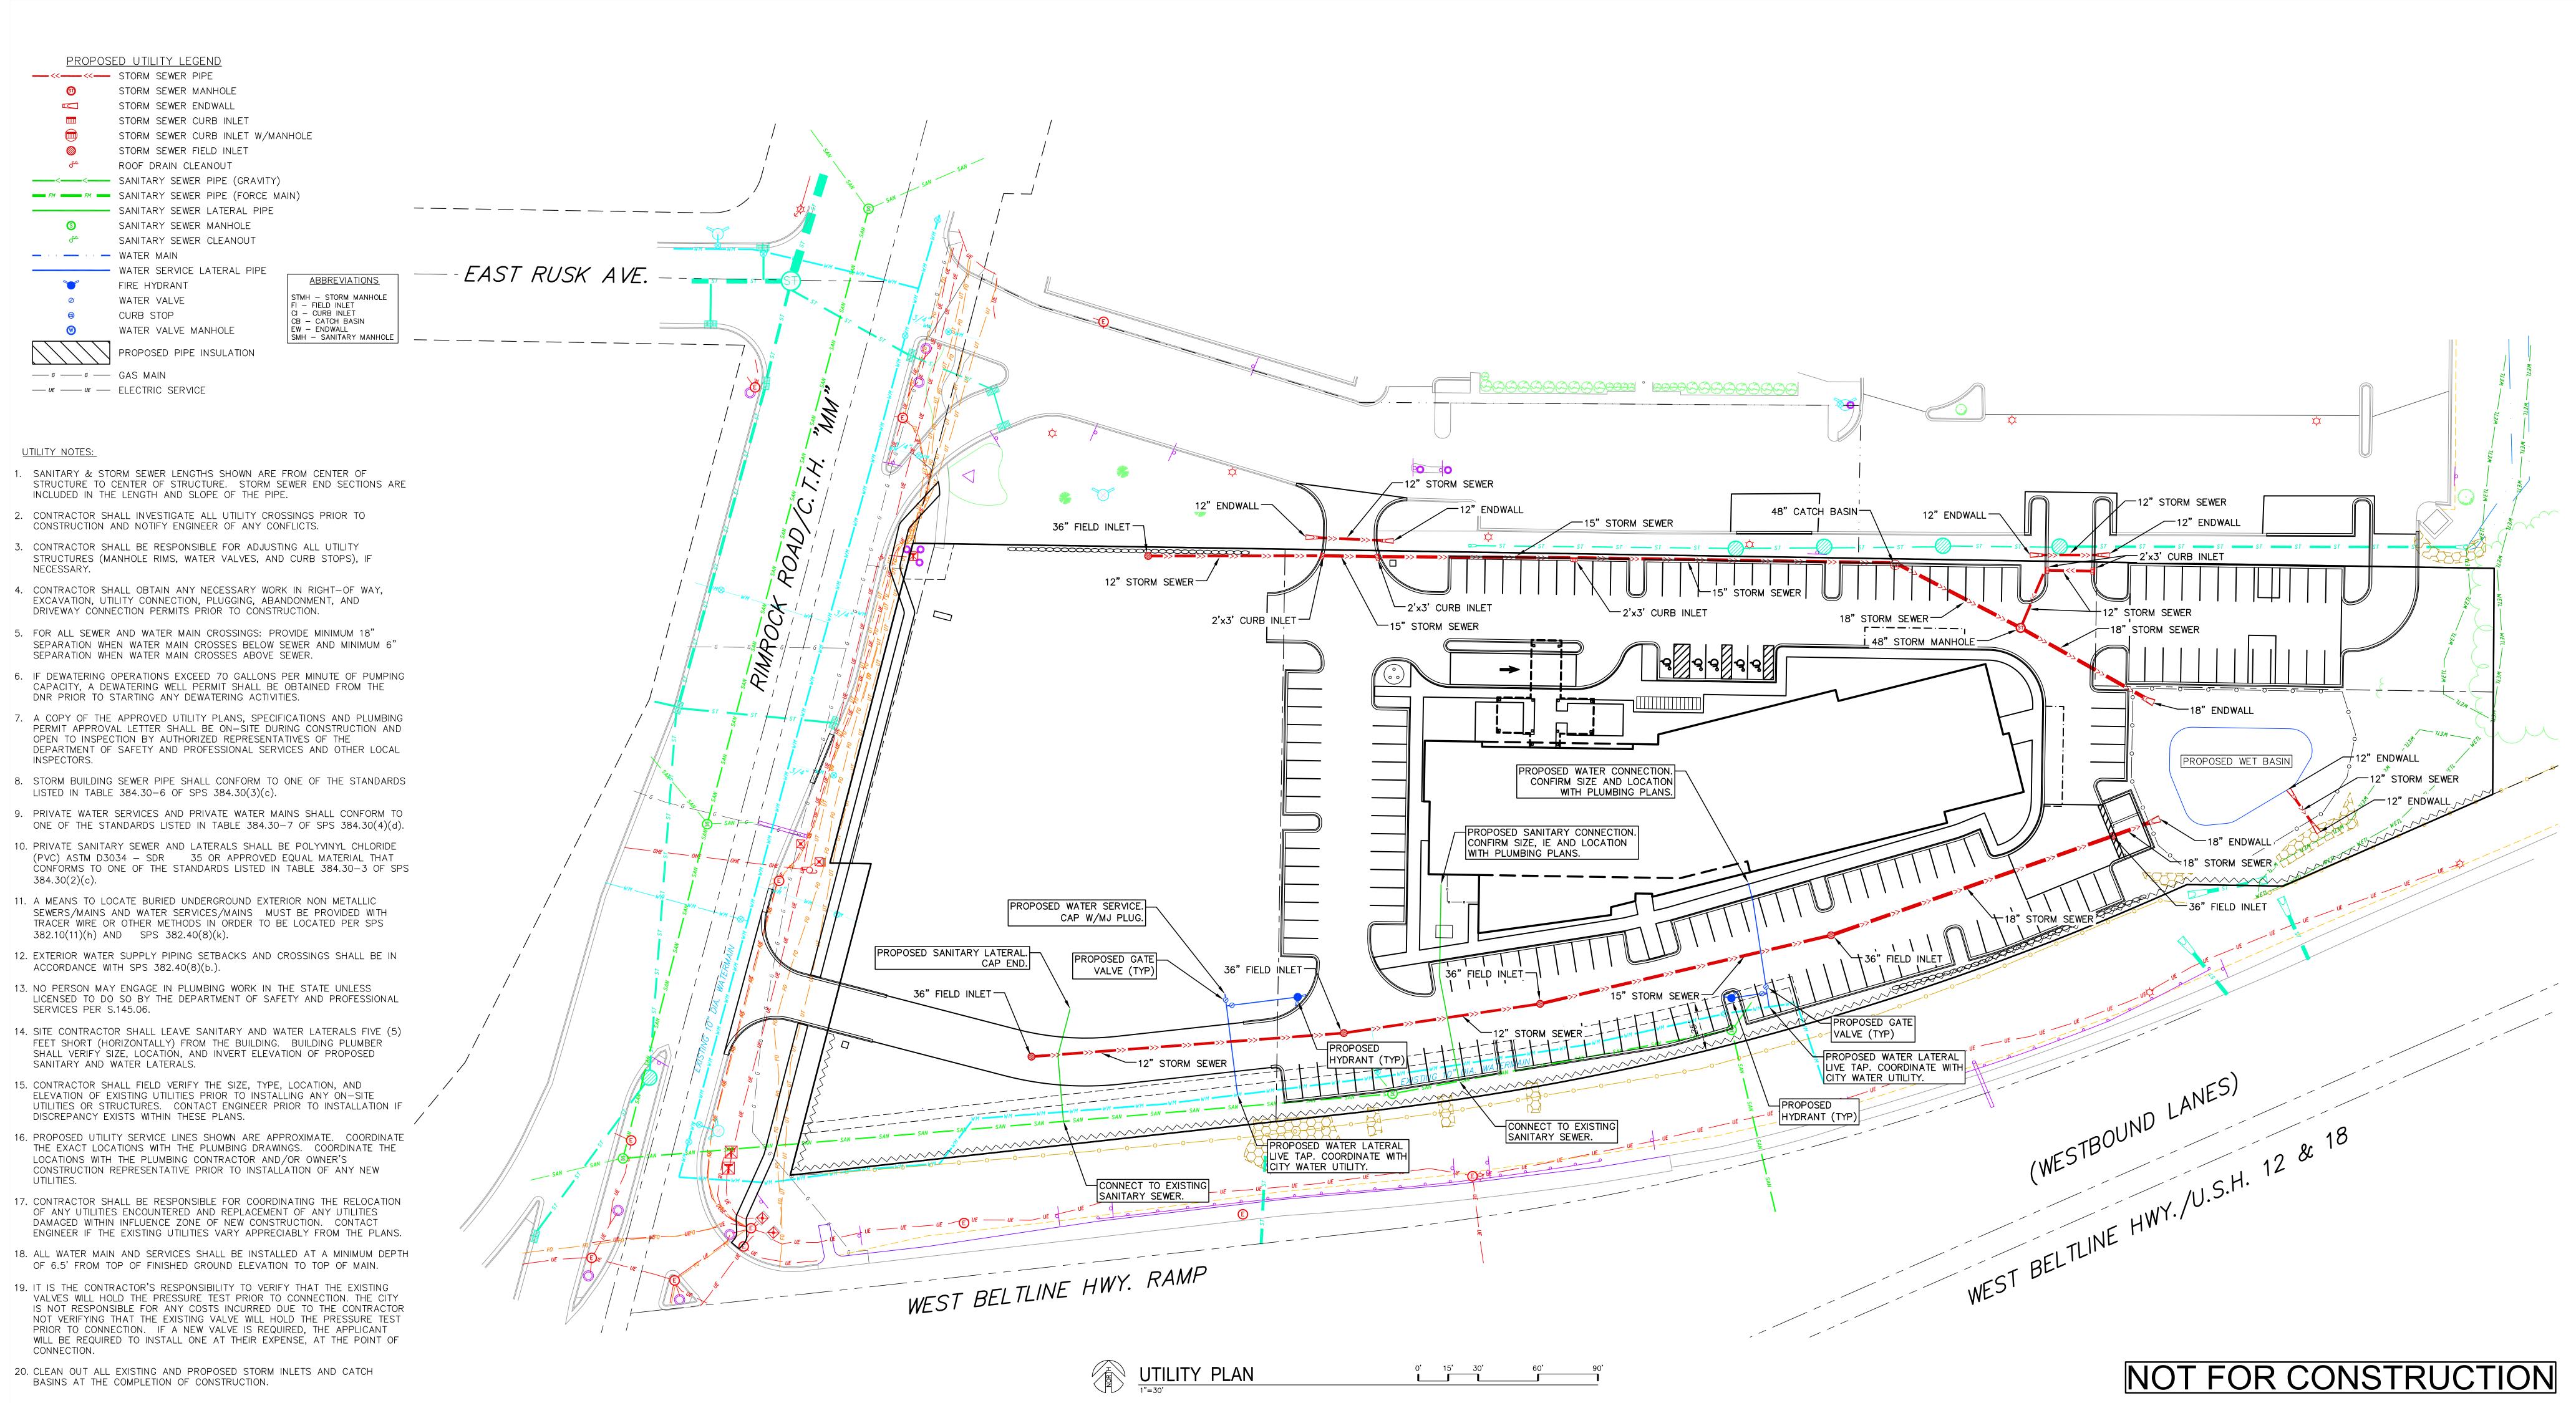
PROJECT: 201732

DRAWN BY: JGOL


DRAWN BY: JGOL
DATE:
SCALE: AS NOTED
LAND USE SUBMITTAL 11/20/17

LAND USE RESUBMITTAL 1/3/18

GRADING AND
EROSION CONTROL
PLAN



7780 ELMWOOD AVE. STE. 204 MIDDLETON, WI 53562

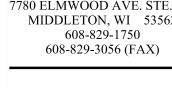



erbich

HOME RIMROCK RO/ MADISON, WIS CLIENT: NORTH c/o XYZ 1600 ASPEN O

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PROJECT: DRAWN BY: SCALE: AS NOTED

LAND USE SUBMITTAL 11/20/17

LAND USE RESUBMITTAL 1/3/18

UTILITY

PLAN C104

EROSION CONTROL MEASURES

EROSION CONTROL SHALL BE IN ACCORDANCE WITH THE CITY OF MADISON EROSION CONTROL ORDINANCE AND CHAPTER NR 216 OF THE WISCONSIN ADMINISTRATIVE CODE.

2. CONSTRUCT AND MAINTAIN ALL EROSION AND SEDIMENT CONTROL MEASURES IN ACCORDANCE WITH WISCONSIN DNR TECHNICAL STANDARDS (http://dnr.wi.gov/runoff/stormwater/techstds.htm) AND WISCONSIN CONSTRUCTION SITE BEST MANAGEMENT PRACTICE HANDBOOK.

3. INSTALL SEDIMENT CONTROL PRACTICES (TRACKING PAD, PERIMETER SILT FENCE, SEDIMENT BASINS, ETC.) PRIOR TO INITIATING OTHER LAND DISTURBING CONSTRUCTION ACTIVITIES.

4. THE CONTRACTOR IS REQUIRED TO MAKE EROSION CONTROL INSPECTIONS AT THE END OF EACH WEEK AND WHEN 0.5 INCHES OF RAIN FALLS WITHIN 24 HOURS. INSPECTION REPORTS SHALL BE PREPARED AND FILED AS REQUIRED BY THE DNR AND/OR CITY. ALL MAINTENANCE WILL FOLLOW AN INSPECTION WITHIN 24 HOURS.

5. EROSION CONTROL IS THE RESPONSIBILITY OF THE CONTRACTOR UNTIL ACCEPTANCE OF THIS PROJECT. EROSION CONTROL MEASURES AS SHOWN SHALL BE THE MINIMUM PRECAUTIONS THAT WILL BE ALLOWED. ADDITIONAL EROSION CONTROL MEASURES, AS REQUESTED IN WRITING BY THE STATE OR LOCAL INSPECTORS, OR THE DEVELOPER'S ENGINEER, SHALL BE INSTALLED WITHIN 24 HOURS.

6. A 3" CLEAR STONE TRACKING PAD SHALL BE INSTALLED AT THE END OF ROAD CONSTRUCTION LIMITS TO PREVENT SEDIMENT FROM BEING TRACKED ONTO 9. INSTALL INLET PROTECTION THE ADJACENT PAVED PUBLIC ROADWAY. SEDIMENT TRACKING PAD SHALL CONFORM TO WISDNR TECHNICAL STANDARD 1057. SEDIMENT REACHING THE PUBLIC ROAD SHALL BE REMOVED BY STREET CLEANING (NOT HYDRAULIC FLUSHING) BEFORE THE END OF EACH WORK DAY.

7. CHANNELIZED RUNOFF: FROM ADJACENT AREAS PASSING THROUGH THE SITE SHALL BE DIVERTED AROUND DISTURBED AREAS.

8. STABILIZED DISTURBED GROUND: ANY SOIL OR DIRT PILES WHICH WILL REMAIN IN EXISTENCE FOR MORE THAN 7-CONSECUTIVE DAYS, WHETHER TO BE WORKED DURING THAT PERIOD OR NOT, SHALL NOT BE LOCATED WITHIN 25-FEET OF ANY ROADWAY, PARKING LOT, PAVED AREA, OR DRAINAGE STRUCTURE OR CHANNEL (UNLESS INTENDED TO BE USED AS PART OF THE EROSION CONTROL MEASURES). TEMPORARY STABILIZATION AND CONTROL MEASURES (SEEDING, MULCHING, TARPING, EROSION MATTING, BARRIER FENCING, ETC.) ARE REQUIRED FOR THE PROTECTION OF DISTURBED AREAS AND SOIL PILES, WHICH WILL REMAIN UN-WORKED FOR A PERIOD OF MORE THAN 14-CONSECUTIVE CALENDAR DAYS. THESE MEASURES SHALL REMAIN IN PLACE UNTIL SITE HAS STABILIZED.

9. <u>SITE DE-WATERING:</u> WATER PUMPED FROM THE SITE SHALL BE TREATED BY TEMPORARY SEDIMENTATION BASINS OR OTHER APPROPRIATE CONTROL MEASURES. SEDIMENTATION BASINS SHALL HAVE A DEPTH OF AT LEAST 3 FEET, BE SURROUNDED BY SNOWFENCE OR EQUIVALENT BARRIER AND HAVE SUFFICIENT SURFACE AREA TO PROVIDE A SURFACE SETTLING RATE OF NO MORE THAN 750 GALLONS PER SQUARE FOOT PER DAY AT THE HIGHEST DEWATERING PUMPING RATE. WATER MAY NOT BE DISCHARGED IN A MANNER THAT CAUSES EROSION OF THE SITE, A NEIGHBORING SITE, OR THE BED OR BANKS OF THE RECEIVING WATER. POLYMERS MAY BE USED AS DIRECTED BY DNR TECHNICAL STANDARD 1061 (DE-WATERING).

10. WASHED STONE WEEPERS OR TEMPORARY EARTH BERMS SHALL BE BUILT PER PLAN BY CONTRACTOR TO TRAP SEDIMENT OR SLOW THE VELOCITY OF STORM WATER.

11. SEE DETAIL SHEETS FOR RIP-RAP SIZING. IN NO CASE WILL RIP-RAP BE SMALLER THAN 3" TO 6".

RESTORED IMMEDIATELY AFTER ROUGH GRADING, TEMPORARY SEED SHALL BE PLACED.

SEEDED AND MULCHED WITHIN 48 HOURS OF PLACING TOPSOIL.

NOTE: CONSTRUCTION SHALL

STANDARD DETAIL DRAWINGS

THAT ARE CURRENT AT THE

TIME OF CONSTRUCTION.

CONFORM TO CITY OF MADISON

12. INLET FILTERS ARE TO BE PLACED IN STORMWATER INLET STRUCTURES AS SOON AS THEY ARE INSTALLED. ALL PROJECT AREA STORM INLETS NEED WISCONSIN D.O.T. TYPE D INLET PROTECTION. THE FILTERS SHALL BE MAINTAINED UNTIL THE CITY HAS ACCEPTED THE BINDER COURSE OF ASPHALT.

13. USE DETENTION BASINS AS SEDIMENT BASINS DURING CONSTRUCTION. AT THE END OF CONSTRUCTION, REMOVE SEDIMENT AND RESTORE PER PLAN

14. RESTORATION (SEED, FERTILIZE AND MULCH) SHALL BE PER SPECIFICATIONS ON THIS SHEET (NOTE: ADD SEEDING RATE STANDARD OF DETAIL BLOCK

15. TERRACES SHALL BE RESTORED WITH 6" TOPSOIL, PERMANENT SEED, FERTILIZER AND MULCH. OTHER AREAS SHALL BE RESTORED WITH 6" TOPSOIL TEMPORARY SEED, FERTILIZER AND MULCH.

16. SEED, FERTILIZER AND MULCH SHALL BE APPLIED WITHIN 7 DAYS AFTER FINAL GRADE HAS BEEN ESTABLISHED. IF DISTURBED AREAS WILL NOT BE

17. FOR THE FIRST SIX WEEKS AFTER RESTORATION (E.G. SEED & MULCH, EROSION MAT, SOD) OF A DISTURBED AREA, INCLUDE SUMMER WATERING

PROVISIONS OF ALL NEWLY SEEDED AND MULCHED AREAS WHENEVER 7 DAYS ELAPSE WITHOUT A RAIN EVENT. 18. EROSION MAT (CLASS I, TYPE A URBAN PER WISCONSIN D.O.T. P.A.L.) SHALL BE INSTALLED ON ALL SLOPES 3:1 OR GREATER BUT LESS THAN 1:1.

19. EROSION MAT (CLASS I, TYPE B URBAN PER WISCONSIN D.O.T. P.A.L.) SHALL BE INSTALLED ON THE BOTTOM (INVERT) OF ROADSIDE DITCHES/SWALES AS

SHOWN ON THIS PLAN, 1 ROLL WIDTH.

20. SOIL STABILIZERS SHALL BE APPLIED TO DISTURBED AREAS WITH SLOPES BETWEEN 10% AND 3:1 (DO NOT USE IN CHANNELS). SOIL STABILIZERS SHALL BE TYPE B, PER WISCONSIN D.O.T. P.A.L. (PRODUCT ACCEPTABILITY LIST), OR EQUAL. APPLY AT RATES AND METHODS SPECIFIED PER MANUFACTURER. SOIL STABILIZERS SHALL BE RE-APPLIED WHENEVER VEHICLES OR OTHER EQUIPMENT TRACK ON THE AREA.

21. SILT FENCE OR EROSION MAT SHALL BE INSTALLED ALONG THE CONTOURS AT 100 FOOT INTERVALS DOWN THE SLOPE ON THE DISTURBED SLOPES STEEPER THAN 5% AND MORE THAN 100 FEET LONG THAT SHEET FLOW TO THE ROADWAY UNLESS SOIL STABILIZERS ARE USED.

22. INSTALL MINIMUM 6'-7' WIDE EROSION MAT ALONG THE BACK OF CURB AFTER TOPSOIL HAS BEEN PLACED IN THE TERRACE IF THIS AREA WILL NOT BE

23. SILT FENCE TO BE USED ACROSS AREAS OF THE LOT THAT SLOPE TOWARDS A PUBLIC STREET OR WATERWAY. SEE DETAILS.

24. SEDIMENT SHALL BE CLEANED FROM CURB AND GUTTER AFTER EACH RAINFALL AND PRIOR TO PROJECT ACCEPTANCE.

PLAN) UNLESS SPECIAL RESTORATION IS CALLED FOR ON THE LANDSCAPE PLAN OR THE DETENTION BASIN DETAIL SHEET.

25. ACCUMULATED CONSTRUCTION SEDIMENT SHALL BE REMOVED FROM ALL PERMANENT BASINS TO THE ELEVATION SHOWN ON THE GRADING PLAN FOLLOWING THE STABILIZATION OF DRAINAGE AREAS.

26. ALL CONSTRUCTION ENTRANCES SHALL HAVE TEMPORARY ROAD CLOSED SIGNS THAT WILL BE IN PLACE WHEN THE ENTRANCE IS NOT IN USE AND AT

THE END OF EACH DAY.

27. ANY PROPOSED CHANGES TO THE EROSION CONTROL PLAN MUST BE SUBMITTED AND APPROVED BY DANE COUNTY LAND CONSERVATION OR PERMITTING MUNICIPALITY.

28. THE CITY, OWNER AND/OR ENGINEER MAY REQUIRE ADDITIONAL EROSION CONTROL MEASURES AT ANY TIME DURING CONSTRUCTION.

CONSTRUCTION SEQUENCE:

1. INSTALL SILT FENCE AND TRACKING PAD

2. STRIP TOPSOIL-DETENTION BASINS

3. ROUGH GRADE DETENTION BASINS

4. SEED DETENTION BASINS

5. STRIP TOPSOIL—STREETS & LOTS.

DRIVE-OVER VELOCITY CHECKS

6. ROUGH GRADE STREETS & LOTS

7. SEED LOT AREAS AND INSTALL

8. CONSTRUCT UNDERGROUND UTILITIES

10. CONSTRUCT ROADS (STONE BASE, CURB & GUTTER, AND SIDEWALK). REMOVE DRIVE-OVER VELOCITY CHECKS WHEN BASE

11. RESTORE TERRACES

COURSE IS PLACED

12. REMOVE TRACKING PAD, SILT FENCE AND DIVERSION BERM MEASURES AFTER DISTURBED AREAS ARE RESTORED

SEEDING RATES:

1. USE ANNUAL OATS AT 3.0 LB./1,000 S.F. FOR SPRING AND SUMMER PLANTINGS. 2. USE WINTER WHEAT OR RYE AT 3.0 LB./1,000 SF FOR FALL PLANTINGS STARTED AFTER SEPTEMBER 15.

1. USE WISCONSIN D.O.T. SEED MIX #40 AT 2 LB./1,000 S.F.

FERTILIZING RATES:

TEMPORARY AND PERMANENT

USE WISCONSIN D.O.T. TYPE A OR B AT 7 LB./1,000 S.F.

MULCHING RATES:

<u>TEMPORARY AND PERMANENT:</u> USE ½" TO 1-½" STRAW OR HAY MULCH, CRIMPED PER

SECTION 607.3.2.3, OR OTHER RATE AND METHOD PER SECTION 627, WISCONSIN D.O.T. STANDARD SPECIFICATIONS FOR HIGHWAY AND STRUCTURE CONSTRUCTION

1. FOLLOW WISCONSIN DNR TECHNICAL STANDARD 1057 FOR FURTHER DETAILS AND INSTALLATION.

50' MINIMUM LENGTH—

MINIMUM 12" DEEP

PAD OF 3" CLEAR

STONE OVER FULL

OF STRUCTURE

LENGTH AND WIDTH

PROFILE VIEW

-50' MINIMUM LENGTH-

TRACKING

PAD

2. LENGTH - MINIMUM OF 50'.

- EXISTING GROUND

3. WIDTH — 24' MINIMUM, SHOULD BE FLARED AT THE EXISTING ROAD TO PROVIDE A TURNING RADIUS.

PLAN VIEW

4. ON SITES WITH A HIGH GROUND WATER TABLE OR WHERE SATURATED CONDITIONS EXIST, GEOTEXTILE FABRIC SHALL BE PLACED OVER EXISTING GROUND PRIOR TO PLACING STONE. FABRIC SHALL BE WISDOT TYPE-HR GEOTEXTILE FABRIC.

— MOUNTABLE BERM

6" MIN. HEIGHT

(OPTIONAL)

- EXISTING

— EARTH FILL

PIPE AS NECESSARY

SEE NOTE 6


PAVEMENT

5. STONE — CRUSHED 3" CLEAR STONE SHALL BE PLACED AT LEAST 12" DEEP OVER THE ENTIRE LENGTH AND WIDTH OF ENTRANCE.

6. SURFACE WATER - ALL SURFACE WATER FLOWING TO OR DIVERTED TOWARDS CONSTRUCTION ENTRANCES SHALL BE PIPED THROUGH THE ENTRANCE. MAINTAINING POSITIVE DRAINAGE. PIPE INSTALLED THROUGH THE STABILIZED CONSTRUCTION ENTRANCE SHALL BE PROTECTED WITH A MOUNTABLE BERM WITH 5:1 SLOPES AND MINIMIUM OF 6" STONE OVER THE PIPE. PIPE SHALL BE SIZED ACCORDING TO THE DRAINAGE REQUIREMENTS. WHEN THE ENTRANCE IS LOCATED AT A HIGH SPOT AND HAS NO DRAINAGE TO CONVEY A PIPE SHALL NOT BE NECESSARY. THE MINIMUM PIPE DIAMETER SHALL BE 6". CONTRACTOR SHALL BE RESPONSIBLE FOR THE MAINTENANCE OF SAID PIPE.

7. LOCATION — A STABILIZED CONSTRUCTION ENTRANCE SHALL BE LOCATED WHERE CONSTRUCTION TRAFFIC ENTERS AND/OR LEAVES THE CONSTRUCTION SITE. VEHICLES LEAVING THE SITE MUST TRAVEL OVER THE ENTIRE LENGTH OF THE TRACKING PAD.



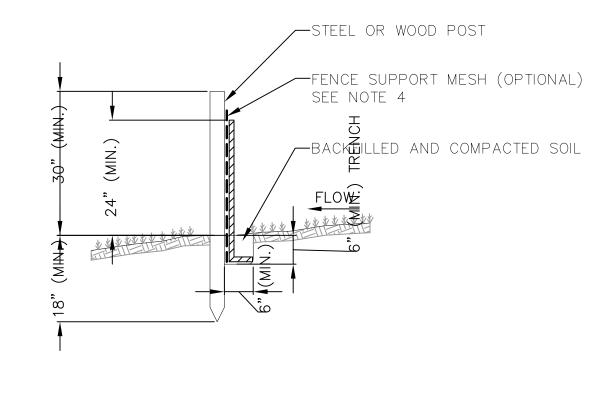

<u>NOTES:</u>

1. INSTALL SILT FENCE TO FOLLOW THE GROUND CONTOURS AS CLOSELY AS POSSIBLE.


2. CURVE THE SILT FENCE UP THE SLOPE TO PREVENT WATER FROM RUNNING AROUND THE

3. POST SPACING WITH FENCE SUPPORT MESH = 10 FT. (MAX.)

POST SPACING WITHOUT FENCE SUPPORT MESH = 6 FT. (MAX.)

4. SILT FENCE SUPPORT MESH CONSISTS OF 14-GAUGE STEEL WIRE WITH A MESH SPACING OF 6 IN. X 6 IN. OR PREFABRICATED POLYMERIC MESH OF EQUIVALENT STRENGTH



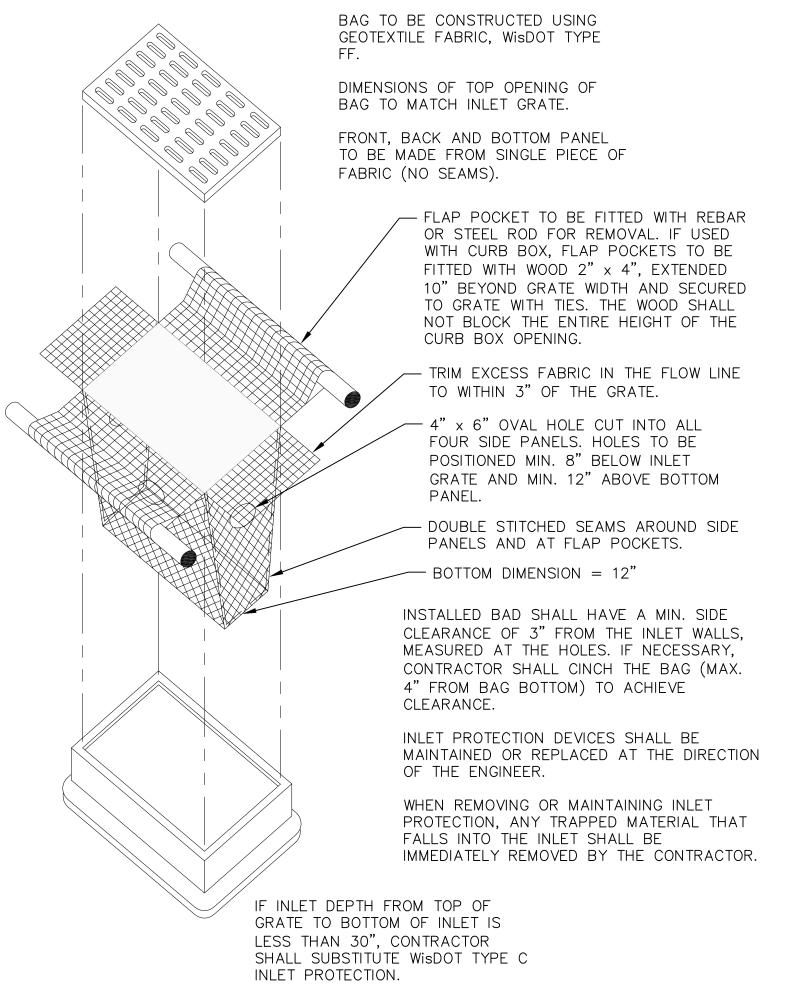





608-829-1750 608-829-3056 (FAX)




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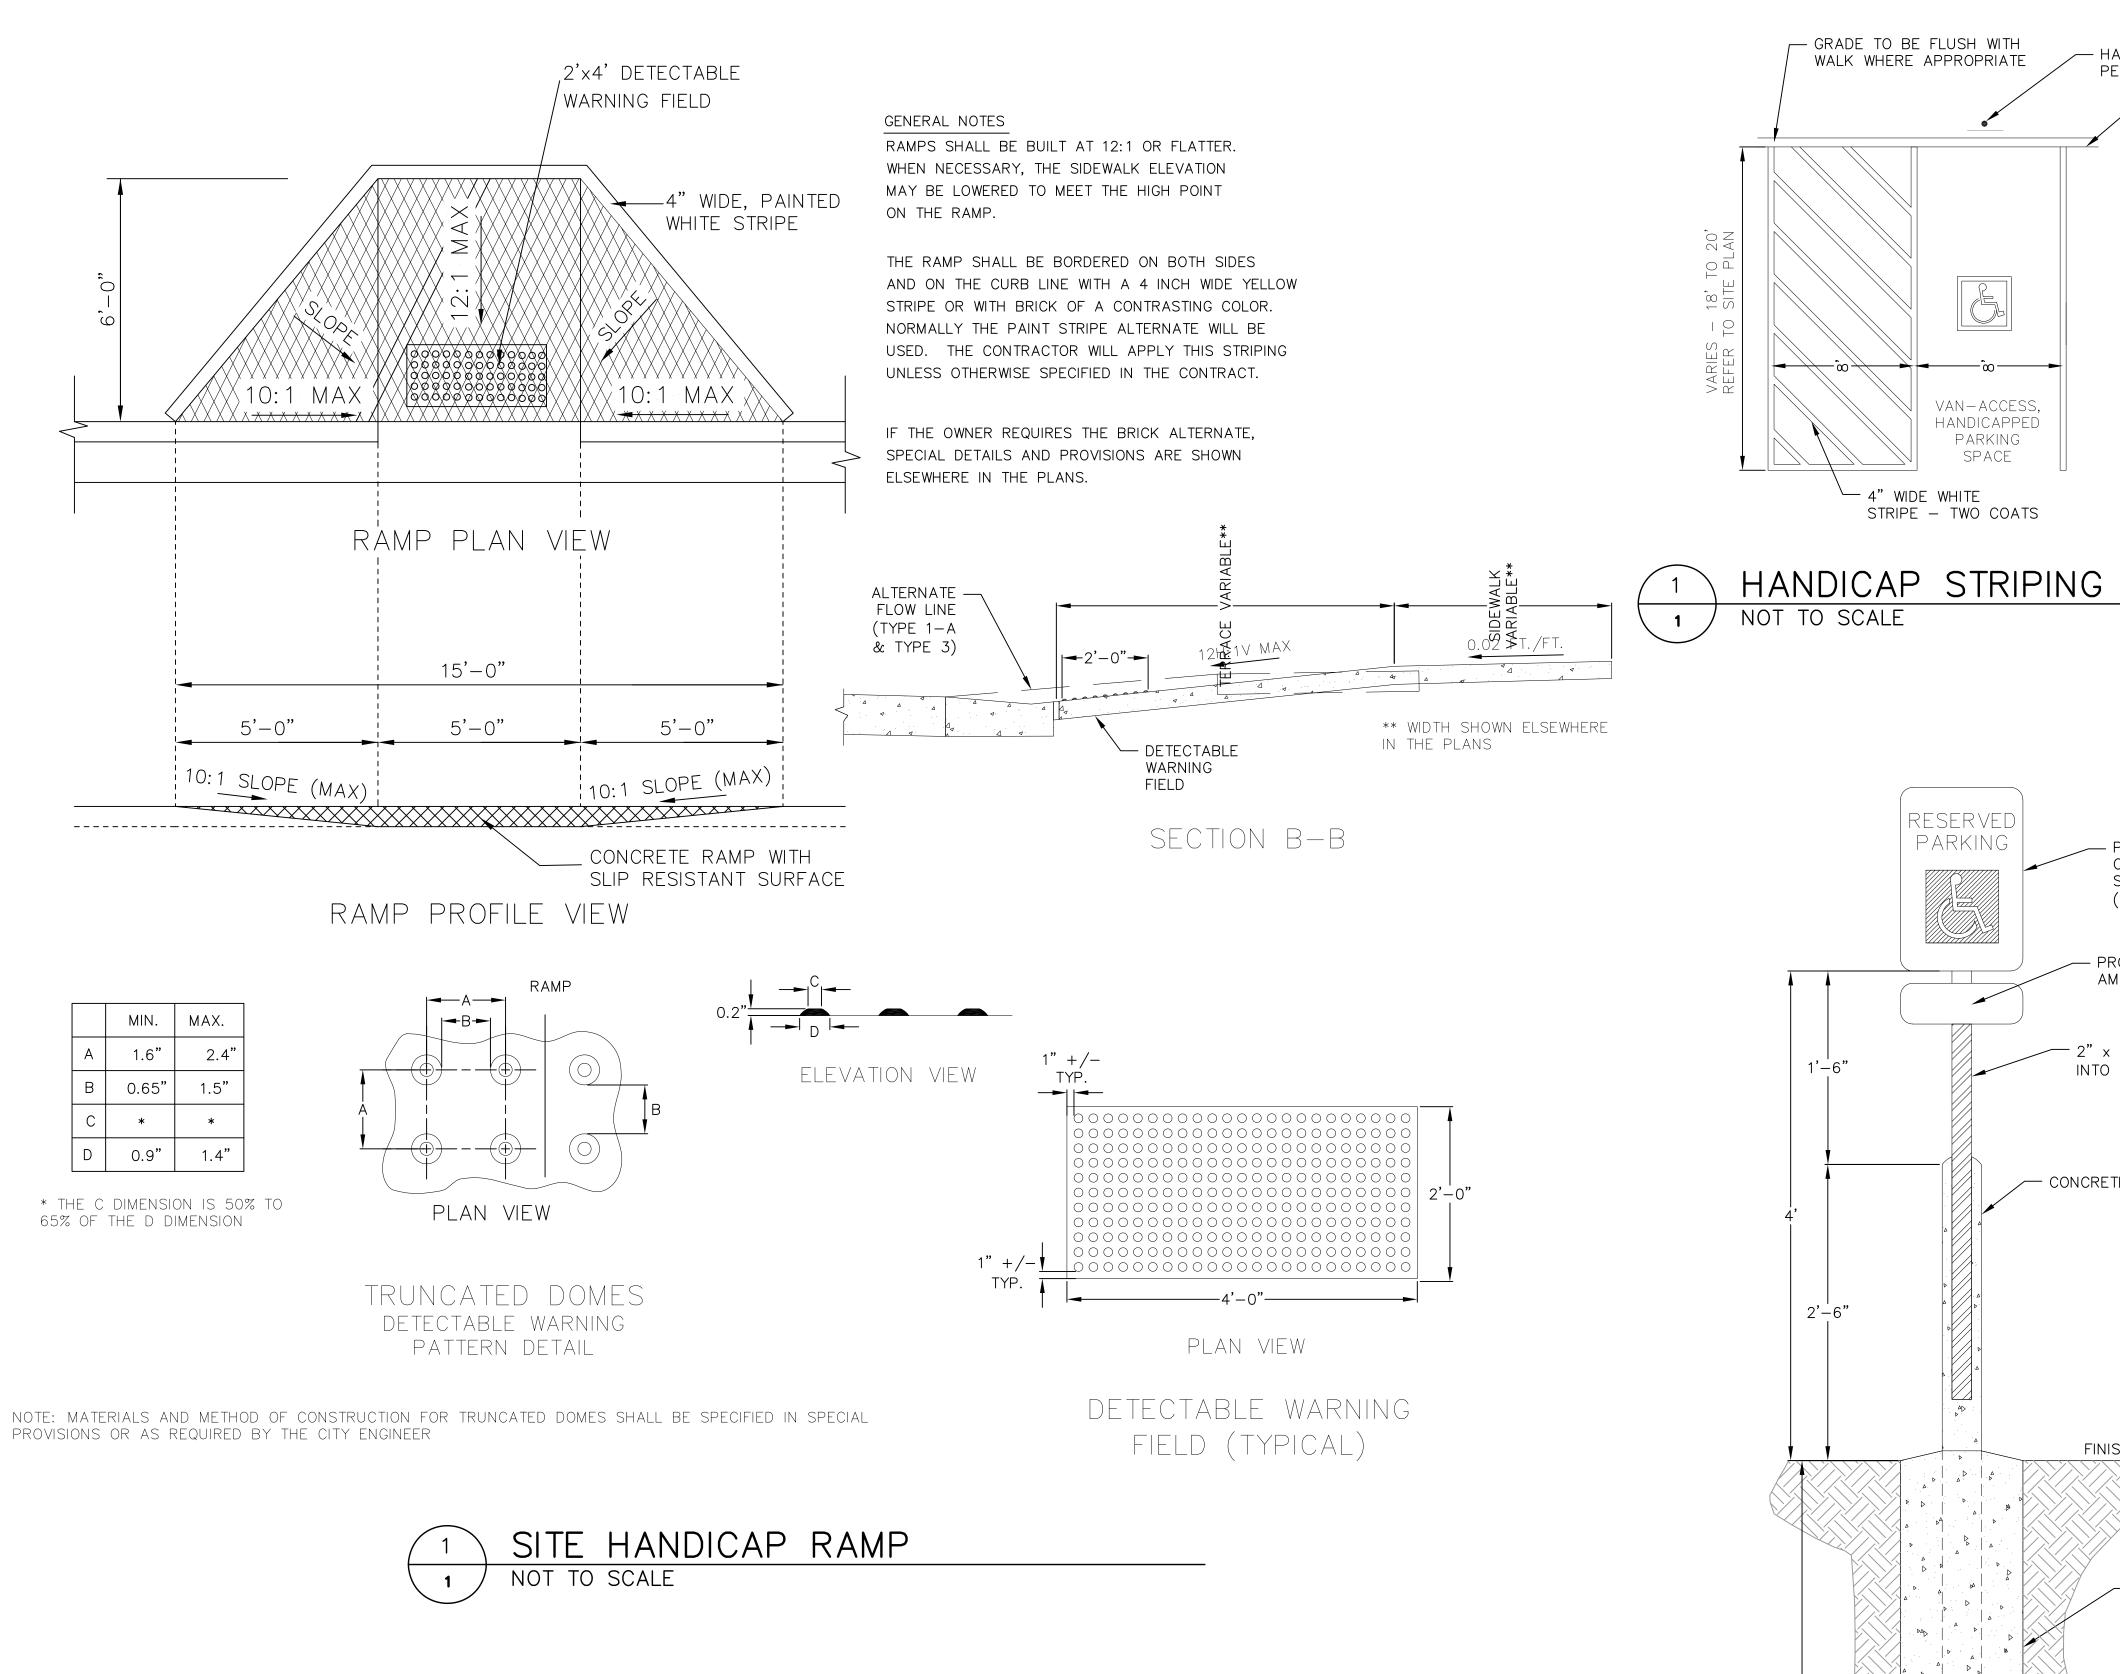
 \mathcal{C} ME ROAD

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LAND USE RESUBMITTAL 1/3/18

CONSTRUCTION DETAIL



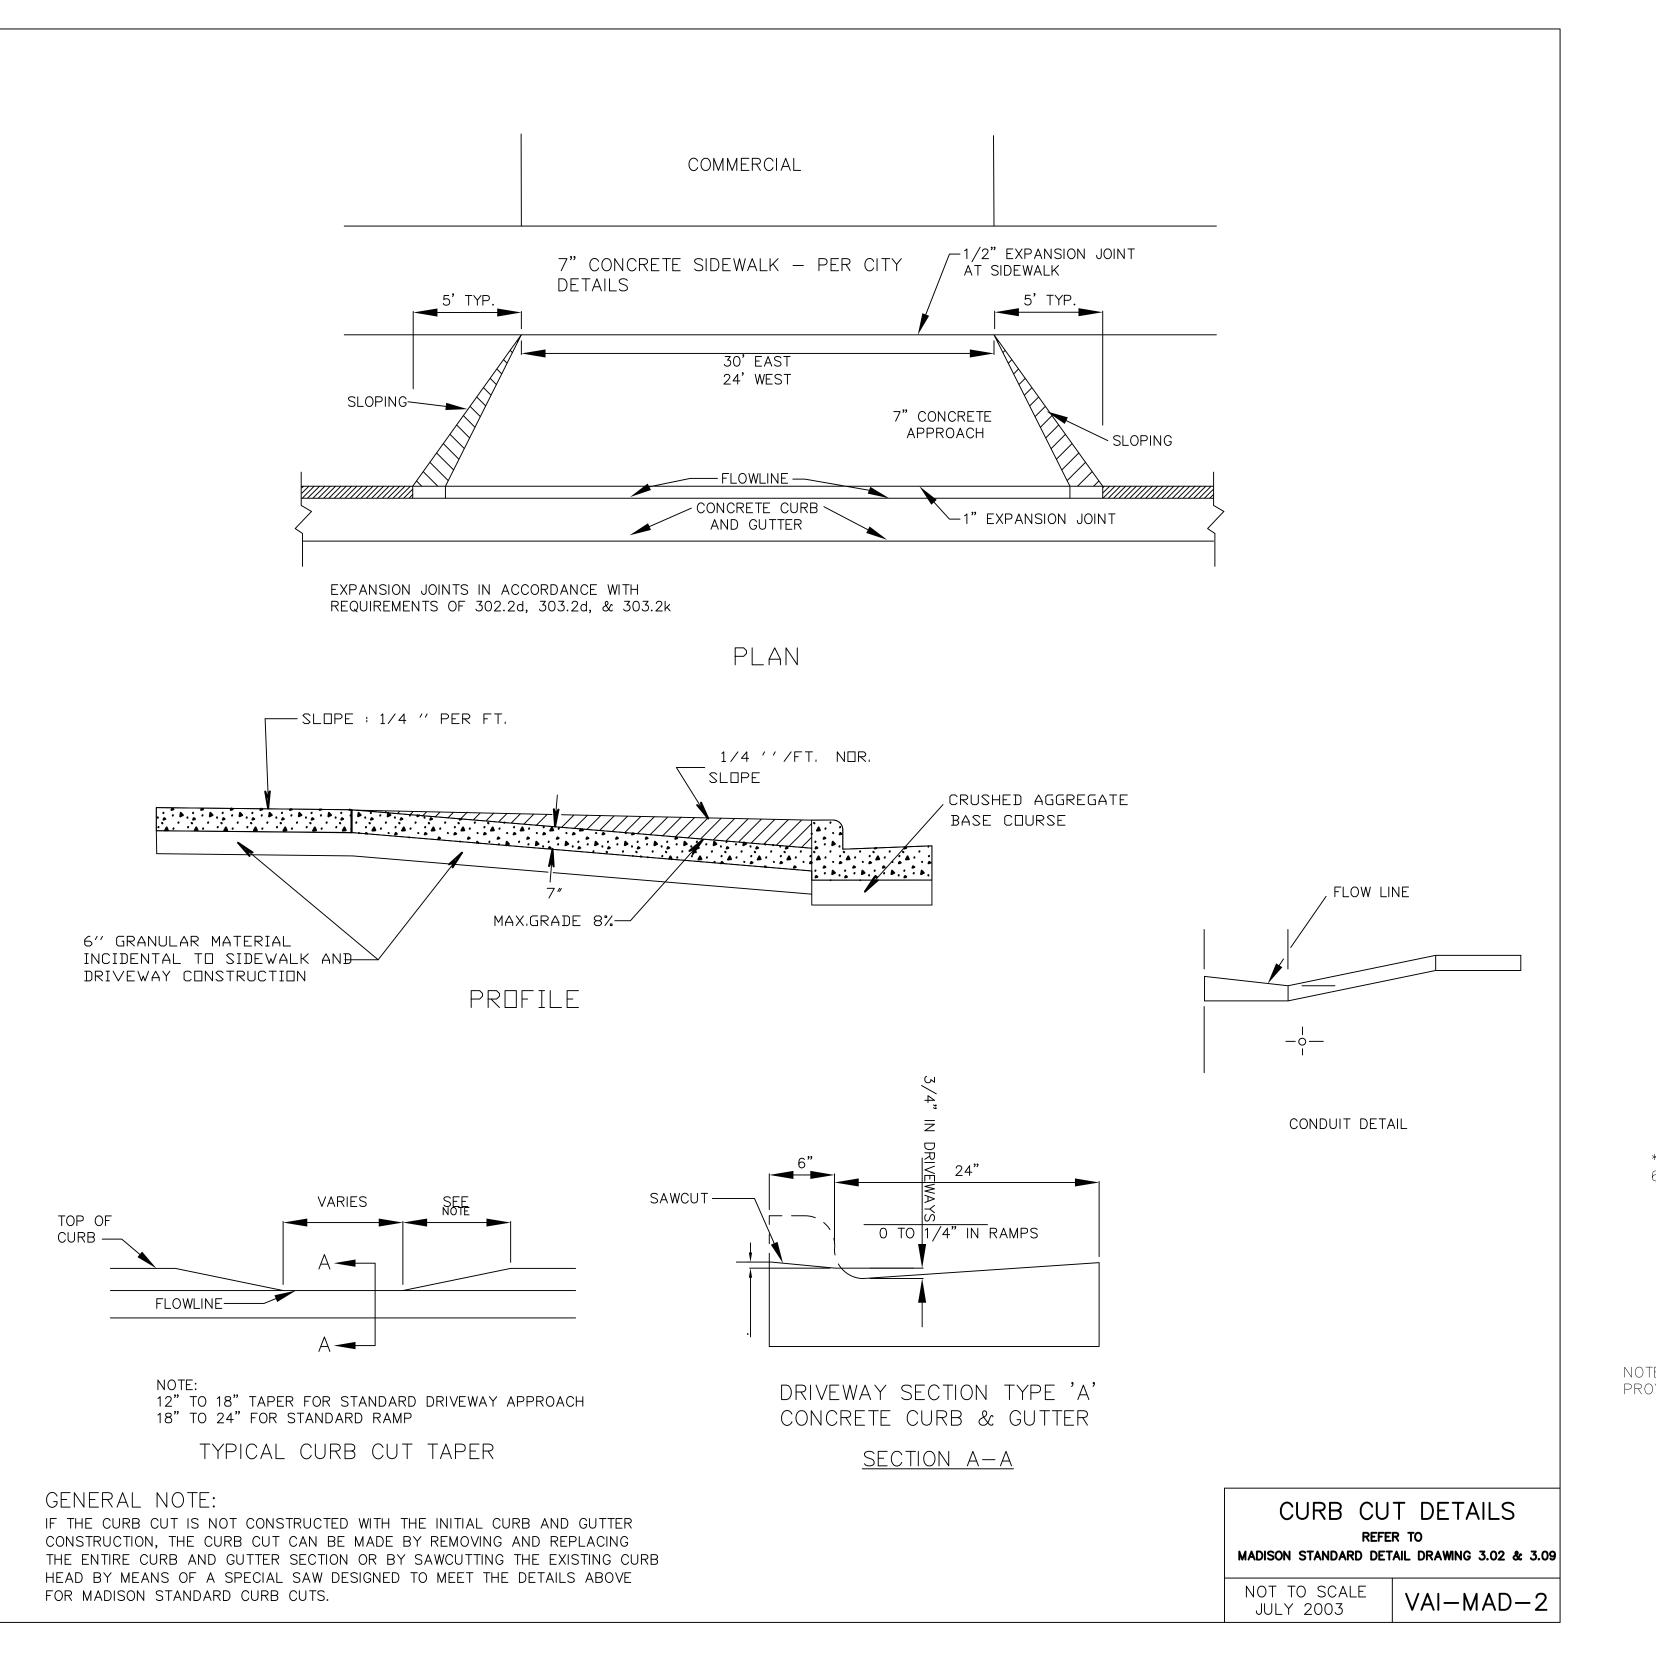

NOT FOR CONSTRUCTION

- PROVIDE SIGN INDICATING FINE AMOUNT AS PER LOCAL CODES. 2" x 2" STEEL TUBE EXTENDED INTO CONCRETE FILLED 4" Ø PIPE CONCRETE FILLED 4" Ø PIPE FINISHED GRADE ─ 12" DIAMETER CONCRETE FOUNDATION 6" BELOW FROST LINE (3 FT MIN.BELOW FINISHED GRADE)

NOTE: CONSTRUCTION SHALL CONFORM TO CITY OF MADISON STANDARD DETAIL DRAWINGS THAT ARE CURRENT AT THE TIME OF CONSTRUCTION.



- GRADE TO BE FLUSH WITH

WALK WHERE APPROPRIATE

VAN-ACCESS,

HANDICAPPED

PARKING

└─ 4" WIDE WHITE

STRIPE - TWO COATS

RESERVED

PARKING

SPACE

HANDICAPPED SIGN

PER ADA REQUIREMENTS

CONCRETE CURB

- PROVIDE US DOT #R7-8 SIGN

(SIGN MAY VARY BY ORDINANCE).

CONTAINING INTERNATIONAL

SYMBOL OF ACCESSIBILITY

7780 ELMWOOD AVE. STE. 204

MIDDLETON, WI 53562

608-829-1750

608-829-3056 (FAX)

Vierbicher
planners | engineers | advisors

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SCALE: AS NOTED

LAND USE SUBMITTAL 11/20/17 LAND USE RESUBMITTAL 1/3/18

CONSTRUCTION

DETAIL

C106

DRAWN BY:


DATE:

EXCAVATED WASHOUT STRUCTURE

CONSTRUCTION SPECIFICATIONS

- 1.LOCATE WASHOUT STRUCTURE A MINIMUM OF 50 FEET AWAY FROM OPEN CHANNELS, STORM DRAIN INLETS, SENSITIVE AREAS, WETLANDS, BUFFERS AND WATER COURSES AND AWAY FROM CONSTRUCTION
- 2.PREPARE SOIL BASE FREE OF ROCKS OR OTHER DEBRIS THAT MAY CAUSE TEARS OR HOLES IN THE LINER. FOR LINER, USE 10 MIL OR THICKER UV RESISTANT, IMPERMEABLE SHEETING, FREE OF HOLES AND TEARS OR OTHER DEFECTS THAT COMPROMISE IMPERMEABILITY OF THE MATERIAL.
- 3.KEEP CONCRETE WASHOUT STRUCTURE WATER TIGHT. REPLACE IMPERMEABLE LINER IF DAMAGED (E.G., RIPPED OR PUNCTURED). EMPTY OR REPLACE WASHOUT STRUCTURE THAT IS 75 PERCENT FULL, AND DISPOSE OF ACCUMULATED MATERIAL PROPERLY. DO NOT REUSE PLASTIC LINER. WET-VACUUM STORED LIQUIDS THAT HAVE NOT EVAPORATED AND DISPOSE OF IN AN APPROVED MANNER. REMOVE HARDENED SOLIDS, WHOLE OR BROKEN UP, FOR DISPOSAL OR RECYCLING. MAINTAIN RUNOFF DIVERSION AROUND EXCAVATED WASHOUT STRUCTURE UNTIL STRUCTURE IS REMOVED.




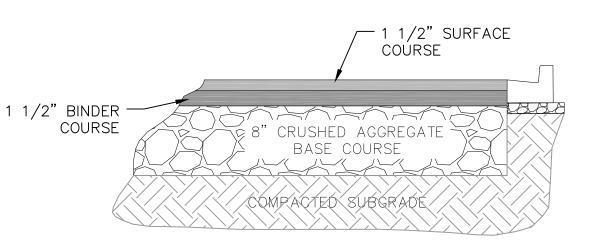


BITUMINOUS PAVEMENT PARKING LOT




NOTE: CONSTRUCTION SHALL CONFORM TO CITY OF MADISON STANDARD DETAIL DRAWINGS THAT ARE CURRENT AT THE TIME OF CONSTRUCTION.

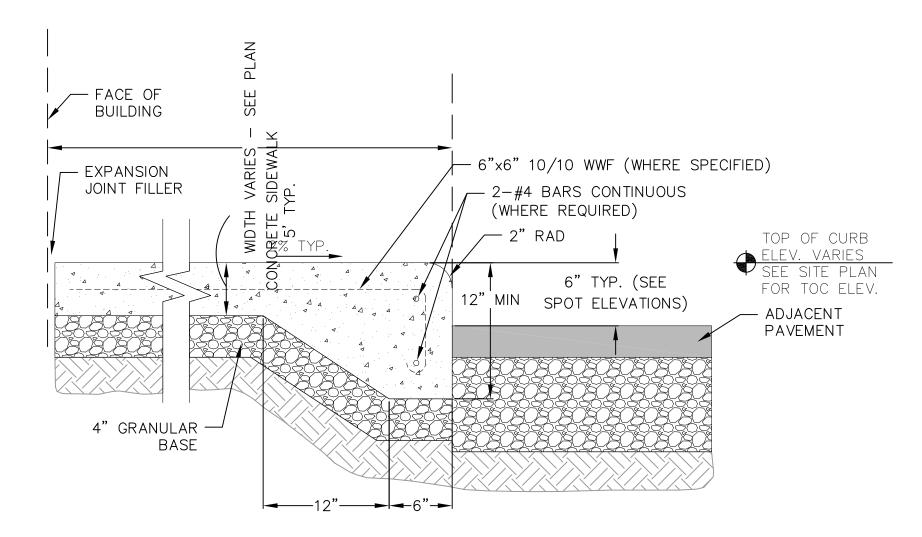


CURBED SIDEWALK DETAIL (INTEGRAL)
NOT TO SCALE

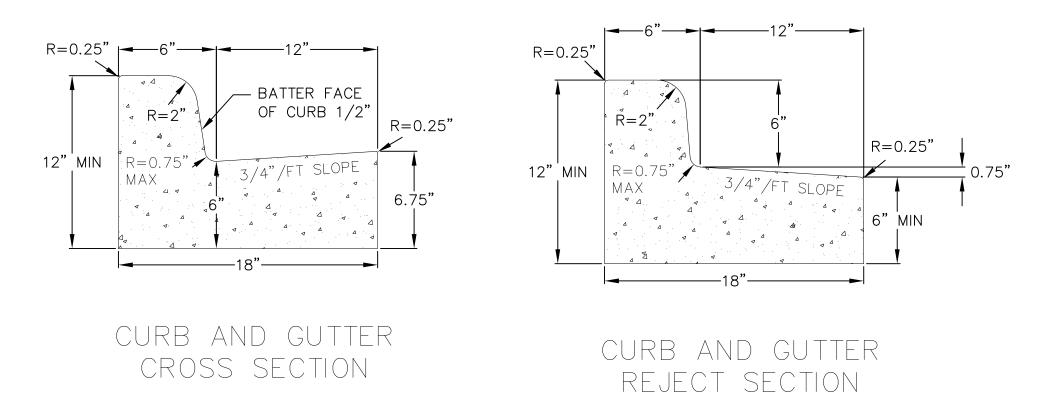


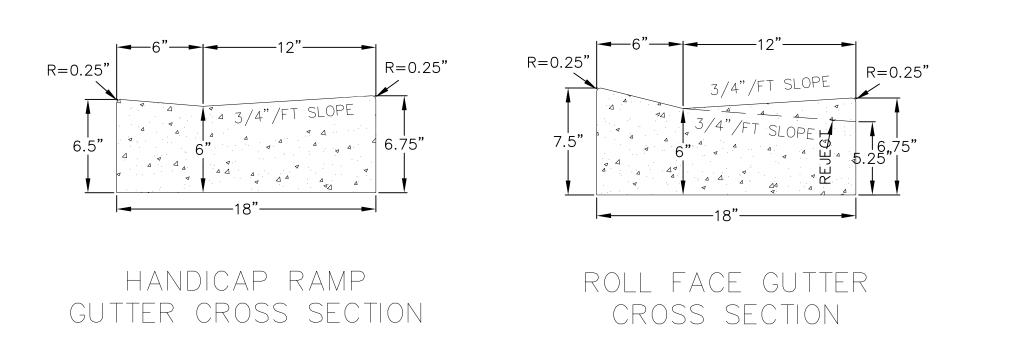


18" CONCRETE CURB AND GUTTER NOT TO SCALE

NOT FOR CONSTRUCTION

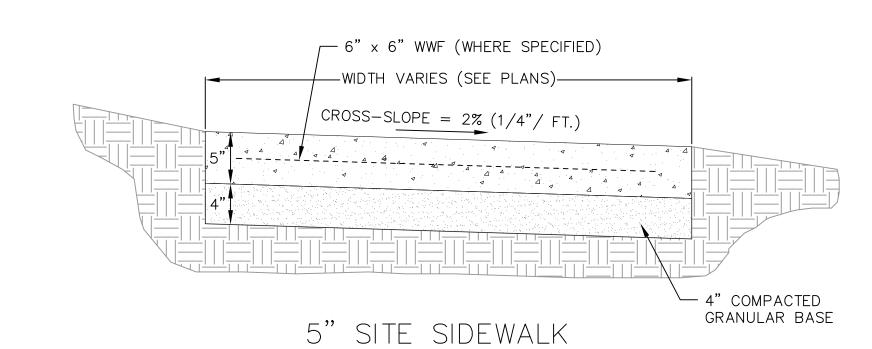

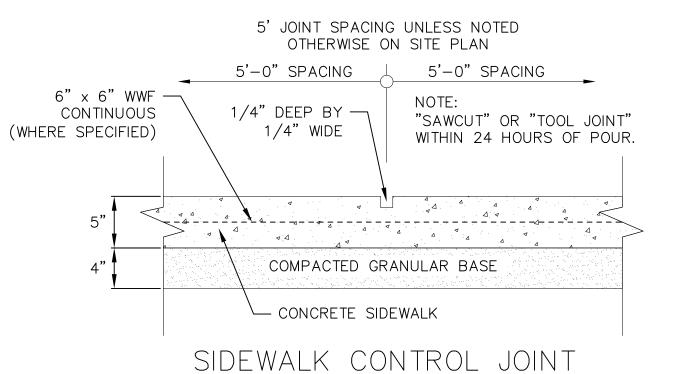

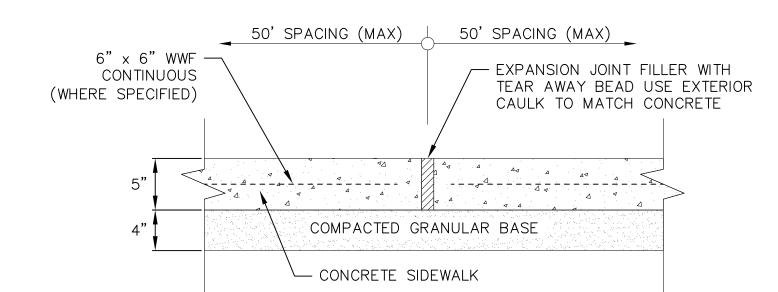


SIDEWALK EXPANSION JOINT



SIGNAGE NOTES:

- 1. ALL SIGNS SHALL BE FABRICATED AND INSTALLED IN ACCORDANCE WITH THE MANUAL ON UNIFORM TRAFFIC CONTROL DEVICES.
- 2. SIGNS SHALL BE A DISTANCE OF 7' FROM GROUND LEVEL TO THE BOTTOM OF THE SIGN
- MOUNTED ON THE POST AND LOCATED 3' BEHIND THE BACK OF CURB. . STREET NAME SIGNS SHALL HAVE WHITE LETTERS AND GREEN BACKGROUND.
- SIGN POSTS SHALL BE 2-3/8" O.D., GALVANIZED 10 FT LONG, 13 GAUGE, AND 0.095 WALL THICKNESS. MOUNT SIGN AT TOP OF THE POST, AND INSTALL POSTS 3' DEEP AND MIX 1/2 BAG OF 80 LB SAKRETE CONCRETE, POURING IT AROUND THE POST BELOW THE GROUND BEFORE COVERING WITH 8" OF TOPSOIL.

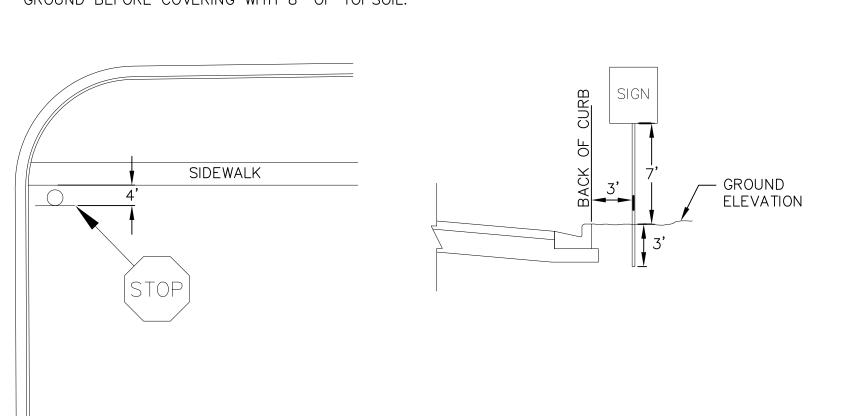










Vierbicher
planners engineers advisors


2 SUITES HOME (MADISON, WISCO

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LAND USE RESUBMITTAL 1/3/18


CONSTRUCTION DETAIL



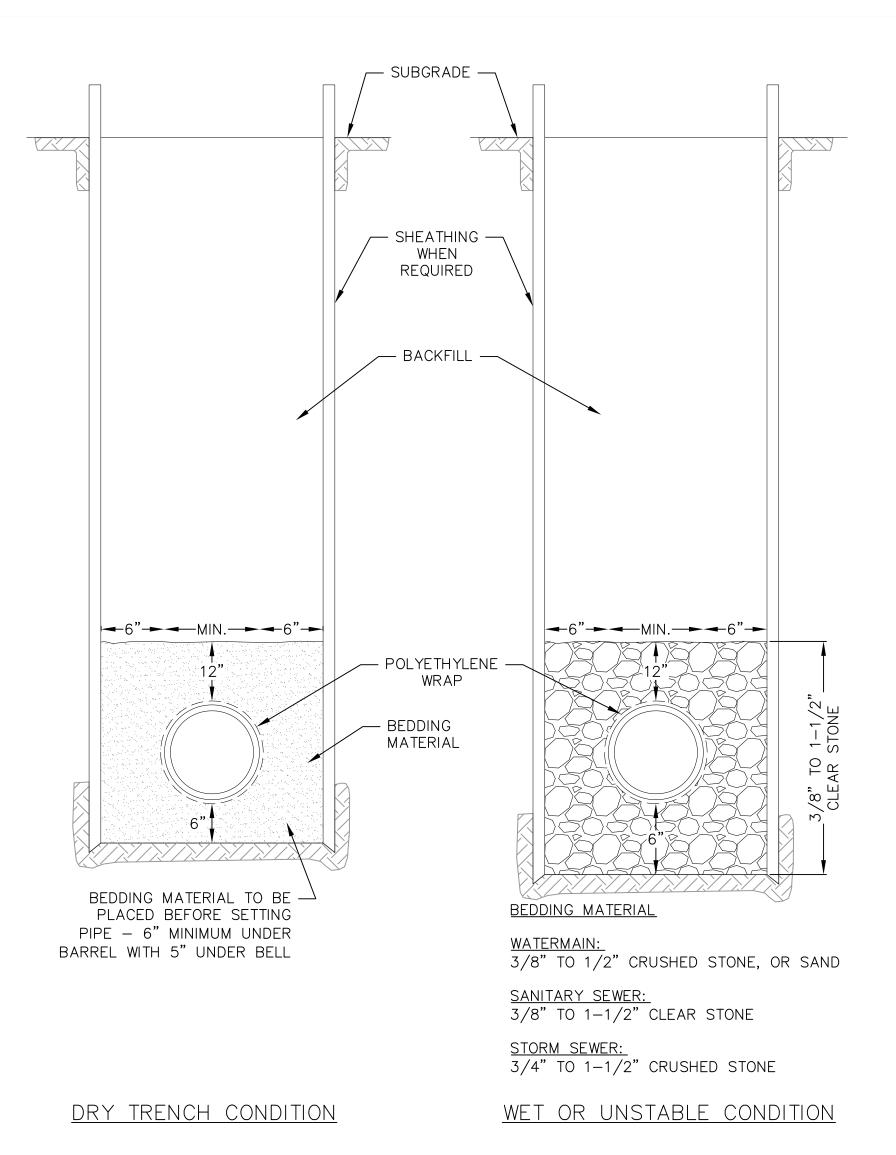


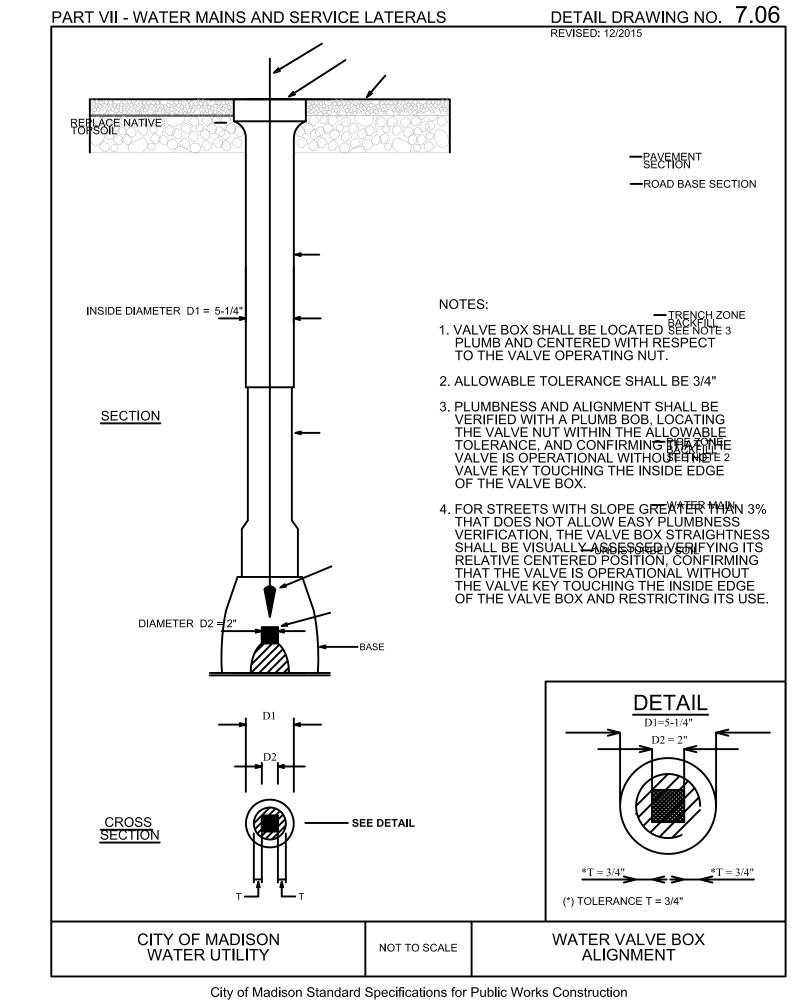
STANDARD GATE VALVE BOX SETTING




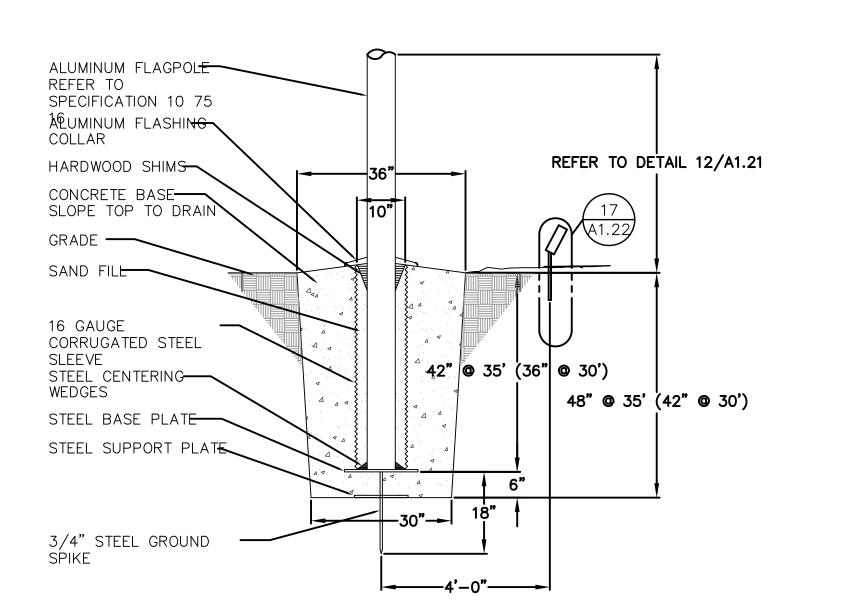



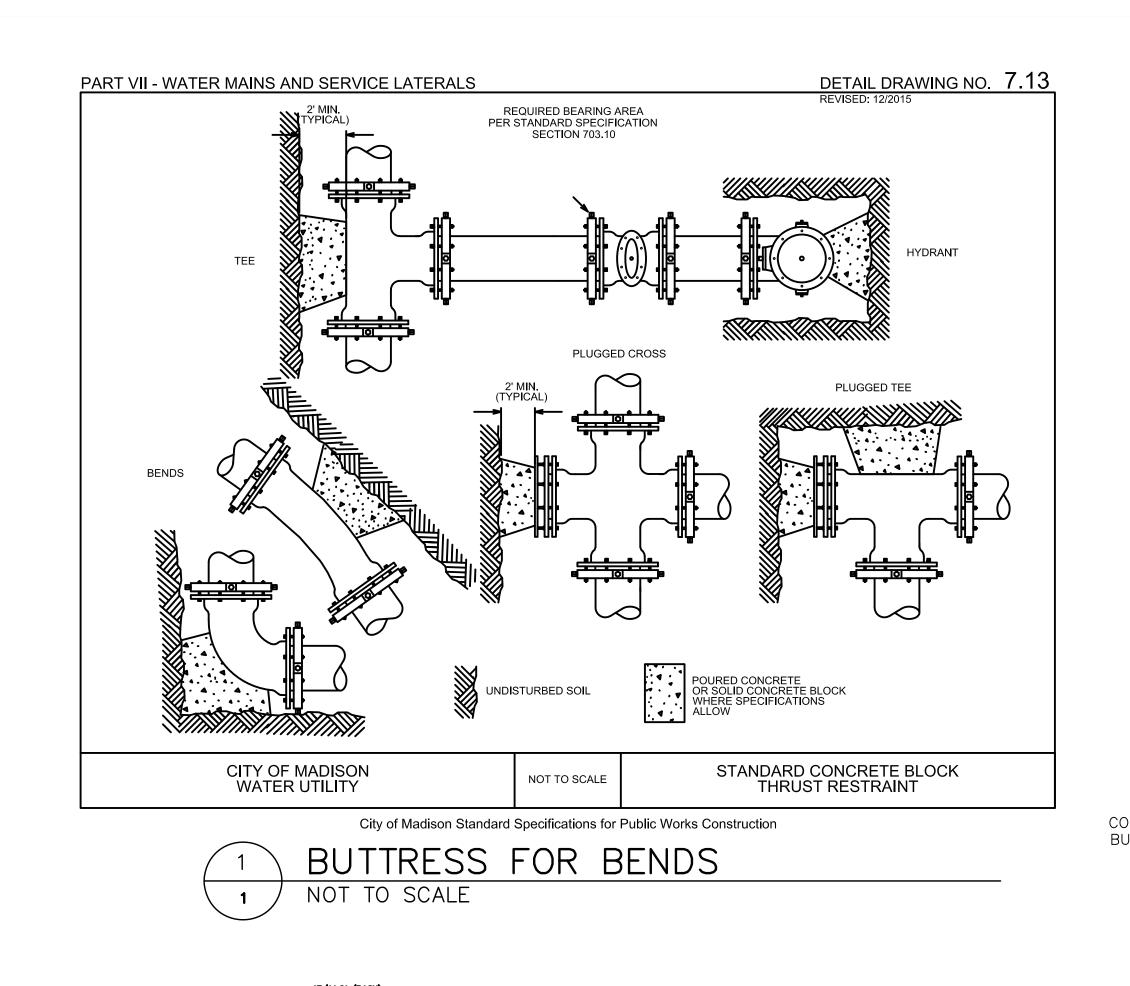


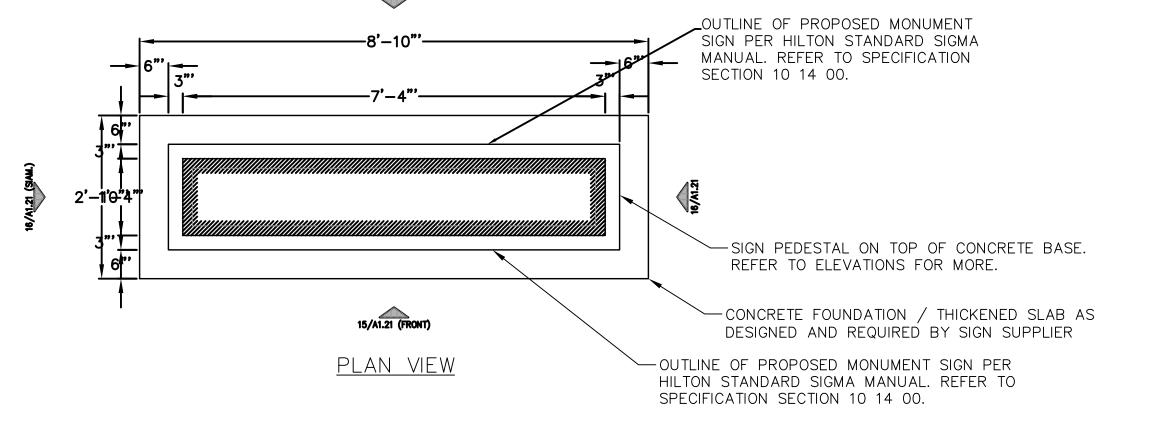


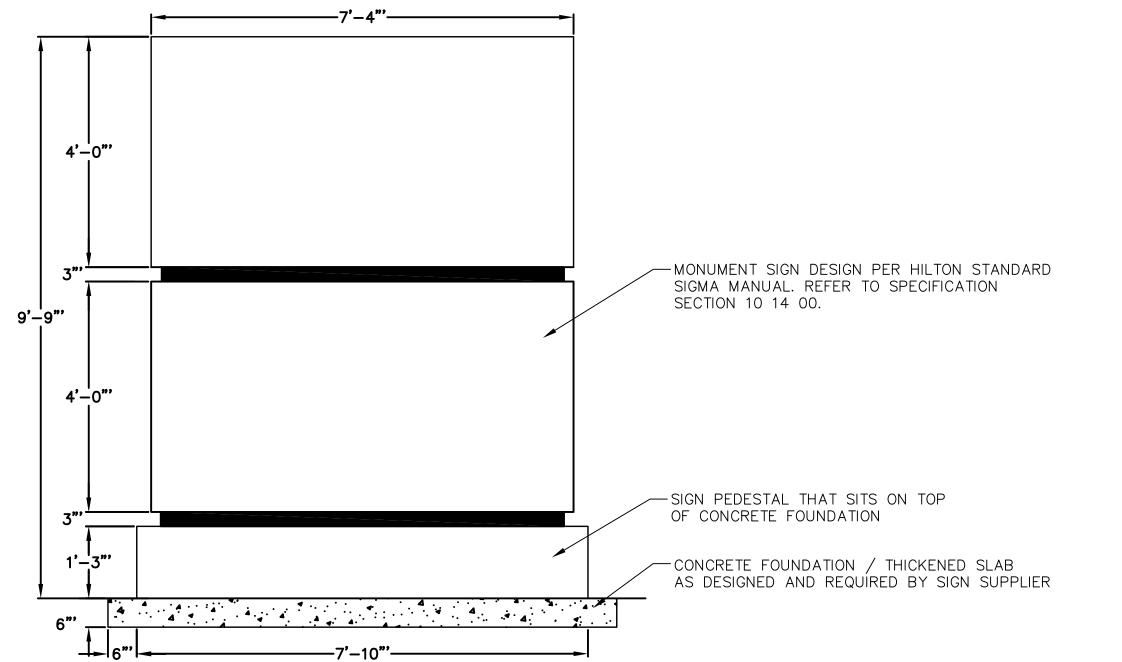




MONUMENTAL SIGN NOT TO SCALE NOT FOR CONSTRUCTION

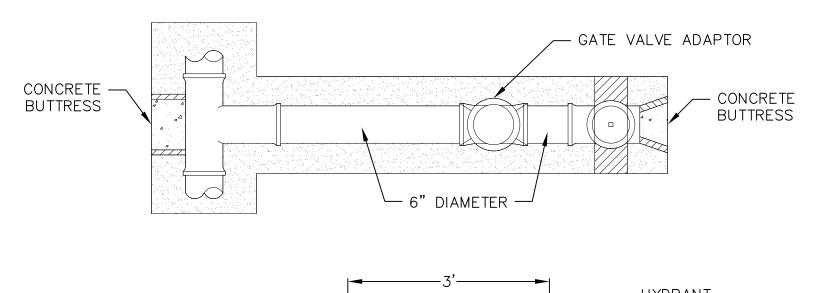

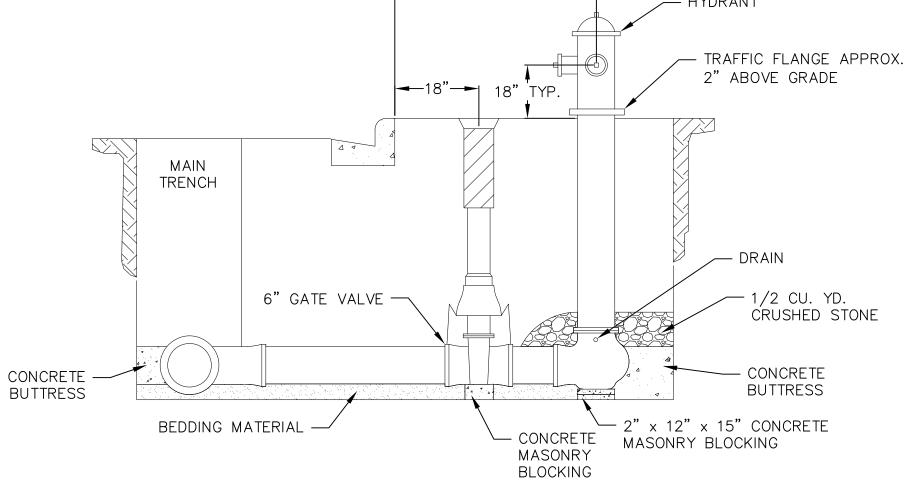



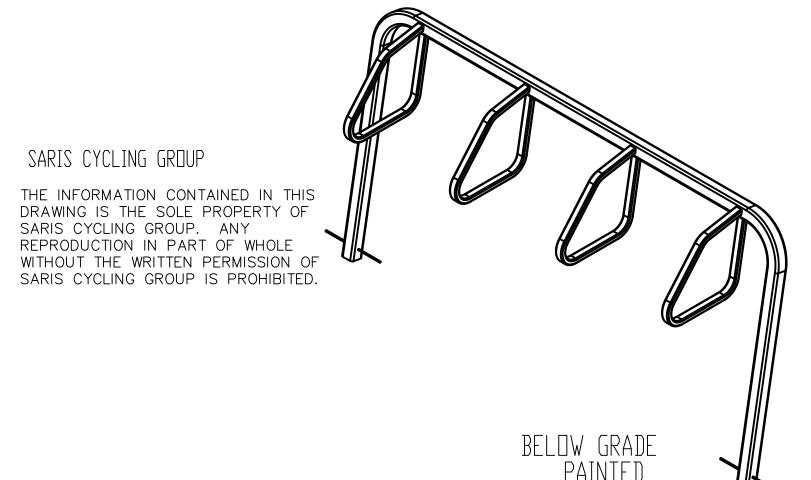

CITY RACK, 2400 SERIES, SGL, BG



WE BRING CYCLING TO LIFE.

WITH MANUFACTURER'S SPECIFICATIONS.

3. WEIGHT IS RACK ONLY, NOT TO BE CONSIDERED AS SHIPPING WEIGHT. 4. FINISHING OPTIONS INCLUDE SUPER DURABLE POLYESTER POWDERCOAT AND HOT DIP

5. SEE WEBSITE OR CATALOG FOR POLYESTER POWDERCOAT COLOR OPTIONS.

DO NOT SCALE DRAWING.
 INSTALLATION TO BE COMPLETED IN ACCORDANCE



NOTE: CONSTRUCTION SHALL STANDARD DETAIL DRAWINGS THAT ARE CURRENT AT THE TIME OF CONSTRUCTION.

MIDDLETON, WI 53562 608-829-1750




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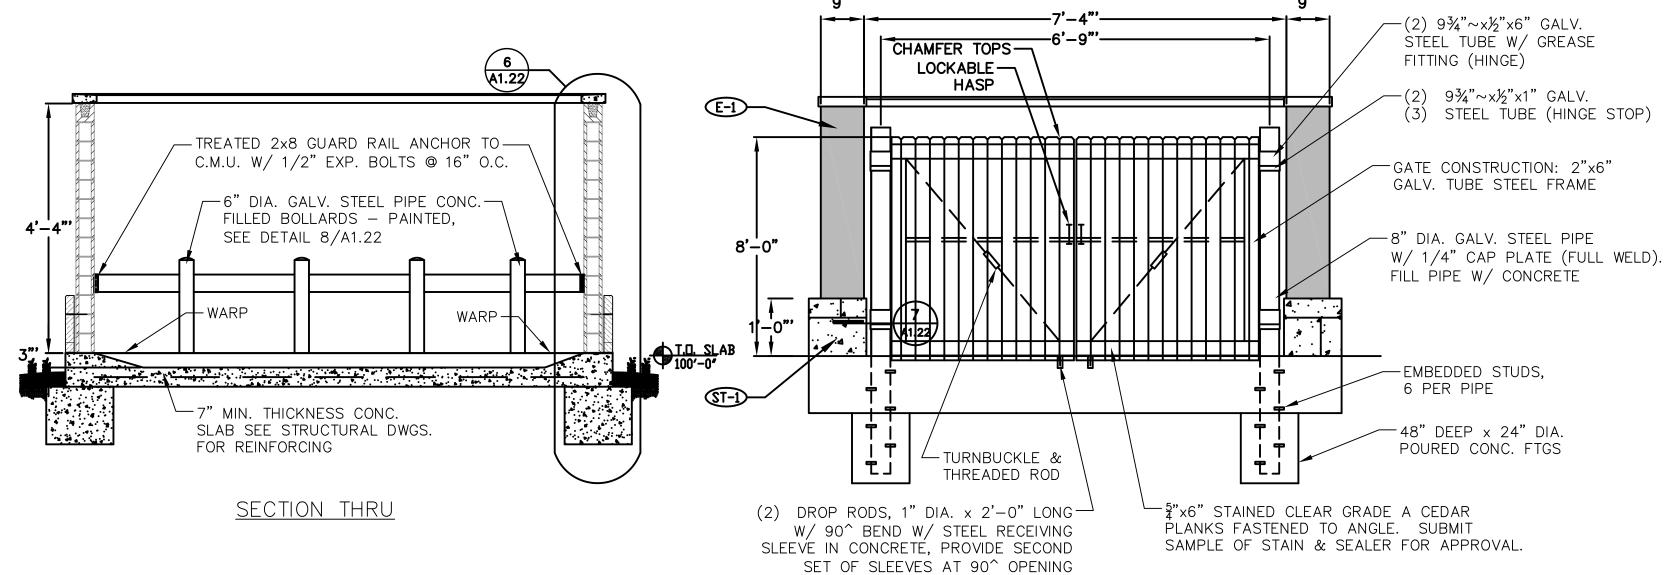
2 SUITES HOME (
RIMROCK ROAD
MADISON, WISCC

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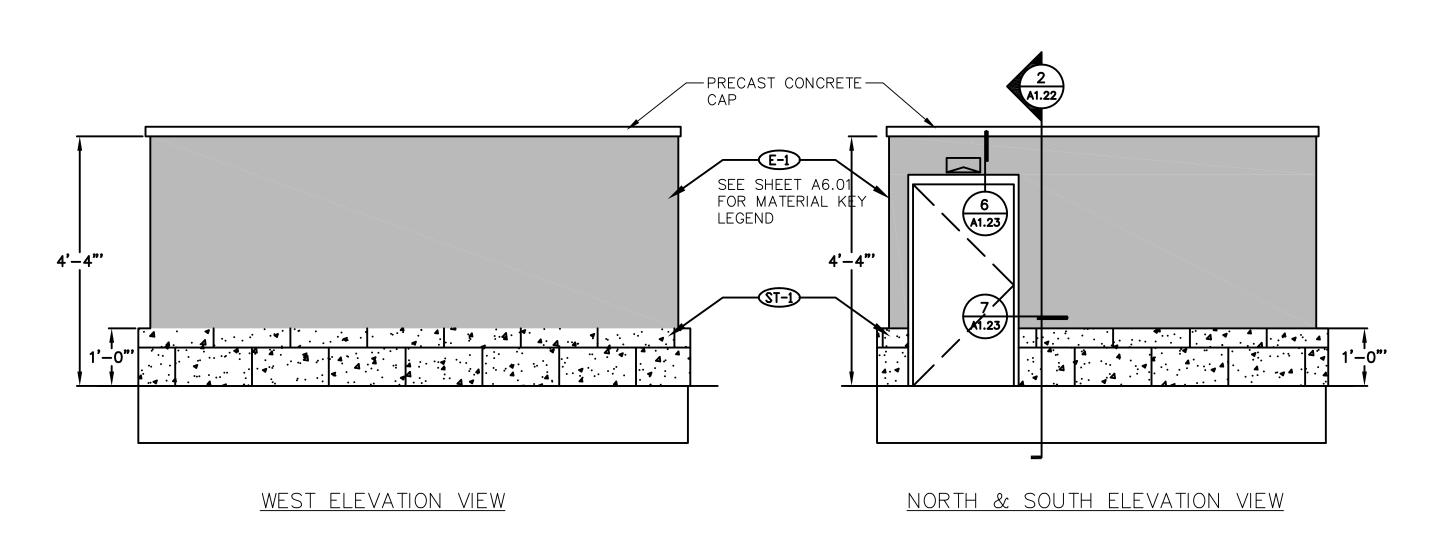
LAND USE SUBMITTAL 11/20/17 LAND USE RESUBMITTAL 1/3/18

CONSTRUCTION DETAIL PLAN




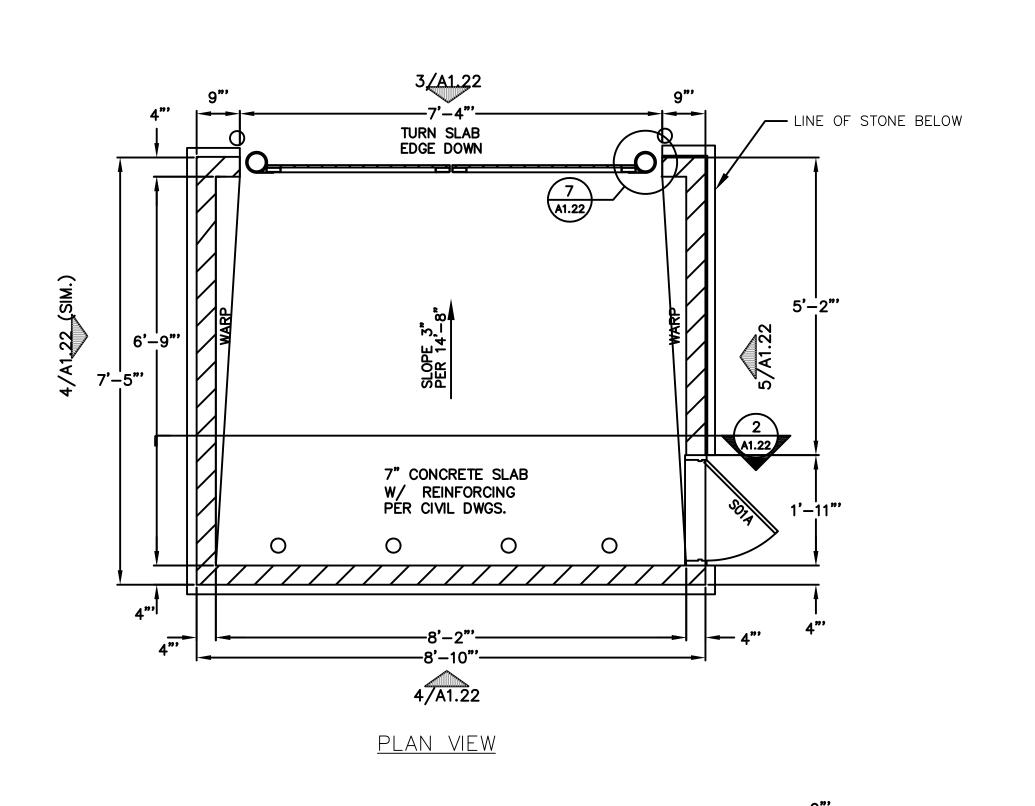


<u>east elevation view</u>






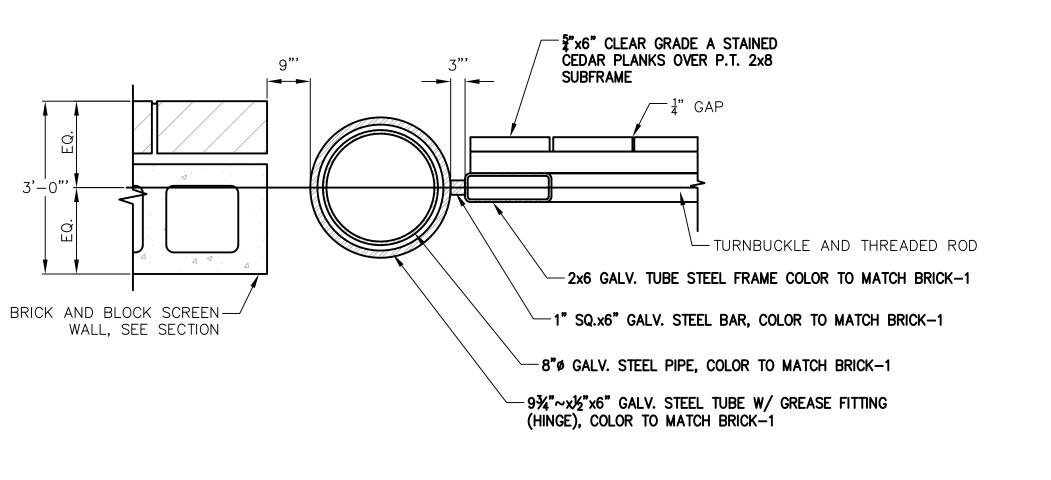



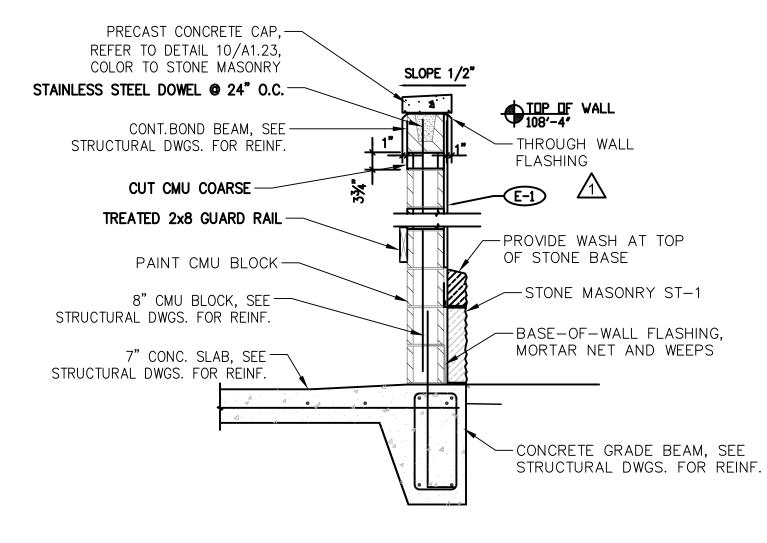




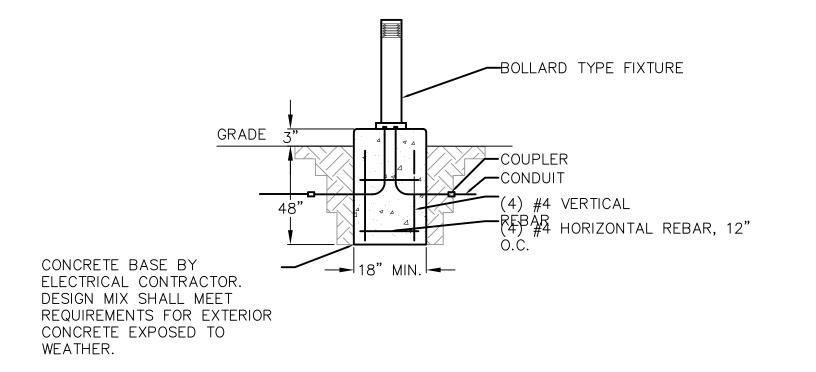



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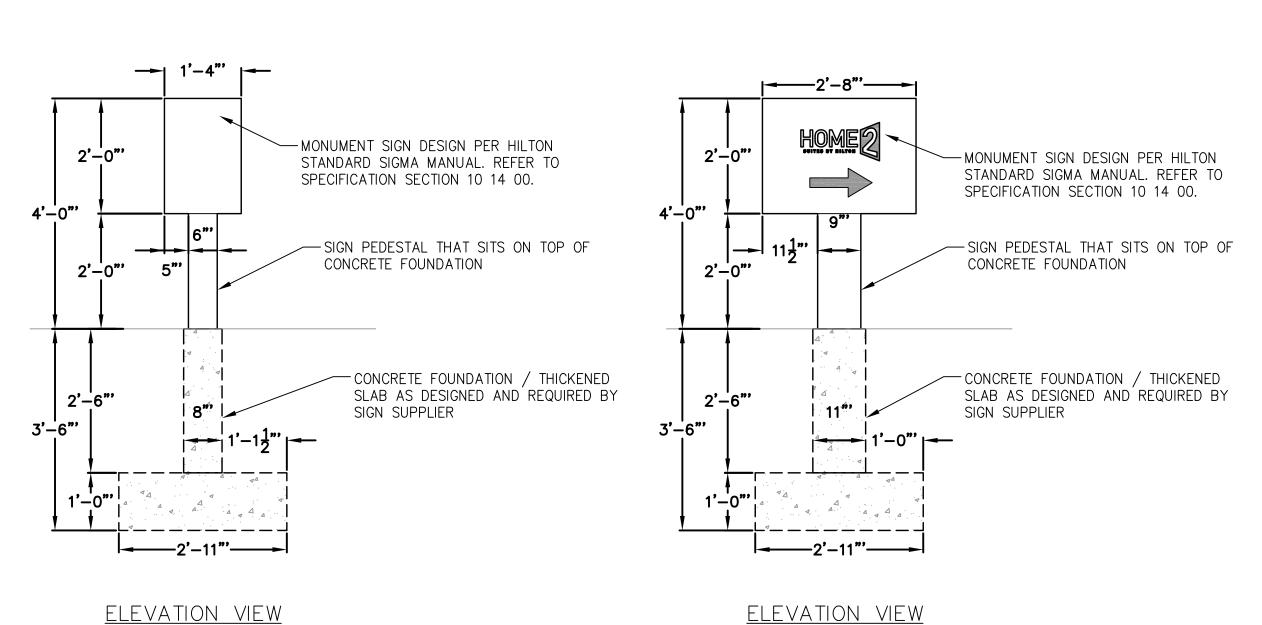
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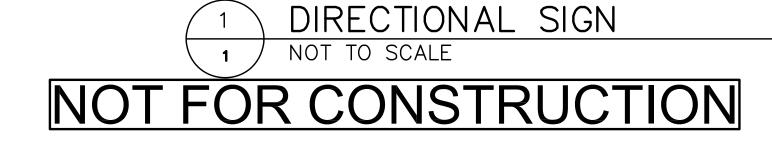



ELEVATION VIEW

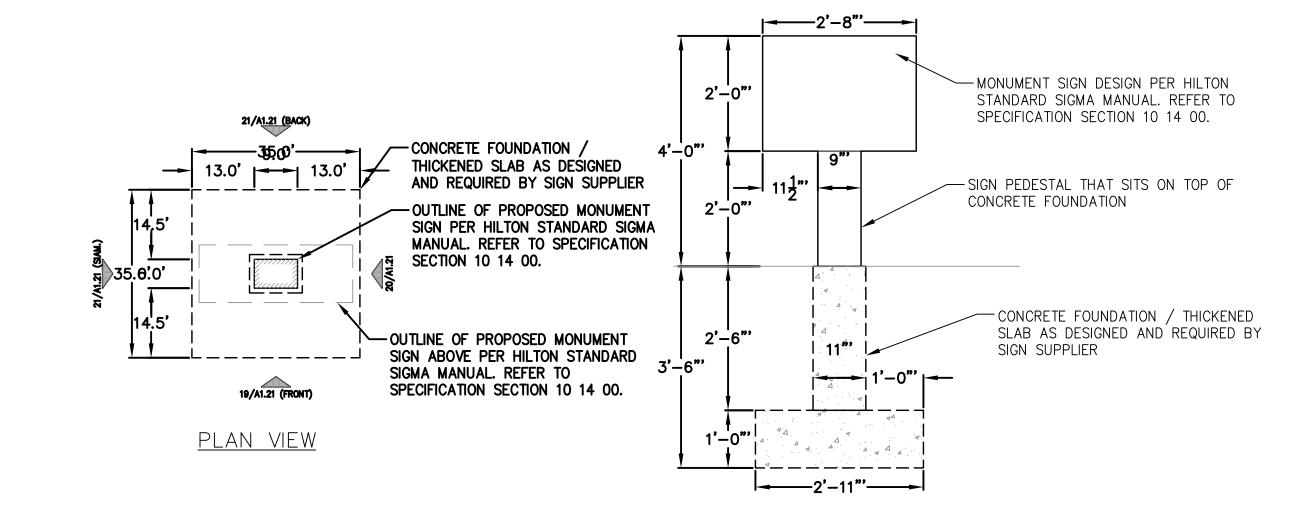



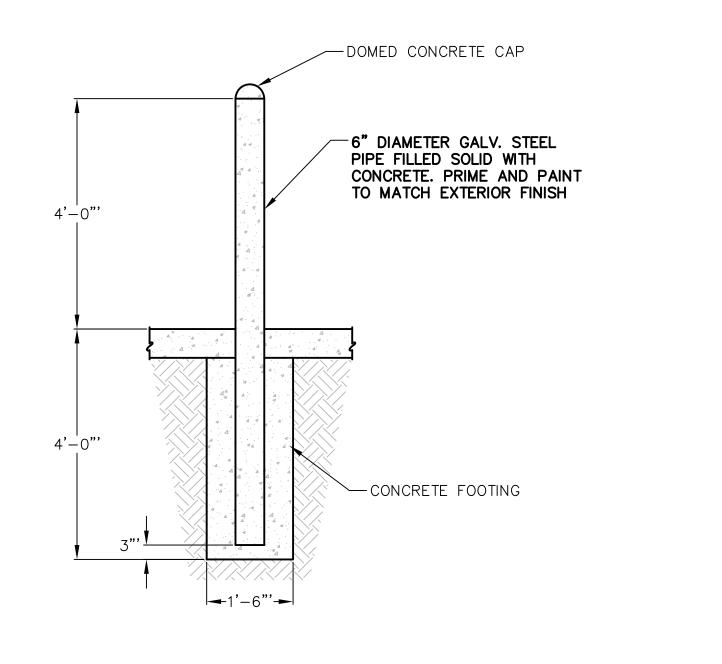

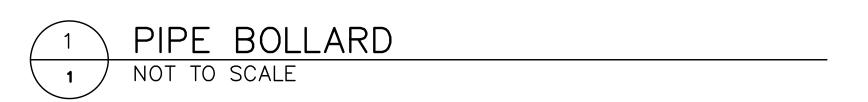

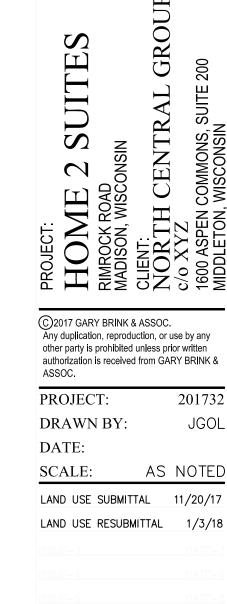

CONSTRUCTION

DETAIL


C109

7780 ELMWOOD AVE. STE. 204

MIDDLETON, WI 53562

608-829-1750 608-829-3056 (FAX)

Vierbich planners | engineers | adv

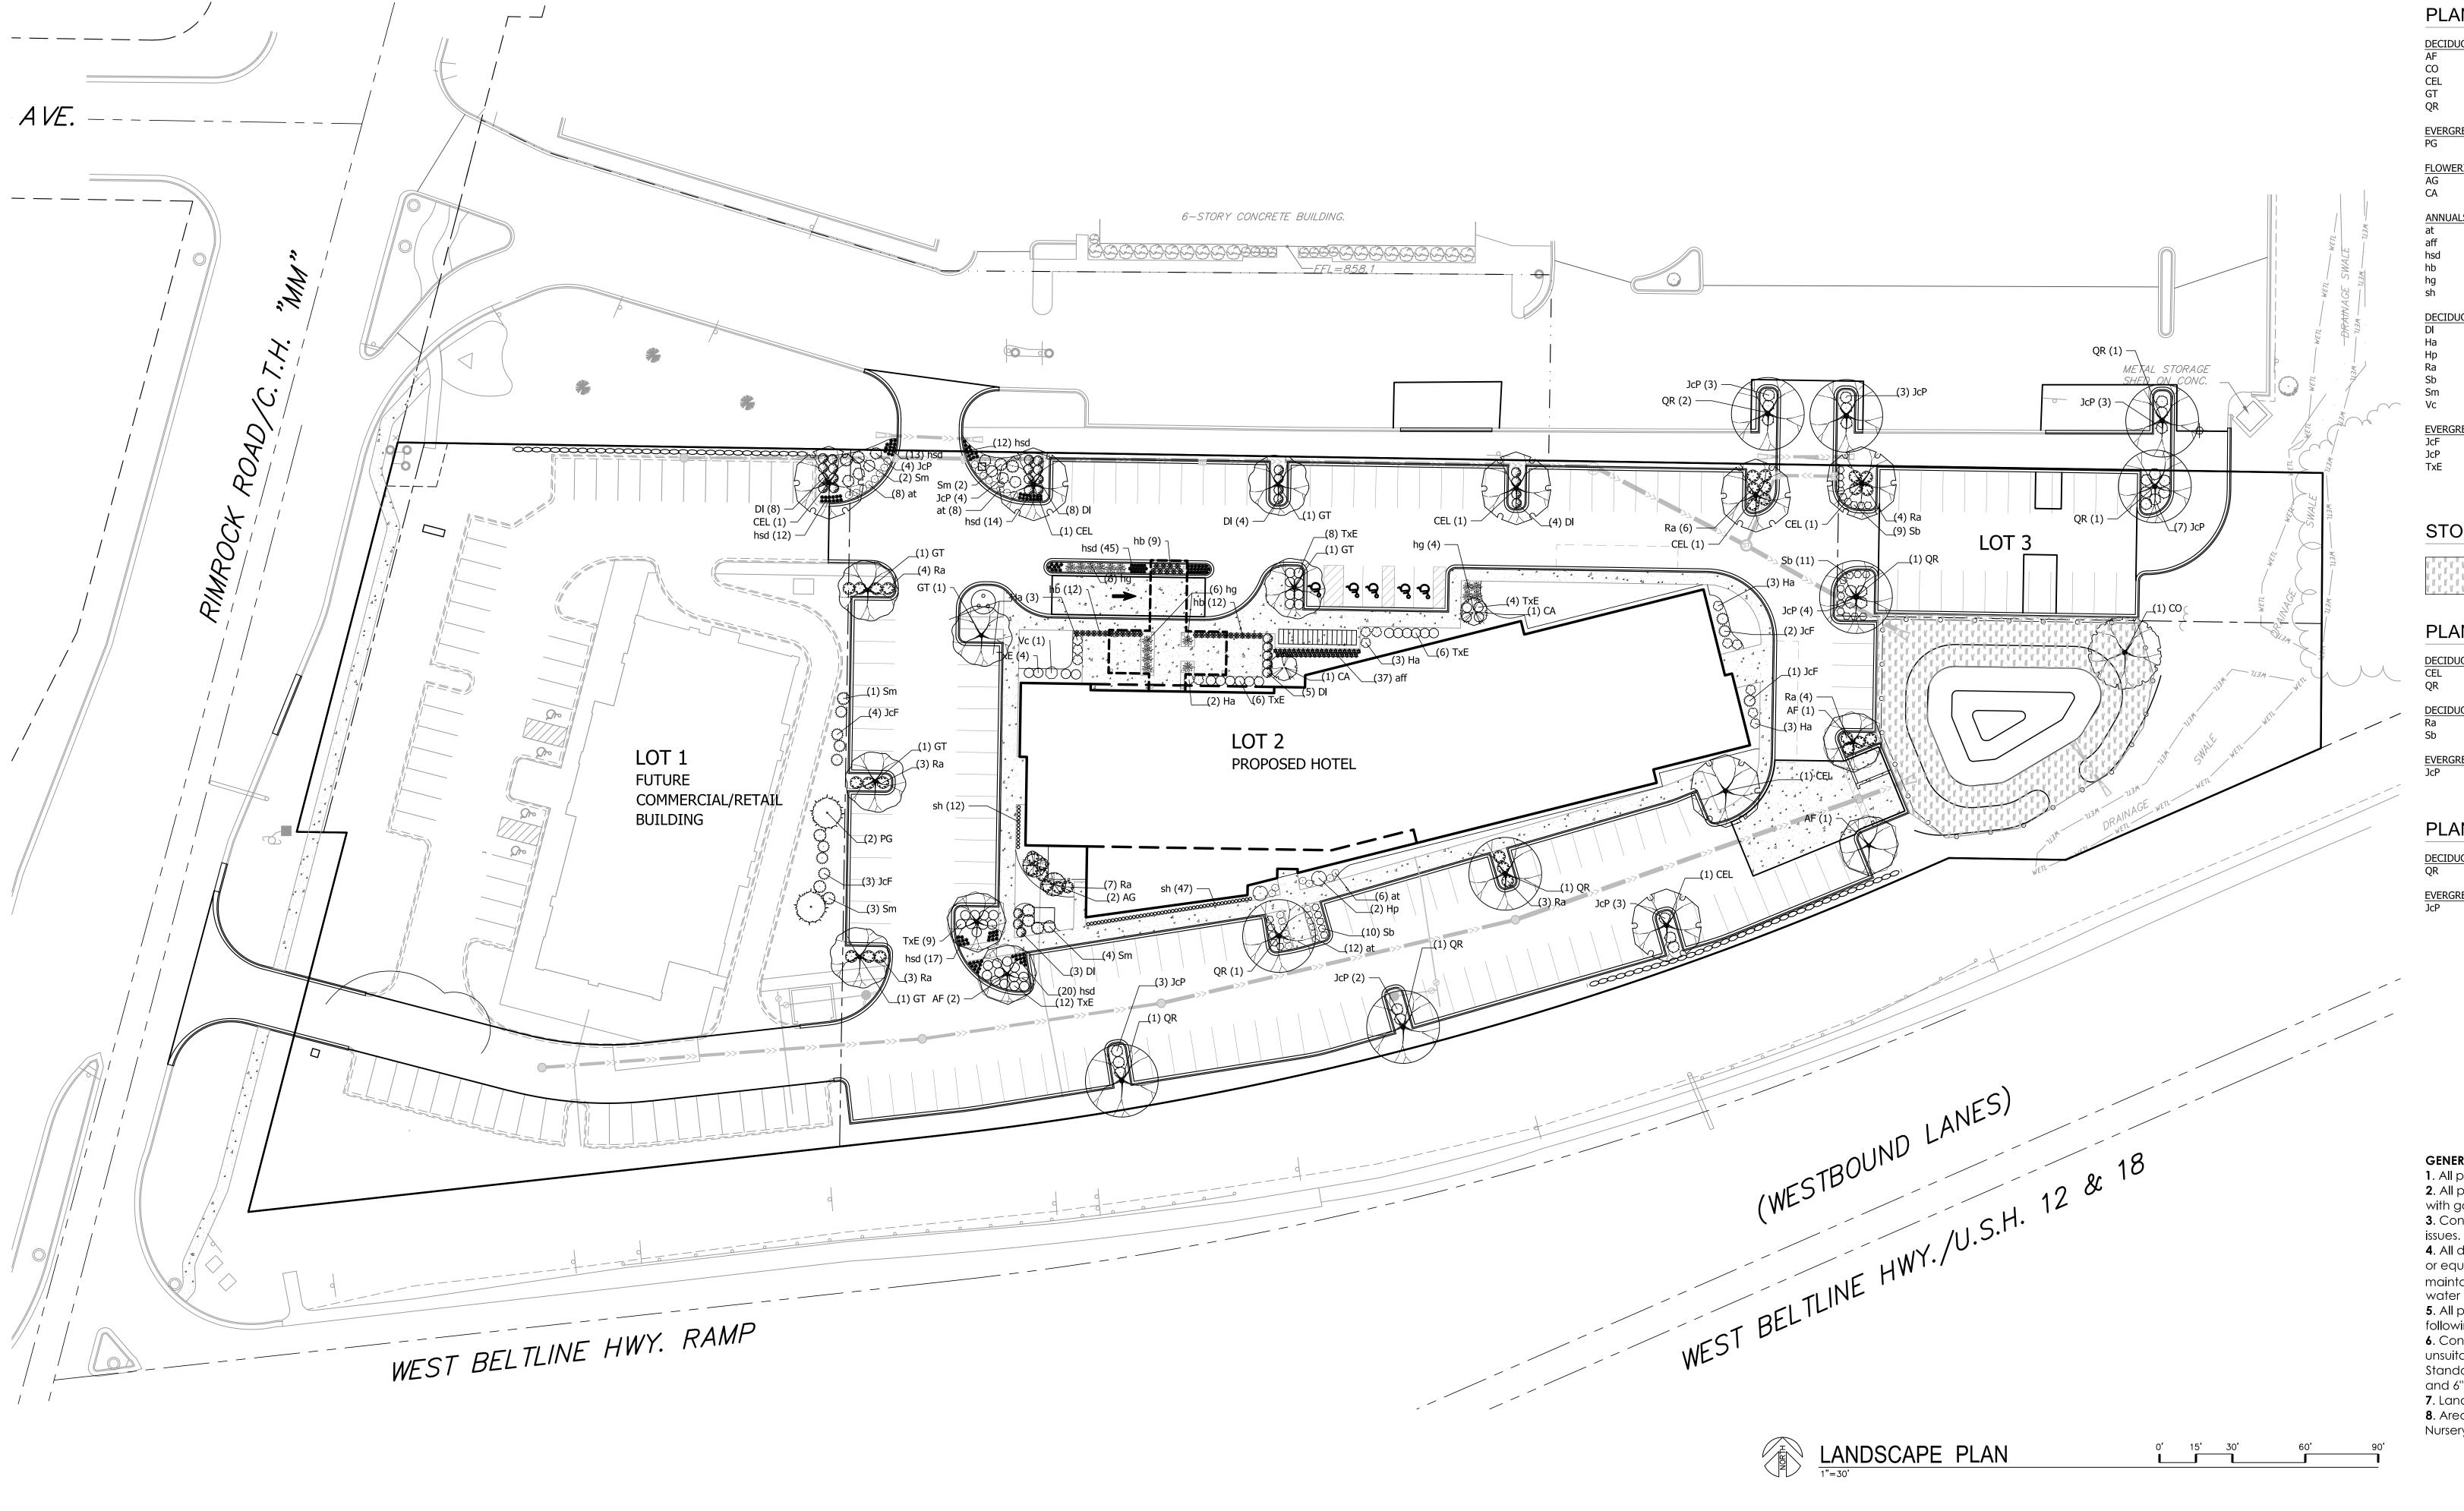

PLANT SCHEDULE LOT 2

PLANT SCHE	EDULE LOT 2				
DECIDUOUS TREES AF CO CEL GT QR	BOTANICAL NAME / COMMON NAME Acer freemanii `Celzam` TM / Celebration Maple Carya ovata / Shagbark Hickory Celtis occidentalis / Common Hackberry Gleditsia triacanthos inermis `Skycole` TM / Skyline Thornless Honey Locust Quercus rubra / Red Oak	CONT B & B B & B B & B B & B B & B	CAL 2"Cal 2"Cal 2.5"Cal 2.5"Cal 2.5"Cal	SIZE	QTY 4 1 6 6 4
EVERGREEN TREES PG	BOTANICAL NAME / COMMON NAME Picea glauca `Densata` / Black Hills Spruce	CONT B & B	CAL	SIZE 6`ht.	QTY 2
FLOWERING TREES AG CA	BOTANICAL NAME / COMMON NAME Amelanchier x grandiflora `Robin Hill` / Apple Serviceberry Cornus alternifolia / Pagoda Dogwood	CONT B & B B & B	<u>CAL</u> 1.5"Cal	SIZE 6` ht. multi stem	<u>QTY</u> 2 2
ANNUALS/PERENNIALS at aff hsd hb hg sh	BOTANICAL NAME / COMMON NAME Amsonia tabernaemontana `Blue Ice` / Blue Ice Star Flower Athyrium filix-femina / Common Lady Fern Hemerocallis x `Stella de Oro` / Stella de Oro Daylily Hosta x `Blue Cadet` / Plantain Lily Hosta x `Guacamole` / Plantain Lily Sporobolus heterolepis / Prairie Dropseed	SIZE 1 gal 1 gal 4" pot 1 gal 1 gal 1 gal 1 gal	FIELD2 Cont Cont Cont Cont Cont Cont	FIELD3	QTY 34 37 120 33 16 59
DECIDUOUS SHRUBS DI Ha Hp Ra Sb Sm Vc	BOTANICAL NAME / COMMON NAME Diervilla lonicera / Dwarf Bush Honeysuckle Hydrangea arborescens `Annabelle` / Annabelle Smooth Hydrangea Hydrangea paniculata `Limelight` TM / Limelight Hydrangea Rhus aromatica `Gro-Low` / Gro-Low Fragrant Sumac Spiraea x bumalda `Anthony Waterer` / Anthony Waterer Spiraea Syringa meyeri `Palibin` / Dwarf Korean Lilac Viburnum carlesii `Spice Island` / Korean Spice Viburnum	SIZE 3 gal 5 gal 5 gal 3 gal 3 gal 5 gal 5 gal	FIELD2 Cont Cont Cont Cont Cont Cont Cont Cont	FIELD3	QTY 32 14 2 30 10 12
EVERGREEN SHRUBS JcF JcP TxE	BOTANICAL NAME / COMMON NAME Juniperus chinensis `Fairview` / Fairview Juniper Juniperus chinensis `Pfitzerana Kallays Compacta` / Kally Pfitzer Compact Juniper Taxus x media `Everlow` / Yew	<u>SIZE</u> B & B 5 gal 3 gal	FIELD2 5`ht. Cont Cont	FIELD3	<u>QTY</u> 10 16 49

STORMWATER SEEDING LOT 2

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(()	ч	(()	11	(0)	N)	BASIC PRAIRIE SEED MIX	5 807 cf	
	W	n	W	11	10	DASIC I NAINIL SELD MIX	3,007 31	
, W , W	W	(0)	W	10	(0)	-		

PLANT SCHEDULE LOT 3

_	<u>DECIDUOUS TREES</u> CEL QR	BOTANICAL NAME / COMMON NAME Celtis occidentalis / Common Hackberry Quercus rubra / Red Oak	CONT B & B B & B	<u>CAL</u> 2.5"Cal 2.5"Cal	-
_	<u>DECIDUOUS SHRUBS</u> Ra Sb	BOTANICAL NAME / COMMON NAME Rhus aromatica `Gro-Low` / Gro-Low Fragrant Sumac Spiraea x bumalda `Anthony Waterer` / Anthony Waterer Spiraea	<u>SIZE</u> 3 gal 3 gal	FIELD2 Cont Cont	<u>(</u>
	EVERGREEN SHRUBS JcP	BOTANICAL NAME / COMMON NAME Juniperus chinensis `Pfitzerana Kallays Compacta` / Kally Pfitzer Compact Juniper	<u>SIZE</u> 5 gal	FIELD2 Cont	<u>(</u>

PLANT SCHEDULE EXISTING LOT

DECIDUOUS TREES QR	BOTANICAL NAME / COMMON NAME Quercus rubra / Red Oak	CONT B & B	<u>CAL</u> 2.5"Cal	
EVERGREEN SHRUBS JcP	BOTANICAL NAME / COMMON NAME Juniperus chinensis `Pfitzerana Kallays Compacta` / Kally Pfitzer Compact Juniperus	<u>SIZE</u> er 5 gal	FIELD2 Cont	-

GENERAL NOTES:

1. All plantings shall conform to quality requirements as per ANSI Z60.1.

2. All plant material shall be true to the species, variety and size specified, nursery grown in accordance with good horticultural practices, and under climactic conditions similar to those of the project site. 3. Contact Landscape Architect, in writing, to request and plant material substitutions due to availability

4. All disturbed areas, unless otherwise noted, to be seeded with Madison Parks Mix by Olds Seed Company or equivalent, per manufacturer's specified application rates. All seeded areas are to be watered daily to maintain adequate soil moisture for proper germination. After vigorous growth is established, apply $\frac{1}{2}$ " water twice weekly until final acceptance.

5. All plants shall be guaranteed to be in healthy and flourishing condition during the growing season following installation. All plant material shall be guaranteed for one year from the time of installation. 6. Contractor shall provide a suitable amended topsoil blend for all planting areas where soil conditions are unsuitable for plant growth. Topsoil shall conform to quality requirements as per Section 625.2(1) of the Standard Specifications for Highway Construction. Provide a minimum of 12" of topsoil in all planting areas and 6" of topsoil in areas to be seeded/sodded.

7. Landscape beds to be mulched with undyed shredded hardwood bark mulch to 3" depth min. 8. Areas labeled 'Basic Prairie Seed Mix' to be seeded with mix of same name from Cardno Native Plant Nursery per manufacturer specified application rates.

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PROJECT: DRAWN BY:

SCALE: AS NOTED LAND_USE_SUBMITTAL 11/20/2017 LAND_USE_RESUBMITTAL01/03/2018

LANDSCAPE

NOT FOR CONSTRUCTION

PLAN L101







vierbiche
planners | engineers | adviso

HOME 2 SUITES
RIMROCK ROAD
MADISON, WISCONSIN
CLIENT:
NORTH CENTRAL GROUP
c/o XYZ

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PROJECT: 201732

DRAWN BY: JGC
DATE:
SCALE: AS NOTE

LAND USE SUBMITTAL 11/20/17
LAND USE RESUBMITTAL 1/3/18

FIRE ACCESS F100

CALCULATION SUMMARY SUGGESTED CONTROL SEQUENCE:
 UNITS
 MIN
 AVG
 AVG/MIN

 FC
 0.3
 0.8
 2.9
 CALCTYPE PARKING LOT - PAVEMENT ILLUMINANCE POLE, BOLLARD AND BUILDING MOUNTED LUMINAIRES AUTOMATICALLY ON AT SUNSET. POLE, BOLLARD AND BUILDING MOUNTED LUMINAIRES AUTOMATICALLY OFF AT SUNRISE. POLE TYPE DISTRIBUTION KEY: 30'-0" TALL POLE WITH LED LUMINAIRE; IES TYPE 3 DISTRIBUTION BOLLARD TYPE DISTRIBUTION KEY: 42" TALL PATHWAY LIGHTING BOLLARD WITH SYMMETRICAL LIGHTING DISTRIBUTION. 0.0 0.0 0.0 0.1 0.1 0.1 0.2 0.2 0.2 0.2 0.4 0.7 1.1 1.2 1.2 1.1 1.0 0.8 0.7 0.5 0.3 SITE LIGHTING PLAN SCALE: 1" = 30'-0"

780 ELMWOOD AVE. STE. 204 MIDDLETON, WI 53562

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SUITES 2

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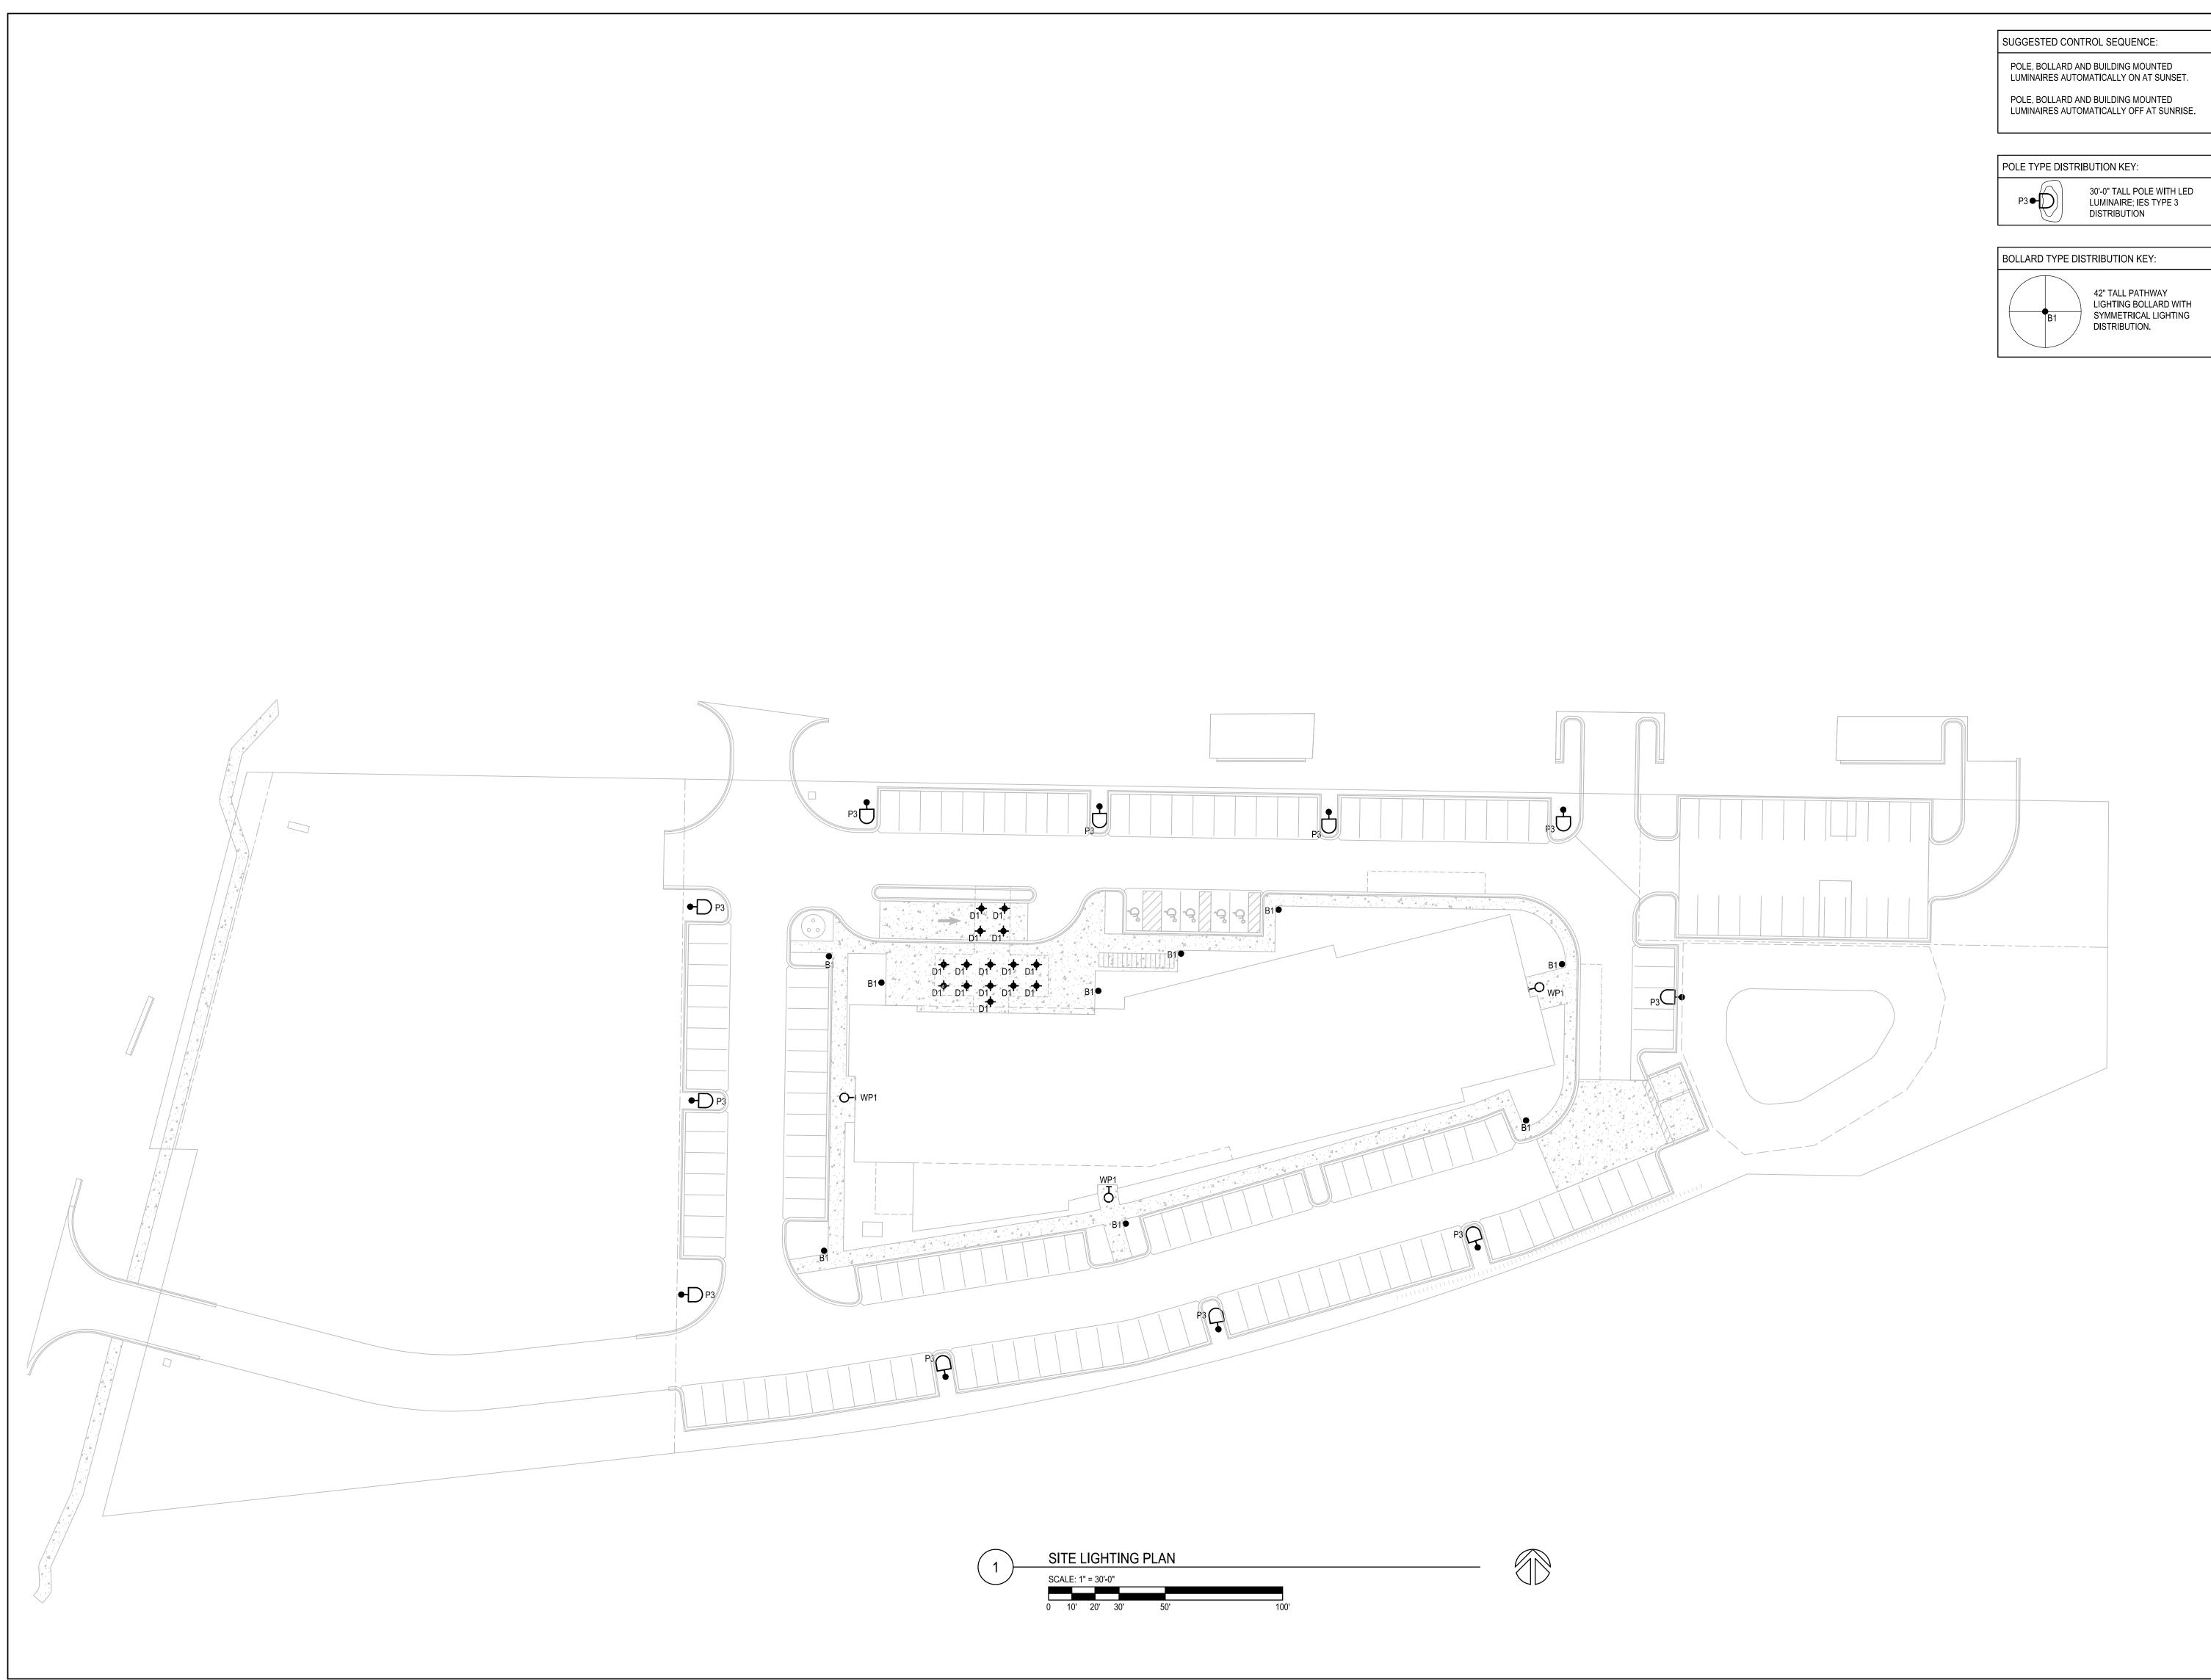
PROJECT: DRAWN BY: DATE: 01/3/18 SCALE: AS NOTED

LAND USE SUBMITTAL 11/20/2011

LAND USE RESUBMITTAL 12/01/2017

LAND USE RESUBMITTAL 1/03/2018

SITE LIGHTING **PLAN**



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 $\frac{PLAN}{E10}$

SITE LIGHTING

HOME 2 SUITES

RIMROCK ROAD
MADISON, WISCONSIN

CLIENT:
NORTH CENTRAL GROUP

c/o MADISON RIMROCK LODGING INVESTORS I, LLC
1600 ASPEN COMMONS, SUITE 200
MIDDLETON, WISCONSIN

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LAND USE SUBMITTAL 11/20/2011 LAND USE RESUBMITTAL 12/01/2011 LAND USE RESUBMITTAL 1/03/2018


01/3/18


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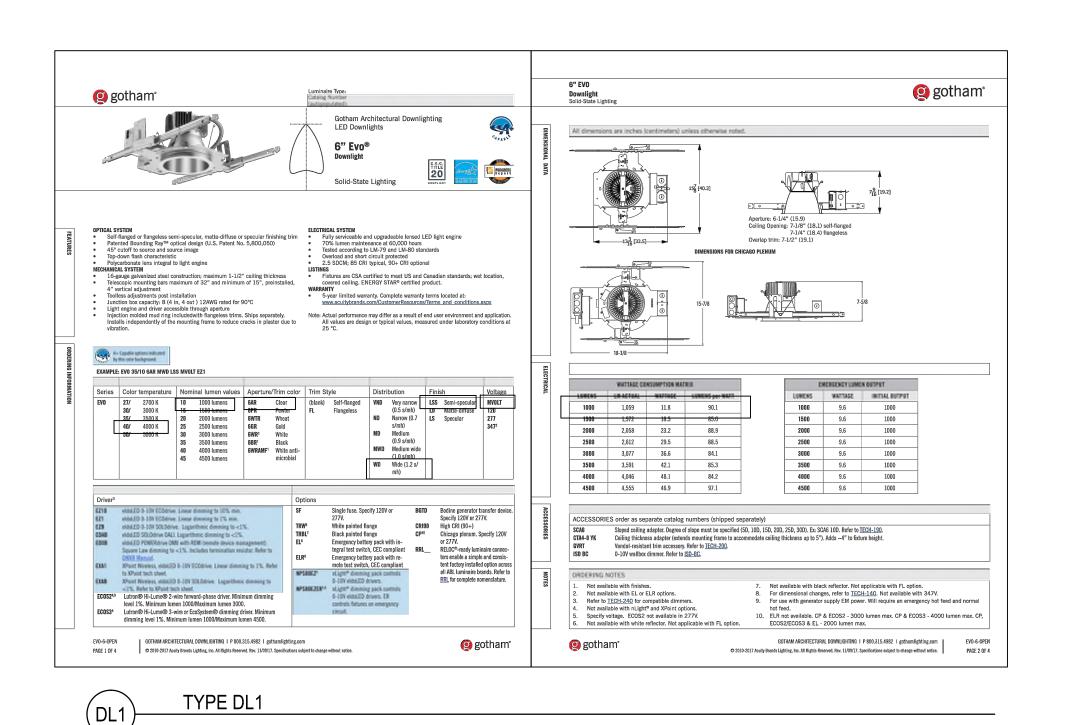
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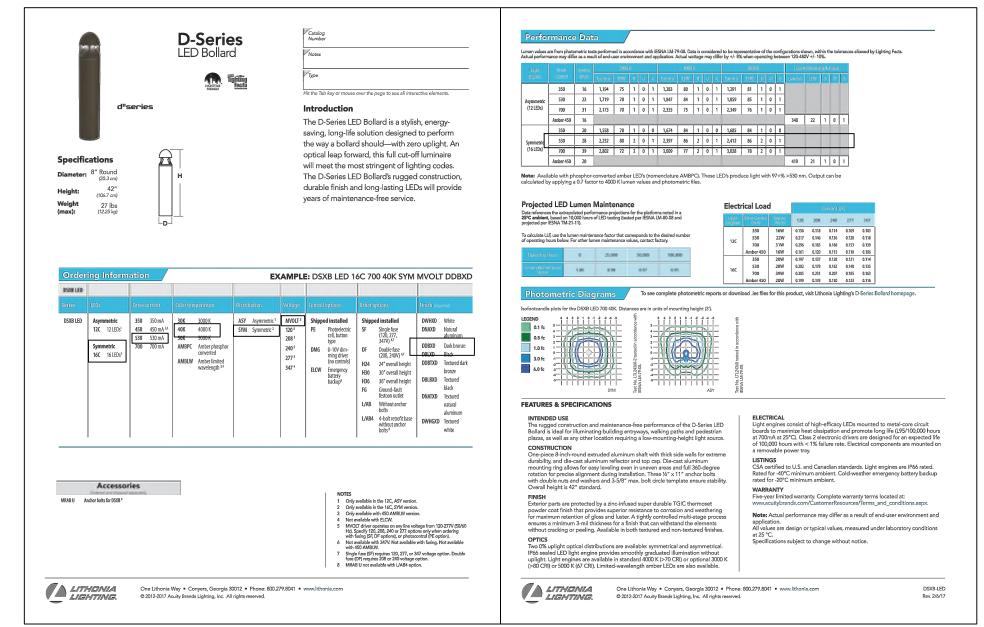
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SCALE:








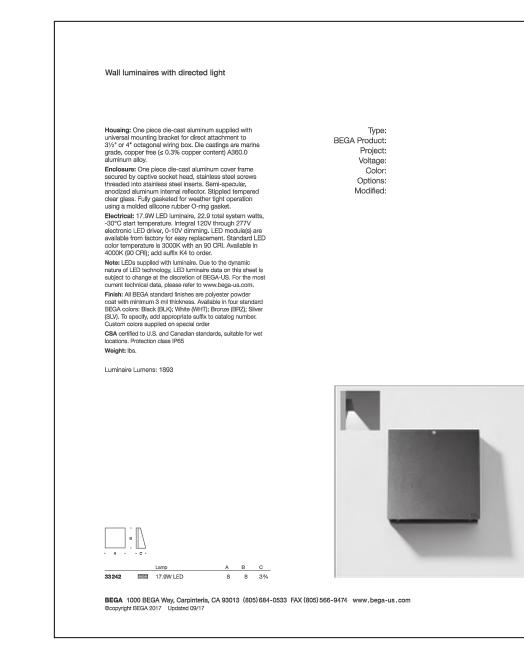

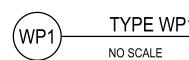TYPE B1 (B1 NO SCALE

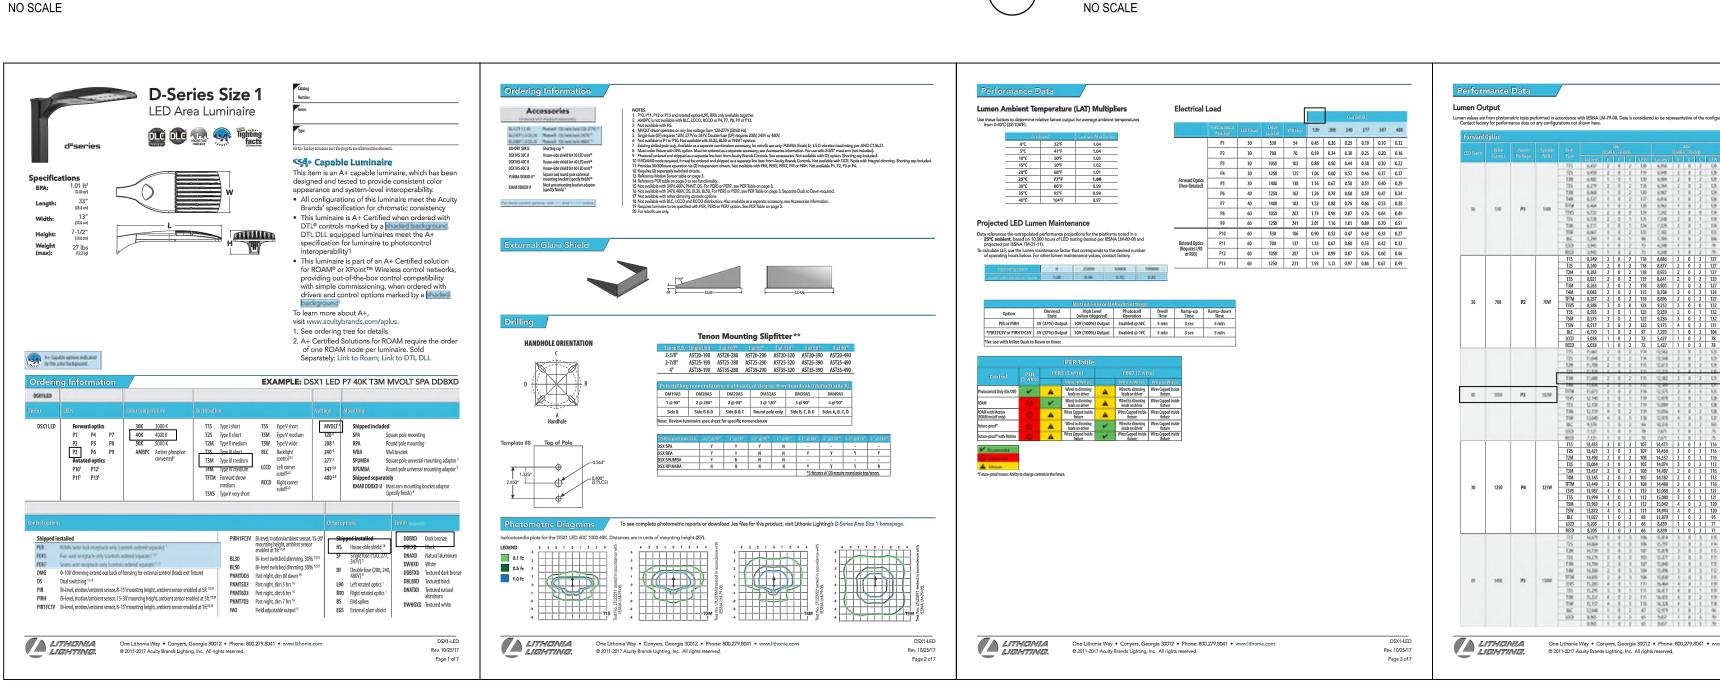

(P3 NO SCALE

TYPE P3

LUMINAIRES

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HOME 2 SUITES
RIMROCK ROAD
MADISON, WISCONSIN
CLIENT:
NORTH CENTRAL GROUP
c/o MADISON RIMROCK LODGING IN
1600 ASPEN COMMONS, SUITE 200
MIDDLETON, WISCONSIN

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PROJECT:

201732 DRAWN BY: DATE: 01/3/18 SCALE:

AS NOTED

LAND USE SUBMITTAL 11/20/2017


LAND USE RESUBMITTAL 12/01/2017 LAND USE RESUBMITTAL 1/03/2018

SITE LIGHTING

Rev. 10/25/17 Page 4 of 7





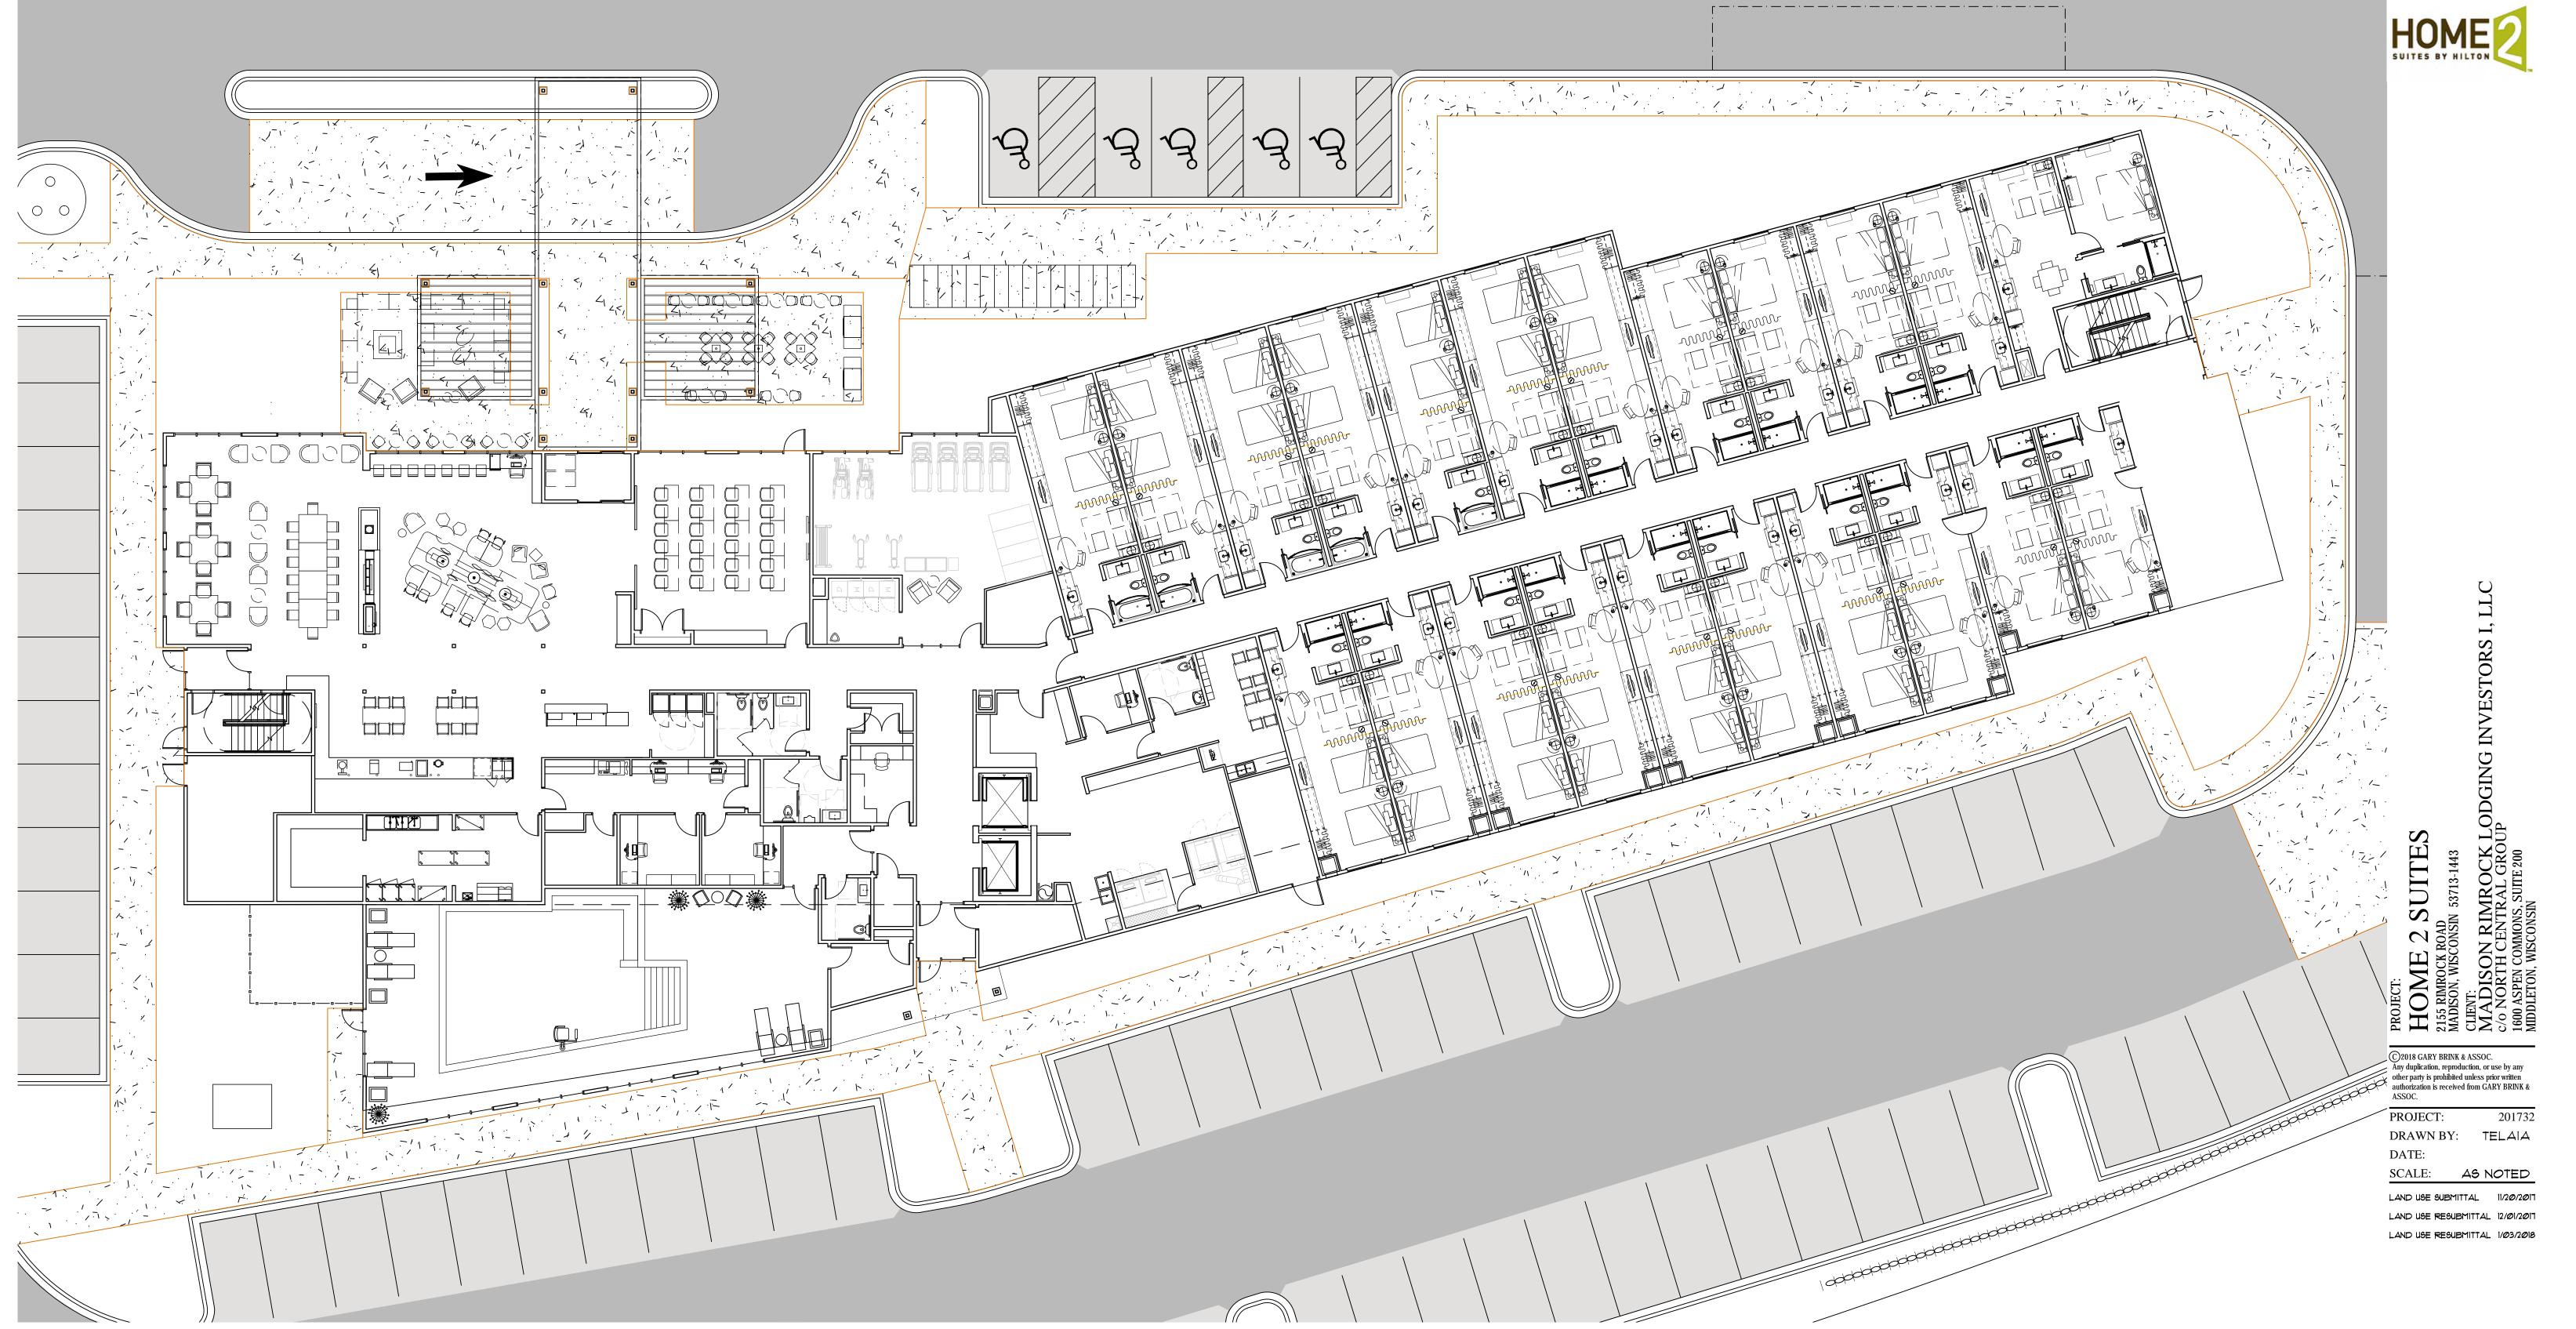

FIRST FLOOR PLAN O' 4' 8' 16'

SCALE: 3/32" = 1' 0'

FIRST FLOOR PLAN

A2.01









CLIENT:
MADISON RIMROCK LODGING INVESTC
c/o NORTH CENTRAL GROUP
1600 ASPEN COMMONS, SUITE 200
MIDDLETON, WISCONSIN HOME 2 SUITES
2155 RIMROCK ROAD
MADISON, WISCONSIN 53713-1443 © 2018 GARY BRINK & ASSOC.

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PROJECT:

DATE:


DRAWN BY: TELAIA

SCALE: AS NOTED

LAND USE SUBMITTAL 11/20/2017 LAND USE RESUBMITTAL 12/01/2017 LAND USE RESUBMITTAL 1/03/2018

201732

A2.02

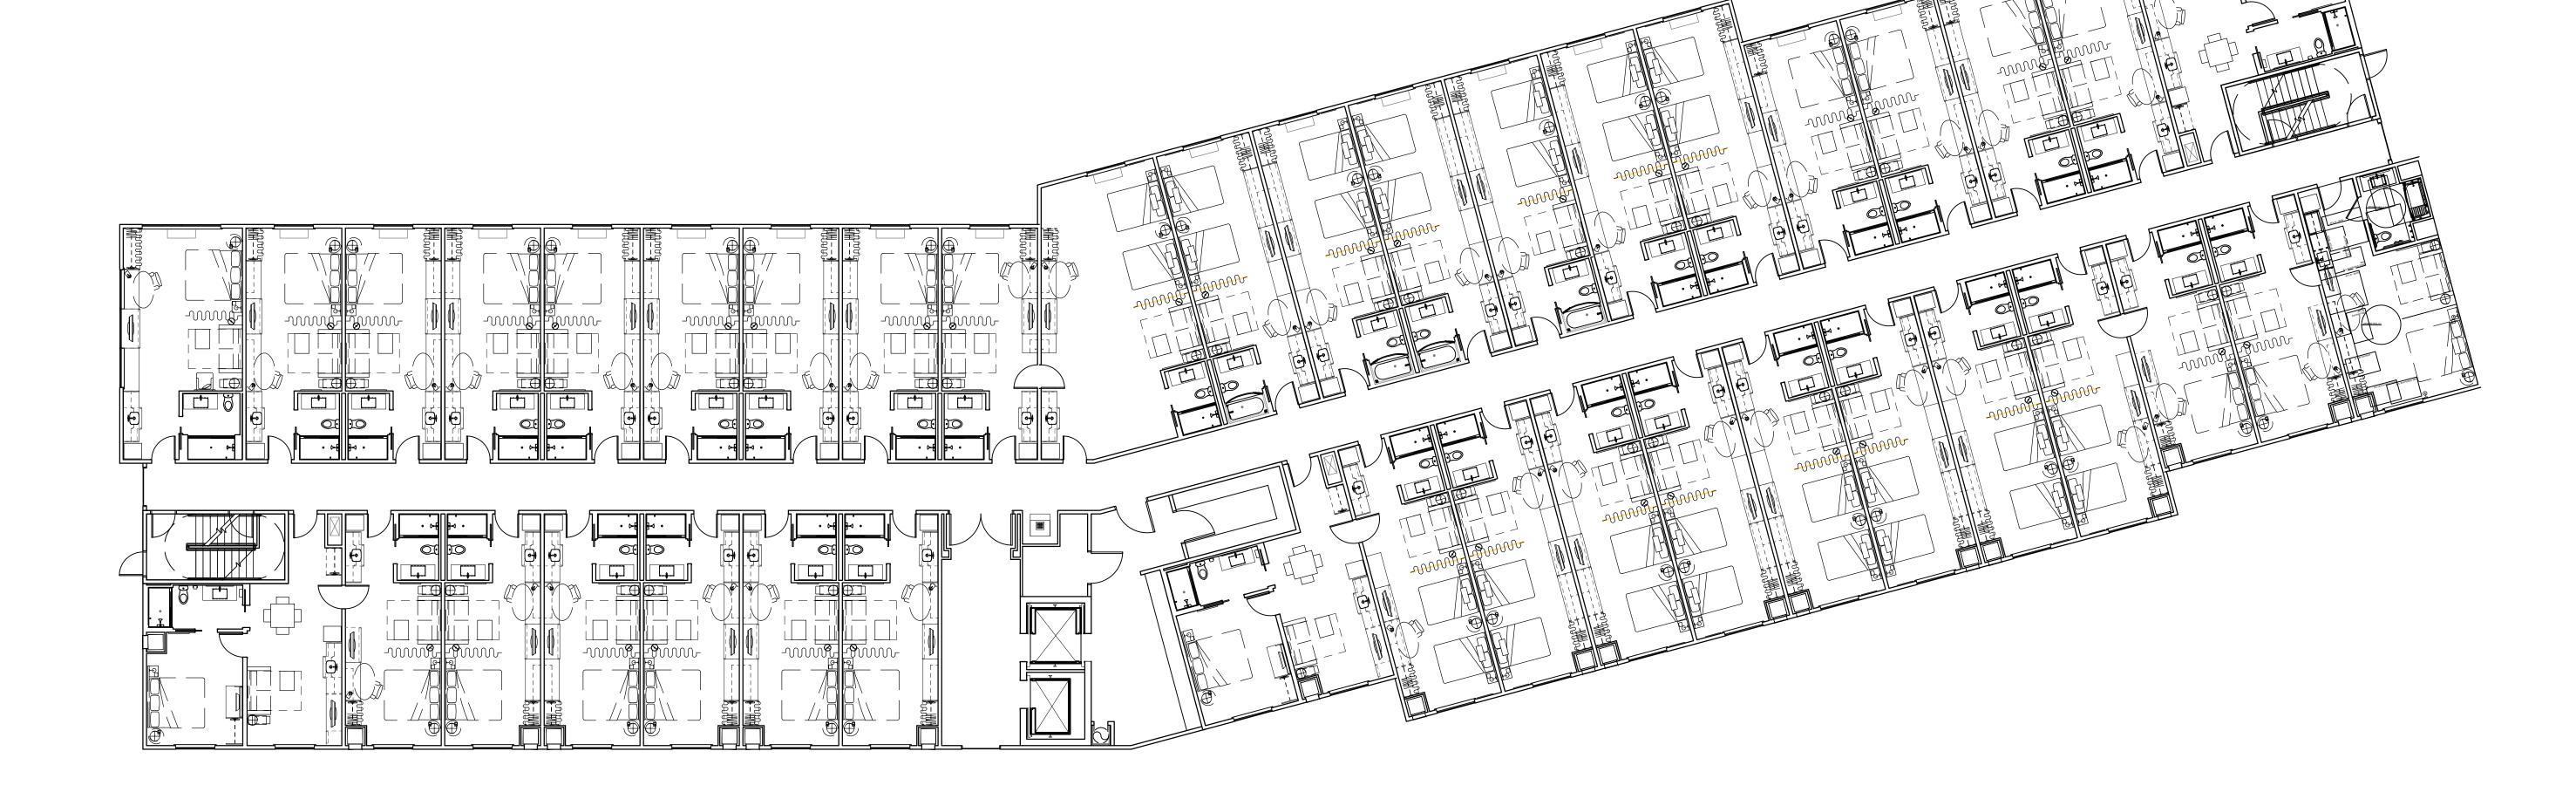

THIRD FLOOR PLAN 6' 4' 8' 16'

SCALE: 3/32' = 1' 0'

2155 RIMROCK KUAL
MADISON, WISCONSIN 53713-1443
CLIENT:
MADISON RIMROCK LODGING INVESTOR;
c/o NORTH CENTRAL GROUP
1600 ASPEN COMMONS, SUITE 200
MIDDLETON, WISCONSIN HOME 2 SUITES
2155 RIMROCK ROAD
MADISON, WISCONSIN 53713-1443


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PROJECT: 201732 DRAWN BY: TELAIA DATE:

SCALE: AS NOTED LAND USE SUBMITTAL 11/20/2017

LAND USE RESUBMITTAL 12/01/2017 LAND USE RESUBMITTAL 1/03/2018

> THIRD FLOOR PLAN A2.03

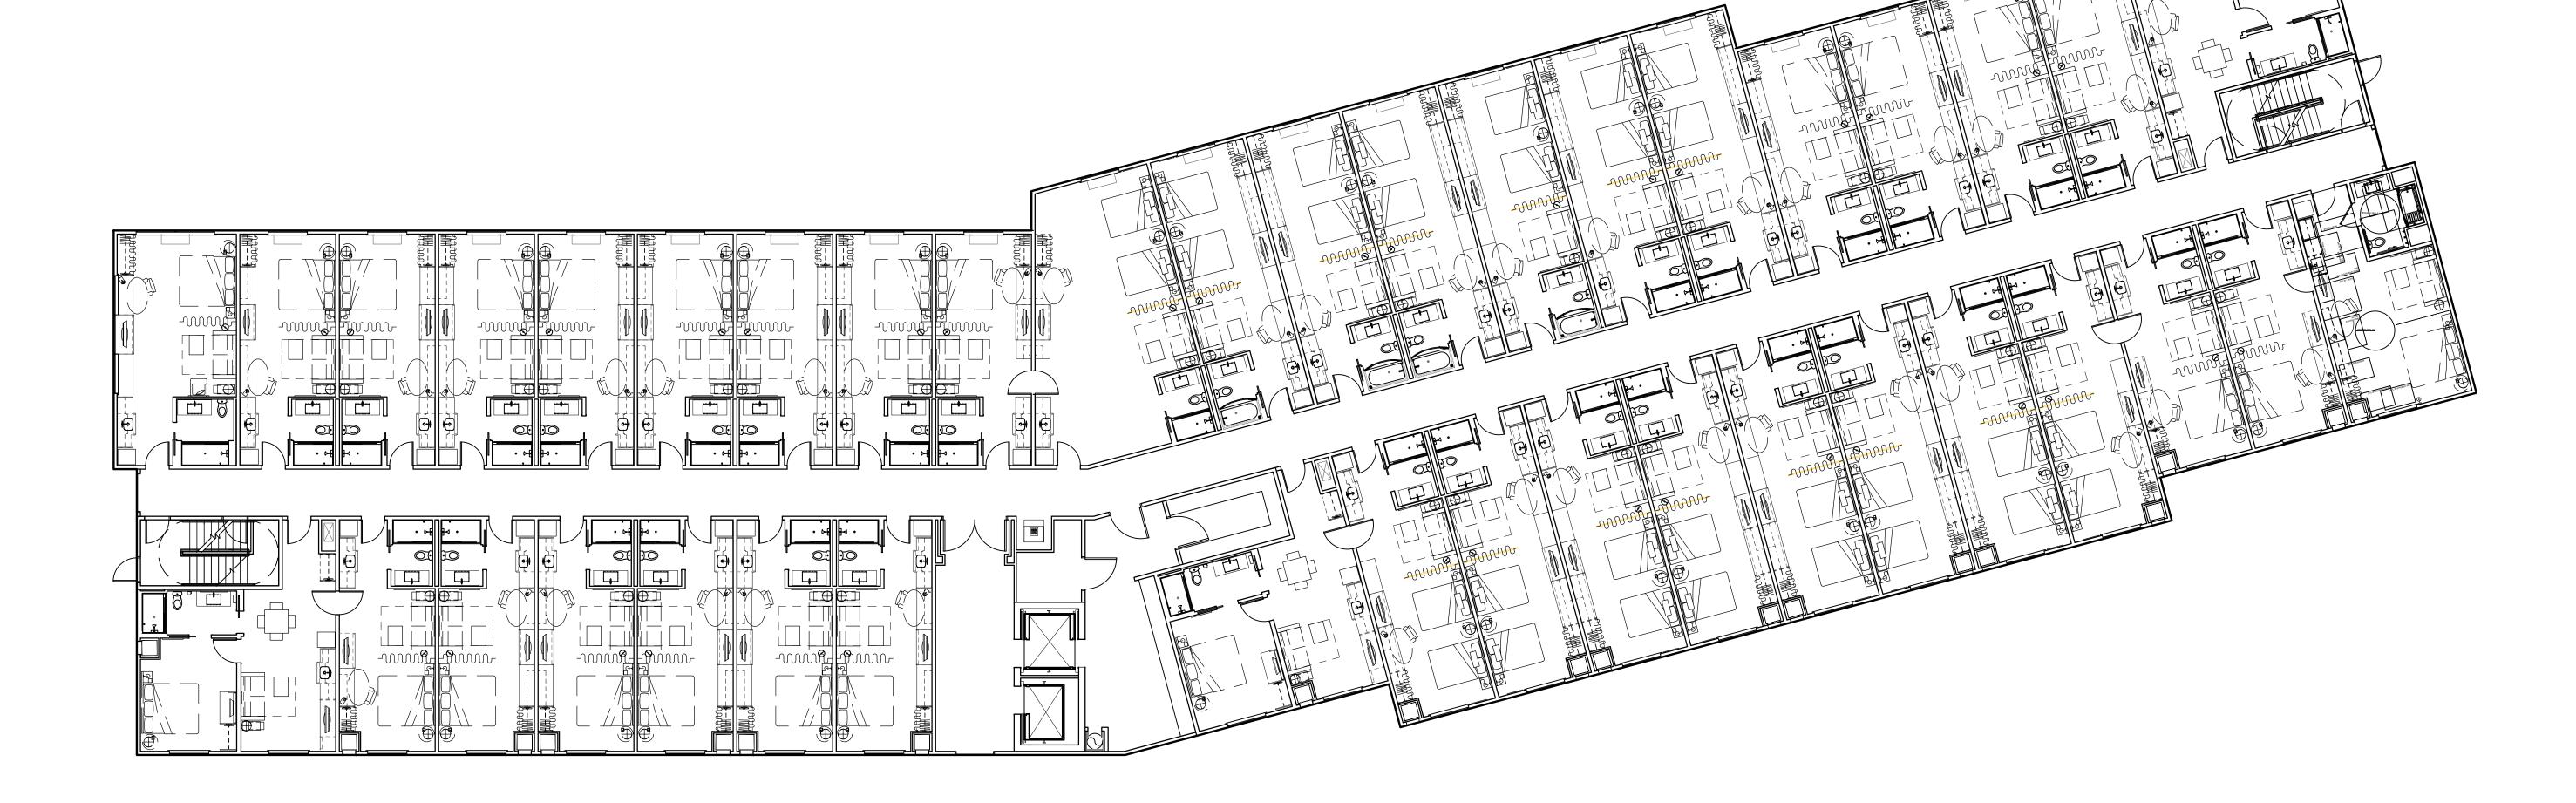

HOME 2 SUITES
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MADISON, WISCONSIN 53713-1443
CLIENT:

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PROJECT: 201732 DRAWN BY: TELAIA DATE:


SCALE: AS NOTED

LAND USE SUBMITTAL 11/20/2017

LAND USE RESUBMITTAL 12/01/2017 LAND USE RESUBMITTAL 1/03/2018

FOURTH FLOOR PLAN

A2.04

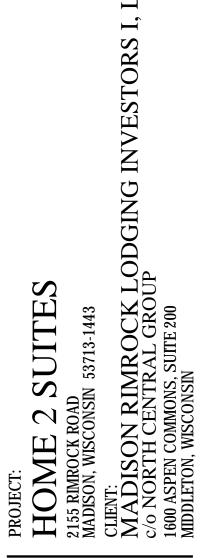

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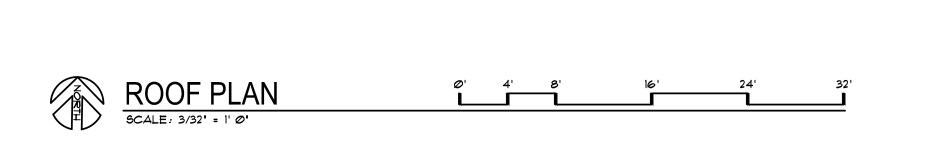
PROJECT: 201732 DRAWN BY: TELAIA DATE:

SCALE: AS NOTED LAND USE SUBMITTAL 11/20/2017

LAND USE RESUBMITTAL 12/01/2017

LAND USE RESUBMITTAL 1/03/2018

ROOF PLAN









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SU	TES	HIL	TON	

	PARAPET VARIES
HOME 2 SUITE BY HILTON	4TH FLOOR 35'-0"
	3RD FLOOR 24'-@"
	2ND FLOOR
	16T FLOOR

EAST ELEVATION

SCALE: 3/32' = 1'-Ø'



MATERIAL IMAGE	MATERIAL DESCRIPTION
	EIFS-1: Sandpebble dryvit
	Metal-1: Charcoal Grey Berridge
	Wood-1: Hazlenut Nichiha
	Brick-1: Dark Iron Spot Smooth County Materials Corporation
	Windows: Clear Glass w/ Dark Bronze Frame
	Beacon: Design Concept

PROJECT:
HOME 2 SUITES
2155 RIMROCK ROAD
MADISON, WISCONSIN 53713-1443

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DRAWN BY:

SCALE: AS NOTED

LAND USE SUBMITTAL 11/20/2017 LAND USE RESUBMITTAL 12/01/2017 LAND USE RESUBMITTAL 1/03/2018



HOME SUITES BY HILTON




NORTH ELEVATION

SCALE: 3/32" = 1'-0"



PARAPET VARIES




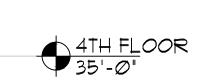







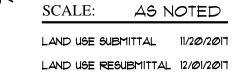

HOME 2 SUITES
2155 RIMROCK ROAD
MADISON, WISCONSIN 53713-1443
CLIENT:
MADISON RIMROCK LODGING INVESTORS
c/o NORTH CENTRAL GROUP
1600 ASPEN COMMONS, SUITE 200
MIDDLETON, WISCONSIN

201732

LAND USE RESUBMITTAL 1/03/2018

SOUTH ELEVATION SCALE: 3/32" = 1'-0"

BUILDING **ELEVATIONS**











PROJECT:
HOME 2 SUITES
2155 RIMROCK ROAD
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CLIENT:
MADISON RIMROCK LODGING INVESTOR
CLIENT:
MADISON RIMROCK LODGING INVESTOR
c/o NORTH CENTRAL GROUP
1600 ASPEN COMMONS, SUITE 200
MIDDLETON, WISCONSIN

PROJECT: DRAWN BY:

DATE:

SCALE: AS NOTED

LAND USE SUBMITTAL 11/20/2017

LAND USE RESUBMITTAL 12/01/2017

LAND USE RESUBMITTAL 1/03/2018