Location 1010-1018 Mayfair Avenue

Project Name

Madison Mayfair Apartments Accessory Building

Applicant


Madison Mayfair Apartments LLC / George and Catherine Knuckey

Existing Use Apartment

Proposed Use

Construct accessory building for apartment complex of 800 sqft in SR-V2 zoning

Public Hearing Date Plan Commission 16 October 2017

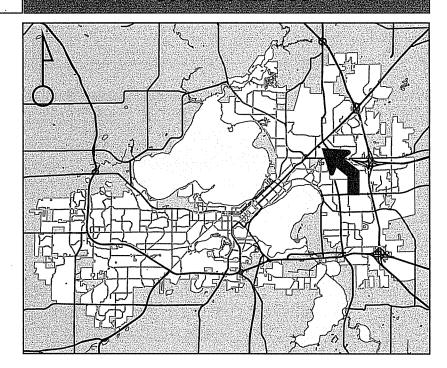


For Questions Contact: Chris Wells at: 261-9135 or cwells@cityofmadison.com or City Planning at 266-4635



Scale: 1" = 400'

City of Madison, Planning Division: PPE: Date: 9 Oct 2017



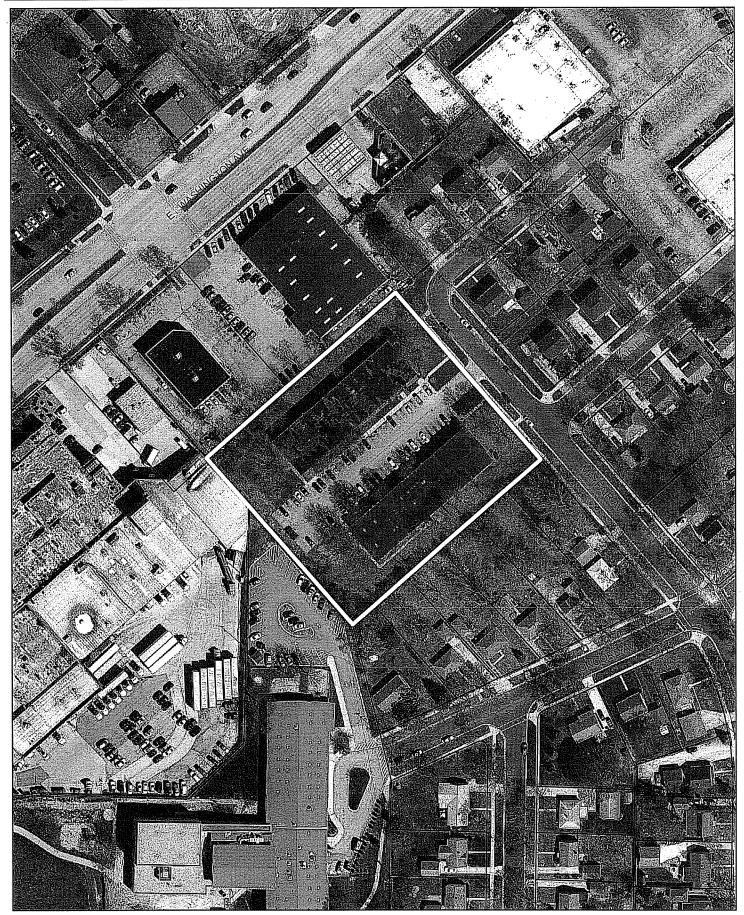

Date of Aerial Photography: Spring 2016

City of Madison



FOR OFFICE USE ONLY: Planning Division Receipt # 126 S. Hamilton St. P.O. Box 2985 Date received Madison, WI 53701-2985 Received by (608) 266-4635 810-324-0407-2 Parcel # Aldermanic district Zoning district All Land Use Applications must be filed with the Zoning Office at the above address. Special requirements This completed form is required for all Review required by applications for Plan Commission review except UDC PC subdivisions or land divisions, which should be filed using the Subdivision Application found on **Common Council** Other the City's web site. Reviewed By LNDUSS - 2017 -1. Project Information Avenue, Madison, W153714 Address: Title: 2. This is an application for (check all that apply) ☐ Zoning Map Amendment (rezoning) from ____ ☐ Major Amendment to an Approved Planned Development-General Development Plan (PD-GDP) Zoning ☐ Major Amendment to an Approved Planned Development-Specific Implementation Plan (PD-SIP) ☐ Review of Alteration to Planned Development (PD) (by Plan Commission) Conditional Use or Major Alteration to an Approved Conditional Use **Demolition Permit** Other requests 3. Applicant, Agent and Property Owner Information eorge & Catherine company Madison May tair Abart ment pt 10 City/State/Zip Sun Prairie, W153590 Street address Email Kruckey, catherine Egmail, com Telephone Kruckey Company Madison Mayfair Apartments, L Project contact person Street address 245 S. Bic d Email Krucker, cathering Camailicor Telephone

Property owner (if not applicant) City/State/Zip _____ Street address Telephone Email

LETTER OF INTENT – 1010 Mayfair Avenue and 1018 Mayfair Avenue, Madison, WI

George and Catherine Knuckey, Owners of Madison Mayfair Apartments, LLC

August 29, 2017

As owners of 1010 and 1018 Mayfair Avenue, Madison, WI we are seeking to construct a $30' \times 40'$ building that will allow us to keep our lawn mowing equipment, ladders, tools and Skid Steer for snow removal. The layout of our interior apartment buildings do not allow for large items to be stored in the basement. The stairs are narrow and we cannot get ladders for the roof and other larger items into the basement. We have taken apartment 1018 Mayfair Avenue, Apartment 1, Madison, WI as our apartment to use and stay at. We do all of our own work (including repairing apartments and exterior repair and maintenance). We do not hire others for lawn care or snow removal. We own our own equipment and have been storing it at another site. This is costly and very inconvenient.

The existing site for the building is located in the rear of the property on a level yard. There would be very little excavation of the dirt on the job site. Mainly just a little leveling of the existing dirt for the actual building. There should be no need to bring in any dirt. The foundation will be: Foundation and Footings.

The gross square footage of the building is 1,200 sq. ft. (30' x 40'). Mr. David Ahrens has given approval for a conditional use building (storage garage) that is 1,200 sq. ft. - See email that is enclosed. The color of the building will be as close to the color of our existing brick building (tan/cream color) with the trim to be a dark grey. The surrounding neighboring buildings are also this tan/cream color. Our building should blend in with the neighborhood.

Our plan is to start the foundation work in the month of October, 2017. The actual building will be constructed around the 1st week of November, 2017. It is estimated that the actual building construction will take 2 weeks.

We would not be adding any employees. We manage and care for our apartments ourselves along with our Son, Watthew Knuckey.

Building 1010 Mayfair Avenue has 24 apartments and Building 1018 has 26 apartments.

Hours of Operation: Always on Call.



(1/80EY

City Of Madison

Building Plan Approval

Application


Department of Planning & Economic & Community Development
Inspection Division
126 S, Hamilton St.
Madison WI 53703
P.O. Box 2984 (zip code 53701-2984)
(608) 266-4551 Fax (608) 266-6522

Instructions: Fill in all applicable data. Submittal of this plan approval Application form is required with each plan submittal, with a minimum of two sets of plans. SUBMIT PLUMBING PLANS SEPARATELY, ACCOMPANIED BY AN APPLICATION FORM.

minimum of two sets of	pians. SUBMIT P	LUM	DING PLANS SEPARATI	ELY, ACCOME	'ANIED BY AN APPLICA'	ΓΙΟΝ FORM.
1. Occupancy ty	pe		2. Project inform		3. Type of submittal	
Check all that	Circle sub u	se	Project Address		X Project type	Review type
apply			1010 and 1018 Maytair		(New	() Foundation
() A. Assembly A1 A2 A3 A4		A5	Ave, Madison, WI			only
() B. Business			Tenant or occupa	nt name	level 1 2 3	() Building
() E. Education	schôol dayc	are	Madison May	Fair Ants	() Addition	() HVAC
() F. Factory	F1 F2		LLC - George	V	() Repair	Truss
() H. Hazardous	H1 H2 H3 H4	H5 .	Lles a building and	nnucke	Y	() Precast
() I. Institutional	11 12 13 14		Has a building cod		() Revision to	() Metal
() M. Mercantile	D4 D0 D0 F		been applied for?	Yes No	previously	building
() R. Residential	R1 R2 R3 F	4			approved plan	() Antenna /
() S. Storage	. S1)S2		Variance approval	number:	() Capacity only	Tower
W U. Utility				<u> </u>	-	
Brief project desc	cription					,
						n, " 1
4. Project designe			HVAC designer		6. Building owner	, a pt lag a
Designer	Reg. #	De	signer	Reg. #	Company name Madison May	D A 1
KARL LEMMENES			*		Madison Max	tair/tps, LL
Design Firm	4	De	sign Firm	17 77	Name	
CLEARY BUILDING	Cers				George Cath	erine Knuc
Address		Add	dress .		Address	
PO Bx 930220				a	1018 Maytair	Aue. Apti
City/state/zip code	53593	City	City/state/zip code City/state/zip code		7,4	
VERONA WI -	343		Modison, W153714		153714	
Contact person	703	Cor	Contact person Contact person			
KARL LEMMENES			, 11.0g		George Kni	ickey
Telephone Number (66%)) QUS A710	Tele	Telephone Number () Telephone Number (8/5) 29			
email	517 1100	ema			email ,	091-0319
KHERMEN W. GMA	12,60m			\ \{ \}	Krinckeyicat	herine Pamo
7. Class Of Constr	ruction	8. E	Building informatio	n Č	atherine knuck	A O
			al stories of building a		() Complete Sprinkle	
() IA () IB					() Partial Sprinkler	()10 ()1011
() IIA () IIB		Tota			explain:	
() IIIA () IIIB			e on:			
() IV		Floo	or: Area:/2	sq. ft.	() Unlimited Area	
() VA (√) VB		Floo	or: Area:	sq. ft.	If areas are separated by fire barriers	
, , , , , , , , , ,			or: Area:	sq. ft.	or firewalls give the re	ason for the
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		Floc	or: Area:	sq. ft.	p mastrix	
and the second			or: Area:	sq. ft.		
to a gray 🛎 or		F100	or: Area:	sq. ft.		a a
. Building permit i	information					
Building contractor (fo		2)	· H//^C	Contractor /	for HVAC plans)	
Sanda South Gotor (10	i building plan	-)	IIVAC	Contractor (ioi rivao pians)	·
stimated Cost: For	alterations de	not	include HVAC, plumb	ing or electri	ical costs	
lew/addition: (total) \$			ation: (no MEP) \$	ing, or electi	New Parking Lot: \$	
			σιοτή (πο will) ψ		THEW FAIRING LOL. \$	

outside face of columns where there is no mezzanines, balconies, lofts, garages, all The area of alterations includes all areas The minimum fee for any review other	o wall. The area I stories, and all affected by the	a includes all flo l roofed over are alteration on bo	oth sides of any new or moved walls.
New Buildings and Additions.	o f	Φ.	
Building Area HVAC Area	s.f \$0.03/s.f.	\$	For Office Use Only Date
	5.1 \$0.02/5.1.	Φ	
Alterations to Existing Buildings Building Area	s.f \$0.04/s.f.	\$	<u>Fees Collected By</u> ☐ C/O Req. ☐ Zoning
HVAC (Separate Submittal only)	s.f \$0.03/s.f.	\$	_
Structural (Separate Submittal only) \$50 per component		\$	
Revisions to previously reviewed plans	. \$100	. `\$	
State Administrative Fee (see schedule)	·	\$	When applicable
Other		\$	
	Total	\$	round up to nearest whole dollar
preparation of the plans to the best of his of Buildings for this submittal. If the total volume of the building is less the building is: () less than 50,000 cubic feet Supervising Professionals Signature the submittal will be rejected. 11. Supervising Professional's Statem per SPS. 361.40 for the performance or seconstruction is in substantial compliance of construction, I will file a written statement.	than 50,000 cm () 50,000 cm () than 50,000 cm ()	e to comply with ubic feet no signature feet or greater retained by the reasonable on the ved plans and of Madison Newsconstruction has	ruildings greater than 50,000 cubic feet or the owner as the supervising professional the observations to determine if the
Supervising Professional Signature	, , , 1 2 2	()	Building () HVAC Registration #
Print Name	. v		Building () HVAC Registration #
Supervising Professional Signature N/A		()	Building () HVAC Registration #
Print Name		,	
		5	
12. Designer of record to complete this manufactured metal buildings. Please : The Department of Safety & Professional Services expectompliance with the general design concept. The project the codes as they apply to their designs. Components Signature of Building Designer of Record	section only to submit only co ects and requires, to to designer, and de include such things	or component one set of pla hat the project design partment, will rely of as trusses, precast	submittals such as trusses, precast, and ns and calculations for components. gner review individual component submittals for n the seal of the component designers for compliance with t, and manufactured metal buildings. Date Signed
N/ft	<u> </u>		

Building Colors

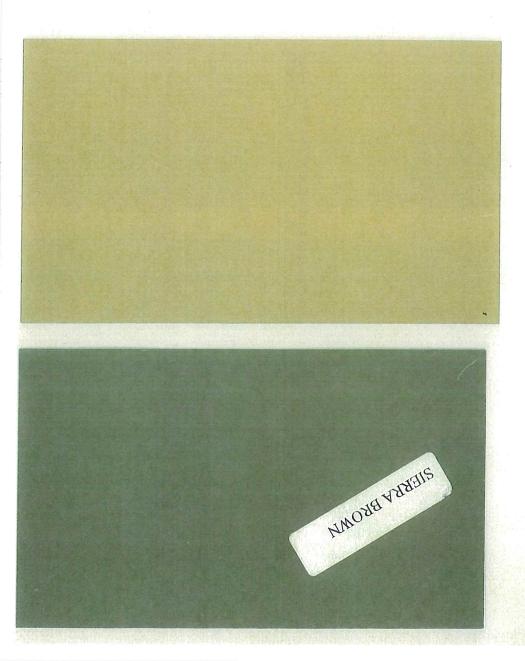

LETTER OF INTENT – 1010 Mayfair Avenue and 1018 Mayfair Avenue, Madison, WI

George and Catherine Knuckey, Owners of Madison Mayfair Apartments, LLC

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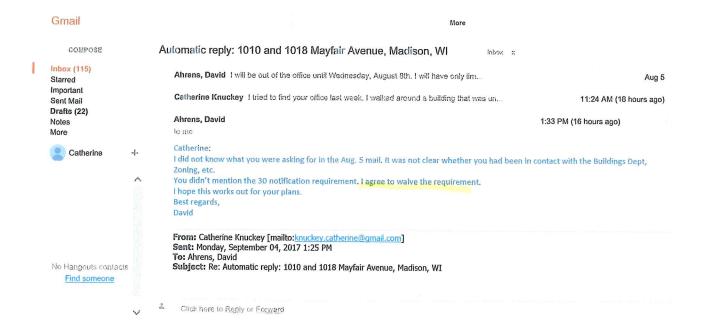
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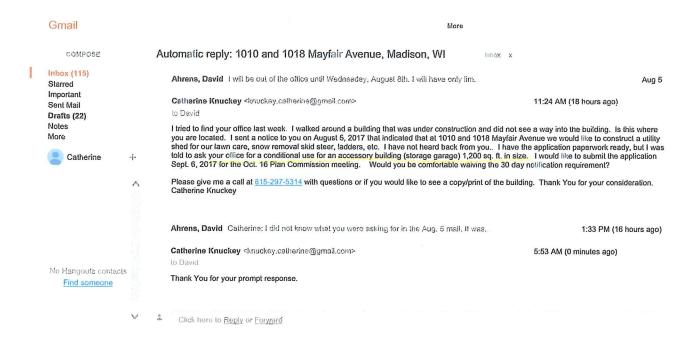
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Building 1010 Mayfair Avenue has 24 apartments and Building 1018 has 26 apartments.

Hours of Operation: Always on Call.







Catherine Knuckey <knuckey.catherine@gmail.com>

1010 and 1018 Mayfair Avenue, Madison, WI

1 message

Catherine Knuckey <knuckey.catherine@gmail.com> To: jsms098@att.net Sat, Aug 5, 2017 at 7:55 AM

George and Catherine, owners of 1010 and 1018 Mayfair Avenue, Madison, WI, would like to construct a 30' x 40' utility building on the back portion of this property. The utility building would be used for our skid steer, lawn equipment, ladders, etc. We do not hire outside help to maintain the buildings. We do our own renovations, snow removal, lawn care, etc. and we need a place for our equipment. We are currently almost finished with renovations to 1018 Apartment 1 for our office and home while we are here. Usually Tuesday thru Saturday. Thank You for your consideration.

Catherine Knuckey 815-297-5314 and George Knuckey 815-297-2579



Catherine Knuckey <knuckey.catherine@gmail.com>


1010 and 1018 Mayfair Avenue, Madison, WI

1 message

Catherine Knuckey <knuckey.catherine@gmail.com>
To: district15@cityofmadison.com

Sat, Aug 5, 2017 at 7:45 AM

George and Catherine, owners of Madison Mayfair Apartments, LLC, would like to construct a 30' x 40' commercial garage on the property. This garage would be located in the rear of the property and would store our snow removal equipment (skid steer), lawn mower, ladders, and other tools necessary to maintain the property. Thank You for your consideration. We are currently in the process of completing an apartment (1018-1) that we will be using as our office and home while we are in Madison. Generally we are here Tuesday thru Saturday. I will be forwarding a message to Diane Calhoun and Jackie Shivers. Catherine Knuckey 815-297-5314 George Knuckey 815-297-2579

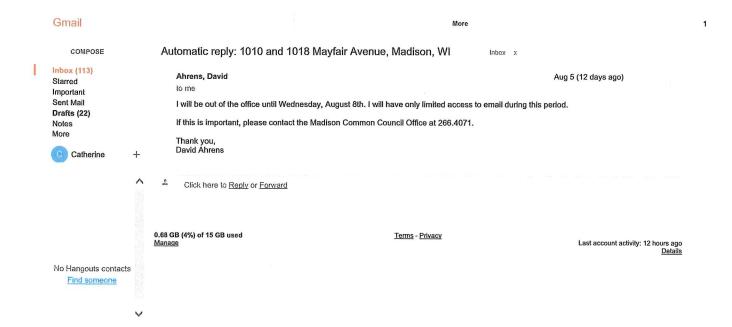

Approximity For / RELOGING PER PLANT COMMESSION [AUTION] OF 2-24-64 70 1010-1018 Mayfair Ave 12-9-64 4/.6 3/44 APARTMENT BUILDING A 14 - 1 BEC UNITS 10 - 2 BED UNITS 2 - 3 BED UNITS FIRST FLOOR SLEV. 47.5 BASE FLOOR ELEV 34.0 BUDG SIZE 86183031 1. 76 DUITS TOTAL PARKING ARCA DETAILE ON PHEET NAV APARTMENT BUILDING \$ - 1.8800 UN 179 17 - 2.8800 UN 175 4 - 3.8800 UN 175 24 UN 172 TOTAL Fiest Floor Cley 18.5 Base Floor Floir 34.0 Blog Size 581×2051 FARKING LOT PLAN APPROVED DRAINAGE APPROVED

Hur & Hongy
City Engineer stree with Section 10.03 General Ordinances CITY OF MADISON LOSSEANENDEST FOR EGGETRIC & TELEPHONE STVIC

GENERAL NOTES AND SPECIFICATIONS

- 1. The materials and labor shown on these plans that are provided by Cleary Building Corp. are limited to those materials and labor as defined by the Cleary Building Corp. contract. Additional materials or accessories that are not being provided by Cleary Building Corp. may be shown on plans for context or building code compliance.
- 2. This building is designed in accordance with the following codes and specifications:
 Wisconsin Uniform Dwelling Code (WUDC)
 National Design Specifications for Wood Construction


Building Category:-Use Group(s) Classification: Building Use:--Private Garage Type of Construction:--TYPE VB Building Gross Square Footage: ----1200 Sq. Ft.

uilding Desigr	n Loads:		
Snow Design	an Data:		
Design	n Truss Lond:	-39 PSF	
Groun	d Snow Load (Pa):	-30 PSF	
Design	n Balanced Roof Snow Load:	-30 PSF	
Flat F	Roof Snow Load (Pf):	-25.2 PSF	
Snow	n Balanced Roof Snow Load: Roof Snow Load (Pf): Exposure Factor (Ce):	-1	
Snow	Load Importance Factor (Is):	-1.0	
Therm	nal Factor (Ct):	-1.2	
Slope	Load Importance Factor (I _s): and Factor (Ct): d Roof Snow Load (P _s):	-30	
Unbal	anced Snow Load:	-7.56 PSF	Windward
	Per SPS 362.1608 (1)	25.2 PSF	
Wind Desig	ın Data:		
Desig	n Wind Speed:———————————————————————————————————	-90 MPH	
Wind	Exposure:	-C	
Wind	Load Importance Factor (I _W):	-1	
Forthauake	Design Data:		
Seism	nic Design Category:	− B	
Spect	ral Response Coefficients (S _{DS}):	−0.09g	
•	ral Response Coefficients (S _{DS}):	−0.073g	
Sita I	1066,———————————————————————————————————	—ı ;	
Seism	nic Importance Factor (I _E):	-1.0	
Mapp	ed Spectral Response Accelerations (%):	−8.5%q	
	(S ₁):—	−4.6%g	
Respo	onse Modification Factor (R):	-6	


- 3. All lumber, unless noted otherwise, shall be S4S #2 SPF or better. All lumber embedded in the ground shall be treated with Chromated Copper Arsenate to a retention level of .60 lbs.
- 4. Grading should be such that the surface water is drained away from the foundation. Minimum grade would be six inches of vertical drop per ten feet of horizontal away from the foundation (5%).
- 5. Fill used for concrete floor slab sub grade, if present, shall be reasonably graded granular material. Fill used in columns holes shall be the excavated soil unless noted otherwise. All fill shall be free from debris, stones over 4"\$ and frozen material.
- 6. Electrical work is not a part of this drawing and shall be installed as per applicable codes.
- Heating, ventilating, and air conditioning work is not a part of this drawing and shall be installed as per applicable codes.
- 8. Plumbing work is not a part of this drawing and shall be installed as per applicable codes.
- 9. All nails are to be threaded hardened steel unless otherwise noted.
- 10. This design is based on a building site with sand, silty sand, clayey sand, silty gravel, clayey gravel soil. As per the WCBC building code and Table 1806.2, an assumed soil bearing design value of 2000 psf has been used in this design. If information is discovered before or during construction contrary to this, the building designer should be contacted.


TABLE OF CONTENTS

- 110. ELEVATIONS
- 120. FLOOR PLAN
- 121. CONCRETE BRACKET LAYOUT PLAN
- 122. CONCRETE DETAILS
- 130. TYPICAL SECTION
- 140. DIAGONAL BRACING DETAILS
- 150. DIAPHRAGM ACTION and MISC. DETAILS
- 160. TRUSS DIAGRAMS

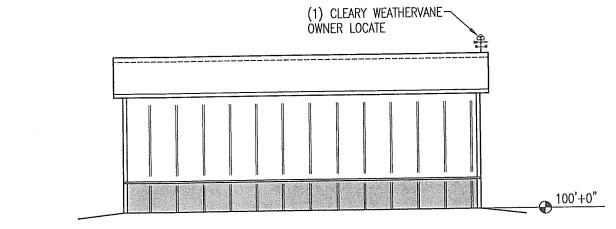

SOUTH ELEVATION

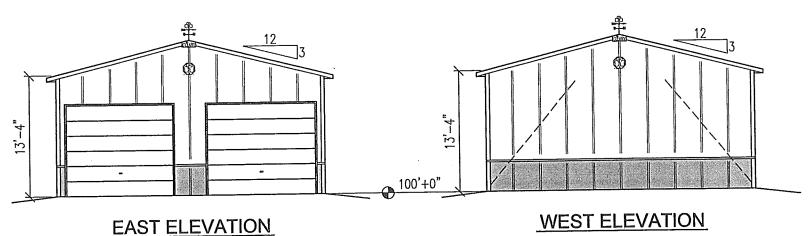

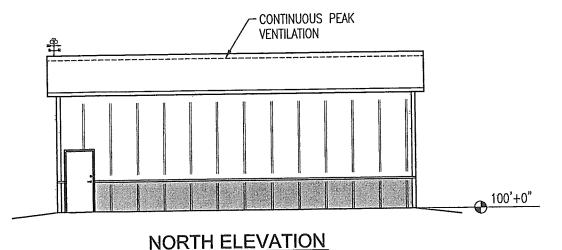



190 PAOLI STREET / P.O. BOX 930220


DRAWN BY	: WALDERA NN: 8/22/17
DATE DRAV	VN: 8/22/17

DATE DIGATION OF EET 17				
PLAN REVISIONS:				
NUMBER DATE BY				
1				
2				
3				

PROJECT NAME:
KNUCKEY, GEORGE
PROJECT SITE ADDRESS:
1018 MAYFAIR AVE APT 1
MADISON, WI - DANE COUNTY
BUILDING SIZE:
30'x40'x13'-4" PRIVATE GARAGE
SHEET NAME:
ELEVATIONS

PROJECT NUMBER: 2017104856

SHEET NUMBER: 110

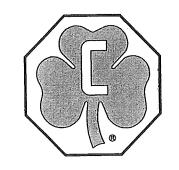

1. FIELD VERIFY ALL DOOR AND WINDOW ROUGH OPENING SIZES PRIOR TO INSTALLING FRAME—OUTS
2. ATTACH ALL ROOF, SIDE, END AND GABLE STEEL WITH PAINTED SCREWS
3. ENDWALL COLUMNS ARE 3—PLY TO THE BUILDING EAVE HEIGHT AND SINGLE PLY FROM THERE TO THE

4. 2x4 STANDARD DIAGONAL CORNER BRACING AT ALL CORNERS (UNLESS OTHERWISE NOTED) 5. 2x6 JACKBRACING AT ENDWALL COLUMNS AND CENTERED ABOVE 12' OVERHEAD DOORS

(SEE DIAPHRAGM ACTION and MISC. DETAILS SHEET)

6. 2x4 PURLIN BLOCKING AT ENDWALL TRUSSES

BUILDING COLORS:		BUILDING ACCESSORIES:
	ROOF: SIERRA SIDES: TAN GABLES: TAN SLIDE DOORS: — TRIM (TYP.): SIERRA F&J TRIM: TAN ACCENTS: —— WAINSCOTING: SIERRA	ATTACH ROOF STEEL TO PURLINS WITH PAINTED SCREWS IN PAN AREA (1) CLEARY WEATHERVANE (OWNER LOCATE) BUILDING ON CONCRETE SLAB WITH DRY-SET BRACKETS CONCRETE FOAM FILLER ENTIRE BUILDING LESS DOORS STEEL TO 100'+0" WITH FABRAL BOTTOM TRIM

BUILDING CORP

190 PAOLI STREET / P.O. BOX 930220 VERONA, WI 53593 / (800) 373-5550

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_		ACCOUNTS NO.			W 50 E	-
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1	DATE D	RAWN: <i>8/22/17</i>		
	PLAN REVISIONS:			
	NUMBER	DATE	B'	


2

3

4

NORTH

PURLIN LAYOUT

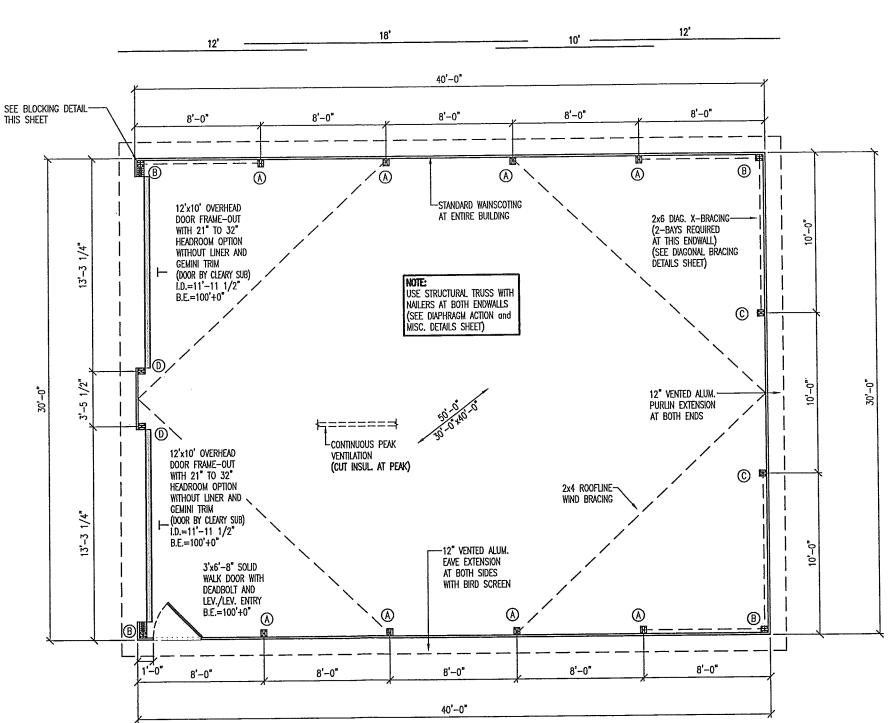


-2x6 SIDEWALL GIRT -3-PLY 2x6 CORNER COLUMN -2x6 TRACK MOUNT (4) 2x6x12" BLOCKING -2x6 DOOR JAMB -2x6 ENDWALL GIRT


BLOCKING DETAIL

CONT. PURLIN DESIGN


CONSTRUCTION FOREMAN NOTE: BE SURE TO MAINTAIN THE OVERALL LAP DISTANCE AND THE SPACING FROM PURLIN END TO CENTER OF TRUSS AS SHOWN

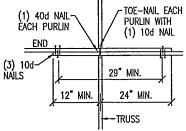

PURLIN LAPS AT FIRST TRUSS FROM EACH ENDWALL

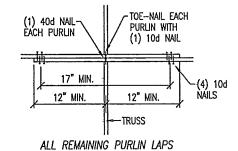

120 SHEET SCALE: NONE

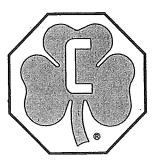

KNUCKEY, GEORGE
PROJECT SITE ADDRESS:
1018 MAYFAIR AVE APT 1
MADISON, WI - DANE COUNTY
BUILDING SIZE:
30'x40'x13'-4" PRIVATE GARAGE
SHEET NAME:
FLOOR PLAN


PROJECT NUMBER:

2017104856

SHEET NUMBER:

PRIVATE GARAGE


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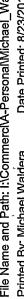


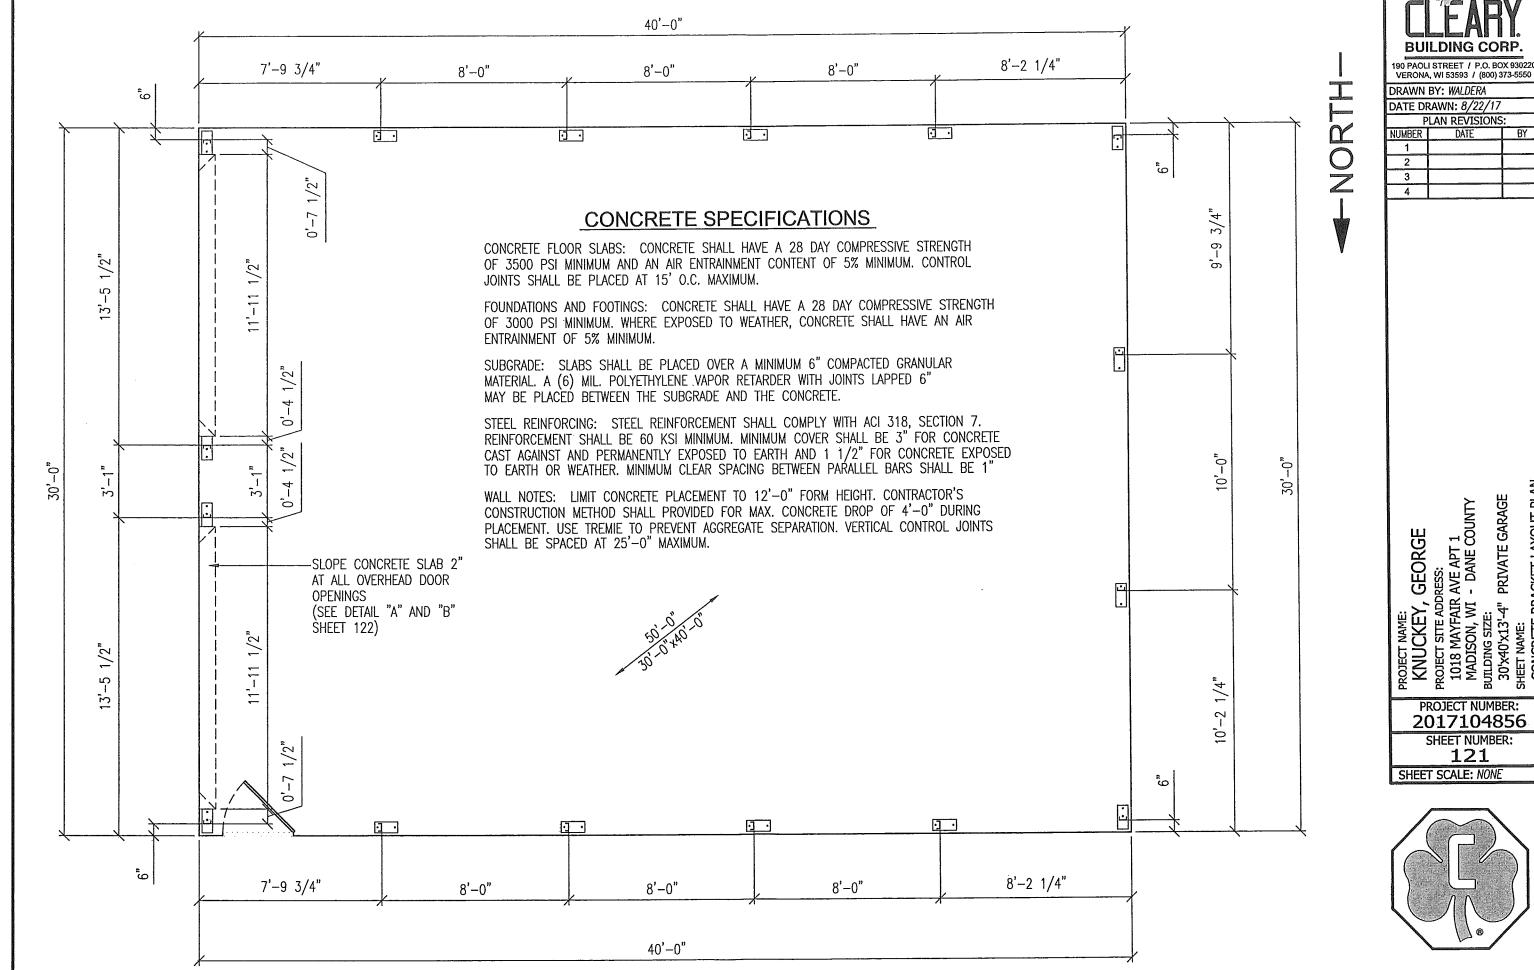
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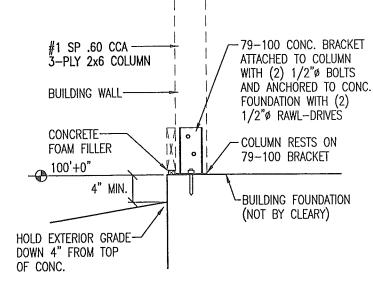
SHEET NAME: CONCRETE BRACKET LAYOUT PLAN

PROJECT NUMBER: 2017104856






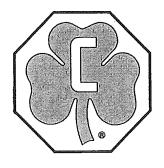

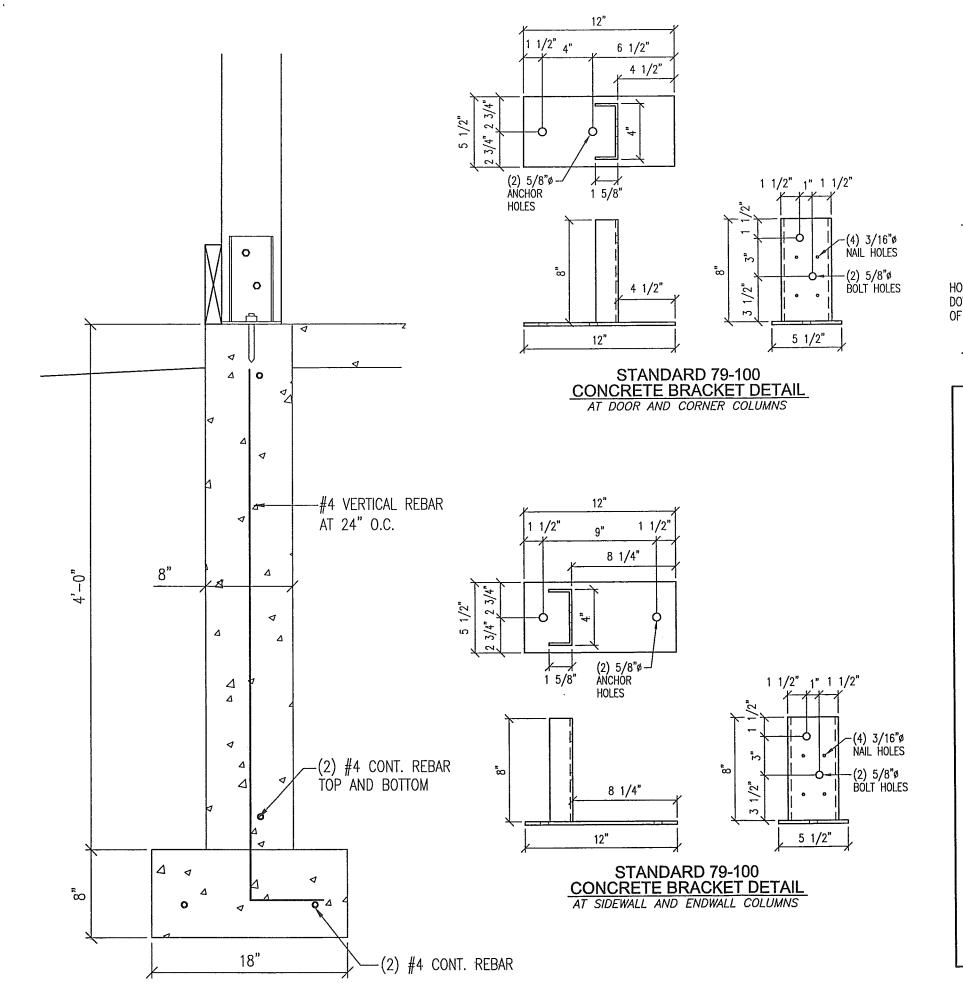

CONCRETE BRACKET PLACEMENT DETAIL

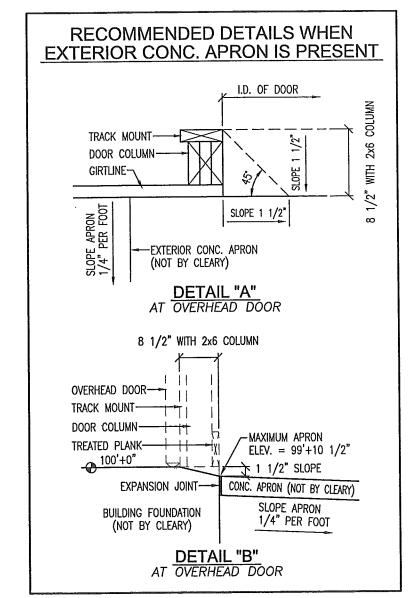



190 PAOLI STREET / P.O. BOX 930220 VERONA, WI 53593 / (800) 373-5550


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DATE	DRA	WN:	8/22/	17


TIE DIVINIA O/ ZZ/ 11						
P	PLAN REVISIONS:					
JMBER	DATE	BY				
1						
2						
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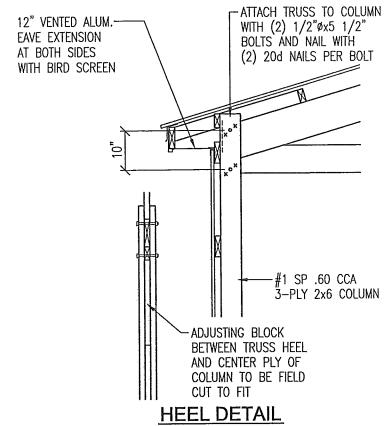
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KNUCKEY, GEORGE
PROJECT SITE ADDRESS:
1018 MAYFAIR AVE APT 1
MADISON, WI - DANE COUNTY
BUILDING SIZE:
30'x40'x13'-4" PRIVATE GARAGE
SHEET NAME:
CONCRETE DETAILS

PROJECT NUMBER: 2017104856

SHEET NUMBER: 122



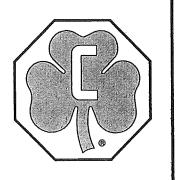

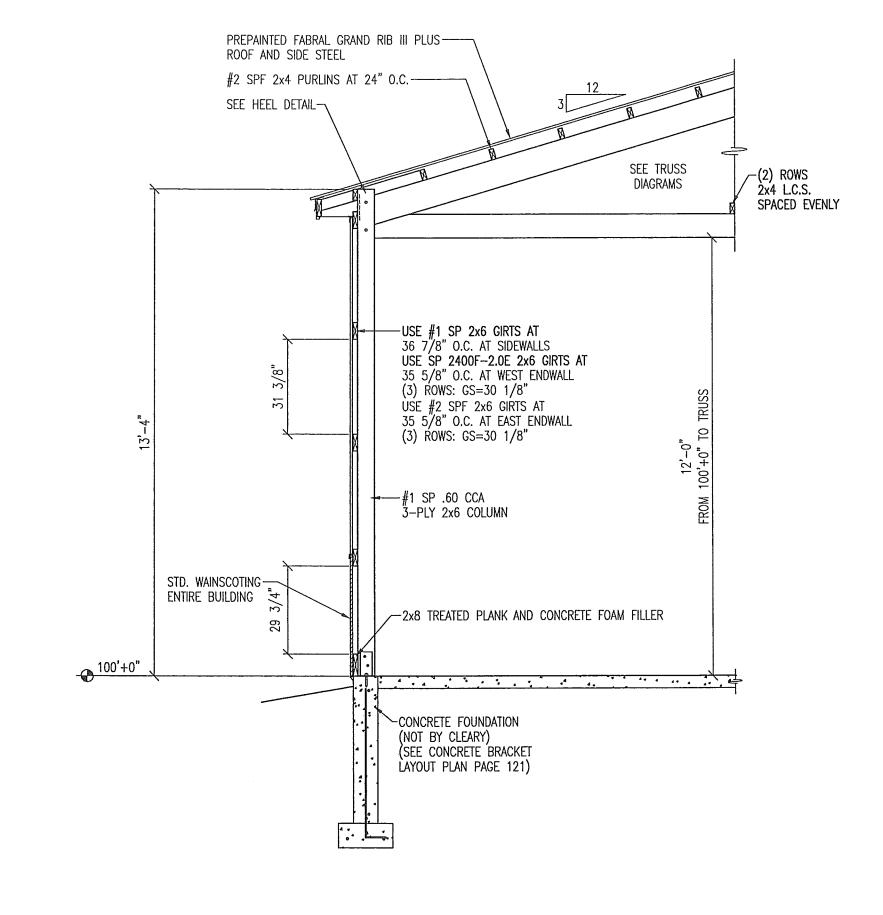




190 PAOLI STREET / P.O. BOX 930220

	VERONA, WI 53593 7 (600) 373-550				
	DRAWN	BY: WALDERA			
	DATE DRAWN: 8/22/17				
PLAN REVISIONS:					
	NUMBER	DATE	BY		
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PROJECT NAME:
KNUCKEY, GEORGE
PROJECT SITE ADDRESS:
1018 MAYFAIR AVE APT 1
MADISON, WI - DANE COUNTY
BUILDING SIZE:
30'x40'x13'-4" PRIVATE GARAGE
SHEET NAME:
TYPICAL SECTION

PROJECT NUMBER: 2017104856

SHEET NUMBER: 130

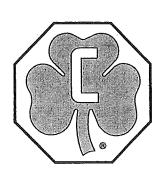


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#2 SPF 2x6 DIAGONAL BRACE . x x \ X X ATTACH DIAGONAL BRACE-TO EACH GIRT WITH (4) 10d NAILS

BRACE TO GIRT CONNECTION DETAIL

ATTACH BOTTOM CHORD OF-CLEARSPAN ENDWALL TRUSS TO BUILDING COLUMN WITH (7) 20d NAILS 2x6x24" BEARING BLOCK ATTACHED TO DIAGONAL BRACE WITH (11) 10d NAILS (BEARING BLOCK BEARS ON _ BOTTOM CHORD OF TRUSS)

BRACE CONNECTION DETAIL AT TOP OF BRACE AT ENDWALL COLUMN

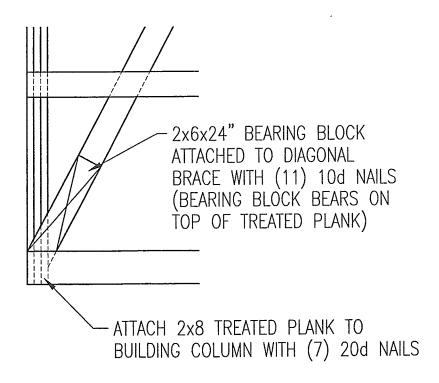

BRACE CONNECTION DETAIL
AT BOTTOM OF BRACE AT ENDWALL COLUMN

ENDWALL DIAGONAL X-BRACING DETAIL


WEST ENDWALL




PLAN REVISIONS


PROJECT NUMBER: 2017104856

SHEET NUMBER: 140

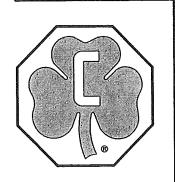

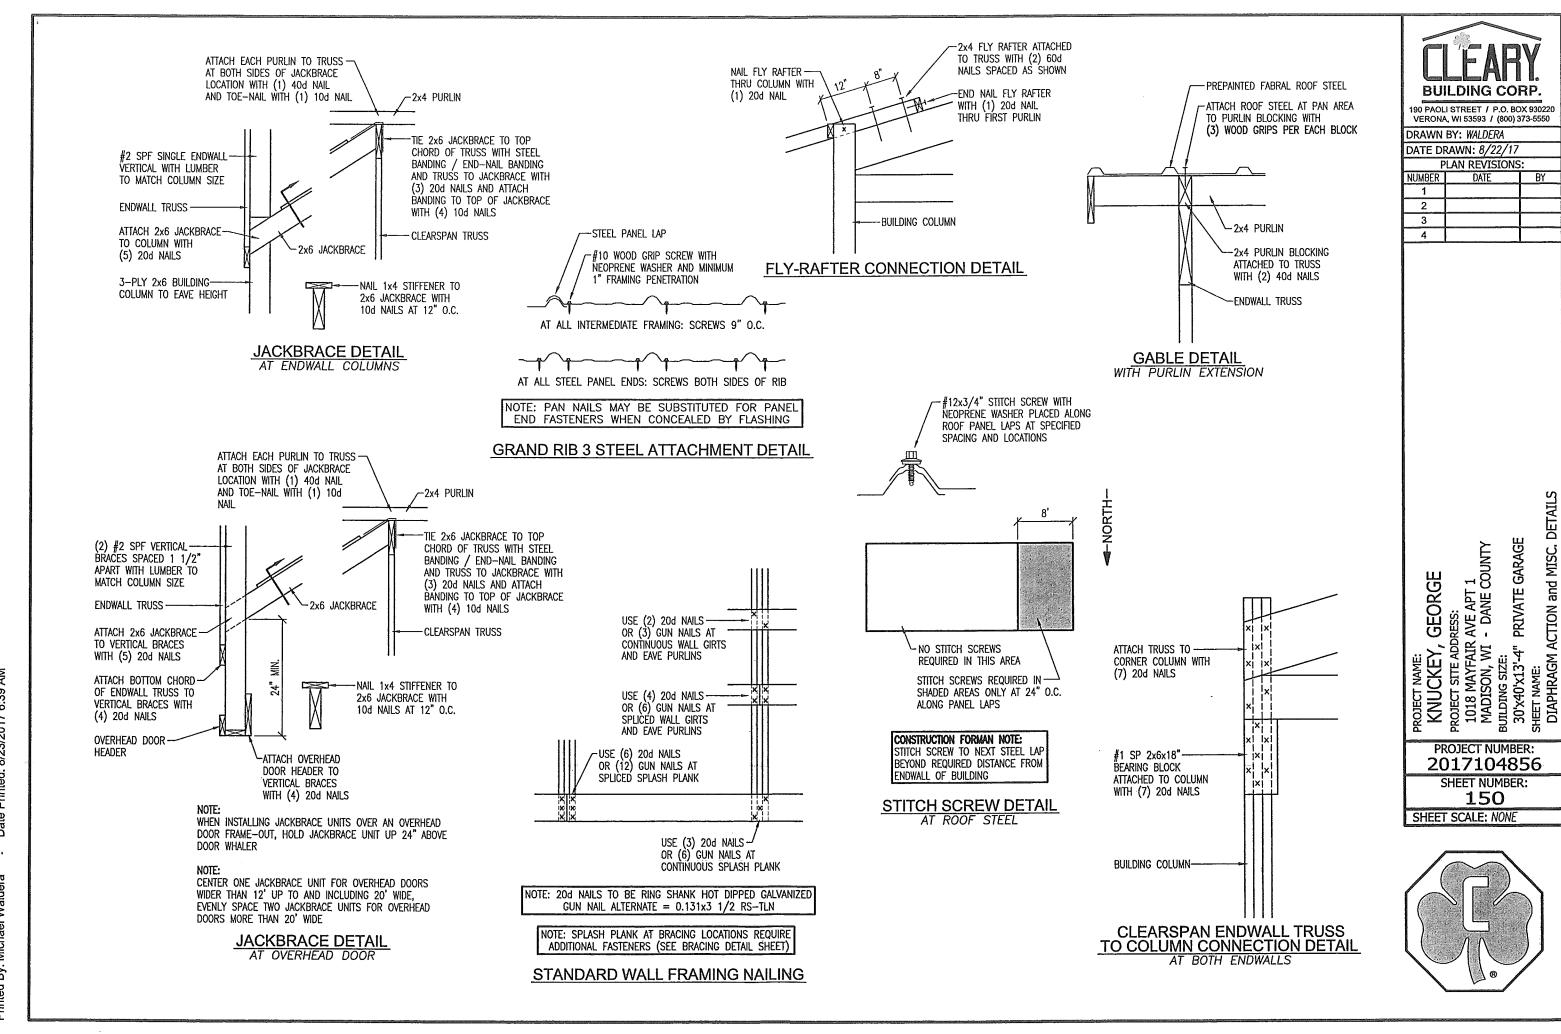

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(2017104856--- , ** - 29-9EMSC30STST80C3truss1BC)

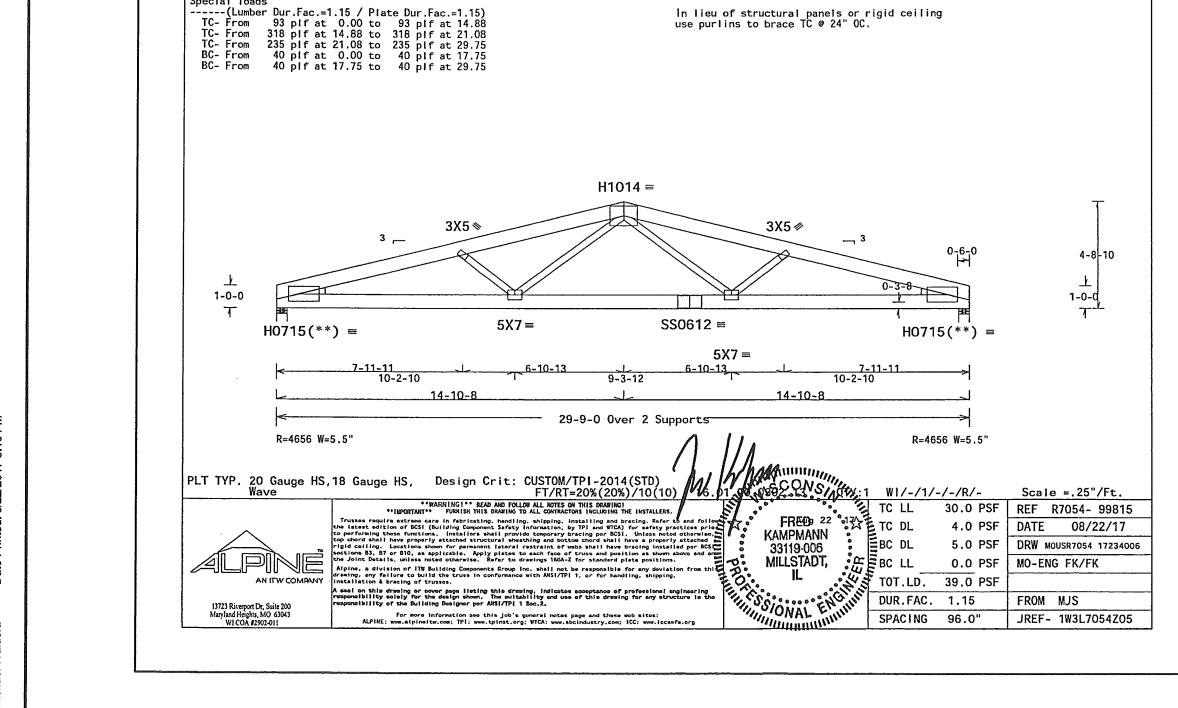Lumber value set "13B" uses design values approved 1/30/2013 by ALSC

Value Set: 13B (Effective 6/1/2013)

:Lt Wedge 2x4 SP #2::Rt Wedge 2x4 SP #2:

Top chord 2x8 SP 2400f-2.0E Bot chord 2x8 SP 2400f-2.0E Webs 2x4 SP #2

Special loads

TRUSS CHECK (CHECK BOX AND INITIAL)

X TRUSS SIZE MW

X ROOF PITCH MW

X BAY SPACING MW

X SLC / RLC _MW_

X DESIGN LOADS MW

THIS DWG PREPARED FROM COMPUTER INPUT (LOADS & DIMENSIONS) SUBMITTED BY TRUSS MFR.

Trusses to be spaced at 96.0" oc maximum.

See Cleary Building Corp. drawing for bearing attachment and bottom chord bracing details.

This designs applies to both open wall and

enclosed wall buildings.

factors.

Truss designed for unbalanced load using 0.25/0.84 windward/leeward

X OVERHANGS

BUILDING CORP

190 PAOLI STREET / P.O. BOX 930220 VERONA, WI 53593 / (800) 373-5550				
DRAWN	BY: WALDERA			
DATE D	RAWN: <i>8/22/17</i>			
P	LAN REVISIONS	:		
NUMBER	DATE	BY		
1				
2				
3				
4				

GARAGE GEORGE PROJECT NAME:
KNUCKEY, GEORG|
PROJECT SITE ADDRESS:
1018 MAYFAIR AVE APT 1
MADISON, WI - DANE C

PROJECT NUMBER: 2017104856

SHEET NUMBER: 160

