

# URBAN DESIGN COMMISSION APPLICATION CITY OF MADISON

This form may also be completed online at: <a href="http://www.cityofmadison.com/planning/documents/UDCapplication.pdf">http://www.cityofmadison.com/planning/documents/UDCapplication.pdf</a>

215 Martin Luther King Jr. Blvd; Room LL-100 PO Box 2985; Madison, Wisconsin 53701-2985 Phone: 608.266.4635 | Facsimile: 608.267.8739

Please complete all sections of the application, including the desired meeting date and the type of action requested.

Date Submitted: 09 12 2017	Informational Presentation
UDC Meeting Date: OC7013ER 4TH	
Combined Schedule Plan Commission Date (if applicable): OCT	BER 16TH Final Approval
1. Project Address: 630 FORWARD DRIVE Project Title (if any): EXACT SCIENCES PAR	
rioject rice (ii any).	AND DOT A
2. This is an application for (Check all that apply to this UDC application	<b>):</b>
☐ New Development  ☐ Alteration to an Existing or Property	eviously-Approved Development
A. Project Type:  Project in an Urban Design District* (public hearing-\$300 fee)  Project in the Downtown Core District (DC) or Urban N  Suburban Employment Center (SEC) or Campus Institut  Planned Development (PD)  General Development Plan (GDP)  Specific Implementation Plan (SIP)  Planned Multi-Use Site or Planned Residential Comple  B. Signage:  Comprehensive Design Review* (public hearing-\$300 fee)	Tixed-Use District (UMX) (\$150 fee, Minor Exterior Alterations) tional District (CI) or Employment Campus District (EC)  x  Street Graphics Variance* (public hearing-\$300 fee)
☐ Signage Exception(s) in an Urban Design District (public Page 1)	nearing-\$300 fee)
C. Other:	
Please specify:	
3. Applicant, Agent & Property Owner Information:	GENERAL CHORN CANDO
Applicant Name: STEVE SIEUS.	Company: GENERAL CAPITAL GEOUP
Street Address: 6938 N. GANTA MONICA BLVD	City/State: FOX POINT WI Zip: 53217
Telephone:(414) 228-3909 Fax:()	Email: SSIRKISD GENERAL CAPITALGEOUP. LOW
Project Contact Person: JODY SHAW  Street Address: 749 UNIVERSITY ROW & UITE 300  Telephone:(608) 274-2741 Fax:()	Company: POTTER LAWYON INC  City/State: MAD ISON WI Zip: 53705  Email: JODY SO POTTERLYWSON.COM
Project Owner (if not applicant): CA GROWTH WO: 900	TT COWARD
Street Address: 441 CHARMANY DRIVE	City/State: MAOLSON, WI zip: 53719
Telephone: (408) 284 - 5100 Fax: (1)	Email: SCOWARDD EXACTSCIENCES COM
4. Applicant Declarations:	
A. Prior to submitting this application, the applicant is required to discuss the	09/08/2017
B. The applicant attests that all required materials are included in this submit the application deadline, the application will not be placed on an Urban Design	n Commission agenda for consideration.
Name of Applicant STEVE SIRIUS	Relationship to Property OWNER'S REPRESENTATIVE
Authorized Signature D. South CV	Date 09/11/2017.



September 12, 2017

City of Madison Urban Design Commission 126 South Hamilton Street Madison, WI 53703

Re: 630 Forward Drive, Madison WI 53711

Exact Sciences Parking Lot at Forward Drive

## Dear Commission Members:

Please accept this Letter of Intent, Application and attachments as our formal request for initial and final approval of the Exact Sciences Parking Lot at Forward Drive. We are not asking for review of the signage for this project. The development team will submit a comprehensive signage package at a later date.

## **Project Team**

Owner:

CG Growth LLC 441 Charmany Drive Madison, WI 53719 (608) 284-5700

Owner's Representative:

General Capital Group

Steve Sirkis

6938 N Santa Monica Blvd. Fox Point, WI 53217 (414) 228-3509

ssirkis@generalcapitalgroup.com

Architect:

Jody Shaw

Potter Lawson, Inc.

749 University Avenue, Suite 300 Madison, Wisconsin 53705

(608) 274-2741

Jodys@Potterlawson.com

Civil Engineer:

Joseph Doyle

Vierbicher Associates Inc. 999 Fourier Dr # 201, Madison, WI 53717 (608) 826-0532 jdoy@vierbicher.com Landscape Architect:

Suzanne Vincent Vierbicher Associates Inc. 999 Fourier Dr # 201, Madison, WI 53717 (608) 826-0532 svin@vierbicher.com

Contractor:

Bob Hougard J.H. Findorff & Son 300 S. Bedford St. Madison, WI 53703 (608) 257-5321 bhougard@findorff.com

The Existing Conditions

The Site for this parking lot is the Tech, R&D building at 630 Forward Drive. This submittal is part of the request to demolish the existing building, and approve the construction of a surface parking lot that will serve both the Second phase of the Exact Sciences Clinical Lab and additional interior build-out of the existing Office building at 601 Rayovac Drive.

### **Staff and Neighborhood Input**

The Development Team reviewed this project with the City Staff on 08.29.2017.

The Development Team has also met with Alder Clear, and given a neighborhood presentation on August 9, 2017.

#### **Project Overview**

Exact Sciences Corporation is a molecular diagnostics company focused on the early detection and prevention of the deadliest forms of cancer. The company has exclusive intellectual property protecting Cologuard, its non-invasive, molecular screening technology for the detection of colorectal cancer.

Phase One of a new Clinical Processing Center for the Cologuard test, as well as future tests that are currently under research, is currently under review by the City of Madison. It is critical for this facility to come on line as soon as possible to meet the growing demand for the Cologuard test.

This parking lot will serve both the completed Clinical Processing Center with the second phase Production Lab and office, as well as future interior build outs of the existing office building at 601 Rayovac Drive. Exact Sciences is currently moving into the first floor of that office building in October of this year, and has plans to occupy additional floors within the next year.

# Working within the Urban Design District Number 2

**Grading:** Requires positive drainage that allows natural vegetation growth and appears natural. Due to the existing building, the site is relatively flat and requires little additional grading once the building is removed. The grades will be sloped to the existing grades, and maintain a natural appearance. Stormwater requirements have already been accounted for in the first Phase of the Clinical Processing Center.

**Landscape:** Species will be as prescribed by the Urban Design District Number 2. There are a number of existing trees that the project will keep in place to form the base of the landscape screen to the adjacent public rights of way.

**Structures:** There are no structures associated with this submittal.

**Lighting:** Parking lighting will meet City of Madison Ordinances and the Urban Design District Number 2 guidelines by providing glare free lighting in a minimal and attractive manner.

**Screening:** Appropriate screening will be provided through between parking areas and the adjacent, public right of way (Forward Drive).

Building Design: There are no buildings associated with this submittal.

# Requested approval


With your recommendations and approval, we look forward to providing Exact Sciences with the ability to begin the demolition of 630 Forward Drive, and add the parking required to meet the projected growth for both the Phase Two of the Clinical Lab, and the additional interior build out of 601 Rayovac Drive.

Regards,


Jody Shaw, AIA LEED AP Potter Lawson, Inc.

# Exact Sciences Parking Lot At Forward Drive

# MADISON, DANE COUNTY, WISCONSIN

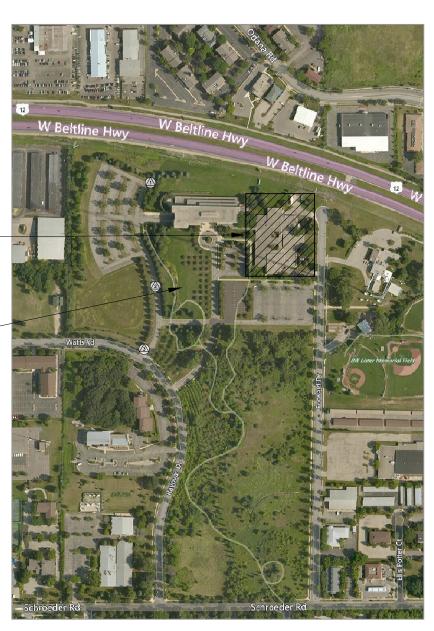



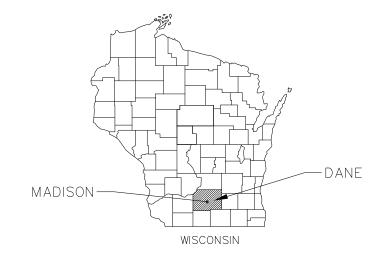

# Drawing Index

Sheet Number Sheet Title Title Sheet Existing Conditions 2 Demolition Plan Site Plan

**Grading Plan Utility Plan** Landscape Plan

# Dial or (800) 242-8511

CALL DIGGER'S HOTLINE 1-800-242-8511

## SITE BENCHMARKS

- CENTERLINE ELEV = 1057.697
- 3. PK NAIL LOCATED ON WEST SIDE OF
  ENTRANCE DRIVE
  APPROX 36' FROM
  WATTS RD CENTERLINE
  ELEV = 1045.067




NORTHEAST PARKING LOT

PROJECT LOCATION-

# TOP NUT OF EX HYDRANT LOCATED AT NE CORNER OF NW PARKING LOT ELEV = 1054.047

2. PK NAIL LOCATED ON CENTERLINE OF WESTERN PRIVATE DRIVE. APPROX 412' FROM WATTS RD

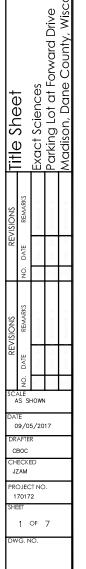

Vierbicher ladvisors


































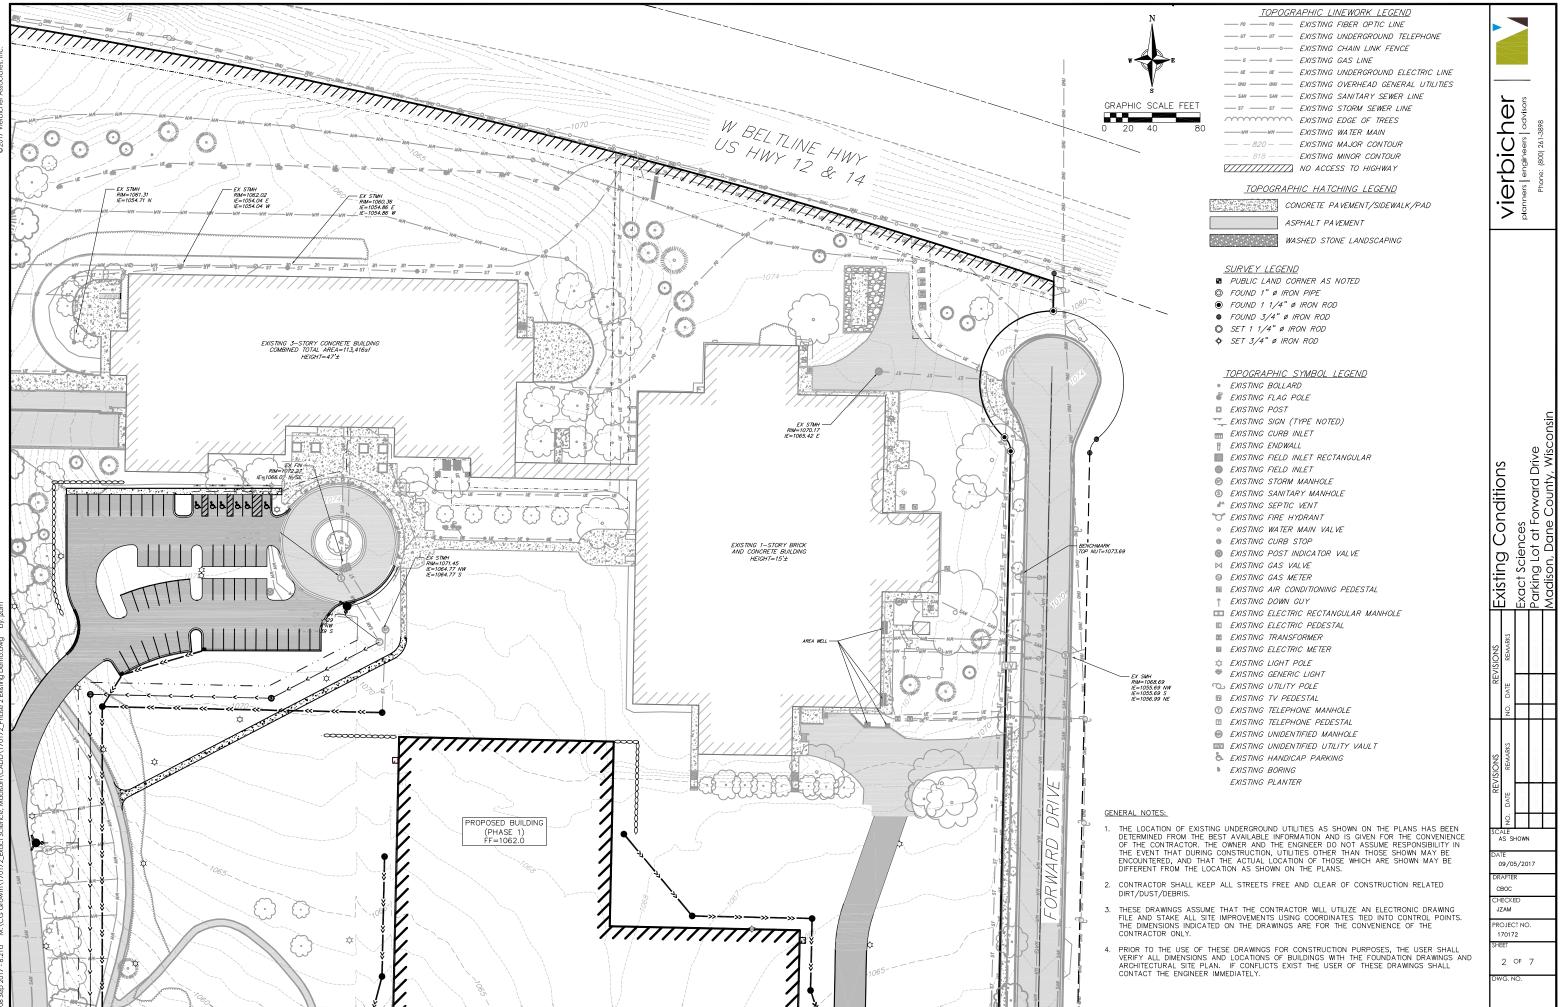


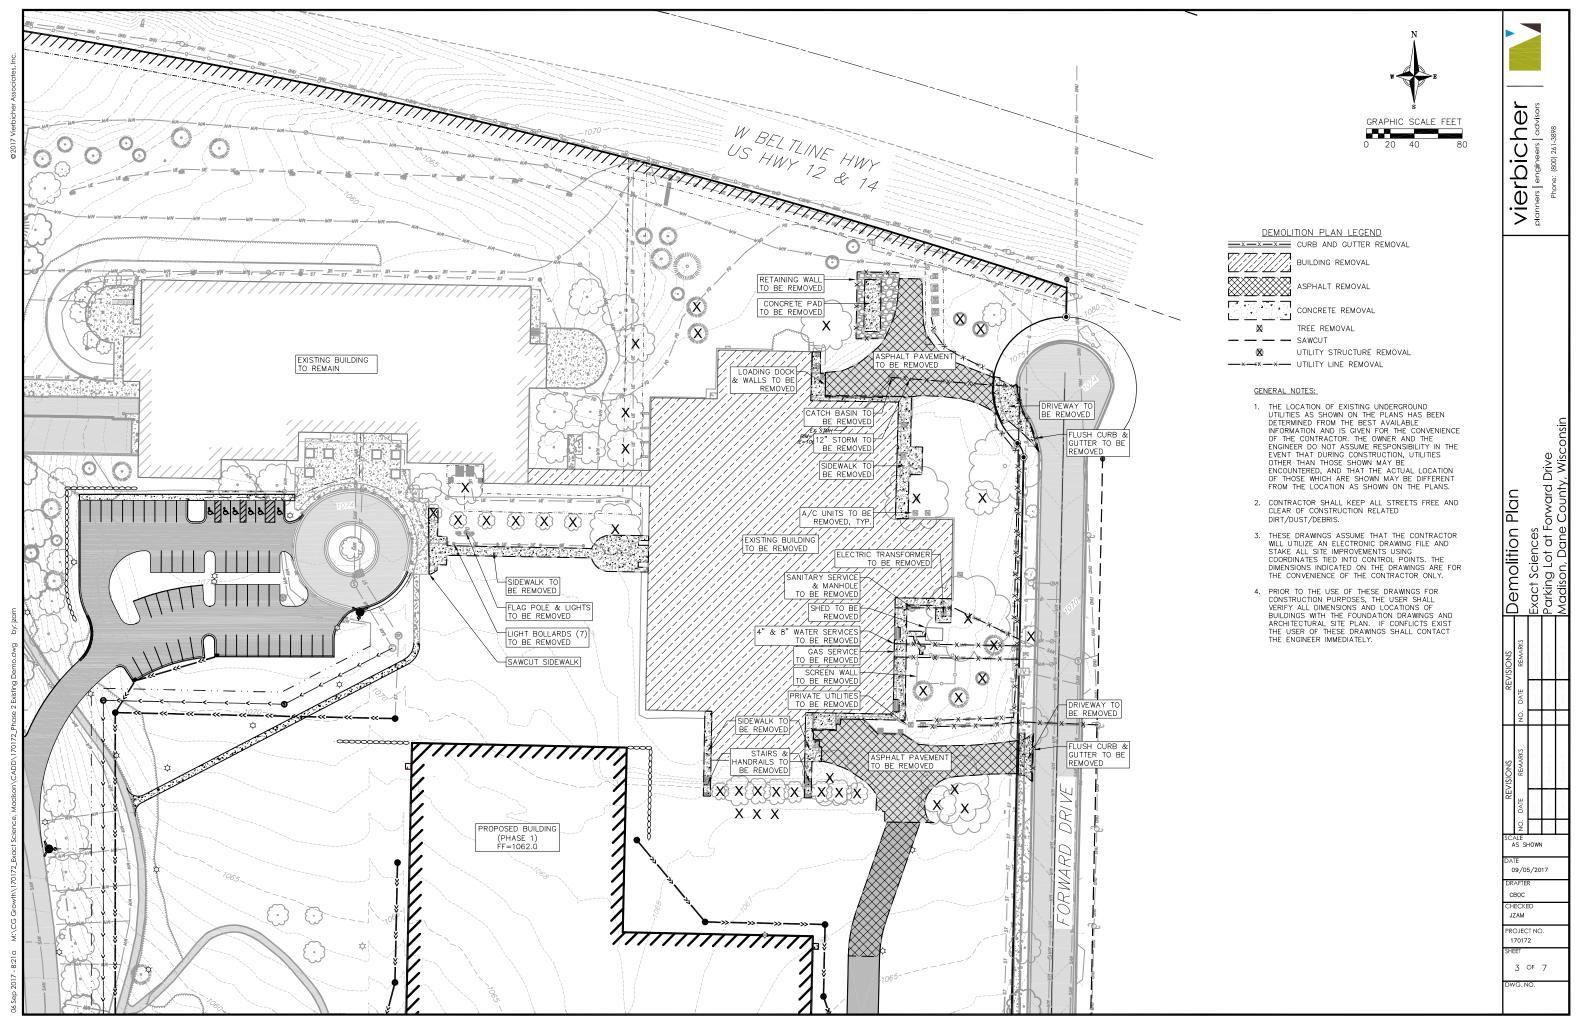

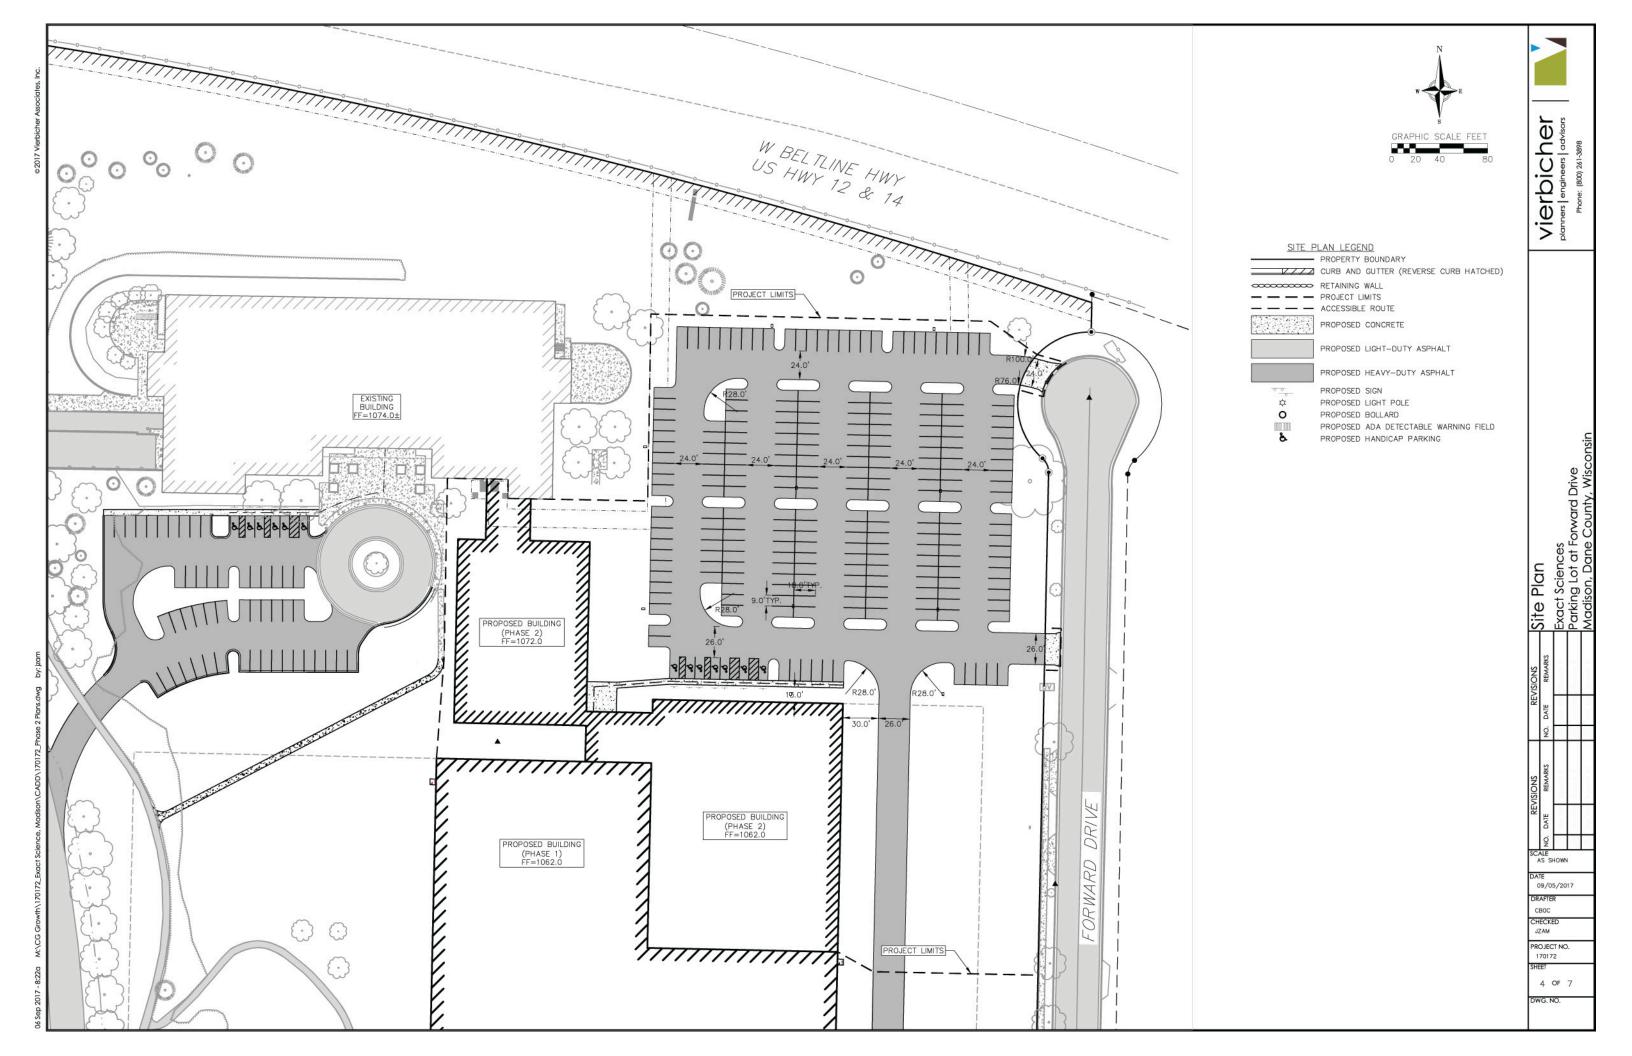

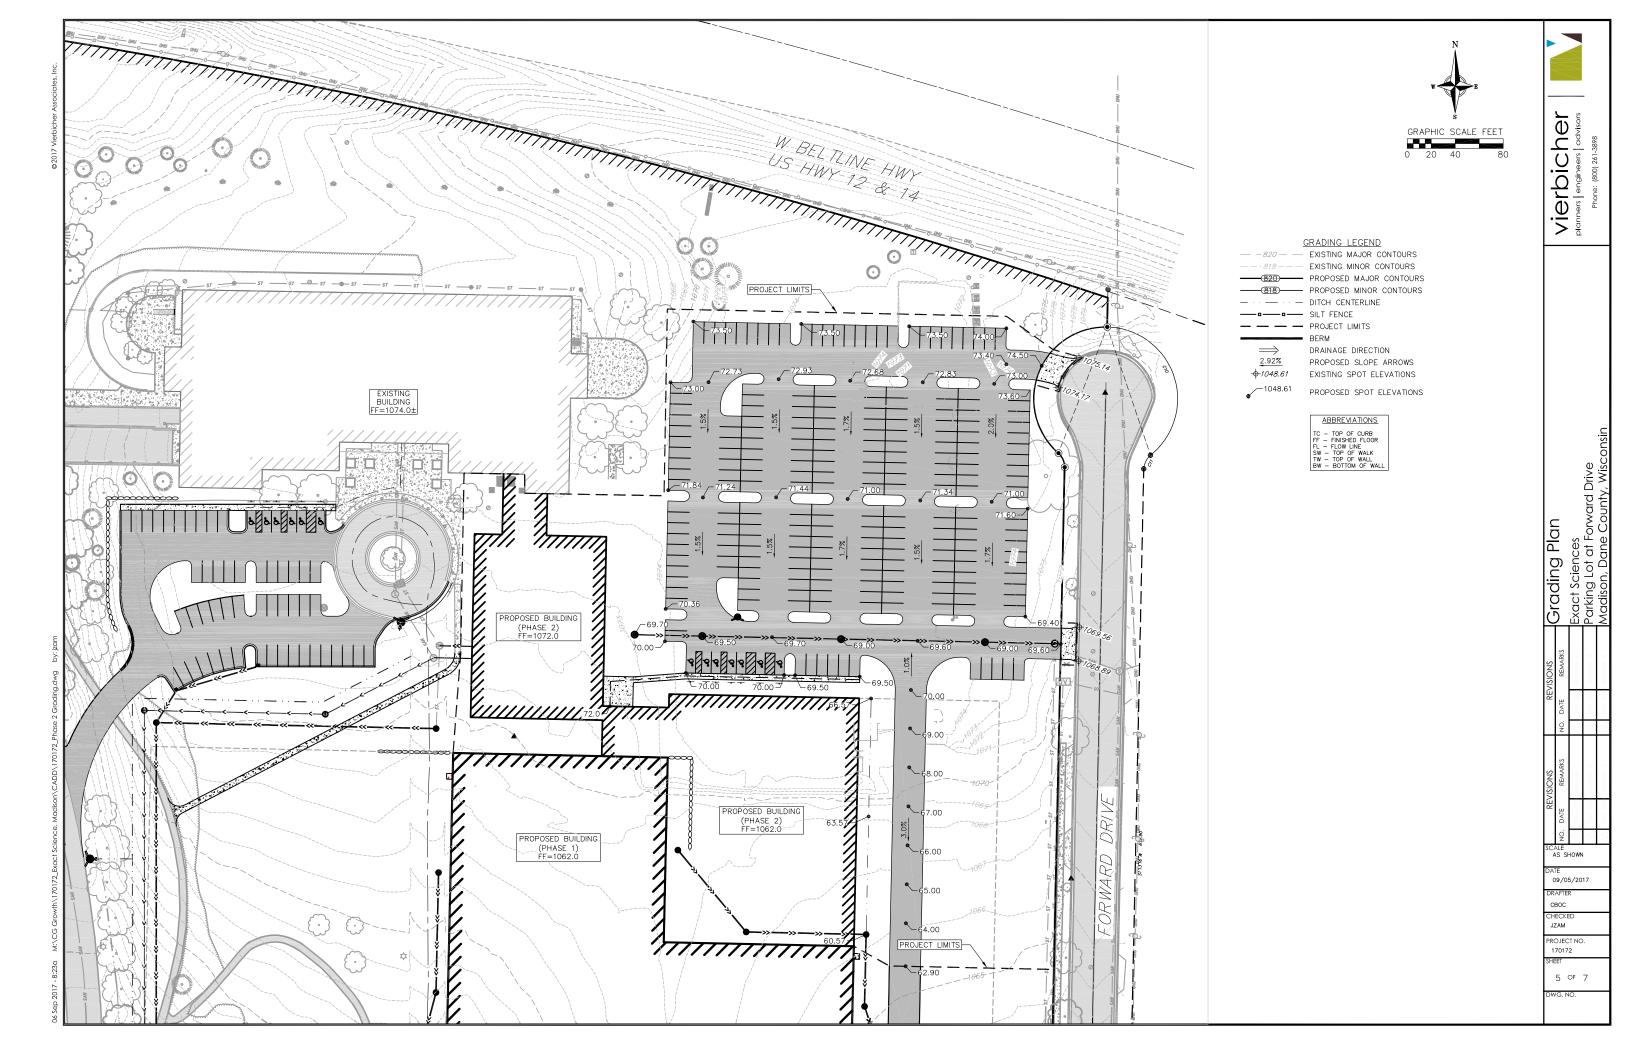

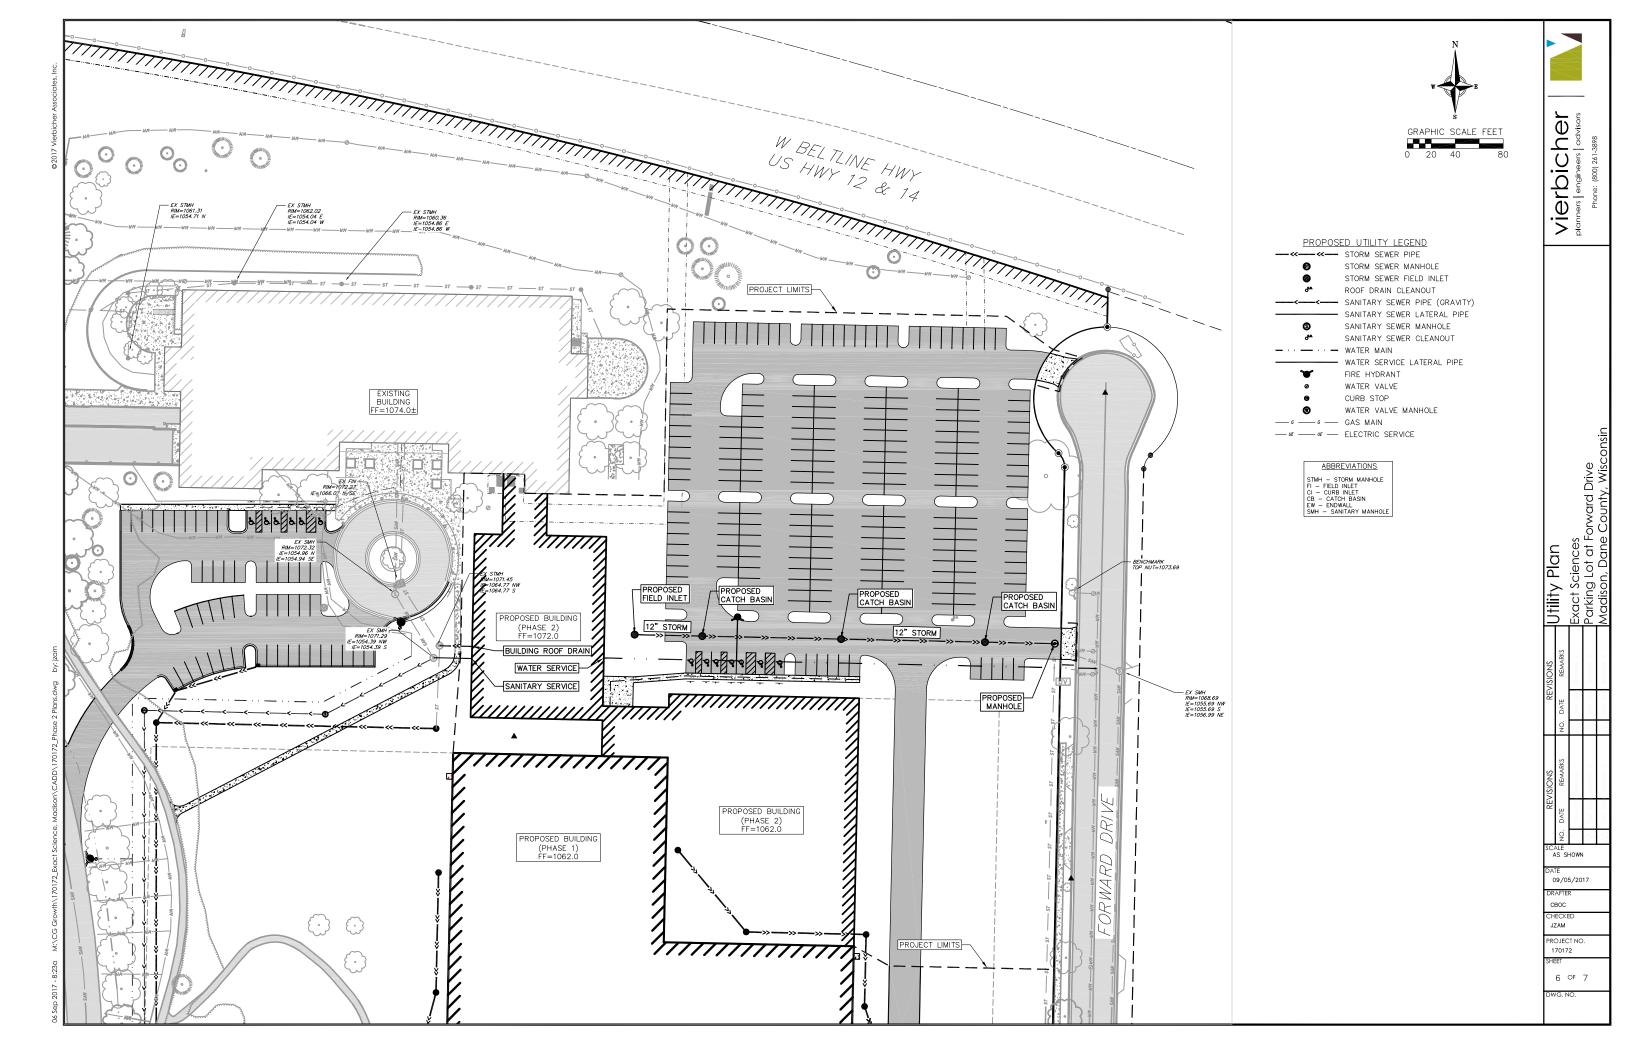

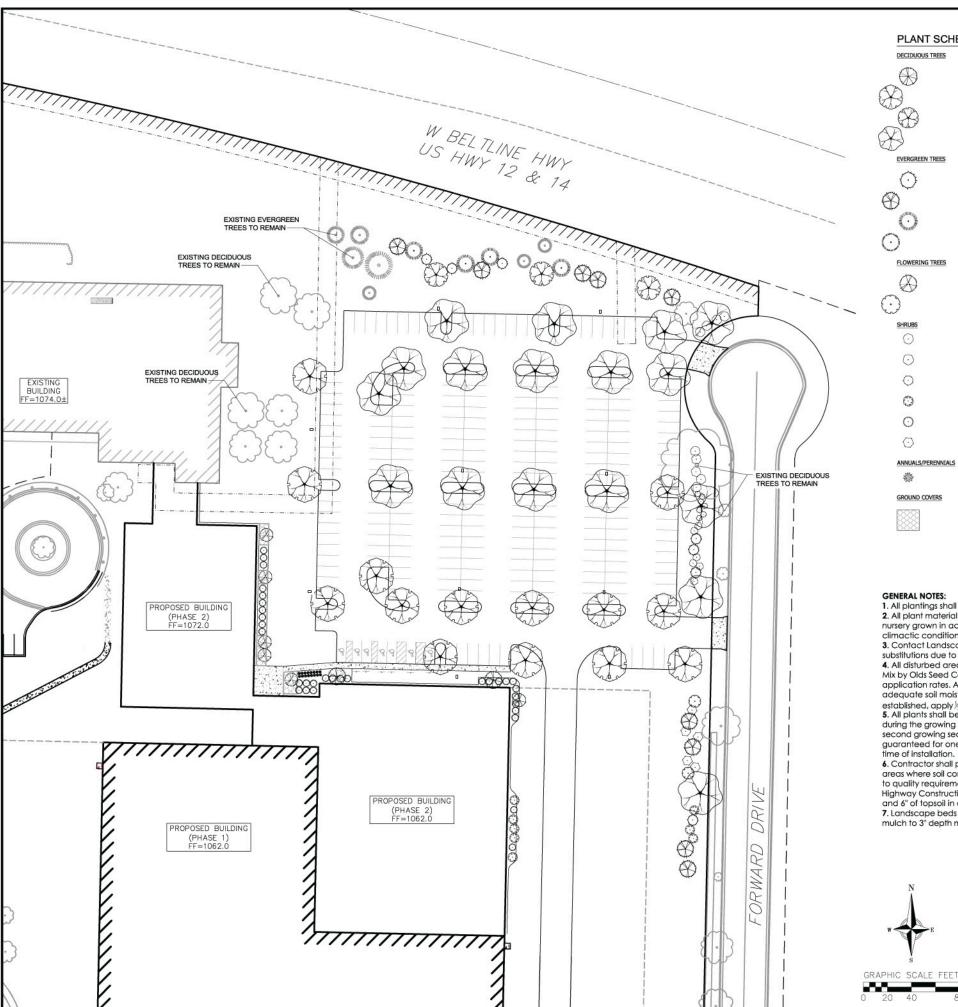


#### PLANT SCHEDULE

	PLANT SCH	DULE					
	DECIDUOUS TREES	BOTANICAL NAME / COMMON NAME	CONT	CAL	SIZE		QTY
		Carpinus caroliniana / American Hombeam	B & B	2"Cal			2
1	<b>X</b> 3	Celtis occidentalis / Common Hackberry	B & B	2.5"Cal			19
		Gymnocladus dioica `Espresso` / Kentucky Coffeetree	B & B	2.5"Cal			3
(	23	Quercus rubra / Red Oak	B & B	2.5"Cal			17
	EVERGREEN TREES	BOTANICAL NAME / COMMON NAME	CONT	CAL	SIZE		QTY
	0	Picea glauca / White Spruce	B & B		6' ht.		7
	$\otimes$	Picea pungens / Colorado Spruce	B & B		6` ht.		10
		Pinus strobus / White Pine	B & B		7` ht.		5
	0	Thuja occidentalis `Wintergreen` / Wintergreen Arborvitae	B & B		7` ht.		2
	FLOWERING TREES	BOTANICAL NAME / COMMON NAME	CONT	CAL	SIZE		QTY
	$\otimes$	Amelanchier laevis / Allegheny Serviceberry	B & B		6' ht. multi stem		6
	$\odot$	Crataegus crus-galli `Inermis` / Thornless Hawthorn	B & B	2"Cal			2
	SHRUBS	BOTANICAL NAME / COMMON NAME	SIZE	FIELD2	FIELD3		QTY
	$\odot$	Amelanchier stolonifera / Running Serviceberry	3 gal	Cont			10
	$\odot$	Cornus sericea / Red Twig Dogwood	5 gal				6
	0	Juniperus chinensis `Pfitzerana Kallays Compacta` / Kally Pfitzer Compact Juniper	3 gal	Cont			7
	0	Sambucus canadensis / Elderberry	5 gal				8
	0	Taxus cuspidata `Monloo` / Emerald Spreader Japanese Yew	5 gal	Cont			31
	$\bigcirc$	Viburnum prunifolium / Blackhaw Vibumum	5 gal	Cont			5
	ANNUALS/PERENNIALS	BOTANICAL NAME / COMMON NAME	SIZE	FIELD2	FIELD3		QTY
	器	Hosta x `Blue Cadet` / Plantain Lily	1 gal	Cont			16
	GROUND COVERS	BOTANICAL NAME / COMMON NAME	CONT	FIELD2	FIELD3	SPACING	QTY
		Asarum canadense / Canadian Wild Ginger	flat	2" pot		18" o.c.	641 sf


#### **GENERAL NOTES:**


- 1. All plantings shall conform to quality requirements as per ANSI Z60.1.
- 2. All plant material shall be true to the species, variety and size specified, nursery grown in accordance with good horticultural practices, and under climactic conditions similar to those of the project site.
- 3. Contact Landscape Architect, in writing, to request and plant material substitutions due to availability issues.
- 4. All disturbed areas, unless otherwise noted, to be seeded with Madison Parks Mix by Olds Seed Company or equivalent, per manufacturer's specified application rates. All seeded areas are to be watered daily to maintain adequate soil moisture for proper germination. After vigorous growth is established, apply 1/2" water twice weekly until final acceptance.
- 5. All plants shall be guaranteed to be in healthy and flourishing condition during the growing season following installation (shrubs and perennials) or the second growing season following installation (trees). All plant material shall be guaranteed for one year (shrubs and perennials) or two years (trees) from the time of installation.
- 6. Contractor shall provide a suitable amended topsoil blend for all planting areas where soil conditions are unsuitable for plant growth. Topsoil shall conform to quality requirements as per Section 625.2(1) of the Standard Specifications for Highway Construction. Provide a minimum of 12" of topsoil in all planting areas and 6" of topsoil in areas to be seeded/sodded.
- 7. Landscape beds to be mulched with undyed shredded hardwood bark mulch to 3" depth min.

# 1 B&B TREE PLANTING DETAIL

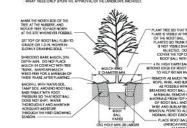

# 2 TREE PROTECTION DETAIL

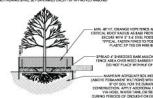

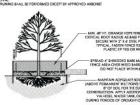



vierbicher ngineers | adv (800) 261-3898

Exact Sciences Parking Lot at Forward Drive Madison, Dane County, Wisc Landscape Plan SCALE AS SHOWN 09/05/2017

CHECKED JZAM PROJECT NO.

170172

DWG. NO.

7 OF 7



Potter Lawson



Success by **Design** 

5802 Research Park Boulevard Madison, WI 53719 608-238-2616 aeieng.com

Notes:

PRELIMINARY NOT FOR CONSTRUCTION

Exact Sciences - Parking Lot at Forward Drive Exact Sciences


630 Forward Drive Madison, WI 53711

201701.02



SITE LIGHTING


E1002

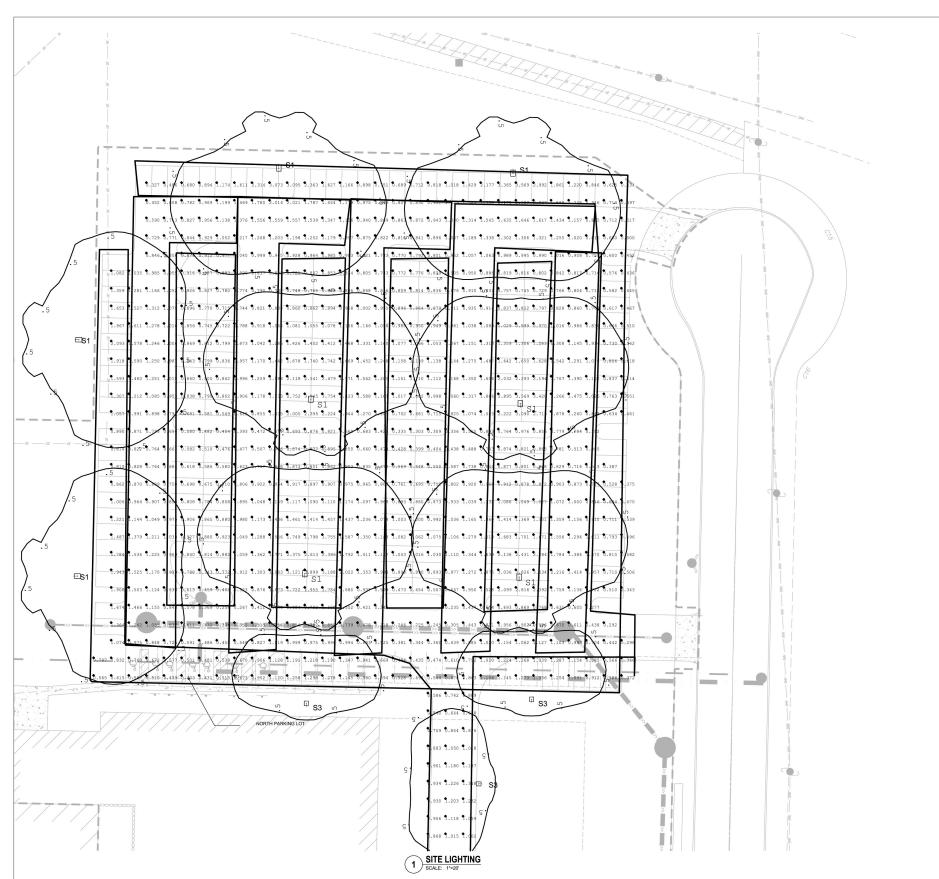


CALCULATION SUMMARY						
Label	CalcType	Units	Avg	Min	Avg/Min	Max
NORTH PARKING LOT	Illuminance	Fc	1.05	N.A.	N.A.	N.A.
NORTH PARKING- DRIVE LANES	Illuminance	Fc	1.00	0.225	4.42	2.216
NORTH PARKING- PARKING STALLS	Illuminance	Fc	1.08	0.225	4.81	3.945

LUMINAIRE SCHEDULE					
Symbol	Qty	Tag	Arrangement	LLF	Description
<b>-</b> →	5	S3	SINGLE - 23' AFF	0.900	DSX1 LED 30C 530 30K T3S MVOLT HS
<u> </u>	8	S1	SINGLE - 23' AFF	0.900	DSX1 LED 60C 700 30K T4M MVOLT

LPD AREA SUMMARY			
LABEL	AREA	TOTAL WATTS	LPD
NORTH LOT LPD	94821	524	0.006

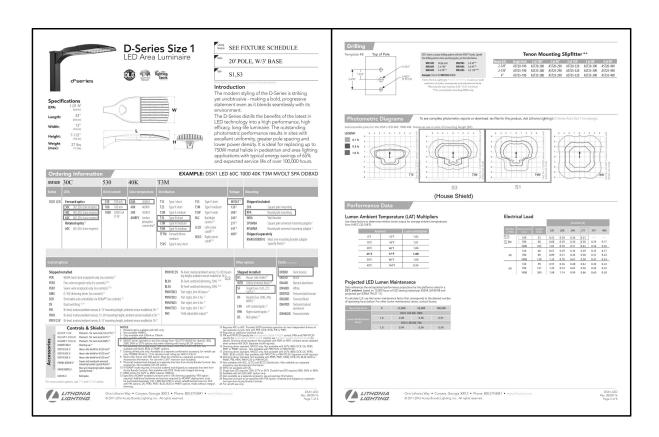

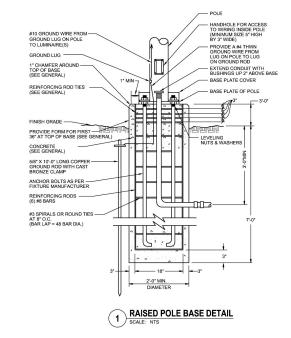



Success by **Design** 



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PRELIMINARY NOT FOR CONSTRUCTION

Exact Sciences - Parking Lot at Forward Drive Exact Sciences

630 Forward Drive Madison, WI 53711

201701.02

Date	Issuance/Revisions	Symbol
09.12.2017	UDC Submittal	

# SITE LIGHTING DETAILS

E1003