

URBAN DESIGN COMMISSION APPLICATION CITY OF MADISON

This form may also be completed online at: http://www.cityofmadison.com/planning/documents/UDCapplication.pdf

215 Martin Luther King Jr. Blvd; R com LL-100 PO Box 2985; Madison, Wisconsin 53701-2985 Phone: 608.266.4635 | Facsimile: 608.267.8739

Please complete all sections of the application, including the desired meeting date and the type of action requested.

Date Submitted: $(0-14-17)$ UDC Meeting Date: $(0-28-17)$		Informational P	į.
Combined Schedule Plan Commission Date (if applicable):		Final Approval	
1. Project Address: 200 South Pinckney Street (Block Project Title (if any): Judge Doyle Square			
2. This is an application for (check all that apply to this UDC application) \[\begin{align*} \text{New Development} & \begin{align*} \text{Alteration to an Existing or Property in an Urban Design District* (public hearing-\$300 fee) \\ \text{Project in an Urban Design District* (public hearing-\$300 fee) \\ \text{Project in the Downtown Core District (DC) or Urban M \\ \text{Suburban Employment Center (SEC) or Campus Institute \\ \text{Planned Development (PD)} \\ \text{General Development Plan (GDP)} \]	eviously-Approved Dev lixed-Use District (UM	Velopment LEG ALD	
Specific Implementation Plan (SIP)Planned Multi-Use Site or Planned Residential Complex			
B. Signage: Comprehensive Design Review* (public hearing-\$300 fee) Signage Exception(s) in an Urban Design District (publiche C. Other: Block 88: public development - parking Please specify: Block 105: private developmen	g garage with private	development ab	-
3. Applicant, Agent & Property Owner Information: Applicant Name: James R. DeStefano	Company: Lothan Van		o Architecture LLC
Street Address: <u>57 West Grand Avenue, Suite 300</u> Telephone:(<u>312</u>) 527-1500 Fax:(<u>312</u>) <u>527-1511</u>	City/State: Chicago, Il Email: idestefano@l	linois	Zip: <u>60611</u>
Project Contact Person: Chris Oddo Street Address: 115 E. Main Street, Suite 200 Telephone: (608) 204-0825 Fax: (866) 297-1762	Company: <u>InSite Cons</u> City/State: <u>Madison</u> , V Email: <u>chris@icsarc</u> ,	Visconsin	zip: <u>53703</u>
Project Owner (if not applicant): Beitler Real Estate Services LLC Street Address: 980 North Michigan Avenue, Suite 1225 Telephone: (312) 768-7001 Fax: (312) 768-7001	City/State: Chicago. Il		Zip: <u>60611</u>
4. Applicant Declarations: A. Prior to submitting this application, the applicant is required to discuss the application was discussed with Al Martin on (name of staff person) B. The applicant attests that all required materials are included in this submitt the application deadline, the application will not be plaged of an Lyban Design	[uly 12, 2016 (on going date of meeting) all and understands that if a	ng series of meet	ings)
Name of Applicant James R. De Ste Lino Authorized Signature	Relationship to Property _		er

George E. Austin Project Director, Judge Doyle Square 215 Martin Luther King Jr. Drive Madison, WI 53703



200 South Pickney Street (Block 88 & Block 105) - Judge Doyle Square Revised UDC Package

Dear Mr. Austin:

Attached with this letter please find revisions to our previous UDC Drawing Package Submittal.

Included in our Drawing Package are written responses to:

- Each of the four (4) Action Items outlined in the UDC Summary dated April 5, 2017
- Responses to the Planning Divisions Conditions for UDC review

We look forward to meeting with the Urban Design Commission on June 28, 2017 to answer any questions to our written responses.

A. Below is a summary of the revisions included in the attached June 13, 2017 Revised UDC Supplemental Drawing Package Submittal.

Section 1 - General Information

- **Updated Cover Sheet**
- **Updated Sheet Index**
- Minor curb line updates to site plans as requested by City Engineering Staff.
- Updated Fire Access Plans to reflect the aerial fire lanes on Doty Street and Wilson Street as required by the Fire

Section 2 - Block 88

- Reduction of Public Parking Garage Access from 36'-0" to 30'-0" on Wilson Street.
- Expansion of the loading dock entry from 10'-0" to 13'-0" on Wilson Street.
- Separation of the Public Parking Garage Pedestrian entrance and the Code Required Egress Door into separate penetrations of the façade to reduce scale on both Wilson Street and Doty Street.
- Reduction of the size of the window penetrations on the limestone façade to reduce scale on both Wilson Street and Doty Street.
- On the elevation facing the Madison Municipal Building limestone framed openings have been added at both the Doty Street and the Wilson Street sides of the elevation. These openings mimic the width and scale of the windows on the adjacent streets and allow for greater pedestrian visibility into the parking entries and exits while also adding elements of visual interest on the MMB façade.
- Addition of several louvres in the façade to account for ventilation requirements on Wilson Street, Doty Street, and the MMB Elevation.

Section 3 - Block 105

- Expansion of the Hotel and Residential loading dock entries from 10'-0" to 13'-0" on Wilson Street.
- Reduction of the Hotel Parking Access from 24'-0" to 20'-0" on Wilson Street.
- Separation of the Code Required Egress Door into a separate penetration in the façade to reduce scale on Wilson Street.
- Reduction of the size of the window penetrations on the limestone façade to reduce scale on both Wilson and Doty Streets.
- Addition of a Fireman's Access Entrance and canopy to allow for the direct access to the Fireman's Lobby from Doty Street as requested by the Fire Marshall
- Addition of several louvres in the façade to account for ventilation requirements on Wilson Street, Doty Street,

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Section 4 – Overall detailed supplemental information

- Cut Sheet provided for parking and loading dock doors.
- Cut Sheet provided for exterior bike racks

B. April 5, 2107 UDC Action Items

1) Details on planters, width and dimensions; minimize as much as possible

The planters, width and dimensions are designed to provide a balance of health plant growth and minimizes obstruction to pedestrians on the sidewalk (walking / wheelchair). Dimensions are reflected in the 100% CD's/Owners Review Landscape Drawings submitted with this cover letter.

2) Explore increasing the sidewalk width

The sidewalk widths are maximized on both blocks along Pinckney Street made available by the curved setback design of the buildings. This setback allows for an abundance of sidewalk area at ground level (more than previously exists). Sidewalk widths on Doty and Wilson Streets were reviewed by City Staff and these areas remain the previous widths as the City is unable to convert existing street area to sidewalk area.

3) More detailed planting plan

The planting plan will consist primarily of Chanticleer Pear Trees designed to specifically to establish a formal uniform look at the base of the buildings and provide a changing color palate as the Chanticleer Pear Trees change colors during each season (white, green and gold). This same concept currently exists at the base of the 100-story John Hancock Center in Chicago, IL along the North, West and South sides of the building, including Michigan Avenue. Additional details on plantings can be found reflected in the 100% CD's/ Owners Review Landscape Drawings submitted with this cover letter.

4) Parking staff should be prepared to address parking and aisle/opening widths at the next meeting City Parking Staff shall address during the meeting but revised opening can be found on pages 2-16, 2-16-A, 2-18, 2-18-A and 3-14.

C. Planning Division Block 88 Conditions Items 70-76

- 70) That the applicant receives Final Approval from the Urban Design Commission prior to submitting plans for final sign off for Block 88 and 105
 - Applicant has been granted Initial Approval and is seeking Final Approval.
- 71) That the "SW" (rear) elevation drawing for Block 88 is revised to show additional building/base detail and articulation for those portions of the building that extend closer to the East Doty and Wilson Street sidewalks than Madison Municipal Building. These details shall be approved by the Urban Design Commission and staff. Vertical openings have been provided to allow for improved visibility of traffic entering and existing on Doty and Wilson Streets. These openings are designed in the same language of the ground floor windows along Doty and Wilson Streets and further break up the limestone wall condition along the loading zone of the MMB. See page 2-19.
- 72) That for Blocks 88 and 105, all screening walls, elevator penthouses, and rooftop mechanicals are clearly labeled and dimensioned on rooftop plans, sections, and elevation drawings. The height of screening walls should be of the minimum height necessary to screen equipment. These details shall be approved by the Urban Design Commission and staff.

The screening walls, elevator penthouses and rooftop mechanicals are clearly labeled on pages 2-12 and 3-07 they are at the minimum heights necessary to screen equipment (17'-0").

73) That the door location on Block 105 retail space (on Wilson Street) be identified. An entrance to Wilson Street shall be provided.

Not part of Block 88; addressed on the Block 105 Conditions.

74) That details on all garage doors on Blocks 88 and 105 be provided and approved by the Urban Design Commission and staff.

The details of the garage doors are outlined on page 4-01B.

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75) That the plans be revised as follows:

The overhead doors for loading docks be brought out to the building façade. Material details for these doors shall be provided.

The overhead doors for loading have been relocated as outlined on pages 2-06 and 3-04. Door Cut Sheet has been provided on Sheet 4-01B

- At open parking garage entries the exterior finishes shall be extended into the opening to effectively provide a finished and continuous aesthetic sense to the pedestrian realm.

The finishes have been extended into the openings a minimum of 10'.

- At the hotel parking garage entry an overhead door shall be provided at the building façade.

Not part of Block 88; addressed on the Block 105 Conditions.

- 76) Material details for this door shall be provided.
- The locations and details for all parking garage intake and exhaust louvers shall be provided. Any other large venting requirements for mechanical equipment which will not be located within the louvers shown above windows or doors shall also be provided.

The locations are identified on pages 2-16, 2-16-A, 2-18, 2-18-A and 3-14.

 Locations of street trees and planters shall be reviewed with appropriate city staff and identified consistently on the submitted plans.

The location of street trees and planters was addressed in UDC Question #3 with additional details found on 100% CD's/ Owners Review Landscape Drawings submitted with this cover letter.

Details for exterior visitor bicycle parking shall be provided for hotel, retail and apartment guests.

Parking for guest bike parking is located on 100% CD's/ Owners Review Landscape Drawings submitted with this cover letter.

- Access and security for the Public Garage Bicycle Parking be reviewed to provide usable entry for persons with bicycles. Consideration should be given to making this a secured parking area for cyclists on a rental basis rather than an open access 24 hour facility.

City Staff has reviewed and is satisfied with the plans as presented in this package.

For the Block 105 proposal the applicant shall continue to work with staff and the Urban Design Commission on design elements along Doty St. at the base of the building to provide a design more contextually compatible.


Not part of Block 88; addressed in Block 105 Conditions.

D. Planning Division Block 105 Conditions Items 72-77

- 72) That the applicant receives Final Approval from the Urban Design Commission prior to submitting plans for final sign off for Block 88 and 105
 - Applicant has been granted Initial Approval and is seeking Final Approval.
- 73) That the "SW" (rear) elevation drawing for Block 88 is revised to show additional building/base_detail and articulation for those portions of the building that extend closer to the East Doty and Wilson Street sidewalks than Madison Municipal Building. These details shall be approved by the Urban Design Commission and staff.

 Not part of Block 105, addressed in Block 88 Conditions
- 74) That for Blocks 88 and 105, all screening walls, elevator penthouses, and rooftop mechanicals are clearly labeled and dimensioned on rooftop plans, sections, and elevation drawings. The height of screening walls should be of the minimum height necessary to screen equipment. These details shall be approved by the Urban Design Commission and staff.

The screening walls, elevator penthouses and rooftop mechanicals are clearly labeled on pages 2-12 and 3-07 and are at the minimum heights necessary to screen equipment.

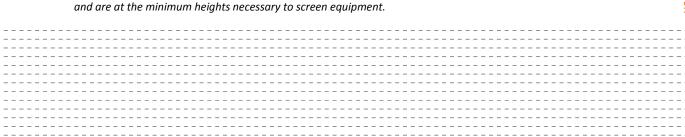

75) That the door location on Block 105 retail space (on Wilson Street) be identified. An entrance to Wilson Street shall be provided.

The door location is identified on pages 3-04 and can be seen on elevations on 3-14 and 3-17.

- 76) That details on all garage doors on Blocks 88 and 105 be provided and approved by the Urban Design Commission and staff.
 - The details of the garage doors are outlined on pages 4-01B.
- 77) That the plans be revised as follows:
- The overhead doors for loading docks be brought out to the building façade. Material details for these doors shall be provided.

The overhead doors for loading have been relocated as outlined on page 3-04.

- At open parking garage entries the exterior finishes shall be extended into the opening to effectively provide a finished and continuous aesthetic sense to the pedestrian realm.

The finishes have been extended into the openings a minimum of 10'.

- At the hotel parking garage entry an overhead door shall be provided at the building façade.

The overhead door is provided and outlined on page 3-04.

The locations and details for all parking garage intake and exhaust louvers shall be provided. Any other large venting requirements for mechanical equipment which will not be located within the louvers shown above windows or doors shall also be provided.

The locations are identified on pages 3-14, 3-15, and 3-16.

 Locations of street trees and planters shall be reviewed with appropriate city staff and identified consistently on the submitted plans.

The location of street trees and planters was addressed in UDC Question #3 with additional details found on page 1-11A.

- Details for exterior visitor bicycle parking shall be provided for hotel, retail and apartment guests.
 - Parking for guest bike parking is located on pages 1-11A.
- Access and security for the Public Garage Bicycle Parking be reviewed to provide usable entry for persons with bicycles. Consideration should be given to making this a secured parking area for cyclists on a rental basis rather than an open access 24 hour facility.


City Staff has reviewed and is satisfied with the plans as presented in this package.


For the Block 105 proposal the applicant shall continue to work with staff and the Urban Design Commission on design elements along Doty St. at the base of the building to provide a design more contextually compatible. The ground level glass has been modified to be taller and narrower delivering a more vertical context to the base of the building. Carrying the ground floor condition above the first floor along Doty Street is not feasible in light of the fact the area on the second floor is occupied living space which requires natural light and the exterior of the building transitions and articulates away from the ground floor wall condition beginning on the second floor.


Please contact me at (608) 445-9594, if you have any questions or need further information.

Thank You,

Chris A. Oddo, AIA Principal

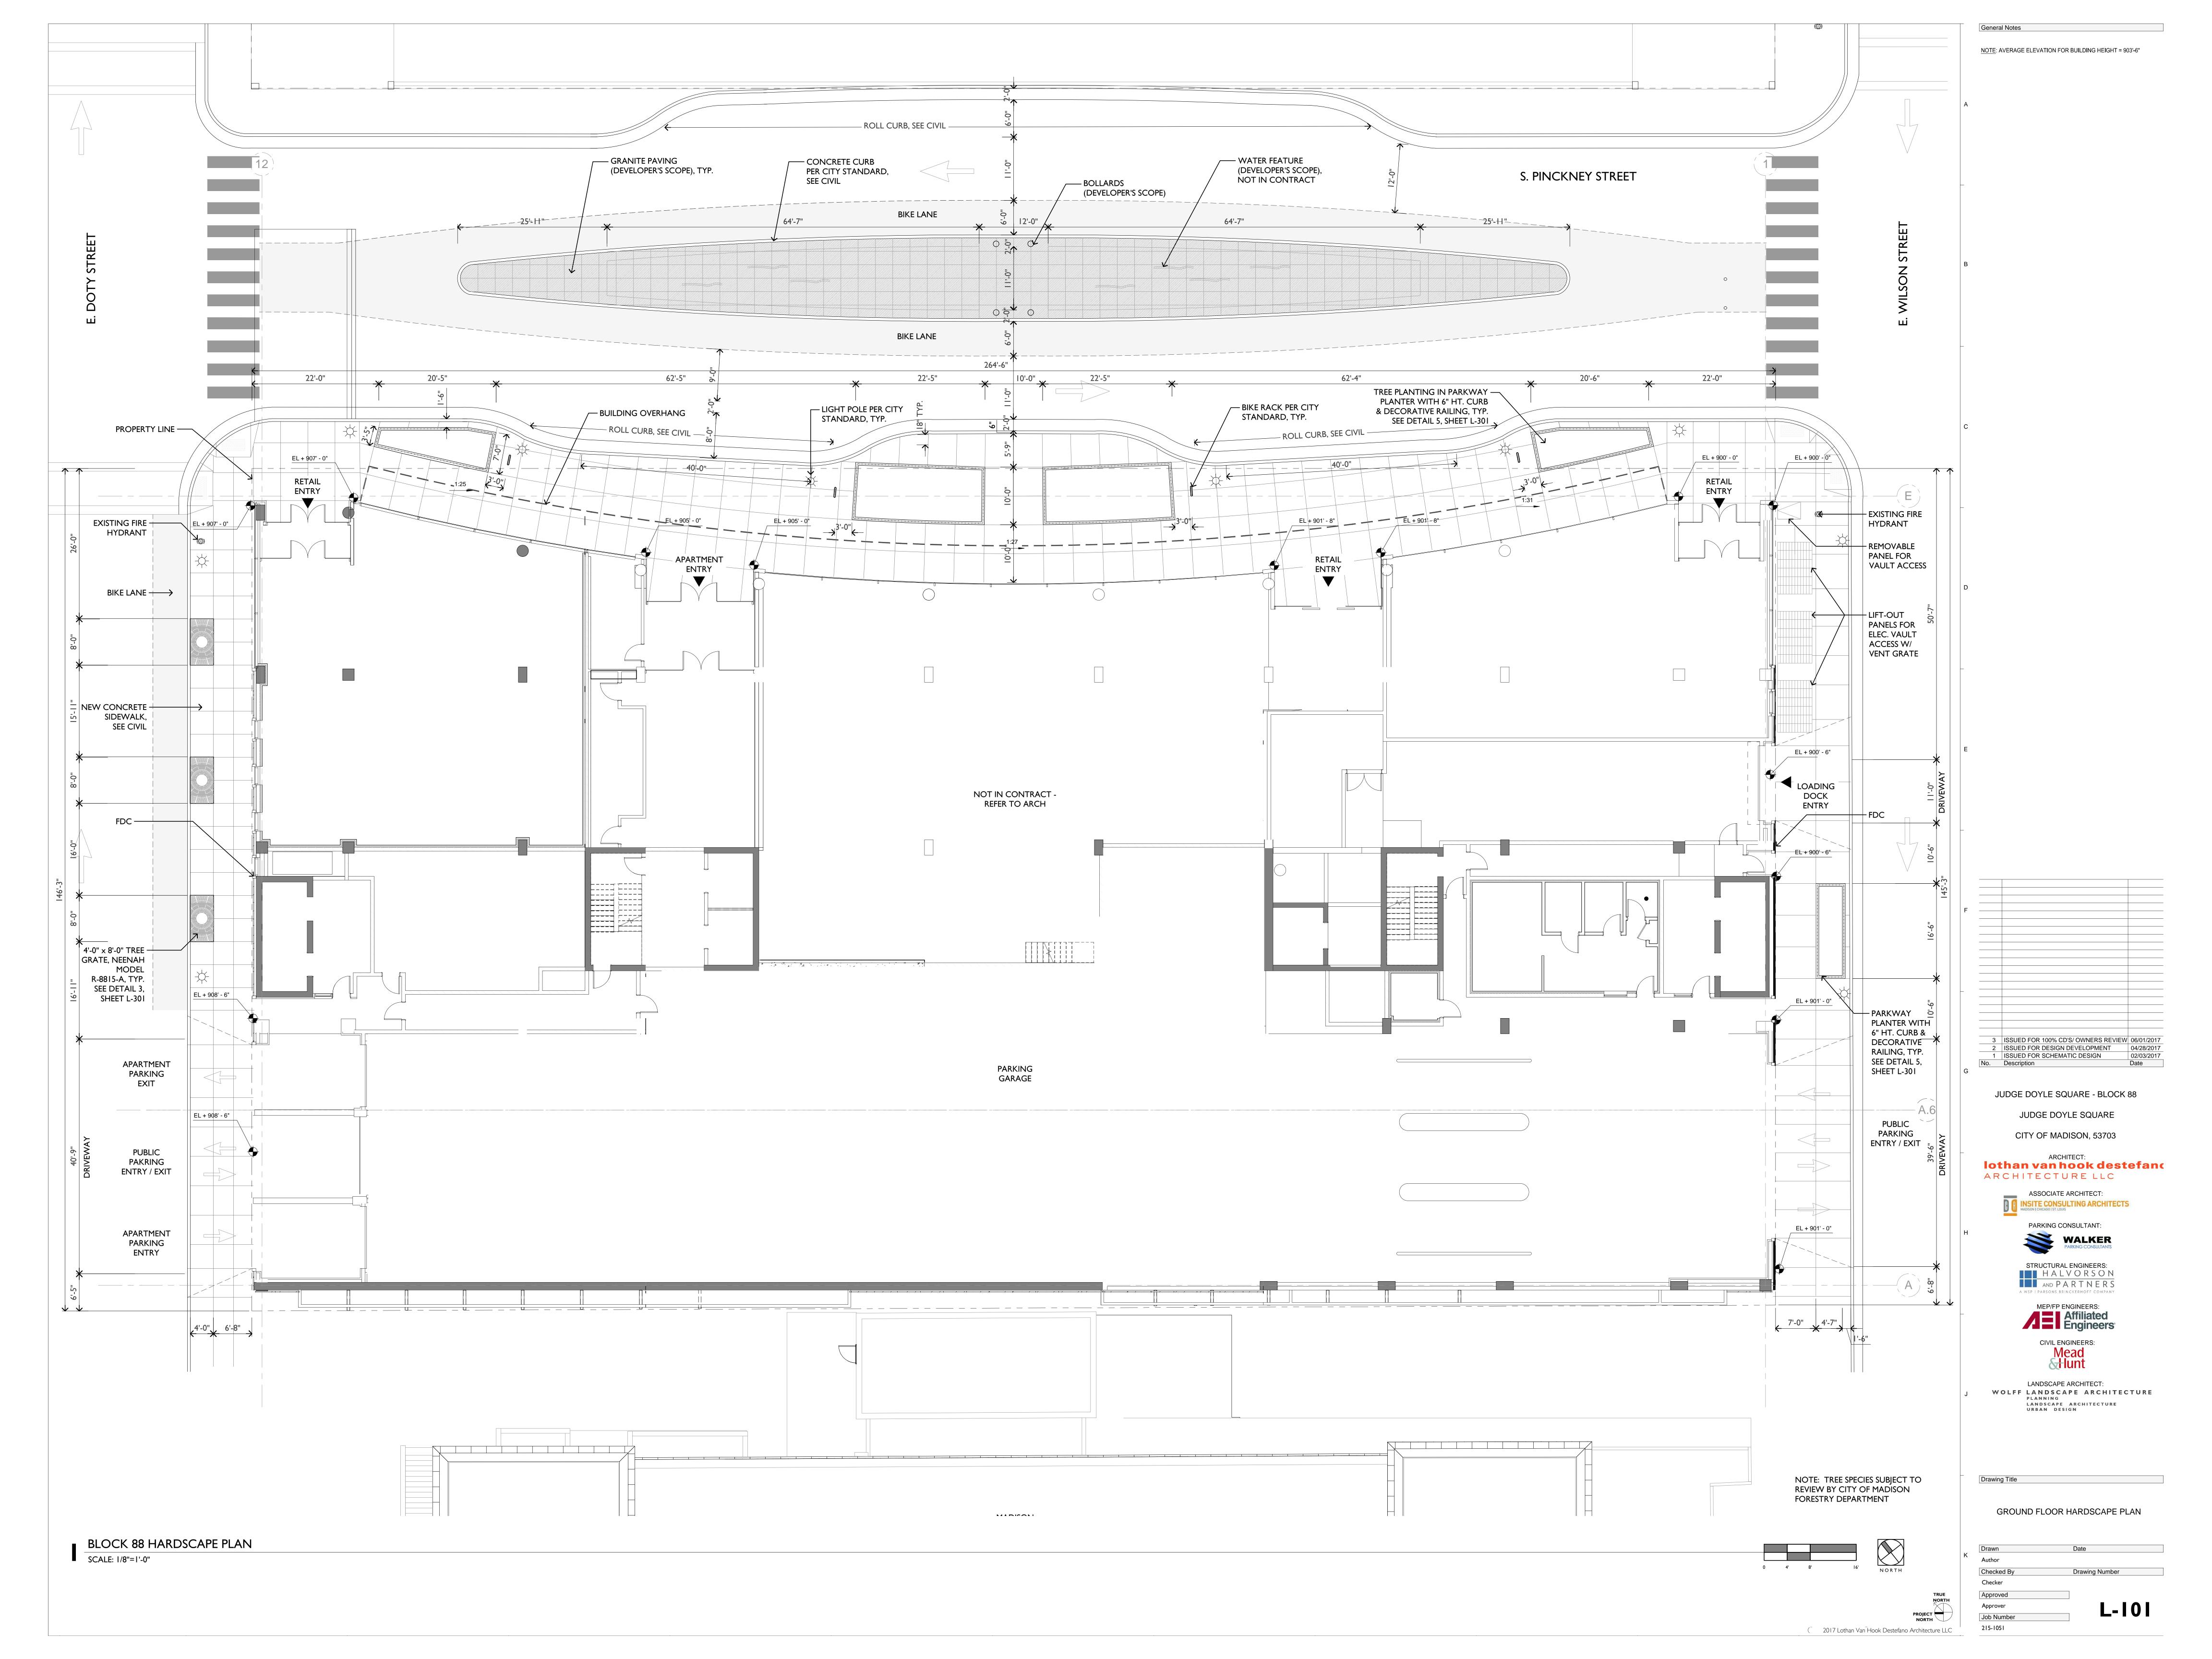

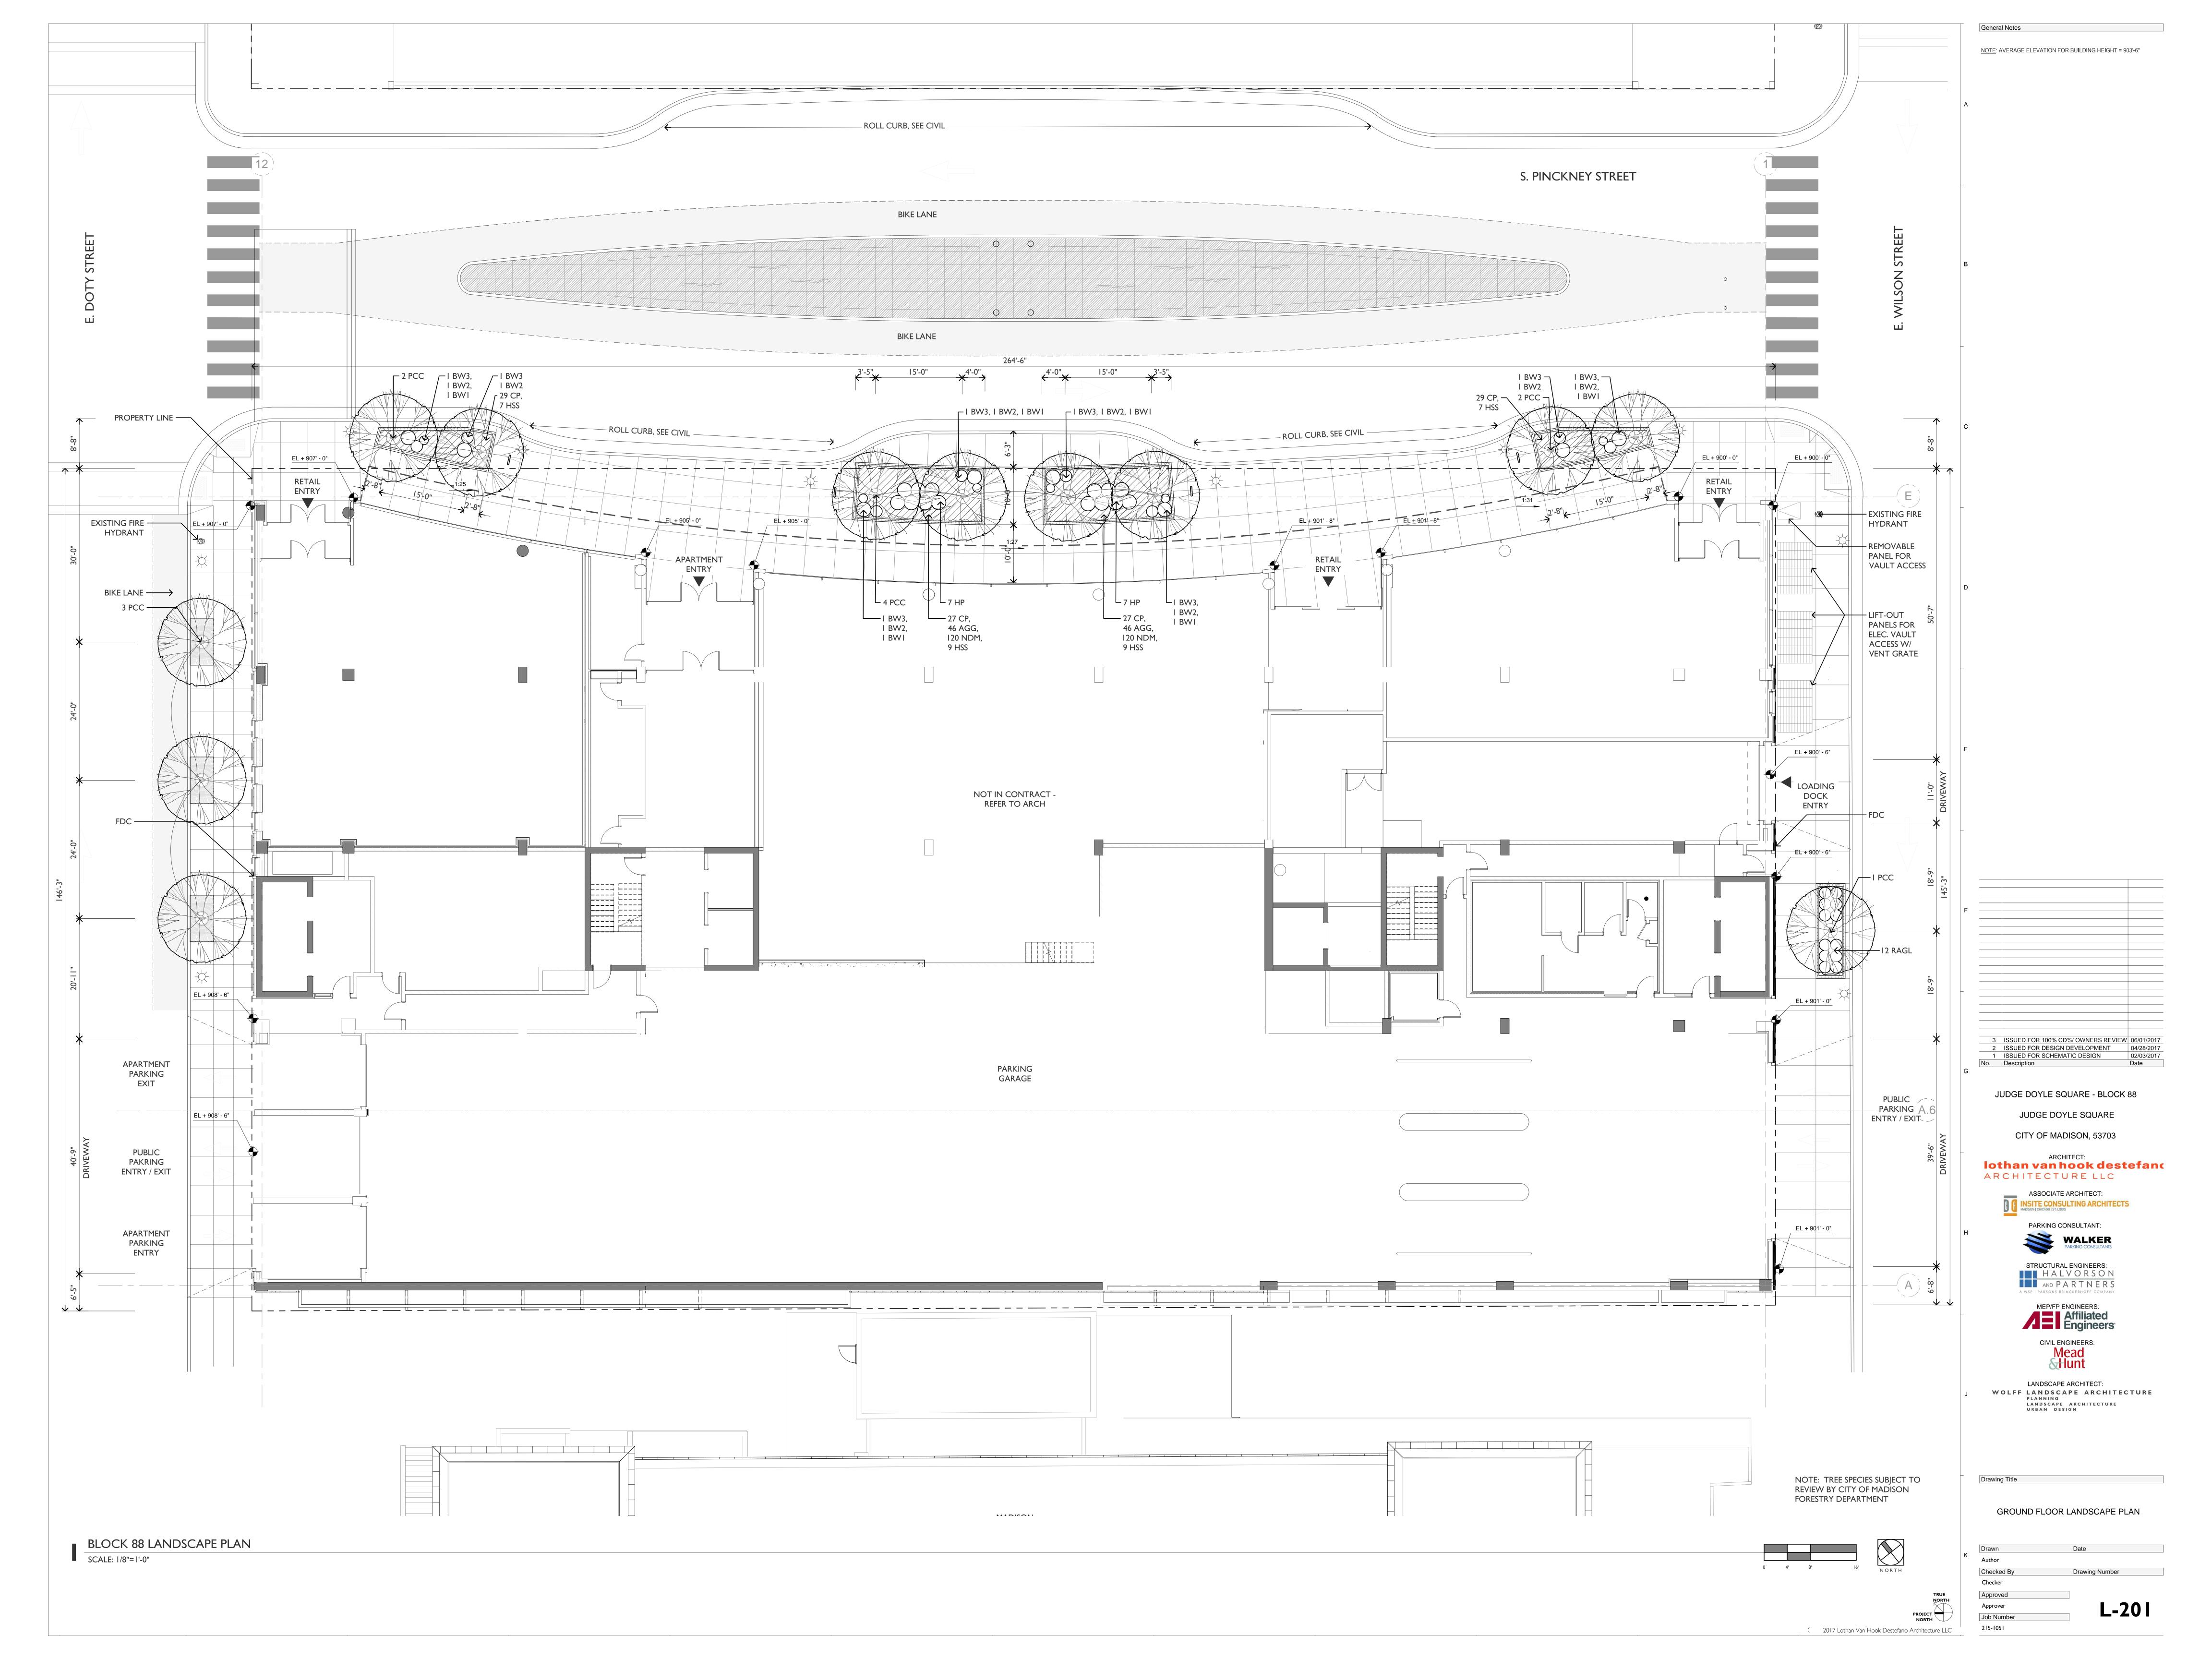

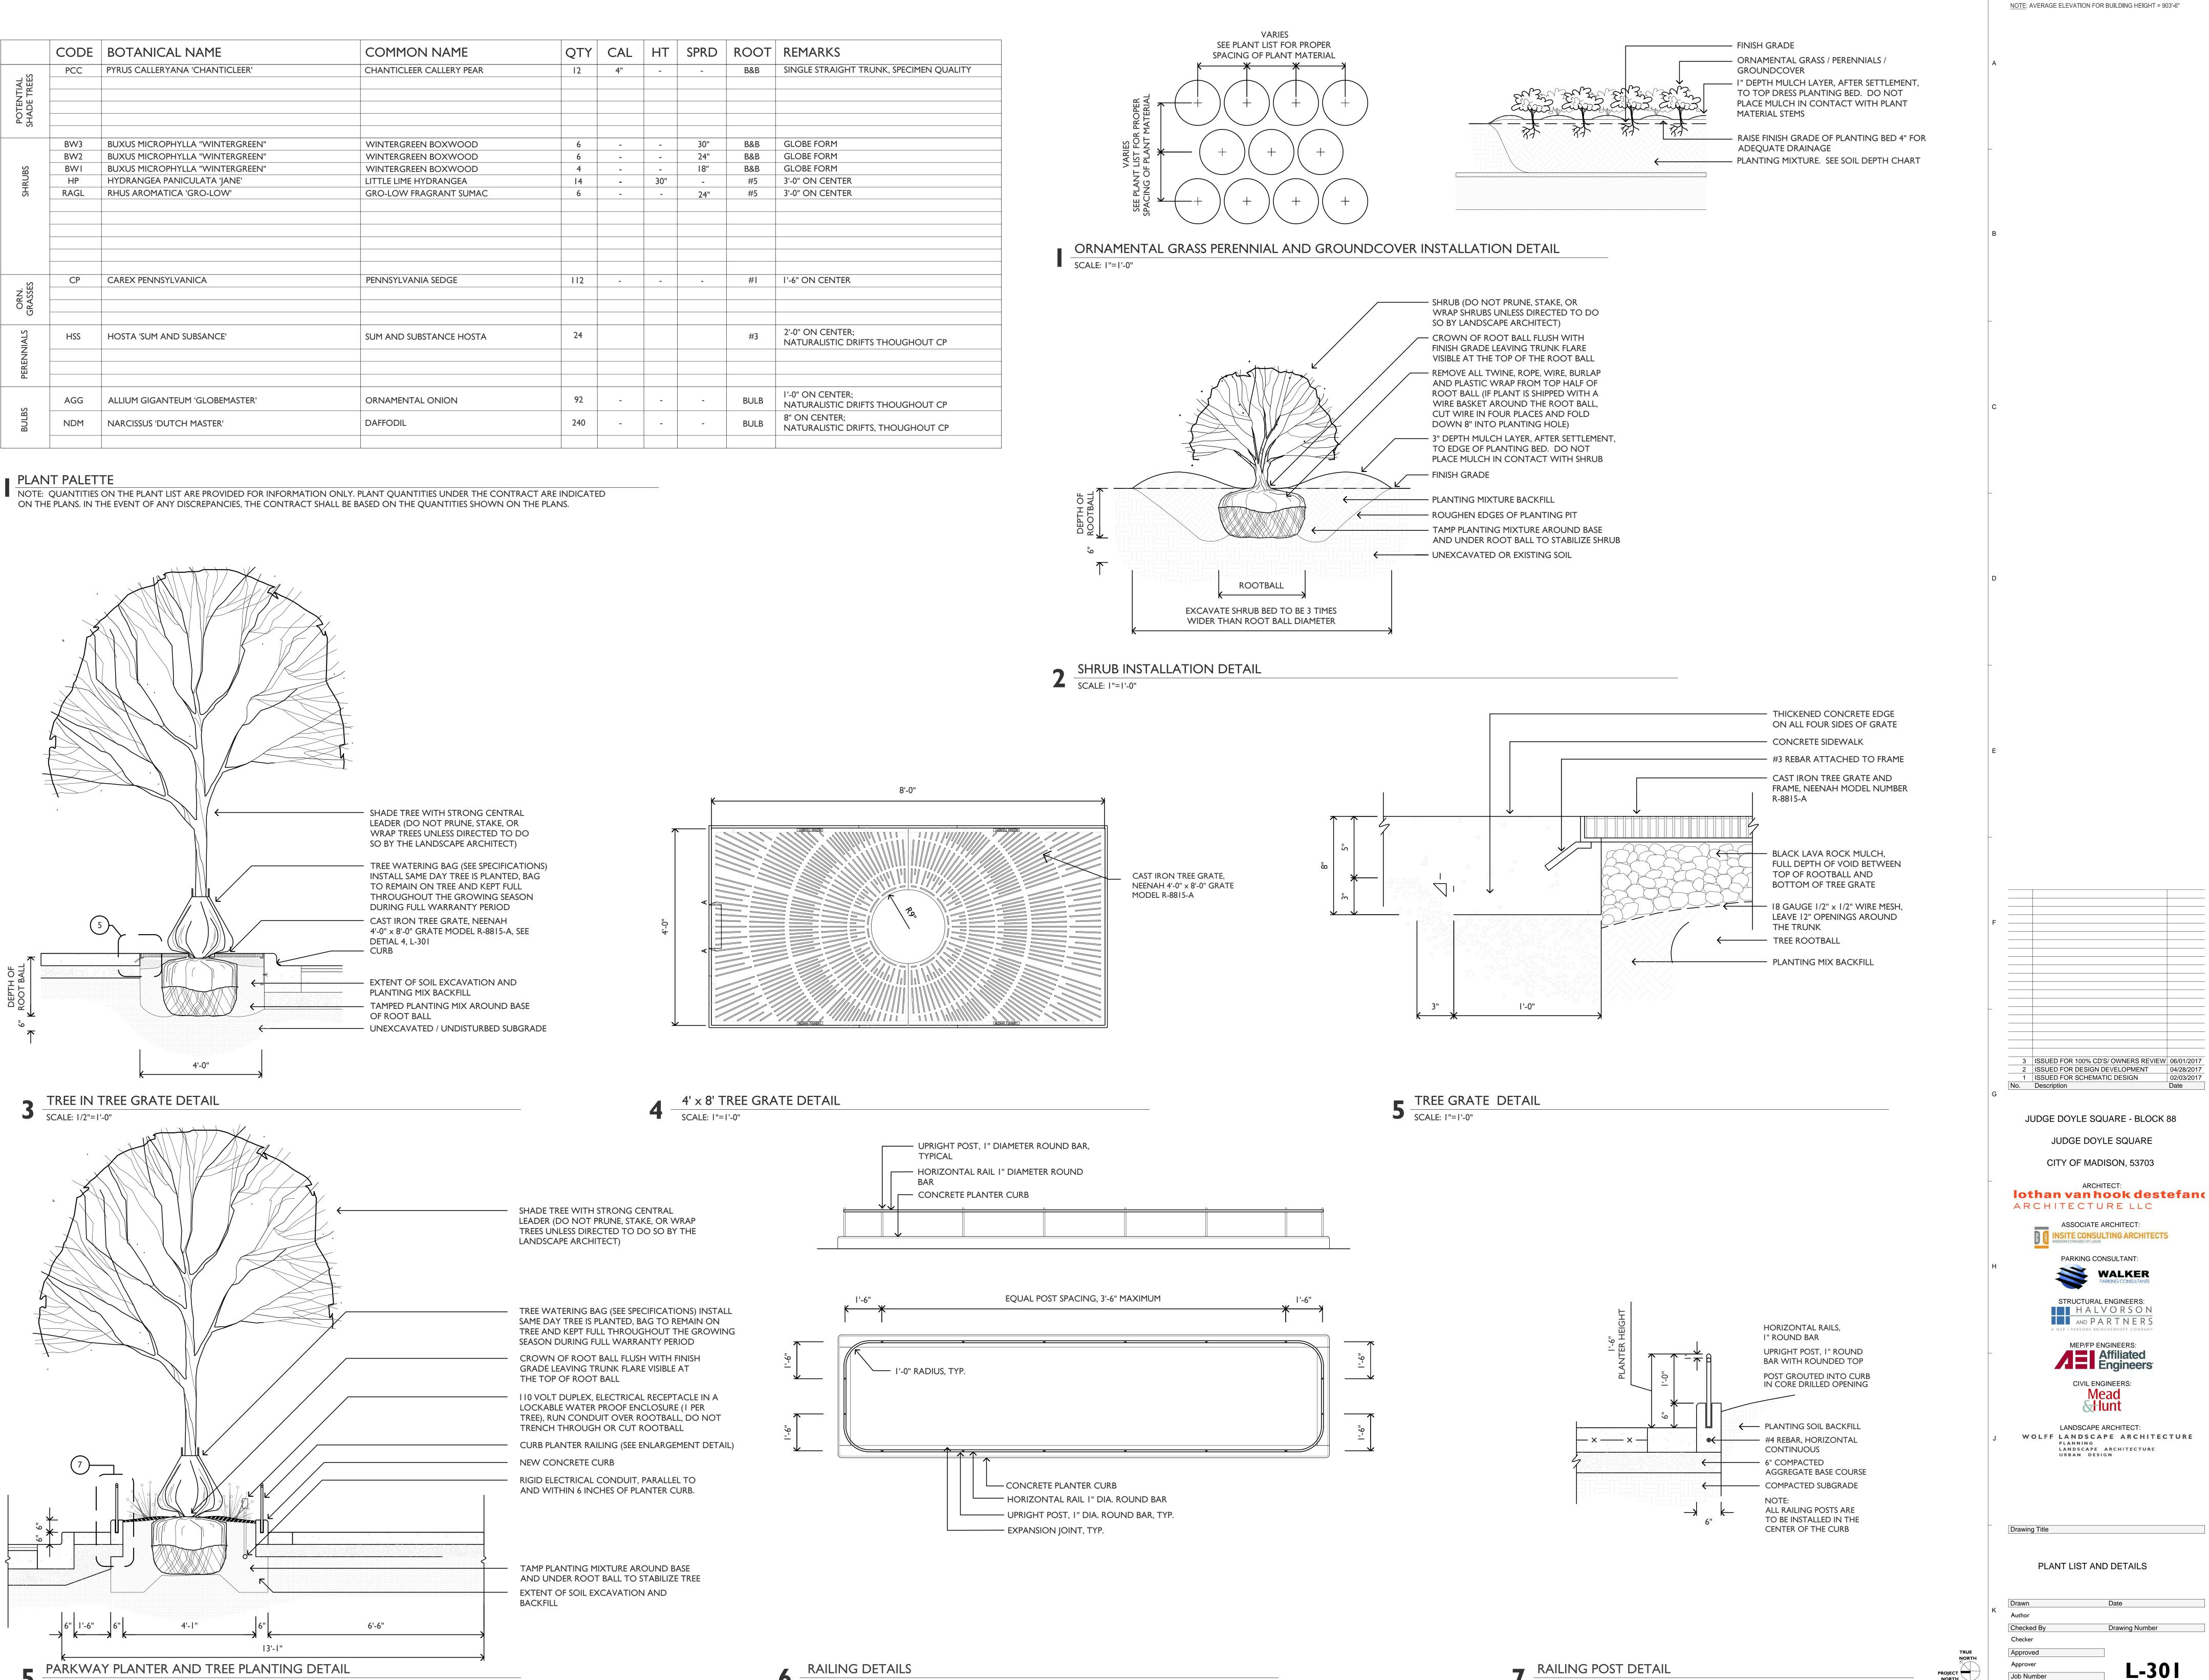

SCALE: 1/2"=1'-0"

General Notes NOTE: AVERAGE ELEVATION FOR BUILDING HEIGHT = 903'-6"

ARCHITECT:

MEP/FP ENGINEERS:

CIVIL ENGINEERS:

Mead Munt


Drawing Number

NORTH

(2017 Lothan Van Hook Destefano Architecture LLC

SCALE: | "=|'-0"

L-301

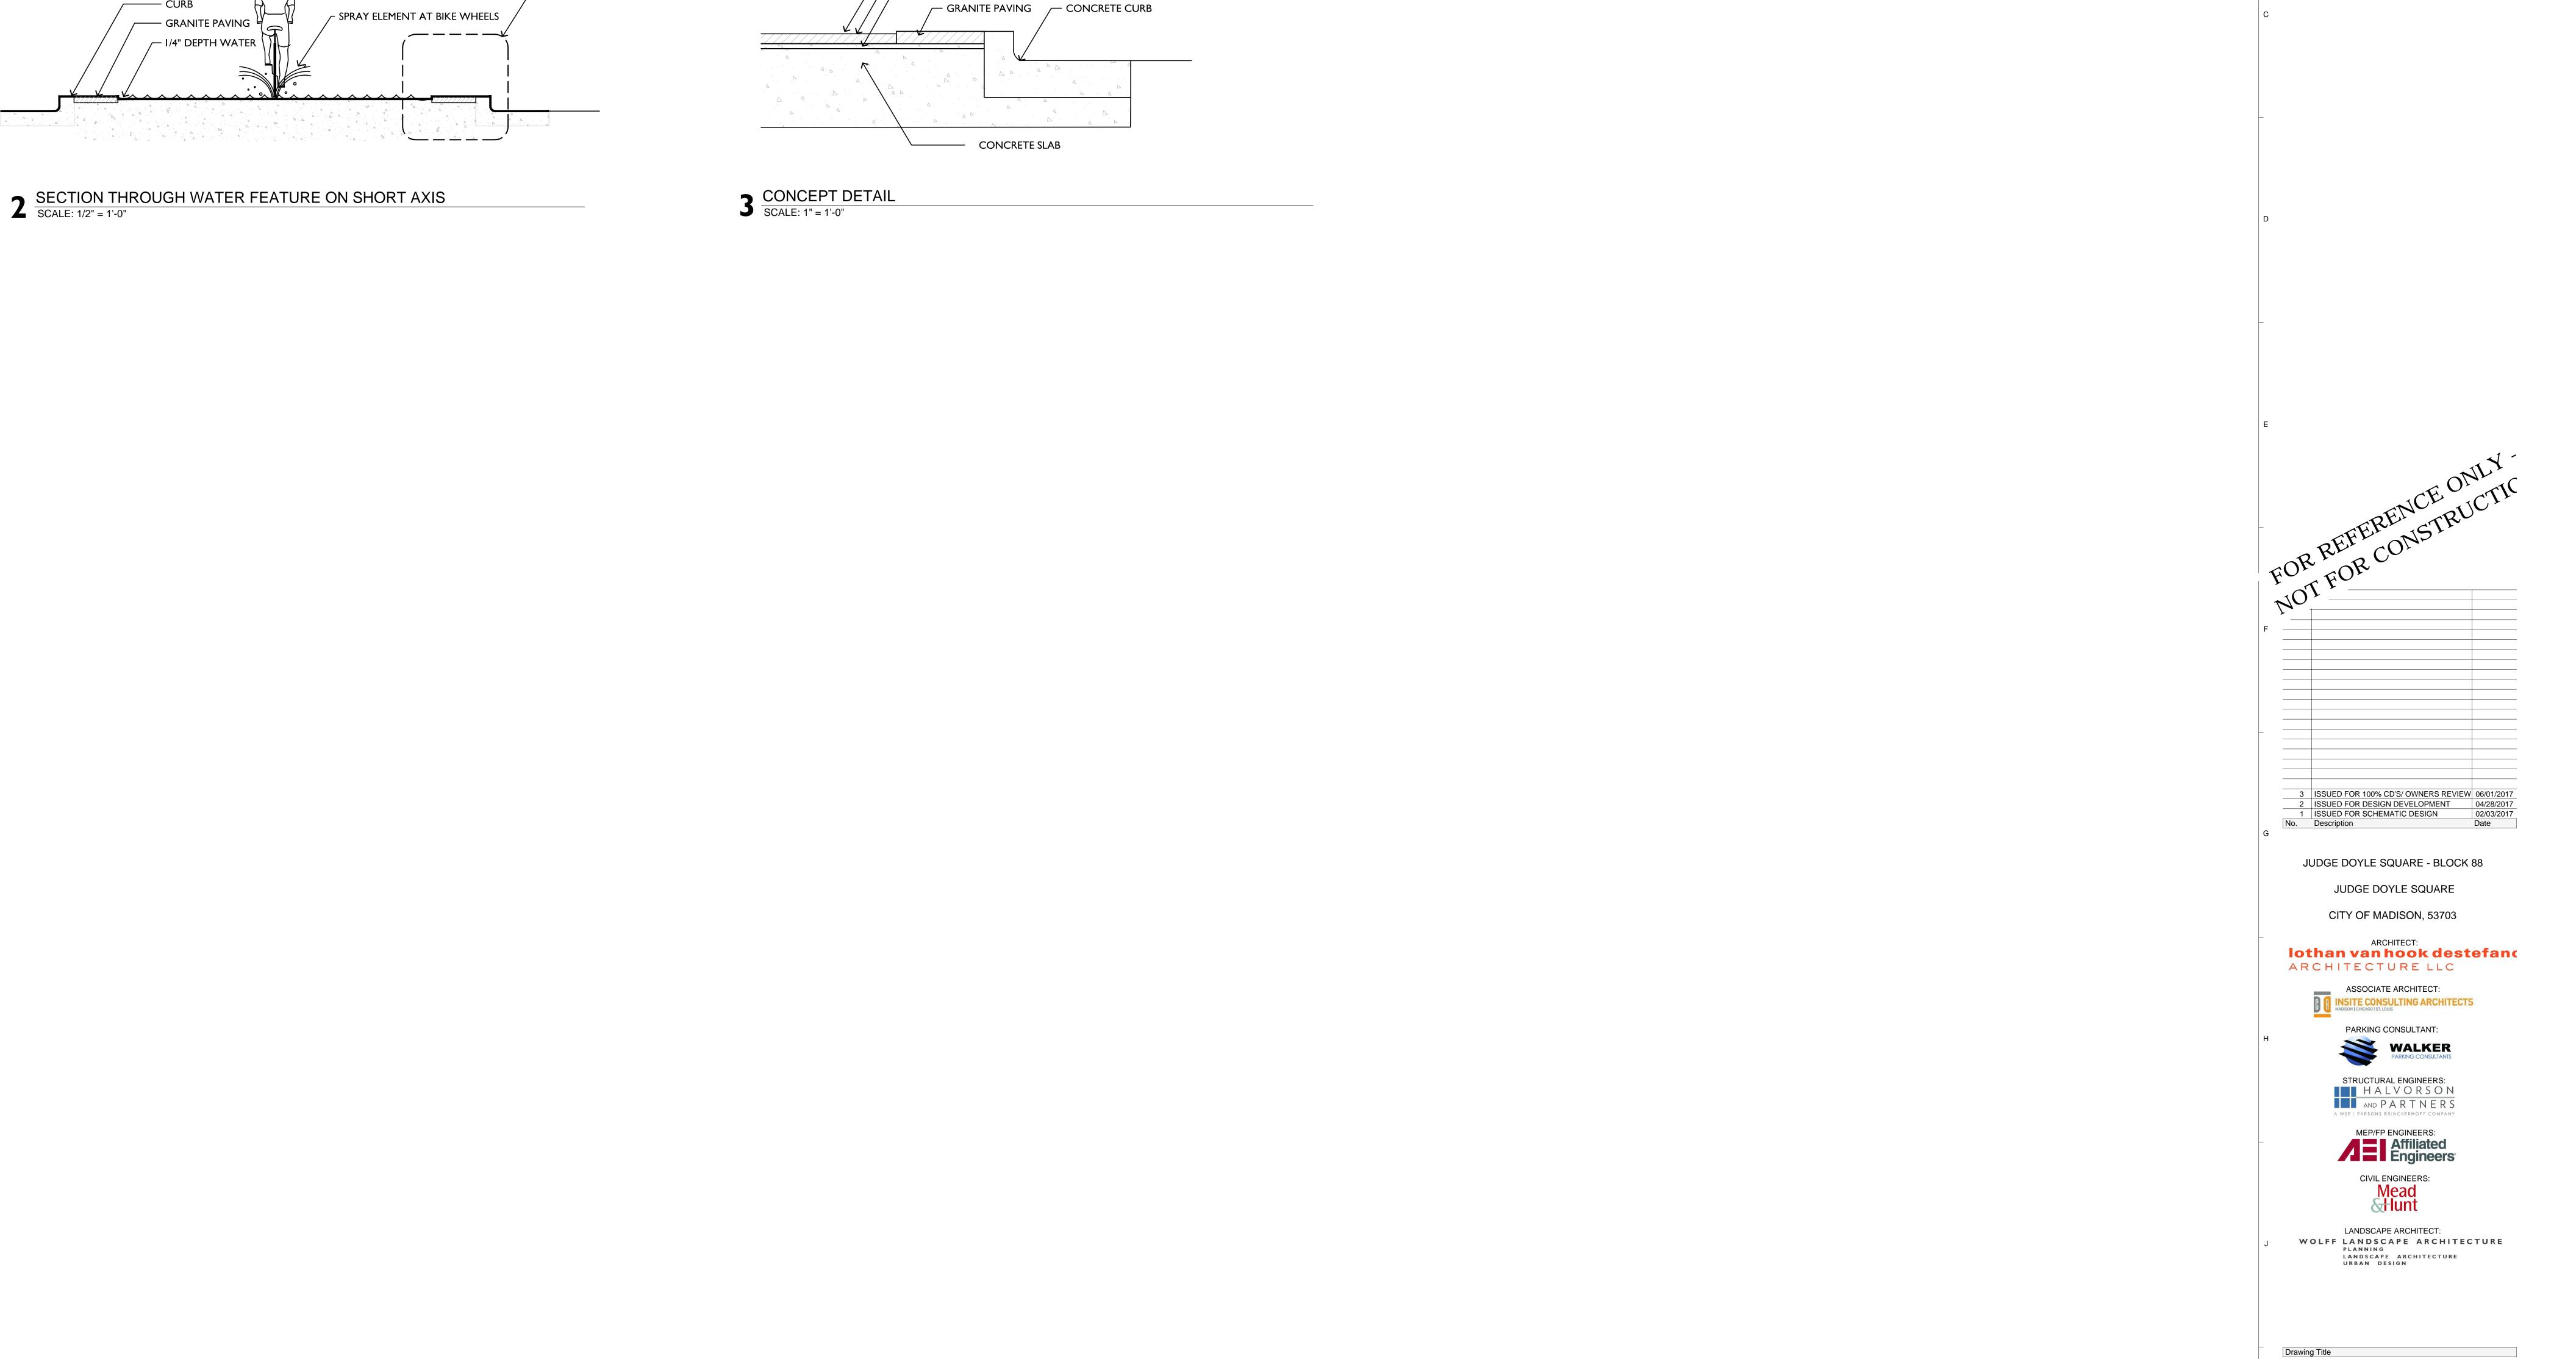

— BICYCLIST SCULPTURE, TYP.

—— I/4" DEPTH WATER

— MORTAR SETTING BED

— GRANITE, GROOVES OR WITH FLAME FINISH

— WATER FEATURE,

OF ROADWAY

SECTION THROUGH WATER FEATURE ON LONG AXIS

SCALE: 1/8" = 1'-0"

 \sim Granite Paving $^{lat}$

/— I/4" DEPTH WATER

TO FOLLOW SLOPE

— BICYCLIST SCULPTURE

NOTE: AVERAGE ELEVATION FOR BUILDING HEIGHT = 903'-6"

WATER FEATURE DETAILS

PROJECT NORTH


(2017 Lothan Van Hook Destefano Architecture LLC

Job Number

Drawing Number

L-302

General Notes

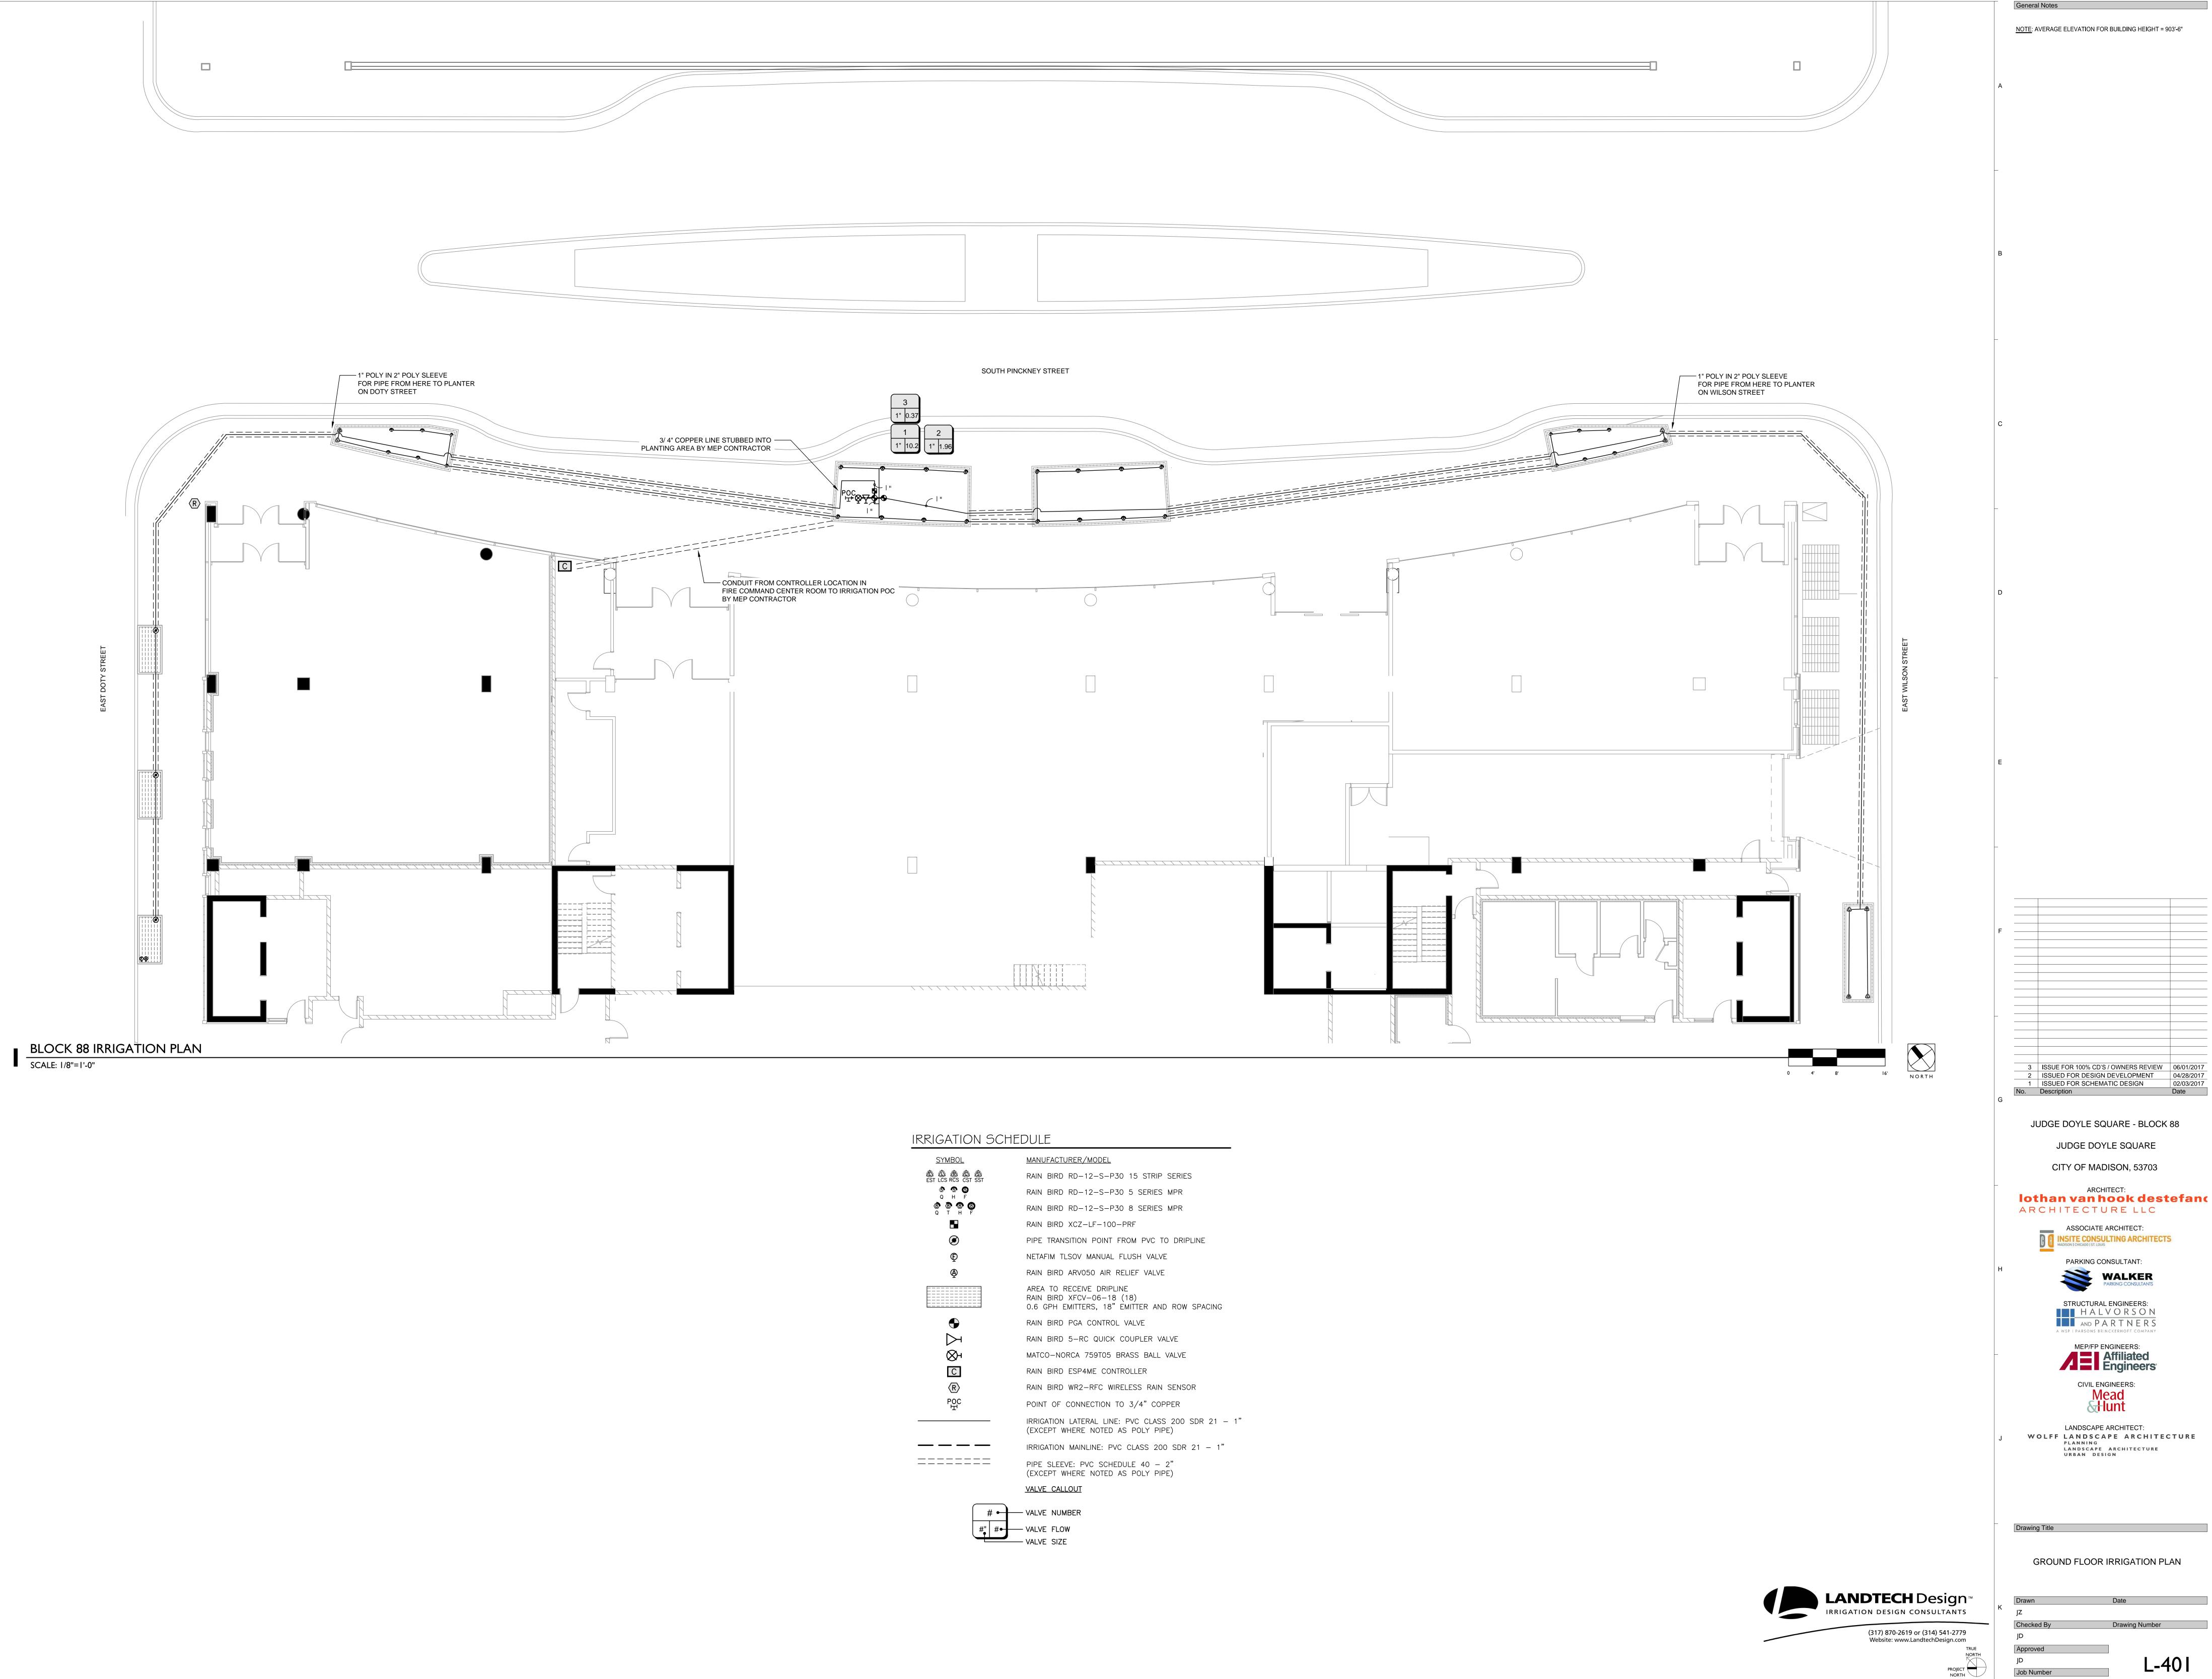


NOTE: AVERAGE ELEVATION FOR BUILDING HEIGHT = 903'-6"

lothan van hook destefanc



Drawing Number L-401

(2017 Lothan Van Hook Destefano Architecture LLC

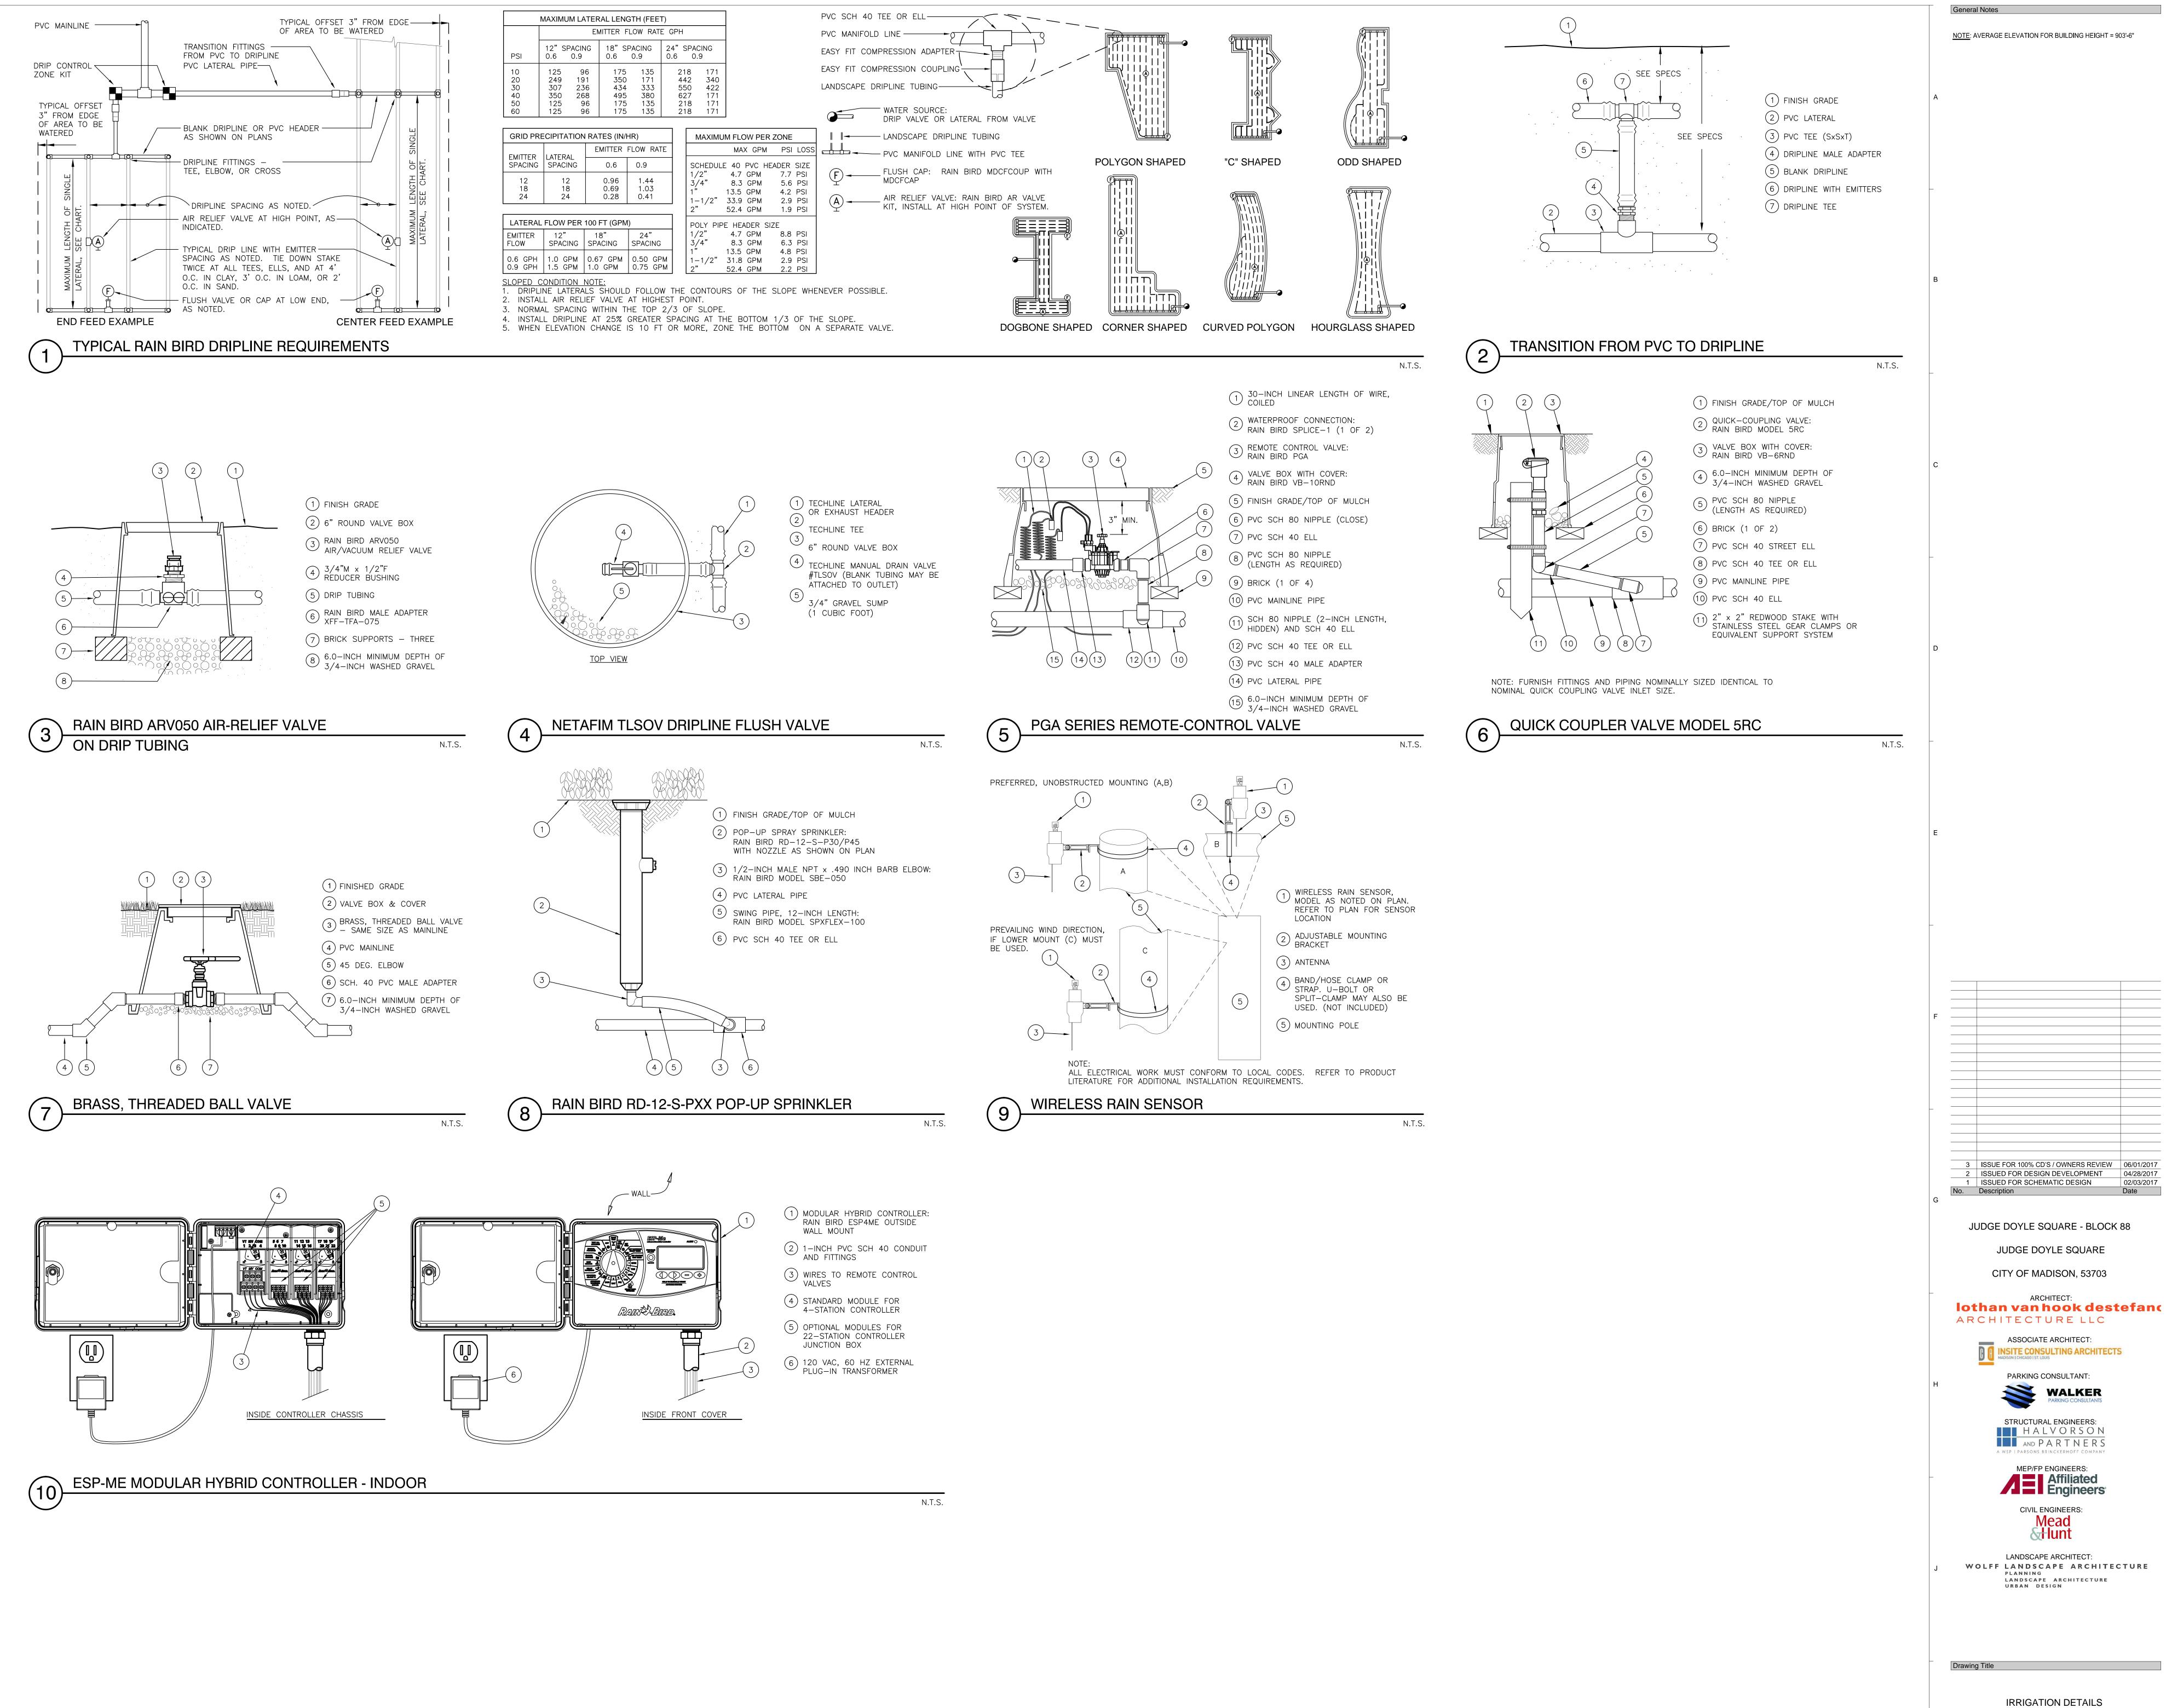

LANDTECH Design[®] IRRIGATION DESIGN CONSULTANTS (317) 870-2619 or (314) 541-2779 Website: www.LandtechDesign.com NORTH 🔍 (2017 Lothan Van Hook Destefano Architecture LLC

Drawing Number L-402

JUDGE DOYLE SQUARE

ARCHITECT:

ASSOCIATE ARCHITECT:

PARKING CONSULTANT:

WALKER PARKING CONSULTANTS

STRUCTURAL ENGINEERS: HALVORSON AND PARTNERS

MEP/FP ENGINEERS:

Affiliated Engineers

CIVIL ENGINEERS:

LANDSCAPE ARCHITECT:

LANDSCAPE ARCHITECTURE

IRRIGATION DETAILS

PLANNING

URBAN DESIGN



	##	DRAWING TITLE			
				3-00	COVER SHEET - BLOCK 105
REVISED	1-00	COVER SHEET - GENERAL INFORMATION		3-01	UNDERGROUND PARKING - LOWER LEVEL 4
REVISED	1-01	TABLE OF CONTENTS		3-02	UNDERGROUND PARKING - LOWER LEVEL 2,3
	1-02	PROJECT INFORMATION SHEET		3-03	UNDERGROUND PARKING - LOWER LEVEL 1
	1-03	EXISTING CONDITIONS INFORMATION/CONTEXT PHOTOS	REVISED		1ST FLOOR PLAN
	1-03-A	CONTEXT PHOTOS	REVISED		2ND FLOOR PLAN
	1-03-B	CONTEXT PHOTOS		3-06	TYPICAL TOWER FLOORS 3-12
	1-03-C	CONTEXT PHOTOS - DEMOLITION		3-06-A	TYPICAL APARTMENT LAYOUTS
	1-03-D	CONTEXT PHOTOS - DEMOLITION		3-06-B	TYPICAL HOTEL LAYOUTS
	1-04	CONDITIONAL USE REQUEST/ DOWNTOWN DESIGN GUIDELINES		3-07	ROOF PLAN
	1-04-A	DOWNTOWN DESIGN GUIDELINES		3-08	BUILDING SECTION AA
	1-04-B	DOWNTOWN DESIGN GUIDELINES		3-09	BUILDING SECTION BB
	1-04-C	DOWNTOWN DESIGN GUIDELINES	REVISED		BUILDING SECTION CC
	1-05	ALDER/NEIGHBORHOOD NOTIFICATION	REVIOLD	3-11	BUILDING SECTION DD
	1-06	SITE CONNECTIVITY DIAGRAM		3-12	BUILDING SECTION EE
	1-07	SURVEY		3-12	BUILDING SECTION FF
REVISED		OVERALL SITE PLAN	REVISED		SE ELEVATION - WILSON STREET
REVISED		PINCKNEY STREET SITE PLAN	REVISED		NE ELEVATION - WESON STREET NE ELEVATION - NEW ENTRY DRIVE
REVISED		FIRE ACCESS PLAN	REVISED		NW ELEVATION - NEW ENTRY DRIVE
REVISED		GROUND FLOOR LANDSCAPE PLAN	REVISED		SW ELEVATION - DOTT STREET
KLVIOLD	1-11-A 1-11-B	SECTIONS	ADDED		HOTEL CANOPY
	1-11-B	BLOCK 88 ROOF LANDSCAPE PLAN	DELETED		CANOPY OPTION A
	1-11-C	BLOCK 38 ROOF LANDSCAPE PLAN BLOCK 105 ROOF LANDSCAPE PLAN	DELETED		CANOPY OPTION A CANOPY OPTION B
	1-11-D	GROUND FLOOR PLANTING PALETTE	DELETED		CANOPY OPTION B CANOPY OPTION C
	1-12-A 1-12-B	ROOF/ AMENITY DECK PLANTING PALETTE	DELETED		CANOPY OPTION C
	1-12-D	ROOF/ AWIENTT DECK PLANTING PALETTE	REVISED		3D MASSING - AERIAL VIEWS
	2-00	COVER SHEET - BLOCK 88	REVISED		3D MASSING - AERIAL VIEWS 3D MASSING - AERIAL VIEWS
	2-00 2-01	PARKING LEVEL U4	REVISED		3D MASSING - AERIAL VIEWS 3D MASSING - STREET LEVEL VIEWS
	2-01	PARKING LEVEL 04 PARKING LEVEL U3	REVISED	-	3D MASSING - STREET LEVEL VIEWS
	2-02	PARKING LEVEL U2	KLVIOLD	J-ZZ	3D WASSING - STREET LEVEL VIEWS
	2-03 2-04	PARKING LEVEL U1		4-00	COVER SHEET - OVERALL MATERIALS,
REVISED		PARKING LEVEL U0		4-00	SHADOW STUDIES, AND RENDERINGS
REVISED	2-05 2-06	LEVEL 1 - WILSON STREET ENTRY		4-01	MATERIALS BOARD - EXTERIOR
REVISED	2-00 2-07	LEVEL 2 - WILSON STREET ENTRY	ADDED		LOADING DOCK/PARKING ENTRY DOORS
KEVIOLD	2-07	LEVEL 3 - APARTMENT PARKING	ADDED		EXTERIOR VISITOR BICYCLE PARKING
	2-09	LEVEL 4 - APARTMENT PARKING	ADDLD	4-01-C 4-02	GRAPHIC SIGNAGE - BLOCK 88
	2-03 2-10	LEVEL 5 - APARTMENT AMENITY		4-02 4-03	GRAPHIC SIGNAGE - BLOCK 105
	2-10 2-11	LEVELS 6-13 - TYPICAL APARTMENT LEVELS		4-03-A	GRAPHIC SIGNAGE - BLOCK 105
	2-11-A	ENLARGED TYPICAL APARTMENT PLAN		4-03-A 4-04	EXTERIOR LIGHTING - BLOCK 88
REVISED	2-11-7	ROOF PLAN		4-04-A	EXTERIOR LIGHTING - BLOCK 88
KEVIOLD	2-13	BUILDING SECTION A-A		4-04-B	EXTERIOR LIGHTING - BLOCK 88
	2-13 2-14	BUILDING SECTIONS B-B, C-C		4-05	EXTERIOR LIGHTING - BLOCK 105
	2-15	BUILDING SECTION D-D		4-05-A	EXTERIOR LIGHTING - BLOCK 105
REVISED	2-16	SE ELEVATION - WILSON STREET		4-05-B	EXTERIOR LIGHTING - BLOCK 105
REVISED	2-16-A	ENLARGED PARKING /LOADING ELEVATION		4-05-C	EXTERIOR LIGHTING - BLOCK 105
KEVIOLD	2-10-A 2-17	NE ELEVATION - PINCKNEY STREET		4-05-C 4-06	EXTERIOR LIGHTING - CUT SHEETS
	2-17-A	ENLARGED RETAIL ENTRY ELEVATION		4-06-A	EXTERIOR LIGHTING - CUT SHEETS
REVISED		NW ELEVATION - DOTY STREET		4-06-A 4-06-B	EXTERIOR LIGHTING - CUT SHEETS
REVISED	-	ENLARGED NW ELEVATION - DOTY STREET		4-06-Б 4-06-С	EXTERIOR LIGHTING - COT SHEETS EXTERIOR LIGHTING - STREET LIGHTS BY CITY
REVISED		SW ELEVATION - MMB		4-06-C 4-06-D	BLOCK 88 - PHOTOMETRIC DRAWINGS
REVISED		3D MASSING - AERIAL VIEW		4-06-E	BLOCK 105 - PHOTOMETRIC DRAWINGS BLOCK 105 - PHOTOMETRIC DRAWINGS
REVISED		3D MASSING - AERIAL VIEW 3D MASSING - STREET LEVEL VIEW		4-00-E 4-07	SHADOW STUDIES
REVISED		3D MASSING - STREET LEVEL VIEW		4-07 4-07-A	SHADOW STUDIES
	2-22	PUBLIC RIGHT OF WAY DIAGRAM		T-V1-A	OI II IDON OI ODILO
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V) \(\Lambda \) FOR CITY OF MADISON AND BEITLER REAL ESTATE

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4-12 4-13 RENDER - OVERALL SITE PLAN


RENDER - STREET WALLS

RENDER - PINCKNEY ST. SITE PLAN


RENDER - PINCKNEY STREET AERIAL

RENDER - PINCKEY STREET PERSPECTIVE

RENDER - 105 APARTMENT ENTRY DRIVE RENDER - 88 APARTMENT ROOF DECK

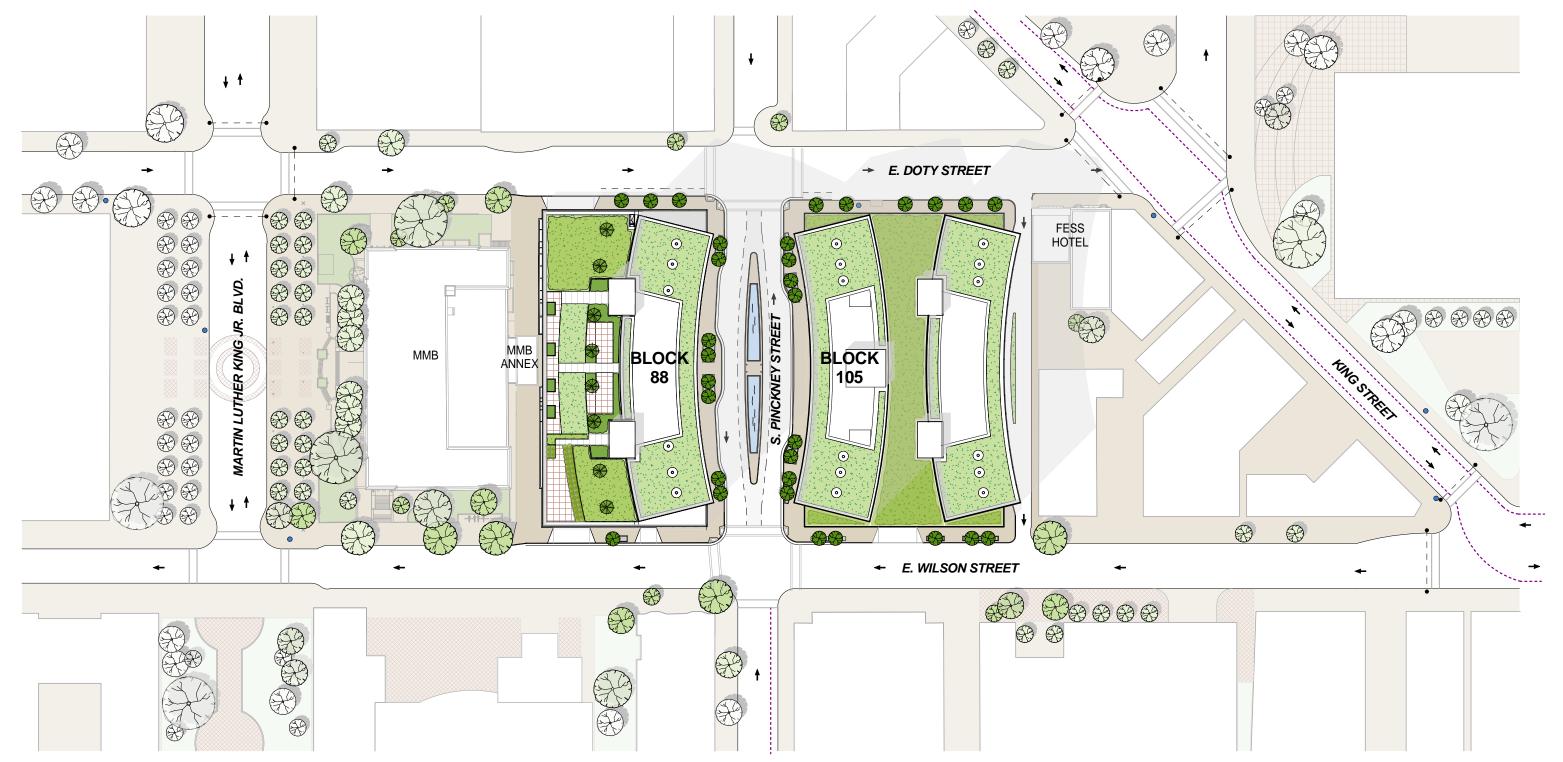


NOTE: AVERAGE ELEVATION FOR BLOCK 88 BUILDING HEIGHT = 903.5'

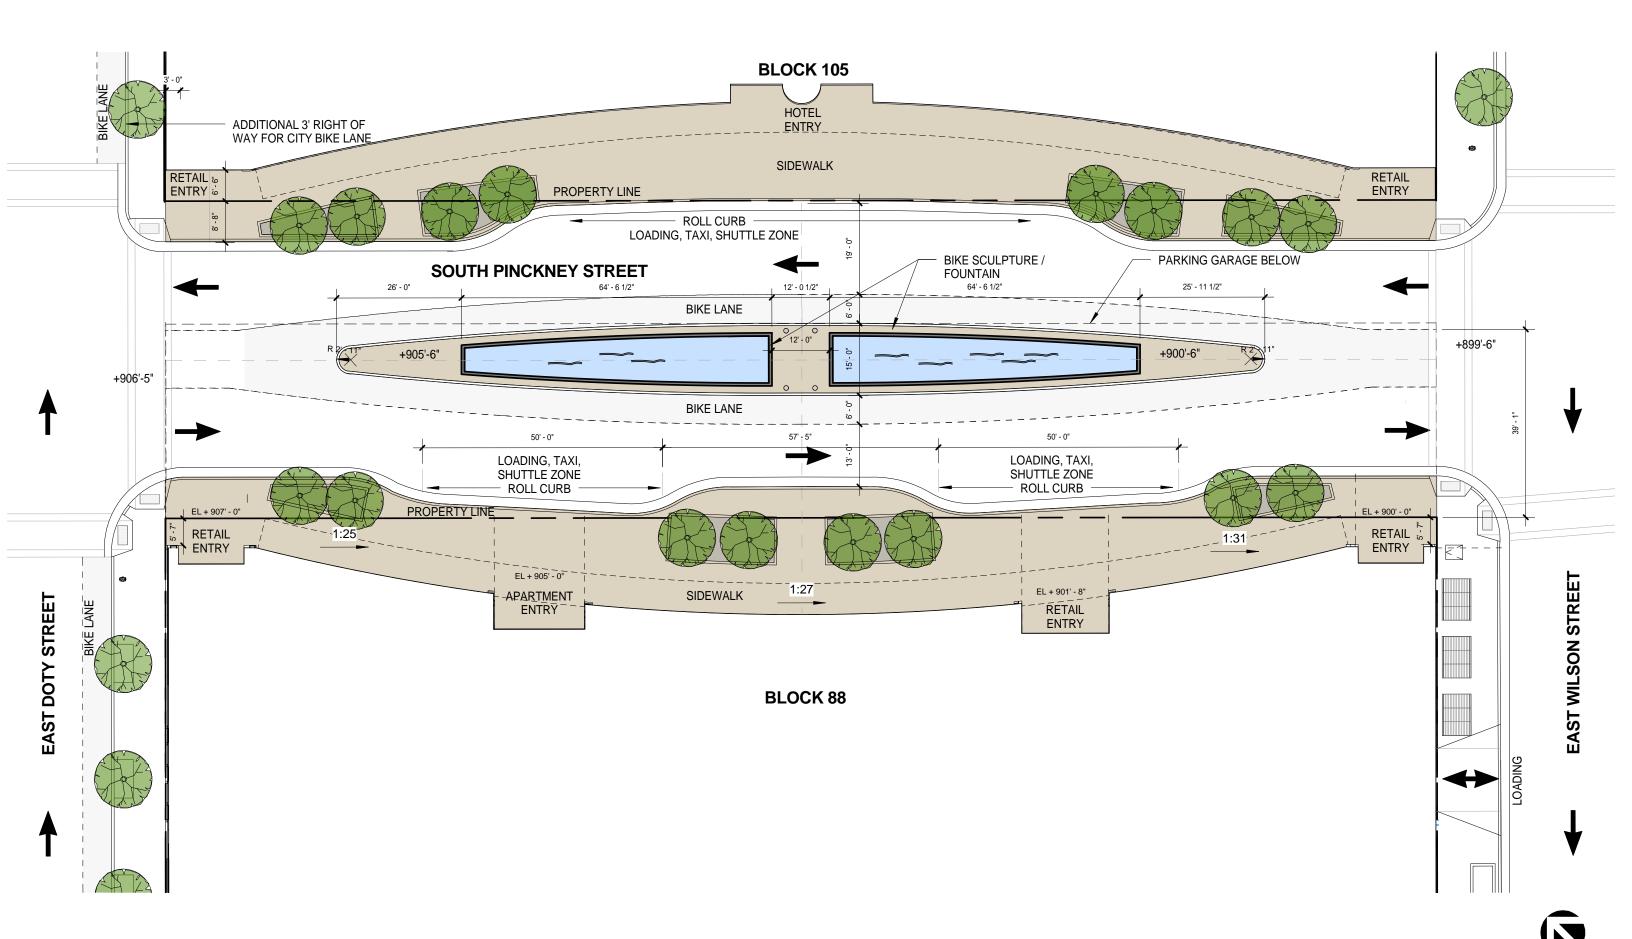


_ V ⊃ ∧ FOR CITY OF MADISON AND BEITLER REAL ESTATE


PINCKNEY STREET SITE PLAN

SCALE: 1" = 20'-0" **1**

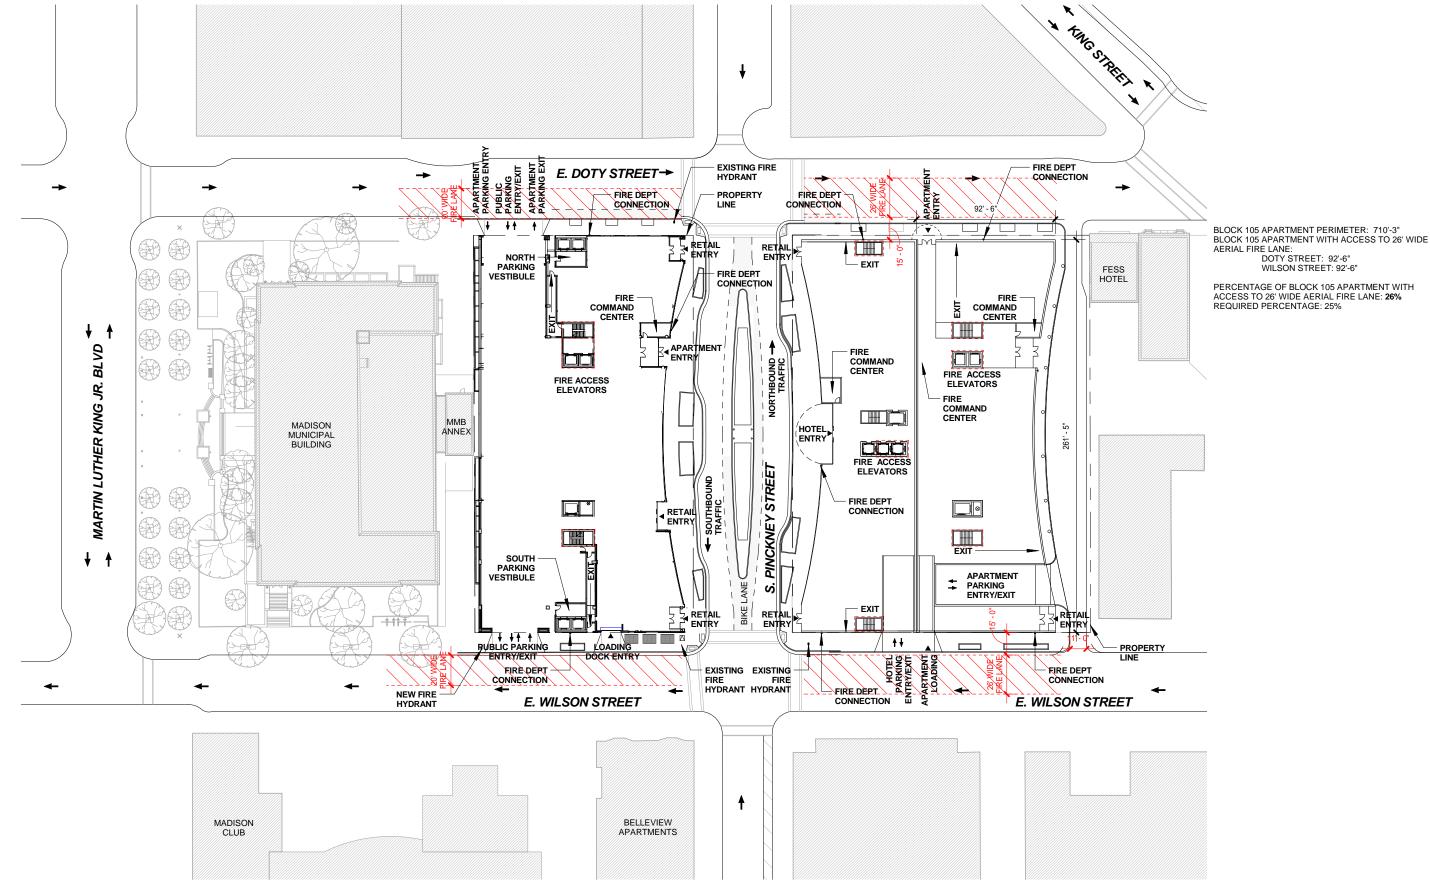

SCALE: 1/64" = 1'-0"

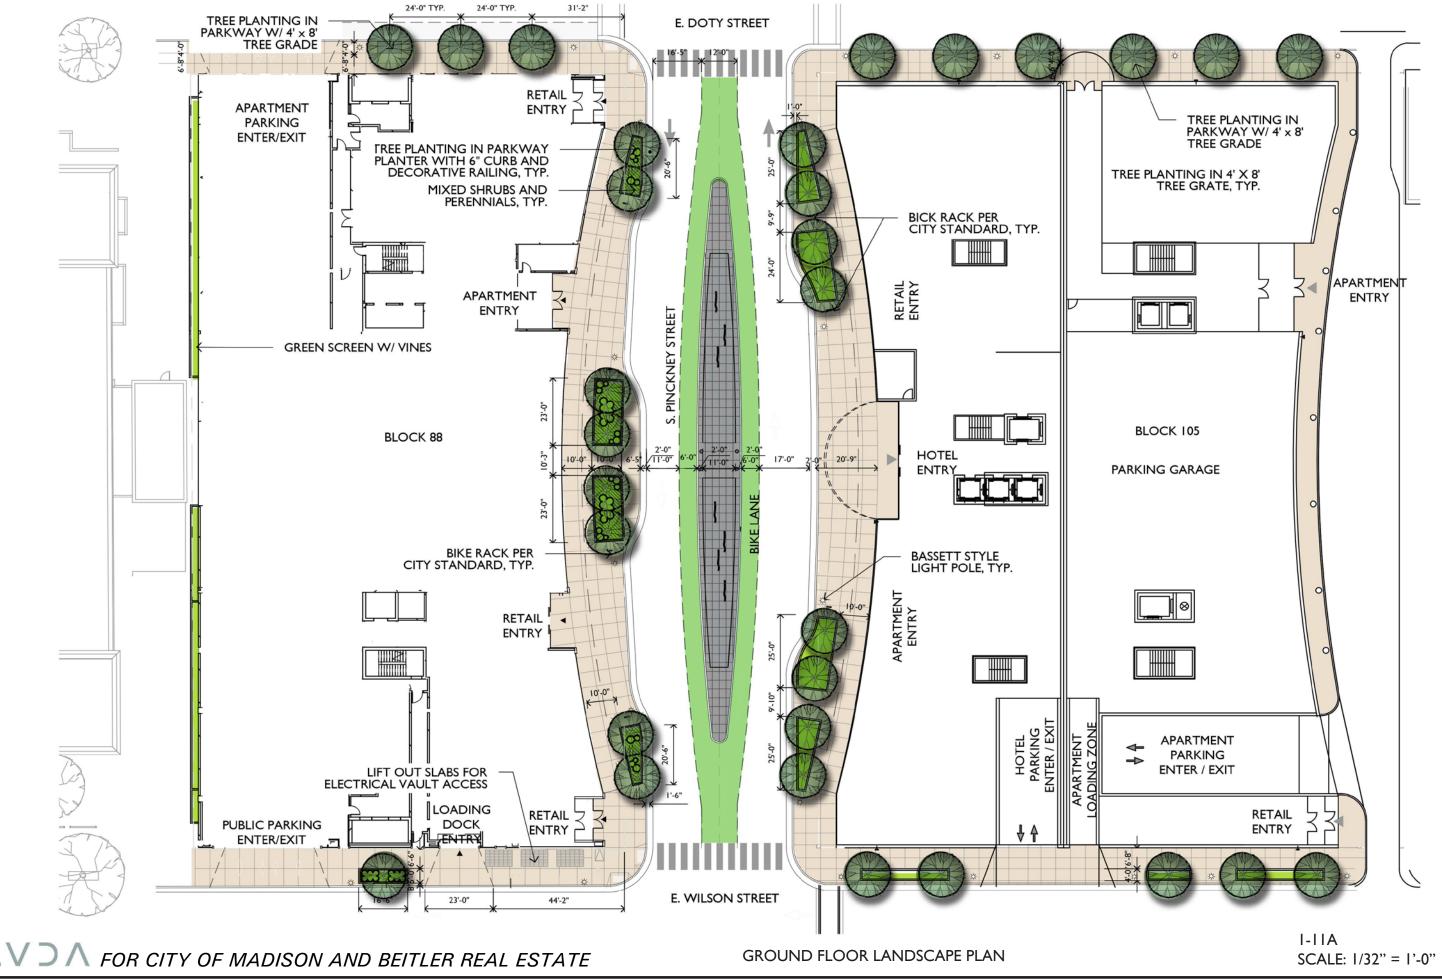

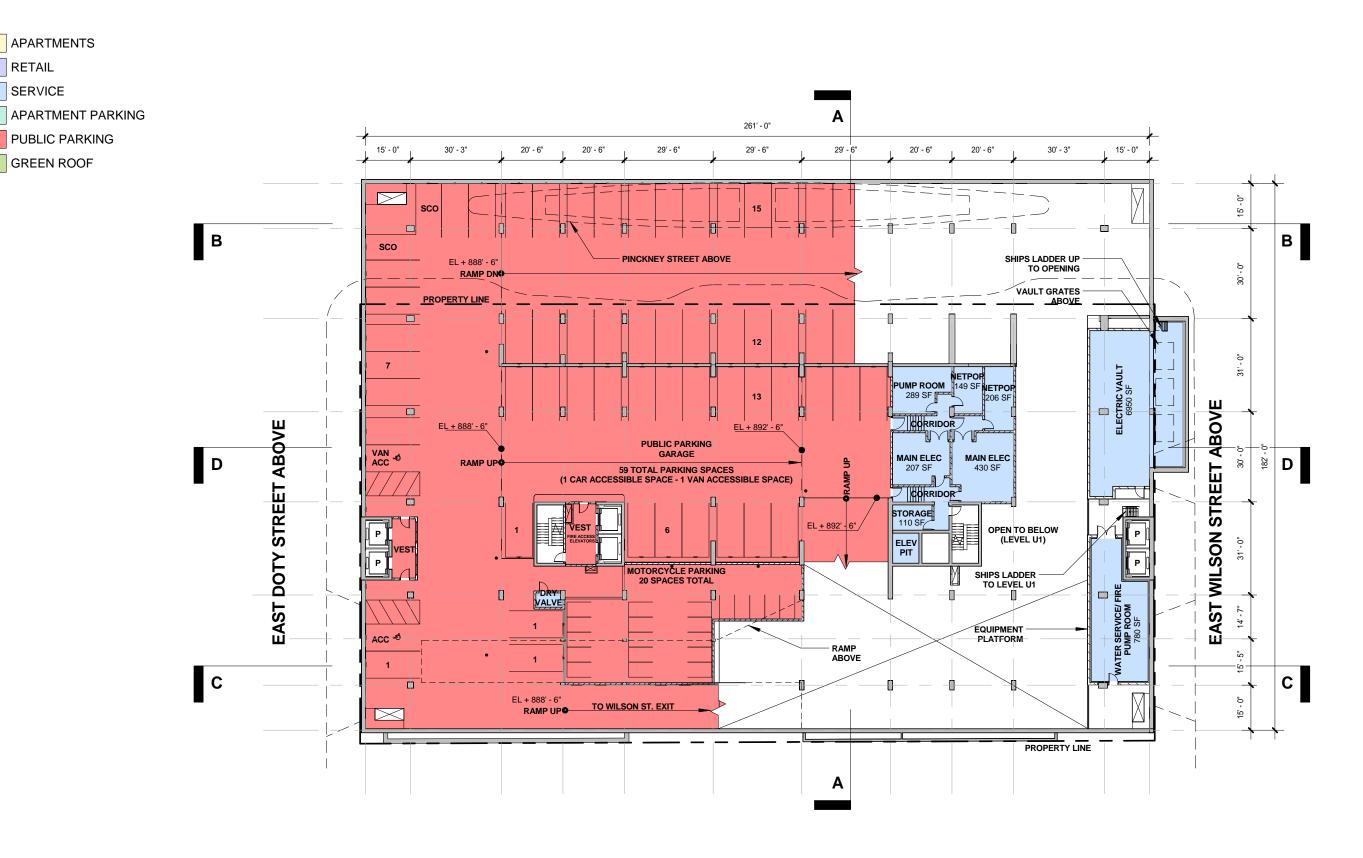

TOTAL GROSS SF: 33,739 SF


FOR CITY OF MADISON AND BEITLER REAL ESTATE




APARTMENTS

GREEN ROOF

RETAIL SERVICE

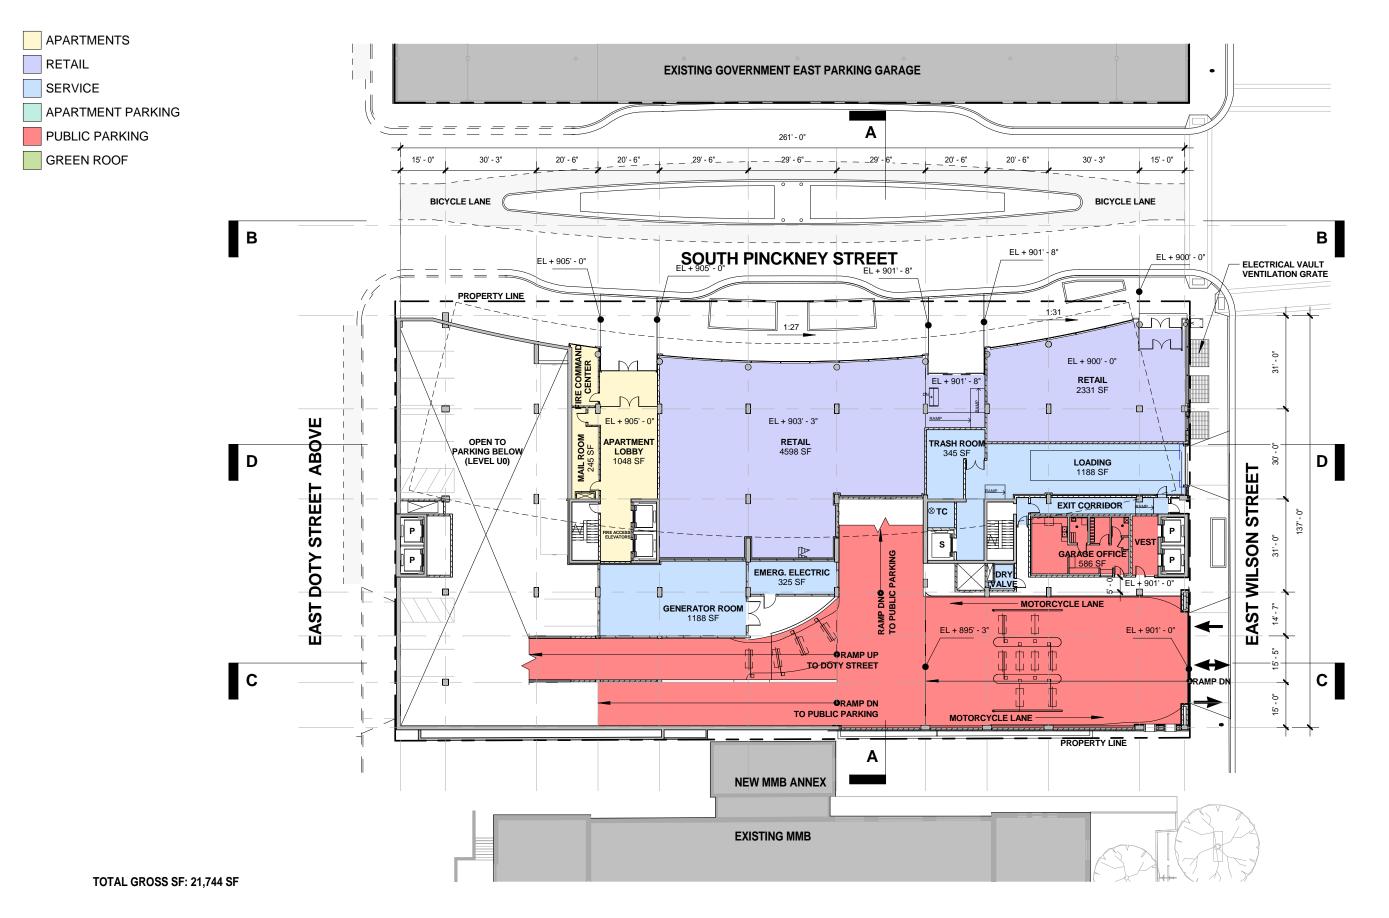




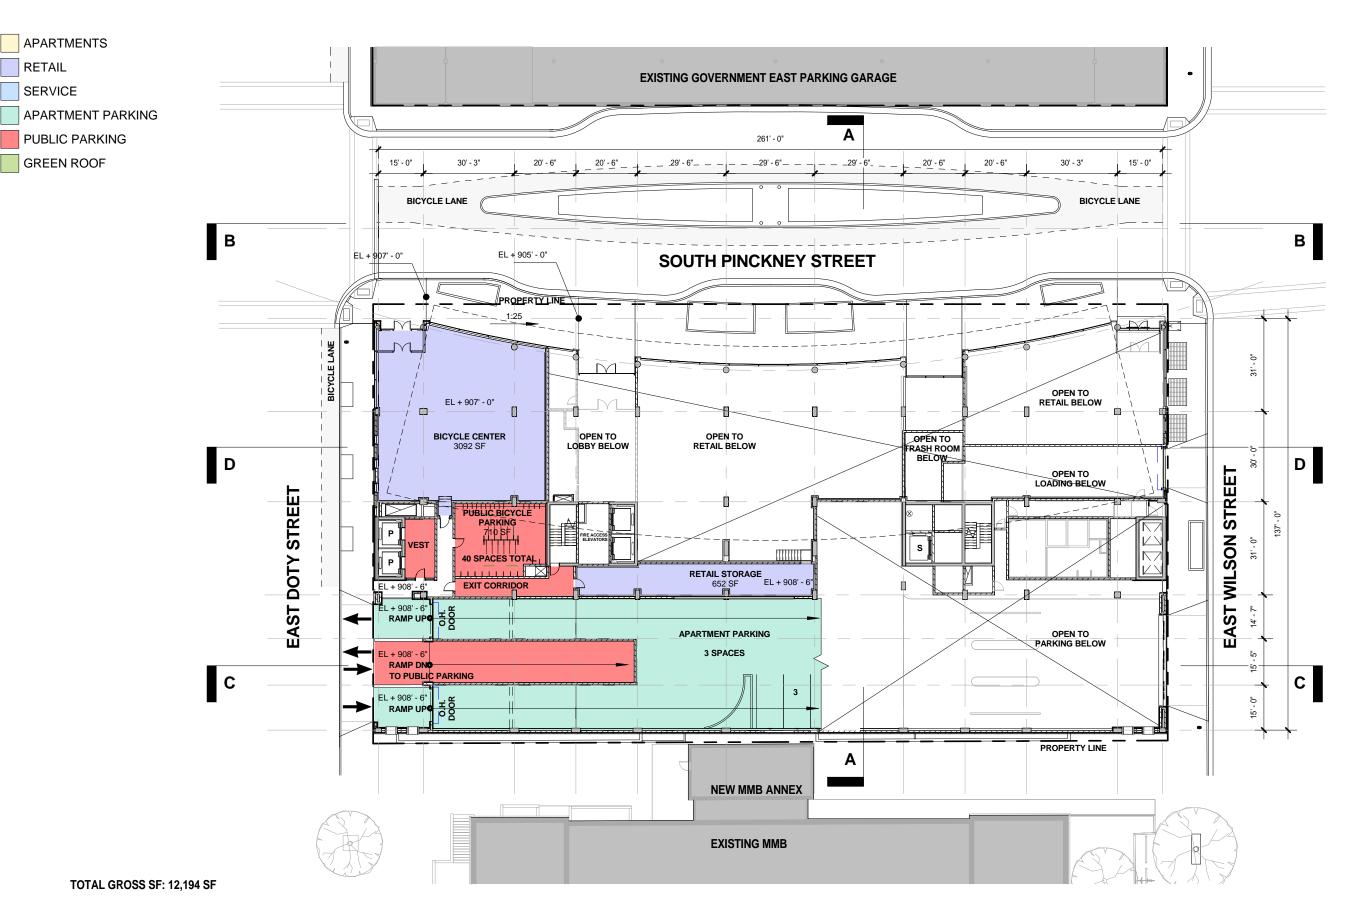

RETAIL

SERVICE

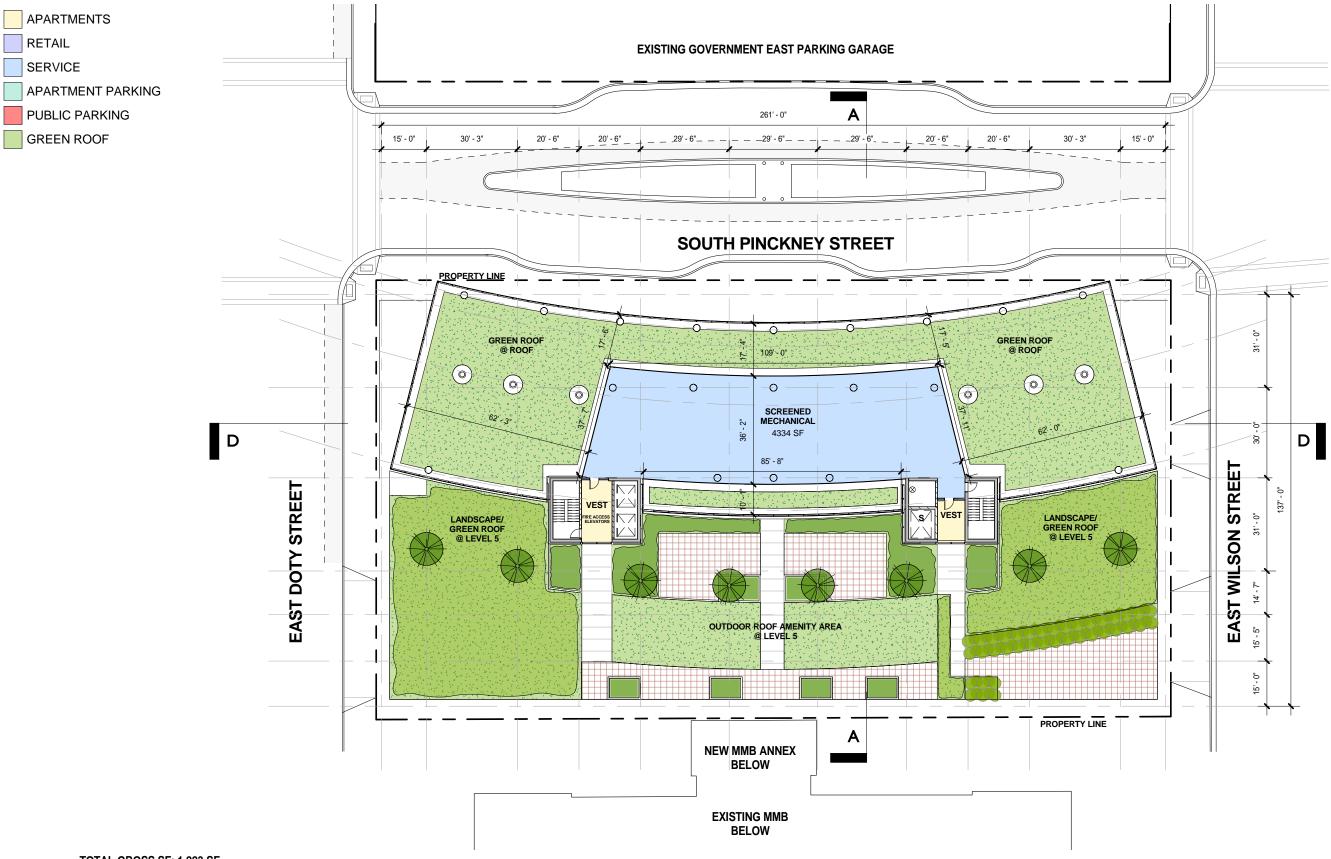


TOTAL GROSS SF: 1,223 SF


FOR CITY OF MADISON AND BEITLER REAL ESTATE





ROOF PLAN

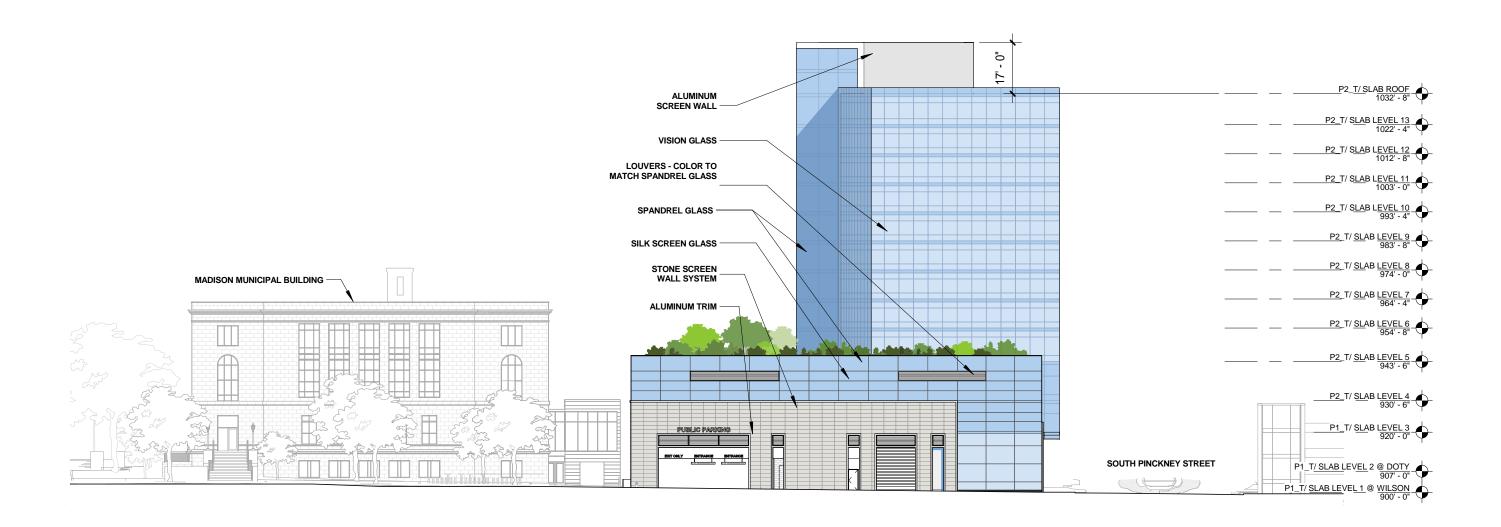


2-16

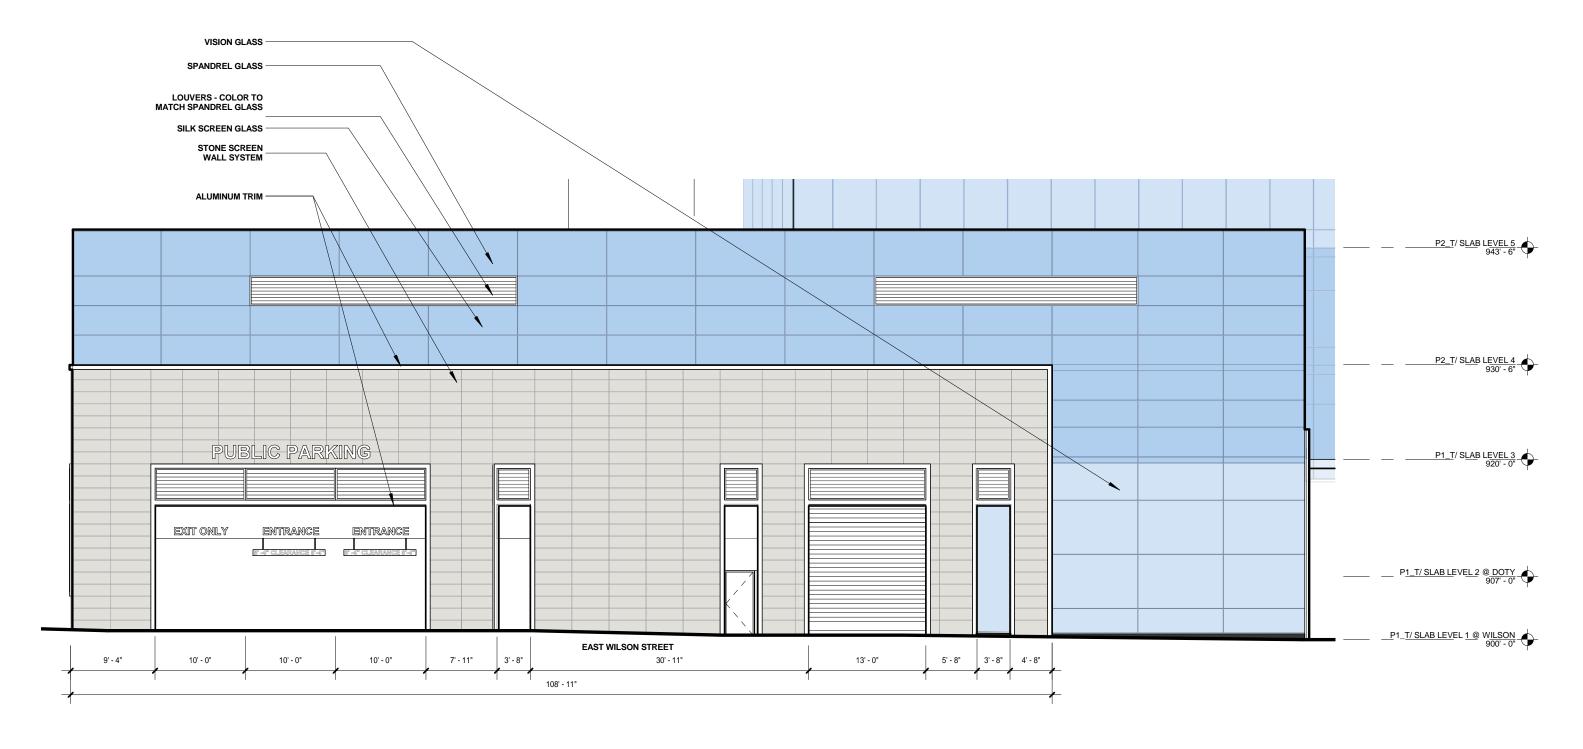

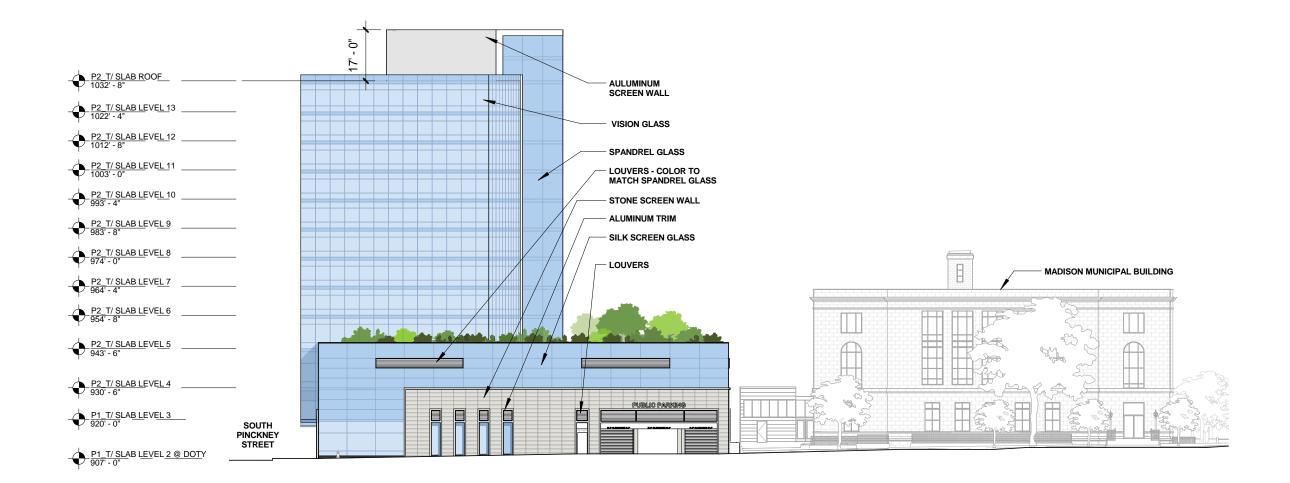


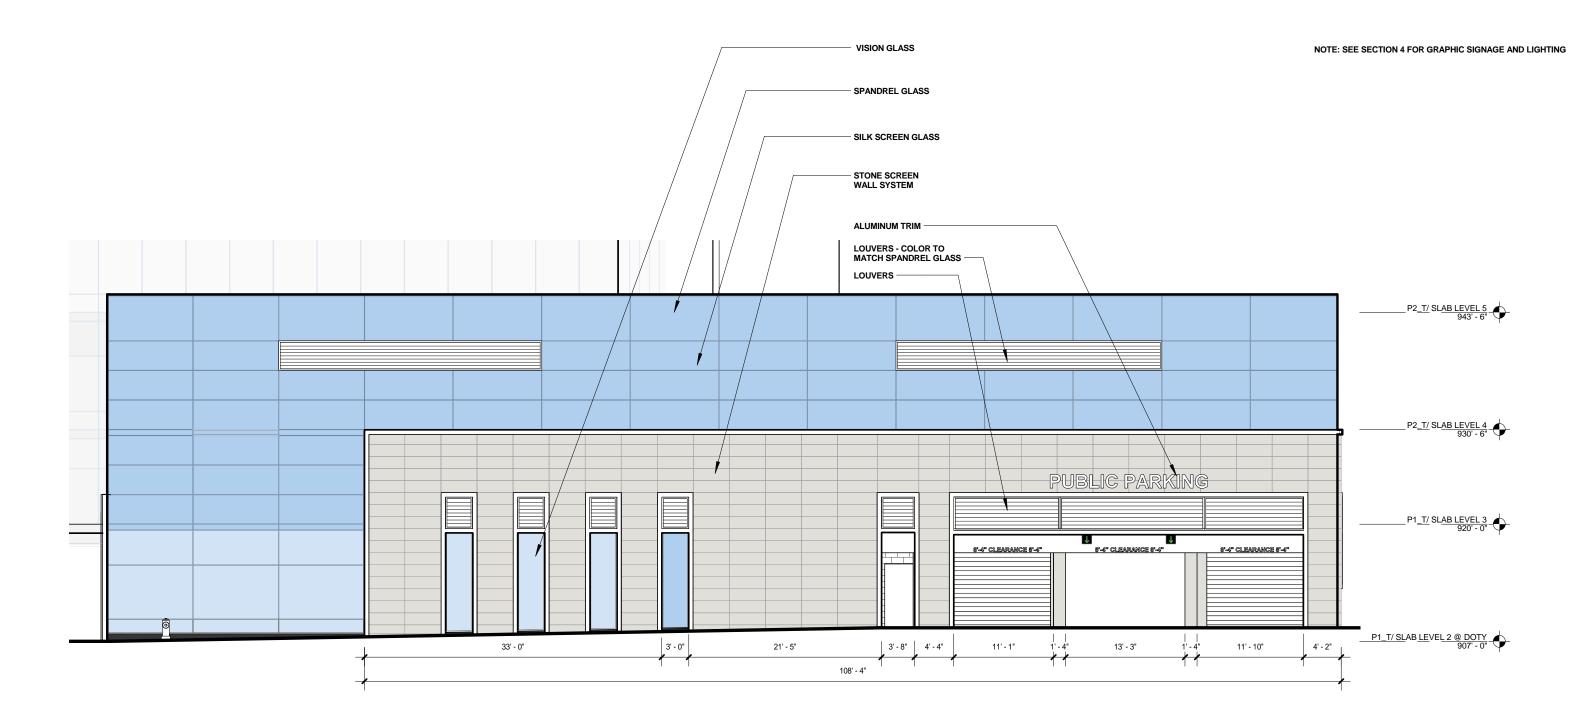

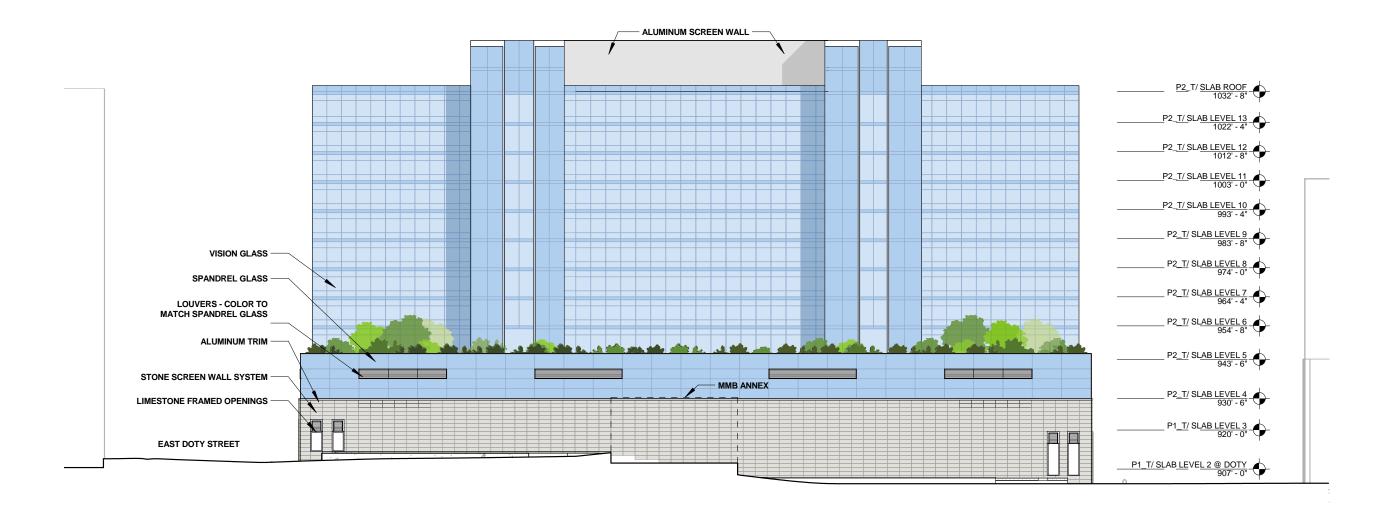


SW ELEVATION - MMB


2-19

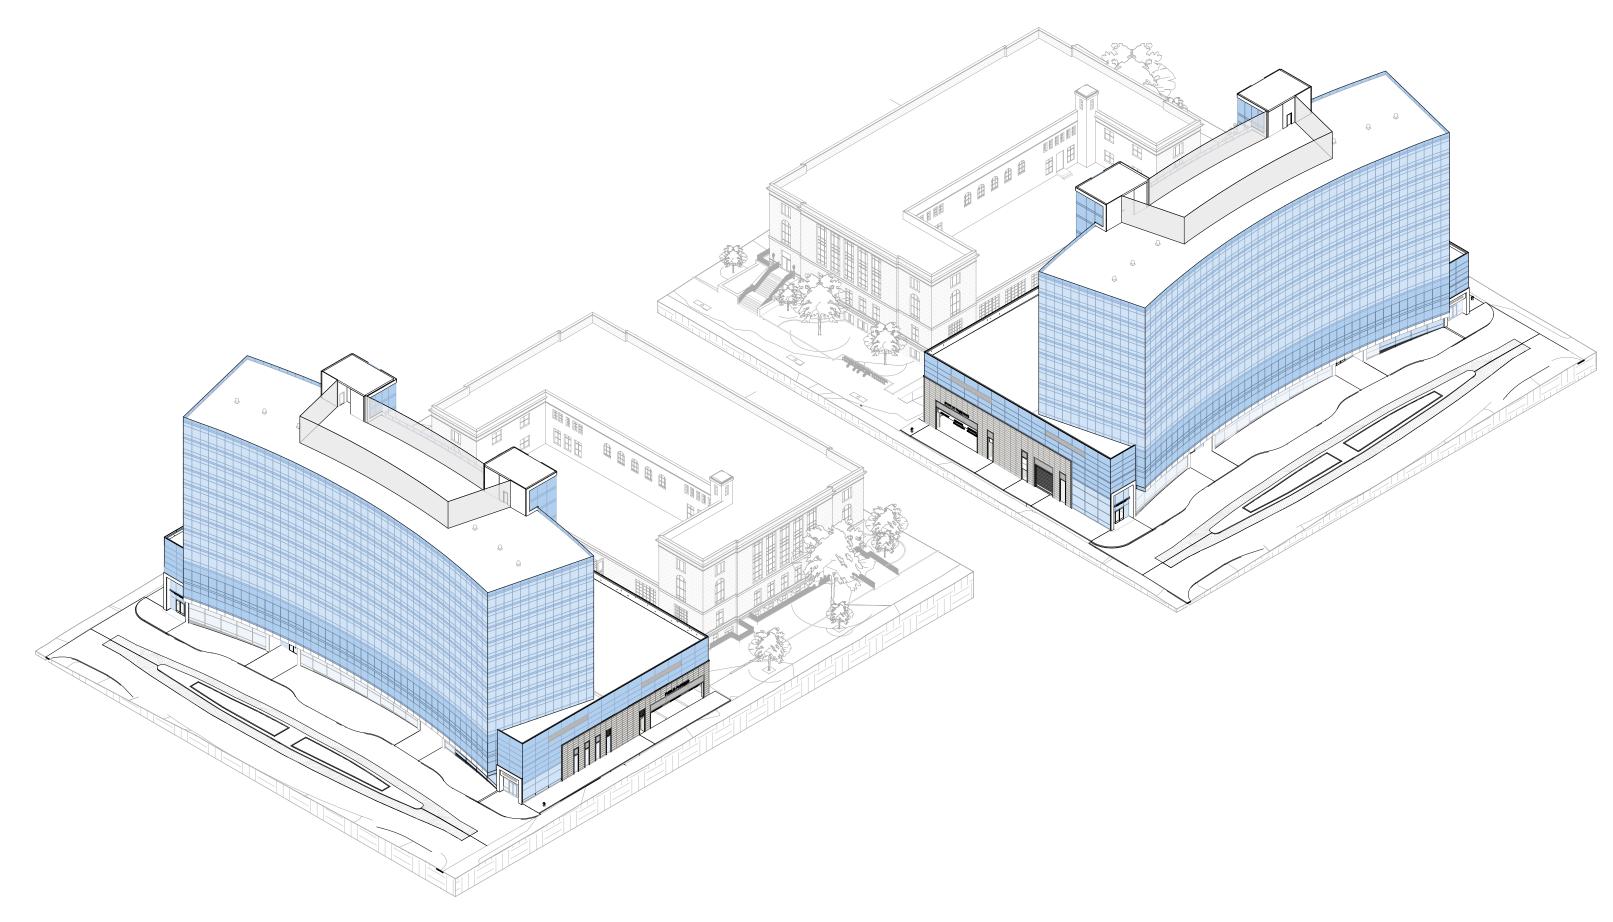


LV) \(\Lambda \) FOR CITY OF MADISON AND BEITLER REAL ESTATE

3D MASSING AERIAL VIEWS

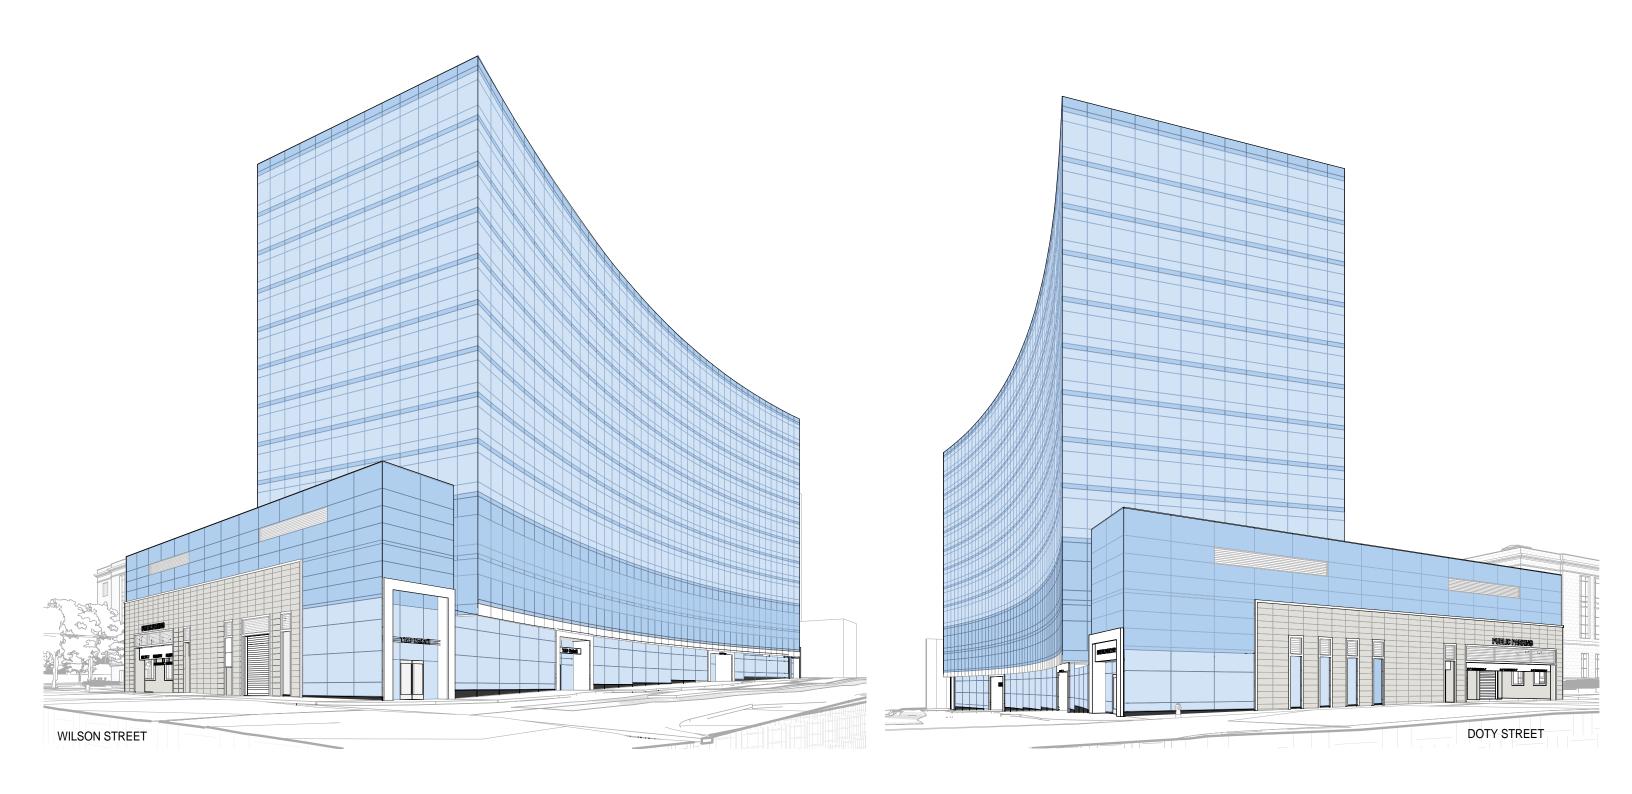

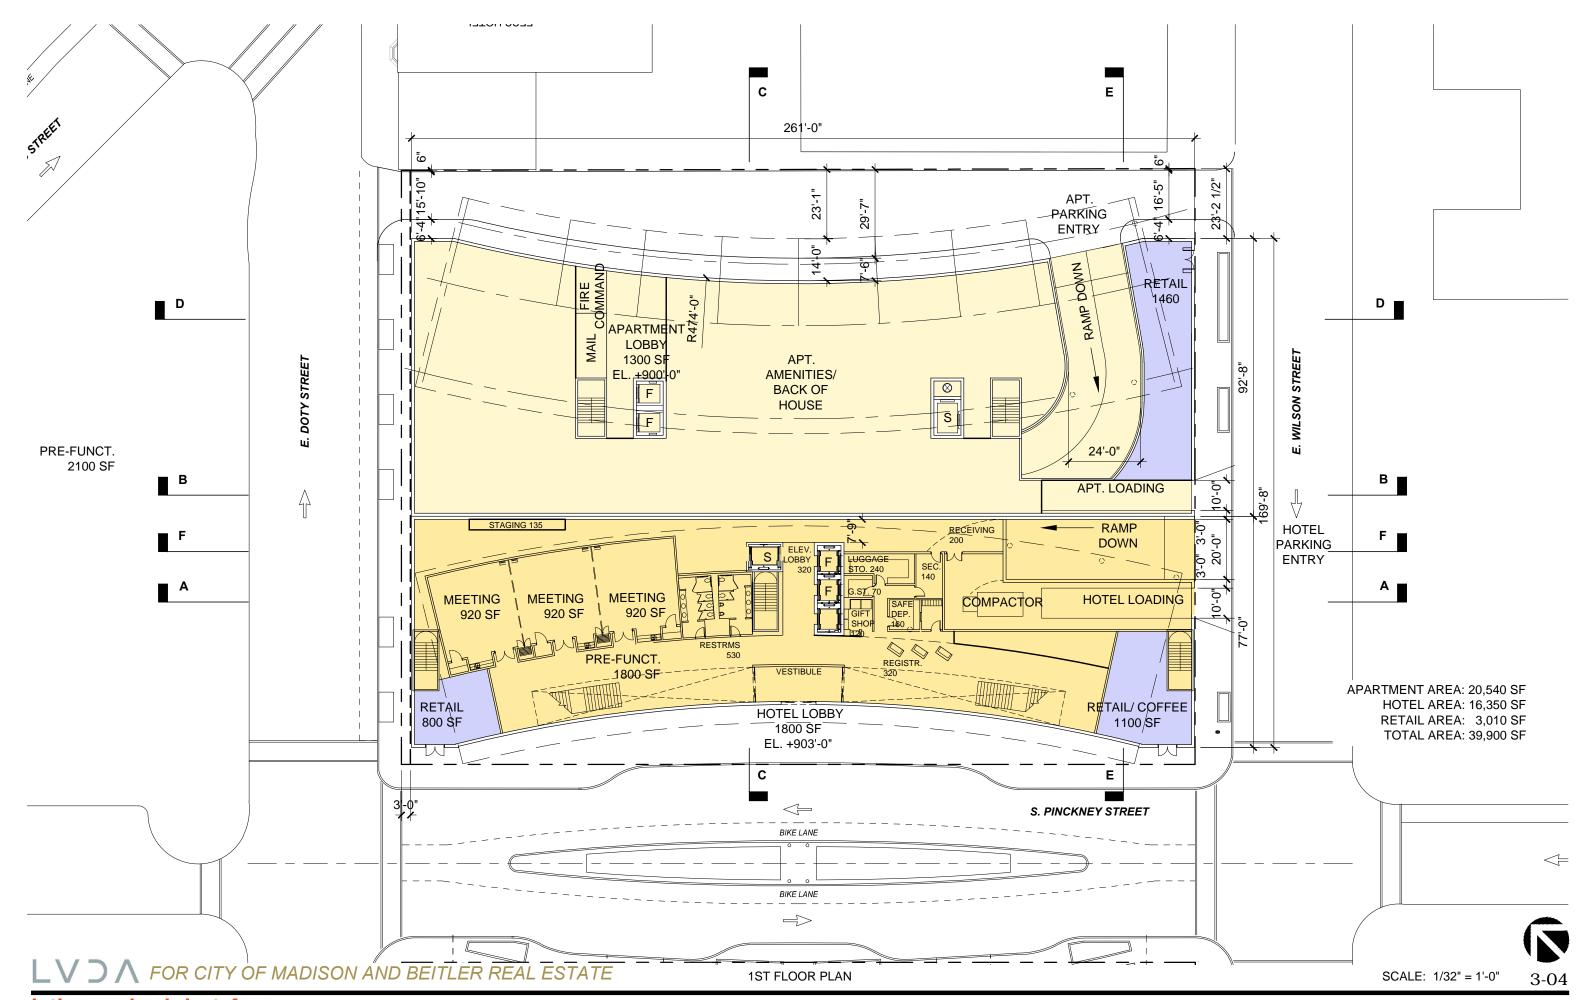

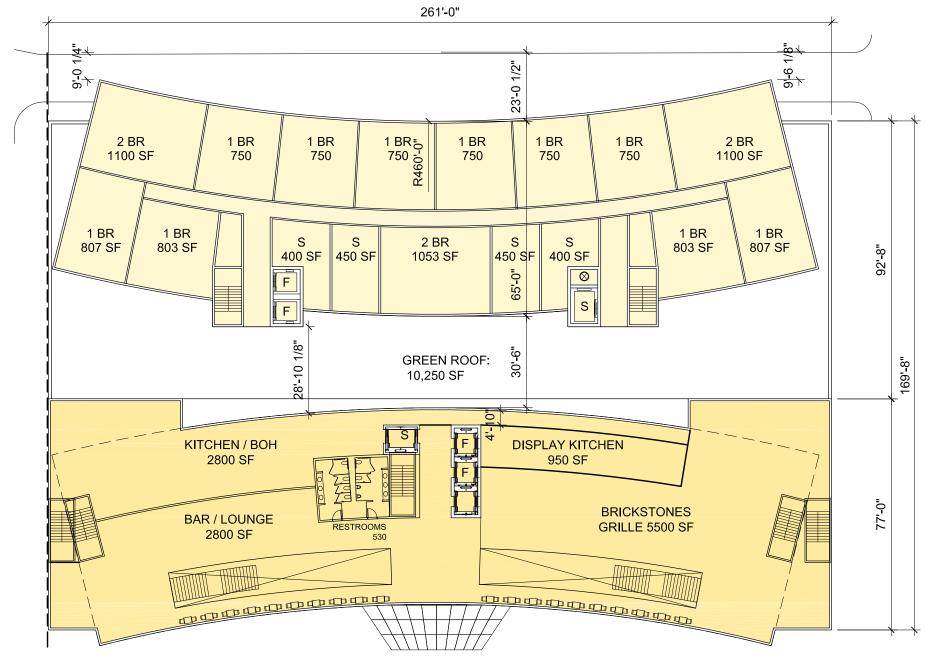

APARTMENT TOWER: 16,150 SF APARTMENT ROOF: 9,060 SF

HOTEL TOWER: 18,340 SF HOTEL ROOF: 885 SF

TOTAL ENCL.: 34,490 SF TOTAL ROOF: 9,945 SF



54'-10 1/4" GREEN ROOF @ ROOF 124'-10,5/8" 54'-11 1/2" SCREENED MECHANICAL EAST DOTY STREET \otimes F FIRE ACCESS ELEVATORS ── VEST GREEN ROOF @ 2ND FLR. FIRE ACCESS ELEVATORS 35'-0" 45'-4 7/8" 44'-3 5/8" SCREENED MECHANIC_(A) GREEN ROOF @ ROOF GREEN ROOF @ ROOF 148'-8 374"


SOUTH PINCKNEY STREET


V) \(\Lambda \) FOR CITY OF MADISON AND BEITLER REAL ESTATE





SCALE: 1/32" = 1'-0"

EAST WILSON STREET

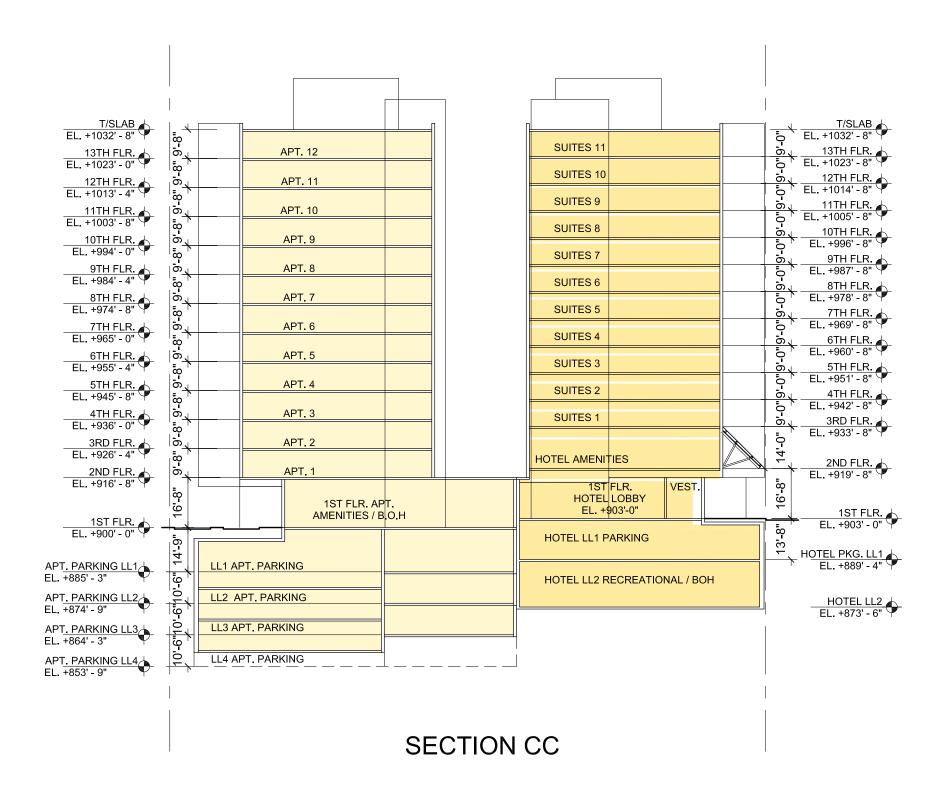

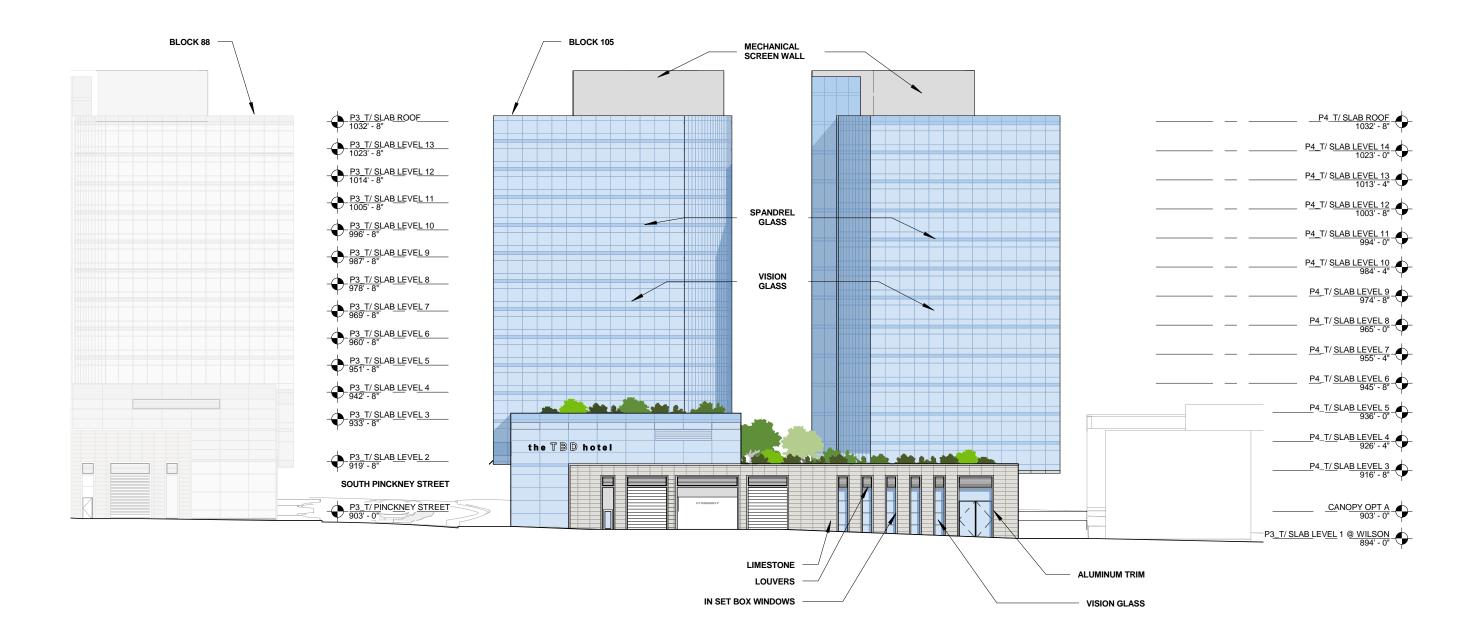


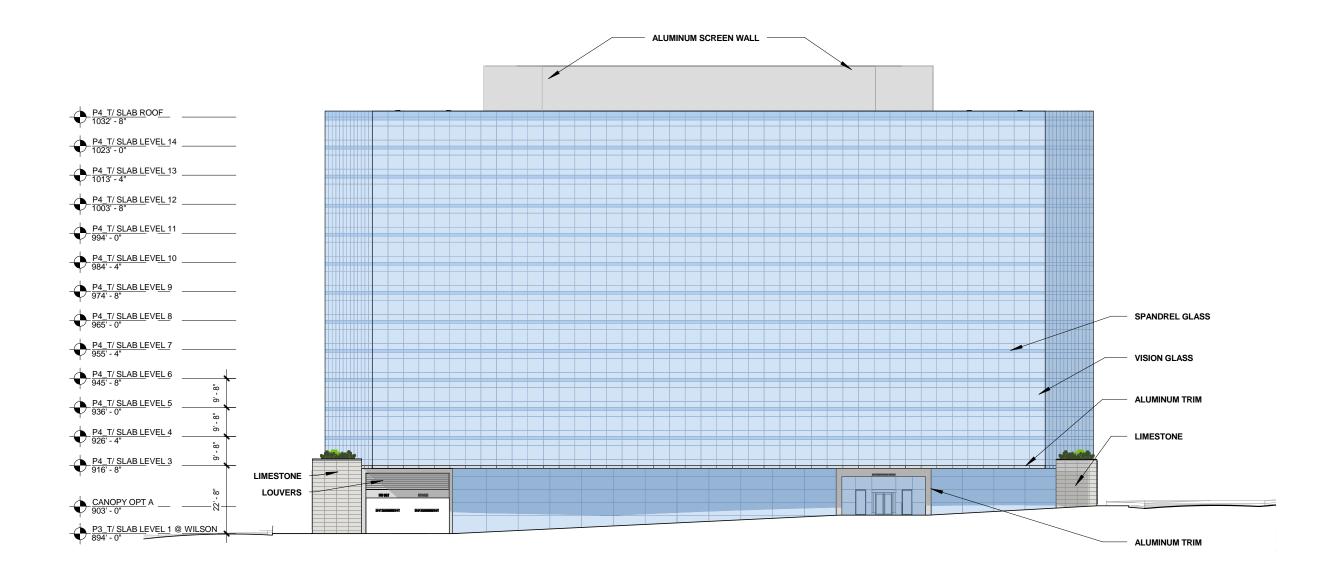


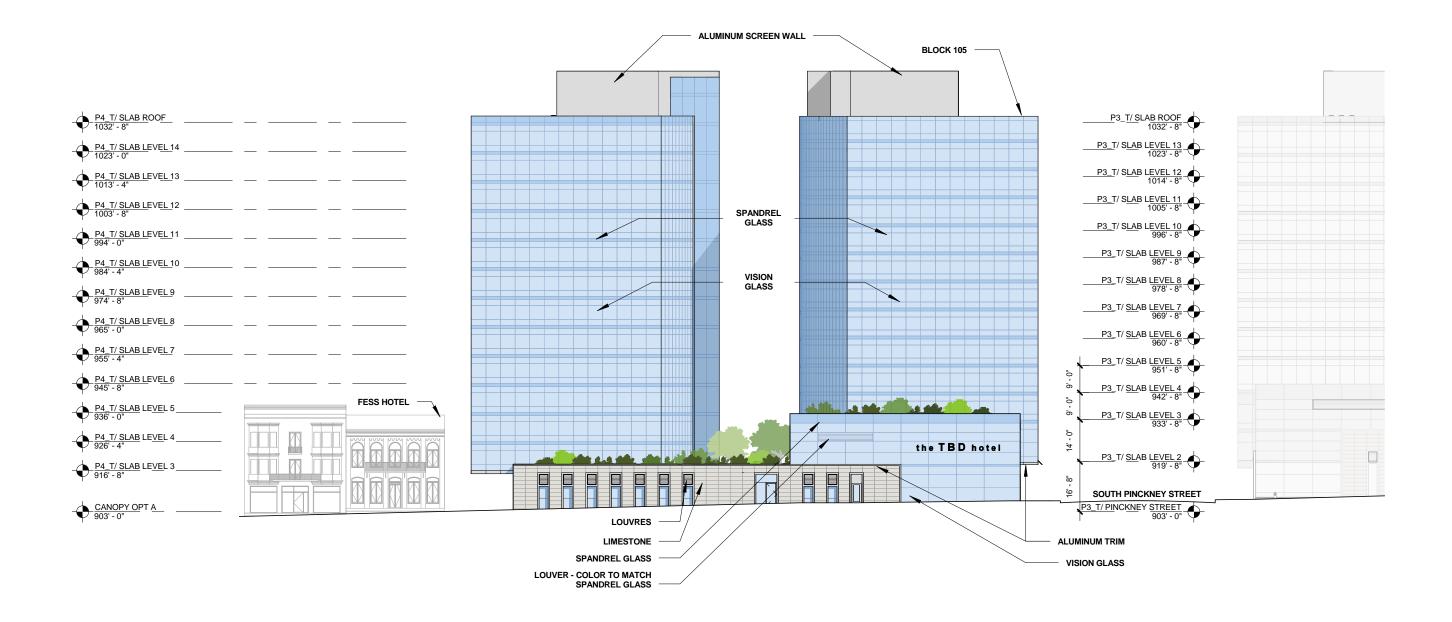

SCALE: 1/32" = 1'-0" **3-16**

REVISED JUNE 13, 2017

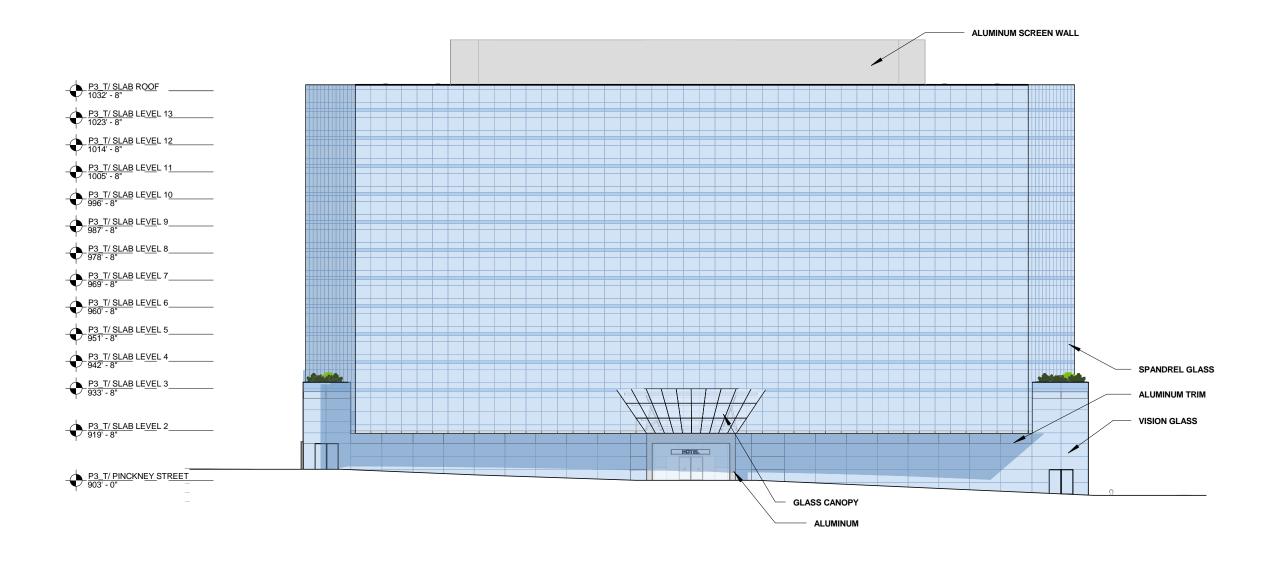

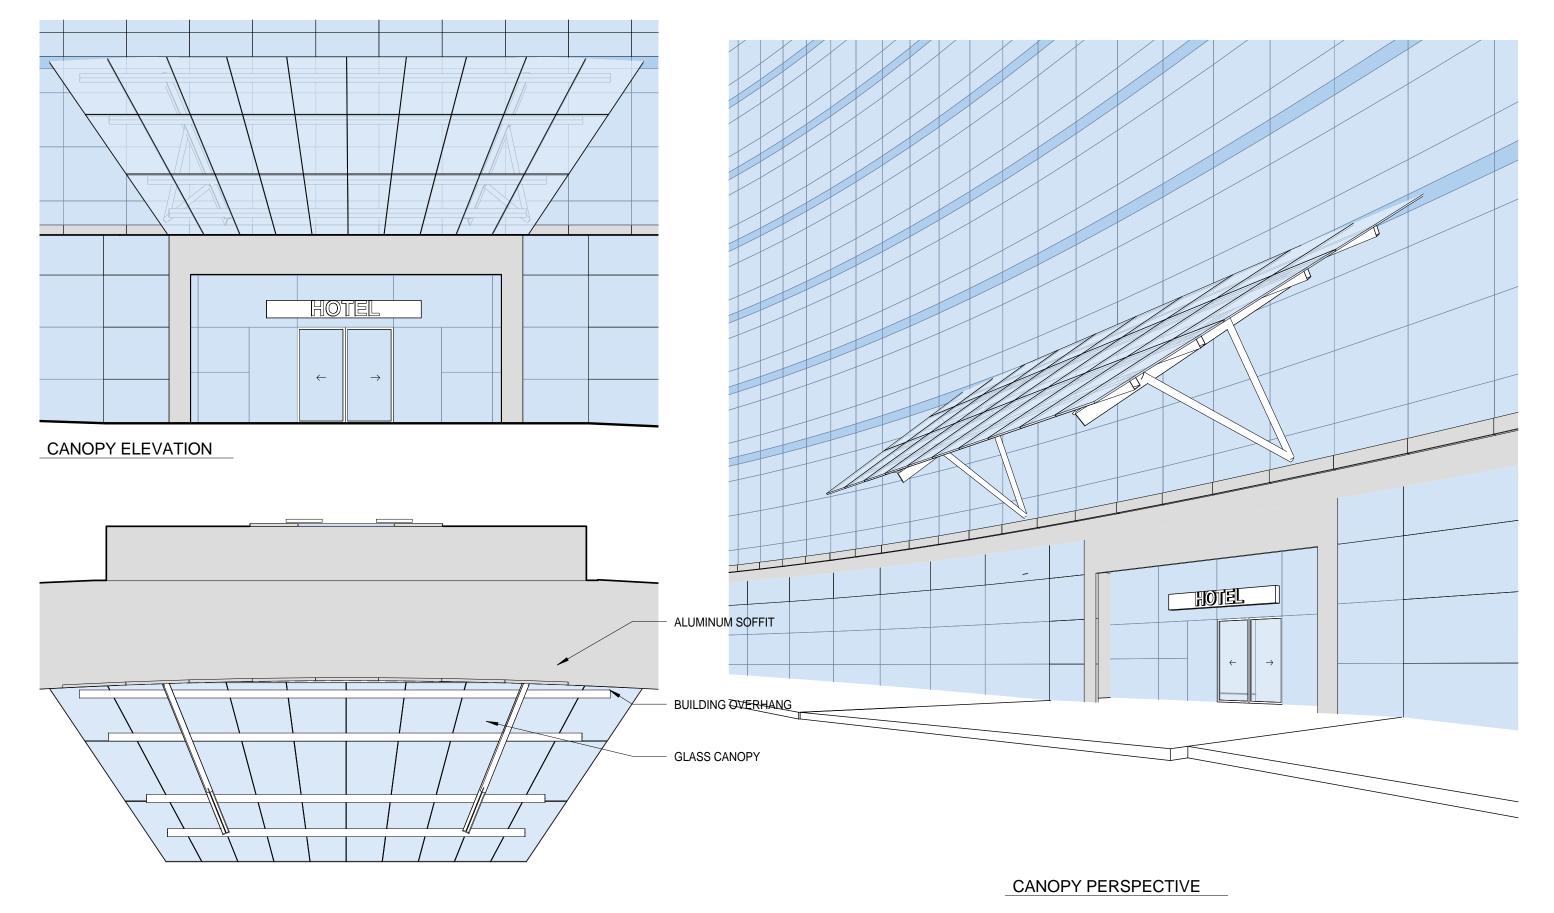


CANOPY RCP




HOTEL CANOPY

REVISED JUNE 13, 2017

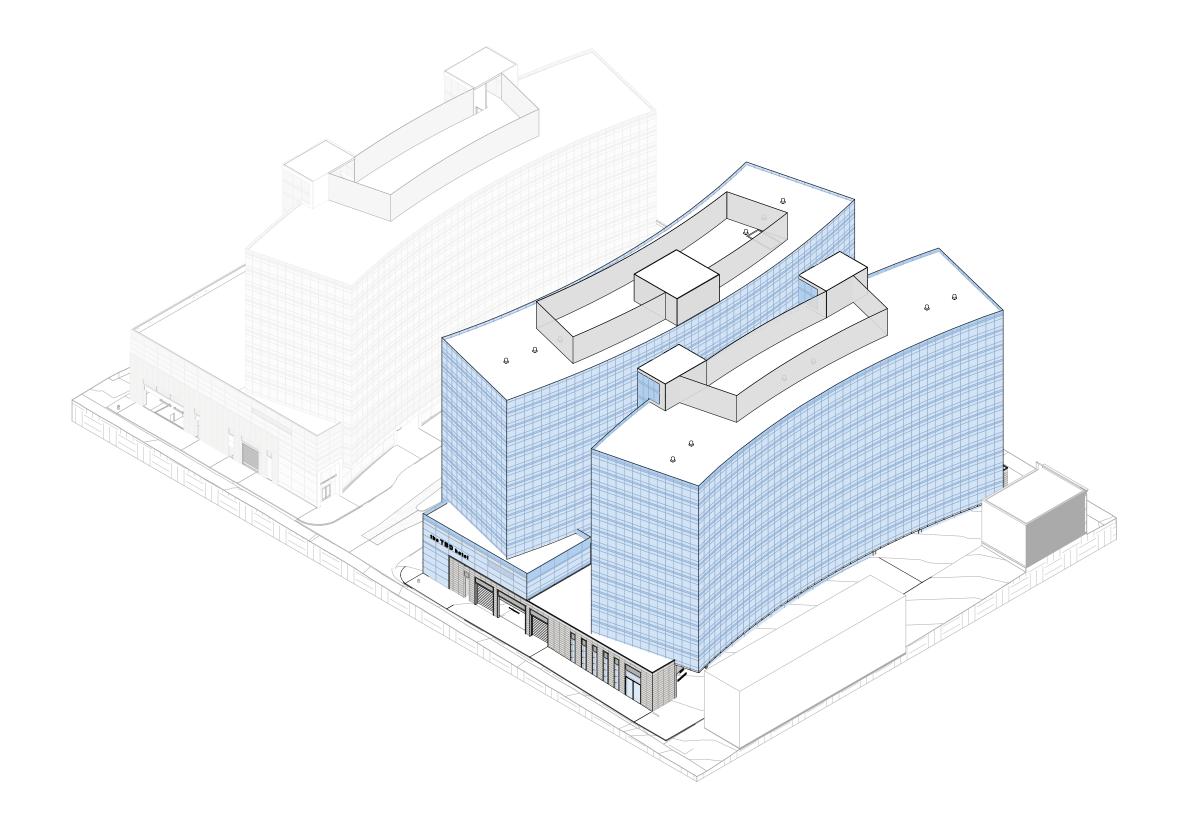


LV) \(\Lambda \) FOR BEITLER REAL ESTATE

3D MASSING AERIAL VIEWS - WILSON STREET

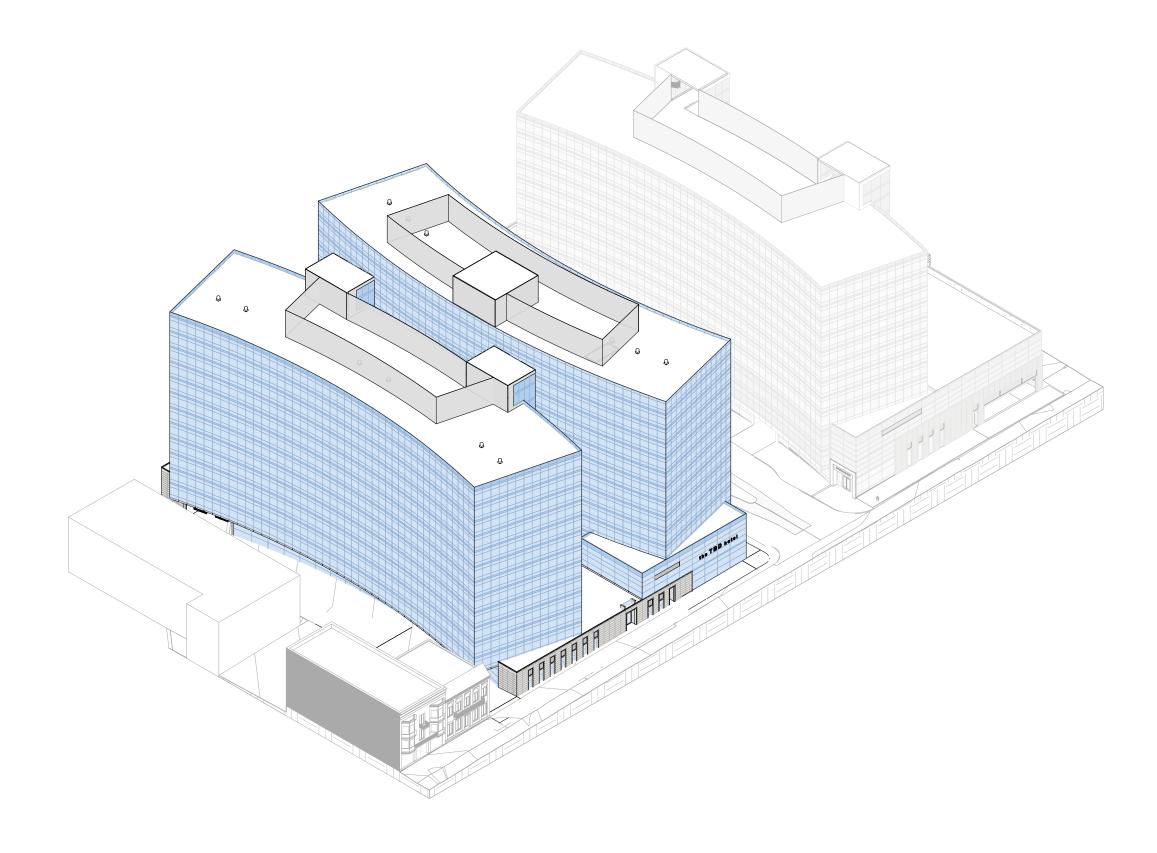



3D MASSING AERIAL VIEWS - DOTY STREET

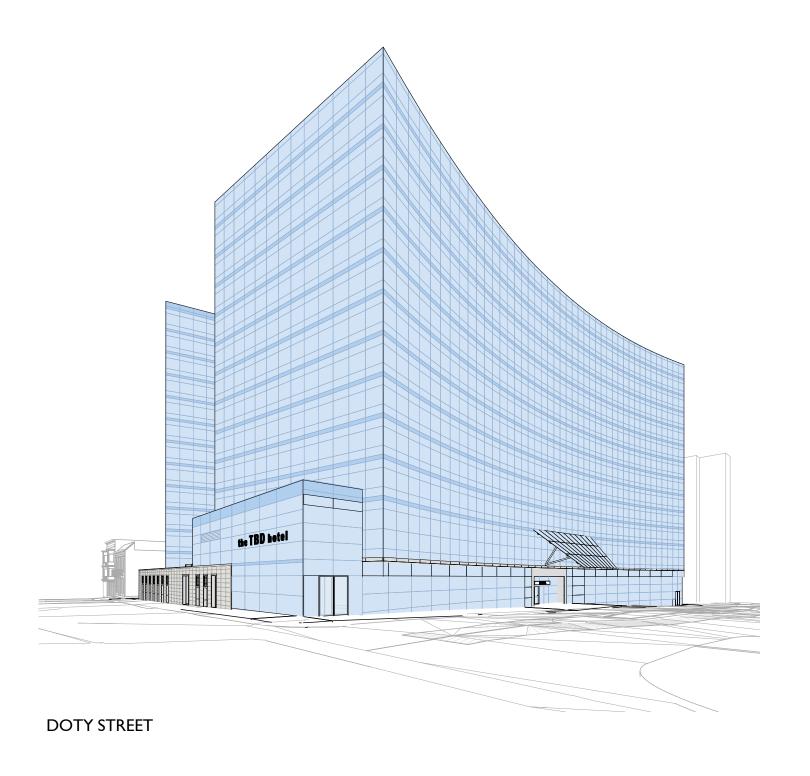




LV) \(\Lambda \) FOR BEITLER REAL ESTATE

3D MASSING STREET LEVEL VIEWS

SCALE: **3-21**

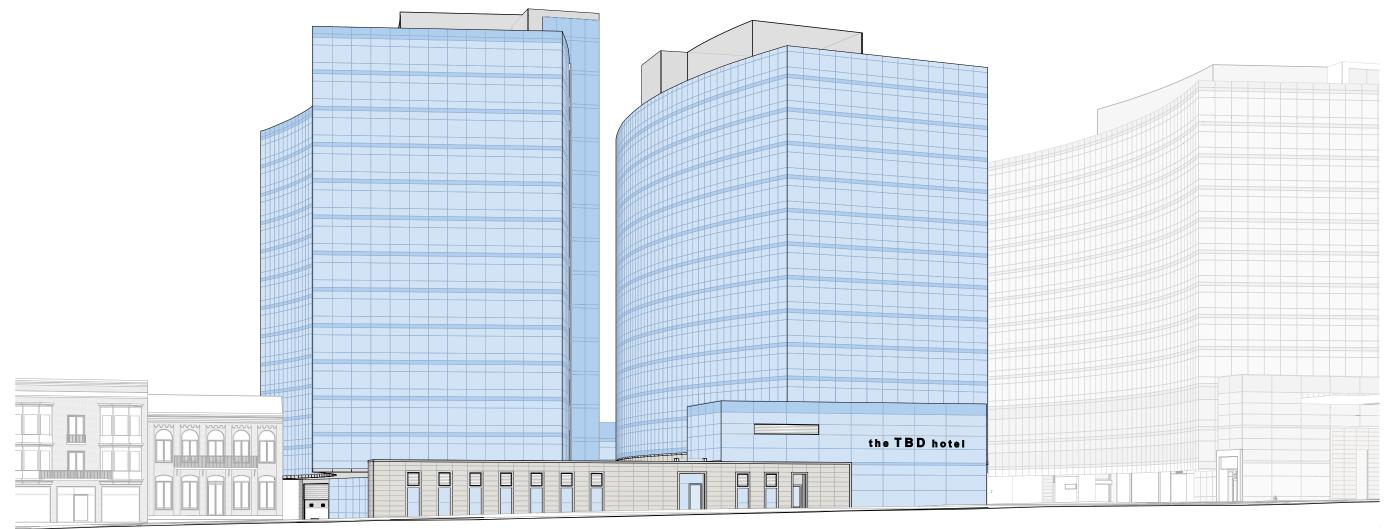

DOTY STREET

HIGH PERFORMANCE LINE

EXTREME® 1024 HIGH PERFORMANCE DOORS

Models EPD1024 and EPI1024 (insulated)



ONE MILLION CYCLES FOR HIGH USE OPENINGS

CONTINUOUS-DUTY DESIGN

Extreme 1024 High Performance Doors deliver a proven combination of steel door security, no annual maintenance requirements outside of routine checks, no need for replacement ports and an exceptional cycle life. Featuring our CycleShield™ finish and backed by a 5 year warranty, they offer reliable durability, environmental separation and ease of repair after impact.

SPEED YOU CAN COUNT ON

Tested to perform for more than a million cycles at an opening speed of up to 24" per second, doors operate three times faster than standard coiling or overhead sectional doors.

PROVEN RETURN ON INVESTMENT

1024 Doors provide the lowest lifetime cost and lowest cost-per-cycle versus other high-performance slatted products. Plus, their cost-per-cycle savings increase dramatically when compared to standard coiling doors often used incorrectly in high-cycle openings. 1024 Doors can also maximize energy savings by quickly sealing your building during inclement weather to minimize air exchange.

PREFERRED APPLICATIONS

This door is a superior choice for high security needs and high-use applications (distribution, government, manufacturing, parking, transportation, etc.). Accepts virtually all activation systems.


800.294.4358 cooksondoor.com

CornellCookson, Inc. is an ISO 9001:2008 registered company



HIGH PERFORMANCE LINE EXTREME® 1024 HIGH PERFORMANCE DOORS Models EPD1024 and EPI1024 (insulated)

STANDARD COMPONENT MATERIALS AND FINISHES

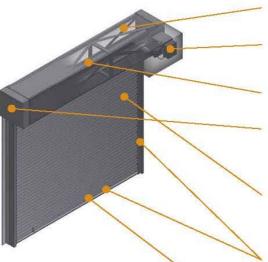

OPERATION AND STRUCTURAL REQUIREMENTS

Motor operation required.

All of our rolling products are supported by the guides. There is no additional support required unless hood supports are mandated by a larger opening width.

OPTIONAL MATERIALS AND FINISHES

- ▶ Stainless steel 300 series in #4 finish ▶ SpectraShield® Powder Coating in more
- than 180 colors
- ▶ Hot-dip galvanizing on steel components
- ► Zinc-enriched, corrosion-resistant powder coating in Gray

HOOD - Galvanized steel with powder coat finish to match curtain. Encloses the curtain and provides weather resistance at the head of the door.

MOTOR - UL listed, SEW Eurodrive TEFC NEMA 4 variable-speed motor and patented, high-performance brake prevents curtain from free falling in the unlikely event of operator component failure.

SPRINGLESS SHAFT - Steel. Design reduces maintenance requirements and facilitates cycle capacity.

BRACKETS/COIL BOX ASSEMBLY - Steel plate brackets with dark bronze powder coat finish are part of the unitized coil box assembly with the curtain and barrel. Access hatch for ease of servicing. Drive and tension brackets both furnished with precision ball bearings.

CURTAIN - Galvanized steel with rust inhibiting CycleShield™ powder coat finish in Gray, Tan or White. Interlocking roll-formed slats with endlocks riveted to ends of alternate slats to maintain slat alignment and prevent wear. MODEL EPI1024 - Features an insulated curtain.

GUIDES - Steel angles with powder coat finish to match curtain, Self-lubricating UHMW anti-wear strips greatly reduce friction and curtain wear. Perimeter-sealing, double brush weather strip. Features up to 10 PSF operational wind load and withstands up to 20 PSF as standard.

BOTTOM BAR - Two back to back structural steel angles with powder coat finish in Gray, Tan or White.

UNIQUE FEATURES

1024 DRIVE AND CONTROL SYSTEM - Control panel features wall-mounted starter. PLC controller with variable-frequency drive featuring soft-start and soft-stop at both ends of limit travel. NEMA4 rated for harsh weather environments.

MONITORED PROTECTION, EVEN AT HIGH SPEEDS - UL 325-2010 (NEMA 4X) compliant photo eye sensors allow for momentary contact operation, useful in parking garages and other high-use openings. Interruption of the photo eye beam before the door fully closes causes the door to immediately halt downward travel and reverse direction to return to the fully open position.

SAFETYGARD™ LIGHT CURTAIN TECHNOLOGY - Built into the guide assembly and extends approximately over 6' high from the finished floor on both sides, detects traffic through opening. If the door is cycling and an object passes through the curtain beams, the door will automatically reverse to the open position.





CUSTOM-DESIGNED SOLUTIONS

Our experienced Architectural Design Support Team can customize our products to fit your specific application. Call 800.294.4358 ext. 1280 or email ads@cooksondoor.com.

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TOR CITY OF MADISON AND BEITLER REAL ESTATE LOADING DOCK/ PARKING ENTRY DOORS

4-01B

Product Data Sheet



A simple circle hovering above ground, provides an artful solution for bicycle storage and security that meets Association of Pedestrian and Bicycle and Professionals (APBP) recommendations. Ring must be embedded. Ring can secure two bicycles parked parallel to the rack. The bicycles can be headed in opposite directions, or in the same direction. The rack provides two-point contact to prevent the bicycle from tipping over. A standard D-shaped bike lock can secure both a wheel and the frame.

Bike Rack

- · Capacity: 2 bikes
- · Bike racks made of 1.5" o.d., .120" wall stainless steel tubing, with a electropolish finish on bare stainless steel.
- · Ring is also available in powdercoated steel.
- · Ring must be embedded.
- · Ring can secure two bicycles parked parallel to the rack.
- The bicycles can be headed in opposite directions, or in the same direction. The rack provides two-point contact to prevent the bicycle from tipping over.
- •A standard D-shaped bike lock can secure both a wheel and the frame.

Finishes

- All metal parts are finished with Landscape Forms' proprietary Pangard II® polyester powdercoat, a hard yet flexible finish that resists rusting, chipping, peeling and fading.
- · Call for standard color chart. Stainless Steel, Satin Finish

To Specify

· Select bike rack style. Specify powdercoat color or stainless steel.

Designed by Brian Kane, IDSA

All Landscape Forms bike racks meet guidelines established by the Association of Pedestrian and Bicycle Professionals.

STYLE	DEPTH	WIDTH	HEIGHT	PRODUCT WEIGHT
Ring	1.5*	25"	27"	13 lb

Visit our landscapeforms.com for more information. Specifications are subject to change without notice. Landscape Forms supports the Landscape Architecture Foundation at the Second Century level. ©2016 Landscape Forms, Inc. Printed in U.S.A.

Landscape Forms, Inc. I 800.521.2546 | F 269.381.3455 | 7800 E. Michigan Ave., Kalamazoo, MI 49048



EXTERIOR VISITOR BICYCLE PARKING

