

URBAN DESIGN COMMISSION APPLICATION CITY OF MADISON

This form may also be completed online at: http://www.cityofmadison.com/planning/documents/UDCapplication.pdf 215 Martin Luther King Jr. Blvd; Room LL-100 PO Box 2985; Madison, Wisconsin 53701-2985 Phone: 608.266.4635 | Facsimile: 608.267.8739

Please complete all sections of the application, including the desired meeting date and the type of action requested.

Date Submitted: 5/15/2017		☐ Informational Pre	sentation
UDC Meeting Date: _6/28/2017	☐ Jnitial Approval		
Combined Schedule Plan Commission Date (if applicable):		▼ Final Approval	
1. Project Address: 5615 Summer Shine Drive (17 Project Title (if any): Part of Lot 564 of The Village at			
2. This is an application for (Check all that apply to this UDC application	1.0		
New Development Alteration to an Existing or P		Pevelopment	
A. Project Type: Project in an Urban Design District* (public hearing-\$300 feet) Project in the Downtown Core District (DC) or Urban In Suburban Employment Center (SEC) or Campus Institution Planned Development (PD) General Development Plan (GDP) Specific Implementation Plan (SIP) Planned Multi-Use Site or Planned Residential Comple	Mixed-Use District (U utional District (CI) or	•	
B. Signage: Comprehensive Design Review* (public hearing-\$300 fee) Signage Exception(s) in an Urban Design District (public C. Other: Please specify:		S Variance* (public hearing	z-\$300 fee)
3. Applicant, Agent & Property Owner Information:			
Applicant Name: Randy Bruce	Company: Knothe &	Bruce Architects, LLC	
Street Address: 7601 University Avenue, Suite 201	City/State: Middleton	, WI	Zip: <u>53562</u>
Telephone:(608) 836-3690 Fax:()	Email: rbruce@kno	thebruce.com_	
Project Contact Person: Randy Bruce	Company		
Street Address:	City/State:		Zip:
Telephone:(608) 836-3690 Fax:()			Zip
Tax.(Linaii		
Project Owner (if not applicant): Grosse, Hanzel & Simon and/or si	gns		
Street Address: 6650 University Avenue	City/State: dickhanze	l@yahoo.com	Zip: <u>53562</u>
Telephone:(608) 575-9023 Fax:()	Email: Middleton, W	/	
4. Applicant Declarations:			
A. Prior to submitting this application, the applicant is required to discuss the	e proposed project with Ui	ban Design Commission sta	iff. This
application was discussed with <u>Jessica Vaughn / Matt Tucker</u> on	5/11/2017	-	
(name of staff person) B. The applicant attests that all required materials are included in this submitthe application deadline, the application will not be placed on an Urban Desi			is not provided by
Name of Applicant Randy Ryue	Relationship to Property	1	
Authorized Signature Hawk bruce	Date 5/15/	170	
		ē.	

May 10, 2017

Ms. Heather Stouder Department of Planning & Development City of Madison 146 S. Hamilton Street PO Box 2985 Madison, Wisconsin 53701

Re: Letter of Intent 5615 Summer Shine Dr. The Village at Autumn Lake – Lot 564 - Phase 2 KBA Project # 1644

dday@donofrio.cc

Ms. Heather Stouder:

The following is submitted together with the plans and application for the staff and Plan Commission's consideration of approval.

Organizational structure:

Owner: Grosse, Hanzel & Simon and/or signs Architect: Knothe & Bruce Architects, LLC

> 6650 University Ave. Middleton, WI

608-575-9023 608-836-3690 Contact: Dick Hanzel Contact: Greg Held

dickhanzel@yahoo.com gheld@knothebruce.com

Engineer: D'Onofrio & Kottke Landscape Olson Toon Landscaping, Inc.

> 7530 Westward Way Design: 3570 Pioneer Road Madison, WI 53717 Verona, WI 53593 (608) 833-7530 (608) 827-9401 (608) 833-1089 fax Contact: Rich Carlson Contact: Dan Day rich@olsontoon.com

Introduction:

The proposed site is Lot 564 of Village of Autumn Lake subdivision, located at the northeast corner of Lien Road and City View Drive in Madison, Wisconsin. This site will be developed along with Lot 520 by development team listed above. The site is zoned CC-T and a conditional-use approval is required to allow the proposed multifamily building with more than 8 units. The plans, architecture and construction allows for the future conversion of existing residential to commercial.

Project Description:

Lot 564 is designed as a two-phase development. The first phase was approved by Plan Commission and contains a two and three-story 47-unit apartment building along with a one-story clubhouse building. The clubhouse and associated swimming pool are provided for community social and recreation facilities to serve both Lots 564 and 520.



7601 University Avenue, Ste 201

Middleton, WI 53562

Letter of Intent –Conditional Use
The Village at Autumn Lake – Lot 564 – Phase 2
5615 Summer Shine Drive, Madison, WI
May 10, 2017
Page 2 of 3

The second phase is the subject of this proposal which contains a two and three-story 29-unit apartment building with underground parking.

The exterior architecture is well articulated, using a combination of stone and horizontal siding to create a moderately dense residential village at the entrance to the Autumn Lake subdivision.

The site is bounded on all four sides by public streets and vehicular access to the site is achieved from two of them: Summer Shine Drive and Willow Rock Road. Underground parking is provided and includes a total of xx resident parking stalls. An additional xx parking spaces are located on grade and on-street parking is available to supplement on-site parking. Bicycle parking is dispersed throughout the site with covered bike parking conveniently located in each basement garage.

Site Development Data:

I lan	CITI	vc.
Den	SILI	CS.

Total Lot Area	131,849 S.F. / 3 Acres
Lot Area (this submittal)	37,688 S.F. / .87 Acres

Dwelling Units 29 DU

Lot Area / D.U. 1,300 S.F. / unit Density 33.33 units/acre

Building Height 2 - 3 stories

Lot Coverage 37,688 S.F. = 41% (75% Max.) Usable Open Space 22,636 S.F. (780 S.F./D.U.)

Dwelling Unit Mix:

 Efficiency
 3

 One Bedroom
 11

 Two Bedroom
 15

 Total Dwelling Units
 29

Vehicle Parking:

Surface15 stallsUnderground30 stallsTotal45 stallsRatio1.5 stalls/unit

Bicycle Parking:

Surface 5 stalls
Surface Guest 3 stalls
Underground Garage – Wall Hung 4 stalls
Underground Garage STD. 2'x6' 22 stalls
Total 34 stalls

Letter of Intent –Conditional Use
The Village at Autumn Lake – Lot 564 – Phase 2
5615 Summer Shine Drive, Madison, WI
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Page 3 of 3

Project Schedule:

This site (Lot 564) will be constructed and managed as a single development along with the buildings on Lot 520. It is anticipated that the construction on this site will start in summer 2017 and that the 7 buildings on the two sites will be completed over a 4-year build-out.

Thank you for your time reviewing our proposal.

Sincerely,

Randy Bruce, AIA

Cree Edge™ Series

LED Area/Flood Luminaire

Product Description

The Cree Edge™ Series has a slim, low profile design. Its rugged cast aluminum housing minimizes wind load requirements and features an integral, weathertight LED driver compartment and high performance aluminum heat sinks. Various mounting choices: Adjustable Arm, Direct Arm, Direct Arm Long, or Side Arm (details on page 2). Includes a leaf/debris guard.

Applications: Parking lots, walkways, campuses, car dealerships, office complexes, and internal roadways

Performance Summary

Patented NanoOptic® Product Technology

Made in the U.S.A. of U.S. and imported parts

CRI: Minimum 70 CRI

CCT: 4000K (+/- 300K), 5700K (+/- 500K) standard

Limited Warranty[†]: 10 years on luminaire/10 years on Colorfast DeltaGuard® finish


†See http://lighting.cree.com/warranty for warranty terms

Accessories

Field-Installed				
Bird Spikes	Backlight Control Shields			
XA-BRDSPK	XA-20BLS-4			
Hand-Held Remote	- Four-pack			
XA-SENSREM	- Unpainted stainless steel			
- For successful implementation of the programmable multi-level option, a minimum of one hand-held remote is required				

DA Mount



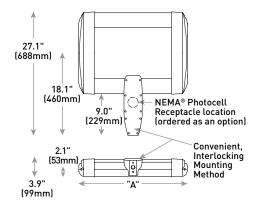

LED Count (x10)	Dim. "A"	Weight
02	12.1" (306mm)	21 lbs. (10kg)
04	12.1" (306mm)	24 lbs. (11kg)
06	14.1" (357mm)	27 lbs. (12kg)
08	16.1" (408mm)	28 lbs. (13kg)
10	18.1" (459mm)	32 lbs. (15kg)
12	20.1" (510mm)	34 lbs. (15kg)
14	22.1" (560mm)	37 lbs. (17kg)
16	24.1" (611mm)	41 lbs. (19kg)

AA/DL/SA Mount - see page 22 for weight & dimensions

Ordering Information

Example: ARE-EDG-2M-AA-12-E-UL-SV-350

						E				
Product	Optic			Mounting*	LED Count (x10)	Series	Voltage	Color Options	Drive Current	Options
ARE- EDG	ZM Type II Medium ZMB Type II Medium WBLS ZMP Type II Medium W/BAS SM Type III Medium Medium Z5 Z5° Flood	3MB Type III Medium w/BLS 3MP Type III Medium w/Partial BLS 4M Type IV Medium 4MB Type IV Medium w/BLS 70 70* Flood	Type IV Medium W/Partial BLS 5M Type V Medium 5S Type V Short	AA Adjustable Arm DA Direct Arm DL Direct Long Arm SA Side Arm - Available with 20-60 LEDs	02 04 06 08 10 12 14	E	UL Universal 120-277V UH Universal 347-480V	BK Black BZ Bronze SV Silver WH White	350 350mA 525 525mA 700m 700mA - Available with 20- 60 LEDs	DIM 0-10V Dimming - Control by others - Refer to Dimming spec. sheet for details - Can't exceed specified drive current F Fuse - Refer to ML spec sheet for availability with ML options - Available with UL voltage only - When code dictates fusing, use time delay fuse HL Hi/Low [Dual Circuit Input] - Refer to HL spec sheet for details - Sensor not included ML Multi-Level - Refer to ML spec sheet for details - Sensor not included ML Multi-Level - Refer to ML spec sheet for details - Sensor mot included ML Multi-Level - Refer to ML spec sheet for availability with ML options - Refer to ML spec sheet for details - Sensor mot included ML Multi-Level - Refer to ML spec sheet for availability with ML options - Refer to ML spec sheet for availability with ML options - Refer to ML spec sheet for availability with ML options - Refer to ML spec sheet for availability with ML options
	40 40° Flood	SN Sign								- Intended for downlight applications at 0° tilt - Color temperature per luminaire - Refer to ML spec sheet for availability with ML options - Available with UL voltage only

^{*} Reference EPA and pole configuration suitability data beginning on page 19 NOTE: Price adder may apply depending on configuration






Rev. Date: V3 08/03/2016




All published luminaire photometric testing performed to IESNA LM-79-08 standards by a NVLAP accredited laboratory. To obtain an IES file specific to your project consult: http://lighting.cree.com/products/outdoor/area/cree-edge-series-1

3ME

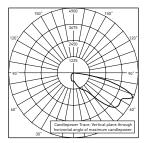

CSA Test Report #: 6448 ARE-EDG-3MB-**-06-E-UL-700 Initial Delivered Lumens: 7,740

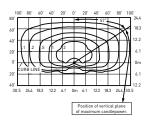

ARE-EDG-3MB-**-12-E-UL-525-40K Mounting Height: 25' (7.6m) A.F.G. Initial Delivered Lumens: 12,420 Initial FC at grade


Type III Med	Type III Medium Distribution w/BLS						
	4000K		5700K				
LED Count (x10)	Initial Delivered Lumens*	BUG Ratings** Per TM-15-11	Initial Delivered Lumens*	BUG Ratings** Per TM-15-11			
350mA							
02	1,499	B1 U0 G1	1,557	B1 U0 G1			
04	2,999	B1 U0 G1	3,114	B1 U0 G1			
06	4,446	B1 U0 G1	4,617	B1 U0 G1			
08	5,929	B1 U0 G2	6,157	B1 U0 G2			
10	7,393	B1 U0 G2	7,677	B1 U0 G2			
12	8,872	B1 U0 G2	9,213	B1 U0 G2			
14	10,285	B1 U0 G2	10,680	B1 U0 G2			
16	11,754	B1 U0 G3	12,206	B1 U0 G3			
525mA							
02	2,099	B1 U0 G1	2,180	B1 U0 G1			
04	4,198	B1 U0 G1	4,359	B1 U0 G1			
06	6,225	B1 U0 G2	6,464	B1 U0 G2			
08	8,300	B1 U0 G2	8,619	B1 U0 G2			
10	10,350	B1 U0 G2	10,748	B1 U0 G2			
12	12,420	B1 U0 G3	12,898	B1 U0 G3			
14	14,398	B1 U0 G3	14,952	B2 U0 G3			
16	16,455	B2 U0 G3	17,088	B2 U0 G3			
700mA							
02	2,564	B1 U0 G1	2,662	B1 U0 G1			
04	5,127	B1 U0 G2	5,325	B1 U0 G2			
06	7,603	B1 U0 G2	7,896	B1 U0 G2			

^{*} Initial delivered lumens at 25°C (77°F). Actual production yield may vary between -10 and +10% of initial delivered lumens


lumens
** For more information on the IES BUG (Backlight-Uplight-Glare) Rating visit: www.ies.org/PDF/Erratas/TM-1511BugRatingsAddendum.pdf. Valid with no tilt

All published luminaire photometric testing performed to IESNA LM-79-08 standards by a NVLAP accredited laboratory. To obtain an IES file specific to your project consult: http://lighting.cree.com/products/outdoor/area/cree-edge-series-1

4M

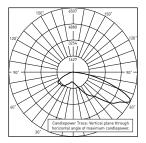

CSA Test Report #: 6438 ARE-EDG-4M-**-06-E-UL-700-40K Initial Delivered Lumens: 11,367

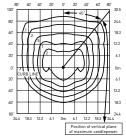


ARE-EDG-4M-**-12-E-UL-525-40K Mounting Height: 25' [7.6m] A.F.G. Initial Delivered Lumens: 17,710 Initial FC at grade

Type IV Med	Type IV Medium Distribution							
	4000K		5700K					
LED Count (x10)	Initial Delivered Lumens*	BUG Ratings** Per TM-15-11	Initial Delivered Lumens*	BUG Ratings** Per TM-15-11				
350mA	350mA							
02	2,138	B1 U0 G1	2,220	B1 U0 G1				
04	4,276	B1 U0 G1	4,440	B1 U0 G1				
06	6,340	B2 U0 G2	6,584	B2 U0 G2				
08	8,454	B2 U0 G2	8,779	B2 U0 G2				
10	10,542	B2 U0 G2	10,947	B2 U0 G2				
12	12,650	B3 U0 G3	13,137	B3 U0 G3				
14	14,665	B3 U0 G3	15,229	B3 U0 G3				
16	16,760	B3 U0 G3	17,405	B3 U0 G3				
525mA								
02	2,993	B1 U0 G1	3,108	B1 U0 G1				
04	5,986	B2 U0 G1	6,216	B2 U0 G2				
06	8,876	B2 U0 G2	9,218	B2 U0 G2				
08	11,835	B2 U0 G2	12,290	B3 U0 G3				
10	14,759	B3 U0 G3	15,326	B3 U0 G3				
12	17,710	B3 U0 G3	18,391	B3 U0 G3				
14	20,531	B3 U0 G3	21,321	B3 U0 G3				
16	23,464	B3 U0 G3	24,367	B4 U0 G3				
700mA								
02	3,656	B1 U0 G1	3,796	B1 U0 G1				
04	7,311	B2 U0 G2	7,593	B2 U0 G2				
06	10,842	B2 U0 G2	11,259	B2 U0 G2				


^{*} Initial delivered lumens at 25°C (77°F). Actual production yield may vary between -10 and +10% of initial delivered

lumens
** For more information on the IES BUG (Backlight-Uplight-Glare) Rating visit: www.ies.org/PDF/Erratas/TM-1511BugRatingsAddendum.pdf. Valid with no tilt

All published luminaire photometric testing performed to IESNA LM-79-08 standards by a NVLAP accredited laboratory. To obtain an IES file specific to your project consult: http://lighting.cree.com/products/outdoor/area/cree-edge-series-1

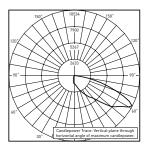

CSA Test Report #: 6449 ARE-EDG-4MB-**-12-E-UL-525-40K Initial Delivered Lumens: 13,155

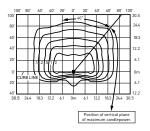

ARE-EDG-4MB-**-12-E-UL-525-40K Mounting Height: 25' [7.6m] A.F.G. Initial Delivered Lumens: 13,340 Initial FC at grade


Type IV Medium Distribution w/BLS				
	4000K		5700K	
LED Count (x10)	Initial Delivered Lumens*	BUG Ratings** Per TM-15-11	Initial Delivered Lumens*	BUG Ratings** Per TM-15-11
350mA				
02	1,610	B0 U0 G1	1,672	B0 U0 G1
04	3,221	B1 U0 G1	3,345	B1 U0 G1
06	4,776	B1 U0 G1	4,959	B1 U0 G1
08	6,368	B1 U0 G2	6,613	B1 U0 G2
10	7,941	B1 U0 G2	8,246	B1 U0 G2
12	9,529	B1 U0 G2	9,895	B1 U0 G2
14	11,046	B1 U0 G2	11,471	B1 U0 G2
16	12,624	B1 U0 G2	13,110	B1 U0 G2
525mA				
02	2,254	B0 U0 G1	2,341	B0 U0 G1
04	4,509	B1 U0 G1	4,682	B1 U0 G1
06	6,686	B1 U0 G2	6,943	B1 U0 G2
08	8,915	B1 U0 G2	9,258	B1 U0 G2
10	11,117	B1 U0 G2	11,544	B1 U0 G2
12	13,340	B1 U0 G2	13,853	B2 U0 G2
14	15,465	B2 U0 G2	16,060	B2 U0 G3
16	17,674	B2 U0 G3	18,354	B2 U0 G3
700mA				
02	2,754	B0 U0 G1	2,860	B0 U0 G1
04	5,507	B1 U0 G1	5,719	B1 U0 G2
06	8,167	B1 U0 G2	8,481	B1 U0 G2

^{*} Initial delivered lumens at 25° C (77° F). Actual production yield may vary between -10 and +10% of initial delivered

lumens


** For more information on the IES BUG (Backlight-Uplight-Glare) Rating visit: www.ies.org/PDF/Erratas/TM-1511BugRatingsAddendum.pdf. Valid with no tilt

AA Mount

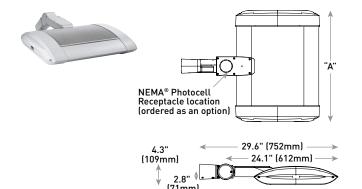


LED Count (x10)	Dim. "A"	Weight
02	12.1" (306mm)	21 lbs. (10kg)
04	12.1" (306mm)	24 lbs. (11kg)
06	14.1" (357mm)	27 lbs. (12kg)
08	16.1" (408mm)	28 lbs. (13kg)
10	18.1" (459mm)	32 lbs. (15kg)
12	20.1" (510mm)	34 lbs. (15kg)
14	22.1" (560mm)	37 lbs. (17kg)
16	24.1" (611mm)	41 lbs. (19kg)

DL Mount

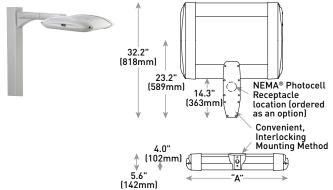

LED Count (x10)	Dim. "A"	Weight
02	12.1" (306mm)	23 lbs. (10kg)
04	12.1" (306mm)	26 lbs. (12kg)
06	14.1" (357mm)	29 lbs. (13kg)
08	16.1" (408mm)	30 lbs. (14kg)
10	18.1" (459mm)	34 lbs. (15kg)
12	20.1" (510mm)	36 lbs. (16kg)
14	22.1" (560mm)	42 lbs. (19kg)
16	24.1" (611mm)	44 lbs. (20kg)

SA Mount

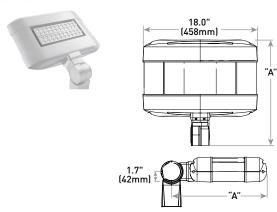

LED Count (x10)	Dim. "A"	Weight
02	16.0" (406mm)	25 lbs. (11kg)
04	18.0" (457mm)	26 lbs. (12kg)
06	20.0" (508mm)	28 lbs. (13kg)

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Cree Edge™ Series

LED Security Wall Pack Luminaire

Product Description

The Cree Edge™ wall mount luminaire has a slim, low profile design. The luminaire end caps are made from rugged die cast aluminum with integral, weathertight LED driver compartments and high performance aluminum heat sinks specifically designed for LED applications. Housing is rugged aluminum. Includes a lightweight mounting box for installation over standard and mud ring single gang J-Boxes. Secures to wall with four 3/16" (5mm) screws (by others). Conduit entry from top, bottom, sides and rear. Allows mounting for uplight or downlight. Designed and approved for easy through-wiring. Includes leaf/debris guard.

Applications: General area and security lighting



Patented NanoOptic® Product Technology

Made in the U.S.A. of U.S. and imported parts

CRI: Minimum 70 CRI

CCT: 4000K (+/- 300K), 5700K (+/- 500K) standard


Limited Warranty[†]: 10 years on luminaire/10 years on Colorfast DeltaGuard® finish

†See http://lighting.cree.com/warranty for warranty terms

Accessories

Field-Installed	
Bird Spikes XA-BRDSPK	Hand-Held Remote XA-SENSREM - For successful implementation of the programmable multi-level option, a minimum of one hand-held remote is required



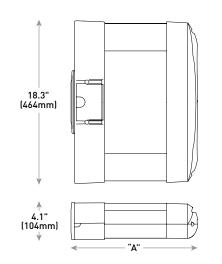

LED Count (x10)	Dim. "A"	Weight		
02	9.9" (251mm)	20 lbs. (9.1kg)		
04	11.9" (303mm)	22 lbs. (10.0kg)		
06	13.9" (353mm)	25 lbs. (11.3kg)		
08	15.9" (404mm)	27 lbs. (12.2kg)		
10	17.9" (455mm)	31 lbs. (14.1kg)		
12	19.9" (505mm)	32 lbs. (14.5kg)		

Ordering Information

Example: SEC-EDG-2M-WM-06-E-UL-SV-700

SEC-EDG		WM		E				
Product	Optic	Mounting	LED Count (x10)	Series	Voltage	Color Options	Drive Current	Options
SEC-EDG	2M Type II Medium 2MB Type II Medium w/BLS 2S Type II Short 2SB Type II Short w/BLS 3M Type III Medium 3MB Type III Medium w/BLS 4M Type IV Medium 4MB Type IV Medium w/BLS	WM Wall Mount	02 04 06 08 10 12	E	UL Universal 120-277V UH Universal 347-480V 34 347V	BK Black BZ Bronze SV Silver WH White	350 350mA 525 525mA -Available with 20-80 LEDs 700 700mA -Available with 20-60 LEDs	DIM 0-10V Dimming - Control by others - Refer to Dimming spec sheet for details - Can't exceed specified drive current F Fuse - Refer to ML spec sheet for availability with ML options - Available with UL voltage only - When code dictates fusing, use time delay fuse ML Multi-Level - Refer to ML spec sheet for details - Intended for downlight applications of 0° tilt P Photocell - Refer to ML spec sheet for availability with ML options - Must specify UL or 34 voltage PML Programmable Multi-Level - Refer to PML spec sheet for details - Intended for downlight applications of 0° tilt 40K 4000K Color Temperature - Minimum 70 CRI - Color temperature per luminaire








Rev. Date: V2 07/28/2016




T (800) 473-1234 F (800) 890-7507


All published luminaire photometric testing performed to IESNA LM-79-08 standards by a NVLAP accredited laboratory. To obtain an IES file specific to your project consult: http://lighting.cree.com/products/outdoor/wall-mount/cree-edge-series-5

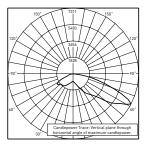

ITL Test Report #: 78793 SEC-EDG-4M-**-06-E-UL-700-40K Initial Delivered Lumens: 11,607

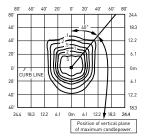


SEC-EDG-4M-**-08-E-UL-525-40K Mounting Height: 10' (3.0m) A.F.G. Initial Delivered Lumens: 11,835 Initial FC at grade

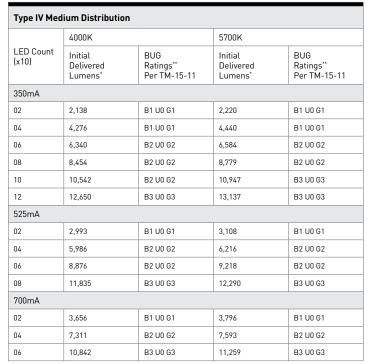

4MB

CSA Test Report #: 6449 ARE-EDG-4MB-**-12-E-UL-525-40K Initial Delivered Lumens: 13,155

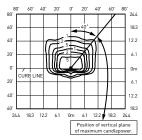

SEC-EDG-4MB-**-08-E-UL-525-40K Mounting Height: 10' (3.0m) A.F.G. Initial Delivered Lumens: 8,915 Initial FC at grade

Type IV Medium Distribution w/BLS					
	4000K		5700K		
LED Count (x10)	Initial Delivered Lumens*	BUG Ratings** Per TM-15-11	Initial Delivered Lumens*	BUG Ratings** Per TM-15-11	
350mA					
02	1,610	B0 U0 G1	1,672	B0 U0 G1	
04	3,221	B1 U0 G1	3,345	B1 U0 G1	
06	4,776	B1 U0 G1	4,959	B1 U0 G1	
08	6,368	B1 U0 G2	6,613	B1 U0 G2	
10	7,941	B1 U0 G2	8,246	B1 U0 G2	
12	9,529	B1 U0 G2	9,895	B1 U0 G2	
525mA					
02	2,254	B0 U0 G1	2,341	B0 U0 G1	
04	4,509	B1 U0 G1	4,682	B1 U0 G1	
06	6,686	B1 U0 G2	6,943	B1 U0 G2	
08	8,915	B1 U0 G2	9,258	B1 U0 G2	
700mA					
02	2,754	B0 U0 G1	2,860	B0 U0 G1	
04	5,507	B1 U0 G1	5,719	B1 U0 G2	
06	8,167	B1 U0 G2	8,481	B1 U0 G2	

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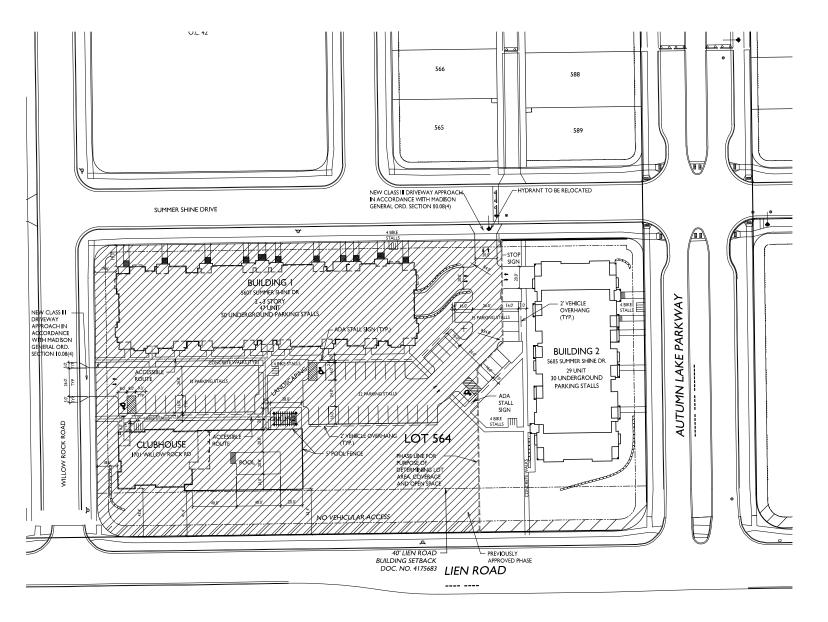
Initial delivered lumens at 25°C (77°F)
 For more information on the IES BUG (Backlight-Uplight-Glare) Rating visit: www.ies.org/PDF/Erratas/TM-15-11BugRatingsAddendum.pdf

Initial delivered lumens at 25°C (77°F)
 For more information on the IES BUG (Backlight-Uplight-Glare) Rating visit: www.ies.org/PDF/Erratas/TM-15-11BugRatingsAddendum.pdf











LOT 564 SITE DEVELOPMENT DATA - PHASE 2 DENSITIES
TOTAL LOT AREA
LOT AREA (THIS SUBMITTAL)
DWELLING UNITS
LOT AREA/ D.U.
DENSITY 131,849 S.F. / 3 ACRES 37,688 S.F. / .87 ACRES 29 DU 1,300 S.F. / DU 33.33 UNITS / ACRE 2-3 STORIES BUILDING HEIGHT LOT COVERAGE USABLE OPEN SPACE USABLE OPEN SPACE / D.U. 37,688 S.F. = 41% (75% MAX) 22,636 S.F. 780 S.F./ D.U. DWELLING UNIT MIX:
EFFICIENCY
ONE BEDROOM
TWO BEDROOM
TOTAL UNITS 15 29 UNITS VEHICLE PARKING STALLS: SURFACE UNDERGROUND TOTAL RATIO 30 45 VEHICLE STALLS I.5 STALLS/UNIT BICYCLE PARKING STALLS
SURFACE
SURFACE GUEST
UNDERGROUND GARAGE - WALL HUNG
UNDERGROUND GARAGE STD. 2'X6'
TOTAL 34 BICYCLE STALLS

GENERAL NOTES:

THE APPLICANT SHALL REPLACE ALL SIDEWALK AND CURB AND GUTTER WHICH ABUTS THE PROPERTY WHICH IS DAMAGED BY THE CONSTRUCTION OR ANY SIDEWALK AND CURB AND GUTTER WHICH THE CITY ENGINEER DETERMINES NEEDS TO BE REPLACED BECAUSE IT IS NOT AT A DESIRABLE GRADE REGRADLES OF WHETHER THE CONDITION EXISTED PRIOR TO BEGINNING CONSTRUCTION.

- ALL WORK IN THE PUBLIC RIGHT-OF-WAY SHALL BE PERFORMED BY A CITY LICENSED CONTRACTOR.
- ALL DAMAGE TO THE PAVEMENT , ADJACENT TO THIS DEVELOPMENT SHALL BE RESTORED IN ACCORDANCE WITH THE CITY OF MADISON'S PAVEMENT PATCHING CRITERIA.
- APPROVAL OF PLANS FOR THIS PROJECT DOES NOT INCLUDE ANY APPROVAL TO PRUNE, REMOVE, OR PLANT TREES IN THE PUBLIC RIGHT-OF-WAY, PERMISSION FOR SUCH ACTIVITIES MUST BE OBTAINED FROM THE CITY FORESTER, 266-4816.
- EASEMENT LINES SHOWN ON THIS SHEET ARE FOR GENERAL REFERENCE ONLY SEE CSM AND CIVIL SHEETS FOR ADDITIONAL AND MORE COMPLETE EASEMENT INFORMATION

ISSUED

PROJECT TITLE Autumn Lake Building 2


5615 Summer Shine Dr.


Lot 564 Village at Autumn Lake SHEET TITLE Site Plan


SHEET NUMBER

PROJECT NO.

1644

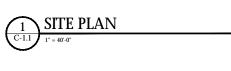

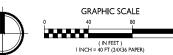

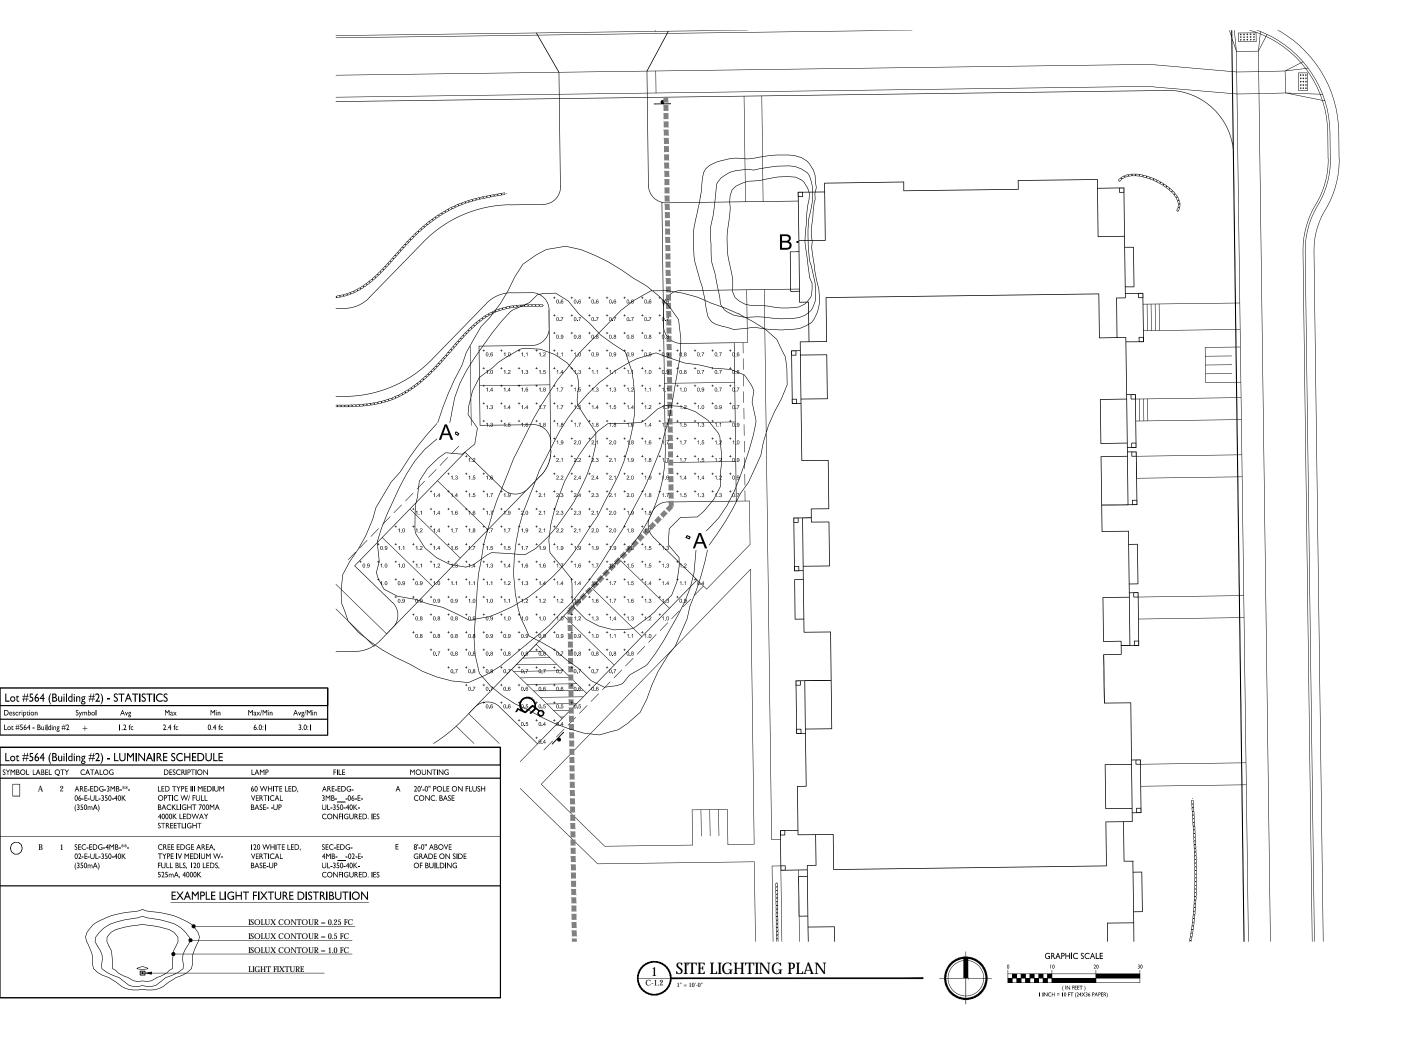

Symbol Avg

Lot #564 - Building #2 +

SYMBOL LABEL QTY CATALOG

B 1 SEC-EDG-4MB-**-02-E-UL-350-40K

A 2 ARE-EDG-3MB-**-

(350mA)

06-E-UL-350-40K (350mA)



ISSUED

PROJECT TITLE Autumn Lake Building 2 5615 Summer Shine Dr.

Lot 564 Village at Autumn Lake


SHEET TITLE

Site Lighting Plan

SHEET NUMBER

PROJECT NO.


1644

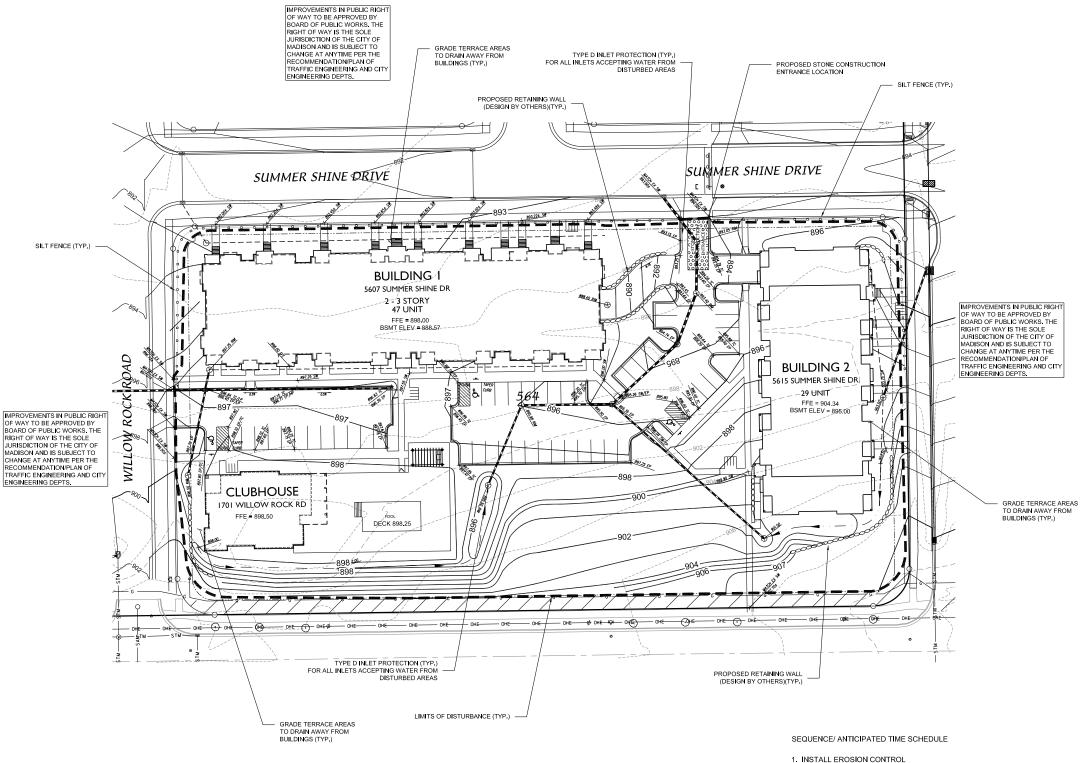







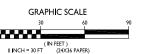

2. ROUGH SITE GRADING, BEGIN BUILDING CONSTRUCTION

4. RESPREAD TOPSOIL AND FINAL RESTORATION 5. REMOVE EROSION CONTROL WHEN SITE HAS BECOME STABILIZED.

FINE GRADING, CONCRETE CURB AND GUTTER, ASPHALT, CONCRETE, UTILITIES, RETAINING WALL, AND BUILDING CONSTRUCTION.

LEGEND



PROPOSED CONTOUR

EXISTING CONTOUR

895.50

SPOT ELEVATION EP - EDGE OF PAVEMENT

EP - EUGE OF PAVEMENT FFE - FINISHED FLOOR ELEVATION TC - TOP OF CURB TW - TOP OF WALL (GROUND ELEVATION) BW - BOTTOM OF WALL (GROUND ELEVATION) HP - HIGHPOINT

LIMITS OF DISTURBANCE

SILT FENCE/SILT SOCK

FLOW ARROW RETAINING WALL (DESIGN BY OTHERS) -

GENERAL NOTES

- 1. ALL WORK SHALL BE PER THE CITY OF MADISON STANDARDSPECIFICATIONS
- 2. CONTRACTOR IS RESPONSIBLE TO OBTAIN ANY AND ALL PERMITS REQUIRED.
- 3. BUILDING CORNERS ARE APPROXIMATE AND FOR GENERAL BUILDING FOOTPRINT ONLY
- 4. IF ANY ERRORS, DISCREPANCIES, OR DIMENSIONS WITH PLAN BECOME APPARENT. IT SHALL BE BROUGHT TO THE ATTENTION OF THE ENGINEER PRIOR TO CONSTRUCTION
- 5. CONTRACTOR SHALL ENSURE THAT ALL STORMWATER DRAINS AWAY FROM BUILDING FOUNDATIONS DURING FINAL RESTORATION
- 6. ALL DIMENSIONS TO FACE OF CURB UNLESS OTHERWISE NOTED
- 7. ALL WORK IN THE PUBLIC RIGHT-OF-WAY SHALL BE PERFORMED BY A CITY LICENSED CONTRACTOR
- 8. CONTRACTOR SHALL REPLACE ALL SIDEWALK AND CURB & GUTTER WHICH ABUTS THE PROPERTY AND IS DAMAGED BY CONSTRUCTION.
- 10. ALL DAMAGE TO THE PAVEMENT OF ADJACENT PUBLIC STREETS SHALL BE RESOTRED IN ACCORDANCE WITH THE CITY OF MADISON'S PAVEMENT PATCHING CRITERIA

GRADING AND EROSION CONTROL NOTES:

- ALL EROSION CONTROL MEASURES SHALL BE CONSTRUCTED AND MAINTAINED BY THE CONTRACTOR IN ACCORDANCE WITH THE WISCONSIN DNR TECHNICAL STANDARDS. IT IS THE CONTRACTOR'S RESPONSIBILITY TO OBTAIN A COPY OF THESE STANDARDS.
- 2. INSTALL EROSION CONTROL MEASURES PRIOR TO ANY SITE WORK, INCLUDING GRADING OR DISTURBANCE OF EXISTING SURFACE MATERIALS AS SHOWN ON PLAN. MODIFICATIONS TO SEDIMENT CONTROL DESIGN MAY BE CONDUCTED TO MEET UNFORESEEN FIELD CONDUTIONS IF MODIFICATIONS CONFORM TO WDNR TECHNICAL STANDARDS.
- 3. EROSION CONTROL MEASURES INDICATED ON THE PLANS SHALL BE CONSIDERED MINIMUMS. IF DETERMINED NECESSARY DURING CONSTRUCTION ADDITIONAL MEASURES SHALL BE INSTALLED TO PREVENT SEDIMENT FROM LEAVING THE SITE.
- INSPECTIONS AND MAINTENANCE OF ALL EROSION CONTROL MEASURES SHALL BE ROUTINE (ONCE PER WEEK MINIMUM) TO ENSURE PROPER FUNCTION OF EROSION CONTROLS AT ALL TIMES. EROSION CONTROL MEASURES ARE TO BE IN WORKING ORDER AT THE END OF EACH WORK DAY.
- INSPECT EROSION CONTROL MEASURES AFTER EACH 1/2" OR GREATER RAINFALL. REPAIR ANY DAMAGE OBSERVED DURING THE INSPECTION.
- 6. NO SITE GRADING OUTSIDE OF THE LIMITS OF DISTURBANCE
- 7. EROSION CONTROL MEASURES SHALL BE REMOVED ONLY AFTER SITE CONSTRUCTION IS COMPLETE WITH ALL SOIL SURFACES HAVING AN ESTABLISHED VEGETATIVE COVER
- 8. INSTALL TYPE D INLET PROTECTION IN ALL STORM SEWER INLETS AND CATCH BASINS THAT MAY RECEIVE RUNOFF FROM DISTURBED AREAS
- 9. CUT AND FILL SLOPES SHALL BE NO GREATER THAN 4:1
- 10. SLOPES EXCEEDING 4:1 SHALL BE STABILIZED WITH CLASS I, TYPE B EROSION MATTING AND ALL DRAINAGE SWALES SHALL BE STABILIZED WITH CLASS II, TYPE B EROSION MATTING.
- 11. ALL INCIDENTAL MUD TRACKING OFF-SITE ONTO ADJACENT PUBLIC THOROUGHFARES SHALL BE CLEANED UP AND REMOVED BY THE END OF EACH WORKING DAY USING PROPER DISPOSAL METHODS.
- 12. ANY DISTURBED AREA THAT REMAINS INACTIVE FOR GREATER THAN 7 DAYS SHALL BE STABILIZED WITH TEMPORARY STABILIZATION METHODS SUCH AS TEMPORARY SEEDING, SOIL TREATMENT, EROSION MATTING, OR MULCH
- 13. PREVENT EXCESSIVE DUST FROM LEAVING THE CONSTRUCTION SITE IN ACCORDANCE WITH LOCAL AND STATE REGULATIONS.
- 14.INSTALL EROSION CONTROLS ON THE DOWNSTREAM SIDE OF STOCKPILES.
- 15. AT A MINIMUM ALL DISTURBED AREAS SHALL RECEIVE A MINIMUM OF 4" OF TOPSOIL FERTILIZER, SEED AND MULCH. SEED MIXTURE SHALL BE WISCONSIN DOT SEED MIX #40 OR EQUIVALENT APPLIED AT A RATE OF 5 POUNDS PER 1000 SQFT ON ALL DISTURBED AREAS. ANNUAL RYEGRASS AT A RATE OF 1 POUNDS PER 1000 SQFT SHALL BE ADDED TO THE MIXTURE. FERTILIZER SHALL BE PLACED PER A SOIL TEST. SEE LANDSCAPE PLAN FOR A MORE DETAILED PLANTING PLAN AND LANDSCAPE DETAILS.
- 16. DEWATERING, IF APPLICABLE, SHALL BE CONDUCTED PER WDNR STORM WATER MANAGEMENT TECHNICAL STANDARD 1061.

LIMITS OF DISTURBANCE =123,560 SQFT

knothe • bruce ARCHITECTS Phone: 7601 University Ave, Ste 201 608.836.3690 Middleton, WI 53562

D'ONOFRIO KOTTKE AND ASSOCIATES, INC.

hone: 608,833,7530 . Fix: 608,839,108

ISSUED

Issued for Land Use & UDC - Ian. 18, 2017 Revised -March 16, 2017 City Submittal -April 14, 2017 City Submittal -May 10, 2017

PROJECT TITLE Village at Autumn

Lake

Lot 564 1704 Autumn Lake Pkwy

SHEET TITLE Grading Plan

SHEET NUMBER

PROJECT NO.

@Knothe & Bruce Architects, LLC

File: U:\User\1603104\Drawings\1603104 Base.dwg Grading-Lot 564 30sc Plotted: May 05, 2017 - 11:44am

ŒY	SCIENTIFIC NAME		QTY	PLANTING SIZE	ROOT CONDITION
	DECIDIOUS TREES		_		
AF	Acer x freemadil Jefferson	Autumn Blaze Macle	10	2.1(2*	BAR
CO	Cells accidentals	Common Hackberry	10	2.1/2"	BAB
GT	Gledisia triacanthos var, Inernis 'Skyline'	Skyline Thomless Honeylocust	4	2 1/2"	BAB
OM	Quercus macrocarpa	Burr Cos	9	2 1/2"	BAB
UA	Umus americana 'Jefferson'	Jefferson Flee	- 6	2 1/2"	BAB
UA	Ulmus americana 'Jetterson'	Jetherson Elm	- 6	2 1/2"	848
	ORNAMENTAL TREES		_		$\overline{}$
AG.	Amelanchier a grand fora 'Autumn Billiance'	Autumn Brill tance Serviceberry	- 2	2.	BAR
MC	Make 'Camelof	Carnelot Crabapole	- 4	2.	848
PC	Pyrus Calleryana 'Chardoleer'	Chantidger Callery Pear	4	2.	BAB
	.,				- 000
	EVERGREEN TREES				858
PG	Ploca glauca var, densata	Black Hills Spruce	- 6	6	
TO	Thus condentals Techny	Techny Arbonytse	24	6	BAB
	•		•	•	
	EVERGREEN SHRUBS				
TM	Taxus x media 'Tauntoni'	Taunton Yew	19	24"	BAB
	DECIDUOUS SHRUBS				
AM	Arorta melanocarpa var. elata	Glossy Black Choksberry	20	\$ 5	Cont
HA	Hydrangea arborescens 'Annabelle'	Annabelle Hydrangea	11	63	Cont
RP	Rhododendron 'PJM'	PJM Rhododendron	16	#3	Cont
RR	Rosa 'Radrazz'	Knockout Shrub Rose	22	#3	Cont
SP	Syringa pubescens subsp. patula 'Miss Kim'	Mas Kim Liac	3	95	Cont
VO.	Vibumum dentatum 'Synnestvedt'	Chicago Lustre Arrowwood Vibumum	27	95	Cont
WF	Welgela forlda 'Alexandra'	Wine & Roses Welgela	19	\$ 5	Cont
	ORNAMENTAL GRASSES / PERENNALS				
	Calamacrostis x accurifora 'Karl Foerster'	Kad Foesser Feather Reed Grass			

GENERAL NOTES:

BARK MULCH TO BE BROWN DYED, RECYCLED HARDWOOD, WITH PRE-EMERGENT HERBICIDE.

WASHED STONE TO BE 1.5" CAPITOL WASHED WITH WEED BARRIER FABRIC.

· BED EDGING TO BE DIMEX EDGEPRO OR EQUIVALENT

ALL CONCRETE AREAS, STEPS AND RAMPS TO BE UN-COLORED CONCRETE, BRUSH FINISHED.

SEE ASP-100 FOR SITE MATERIAL IMAGES.

BIKE PARKING AND AMENITIES NOTES:

• SEE SITE PLAN FOR DETAILED LAYOUT


• ALL SEATING SHOWN WILL BE SUPPLIED BY TENANT AND NON-PERMANENT FIXTURE.

LANDSCAPING WORKSHEET

Total square footage of developed area 37,695 st

Total landscape points required 629 pts

			CREDITS / EXIS	TING LANDSCAPING	CREDITS / PROF	OSED LANDSCAPIN
PLANT TYPE / ELEMENT	MINIMUM SIZE AT INSTALLATION	POINTS	QUANTITY	POINTS ACHIEVED	QUANTITY	POINTS ACHIEVED
Overstory deciduous tree	2 1/2" callper measured dbh	35			33	1155
Tall evergreen tree	5'-6' tal	35			6	210
Ornamental tree	1 1/2" caliper	15			11	165
Upright evergreen shrub	3'-4' tal	10			24	240
Shrub, deciduous	#3 gallon container size, Min. 12"-24"	3			159	477
Shrub, evergreen	#3 gallon container size, Min. 12"-24"	4			32	128
Ornamental grasses/perennials	#1 gallon container size, Min. 8"-18"	2			14	28
Ornamental fencing or wall		4 per 10 H				
Existing significant specimen tree	2 1/2" cap ler dbh	14 per cel, in, Max 200/tree				
Landscape furniture (public)		Siseat	•			
SUB TOTALS						2403
				Total Number of Point	ts Provided	2403

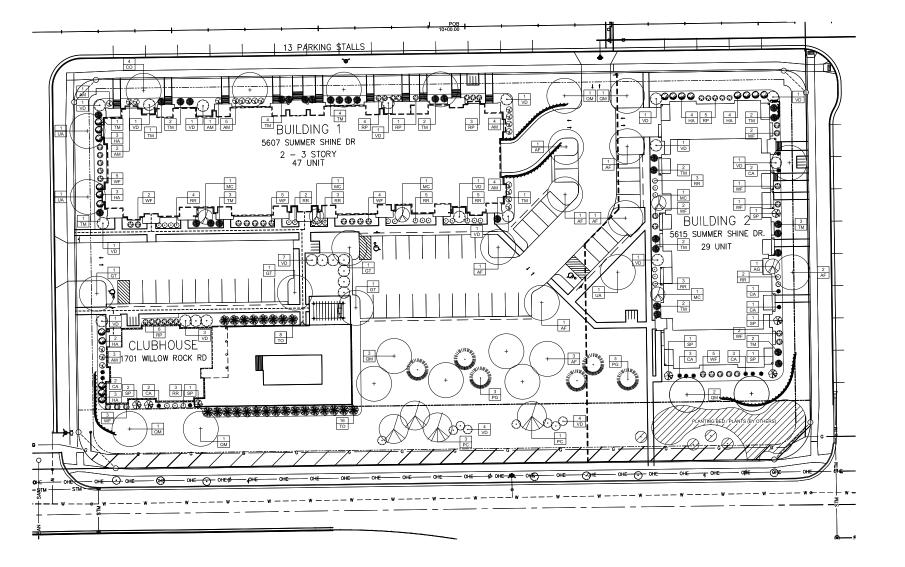



3570 Pioneer Road Verona, WI 53593 PH: (608) 827-9401 FAX: (608) 827-9402 WEB: www.olsontoon.com

564 LOT **AUTUMN LAKE**

L-1.2

Date: 1/19/17 Scale: 1" = 30'-0" Designer: rc/mm Job # 6758

Revisions: 2017.03.17 mm 2017.04.12 mm 2017.05.08 mm




PROJECT TITLE
Autumn Lake
Building 2
5615 Summer Shine Dr.

Lot 564
Village at Autumn Lake
SHEET TITLE
Basement Floor Plan
Building 2

SHEET NUMBER

A-1.0


PROJECT NO.

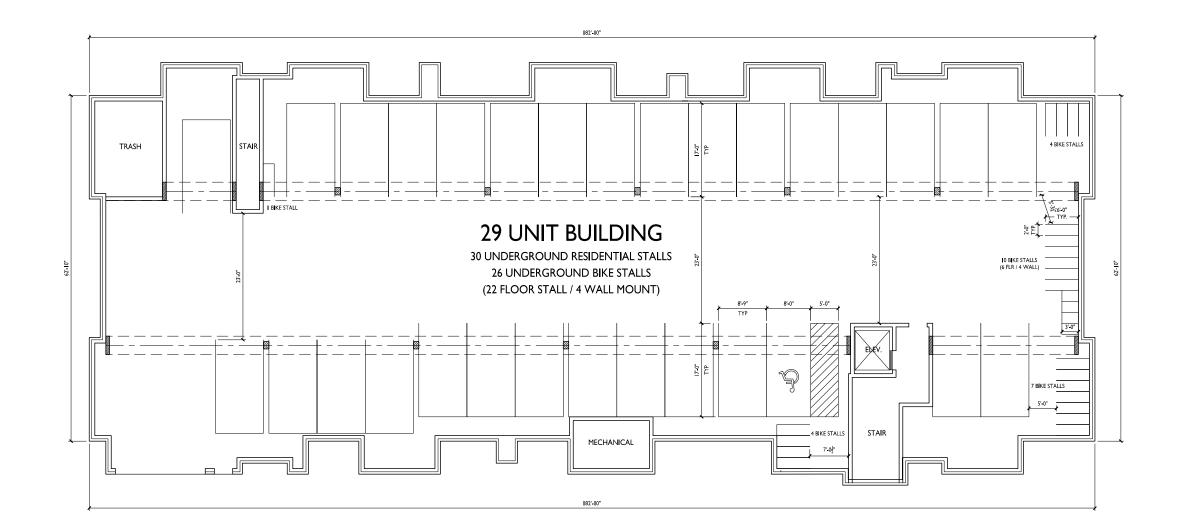







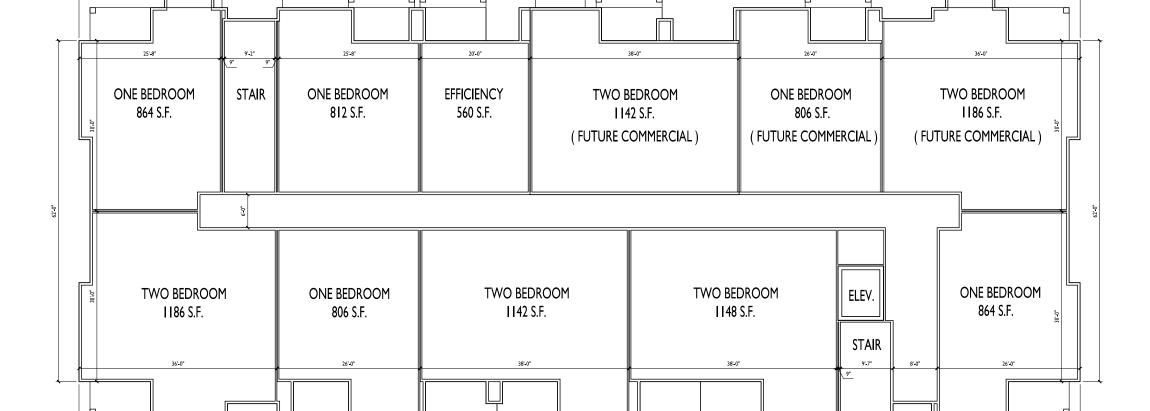

Autumn Lake
Building 2
5615 Summer Shine Dr.

Lot 564
Village at Autumn Lake
SHEET TITLE
First Floor Plan
Building 2

SHEET NUMBER

A-1.


1644

PROJECT NO.







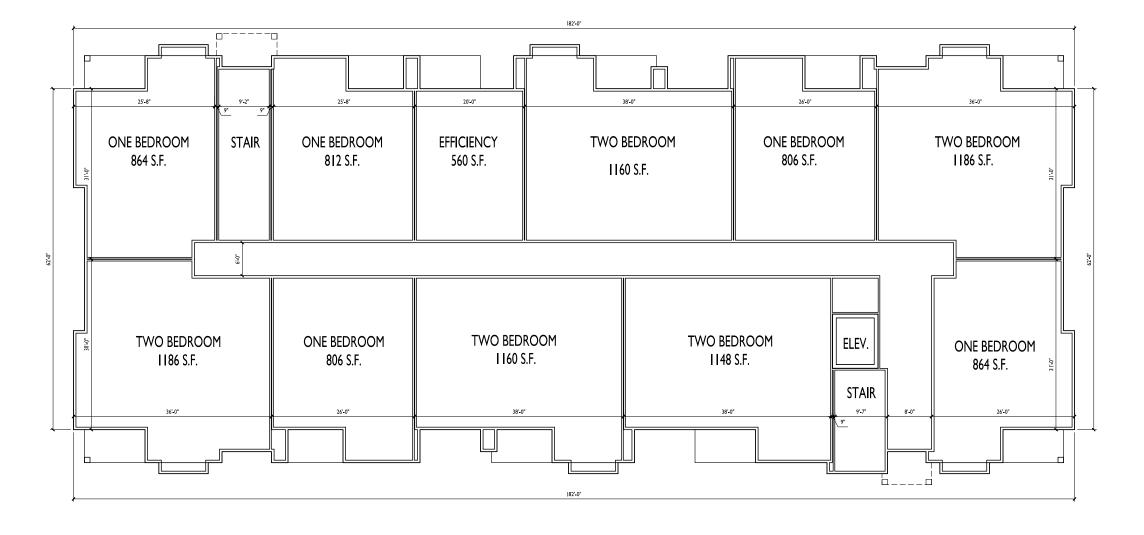

PROJECT TITLE
Autumn Lake
Building 2
5615 Summer Shine Dr.

Lot 564
Village at Autumn Lake
SHEET TITLE
Second Floor Plan
Building 2

SHEET NUMBER

A-1.2

1644


PROJECT NO.

SECOND FLOOR PLAN

1/8" = 1'-0"





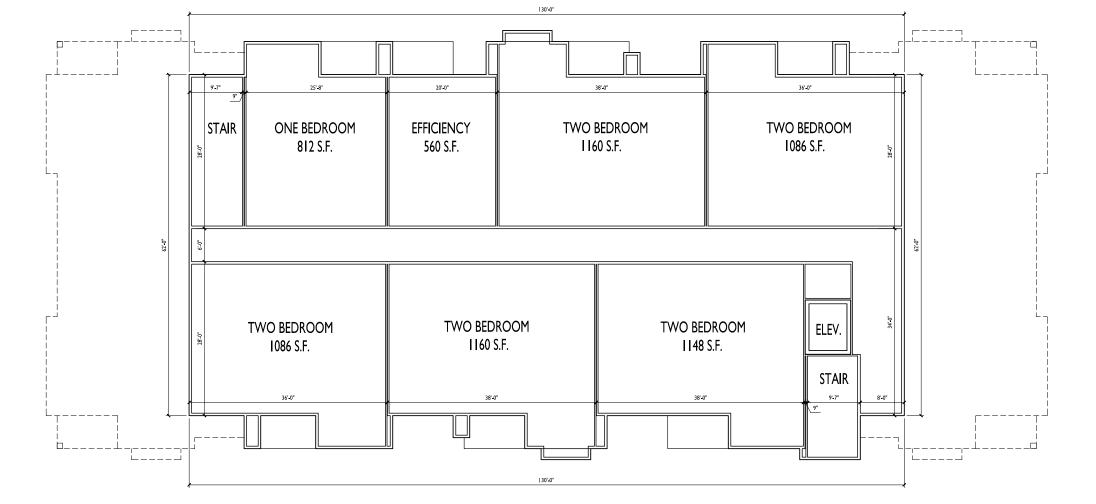

PROJECT TITLE
Autumn Lake
Building 2
5615 Summer Shine Dr.

Lot 564
Village at Autumn Lake
SHEET TITLE
Third Floor Plan
Building 2

SHEET NUMBER

A-1.3

PROJECT NO.







Knothe bruce
A R C H I T E C T S
Plane: 7401 University Ave, Suc 201
400.834.3470 Middleton, WI 53542

ISSUED

Issued for Land Use - May 10,, 2017

EXTERIOR MATERIAL SCHEDULE				
ROOF	GAF WEATHERED WOOD			
MASONRY VENEER	MILL CREEK - CASTLE ROCK (MADISON BLOCK & STONE)			
CAST STONE HEADS & SILLS	BUFF			
HOR I ZONTAL SIDING	COMPOSITE - IRON GRAY - JAMES HARDIE			
SHAKE SIDING, FRIEZE, DECK, WINDOW TRIM BRDS	COMPOSITE - COBBLE STONE - JAMES HARDIE			
FASCIA	ALUMINUM WRAPPED - HERRINGBONE #819 - QUALITY EDGE			
WINDOWS	WEATHER-SHIELD TAN			
RAILING	ALUMINUM - DARK BRONZE			
ENTRY DOORS	ALUMINUM STOREFRONT - DARK BRONZE			

PROJECT TITLE

Exterior Elevations
Building 2

SHEET NUMBER

A-2.1

PROJECT NO.

WEST ELEVATION

AVERAGE GRADE





PROJECT TITLE

Exterior Elevations
Building 2

SHEET NUMBER

A-2.2

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PROJECT NO.

NORTH ELEVATION
(ALONG SUMMER SHINE DR.)


(Along summer shine dr.)



SOUTH ELEVATION (ALONG LIEN RD.)





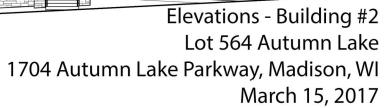

knothe bruce

