

City of Madison

Conditional Use Alteration

1603-1609 Monroe Street

Project Name Shimanski Conditional Use **Applicant** Gregg Shimanski / Paul Cuta - CaS4 Architecture, LLC


Existing Use

Approved mixed-use building


Proposed Use

Construct vehicle access sales and service window in approved mixed-use building

Public Hearing Date Plan Commission 24 April 2017

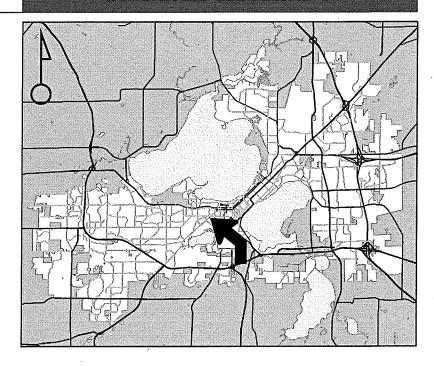

For Questions Contact: Tim Parks at: 261-9632 or tparks@cityofmadison.com or City Planning at 266-4635

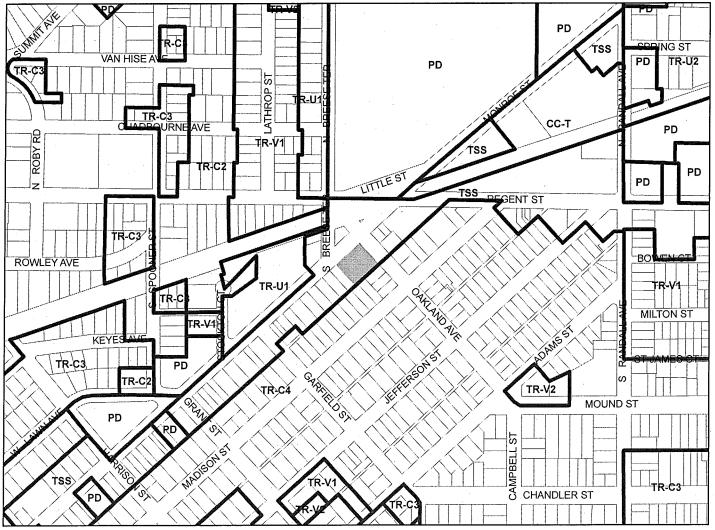


Scale: 1'' = 400'

City of Madison, Planning Division: PPE: Date: 10 April 2017



City of Madison

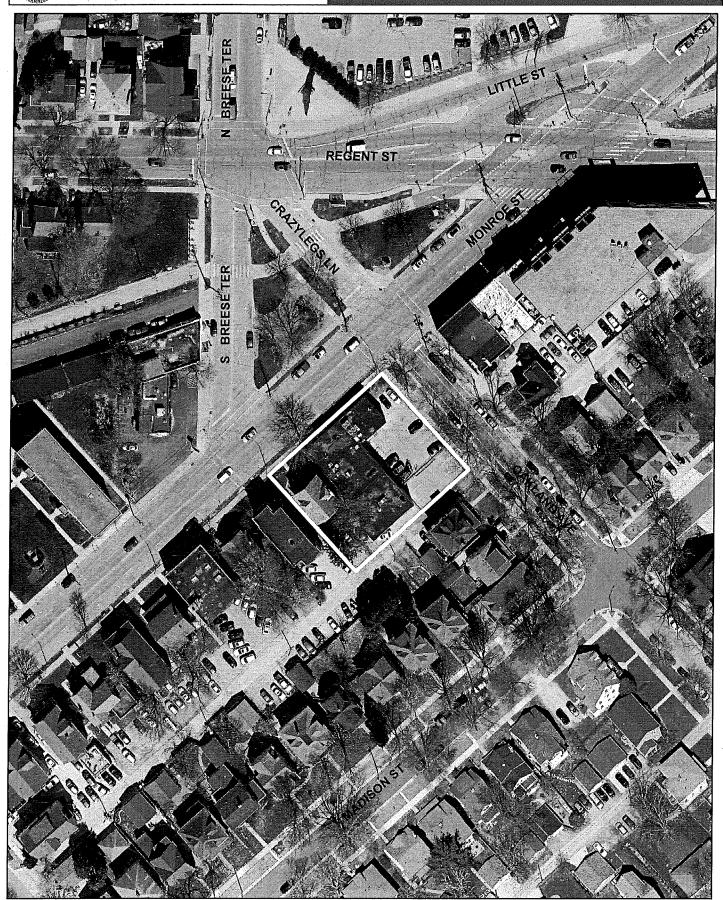

Date of Aerial Photography: Spring 2016



1. Project Information

Telephone



All Land Use Applications must be filed with th
Zoning Office at the above address.

City of Madison		FOR OFFICE USE ON	LY:
Planning Division		Paid <u>#950</u>	Receipt # 026707-0005
126 S. Hamilton St P.O. Box 2985	t.	Date received	Receipt # $026707-0005$ $2/22/17$
Madison, WI 5370)1-2985	Received by	a for
(608) 266-4635	A CONSTR	Parcel #	0709-224-6805-4
		Aldermaņic district	B-Eskich
All Land Use Annli	cations must be filed with the	Zoning district	
Zoning Office at th		Special requirements	23A, Ex. CU (4P-27
•	rm is required for all	Review required by	
• •	an Commission review except d divisions, which should be	UDC ,	□ PC
filed using the Sub	division Application found on	☐ Common Council	
the City's web site.		Reviewed By	
		,	
Duniant Informatio			
Project Informatio			
Address: \(\lambda_0\)	03,1605,1609 \$ 1611 MONE	DE SINCET!	
Title:	IXTEEN () HULFE	lonnoe (1603 MANNOE
This is an applicati	ion for (check all that apply)		
☐ Zoning Map A	mendment (rezoning) from	to	
	ment to an Approved Planned Develop		
	ment to an Approved Planned Develop		
☐ Review of Alte	eration to Planned Development (PD) (k	oy Plan Commission)	
Conditional Us	se or Major Alteration to an Approved	Conditional Use	
☐ Demolition Pe	rmit		
☐ Other request	S		
Applicant Agent a	nd Property Owner Information		
Applicant name	Paul Cuth	Company Ca.	S. A la cultania
Street address			>4 Anatotavião
	303 S. Parenson Stel		
Telephone	608-345-1114	Email pairec	as fairch. com.
Project contact per	_	_Company	
Street address	SPPLICANT	- ,	
Telephone		_Email	
Property owner (if	not applicant) Sixter O	THUEE MANNOE	Go GNEGG SHIMMUSKI
Street address	1603 Mayros St.	_City/State/Zip	Lason, W/ 53711
Tolonhono	609 112 = 5117	Email Ata O	12- 4-

4. Project Description			
Provide a brief description of the project and all proposed uses of the site:			
BUILDING WITH 44 RES. UNITS & 5,353 SF OF COMMERCIAL	150-USE		
BUILDING WITH 44 RES. UNITS & 5,353 SF OF COMMERCIAL	SPLCE.		
Scheduled start date <u>April 3,1017</u> Planned completion date <u>May. 2018</u>			
5. Required Submittal Materials			
Refer to the Land Use Application Checklist for detailed submittal requirements.			
Filing fee Pre-application notification)		
☐ Supplemental Requirements			
Letter of intent Survey or existing conditions site plan Electronic Submittal*			
Legal description Development plans			
*Electronic copies of all items submitted in hard copy are required. Individual PDF files of each item submitted should be compiled or flash drive, or submitted via email to pcapplications@cityofmadison.com. The email must include the project address, project nand applicant name. Electronic submittals via file hosting services (such as Dropbox.com) are not allowed. Applicants who are una provide the materials electronically should contact the Planning Division at (608) 266-4635 for assistance.	ame, ble to		
For concurrent UDC applications a separate pre-application meeting with the UDC Secretary is required prior to subr Following the pre-application meeting, a complete UDC Application form and all other submittal requirements must be submitted to the UDC Secretary. An electronic submittal, as noted above, is required. Electronic submittals should be compiled on a CD or flash drive, or sent via email to udcapplications@cityofmadison.com.			
6. Applicant Declarations			
□ Pre-application meeting with staff. Prior to preparation of this application, the applicant is strongly encouraged to discuss the proposed development and review process with Zoning and Planning Division so Note staff persons and date.	taff.		
Planning staff Date			
Zoning staff Date			
□ <u>Demolition Listserv</u>			
☐ Public subsidy is being requested (indicate in letter of intent)			
Pre-application notification: The zoning code requires that the applicant notify the district alder and any nearby neighborhood and business associations in writing no later than 30 days prior to FILING this request. List the alderperson, neighborhood association(s), business association(s), AND the dates you sent the notices:			
MULTIPLE MEETINGS & WORF, W/XIOGN & MECHBONHOOD GNOUP. LAST HOSET WAS 2/15/17. SUDER ESKRICH MILL SEND & LETTEN/EMAIL.	NG.		
Was 2/15/17. Side Eskrich will sent a Letter/EMAL.	_		
The alderperson and the Director of Planning & Community & Economic Development may reduce the 30-requirement or waive the pre-application notification requirement altogether. Evidence of the pre-application notification is required as part of the application materials. A copy of the notification letters or any corresponde granting a waiver is required as part of the application materials.	on		
The applicant attests that this form is accurately completed and all required materials are submitted:			
Name of applicant Paul Cutts Relationship to property Ancutater.	<u> </u>		
Authorizing signature of property owner 121 GREGG SHIMANSICI, New 12 Styleen O Mile, Lie 12	_		

LAND USE APPLICATION — CHECKLIST

LND-C

Use this checklist to prepare a complete Land Use Application that addresses the City's land use development project standards, requirements and review criteria. Pursuant to Section 28.181(4), MGO, no application is complete unless all required information is included and all application fees have been paid. The Zoning Administrator may reject an incomplete application.

City of Madison Planning Division 126 S. Hamilton St. P.O. Box 2985 Madison, WI 53701-2985 (608) 266-4635



Req.	Info	quired Submittal ormation	Contents	No. of Copies	√
X	Filin	ig Fee (\$ 950)	Refer to the Land Use Application Instructions and Fee Schedule. Make checks payable to City Treasurer.	1	
X	Land Use Application and completed Submittal Checklist		Form must include property owner's authorization.	1	
X	X Letter of Intent		Narrative description of the proposal in detail, including, but not limited to, the existing site conditions, project schedule, phasing plan, proposed uses, hours of operation, number of employees, gross square footage, number of units and bedrooms, public subsidy requested, project team, etc.	32	
X	Lega	l Description	Legal description of the property, complete with the proposed zoning districts and project site area in square feet and acres.	2	
alex.	Pre-Application Notification		Proof of written 30-day notification to alder, neighborhood association, and business associations.	1	
X	Vicinity Map		Indicate site and adjacent streets.	32	
X	Survey or Existing Conditions Site Plan		Shows existing property boundaries and site conditions, including easements and encumbrances of record. Completion by a registered land surveyor may be required.	2	
Supplemental Requirements (Based on Application Type)			Additional materials may be required for: demolition permit; lakefront development; outdoor eating areas; development adjacent to parks; development within downtown core and urban mixed-use districts; modifications to parking requirements; Planned Development; and master plan applications. Refer to Supplemental Requirements_form.	Include in Plan Set as required	
X	Development Plans		Thirty-two (32)-11" x 17" legible copies; and One (1), 24" x 36" copy of the plan set are required.	33	
	X	Site Plan	See reverse side for specific sheet requirements.		
	X	Grading Plan	See reverse side for specific sheet requirements.		
	X	Utility Plan	See reverse side for specific sheet requirements.		
	X	Landscape Plan and Landscape Worksheet	See reverse side for specific sheet requirements.		
	> Building Elevations		See reverse side for specific sheet requirements.		***************************************
	★ Roof and Floor Plans		See reverse side for specific sheet requirements. Parking Later.		
		Fire Access Plan and Fire Access Worksheet	See reverse side for specific sheet requirements.		
		Supplemental Development Plan Requirements	As determined by staff through the Pre-application process. Land Use Application Checklist		

Note: Not all development plan materials listed are required for all applications. Submittal materials are as determined by staff.

For electronic submittals, one copy of each item listed above and indexed accordingly, in PDF file format, is required. All development plan set sheets must be scalable to full- and half-size sheets.



Kevin Firchow
City of Madison– Department of Planning
Department of Planning and Economic Development
215 Martin Luther King Jr. Blvd., Suite LL100
Madison, WI 53703

4/13/16 11/21/16 2/22/17 4/19/17

Re Planning Commission Submittal – Letter of Intent Sixteen O Three Monroe– c/o Gregg Shimanski Development

Dear Kevin and Committee Members,

Sixteen O Three Monroe

Action Requested

Major Alteration to Approved Demolition & Conditional Use to Add an Auto Bank Window Below the building in TSS Zoning.

Introduction

1603 Monroe Street is a new, mixed-use building with an approved conditional use located on the corner of Monroe Street and Oakland Street. The building combines the properties at 1603/1605 & 1609 Monroe Street. The new building is a mixed-use building comprised of one level of structured parking, first floor commercial space, and 44 rental housing units on levels one though four. The parking level is partially exposed along Oakland Street and the Alley. Parking access is immediately off of Oakland Street and provides 10 public-use/shared-use parking stalls immediate upon entry. An additional 23 vehicle parking stalls, 12 moped parking stalls and 44 bicycle spaces are provided for secured residential parking. The first floor commercial space fronts Monroe Street with a modulated, arcade that step together with the floor slab as the site drops from West to East to help improve the pedestrian experience and active zone as one moves along the face of the building. The commercial level is delineated by the expansive use of clear glazed storefront capped with a recessive signage band and belt course of hook-strap metal panel. A longtime Financial Institution on Monroe Street, is interested in relocating to the commercial space located at the corner of Monroe and Oakland Streets. As part of this relocation, they require the ability to provide drive-up banking to their clients. We are proposing a design that can provide a single autobanking lane below the first floor of the new building and will be totally enclosed. This will result in the business going from it's current three auto banking/drive-up lanes to just one lane with two machines and a pull out option - one (1) ITM and one (1) ATM. The resulting traffic flow allows for a one-way flow, entering directly off of Oakland for all users, including residents, public parking and drive-up window. Egress from the structure is also "one-way" and on the Alley immediately South of the new building. The proposed design was reviewed with City of Madison Traffic Engineering in an initial meeting with Eric Halvorson which resulted in implementation of specific design considerations including angled parking in the one-way section, a narrower drive lane to discourage counter flow and narrower entry and exit doors to also help alleviate the potential for counter flow traffic. Additional design considerations were added after meeting with the neighborhood and Alder. These included physical measures and



signage to try to reinforce and assure a left turn only at the egress point into the alley ROW. The project has also requested and received a combined parking reduction and shared parking consideration, which we feel is highly appropriate given the location of the new building at the confluence of multiple modes of transportation.

Zoning

The TSS zoning for this site allows now allows for the introduction of drive-up / teller windows below or within the building enclosure as an approved Conditional Use.

Project Team

Owner Architect Contractor

Sixteen O Three, LLC CāS₄ Architecture, LLC

Krupp

Gregg Shimanski

Paul Cuta

Aaron Gundlach

Existing Conditions

See attached Photos

Proposed Uses

Commercial Parking & Storage

5,353 16,053

Net Square Feet **Gross Square Feet**

Residential & General Use

39,965

Gross Square Feet

Hours of Operation

Typical hours of operation are:

Commercial 7:30 am - 6:00 pm

Monday - Friday

Residential 24/7

Building Square Footage

61,371 Gross Square Feet

Number of Dwelling Units

Forty Four (44)

18 - Studios

4 - Convertible/One Bedroom Units

10 - One Bedroom Units

12 - Two Bedroom Units

Auto & Bike Parking Stalls

Bicycle Parking

51

Moped Parking

12

Auto Parking

(33 Total)

Accessible

0

Van Accessible

2

Non-Accessible

31



Lot Coverage and Usable Open Space:

Lot Size

16,786 sf

Pervious Area:

 Landscape
 153 SF

 Green Roof
 2,578 SF

 Total
 2,731 SF

Proposed ISR

83.7%

Residential Balconies & Terraces

2,785 SF

Value of Land

\$700,000 - \$900,00

Estimated Project Cost

\$8,800,000 (\$7,000,000 construction cost)

Number of Construction & Full-Time Equivalent Jobs Created

Commercial Space

12

FTE's

Construction Jobs

15-30

FTE's

Public Subsidy Requested

None.

Paul M. Cuta, AIA

Partner

PMC/mds

Attachments:

Copied File

1603 Monroe Street

1603 - 16011 Monroe Street, Madison, WI 53711

Plan Commission - Major Alteration for Adding Auto Bank



03 S. Paterson Street, Ste. 1 Madison, Wi 53703

Structural Engineering

Civil Engineering

Landscape Architectu

1603 Monroe

1603-1611 Monroe Street Madison, WI 53703

Project #: 15002.00

Cond. of Approval Response NOT FOR CONSTRUCTION

	r reminiary contractor det	2-20-201
2	Plan Commission Submittal	4-13-201
3	Preliminary Pricing Set	6-28-201
4	Pian Commission Resubmittal - Major Alteration	11-21-20
5	Response to Cond. Use Conditions of Approval	02-8-201
6	Pian Commission Resubmittal - Major Alteration (Drive Thru)	2-22-201
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Drawn by: CaS4 Architecture Checked by: CaS4 Architecture

Title Sheet

PROJECT LOCATION MAP

PROJECT

G001 5

		Landscape		tectural	
2801	Surveying & Engineering International Lane, Ste. 101 on, WI 53704	303 S.	aiki Design Paterson Street, Ste. 1 on, WI 53703	303 S.	rchitecture, LLC Paterson Street, Ste. 1 n, WI 53703
ph 6	08-280-9266	ph 60	08-251-3600	ph 60	8-709-1250
C100 C200 C300 C400 C500	Existing Conditions Site Plan Grading & Erosion Control Plan Utility Plan Details & Notes	L100 L102	Site Planting Plan Details & Plant Schedules	G001 A100 A101 A200 A201	Title Sheet Level P1 Floor Plan Level L1 Floor Plan Exterior Elevations Exterior Elevations

PROJECT INFORMATION

Olio Alca. 10,700 al

Building Footprint: 15,870 a

Parking and Storage (S-2)	16,053
Commercial and Core (A-2 an	d/or B) 5,353
Residential and Core (R-2)	39,965
BUILDING SUMMARY	
Building Type:	Apartment House
Occupancy Classification: R-	-2 over A-2, B and S-2
(3 hour separation	n at second floor line)
Construction Type:	Type 1A up to 2nd
	Level; VA above
Maximum Allowable Area:	36,000 gsf/floor
Maximum Allowable Stories:	4 over 2nd level
	separation
Total Occupancy Load:	
Residential (R-2)	200 occupants
(39,965 gsf / 200 gsf per occ.)
Commercial Space (A-2)	255 occupants
(3,817 nsf / 15 nsf per occ.)	
Business (B)	8 occupants
(1,436 gaf / 200 gaf per occ.)	
Parking (S-2)	81 occupants
(16,053 gsf / 200 gsf per occ.)
TOTAL	544 occupants

Level	Gross Square Fed
Level P1	15,87
Level 1 (Grade)	13,01
Level 2	10,86
Level 3	10,86
Level 4	10,76
TOTAL	61,37

TOTAL		01,571
ZONING (Cit	y of Madisor	1)
District	Traditiona	Shopping Street (TSS)
Setbacks:	No	ne Required for this site
Max. Lot Cov	erage:	85%
2,	578 sf Greer	Roof + 153 sf
Œ	Grade = 2,	731 / 16,786 sf = 83.7%
Maximum He	ight:	3 stories / 40 feet
Additional He	eight:	
All	owed with C	onditional Use Approval
Usable Open	Space:	None Required
Maximum Siz	:e;	
10,000	GSF for Ind	ividual Establishment
25,000	GSF for Mb	ked-Use/Multi-Tennat
Fycee	tina limite ell	owed with Conditional

PARKING COUNTS	
AUTOMOBILE PARKING	
Interior	
Residential - Rental	23
1 Handicap Stalls provided (4.3%)	
(2 Combined HC Stalls provided (6.1%)	
Public/Shared Use	10
1 Handicap Stalls provided (10.0%)	
Surface Parking	0
TOTAL ONSITE PARKING	33
MOPED PARKING	
Interior - Residential	10
Interior - Public Use	2
Exterior	0
TOTAL ONSITE PARKING	12
BIKE PARKING - REQUIRED	
44 Units (1/per 1 & 2 bedroom units)	44
Guests (44 units * .1 stalls/unit)	4
Commercial (1 per 2,000 sf)	3
TOTAL REQUIRED	51
BIKE PARKING - PROVIDED ONSITE	
Interior - Residential	44
Interior - Public Use	0
Exterior - Public Use	
TOTAL PROVIDED ONSITE	51

● 3/4" SOLID IRON ROD FOUND

@ 1" IRON PIPE FOUND UNLESS NOTED

X SET X CUT IN CONCRETE

O 3/4" X 18" SOLID IRON RE-ROD SET, WT. 1.50 lbs./ft.

SPOT ELEVATION

OVERHEAD LITHITY WAS

BURIED GAS LINE WATER MAIN

SANITARY SEWER

STORM SEWER

BURIED FIBER OPTIC

WATER VALVE

GAS WETER

AIR CONDITIONER UTILITY POLE

LIGHT POLE FIRE HYDRANT

--- SIGN

GUY WIRE

CLOTHES LINE POST STORM SEWER INLET

TELEPHONE MANHOLE

STORM SEWER MANHOLE

ROUND CATCH BASIN STORM SEWER STRUCTUR

RECTANGLE CATCH BASIN

SANITARY SEWER MANHOLE

OECIDUOUS TREE

CONIFEROUS TREE

() INDICATES RECORDED AS PER PLAT

[] INDICATES RECORDED AS PER PLAT OF SURVEY

| | INOXCATES RECORDED AS PER RECORD DEED

PARKING METER


BOLLARD ... WOOD FENCE

... EXISTING CONTOUR MAJOR

EXISTING CONTOUR MINOR

DISTANCES ARE MEASURED TO THE NEAREST HUNDREDTH OF A FOOT. BUILDINGS ARE MEASURED TO THE NEAREST TENTH OF A FOOT

ALL OF LOTS 1 AND 2 AND PART OF LOT 3, BLOCK 2, OAKLAND HEIGHTS AS RECORDED IN VOLUME 1 OF PLATS, ON PAGE 30, AS DOCUMENT NUMBER 211232, DANE COUNTY REGISTRY, LOCATED IN THE NORTHWEST QUARTER OF THE SOUTHEAST QUARTER OF SECTION 22, TOWNSHIP 07 NORTH, RANGE 09 EAST, CITY OF MADISON, DANE COUNTY, WISCONSIN.

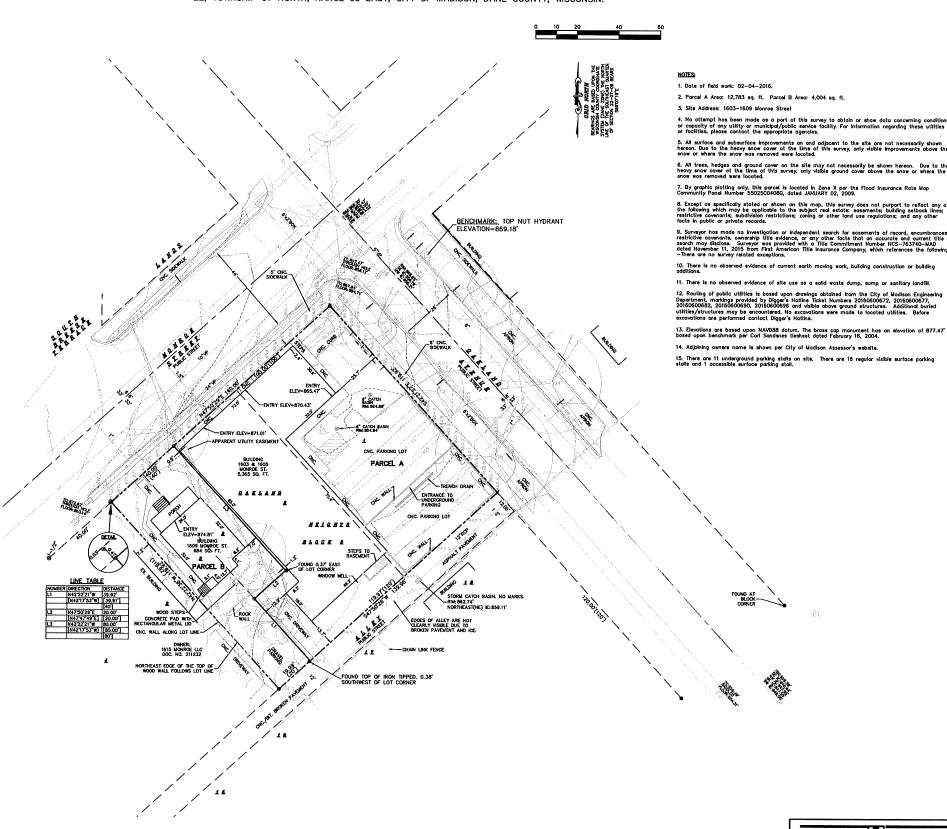



303 S. Paterson Street, Ste. 1 Madison, WI 53703 ph 608-709-1250

Structural Engineering:

Civil Engineering:



Landscape Architecture:

Sixteen O Three Monroe

1603-1611 Monroe Street Madison, WI 53703

Project #: 15002.00

Permit & Construction

Issued for:


No.	Description	Date
1	Preliminary Contractor Set	02-26-201
2	Plan Commission Submittal	04-13-201
3	Preliminary Pricing Set	06-28-201
4	Plan Commission Resubmittal - Major Alteration	11-21-201
5	Response to Cond. Use Conditions of Approval	02-06-201
6	Final Check Set	03-15-201
7	Footings, Foundation, Precast & Framing Bidding	03-16-201
8	Permit & Construction	04-14-201


Drawn by: BSEI Checked by: CaS4 Architecture


Existing Conditions

Dial [31] or (800) 242-8511 www.DiggersHotline.com

124:378.81 NE 12:007.07 Se 12:007.11

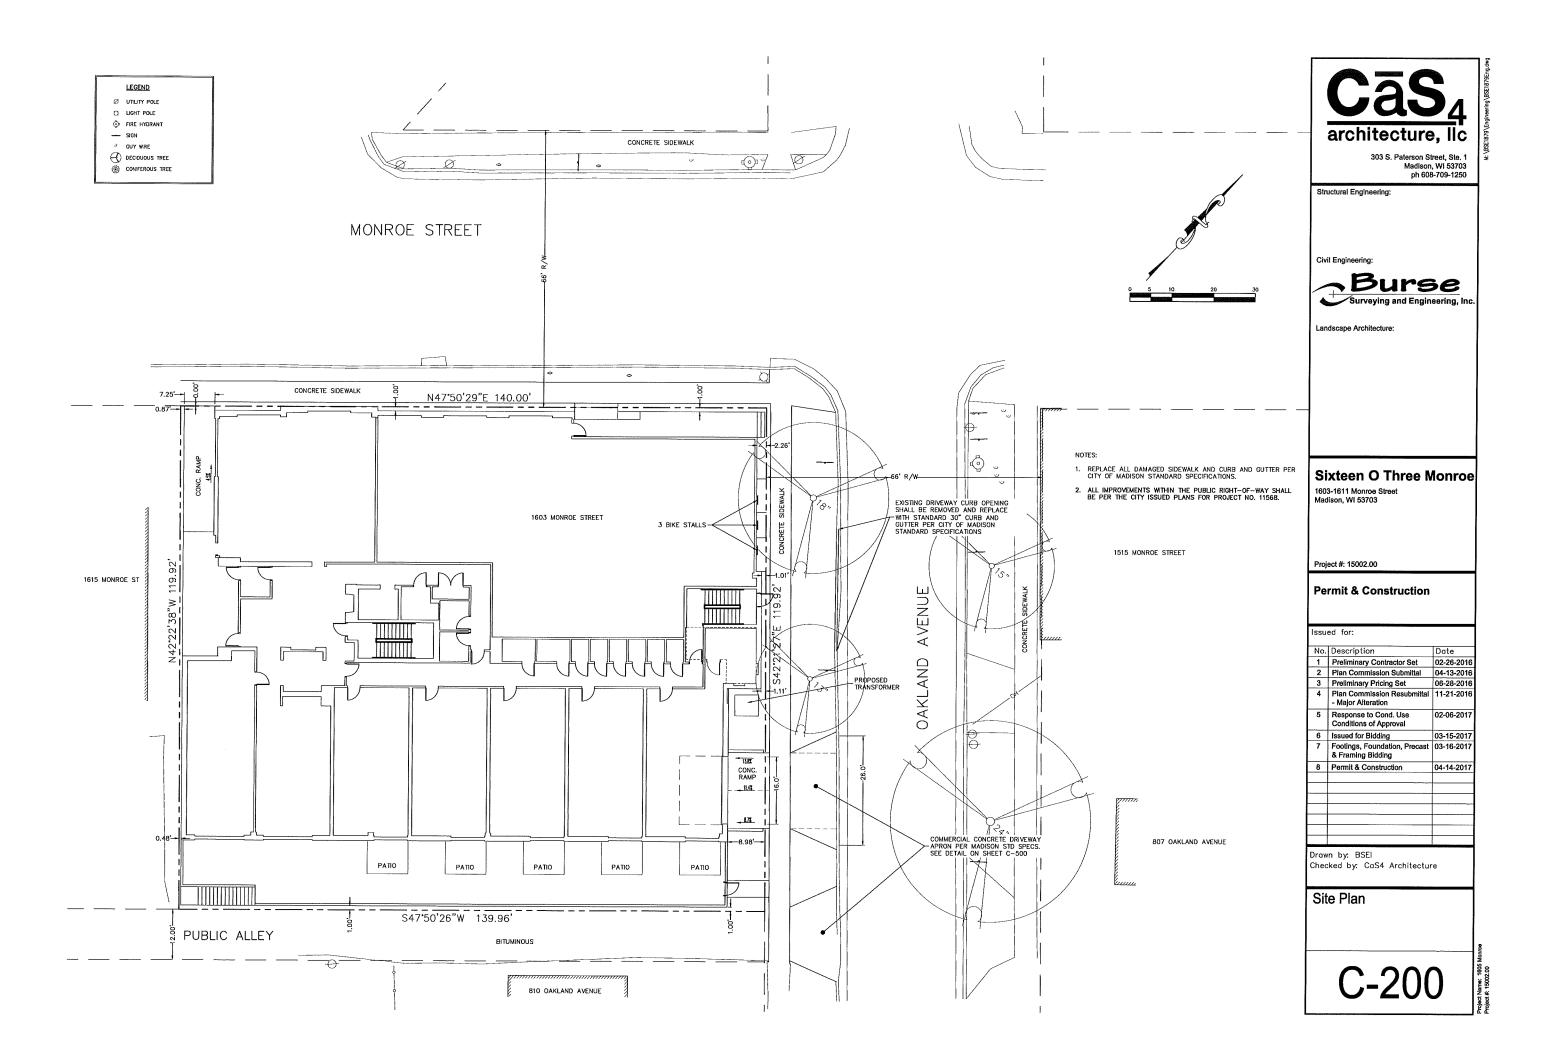

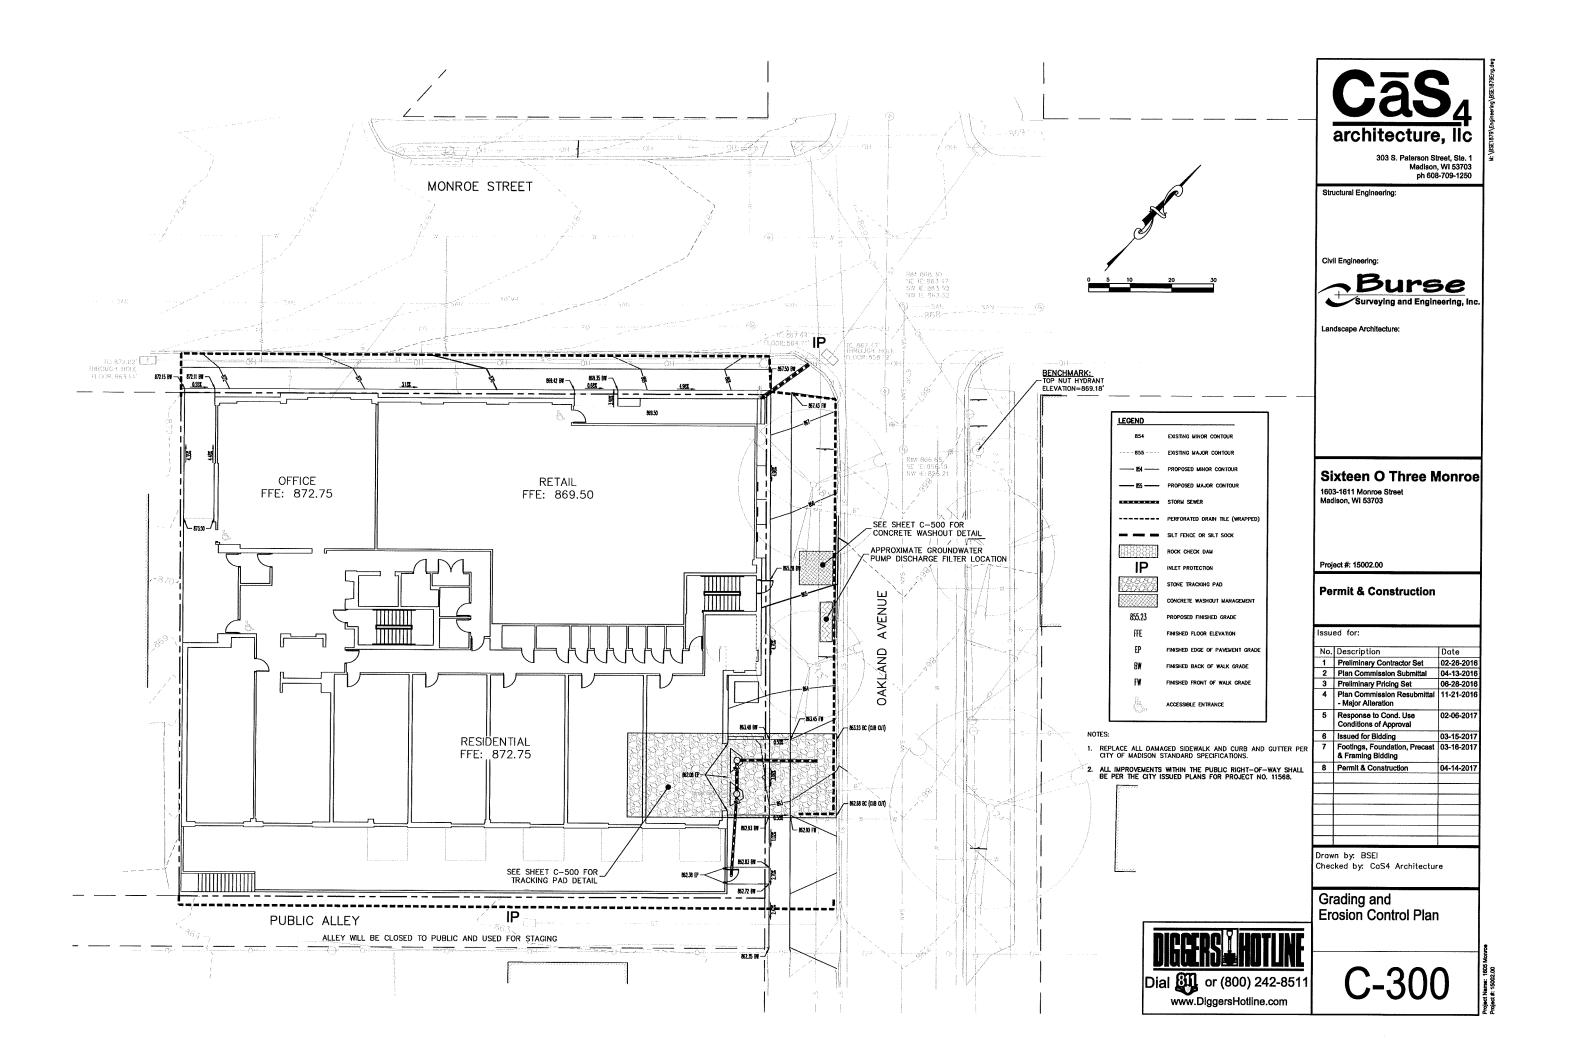

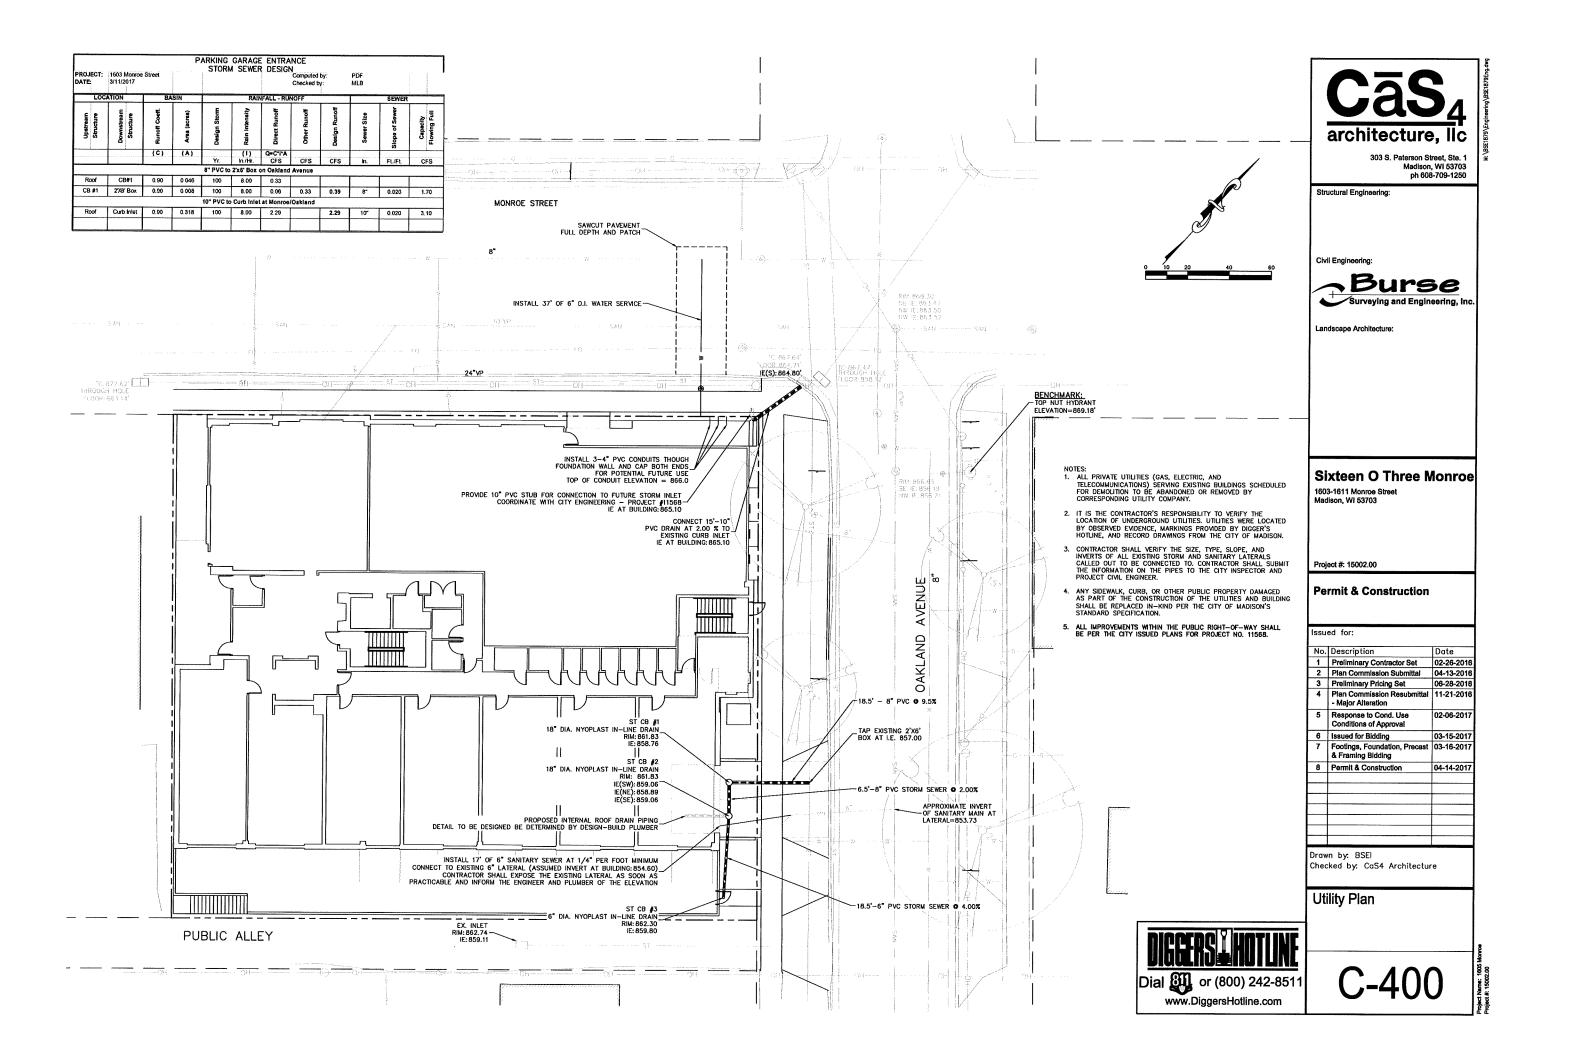

Erosion Control Notes/Specifications:

- Erosion control devices and/or structures shall be installed prior to demolition operations. These shall be properly maintained for maximum effectiveness until the site is completely stabilized.
- 2. Erosion control is the responsibility of the contractor until acceptance of this project. Erosion control measures as shown shall be the minimum precautions that will be allowed. The contractor shall be responsible for recognizing and correcting all erosion control problems that are the result of construction activities. Additional erosion control measures, as requested in writing by the state or local inspectors, or the developer's engineer, shall be installed within 24 hours.
- All erosion control measures and structures serving the site must be inspected at least weekly or within 24 hours of the time 0.5 inches of rain is produced. All maintenance will follow an inspection within 24 hours. Inspection schedule and record keeping shall comply with NR 216.46(9), Wis. Adm. Code.
- Construction Entrances Provide a stone tracking pad at each point of access. Install according to WDNR Standard 1057.
- 5. Dewatering Water pumped from the site shall be treated by using a geotextile bewatering — water pumper from the site stall be freated by using a geotextile bag. Sandy soil is expected to be found at the bottom of the excavation, therefore Geotextile Bags shall be Type I per DNR Technical Standard 1061. The following table identifies the size a bag required for a given sized pump. This water shall be discharged in a manner that does not induce erosion of the site or

Pump Size (Max GPM)	Type I Bag Size (sq-ft)
50	25
100	50
150	75

- Storm Sewer Inlets Provide WDOT Type D "CatchAll" inlet protection or equivalent. Refer to WDOT Product Acceptability List at: http://www.dot.wisconsin.gov/business/engrserv/pol.htm. Inlet protection shall be installed prior to the storm sewer system receiving site runoff. Other than for performing maintenance, these devices shall not be removed until site stabilization is complete.
- 9. Building and waste materials shall be prevented from running-off the site and entering waters of the state in conformance with NR151.12(6m).
- 10. No solid material shall be discharged or deposited into waters of the state in violation of Ch. 30 or 31 of the Wisconsin State Statutes or 33 USC 1344 permits.
- 11. Erosion control devices shall adhere to the technical standards found at: http://dnr.wi.gov/topic/stormwater/standards/const_standards.html and comply with all City of Madison ordinances.
- 12. All debris tracked onto public streets shall be be swept or scraped clean by the
- 13. All building and waste material shall be handled properly to prevent runoff of these materials off of the site. Contractor shall prepare a concrete management
- 14. All disturbed areas shall be seeded, sodded, or otherwise restored immediately after grading activities have been completed per the approved landscape plan.

Schedule:

April 15, 2017	Install perimeter erosion control items. Begin site demolition.
May 15, 2017	Begin foundation excavation/building construction.
April 1, 2018	Building and site work substantially complete.
May 1, 2018	Install/complete final restoration and landscaping.
July 1, 2018	Vegetation established.



YEAR 1


Soil Loss & Sediment Discharge Calculation Tool


for use on Construction Sites in the State of Wisconsin VDNR Official Version 1.0 (05-15-2015)




Project:	1603 Mor	901											
Date:	2/5/2017										-		
County:	Dane -										Version		
Activity	Begin Date	End Date	Perio d X R	Annual R Factor	Sub Soil Texture	Soil Erodibility K Factor	Slope (X)	Slope Length (feet)	LS Fact or		Soil loss A (tonslacre)		Disoha
Bare Ground -	4/15/2017	5/W2018	102.8%	150	Sandr Clar Loam -	0.37	4.0%	10	0.16	100	9.1	3-tt Fence	4.4
Seed with Malon or Er -	5/W2018	7/1/2018	30.0%	150	Standy Chy Loan	0.37	4.0%	10	0.16	0.10	0.3	Sit Pence	- 0.0
End -	7/W2018						4.0%	10	0.16				. 0.0
				_			4.0%	10	0.16	_			- 0.0
•							4.0%	0		_			- 0.0
				_			0.0%	0					- 0.0
										TOTAL	9.4	TOTAL	4.4
										DATES	EXCEED 1	% Reduction	MONE

8/7-8/23 Terl, introduced grasses and legume Native Grasses, forbs, and legumes

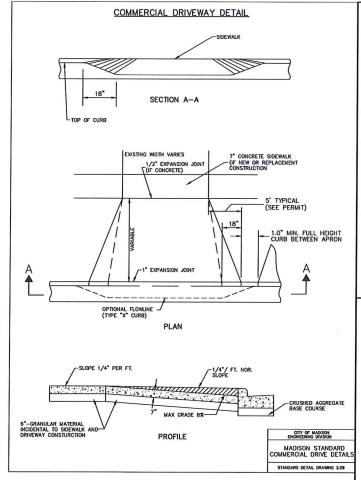

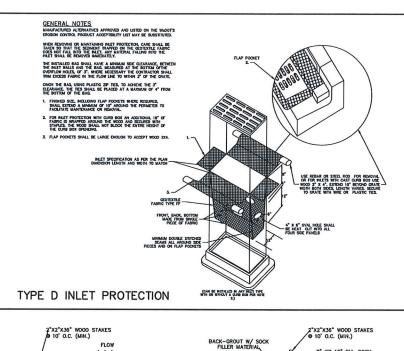

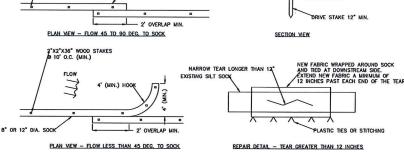

FLOW,

GENERAL NOTES.

1. SOCK MATERIAL PER STANDARD SPECIFICATIONS. SILT SOCK FILLER SHALL BE COMPOST OR WOOD CHIPS (2" MAX.)

2. WHEN SLT SOCK IS USED ON A PAYED SURFACE CONCRETE BLOCKS SHALL BE USED TO SECURE SILT SOCK IN PLACE
OF STANDIG


3. ACCUMULATED SEDIMENT SHALL BE REMOVED FROM BEHIND THE SILT SOCK WHEN IT HAS REACHED A HEIGHT EQUAL
TO HALF OF THE SOCK HEIGHT.


4. SMALL HOLES OR NARROW RIPS LESS THAN 12' LONG MAY BE STITCHED CLOSED USING PLASTIC ZIP TIES. LARGER
RIPS SHALL BE FIXED PER THE REPAIR DETAIL. HEAVILY DAMAGED SECTIONS SHALL BE REPLACED ENTIRELY. MAINTAIN 2'
MINIMUM OVERJA AT EACH END.


5. 8" OR 12" DIAMETER SOCK AS SPECIFIED IN THE EROSION CONTROL PLAN OR AS DIRECTED BY THE CONSTRUCTION
ENGINEER.

CITY OF MADISON ENGINEERING DIVISION

SILT SOCK NDARD DETAIL DRAWING 1.09

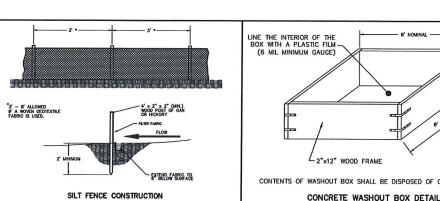

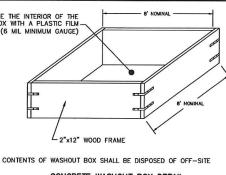

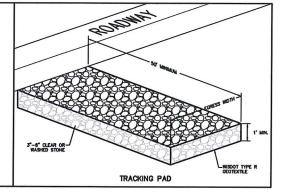



303 S. Paterson Street, Ste. 1 Madison, WI 53703 ph 608-709-1250

Structural Engineering:

Civil Engineering:



Landscape Architecture:

Sixteen O Three Monroe

1603-1611 Monroe Street

Project #: 15002.00


Permit & Construction

Issued for:

No.	Description	Date
1	Preliminary Contractor Set	02-26-20
2	Plan Commission Submittal	04-13-20
3	Preliminary Pricing Set	06-28-20
4	Plan Commission Resubmittal - Major Alteration	11-21-20
5	Response to Cond. Use Conditions of Approval	02-06-20
6	Issued for Bidding	03-15-20
7	Footings, Foundation, Precast & Framing Bidding	03-16-20
8	Permit & Construction	04-14-20

Drawn by: BSEI Checked by: CaS4 Architecture

Details & Notes

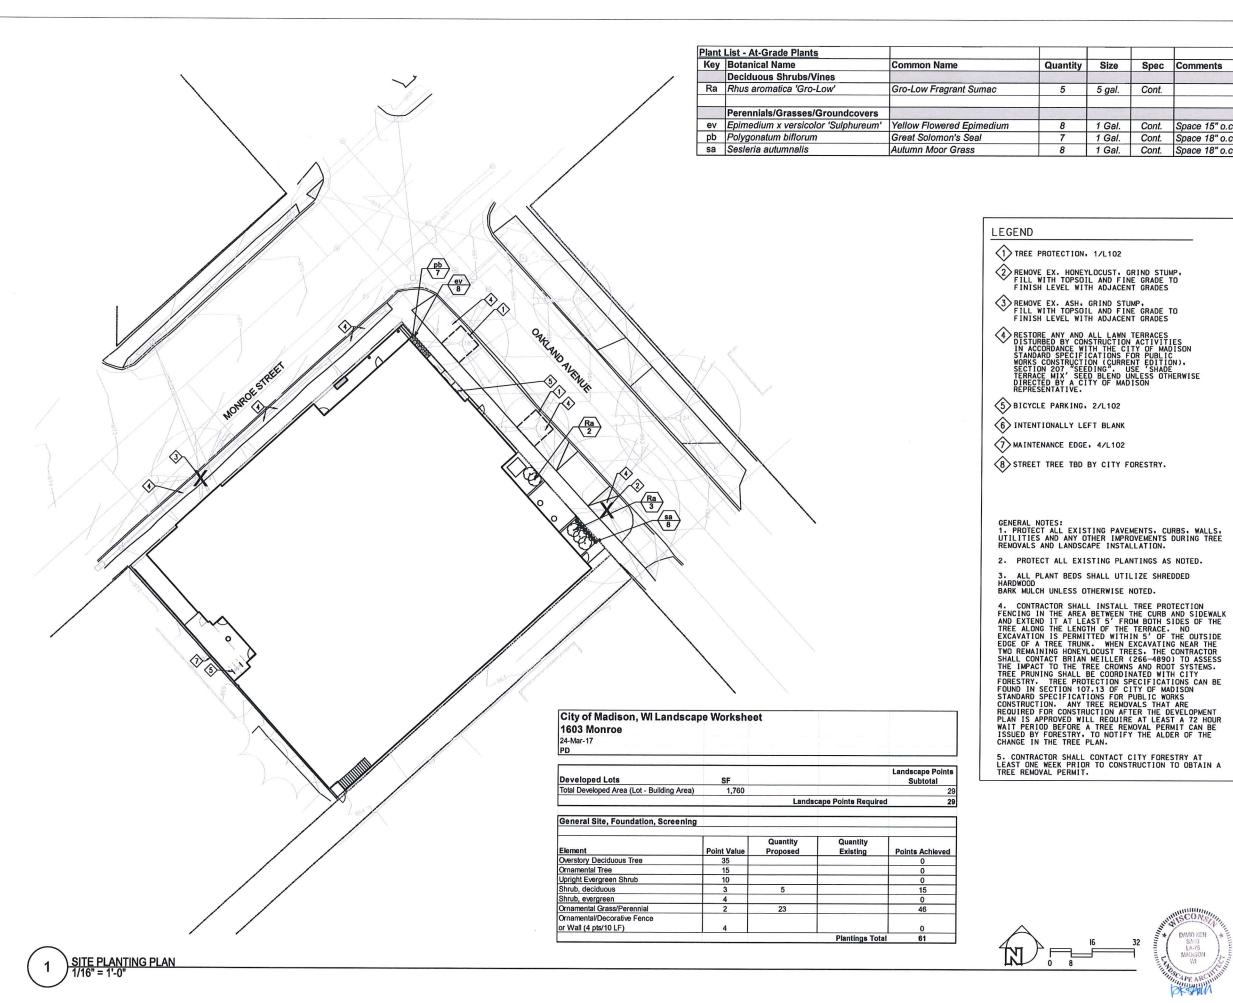



303 S. Paterson Street. Ste. 1 Madison, WI 53703 ph 608-709-1250

Structural Engineering:

Quantity

5

Size

5 gal.

1 Gal.

1 Gal.

1 Gal.

Spec

Cont.

Comments

Cont. Space 15" o.c.

Cont. Space 18" o.c.

Cont. Space 18" o.c.

Civil Engineering

KEN SAIKI DESI

Sixteen O Three Monroe

1603-1611 Monroe Street Madison, WI 53703


Project #: 15002.00

Permit & Construction

issue	ed for:	
No.	Description	Date
1	Preliminary Contractor Set	2-26-2016
2	Plan Commission Submittal	4-13-2016
3	Preliminary Pricing Set	6-28-2016
4	Plan Commission Resubmittal - Major Alteration	11-21-2010
5	Response to Cond. Use Conditions of Approval	02-6-2017
6	Final Check Set	3-15-2017
7	Footings, Foundation, Precast & Framing Bidding	3-16-2017
8	Permit & Construction	4-14-2017

Drawn by: CaS4 Architecture Checked by: CaS4 Architecture

Site Planting Plan

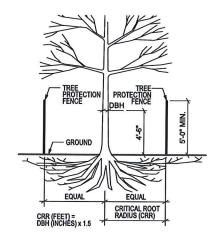

NOTES:


1. ALL TREES INDICATED TO BE RETAINED ON THE PLANS SHALL BE PROTECTED DURING CONSTRUCTION WITH FENCING CONFORMING TO THE CITY OF MADISON STANDARD SPECIFICATIONS FOR PUBLIC WORKS CONSTRUCTION (CURRENT EDITION), SECTION 107.13

2. TREE PROTECTION FENCES SHALL BE INSTALLED PRIDE TO THE COMMENCEMENT OF ANY SITE DEMOLITION OF PREPARATION WORK (CLEARING, GRUBBING, OR GRADING) AND SHALL BE MAINTAINED THROUGHOUT ALL PHASES OF THE CONSTRUCTION PROJECT. NO CONSTRUCTION MATERIALS, EQUIPMENT, OR THE CONSTRUCTION MATERIALS, EQUIPMENT, OR THE THE SMAY BE STORED IN THE TREE PROTECTION OF THE PROTECTION OF


3. PLACE PROTECTION FENCE AT THE BACK OF CURB AND EDGE OF SIDEWALK AND A MINIMUM OF 5-0° ON EITHER SIDE OF THE TRUNK WITHIN THE TERRACE, OR AS INDICATED BY A CITY OF MADISON REPRESENTATIVE.


5. PLACE TREE PROTECTION FENCE STAKES AT 5'-0" O.C. MAX.


1 TREE PROTECTION NOT TO SCALE

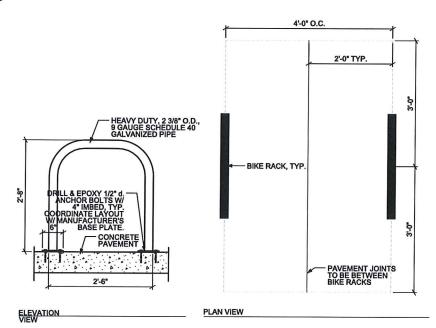

2 BICYCLE PARKING NOT TO SCALE

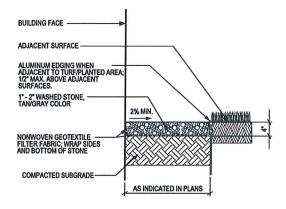

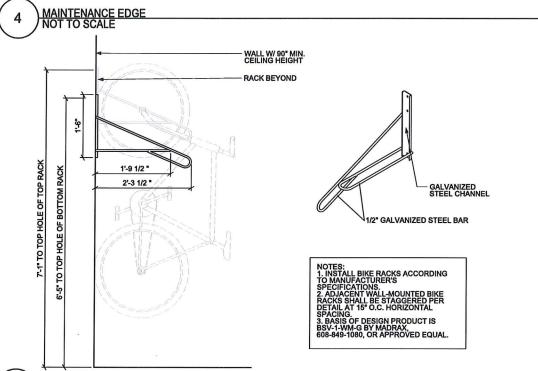

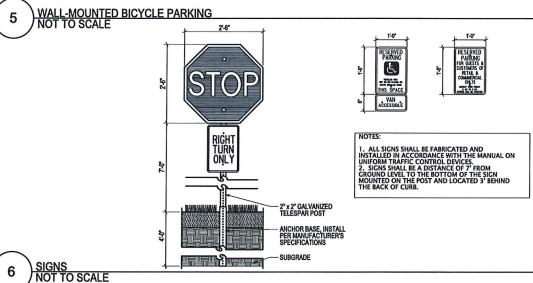

CaS₄

303 S. Paterson Street, Ste. 1 Madison, WI 53703 ph 608-709-1250

Structural Engineering:

Civil Engineering:

Landscape Architecture:

KEN SAIKI DESIGN

303 S. PATERSO S. U. I. T. E. O. N. MADISON, WI 5370

Sixteen O Three Monroe

1603-1611 Monroe Street Madison, WI 53703

Project #: 15002.00

Permit & Construction


	Issue	ed for:	
	No.	Description	Date
	1	Preliminary Contractor Set	2-26-2016
	2	Plan Commission Submittal	4-13-2016
	3	Preliminary Pricing Set	6-28-2016
	4	Plan Commission Resubmittal - Major Alteration	11-21-201
_	5	Response to Cond. Use Conditions of Approval	02-6-2017
	6	Final Check Set	3-15-2017
	7	Footings, Foundation, Precast & Framing Bidding	3-16-2017
	8	Permit & Construction	4-14-2017

Drawn by: CaS4 Architecture Checked by: CaS4 Architecture

Details and Plant Schedules

L102

3 INTENTIONALLY LEFT BLANK NOT TO SCALE oct Name: 1605 Monro

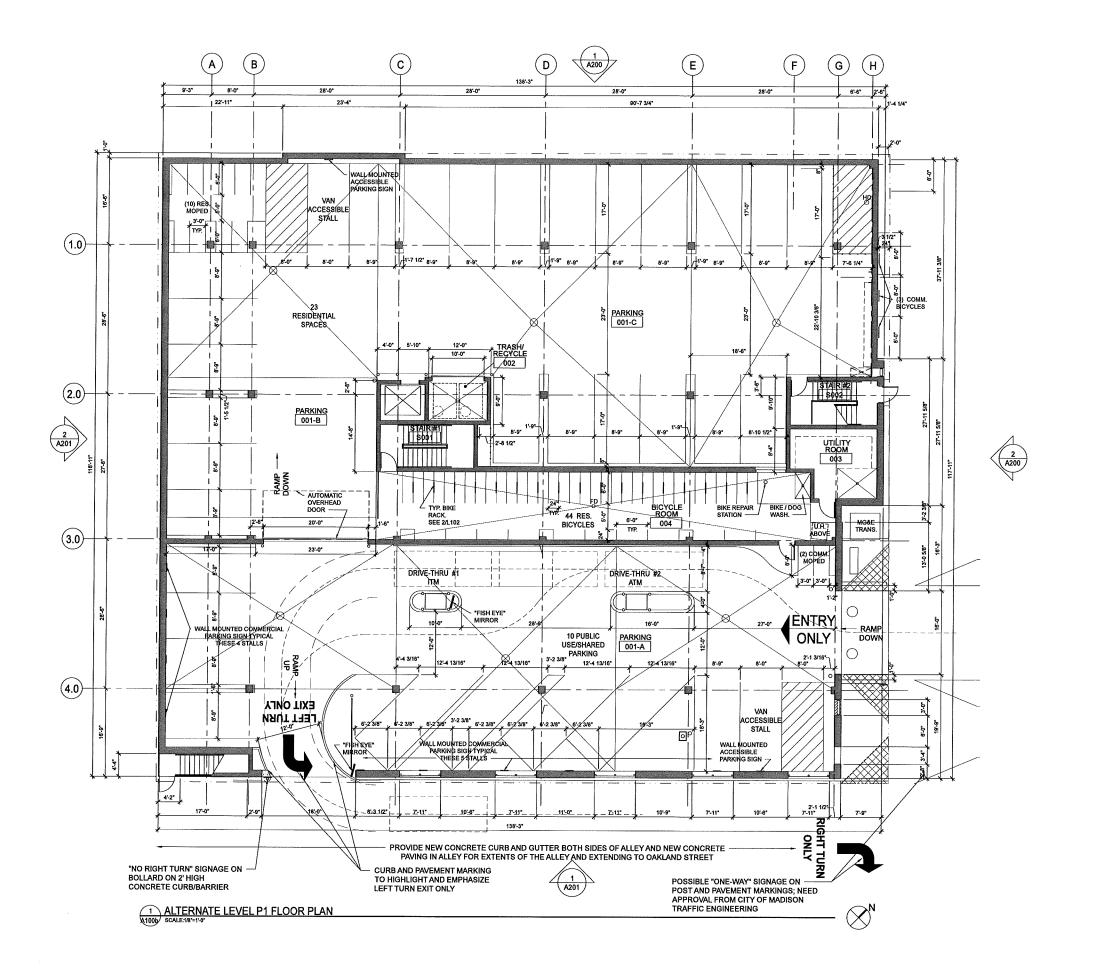



303 S. Paterson Street, Ste. 1 Madison, WI 53703 ph 608-709-1250

Structural Engineering:

Civil Engineering:

Landscape Architecture:

Sixteen O Three Monroe

1603-1611 Monroe Street Madison, WI 53703

Project #: 15002.00

Permit & Construction


No.	Description	Date
1	Preliminary Contractor Set	2-26-20
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3	Preliminary Pricing Set	6-28-20
4	Plan Commission Resubmittal - Major Alteration	11-21-20
5	Response to Cond. Use Conditions of Approval	02-6-20
6	Final Check Set	3-15-20
7	Footings, Foundation, Precast & Framing Bidding	3-16-20
8	Permit & Construction	4-14-20

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Level P1 Floor Plan Auto Bank Alternative

A100b

oject Name: 1605 Monroe



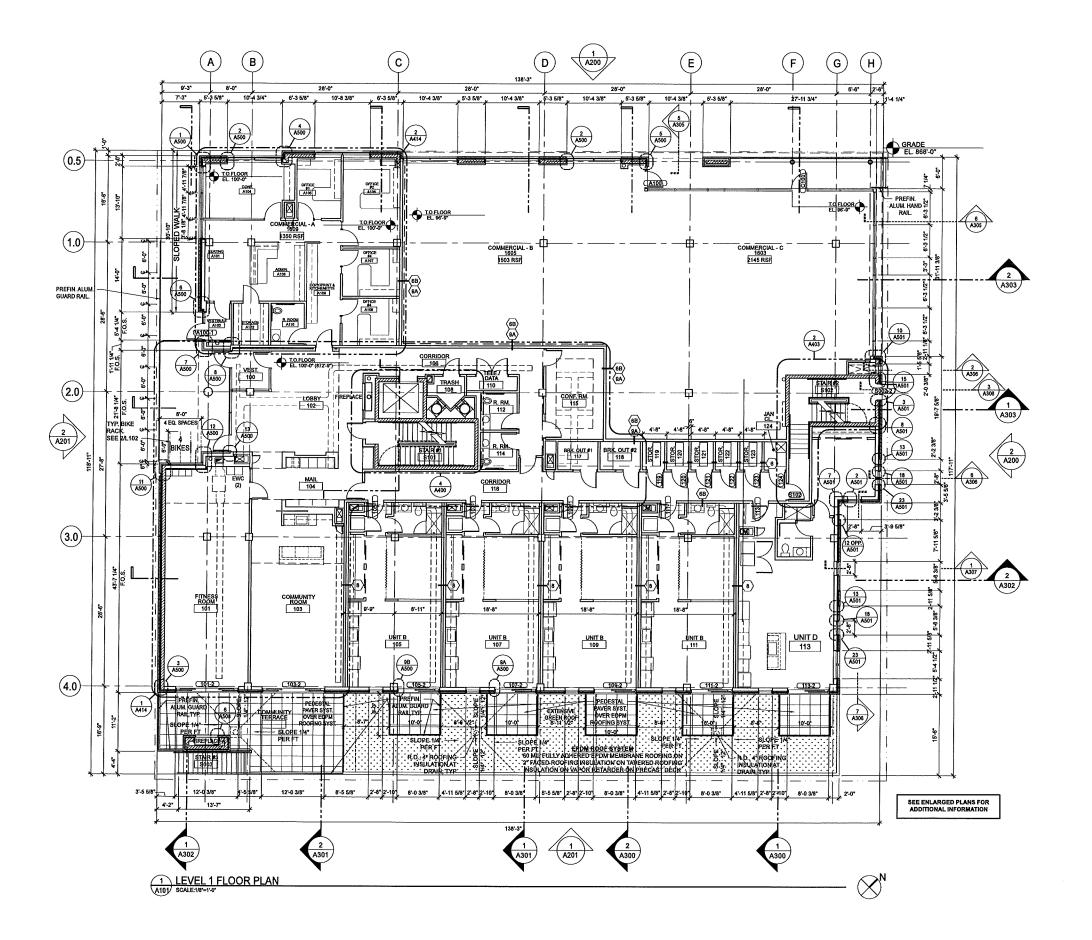

303 S. Paterson Street, Ste. 1 Madison, WI 53703 ph 608-709-1250

Structural Engineering:

Civil Engineering

Landscape Architecture:

Sixteen O Three Monroe

1603-1611 Monroe Street Madison, WI 53703

Project #: 15002.00

Permit & Construction


No.	Description	Date
1	Preliminary Contractor Set	2-26-2
2	Plan Commission Submittal	4-13-
3	Preliminary Pricing Set	6-28-2
4	Plan Commission Resubmittal - Major Alteration	11-21
5	Response to Cond. Use Conditions of Approval	02-6-2
6	Final Check Set	3-15-2
7	Footings, Foundation, Precast & Framing Bidding	3-16-2
8	Permit & Construction	4-14-2

Drawn by: CaS4 Architecture Checked by: CaS4 Architecture


Level 1 Floor Plan

A101

roject Name: 1805 Monroe

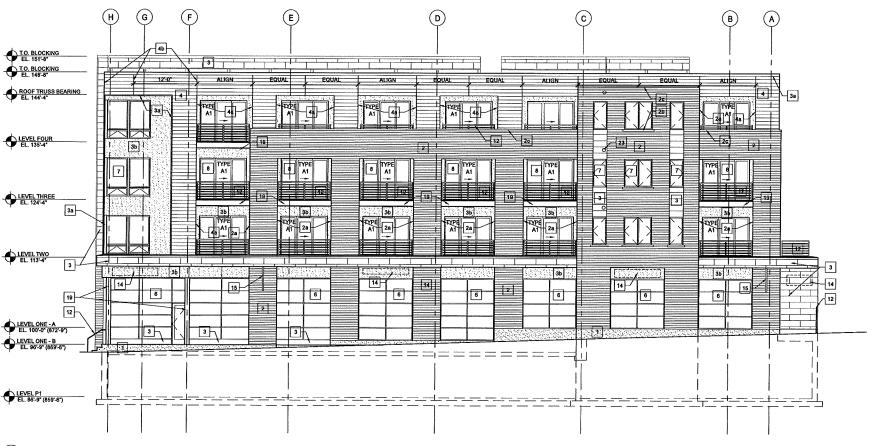


NORTH (MONROE STREET) ELEVATION

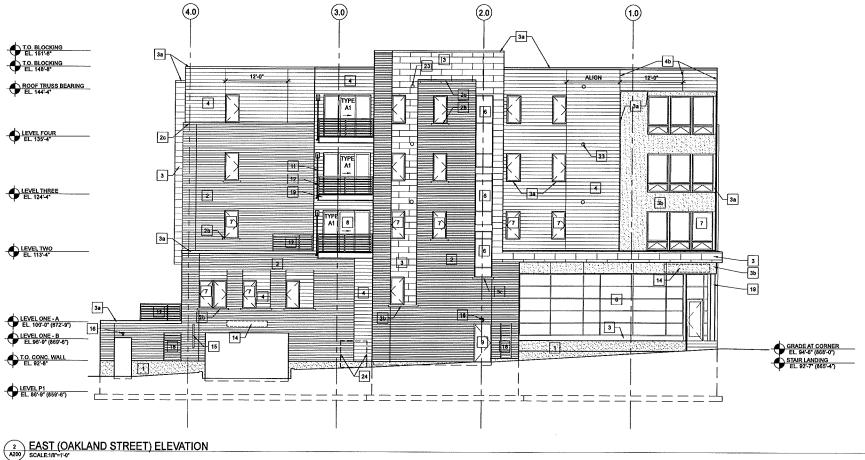

ELEVATION KEYNOTE LEGEND

- 1 SANDBLASTED CAST IN PLACE CONCRETE
- 2 BRICK VENEER
- 2a BRICK VENEER RETURNS AT BALCONY
- 2b CAST STONE SILL WAVASH & 4" LUG.
- 2c CAST STONE CAP.
- 3 HOOK & STRAP FLAT SEAM METAL PANEL
- 3a PRE-FINISHED METAL COPING, SILL & CAP.
- 3b EXTERIOR PLASTER SYSTEM.
- 4 COMPOSITE LAP SIDING 8" EXPOSURE
- COMPOSITE LAP SIDING RETURNS AT BALCONY
- 4b PREFINISHED METAL / ALUMINUM CORNER & BUTT TRIM COLOR TO MATCH SIDING. SEE DETAILS 16/A500 & 17/A500.
- 5 TONGUE AND GROOVE WOOD SIDING
- 6 ALUMINUM STOREFRONT SYSTEM WITH CLEAR INSULATED GLAZING
- 7 VINYL WINDOWS WITH CLEAR INSULATED GLAZING
- 8 VINYL SLIDING PATIO DOORS WITH CLEAR INSULATED GLAZING
- 9 INSULATED HOLLOW METAL DOOR AND FRAME; PAINTED.
- 10 ALUMINUM WINDOW FRAME WITH INSULATED TRANSLUCENT GLAZING
- 11 GALVANIZED STEEL BALCONY SUPPORTS
- 12 PREFINISHED ALUMINUM RAILING SYSTEM
- ALUMINUM FRAMED GARAGE DOOR WITH INSULATED TRANSLUCENT GLAZING
- 14 SIGNAGE BAND LOCATION W/POWER
- 15 BLADE SIGNAGE
- 16 EXTERIOR LIGHTING TYPE CC
- 16a EXTERIOR LIGHTING TYPE DD
- ALUMINUM LOUVER TO MATCH ALUMINUM STOREFRONT SYSTEM
- 18 ALUMINUM LOUVER FINISHED TO MATCH ADJACENT WALL FINISH
- 19 GALVANIZED STEEL STRUCTURE
- VINYL COATED METAL MESH SCREEN WALL/GUARD & SECURE GATE
- 21 PAINTED MIRA-TEC TRIM BOARD
- HEAT-N-GLOW LANAI GAS FIREPLACE w/ 1/2* STN. STEEL PLATE FRAME & HEARTH.
- 23 PREFINISHED HVAC VENT.
- 24 MG&E TRANSFORMER LOCATION

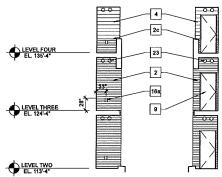

3 TYPICAL PORCH SIDE WALL ELEVATION
A200 SCALE:1/8"=1'-0"

architecture, Ilc

303 S. Paterson Street, Ste. 1 Madison, WI 53703 ph 608-709-1250

Structural Engineering:

Civil Engineering:

Landscape Architecture

Sixteen O Three Monroe

1603-1611 Monroe Street Madison, WI 53703

Project #: 15002.00

Permit & Construction

Issued for: No. Description

110.	Description	Date
1	Preliminary Contractor Set	2-26-2016
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8	Permit & Construction	4-14-2017


Drawn by: CaS4 Architecture Checked by: CaS4 Architecture

BUILDING ELEVATIONS (Alternate for Drive-Thru)






WEST ELEVATION
A201) SCALE:1/8°=1'-0"

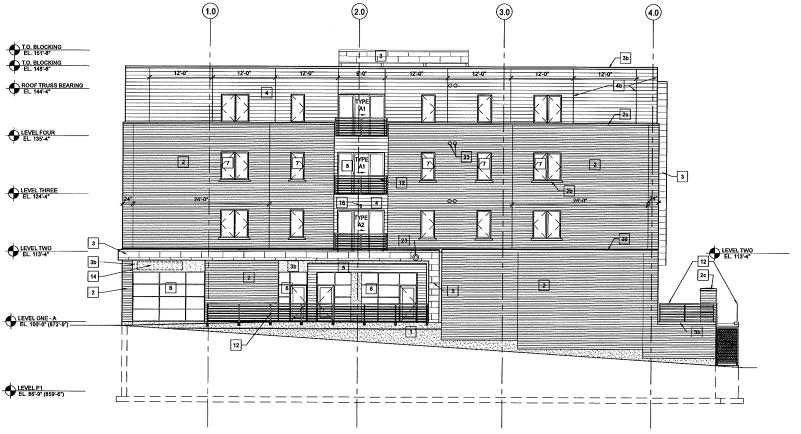

ELEVATION KEYNOTE LEGEND

- 1 SANDBLASTED CAST IN PLACE CONCRETE
- 2 BRICK VENEER
- 2a BRICK VENEER RETURNS AT BALCONY
- 2b CAST STONE SILL w/WASH & 4" LUG.
- 2c CAST STONE CAP.
- 3 HOOK & STRAP FLAT SEAM METAL PANEL
- 3a PRE-FINISHED METAL COPING, SILL & CAP.
- 36 EXTERIOR PLASTER SYSTEM. 4 COMPOSITE LAP SIDING - 8" EXPOSURE
- COMPOSITE LAP SIDING RETURNS AT BALCONY
- 4b PREFINISHED METAL / ALUMINUM CORNER & BUTT TRIM COLOR TO MATCH SIDING. SEE DETAILS 16/A500 & 17/A500.
- 5 TONGUE AND GROOVE WOOD SIDING
- 6 ALUMINUM STOREFRONT SYSTEM WITH CLEAR INSULATED GLAZING
- 7 VINYL WINDOWS WITH CLEAR INSULATED GLAZING
- 8 VINYL SLIDING PATIO DOORS WITH CLEAR INSULATED GLAZING
- 9 INSULATED HOLLOW METAL DOOR AND FRAME; PAINTED.
- 10 ALUMINUM WINDOW FRAME WITH INSULATED TRANSLUCENT GLAZING
- 11 GALVANIZED STEEL BALCONY SUPPORTS
- 12 PREFINISHED ALUMINUM RAILING SYSTEM
- 13 ALUMINUM FRAMED GARAGE DOOR WITH INSULATED TRANSLUCENT GLAZING
- 14 SIGNAGE BAND LOCATION W/POWER
- 15 BLADE SIGNAGE
- 16 EXTERIOR LIGHTING TYPE CC
- 16a EXTERIOR LIGHTING TYPE DD
- ALUMINUM LOUVER TO MATCH ALUMINU STOREFRONT SYSTEM
- 18 ALUMINUM LOUVER FINISHED TO MATCH ADJACENT WALL FINISH
- 19 GALVANIZED STEEL STRUCTURE
- VINYL COATED METAL MESH SCREEN WALL/GUARD & SECURE GATE
- 21 PAINTED MIRA-TEC TRIM BOARD
- HEAT-N-GLOW LANAI GAS FIREPLACE W/ 1/2* STN. STEEL PLATE FRAME & HEARTH.
- 23 PREFINISHED HVAC VENT.
- 24 MG&E TRANSFORMER LOCATION

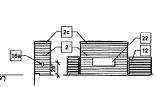

3 EXT. FIREPLACE ELEVATION
SCALE:1/8"=1'-0"

303 S. Paterson Street, Ste. 1 Madison, WI 53703 ph 608-709-1250

Structural Engineering:

Civil Engineering

Landscape Architecture:

Sixteen O Three Monroe

1603-1611 Monroe Street

Project #: 15002.00

Permit & Construction

No.	Description	Date
1	Preliminary Contractor Set	2-26-201
2	Plan Commission Submittal	4-13-201
3	Preliminary Pricing Set	6-28-201
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5	Response to Cond. Use Conditions of Approval	02-6-201
6	Final Check Set	3-15-201
7	Footings, Foundation, Precast & Framing Bidding	3-16-201
8	Permit & Construction	4-14-201

Drawn by: CaS4 Architecture Checked by: CaS4 Architecture

BUILDING ELEVATIONS (Alternate for Drive-Thru)

A201b