












VIEW FROM E. MAIN ST. LOOKING NORT

SITE PHOTOS

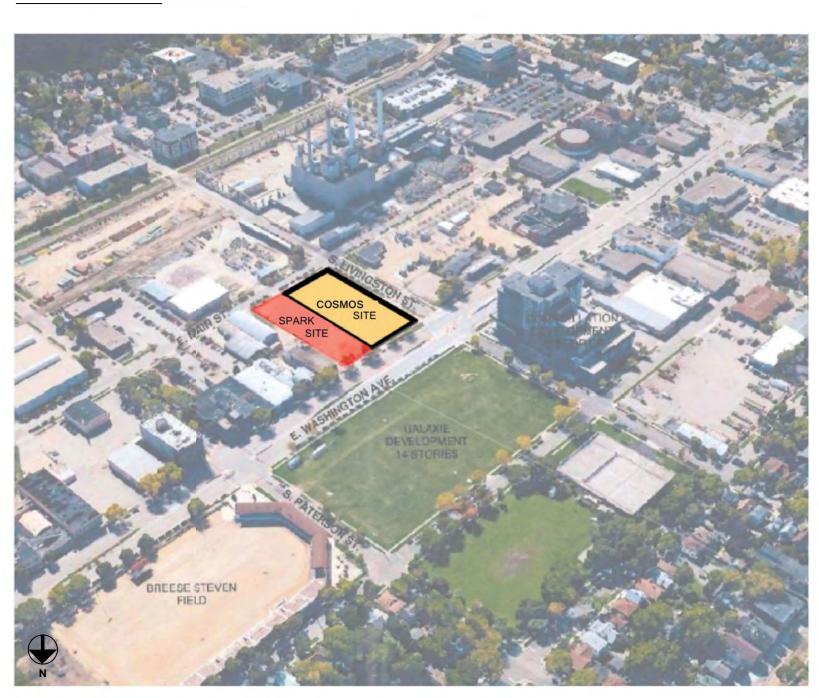




THE COSMOS PROJECT


SHEET INDEX T001 TITLE SHEET, SITE PHOTOS, SITE LOCATOR MAP C100 EXISTING CONDITIONS C200 SITE PLAN C300 GRADING PLAN C400 UTILITY PLAN C500 SCHEDULES L100 SITE PLAN RENDERING L101 LANDSCAPE PLAN L102 PLAZA DETAIL L103 LANDSCAPE DETAILS L104 SHARED PLAZA PLAN A201 FLOOR PLANS A202 FLOOR PLANS A203 FLOOR PLANS A401 EXTERIOR ELEVATIONS A402 EXTERIOR ELEVATIONS A501 RENDERINGS A502 RENDERINGS A503 RENDERINGS A504 RENDERINGS A601 LOT COVERAGE DIAGRAM A701 BONUS STORIES A702 BONUS STORIES E101 LIGHTING CALCS E201 LIGHTING CUT SHEETS E202 LIGHTING CUT SHEETS E203 LIGHTING CUT SHEETS E301 LIGHTING SIMULATIONS E302 LIGHTING SIMULATIONS

AERIAL PHOTO





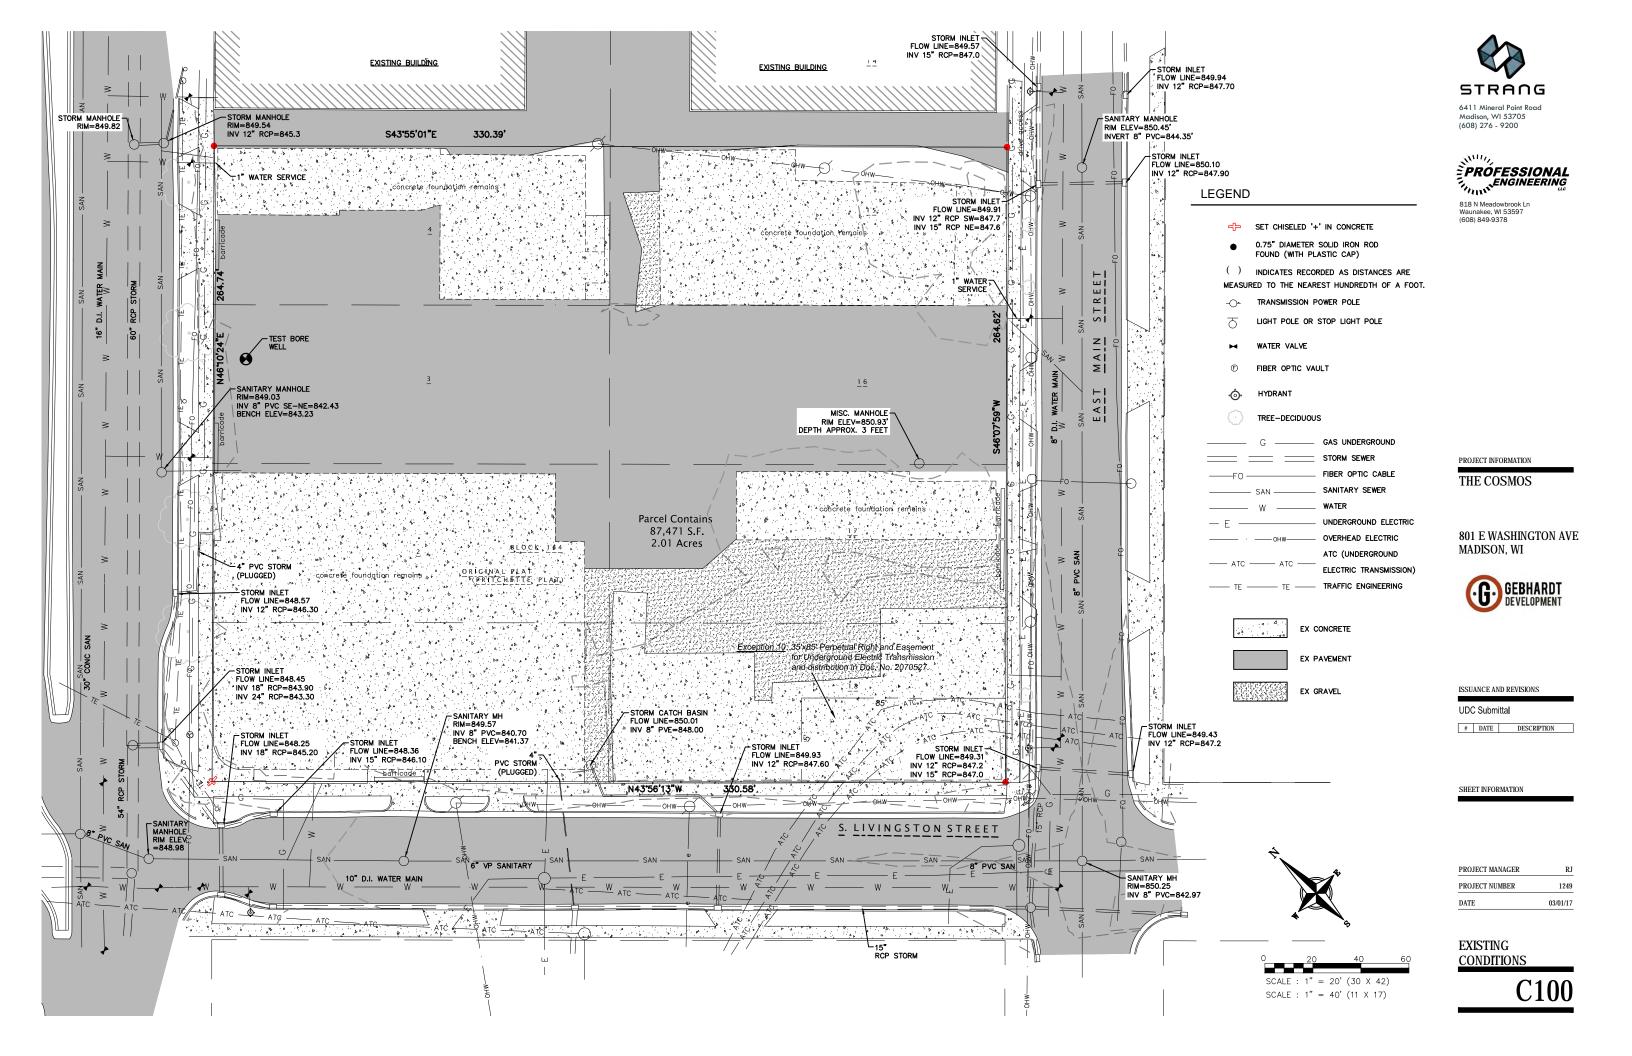

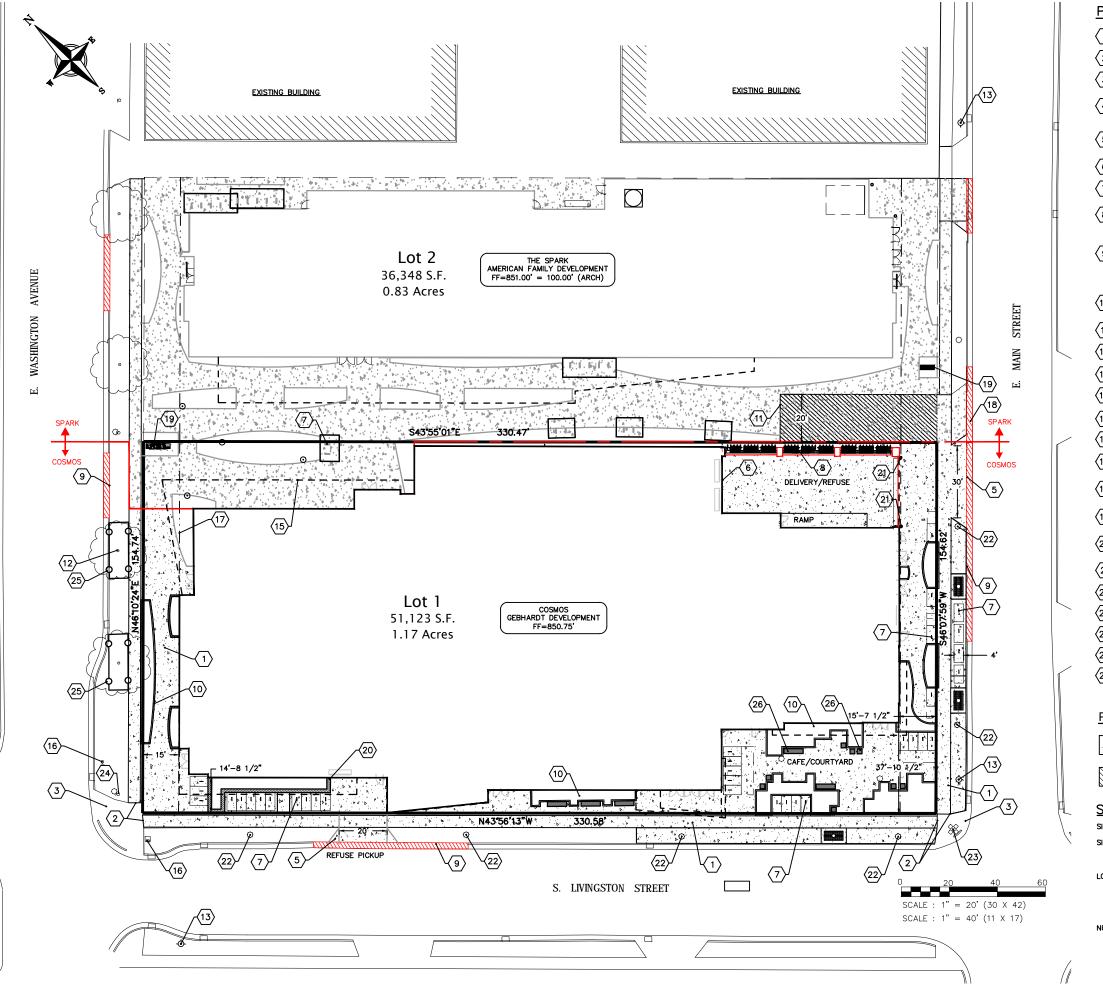

PLAN KEY

- 1 CONCRETE SIDEWALK, TYP.
- 2 MATCH EXISTING SIDEWALK, TYP.
- 3 EXISTING SIDEWALK TO REMAIN, TYP.
- 4 SIDEWALK TO BE 7" THICK IN FIRELANE SECTION
- NEW DRIVEWAY APPROACH SHALL BE IN ACCORDANCE WITH CITY STANDARDS
- 6 LOADING DOCK
- 7 BICYCLE RACK (58 TOTAL STALLS), TYP.
- igg(8) VERTICAL BICYCLE RACK (50 TOTAL STALLS), TYP.
- EXISTING DRIVEWAY TO BE ABANDONED 9 IN ACCORDANCE WITH CITY STANDARDS W/ CURB REPLACED & TERRACE RESTORED
- LANDSCAPE AREA, TYP.
 SEE LANDSCAPE PLANS
- 11 FIRE LANE
- 12 EX TREE, TYP.
- (13) EXISTING FIRE HYDRANT
- 14 PROPOSED LOT LINE
- $\langle 15 \rangle$ CANOPY/UPPER FLOOR OVERHANG, TYP.
- (16) EXISTING STOP LIGHT
- 17 15' BUILDING SETBACK
- ROLL CURB TO BE PROVIDED FOR FIRE
- 18 LANE ENTRANCE
- 19 MONUMENT SIGN
- LANDSCAPE PLANTER, SEE LANDSCAPE 20 PLAN
- 21 BOLLARD
- 22 PEDESTRIAN LIGHT (10' HIGH POLE)
- 23 STREET LIGHT (30' HIGH POLE)
- 24 EXISTING STREET LIGHT
- 25 TREE PROTECTION, TYP.
- 26 BENCH, TYP.

PAVEMENT KEY

CONCRETE



FIRE LANE

SITE INFORMATION

SITE ADDRESS: 801 EAST WASHINGTON AVENUE

SITE ACREAGE TOTAL: LOT 1: 51,123 SQ. FT. (1.17 ACRES) LOT 2: 36,348 SQ. FT. (0.83 ACRES)

LOT COVERAGE:

COVERAGE:

LOT 1: 43,454 SQ. FT. (85% IMPERVIOUS, INCLUDES VEGETATED ROOF)

LOT 2: 28,927 SQ. FT. (80% IMPERVIOUS, INCLUDES 3,140 SF VEGETATED ROOF)

NUMBER OF BIKE PARKING STALLS: LOT 1: 226 STALLS (58 TRADITIONAL, 50 VERTICAL, 60 INTERIOR, 8 IN RIGHT—OF—WAY, & 50 SHARED IN PLAZA AREA) 43 STALLS



6411 Mineral Point Road Madison, WI 53705 (608) 276 - 9200



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PROJECT INFORMATION

THE COSMOS

801 E WASHINGTON AVE MADISON, WI



ISSUANCE AND REVISIONS


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DATE DESCRIPTION

SHEET INFORMATION

PROJECT MANAGER PROJECT NUMBER 1249 DATE 03/01/17

SITE PLAN



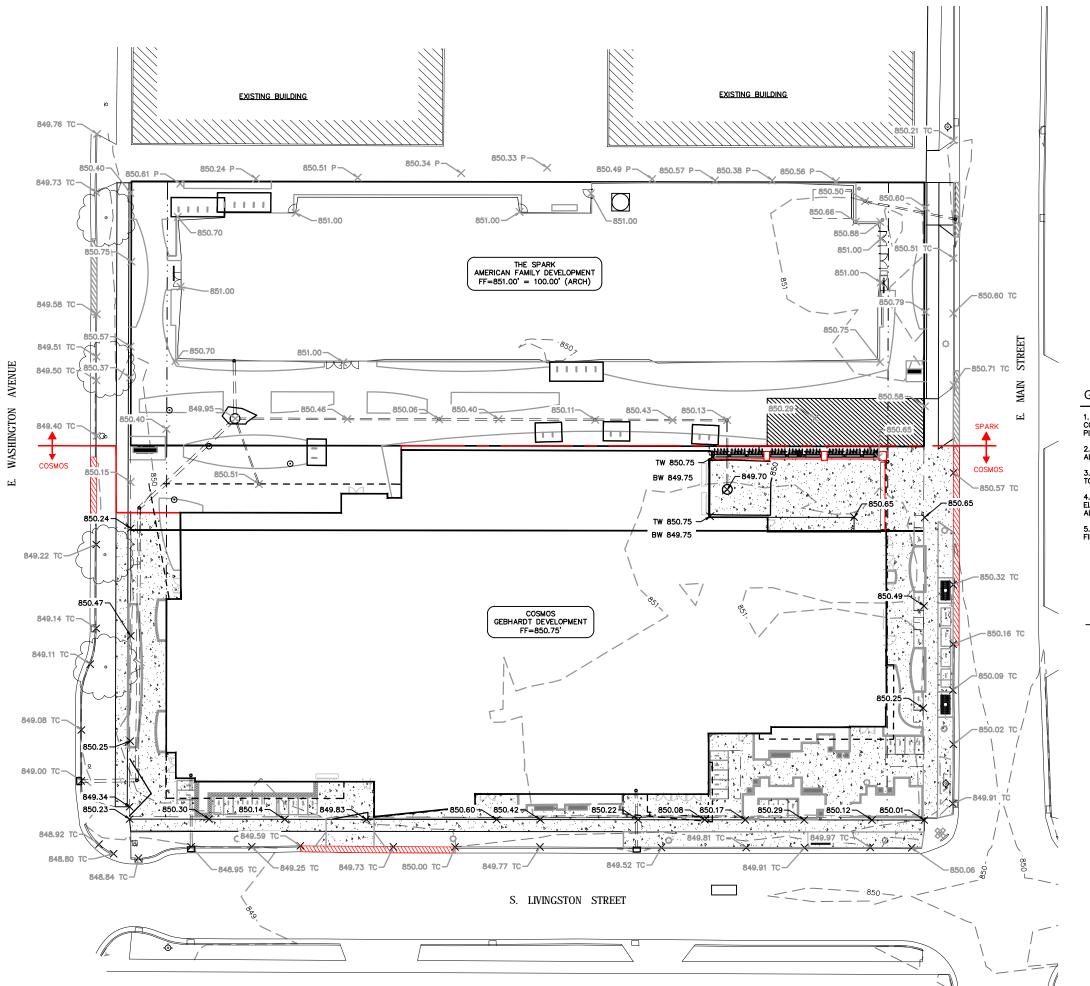

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GRADING NOTES

 ALL WORK IN THE RIGHT OF WAY SHALL BE CONSTRUCTED IN ACCORDANCE WITH THE CITY ISSUED PLANS.

2. ALL CONSTRUCTION TO BE IN ACCORDANCE WITH ALL CITY STANDARDS AND SPECIFICATIONS.

3. CONTRACTOR SHALL CALL DIGGERS HOTLINE PRIOR TO ANY CONSTRUCTION.

4. ALL MATCHING PAVEMENT AND STORM SEWER ELEVATIONS SHALL BE VERIFIED IN THE FIELD TO ALLOW FOR PROPER DRAINAGE.

5. CONTOUR AND SPOT ELEVATIONS SHOWN ARE FINISH GRADE ELEVATIONS.

PROJECT INFORMATION

THE COSMOS

801 E WASHINGTON AVE MADISON, WI



GRADING LEGEND

	EXISTING CONTOUR
	PROPOSED CONTOUR
× 800.00 TC	TOP OF CURB ELEVATION
× 800.00 TW	TOP OF RETAINING WALL ELEVATION

imes 800.00 BW BOTTOM OF RETAINING WALL ELEVATION

X 800.00 SPOT ELEVATION

ISSUANCE AND REVISIONS

UDO	Submi	ittal
#	DATE	DESCRIPTION

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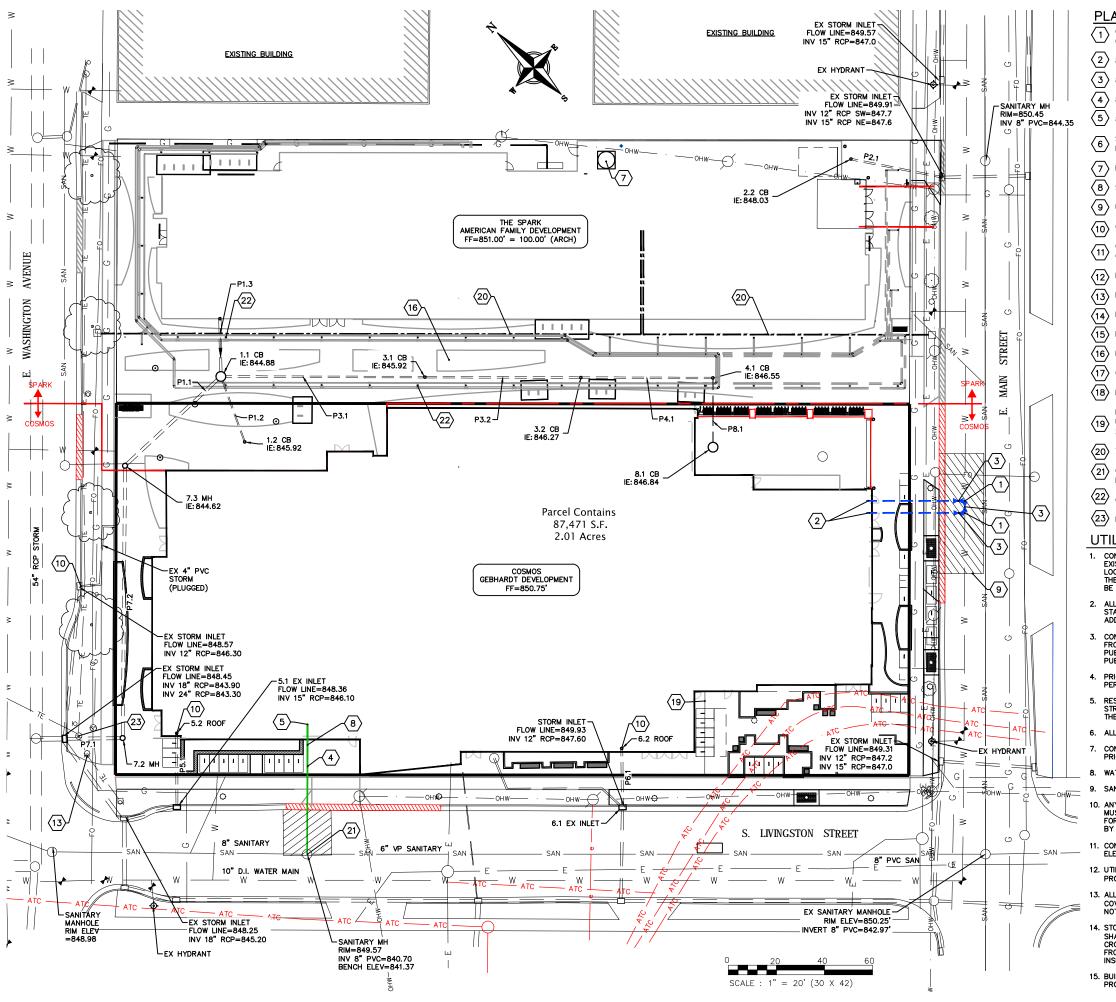


o	20	40		60
SCALE	1" —	20' (30 X	42)	

SCALE : $1" = 40' (11 \times 17)$

PROJECT MANAGER RJ
PROJECT NUMBER 1249
DATE 03/01/17

GRADING PLAN



PLAN KEY

- CONNECT TO EXISTING WATER MAIN WITH 8"X8"X8" CUT-IN TEE.
 COORDINATE INSTALLATION WITH MADISON WATER UTILITY
- 2 8" WATER SERVICE
- 3 8" VALVE
- 4 8" SANITARY LATERAL @ 0.52% MIN. SLOPE
- (5) 8" SANITARY INV=844.50'. EXTEND 5 FEET INTO BUILDING
- 7 RAINWATER HOLDING TANK
- 8 SEE PLUMBING PLANS FOR CLEAN OUT LOCATION
- 9 UTILITY PATCH PER CITY REQUIREMENTS
- $\langle \overline{10} \rangle$ connect to existing storm sewer inlet per city standards
- CONNECT TO ROOF DRAIN. COORDINATE WORK WITH PLUMBING CONTRACTOR.
- $\langle 12 \rangle$ EXISTING 1" WATER SERVICE TO BE ABANDONED
- (13) EXISTING LIGHT POLE
- (14) EXISTING OVERHEAD ELECTRICAL TO BE RELOCATED
- (15) EXISTING POWER POLE TO BE REMOVED
- (16) FOOTING CAP OR FOUNDATIONS
- (17) GAS SERVICE, COORDINATE LOCATION WITH MG&E
- (18) ELECTRIC SERVICE, COORDINATE LOCATION WITH MG&E
- EXCEPTION 10: 35'X85' PERPETUAL RIGHT AND EASEMENT FOR UNDERGROUND ELECTRIC TRANSMISSION AND DISTRIBUTION IN DOC. NO.
- $\langle 20 \rangle$ TELECOM 4" FIBER/COPPER CONDUIT, COORDINATE LOCATION WITH AT&T
- (21) CONNECT TO EX SANITARY MANHOLE PER CITY REQUIREMETNS, INVERT=841.40
- (22) GEO-EXCHANGE WELL, TYP
- 23 INSTALL STORM UNDER TRAFFIC ENGINEERING VAULT

UTILITY NOTES

- 1. CONTRACTOR SHALL CALL DIGGERS HOTLINE PRIOR TO ANY CONSTRUCTION. ALL EXISTING UTILITIES SHOWN ON THE PLAN ARE APPROXIMATE AND WERE FIELD LOCATED FROM GROUND MARKING OR BASED OFF OF CITY UTILITY RECORDS. THE LOCATIONS ARE SHOWN FOR INFORMATIONAL PURPOSES ONLY AND SHOULD BE FIELD VERIFIED PRIOR TO CONSTRUCTION.
- ALL SITE UTILITY WORK SHALL BE DONE IN ACCORDANCE WITH THE CITY STANDARD SPECIFICATIONS FOR PUBLIC WORKS CONSTRUCTION, LATEST ADDITION
- CONTRACTOR SHALL OBTAIN ALL NECESSARY PLUGGING/CONNECTION PERMITS FROM THE CITY PRIOR TO ANY UTILITY WORK. CONTRACTOR TO NOTIFY THE PUBLIC WORKS DEPARTMENT A MINIMUM OF 48 HOURS BEFORE CONNECTING TO PUBLIC UTILITIES.
- 4. PRIOR TO CONSTRUCTION, CONTRACTOR SHALL OBTAIN A STREET OPENING PERMIT FOR ANY WORK TO BE DONE WITHIN THE RIGHT-OF-WAY.
- RESTORATION OF PAVEMENT, CURB & GUTTER, AND SIDEWALK WITHIN THE STREET RIGHT OF WAY IS CONSIDERED INCIDENTAL AND SHALL BE INCLUDED IN THE COST OF THE UNDERGROUND IMPROVEMENTS.
- 6. ALL STORM SEWER PIPE TO BE SDR-35 PVC OR SCHEDULE 40 PVC AS NOTED.
- CONTRACTOR SHALL CONFIRM CONNECTION ELEVATION GRADES OF ALL PIPES PRIOR TO BEGINNING CONSTRUCTION.
- 8. WATER MAIN SHALL BE DUCTILE IRON, CLASS 52.
- . SANITARY SEWER SERVICES SHALL BE SDR-35 PVC.
- 10. ANY PERSON WHO INSTALLS A NONCONDUCTIVE WATER OR SEWER LATERAL MUST ALSO INSTALL A LOCATION WIRE OR OTHER EQUALLY EFFECTIVE MEANS FOR MARKING THE LOCATION OF THE LATERAL. METHOD SHALL BE APPROVED BY THE CITY.
- 11. CONTRACTOR TO COORDINATE NEW, RELOCATED AND/OR ABANDONED GAS, ELECTRIC, TELEPHONE, AND CABLE WITH APPROPRIATE UTILITY COMPANIES.
- UTILITIES SERVING PROPOSED BUILDINGS SHALL BE STUBBED INTO THE PROPOSED BUILDING(S) A MIN. OF 5' AND STAKED.
- 13. ALL WATER MAIN PIPE AND FITTINGS SHALL BE INSTALLED TO A MIN. DEPTH OF COVER OF 6.5'. AFTER REGRADING, EXISTING WATER MAIN PIPE WHICH DOES NOT MEET THIS REQUIREMENT SHALL BE INSULATED.
- 14. STORM SEWERS WHICH CROSS AN ACTIVE SEWER OR WATER MAIN OR LATERAL SHALL HAVE A MINIMUM CLEAR VERTICAL CLEARANCE OF THREE (3) FEET. CROSSINGS WITH LESSER VERTICAL CLEARANCE SHALL BE PROTECTED FROM FROST DAMAGE BY PLACEMENT OF 2-INCH THICK POLYSTYRENE BOARD INSULATION.
- 15. BUILDING PLUMBER SHALL VERIFY SIZE, SLOPE, AND EXACT LOCATION OF PROPOSED SANITARY LATERALS AND WATER SERVICES PRIOR TO INSTALLATION.



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PROJECT INFORMATION

THE COSMOS

801 E WASHINGTON AVE MADISON, WI



ISSUANCE AND REVISIONS

UDC Submittal

| DATE | DESCRIPTION

SHEET INFORMATION

 PROJECT MANAGER
 RJ

 PROJECT NUMBER
 1249

 DATE
 03/01/17

UTILITY PLAN

			STRU	CTURE TABLE		
	STRUCTURE NAME	SIZE	TOP OF CASTING	PIPES IN	PIPES OUT	CASTING
	1.1 CB	4' DIA. CB	849.96	P3.1, 8" INV IN =845.46 P1.3, 12" INV IN =844.88 P1.2, 6" INV IN =845.63	P1.1, 15" INV OUT =844.88	NEENAH R-2050
	1.2 CB	12" DIA YARD DRAIN	850.51		P1.2, 6" INV OUT =845.92	12" GRATE
	1.3 ROOF	CONNECT TO INTERIOR ROOF DRAIN	850.90		P1.3, 12" INV OUT =845.00	
	2.1 EX INLET		849.91	P2.1, 8" INV IN =847.80		
	2.2 CB	3' DIA. CB	850.50		P2.1, 8" INV OUT =848.03	NEENAH R-2050
	3.1 CB	12" DIA YARD DRAIN	850.06	P3.2, 8" INV IN =845.92	P3.1, 8" INV OUT =845.92	12" GRATE
	3.2 CB	12" DIA YARD DRAIN	850.11	P4.1, 8" INV IN =846.27	P3.2, 8" INV OUT =846.27	12" GRATE
ARK	4.1 CB	12" DIA YARD DRAIN	850.13	P8.1, 6" INV IN =846.55	P4.1, 8" INV OUT =846.55	12" GRATE
SMOS	5.1 EX INLET	CONNECT TO EX INLET	847.38	P5.1, 10" INV IN =846.50		
	5.2 ROOF	CONNECT TO INTERIOR ROOF DRAIN	850.75		P5.1, 10" INV OUT =846.80	
	6.1 EX INLET	CONNECT TO EX INLET	848.58	P6.1, 10" INV IN =847.70		
	6.2 ROOF	CONNECT TO INTERIOR ROOF DRAIN	850.75		P6.1, 10" INV OUT =847.82	
	7.1 EX INLET	CONNECT TO EX INLET	849.16	P7.1, 15" INV IN =843.90		
	7.2 MH	4' DIA. CB	849.87	P7.2, 15" INV IN =844.03	P7.1, 15" INV OUT =844.03	NEENAH R-1550
	7.3 MH	4' DIA. CB	850.30	P1.1, 15" INV IN =844.62	P7.2, 15" INV OUT =844.62	NEENAH R-1550
	8.1 CB	3' DIA. CB	849.70		P8.1, 6" INV OUT =846.84	NEENAH R-2050

			PIP	E TABLE			
NAME	SIZE	LENGTH	SLOPE	MATERIAL	START INVERT ELEVATION	END INVERT ELEVATION	
P1.1	15"	55'	0.48%	ADS N12	844.88'	844.62'	
P1.2	6"	30'	1.00%	ADS N12	845.92'	845.63'	
P1.3	12"	25'	0.50%	ADS N12	845.00'	844.88'	
P2.1	8"	39'	0.60%	ADS N12	848.03'	847.80'	
P3.1	8"	85'	0.54%	ADS N12	845.92'	845.46'	
P3.2	8"	65'	0.55%	ADS N12	846.27'	845.92'	SPARK
P4.1	8"	56'	0.51%	ADS N12	846.55'	846.27	<u> </u>
P5.1	10"	31'	0.98%	ADS N12	846.80'	846.50'	+
P6.1	10"	25'	0.50%	ADS N12	847.82'	847.70'	COSMOS
P7.1	15"	25'	0.52%	ADS N12	844.03'	843.90'	
P7.2	15"	114'	0.52%	ADS N12	844.62'	844.03'	
P8.1	6"	29'	0.99%	ADS N12	846.84'	846.55'	



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PROJECT INFORMATION

THE COSMOS

801 E WASHINGTON AVE MADISON, WI



ISSUANCE AND REVISIONS


UDC Submittal

DATE DESCRIPTION

SHEET INFORMATION

PROJECT MANAGER	R.I
PROJECT NUMBER	1249
DATE	03/01/17

SCHEDULES

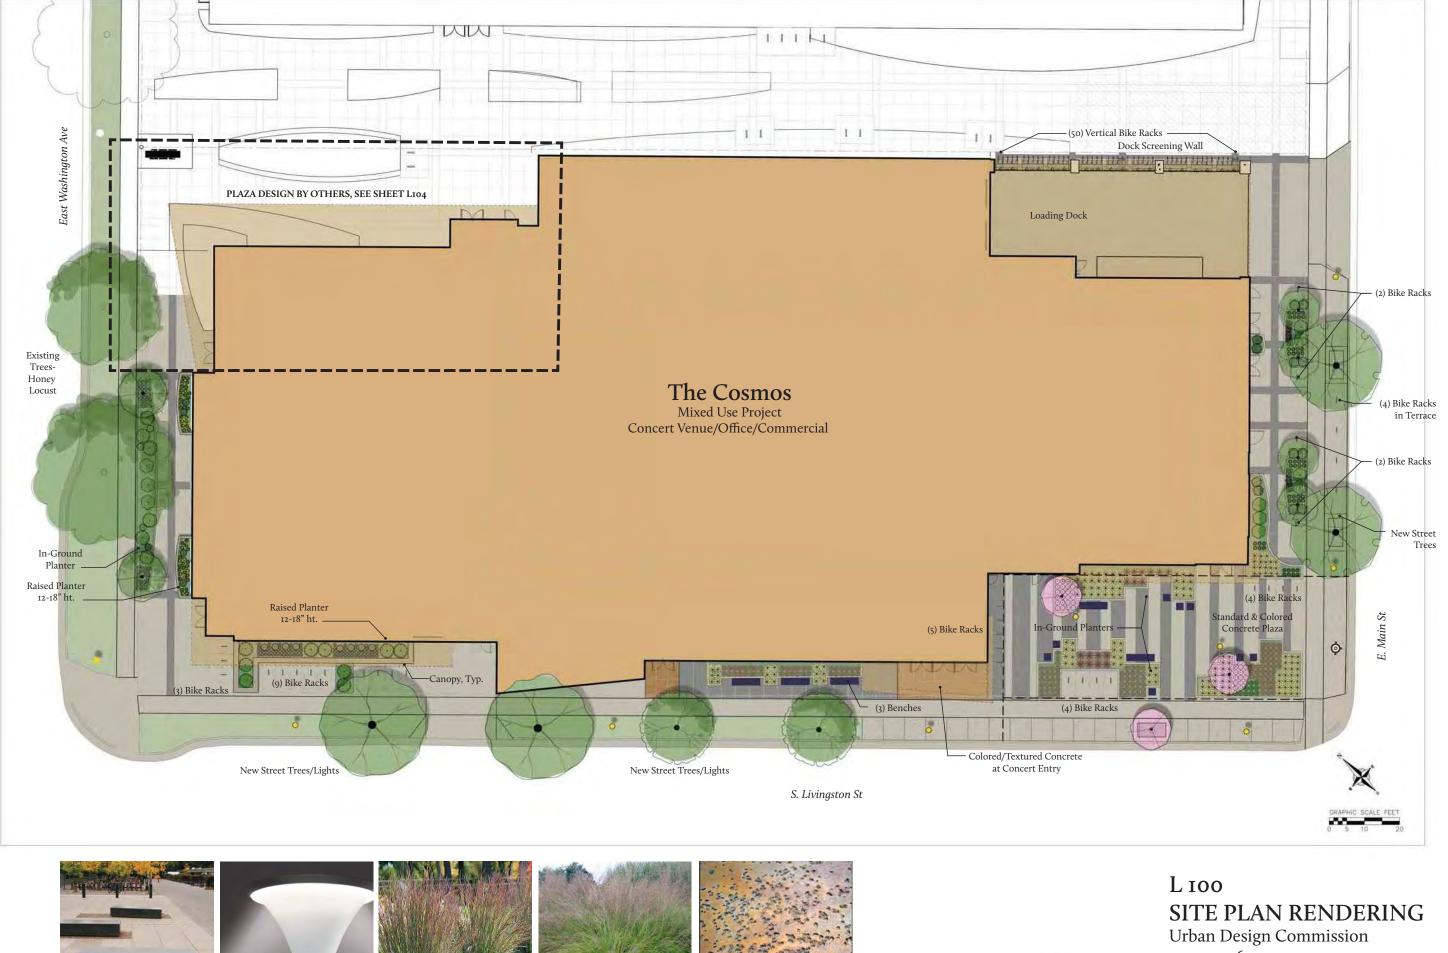












03.01.2016









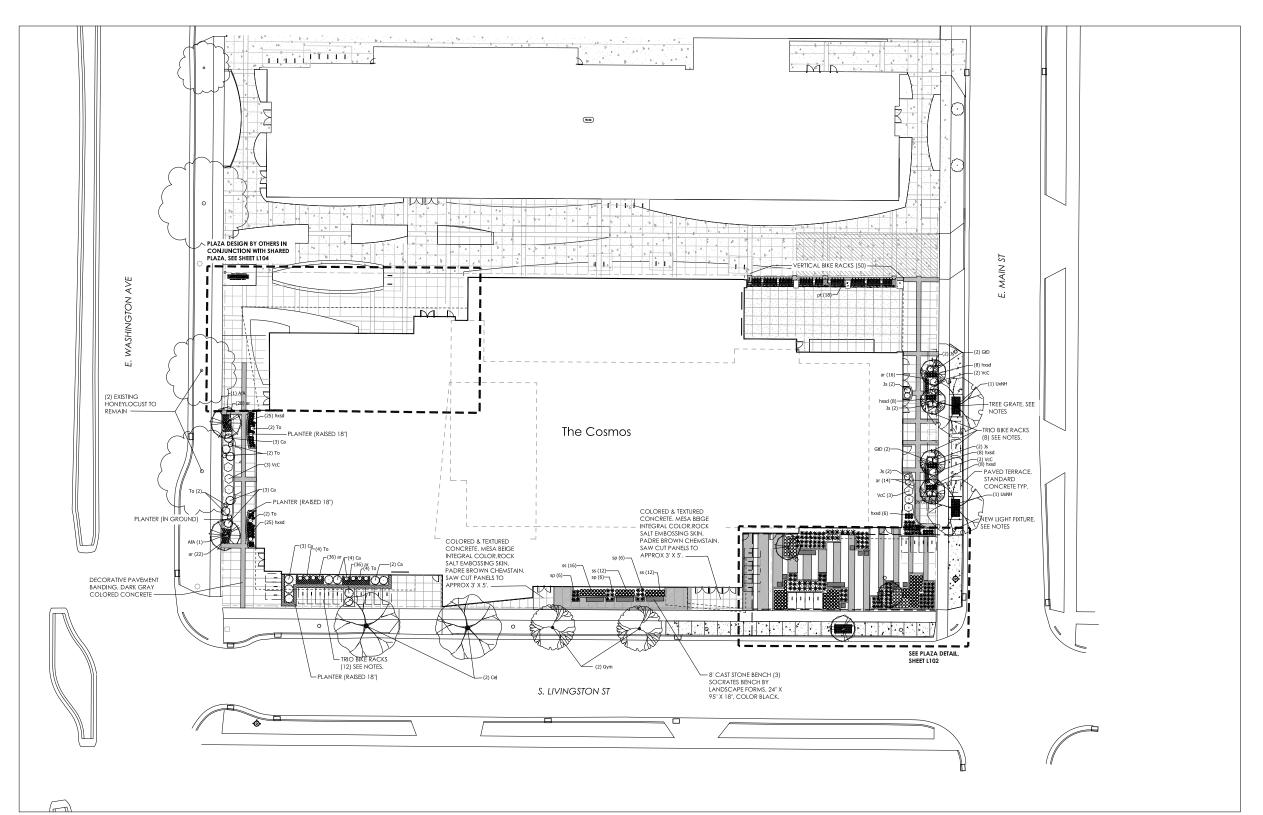





ARCHITECTURE ENGINEERING INTERIOR DESIGN

STRANG, INC. 6411 MINERAL POINT ROAD MADISON, WI 53705-4395

UDC Submittal (Revised)

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DATE	03-01-2017
PROJECT NO.	2016090
DDG IEGT TITLE	

GEBHARDT DEVELOPMENT -THE COSMOS PROJECT

801 E. WASHINGTON AVENUE MADISON, WISCONSIN 53703

SHEET NAME

LANDSCAPE PLAN



SHEET NO.

L101

PLANT SCHEDULE					
	DECIDUOUS TREES AfA Cel GtD Gym UxNH	BOTANICAL NAME / COMMON NAME Acer x freemant! Armstrong Armstrong Freeman Maple Celfs cocidentals: O'Chapoland / Common Hackberry Gleditsst tracanthos 'Draves' Street Keeper Honey Locust Gymnodadus diolca 'Espresso' Kentucky Coffeetree Ulmas x 'New Horizon' New Horizon Em	CONT B & B B & B B & B B & B B & B	CAL 2.5"Cal 2"Cal 2.5"Cal 2"Cal 2.5"Cal	QTY 2 2 4 2 2
	FLOWERING TREES Pyr	BOTANICAL NAME / COMMON NAME Pyrus calleryana "Capital" / Capital Callery Pear	CONT B & B	CAL 1,5"Cal	<u>QT</u>
	ANNUALS/PERENNIALS ar cs	BOTANICAL NAME / COMMON NAME Ajuga reptans `Bronze Beauty` / Bronze Beauty Bugleweed Celastrus scandens `Bailumn` / Autumn Revolution Bittersweet 3rt Floor Mechanical Screen Planters	SIZE 4" pot 1 gal	FIELD2	<u>QTY</u> 152 19
	hxsd pvs pt ss ses sp	Sid Floor Precisional Scient Platials Side Floor Daylily Hemerocallis x "Stella de Oro" Stella de Oro Taylily Paricum virgatum "Shenandoah" Shenandoah Red Switch Grass Parthenordssus tricupidata Soston Ivy Schizachyrium scoparium Little Bluestem Grass Sesleria autumnalis Autumn Moor Grass Sporobolus heterolepis Prairte Dropseed	4" pot 4" pot 1 gal 4" pot 4" pot 4" pot		96 17 18 137 48 147
	DECIDUOUS SHRUBS Ca VcC	BOTANICAL NAME / COMMON NAME Cotoneaster apiculatus / Cranberry Cotoneaster Viburnum carlesii `Compactum` / Korean Spice Viburnum	SIZE 3 gal 3 gal	FIELD2	<u>OT</u> 15 10
	EVERGREEN SHRUBS Js To	BOTANICAL NAME / COMMON NAME Juniperus sabina "Blue Forest" / Blue Forest Juniper Thuja occidentalis "Danica" TM / Danica Globe Cedar	SIZE 3 gal 5 gal	FIELD2	<u>QT</u> 12 16

GREEN ROOF PLANT SCHEDULE

GREEN ROOF PLANTS
Allium schoenoprasum 'Forescate' / Common Chives
Allium schoenoprasum 'Forescate' / Common Chives
Allium sensecrate gluacum / Ornamental Orion
Sedum aner / Goldmons Stornecrop
Sedum Porbatian 'Immergrunchen' / Hybrid Stonecrop
Sedum reflexum / Soruce-leaved Stonecrop
Sedum reflexum / Foresteramum' / Iceberg Stonecrop
Sedum spurium 'Dragon' s Blood' / Two Row Stone Crop
Sedum spurium 'Fudagaluf' / Sonecrop
Sedum ternatum / Hourantal Stonecrop
Sedum ternatum / Fudagaluf' / Spraite Dropseed

CREEN ROOF NOTES:

1. GREEN ROOF SYSTEM TO BE PRE-PLANTED TRAY SYSTEM, GREENGRID OR EQUAL. 4.2° DEPTH MIN. PLACE OVER WATERPROOF ROOF MEMBRANE, PROVIDE HOSE BIB CONNECTIONS FOR IRRIGATION, 2. SEE SHEET A202 FOR GREEN ROOF PLANTING AREA LOCATIONS AND DIMENSIONS.

GENERAL NOTES:

1. FINAL STREET TREE SPECIES SELECTION AND PLACEMENT TO BE DETERMINED IN COORDINATION WITH CITY FORESTER.

2. UNPAVED STREET TIEGRACES TO BE SODDED WITH TURF SOD.


3. NEW STREET LIGHTING TO MATCH ESTABLISHED CITY DESIGN. FINAL LIGHT QUANTITIES AND PLACEMENT TO BE DETERMINED BY CITY PUBLIC WORKS STAFF.

4. SITE PAYING TO BE STANDARD COLOR, BROOM FINISHED CONCRETE UNLESS OTHERWISE SPECIFIED.

5. ALL GROUND MOUNTED BIKE RACKS OUTSIDE OF PLAZA ARTA DB ET TRIO.


7. RACK BY FORMS AND SURFACES, IN GROUND MOUNT, ALUMINUM TESTURE FINISH, INSTALL PER CITY OF MADDISON BRACK SPACING GUIDELINES (AS SHOWN ON PLAN), VERTICAL BIKE RACKS TO SEE SPORTWORKS VERTICAL WALL MOUNT RACK OR SIMILAR.

6. TREE GRATES TO BE NEENAH FOUNDRY EXTENDED COLLECTION 48" X 96" GRATE. MODEL R-8815-A.

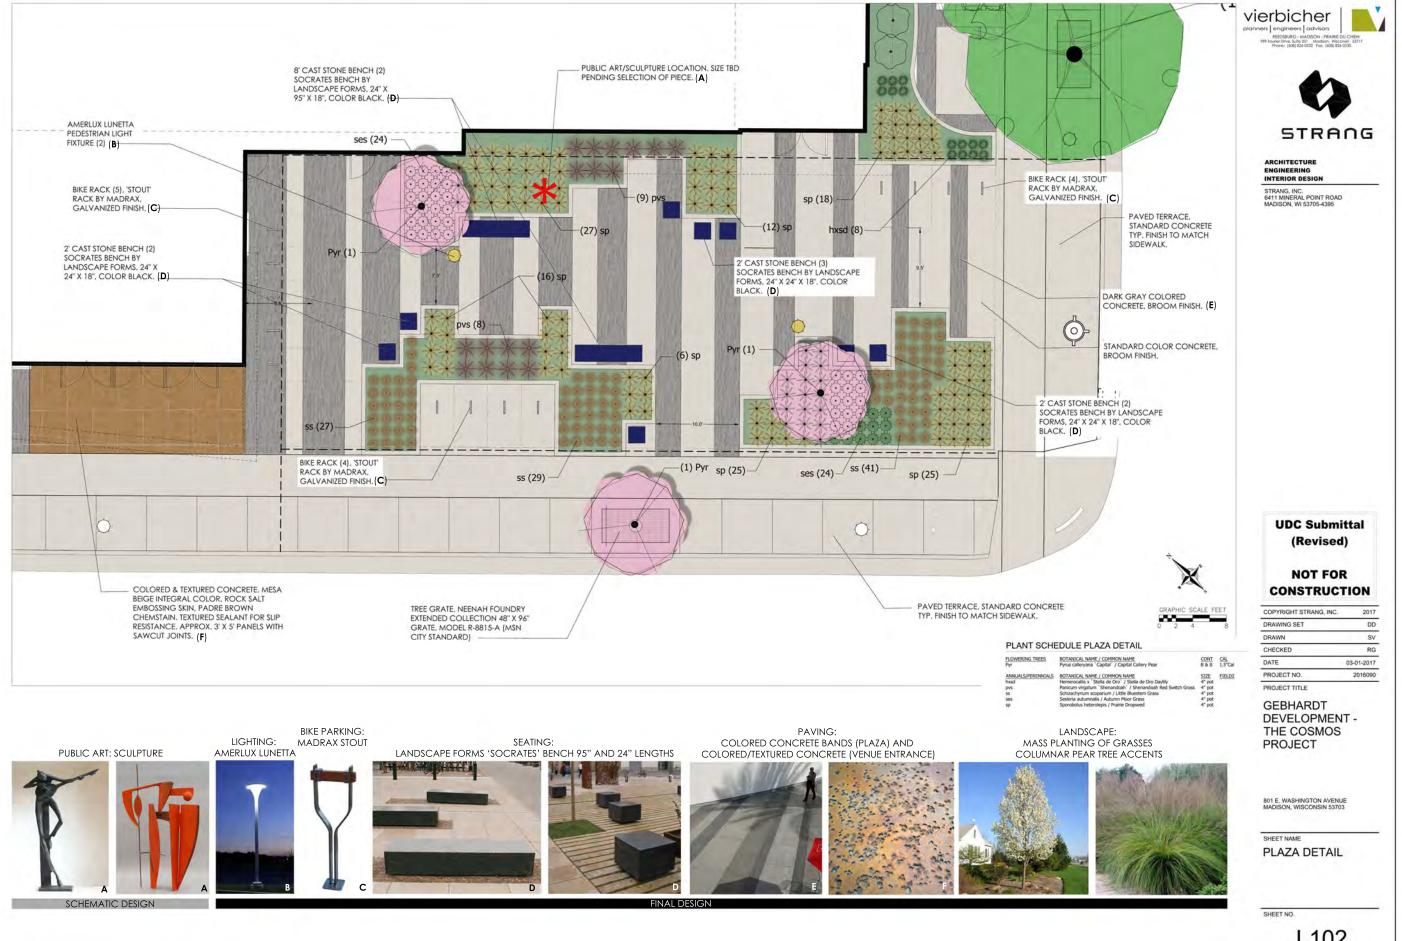


L102


1 IN-GROUND PLANTER DETAIL

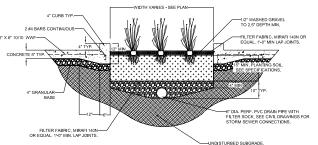

2) RAISED PLANTER/SEAT WALL 'A' DETAIL: PLAN VIEW

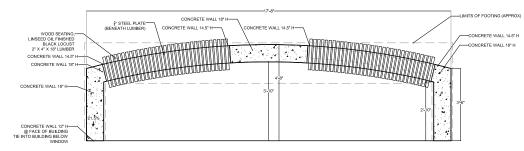

3 RAISED PLANTER/SEAT WALL DETAIL: SECTION VIEW

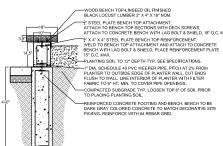

· - - - - <u>2</u>


vierbicher planners | engineers | advisors EEDSBURG-ANGSON-PRAIRE DU CHEN 975046 (Die Mar 2014) (Misson Waccold 2017)



ARCHITECTURE ENGINEERING INTERIOR DESIGN

STRANG, INC. 6411 MINERAL POINT ROAD MADISON, WI 53705-4395

POROUS PAVING/SCREENING PLANTER DETAIL NTS SCREENING MESH, SEE ARCHITECTURAL DETAILS. PLANTING SOIL PERMEABLE PAVERS DECORATIVE CONCRETE BAND DARK GRAY COLON TO MATCH SITE PAVING SOIL PERMEABLE PAVERS DETAIL SOIL STRUCTURAL SOIL TO 24" DEPTH TYP. SEE SPECIFICATIONS WASHED GRAVE DRAINGE LAYER "DIA PERF. PUT GRAIN PIPE WITH E SIGN SEWER CONNECTIONS.

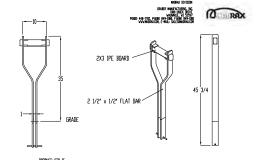



5 STOUT BIKE RACK DETAIL

MOTES

INCIDENT BUT BACKS ACCRESS TO WARFACTURES SECTIONING.


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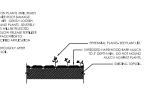
6 TREE PLANTING DETAIL- B&B


ANATORIS CHE UND HE APPROVAL OF THE LANGUAGE AND EXECUTION HAVE THE SOLD HAVE THE SOLD

7 SHRUB PLANTING DETAIL NTS



8 PERENNIAL PLANTING DETAIL

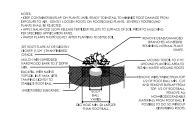

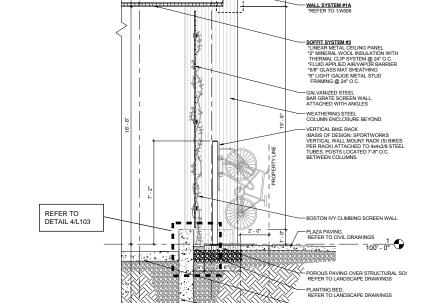

WALL SECTION AT VERTICAL BIKE PARKING

SCALE: N.T.S.

UDC Submittal (Revised)

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DATE	03-01-2017
PROJECT NO.	2016090

PROJECT TITLE

GEBHARDT DEVELOPMENT -THE COSMOS PROJECT


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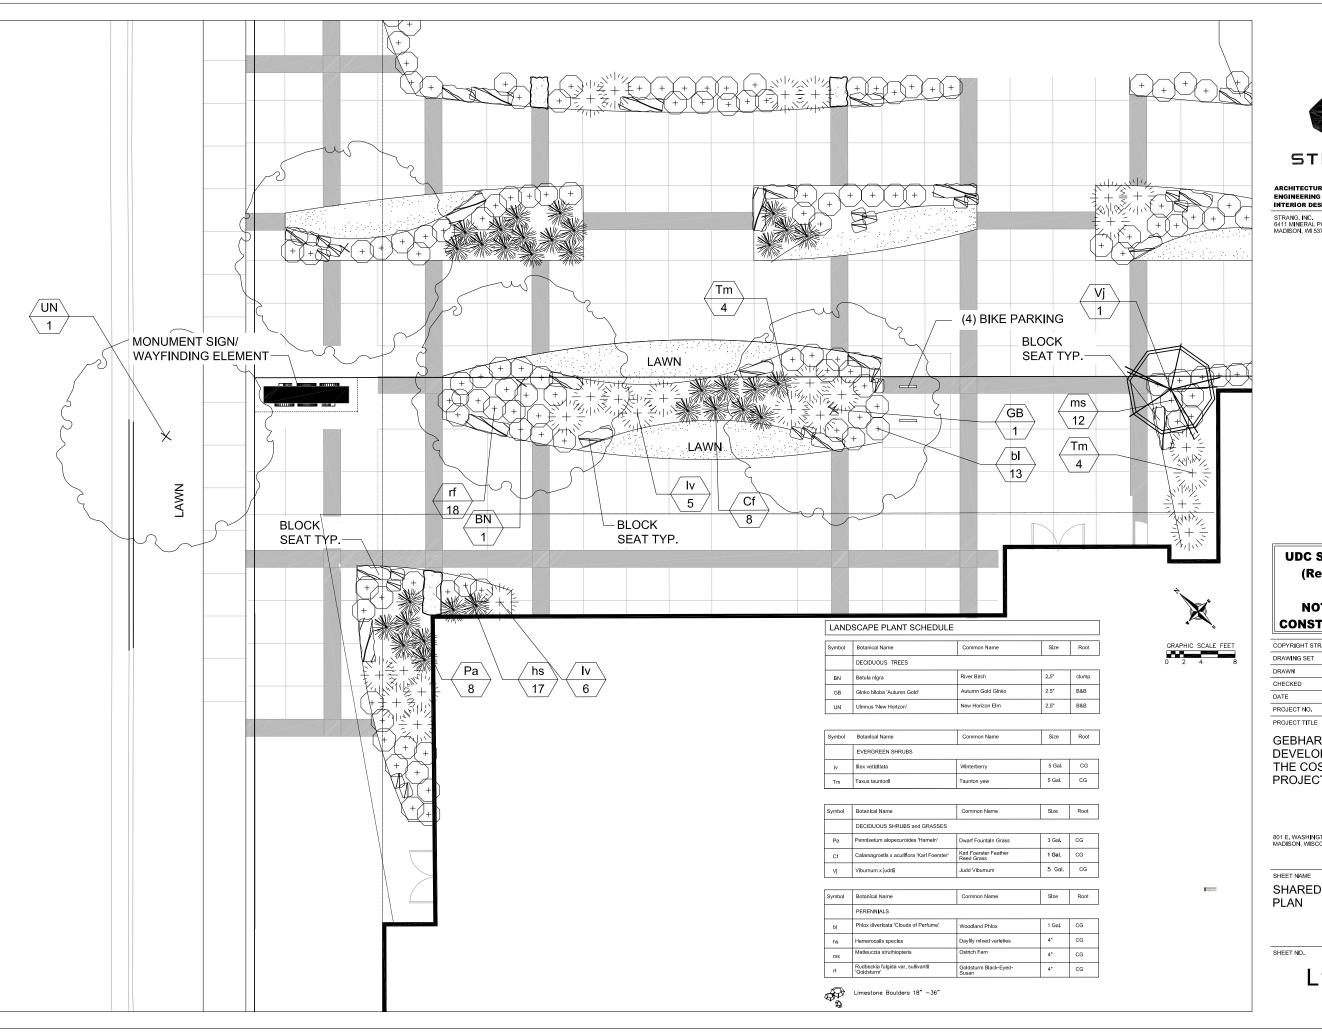
SHEET NAME

LANDSCAPE DETAILS

SHEET NO.

L103



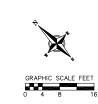



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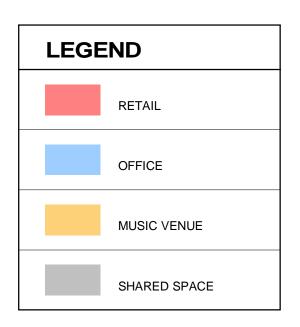
GEBHARDT DEVELOPMENT -THE COSMOS **PROJECT**


801 E. WASHINGTON AVENUE MADISON, WISCONSIN 53703


SHEET NAME

SHARED PLAZA

L104



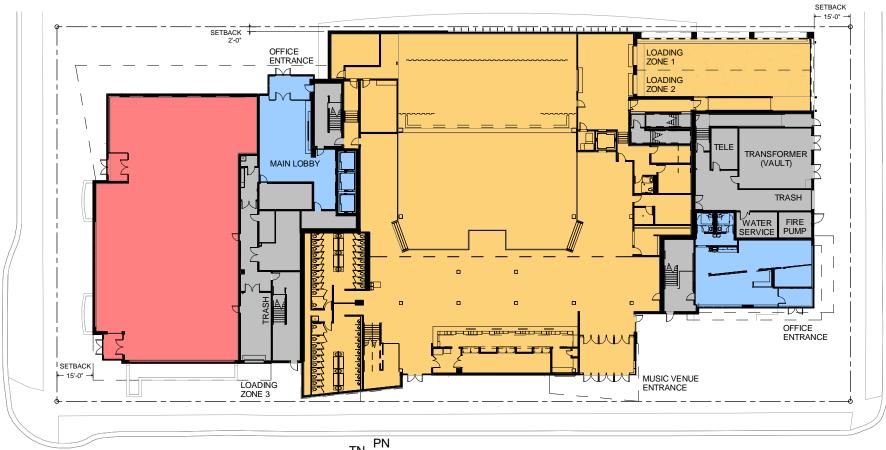

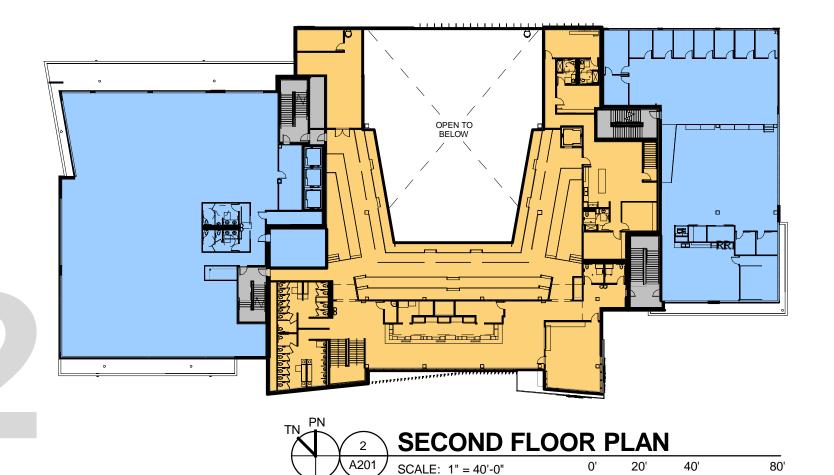











GEBHARDT DEVELOPMENT - THE COSMOS PROJECT

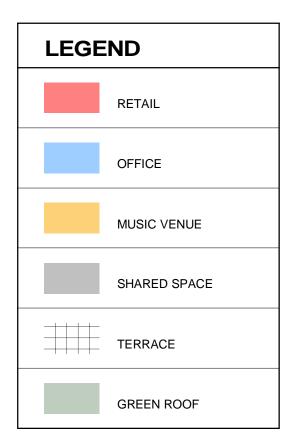

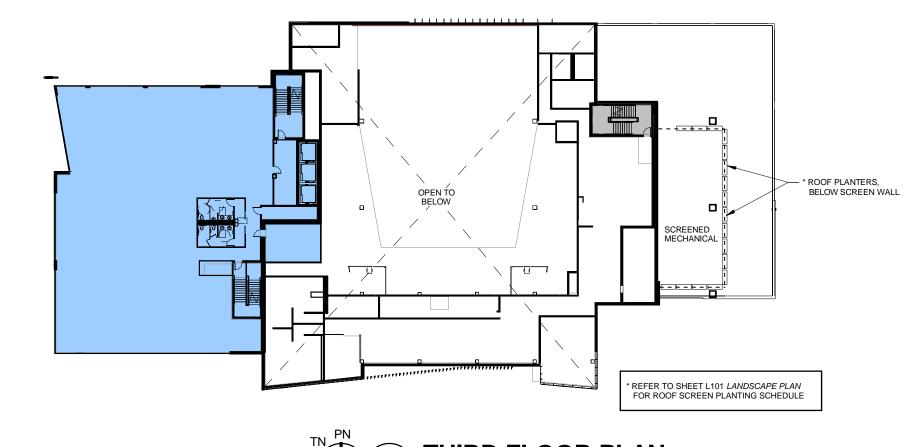

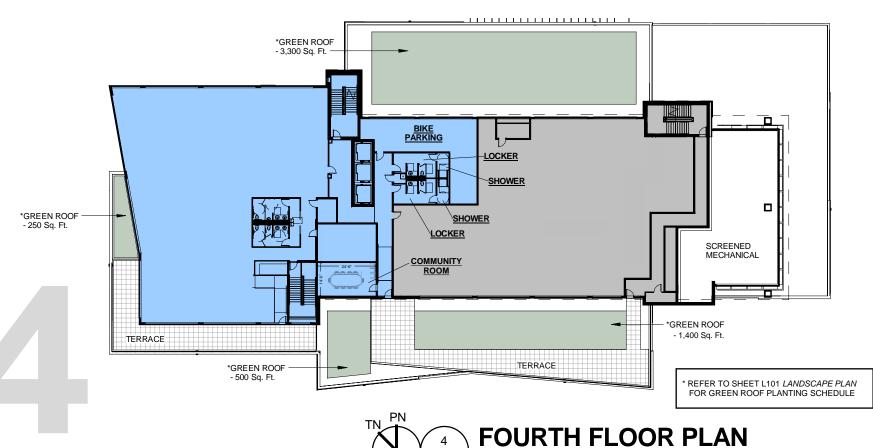

SCALE: 1" = 40'-0"

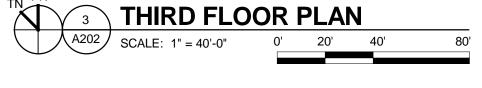








GEBHARDT DEVELOPMENT - THE COSMOS PROJECT 03-01-2017 A202

80'

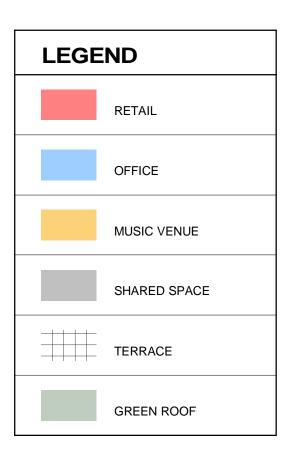

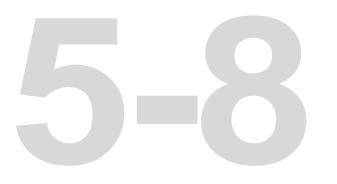

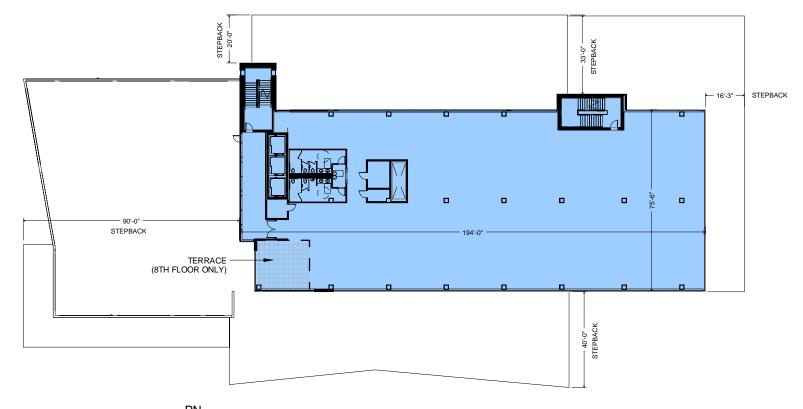

FIFTH THRU EIGHTH FLOOR PLANS





GEBHARDT DEVELOPMENT - THE COSMOS PROJECT

A203

SCALE: 1" = 40'-0"

















VIEW FROM E. WASHINGTON AVE. (LOOKING SOUTH-EAST)







VIEW FROM S. LIVINGSTON ST. (LOOKING NORTH-EAST)








VIEW FROM E. MAIN ST. (LOOKING NORTH-WEST)





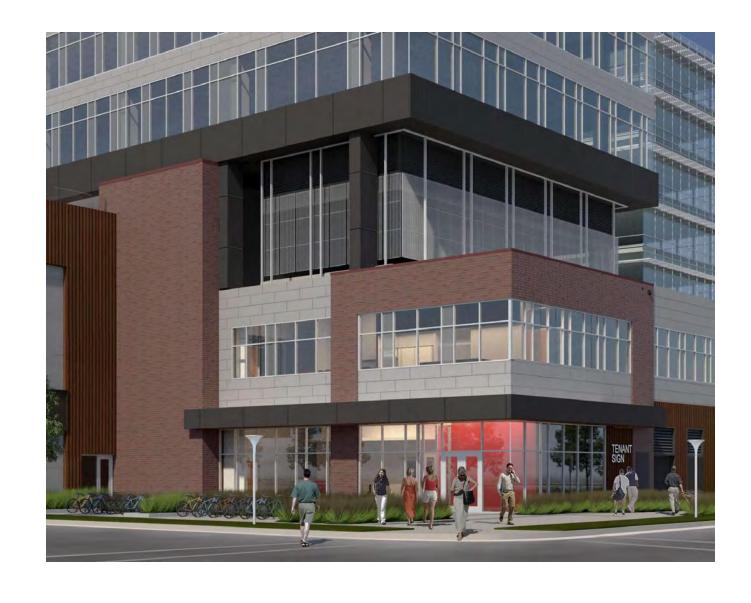











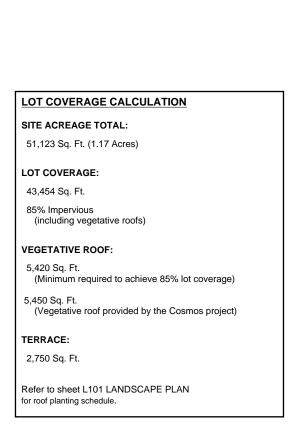

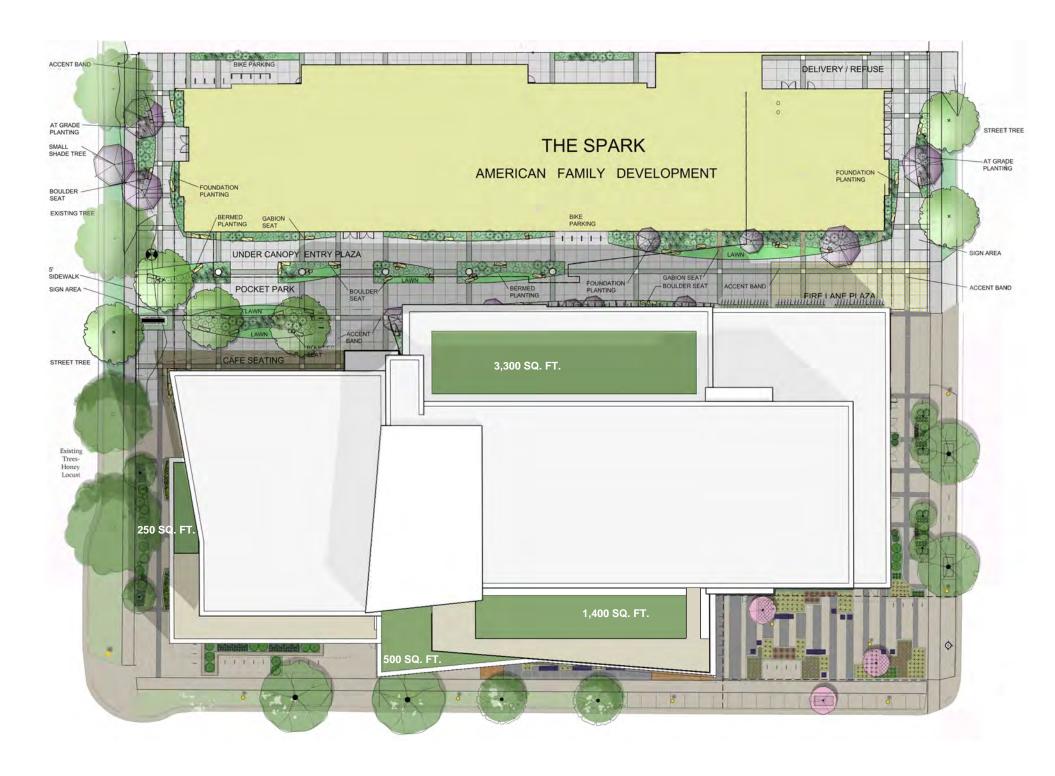




LOT COVERAGE DIAGRAM





GEBHARDT DEVELOPMENT - THE COSMOS PROJECT 03-01-2017 A601

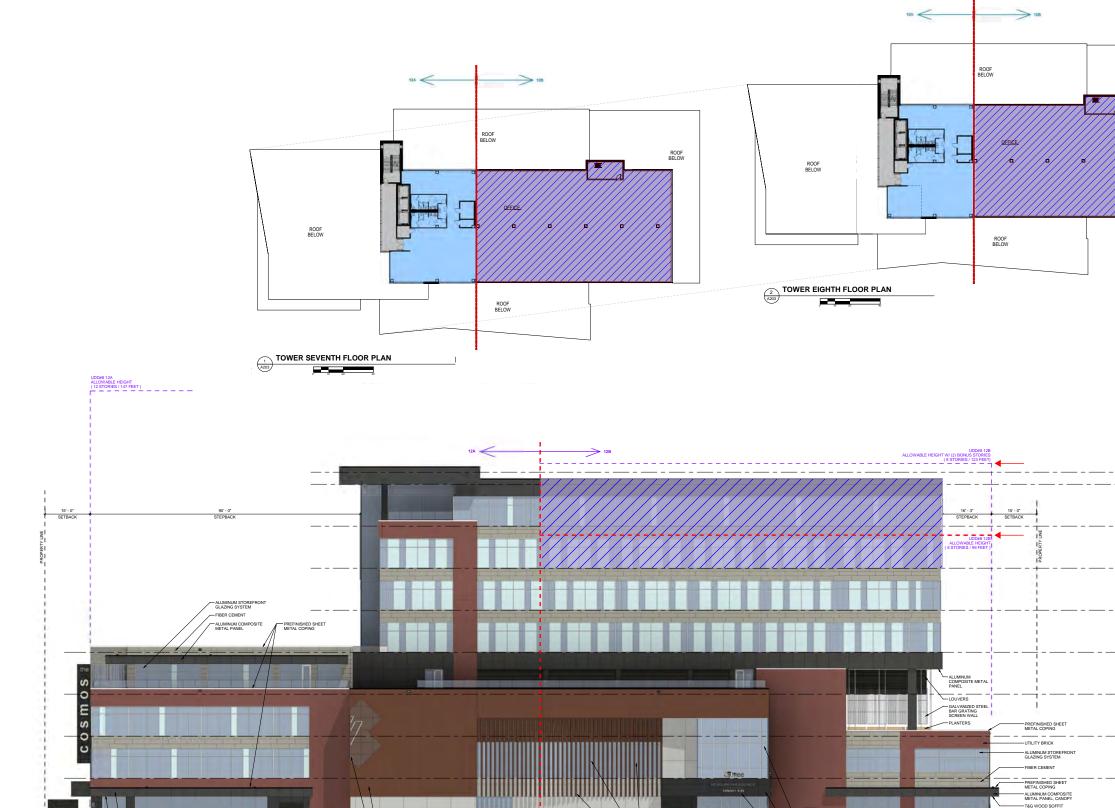

S. LIVINGSTON ST. (SOUTH/WEST) ELEVATION

GENERAL NOTES


Shaded portion of elevation and floor plans on sheet A701 represents the requested Bonus Stories / Area.

Urban Design District #8 makes provisions for Bonus Stories within it's

Urban Design District #8 makes provisions for Bonus Stories within it's Upper Level Development Standards. See except below.

UPPER LEVEL DEVELOPMENT STANDARDS Per UDD#8, MGO Sec 33.24(15)(e)12:

- b. Bonus stories may be allowed as follows:i. Two (2) bonus stories on Block...12b...
- c. Bonus stories may be granted if it is determined that the provisions of at least (1) element from i. or a combination of elements from ii. provides sufficient public benefit to warrant the additional height.
 - --On-site, publicly accessible plazas and/or pocket parks that are visible from the street and provide seating, landscaping, public art and/or other public amenities. For each one (1) square foot of plaza or park that is provided, five (5) square feet of bonus area is available.
 - ii. --Mid-block and through-block public pedestrian, bike, and/or vehicular connections.
 - --On-site, publicly accessible plazas and/or pocket parks that are visible from the street and provide seating, landscaping, public art and/or other public amenities. For each one (1) square foot of plaza or park that is provided, ten (10) square feet of bonus area is available.
 - --Adequately sized community meeting rooms available free of charge for neighborhood, public, or other community meetings...
 - --LEED Silver certification of equivalent
 - --Minimum of fifty percent (50%) vegetative roof cover.

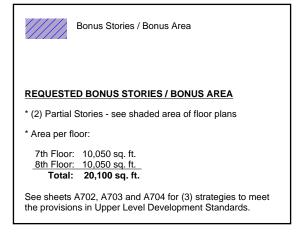



BONUS STORIES (REQUIREMENTS)


- ALUMINUM CURTAIN WALL GLAZING SYSTEM

STRANG

ROOF BELOW

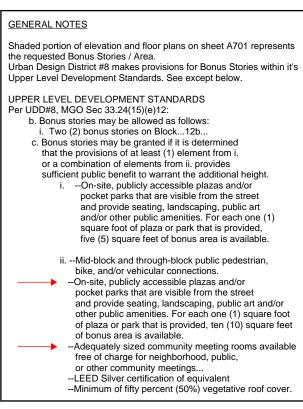

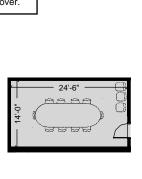

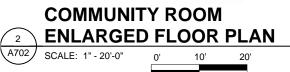



BERMED PLANTING

TERRACE

UNDER CANOPY ENTRY PLAZA

POCKET PARK

SMALL \

BOULDER SEAT

SIDEWALK~

BONUS STORIES (PROVISIONS)

On-site, publicly accessible plaza

and/or pocket park

 $(3,300 \text{ sq. ft.}) \times (10) = 33,000 \text{ sq. ft.}$

* Conditions of Sec 33.24(15)(e)12(c)(ii) are met

EARNED BONUS STORIES / BONUS

* (2) Stories

* Area:

Community Meeting Room

On-Site, Publicly Accessible Plaza + Community Meeting Room



1

DELIVERY / REFUSE

FIRE LANE PLAZA

THE SPARK

AMERICAN FAMILY DEVELOPMENT

LOCKER

SHOWER

TERRACE

LOCKER

COMMUNITY ROOM **MECHANICAL**


GABION SEAT

ACCENT BAND

STREET TREE

ACCENT BAND




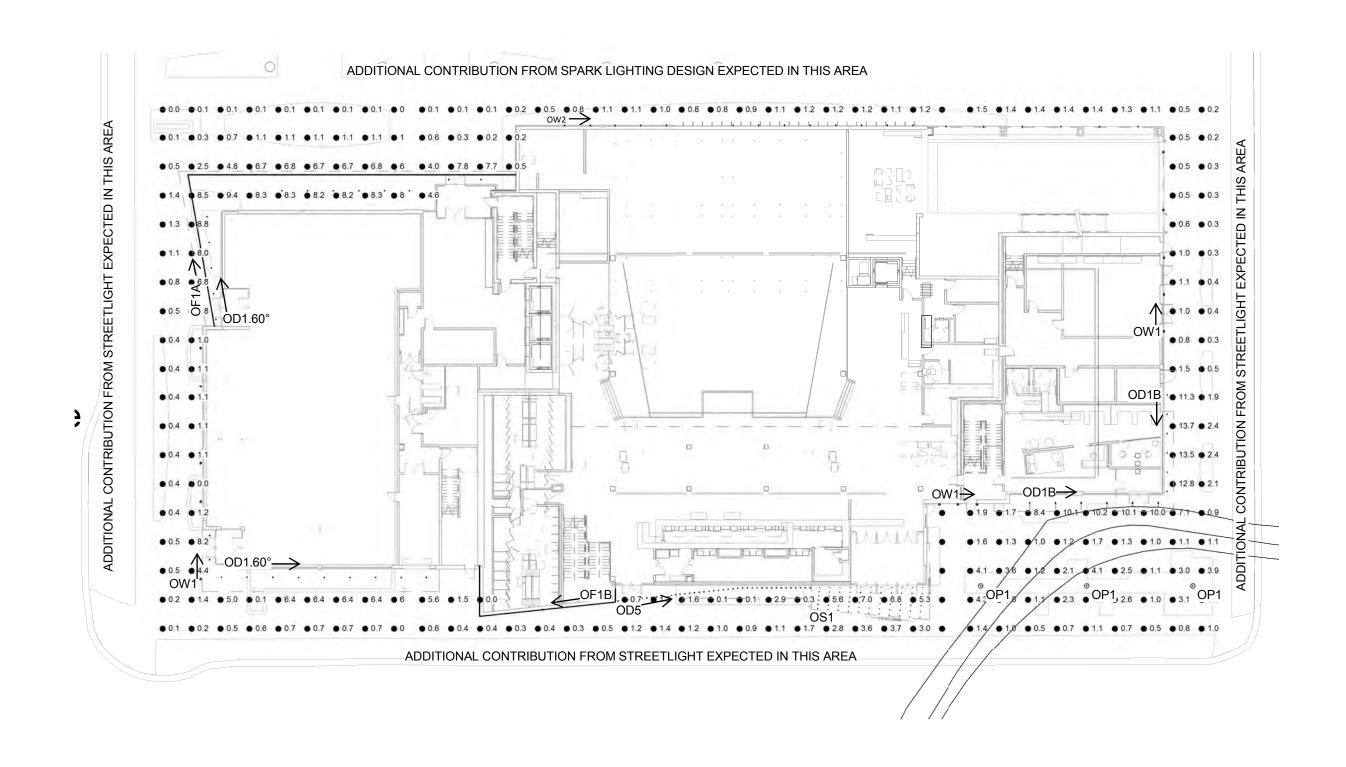


LIGHTING CALCS





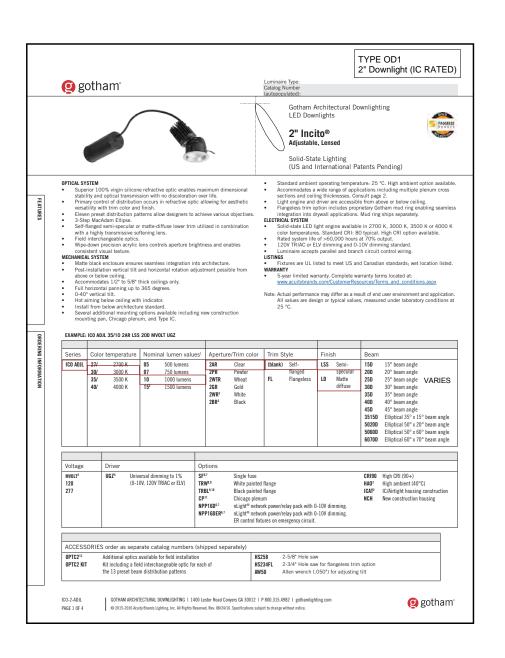



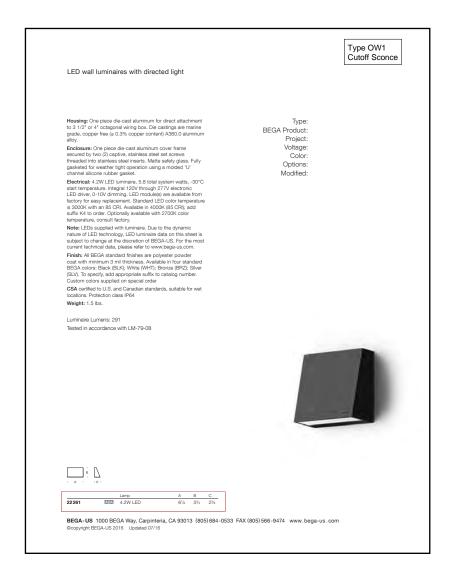










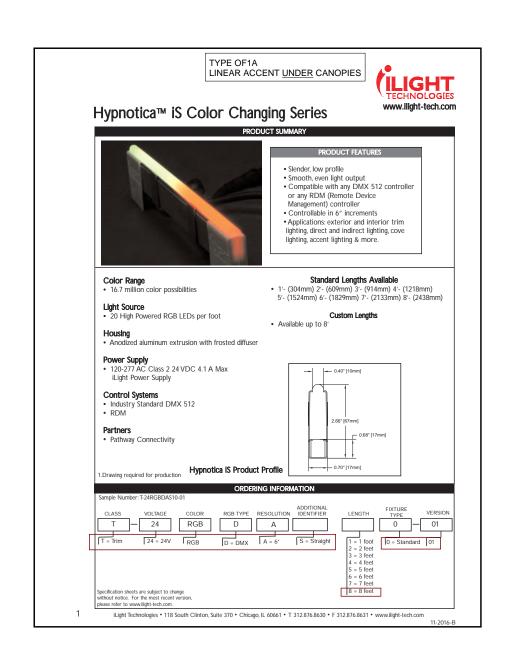










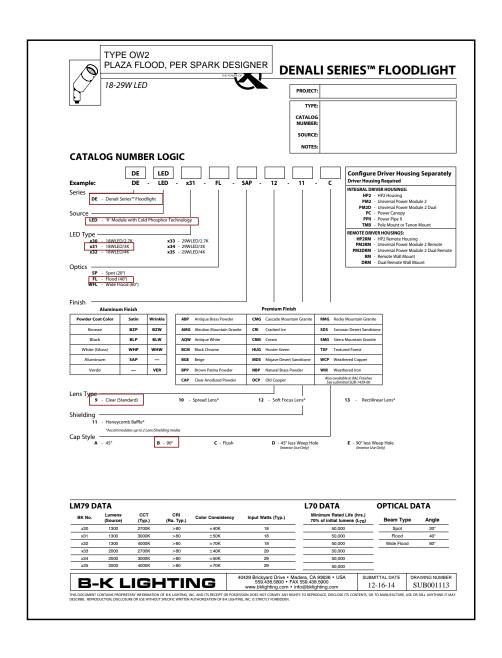


LIGHTING CUT SHEETS





GEBHARDT DEVELOPMENT - THE COSMOS PROJECT 03-01-2017 **E203**

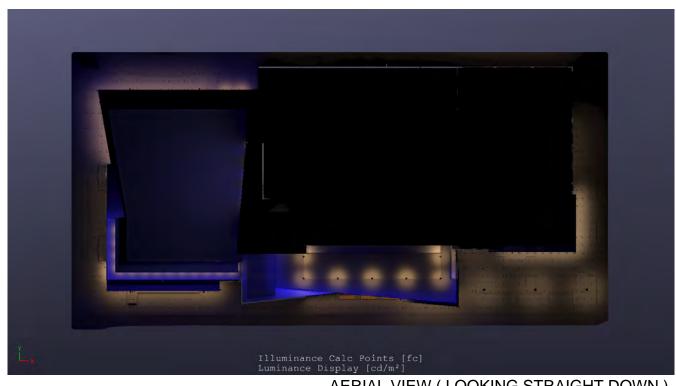


AERIAL VIEW (LOOKING STRAIGHT DOWN)



STREET LEVEL VIEW (LOOKING SOUTH-WEST)



STREET LEVEL VIEW (LOOKING SOUTH-EAST)

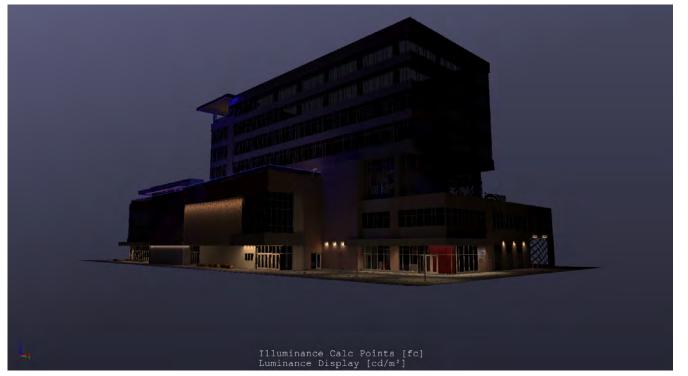


STREET LEVEL VIEW (LOOKING NORTH-EAST)






LIGHTING SIMULATIONS

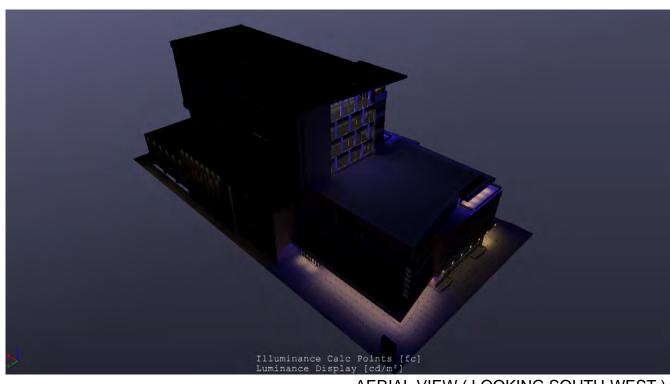


AERIAL VIEW (LOOKING SOUTH-WEST)

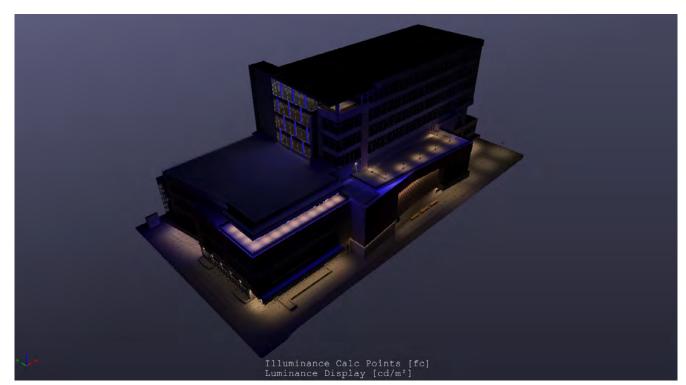

AERIAL VIEW (LOOKING SOUTH-EAST)



AERIAL VIEW (LOOKING NORTH-EAST)

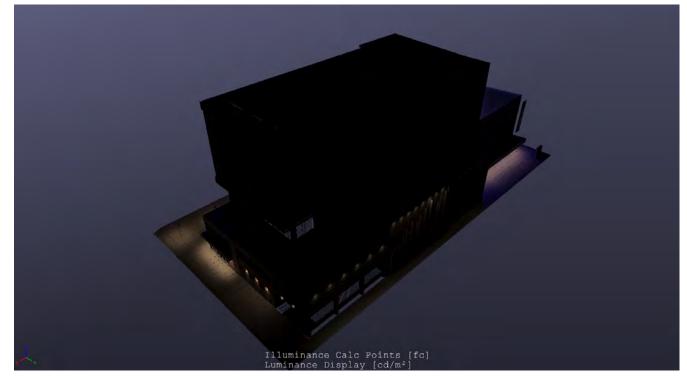

AERIAL VIEW (LOOKING NORTH-WEST)





LIGHTING SIMULATIONS